BENCHMARK	DATA			
DESCRIPTION	ELEVATION ENGLISH			
S.E. CORNER OF CONCRETE BASE FOR OLD WIND SOCK AT OFFICE BLDG	(589.10)			
BRASS PLUG IN WEST WALL © GRACE LUTH. CHURCH	(589.84)			
DESCRIPTION				

### DESCRIP HON

MORRIS MUNICIPAL AIRPORT

SECTIONS 10 & 15, TOWNSHIP 34N., RANGE 7E. OF 3RD P.M. SARATOGA TOWNSHIP GRUNDY COUNTY,

# THE CITY OF MORRIS, ILLINOIS

**MORRIS MUNICIPAL AIRPORT** 

JAMES R. WASHBURN FIELD

**CONSTRUCTION PLANS FOR** 

## APPLY EMULSIFIED ASPHALT SEAL COAT AND REMARK RUNWAY 18/36

**ILLINOIS PROJECT NO. C09-4763** SBG PROJECT NO. 3-17-SBGP-133/139/144

LATITUDE 41° - 25' - 31.8" LONGITUDE 88° - 25' - 7.2" **ELEVATION 585.01 JANUARY 29, 2021 RUNWAY CATEGORY B, GROUP II** 

YORKVILLE

JOLIET


INDEX OF SHEETS				
SHEET #	EET # DESCRIPTION			
1	COVER SHEET			
2	SITE MAP/ GENERAL NOTES			
3	SAFETY PLAN			
4	PLAN VIEW			
5	PAVEMENT MARKING DETAIL 1			
6	PAVEMENT MARKING DETAIL 2			

TOTAL NUMBER OF SHEETS = 6 CONTRACT NO. = MR024

ITEM NO. 04A


SUMMARY OF QUANTITIES					
ITEM #	ITEM # DESCRIPTION				
AR 150520	AR 150520 MOBILIZATION				
AR 201661	AR 201661 CLEAN AND SEAL BITUMINOUS CRACKS				
AR 608510	AR 608510 EXISTING ASPHALT SURFACE TREATMENT				
AR 620520	PAVEMENT MARKING — WATERBORNE	S.F.	29,500		



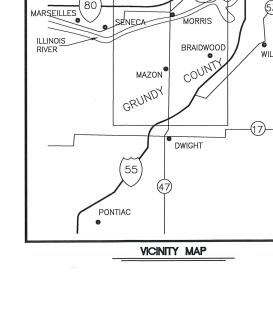


SANDWICH

MUNICIPAL AIRPORT

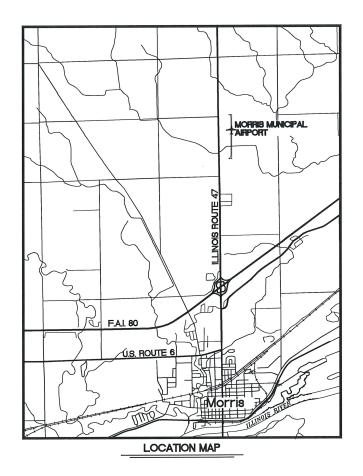

CITY OF MORRIS	Illinois Department of Transportation Division of Aeronautics	
APPROVED TO JOHN THE MAYOR		
DATE 1-29-2021 2020	APPROVED CHIEF ENGINEER	
APPROVED Care a adair CITY CLERK	DATE2020	
DATE Daywary 29, 2020		

WN BY: ECW	REVISIONS				CONCTRUCTION	CURRENT AS OF: 01/27/21		1
WIN DI. LOW	LEVEL	BY	DATE	DESCRIPTION	CONSTRUCTION	01/2		÷
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					DI VVIC			-
E: 10/01/2020					PLANS	FILE NO.:	1217-00	OF

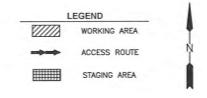

#### SAFETY PLAN:

- 1. All proposed work will be inside of the Airfield Operations Area (AOA). Runway 18/36 and surrounding taxiways will be closed for the duration of the project. Contractor must advise the Airport Manager no less then 72 hours before any runway/taxiway closures can take place.
- The Contractor shall be responsible for familiarizing himself and comply with the requirements of FAA Advisory Circular 150/5370-26. As part of this compliance, the Contractor shall prepare and submit a Safety Plan Compliance Document in accordance with AC 150/5370-2G. This document should be submitted to the Airport Manager for review. Once approved, the Airport Manager will submit the document to the Illinois Division of Aeronautics for final approval. The Contractor's Notice to Proceed will not occur until the Safety Plan Compliance Document has been approved.
- 3. All material storage, equipment parking, and employee parking shall occur in the area designated on the plans or as defined by the Resident Engineer as the Parking and Staging area. Stockpiled materials shall not violate FAA part 77 Airport Surfaces. The material storage, equipment and employee parking shall be clearly delineated
- 4. The Contractor shall limit the height of all equipment and material storage stockpiles to a maximum of 30 feet above the ground
- 5. The Contractor shall identify all vehicles and equipment with 3' square checkered flags (international orange and white) while on airport property.
- 6. The Contractor shall limit the number of vehicles traversing the designated work area. Under no circumstances shall the contractor's employees be allowed to operate personal vehicles within the AOA.

  7. The Contractor shall limit the use of construction equipment on pavements to remain or completed proposed
- 8. Only rubber tired vehicles may be operated on airport pavement that is to remain or has been completed. 9. All barricades located in the AOA shall be low profile as provided in the plan details and shall be kept outside of the denoted Runway Safety Area (RSA) and Taxiway Safety Area (TSA).
- 10. The Contractor shall provide a Safety Plan Compliance Document (SPCD) that details the contractor's methods for compliance with the project safety plan and the requirements of the FAA Advisory Circular 150/5370-2G. the SPCD shall be provided with the proposed project schedule, both of which shall be provided a minimum of 5 business days prior to the pre-construction meeting. the SPCD shall include the following information: A. Proposed access points and storage areas
- Temporary marking to be used Location and type of traffic control devices
- Areas of construction operations and measures to prevent equipment and employees from entering restricted Any requested alternatives to the requirements of the plans and specifications.
- 11. All Notice to Airmen (NOTAM) will be issued by the Airport Manager. A minimum of 72 hours' notice to the Airport Manager will be required for the issuance of a NOTAM. No runway or taxiway shall be closed without authorization by the Airport Manager.

#### **GENERAL NOTES:**

- The Contractor shall notify the Resident Engineer a minimum of 7 days prior to the start of construction. The Contractor shall provide a Construction Superintendent. The Superintendent shall be present on the site at any time work is being performed. Additionally, the Superintendent shall be available by phone 24 hours a day, 7
- days a week until the project has been deemed complete.

  3. The Contractor shall be responsible for the protection, preservation, and repair to any existing facilities that are to remain in place. The cost of this protection, preservation, and repair will not be paid for separately but
- should be included in the adjacent pay items.

  The Contractor shall be responsible to verify the existing conditions of the work area prior to beginning construction. Should discrepancies between the condition in the field and the information provided on the plan be discovered, the Contractor shall immediately notify the Resident Engineer.
- The Contractor shall maintain consistent coordination with the Resident Engineer, Airport Manager, and his subcontractors. Proposed work schedules shall be provided to and approved by the Resident Engineer. Updated schedules shall be provided to the Resident Engineer as the project progresses. The sequence of work shall closely follow the approved schedule unless written permission is given from the Resident Engineer to vary from
- the proposed schedule.

  6. The Contractor shall not enter the Airfield Operations Area (AOA) without expressed authorization from the Airport Manager. This authorization shall be obtained each day entry into the AOA is required.

  7. Prior to the request for final inspection, the Contractor shall have all waste, surplus materials, and non-critical equipment removed from the Airport Property. All areas disturbed by the Contractor shall be re-graded, top-soiled, and seeded.
- 8. The Contractor shall provide all necessary traffic control and maintenance as specified in the plans and as directed by the Resident Engineer. Traffic Control and maintenance may have to be adjusted from time to time to accommodate operations of the airport. These adjustments must be made as quickly as practicable. All work and equipment associated with traffic control and maintenance and adjustments thereof, shall not be paid for separately but shall be included in the cost of the contract.

  9. The Contractor shall be responsible for the protection of all pavements that have been inspected and approved
- Any damage to occur to a previously inspected and approved pavement shall be repaired by the Contractor at
- 10. The Calendar days for this contract were determined based on an approximated number of working days required to complete the proposed improvement. The number of available working days per month has been assumed as

	WORK	CING DAYS	
JANUARY	0	JULY	13
FEBRUARY	0	AUGUST	0
MARCH	0	SEPTEMBER	0
APRIL	0	DCTDBER	0
MAY	9	NOVEMBER	0
JUNE	4	DECEMBER	0

SITE MAP NOT TO SCALE

DRAWN BY: ECW DATE CHECKED BY: CHECKED CREATED: 10/19/2020




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MORRIS MUNICPAL AIRPORT SEAL COAT AND PAVEMENT MARKING MORRIS, ILLINOIS

SITE PLAN & GENERAL NOTES

FINAL

CURRENT AS OF: 01/27/21 SHEET 2 FILE NO.: 1217-00

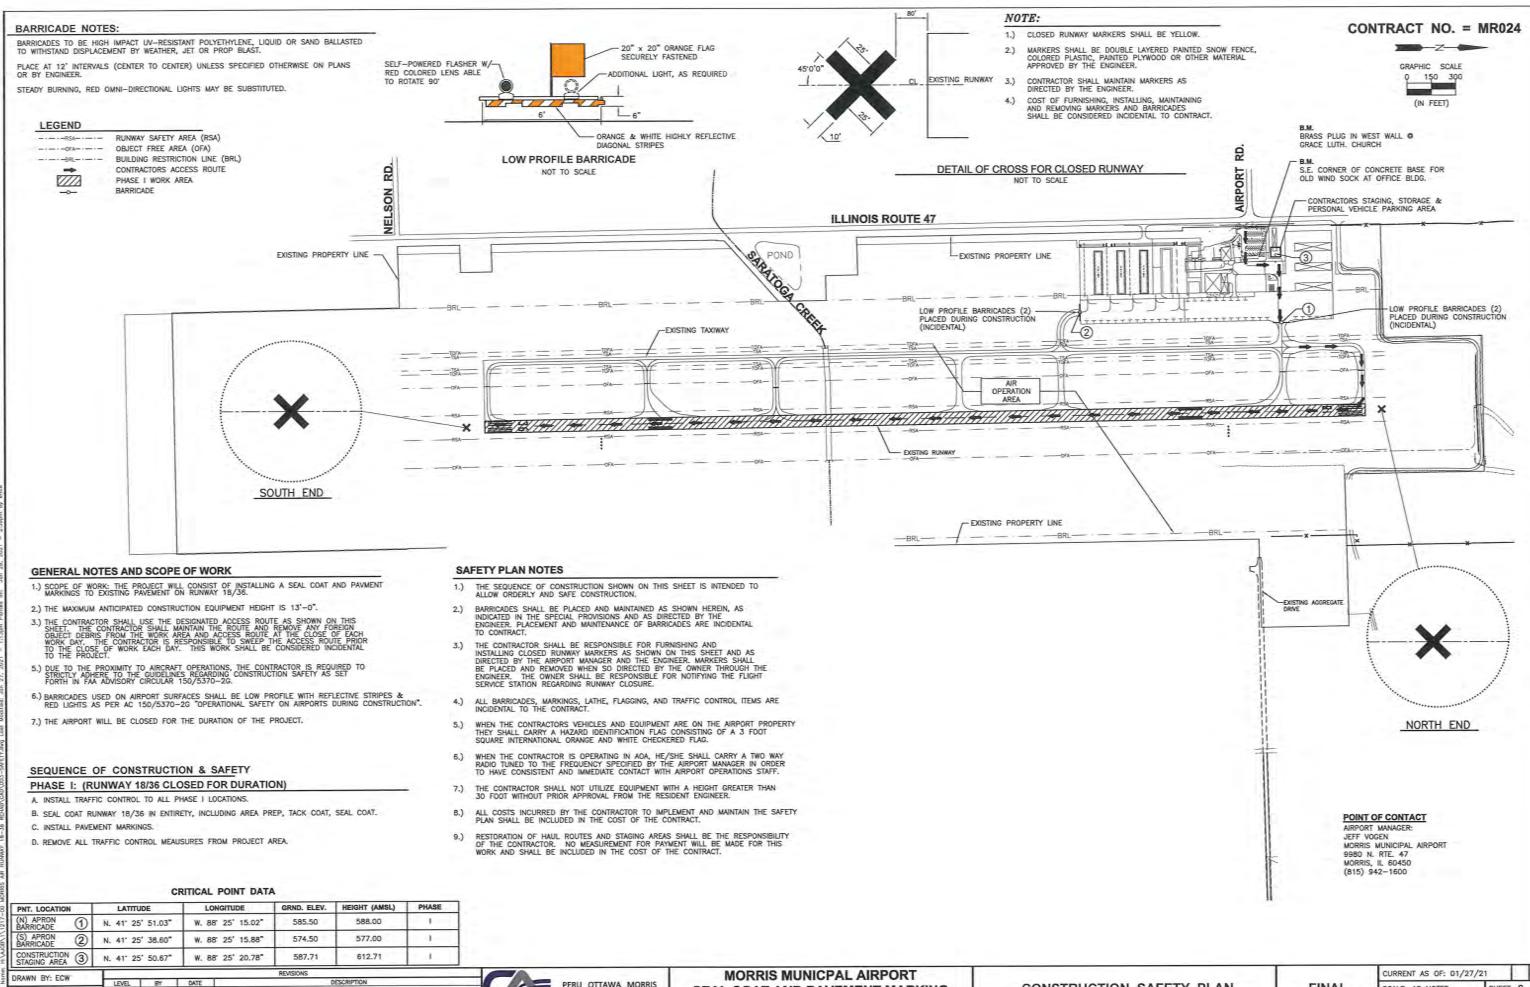

CHAMIN & ASSOCI

CHECKED BY: CHECKED

CREATED: 10/19/2020

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ILLINOIS

MORRIS MUNICPAL AIRPORT SEAL COAT AND PAVEMENT MARKING MORRIS, ILLINOIS

CONSTRUCTION SAFETY PLAN

FINAL SCALE: AS N

SCALE: AS NOTED SHEET 3
FILE NO.: 1217-00 OF 6

GRAPHIC SCALE 0 100 200 (IN FEET)


#### CLEAN AND SEAL BITUMINOUS CRACKS

RAWN BY: ECW

CHECKED BY: CHECKE

CREATED: 10/12/2020

- 1. REMOVE ALL VEGETATION AND DEBRIS FROM CRACKS TO A MINIMUM DEPTH OF 1 INCH.
  2. THE PAVEMENT TEMPERATURE SHOULD BE 50'F AND RISING OR MEET THE MANUFACTURER'S RECOMMENDATIONS AT THE TIME OF THE APPLICATION OF THE CRACK SEALING MATERIAL.
  3. SEALANT IS NOT TO BE INSTALLED IF MOISTURE IS OBSERVED IN THE CRACK.
  4. IF EXTENSIVE VEGETATION EXISTS, TREAT THE SPECIFIC AREA WITH A CONCENTRATED WATER BASED HERBICIDE, APPROVED BY THE RESIDENT ENGINEER.
  5. USE AN AIR COMPRESSOR WITH AN OPERABLE OIL AND WATER TRAP TO CLEAN ALL CRACKS, WITH COMPRESSED HOT AIR.
  6. IF NECESSARY, SAW OR ROUT THE CRACKS TO THE REQUIRED WIDTH AND DEPTH.
  7. THE CONTRACTOR SHALL APPLY THE SEALANT UNIFORMLY FROM THE BOTTOM TO THE TOP OF THE CRACK AVOIDING VOIDS OR ENTRAPPING AIR.
  8. FILL ALL CRACKS GREATER THEN 1/4 INCH WIDE WITH CRACK SEALANT (PER ASTIN D6690).
  9. UNDER-FILL THE CRACK SEALANT A MINIMUM OF 1/8 INCH, NOT TO EXCEED 1/4 INCH, TO AVOID CONTAMINATION OF SEAL COAT.
  10. ANY EXCESS JOINT OR CRACK SEALER SHALL BE REMOVED FROM THE PAVEMENT SURFACE.
  11. CONTRACTOR SHALL OPERATE IN ACCORDANCE WITH FAA ADVISORY CIRCULAR 150/5370—10H (CHAPTER 3) IN REGARDS TO THE CLEANING AND SEALING OF BITUMINOUS CRACKS ON RUNNWAY 18/36.

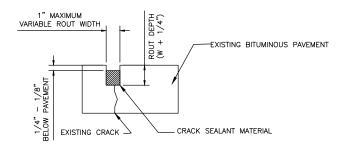

HMA CRACK SEALING DETAIL NOT TO SCALE

#### EMULSIFIED ASPHALT SEAL COAT W/ AGGREGATE

- AGGREGATE MATERIAL SHALL BE DRY, CLEAN, DUST AND DIRT FREE, SOUND, DURABLE, ANGULAR SHAPED MANUFACTURED SPECIALTY SAND, SUCH AS THAT USED AS AN ABRASIVE, WITH MOHS HARDNESS OF 6 TO 8.

  THE CONTRACTOR SHALL SUBMIT THE SPECIALTY SAND MANUFACTURER;S TECHNICAL DATA AND A MANUFACTURE'S CERTIFICATION OF ANALYSIS INDICATING THAT THE SPECIALTY SAND MEETS THE REQUIREMENTS OF THE MATERIAL DELIVERED FOR US ON THE PROJECT.

- 3. THE CONTRACTOR SHALL PROVIDE A CERTIFICATION SHOWING PARTICLE SIZE ANALYSIS AND PROPERTIES OF THE MATERIAL DELIVERED FOR USE ON THE PROJECT.

  4. THE CONTRACTOR'S CERTIFICATION MY BE SUBJECT TO VERIFICATION BY TESTING THE MATERIAL DELIVERED FOR USE ON THE PROJECT.

  5. DILUTION RATE FOR THE PROJECT SHALL BE DILUTED AT A ONE-TO-ONE RATIO. ONE PART CONCENTRATE TO ONE PART WATER.


  6. THE CONTRACTOR SHALL PROVIDE A COPY OF THE MANUFACTURER'S COA FOR THE EMULSIFIED ASPHALT DELIVERED TO THE PROJECT.

  7. THE COA SHALL BE SUBMITTED TO AND APPROVED BY THE RESIDENT ENGINEER PRIOR TO CONSTRUCTION OF THE PROJECT.

  8. THE ASPHALT MATERIAL STORAGE AND HANDLING TEMPERATURE SHALL BE BETWEEN 50°F 160°F.

  9. PRIOR TO FULL APPLICATION, THE CONTRACTOR SHALL PLACE A SERIES OF CONTROL STRIPS A MINIMUM OF 300 FEET LONG BY 12 FEET WIDE, AT VARYING APPLICATION RATES AS RECOMMENDED BY THE MANUFACTURER'S REPRESENTATIVE AND ACCEPTABLE TO THE RESIDENT ENGINEER TO DETERMINE APPROPRIATE APPLICATION RATE.

  10. THE CONTRACTOR SHALL FURNISH ALL EQUIPMENT, TOOLS, AND MACHINERY NECESSARY FOR THE PERFORMANCE OF THE WORK.
- 11. CONTRACTOR SHALL OPERATE IN ACCORDANCE WITH FAA ADVISORY CIRCULAR 150/5370-10H (CHAPTER 8) IN REGARDS TO EMULSIFIED SEAL COATING OF RUNWAY

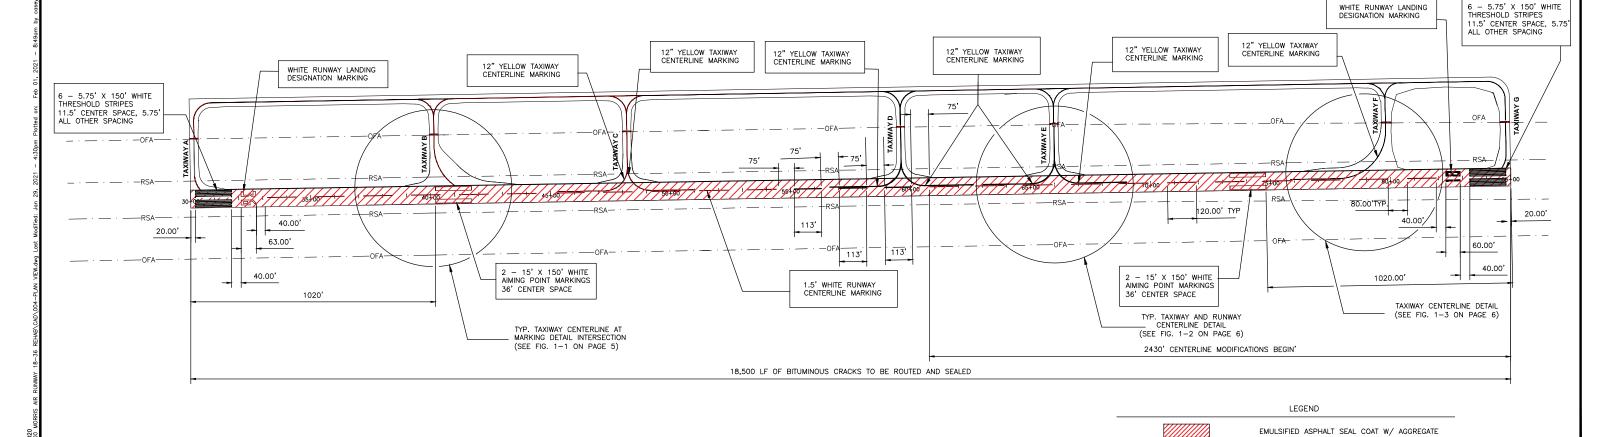

PERU OTTAWA MORRIS ILLINOIS

**MORRIS MUNICPAL AIRPORT SEAL COAT AND PAVEMENT MARKING** MORRIS, ILLINOIS

**PLAN VIEW** 

-RSA-

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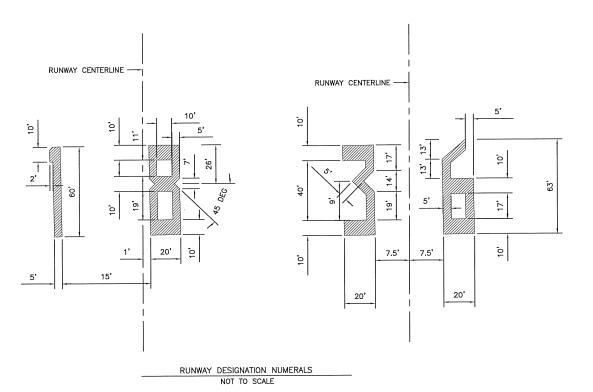
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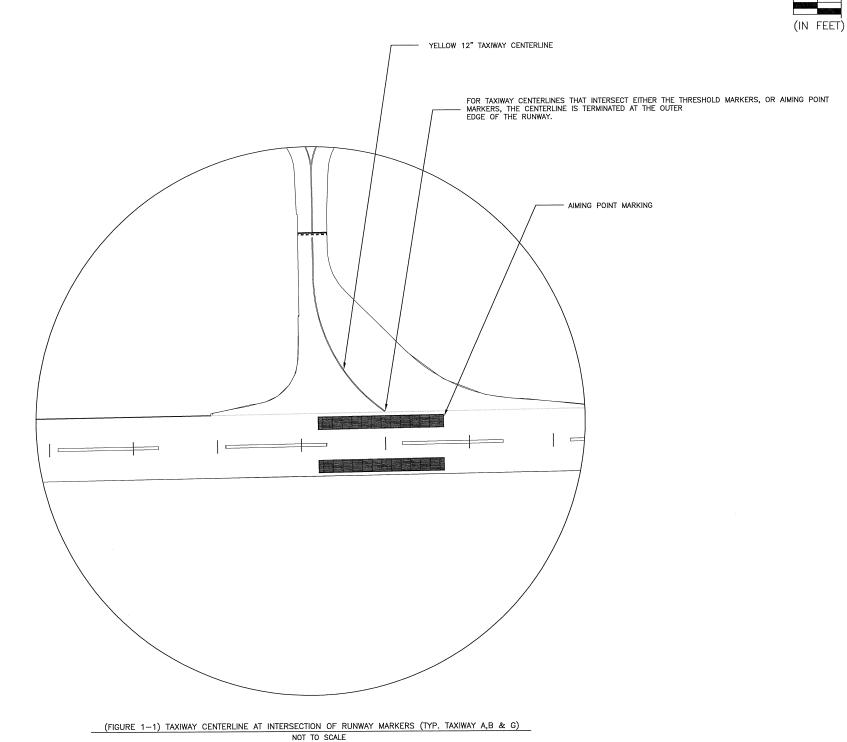
RUNWAY SAFETY AREA (RSA)

OBJECT FREE AREA (OFA)

CURRENT AS OF: 01/29/21 SCALE: AS NOTED HEET 4 FILE NO.: 1217-0

PAVEMENT	MARKING -	WATERBORNE	SCHEUDLE		
DESCRIPTION	UNIT AREA	NO. REQ'D	TOTAL		
NUMERAL 1	318 SF	1	318 SF		
NUMERAL 8	876 SF	1	876 SF		
NUMERAL 3	633 SF	1	633 SF		
NUMERAL 6	712 SF	1	712 SF		
CENTERLINE STRIPE	180 SF	25	4,500 SF		
THRESHOLD MARKING	863 SF	12	10,350 SF		
AIMING POINT MARKING	2,250 SF	4	9,000 SF		
		TOTAL WHITE	26,389 SF		
TAXIWAY CENTERLINE	301 SF	7	2,107 SF		
		TOTAL YELLOW	2,107 SF		
		TOTAL WATERBORNE	28,496 SF		





DRAWN BY: ECW

CHECKED BY: CHECKED

CREATED: 10/19/2020

PAVEMENT MARKING NOTES:

1. ALL RUNWAY MARKINGS ARE WHITE INCLUDING; CENTERLINES, RUNWAY DESIGNATION NUMERALS, THRESHOLD, AND AIMING POINT MARKERS

2. ALL TAXIWAY CENTERLINE MARKINGS ARE YELLOW

3. PERMANENT MARKINGS SHALL BE "WATERBORNE" PAINT AT AN APPLICATION RATE APPROVED BY THE RESIDENT ENGINEER

4. APPLY REFLECTIVE MEDIA ON ALL PAINTED SURFACES

REVISIONS

PERU OTTAWA MORRIS

**MORRIS MUNICPAL AIRPORT SEAL COAT AND PAVEMENT MARKING MORRIS, ILLINOIS** 


**PAVEMENT MARKING DETAIL** 

**FINAL** 

CURRENT AS OF: 01/27/21 SCALE: AS NOTED SHEET 5 6 FILE NO.: 1217-00

CONTRACT NO. = MR024 ZGRAPHIC SCALE 0 100 200

(IN FEET)

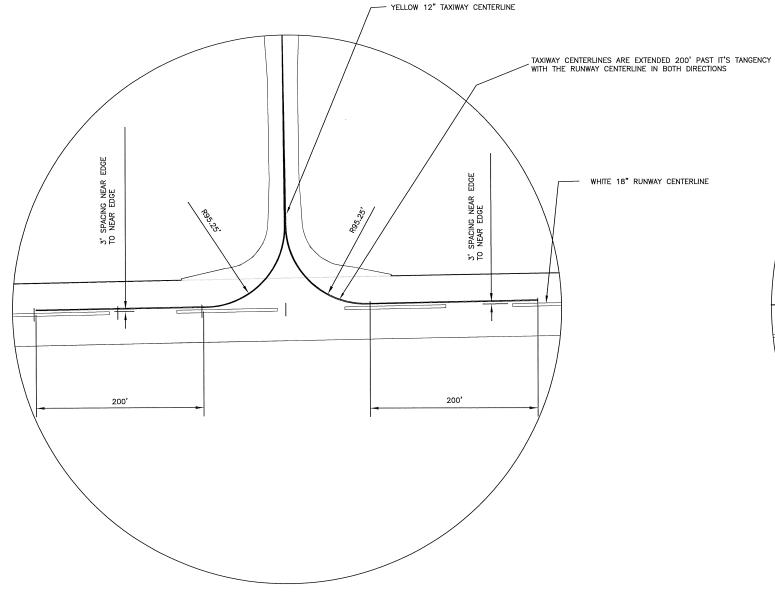

TAXIWAY CENTERLINES ARE EXTENDED 200' PAST IT'S TANGENCY WITH THE RUNWAY CENTERLINE - YELLOW 12" TAXIWAY CENTERLINE WHITE 18" RUNWAY CENTERLINE

(FIGURE 1-3) TAXIWAY CENTERLINE AND RUNWAY CENTERLINE INTERSECTION AT TAXIWAY F

NOT TO SCALE

PAVEMENT MARKING NOTES:

1. ALL RUNWAY MARKINGS ARE WHITE INCLUDING; CENTERLINES, RUNWAY DESIGNATION NUMERALS, THRESHOLD, AND AIMING POINT MARKERS
2. ALL TAXIWAY CENTERLINE MARKINGS ARE YELLOW
3. PERMANENT MARKINGS SHALL BE "WATERBORNE" PAINT AT AN APPLICATION RATE APPROVED BY THE RESIDENT ENGINEER
4. APPLY REFLECTIVE MEDIA ON ALL PAINTED SURFACES

CHECKED BY: CHECKED CREATED: 10/19/2020

PERU OTTAWA MORRIS

ILLINOIS

(FIGURE 1-2) TAXIWAY CENTERLINE AND RUNWAY CENTERLINE INTERSECTION (TYP. TAXIWAY C,D & E) NOT TO SCALE

> **MORRIS MUNICPAL AIRPORT SEAL COAT AND PAVEMENT MARKING** MORRIS, ILLINOIS

**PAVEMENT MARKING DETAIL 2** 

**FINAL** 

CURRENT AS OF: 01/27/21 SCALE: AS NOTED SHEET 6 FILE NO.: 1217-00