


	BRICK
	CMU MASONRY
	GRAVEL
	CAST-IN-PLACE CONCRETE
	EARTH
	RIGID INSULATION
	PRECAST CONCRETE

**MATERIALS KEY**

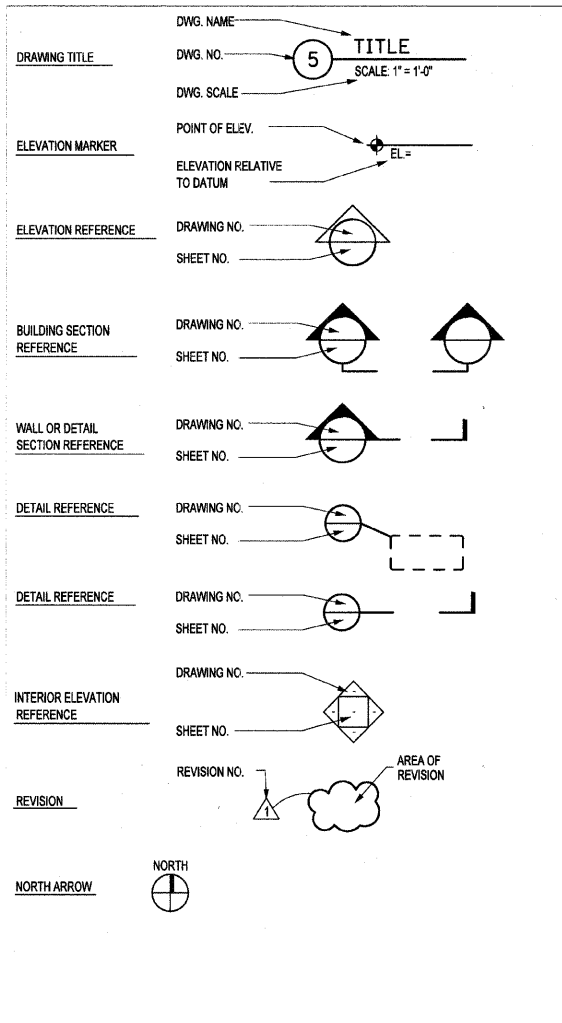

**SYMBOLS**

AB	ANCHOR BOLTS	EXIST	EXISTING	MACH	MACHINE	RE	REGARDING
ACT	ACOUSTICAL CEILING TILE	EXP	EXPOSED	MAINT	MAINTENANCE	REF	REFER TO
ADA	AMERICANS WITH DISABILITIES ACT	EXPN	EXPANSION	MAS	MASONRY	REINF	REINFORCE (ED, ING, MENT)
AFF	ABOVE FINISH FLOOR	EXT	EXTERIOR	MATL	MATERIAL	RES	REQUIRED
ALT	ALTERNATE	EXTR	EXTRUDED	MAX	MAXIMUM	REC'D	REQUIRED
ALUM	ALUMINUM	FA	FIRE ALARM	MECH	MECHANICAL	REV	REVERSE
APPROX	APPROXIMATE (LY)	FAAP	FIRE ALARM ANNUNCIATOR PANEL	MED	MEDIUM	RM	ROOM
AR	AREA OF REFUGE	FD	FLOOR DRAIN	MEMB	MEMBRANE	RO	ROUGH OPENING
ARCH	ARCHITECT (URAL)	FDC	FIRE DEPARTMENT STANDPIPE	MFR	MANUFACTURE (ER)	RR	RAILROAD
ASSY	ASSEMBLY	FDN	FOUNDATION	MH	MANHOLE	RSL	RESILIENT BASEBOARD
AUX	AUXILIARY	FE	FIRE EXTINGUISHER	MIN	MINIMUM	SAN	SANITARY
AR	AREA OF REFUGE	FEC	FIRE HOSE CABINET	MISC	MISCELLANEOUS	SC	SOLID CORE
@	AT	FFE	FINISH FLOOR ELEVATION	MO	MASONRY OPENING	SCH	SCHEDULE
B/	BOTTOM OF BOARD	FIN	FINISH (ED)	MP	METAL PANEL	SD	SMOKE DETECTOR
BD	BOARD	FIXT	FIXTURE	MS	MOP SINK	SDMG	SIDING
BITUM	BITUMINOUS	FL	FLUSH	MTD	MOUNTED	SEAL	SEALER
BLDG	BUILDING	FLR	FLOOR	MTL	METAL	SECT	SECTION
BLK	BLOCK (WOOD BLOCKING)	FLR	FLOOR	MULL	MULLION	SGFT	STRUCT. GLAZED FACE TILE
BTM	BOTTOM	FLUOR	FLUORESCENT	N	NORTH	SHT	SHEET
BR	BRICK	FR	FIRE RESISTANT	NA	NOT APPLICABLE	SHTHG	SHEATHING
BTWN	BETWEEN	FRT	FIRE RETARDANT TREATED	NIC	NOT IN CONTRACT	SIM	SIMILAR
C	CHANNEL SHAPE	FT	FEET (FOOT)	NOM	NOMINAL	SL	SLOPE
C/C	CENTER TO CENTER	FTG	FOOTING	NTS	NOT TO SCALE	SPEC	SPECIFICATION
CEM	CEMENTITIOUS	FVC	FIRE VALVE CABINET	OV	OVERALL	SPKR	SPEAKER
CIP	CAST-IN-PLACE CONCRETE	GA	GALVE	OC	ON CENTER	SQ	SQUARE
CIRC	CIRCULATION	GALV	GALVANIZE (ED)	OD	OUTSIDE DIAMETER	SS	STAINLESS STEEL
CJ	CONTROL JOINT	GC	GENERAL CONTRACTOR	OF	OFFICE	STD	STANDARD
CL	CENTER LINE	GL	GLASS/GLAZED	OH	OVERHEAD	STL	STEEL
CLG	CEILING	GLAM	GLUE LAMINATED LUMBER	OPNG	OPENING	STOR	STORAGE
CLOS	CLOSET	GR	GUARD RAIL	OP	OPPOSITE	STR	STAIR
CLR	CLEAR(ANCE)	GRD	GRADE	OPPH	OPPOSITE HAND	STRUCT	STRUCTURE (AL)
CMU	CONCRETE MASONRY UNIT	GRND	GROUND	PART	PARTIAL	ST.SM	STANDING SEAM
CO	CLEAN OUT	GRP	GROUP	PARTN	PARTITION	SUSP	SUSPENDED
COL	COLUMN	GWB	GYPSPUM WALLBOARD	PC	PRECAST CONCRETE	SYM	SYMBOL
COMP	COMPOSITE	GYP	GYPSPUM	PCF	POUNDS PER CUBIC FOOT	SYS	SYSTEM
CONC	CONCRETE	HB	HINGE BRICK	PCP	PRECAST PAVERS	TRD	TREAD
CONN	CONNECT (ED, ING, ION)	HC	HOLLOW CORE	PED	PEDESTRIAN	T/	TOP OF
CONN	CONSTRUCTION	HD	HEAD	PERF	PERFORATED	T & G	TONGUE AND GROOVE
CONT	CONTINUOUS	HDW	HARDWARE	PERP	PERPENDICULAR	TD	TRENCH DRAIN
CONTR	CONTRACTOR	HDWD	HARDWOOD	PKG	PARKING	TEL	TELEPHONE
COORD	COORDINATE (ED)	HGT	HEIGHT	PL	PLATE	THK	THICK / THICKNESS
CT	CLAY TILE	HM	HOLLOW METAL	PLAM	PLASTIC LAMINATE	TT	TRAFFIC TOPPING
CTR	CENTER	HOR	HORIZONTAL	PLBG	PLUMBING	TYP	TYPICAL
CU	CUBIC	HP	HIGH POINT	PLSTR	PLASTER	UH	UNIT HEATER
DBL	DOUBLE	H.R.	HAND RAIL	PLYWD	PLYWOOD	UL	UNDERWRITERS LABORATORIES, INC.
DET	DETAIL	HRS	HOURS (FIRE RESISTANT RATING)	PNL	PANEL	PR	UNDERCUT
DF	DRINKING FOUNTAIN	HTG	HEATING	PR	PAIR	UNDRCT	UNLESS NOTED OTHERWISE
DIA	DIAMETER	HTR	HEATER	PREFAB	PREFABRICATE	U.N.O.	UNION PACIFIC RAILROAD
DIAG	DIAGONAL	HV	HIGH VOLTAGE	PSF	POUNDS PER SQUARE FOOT	U.P.	UNION PACIFIC RAILROAD
DIFF	DIFFUSER	ID	INSIDE DIAMETER	PSI	POUNDS PER SQUARE INCH	VAR	VARIABLE
DIM	DIMENSION	INFO	INFORMATION	PT	PAINT	VCT	VINYL COMPOSITION TILE
DN	DOWN	INSUL	INSULATION	PTD	PAINTED	VERT	VERTICAL
DN	DOWN	IN	INCH (ES)	PVC	POLYVINYLCHLORIDE	VF	VERIFY IN FIELD
DN	DOWN	INCL	INCLUDED (ING)	PVG	PAVING	VTR	VENT THROUGH ROOF
DPPG	DAMP-PROOFING	INT	INTERIOR	PVMT	PAVEMENT	VIN	VINYL
DR	DOOR	JST	JOIST	PVR	PAVER	W	WIDE FLANGE SHAPE
DS	DOWNSPOUT	JT	JOINT	QTY	QUANTITY	WF	WITH
DWG	DRAWING	KSF	KIPS PER SQUARE FOOT	RDR	RISER	W/O	WITHOUT
EA	EACH	KSI	KIPS PER SQUARE INCH	RAD	RADIUS	WC	WATER CLOSET
EJ	EXPANSION JOINT	LAM	LAMINATED	RB	RESILIENT BASE	WD	WOOD
EL	ELEVATION	LAND	LANDING	RBC	RUBBERIZED BITUMINOUS	WDW	WINDOW
ELEC	ELECTRICAL	LAV	LAVATORY	COMP	COMPOUND	WP	WORKING POINT
ELEV	ELEVATION	LB	POUND (S)	RCP	REFLECTED CEILING PLAN	WT	WEIGHT
ENC	ENCLOSURE	LL	LIVE LOAD	RD	ROOF DRAIN	WNR	WOOD VENEER
ENTR	ENTRANCE	LOB	LOBBY	RECYC	RECYCLE	WWF	WELDED WIRE FABRIC
EQ	EQUAL	LP	LOW POINT	RECEPT	RECEPTACLE	YD	YARD
EQUIP	EQUIPMENT	LWT	LIGHTWEIGHT				
ETC	ETCETERA						
EMC	ELECTRIC WATER COOLER						
EXH	EXHAUST						

**ABBREVIATIONS**

SHEET #	DESCRIPTION
G1.0	ABBREVIATIONS, SYMBOLS, DRAWING LIST
A1.0	OAK PARK AVE. VIADUCT PLAN
A1.1	OAK PARK AVE.-VIADUCT ELEVATIONS
A1.2	OAK PARK AVE.-VIADUCT ELEVATIONS
A2.0	ORNAMENTAL METAL PANEL ENLARGED PLANS AND DETAILS
A2.1	GATEWAY MONUMENT SIGN DETAILS

**DRAWING LIST**



USER NAME = #USER#	DESIGNED <i>AT</i>	REVISED -
	DRAWN <i>EB</i>	REVISED -
PLOT SCALE = #SCALE#	CHECKED <i>DK</i>	REVISED -
PLOT DATE = #DATE#	DATE <i>11-18-2008</i>	REVISED -

STATE OF ILLINOIS  
DEPARTMENT OF TRANSPORTATION

ABBREVIATIONS, SYMBOLS, DRAWING LIST

SCALE: AS SHOWN SHEET NO. OF SHEETS STA. TO STA.

F.A. RTE.	SECTION	COUNTY	TOTAL SHEETS	SHEET NO.
2775	06-00243-00-BR	COOK	14	5
FED. ROAD DIST. NO. ILLINOIS FED. AID PROJECT			CONTRACT NO. 63091	

SHEET G1.0