State of Illinois Department of Natural Resources

Office of Mines and Minerals

Division of Abandoned Mined Lands

Funded by the United States Department of Interior Federal Office of Surface Mining

Farmington Embankments
Reclamation Project
AML-GKnE-1411
Knox County

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STATE MAP

Farmington Embankment

Knox County

PROJECT LOCATION MAP

Pre-Bid Meeting:

A pre-bid meeting for this project is scheduled for 10:00 A.M. February 20, 2015 at the Farmington Municipal Building, 322 East Fort Street, Farmington, Illinois.

Approved for Bidding:

James Hafliger, Acting Director Office of Mines and Minerals

Approved By:

June Points


Greg Pinto, Acting Manager

Prepared By IDNR Staff

Preared By:



Hanson Professional Services Inc. 1525 S. 6th Street Springfield, IL 62568 phone: 217-788-2450 fax: 217-788-2503

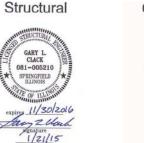



Contract No. M1411

SCHEDULE OF DRAWINGS:

- 1. Cover Sheet
- 2. Sheet Index and IDOT Standards List
- 3. Summary of Quantities and General Notes
- 4. Erosion Control Plan and Laydown Area
- 5. Existing West Site Demolition Plan
- 6. Existing East Site Demolition Plan
- 7. Site Development Plan
- 8. Proposed West Site Grading Plan
- 9. West Site Sections and Details
- 10. Proposed East Site Grading Plan
- 11. Proposed Outlet Structure Sections and Details
- 12. East Site Sections
- 13. Typical Details
- 14. Proposed Road Plan and Profile
- 15. Structural General Notes
- 16. Proposed Drop Inlet Structural Plans and Sections
- 17. Proposed Drop Inlet Structural Details and Sections
- 18. Proposed Energy Dissipator Plans and Sections
- 19. West Site Road Sections Sta. 0+00 to Sta. 4+00
- 20. East Site Road Sections Sta. 11+00 to Sta. 13+50
- 21. East Site Road Sections Sta. 14+00 to Sta. 16+00
- 22. East Site Road Sections Sta. 16+50 to Sta. 17+16
- 23. Boring Logs
- 24. Boring Logs

665001-02

IDOT Standard Drawings Applicable to the Contract

Woven Wire Fence

280001-07	Temporary Erosion Control System
542301-03	Precast Reinforced Concrete Flared End Section
602701-02	Manhole Steps
630001-10	Steel Plate Beam Guardrail
630301-06	Traffic Barrier Terminal, Type 1 (Special) Tangent
631011-09	Traffic Barrier Terminal, Type 2

SPACING LETTERS 3.5" 3.5" 3.0" 3.5" 2.5" 2.5" 2.5" 3.0"

ABANDONED MINED LANDS RECLAMATION PROJECT STATE OF ILLINOIS

BRUCE RAUNER, GOVERNOR

10" dia. state seal

Department of Natural Resources Wayne Rosenthal, Director

Funding provided by the US Department of the Interior Office of Surface Mining, with fees paid by the Coal Industry

- 2. The sign shall be painted on ½" or thicker exterior plywood (4' x 8'), color shall be black on white, and a 10" diameter Illinois state seal shall be provided by the D.N.R.
- 3. The posts shall be made of 4" x 4" wood or 2.5" metal pipe, and shall be 10' long. The sign shall be securely fastened to the posts with six 2.5" long, round head wood screws (for wood posts) or four 5" long, $\frac{3}{8}$ "
- diameter corriage bolts (for wood or metal posts).

 4. The top of the sign shall be level with the top of the posts, and the posts shall be 1' from the edges of the sign. The posts shall be set in the ground 3', so that the bottom of the sign is 3' from the ground.

CONSTRUCTION SIGN DETAIL

EXACT LOCATION TO BE SET BY ENGINEER

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SUMMARY OF QUANTITIES OLIANTITY QUANTITY PAY ITEM UNIT TOTAL ITFM NO. WEST SITE FAST SITE NRM20110 | Special Clearing 5204 NRM20210 Earth Excavation Cu Yd 2251 7455 NRM20510 Dam Embankment Cu Yd 7554 7554 21001000 | Geotechnical Fabric For Ground Stabilization 889 1149 2038 Sa Yd 25000200 Acre 3.5 Seeding, Class 2 NRM25040 Nitrogen Fertilizer Nutrient Pound 120 840 960 NRM25050 | Phosphorus Fertilizer Nutrient Pound 100 700 800 NRM25060 Potassium Fertilizer Nutrient 250 1750 2000 Pound NRM25070 Agricultural Limestone Ton 25100115 Mulch Method 2, Procedure Acre NRM25810 Mowing 3.5 Acre .5 4 28000400 Perimeter Erosion Barrier (Silt Filter Fence) Foot 850 2800 3650 28000500 Inlet and Pipe Protection Each 28100107 Stone Riprap A4 (RR4) Sq Yd 748 748 28100109 Stone Riprap A5 (RR5) 240 240 480 Sa Yd 28200200 Filter Fabric Sq Yd 240 988 1228 NRM28610 Special Excelsior Blanket 2130 5614 7744 Sa Yd Aggregate Base Course, Type A, 8" Ton 405 525 930 40200800 | Aggregate Surface Course, Type E Ton 202 263 465 48100300 Aggregate Shoulder Type A 4" 232 Sq Yd 178 410 50105220 Pipe Culvert Removal Foot 125 146 271 50200100 Structure Excavation Cu Yd 66 66 50200300 Cofferdam Excavation 3600 3600 Cu Yd 50201101 Each Cofferdam (Location -50201102 Cofferdam (Location - 2) Each 50201103 | Cofferdam (Location - 3) Fach 50201104 Cofferdam (Location - 4) Each 151 50300225 Concrete Structures Cu Yd 151 50800205 Reinforcement Bars, Epoxy Coated Pound 34250 34250 50901760 | Pipe Handrail Foot 121 121 Foot 170 542A4057 Pipe Culverts, Class A, Type 6, 72" (Reinforced Concrete) 170 NRM54210 Concrete Pressure Pipe, 42" Foot 176 176 54213717 | Precast Reinforced Concrete Flared End Sections 72" Each 2 NRM55010 Ductile Iron Pipe Vent. 8" Dig. L. Sum NRM60110 | Toe Drain and Graded Filter L. Sum NRM60410 | Trash Rack - Drop Inlet Structure L. Sum 63000001 Steel Plate Beam Guardrail Type A 6 ft Spacing Foot 400 600 1000 63100045 Traffic Barrier Terminal, Type 2 Fach 63100167 Traffic Barrier Terminal, Type 1 (Special) Tangent Each 63200310 Guardrail Removal Foot 450 957 1407 Foot 550 696 66500105 1246 66501400 Woven Wire Gates, 4'x12' Double Each 67000500 | Engineer's Field Office Type B Cal. Mo. NRM67110 Mobilization L. Sum Each 4 78201000 Terminal Marker - Direct Applied X0327195 Concrete Pipe Cradle Cu Yd 126 126 X0327691 Grating for Concrete Flared End Sections Fach X5504210 Ductile Iron Pipe Storm Sewers, 12" Foot 50 50 X6040205 Frames and Lids Special Fach 1 Foot 125 X6330725 Steel Plate Beam Guardrail (Short Radius) 125 XX004656 Embankment Cu Yd 1200 1200 XX004897 Gate Valve 12" Ductile Iron & Operator Each Z0004002 Each Bollards Z0022800 Fence Remova Foot 672 653 1325

- 1. See Special Provisions
- 2. See Plan Details

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SITE GENERAL NOTES

<u>GENER</u>AL

- "IDOT STANDARD SPECIFICATIONS", WHERE REFERENCED IN THE PLANS OR TECHNICAL SPECIFICATIONS, REFERS TO THE "STANDARD SPECIFICATIONS FOR ROAD AND BRIDGE CONSTRUCTION" ADOPTED JANUARY 1, 2012, AND THE "SUPPLEMENTAL SPECIFICATIONS AND RECURRING SPECIAL PROVISIONS" ADOPTED JANUARY 1, 2015, BOTH PUBLISHED BY THE ILLINOIS DEPARTMENT OF TRANSPORTATION (IDOT).
- 2. PRIOR TO PERFORMING ANY WORK IN OR ON THE RIGHT OF WAY OF ANY PUBLIC R.O.W., THE CONTRACTOR SHALL NOTIFY THE PUBLIC AGENCY ENGINEER'S OFFICE. THE CONTRACTOR SHALL ERECT WARNING SIGNS AND BARRICADES TO PROTECT THE TRAVELING PUBLIC AND HIS WORKERS. THE SIGNING AND BARRICADING SHALL CONFORM TO THE APPROPRIATE APPLICATIONS OUTLINED IN THE MANUAL OF UNIFORM TRAFFIC CONTROL DEVICES OR AS OTHERWISE DIRECTED BY THE PUBLIC AGENCY ENGINEER. IF PERMITS ARE REQUIRED TO CONDUCT THE WORK ON PUBLIC R.O.W., THE CONTRACTOR SHALL SECURE THE PERMITS AND SUPPLY THEM TO THE OWNER AT NO ADDITIONAL COSTS.
- 3. ALL SECTIONS, DETAILS, AND NOTES SHOWN ON THE DRAWINGS ARE INTENDED TO BE TYPICAL AND SHALL APPLY TO SIMILAR SITUATIONS ELSEWHERE, UNLESS
- 4. ANY EXISTING ADJACENT PAVEMENT DAMAGED DURING REMOVAL SHALL BE REPLACED WITH PAVING MATERIALS MATCHING IN KIND THE EXISTING PAVEMENT.
- THE CONTRACTOR SHALL VERIFY ALL DIMENSIONS AND EXISTING CONDITIONS BEFORE STARTING WORK. IF CONDITIONS VARY FROM THOSE INDICATED ON THE DRAWINGS, THE OWNER SHALL BE NOTIFIED AND NO WORK SHALL BE DONE IN THE AREA WITHOUT HIS APPROVAL
- 6. THE CONTRACTOR SHALL COORDINATE WORK AND COOPERATE WITH OTHER SUBCONTRACTORS ON ADJACENT AND CONCURRENT WORK.
- 7. SCALE FOR THE DRAWINGS IS FOR GENERAL INFORMATION ONLY. LOCATIONS AND DIMENSIONS SHALL BE TAKEN AS SHOWN AND NOT SCALED
- 8. IT IS THE CONTRACTOR'S RESPONSIBILITY TO ASCERTAIN EXISTING FIELD CONDITIONS BEFORE BIDDING ON THIS PROJECT, ORDERING MATERIALS, OR BEGINNING
- 9. CONTRACTOR'S WORK ACTIVITIES SHALL BE RESTRICTED TO AREAS WITHIN THE LIMITS OF CONSTRUCTION. CONTRACTOR'S ACTIVITIES AND VEHICLES SHALL NOT BE ALLOWED OUTSIDE OF THESE LIMITS UNLESS APPROVED BY THE OWNER.
- 10. DISTURBED EARTH SURFACES SHALL BE SEEDED PER THE PROJECT SPECIFICATIONS.

SURVEY AND LAYOUT

- WHERE SECTION, SUB-SECTION, SUBDIVISION, OR PROPERTY MONUMENTS ARE ENCOUNTERED. THE ENGINEER SHALL BE NOTIFIED BEFORE SUCH MONUMENTS ARE REMOVED. THE CONTRACTOR SHALL PROTECT AND PRESERVE ALL PROPERTY MARKERS UNTIL AN OWNER OR AUTHORIZED SURVEYOR HAS WITNESSED OR REFERENCED THEIR LOCATION.
- 2. THE CONTRACTOR SHALL BE RESPONSIBLE FOR RE-ESTABLISHING ANY PROPERTY MONUMENTS THAT BECOME DAMAGED OR DESTROYED DURING CONSTRUCTION
- 3. THE CONTRACTOR SHALL BE RESPONSIBLE FOR PROPER ALIGNMENT (VERTICAL AND HORIZONTAL) AT ALL INTERFACES BETWEEN NEW AND EXISTING WORK TO ASSURE PROPER INSTALLATION AND USAGE.

CONTACT INFORMATION

MR. JIM GREGG, NORTHERN ILLINOIS REGIONAL MANAGER ILLINOIS DEPARTMENT OF NATURAL RESOURCES (217) 785-5190

HANSON PROFESSIONAL SERVICES, INC. GARY CLACK, PROJECT MANAGER (217) 747-9321

UTILITIES

- THE CONTRACTOR WILL BE RESPONSIBLE FOR REPAIRS TO ANY UTILITY LINES AND EXISTING IMPROVEMENTS TO REMAIN THAT ARE DAMAGED AS A RESULT OF THE
- 2. THE CONTRACTOR WILL BE RESPONSIBLE FOR REPAIRS TO ANY EXISTING FIELD TILE DAMAGED AS A RESULT OF THE WORK.
- 3. ALL WORK AND EXCAVATIONS NEAR AND AROUND EXISTING STRUCTURES AND UTILITIES SHALL BE BY HAND METHODS.

STORM WATER POLLUTION PREVENTION PLAN

THE CONTRACTOR AND HIS SUBCONTRACTORS SHALL FOLLOW THE STORM WATER POLLUTION PREVENTION PLAN INCLUDED IN THE SPECIFICATIONS.

EARTHWORK


- CONTRACTOR IS RESPONSIBLE FOR THE SITE RESTORATION AND LANDSCAPING WITHIN THE CONSTRUCTION LIMITS.
- 2. ALL OPEN EXCAVATION WORK SHALL BE PERFORMED IN ACCORDANCE WITH OSHA 29 CFR 1926, SUBPART P- "EXCAVATIONS". THE SUBCONTRACTOR SHALL DESIGNATE A QUALIFIED "COMPETENT PERSON" AS DEFINED IN OSHA SECTION 1926.650(b) PRIOR TO THE COMMENCEMENT OF ANY EXCAVATION ACTIVITIES.
- NO BACKFILL SHALL BE PLACED AGAINST CAST-IN-PLACE CONCRETE STRUCTURES UNTIL THE CONCRETE HAS ATTAINED ITS SPECIFIED 28 DAY DESIGN COMPRESSIVE
- 4. BACKFILL SHALL BE PLACED AND COMPACTED IN UNIFORM HORIZONTAL LAYERS IN ACCORDANCE WITH THE SPECIFICATIONS.


SCHEDULE OF SEEDING, FERTILIZER NUTRIENTS, MULCH & MOWING							
ITEM	APPLICATION RATE	August 15, 2015 — September 15, 2015	April 1, 2016 – May 1, 2016	May 1, 2016 - June 1, 2016	TOTAL QUANTITY		
Seeding, Class 2	Per Specifications	4 Acres	-	-	4 Acres		
Agricultural Limestone	2 Tons/Acre	8 Tons	-	=	8 Tons		
Nitrogen Fertilizer Nutrient	120 Pounds/Acre	480 Pounds	-	480 Pounds	960 Pounds		
Phosphorus Fertilizer Nutrient	100 Pounds/Acre	400 Pounds	-	400 Pounds	800 Pounds		
Potassium Fertilizer Nutrient	250 Pounds/Acre	1000 Pounds	-	1000 Pounds	2000 Pounds		
Special Excelsion Blanket	Sq Yd	7744 Sq Yd	-	-	7744 Sq Yd		
Mulch Method 2, Procedure 1	Per Specifications	2 Acres	_	_	2 Acres		
Mowing	Acres	_	4 Acres	_	4 Acres		

WEST SITE

EROSION CONTROL NOTES:

- 1. THE CONTRACTOR SHALL BE REQUIRED TO COMPLY WITH THE PROVISIONS OF THE GENERAL PERMIT AND MUST BECOME A PARTY TO THE DEPARTMENT OF NATURAL RESOURCES; OFFICE OF MINES AND MINERALS; DIVISION OF ABANDONED MINED LANDS RECLAMATION STORM WATER POLLUTION PREVENTION PLAN. CONTRACTOR WILL NOT BE SUBJECT TO A PERMIT APPLICATION FEE.
- 2. THE CONTRACTOR SHALL PROVIDE A STABILIZED CONSTRUCTION ENTRANCE AT LOCATIONS SHOWN ON THE PLANS. THE STABILIZED CONSTRUCTION ENTRANCE SHALL BE REMOVED AT THE COMPLETION OF CONSTRUCTION AND THE EXISTING TO CREATE THE ACCESS ROAD SHALL BE REMOVED AND LEGALLY DISPOSED.
- 3. IT SHALL BE THE CONTRACTOR'S RESPONSIBILITY TO MAINTAIN STORM WATER DRAINAGE FLOWS AT ALL TIMES DURING THE PERFORMANCE OF THE WORK.
 SURFACE WATER RUNOFF SHALL BE CONTROLLED IN SUCH A MANNER TO PREVENT
- 4. ALL SOIL EROSION AND SEDIMENT CONTROL MEASURES SHALL BE PROPERLY INSTALLED AND FUNCTIONING PRIOR TO CONSTRUCTION IN AN AREA.
- 5. THE CONTRACTOR SHALL IMPLEMENT A DAILY INSPECTION PROGRAM OF THE EROSION AND SEDIMENT CONTROL MEASURES AND MAINTAIN THESE MEASURES IN A FUNCTIONAL CONDITION.
- 6. CUT AND FILL SLOPES AND STOCKPILED MATERIAL SHALL BE PROTECTED TO PREVENT EROSION.
- PLACE PERIMETER EROSION BARRIER AT LOCATIONS SHOWN ON THE PLANS.
 PERIMETER EROSION BARRIER SHALL ALSO BE APPLIED AT AREAS TO BE DETERMINED BY THE CONTRACTOR AT ANY LOCATION AROUND THE PERIMETER OF THE SITE WHERE STORM WATER RUNOFF OCCURS. PERIMETER EROSION BARRIER SHALL ALSO BE APPLIED AROUND ALL SUBSOIL AND TOPSOIL STOCKPILE AREAS.
- 8. ALL EROSION CONTROL MEASURES WILL BE INSPECTED ONCE PER WEEK AND FOLLOWING ANY STORM EVENT OF ½" OR GREATER. ALL EROSION CONTROL MEASURES SHALL BE FUNCTIONAL. ANY REPAIR SHALL BE MADE AS SOON AS IT IS REASONABLE. ANY ACCUMULATED SEDIMENT SHALL BE REMOVED.
- 9. EROSION CONTROL MEASURES SHALL BE MAINTAINED ON SITE UNTIL SEEDING INSTALLATION IS COMPLETE.
- 10. THE CONTRACTOR SHALL BE RESPONSIBLE TO MAINTAIN TEMPORARY EROSION CONTROL MEASURES THROUGHOUT CONSTRUCTION.

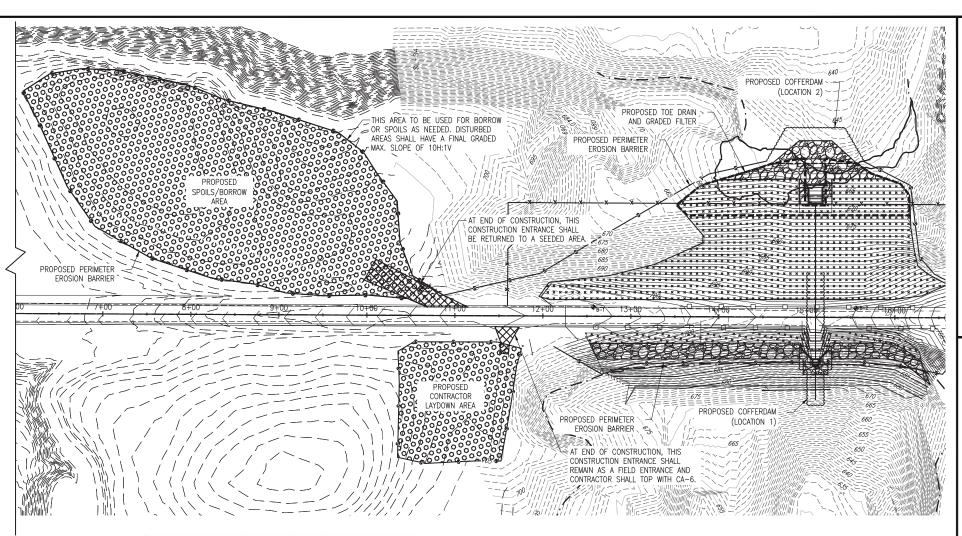

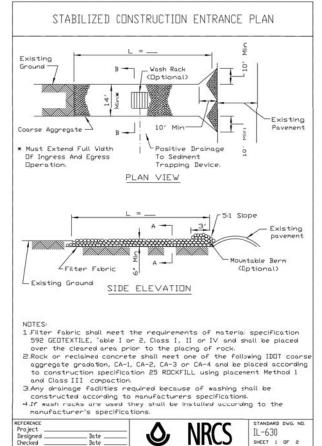

(INCLUDED WITH EARTH EXCAVATION) STONE RIPRAP AREAS TOE DRAIN AND GRADED FILTER LIMITS EXISTING ON-SITE ROADWAYS MAY BE USED FOR CONSTRUCTION TRAFFIC. THE CONTRACTOR SHALL PROVIDE TEMPORARY ADDITIONAL ROADS NEEDED FOR REQUIRED CONSTRUCTION ACCESS, MAINTAIN EXISTING ROADS THROUGHOUT CONSTRUCTION, AND RESTORE TO ORIGINAL OR BETTER CONDITION AT COMPLETION OF WORK.

EAST SITE

LEGEND SEEDING CLASS 2 & SPECIAL EXCELSIOR BLANKET SEEDING CLASS 2 & MULCH METHOD 2, PROCEDURE 1 PERIMETER EROSION BARRIER SEDIMENT CONTROL, STABILIZED CONSTRUCTION ENTRANCE

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Drawn By: Checked By

Plan

KEYPLAN

West Site Demolition 24 of 5 Sheet

———×——— EXISTING FENCE ----- EXISTING GUARDRAIL _____ EXISTING CONTOURS - · - EDGE OF WATER BORINGS FENCE REMOVAL

DEMOLITION NOTES:

- 1. CATTLE GATES TO BE REMOVED SHALL BE STOCKPILED WITHIN THE PROJECT LIMITS AS DETERMINED BY THE
- EXISTING FENCE IS 5 STRAND BARBED WIRE WITH ELECTRIC.
 PROPERTY OWNERS WILL DE-ENERGIZE ELECTRIC FENCE.
 CONTRACTOR TO COORDINATE TIMING WITH ENGINEER.


KEYPLAN

Farmington Embankments Reclamation Project AML-GKnE-1411 Knox County


State of Illinois Department of Natural Resources

Plan Demolition East Site I

24 of 9 Sheet

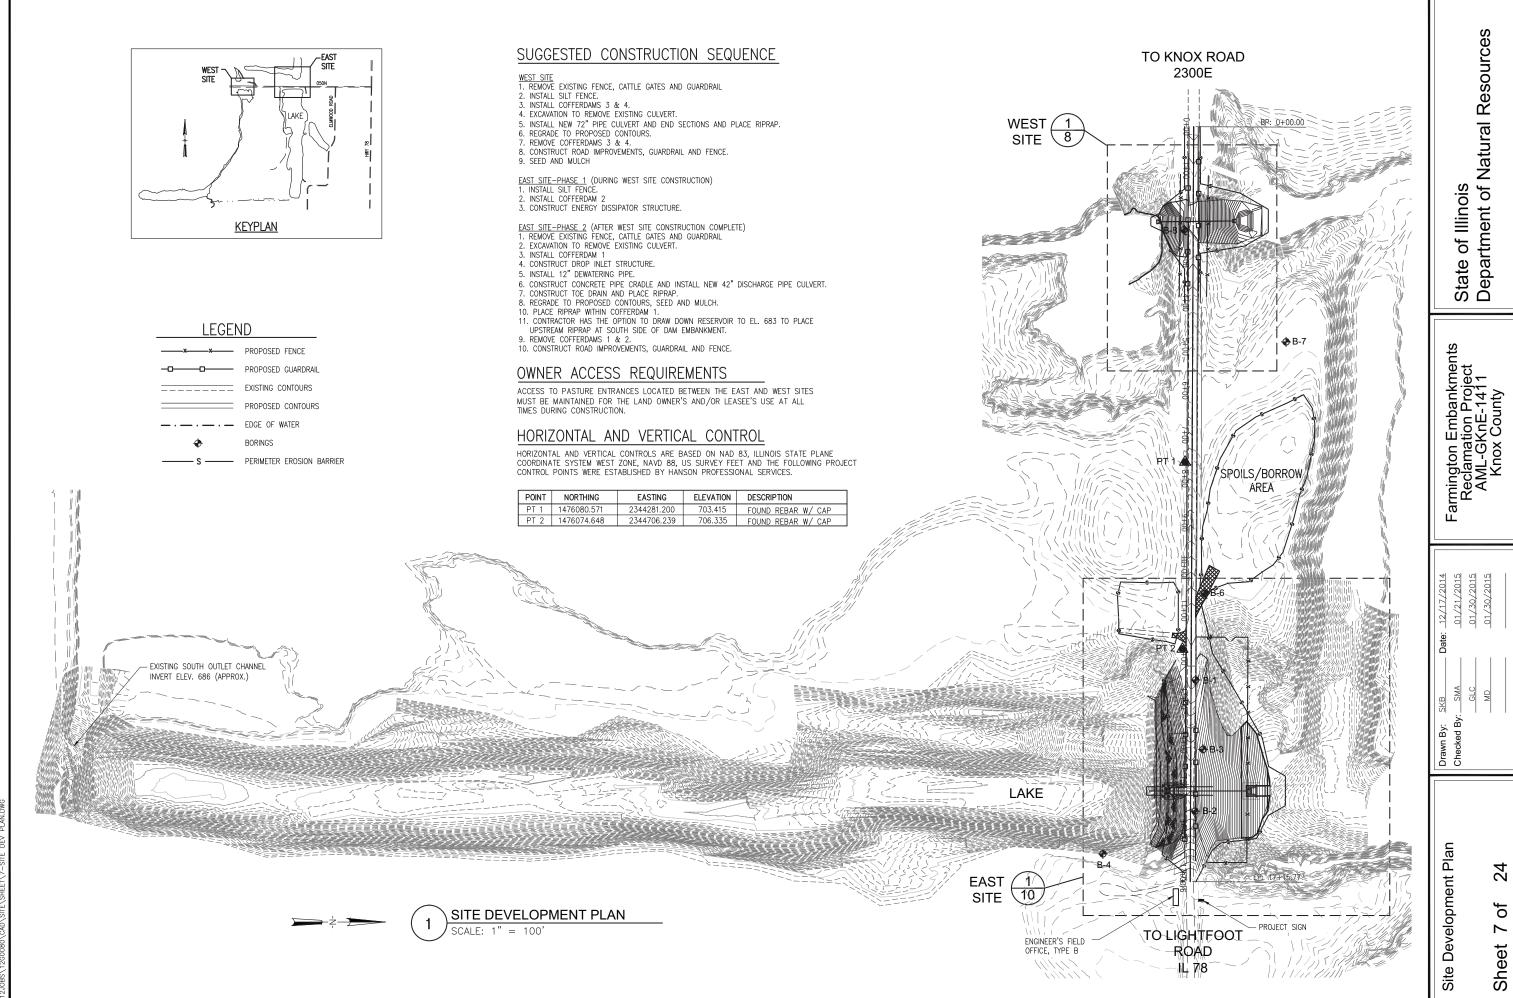

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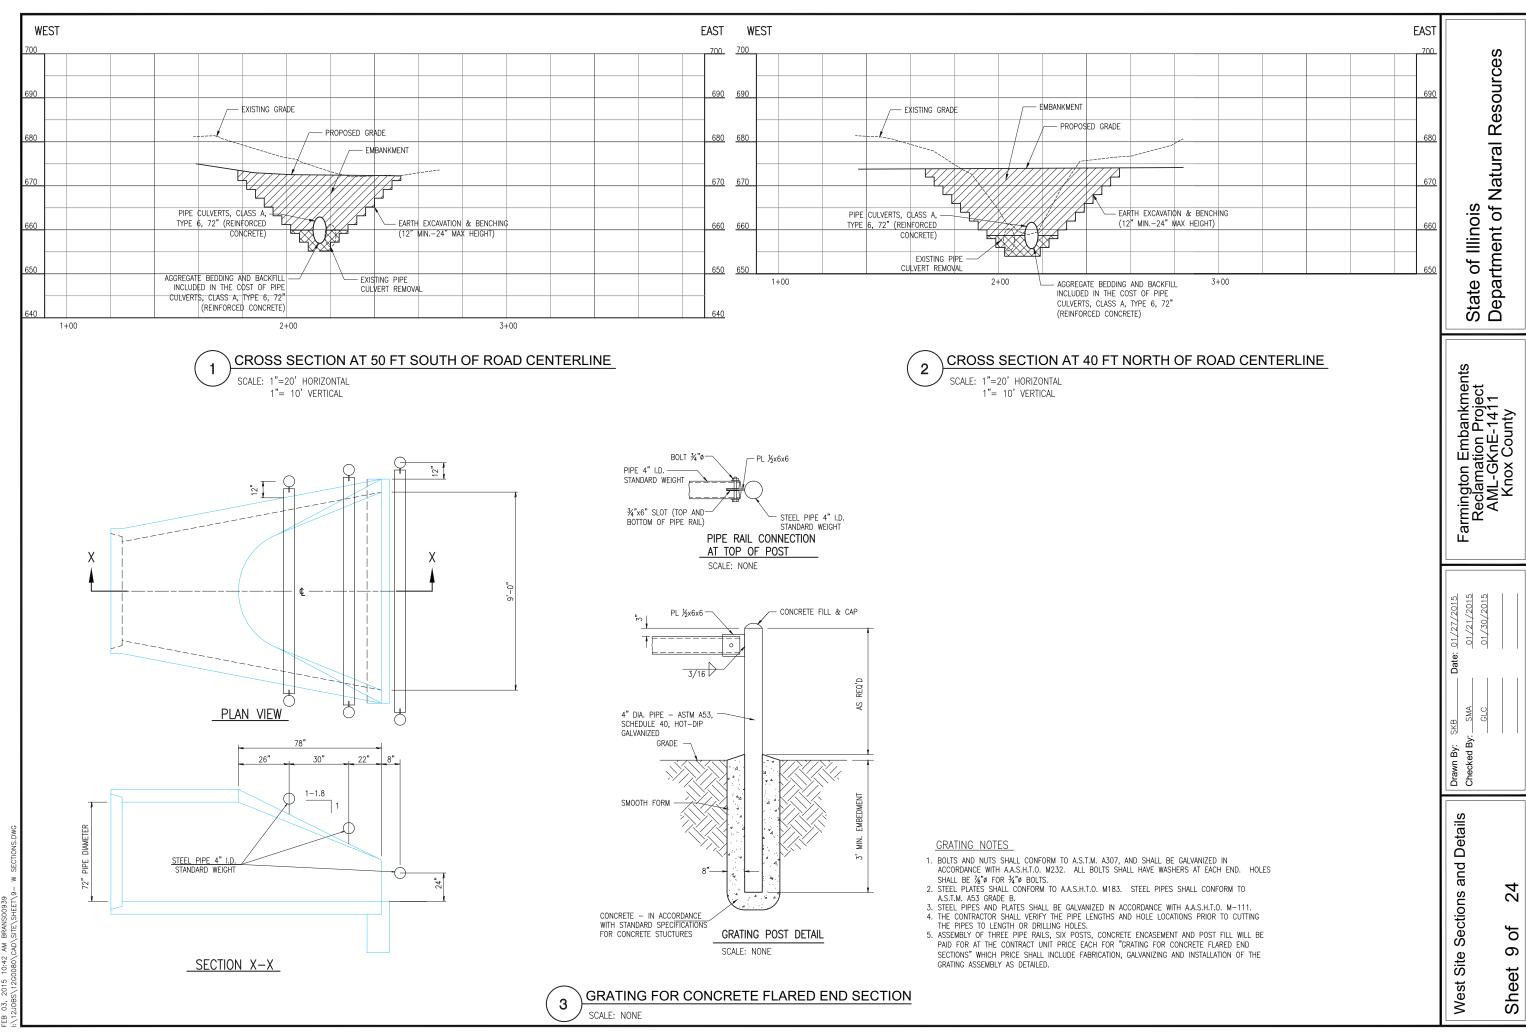

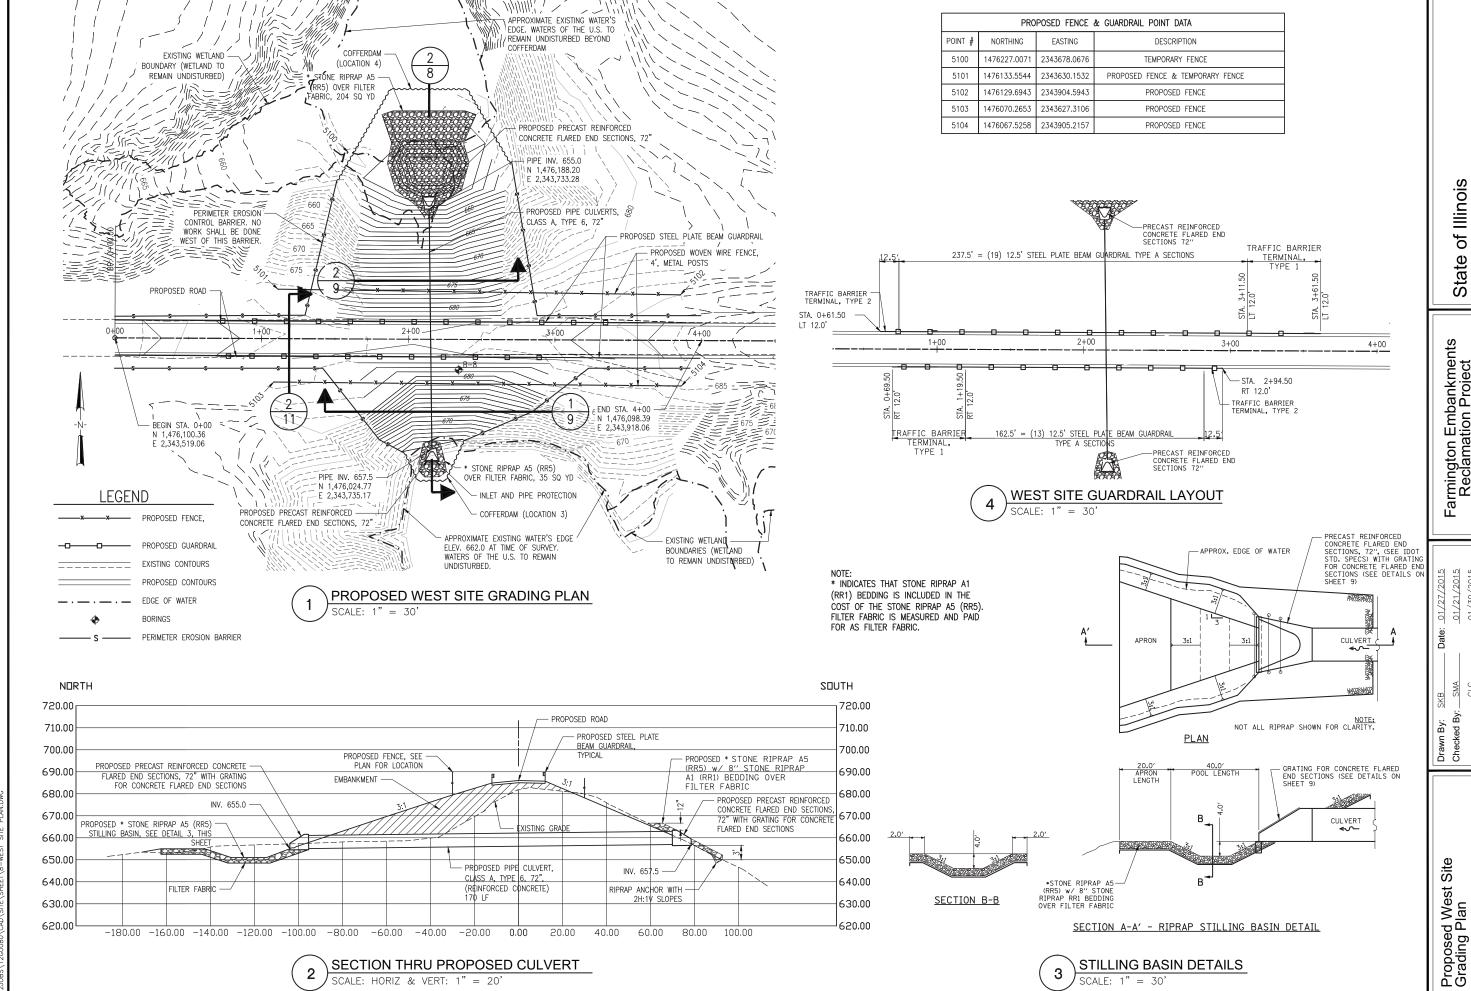
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Farmington Embankments Reclamation Project AML-GKnE-1411 Knox County

24 ∞ Sheet


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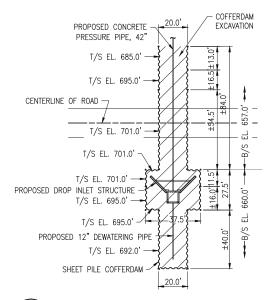


BORINGS

PERIMETER EROSION BARRIER


PROPOSED FENCE & GUARDRAIL POINT DATA						
POINT #	NORTHING	EASTING	DESCRIPTION			
5112	1476112.0146	2344678.8255	PROPOSED FENCE			
5113	1476223.6531	2344679.5109	PROPOSED FENCE			
5114	1476221.1303	2345191.5484	PROPOSED FENCE			
5115	1476127.6640	2345191.2417	PROPOSED FENCE			

* INDICATES THAT STONE RIPRAP A1 (RR1) BEDDING WILL BE INCLUDED IN THE COST OF STONE RIPRAP A4 (RR4) AND STONE RIPRAP A5 (RR5). FILTER FABRIC IS MEASURED AND PAID FOR AS FILTER FABRIC.

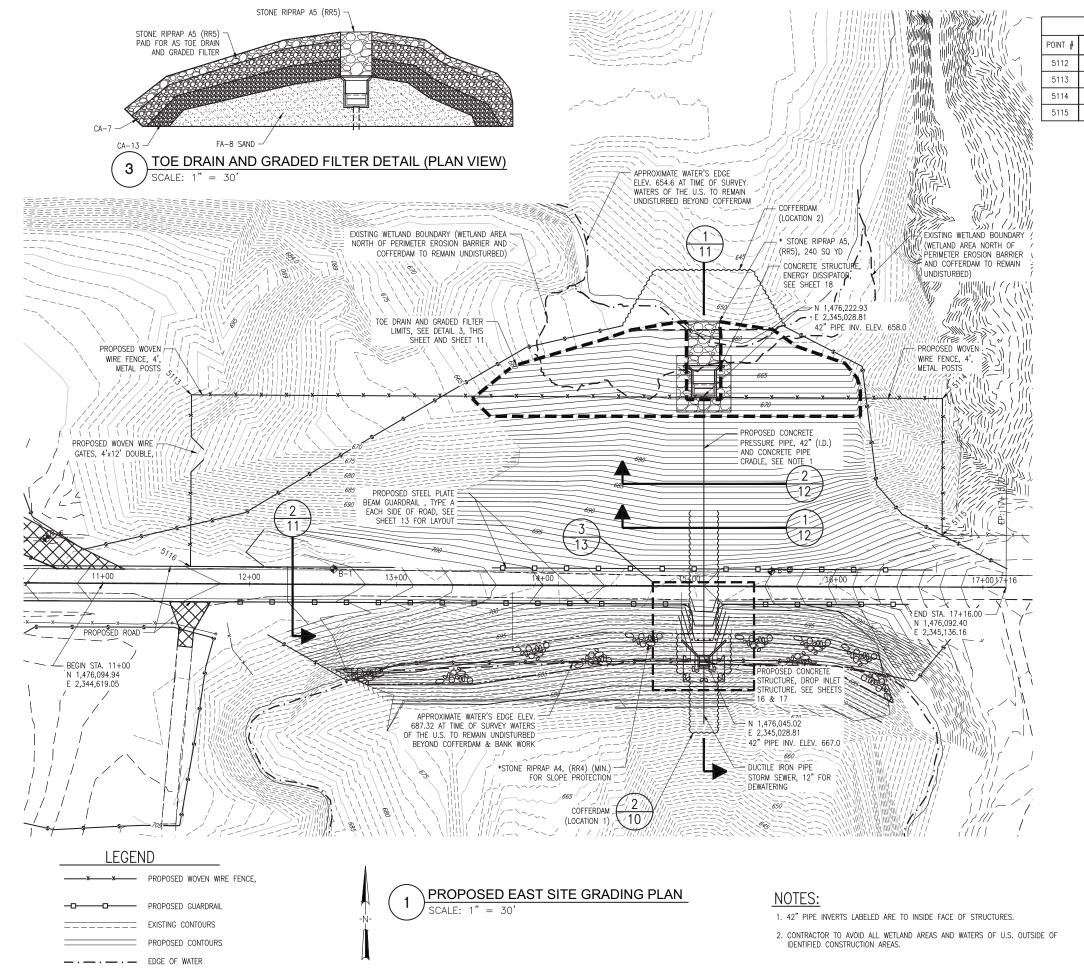

COFFERDAM PLAN LOCATION 1

SCALE: 1" = 30(FINAL COFFERDAM CONFIGURATION IS SUBJECT TO DESIGN BY CONTRACTOR.)

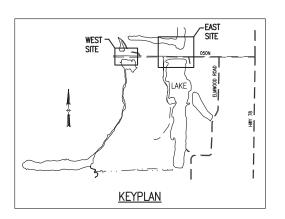

Š Proposed East { Grading Plan

10 Sheet

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Farmington Embankments Reclamation Project AML-GKnE-1411 Knox County

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Proposed Outlet Structure Sections and Details


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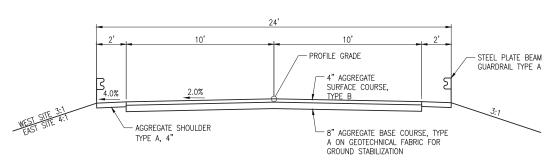
7

Sheet

TOE DRAIN & GRADED FILTER SECTION




CROSS SECTION AT PROPOSED OUTLET STRUCTURE

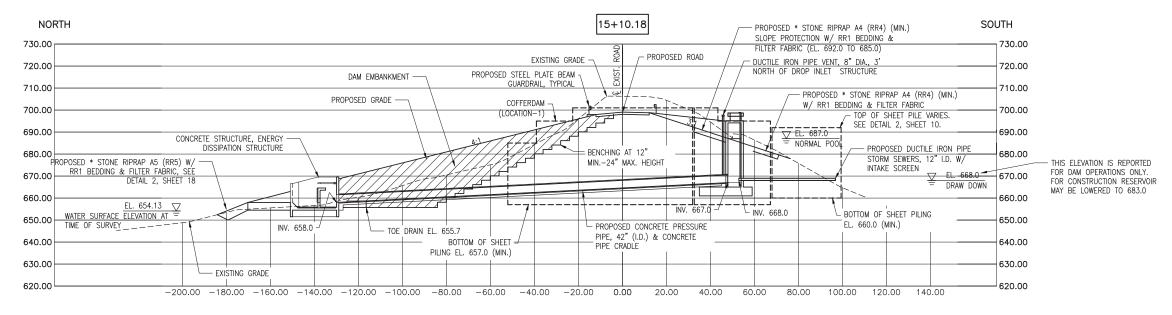

(RR1) BEDDING INCLUDED IN COST OF STONE RIPRAP A4 (RR4) AND STONE RIPRAP A5 (RR5). FILTER FABRIC IS MEASURED AND PAID FOR AS FILTER FABRIC.

* INDICATES THAT STONE RIPRAP A1


TYPICAL ROAD SECTION

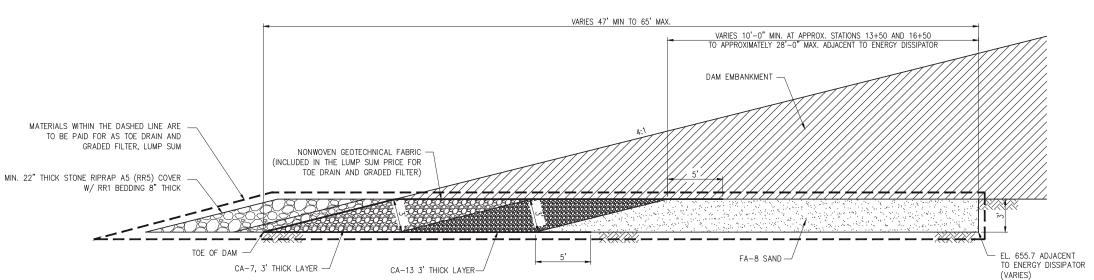

24 East Site Sections of 12 Sheet


CROSS SECTION AT 40 FT NORTH OF ROAD CENTERLINE

SCALE: 1"= 20' HORIZONTAL 1"= 10' VERTICAL

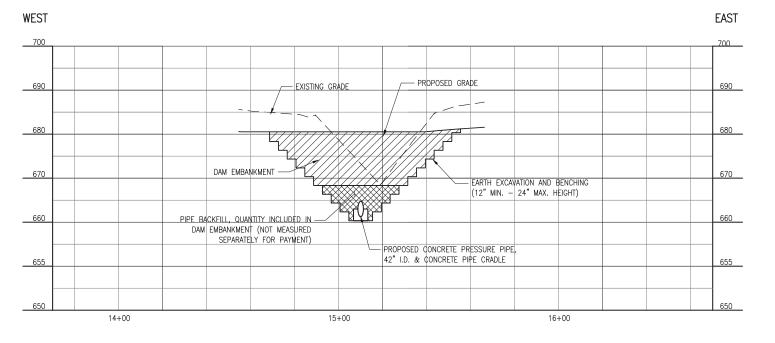





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GENERAL STRUCTURAL NOTES

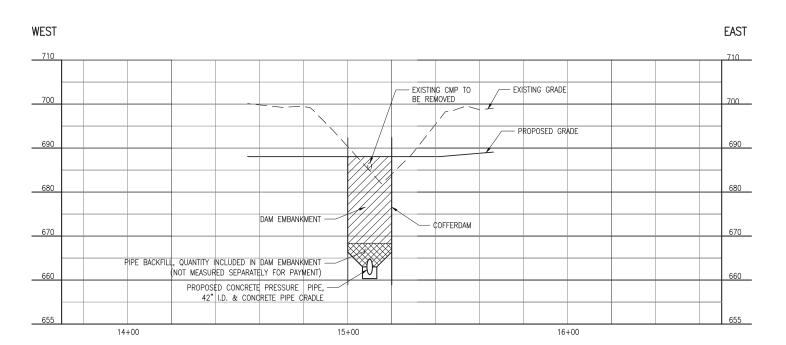GENERAL:

- G-1. GOVERNING CODE: ACL 318 ACL 350
- G-2. SOIL PRESSURES EQUIVALENT FLUID PRESSURES ACTIVE/AT REST = 100 PCF PASSIVE = 150 PCF
- G-3. THE CONTRACTOR SHALL FIELD VERIFY ALL DIMENSIONS, COORDINATES AND EXISTING CONDITIONS PRIOR TO CONSTRUCTION. NOTIFY THE ENGINEER OF ANY DISCREPANCY
- G-4. STRUCTURAL SYSTEM IS DESIGNED TO WORK AS A COMPLETED SYSTEM, ANY TEMPORARY SHORING, OR BRACING NEEDED DURING CONSTRUCTION SHALL BE THE RESPONSIBILITY OF THE CONTRACTOR; CONTRACTOR IS RESPONSIBLE FOR ADEQUACY OF TEMPORARY SHORING.
- G-5. ALL SUBTERRANEAN STRUCTURES, UTILITIES, PIPING, ETC. IN THE AREA OF ALL EXCAVATIONS TO BE LOCATED AND MARKED BY CONTRACTOR PRIOR TO EARTH REMOVAL WORK. FLAGS OR PAINT ARE ACCEPTABLE METHODS. CONTRACTOR TO MAINTAIN MARKERS UNTIL ALL EXCAVATION ACTIVITIES HAVE CEASED. COORDINATE WITH
- G-6. THE CONTRACTOR IS SOLEY RESPONSIBLE FOR ALL SITE SAFETY AND ALL ACCIDENTS WHICH RESULT IN DEATH, PERSONAL INJURY OR DAMAGE TO PROPERTY ARISING OUT OF OR IN CONNECTION WITH PERFORMANCE OF THE WORK, WHETHER ADJACENT TO OR AT THE SITE
- G-7. NO PIPES OR SLEEVES FOR MECHANICAL TRADES SHALL PASS THROUGH STRUCTURAL MEMBERS WITHOUT APPROVAL OF THE ENGINEER.
- ALL SECTIONS, DETAILS AND NOTES SHOWN ON THE DRAWINGS ARE INTENDED TO BE TYPICAL AND SHALL APPLY TO SIMILAR SITUATIONS ELSEWHERE UNLESS OTHERWISE SHOWN.
- G-9. SHOP DRAWINGS PREPARED BY SUPPLIERS AND SUBCONTRACTORS SHALL BE REVIEWED BY THE CONTRACTOR PRIOR TO SUBMITTING TO ENGINEER. ENGINEER'S REVIEW SHALL BE FOR SIZES AND GENERAL CONFORMANCE WITH INFORMATION GIVEN IN CONSTRUCTION DOCUMENTS ONLY, NO WORK SHALL BE STARTED WITHOUT SUCH REVIEW. BASED ON SUCH REVIEWS, ACTIONS WILL BE NOTED FOR EACH SHOP DRAWING SUBMITTAL AS LISTED BELOW:

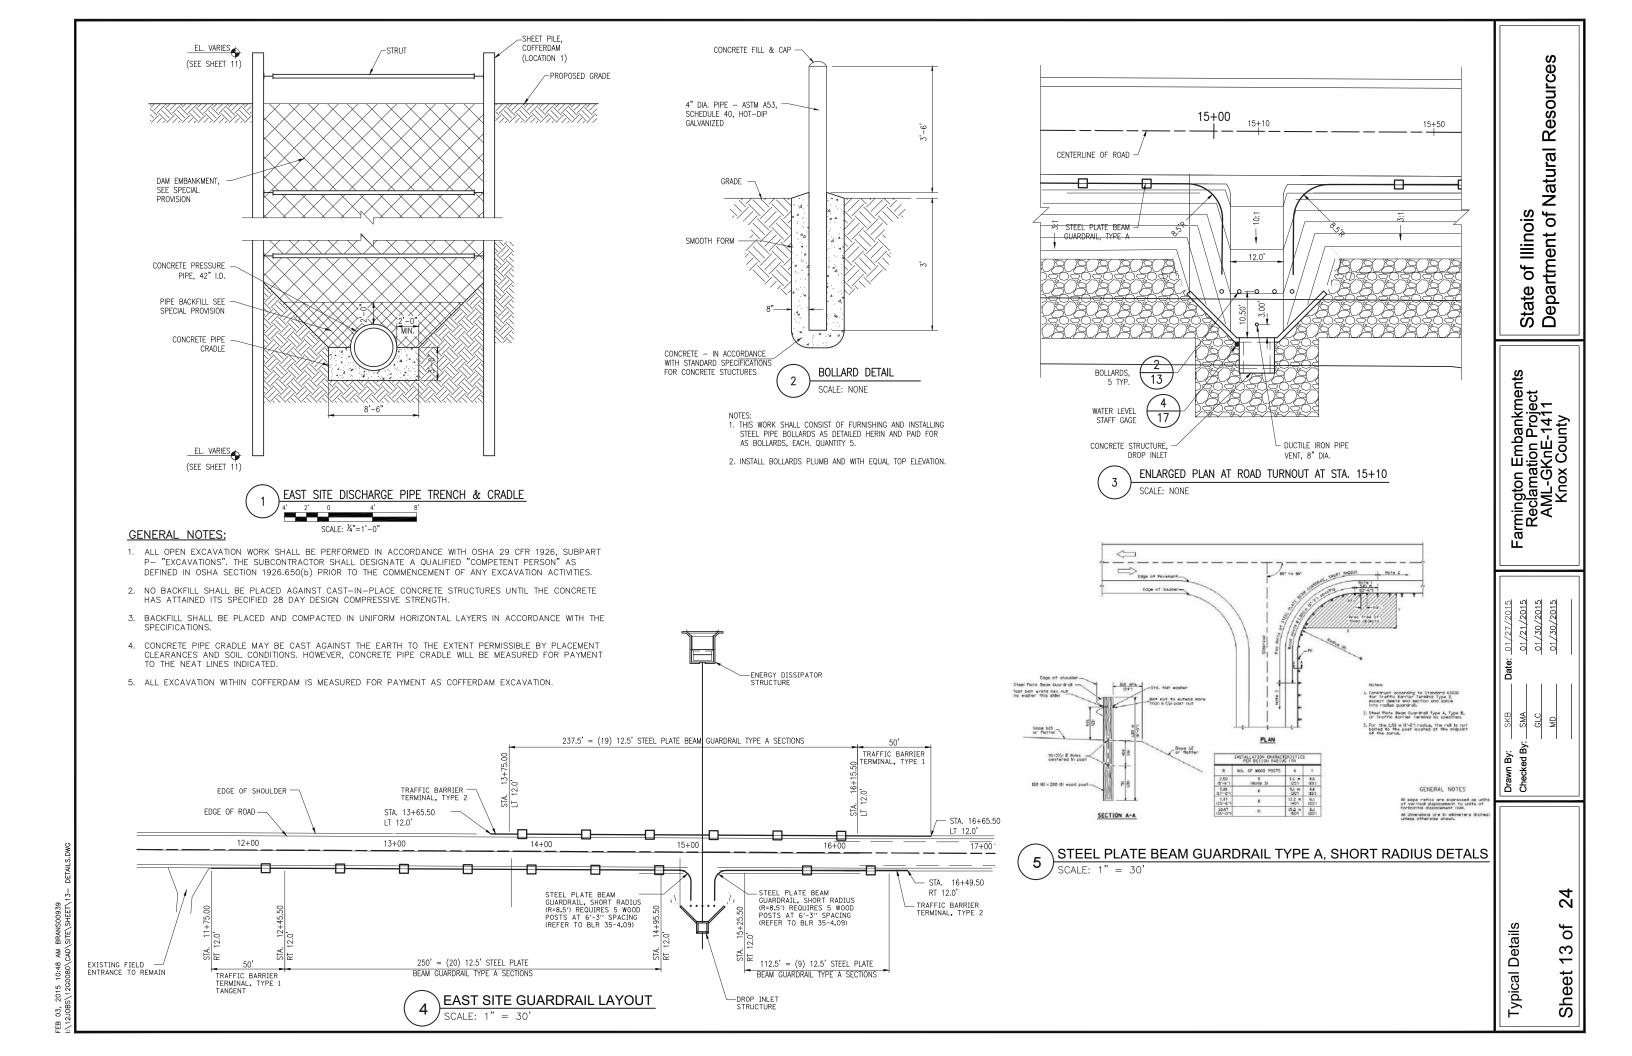FABRICATION, MANUFACTURING OR CONSTRUCTION MAY NO EXCEPTIONS TAKEN

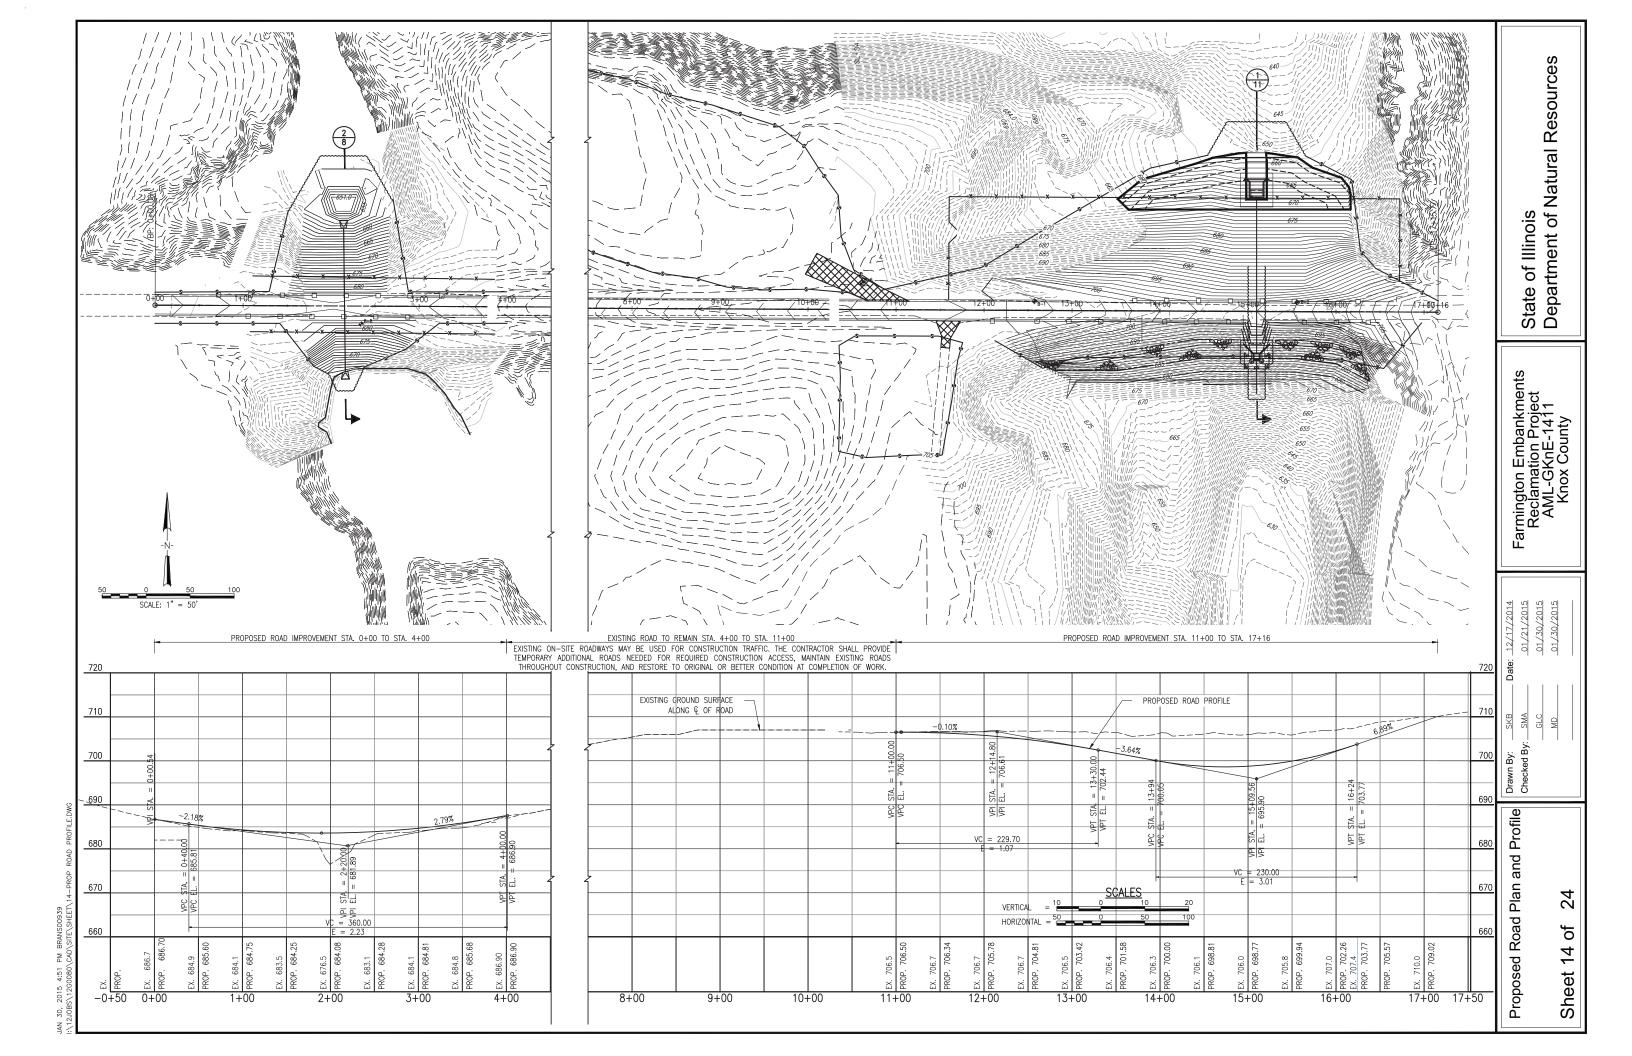PROCEED ON THE BASIS THAT THE SUBMITTAL IS IN CONFORMANCE WITH THE DESIGN CONCEPT AND THE

CONTRACT DOCUMENTS.

FABRICATION, MANUFACTURING OR CONSTRUCTION MAY FURNISH AS CORRECTED

PROCEED AFTER MAKING THE NOTED CORRECTIONS TO SATISFY COMPLIANCE WITH THE DESIGN CONCEPT AND / OR

THE CONTRACT DOCUMENTS.

NO FABRICATION, MANUFACTURING OR CONSTRUCTION MAY REVISE AND SUBMIT PROCEED. RESUBMIT FOR REVIEW AFTER REQUESTED

NO FABRICATION, MANUFACTURING OR CONSTRUCTION MAY SUBMIT SPECIFIED ITEM

PROCEED. SUBMIT SPECIFIED ITEM TO HANSON FOR REVIEW.

NO FABRICATION, MANUFACTURING OR CONSTRUCTION MAY REJECTED-SEE REMARKS OCCUR FOR REASONS STATED IN "REMARKS"

G-10. ALL ASTM AND AASHTO DESIGNATIONS SHALL BE THE LATEST UNLESS NOTED OTHERWISE.

PIPE HANDRAIL

- PH-1. PIPE HANDRAIL SHALL BE CONSTRUCTED AS SHOWN OR AS REQIURED BY THE LATEST O.S.H.A. REQUIREMENTS.
- PH-2. PIPE HANDRAIL PIPE SHALL CONFORM TO ASTM A-53 TYPE E OR S. GRADE B.

FOUNDATION:

- F-1. ALL FOOTING EXCAVATIONS SHALL BE CLEAN AND FREE OF DEBRIS, STANDING WATER AND LOOSE SOIL AND BE INSPECTED AND APPROVED BY THE ENGINEER PRIOR TO PLACEMENT OF CONCRETE
- F-2. ALL FILL MATERIAL SHALL BE APPROVED FOR USE IN ADVANCE OF PLACEMENT BY THE ENGINEER. NO FILL SHALL BE PLACED OVER FROZEN, MUDDY OR OTHER DELETERIOUS MATERIAL. LIFT THICKNESS SHALL BE MINIMIZED TO ALLOW EFFICIENT COMPACTION. NO FILL MAY BE PLACED OVER A PREVIOUS LIFT THAT HAS NOT BEEN ADEQUATELY COMPACTED AND ACCEPTED BY THE ENGINEER.
- F-3. BACKFILL AGAINST WALLS SHALL BE PLACED EVENLY ON ALL SIDES IN ORDER TO ACHIEVE GENERALLY BALANCED LOADINGS. DO NOT BACKFILL AROUND WALLS UNTIL CONCRETE HAS ATTAINED THE SPECIFIED MIN. 28 DAY COMPRESSIVE STRENGTH.

CONCRETE:

C-1. MATERIAL PROPERTIES (U.N.O.) CONCRETE - CLASS SI

CONCRETE REINFORCEMENT - FY = 60 KSI (A615 GR 60) EPOXY COATED

C-2. PROTECTIVE COVERING FOR REINFORCEMENT BARS SHALL BE AS FOLLOWS UNLESS OTHERWISE NOTED ON THE PLANS:

FOOTINGS: BOTTOM AND SIDES = 3" TOP = 2"WALLS: EXTERIOR EXPOSURE = 2" INTERIOR EXPOSURE = 2' BEAMS / COLUMNS: OVER TIES OR STIRRUPS = 2"

ELEVATED SLABS: = 2"

- C-3. A 3/4" X 3/4" CHAMFER SHALL BE PROVIDED AT THE EDGE OF ALL FINISHED WALLS, BEAMS AND COLUMNS.
- C-4. TWO #5 BARS EACH FACE SHALL BE PROVIDED DIAGONALLY AT ALL CORNERS OF WALL AND SLAB OPENINGS.
- C-5. LAP ALL BARS AS FOLLOWS U.N.O. (CLASS B): #3=1'-7" #4=2'-1" #6=3'-1" #7=4'-6" #5=2'-7" #8=5'-2"
- C-6. ALL CONCRETE SHALL BE WET CURED.
- C-7. FOR EPOXY COATED BARS, PROVIDE 1.3 TIMES THE INDICATED LAP LENGTH. FOR TOP BARS, PROVIDE AN ADDITIONAL 1.3 TIMES THE INDICATED LAP LENGTH.
- C-8. HOOK REINFORCEMENT BARS AT DISCONTINUOUS ENDS, TYPICAL UNLESS OTHERWISE
- C-9. COUPLER AND STRUCTURAL CONNECTORS: WHERE SPECIFIED, PROVIDE COUPLER A CONNECTOR CAPABLE OF DEVELOPING 125% OF THE YIELD STRENGTH OF THE SPLICED CONNECTED BAR. PROVIDE THREADED DOWELS WHERE REQUIRED.

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Farmington Embankments Reclamation Project AML-GKnE-1411 Knox County


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Drawn By:	Checked By: SMA	٩	

Š General Structural


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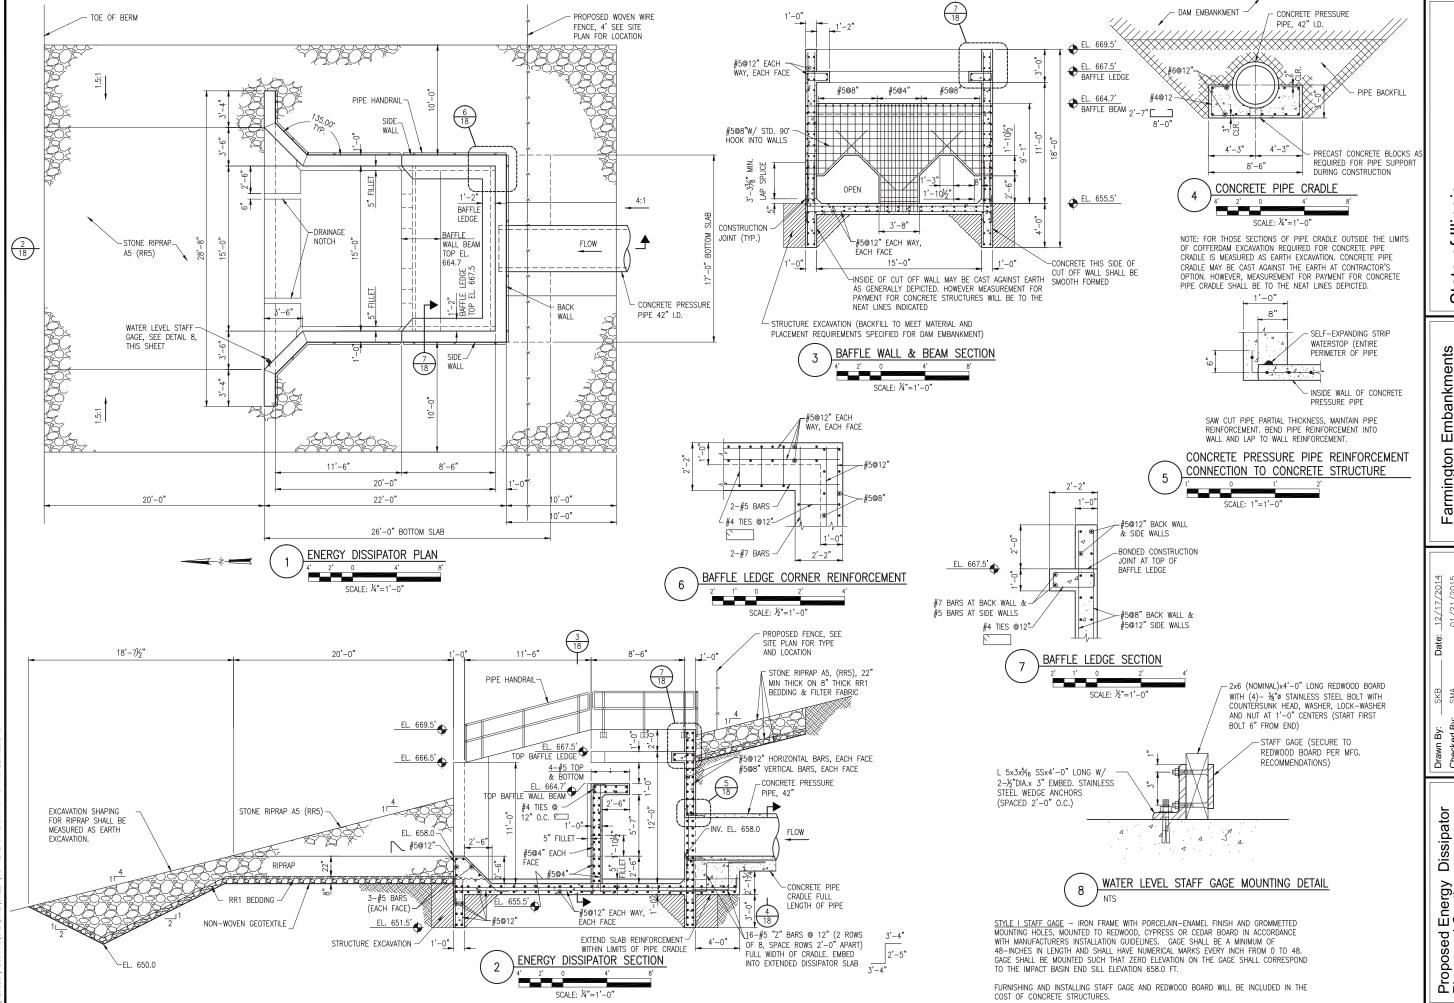
 Drawn By:
 SKB
 Date:
 01/27/20

 Checked By:
 SMA
 01/21/20

 GLC
 01/30/20

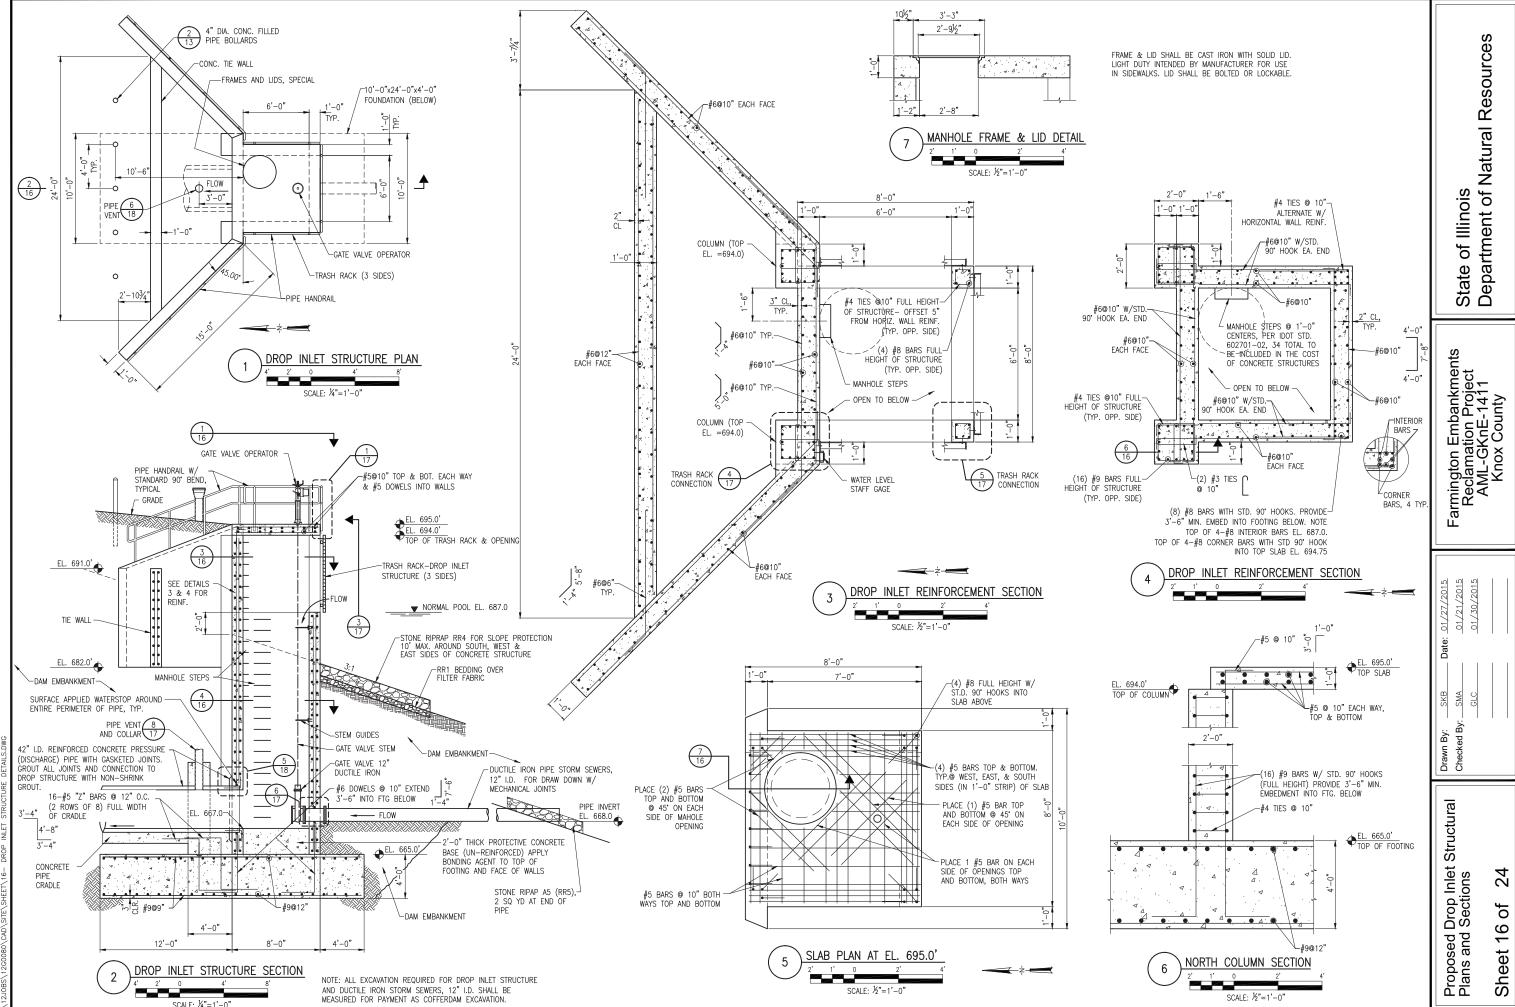Proposed Drop Inlet Structure Details and Sections

Details and Sections
Sheet 17 of 24

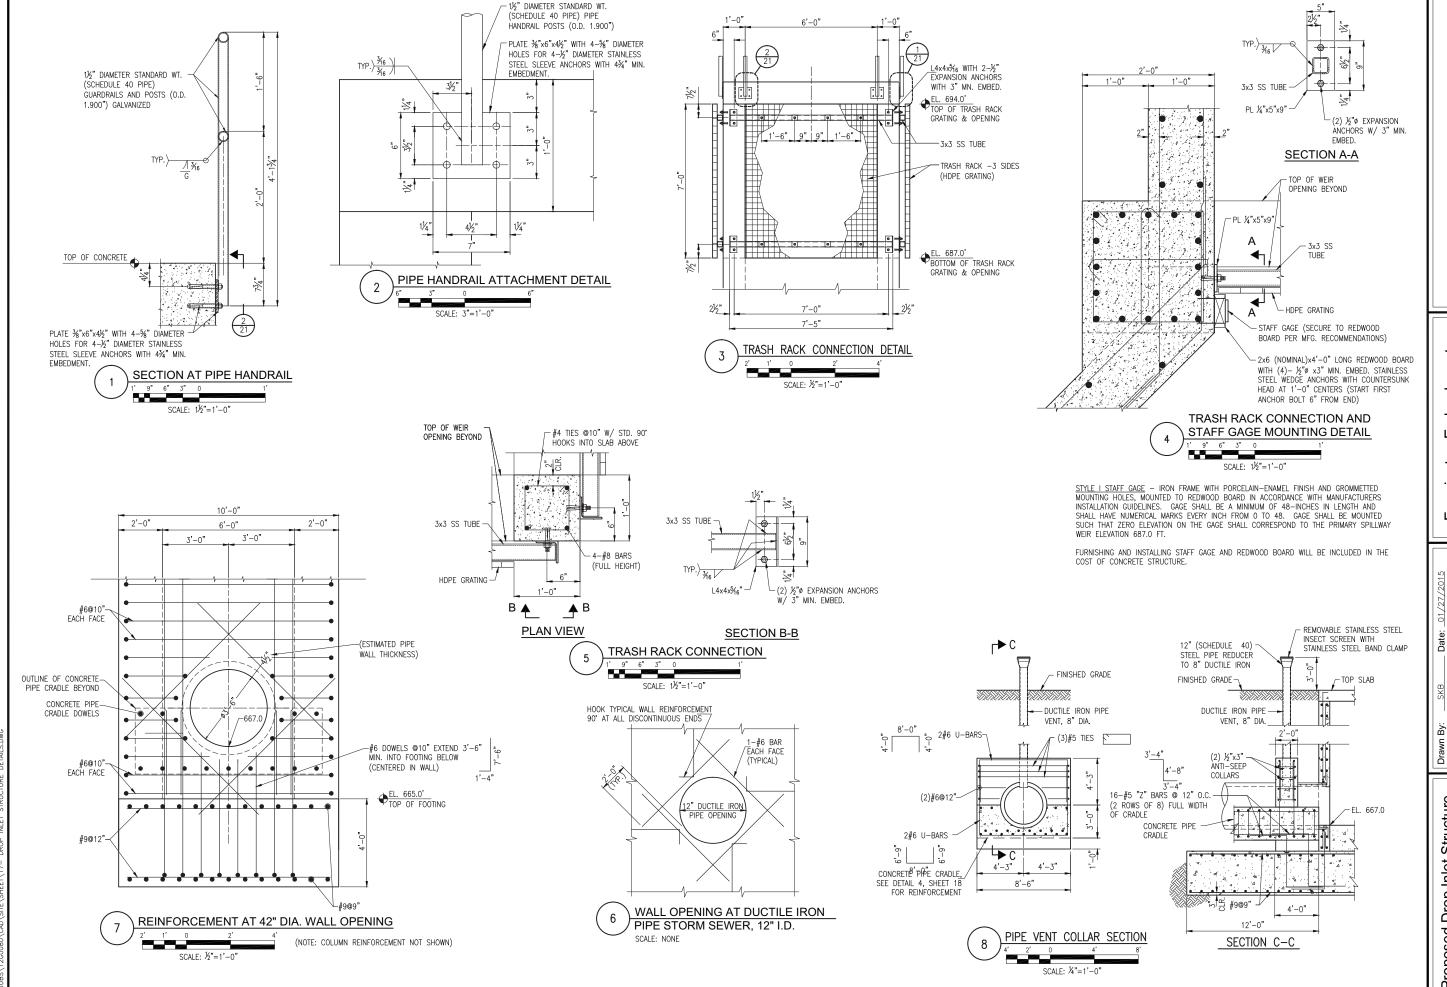

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Farmington Embankments Reclamation Project AML-GKnE-1411 Knox County

By:

Energy Dissipator Sections


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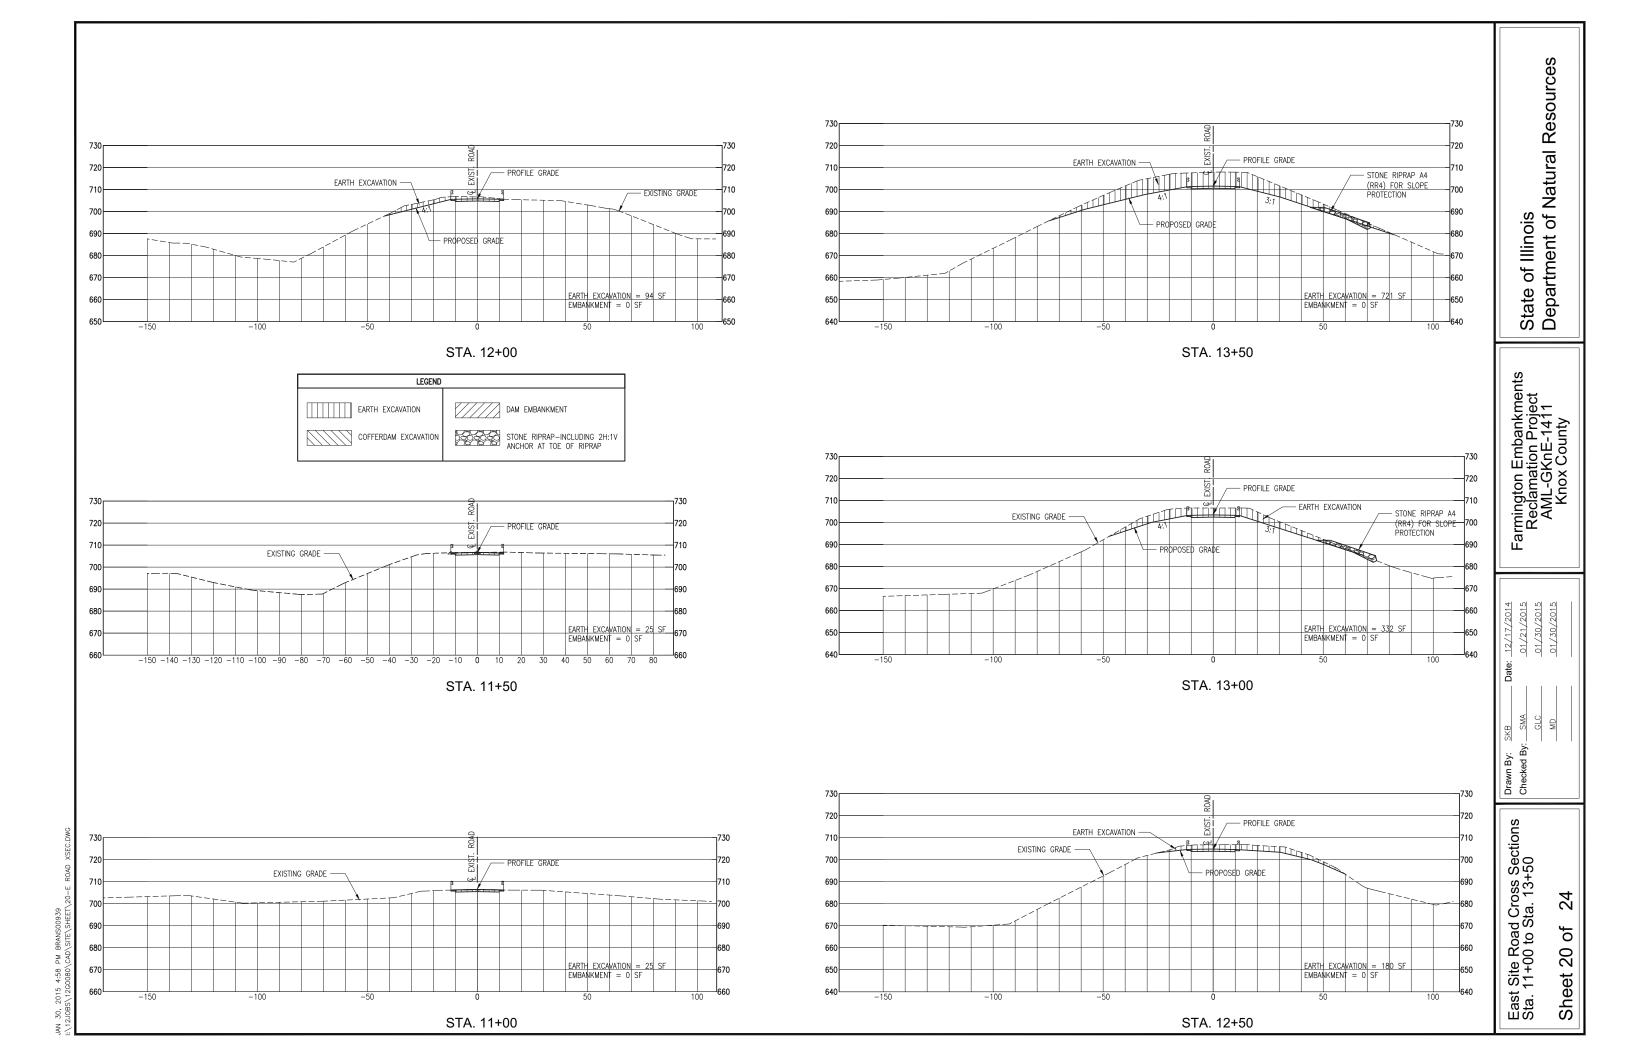
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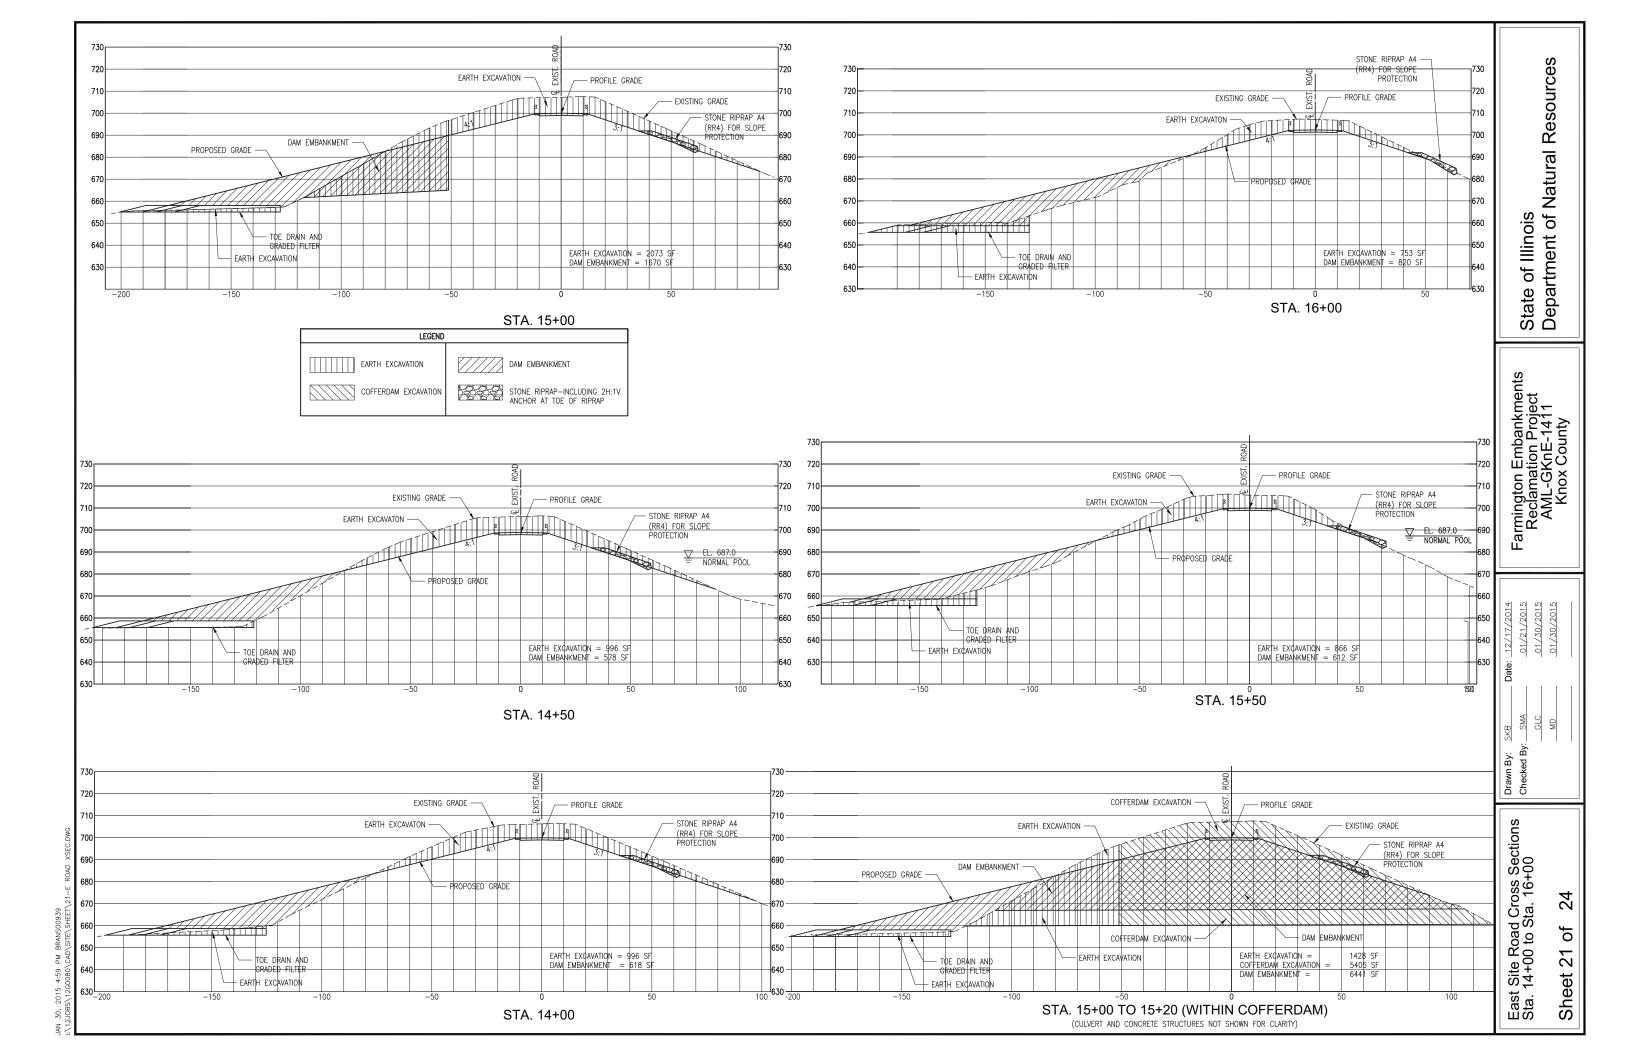
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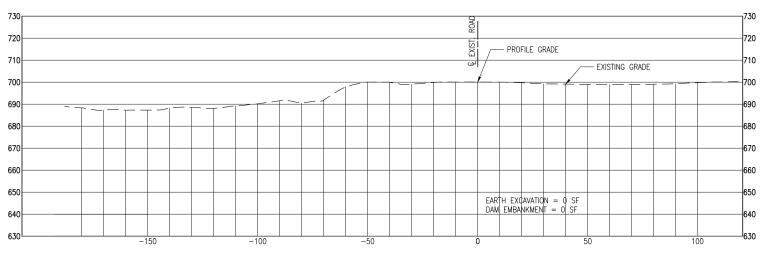
Proposed E









LEGEND EARTH EXCAVATION DAM EMBANKMENT COFFERDAM EXCAVATION STONE RIPRAP

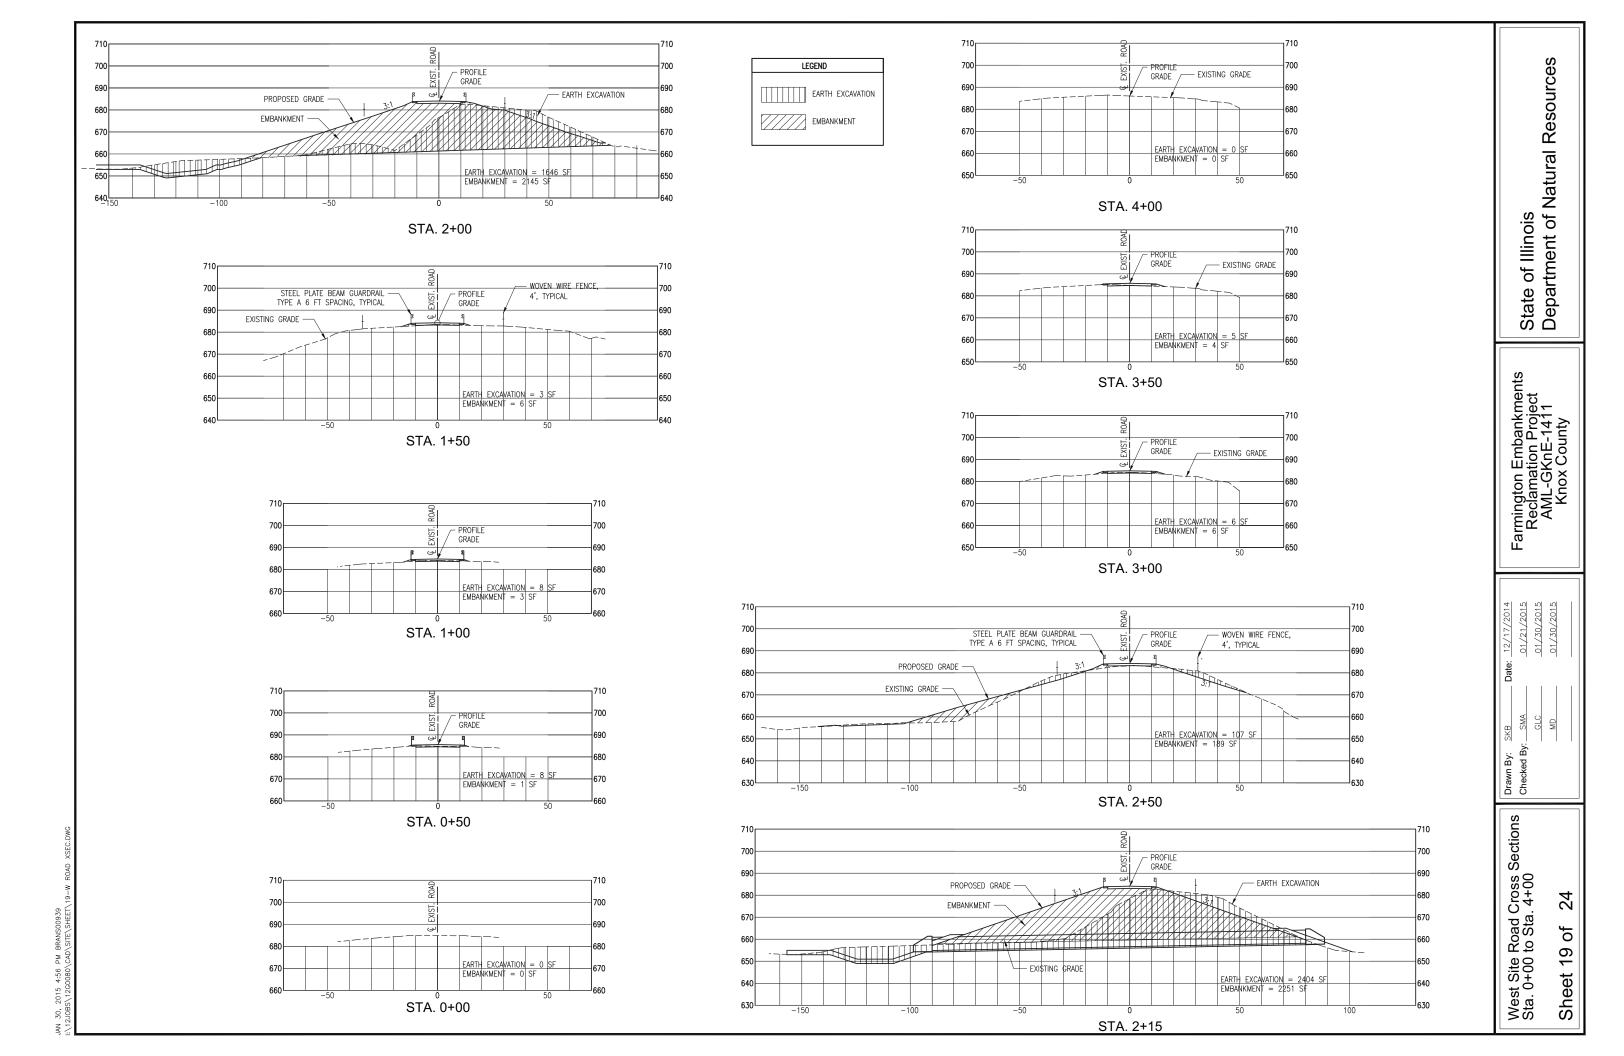

STA. 17+16

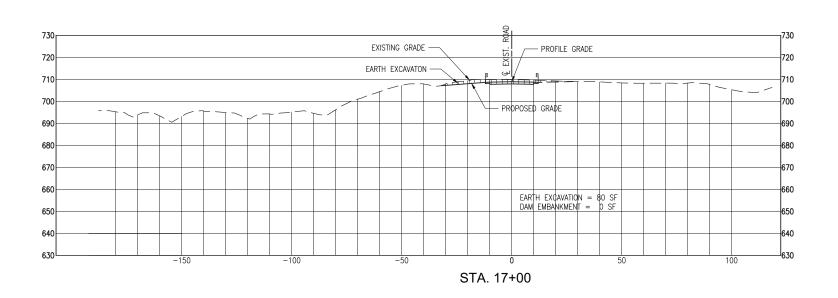

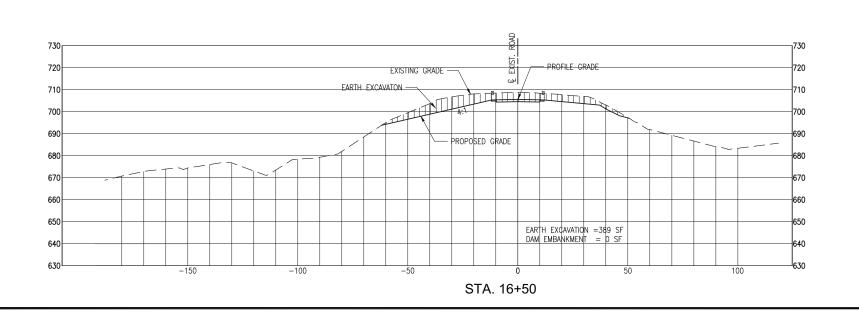

JAN 30, 2015 5:00

East Site Road Cross Sections Sta. 16+50 to Sta. 17+16

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Farmington Embankments Reclamation Project AML-GKnE-1411 Knox County

: 12/17/2014 01/21/2015 01/30/2015 01/30/2015

Drawn By: SKB Checked By: SMA

of Sheet 22

24

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Farmington Embankments Reclamation Project AML-GKnE-1411 Knox County

Drawn By: Checked By

Boring Logs Soil

24 of 23 Sheet

PROJECT Farmington Dam Embankment, Farmington, Illinoi CLIENT Hanson Professional Services Inc., 1525 S. Sixth St., Springfield, IL 62703 BORING B-8 DATE STARTED 5-30-14 DATE COMPLETED 5-30-14 JOB 14-081 GROUND SURFACE 682.02 (SURVEYED) V WHILE DRILLING DRY END OF BORING ▼ AT END OF BORING DRY ▼ 24 HOURS SAMPLE N WC Qu YDRY DEPTH ELEV. SOIL DESCRIPTIONS Brown SAND & GRAVEL Gray-brown silty CLAY, trace sand Brown silty CLAY, trace sand and gravel Gray-brown silty CLAY, trace sand and gravel 10-Gray fractured SHALE Brown-gray silty CLAY, trace sand and gravel 20-End of Boring at 30.0' 35-45-DRILL RIG NO. RS approximate boundaries between soil types; in-situ, the transition may be gradual.

PROJECT Farmington Dam Embankment, Farmington, Illinoi CLIENT Hanson Professional Services Inc., 1525 S. Sixth St., Springfield, IL 62703 BORING B-7 DATE STARTED 5-30-14 DATE COMPLETED 5-30-14 JOB 14-081 GROUND SURFACE 698 (APPROX.) ▼ WHILE DRILLING

□ AT END OF BORING DRY END OF BORING ▼ 24 HOURS SAMPLE N WC Qu YDRY DEPTH ELEV. SOIL DESCRIPTIONS Gray-brown silty CLAY, trace sand and gravel Brown silty CLAY, trace sand and gravel X Dark gray weathered SHALE Brown-gray silty CLAY, trace sand and gravel 10 X X Gray-brown silty CLAY, trace sand and gravel 20 — Gray weathered SHALE End of Boring at 25.0° 30 -35 — 40 -45-DRILL RIG NO. RS approximate boundaries between soil types; in-situ, the transition may be gradual.

Soil Boring Logs

Drawn By: ____Checked By: ___

24 of

Farmington Embankments Reclamation Project AML-GKnE-1411 Knox County . 12/17/2014 01/21/2015 01/30/2015

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Sheet 24