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FOR INDEX	OF SHEETS, SEE	SHEET NO. 2
DE2-D59188 LICENSED PROFESSIONAL ENGINEER OF	BY: HDR, INC. DWGS. 1-12, 25-37	DATE: 11/25/2019
LLINO15	LICENSE EXPIRES NOV. 30, 20	021
OBI-OOTS65 LICENSED STRUCTURAL ENGINEER OF	BY: HDR. INC. DWGS. 13-15. 20-21. 24	DATE: 11/25/2019
LL INOIS	LICENSE EXPIRES NOV. 30, 2	2020
JANE J. CHEN JANE J. CHEN 157.001346 LICENSED LANDSCAPE	BY: ALTAMANU, INC. DWCS. 16-19, 22-23,	DATE: 11/25/2019

A LICENSE EXPIRES AUG. 31, 2021

DESIGN DESIGNATION:

IL-390: EXPRESSWAY

US ROUTE 20: OTHER PRINCIPAL ARTERIAL

ROSELLE ROAD: OTHER PRINCIPAL ARTERIAL

PLUM GROVE ROAD: MAJOR COLLECTOR

ROHLWING ROAD: MINOR ARTERIAL

TRAFFIC DATA (ADT) (2016)

POSTED / DESIGN SPEED

03-06-2020 LETTING ITEM 004


IL-390: 55 /60 MPH

US ROUTE 20: 40 /45 MPH US ROUTE 20: 38,000 VPD

ROSELLE ROAD: 40 /45 MPH **ROSELLE ROAD: 25,700 VPD**

PLUM GROVE ROAD: 30 /35 MPH PLUM GROVE ROAD: 8,200 VPD

ROHLWING ROAD: 40 /45 MPH ROHLWING ROAD: 18,500 VPD

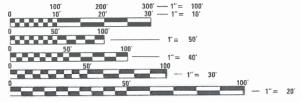

FULL SIZE PLANS HAVE BEEN PREPARED USING STANDARD ENGINEERING SCALES, REDUCED SIZED PLANS WILL NOT CONFORM TO STANDARD SCALES, IN MAKING MEASUREMENTS ON REDUCED PLANS, THE ABOVE SCALES MAY BE USED

JOINT UTILITY LOCATION INFORMATION FOR EXCAVATION 1-800-892-0123 MEADE ELECTRIC CO. DISTRICT ONE ELECTRICAL MAINTENANCE CONTRACTOR LOCATES IDOT ELECTRICAL EQUIPMENT AND UNDERGROUND CABLES 1-773-287-7672

> Rosemont, IL @018 773-380-7900

CONTRACT NJ. 61E69


DESIGN FIRM REGISTRATION NUMBER 184,001070

STATE OF ILLINOIS DEPARTMENT OF TRANSPORTATION

PLANS FOR PROPOSED FEDERAL AID HIGHWAY

FAP 345A IL ROUTE 390 (ELGIN O'HARE WESTERN ACCESS TOLLWAY) AT VARIOUS LOCATIONS LANDSCAPING AND SCENIC BEAUTIFICATION SECTION 14-00245-05-LS PROJECT USYC(144)

> **COOK AND DUPAGE COUNTIES** JOB NO.: C-91-400-16

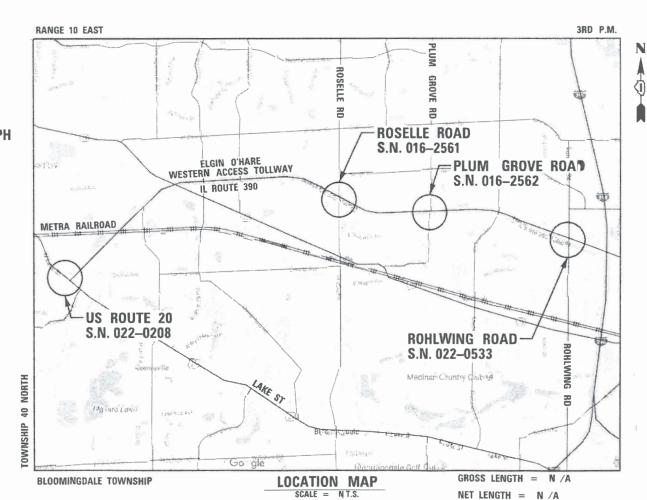




14-00245-05-LS

COUNTY SHEETS NO.

COOK/DUPAGE 37

ILLINOIS CONTRACT NO. 61E69

PROJECT LOCATED IN THE VILLAGES OF HANOVER PARK, ROSELLE, AND ITASCA

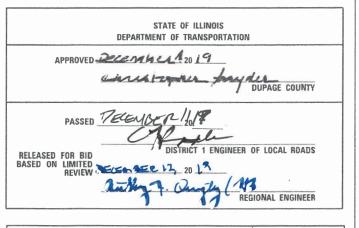

PRINTED BY THE AUTHORITY OF THE STATE OF ILLINOIS

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DESIGNED - AS

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6/10/2019

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GENERAL CONSTRUCTION NOTES

THE CONTRACTOR WILL NOT BE ALLOWED TO SET UP A FIELD OFFICE WITHIN CONTRACT LIMITS ON STATE, ILLINOIS TOLLWAY OR OTHER PUBLIC RIGHT OF WAY WITHOUT WRITTEN PERMISSION FROM THE ENGINEER.

THE CONTRACTOR'S SUPERINTENDENT OR DESIGNEE MUST BE ON THE CONSTRUCTION SITE DURING THE WORKING HOURS WHILE THIS PROJECT IS IN PROGRESS. THE CONTRACTOR'S SUPERINTENDENT MUST BE THE DESIGNATED RESPONSIBLE CONTRACTOR REPRESENTATIVE AND MUST BE AVAILABLE IN CASE OF EMERGENCIES ON A TWENTY-FOUR (24) HOUR BASIS.

THE CONTRACTOR MUST COORDINATE OFF-SITE HAUL AND ACCESS ROUTES WITH THE PARTY HAVING JURISDICTION OVER THE AFFECTED ROUTE. ON-SITE HAUL AND ACCESS ROUTES MUST BE MAINTAINED BY THE CONTRACTOR AND MUST BE RESTORED TO THEIR ORIGINAL CONDITION UPON COMPLETION OF BEING USED AS A HAUL ROUTE, FENCING, DRAINAGE, GRADING, RESURFACING, OR OTHER WORK NECESSARY TO CONSTRUCT AND MAINTAIN HAUL ROUTES IS THE CONTRACTOR'S RESPONSIBILITY AND MUST BE APPROVED BY THE ENGINEER PRIOR TO THE WORK. ANY RESTORATION SEEDING MUST INCLUDE THE USE OF SEED MIXES DEVELOPED FOR THE CORRIDOR AND APPROVED BY THE USDA.

STOCKPILES AND MATERIAL STORAGE ARE PROHIBITED IN SPECIAL MANAGEMENT AREAS INCLUDING WETLANDS, WETLAND BUFFERS, AND FLOOD PLAINS, LOCATIONS OF STOCKPILES MUST BE APPROVED BY THE ENGINEER AND HAVE PROPER EROSION CONTROL MEASURES.

ALL STORM SEWER FACILITIES WITH OPEN LIDS THAT ARE OR WILL BE FUNCTIONING DURING CONSTRUCTION SHALL BE PROTECTED OR FILTERED. ALL DRAINAGE STRUCTURES THAT HAVE OPEN LIDS IN PAVEMENT AREAS SHALL BE PROTECTED WITH INLET FILTERS (28000510).

THE CONTRACTOR MUST CLEAN UP, GRADE THE WORK AREAS AS THE PROJECT PROTECTION TO ELIMINATE THE CONCENTRATION OF RUNOFF, OR MUST INSTALL APPROPRIATE SEDIMENT CONTROL DEVICES TO TRAP SEDIMENT. PAVEMENT MUST BE CLEANED DAILY OR AS NECESSARY TO REMOVE TRACK-OUT MATERIAL.

CONTRACTOR SHALL BE RESPONSIBLE FOR REPAIRING PAVEMENT OR PROPERTY DAMAGED DURING CONSTRUCTION OPERATIONS BY CONTRACTOR'S FORCES INCLUDING SUBCONTRACTORS.

THE CONTRACTOR SHALL BE MADE AWARE THAT ALL CONSTRUCTION VEHICLES SHALL BE LIMITED TO A MAXIMUM OF 15 FEET ABOVE EXISTING GRADE WHILE CROSSING UNDER COMMONWEALTH EDISON'S TRANSMISSION LINES AND COMPLY WITH OSHA AND COMED CLEARANCE REQUIREMENTS.

FENCE: EXISTING FENCE THAT HAS TO BE DISCONNECTED AND/OR REMOVED FOR THE CONTRACTOR'S OPERATION SHALL BE RECONNECTED AND/OR REPLACED BY THE CONTRACTOR IN KIND AT NO ADDITIONAL COST TO THE ILLINOIS TOLLWAY. TEMPORARY FENCE SHOULD BE INSTALLED IF EXISTING FENCE IS TO BE REMOVED BY THE CONTRACTOR IN ACCORDANCE WITH SECTION 664 OF THE STANDARD SPECIFICATIONS. ANY RIGHT-OF-WAY MARKERS DISTURBED BY THE CONTRACTOR'S OPERATION SHOULD BE REESTABLISHED BY A REGISTERED LAND SURVEYOR.

ALL ELEVATIONS ARE BASED ON UNITED STATES COAST AND GEODETIC SURVEY DATUM.

AT THE TIME OF THE PRECONSTRUCTION CONFERENCE, THE CONTRACTOR SHALL SUBMIT FOR APPROVAL, THE PROPOSED CONCRETE TRUCK WASHOUT LOCATIONS. RUNOFF FROM WASH AREAS SHALL BE CONTAINED IN DESIGNATED AREAS SO THAT RUNOFF DOES NOT REACH THE STORM SEWER OR DITCH SYSTEMS.

IT SHALL BE THE CONTRACTOR'S RESPONSIBILITY TO VERIFY THE LOCATION OF ALL FIBER OPTIC UTILITIES PRIOR TO STARTING CONSTRUCTION. THE CONTRACTOR SHALL INITIATE THE LOCATE PROCESS FOR THE FIBER OPTIC CABLE BY COMPLETING A "REQUEST TOLLWAY UTILITIES LOCATE" FORM FILLED ON-LINE ON THE ILLINOIS TOLLWAY WEBSITE UNDER "DOING BUSINESS / CONSTRUCTION AND ENGINEERING / PERMITS AND UTILITY INFORMATION" AT LEAST FOUR (4) DAYS PRIOR TO STARTING ANY UNDERGROUND OPERATIONS, EXCAVATIONS OR DIGGING OF ANY TYPE IN GENERAL AREA OF THE FIBER OPTIC CABLE.

EXISTING TOPSOIL DEPTH IS ESTIMATED TO BE SIX (6) INCHES. THE PROPOSED TOPSOIL SHALL BE PLACED TO A DEPTH OF SIX (6) INCHES. THE ACTUAL DEPTH OF TOPSOIL SHALL BE DETERMINED IN THE FIELD AT THE TIME OF CONSTRUCTION BY THE ENGINEER.

NO WORK SHALL BE PERFORMED OVER LIVE TRAFFIC LANES. NO DAYTIME CLOSURES SHALL BE PERMITTED. ONLY NIGHT TIME OPERATIONS SHALL BE PERMITTED.

ALL TOLLWAY LANE CLOSURES SHALL CONFORM TO THE MAINTENANCE OF TRAFFIC (ILLINOIS TOLLWAY) SPECIAL PROVISION AND APPLICABLE TOLLWAY STANDARDS.

TREE AND BRANCHES

THE CONTRACTOR SHALL NOT REMOVE ANY TREES OR BRANCHES ON TOLLWAY RIGHT-OF-WAY WITHOUT PRIOR APPROVAL BY THE ILLINOIS TOLLWAY LANDSCAPE ARCHITECT.

CONTRACTOR SHALL NOT DAMAGE ANY TREES OUTSIDE OF THE WORK LIMITS. IF ANY EXISTING TREES ARE DAMAGED DUE TO CONSTRUCTION ACTIVITIES, CONTRACTOR SHALL REPLACE THE TREE IN KIND.

USE OF WATER

THE INDISCRIMINATE USE OF FIRE HYDRANTS, EXISTING STREAMS, CREEKS, WETLANDS, OR PONDS IS STRICTLY PROHIBITED. THE CONSTRUCTION SHALL PROVIDE A WATER TRUCK AND DRIVER AS REQUIRED TO OBTAIN AND TRANSPORT THIS WATER. THE CONTRACTOR SHALL BE RESPONSIBLE FOR OBTAINING WATER FROM AN APPROVED SOURCE. IF THIS WATER IS FROM A SOURCE OTHER THAN HIS/HER YARD. WRITTEN APPROVAL FROM THE AGENCY HAVING JURISDICTION FOR THE SOURCE OF THE WATER MUST BE RECEIVED BY THE CONTRACTOR PRIOR TO USE OF THE WATER.

SPECIAL PROJECT NOTES

THE CONTRACTOR SHALL BE ALERT TO POST ALL NECESSARY SIGNAGE, HAVE FLAGGERS AT LOCATIONS OF RESTRICTED LANE OPERATIONS, AND TAKE DOWN THE SIGNAGE WHEN THE WORK IS COMPLETED IN ACCORDANCE WITH THE TRAFFIC CONTROL PROVISIONS OF SECTION 700, 701 AND 702.

THE CONTRACTOR SHALL BE RESPONSIBLE FOR CONTACTING THE OWNERS OF ALL UTILITIES PRIOR TO CONSTRUCTION TO DETERMINE THE LOCATION OF ALL UTILITY EQUIPMENT. THE CONTRACTOR SHALL COOPERATE WITH ALL UTILITY OWNERS IN ACCORDANCE WITH THE STANDARD SPECIFICATIONS IF UTILITY RELOCATION, ADJUSTMENT, OR PROTECTION IF NECESSARY.

ALL UTILITY OWNERS SHALL BE NOTIFIED AT LEAST 3 DAYS PRIOR TO THE START OF CONSTRUCTION.

THE CONTRACTOR SHALL USE ALL NECESSARY PRECAUTIONS AND PROTECTION MEASURES REQUIRED TO MAINTAIN EXISTING UTILITIES, SEWERS, AND APPURTENANCES THAT MUST BE KEPT IN OPERATION.

THE CONTRACTOR SHALL CONTACT THE DISTRICT ONE TRAFFIC CONTROL SUPERVISOR FOR ARTERIALS AT Kalpana. Kannan-Hosadurga@illinois.gov AT LEAST 72 HOURS IN ADVANCE OF REGINNING WORK.

ROADWAY JURISDICTIONS:

ELGIN O'HARE WESTERN ACCESS TOLLWAY (IL-390): ILLINOIS STATE TOLL HIGHWAY AUTHORITY IIS-20/LAKE STREET: IDOT ROSELLE ROAD: COOK COUNTY PLUM GROVE ROAD: COOK COUNTY ROHLWING ROAD: IDOT

SCALE: NTS

STATE OF ILLINOIS **DEPARTMENT OF TRANSPORTATION**

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AND GENERAL NOTES			CONTRACT	NO. (61E6
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21101505 TOPSOIL EXCAVATION AND PLACEMENT			20101100	TREE TRUNK PROTECTION	EACH	1
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28000305 TEMPORARY DITCH CHECKS FOOT			20200100	EARTH EXCAVATION	CU YD	2:
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SB700300 CONCRETE SEALER S0 FT 1						
# 70102620 TRAFFIC CONTROL AND PROTECTION. STANDARD 701501 L SUM * 70102630 TRAFFIC CONTROL AND PROTECTION. STANDARD 701601 L SUM * 70102635 TRAFFIC CONTROL AND PROTECTION. STANDARD 701601 L SUM 70102640 TRAFFIC CONTROL AND PROTECTION. STANDARD 701701 L SUM 70102640 TRAFFIC CONTROL AND PROTECTION. STANDARD 701801 L SUM 70300904 PAVEMENT MARKING TAPE. TYPE IV 4" FDDT 5. + A2004520 TREE. GINKGO BILOBA PRINCETON SENTRY (PRINCETON SENTRY GINKGO). 2-1/2" EACH + A2005520 TREE. OLERGUS BICOLOR (SWAMP WHITE DAK). 2-1/2" CALIPER. BALLED AND BURLAPPED + A2006618 TREE. OLERGUS IMBRICARIA (SHINGLE DAK). 2-1/2" CALIPER. BALLED AND BURLAPPED + A2008470 TREE. OLERGUS IMBRICARIA (SHINGLE DAK). 2-1/2" CALIPER. BALLED AND BURLAPPED + A2008470 TREE. OLERGUS IMBRICANA PRINCETON (PRINCETON AMERICAN ELM). 2-1/2" CALIPER. EACH + A2008470 SALLED AND BURLAPPED + C2C00524 SHRUB. ARDNIA MELANDCARPA (BLACK CHOKE BERRY). 2' HEIGHT. CONTAINER EACH 1			51603000	DRILLED SHAFT IN SOIL	CU YD	1.
# 70102620 TRAFFIC CONTROL AND PROTECTION. STANDARD 701501 L SUM * 70102630 TRAFFIC CONTROL AND PROTECTION. STANDARD 701601 L SUM * 70102635 TRAFFIC CONTROL AND PROTECTION. STANDARD 701601 L SUM 70102640 TRAFFIC CONTROL AND PROTECTION. STANDARD 701701 L SUM 70102640 TRAFFIC CONTROL AND PROTECTION. STANDARD 701801 L SUM 70300904 PAVEMENT MARKING TAPE. TYPE IV 4" FDDT 5. + A2004520 TREE. GINKGO BILOBA PRINCETON SENTRY (PRINCETON SENTRY GINKGO). 2-1/2" EACH + A2005520 TREE. OLERGUS BICOLOR (SWAMP WHITE DAK). 2-1/2" CALIPER. BALLED AND BURLAPPED + A2006618 TREE. OLERGUS IMBRICARIA (SHINGLE DAK). 2-1/2" CALIPER. BALLED AND BURLAPPED + A2008470 TREE. OLERGUS IMBRICARIA (SHINGLE DAK). 2-1/2" CALIPER. BALLED AND BURLAPPED + A2008470 TREE. OLERGUS IMBRICANA PRINCETON (PRINCETON AMERICAN ELM). 2-1/2" CALIPER. EACH + A2008470 SALLED AND BURLAPPED + C2C00524 SHRUB. ARDNIA MELANDCARPA (BLACK CHOKE BERRY). 2' HEIGHT. CONTAINER EACH 1						
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* TO102620 TRAFFIC CONTROL AND PROTECTION, STANDARD 701501 L SUM * TO102630 TRAFFIC CONTROL AND PROTECTION, STANDARD 701601 L SUM * TO102635 TRAFFIC CONTROL AND PROTECTION, STANDARD 701701 L SUM TO102640 TRAFFIC CONTROL AND PROTECTION, STANDARD 701701 L SUM TO102640 TRAFFIC CONTROL AND PROTECTION, STANDARD 701801 L SUM TO300904 PAVEMENT MARKING TAPE, TYPE IV 4" FOOT 5. * A2004520 TREE, GINKGO BILOBA PRINCETON SENTRY (PRINCETON SENTRY GINKGO), 2-1/2" EACH * A2006520 TREE, OUERCUS BICOLOR (SWAMP WHITE DAK), 2-1/2" CALIPER, BALLED AND EACH * A2006618 TREE, OUERCUS IMBRICARIA (SHINGLE DAK), 2-1/2" CALIPER, BALLED AND BURLAPPED * A2008470 BALLED AN						
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* 70102635 TRAFFIC CONTROL AND PROTECTION. STANDARD 701701 L SUM 70102640 TRAFFIC CONTROL AND PROTECTION. STANDARD 701801 L SUM 70300904 PAVEMENT MARKING TAPE. TYPE IV 4" FOOT 5. + A2004520 TREE. GINKGO BILOBA PRINCETON SENTRY (PRINCETON SENTRY GINKGO). 2-1/2" EACH + A2006520 TREE. OUERCUS BICOLOR (SWAMP WHITE DAK). 2-1/2" CALIPER. BALLED AND EACH + A2006618 TREE. OUERCUS IMBRICARIA (SHINGLE OAK). 2-1/2" CALIPER. BALLED AND BURLAPPED + A2008470 TREE. ULMUS AMERICANA PRINCETON (PRINCETON AMERICAN ELM). 2-1/2" CALIPER. EACH + C2C00524 SHRUB. ARDNIA MELANDCARPA (BLACK CHOKE BERRY). 2' HEIGHT. CONTAINER EACH 1			.0.02020	10 00.11100 110 110 120 1011 01110 110 100 100	2 00	
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TO102640 TRAFFIC CONTROL AND PROTECTION. STANDARD 701801 TO300904 PAVEMENT MARKING TAPE. TYPE IV 4" FODT 5. TREE. GINKGO BILOBA PRINCETON SENTRY (PRINCETON SENTRY GINKGO). 2-1/2" EACH A2004520 TREE. OUERCUS BICOLOR (SWAMP WHITE DAK). 2-1/2" CALIPER. BALLED AND BURLAPPED TREE. OUERCUS IMBRICARIA (SHINGLE DAK). 2-1/2" CALIPER. BALLED AND BURLAPPED A2006618 TREE. OUERCUS IMBRICARIA (SHINGLE DAK). 2-1/2" CALIPER. BALLED AND BURLAPPED EACH A2008470 TREE. ULMUS AMERICANA PRINCETON (PRINCETON AMERICAN ELM). 2-1/2" CALIPER. EACH C2C00524 SHRUB. ARONIA MELANDCARPA (BLACK CHOKE BERRY). 2' HEIGHT. CONTAINER EACH 1		¥	70102635	TRACEIC CONTROL AND PROTECTION STANDARD 701701	I SUM	1
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+ A2006520 TREE. GINKGO BILOBA PRINCETON SENTRY (PRINCETON SENTRY GINKGO), 2-1/2" EACH + A2006520 TREE. GINKGO BILOBA PRINCETON SENTRY (PRINCETON SENTRY GINKGO), 2-1/2" EACH + A2006520 TREE. OUERCUS BICOLOR (SWAMP WHITE DAK), 2-1/2" CALIPER, BALLED AND EACH + A2006618 TREE. OUERCUS IMBRICARIA (SHINGLE DAK), 2-1/2" CALIPER, BALLED AND BURLAPPED EACH + A2008470 TREE. ULMUS AMERICANA PRINCETON (PRINCETON AMERICAN ELM), 2-1/2" CALIPER, EACH + C200524 SHRUB. ARONIA MELANOCARPA (BLACK CHOKE BERRY), 2' HEIGHT, CONTAINER EACH 1			70102640	TRACCIC CONTROL AND PROTECTION STANDARD 701801	1 51114	1
+ A2004520 TREE, CINKGO BILOBA PRINCETON SENTRY (PRINCETON SENTRY GINKGO), 2-1/2" EACH + A2006520 TREE, OUERCUS BICOLOR (SWAMP WHITE DAK), 2-1/2" CALIPER, BALLED AND + A2006618 TREE, OUERCUS IMBRICARIA (SHINGLE DAK), 2-1/2" CALIPER, BALLED AND BURLAPPED EACH + A2008470 TREE, ULMUS AMERICANA PRINCETON (PRINCETON AMERICAN ELM), 2-1/2" CALIPER, EACH + C2C00524 SHRUB, ARONIA MELANDCARPA (BLACK CHOKE BERRY), 2' HEIGHT, CONTAINER EACH 1			70102640	TRAFFIC CONTROL AND PROTECTIONS STANDARD TOTAGE	L SUM	
+ A2004520 TREE, CINKGO BILOBA PRINCETON SENTRY (PRINCETON SENTRY GINKGO), 2-1/2" EACH + A2006520 TREE, OUERCUS BICOLOR (SWAMP WHITE DAK), 2-1/2" CALIPER, BALLED AND + A2006618 TREE, OUERCUS IMBRICARIA (SHINGLE DAK), 2-1/2" CALIPER, BALLED AND BURLAPPED EACH + A2008470 TREE, ULMUS AMERICANA PRINCETON (PRINCETON AMERICAN ELM), 2-1/2" CALIPER, EACH + C2C00524 SHRUB, ARONIA MELANDCARPA (BLACK CHOKE BERRY), 2' HEIGHT, CONTAINER EACH 1	İ		70700004	DAVENENT HARVING TARE TYPE IV 4"	COOT	F 0
+ A2006520 TREE. QUERCUS BICOLOR (SWAMP WHITE DAK). 2-1/2" CALIPER. BALLED AND EACH + A2006618 TREE, QUERCUS IMBRICARIA (SHINGLE DAK). 2-1/2" CALIPER, BALLED AND BURLAPPED EACH + A2008470 TREE. ULMUS AMERICANA PRINCETON (PRINCETON AMERICAN ELM). 2-1/2" CALIPER. + C2C00524 SHRUB. ARONIA MELANDCARPA (BLACK CHOKE BERRY). 2' HEIGHT. CONTAINER EACH 1			10300304	FAVEMENT MARKING TAPE, TIPE IV 4	F 001	3.0
+ A2006520 TREE, OUERCUS BICDLOR (SWAMP WHITE DAK), 2-1/2" CALIPER, BALLED AND EACH + A2006618 TREE, OUERCUS IMBRICARIA (SHINGLE DAK), 2-1/2" CALIPER, BALLED AND BURLAPPED EACH + A2008470 TREE, ULMUS AMERICANA PRINCETON (PRINCETON AMERICAN ELM), 2-1/2" CALIPER, EACH + C2C00524 SHRUB, ARONIA MELANDCARPA (BLACK CHOKE BERRY), 2' HEIGHT, CONTAINER EACH 1			12004520	TREE, GINKGO BILOBA PRINCETON SENTRY (PRINCETON SENTRY GINKGO), 2-1/2"	E 4 CU	
+ A2006470 TREE, OUERCUS IMBRICARIA (SHINGLE DAK), 2-1/2" CALIPER, BALLED AND BURLAPPED EACH + A2008470 TREE, ULMUS AMERICANA PRINCETON (PRINCETON AMERICAN ELM), 2-1/2" CALIPER, EACH + C2C00524 SHRUB, ARONIA MELANDCARPA (BLACK CHOKE BERRY), 2' HEIGHT, CONTAINER EACH 1	+		A2004520	CALIPER, BALLED AND BURLAPPED	EACH	10
+ A2006470 TREE, OUERCUS IMBRICARIA (SHINGLE DAK), 2-1/2" CALIPER, BALLED AND BURLAPPED EACH + A2008470 TREE, ULMUS AMERICANA PRINCETON (PRINCETON AMERICAN ELM), 2-1/2" CALIPER, EACH + C2C00524 SHRUB, ARONIA MELANDCARPA (BLACK CHOKE BERRY), 2' HEIGHT, CONTAINER EACH 1				TREE, QUERCUS BICDLOR (SWAMP WHITE DAK), 2-1/2" CALIPER, BALLED AND		
+ A2008470 TREE, ULMUS AMERICANA PRINCETON (PRINCETON AMERICAN ELM), 2-1/2" CALIPER, EACH + C2C00524 SHRUB, ARONIA MELANDCARPA (BLACK CHOKE BERRY), 2' HEIGHT, CONTAINER EACH 1	+				LACH	7
+ A2008470 TREE, ULMUS AMERICANA PRINCETON (PRINCETON AMERICAN ELM), 2-1/2" CALIPER, EACH + C2C00524 SHRUB, ARONIA MELANDCARPA (BLACK CHOKE BERRY), 2' HEIGHT, CONTAINER EACH 1						
+ C2CO0524 SHRUB, ARONIA MELANOCARPA (BLACK CHOKE BERRY), 2' HEIGHT, CONTAINER EACH 1	+		A2U06618	THEE, OUERCUS IMBRICARIA (SHINGLE DAK), 2-1/2" CALIPER, BALLED AND BURLAPPED	Ł ACH	19
+ C2CO0524 SHRUB. ARDNIA MELANDCARPA (BLACK CHOKE BERRY), 2' HEIGHT. CONTAINER EACH 1				TREE. III MUS AMERICANA PRINCETON (PRINCETON AMERICAN ELM). 2-1/2" CALIPER		
	+				EACH	10
+ C2CO1120 SHRUB, CEPHALANTHUS OCCIDENTALIS (BUTTON BUSH), 2' HEIGHT, CONTAINER EACH 2	+		C2C00524	SHRUB, ARDNIA MELANDCARPA (BLACK CHOKE BERRY), 2' HEIGHT, CONTAINER	EACH	10
+ C2CO1120 SHRUB, CEPHALANTHUS OCCIDENTALIS (BUTTON BUSH), 2' HEIGHT, CONTAINER EACH						
	+		C2C01120	SHRUB, CEPHALANTHUS OCCIDENTALIS (BUTTON BUSH), 2' HEIGHT, CONTAINER	EACH	22

DESIGNED - AS

DRAWN - RR

CHECKED - EN

DATE - 6/10/2019

REVISED -

REVISED -

REVISED -

REVISED -

DUPAGE COUNTY
DIVISION OF TRANSPORTATION
421 COUNTY FARM ROAD
WHEATON, IL

I YD	17		+	*	X0320060	GATEWAY MONUMENT SIGN COMPLETE	EACH	1	_
FT	707		+	*	X0322955	WEED CONTROL SELECTIVE (WOODY PLANTS & BROADLEAF)	GALLON	0.2	
SUM	1		+	*	X1400225	SOLAR LED LIGHTING UNIT COMPLETE	EACH	7	
SUM	1			*	X7030005	TEMPORARY PAVEMENT MARKING REMOVAL	SO FT	1,700	
SUM	1		+	*	XX007181	VERTICAL IDENTIFIER	EACH	4	
SUM	1		+	*	XX007465	STEEL FENCE PANELS	FOOT	1.204	
SUM	1			*	20013798	CONSTRUCTION LAYOUT	L SUM	1	
			-				5007		
тос	5.000			*	Z0022800	FENCE REMOVAL	FOOT	300	
ACH	10			*	Z0030850	TEMPORARY INFORMATION SIGNING	SO FT	130	
чсп				<i>*</i>	20030830	TEMPORARY INFORMATION STONING	30 1 1	150	
ACH	7			*	Z0064800	SELECTIVE CLEARING	UNIT	10	
АСН	19	#		*	Z0076600	TRAINEES	HOUR	500	
СН	10	#		*	Z0076604	TRAINEES TRAINING PROGRAM GRADUATE	HOUR	500	
СН	108		+	*	D2C01030	EVERGREEN, JUNIPERUS HORIZONTALIS ANDORRA (ANDORRA CREEPING JUNIP WIDTH, CONTAINER	ER), 24" EACH	67	,
СН	22								
		#	CONSTRUCTI	ON TYPE CODE	0042				
						F.A.F RTE	SECTION	COUNTY	Y TOTAL SHEET SHEET NO.
r	_	TATE OF ILLI		TION		SUMMARY OF QUANTITIES 345/		COOK/DUP	AGE 37 3
יט	CPAKIW	ENT OF TRAI	NOPUKIA	HUN	SCALE: N	S	ILL INDIS FE	CONTR D. AID PROJECT	ACT NO. 61E69

ITEM

C2C03620 SHRUB, HYDRANGEA PANICULATA LITTLE LIME (LITTLE LIME HYDRANGEA), 2' HEIGHT. CONTAINER GROWN

C2CO48G5 SHRUB. PHYSOCARPUS OPULIFOLIUS (COMMON NINEBARK), CONTAINER GROWN, 5-GALLON

C2CO58G2 SHRUB, RHUS AROMATICA GRD-LDW (GRD-LDW FRAGRANT SUMAC), CONTAINER GROWN, 2-GALLON

D2CO3524 EVERGREEN. TAXUS X MEDIA DENSIFORMIS (DENSE ANGLOJAPANESE YEW), 2' WIDTH.

D2001988 EVERGREEN, PICEA GLAUCA DENSATA (BLACK HILLS SPRUCE), 8' HEIGHT, BALLED AND

C2CO3724 SHRUB, HYPERICUM KALMIANUM (KALM ST. JOHNSWORT), 2' HEIGHT, CONTAINER

TOTAL

QUANTITY

90

264

40

18

74

10

7

0.2

75

1

UNIT

EACH

EACH

EACH

EACH

EACH

UNIT

GALLON

POUND

LSUM

SPECIALTY ITEM

+

+

+

+

+

*

SPECIAL PROVISIONS

NUMBER

BURLAPPED

K0012992 PERENNIAL PLANTS, ORNAMENTAL TYPE, 2-GALLON POT

KO029632 WEED CONTROL. NON-SELECTIVE AND NON-RESIDUAL

KO029634 WEED CONTROL, PRE-EMERGENT GRANULAR HERBICIDE

X0320015 MAINTENANCE OF TRAFFIC (ILLINOIS TOLLWAY)


[#] CO


EARTHWORK SCHEDULE							
LOCATION	EARTH EXCAVATION (20200100) (CU YD)	TOPSOIL EXCAVATION AND PLACEMENT (21101505) (CU YD)					
WB IL-390 EXIT RAMP AT LAKE STREET (US ROUTE 20)	2.4	0.3					
EB IL-390 ENTRANCE RAMP AT LAKE STREET (US ROUTE 20)	13.3	1.4					
EB IL-390 EXIT RAMP AT ROSELLE ROAD	2.4	0.3					
WB IL-390 EXIT RAMP AT ROSELLE ROAD	2.4	0.3					
WB IL-390 AT ROHLWING ROAD	2.4	0.3					
TOTAL	23	3					


NOTE: EXCAVATED MATERIAL SHALL NOT BE HAULED OFF SITE. EXCAVATED MATERIAL SHALL REMAIN ON SITE AND BE PLACED BEHIND THE PROPOSED SIGNS OR AT A LOCATION APPROVED BY THE ENGINEER.

DUPAGE COUNTY	DESIGNED	-	AS	REVISED	=	Γ
DIVISION OF TRANSPORTATION 421 COUNTY FARM ROAD	DRAWN	-	RR	REVISED	=	i
WHEATON, IL	CHECKED	-	EN	REVISED	=	i
	DATE	-	6/10/2019	REVISED	-	L

		F.A.P. RTE.	SECTION	COUNTY	TOTAL SHEETS	SHEET NO.
EARTHWORK SCHEDULE			14-00245-05-LS	COOK/DUPAGE	37	4
				CONTRACT	T NO. 6	61E69
	SCALE: NTS		ILLINOIS FED. A	ID PROJECT		

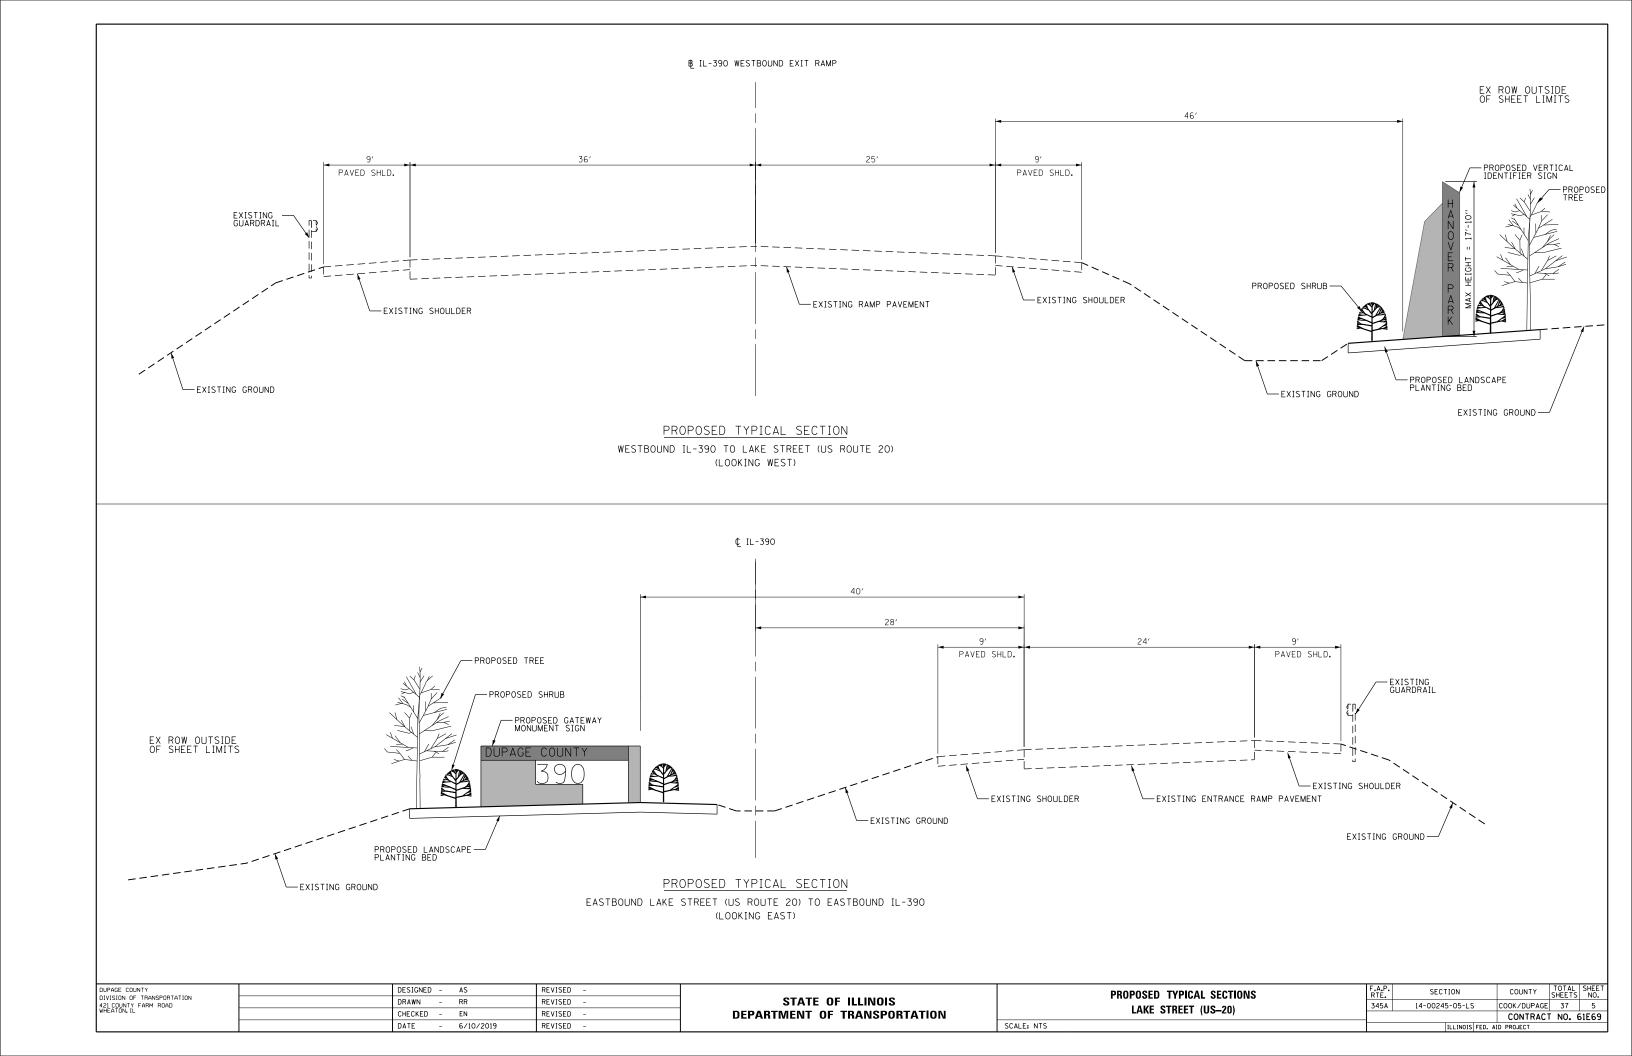


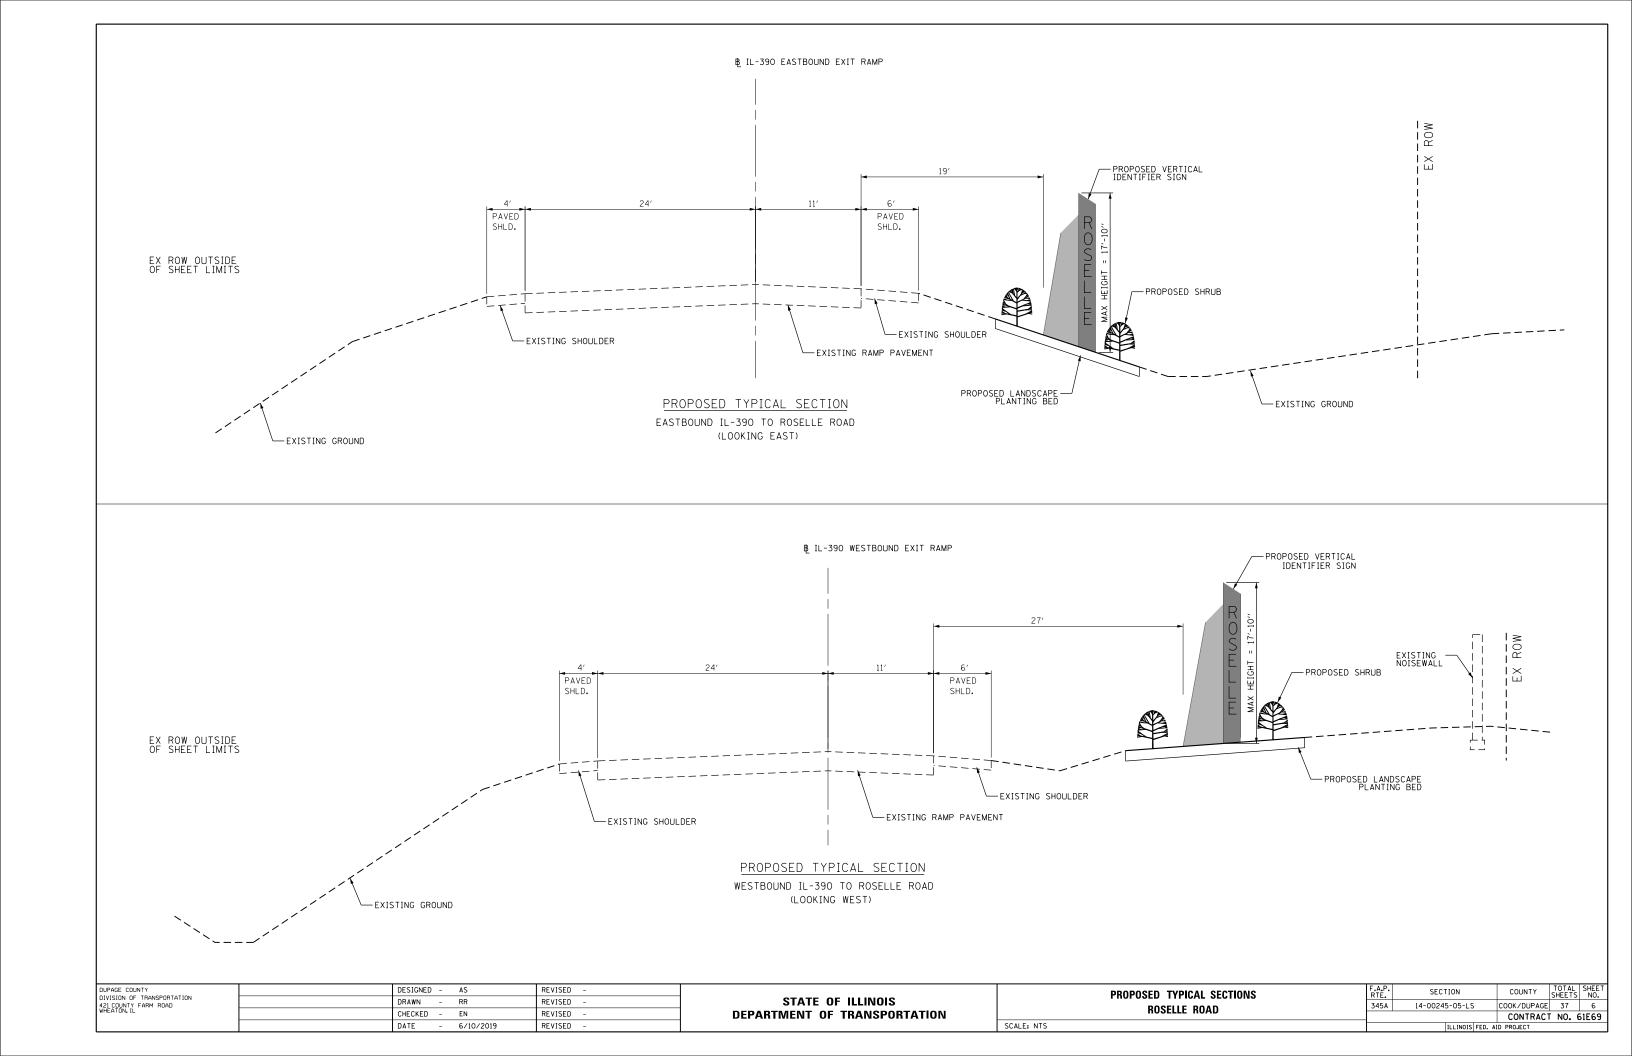


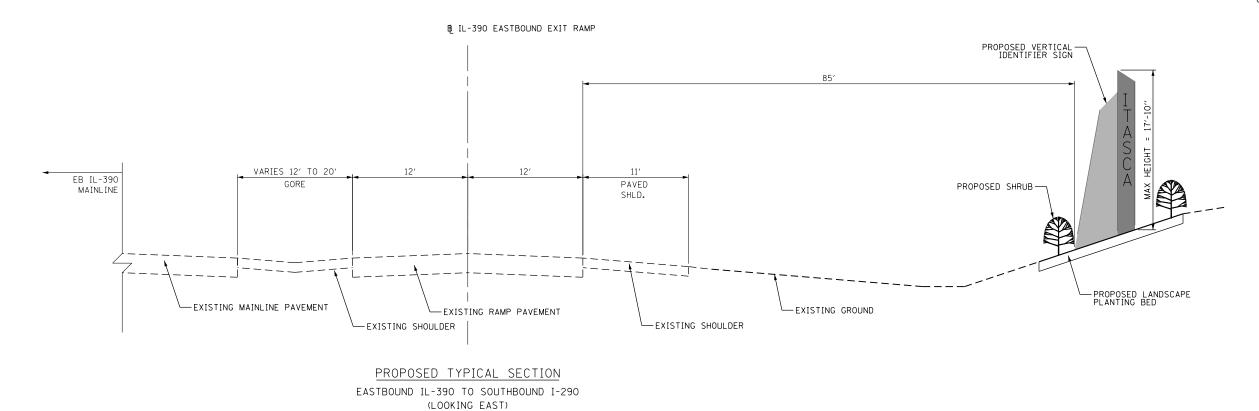



SCALE: NTS


PROPOSED TYPICAL SECTIONS	F.A.P. RTE.	SECTION	COUNTY	TOTAL SHEETS	SHEE NO.
ROHLWING ROAD	345A	14-00245-05-LS	COOK/DUPAGE	37	7
HOHEWING HOAD			CONTRACT	NO. (31E69
		ILL INDIS FED. AL	D PROJECT		

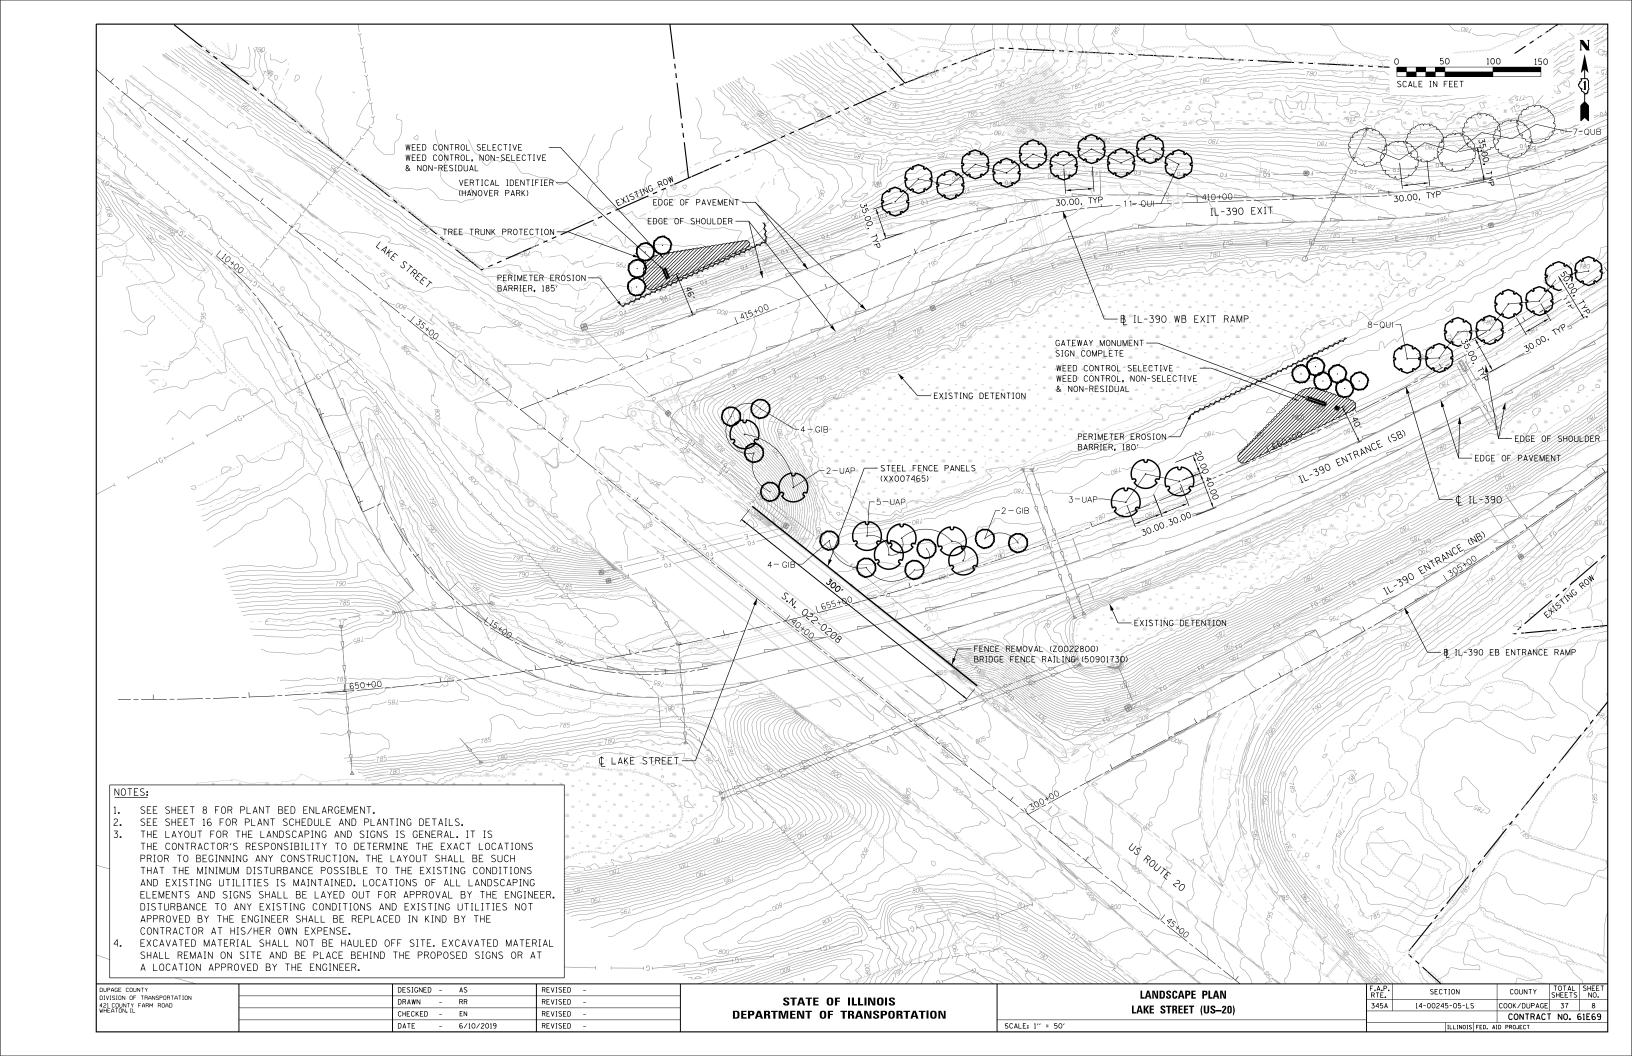


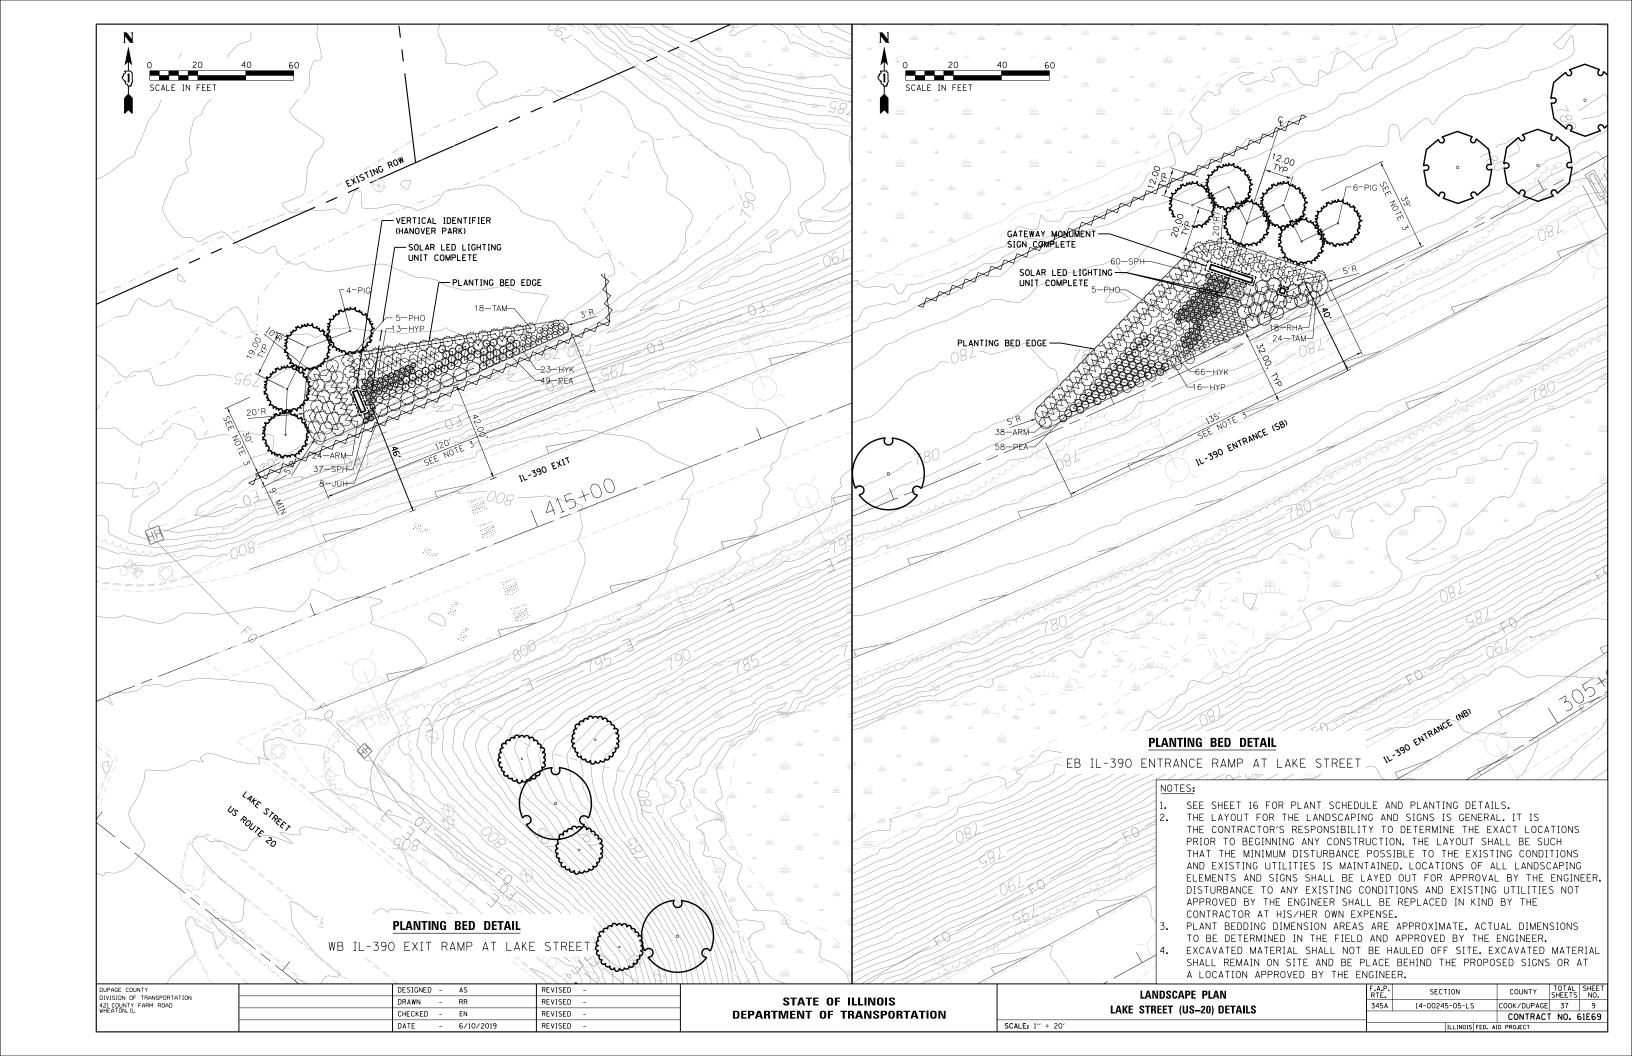


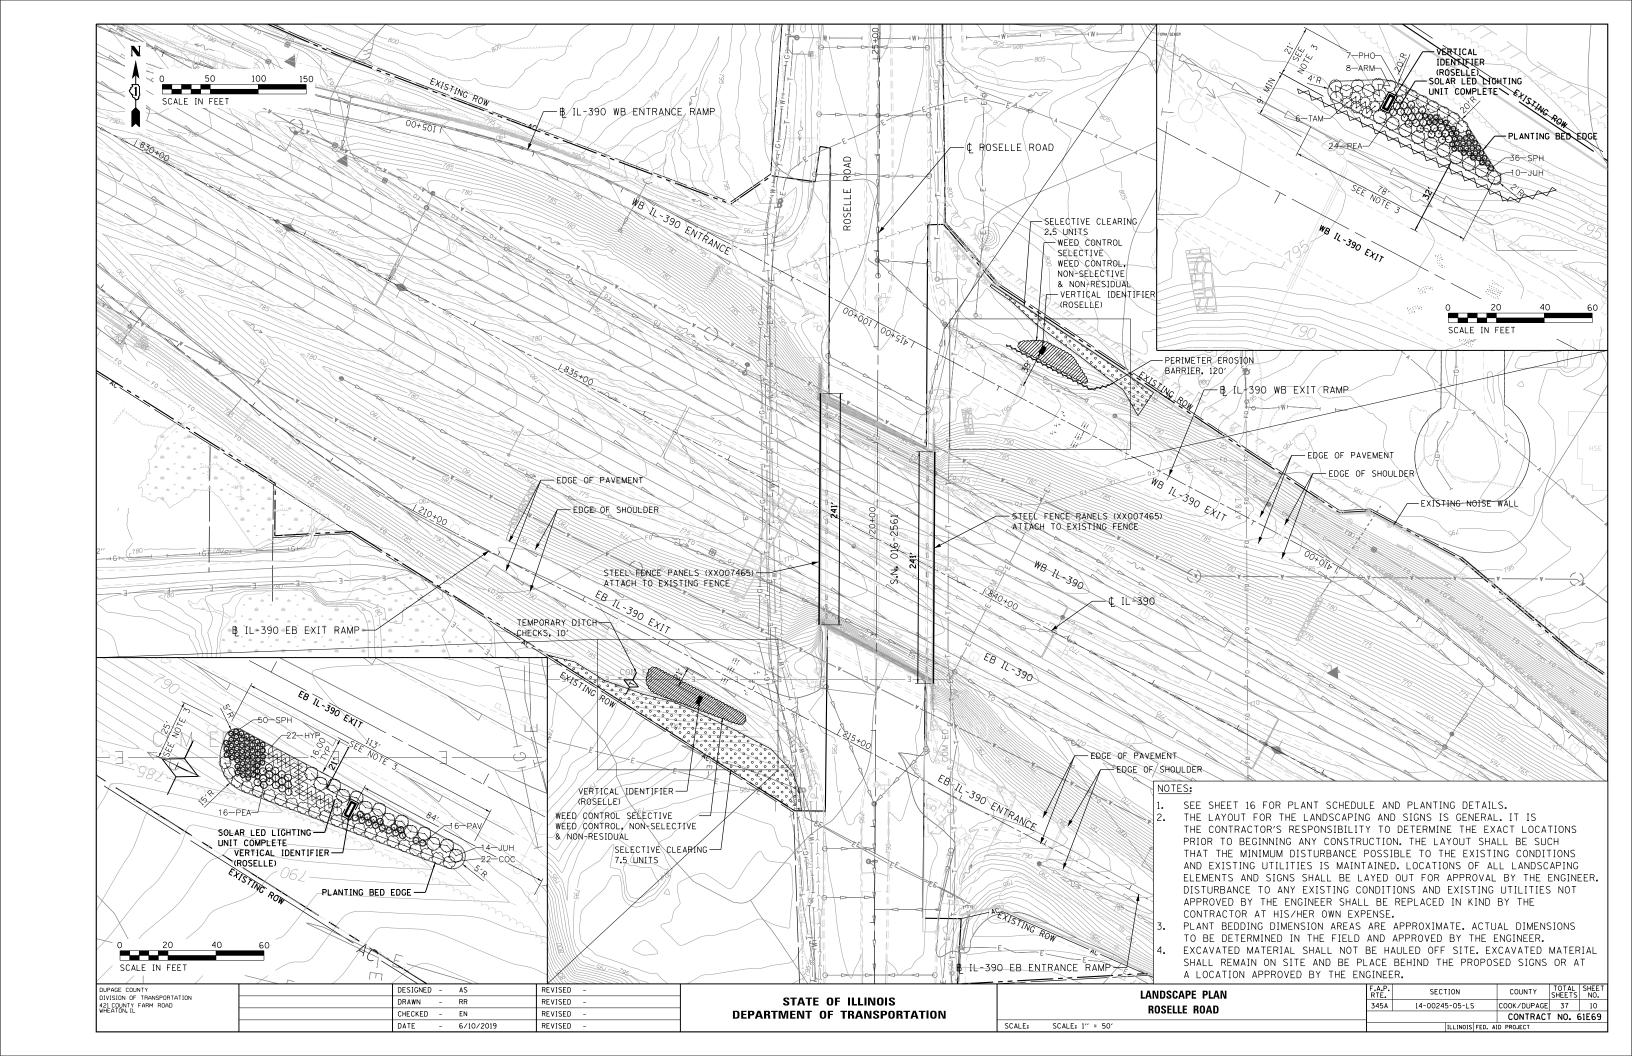


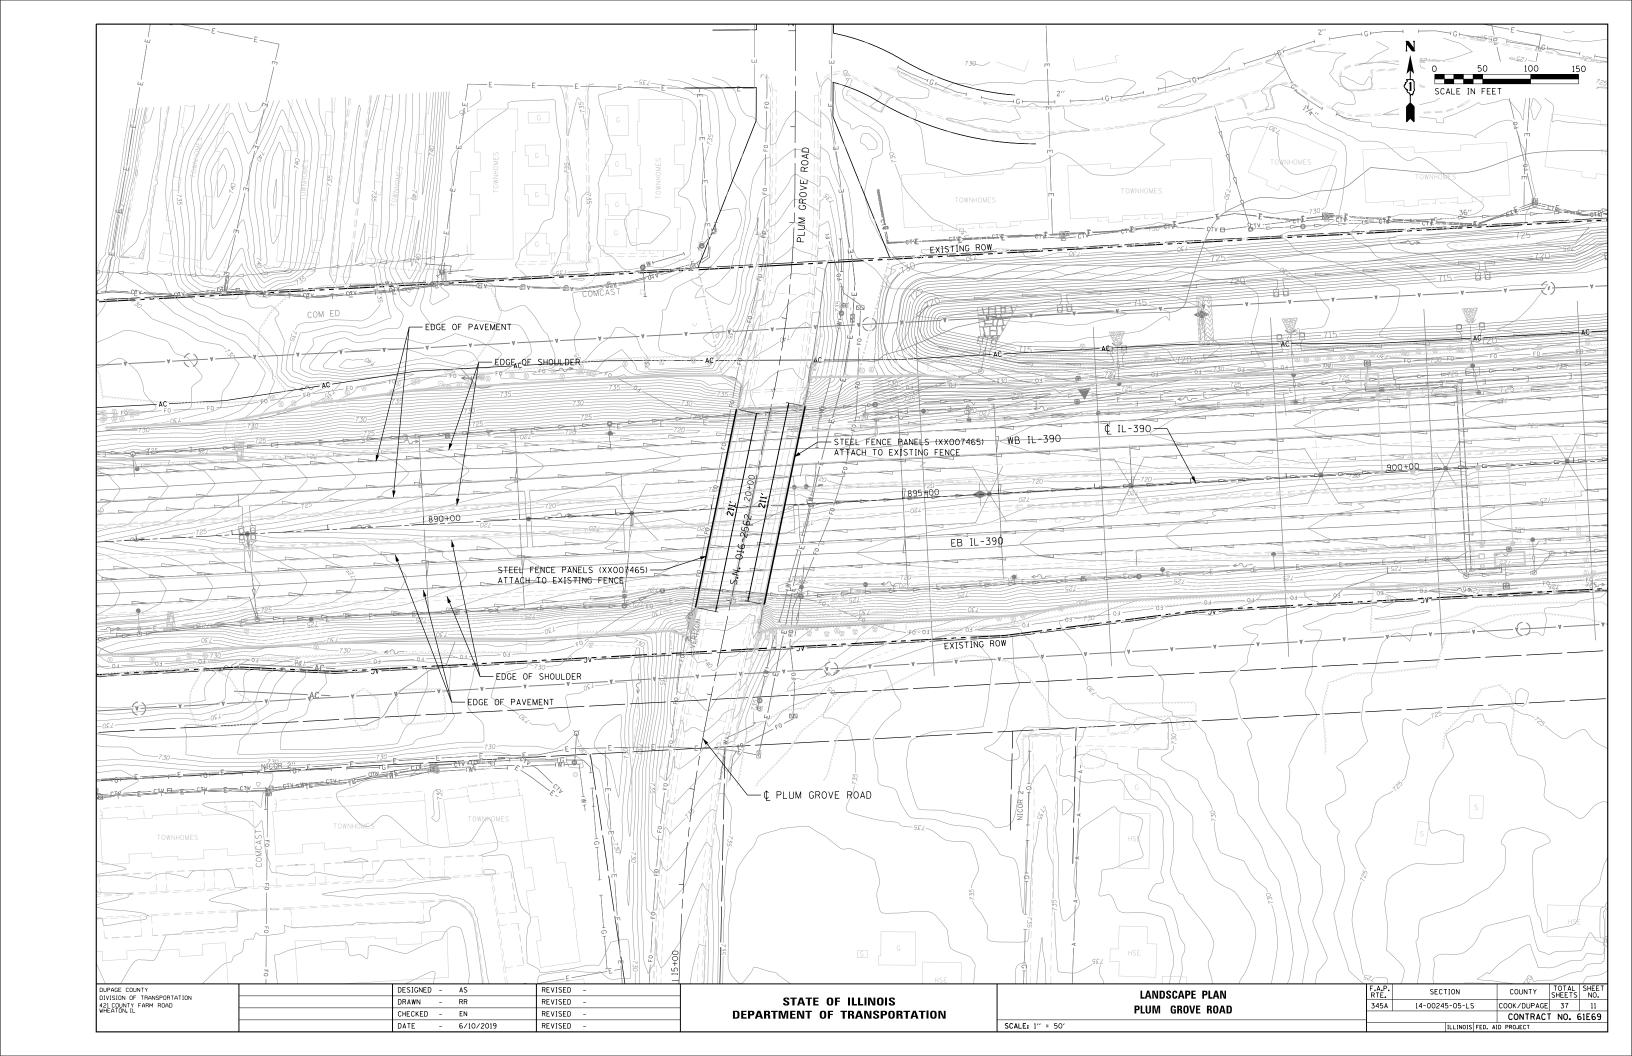

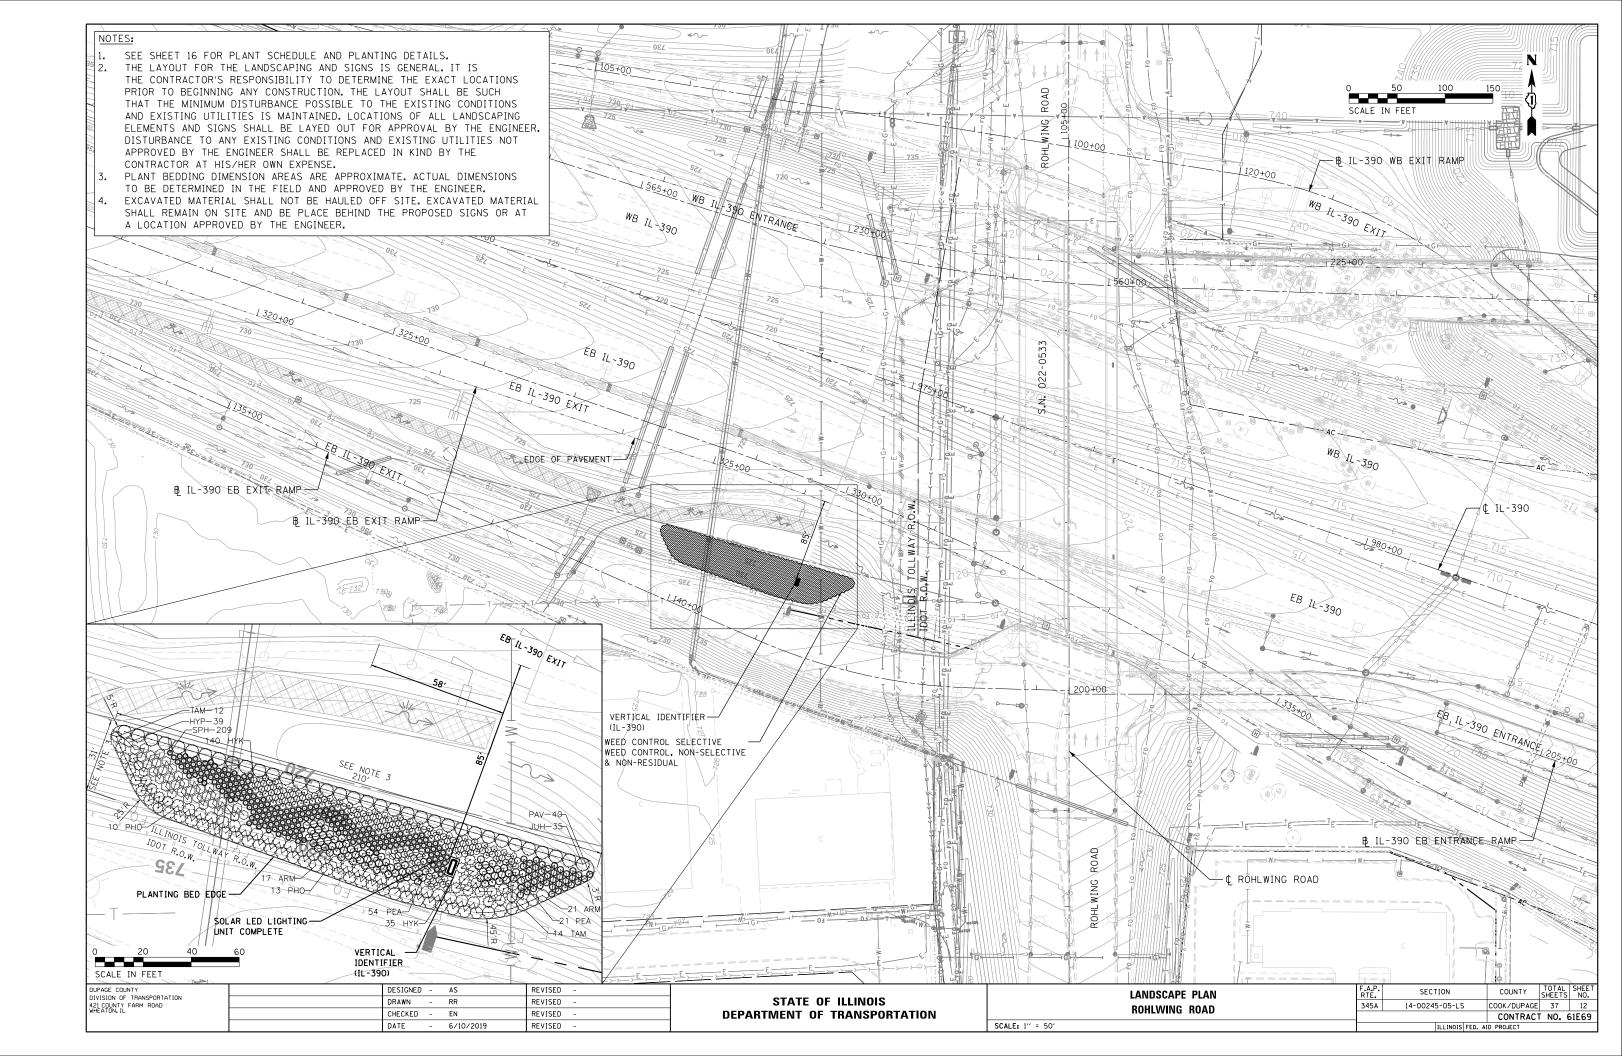

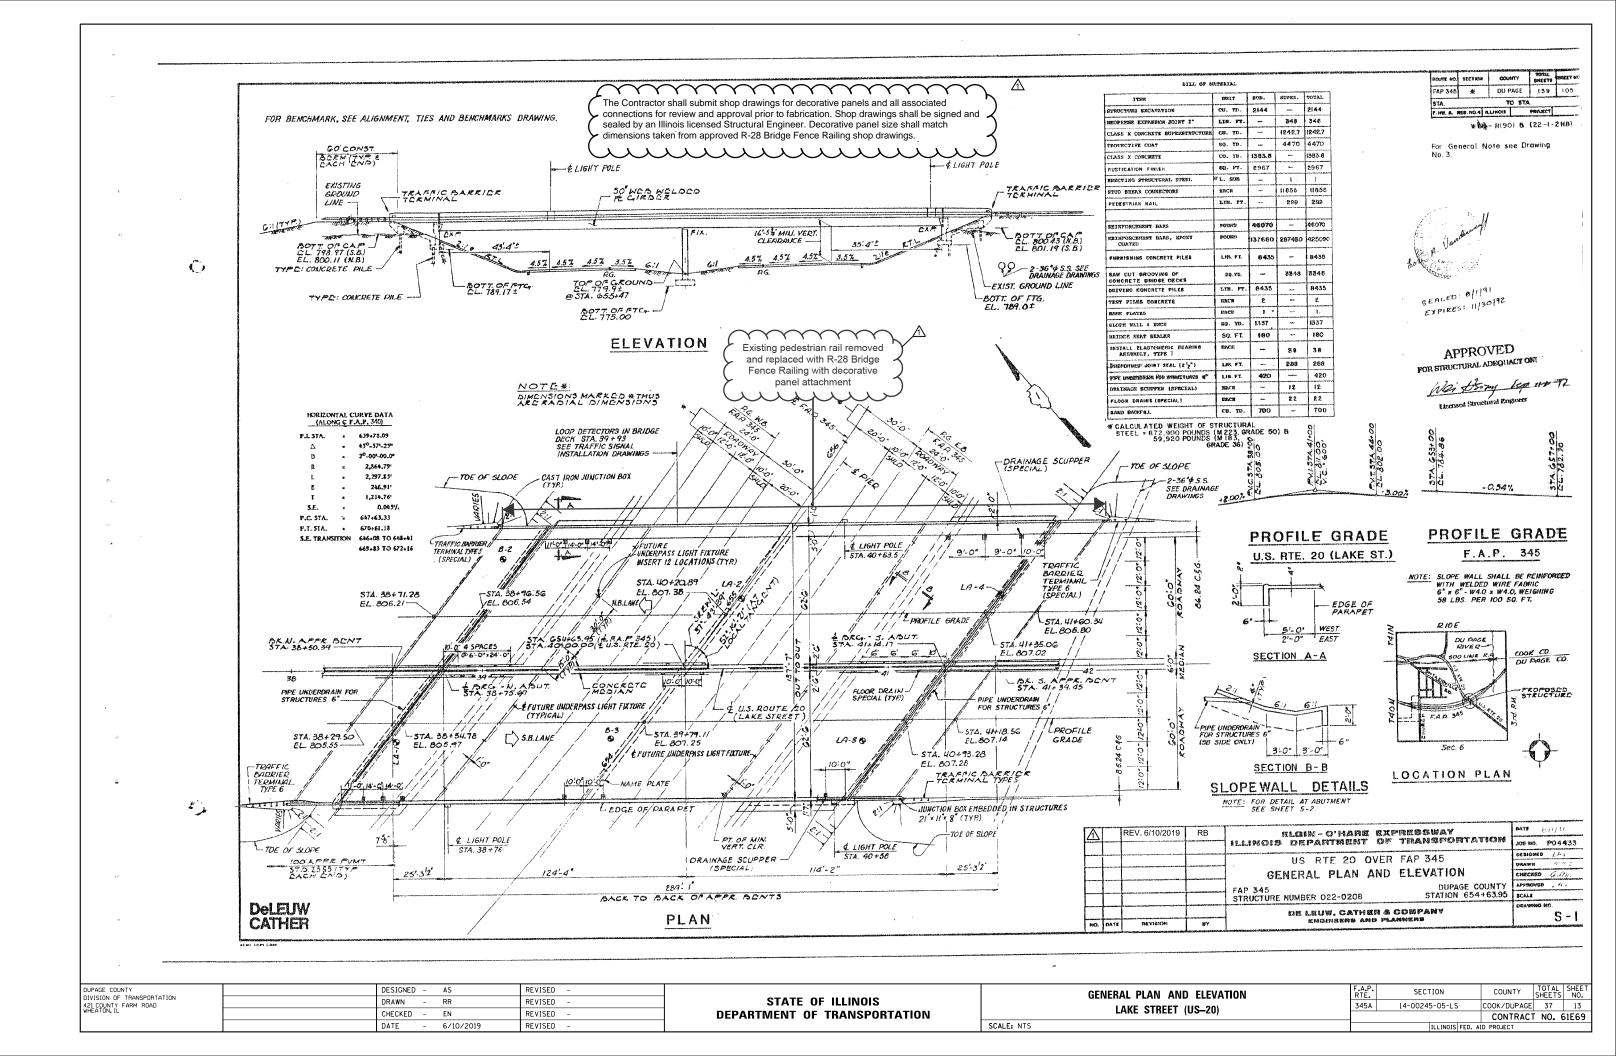


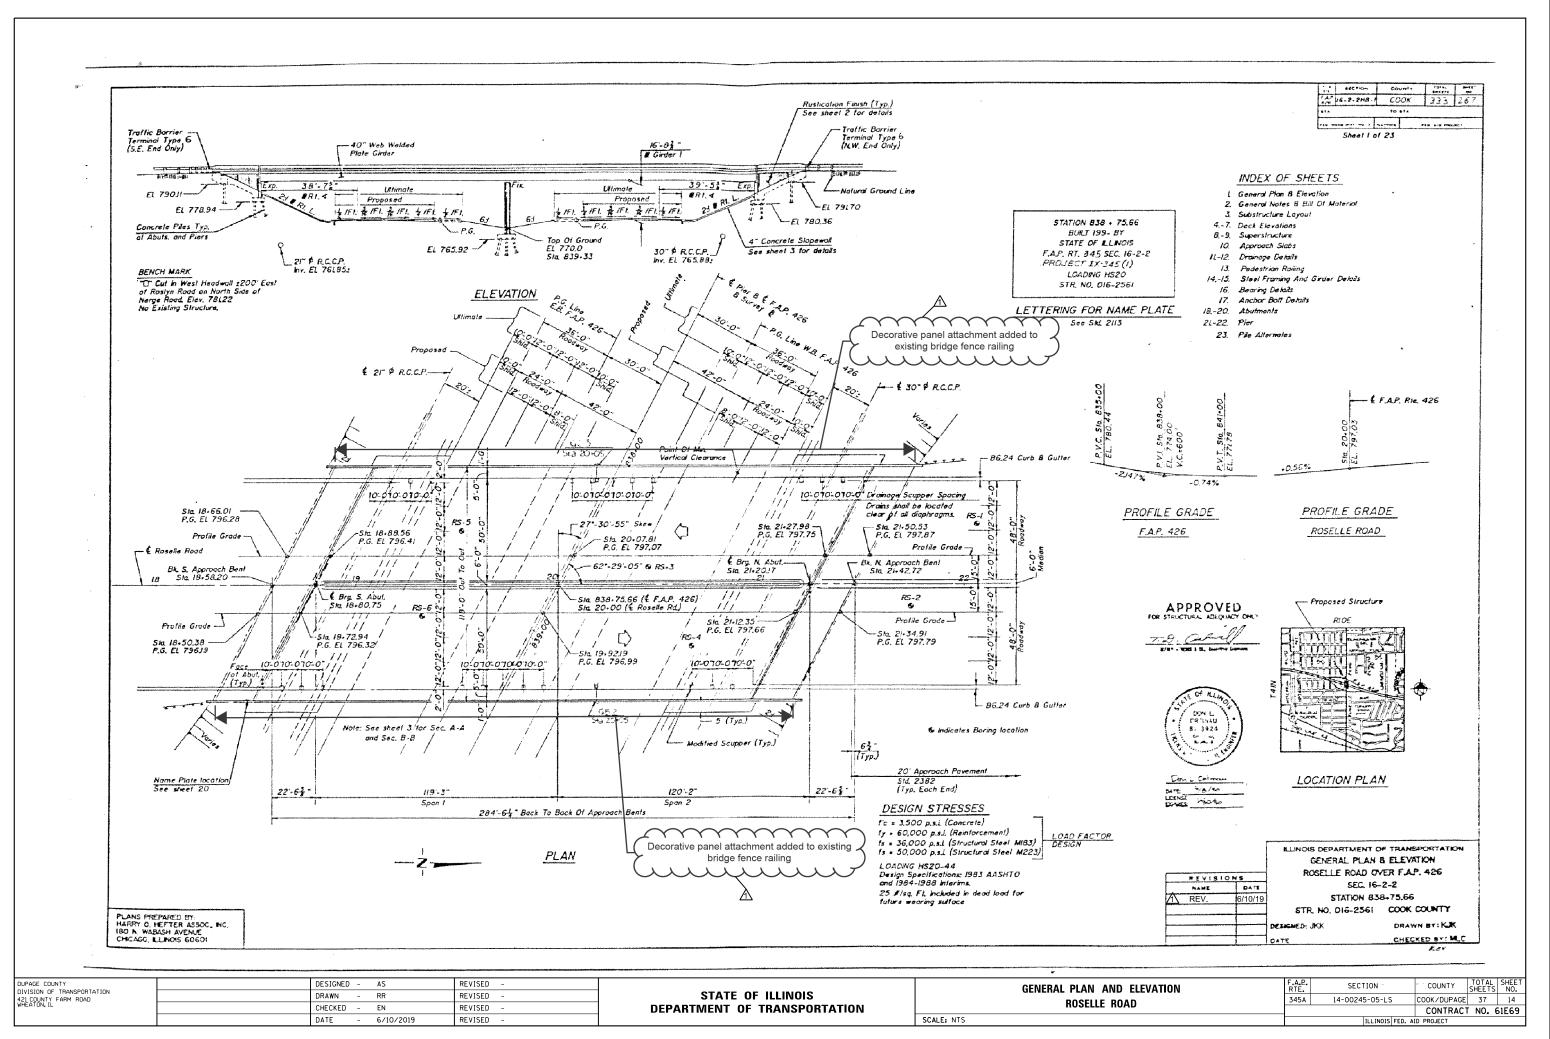

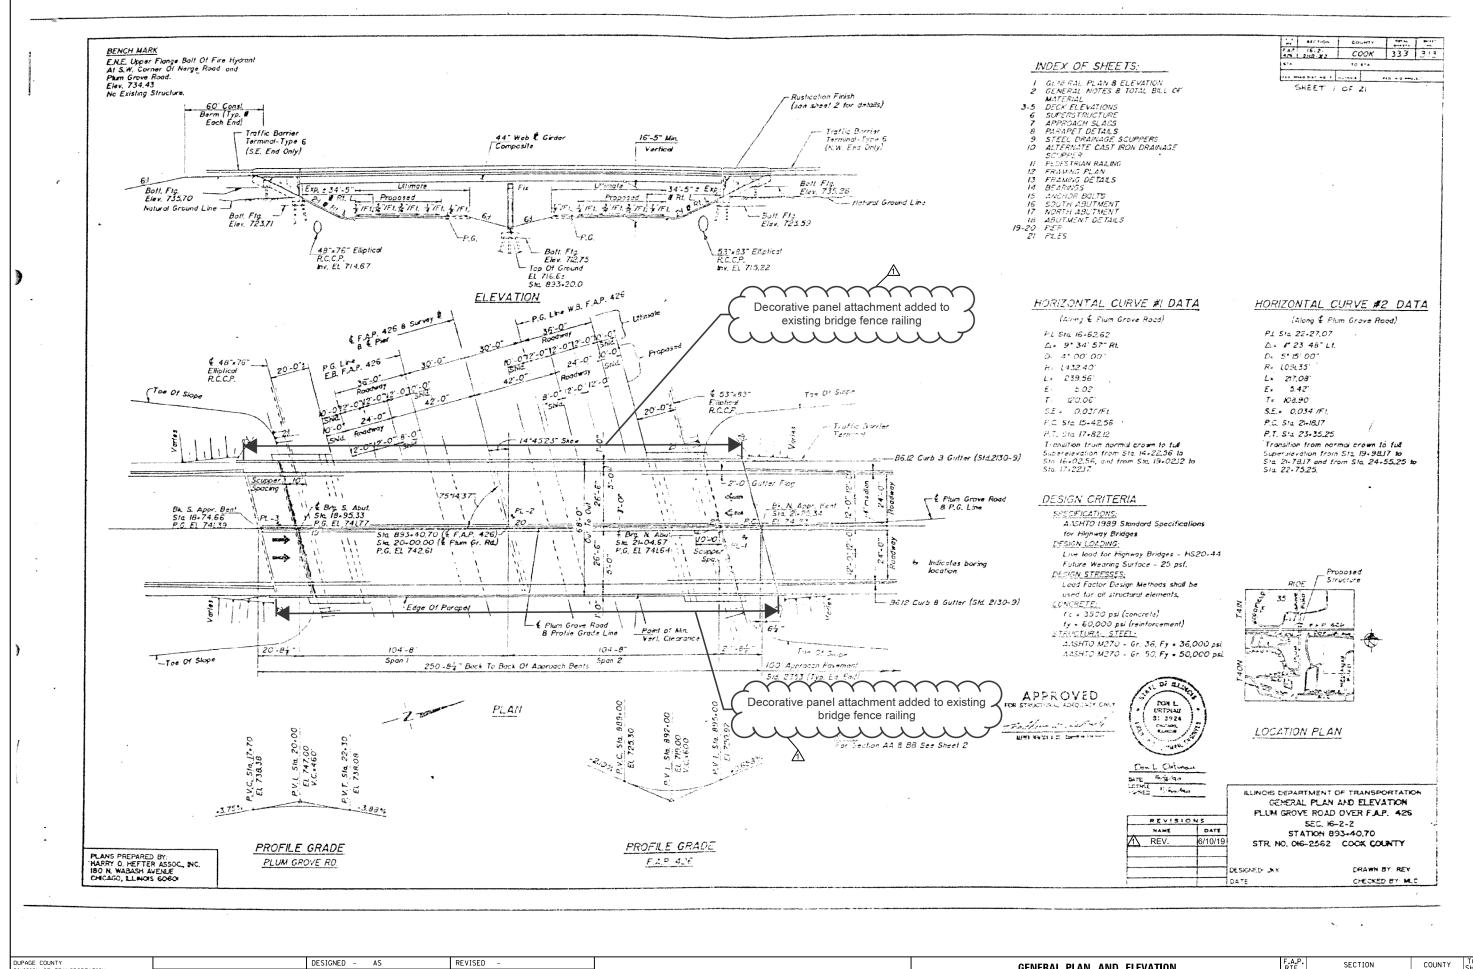

DUPAGE COUNTY	DESIGNED -	AS	REVISED -		GENERAL PLAN AND ELEVATION	F.A.P. RTE.	SECTION	COUNTY	TOTA	L SHEET
421 COUNTY FARM ROAD	DRAWN -	RR	REVISED -	STATE OF ILLINOIS	PLUM GROVE ROAD	345A	14-00245-05-LS	COOK/DUPAG	GE 37	15
WHEATON, IL	CHECKED -	EN	REVISED -	DEPARTMENT OF TRANSPORTATION				CONTRAC	CT NO.	. 61E69
	DATE -	6/10/2019	REVISED -		SCALE: NTS		ILLINOIS FED. A	ID PROJECT		



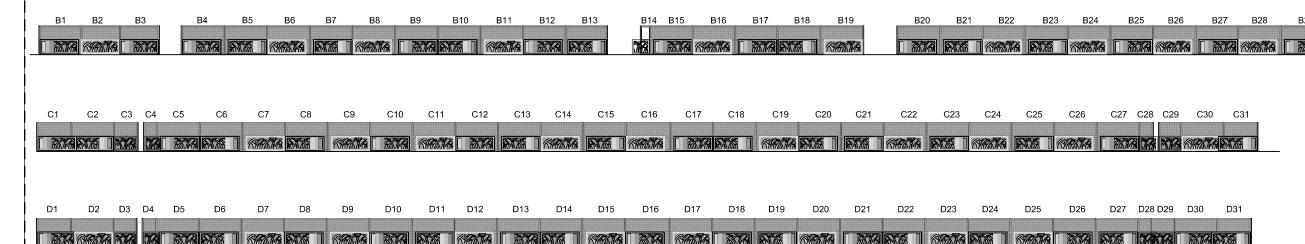

STEEL FENCE PANELS

Fence Panel Schedule | ITEM | SIZE | Panel 1 | A | 8'-0" Panel 2 A 8'-7 5/8" Panel 3 A 7'-2 1/8" GAP A 1'-0" Panel 4 A 8'-7 1/8"
Panel 5 A 8'-8"
Panel 6 A 8'-7 6/8" Panel 7 A 8'-6"
Panel 8 A 8'-8 1/8" Panel 9 A 8'-75/16" Panel 10 A 8'-7 7/8" Panel 11 A 8'-7 1/4" Panel 12 A 8'-7 1/2" Panel 13 A 8'-75/8"
Panel 14 A 8'-76/8" Panel 15 A 8'-7 1/2" Panel 16 A 8'-7 3/4" Panel 17 A 8'-7 1/4" Panel 18 A 8'-7 3/4" Panel 19 A 8'-6 3/4" Panel 20 A 8'-7 3/4" Panel 21 A 3'-2 1/2" GAP A 21 7" Panel 22 A 3'-4 1/2" Panel 23 A 8'-7 1/4" Panel 24 A 8'-7 1/4" Panel 25 A 8'-7 1/2" Panel 26 A 8'-7 1/4" Panel 27 A 8'-7 3/8" Panel 28 A 8'-7 3/4" Panel 29 A 8'-7 1/4"
Panel 30 A 8'-8" Panel 31 A 8'-7 1/4" GAP A 0'-10"
Panel 32 A 6'-10 1/2" Panel 33 A 8'-77/8"

Panel 34 A 8'-7 1/4"

SCALE: AS SHOWN

ROSELLE

ROSELLE PLUM GROVE Fence Panel Schedule Fence Panel Schedule | SIZE | Panel 1 | B | 8'-5 1/2" ITEM C 6'-10 1/8" Panel 1 Panel 2 B 7'-9 1/2"
Panel 3 B 7'-10" Panel 2 C 8'-7 1/8" Panel 3 C 4'-8 3/8" GAP B 1'-1" GAP C 1'-1 9/16" Panel 4 B 8-8"
Panel 5 B 8'-7 1/4"
Panel 6 B 8'-8" Panel 4 C 2'-4 1/14" Panel 5 C 8'-8 7/8" C 8'-75/8" Panel 6 Panel 7 B 8'-7 1/2"
Panel 8 B 8'-7 1/2" C 8'-73/8" Panel 7 Panel 8 Panel 9 B 8'-7 1/2" Panel 9 C 8'-7 1/2" C 8'-7 1/4" C 8'-7 11/14 Panel 10 B 8'-8 1/4" Panel 10 B 8'-71/4" Panel 11 8'-7 11/14" Panel 11 Panel 12 B 8'-7 1/4" Panel 12 C 8'-7 3/4" Panel 13 B 8'-4 1/4" Panel 13 C 8'-7 1/2" LIGHT POST B 2'-5 3/4" Panel 14 C 8'-7 1/4" Panel 14 B 1'-7 3/4" Panel 15 C 8'-7 1/2" Panel 15 B 8'-7 1/2" Panel 16 C 9'- 1/2" Panel 17 C 8'-7 1/2" Panel 16 B 8'-7 1/4" Panel 17 B 8'-6 1/2" Panel 18 C 8'-7 7/8" Panel 18 B 8'-8 1/4" Panel 19 C 8'- 73/4" Panel 19 B 8'-8 1/8" Panel 20 C 8'-7 1/4" Panel 20 B 8'-7 3/4" Panel 21 C 8'-7 3/4" Panel 21 B 8' 7 1/2" Panel 22 C 8' 7 3/4" Panel 22 B 8'-5 3/4" Panel 23 C 8'-8" Panel 24 C 8'-7 3/16" Panel 23 B 8'-8 7/8" Panel 24 B 8'-7 1/2" Panel 25 C 8'-7 3/8" Panel 25 B 8'-7 5/8" Panel 26 C 8'-7 1/2" Panel 26 B 8'-7 5/8" Panel 27 C 8'-7 1/2" Panel 27 B 8'-7 1/4"
Panel 28 B 8'-7 1/2" Panel 28 C 2'-6 1/2" GAP C 1'- 15/16" Panel 29 C 4'-4" Panel 30 C 8'-7 1/4" Panel 31 C 6'-9 3/8" Panel 29 B 8'-7 3/4"
Panel 30 B 8'-7 1/2" GAP B 1'-10" Panel 31 B 7'-10 3/8"
Panel 32 B 7'-10" Panel 33 B 7'-10 1/8"

Fence Panel Schedule SIZE D 6'-9 1/2" ITEM Panel 1 Panel 2 8'-7 1/2" Panel 3 D 4'-6 1/4" 1'- 5/8" D 2'-63/4"
D 8'-71/2" Panel 4 Panel 5 Panel 6 D 8'-7 1/2" Panel 7 Panel 8 D 8'-7 1/2" Panel 9 D 8'-7 1/2" D 8'-7 1/2" D 8'7 3/4" Panel 10 Panel 11 Panel 12 D 8'-7 1/8" Panel 13 D 8'-7 3/4"
Panel 14 D 8'-7 1/8" Panel 15 D 8'-8 1/4" Panel 16 D 9'-0" Panel 17 D 8'-7 1/2" Panel 18 D 8'-7 1/4"
Panel 19 D 8'-7 3/4" Panel 20 D 8'-7 3/4" Panel 21 D 8'-7 3/8" Panci 22 D 8'7 1/2" Panel 23 D 8'-7 3/4" Panel 24 D 8'-7" Panel 25 D 8'-7 3/4" Panel 26 D 8'-7 1/2" Panel 27 D 8'-7 3/4" Panel 28 D 2'-4 3/4"
Panel 29 D 4'-8"
Panel 30 D 8'-7 1/2"
Panel 31 D 6'-9 1/2"

B31

PLUM GROVE

SIZE

B33


- 1. ELEVATIONS AND DIMENSIONS SHOWN ARE TAKEN FROM EXISTING FENCE SHOP DRAWINGS. THE CONTRACTOR SHALL FIELD VERIFY ALL DIMENSIONS, COORDINATES, AND EXISTING CONDITIONS PRIOR TO CONSTRUCTION. NOTIFY THE ENGINEER OF ANY DISCREPANCY IMMEDIATELY.
- 2. SUBMIT SHOP DRAWINGS FOR DECORATIVE PANELS AND ALL ASSOCIATED CONNECTIONS FOR REVIEW AND APPROVAL PRIOR TO FABRICATION. ALL SHOP DRAWINGS SHALL BE SIGNED AND SEALED BY AN ILLINOIS LICENSED STRUCTURAL ENGINEER.


DUPAGE COUNTY D.U. OF TRANS
421 COUNTY FARM ROAD WHEATON, IL


COUNTY	USER NAME = \$USER\$	DESIGNED -	JB	REVISED -
FRANS NTY FARM ROAD		DRAWN -	JC	REVISED -
N, IL	PLOT SCALE = \$SCALE\$	CHECKED -	JB	REVISED -
	PLOT DATE = \$DATE\$	DATE -	06/10/2019	REVISED -

STATE OF ILLINOIS
DEPARTMENT OF TRANSPORTATION


	F.A.U. RTE.	SECTION		COUNTY	TOTAL SHEETS	SHEE NO.
FENCE AFFIXMENT DETAILS	345A	14-00245-05-LS		COOK/DUPAGE	37	16
				CONTRA	CT NO.	61E69
		ILLINOIS	FED, AII	D PROJECT		

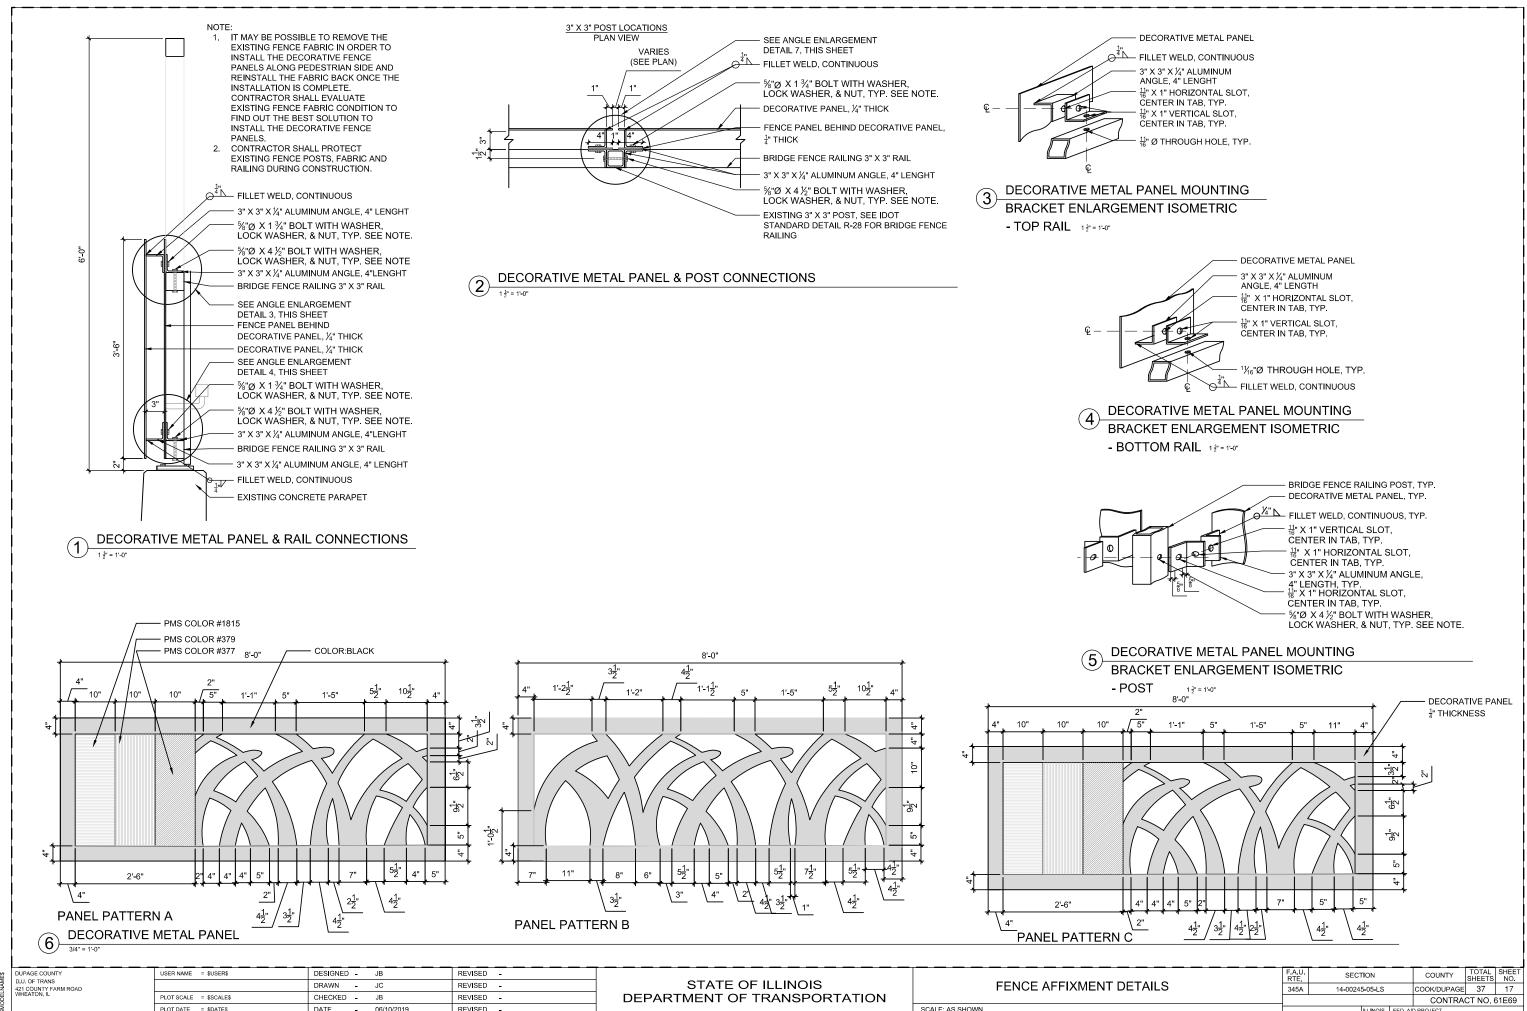


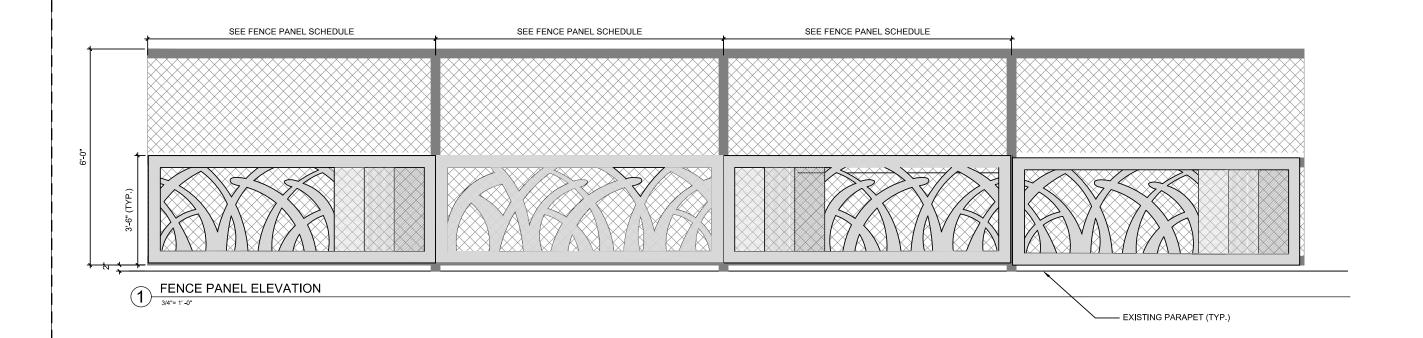

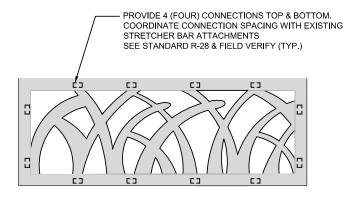

PROVIDE 2 (TWO) CONNECTIONS BOTH SIDES.
COORDINATE CONNECTION SPACING WITH EXISTING STRETCHER BAR ATTACHMENTS SEE STANDARD R-28 & FIELD VERIFY (TYP.)

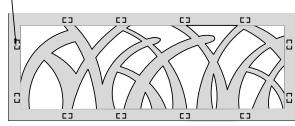

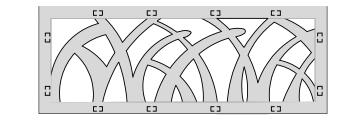

DECORATIVE FENCE PANEL MOUNTING BRACKET SPACING
3/4"= 1"-0"

GENERAL NOTES

- 1. CONTRACTOR SHALL VERIFY EXISTING CONDITIONS WHERE APPLICABLE TO THE WORK, AND SHALL NOTIFY THE ENGINEER OF DISCREPANCIES IN THE FIELD CONDITIONS IN WRITING PRIOR TO FABRICATION OR MOBILIZATION OF WORK FORCE. WRITTEN NOTICE SHALL INCLUDE, BUT NOT BE LIMITED TO, DATE, REFERENCES TO CONSTRUCTION DOCUMENTS, AND CONTRACTOR'S RECOMMENDATION FOR RECTIFYING DISCREPANCIES.
- 2. DRAWINGS DESCRIBE THE DESIGN INTENT FOR FINAL SIZE, APPEARANCE AND CONFIGURATION OF ELEMENTS. CONTRACTOR SHALL PROVIDE, INSTALL AND BE RESPONSIBLE FOR: THE FINAL ENGINEERING OF THE ELEMENTS, CONNECTIONS AND ANCHORAGE SYSTEMS FOR THE ELEMENTS, AND FINAL ASSEMBLY TO ACHIEVE ORIGINAL
- MANUFACTURER WILL PROVIDE DESIGN AND SHOP DRAWINGS OF PANEL ITEMS:
 3.1. INDICATING DIMENSIONS, MATERIALS, FINISHES, FASTENINGS, ANCHORAGE, JOINING, SEALING, BACKING
 - 3.2. INDICATING ALL GRAPHIC ELEMENTS
 - 3.3. ADDITIONAL ELEMENTS REQUIRED TO CLEARLY CONVEY THE FABRICATION AND INSTALLATION REQUIREMENTS
 - 3.4. DESIGN CALCULATIONS
- 4. NO FABRICATION SHALL BEGIN PRIOR TO RECEIVING APPROVAL BY THE ENGINEER.
- 5. CONTRACTOR TO PROVIDE MOCK UP PLAN OF PANEL ASSEMBLIES
- 6. ALL HARDWARE SHALL BE PAINTED TO MATCH COLOR OF THE PAINTED METAL WORK/ GRAPHIC BEING ATTACHED OR AS OTHERWISE INDICATED IN DRAWINGS

- 7. ALL WELDS TO BE GROUND SMOOTH FOR A SEAMLESS APPEARANCE
- 8. APPLY ALL PAINT FINISHES IN STRICT ACCORDANCE WITH MANUFACTURER'S INSTRUCTIONS

GRAPHIC PANEL NOTES:


SCALE: AS SHOWN

- 1. GRAPHICS PANEL SHALL BE THERMAL OR WATER JET CUT 1/4" ALUMINUM PANEL.
- 2. DIGITAL VECTOR GRAPHICS FILE OF ARTWORK CAN BE PROVIDED BY COMMISSIONER AT CONTRACTOR'S
- CONTRACTOR TO SUBMIT SCALED MOCKUP OF GRAPHICS PANEL CONTAINING ALL COLORS TO BE UTILIZED IN FINAL FULL SIZE GRAPHICS FOR APPROVAL PRIOR TO FINAL PRODUCTION. SIZE OF MOCKUP SHALL BE AS APPROVED BY THE ENGINEER.

DUPAGE COUNTY	USER NAME = \$USER\$	DESIGNED - JB	REVISED -
D.U. OF TRANS 421 COUNTY FARM ROAD		DRAWN - JC	REVISED -
WHEATON, IL	PLOT SCALE = \$SCALE\$	CHECKED - JB	REVISED -
	PLOT DATE = \$DATE\$	DATE - 06/10/2019	REVISED -

STATE OF ILLINOIS
DEPARTMENT OF TRANSPORTATION

	F.A.U. RTE.	SECTION	COUNTY	TOTAL SHEETS	SHEET NO.
FENCE AFFIXMENT DETAILS	345A	14-00245-05-LS	COOK/DUPAGE	37	18
			CONTRAC	CT NO. 6	31E69

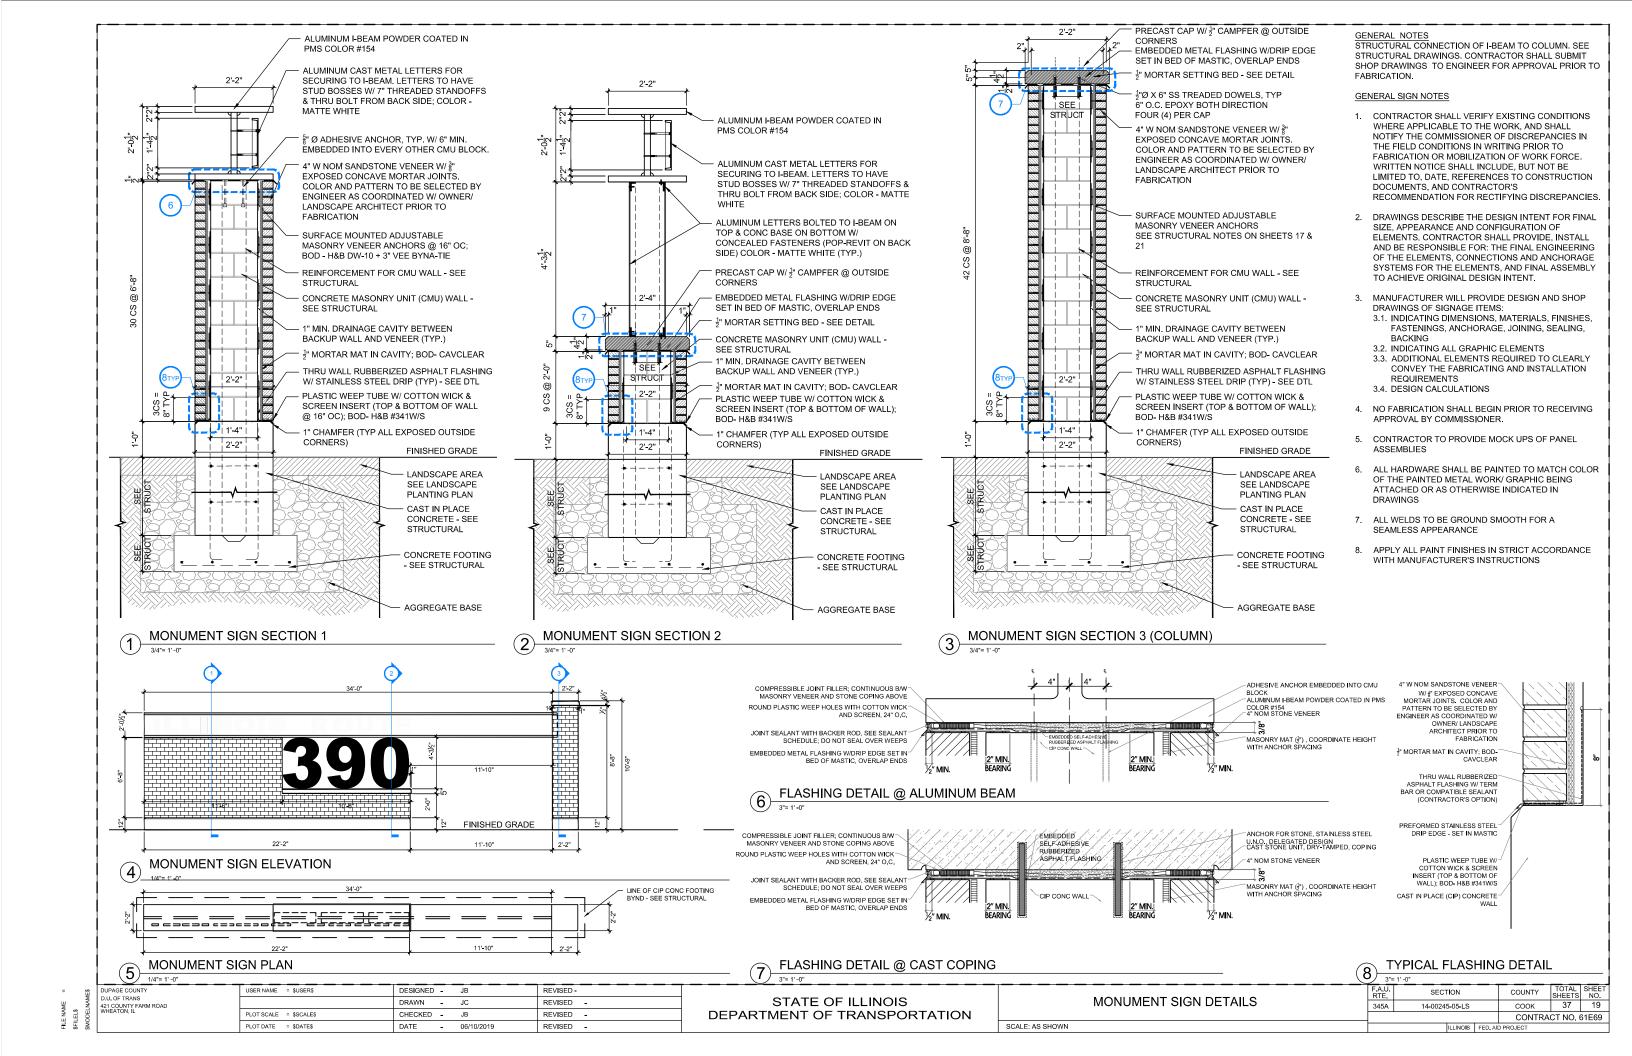

GENERAL NOTES

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///XX//X

typ.

Reinforcement bars shall conform to the requirements ASTM A 706 GR 60. Reinforcement bars designated (E) shall be epoxy coated.

A normal surface finish followed by Concrete Sealer application will be required on concrete surfaces above the lowest elevation 6" below finished ground line.

Anchor studs shall be installed in accordance with article 509.06 of the

Standard Specifications and shall be included in the cost of Concrete Structures.

Steel shapes shall be AASHTO M270 Grade 36 in accordance with article 1006.04 of the Standard Specifications.

Steel shapes, bolts, nuts and washers shall be hot-dipped galvanized in accordance with AASHTO M232 or M111.

Concrete masonry units shall be 8" wide, 14" face shell thickness, ground face block. Limestone veneer to be directly anchored to concrete masonry units. Anchoring with wire ties to the mortar bed will not be permitted. Veneer anchors shall be hot-dipped galvanized. Provide at least one anchor for each 2.67 Sq. Ft. of wall area. Spacing of veneer anchors shall not exceed 32" horizontally and 25" vertically. Contractor shall submit veneer anchoring system to the Engineer for approval. Cost of veneer anchors shall be included with Gateway Monument Sign Complete.

See Gateway Monument Sign Detail on sheet 16 for Aluminum I-Beam, architectural components and details.

10′-8"

★ 8-#5 v(E) bars

5-#5 w(E) bars, top and bottom

See sec. A-A, B-B, C-C and D-D

at 1'-4" cts.

Cost of steel shapes, bolts, nuts, anchors and washers shall be included in the cost of Concrete Structures.

W1.7 ties and hoops to be hot-dipped galvanized. Cost included with Gateway Monument Sign Complete.

┌▶ *A*

2-#4 h3(E) bars, each wythe

8-#5 v1(E) bars at 1'-4" cts.

2-#4 h2(E) bars, each wythe $\rightarrow B$

See sec, A-A and B-B

See sec. A-A and B-B

2-#5 h1(E) bars, each face

See sec. A-A and B-B

23-#5 n(E) bars, each face

at 12" cts.

22'-2"

DESIGN SPECIFICATIONS

ACI 530-11: Building Code Requirements and Specifications for Masonry Structures.

- Aluminum I-Beam

2017 AASHTO LRFD Bridge Design Specifications, 8th Edition.


DESIGN STRESSES

MASONRY UNITS

f'm = 1,500 psi Fb = 500 psi Fs = 32,000 psi n = 21.5

FIELD UNITS

f'c = 3,500 psify = 60,000 psi (Reinforcement)

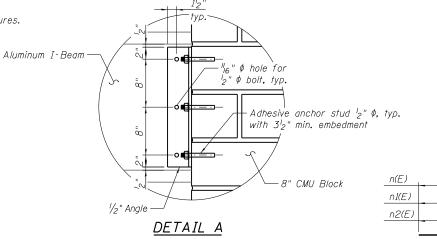

 $\vdash G$

Detail A

8" CMU Block, typ.-

Ground

typ.

 $\downarrow D$

2'-2"

<u>₩ 4-#5 v2(E) bars</u> See sec. F-F

3-#5 s(E) bars at 12" cts.

See sec. D-D

See sec. A-A, B-B, C-C and D-D

3-#5 h(E) bars, each face

11-#5 n1(E) bars, each face

at 12" cts.

11'- 10"

SCALE:

37-#5 t(E) bars


top and bottom at 12" cts.

BARS n(E), n1(E) and n2(E)

5′-0"

3'-3"

5′-8"

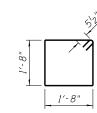

BAR s(E)

** GATEWAY MONUMENT SIGN BILL OF MATERIAL

	Bar	No.	Size	Length	Shape	
	h(E)	6	#5	35′-8"		
	h1(E)	4	#5	21'-8"		
	h2(E)	4	#4	21'-0"		
	h3(E)	4	#4	10'-4"		
	n(E)	46	#5	5′-10"		
	n1(E)	22	#5	4'-1"		
	n2(E)	6	#5	6′-6"		
	s(E)	3	#5	7′-7"	ß	
	t(E)	74	#5	4'-6"		
	v(E)	16	#5	7′-6"		
	v1(E)	16	#5	2'-6"		
	v2(E)	4	#5	9'-2"		
	w(E)	10	#5	35′-8"		
	Ctrusti	re Exc	avation	Cu. Yd.	61.0	
				Cu. Yd.	18.3	
ace		te Struc		Cu. 70.	10.5	
		cement	Buis,	Pound	1,760	
	Epoxy	te Seale	25	Sq. Ft.	171	
		y Monun		34. 11.	17.1	
		y monun. omplete	116/11	Each	1	
	Jigii C	Jilipiere				

GATEWAY MONUMENT SIGN ELEVATION

(Architectural components not shown for clarity)


** Core and set bar according to article 509.06 of the Standard Specifications. Cored holes shall be roughened or scored per manufactures recommendations. Depth of hole shall be 10" minimum. Cost shall be included with Reinforcement Bars, Epoxy Coated.


STATE OF ILLINOIS
DEPARTMENT OF TRANSPORTATION

Ε

3-#5 n2(E) bars, each face

at 10" cts.

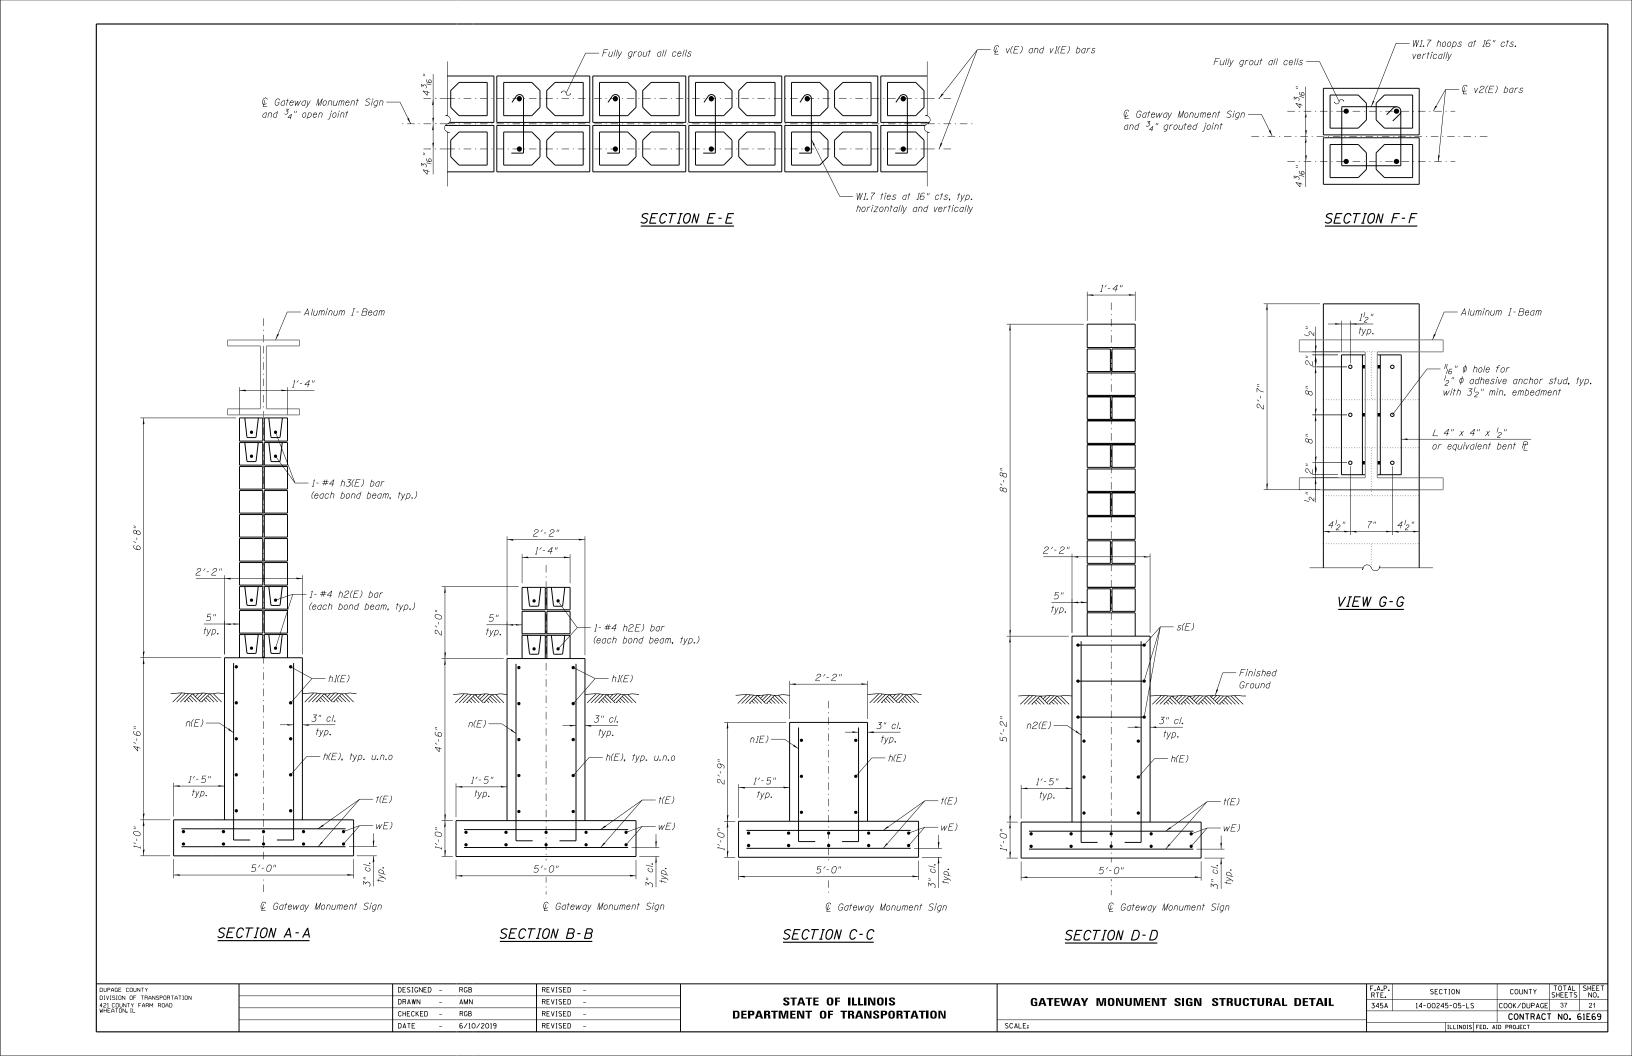

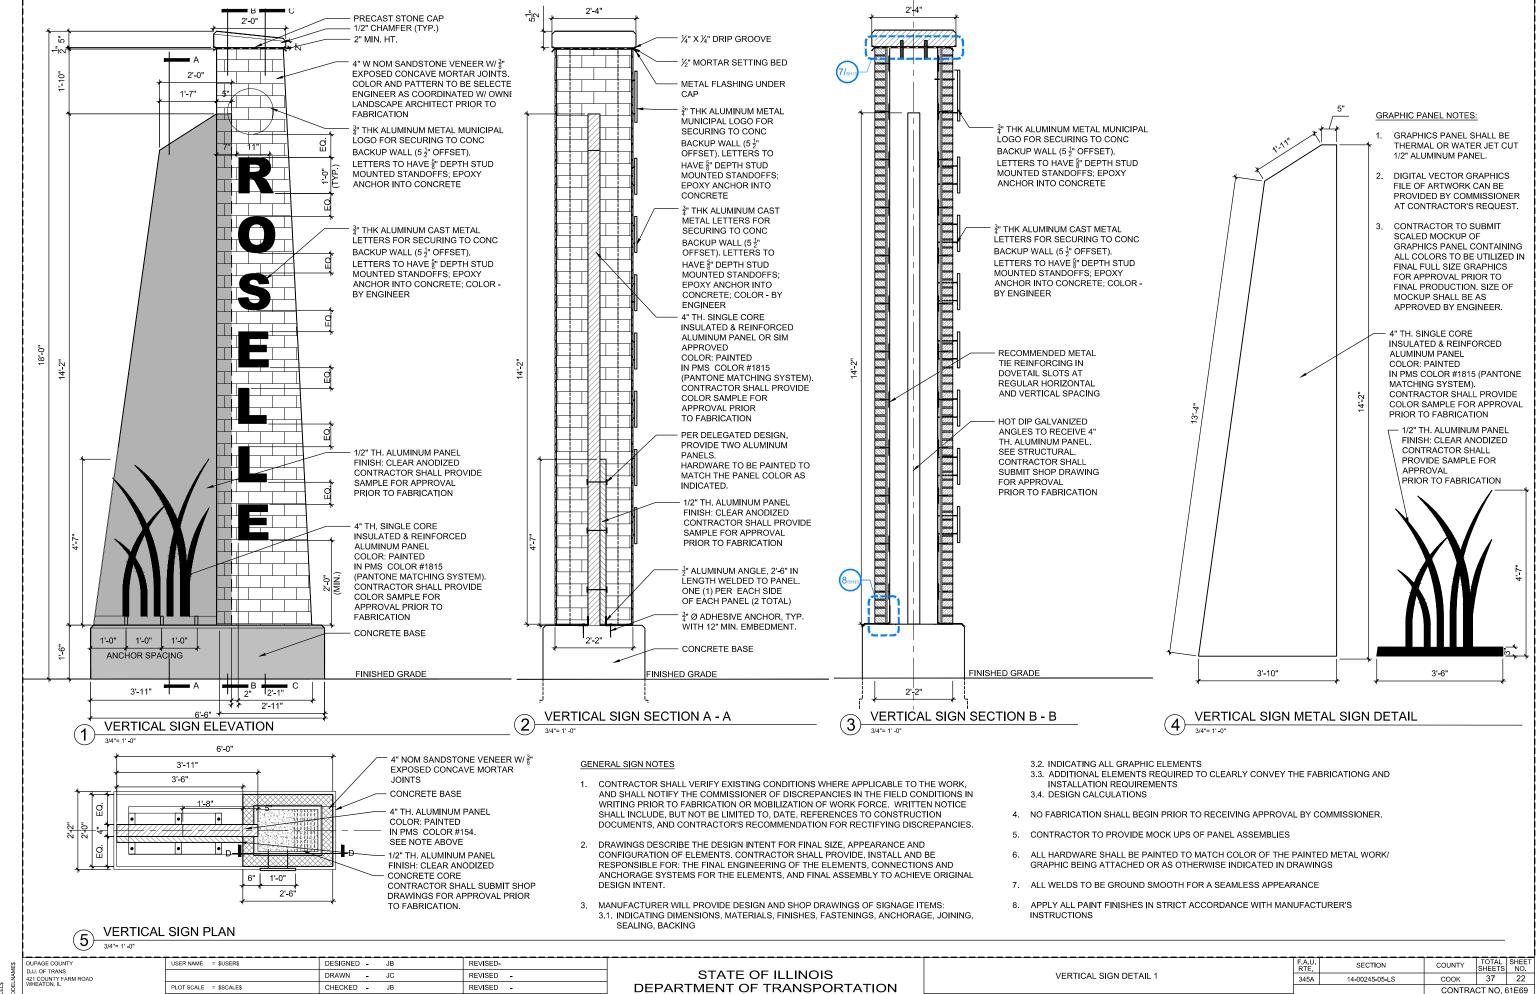


SCALE: AS SHOWN

PLOT DATE = \$DATE\$

06/10/2019

REVISED -

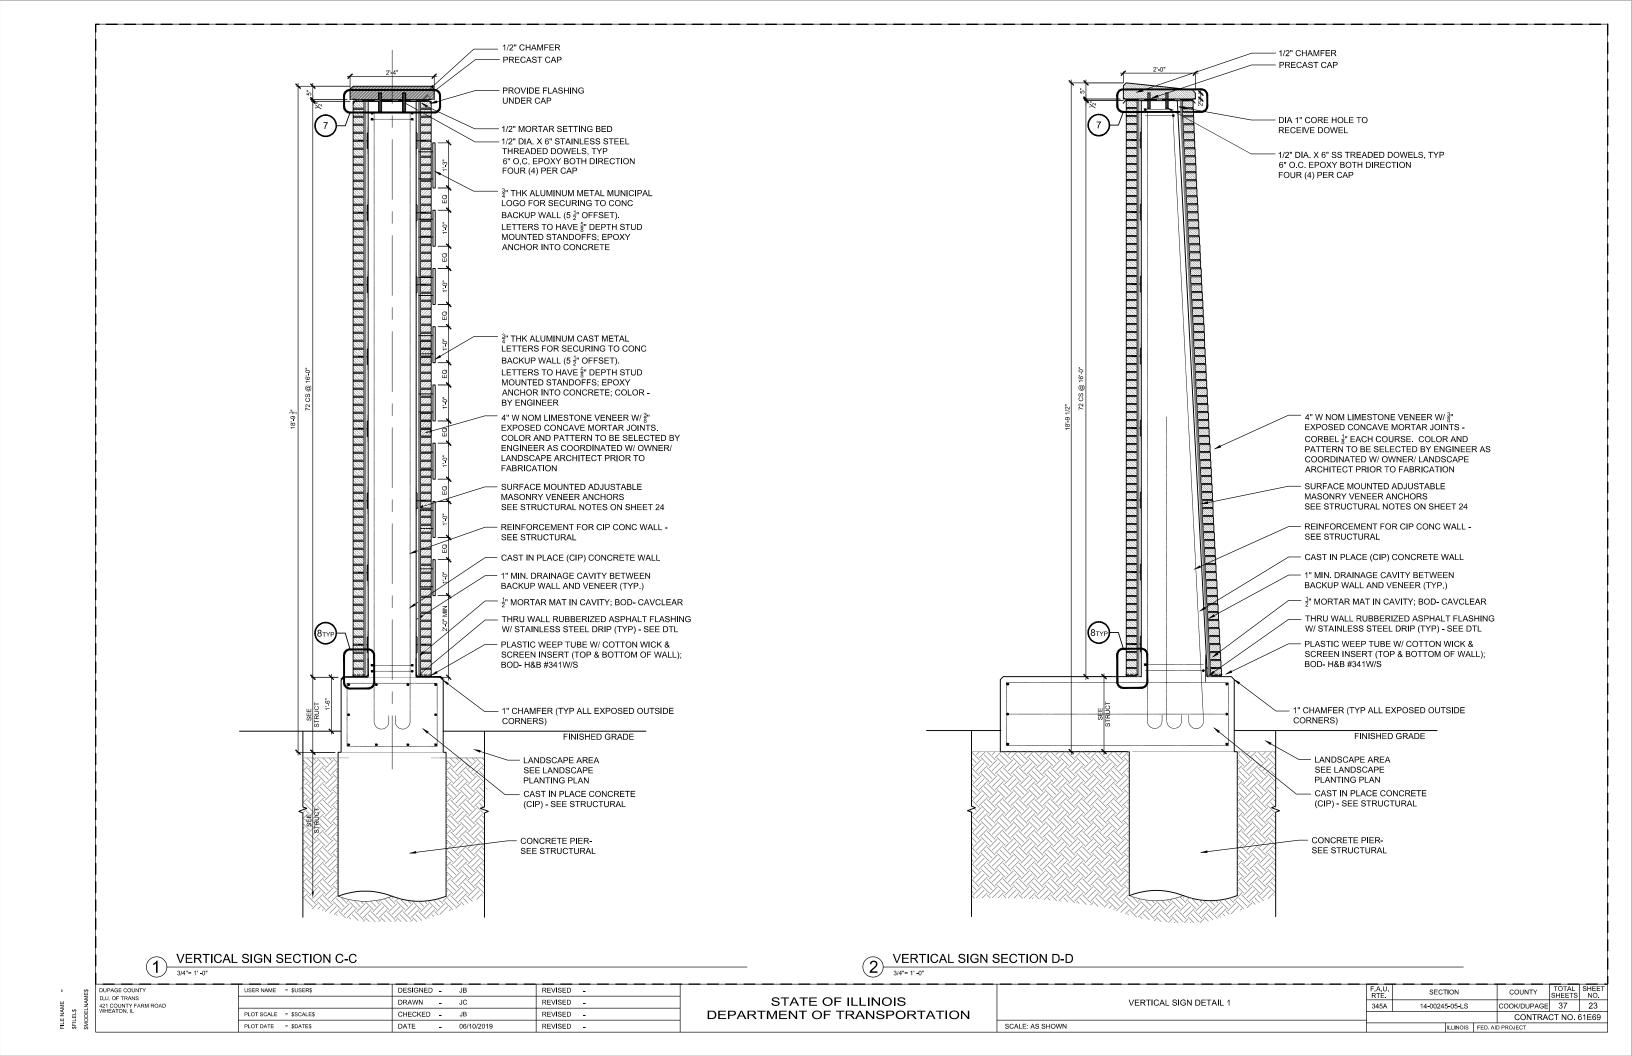

GENERAL NOTES

ı₽E

Reinforcement bars shall conform to the requirements ASTM A 706 GR 60.

s1(E)

1½" cl. typ.

6-#7 v1(E) bars

See sec. A-A and B-B

L 4" x 4" x 1/4"

6'-6" 3'-11"

8-#4 s(E) bars

at 10" cts.

10-#5 h(E) bars

minimum top and bottom.

See sec. D-D

See view E-E

Reinforcement bars designated (E) shall be epoxy coated.

A normal surface finish followed by Concrete Sealer application will be required on concrete surfaces above the lowest elevation 6" below finished ground line. Anchor studs shall be installed in accordance with article 509.06 of the Standard Specifications and shall be included in the cost of Concrete Structures. Steel shapes shall be AASHTO M270 Grade 36 in accordance with article 1006.04 of the Standard Specifications.

Steel shapes, bolts, nuts and washers shall be hot-dipped galvanized in accordance with AASHTO M232 or M111. Limestone veneer to be directly anchored to concrete. Anchoring with wire ties to the mortar bed will not be permitted. Veneer anchors shall be hot-dipped galvanized. Provide at least one anchor for each 2.67 Sq. Ft. of wall area. Spacing of veneer anchors shall not exceed 32" horizontally and 25" vertically. Contractor shall submit veneer anchoring system to the Engineer for approval. Cost of veneer anchors shall be included with Vertical Identifier Sign Complete. See Vertical Identifier Sign Details on sheets 19 and 20 for architectural components and details.

2-#7 v2(E) bars

See sec. B-B

В

10-#9 v(E) bars

See sec. C-C

Cost of steel shapes, bolts, nuts, anchors and washers shall be included in the cost of Concrete Structures.

r D

DESIGN SPECIFICATIONS


2017 AASHTO LRFD Bridge Design Specifications, 8th Edition

DESIGN STRESSES FIELD UNITS

f'c = 3,500 psi fy = 60,000 psi (Reinforcement)




BAR s1(E)

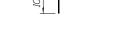


BAR h(E)

2′-6"

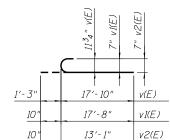

BAR s(E) BARS v(E), v1(E) and v2(E)

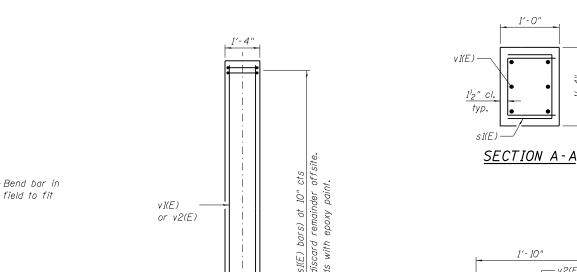


- h(E)

- s(E)


© Vertical Identifier Sign

Finished Ground

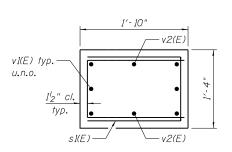

SECTION B-B (Steel plate and anchors not shown for clarity)

SECTION C-C

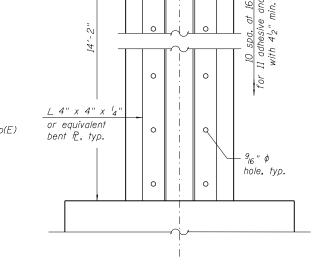

typ.

* VERTICAL IDENTIFIER SIGN BILL OF MATERIAL

	Bar	No.	Size	Length	Shape
	h(E)	10	#5	7′-8"	
	s(E)	8	#4	9′-9"	<u>.</u>
	s1(E)	40	#4	4'-3"	
**	sp(E)	1	#4	<i>15′-11</i> "	^
	v(E)	10	#9	19'-1"	
	v1(E)	6	#7	18′-6"	
	v2(E)	2	#7	13′-11"	
	Structu	ire Exc	avation	Cu. Yd.	5.0
	Concre	te Struc	ctures	Cu. Yd.	3.0
	Reinfor Epoxy	cement Coated	Bars,	Pound	1,380
	Drilled	Shaft i.	n Soil	Cu. Yd.	4.2
	Concre	te Seale	er	Sq. Ft.	134
		l Identii omplete	fier	Each	1

* Quantities shown are for one vertical identifier. ** Length is height of spiral.

#4 sp(E) spiral Provide 3 hoops Extend spiral 2" into footing. 3'-0" Dia.

VERTICAL IDENTIFIER

(Architectural components not shown for clarity)

SECTION D-D

3'-0"

10" typ.

(Bars v(E) and sp(E) not shown for clarity)


DUPAGE COUNTY	DESIGNED	-	RGB	REVISED -	
DIVISION OF TRANSPORTATION 421 COUNTY FARM ROAD	DRAWN	-	AMN	REVISED -	
WHEATON, IL	CHECKED	-	RGB	REVISED -	
	DATE	-	6/10/2019	REVISED -	ı

STATE OF ILLINOIS **DEPARTMENT OF TRANSPORTATION**


	VERTICAL	IDENTIFIER	SIGN	STRUCTURAL	DETAIL
CALE.					

VIEW E-E

	ILLINOIS F	ED. AI	D PROJECT		
			CONTRACT	NO. 6	51E69
345A	14-00245-05-LS		COOK/DUPAGE	37	24
F.A.P. RTE.	SECTION		COUNTY	TOTAL SHEETS	SHEET NO.

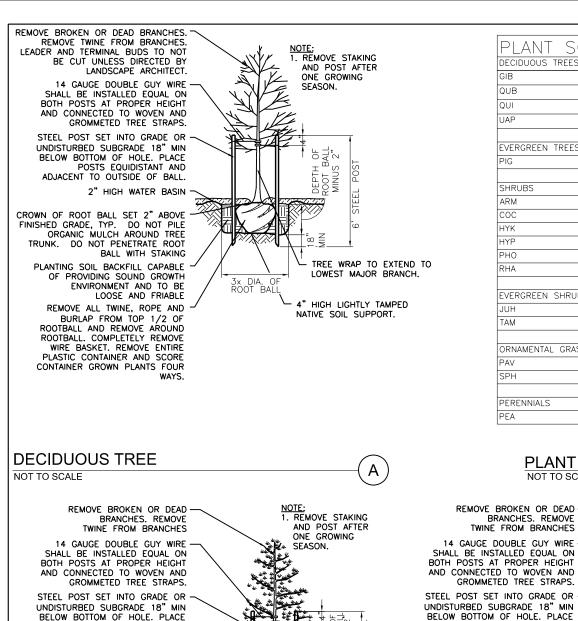



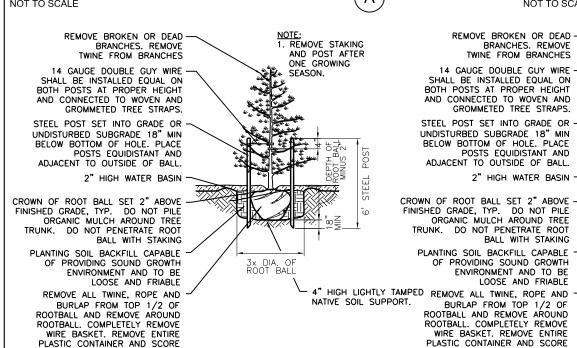

CONTAINER GROWN PLANTS FOUR

EVERGREEN TREE

NOT TO SCALE

DUPAGE COUNTY

IVISION OF TRANSPORTATION

421 COUNTY FARM ROAD WHEATON, IL



POSTS EQUIDISTANT AND

2" HIGH WATER BASIN

BALL WITH STAKING

LOOSE AND FRIABLE

ADJACENT TO OUTSIDE OF BALL.

ORGANIC MULCH AROUND TREE

PLANTING SOIL BACKFILL CAPABLE

OF PROVIDING SOUND GROWTH

DO NOT PENETRATE ROOT

ENVIRONMENT AND TO BE

BURLAP FROM TOP 1/2 OF

ROOTBALL AND REMOVE AROUND

ROOTBALL COMPLETELY REMOVE

PLASTIC CONTAINER AND SCORE

CONTAINER GROWN PLANTS FOUR

WIRE BASKET, REMOVE ENTIRE

1. REMOVE STAKING

ONE GROWING

SEASON.

3x DIA, OF


ROOT BALL

AND POST AFTER

1. SEE PLANT SCHEDULE FOR SIZES OF ROOTBALL (X). 2. WEED BARRIER TO NOT BE USED IN MULCH BEDS. 3. PERIMETER OF ORGANIC MULCH PLANT BED TO RECEIVE SPADED EDGE.

SCALE: NTS

ALL BROKEN BRANCHES, STUBS, AND IMPROPER CUTS OF FORMER

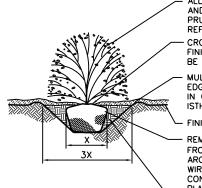


REFER TO ISTHA SPECIFICATIONS. CROWN OF ROOTBALL TO BE 2" ABOVE FINISHED GRADE. TRUNK FLARE SHOULD BE VISIBLE AT TOP OF ROOTBALL

MULCH LAYER IN SAUCER SHAPE AROUND EDGE OF HOLE. DO NOT PLACE MULCH IN CONTACT WITH SHRUB. REFER TO ISTHA SPECIFICATIONS FOR MULCH DEPTH

FINISHED GRADE

REMOVE ALL TWINE, ROPE AND BURLAP FROM TOP 1/2 OF ROOTBALL AND REMOVE AROUND ROOTBALL, COMPLETELY REMOVE WIRE BASKET, REMOVE ENTIRE PLASTIC CONTAINER AND SCORE CONTAINER GROWN PLANTS FOUR WAYS

PLANTING SOIL BACKFILL CAPABLE OF PROVIDING SOUND GROWTH ENVIRONMENT AND TO BE LOOSE AND FRIABLE

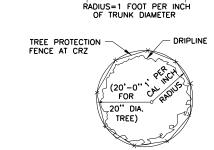

DRIPLINE (VARIES)

FENCE LOCATION

(LIMITS OF CRITICAL

ROOT ZONE)

В

F

CHAIN LINK FENCE.

TREE PRESERVATION DETAIL

Ε

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4" HIGH LIGHTLY

TAMPED NATIVE

SOIL SUPPORT.

JΒ SCALE

EVERGREEN TREE ON SLOPE NOT TO SCALE

DESIGNED - AS REVISED ORAWN RR REVISED

REVISED

REVISED

CHECKED

6/10/2019

DATE

STATE OF ILLINOIS **DEPARTMENT OF TRANSPORTATION**

PLANTING DETAILS	F.A.P. RTE.	SECTION	COUNTY	TOTAL SHEETS	SHEET NO.
AND SCHEDULE	345A	14-00245-05-LS	COOK/DUPAGE	37	25
AND SCHEDOLL			CONTRACT	NO. (61E69
		ILLINOIS FED. A	D PROJECT		



FL₁₀

Solar Sign Light System



This sign light system is supplied with one light fixture offered in 5W, 10W, 20W, or 30W. Increasing the power (Wattage) of the light fixture increases the light spread, as well as the light intensity. Each light fixture is capable of illuminating signs with the dimensions as


5W: Up to 8' x 8' 10W: Up to 12' x 10'

20W: Up to 14' x 12' 30W: Up to 18' x 12'

The above sign dimensions are based on the light fixture mounted approx. 6' from

Illumination time is up to 8 hours, or dusk to dawn. Additional illumination times are available upon request.

Color Temperature	5700k	Waterproof Rating	IP65
CRI	>70	LED Brand	LUMILEDS
Input Power	5W, 10W, 20W or 30W	LED Type	LUXEON 3030 2D
Lumens	5W 665 Im	Cable Length	20'
	10W 1330 lm	PF	>0.9
	20W 2660 Im	Housing	Aluminum, PC, Steel
	30W 3990 Im	Housing Color	Brown / Bronze
Viewing Angle	7H7V	Operating Temperature	-4° to 113°F
Input Voltage	24V DC	Safety Certification	UL, CUL, DLC
Driver Model	Meanwell		- Vicensia (IV)

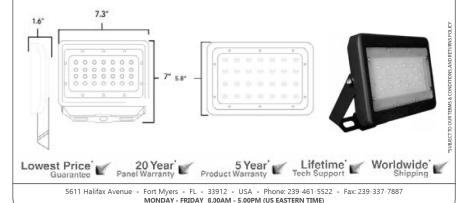

www.solarilluminations.com • sales@solarilluminations.com



MC4 Connector

FL₁₀

Solar Sign Light System

Solar Panel

Systems are supplied with high quality monocrystalline or polycrystalline solar panels with the highest performance and efficiency. They are designed to endure the harshest environments, and are guaranteed to provide power for well over 20 years. Typically manufactured in the USA, Canada, or Germany. The solar panel power is subject to LED consumption, installation location, and illumination period. Please consult with our engineers for specific details and solar power recommendations.

Photovoltaic Module

- Highly efficient monocrystalline or polycrystalline solar panel with aluminum frame, anti-aging, and encapsulated membrane.
- Anti-reflective and anti-soiling surface that reduces power losses from dirt and dust
- Certified to withstand high wind loads (340PSI) and snow loads (780PSI); and resistance to high salt and ammonia.
- Manufactured to international standards, verified and certified by
- independent testing laboratories. (UL, ETL, IEC, MCS, & TUV)
- Assembled to strict quality control standards; international standards ISO 9001 and ISO 14001
- Range of solar panel power avalible from 45W to +500W.
- The solar panel power is subject to LED consumption, installation location, and illumination period. Please consult our engineers for specific solar power requirements.
- Solar panels can be supplied in a single or dual format (2 x 70W = 140W 2 x 100W = 200W etc.)
- Typical solar panel life is over 30 years, subject to environmental
- 45W panel dimensions: 34.25" x 20.13" x 1.5"
- 70W panel dimensions: 32 35" x 26 22" x 1 5"
- 90W panel dimensions: 40.25" x 26.25" x 1.5" 100W panel dimensions: 47.87" x 26.43" x 1.5"
- 140W panel dimensions: 44" x 38.7" x 1.5" (or may be supplied as two
- 240W panel dimensions: 64.38" x 39" 1.5"
- 280W panel consists of two 140W panels











Lowest Price 20 Year 5 Year Lifetime Guarantee Panel Warranty Product Warranty Lifetime MONDAY - FRIDAY 8.00AM - 5.00PM (US EASTERN TIME) www.solarilluminations.com • sales@solarilluminations.com



FL₁₀

Solar Sign Light System





"EastPenn batteries are engineered and tested to provide reliable, long-lasting power for Photovoltaic (PV) and renewable energy applications where frequent deep cycles are required and minimum maintenance is desirable."



Battery · Manufactured by: East Penn Manufacturing Co. Inc.

- 100% made in the USA
- System supplied standard with two 12 Volt batteries. Batteries are wired in series to make a 24 Volt system
- Available battery capacities range from 12Ah to 245Ah (per battery).
- Choice of two battery types: Absorbed Glass Mat (AGM) or Gel Cell.
- Please consult our engineers for specific battery capacity requirements.
- Classified as Non-spillable (defined by DOT, ICAO and IATA),
- NonHAZMAT, and valve regulate.
- Conforms to ISO9001, ISO/TS 16949, and ISO14001 standards.
- Typical battery life is approximately 5 to 7 years, subject to

VRLA Technology

VRLA batteries are maintenance free for life. VRLA stands for Valve Regulated Lead Acid, which means the batteries are sealed. Gas will only escape through the safety valves in the case of overcharging or cell failure.

AGM and Gel batteries have exceptional discharge recovery, even after deep or prolonged discharge. However, it should be noted that repetitive deep discharge and prolonged deep discharge have a negative influence on the service life of all lead acid batteries.

Gel batteries in general have a longer service life and better cycle capacity than

Please Note: The rated capacity of our AGM or gel deep cycle batteries refer to 20 hour discharge rate (i.e. 0.05CA). Most products actually operate near, or at a 100 hour discharge rate (i.e. 0.01CA) and thus actual available battery capacity is slightly higher than the advertised rate.

and thus actual available battery capacity is slightly higher than the advertised rate.

The total available battery power is measured in watt-hour (Wh) or V*Ah. When comparing our total battery capacity with competitor's, please note that the battery capacity from a 12V system is not interchangeable with the battery capacity of a 24V system. However, the total battery power (i.e. watt-hours) is always comparable provided the correct system voltage is considered during






5611 Halifax Avenue • Fort Myers • FL • 33912 • USA • Phone: 239-461-5522 • Fax: 239-337-7887 MONDAY - FRIDAY 8.00AM - 5.00PM (US EASTERN TIME)


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		1						_
DUPAGE COUNTY			DESIGNED	-	AS	REVISED	-	
	DIVISION OF TRANSPORTATION 421 COUNTY FARM ROAD		DRAWN	-	RR	REVISED	-	
WHEATON, IL	WHEATON, IL		CHECKED	-	EN	REVISED	-	
			DATE	-	6/10/2019	REVISED	-	

STATE OF ILLINOIS **DEPARTMENT OF TRANSPORTATION**

SECTION COUNTY LIGHTING DETAIL COOK/DUPAGE 37 26 345A 14-00245-05-LS CONTRACT NO. 61E69 SCALE: NTS



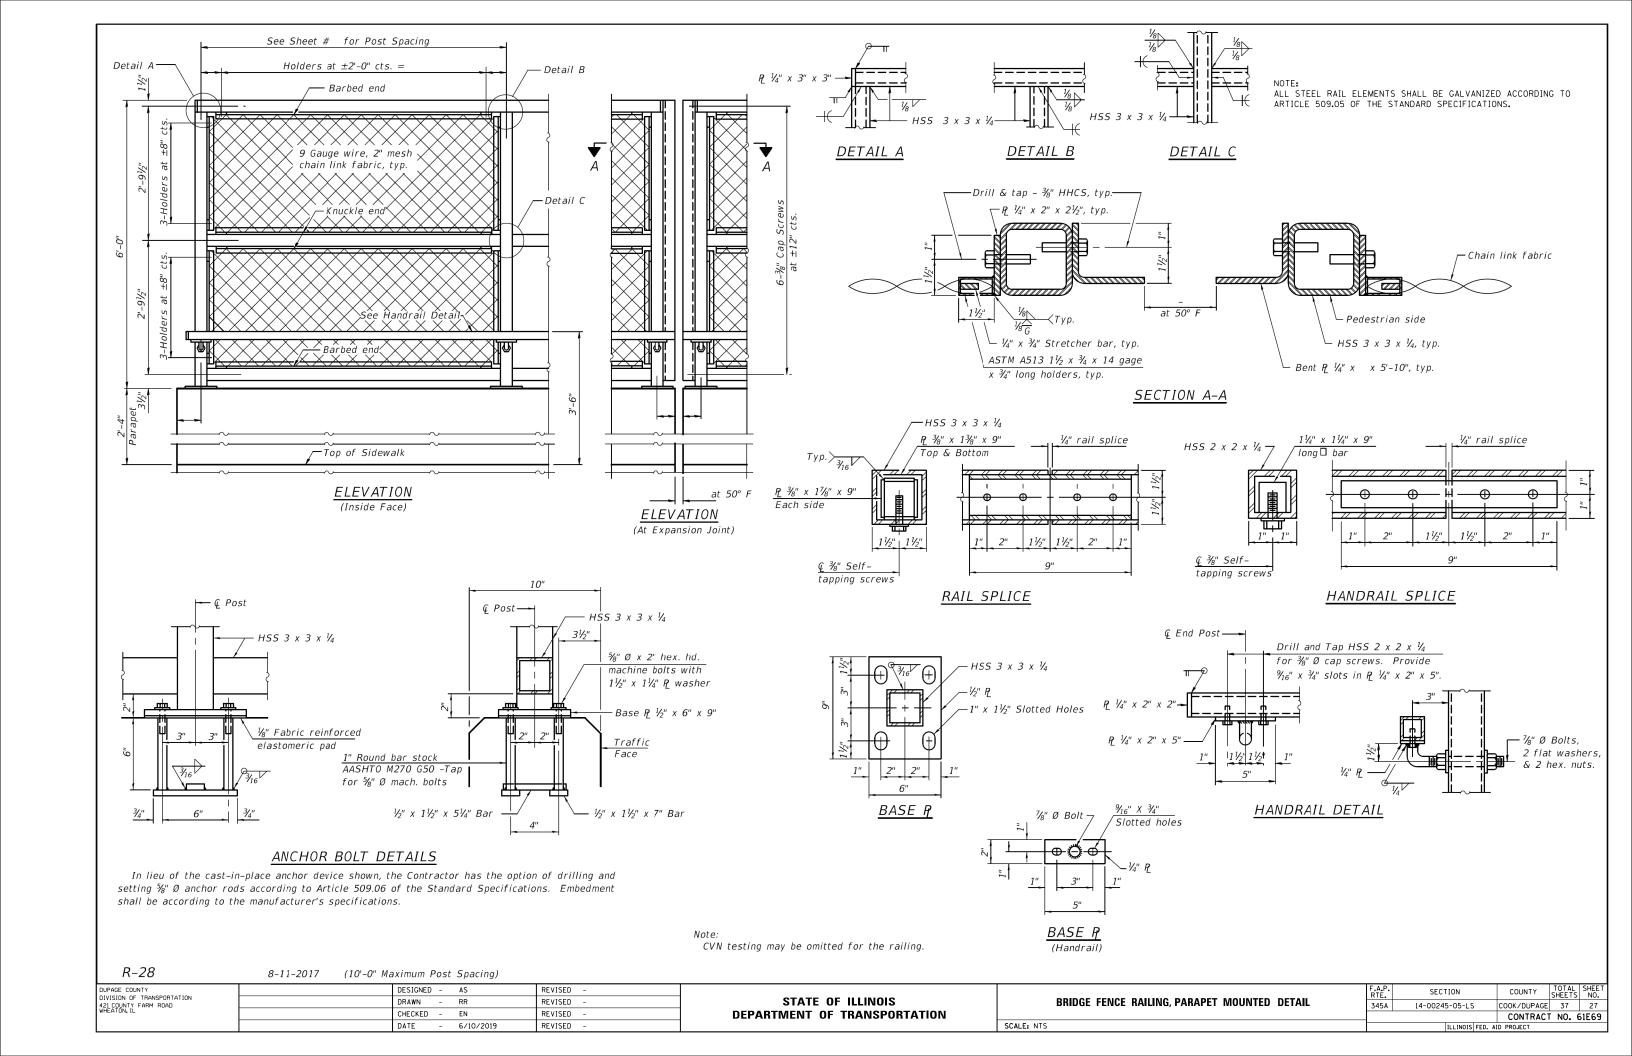

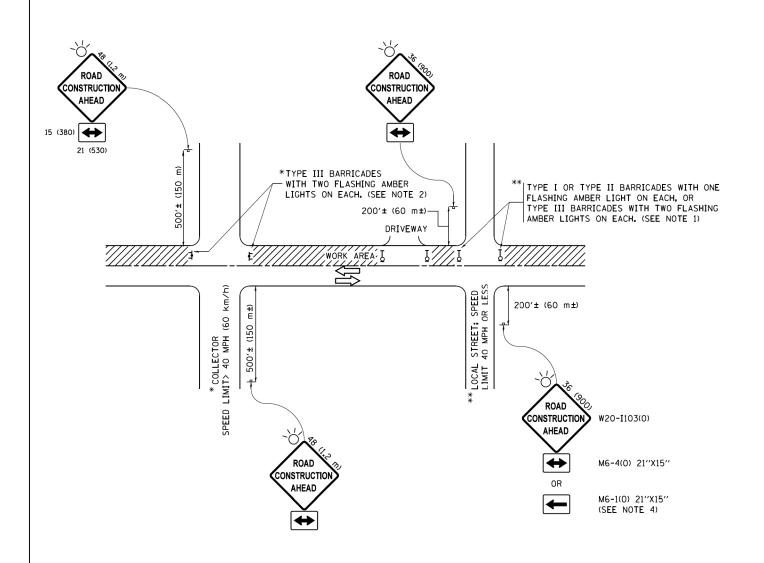NOTES:

- 1. SIDE ROAD WITH A SPEED LIMIT OF 40 MPH (60 km/h) OR LESS AS SHOWN ON THE DRAWING AND AS DIRECTED BY THE ENGINEER:
 - a) ONE "ROAD CONSTRUCTION AHEAD" SIGN 36 x 36 (900x900) WITH A FLASHER MOUNTED ON IT APPROXIMATELY 200" (60 m) IN ADVANCE OF THE MAIN ROUTE.
 - b) THE CLOSED PORTION OF THE MAIN ROUTE SHALL BE PROTECTED BY BLOCKING WITH TYPE I, TYPE II OR TYPE III BARRICADES, 1/3 OF THE CROSS SECTION OF THE CLOSED PORTION.
- 2. SIDE ROAD WITH A SPEED LIMIT GREATER THAN 40 MPH (60 km/h) AS SHOWN ON THE DRAWING AND AS DIRECTED BY THE ENGINEER:
 - a) ONE "ROAD CONSTRUCTION AHEAD" SIGN 48 \times 48 (1.2 m \times 1.2 m) WITH A FLASHER MOUNTED ON IT APPROXIMATELY 500" (150 m) IN ADVANCE OF THE MAIN ROUTE.
 - b) THE CLOSED PORTION OF THE MAIN ROUTE SHALL BE PROTECTED BY BLOCKING WITH TYPE III BARRICADES, 1/2 OF THE CROSS SECTION OF THE CLOSED PORTION.
- 3. CONES MAY BE SUBSTITUTED FOR BARRICADES OR DRUMS AT HALF THE SPACING DURING DAY OPERATIONS. CONES SHALL BE A MINIMUM OF 28 (710)
- 4. WHEN THE SIDE ROAD LIES BETWEEN THE BEGINNING OF THE MAINLINE SIGNING AND THE WORK ZONE, A SINGLE HEADED ARROW (M6-1) SHALL BE USED IN LIEU OF THE DOUBLE HEADED ARROW (M6-4).

SCALE: NONE

- 5. WHEN WORK IS BEING PERFORMED ON A SIDE ROAD OR DRIVEWAY, FOLLOW THE APPLICABLE STANDARD(S). THE DIRECTIONAL ARROW (M6-1 OR M6-4) SHALL BE COVERED OR REMOVED WHEN NO LONGER CONSISTENT WITH THE TRAFFIC CONTROL SET-UP.
- 6. ADVANCE WARNING SIGNS ARE TO BE OMITTED ON DRIVEWAYS UNLESS OTHERWISE SPECIFIED IN THE PLANS OR BY THE ENGINEER
- 7. THE TRAFFIC CONTROL AND PROTECTION FOR SIDE ROADS, INTERSECTIONS, AND DRIVEWAYS SHALL BE INCLUDED IN THE COST OF SPECIFIED TRAFFIC CONTROL STANDARDS OR ITEMS.

All dimensions are in inches (millimeters) unless otherwise shown.

FILE NAME =	USER NAME = footemj	DESIGNED - L.H.A.	REVISED	- A. HOUSEH 10-15-96
pw:\\ILØ84EBIDINTEG.:ll:no:s.gov:PWIDOT\Do	cuments\IDOT Offices\District 1\Projects\Dist	St ORAWM \CADD o to\CADsheets\tc10.dgn	REVISED	-T. RAMMACHER 01-06-00
	PLOT SCALE = 50.000 '/ in.	CHECKED -	REVISED	- A. SCHUETZE 07-01-13
Default	PLOT DATE = 9/15/2016	DATE - 06-89	REVISED	- A. SCHUETZE 09-15-16

STATI	E OF	ILLINOIS
DEPARTMENT	OF	TRANSPORTATION

TRAFFIC CONTROL AND PRO	F.A.U. RTE.	SECTION		
SIDE ROADS, INTERSECTIONS,	345	14-00245-05-LS		
SIDE HOADS, INTERSECTIONS, I		TC-10	(
SHEET 1 OF 1 SHEETS S	STA. TO STA.		TILINOIS FED. AT	n

TURN BAY ENTRANCE AT START OF LANE CLOSURE TAPER

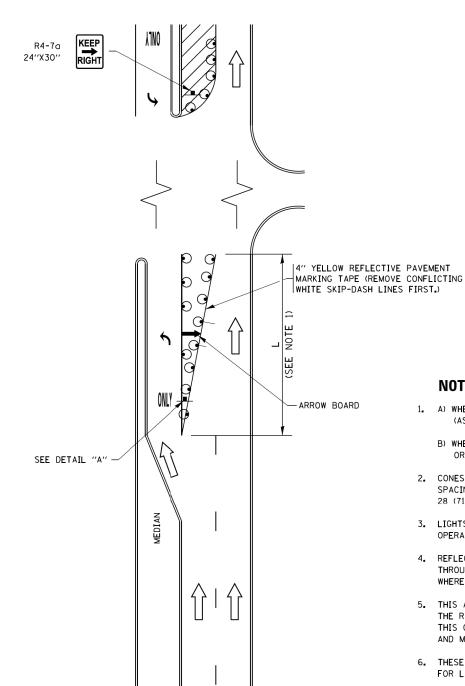



FIGURE 1

LEGEND WORK AREA LANE OPEN TO TRAFFIC ARROW BOARD TYPE I OR II BARRICADE OR DRUM WITH STEADY BURN LIGHT DRUM WITH STEADY BURN LIGHT SIGN ASSEMBLY TYPE I OR II CHECK BARRICADE WITH FLASHING LIGHT

NOTES:

- 1. A) WHEN "L" IS ≤ THE STORAGE LENGTH OF THE TURN LANE (AS SHOWN IN FIG. 1), USE FIGURE 1.
 - B) WHEN "L" IS > THE STORAGE LENGTH OF THE TURN LANE OR THE TURN LANE IS WITHIN THE LANE CLOSURE, USE FIGURE 2.
- 2. CONES MAY BE SUBSTITUTED FOR BARRICADES OR DRUMS AT HALF THE SPACING DURING DAY OPERATIONS. CONES SHALL BE A MINIMUM OF 28 (710) IN HEIGHT.
- 3. LIGHTS WILL NOT BE REQUIRED ON BARRICADES OR DRUMS FOR DAY OPERATIONS. ALL LIGHTS SHALL BE MONODIRECTIONAL.
- 4. REFLECTIVE TEMPORARY PAVEMENT MARKINGS SHALL BE PLACED THROUGHOUT THE BARRICADED AREAS OF EACH TURN BAY AS SHOWN WHERE THE CLOSURE TIME IS GREATER THAN FOURTEEN (14) DAYS.
- 5. THIS APPLICATION ALSO APPLIES WHEN WORK IS BEING PERFORMED IN THE RIGHT LANE(S) AND THE RIGHT TURN BAY IS TO REMAIN OPEN. UNDER THIS CONDITION, "RIGHT TURN LANE" R3-I100R 24 x 24 (600 x 600) AND M6-2R 21 x 15 (530 x 380) SHALL BE USED.
- 6. THESE CONTROLS SHALL SUPPLEMENT MAINLINE TRAFFIC CONTROL FOR LANE CLOSURES.
- 7. THE SIGNS SHALL BE MOUNTED ABOVE THE BARRICADES/DRUMS ON SEPARATE SIGN SUPPORTS THAT MEET NCHRP 350 OR MASH PREQUIREMENTS.
- 8. TRAFFIC CONTROL AND PROTECTION AT TURN BAYS (TO REMAIN OPEN TO TRAFFIC) SHALL BE INCLUDED IN THE COST OF SPECIFIED TRAFFIC CONTROL STANDARDS OR ITEMS.

TURN BAY ENTRANCE WITHIN A LANE CLOSURE

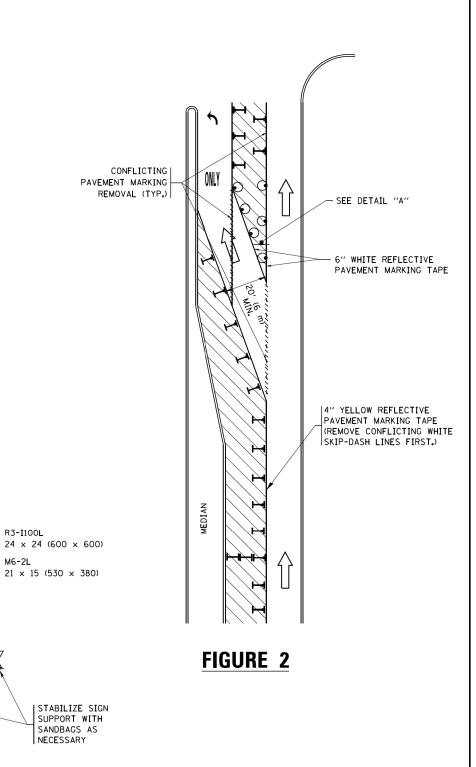

DETAIL A

LANE


All dimensions are in inches (millimeters) unless otherwise shown.

FILE NAME =	USER NAME = footemj	KE AT 2 FD	-1.	RAMMACHER	09-08-94	KENIZED	-	K. BOKO	09-14-09
pw:\\IL084EBIDINTEG.:ll1no1s.gov:PWIDOT\Do	cuments\IDOT Offices\District 1\Projects\Dist	A OBENISEO	DData	/CAADsH HOUSEH	14 1∤- 07-95	REVISED	- A.	SCHUETZ	E 07-01-13
	PLOT SCALE = 50.0000 '/ in.	REVISED	-	A. HOUSEH	10-12-96	REVISED	- A.	SCHUETZ	E 09-15-16
Default	PLOT DATE = 9/15/2016	REVISED	-T.	RAMMACHER	01-06-00	REVISED	-		

STATE OF ILLINOIS **DEPARTMENT OF TRANSPORTATION**

TRAFI	FIC CONT	ROL AND	PROTECTION	AT TURN BAYS				
	(TO REMAIN OPEN TO TRAFFIC)							
SCALE: NONE	SHEET 1	OF 1	SHEETS STA.	TO STA.				

TOTAL SHEET NO. 37 29 SECTION COUNTY СООК 14-00245-05-LS TC-14 CONTRACT NO. 61E69

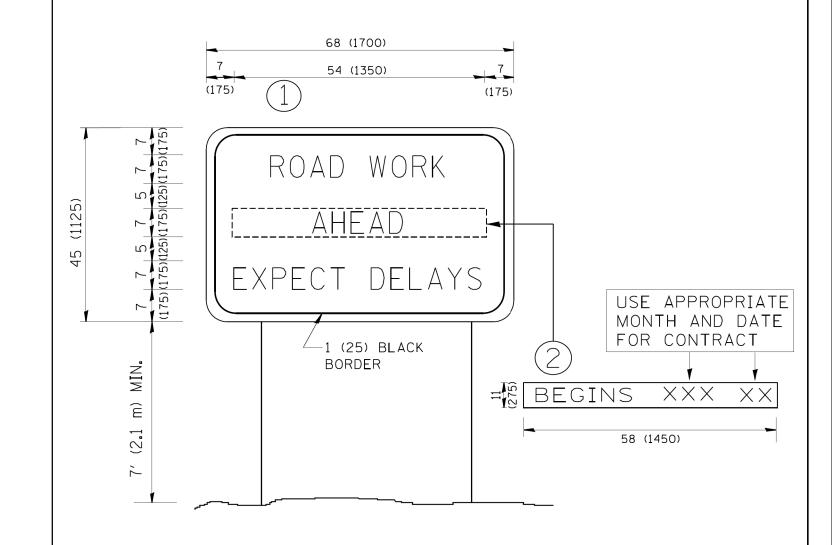


NOTES:

- 1. USE BLACK LETTERING ON ORANGE BACKGROUND.
- 2. ERECT SIGNS IN ADVANCE OF THE LOCATION FOR THE "ROAD CONSTRUCTION AHEAD" SIGN AT LOCATIONS AS DIRECTED BY THE ENGINEER.
- 3. ERECT SIGN () WITH INSTALLED PANEL (2) ONE WEEK PRIOR TO THE START OF CONSTRUCTION.
- 4. REMOVE PANEL (2) SOON AFTER THE START OF CONSTRUCTION.
- 5. SEE SPECIAL PROVISION FOR "TEMPORARY INFORMATION SIGNING" FOR ADDITIONAL INFORMATION.
- 6. ONE SIGN ASSEMBLY EQUALS 25.70 SQ. FT. (2.3 SQ. M.)
- 7. SHALL BE PAID FOR AS TEMPORARY INFORMATION SIGNING.

ALL DIMENSIONS ARE IN INCHES (MILLIMETERS) UNLESS OTHERWISE SHOWN.

FILE NAME =	USER NAME = gaglianobt	DESIGNED -	REVISED - R. MIRS 09-15-97		ARTERIAL ROAD	F.A. U. SECTION	COUNTY TOTAL SHEET
W:\diststd\22x34\tc22.dgn		DRAWN -	REVISED - R. MIRS 12-11-97	STATE OF ILLINOIS		345 14-00245-05-LS	COOK 37 30
	PLOT SCALE = 50.000 '/ IN.	CHECKED -	REVISED -T. RAMMACHER 02-02-99	DEPARTMENT OF TRANSPORTATION	INFORMATION SIGN	TC-22	CONTRACT NO. 61E69
	PLOT DATE = 1/4/2008	DATE -	REVISED - C. JUCIUS 01-31-07		SCALE: NONE SHEET NO. 1 OF 1 SHEETS STA. TO STA.	FED. ROAD DIST. NO. 1 ILLINOIS FED.	

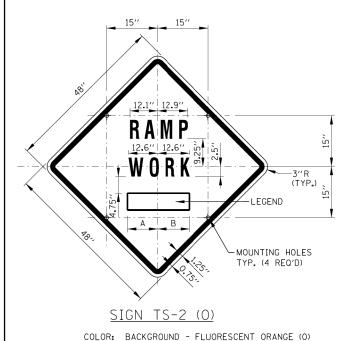

BORDER AND SYMBOL - BLACK


7" FEDERAL SERIES D

MOUNTING HOLES: $\frac{7}{16}$ " DIA., 4 HOLES SPACED AS SHOWN

SIZE: 48"×48"

LETTERING:

SIGN NO. LEGEND TS-2A AHEAD 15.50 15.50' 500 FT 14.25" 15.13" TS-2B TS-2C 15.75" *L*2 1000 FT | 14.88" L2 15.75" L2 15.75" L3 TS-2D 1500 FT 14.88" L2 15.75" \(\alpha\)
1 MILE | 15.75" \(\alpha\)
1 MILE | 13.06" TS-2E TS-2F 13.06"

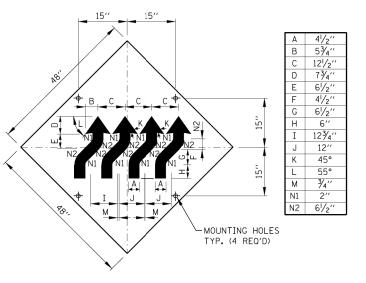

24" SUPPLEMENTAL PLATE (0)

6.75"

COLOR: BACKGROUND - FLUORESCENT ORANGE (O) BORDER AND LETTTERS - BLACK SIZE: 24"×18"


LETTERING: 4" FEDERAL SERIES D MOUNTING HOLES: 1/6" DIA., 2 HOLES SPACED AS SHOWN

SIGN W1-4dR (0)

COLOR: BACKGROUND-FLUORESCENT ORANGE (0)
TYPE A REFLECTIVE SHEETING PER STANDARD SPECIFICATIONS (* A) BORDER AND LETTERS-BLACK

SIZE: 48"×48"


MOUNTING HOLES: 16" DIA., 4 HOLES SPACED AS SHOWN.

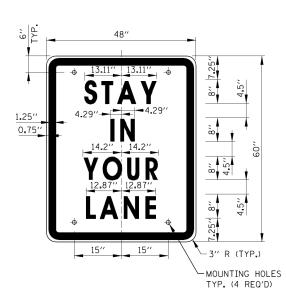

SIGN TS-3

COLOR: BACKGROUND - WHITE (REFLECTORIZED) (*A) BORDER AND LETTERS - BLACK

SIZE: 48"x60" LETTERING: LEGEND - 8" FEDERAL SERIES D MOUNTING HOLES: 1/6" DIA., 4 HOLES, SPACED AS SHOWN

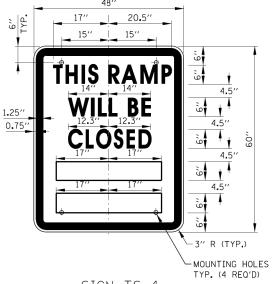

SIGN TS-4


COLOR: BACKGROUND - WHITE (REFLECTORIZED)(*A) BORDER AND LETTERS - BLACK

SIZE: 48"x60"

LETTERING: LEGEND - 6" FEDERAL SERIES C MOUNTING HOLES: $\frac{1}{16}$ " DIA., 4 HOLES, SPACED AS SHOWN

RAMP CLOSURE ADVANCE INFORMATION SIGN

THE VARIABLE MESSAGE WITH DATES FOR THE BOTTOM TWO LINES SHALL BE DETERMINED BY THE ENGINEER
AND GIVEN TO THE CONTRACTOR BEFORE THE REQUIRED FIELD ERECTION DATE.

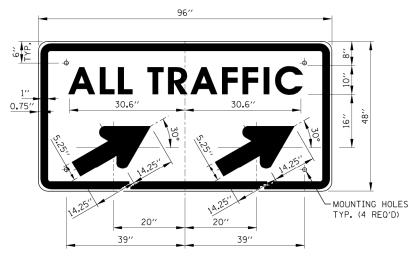

SIGN TS-5a & TS-5b

SCALE: NTS

COLOR: BACKGROUND - WHITE (REFLECTORIZED)(* A)
BORDER AND LETTERS - BLACK ARROW - BLACK SIZE: 96"×48"

LETTERING: 10" FEDERAL SERIES D

MOUNTING HOLES: 10" TEDERAL SERIES D

MOUNTING HOLES: 10" TEDERAL SERIES D

NOTE: SIGN TS-50 IS SHOWN, SUBSTITUTE

LEGEND "*" FOR "* T" FOR SIGN TS-5b

NOTES:

- ALL LETTERING IS DESIGNATED BY SIZE AND SERIES IN ACCORDANCE WITH THE LATEST EDITION OF "STANDARD ALPHABETS FOR HIGHWAY SIGNS AND PAVEMENT MARKINGS" AS PUBLISHED BY THE U.S. DEPARTMENT OF TRANSPORTATION. LETTERING SPACING SHALL BE IN ACCORDANCE WITH THIS GUIDE EXCEPT WHERE NOTED.
- SYMBOLS AND ARROWS SHALL CONFORM TO THE DETAILS SHOWN IN THE LATEST EDITION OF "STANDARD HIGHWAY SIGNS" AS PUBLISHED BY THE U.S. DEPARTMENT OF TRANSPORTATION.
- SEE THE CONTRACT REQUIREMENTS FOR ADDITIONAL NOTES AND SPECIFICATIONS. FLUORESCENT ORANGE REFLECTIVE SHEETING PER THE STANDARD SPECIFICATIONS.
- (*A) REFLECTIVE SHEETING PER THE STANDARD SPECIFICATIONS.
- 4. DIMENSIONS INDICATED THUS L ARE BASED ON A REDUCTION IN STANDARD LETTERING SPACING AS SHOWN BELOW:
 - L1 SPACING REDUCED BY 25%
 - L2 SPACING REDUCED BY 40%
 - L3 SPACING REDUCED BY 50%

SHEET 1 OF 2


TS-5b		Illinois Tallagor
DATE	REVISIONS	J Tollway
11-01-12	DELETED SIGN TS-1	
03-31-14	REVISED FINE SIGN NUMBER AND	
	ADDED LED SPEED LIMIT DISPLAY	CONSTRUCTION SIGNS
3-11-2015	REVISED NOTES	
3-31-2017	REVISED END WZSL SIGN COLOR	
3-01-2019	REMOVED STANDARD IDOT SIGNS,	
	REVISED WZSL ASSEMBLY, ADDED WZSL	STANDARD E1-07
	TRANSITION	STANDARD ET-OT


Paul Koracs APPROVED. CHIEF ENGINEERING OFFICER

UPAGE COUNTY	DESIGNED -	AS	REVISED -
IVISION OF TRANSPORTATION 21 COUNTY FARM ROAD	DRAWN -	RR	REVISED -
HEATON, IL	DRAWN - RR REVISED - CHECKED - EN REVISED -		
	DATE -	6/10/2019	REVISED -

STATE OF ILLINOIS **DEPARTMENT OF TRANSPORTATION**

TOLLWAY DETAILS	F.A.P. RTE.	SECTION	COUNTY	TOTAL SHEETS	SHEET NO.
TOLLWAY DETAILS	345A	14-00245-05-LS	COOK/DUPAGE	37	31
			CONTRACT	NO. (61E69
		ILLINOIS FED. A	D PROJECT		

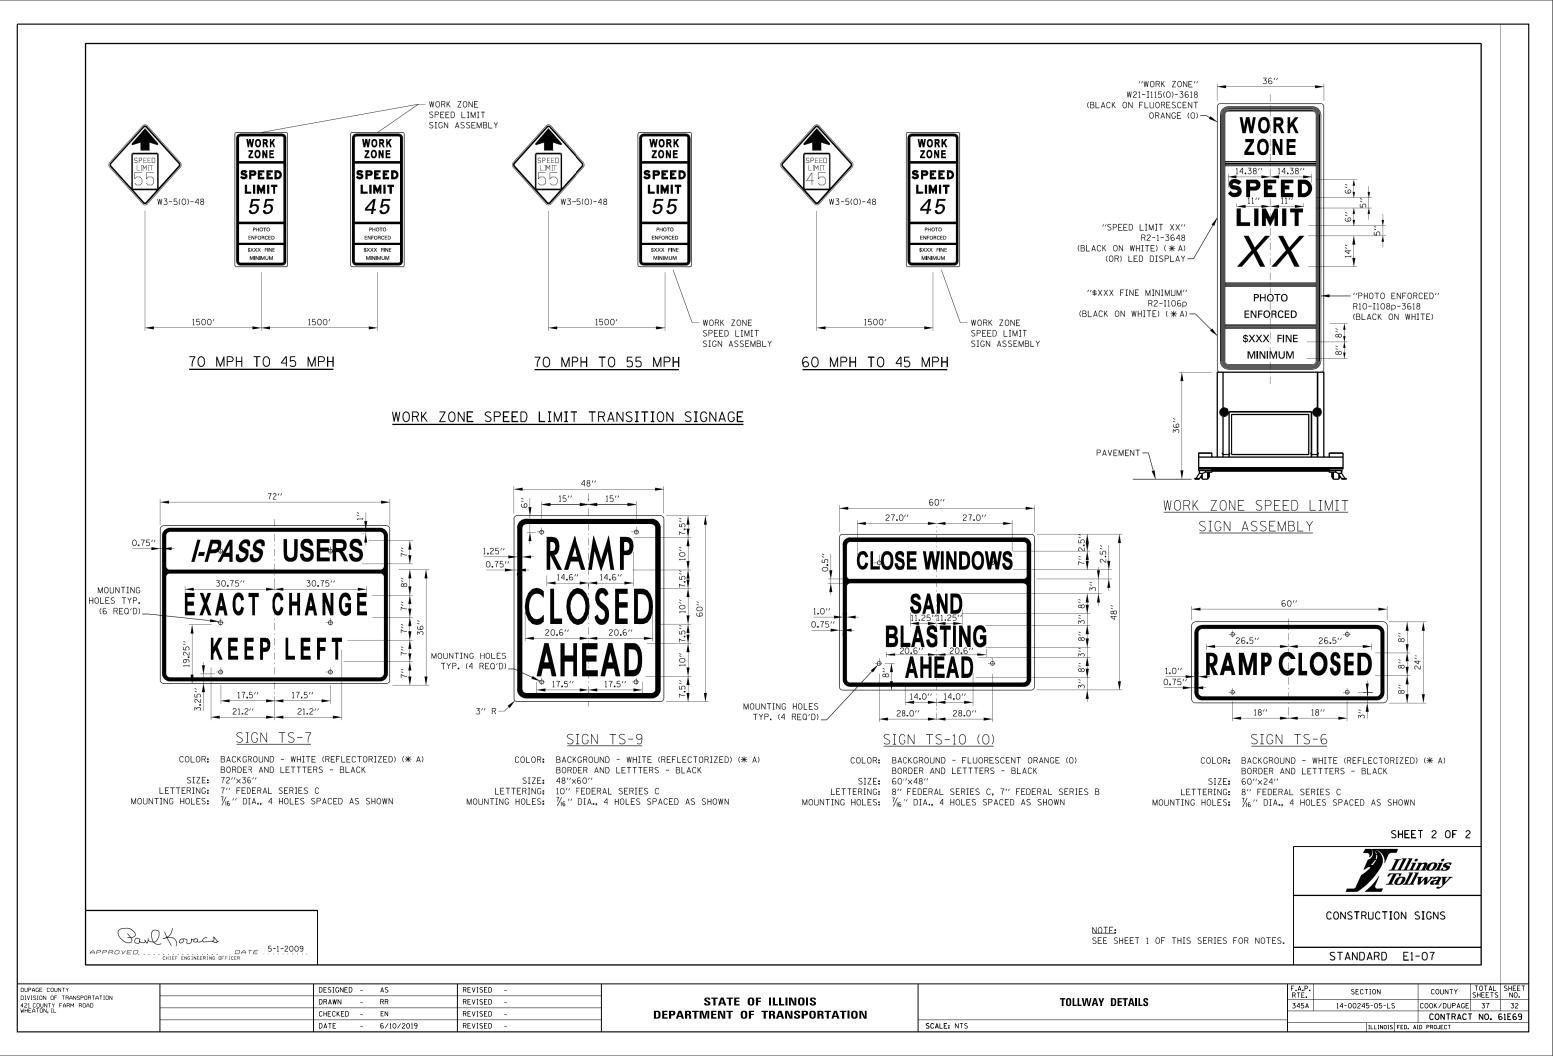

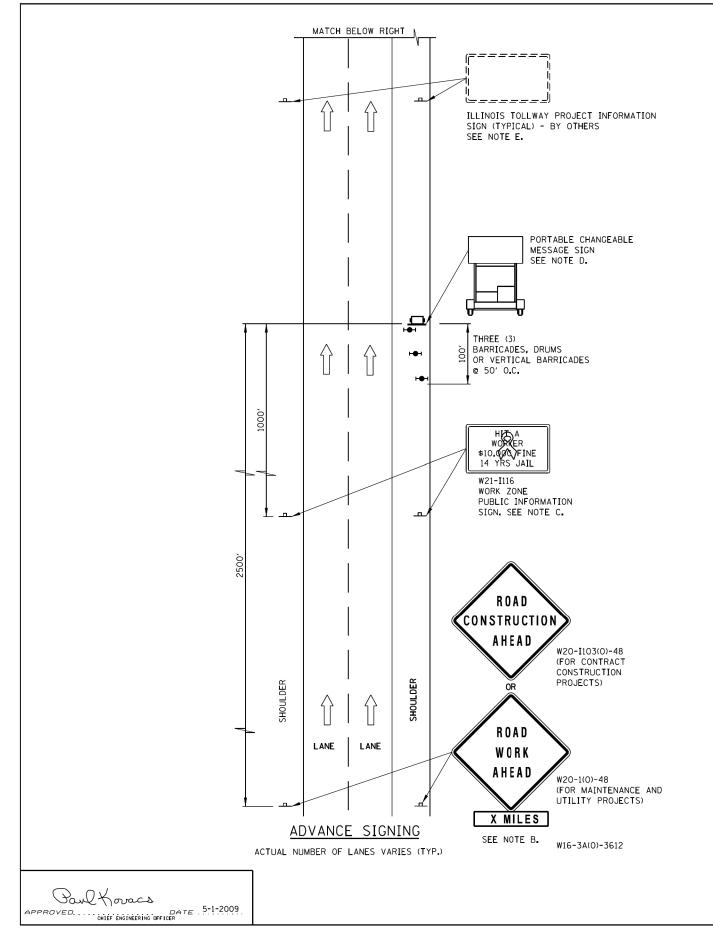

ADVANCE SIGNING NOTES:

- A. THE ADVANCE SIGNING SHOWN ON THIS STANDARD SHALL APPLY ANY TIME THE CONTRACTOR CLOSES ONE OR MORE LANES, OR IS REQUIRED TO SHIFT THE LANE ALIGNMENT. THE "ROAD WORK AHEAD" OR "ROAD CONSTRUCTION AHEAD" SIGNS, WORK ZONE PUBLIC INFORMATION SIGNS AND PORTABLE CHANGEABLE MESSAGE ARE STATIONARY.
- B. THE ROAD CONSTRUCTION AHEAD SIGN (W20-1A, WITH W16-3a SUPPLEMENTAL PLATE) OR ROAD WORK AHEAD SIGN (W20-1, WITH W16-3A SUPPLEMENTAL PLATE) SHALL BE LOCATED UP TO 5 MILES IN ADVANCE OF THE PROJECT LIMITS, WITH THE LOCATION BEING DETERMINED BY THE ENGINEER.
- C. THE WORK ZONE PUBLIC INFORMATION SIGN IS 60" WIDE BY 48" HIGH. THE CONTRACTOR SHALL OBTAIN THE CAMERA-READY ARTWORK REQUIRED FOR THE SIGN MESSAGE BY CONTACTING IDOT'S CENTRAL BUREAU OF OPERATIONS.
- THE PORTABLE CHANGEABLE MESSAGE SIGN SHALL BE USED TO DISPLAY THE STATUS OF LANE WITHIN THE CONTRACT LIMITS. THE PRIMARY MESSAGES SHALL BE: "RIGHT LANE(S) CLOSED" / "x MILES AHEAD", "LANE(S) SHIFT" / "x MILES AHEAD", "ALL LANES OPEN". THE PORTABLE CHANGEABLE MESSAGE SIGN MAY BE MOVED TO THE MEDIAN SHOULDER WHEN THE LANE CLOSURES ARE ON THE LEFT, PROVIDED THE EXISTING SHOULDER WIDTH IS ADEQUATE.
- E. THE ILLINOIS TOLLWAY WILL FURNISH AND INSTALL STATIC PROJECT INFORMATION SIGNS IN ADVANCE, THROUGH AND AT THE END OF THE WORK ZONE. THESE SIGNS WILL BE INSTALLED ALONG THE OUTSIDE SHOULDER WITH THE ADVANCE SIGNS LOCATED BEYOND THE PORTABLE CHANGEABLE MESSAGE SIGN. THE ENGINEER AND CONTRACTOR SHALL COORDINATE WITH THE ILLINOIS TOLLWAY REGARDING THE LOCATION OF THESE SIGNS AND NOTIFY THE ILLINOIS TOLLWAY OF ANY DAMAGE TO THE SIGNS OR SUPPORTS.

LEGEND

ARROW BOARD

WORK AREA

F SIGN

DIRECTION INDICATOR BARRICADE WITH SEQUENTIAL FLASHING WARNING LIGHT

TYPE II BARRICADE, DRUM, OR
VERTICAL BARRICADE WITH STEADY
BURN MONODIRECTIONAL LIGHT

FLAGGER WITH TRAFFIC CONTROL SIGN

TRUCK MOUNTED ATTENUATOR

₹ WORKER

X LANE CLOSED

LL CHECK BARRICADE

SHEET 1 OF 3

STANDARD E2-08

DATE REVISIONS

3-31-2016 ADDED LANE CLOSURE WITH BARRIER AND ADDED
SEQUENTIAL FLASHING WARNING LIGHT.
3-31-2017 ADDED TAPER RATE TABLE
3-01-2019 RE-ARRAGEO DETAILS, REVISED NOTE 17,
ADDED NOTES 18 & 19, ADDED TMA

DUPAGE COUNTY DESIGNED - AS REVISED SECTION COUNTY DIVISION OF TRANSPORTATION STATE OF ILLINOIS DRAWN - RR REVISED **TOLLWAY DETAILS** 421 COUNTY FARM ROAD WHEATON, IL 345A 14-00245-05-LS COOK/DUPAGE 37 33 CHECKED - EN REVISED **DEPARTMENT OF TRANSPORTATION** CONTRACT NO. 61E69 SCALE: NTS DATE - 6/10/2019 REVISED ILLINOIS FED. AID PROJECT

