STATE OF ILLINOIS **DEPARTMENT OF TRANSPORTATION**

22-00026-00-RS COOK 49 FED. ROAD DIST. NO. 1 ILLINOIS FED. AID PROJECT NM5A(507)

CONTRACT NO. 61L14

PLANS FOR PROPOSED FEDERAL AID HIGHWAY

FAU ROUTE 1049 (CENTER STREET) 175TH STREET TO 171ST STREET

ROADWAY RESURFACING AND PEDESTRIAN ACCOMODATIONS

SECTION NO.: 22-00026-00-RS

PROJECT NO.: NM5A(507)

VILLAGE OF EAST HAZEL CREST

COOK COUNTY

JOB NO.: C-91-177-23

FOR INDEX OF SHEETS, SEE SHEET NO. 2

FOR HIGHWAY STANDARDS, SEE SHEET NO. 2

CENTER STREET 175TH STREET TO 171ST STREET

2019 ADT-


3,800 **25 MPH**

POSTED SPEED LIMIT-

FUNCTIONAL CLASSIFICATION-


MAJOR COLLECTOR

VILLAGE 0F **EAST HAZEL CREST**

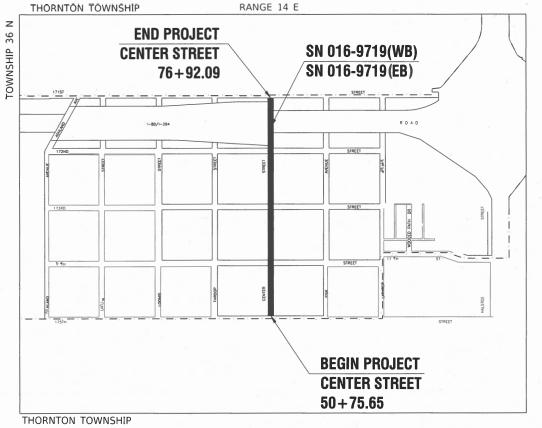

LOCATION MAP NOT TO SCALE

GROSS AND NET LENGTH= 2616.44 FEET= 0.50 MLES

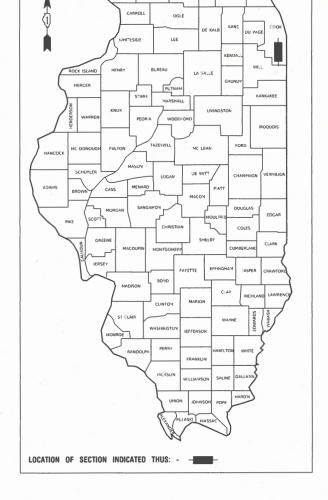



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AID PROGRAM ENGINEER: CARMEN RAMOS, PE,

J. U. L. I. E.

OR 811

1 - 800 - 892 - 0123

CONTRACT NO. 61L14

FULL SIZE PLANS HAVE BEEN PREPARED USING STANDARD ENGINEERING SCALES, REDUCED SIZED PLANS WILL NOT CONFORM TO STANDARD SCALES, IN MAKING MEASUREMENTS ON REDUCED PLANS, THE ABOVE SCALES MAY BE USED

JOINT UTILITY LOCATION INFORMATION FOR EXCAVATION

INDEX OF SHEETS

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- 000001-08 STANDARD SYMBOLS, ABBREVIATIONS AND PATTERNS
- 280001-07 TEMPORARY EROSION CONTROL SYSTEMS
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- 424006-06 DIAGONAL CURB RAMPS FOR SIDEWALKS
- 424011-05 CORNER PARALLEL CURB RAMPS FOR SIDEWALKS
- 424016-06 MID-BLOCK CURB RAMPS FOR SIDEWALKS
- 424021-07 DEPRESSED CORNER FOR SIDEWALKS
- 424026-04 ENTRANCE / ALLEY PEDESTRIAN CROSSINGS
- 442201-03 CLASS C AND D PATCHES
- 606001-08 CONCRETE CURB TYPE B AND COMBINATION CONCRETE CURB AND GUTTER
- 701001-02 OFF ROAD OPERATIONS, 2L, 2W, MORE THAN 15'(4.5m) AWAY
- 701006-05 OFF ROAD OPERATIONS, 2L, 2W, 15'(4.5m) TO 24"(600mm) FROM PAVEMENT EDGE
- 701011-04 OFF ROAD MOVING OPERATIONS, 2L.2W, DAY ONLY
- 701301-04 LANE CLOSURE, 2L, 2W, SHORT TIME OPERATIONS
- 701311-03 LANE CLOSURE, 2L, 2W, MOVING OPERATIONS - DAY ONLY
- 701501-06 URBAN LANE CLOSURE, 2L, 2W, UNDIVIDED
- 701701-10 URBAN LANE CLOSURE MULTILANE INTERSECTION 701801-06 SIDEWALK CORNER OR CROSSWALK CLOSURE
- 701901-10 TRAFFIC CONTROL DEVICES
- 720001-01 SIGN PANEL MOUNTING DETAILS
- 720006-04 SIGN PANEL ERECTION DETAILS
- 728001-01 TELESCOPING STEEL SIGN SUPPORT
- 731001-01 BASE FOR TELESCOPING STEEL SIGN SUPPORT
- 780001-05 TYPICAL PAVEMENT MARKINGS
- 814001-03 HANDHOLES
- DETECTOR LOOP INSTALLATIONS 886001-01
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DISTRICT ONE DETAILS

- BD-22 PAVEMENT PATCHING FOR HMA SURFACED PAVEMENT
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- BE-220 ELECTRIC SERVICE INSTALLATION AERIAL, REMOTE DISCONNECT
- BE-300 LIGHT POLE FOUNDATION 30'(9.144m) TO 35'(10.668m) M.H. 1/2" (292mm) BOLT CIRCLE
- BE-310 LIGHT POLE FOUNDATION 40'(12.192m) TO 47 1/2'(14.478m) M.H. 15" (381mm) BOLT CIRCLE
- BE-702 MISCELLANEOUS ELECTRICAL DETAILS SHEET A
- TC-10 TRAFFIC CONTROL AND PROTECTION FOR SIDE ROADS, INTERSECTIONS AND DRIVEWAYS
- TC-13 DISTRICT ONE TYPICAL PAVEMENT MARKINGS
- TC-16 SHORT TERM PAVEMENT MARKING LETTERS AND SYMBOLS
- TC-22 ARTERIAL ROAD INFORMATION SIGN
- TS-07 DETECTOR LOOP INSTALLATION DETAIL FOR ROADWAY RESURFACING

GENERAL NOTES

- 1. ITEMS OF WORK LISTED IN THE SUMMARY OF QUANTITIES NOT SPECIFICALLY CALLED OUT ON THE PLANS SHALL BE PERFORMED AS DIRECTED BY THE
- 2. THE ROBINSON ENGINEERING, LTD. FIELD OFFICE (815-806-0300), COOK COUNTY DEPARTMENT OF TRANSPORTATION AND HIGHWAYS (CCDOTH) DESIGN ENGINEER (312-603-1734) AND THE PUBLIC WORKS DIRECTOR (708-798-0213) AT THE VILLAGE OF EAST HAZEL CREST, SHALL BE NOTIFIED FIVE (5) WORKING DAYS BEFORE CONSTRUCTION BEGINS.
- 3. BEFORE STARTING ANY EXCAVATION THE CONTRACTOR SHALL CALL "J.U.L.I.E." AT (800) 892-0123 OR 811 AND (312) 744-7000 FOR FIELD LOCATIONS OF BURIED ELECTRIC, TELEPHONE, GAS, AND OTHER UTILITIES. (48 HOUR NOTIFICATION REQUIRED)
- 4. UTILITIES INDICATED ON THE PLANS ARE PROVIDED FOR THE CONTRACTOR'S USE AND ARE BASED UPON INFORMATION AVAILABLE AT THE TIME OF THE ADVERTISEMENT FOR BIDS. THE OWNER AND ENGINEER DO NOT GUARANTEE THE ACCURACY OF UTILITY INFORMATION.
- 5. IT SHALL BE THE CONTRACTOR'S RESPONSIBILITY TO VERIFY ALL DIMENSIONS AND CONDITIONS EXISTING IN THE FIELD PRIOR TO CONSTRUCTION AND ORDERING OF MATERIALS
- 6. THE THICKNESS OF HMA MIXTURE STATED IN THE SPECIFICATIONS IS THE NOMINAL THICKNESS. DEVIATIONS FROM THE NOMINAL THICKNESS WILL BE PERMITTED WHEN SUCH DEVIATIONS OCCUR DUE TO IRREGULARITIES IN THE EXISTING SURFACE OR BASE ON WHICH THE HMA SURFACE IS PLACED
- 7. ANY LOOSE MATERIAL DEPOSITED IN THE FLOW LINE OF DITCHES, GUTTERS OR OTHER DRAINAGE STRUCTURES SHALL BE REMOVED BY THE END OF EACH DAY BY THE CONTRACTOR
- 8. CLASS D PATCHING QUANTITIES FOR THIS CONTRACT SHALL BE PERFORMED AT THE DIRECTION OF THE ENGINEER AFTER PAVEMENT MILLING
- CONTRACTOR SHALL TAKE PRECAUTION BY PRESERVING EXISTING TREES WITHIN THE RIGHT OF WAY. IF ANY DAMAGE OCCURS, TREES SHALL BE REPLACED IN KIND PER ARTICLE 201.07 REPAIR OR REPLACEMENT OF EXISTING PLANT MATERIAL REQUIREMENTS STATED HEREIN
- 10.NO PAVEMENT PATCHING SHALL BE PERMITTED AFTER FRIDAY AT 3:00 PM OF EACH AND EVERY WEEK AND NO HOLES WILL BE ALLOWED TO REMAIN OPEN OVERNIGHT OR OVER THE WEEKEND.
- 11. ALL EQUIPMENT SHALL BE REMOVED OFF THE VILLAGE STREETS DURING ALL HOLIDAY WEEKENDS AS COORDINATED WITH THE VILLAGE
- 12. HMA PAVING SHALL BE PERFORMED WITH HOT JOINTS
- 13.ALL SIGNS REMOVED THAT ARE NOT BEING REINSTALLED ARE THE PROPERTY OF THE VILLAGE AND SHALL BE DELIVERED TO THE VILLAGE OF EAST HAZEL CREST PUBLIC WORKS DEPARTMENT AT 17217 THROOP STREET, EAST HAZEL CREST, IL
- 14. PROPOSED SIGNS AND DECORATIVE SIGN POSTS SHALL BE APPROVED BY THE VILLAGE AND RESIDENT ENGINEER PRIOR TO MANUFACTURING
- 15. AGGREGATE SUBGRADE IMPROVEMENT (CU YD) HAS BEEN PROVIDED FOR USE AT LOCATIONS INDICATED FOR SOILS THAT TEND TO BE UNSTABLE AND/OR UNSUITABLE. THE ACTUAL NEED FOR THE REMOVAL AND REPLACEMENT WITH THE ABOVE ITEM WILL BE DETERMINED IN THE FIELD AT THE TIME OF CONSTRUCTION BY THE GEOTECHNICAL ENGINEER. ALL POTENTIALLY UNSTABLE/UNSUITABLE MATERIALS ARE NOTE ENCOUNTERED, THEN THE QUANTITY SHALL BE DEDUCTED AND NO ADDITIONAL COMPENSATION WILL BE DUE TO THE CONTRACTOR
- 16. THE CONTRACTOR'S ATTENTION IS CALLED TO THE FACT THAT THE PRESERVATION OF EXISTING TREES IS OF UTMOST IMPORTANCE TO THE VILLAGE OF FAST HAZEL CREST
- 17. EXISTING VEGETATED AREAS (TREES, SHRUBS, VEGETATIVE BUFFERS, TURF AREAS, ETC.) WHERE DISTURBANCE IS NOT OCCURRING (INCLUDING AREAS OUTSIDE THE PROJECT LIMITS) SHALL NOT BE DISTURBED TO ENSURE THAT EXISTING VEGETATION IS PRESERVED HEALTHY TO MINIMIZE SOIL EROSION AND TO ELIMINATE SOIL COMPACTION. NO MATERIALS ARE TO BE STORED OR VEHICLES DRIVEN OR PARKED WITHIN THESE UNDISTURBED AREAS AT ANY TIME
- 18. THE EXACT LOCATIONS OF ALL UTILITIES SHALL BE FIELD VERIFIED BY THE CONTRACTOR BEFORE THE INSATLLATION OF ANY COMPONENTS OF THE TRAFFIC SIGNAL SYSTEM. FOR LOCATIONS OF UTILITIES, CALL TOLL FREE 1-800-892-0123
- 19. A MINIMUM OF FIVE (5) WORKING DAYS PRIOR TO THE CONTRACTOR CUTTING LOOPS, THE CONTRACTOR SHALL HAVE THE PROPOSED LOOP LOCATIONS MARKED AND CONTACT THE CCHD DESIGN ENGINEER AT (312) 603-1734 TO INSPECT AND APPROVE THE LAYOUT
- 20. ALL ELECTRICAL CABLE ASSOCIATED WITH THE DETECTOR LOOP REPLACEMENT WORK SHOULD HAVE POLYVINYL CHLORIDE JACKET

- 21.ALL ELECTRICAL CABLE ASSOCIATED WITH THE STREET LIGHTING SHOULD HAVE HIGH DENSITY POLYURETHANE JACKET
- 22. THE TRAFFIC SIGNAL WORK SHALL BE INSTALLED BY AN ELECTRICAL CONTRACTOR APPROVED BY THE COOK COUNTY DEPARTMENT OF TRANSPORTATION AND HIGHWAYS
- 23. CARE IS TO BE TAKEN AS NOT TO DAMAGE ANY OF THE EXISTING TRAFFIC SIGNAL AND/OR STREET LIGHTING CONDUITS, FIBER CABLES AND EQUIPMENT. IF ANY OF THE TRAFFIC SIGNAL CONDUITS, CABLES AND/OR EQUIPMENT IS DAMAGED. THE CONTRACTOR SHALL REPAIR AND/OR REPLACE THE CONDULTS. CABLES AND/OR EQUIPMENT AT NO COST TO THE COUNTY
- 24. THE COUNTY IS NOT PART OF JULIE FOR LOCATION OF TRAFFIC SIGNAL EQUIPMENT, CONTACT THE MECHANICAL, ELECTRICAL, ARCHITECTURAL AND LANDSCAPING DIVISION AT 312-603-1734
- 25.FOR THE LOCATION OF UNDERGROUND COUNTY MAINTAINED FACILITIES. SEE COUNTY SPECIAL PROVISION "TRAFFIC SIGNAL WORK GENERAL
- 26.IF THIS CONTRACT REQUIRES THE SERVICES OF AN ELECTRICAL CONTRACTOR THE CONTRACTOR SHALL BE RESPONSIBLE AT HIS/HER OWN EXPENSE FOR LOCATING EXISTING CCDOTH FACILITIES PRIOR TO PERFORMING ANY WORK. IF THIS CONTRACT DOES NOT REQUIRE THE SERVICES OF ELECTRICAL CONTRACTOR THE CONTRACTOR MAY REQUEST ONE FREE LOCATE FOR EXISTING CCDOTH ELECTRICAL FACILITIES FROM THE COUNTY ELECTRICAL MAINTENANCE CONTRACTOR(S) PRIOR TO THE START OF ANY WORK IF THE TRAFFIC SIGNAL IS STILL MAINTAINED BY THE COUNTY. ADDITIONAL REQUESTS MAY BE AT THE EXPENSE OF THE CONTRACTOR. THE LOCATION OF UNDERGROUND TRAFFIC FACILITIES DOES NOT RELIEVE THE CONTRACTOR OF THEIR RESPONSIBILITY TO REPAIR ANY FACILITIES DAMAGED DURING CONSTRUCTION AT THEIR EXPENSE.
- 27.RESTORATION SHALL BE DONE WITH 4" TOPSOIL, FERTILIZER, AND SOD FOR ALL DISTURBED AREAS WITHIN COOK COUNTY ROW

SECTION

22-00026-00-RS

COUNTY

COOK

CONTRACT NO. 61L14

49

FILE NAME = 21-R0969-INDX-01 - P01 USER NAME = DESIGNED - MG REVISED CHECKED - WPD REVISED PLOT SCALE = DRAWN RG,MED REVISED PLOT DATE = 12-05-24 CHECKED - AG REVISED

STATE OF ILLINOIS DEPARTMENT OF TRANSPORTATION

CENTER STREET ROADWAY RESURFACING AND PEDESTRIAN ACCOMODATIONS 1049 INDEX OF SHEETS, STANDARDS & GENERAL NOTES SHEET NO. 2 OF 49 SHEETS STA. SCALE: NONE FED. ROAD DIST. NO. 1 ILLINOIS FED. AID PROJECT NM5A(507

							FED 80%	FED 80%
* SPECIAL	TY ITEM						VILLAGE 20%	VILLAGE 20%
							ROADWAY	SAFETY
CODE NO.		PAY I	TENA		LINIT	TOTAL	CONSTRUCTION	N TYPE CODE
CODE NO.		PATI	I EIVI		UNIT	QUANTITY	0005	0021
20101100	TREE TRUNK PROTECTION				EACH	13	13	
20101200	TREE ROOT PRUNING				EACH	13	13	
20101350	TREE PRUNING (OVER 10 INCH DIAM	METER)			EACH	13	13	
20101700	SUPPLEMENTAL WATERING				UNIT	1	1	
20201200	REMOVAL AND DISPOSAL OF UNSUITA	ABLE MATERIAL			CU YD	20	20	
21101615	TOPSOIL FURNISH AND PLACE, 4"				SQ YD	2000	3000	
21101015	TOFSOIL FURNISH AND PLACE, 4"				טז ענ	3000	3000	
21400100	GRADING AND SHAPING DITCHES				FOOT	1300	1300	
25000210	SEEDING, CLASS 2A				ACRE	0.75	0.75	
25000400	NITROGEN FERTILIZER NUTRIENT				POUND	60	60	
23000400	NTIROGEN FERTILIZER NOTRIENT				FOUND	00	00	
25000500	PHOSPHORUS FERTILIZER NUTRIENT				POUND	60	60	
25000600	POTASSIUM FERTILIZER NUTRIENT				POUND	60	60	
25100630	EROSION CONTROL BLANKET				SQ YD	3000	3000	
					`			
25200110	SODDING, SALT TOLERANT				SQ YD	30	30	
28000250	TEMPORARY EROSION CONTROL SEEDI	NG			POUND	65	65	
28000510	INLET FILTERS				EACH	14	14	
	-							
30300001	AGGREGATE SUBGRADE IMPROVEMENT				CU YD	20	20	
35101600	AGGREGATE BASE COURSE, TYPE B	A "		SQ YD	850		850	
22101000	AGGILLOWIE BASE COOKSE, TIPE B	T			30 10	930		630
E NAME = 21R0969-QUAN-01 - 22X3	USER NAME =	DESIGNED — MG	REVISED —	07475.05	II I INICIC		CENTE	R STREET
	PLOT SCALE =	CHECKED — ### DRAWN — BG MED	REVISED —	STATE OF		TION	ROADWAY RESURFACING AND	D PEDESTRIAN ACCOMODAT DF QUANTITIES

STATE OF ILLINOIS
DEPARTMENT OF TRANSPORTATION

CENTER STREET
ROADWAY RESURFACING AND PEDESTRIAN ACCOMODATIONS
SUMMARY OF QUANTITIES

SCALE: NONE SHEET NO. 3 OF 49 SHEETS STA. TO STA.

* CDECIAL	* SPECIALTY ITEM							FED 80% VILLAGE 20%
* SPECIAL	. 1 1 1 1 1 1 1 1 1 1 1 1 1 1 1 1 1 1 1						VILLAGE 20%	
	1					1	ROADWAY	SAFETY
CODE NO.		PAY	ITEM		UNIT	TOTAL	CONSTRUCTION	
						QUANTITY	0005	0021
35102200	AGGREGATE BASE COURSE, TYPE B	10"			SQ YD	1630	1630	
35000100	DDEDADATION OF DAGE				CO VD	1.45	1.45	
35800100	PREPARATION OF BASE				SQ YD	145	145	
35800200	AGGREGATE BASE REPAIR				TON	15	15	
40201000	AGGREGATE FOR TEMPORARY ACCESS				TON	100	100	
40600275	BITUMINOUS MATERIALS (PRIME CO.	AT)			POUND	3390	3390	
40600290	BITUMINOUS MATERIALS (TACK COA	Τ)			POUND	6720	6720	
40600370	LONGITUDINAL JOINT SEALANT			FOOT	6430	6430		
40600400	MIXTURE FOR CRACKS, JOINTS, AND		TON	5	5			
40600982	HOT-MIX ASPHALT SURFACE REMOVAL	I PUTT IOINT			SQ YD	170	170	
40000302	HOT-MIX ASTRIALT SONTACE NEMOVAL	L - BOTT JOINT			30 10	170	170	
40603080	HOT-MIX ASPHALT BINDER COURSE,	IL-19.0, N50			TON	315	315	
40602200	POLYMERIZED HOT-MIX ASPHALT BII	NDED COURCE II 4 75 NEO			TON	120	420	
40603200	POLIMERIZED HOT-MIX ASPHALT BIT	NDER COURSE, IL-4.75, NSU			TON	430	430	
40604060	HOT-MIX ASPHALT SURFACE COURSE	, IL-9.5, MIX "D", N50			TON	900	900	
42400200	PORTLAND CEMENT CONCRETE SIDEWA	ALK 5 INCH			SQ FT	7650		7650
42400800	DETECTABLE WARNINGS				SQ FT	100		100
					SQ YD	1400		
44000100	PAVEMENT REMOVAL	PAVEMENT REMOVAL					1400	
44000157	HOT-MIX ASPHALT SURFACE REMOVAL, 2"				SQ YD	8800	8800	
44000200	DRIVEWAY PAVEMENT REMOVAL				SQ YD	30	30	
= 21R0969-QUAN-01 - 22X34_0	USER NAME =	DESIGNED — MG	REVISED —			<u> </u>	CENTER	
	DI OT COME	CHECKED — ###	REVISED —	STATE OF IL	LINOIS		ROADWAY RESURFACING AND	PEDESTRIAN ACCOMODAT

STATE OF ILLINOIS
DEPARTMENT OF TRANSPORTATION

CENTER STREET
ROADWAY RESURFACING AND PEDESTRIAN ACCOMODATIONS
SUMMARY OF QUANTITIES

SCALE: NONE SHEET NO. 4 OF 49 SHEETS STA. TO STA.

* SPECIAL	TY ITEM	FED 80% VILLAGE 20%	FED 80% VILLAGE 20%		
31 201/12				ROADWAY	SAFETY
			TOTAL	CONSTRUCTIO	
CODE NO.	PAY ITEM	UNIT	QUANTITY		
			QUANTITI	0005	0021
44000400	GUTTER REMOVAL	FOOT	45	45	
44000500	COMBINATION CURB AND GUTTER REMOVAL	FOOT	190	190	
44004250	PAVED SHOULDER REMOVAL	SQ YD	1115	1115	
44201761	CLASS D PATCHES, TYPE I, 10 INCH	SQ YD	10	10	
44201765	CLASS D PATCHES, TYPE II, 10 INCH	SQ YD	20	20	
	CLASS D. DATGUES . TYPE . LL. 40 . LLS.				
44201769	CLASS D PATCHES, TYPE III, 10 INCH	SQ YD	15	15	
44201771	CLASS D PATCHES, TYPE IV, 10 INCH	SQ YD	100	100	
44201771	CLASS D FAICHES, TIPE IV, 10 INCH	3Q 1U	100	100	
55100300	STORM SEWER REMOVAL, 8"	FOOT	10	10	
33100300	STONE SEVEN NEW YORK	1001	10	10	
60234200	INLETS, TYPE A, TYPE 1 FRAME, OPEN LID	EACH	3	3	
				_	
60300405	VALVE BOXES TO BE ADJUSTED	EACH	5	5	
60406001	FRAMES AND LIDS, TYPE 1, ADA COMPLIANT, OPEN LID	EACH	1		1
60500050	REMOVING CATCH BASINS	EA CH	3	3	
60600605	CONCRETE CURB, TYPE B	FOOT	35		35
60602500	CONCRETE GUTTER, TYPE A	FOOT	45	45	
60605000	COMBINATION CONCRETE CURB AND GUTTER, TYPE B-6.24	FOOT	190	190	
67100100	MODILITATION		1		
67100100	MOBILIZATION	LSUM	1	1	
70102620	TRAFFIC CONTROL AND RECTION STANDARD 701501	1.01**	1	1	
70102620	TRAFFIC CONTROL AND PROTECTION, STANDARD 701501	LSUM	1	1	
NAME = 21R0969-QUAN-01 - 22X	4_03	L.		CFNT	ER STREET
	CHECKED — ### REVISED —	STATE OF ILLINOIS		ROADWAY RESURFACING AN	ID PEDESTRIAN ACCOMODA

 USER NAME
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 PLOT SCALE
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 PLOT DATE
 =
 12-05-24
 CHECKED
 — AG
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STATE OF ILLINOIS DEPARTMENT OF TRANSPORTATION CENTER STREET
ROADWAY RESURFACING AND PEDESTRIAN ACCOMODATIONS
SUMMARY OF QUANTITIES

SCALE: NONE SHEET NO. 5 OF 49 SHEETS STA. TO STA.

			PLOT SCALE = 12-05-24				DEPARTMENT OF TRANSPORTATION SCALE: NON			SUMMARY OF QUANTITIES		
				CHECKED -		REVISED —		STATE OF			ROADWAY RESURFACING AN	D PEDESTRIAN ACCOMODATION
	FILE NAME = 21R0969-QUAN-01 - 22X3-	4_Q4	USER NAME =	DESIGNED -		REVISED —						ER STREET
	82110005	LUMINA	AIRE, LED, ROADWAY, OUT	TPUT DESIGNATI	ON E				EACH	9	9	
k												
	31702440	LLLCIP	CABLE IN CONDOIT, C		55E, 5-1/C NO.	-10			1001	1.5	13	
*	81702440	ELECTR	SIC CABLE IN CONDUIT, 6	600V (XLP-TYPF	USE) 3-1/C NO	1/0			FOOT	15	15	
*	81603090	UNIT	DUCT, 600V, 3-1C NO.4,	1/C NO.6 GROU	ND, (XLP-TYPE U	SE), 1 1/4" DIA.	POLYETHYL	ENE	FOOT	2110	2110	
*	81028210	UNDERG	GROUND CONDUIT, GALVAN	IIZED STEEL, 2	1/2" DIA.				FOOT	125	125	
k	80400200	ELECTR	IC UTILITY SERVICE COM	NNECTION					L SUM	1	1	
	30400100	LLLCIP	SERVICE INSTALLATIO	U.1					LACII	-	1	
<	80400100	FLECTR	IC SERVICE INSTALLATION	ON					EACH	1	1	
k	78000650	THERMO	DPLASTIC PAVEMENT MARK	ING - LINE 24"					FOOT	50		50
*	78000600	THERMO	DPLASTIC PAVEMENT MARK	ING - LINE 12"					FOOT	500		500
	78000400	IHEKMO	PELASTIC PAVEMENT MARK	LINE 6"					FOOT	400		400
*	79000400	THEDIA	DPLASTIC PAVEMENT MARK	ING LINE C"					FOOT	400		400
*	78000200	THERMO	DPLASTIC PAVEMENT MARK	ING - LINE 4"					FOOT	9510		9510
k	78000100	THERMO	DPLASTIC PAVEMENT MARK	ING - LETTERS	AND SYMBOLS				SQ FT	170		170
k	72800100	TELESO	COPING STEEL SIGN SUPPO	ORT					FOOT	70		70
	72400500	RELOCA	ATE SIGN PANEL ASSEMBLY	Y - TYPE A					EACH	2		2
	72400500	72400500 RELOCATE SIGN PANEL ASSEMBLY - TYPE A					FAC::					
*	72000100	72000100 SIGN PANEL - TYPE 1				SQ FT	40		40			
	70300130	31101(1	TERM LAVEINENT MAINTING	, KLHOVAL					34 11	90		30
	70300150	SHORT	TERM PAVEMENT MARKING	S REMOVAL					SQ FT	90		90
	70300100	SHORT	TERM PAVEMENT MARKING	i					FOOT	265		265
	. 3232340			,	•				2330	-	-	
	70102640	TRAFFI	C CONTROL AND PROTECT!	ION, STANDARD	701801				LSUM	1	1	
	70102635	TRAFFI	C CONTROL AND PROTECT	ION, STANDARD	701701				LSUM	1	1	
									01411	QUANTITY	0005	0021
	CODE NO.				PAY 1	ITEM			UNIT	TOTAL	CONSTRUCTIO	N TYPE CODE
											ROADWAY	SAFETY
	* SPECIALTY	/ ITEM									VILLAGE 20%	VILLAGE 20%
	* CDECIALT	/ ITENA									FED 80%	FED 80%

PLOT DATE = 12-05-24

CHECKED — AG

REVISED —

SUMMARY OF QUANTITIES SCALE: NONE SHEET NO. 6 OF 49 SHEETS STA.


COUNTY TOTAL SHEET NO.
COOK 49 6 SECTION CONTRACT NO. 61L14 FED. ROAD DIST. NO. 1 ILLINOIS FED. AID PROJECT NM5A(507)

TO STA.

			FED 80%	FED 80%	
* SPECIALTY	TITEM			VILLAGE 20%	VILLAGE 20%
				ROADWAY	SAFETY
CODE NO.	PAY ITEM	UNIT	TOTAL	CONSTRUCTION	TYPE CODE
CODE NO.	TAT TIEM	ONTT	QUANTITY	0005	0021
82110006	LUMINAIRE, LED, ROADWAY, OUTPUT DESIGNATION F	EACH	2	2	
82500350	LIGHTING CONTROLLER, BASE MOUNTED, 240VOLT, 100AMP	EACH	1	1	
83007300	LIGHT POLE, ALUMINUM, 35 FT. M.H., 8 FT. MAST ARM	EACH	11	11	
83007300	ETGIT TOLE, ALDMINON, 33 TT. M.H., 0 TT. MAST ANN	EACH	11	11	
83600200	LIGHT POLE FOUNDATION, 24" DIAMETER	FOOT	60	60	
85000200	MAINTENANCE OF EXISTING TRAFFIC SIGNAL INSTALLATION	EACH	1	1	
87301305	ELECTRIC CABLE IN CONDUIT, LEAD-IN, NO. 14 1 PAIR	FOOT	60	60	
00000100	DETECTOR LOOP. TWO I	5007	150	150	
88600100	DETECTOR LOOP, TYPE I	FOOT	150	150	
89502300	REMOVE ELECTRIC CABLE FROM CONDUIT	FOOT	60	60	
K0036120	MULCH PLACEMENT 4"	SQ YD	60	60	
X1700066	POTHOL I NG	EACH	5	5	
	FARTH EVEN ATTON (CRECIAL)	011.115			
X2020410	EARTH EXCAVATION (SPECIAL)	CU YD	300	300	
X6025604	PROPOSED MANHOLE/CATCH BASIN CONNECTION OVER EXISTING STORM SEWER	EACH	3	3	
X6026050	SANITARY MANHOLES TO BE ADJUSTED	EACH	2	2	
X8360215	LIGHT POLE FOUNDATION, 24" DIAMETER, OFFSET	FOOT	25	25	
70001711	HOT MLY ACRUAL T DRIVEWAY DAVEMENT. All	60.1/5			
Z0004514	HOT-MIX ASPHALT DRIVEWAY PAVEMENT, 4"	SQ YD	70	70	
Z0017400	DRAINAGE & UTILITY STRUCTURES TO BE ADJUSTED	EACH	19	19	
Z0017700	DRAINAGE & UTILITY STRUCTURES TO BE RECONSTRUCTED	EACH	1	1	
Z0073510	TEMPORARY TRAFFIC SIGNAL TIMING	EACH	1	1	
		Enem	1	1	


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	CHECKED — ###	REVISED —
PLOT SCALE =	DRAWN — RG,MED	REVISED —
PLOT DATE = 12-05-24	CHECKED — AG	REVISED —

FILE NAME = 21R0969-QUAN-01 - 22X34_Q5

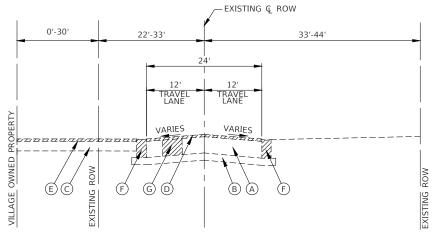

EXISTING TYPICAL SECTION

CENTER STREET STA 50+75.65 TO STA 55+03.50 NOTE: GUTTER ENDS AT STATION 54+36

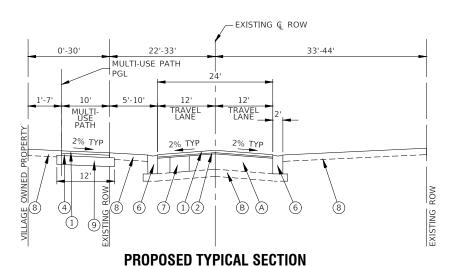

CENTER STREET STA 50+75.65 TO STA 55+03.50

EXISTING LEGEND

- EXISTING HMA PAVEMENT, 5.5" TO 13.5"
- EXISTING AGGREGATE SUBBASE, 6"±1"
- EXISTING AGGREGATE SUBBASE, 8"±1"
- HOT-MIX ASPHALT SURFACE REMOVAL, 2"
- FULL DEPTH PAVEMENT REMOVAL, 6"±1"
- GUTTER REMOVAL OR COMBINATION CONCRETE CURB AND GUTTER REMOVAL (AS DIRECTED BY THE ENGINEER)
- PAVEMENT REMOVAL FOR CLASS D PATCHES, 10 INCH
- (H)GUARDRAIL
- PAVED SHOULDER REMOVAL, 16"±1"
- ITEM TO BE REMOVED (AS DIRECTED BY ENGINEER)

PROPOSED LEGEND

- (1) HOT-MIX ASPHALT SURFACE COURSE, IL-9.5, MIX "D", N50 1-1/2"
- POLYMERIZED HOT-MIX ASPHALT BINDER COURSE, IL-4.75, N50, 3/4"
- HOT-MIX ASPHALT BINDER COURSE, IL-19.0, N50, 3-3/4"
- (4) HOT-MIX ASPHALT BINDER COURSE, IL-19.0, N50, 2-1/4"
- PORTLAND CEMENT CONCRETE SIDEWALK, 5 INCH
- AGGREGATE BASE COURSE, TYPE B 4"
- CONCRETE GUTTER, TYPE A OR COMBINATION CONCRETE CURB AND GUTTER, TYPE 6
- CLASS D PATCHES, 10 INCH (AS DIRECTED BY ENGINEER)
- TOPSOIL FURNISH AND PLACE, 4"
 SEEDING, CLASS 2A, EROSION CONTROL BLANKET
- AGGREGATE BASE COURSE, TYPE B 10"


NOTE

- 1. THE LONGITUDINAL JOINT SEALANT SHALL BE PLACED ON THE POLYMERIZED HOT-MIX ASPHALT BINDER COURSE, IL-4.75, N50 PRIOR TO THE SURFACE
- 2. CLASS D PAVEMENT PATCHES SHALL BE PERFORMED AFTER MILLING.

EXISTING & ROADWAY -EXISTING € ROW 22 11.5' 3.5' SHOULDER SHOULDER_3 VARIES UNINI

EXISTING TYPICAL SECTION

CENTER STREET STA 55+03.50 TO STA 56+86.85

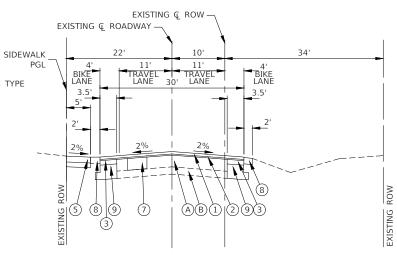

PROPOSED TYPICAL SECTION

CENTER STREET
STA 55+03.50 TO STA 56+86.85

HOT-MIX ASPHALT MIXTURE REQUIREMENTS

MIXTURE TYPE	AIR VOIDS @ Ndes	QMP						
ROADWAY RESURFACING								
HOT-MIX ASPHALT SURFACE COURSE, IL-9.5, MIX "D", N50, 1-1/2"	4% @ 50 Gyr.	LR 1030-2						
POLYMERIZED HOT-MIX ASPHALT BINDER COURSE, IL-4.75, N50, 3/4"	3.5% @ 50 Gyr.	LR 1030-2						
HOT-MIX ASPHALT MULTI-USE PATH								
HOT-MIX ASPHALT SURFACE COURSE, IL-9.5, MIX "D", N50 1-1/2"	4% @ 50 Gyr.	LR 1030-2						
HOT-MIX ASPHALT BINDER COURSE, IL-19.0, N50, 2-1/4"	4% @ 50 Gyr.	LR 1030-2						
HOT-MIX ASPHALT SHOULDER								
HOT-MIX ASPHALT SURFACE COURSE, IL-9.5, MIX "D", N50 1-1/2"	4% @ 50 Gyr.	LR 1030-2						
POLYMERIZED HOT-MIX ASPHALT BINDER COURSE, IL-4.75, N50, 3/4"	3.5% @ 50 Gyr.	LR 1030-2						
HOT-MIX ASPHALT BINDER COURSE, IL-19.0, N50, 3-3/4"	4% @ 50 Gyr.	LR 1030-2						
HMA DRIVEWAY PAVEMENT, 4"								
HOT-MIX ASPHALT SURFACE COURSE, IL-9.5, MIX "D", N50, 1-1/2"	4% @ 50 Gyr.	LR 1030-2						
HOT-MIX ASPHALT BINDER COURSE. IL-19.0, N50, 2-1/2"	4% @ 50 Gyr.	LR 1030-2						
PATCHING								
CLASS D PATCHES (HMA BINDER, IL-19.0, N50), 10"	4% @ 50 Gyr.	LR 1030-2						
QMP DESIGNATION: QUALITY CONTROL/QUALITY ASSURANCE (QC/QA) PER LR1030-2								


SCALE:

- 1. THE UNIT WEIGHT USED TO CALCULATE ALL HMA SURFACE MIXTURE IS 112 LBS/SQ/IN.
- 2. ALL PATCHING OPERATIONS SHALL TAKE PLACE AFTER SURFACE MILLING HAS BEEN
- 3. THE "AC TYPE" FOR POLYMERIZED HMA MIXES SHALL BE "SBS/SBR PG 76-22" AND FOR NON-POLYMERIZED HMA THE "AC TYPE" SHALL BE "PG-64-22" UNLESS MODIFIED BY RECLAIMED MATERIALS SPECIFICATIONS.


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		CHECKED — WPD	REVISED —
	PLOT SCALE =	DRAWN — RG	REVISED —
	PLOT DATE = 12-05-24	CHECKED — AG	REVISED —

STATE OF ILLINOIS DEPARTMENT OF TRANSPORTATION

CENTER STREET	F.A.U RTE. SECTION			COUNTY	TOTAL SHEETS	SHEET NO.		
ROADWAY RESURFACING AND PEDEST	1049	1049 22-00026-00-RS			COOK	49	8	
TYPICAL CROSS SEC	CONTRACT NO. 61L14					14		
SHEET NO 8 OF 40 SHEETS ST	TO STA	TER DOLD DIOT NO. 4 HUMOID TER AIR DROUGHT M				D DDG (FOT All 45 A	(507)	

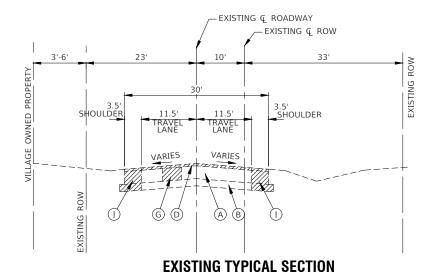

CENTER STREET STA 56+86.85 TO STA 64+13.79

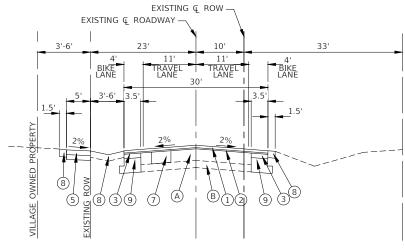

PROPOSED TYPICAL SECTION

CENTER STREET STA 56+86.85 TO STA 64+13.79

EXISTING LEGEND

- EXISTING HMA PAVEMENT, 5.5" TO 13.5"
- (B) EXISTING AGGREGATE SUBBASE, 6"±1"
- EXISTING AGGREGATE SUBBASE, 8"±1"
- (C) (D) HOT-MIX ASPHALT SURFACE REMOVAL, 2"
- FULL DEPTH PAVEMENT REMOVAL, 6"±1"
- GUTTER REMOVAL OR COMBINATION CONCRETE CURB AND GUTTER REMOVAL (AS DIRECTED BY THE ENGINEER)
- PAVEMENT REMOVAL FOR CLASS D PATCHES, 10 INCH
- \bigoplus GUARDRAIL
- Ĭ PAVED SHOULDER REMOVAL, 16"±1"


ITEM TO BE REMOVED (AS DIRECTED BY ENGINEER)

PROPOSED LEGEND

- HOT-MIX ASPHALT SURFACE COURSE, IL-9.5, MIX "D", N50 1-1/2"
- POLYMERIZED HOT-MIX ASPHALT BINDER COURSE, IL-4.75, N50, 3/4"
- HOT-MIX ASPHALT BINDER COURSE, IL-19.0, N50, 3-3/4"
- 4 HOT-MIX ASPHALT BINDER COURSE, IL-19.0, N50, 2-1/4"
- PORTLAND CEMENT CONCRETE SIDEWALK, 5 INCH
- AGGREGATE BASE COURSE, TYPE B 4"
- CONCRETE GUTTER, TYPE A OR COMBINATION CONCRETE CURB AND GUTTER, TYPE 6
- CLASS D PATCHES, 10 INCH (AS DIRECTED BY ENGINEER)
- 8
- TOPSOIL FURNISH AND PLACE, 4" SEEDING, CLASS 2A, EROSION CONTROL BLANKET
- AGGREGATE BASE COURSE, TYPE B 10"


NOTE

- 1. THE LONGITUDINAL JOINT SEALANT SHALL BE PLACED ON THE POLYMERIZED HOT-MIX ASPHALT BINDER COURSE, IL-4.75, N50 PRIOR TO THE SURFACE
- 2. CLASS D PAVEMENT PATCHES SHALL BE PERFORMED AFTER MILLING.

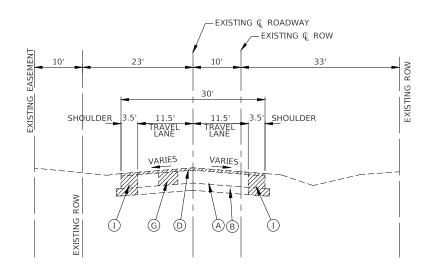

EXISTING TYPICAL SECTION

CENTER STREET STA 64+13.79 TO STA 67+11.74

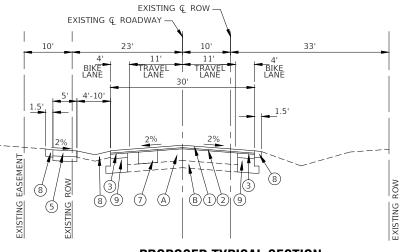

PROPOSED TYPICAL SECTION

CENTER STREET STA 64+13.79 TO STA 67+11.74


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	PLOT SCALE =	DRAWN — RG	REVISED —	
	PLOT DATE = 12-05-24	CHECKED — AG	REVISED —	

STATE OF ILLINOIS DEPARTMENT OF TRANSPORTATION

SCALE:


CENTER STREET							
ROADWAY RESURFACING AND PEDESTRIAN ACCOMODATIONS							
TYPICAL CROSS SECTIONS							
	OUEET NO. 0	05.40	OLIFETO	0.7.4	TO 0T4	_	

F.A.U RTE.		SEC	TION	COUN	NTY	TOTAL SHEETS	SHEE NO.	
1049		22-000	26-00-RS		coc	K	49	9
					CONTR	RACT	NO. 61L	14
FED BO	AD DIST NO	າ 1	ILLINOIS	AID PROJECT NIMEA/507)				

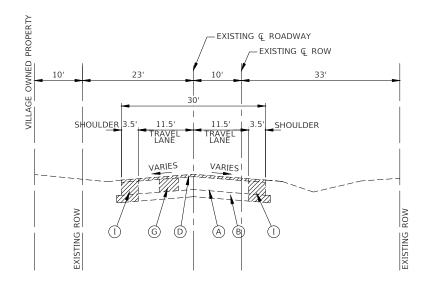

EXISTING TYPICAL SECTION

CENTER STREET STA 67+11.74 TO STA 70+27.00

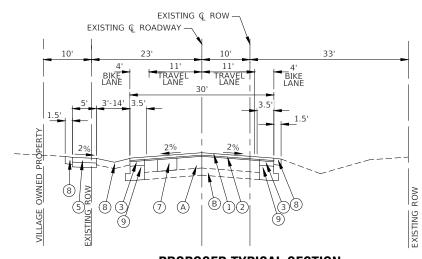


PROPOSED TYPICAL SECTION NOTE: PROPOSED SIDEWALK ENDS AT STA 70+73.16

CENTER STREET STA 67+11.74 TO STA 70+27.00

EXISTING LEGEND

- EXISTING HMA PAVEMENT, 5.5" TO 13.5"
- EXISTING AGGREGATE SUBBASE, 6"±1"
- EXISTING AGGREGATE SUBBASE, 8"±1"
- HOT-MIX ASPHALT SURFACE REMOVAL, 2"
- FULL DEPTH PAVEMENT REMOVAL, 6"±1"
- GUTTER REMOVAL OR COMBINATION CONCRETE CURB AND GUTTER REMOVAL (AS DIRECTED BY THE ENGINEER)
- PAVEMENT REMOVAL FOR CLASS D PATCHES, 10 INCH
- (H)GUARDRAIL
- PAVED SHOULDER REMOVAL, 16"±1"
- ITEM TO BE REMOVED (AS DIRECTED BY ENGINEER)

−EXISTING Q ROW 31' TRAVEL LANE TRAVEL SHOULDE VARIES VARIES \oplus H (A)(B) EXISTING

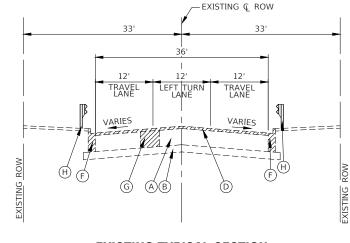

PROPOSED LEGEND

- HOT-MIX ASPHALT SURFACE COURSE, IL-9.5, MIX "D", N50 1-1/2"
- POLYMERIZED HOT-MIX ASPHALT BINDER COURSE, IL-4.75, N50, 3/4"
- HOT-MIX ASPHALT BINDER COURSE, IL-19.0, N50, 3-3/4"
- HOT-MIX ASPHALT BINDER COURSE, IL-19.0, N50, 2-1/4"
- PORTLAND CEMENT CONCRETE SIDEWALK, 5 INCH (5) AGGREGATE BASE COURSE, TYPE B 4"
- CONCRETE GUTTER, TYPE A OR COMBINATION CONCRETE CURB AND GUTTER, TYPE 6
- 7 CLASS D PATCHES, 10 INCH (AS DIRECTED BY ENGINEER)
- TOPSOIL FURNISH AND PLACE, 4"
 SEEDING, CLASS 2A, EROSION CONTROL BLANKET
- AGGREGATE BASE COURSE, TYPE B 10"

NOTE


- THE LONGITUDINAL JOINT SEALANT SHALL BE PLACED ON THE POLYMERIZED HOT-MIX ASPHALT BINDER COURSE, IL-4.75, N50 PRIOR TO THE SURFACE COURSE.
- 2. CLASS D PAVEMENT PATCHES SHALL BE PERFORMED AFTER


EXISTING TYPICAL SECTION

CENTER STREET STA 70+27.00 TO STA 74+52.00

EXISTING TYPICAL SECTION

CENTER STREET STA 74+52.00 TO STA 76+92.09

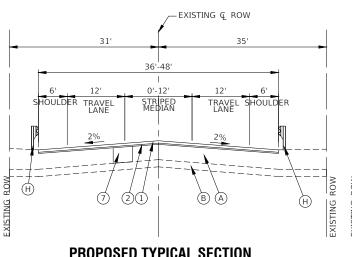

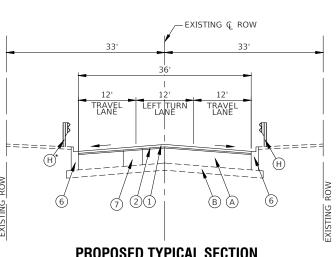

PROPOSED TYPICAL SECTION

CENTER STREET STA 70+27.00 TO STA 74+52.00

SCALE:

PROPOSED TYPICAL SECTION CENTER STREET


STA 74+52.00 TO STA 76+92.09 *EXISTING WEST GUARD RAIL ENDS AT STATION 75+73.


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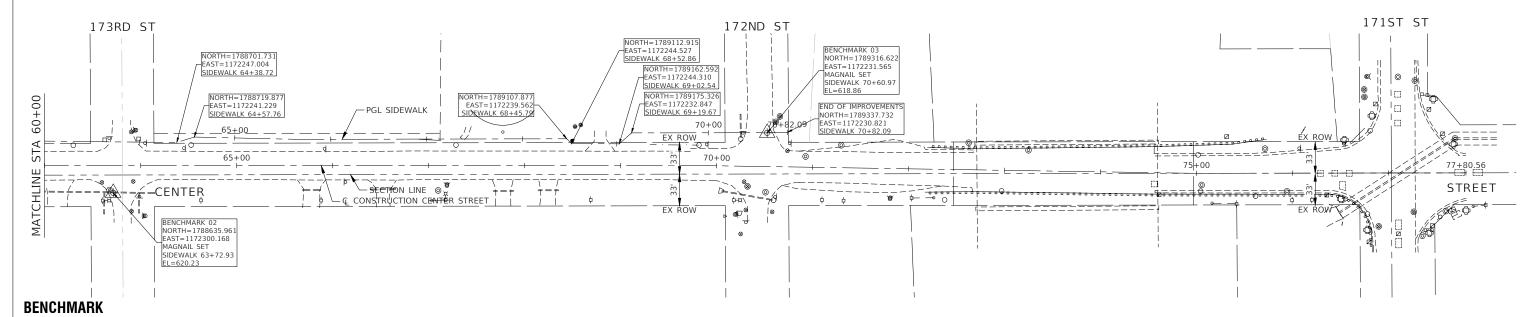
STATE OF ILLINOIS DEPARTMENT OF TRANSPORTATION

CENTER STREET								
ROADWAY RESURFACING AND PEDESTRIAN ACCOMODATIONS								
TYPICAL CROSS SECTIONS								
OUTET NO 40 OF 40 OUTETO	074 70 074							

SECTION 22-00026-00-RS COOK 49 CONTRACT NO. 61L14



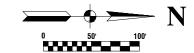

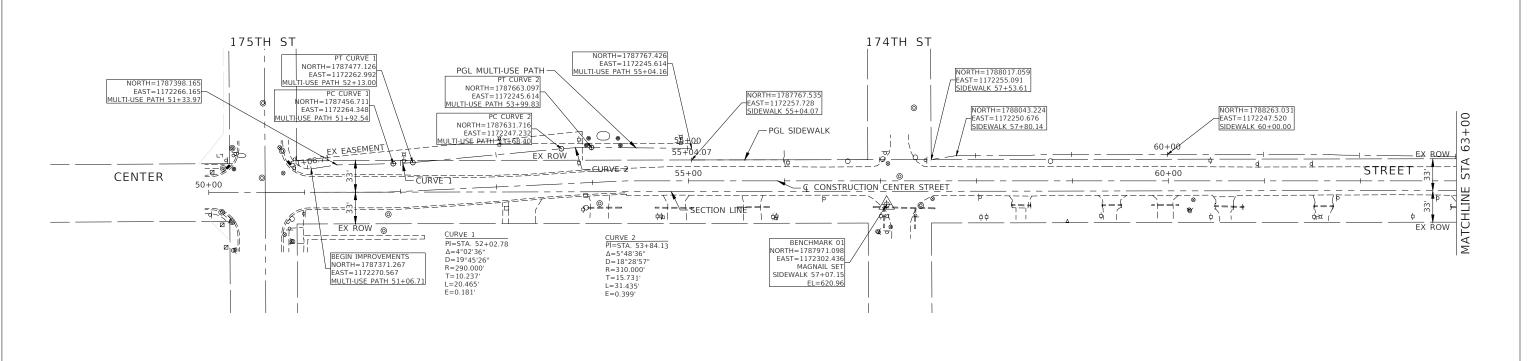

BM-01
MAGNAIL SET IN PAVEMENT AT SOUTHEAST INTERSECTION OF 174TH STREET AND CENTER STREET


BM-02 MAGNAIL SET IN PAVEMENT AT SOUTHEAST INTERSECTION OF 173RD STREET AND CENTER STREET


BM-03 MAGNAIL SET IN PAVEMENT AT NORTHWEST INTERSECTION OF 172ND STREET AND CENTER STREET EL=618.86


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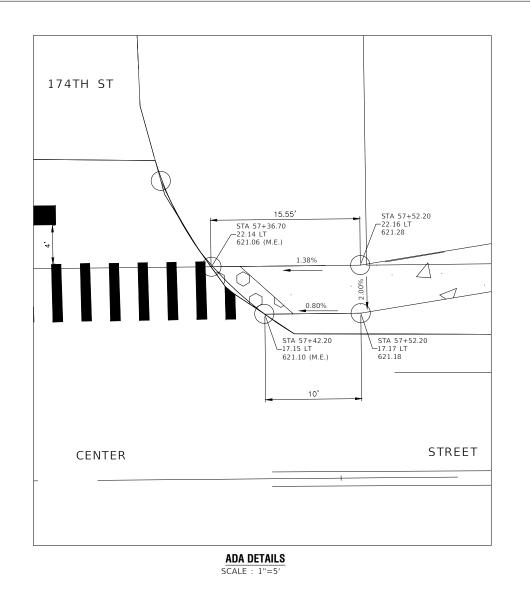
STATE OF ILLINOIS DEPARTMENT OF TRANSPORTATION


	CENTER STREET						COUNTY	TOTAL SHEETS	SHEET NO.
ROADWAY	ROADWAY RESURFACING AND PEDESTRIAN ACCOMODATIONS						соок	49	11
	ALIGNMENT AND TIES						CONTRACT	NO. 61L1	4
SCALE: NONE S	SHEET NO. 11 OF 49 SHEETS	STA. 50+75.65 TO STA. 76+92.09	FED. ROAD DIST. NO. 1 ILLINOIS FED. AID PROJECT 1			D PROJECT NM5A	(507)		



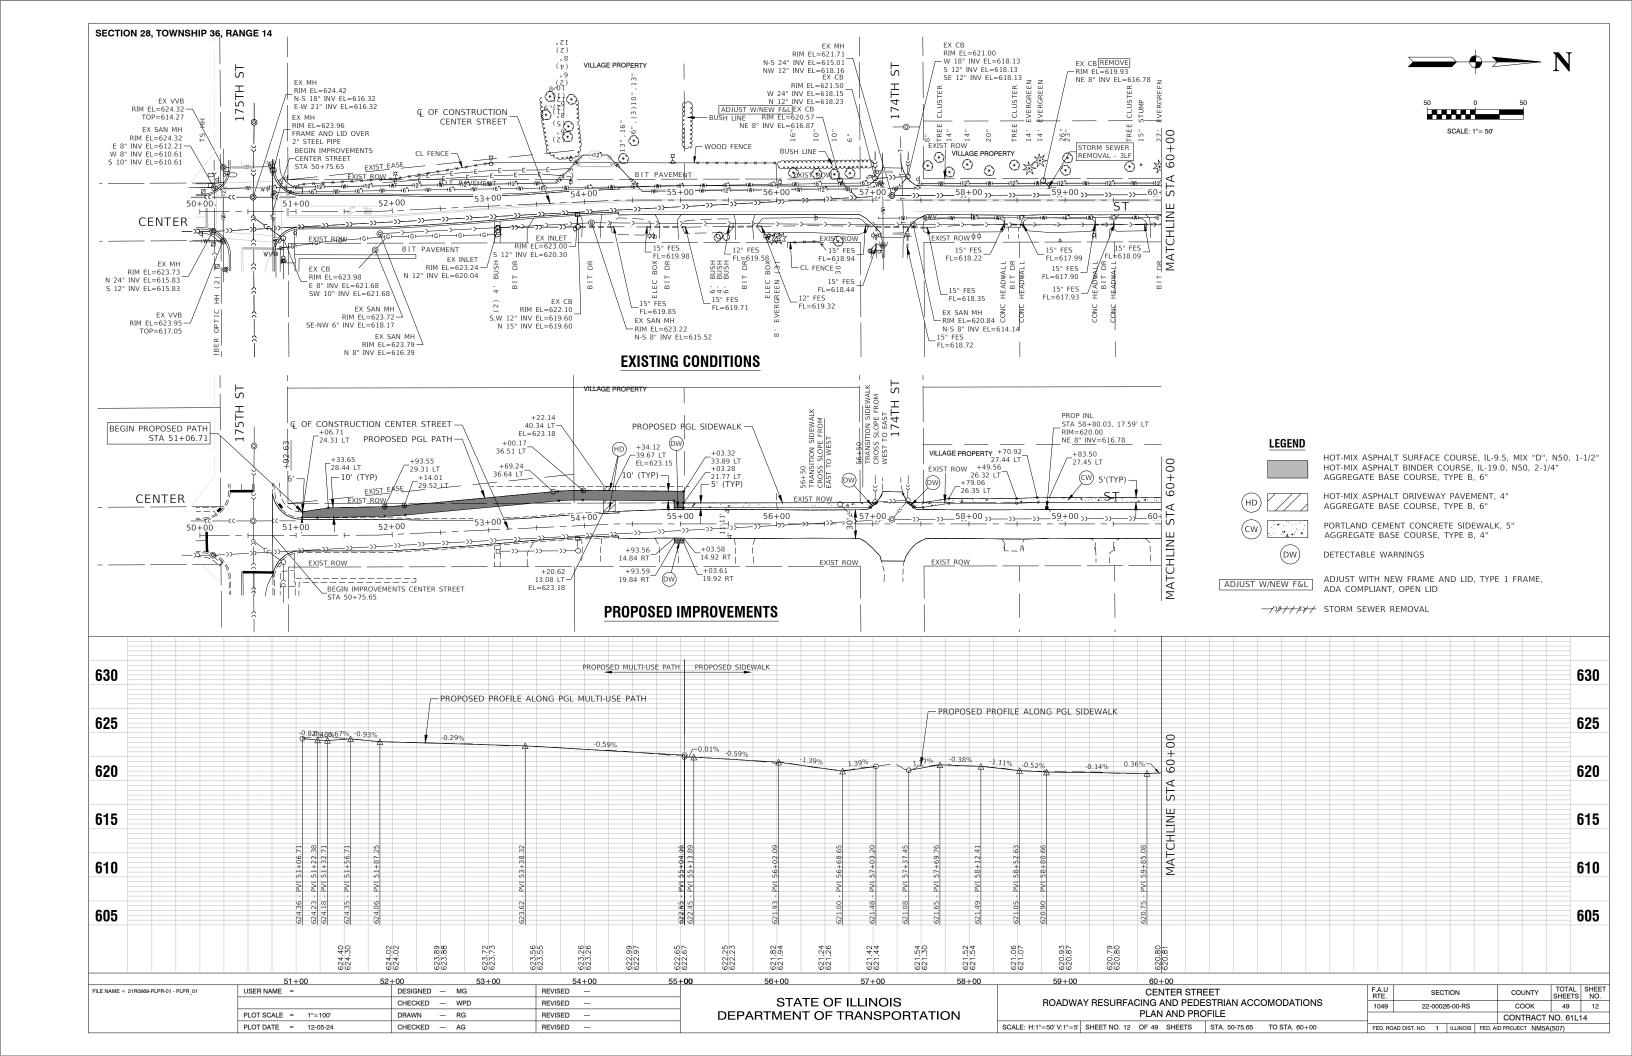

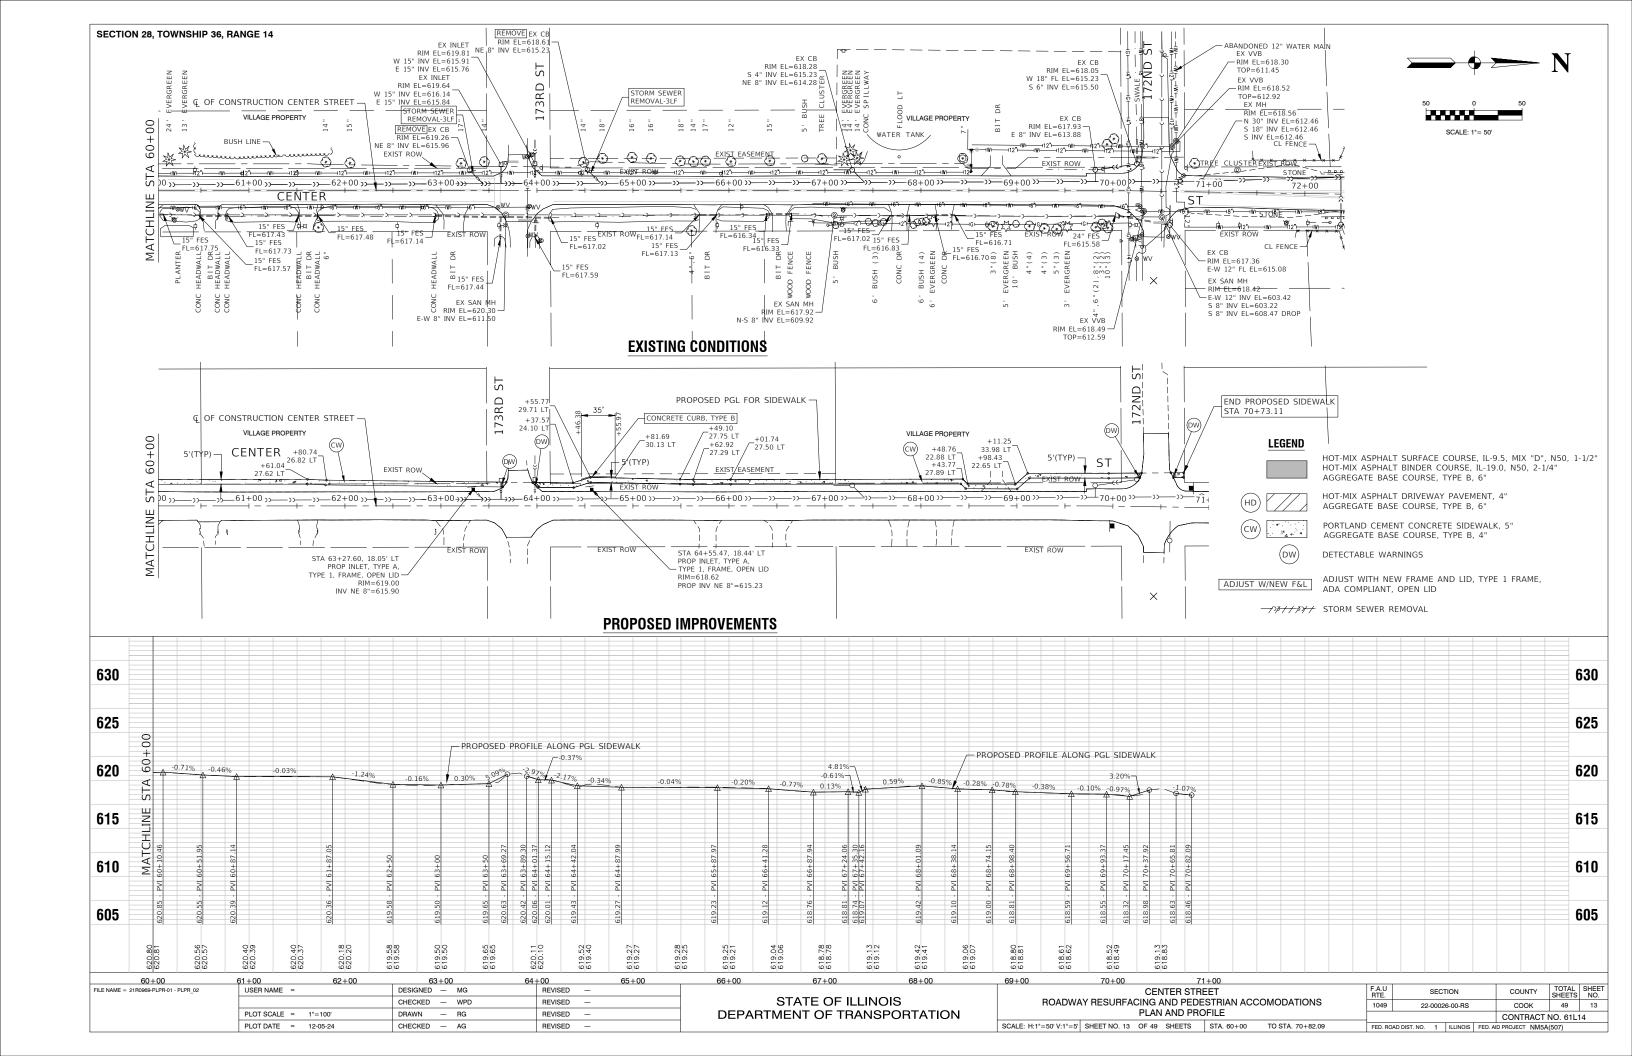


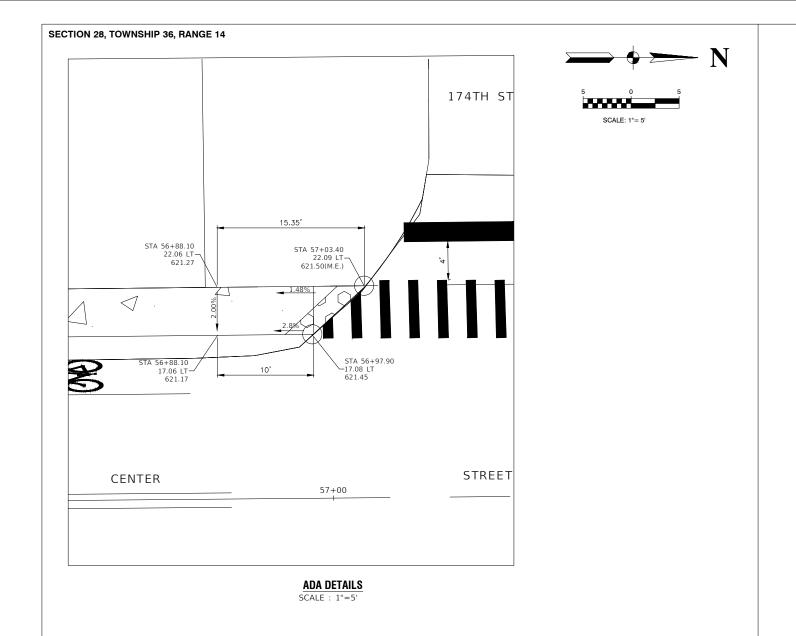

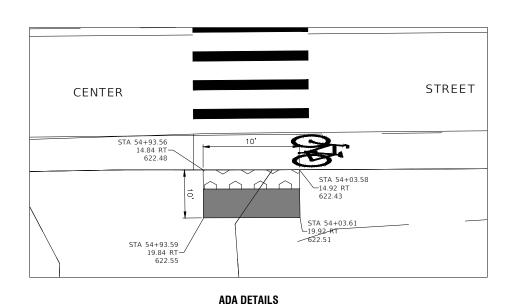


SCALE : 1"=5'

	CENTER STREET							COUNTY	TOTAL SHEETS	SHEET NO.
ROADWA	ROADWAY RESURFACING AND PEDESTRIAN ACCOMODATIONS ADA DETAIL SHEET					22-00026-00-RS		COOK 49		14
								CONTRACT	NO. 61L	14
SCALE: 1"=5'	SHEET NO. 14 OF 49 SHEETS	STA.	TO STA.	FED. RO	AD DIST. NO. 1	ILLINOIS	FED. Al	D PROJECT NM5A	(507)	

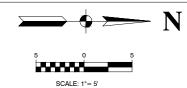






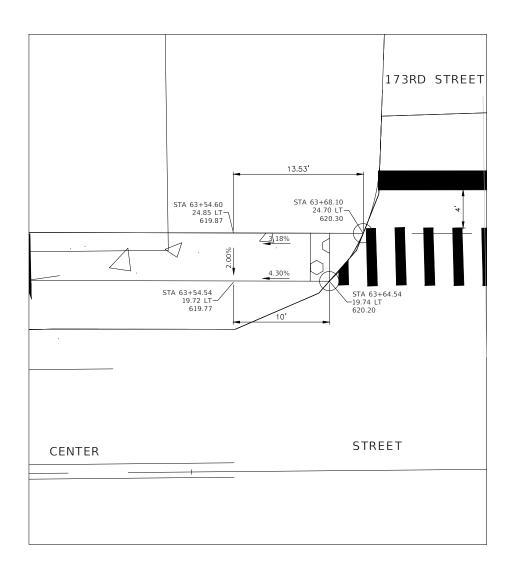



ADA DETAILS
SCALE : 1"=5'

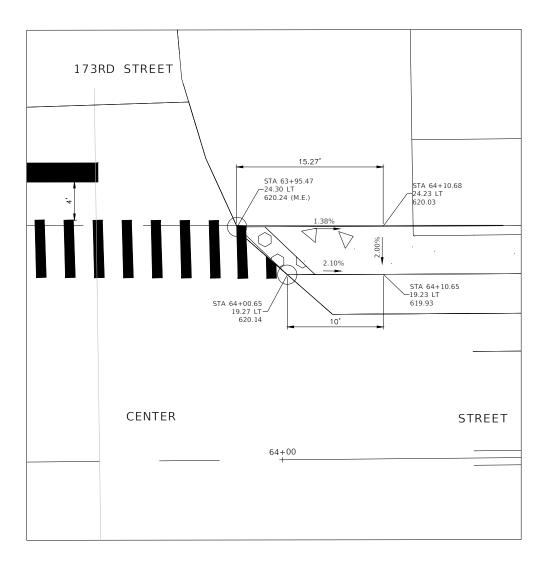


ADA DETAILS SCALE : 1"=5'

FILE NAME = 21R0969-PLPR-01 - ADA DETAILS (2)	USER NAME =	DESIGNED — MG	REVISED —		CENTER STREET	F.A.U RTE	SECTION	COUNTY	TOTAL SHEETS	SHEET
		CHECKED — WPD	REVISED —	STATE OF ILLINOIS	ROADWAY RESURFACING AND PEDESTRIAN ACCOMODATIONS ADA DETAIL SHEET		22-00026-00-RS	соок	49	15
	PLOT SCALE =	DRAWN — RG	REVISED —	DEPARTMENT OF TRANSPORTATION				CONTRACT	NO. 61L	14
	PLOT DATE = 12-05-24	CHECKED — AG	REVISED —		SCALE: 1"=5" SHEET NO. 15 OF 49 SHEETS STA. TO STA.	FED. ROAD	D DIST. NO. 1 ILLINOIS FED. A	AID PROJECT NM5A	A(507)	

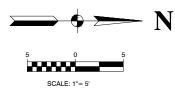

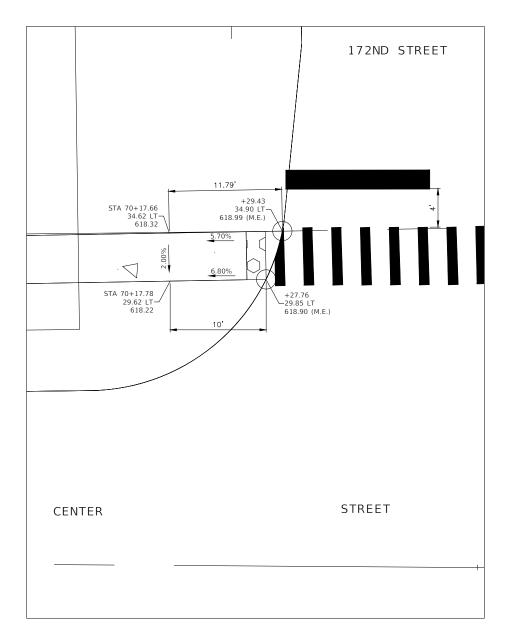




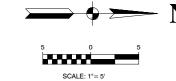


COUNTY TOTAL SHEET NO.
COOK 49 16


CONTRACT NO. 61L14

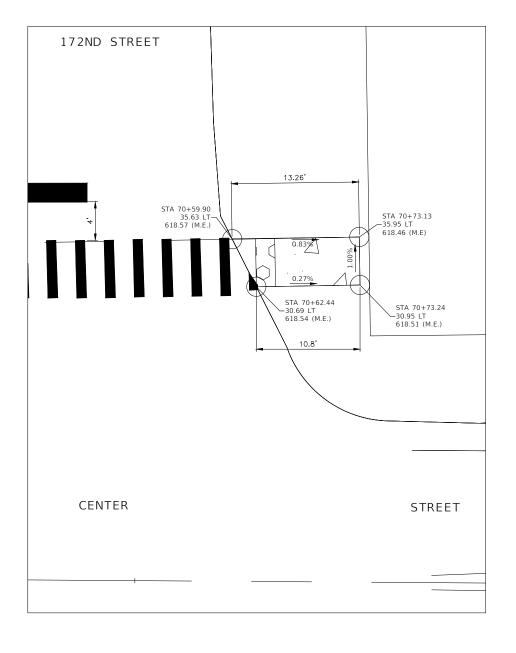

ADA DETAILS SCALE : 1"=5'

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		CHECKED — WPD	REVISED —	STATE OF ILLINOIS ROADWAY RESURFACING AND PEDESTRIAN ACCOMODATIONS				ONS	1049	22-00026-00-RS	соок	49		
	PLOT SCALE =	DRAWN — RG	REVISED —	DEPARTMEN ⁻	OF TRANSPORTATION	ADA DETAIL SHEET					CONTRAC	CT NO. 61L		
	PLOT DATE = 12-05-24	CHECKED — AG	REVISED —			SCALE: 1"=5'	SHEET NO. 16 OF 49 SHEETS STA. TO STA.		FED. ROAD	DIST. NO. 1 ILLINOIS FE	D. AID PROJECT NN	√15A(507)		

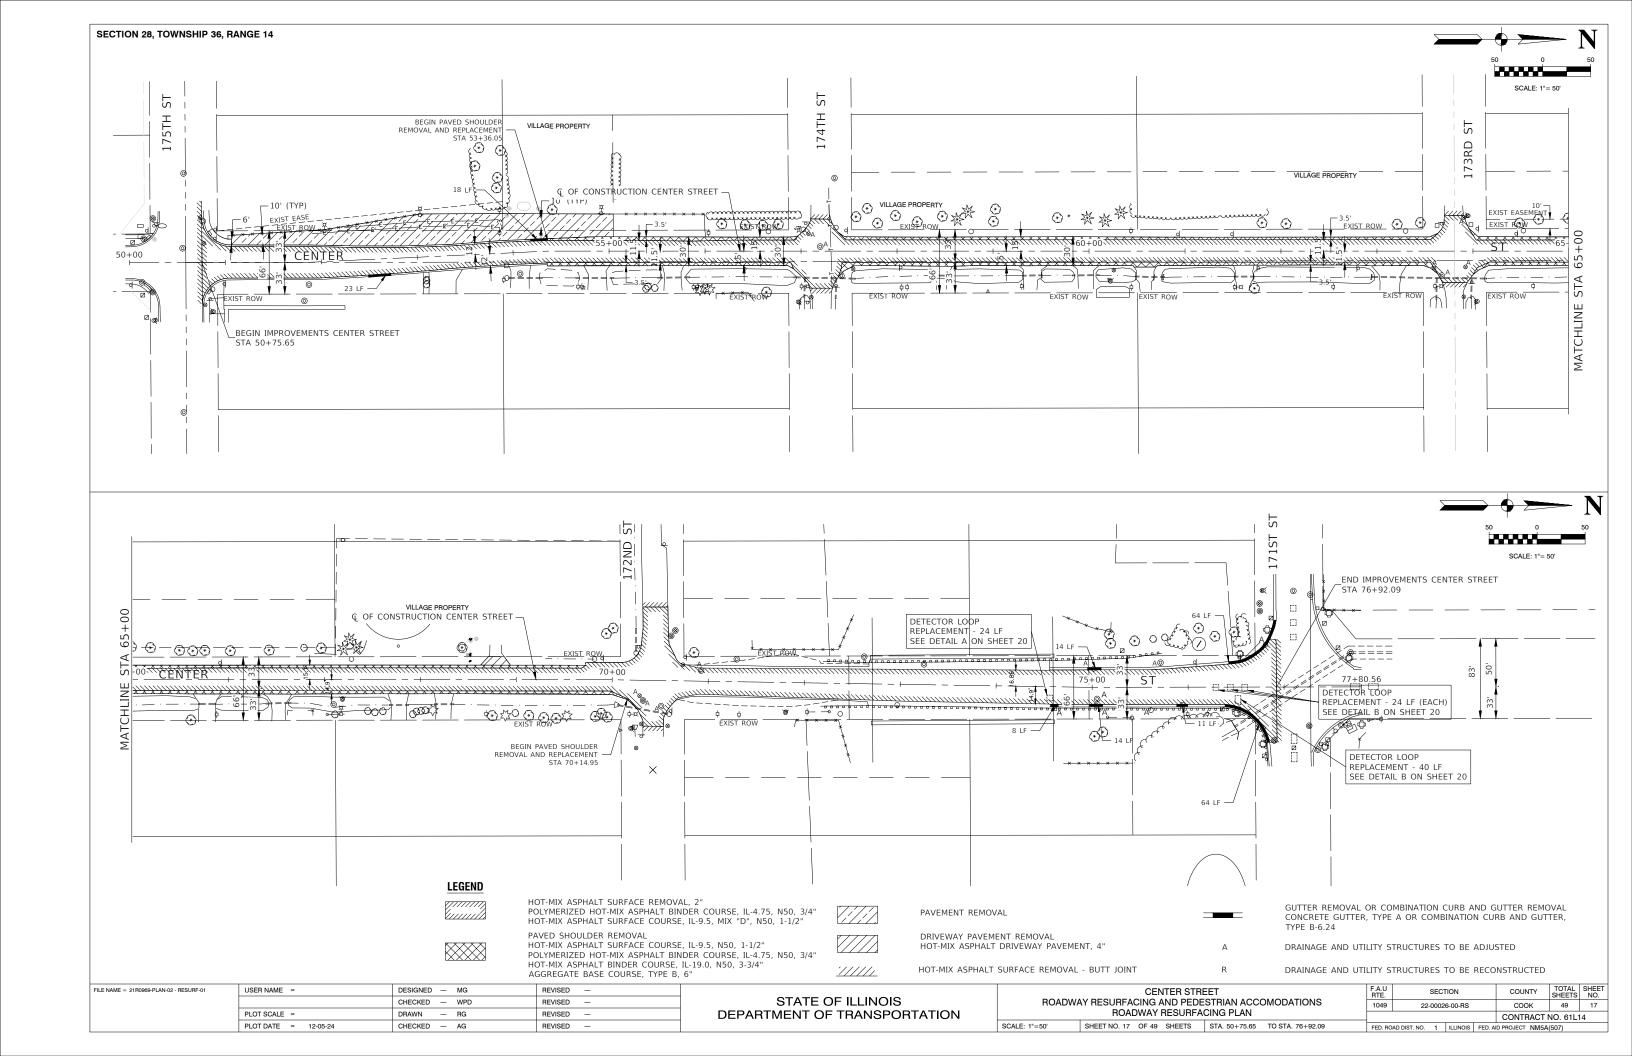

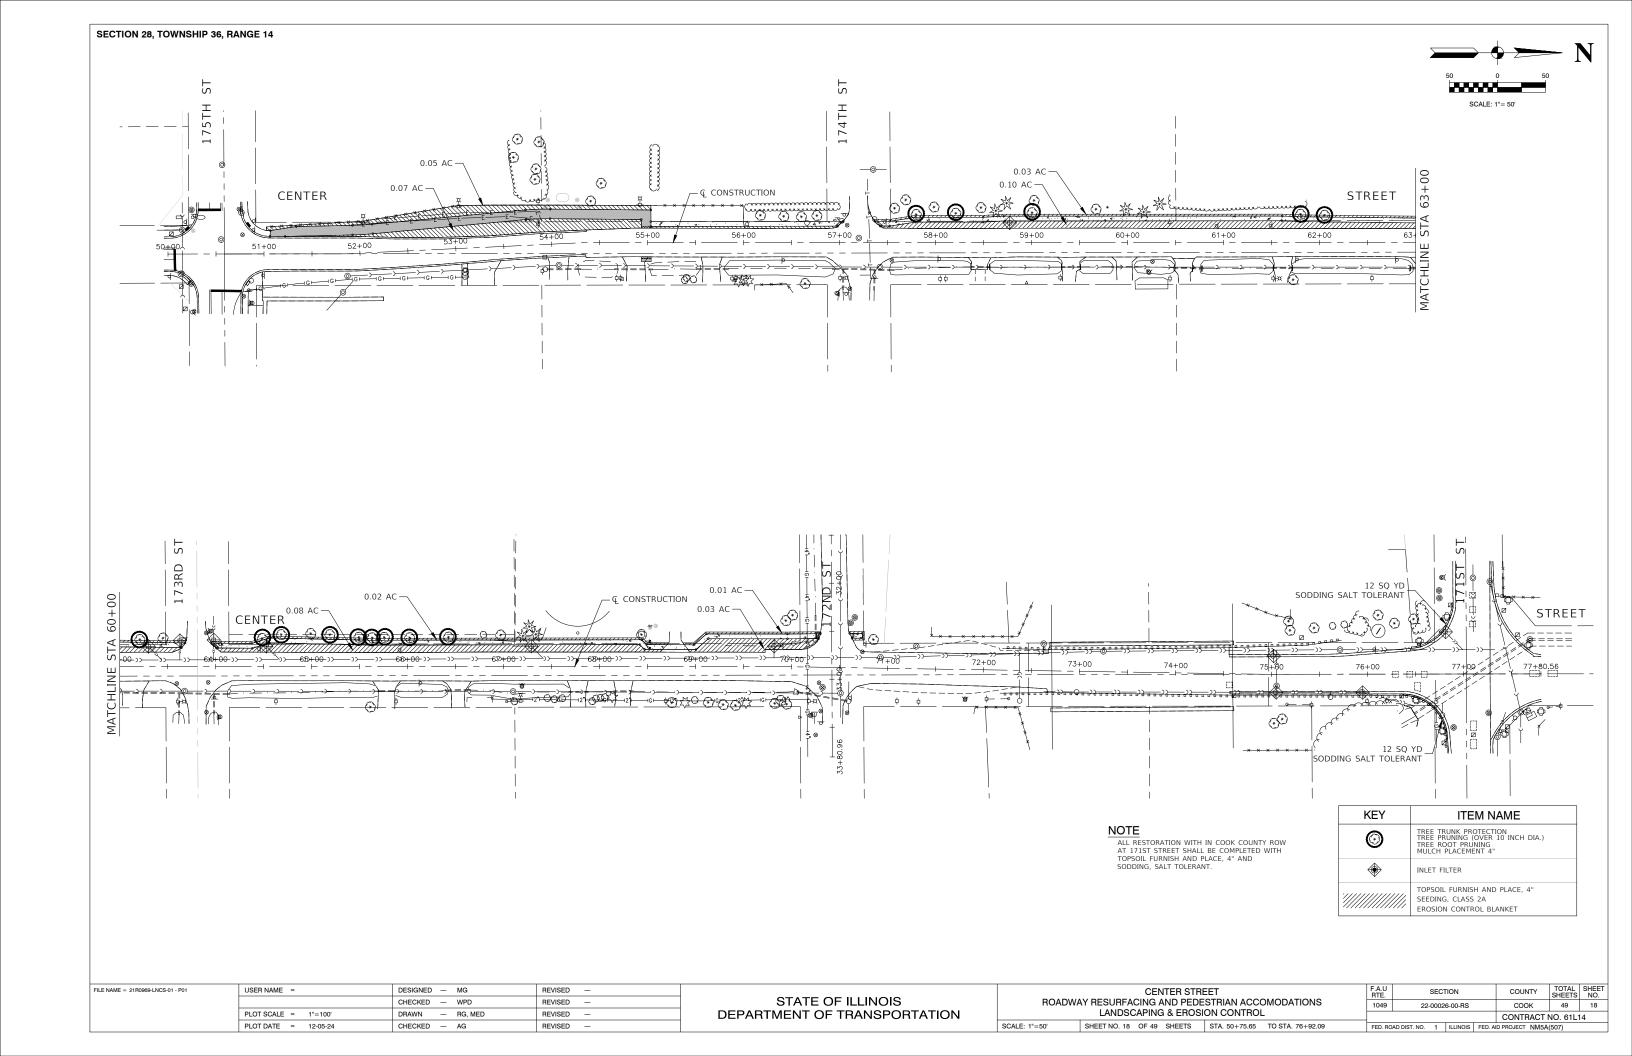

ļ	USER NAME =	DESIGNED — MG	REVISED —	07177 07 11 11 10 10		CENTER STREET			F.A.U RTE.	SECTION	ON (COUNTY	SHEETS	SHEE NO.
		CHECKED — WPD	REVISED —	STATE OF ILLINOIS	ROADWAY RESURFACING AND PEDESTRIAN ACCOMODATIONS PAVEMENT MARKING AND SIGNAGE PLAN				1049	22-00026-	00-RS	соок	49	19
	PLOT SCALE =	DRAWN — RG,MED	REVISED —	DEPARTMENT OF TRANSPORTATION			.N			CC	ONTRACT N	NO. 61L	14	
	PLOT DATE = 12-05-24	CHECKED — AG	REVISED —		SCALE: 1"=50"	SHEET NO. 19 OF 49 SHEETS	STA. 50+75.65	TO STA. 69+00	FED. ROAD DI	ST. NO. 1	LINOIS FED. AID PRO	DJECT NM5A((507)	-

FILE NAME = 21R0969-PVMK-01 - P01



AHEAD R3-17aP 24"X12" 19.5' POST

A



ENDS R3-17bp 24"X9" 19.5' POST

B


AHEAD R3-17aP 24"X12" 14' POST (C)




ENDS


R3-17bp 24"X9" 14' POST D


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		CHECKED — WPD	REVISED —	STATE OF ILLINOIS ROADWAY RESURFACING AND PEDESTRIAN ACCOMODATIONS		ROADWAY RESURFACING AND PEDESTRIAN ACCOMODATIONS		ROADWAY RESURFACING AND PEDESTRIAN ACCOMODATIONS		1049	22-00026-00-RS	соок	49	20
	PLOT SCALE = 1"=100"	DRAWN — RG,MED	REVISED —	DEPARTMENT OF TRANSPORTATION	PAVEMENT MARKING AND SIGNAGE PLAN SCALE: 1'=50' SHEET NO. 20 OF 49 SHEETS STA. 69+00 TO STA. 76+92.04		LAN			CONTRACT N	NO. 61L	14		
	PLOT DATE = 12-05-24	CHECKED — AG	REVISED —				SCALE: 1'=50' SHEET NO. 20 OF 49 SHEETS STA. 69+00 TO STA. 76+92.04 FED. F		FED. ROAD DIS	ST. NO. 1 ILLINOIS FED.	ID PROJECT NM5A((507)		

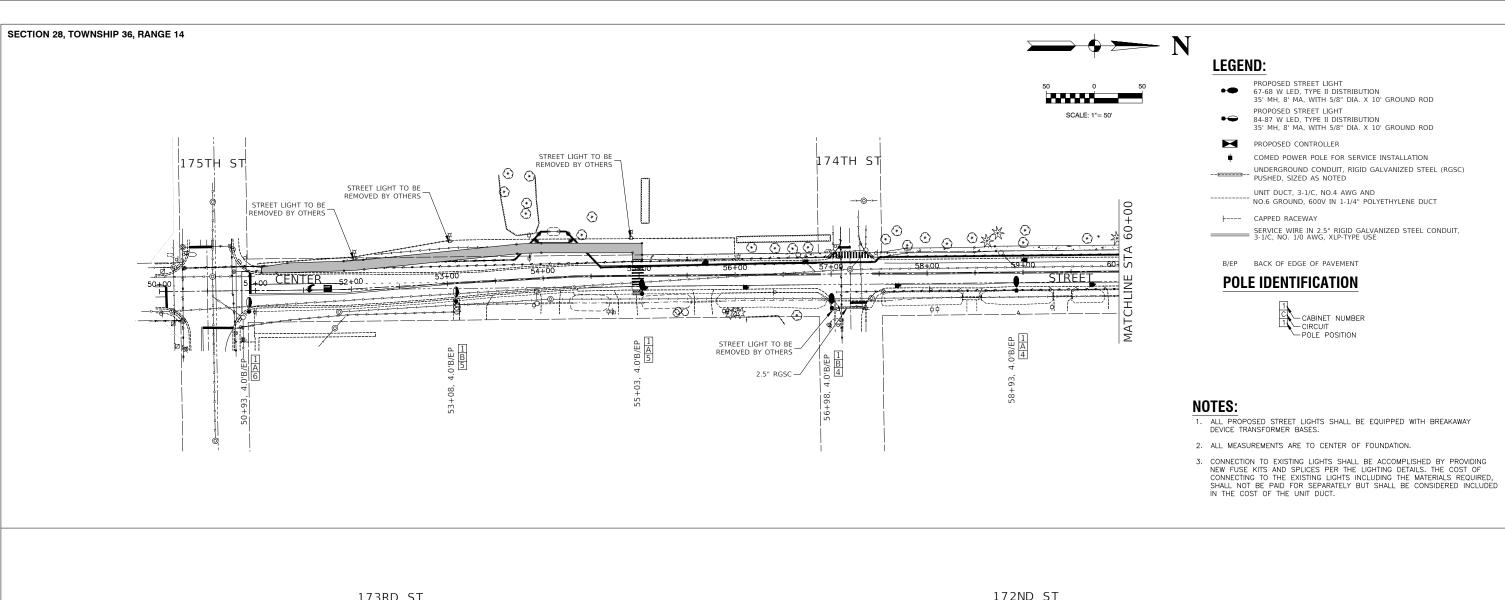

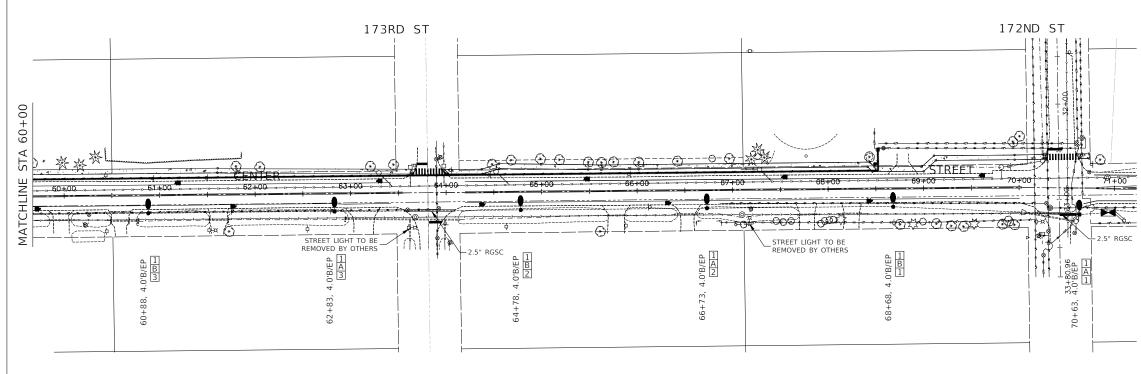


FILE NAME = 21R0969-LGHT-01 - IDOT P01 USER NAME = CENTER STREET DESIGNED - MG REVISED SECTION COUNTY STATE OF ILLINOIS CHECKED - WPD REVISED ROADWAY RESURFACING AND PEDESTRIAN ACCOMODATIONS 1049 22-00026-00-RS COOK 49 21 PLOT SCALE = 1"=100' DRAWN - MED REVISED DEPARTMENT OF TRANSPORTATION STREET LIGHTING PLANS CONTRACT NO. 61L14 SCALE: 1"=50' SHEET NO. 21 OF 49 SHEETS STA. 50+75.65 TO STA. 71+50 PLOT DATE = 12-05-24 CHECKED - AG REVISED

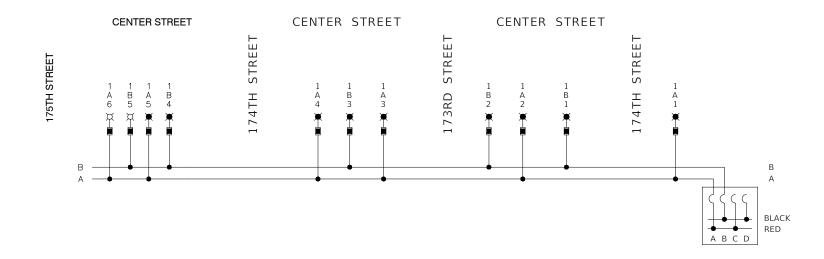

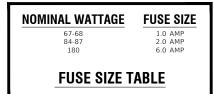

TYPICAL CIRCUIT WIRING

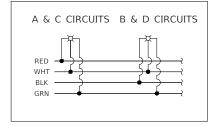

CABINET 1 - CENTER STREET							
CIRCUIT	WATTS		AMPS @ 240V				
		RED PHASE	BLACK PHASE				
А	427	3.56					
В	359			2.99			
С	0	0.00					
D	0			0.00			
SUBTOTAL	786	3.56	2.99				
ТОТА	L AMPS	@ 120 V	6.55				

INDIVIDUAL LOAD DATA INPUT VOLTS MAX INPUT AMPS INPUT WATTS 120.00 0.60 67-68 120.00 0.70 84-87


NOTES

1. EQUIPMENT GROUND CONDUCTORS SHALL BE SPLICED AND BOUNDED AT EACH LIGHT POLE OR OTHER EQUIPMENT.

LEGEND

- ₩ PROPOSED LUMINAIRE, 67-68W LED
- M PROPOSED LUMINAIRE, 84-87W LED
- PROPOSED FUSE REFER TO FUSE SIZE TABLE
- A LUMINAIRE CIRCUIT, 120V
- ζ CIRCUIT BREAKER
- CONNECTION

FILE NAME = 21R0969-LGHT-01 - IDOT P02 (2)	USER NAME =	DESIGNED — MG	REVISED —		CENTER STREET ROADWAY RESURFACING AND PEDESTRIAN ACCOMODATIONS SINGLE LINE WIRING DIAGRAM		SECTION	COUNTY	TOTAL	SHEET
		CHECKED — WPD	REVISED —	STATE OF ILLINOIS			22-00026-00-RS	соок	49	22
	PLOT SCALE =	DRAWN — ACAD	REVISED —	DEPARTMENT OF TRANSPORTATION				CONTRACT	NO. 61L1	4
	PLOT DATE = 12-05-24	CHECKED — ACAD	REVISED —		SCALE: SHEET NO. 22 OF 49 SHEETS STA. TO STA.	FFD. BOA	AD DIST, NO. 1 ILLINOIS FED.	AID PROJECT NM5		

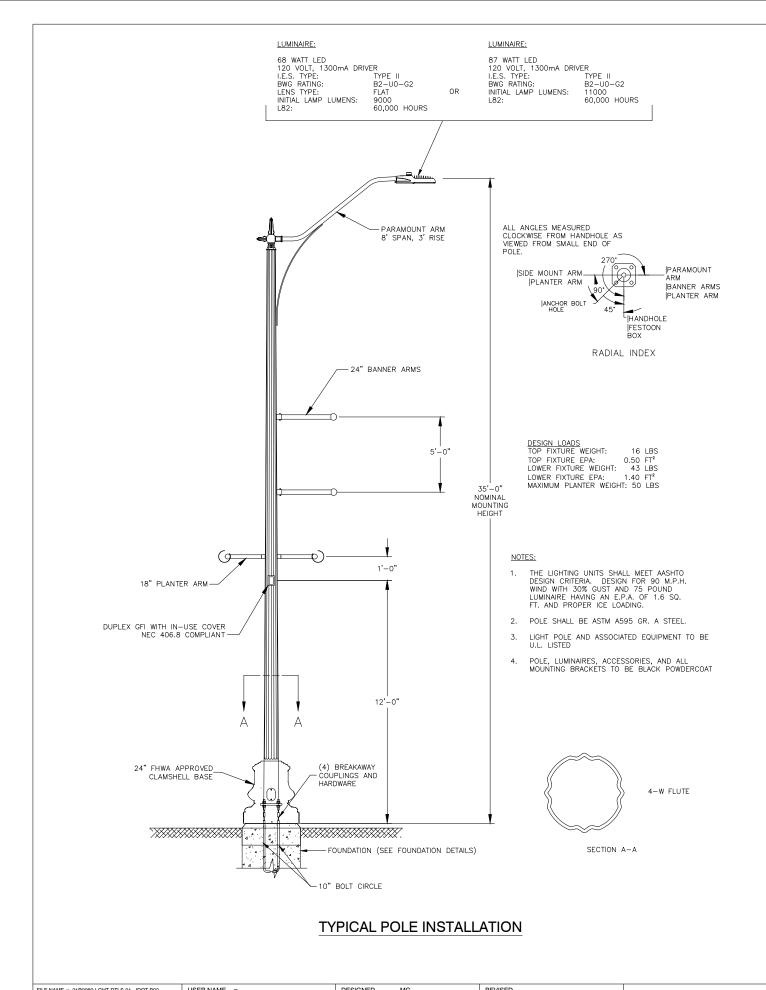



H0909-LGH1-D1L5-01 - IDO1 P02	USER NAME =	DESIGNED — MG	HEVISED —	
		CHECKED — WPD	REVISED —	
	PLOT SCALE =	DRAWN — MED	REVISED —	
	PLOT DATE = 12-05-24	CHECKED — APG	REVISED —	

STATE OF ILLINOIS DEPARTMENT OF TRANSPORTATION

SCALE:

CENTER STREET ROADWAY RESURFACING AND PEDESTRIAN ACCOMODATIONS 174TH STREET LIGHTING DETAILS			F.A.U RTE.	F.A.U RTE. SECTION		COUNTY	TOTAL SHEETS	SHEET NO.			
			1049	22-00026-00-RS		соок	49	23			
							CONTRACT	NO. 61L1	4		
s	SHEET NO. 23 OF 49	SHEETS	STA.	TO STA.	FED. R	FED. ROAD DIST. NO. 1 ILLINOIS FED. A			ID PROJECT NM5A(507)		

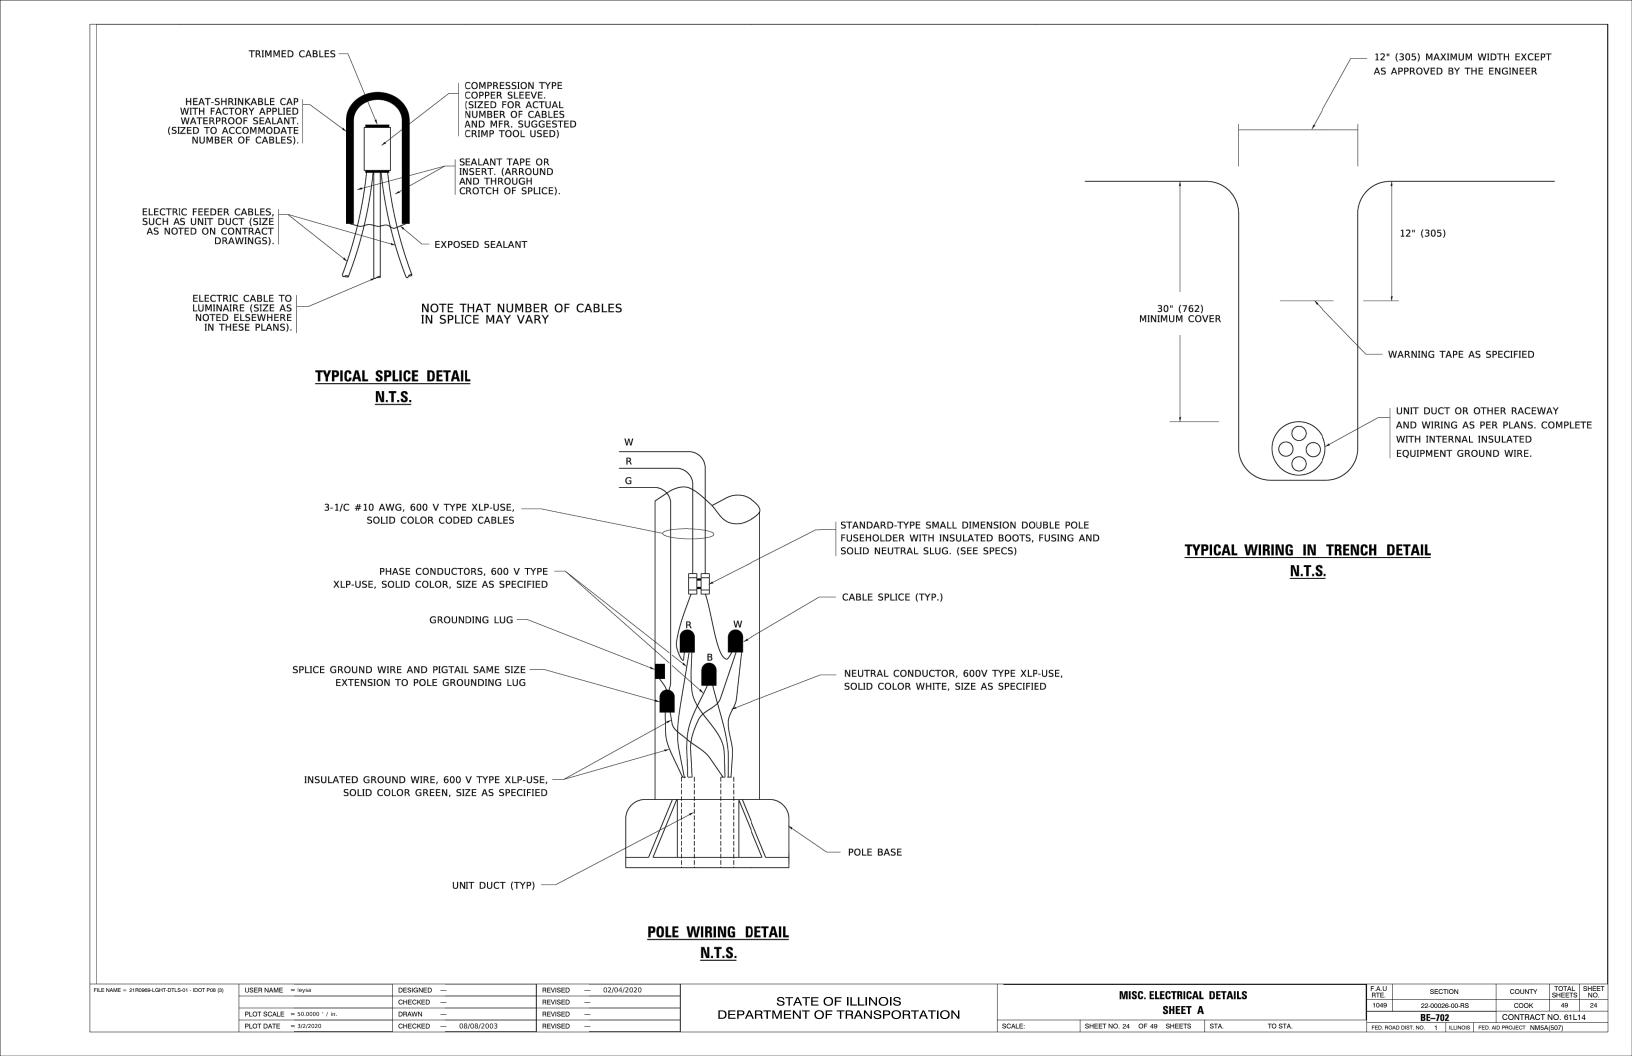

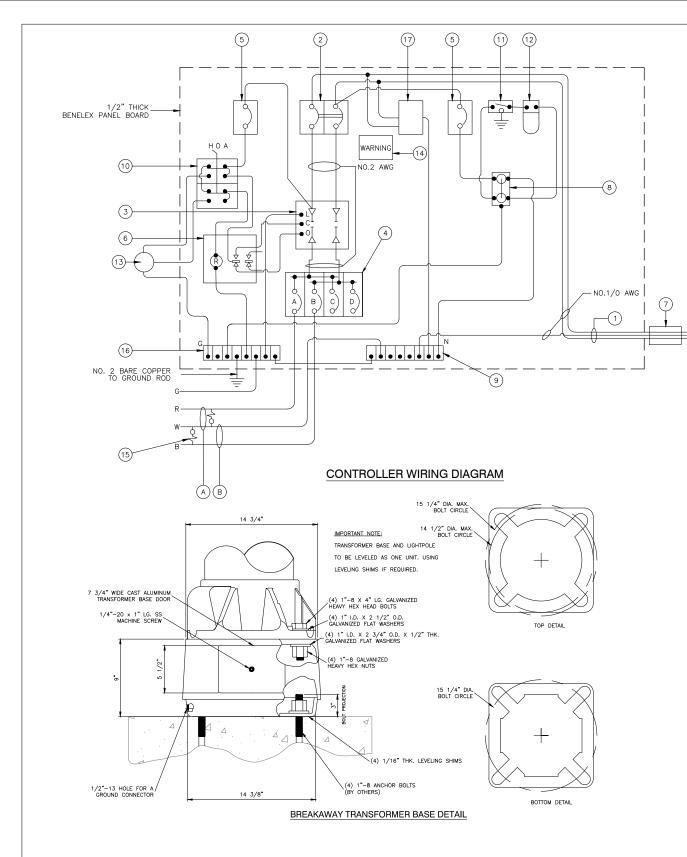

CONTROLLER WIRING DIAGRAM LEGEND

- \bigcirc 3-1/C, NO. 1/O, 600V SERVICE WIRE IN 2.5" DIA. GALVANIZED STEEL CONDUIT FOR 120/240 VOLT, 10, 3 WIRE, 60HZ. SERVICE.
- (1) 100 AMP MAIN CIRCUIT BREAKER, 2 POLE, 600 VOLT, 100 AMP BASE, NON-INTERCHANGEABLE TRIP INTERRUPTING RATING NEMA 14000 AMP AT 480 V.
- (1) 100 AMP REMOTE CONTROL CONTACTOR SWITCH, ELECTRICALLY OPERATED, MECHANICALLY HELD, 2 POLE, 600 VOLT
- (4) 30 AMP CIRCUIT BREAKER, 1 POLE, 120 VOLT, 100 AMP BASE, NON-INTER-CHANGEABLE TRIP RATING NEMA 14000 AMP AT 240 VOLTS.
- (2) 20 AMP CONTROL CIRCUIT—CIRCUIT BREAKER, 1 POLE, 120 VOLT, 100 AMP
 BASE, NON—INTERCHANGEABLE TRIP INTERRUPTING RATING NEMA 14000 AMP AT 240 V.
- (1) 20 AMP, 1 POLE DOUBLE THROW, 120 VOLT RELAY
- 7) METER SOCKET, 1ø, 3 WIRE, 100A
- (1) 20 AMP, 120 VOLT DUPLEX GFCI RECEPTACLE MOUNTED IN BOX.
- 9) NEUTRAL BUS BAR, 1/4"x1"x12" MINIMUM LENGTH MOUNTED ON PANEL WITH LUGS.
- (10) 3 POSITION SELECTOR SWITCH, 120V.
- (11) SWITCH FOR LIGHTING FIXTURE MOUNTED IN BOX, 20 AMP.
- (12) WEATHER-PROOF LIGHTING FIXTURE WITH 1600 LUMEN, 120 V LED LAMP.
- PHOTOCELL MOUNTED TO CABINET, 120 V. 1000 VA BALLAST RATING, 1-4 FC ON 3-12 FC OFF, 30 SECOND MINIMUM DELAY.
- (14) WARNING PLATE TO READ: WARNING, MAINTENANCE CIRCUIT IS LIVE WHEN MAIN BREAKER IS SWITCHED OFF
- (15) IN-LINE FUSEHOLDER WITH FUSE AS NOTED IN FUSE TABLE
- GROUND BUS BAR 1/4"x1"x12" MINIMUM LENGTH MOUNTED ON PANEL WITH LUGS
- SURGE ARRESTER, UL LISTED, NEC 280 COMPLIANT, 10, 3 WIRE 60 HZ. MAX. 3,405 JOULES
- A CIRCUIT (RED)
- B CIRCUIT (BLACK)
- C CIRCUIT (RED) FOR FUTURE USE
- D CIRCUIT (BLACK) FOR FUTURE USE


GENERAL NOTES FOR CONTROL CABINET

- 1. ENTIRE CONTROL CABINET SHALL BE GROUNDED.
- 2. ALL WIRING SHALL BE TAGGED WITH SELF-STICKING WIRE MARKERS.
- 3. GROUND BUS TO BE COLOR CODED GREEN, NEUTRAL BUS WHITE, AND BONDED TO CABINET ENCLOSURE, BY LISTED PRESSURE CONNECTORS OR LISTED CLAMPS.
- 4. ALL INTERNAL CONTROLLER WIRING TO BE NO.12 AWG UNLESS OTHERWISE SPECIFIED.
- 5. CABINET WIRING INSULATION TO BE TYPE XHHW OR APPROVED EQUAL.
- 6. THE CONTROLLER SHALL BE UL LISTED, NEMA 3R AND SUITABLE FOR USE AS SERVICE ENTRANCE

LIGHTING GENERAL NOTES

- 1. ALL WORK TO CONFORM TO THE MOST RECENT NATIONAL ELECTRICAL CODE AND ANY APPLICABLE LOCAL CODES.
- 2. CONTRACTOR TO VERIFY LOCATION OF ALL UNDERGROUND UTILITIES BEFORE TRENCHING OR AUGERING.
- 3. BEFORE INSTALLING STANDARDS NEAR OVERHEAD FACILITIES CALL C.E. Co. FOR APPROVAL OF LOCATION
- 4. THE CONTRACTOR WILL BE RESPONSIBLE FOR THE ESTABLISHMENT OF FINISHED GRADE. THE RESIDENT ENGINEER MAY ASSIST THE CONTRACTOR, AS APPLICABLE, BUT THE RESPONSIBILITY COORDINATING THE FINISHED GRADE ELEVATION WITH THE TOP OF THE FOUNDATION HEIGHTS AND THE LIGHT SHALL REMAIN WITH THE CONTRACTOR.
- 5. NO POLES SHALL BE ERECTED UNTIL THE RESPECTIVE FOUNDATIONS HAVE CURED, AS APPROVED BY THE ENGINEER.
- 6. THE CONTRACTOR SHALL MAKE SPECIAL NOTE OF THE REQUIREMENTS FOR WIRE MARKERS AND SHALL TAG ALL WIRE MARKERS AND SHALL TAG ALL WIRE ACCORDINGLY.
- EQUIPMENT GROUND CONDUCTORS SHALL BE SPLICED AND BONDED AT EACH LIGHT POLE OR OTHER PIECE OF EQUIPMENT.
- 8. CONDUITS AND UNIT DUCTS MUST BE POSITIONED IN THE FIELD TO AVOID CONFLICT WITH TREES, BUSHES, DRAINS AND OTHER UTILITIES.

SCALE:

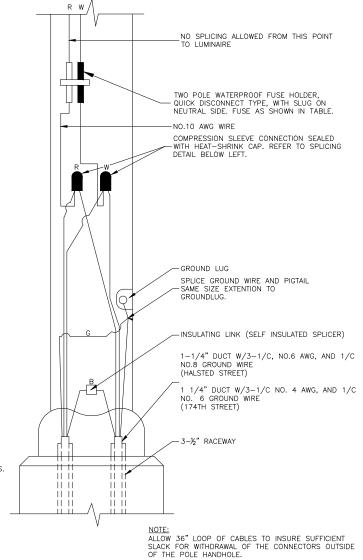

POLE HANDHOLE WIRING DIAGRAM

(TYPICAL FOR SINGLE LUMINAIRE INSTALLATION)
(RED PHASE SHOWN)

 USER NAME =
 DESIGNED — MG
 REVISED —


 CHECKED — WPD
 REVISED —

 PLOT SCALE =
 DRAWN — MED
 REVISED —


 PLOT DATE = 12-05-24
 CHECKED — APG
 REVISED —

FILE NAME = 21R0969-LGHT-DTLS-01 - IDOT P03

STATE OF ILLINOIS
DEPARTMENT OF TRANSPORTATION

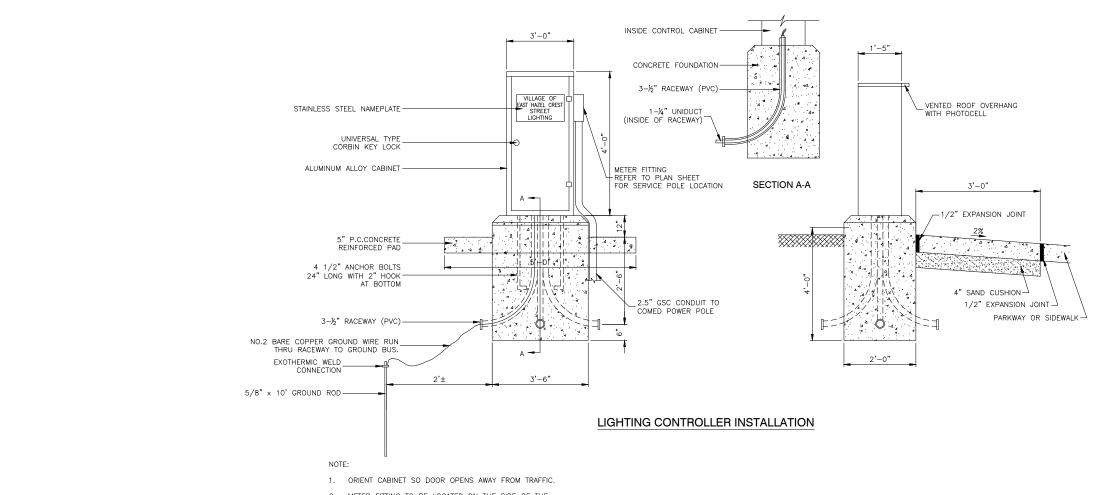

2. METER FITTING TO BE LOCATED ON THE SIDE OF THE CABINET CLOSEST TO SERVICE POLE.

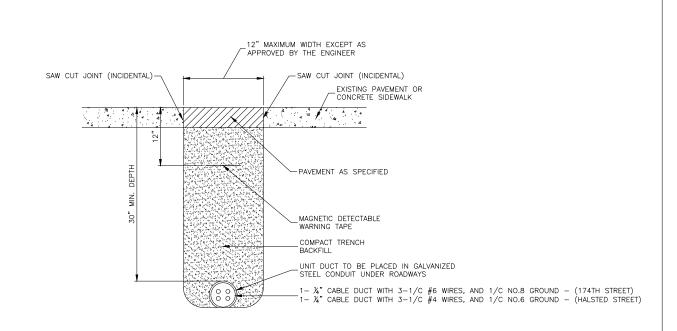


TRENCH DETAIL - PAVED AREAS

STATE OF ILLINOIS DEPARTMENT OF TRANSPORTATION

12" MAXIMUM WIDTH EXCEPT AS APPROVED BY THE ENGINEER	
[Z] [2] [4]	
RESTORATION AS SPECIFIED	
MAGNETIC DETECTABLE WARNING TAPE	
COMPACTED EARTH BACKFILL COMPACTED TRENCH BACKFILL	
0 0 1- 1/2" CABLE DUCT WITH 3-1/C #6 WIRES, AND 1/C NO.8 GROUND - (174TH STI 1- 1/2" CABLE DUCT WITH 3-1/C #4 WIRES, AND 1/C NO.6 GROUND - (HALSTED STATES)	REET) STREET)

TRENCH DETAIL - UNPAVED AREAS

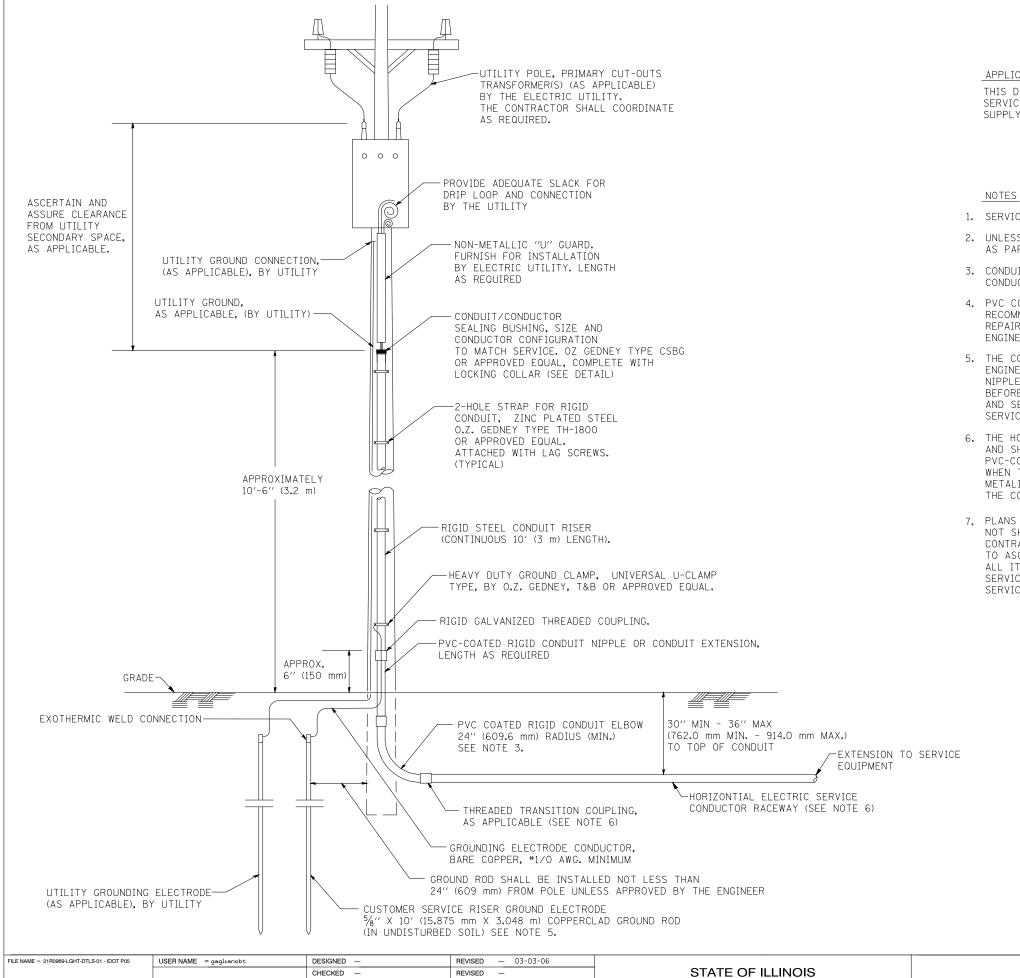

REVISED

REVISED

DEPARTMENT OF TRANSPORTATION

SCALE:

PLOT SCALE = 50.0000 ' / IN.

PLOT DATE = 1/4/2008

DRAWN


CHECKED -

— MEA

APPLICATION

THIS DETAIL APPLIES FOR LOW VOLTAGE ELECTRIC SERVICE (660 V OR LESS) FROM AN OVERHEAD UTILITY SUPPLY TO SEPERATLY-MOUNTED SERVICE EQUIPMENT.

- 1. SERVICE VOLTAGE SHALL BE AS INDICATED ELSEWHERE IN THE DRAWINGS.
- 2. UNLESS OTHERWISE INDICATED, ITEMS AND WORK SHALL BE INCLUDED AND PAID AS PART OF THE ELECTRIC UTILITY SERVICE INSTALLATION PAY ITEM.
- 3. CONDUIT AND CONNECTOR DIAMETER SHALL MATCH THE DIAMETER OF THE SERVICE CONDUCTOR RACEWAY AS INDICATED ON THE PLANS.
- 4. PVC COATED RACEWAYS AND ACCESSORIES SHALL BE CAREFULLY INSTALLED WITH MFR RECOMMENDED TOOLS AND PROCEDURES TO AVOID DAMAGE. ANY DAMAGE SHALL BE REPAIRED WITH COMPATIBLE PVC TOUCH-UP MATERIAL TO THE SATISFACTION OF THE ENGINEER OR THE DAMAGED MATERIAL SHALL BE REPLACED AT NO ADDITIONAL COST.
- 5. THE CONTRACTOR SHALL OBTAIN INSPECTION AND APPROVAL BY THE ENGINEER OF SERVICE RISER GROUND ELECTRODE, RISER ELBOW, NIPPLE AND CONNECTION TO SERVICE CONDUCTOR RACEWAY EXTENSION BEFORE BACKFILL AND SHALL ALSO OBTAIN INSPECTION OF SERVICE RISER AND SEALING BUSHING BEFORE UTILITY "U" GUARD INSTALLATION AND SERVICE CONNECTION.
- 6. THE HORIZONTAL ELECTRIC SERVICE CONDUCTOR RACEWAY SHALL BE AS INDICATED AND SHALL BE MEASURED SEPARATELY FOR PAYMENT. WHEN THE RACEWAY IS PVC-COATED RIGID GALVANIZED STEEL, THE COUPLING SHALL BE THE SAME. WHEN THE RACEWAY IS PVC CONDUIT (IN CONCRETE), THE COUPLING SHALL BE A METALIC TO NON METALIC ADAPTER. WHEN THE RACEWAY IS ENCASED IN CONCRETE, THE CONCRETE SHALL EXTEND TO COVER THE COUPLING.
- 7. PLANS AND DETAILS INDICATE THE GENERAL NATURE AND REQUIREMENTS. THEY DO NOT SHOW EVERY ACCESSORY AND ATTACHMENT, AND THEY DO NOT RELIEVE THE CONTRACTOR OF THE REQUIREMENTS OF THE SPECIFICATIONS AND SPECIAL PROVISIONS TO ASCERTAIN UTILITY REQUIREMENTS AND TO COORDINATE ACCORDINGLY, FURNISHING ALL ITEMS AND WORK NOT PROVIDED BY THE UTILITY, BUT NECESSARY FOR A COMPLETE SERVICE INSTALLATION IS REQUIRED AND SHALL BE INCLUDED IN THE ELECTRIC UTILITY SERVICE INSTALLATION PAY ITEM.

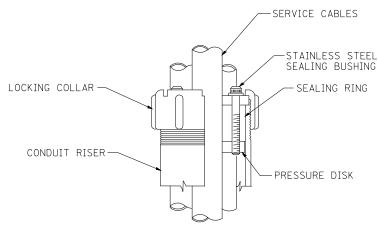


SEALING BUSHING DETAIL


COUNTY ELECTRIC SERVICE INSTALLATION 1049 22-00026-00-BS COOK 49 27 **AERIAL, REMOTE DISCONNECT** CONTRACT NO. 61L14 BE-220 SHEET NO. 27 OF 49 SHEETS STA. TO STA.

LIGHT POLE FOUNDATION DEPTH TABLE 30 FT. (9.144 m) TO 35 FT. (10.668 m) MOUNTING HEIGHT

. (3.144 11) 10 33	1 1. (10.000 11	IV MODIVITING II				
SOIL CONDITIONS	DESIGN DEPTH "D" OF FOUNDATION					
201F COUDITION2	SINGLE ARM POLE	TWIN ARM POLE				
SOFT CLAY	11'-0''	12′-8″				
Qu = 0.375 TON/SQ, FT,	(3.35 m)	(3 . 85 m)				
MEDIUM CLAY	9'-0''	14′-10′′				
Qu = 0.75 TON/SQ.FT	(2.74 m)	(4 . 52 m)				
STIFF CLAY	7'-6''	8'-7''				
Qu = 1.50 TON/SQ. FT.	(2.29 m)	(2.61 m)				
LOOSE SAND	9'-6''	10'-7''				
Ø = 34°	(2.90 m)	(3.22 m)				
MEDIUM SAND	9'-0''	9′-10′′				
Ø = 37.5°	(2.74 m)	(2.99 m)				
DENSE SAND	8'-3''	9'-7''				
Ø = 40°	(2.51 m)	(2.91 m)				

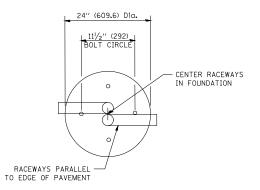


TOP VIEW

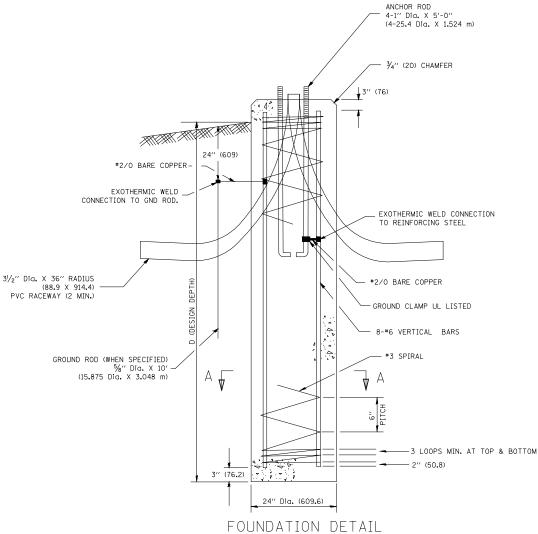

NOTES

- 1. ALL DIMENSIONS ARE IN INCHES (MILLIMETERS) UNLESS OTHERWISE SHOWN.
- 2. THE ANCHOR RODS AND RACEWAYS SHALL BE PROPERLY SECURED IN PLACE BEFORE THE CONCRETE IN PLACED.
- 3. THE FOUNDATION SHALL NOT PROTRUDE MORE THAN 4 IN. (100 mm) ABOVE THE FINISHED GRADE WITHIN A 60 IN. (1.5 m) CHORD ACROSS THE FOUNDATION, WITH ANCHOR RODS INCLUDED, IN ACCORDANCE WITH AASHTO GUIDELINES. IF THE FOUNDATION HEIGHT, INCLUDING ANCHOR RODS, EXTENDS BEYOND THESE SPECIFIED LIMITS, THE FOUNDATION SHALL BE REPLACED AT THE CONTRACTOR'S EXPENSE, SEE FOUNDATION EXTENSION DETAIL.
- 4. THE HOLE FOR THE FOUNDATION SHALL BE MADE BY DRILLING WITH AN AUGER, OF THE SAME DIAMETER AS THE FOUNDATION, IF SOIL CONDITIONS REQUIRE THE USE OF A LINER TO FORM THE HOLE, THE LINER SHALL BE WITHDRAWN AS THE CONCRETE IS DEPOSITED.
- 5. THE TOP OF THE FOUNDATION SHALL BE CONSTRUCTED LEVEL. A LINER OR FORM SHALL BE USED TO PRODUCE A UNIFORM SMOOTH SIDE TO THE TOP OF THE FOUNDATION. FOUNDATION TOP SHALL BE CHAMFERED 3/4-IN. (20 mm).
- THE CONCRETE SHALL BE CLASS SI. CONCRETE SHALL CURE ACCORDING TO ARTICLE 1020.13
 BEFORE LIGHT POLES ARE INSTALLED.
- 7. THE ANCHOR ROD SHALL BE A HOOK ROD TYPE. COLD BENDING OF THE ANCHOR ROD WILL NOT BE ALLOWED. THE RADIUS OF THE HOOK BEND SHALL NOT BE LESS THAN 4 TIMES THE NOMINAL DIAMETER OF THE ANCHOR ROD. A TACK WELDED ANCHOR ROD MAY BE SUBSTITUTED WITH THE APPROVAL OF THE ENGINEER.
- 8. THE ANCHOR RODS SHALL BE ACCORDING TO ASTM F1554 GRADE 725 (GRADE 105). NUTS SHALL BE HEXAGON NUTS ACCORDING TO ASTM A 194 2H OR ASTM A 563 DH, AND WASHERS SHALL BE ACCORDING TO ASTM F 436.
- 9. ANCHOR RODS, NUTS AND WASHERS SHALL BE COMPLETELY GALVANIZED BY EITHER THE HOT-DIPPED PROCESS CONFORMING WITH AASHTO M 232, THE MECHANICAL PLATING METHOD CONFORMING TO AASHTO M 298, CLASS 50 WITH A MAXIMUM COATING THICKNESS OF 150 UM(6 MILS) OR THE ELECTROLYTIC PROCESS ACCORDING TO ASTM F 1136.
- O. THE ANCHOR RODS SHALL BE THREADED A MINIMUM OF 6 INCHES (150 mm) WITH A MINIMUM OF 3 INCHES (75 mm) OF THREADED ANCHOR ROD EMBEDDED IN THE FOUNDATION.
- 11. ANCHOR RODS SHALL PROJECT 2¾4" (69.9 mm) ABOVE THE TOP OF THE FOUNDATION. IF BREAKAWAY COUPLINGS ARE SPECIFIED, THE CONTRACTOR SHALL CAREFULLY COORDINATE THE ANCHOR ROD PROJECTION WITH THE INSTALLATION REQUIREMENTS OF THE BREAKAWAY COUPLINGS.
- 12. THE CONTRACTOR SHALL USE A #3 SPIRAL AT 6" (152.4 mm) PITCH OR MAY SUBSTITUTE #3 TIES AT 12" (304.8 mm) O.C. WITH THE APPROVAL OF THE ENGINEER.
- 13. THE CABLE TRENCHES AND FOUNDATION SHALL BE BACK FILLED AND COMPACTED AS SPECIFIED BEFORE THE LIGHT POLE IS ERECTED.
- 14. THE RACEWAYS SHALL PROJECT 1" (25.4 mm) ABOVE THE TOP OF THE FOUNDATION.

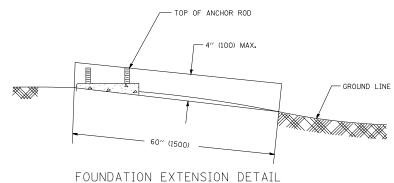


ANCHOR BOLT DETAIL

6" (152,4)

THREADED

5%" T. X 4" DIA. WASHER, TACK WELDED

FILE NAME = 21R0969-LGHT-DTLS-01 - IDOT P06

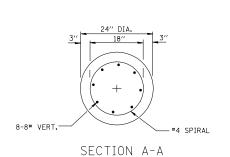

USER NAME = gaglianobt	DESIGNED —	REVISED —
	CHECKED —	REVISED —
PLOT SCALE = 50.0000 ' / IN.	DRAWN —	REVISED —
PLOT DATE = 1/4/2008	CHECKED —	REVISED —

STATE OF ILLINOIS
DEPARTMENT OF TRANSPORTATION

SCALE:


LIGHT POLE FOUR	LIGHT POLE FOUNDATION					COUNTY	TOTAL SHEETS	SHEET NO.
36' (9.144 m) TO 35' (10.668 m) M.H. 11 1/2" (292 mm) BOLT CIRCLE			19 22-00026-00-RS			соок	49	28
			BE-300			CONTRACT NO. 61L14		14
SHEET NO. 28 OF 49 SHEETS	STA. TO STA.	FED. RO	AD DIST. NO. 1	ILLINOIS	FED. Al	ID PROJECT NM5A	(507)	


FOUNDATION DESIGN TABLE

	DESIGN DEPTH (OF FOUNDATION	REINFORCEMENT IN FOUNDATION					
TYPE OF SOIL	SINGLE ARM	TWIN ARM	SINGLE	ARM	TWIN ARM			
	D	D	VERT BARS	SPIRAL	VERT BARS	SPIRAL		
SOFT CLAY	13'-0''	15′-0′′	8-#6X12'-6''	#3X122′	8-#6X14'-3''	#3X141′		
	(3.962 m)	(4.572 m)	(3.810 m)	(37.186 m)	(4.343 m)	(42.977 m)		
MEDIUM CLAY	9'-6''	10'-9''	8-#6X9'-0''	#3X90′	8-#6X10'-0''	#3X100′		
	(2.896 m)	(3.277 m)	(2.743 m)	(27.432 m)	(3.048 m)	(30.480 m)		
STIFF CLAY	7'-0''	8'-0''	8-#6X6′-6′′	#3X66′	8-#6X7'-6''	#3X76′		
	(2.134 m)	(2.438 m)	(1.981 m)	(20.112 m)	(2.286 m)	(23.165 m)		
LOOSE SAND	9′-0′′	10'-0''	8-#6X8'-6''	#3X85′	8-#6X9'-6''	#3X94′		
	(2.743 m)	(3.048 m)	(2.591 m)	(25.908 m)	(2.896 m)	(28.651 m)		
MEDIUM SAND	8'-3''	9'-0''	8-#6X8'-0''	#3X78′	8-#6X8'-6''	#3X85′		
	(2 . 515 m)	(2.743 m)	(2.438 m)	(23.774 m)	(2.591 m)	(25.908 m)		
DENSE SAND	7'-9''	9'-0''	8-#6X7'-6''	#3X73′	8-#6X8'-6''	#3X85′		
	(2.362 m)	(2.743 m)	(2.286 m)	(22.250 m)	(2.591 m)	(25.908 m)		
ROCK OR SOLIDIFIED SLAG	5′-0′′ (1.524 m)	5′-0′′ (1 . 524 m)	NONE	NONE	NONE	NONE		

NOTES

- 1. ALL DIMENSIONS ARE IN INCHES (MILLIMETERS) UNLESS OTHERWISE SHOWN.
- 2. THE ENGINEER SHALL DETERMINE THE CLASS OF SOIL DURING EXCAVATION AND SELECT THE DESIGN DEPTH OF FOUNDATION FROM THE DESIGN TABLE.
- 3. EXCAVATION OF THE POLE FOUNDATION SHALL BE MADE WITH AN AUGER, 24" (609.6 mm) OR 30" (762.0 mm) IN DIAMETER.
- 4. THE ANCHOR ROD SHALL BE A HOOK ROD TYPE, COLD BENDING OF THE ANCHOR ROD WILL NOT BE ALLOWED. THE RADIUS OF THE HOOK BEND SHALL NOT BE LESS THAN 4 TIMES THE NOMINAL DIAMETER OF THE ANCHOR ROD, A TACK WELDED ANCHOR ROD MAY BE SUBSTITUTED WITH THE APPROVAL OF THE ENGINEER.
- 5. THE ANCHOR BOLTS AND RACEWAYS SHALL BE PROPERLY SECURED IN PLACE BEFORE THE CONCRETE IS PLACED IN THE FORM.
- 6. THE ANCHOR RODS SHALL BE ACCORDING TO ASTM F1554 GRADE 725 (GRADE 105). NUTS SHALL BE HEXAGON NUTS ACCORDING TO ASTM A 194 2H OR ASTM A 563 DH, AND WASHERS SHALL BE ACCORDING TO ASTM F 436.
- 7. THE CONTRACTOR SHALL COORDINATE EXTENSION OF ANCHOR BOLTS ABOVE TOP OF FOUNDATION WITH THE BREAKAWAY DEVICE MANUFACTURER'S REQUIREMENTS. IF LIGHT POLE IS MOUNTED WITHOUT BREAKAWAY DEVICE, ANCHOR BOLTS SHALL PROJECT 23/4" (69.9 mm) ABOVE TOP OF THE FOUNDATION. THE CONTRACTOR SHALL CONFIRM ANCHOR BOLT EXTENTION WITH ENGINEER.
- 8. RACEWAYS SHALL PROJECT 1" (25.4 mm) ABOVE THE TOP OF THE FOUNDATION.
- 9. THE CABLE TRENCH SHALL BE BACKFILLED AND FIRMLY COMPACTED BEFORE THE LIGHT IS ERECTED.

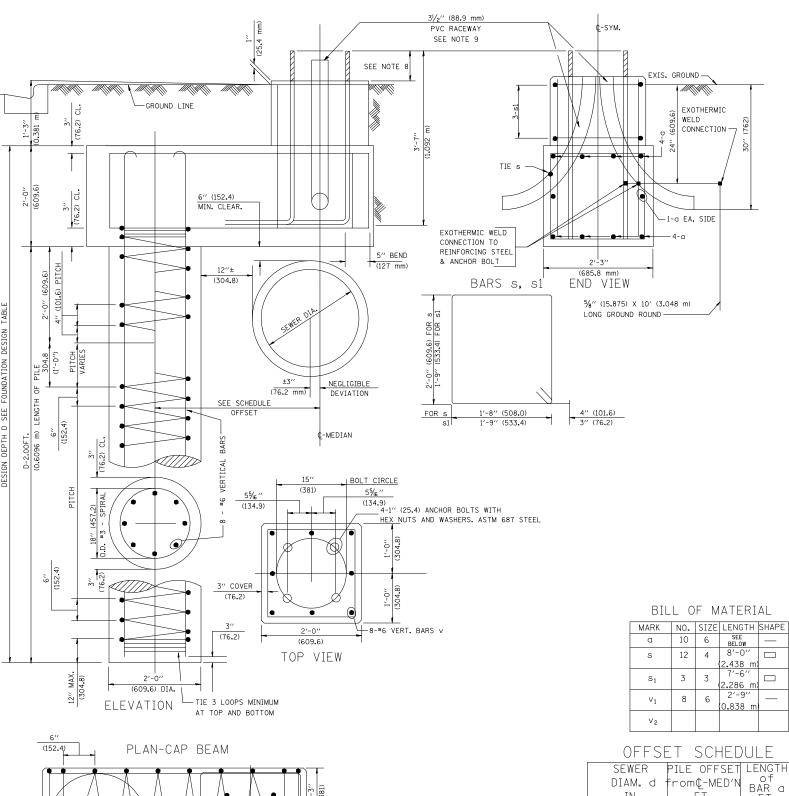

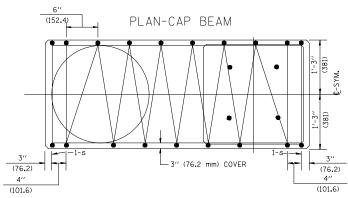

SCALE:

SEWER	PILE OFFSET	
DIAM. d -	from¢-MED′N	of BAR a
IN.	FT.	FT.
UP TO 24"	3'-3''	#6 × 5′-3′′
(609.6 mm)	(0.991 m)	(1.600 m)
27" (685.8 m)TO	3'-9''	5′-9′′
36" (914.4 mm)	(1.143 m)	(1.753 m)
42" (1066.8 mm) TO	4′-6′′	6′-6′′
48" (1219.2 mm)	(1.372 m)	(1 . 981 m)
54" (1371.6 mm) TO	5′-0′′	7′-0′′
60" (1524 . 0 mm)	(1.524 m)	(2.134 m)
66" (1676.4 mm) TO	5′-6′′	7′-6′′
72" (1828.8 mm)	(1.676 m)	(2.286 m)

STATE OF ILLINOIS
DEPARTMENT OF TRANSPORTATION

	LIGHT POLE FOUNDATION OFFSET 40' (12.192 m) TO 47 12 ' (14.478 m) M.H.				F.A.U RTE. SECTION		COUNTY TOTAL SHEETS		SHEET NO.	
	15" (381 mm) BOLT CIRCLE			1049	049 22-00026-00-RS			COOK	49	29
					BE-3	310		CONTRACT	NO. 61L1	4
	SHEET NO. 29 OF 49 SHEETS	STA.	TO STA.	FED. ROAD DIST. NO. 1 ILLINOIS FED. A		FED. Al	D PROJECT NM5A	(507)		



REFER TO SECTION 442 OF THE STANDARD SPECIFICATIONS FOR ROAD AND BRIDGE CONSTRUCTION AND THE RECURRING SPECIAL PROVISION "PATCHING WITH HOT-MIX ASPHALT OVERLAY REMOVAL."

BASIS OF PAYMENT

- 1. REFER TO SECTION 442 OF THE STANDARD SPECIFICATIONS FOR ROAD AND BRIDGE CONSTRUCTION AND THE RECURRING SPECIAL PROVISION "PATCHING WITH HOT-MIX ASPHALT OVERLAY REMOVAL."
- SAW CUT/SCORING OF EXISTING HMA OVERLAY IS INCLUDED IN THE COST OF PAVEMENT PATCHING.
- SAW CUT/SCORING OF EXISTING PAVEMENT IS INCLUDED IN THE COST OF PAVEMENT PATCHING.

* SEE TYPICAL SECTIONS FOR

THICKNESS AND MATERIALS

HMA REMOVAL OVER PATCHES * AND HMA REPLACEMENT OVER PATCHES FOR PATCHING FIRST CONSTRUCTION 6 (150) MIN. -SAW CUT/SCORING EXIST. HMA FOR PATCHING FIRST CONSTRUCTION OVERLAY, TYPICAL. TOP OF EXIST. HMA OR MILLED SURFACE CLASS C OR CLASS D PATCH OF THE THICKNESS SPECIFIED 12 (300) SAW CUT/SCORING, TYPICAL **EXISTING PAVEMENT** PROPOSED UNSUITABLE SUBGRADE REMOVAL AND REPLACEMENT UTILITY OR STORM SEWER TRENCH (IF PATCH IS DUE TO UTILITY OR SEWER WORK, THE WIDTH OF THE FULL DEPTH PATCH SHALL BE 12 (300) WIDER ON EACH SIDE OF THE TRENCH).

SEQUENCE OF CONSTRUCTION (PATCHING FIRST)

- 1. REMOVE THE EXISTING HMA MATERIAL OVER THE AREA TO BE PATCHED.
- 2. REMOVE AND REPLACE WITH CLASS C OR D PATCH.
- 3. REPLACE HMA MATERIAL OVER THE AREA TO BE PATCHED.

SEQUENCE OF CONSTRUCTION (MILLING FIRST)

- 1. MILL HMA FIRST IF THERE IS AT LEAST 4½ INCHES OR MORE OF HMA MATERIAL ON TOP OF THE EXISTING PAVEMENT OR IF THE PAVEMENT IS FULL DEPTH HMA. A MINIMUM OF 2 INCHES OF HMA MATERIAL SHALL BE IN PLACE AFTER MILLING.
- 2. REMOVE AND REPLACE WITH FULL DEPTH CLASS D PATCHES TO TOP OF MILLED SURFACE.

ALL DIMENSIONS ARE IN INCHES (MILLIMETERS) UNLESS OTHERWISE SHOWN.


	USER NAME = Lawrence.DeMarkhe	DESIGNED - R. SHAH	REVISED - R. BORO 01-01-07		PAVEMENT PATCHING FOR	F.A. SECTION	COUNTY TOTAL SHEET
	DRAWN -	REVISED - R. BORO 09-04-07	STATE OF ILLINOIS		NEG	SPICETS NO.	
	PLOT SCALE = 100.0000 ' / in.	CHECKED -	REVISED - K. ENG 10-27-08	DEPARTMENT OF TRANSPORTATION	HMA SURFACED PAVEMENT	BD400-04 (BD-22)	CONTRACT NO.
PLOT DATE = 11/18/2022	DATE - 10-25-94	REVISED - K. SMITH 11-18-22		SCALE: NONE SHEET 1 OF 1 SHEETS STA. TO STA.	ILLINOIS FED		

FILE NAME = 21R0969-DTLS-01 - BD-22

USER NAME =	DESIGNED — MG	REVISED —	Ī
	CHECKED — WPD	REVISED —	
PLOT SCALE =	DRAWN — RG	REVISED —	
PLOT DATE = 12-05-24	CHECKED — AG	REVISED —	

STATE OF ILLINOIS
DEPARTMENT OF TRANSPORTATION

CENTER STREET										
ROADWAY RESURFACING AND PEDESTRIAN ACCOMODATIONS										
DISTRICT 1 DETAILS										
SCALE: 1"=5'	SHEET NO. 30 O	F 49 SH	IEETS	STA.	TO STA.					

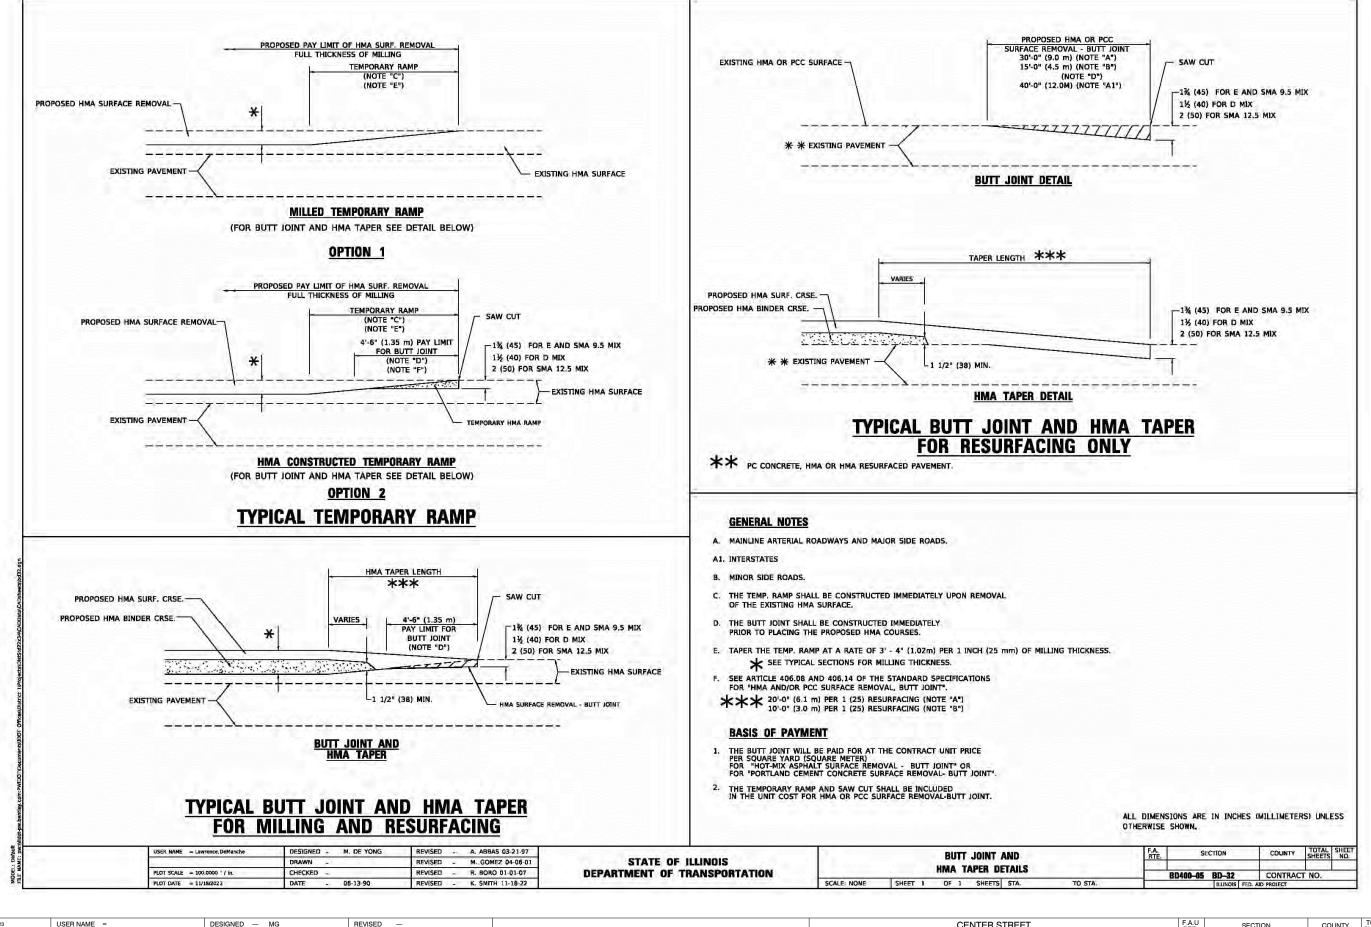

CHECKED - AG

PLOT DATE = 12-05-24

REVISED


REVISED

REVISED

STATE OF ILLINOIS
DEPARTMENT OF TRANSPORTATION

CENTER STREET
ROADWAY RESURFACING AND PEDESTRIAN ACCOMODATIONS
DISTRICT 1 DETAILS

SCALE: 1*=5' SHEET NO. 31 OF 49 SHEETS STA TO STA.

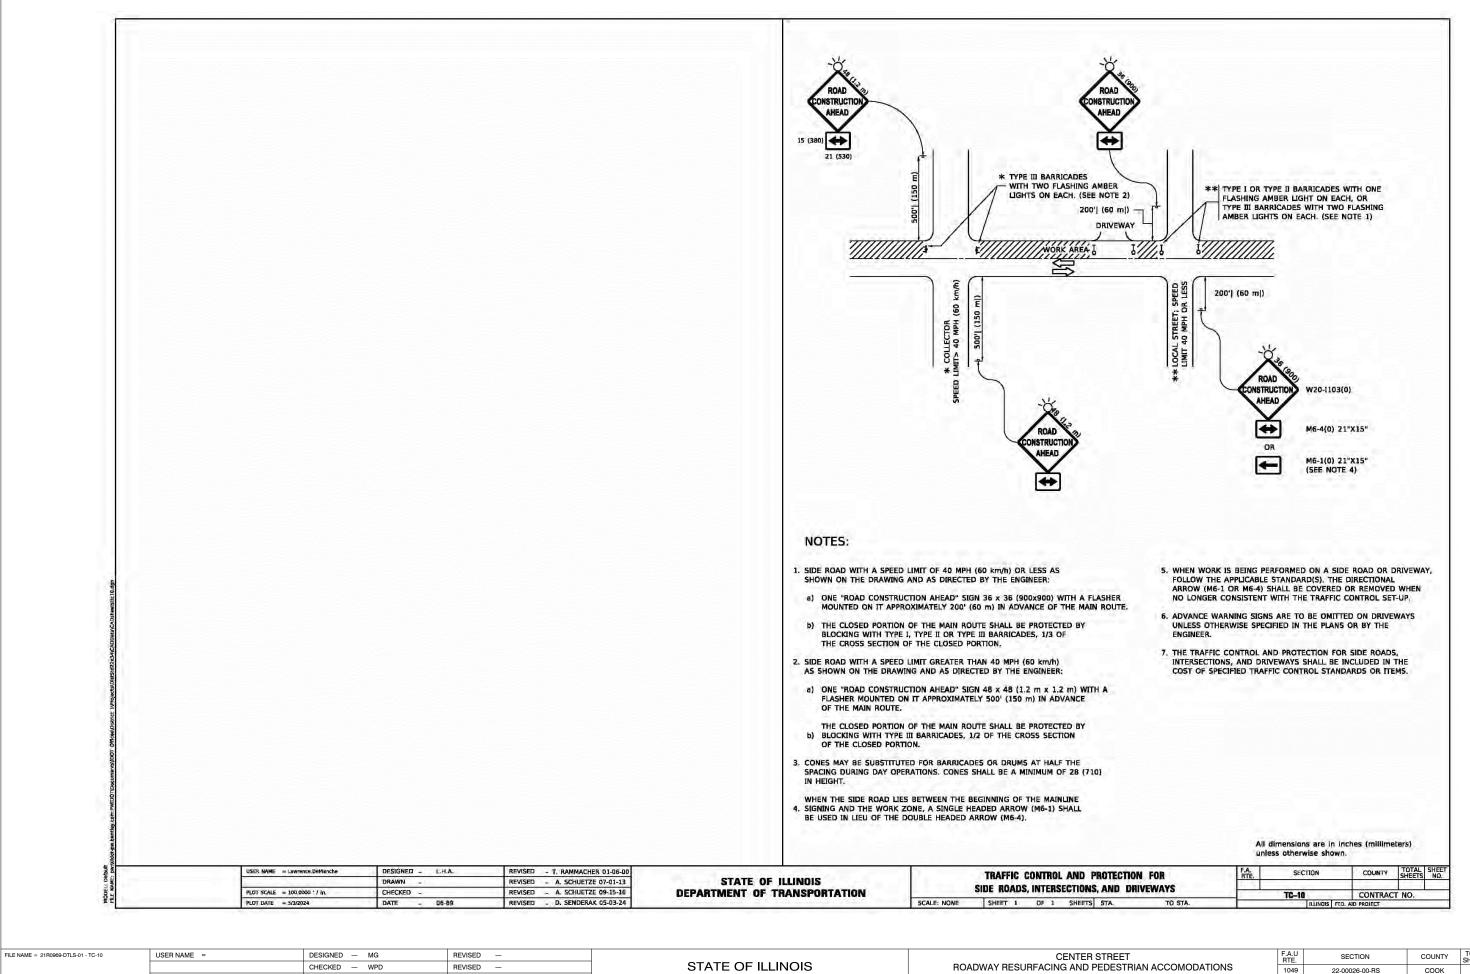


PLOT SCALE = DRAWN REVISED PLOT DATE = 12-05-24 CHECKED - AG REVISED

DEPARTMENT OF TRANSPORTATION

DISTRICT 1 DETAILS SCALE: 1"=5" SHEET NO. 32 OF 49 SHEETS STA.

49 32 CONTRACT NO. 61L14

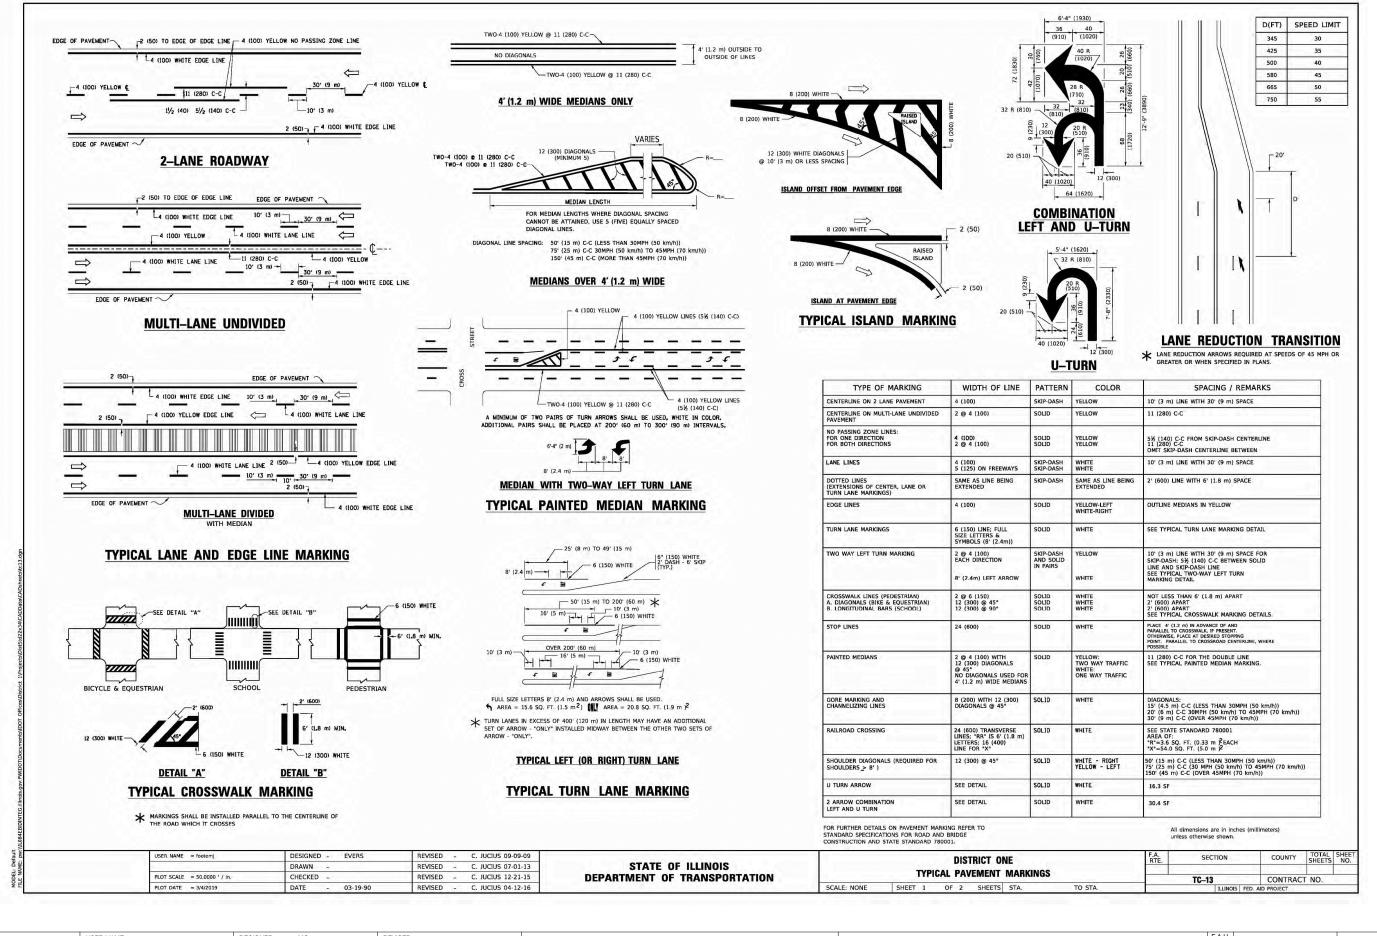



STATE OF ILLINOIS DEPARTMENT OF TRANSPORTATION

SCALE: 1"=5"

CENTER STREET ROADWAY RESURFACING AND PEDESTRIAN ACCOMODATIONS								
						1	049	
DISTRICT 1 DETAILS								
5'	SHEET NO. 33	OF 49	SHEETS	STA.	TO STA.	FF	FD RO	

F.A.U RTE.		SECT	ION		COUNTY	TOTAL SHEETS	SHEE NO.	
1049	22-	0002	6-00-RS		COOK	49	33	
				CONTRACT NO. 61L14				
FED. RO	AD DIST. NO.	1	ILLINOIS	ID PROJECT NM5A(507)				

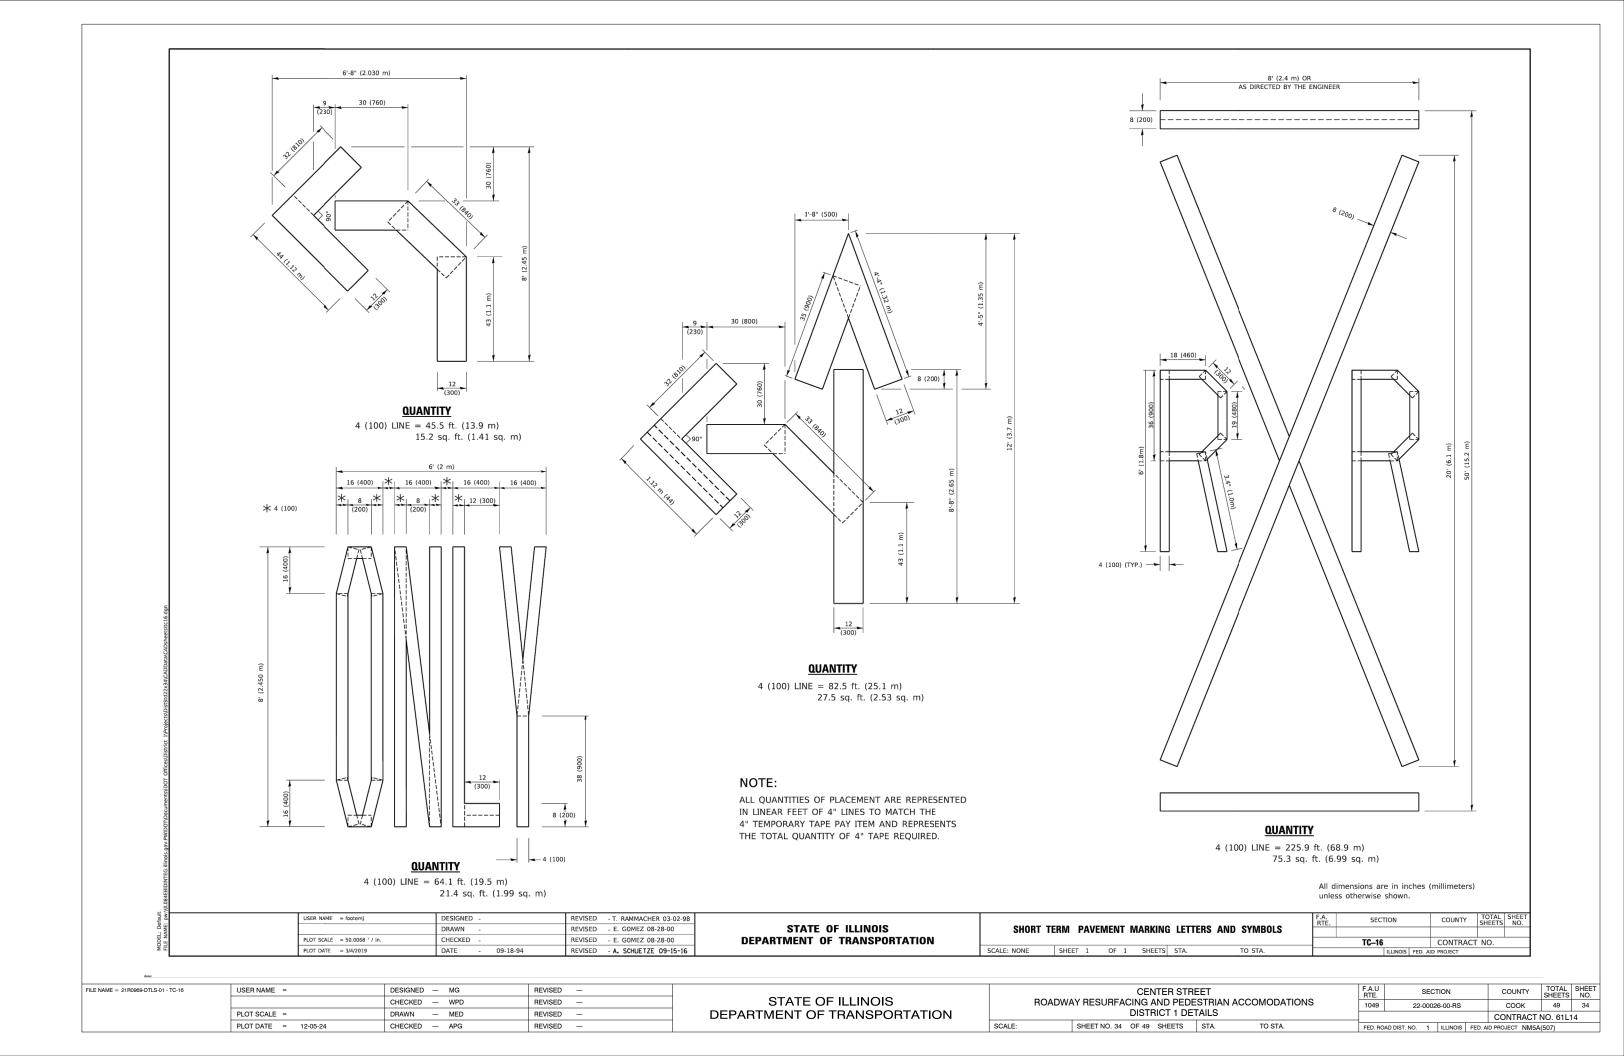

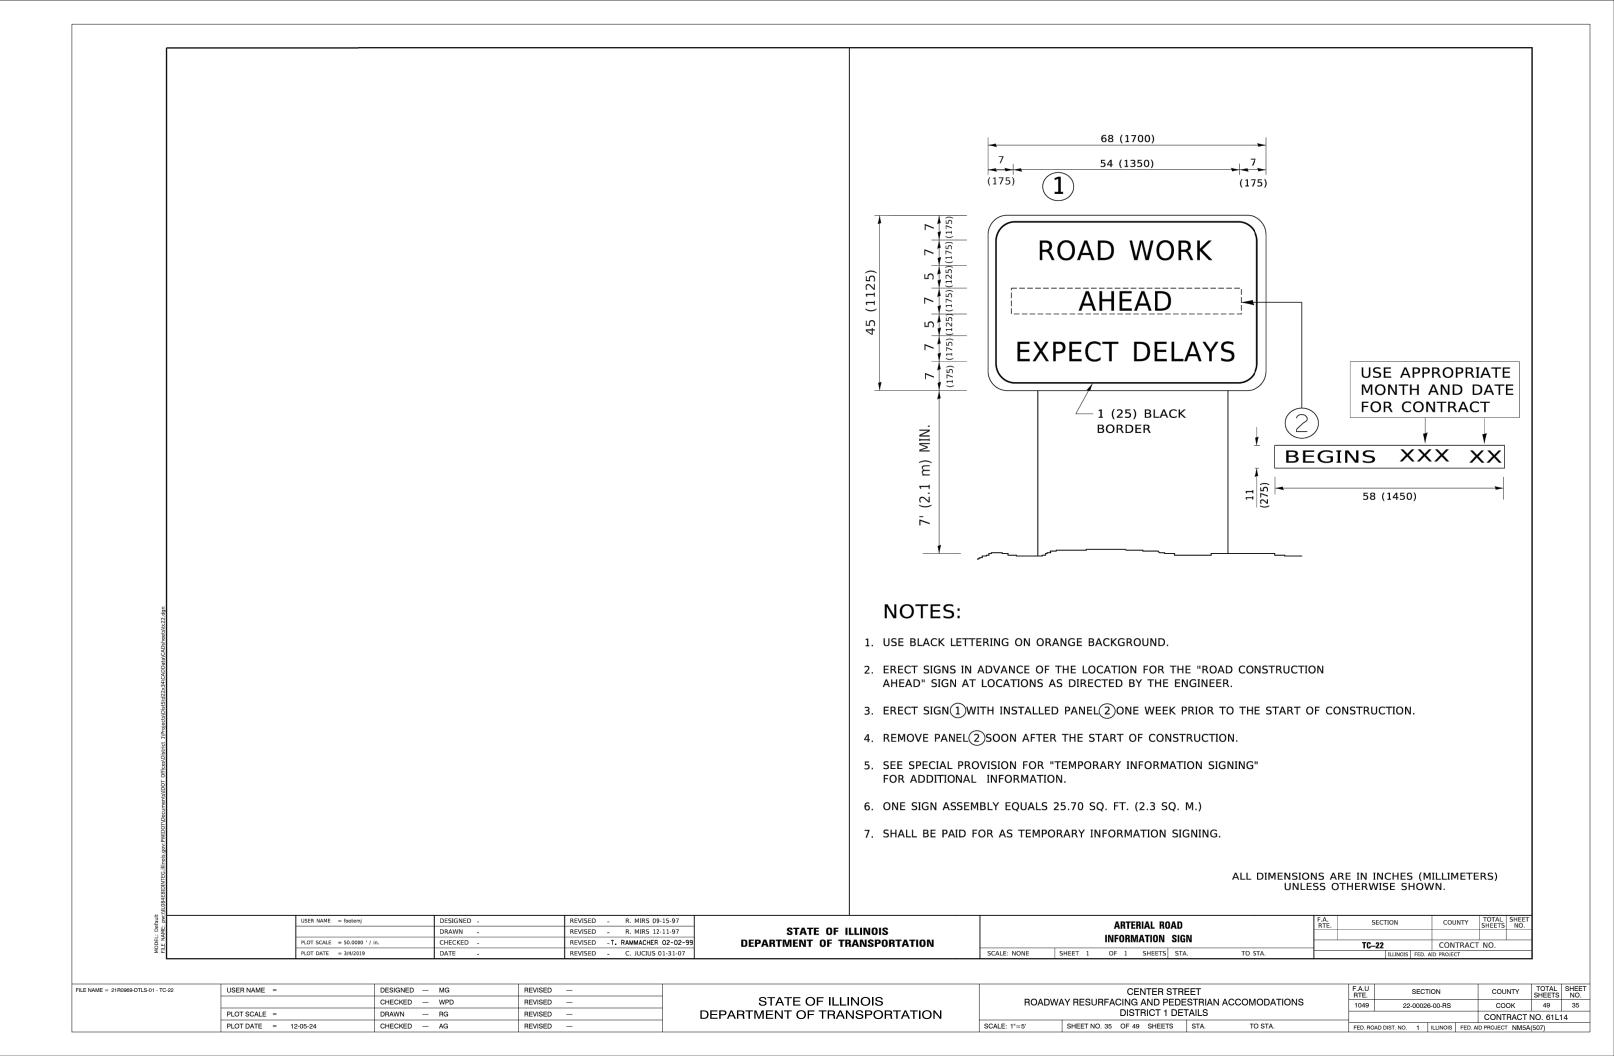

TRAFFIC SIGNAL LEGEND (NOT TO SCALE)

CONTROLLER CABINET COMMUNICATION CABINET MASTER CONTROLLER	\boxtimes		ITEM	EXISTING	PROPOSED	ITEM	EXISTING	PROPOSED
		\blacksquare	HANDHOLE -SQUARE -ROUND			SIGNAL HEAD -(P) PROGRAMMABLE SIGNAL HEAD	R Y	R R Y
MASTER CONTROLLER	ECC	СС	HEAVY DUTY HANDHOLE					R
	ЕМС	МС	-SQUARE -ROUND	H (f)	⊞ ⊕			4 6 4 6 P
MASTER MASTER CONTROLLER	EMVC	ммс	DOUBLE HANDHOLE			SIGNAL HEAD WITH BACKPLATE		RRR
UNINTERRUPTABLE POWER SUPPLY	∲	*	JUNCTION BOX		•	-(P) PROGRAMMABLE SIGNAL HEAD -(RB) RETROREFLECTIVE BACKPLATE		Y G G G
SERVICE INSTALLATION -(P) POLE MOUNTED	P	- = -P	RAILROAD CANTILEVER MAST ARM	X OX X	X eI X			R
SERVICE INSTALLATION	C CM	C CM	RAILROAD FLASHING SIGNAL	Xo X	X⊕X		P RB	P RB
(G) GROUND MOUNTED (GM) GROUND MOUNTED METERED	$\boxtimes^{G} \boxtimes^{GM}$	≖ ^G ≖ ^{GM}	RAILROAD CROSSING GATE	X0X>	1 ● 1	PEDESTRIAN SIGNAL HEAD	©	*
TELEPHONE CONNECTION	ET	Т	RAILROAD CROSSBUCK	X	*	AT RAILROAD INTERSECTIONS		
STEEL MAST ARM ASSEMBLY AND POLE	0	•——	RAILROAD CONTROLLER CABINET		▶∢	PEDESTRIAN SIGNAL HEAD WITH COUNTDOWN TIMER	C D	₽ C ★ D
ALUMINUM MAST ARM ASSEMBLY AND POLE	0		UNDERGROUND CONDUIT (UC), GALVANIZED STEEL			ILLUMINATED SIGN		
STEEL COMBINATION MAST ARM ASSEMBLY AND POLE WITH LUMINAIRE	o-> <	• ×	TEMPORARY SPAN WIRE, TETHER WIRE, AND CABLE			"NO LEFT TURN"/"NO RIGHT TURN"		\odot
SIGNAL POST -(BM) BARREL MOUNTED - TEMPORARY	0	 ◆ BM 	SYSTEM ITEM	S	SP	NUMBER OF CONDUCTORS, ELECTRIC CABLE NO. 14, UNLESS NOTED OTHERWISE.		(5)
WOOD POLE	⊗	8	INTERSECTION ITEM	I	IP	ALL DETECTOR LOOP CABLE TO BE SHIELDED	\sim	<u> </u>
GUY WIRE	₩	& >-	REMOVE ITEM		R	GROUND CABLE IN CONDUIT, NO. 6 SOLID COPPER (GREEN)	1#6	
SIGNAL HEAD	>	<i>-</i> ⊨ ►	RELOCATE ITEM		RL	ELECTRIC CABLE IN CONDUIT, TRACER NO. 14 1/C	<u>—(1)—</u>	_1_
SIGNAL HEAD WITH BACKPLATE	+->	+-	ABANDON ITEM CONTROLLER CABINET AND		А	COAXIAL CABLE	<u> </u>	—c—
SIGNAL HEAD OPTICALLY PROGRAMMED	_	_ ▶ P	FOUNDATION TO BE REMOVED		RCF	COANIAL CABLE		
FLASHER INSTALLATION	o⇔ ^F o⇔ ^{FS}	•► FS •►	MAST ARM POLE AND FOUNDATION TO BE REMOVED		RMF	VENDOR CABLE	— <u>v</u> —	
-(FS) SOLAR POWERED	F DDFS	F FS	SIGNAL POST AND FOUNDATION TO BE REMOVED		RPF	COPPER INTERCONNECT CABLE, NO. 18, 3 PAIR TWISTED, SHIELDED	<u></u>	
PEDESTRIAN SIGNAL HEAD	-0	-1	DETECTOR LOOP, TYPE I			FIBER OPTIC CABLE -NO. 62.5/125, MM12F		—(12F)—
PEDESTRIAN PUSH BUTTON -(APS) ACCESSIBLE PEDESTRIAN PUSH BUTTON			PREFORMED DETECTOR LOOP	P P	P P	-NO. 62.5/125, MM12F SM12F -NO. 62.5/125, MM12F SM24F		
RADAR DETECTION SENSOR	R	R	SAMPLING (SYSTEM) DETECTOR	s s	s s			(36F)
/IDEO DETECTION CAMERA	(V)	v.	INTERSECTION AND SAMPLING (SYSTEM) DETECTOR	IS (IS)	IS (IS)			
RADAR/VIDEO DETECTION ZONE			QUEUE AND SAMPLING (SYSTEM) DETECTOR	os os	os os	GROUND ROD -(C) CONTROLLER -(M) MAST ARM	_CMPS 	$\stackrel{\stackrel{\cdot}{=}^{C}}{\stackrel{\top}{=}}^{M} \stackrel{\stackrel{\cdot}{=}^{P}}{\stackrel{\cdot}{=}^{S}}$
PAN, TILT, ZOOM (PTZ) CAMERA	PTZ	PTZ■	WIRELESS DETECTOR SENSOR	®	®	-(P) POST -(S) SERVICE		
EMERGENCY VEHICLE LIGHT DETECTOR	\boxtimes	~	WIRELESS ACCESS POINT		_			
CONFIMATION BEACON	○ —0	⊷			_			
WIRELESS INTERCONNECT	○ + -	•++ -						
WIRELESS INTERCONNECT RADIO REPEATER	ERR	RR						

LE NAME = 21R0969-DTLS-01 - TS-05	USER NAME =	DESIGNED — MG	REVISED —
		CHECKED — WPD	REVISED —
	PLOT SCALE =	DRAWN — RG	REVISED —
	DLOT DATE - 12.05.24	CHECKED VC	BEVICED

STATE OF ILLINOIS
DEPARTMENT OF TRANSPORTATION

SCALE: 1"=5'

CENTER STREET					F.A.U RTE.				COUNTY	TOTAL SHEETS	SHEET NO.		
ROADWAY RESURFACING AND PEDESTRIAN ACCOMODATIONS DISTRICT 1 DETAILS						1049	22-00026-00-RS			соок	49	36	
						CONTRACT NO. 61L						4	
"=5"	SHEET NO. 36	OF 49	SHEETS	STA.	TO STA.	FFD. BO	FED ROAD DIST NO. 1 ILLINOIS FED AID PRO				D PROJECT NM5A	(507)	

PROVIDE A PAVEMENT REPLACEMENT NOTE WHICH SHOULD EQUAL 3' (900 mm) X WIDTH OF PAVED SHOULDER. PAVED OR NON-PAVED SHOULDER PAVED OR NON-PAVED SHOULDER PAVED OR NON-PAVED SHOULDER 10' (1.5 m) (1.8 m) (1.5 m) * 10' (3.0 m) | (3.0 m) | 1" (25 mm) UNIT DUCT-TRENCHED TO E/P ** * = (600 mm) * * UNIT DUCT IS TO BE SHOWN ON PLAN SHEETS BUT SHALL NOT BE INCLUDED IN THE PAY ITEMS.


VOLUME DENSITY ("FAR OUT" DETECTION) ON SAME APPROACH (PROTECTED / PERMITTED LEFT TURN PHASING) HANDHOLE LOCATION MAY VARY DEPENDING ON GEOMETRICS AND DESIGN OF TRAFFIC SIGNALS. HEAVY-DUTY HANDHOLES TO BE USED WHICH THE MEDIAN IS MOUNTABLE. REFER TO STANDARD 814001 TO ENSURE THAT HANDHOLE FITS IN MEDIAN. TRENCHED 1" (25 mm) VITT DUCT (3) ** ** ** UNIT DUCT (3) ** (3.6 m) ** UNIT DUCT (3) ** (3.6 m) ** ** UNIT DUCT IS TO BE SHOWN ON PLAN SHEETS BUT SHALL NOT BE INCLUDED IN THE PAY ITEMS.

PLAN SHEET FOR DETECTOR LOOP REPLACEMENT

ON SAME APPROACH (PROTECTED / PERMITTED LEFT TURN PHASING) * = (600 mm) * = (600 m

LEFT TURN LANES WITHOUT MEDIANS

VOLUME DENSITY ("FAR OUT" DETECTION)

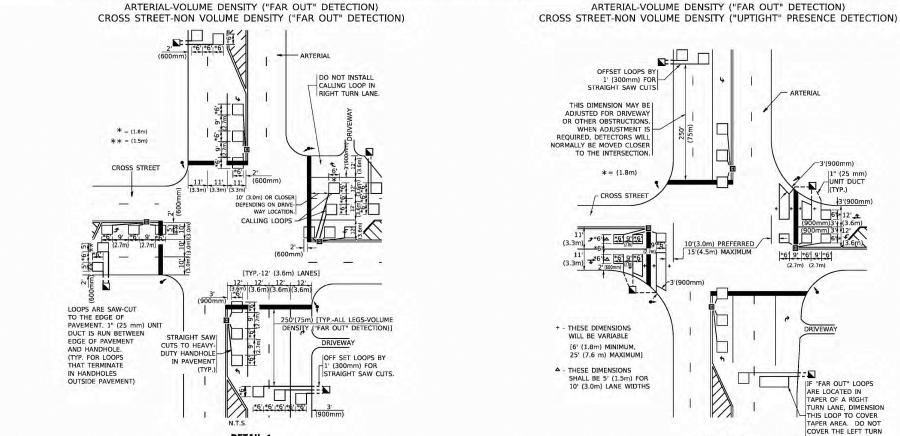

REVISED

REVISED

REVISED

REVISED

NOTES:

VEHICLES LOOP DETECTORS

- * ALL LEAD IN CABLE SHALL BE TWO CONDUCTOR NO. 14 TWISTED, SHIELDED.
- * EACH DETECTOR LOOP SHALL HAVE ITS OWN SAW CUT FROM THE LOOP TO THE EDGE OF PAVEMENT OR TO A HANDHOLE IN THE PAVEMENT.
- * EACH DETECTOR LOOP SHALL HAVE ITS OWN ONE INCH (25 mm) UNIT DUCT BETWEEN THE EDGE OF PAVEMENT AND THE FIRST HANDHOLE OR JUNCTION BOX. EACH UNIT DUCT RUN SHALL BE SHOWN ON THE PLANS BY THE DESIGNER, BUT SHALL NOT BE PAID FOR SEPARATLY. THIS ITEM IS INCIDENTAL TO THE PAY ITEM FOR DETECTOR LOOPS.
- * ONE DIMENSION OF <u>ALL</u> DETECTOR LOOPS SHALL BE SIX FEET (1.8 m)
- * EACH LANE OF NON-LOCKING, PRESENCE DETECTION AND EACH LANE OF A DOUBLE LEFT TURN LANE REQUIRES A SEPARATE INDUCTIVE LOOP DETECTOR AND LEAD IN CABLE.
- * WHEN NON-LOCKING, PRESENCE DETECTION IS USED, MORE THAN ONE LOOP PER LANE IS REQUIRED BEHIND THE STOP BAR (i.e. 1-1/2, 1-3/4, 2).
- * WHEN SYSTEM LOOPS ARE REQUIRED ON AN APPROACH OF AN INTERSECTION, THE LOOPS USED FOR VOLUME DENSITY AND INTERSECTION TIMING SHALL ALSO BE USED AS SYSTEM DETECTORS. <u>EACH</u> ONE OF THESE TYPE OF LOOPS REQUIRES A <u>SEPARATE</u> TWO CONDUCTOR NO. 14 TWISTED SHIELDED CABLE AND A <u>SEPARATE</u> INDUCTIVE LOOP DETECTOR WHEN NEW CONTROLLERS ARE UTILIZED. THE DESIGNER SHALL LABEL THESE TYPES OF LOOPS AS "INTERSECTION AND SAMPLING (SYSTEM) DETECTORS" ON THE SIGNAL LAYOUT, THE INTERCONNECT PLAN AND THE SYSTEM CABLE PLAN. WHEN AN EXISTING CONTROLLER IS UTILIZED FOR THIS TYPE OF DETECTION, THE PAY ITEM "INDUCTIVE LOOP DETECTOR WITH SYSTEM OUTPUT" SHOULD BE USED.

PLACEMENT OF DETECTORS

THE FOLLOWING FIGURES REPRESENT THE MOST COMMON DETECTOR LOOP LOCATIONS AND SIZES. ADJUSTMENTS WILL BE NECESSARY FOR SPECIFIC GEOMETRIC CONSIDERATIONS.

LOCATIONS AND DEMENSIONS OF DETECTOR LOOPS ARE REQUIRED ON ALL SIGNAL LAYOUT PLAN SHEETS.

"FAR OUT" DETECTION REFERS TO LOCKING, PRESENCE TYPE DETECTION LOCATED IN THRU LANES, RIGHT TURN LANES, AND RIGHT TURN LANE TAPER AREAS (IF APPLICABLE), USUALLY 250' (75 m) IN ADVANCE OF STOP BARS, "UPTIGHT" DETECTION REFERS TO NON-LOCKING PRESENCE TYPE DETECTION LOCATED IN ALL LANES AND 10'-15' (3.0 m-4.5 m) BEHIND THE CROSSING STREET'S EDGE OF PAVEMENT EXTENDED.

NOTE:

ALL DETAILS AND NOTES SHOWN ARE FROM THE I.D.O.T. DISTRICT 1 TRAFFIC SIGNAL DESIGN GUIDELINES DATED JANUARY 1995

THIS DRAWING HAS BEEN PREPARED TO ASSIST THE RESIDENT ENGINEER FOR ALL ROADWAY RESURFACING OR S.M.A.R.T. PROJECTS WHERE THE DIMENSIONS ARE NOT SHOWN ON THE PLANS AND THE FINAL LOCATIONS FOR CROSSWALKS OR STOP BARS ARE NOT DETERMINED.

SECTION

TS-07

FILE NAME = 21R0969-DTLS-01 - TS-07	USER NAME =	DESIGNED — MG	REVISED —	
		CHECKED — WPD	REVISED —	
	PLOT SCALE =	DRAWN — RG	REVISED —	
	PLOT DATE = 12-05-24	CHECKED — AG	REVISED —	

JSER NAME = footemj

PLOT DATE = 3/4/2019

PLOT SCALE = 50.0000 ' / In

DETAIL 1

N.T.S.

DESIGNED

CHECKED -

R.K.F.

DRAWN

DATE

STATE OF ILLINOIS
DEPARTMENT OF TRANSPORTATION

STATE OF ILLINOIS

DEPARTMENT OF TRANSPORTATION

DETAIL 2

N.T.S.

LANE OR LEFT TURN

SCALE: NONE

CENTER STREET
ROADWAY RESURFACING AND PEDESTRIAN ACCOMODATIONS
DISTRICT 1 DETAILS

SCALE: 1*=5' SHEET NO. 37 OF 49 SHEETS STA TO STA

DISTRICT 1 - DETECTOR LOOP INSTALLATION


DETAILS FOR ROADWAY RESURFACING


SHEET 1 OF 1 SHEETS STA.


COUNTY

CONTRACT NO

TOTAL SHEETS

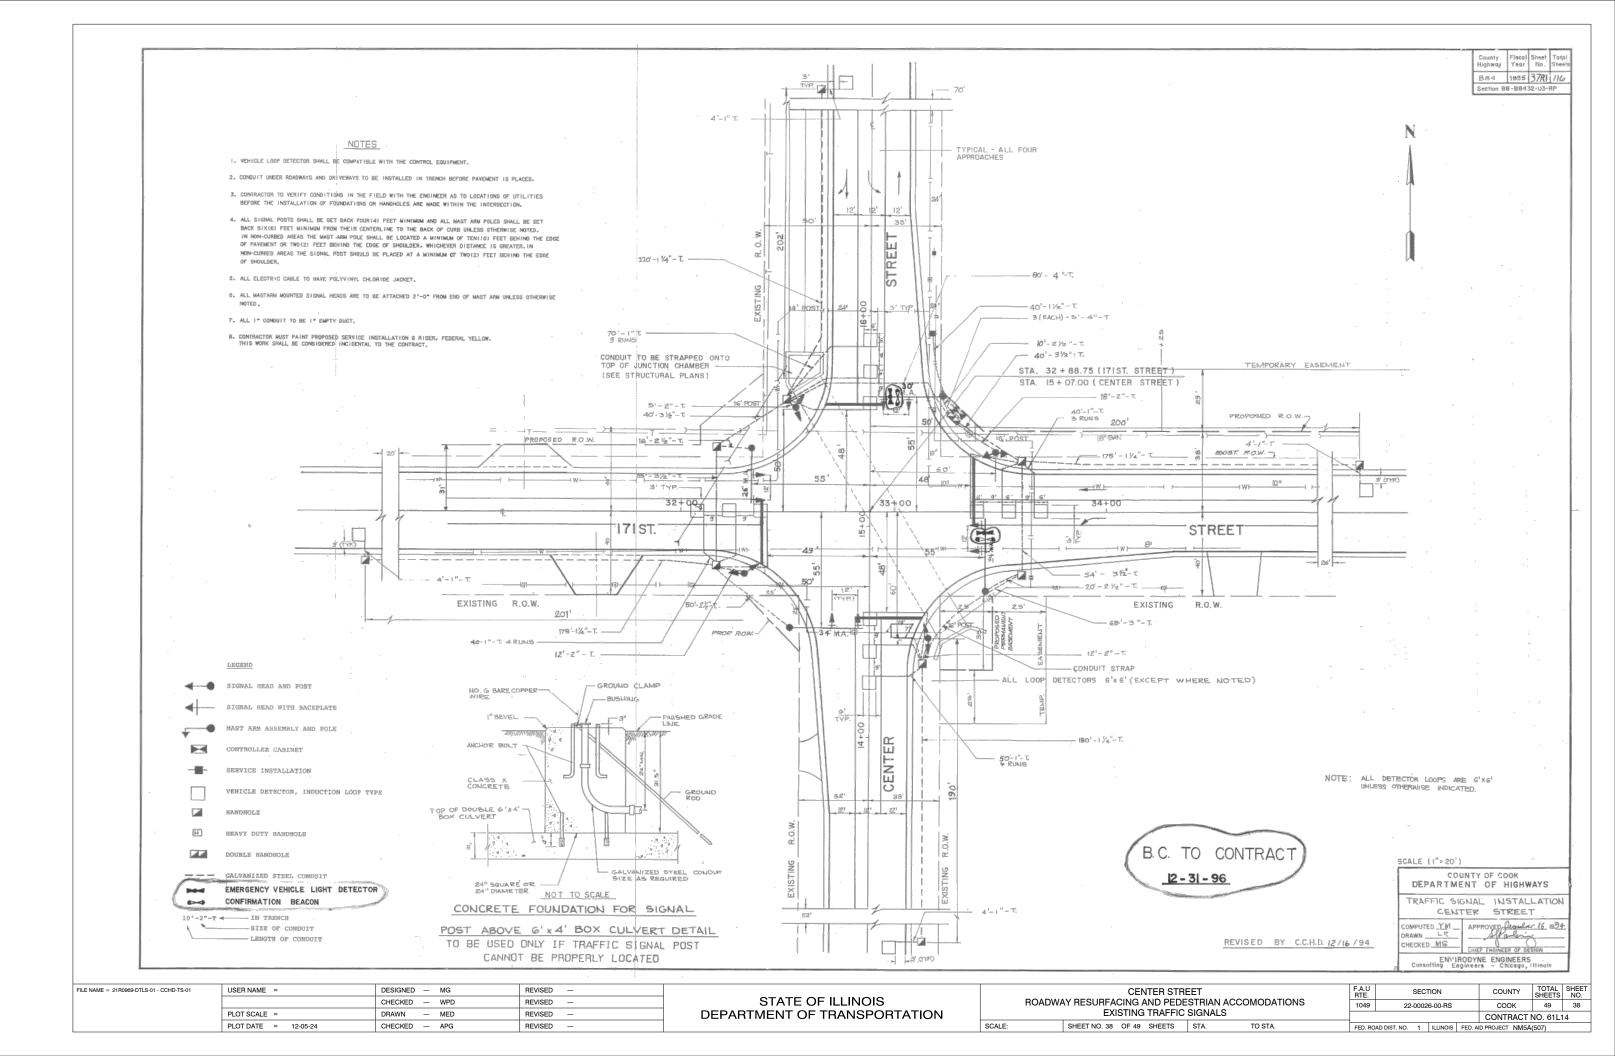

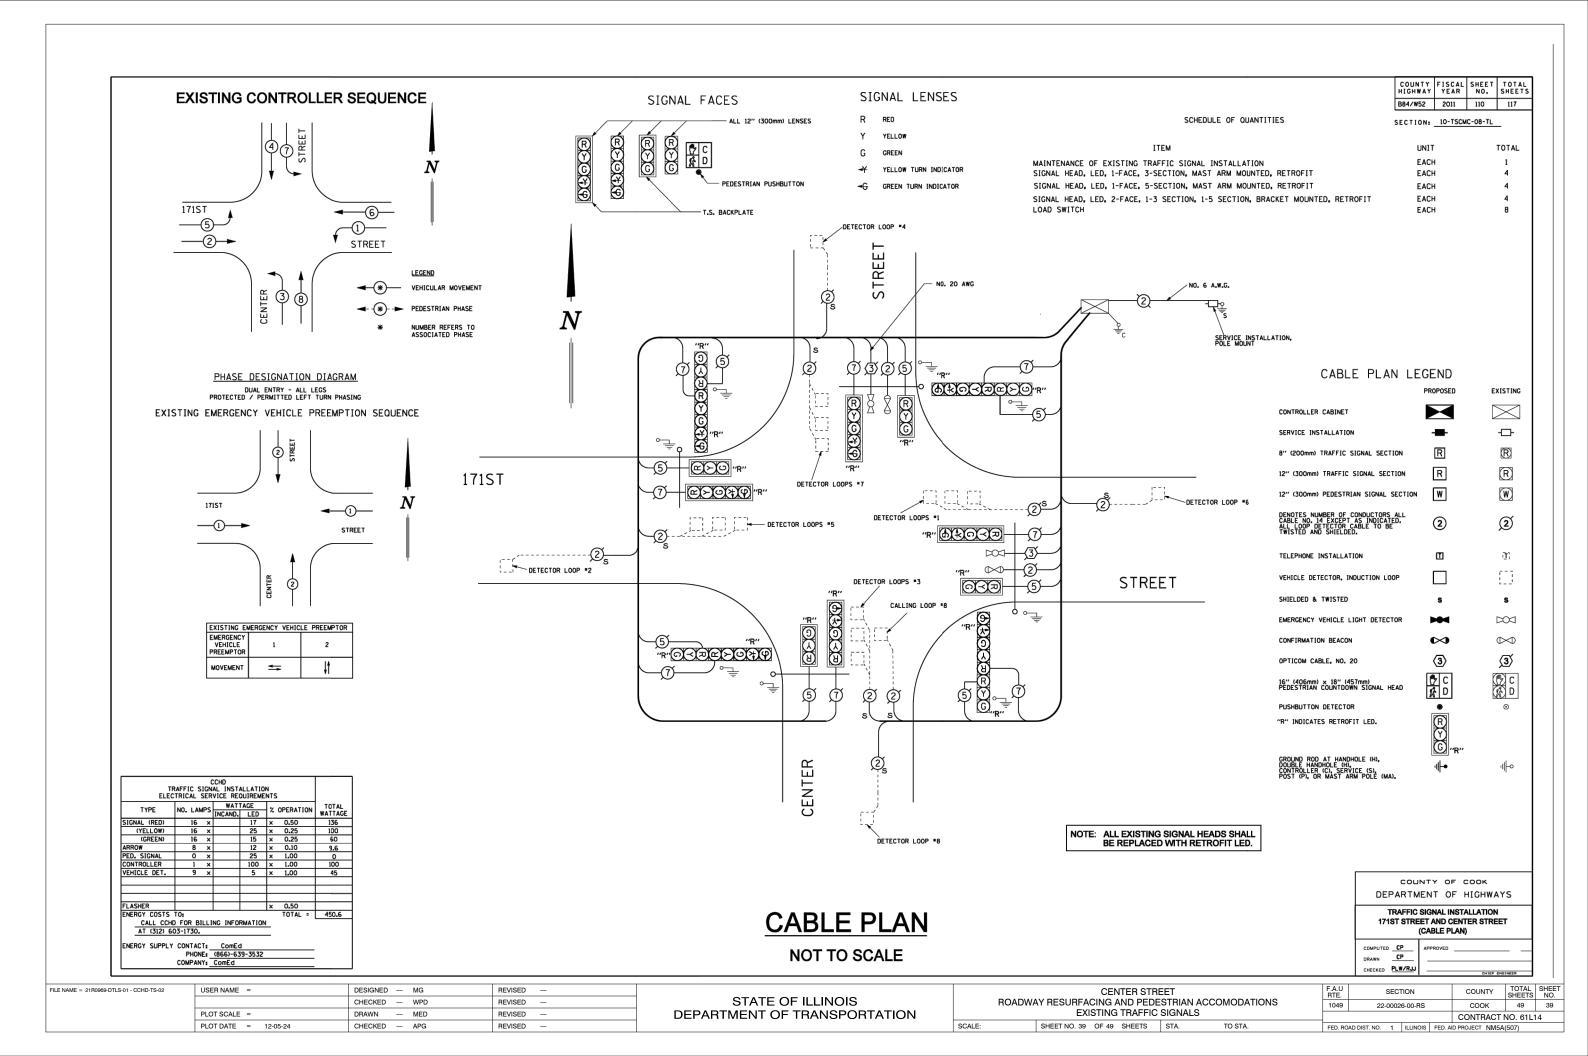

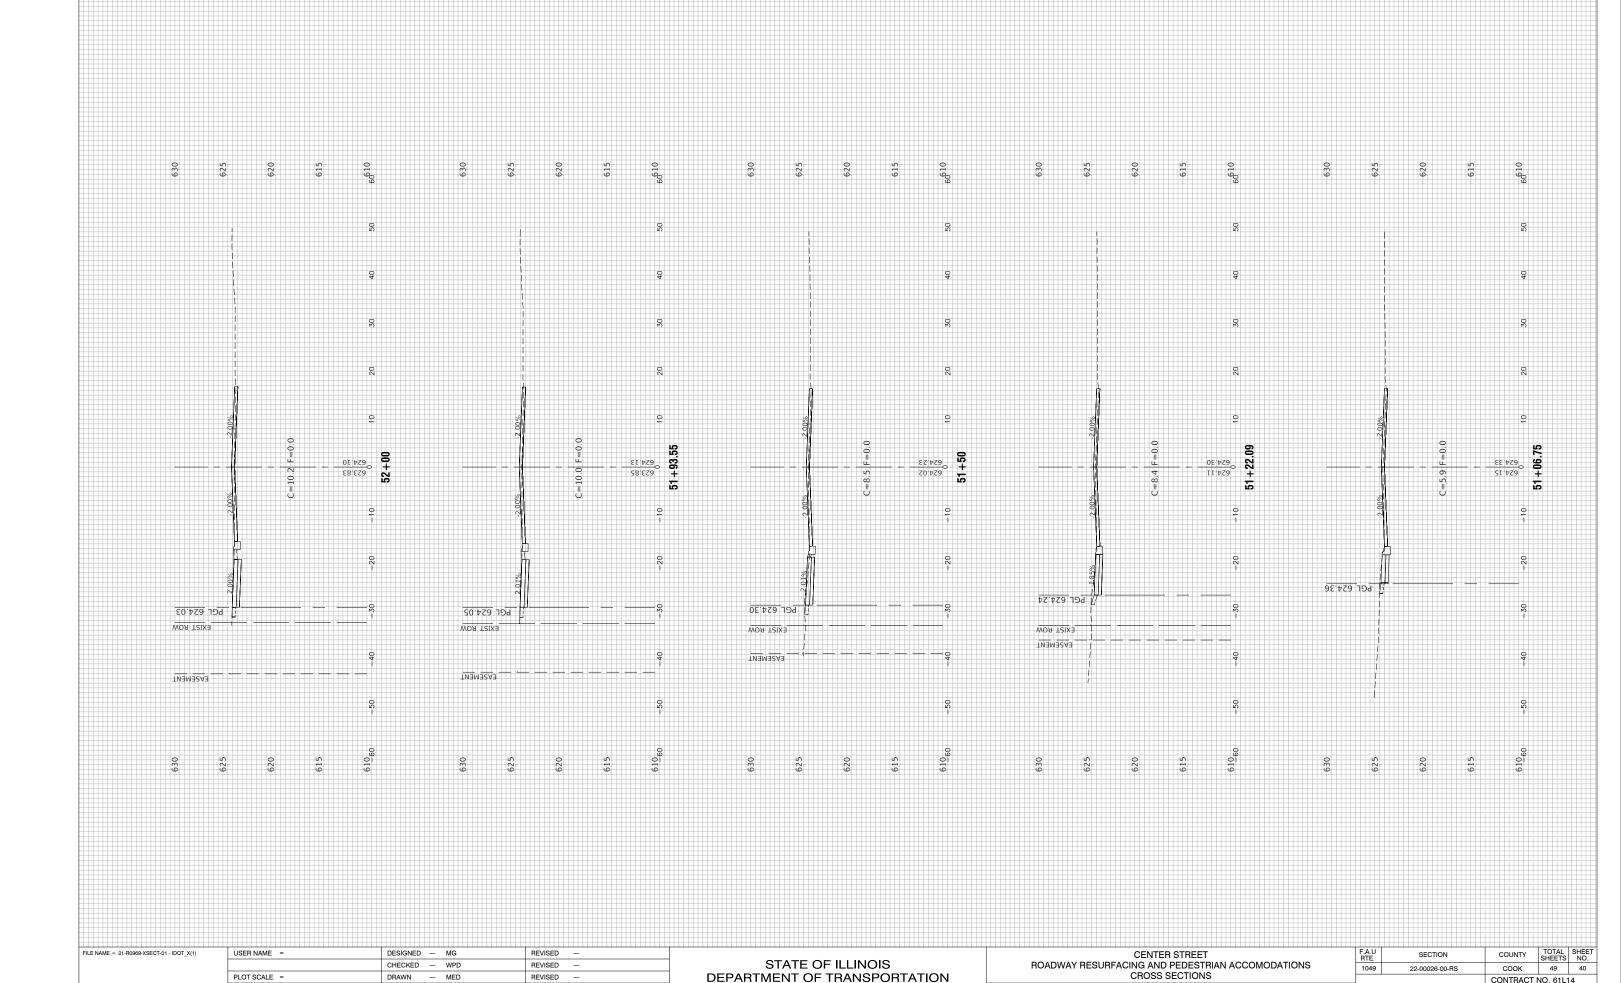

STATE OF ILLINOIS DEPARTMENT OF TRANSPORTATION

22-00026-00-RS

SHEET NO. 40 OF 49 SHEETS STA.

TO STA.

CONTRACT NO. 61L14

CHECKED — WPD

DRAWN — MED

CHECKED — AG


PLOT SCALE =

PLOT DATE = 12-05-24


REVISED —

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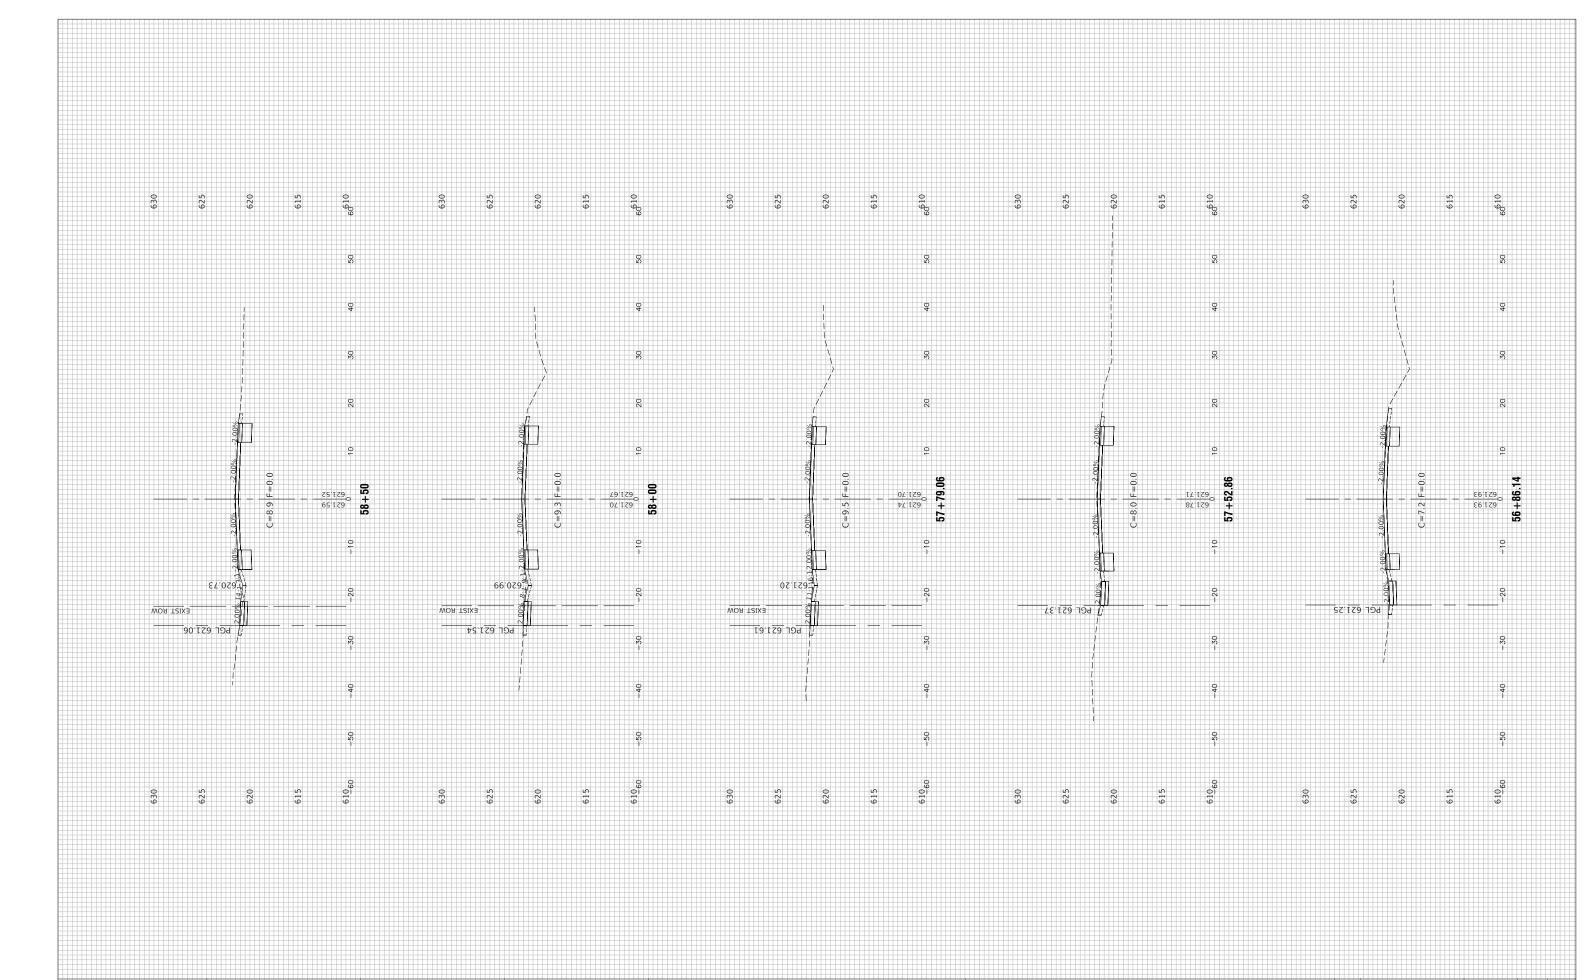
REVISED —

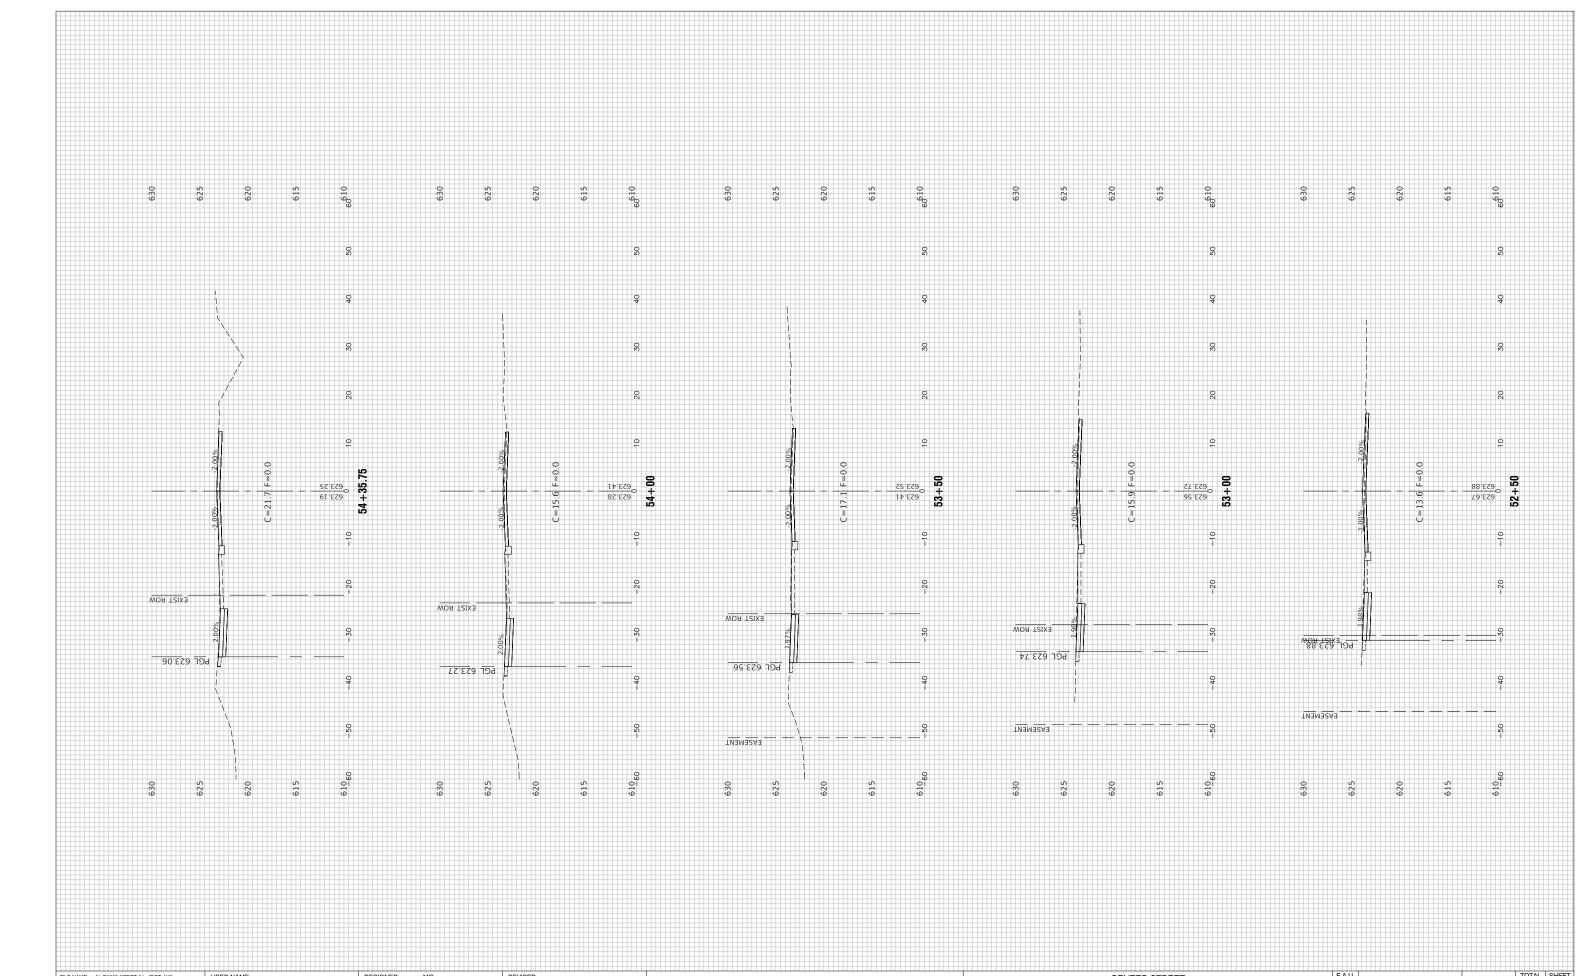


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		CHECKED — WPD	REVISED —	STATE OF ILLINOIS	RO	PADWAY RESURFACING AND PEDESTRIAN ACCOMODATIONS	1049	22-00026-00-RS	соок	49	41
	PLOT SCALE =	DRAWN — MED	REVISED —	DEPARTMENT OF TRANSPORTATION		CROSS SECTIONS			CONTRACT	T NO. 61L1	4
	PLOT DATE = 12-05-24	CHECKED — AG	REVISED —		SCALE:	SHEET NO. 41 OF 49 SHEETS STA. TO STA.	FED. RO	AD DIST. NO. 1 ILLINOIS FED.	. AID PROJECT NM5	15A(507)	

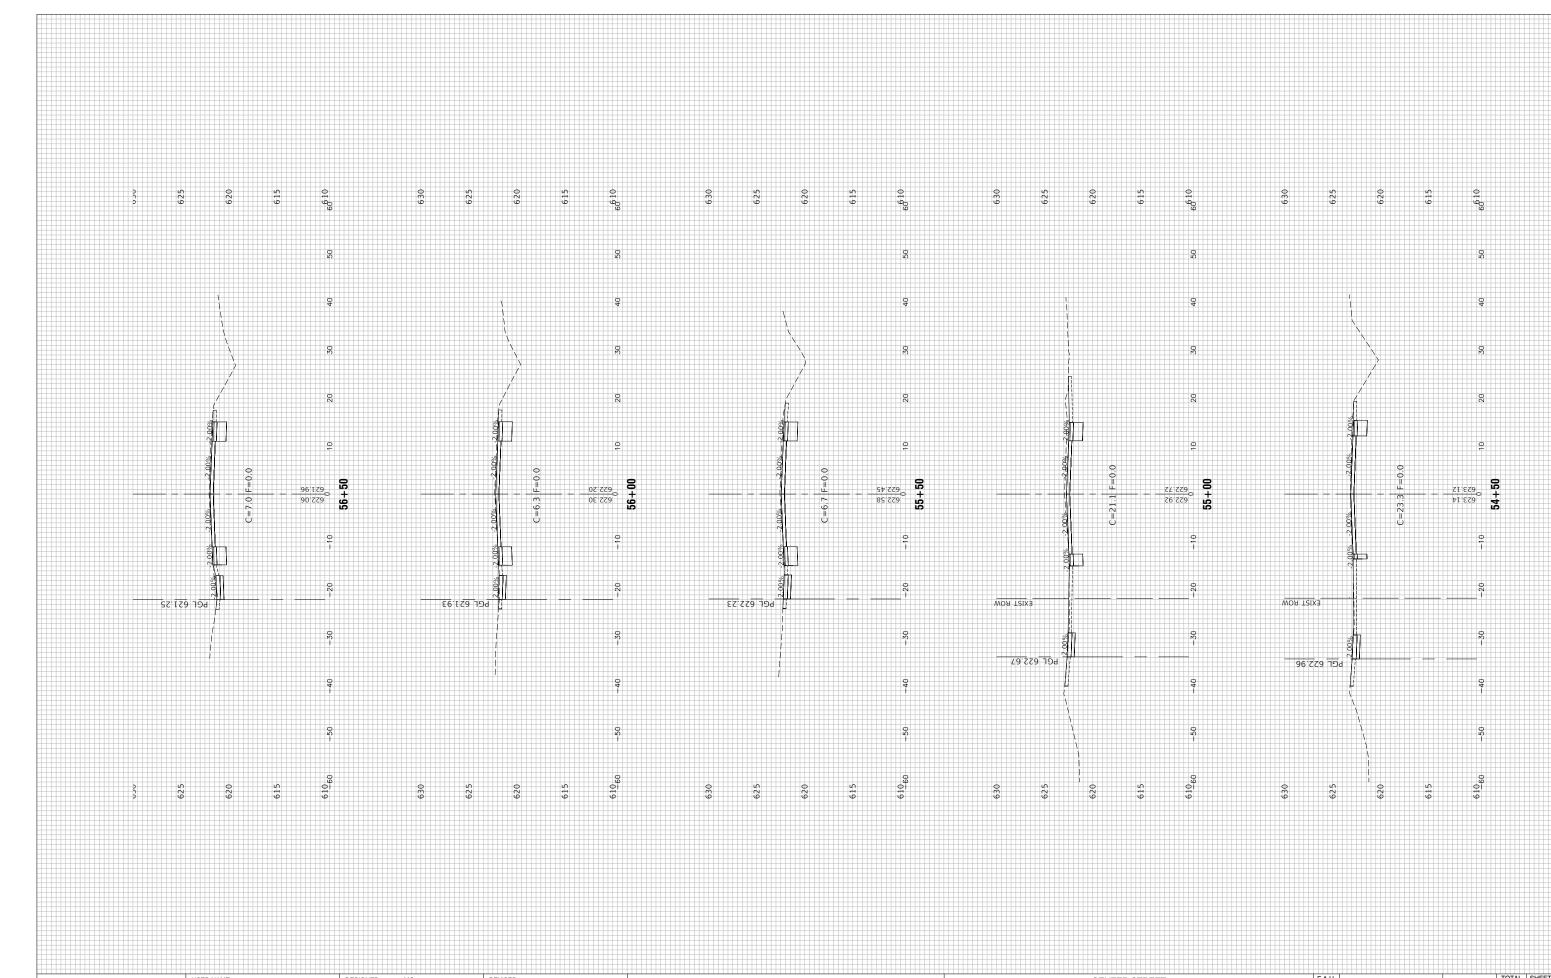


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		CHECKED — WPD	REVISED —	STATE OF ILLINOIS	RC	DADWAY RESURFACING AND PEDESTRIAN ACCOMODATIONS	1049	22-00026-00-RS	соок	49	42
	PLOT SCALE =	DRAWN — MED	REVISED —	DEPARTMENT OF TRANSPORTATION		CROSS SECTIONS			CONTRAC	CT NO. 61L	_14
	PLOT DATE = 12-05-24	CHECKED — AG	REVISED —		SCALE:	SHEET NO. 42 OF 49 SHEETS STA. TO STA.	FED. RO	AD DIST. NO. 1 ILLINOIS F	FED. AID PROJECT NM:	/I5A(507)	




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		CHECKED — WPD	REVISED —	STATE OF ILLINOIS	RC	DADWAY RESURFACING AND PEDESTRIAN ACCOMODATIONS	1049	22-00026-00-RS	соок	49	43
	PLOT SCALE =	DRAWN — MED	REVISED —	DEPARTMENT OF TRANSPORTATION		CROSS SECTIONS			CONTRACT	T NO. 61L1	4
	PLOT DATE = 12-05-24	CHECKED — AG	REVISED —		SCALE:	SHEET NO. 43 OF 49 SHEETS STA. TO STA.	FED. RO.	AD DIST. NO. 1 ILLINOIS FED.	. AID PROJECT NM5	5A(507)	

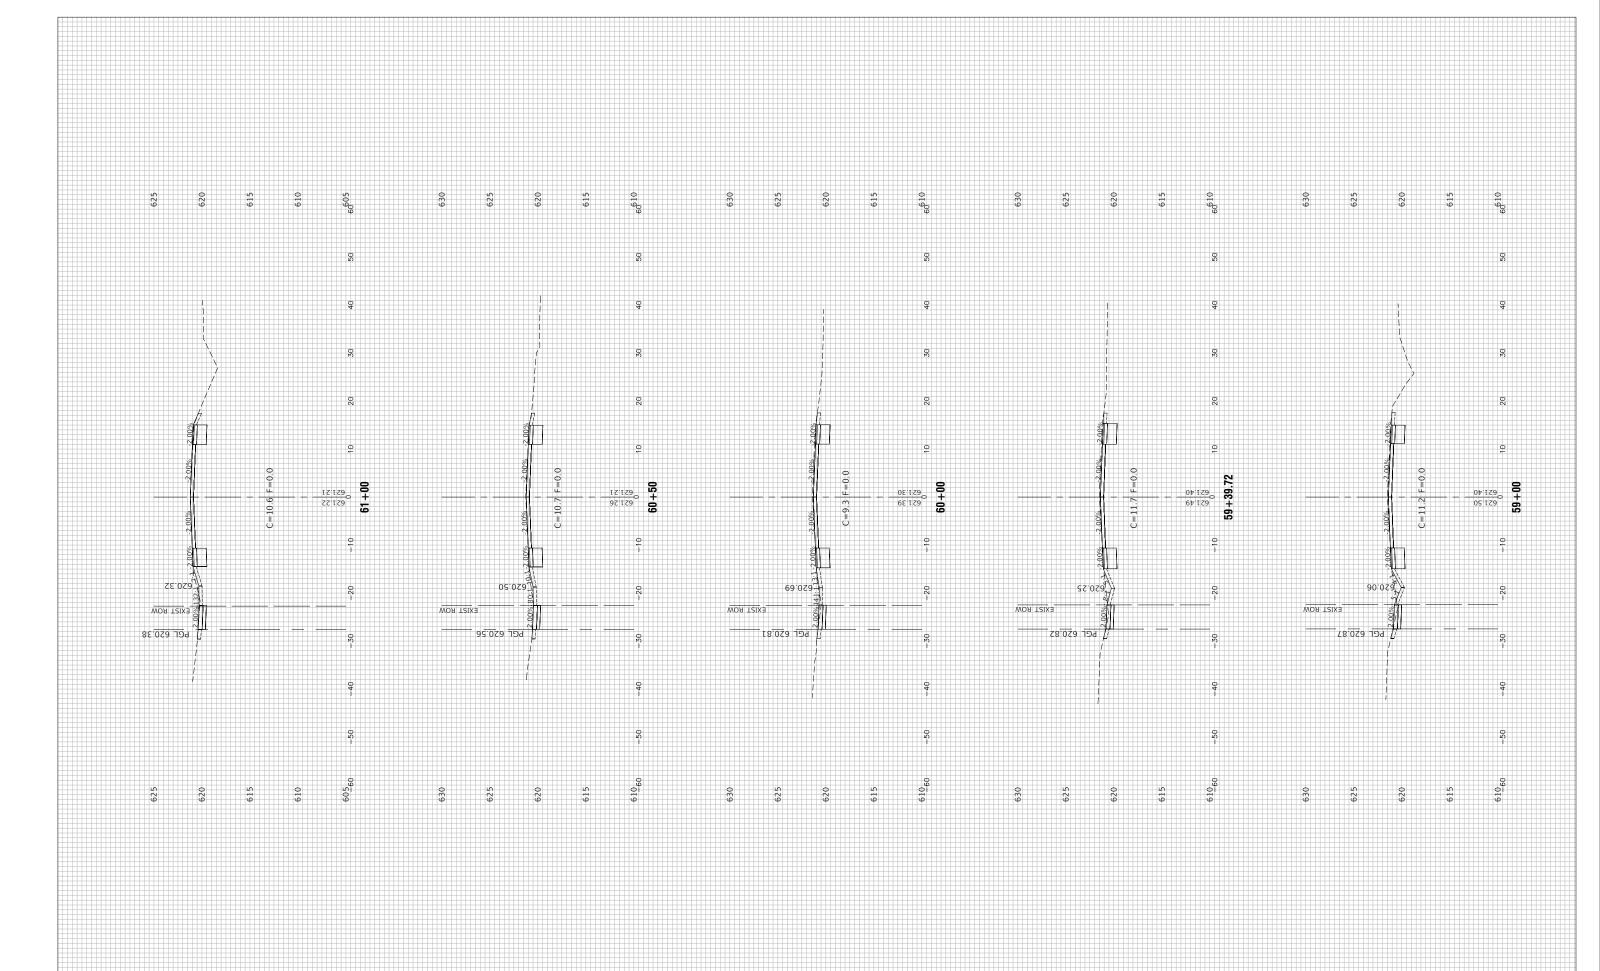


		T ====================================	T == #0==				F.A.U		COUNTY TOTAL SHEET
FILE NAME = 21-R0969-XSECT-01 - IDOT_X(5)	USER NAME =	DESIGNED — MG	REVISED —			CENTER STREET	RTE.	SECTION	COUNTY SHEETS NO.
		CHECKED — WPD	REVISED —	STATE OF ILLINOIS	ROADW	AY RESURFACING AND PEDESTRIAN ACCOMODATIONS	1049	22-00026-00-RS	COOK 49 44
	PLOT SCALE =	DRAWN — MED	REVISED —	DEPARTMENT OF TRANSPORTATION		CROSS SECTIONS			CONTRACT NO. 61L14
	PLOT DATE = 12-05-24	CHECKED — AG	REVISED —		SCALE:	SHEET NO. 44 OF 49 SHEETS STA. TO STA.	FED. ROAD I	DIST. NO. 1 ILLINOIS FEE). AID PROJECT NM5A(507)

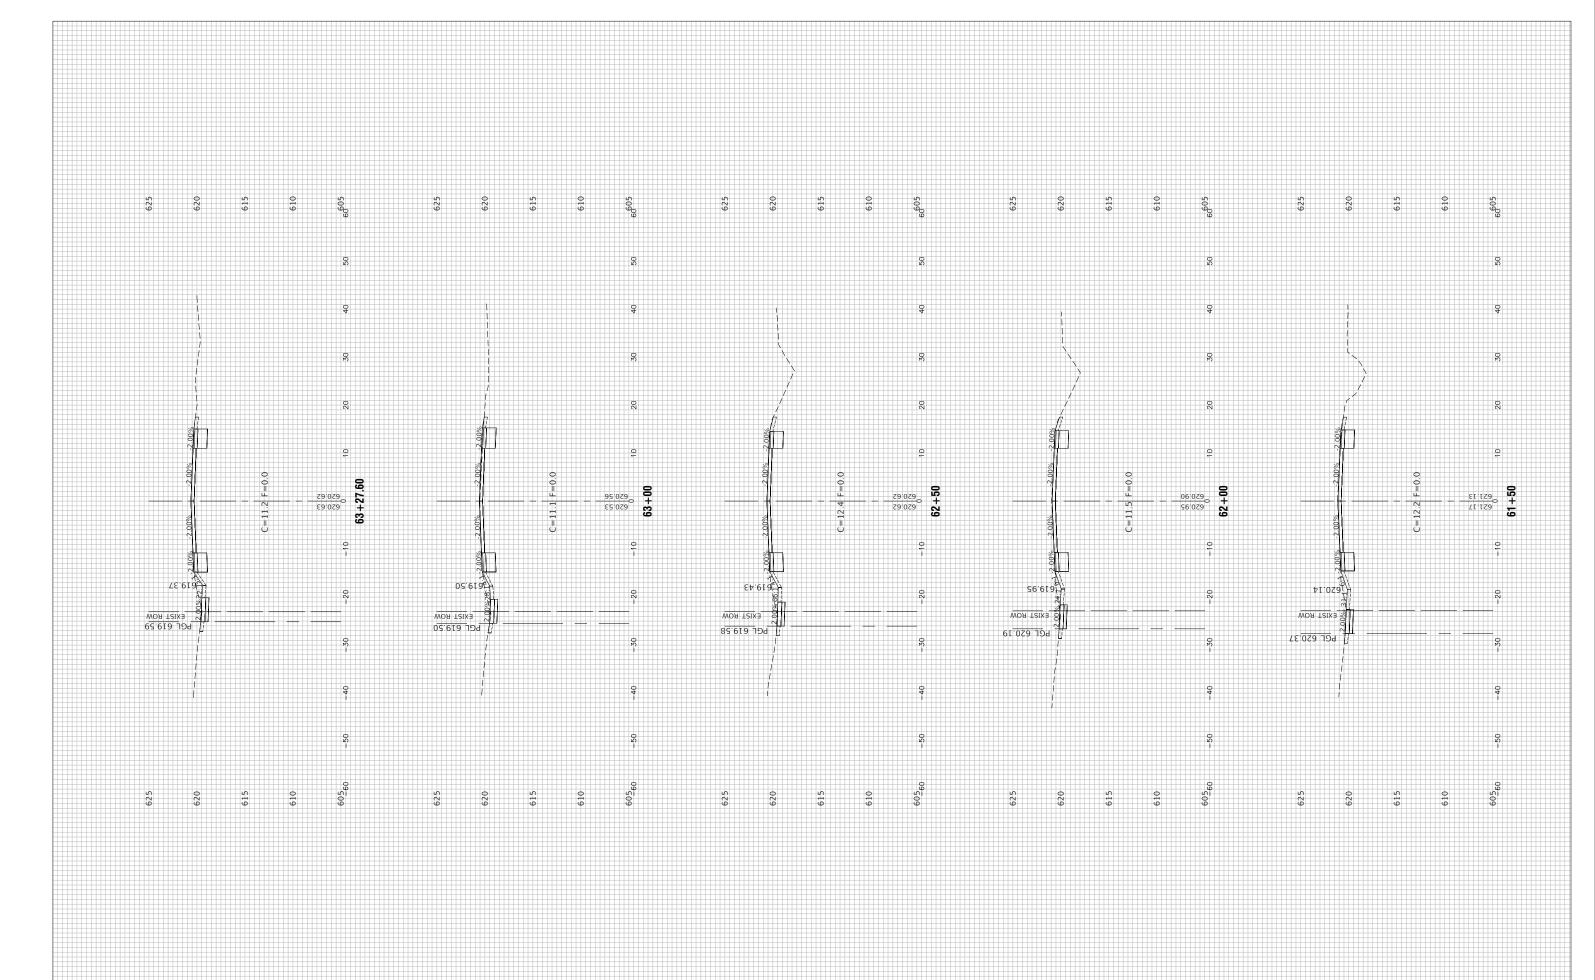

FILE NAME = 21-R0969-XSECT-01 - IDOT_X(6)	USER NAME =	DESIGNED — MG	REVISED —	07477 05 11 4 13 10 10			CENTER STE			RTE.	SECTION	COUNTY	SHEETS	NO.
		CHECKED — WPD	REVISED —	STATE OF ILLINOIS	ROADW				COMODATIONS	1049	22-00026-00-RS	соок	49	45
	PLOT SCALE =	DRAWN — MED	REVISED —	DEPARTMENT OF TRANSPORTATION			CROSS SECT	IONS				CONTRACT	NO. 61L	.14
	PLOT DATE = 12-05-24	CHECKED — AG	REVISED —		SCALE:	SHEET NO. 45	OF 49 SHEETS	STA.	TO STA.	FED. ROAD D	IST. NO. 1 ILLINOIS FED.	AID PROJECT NM5	A(507)	

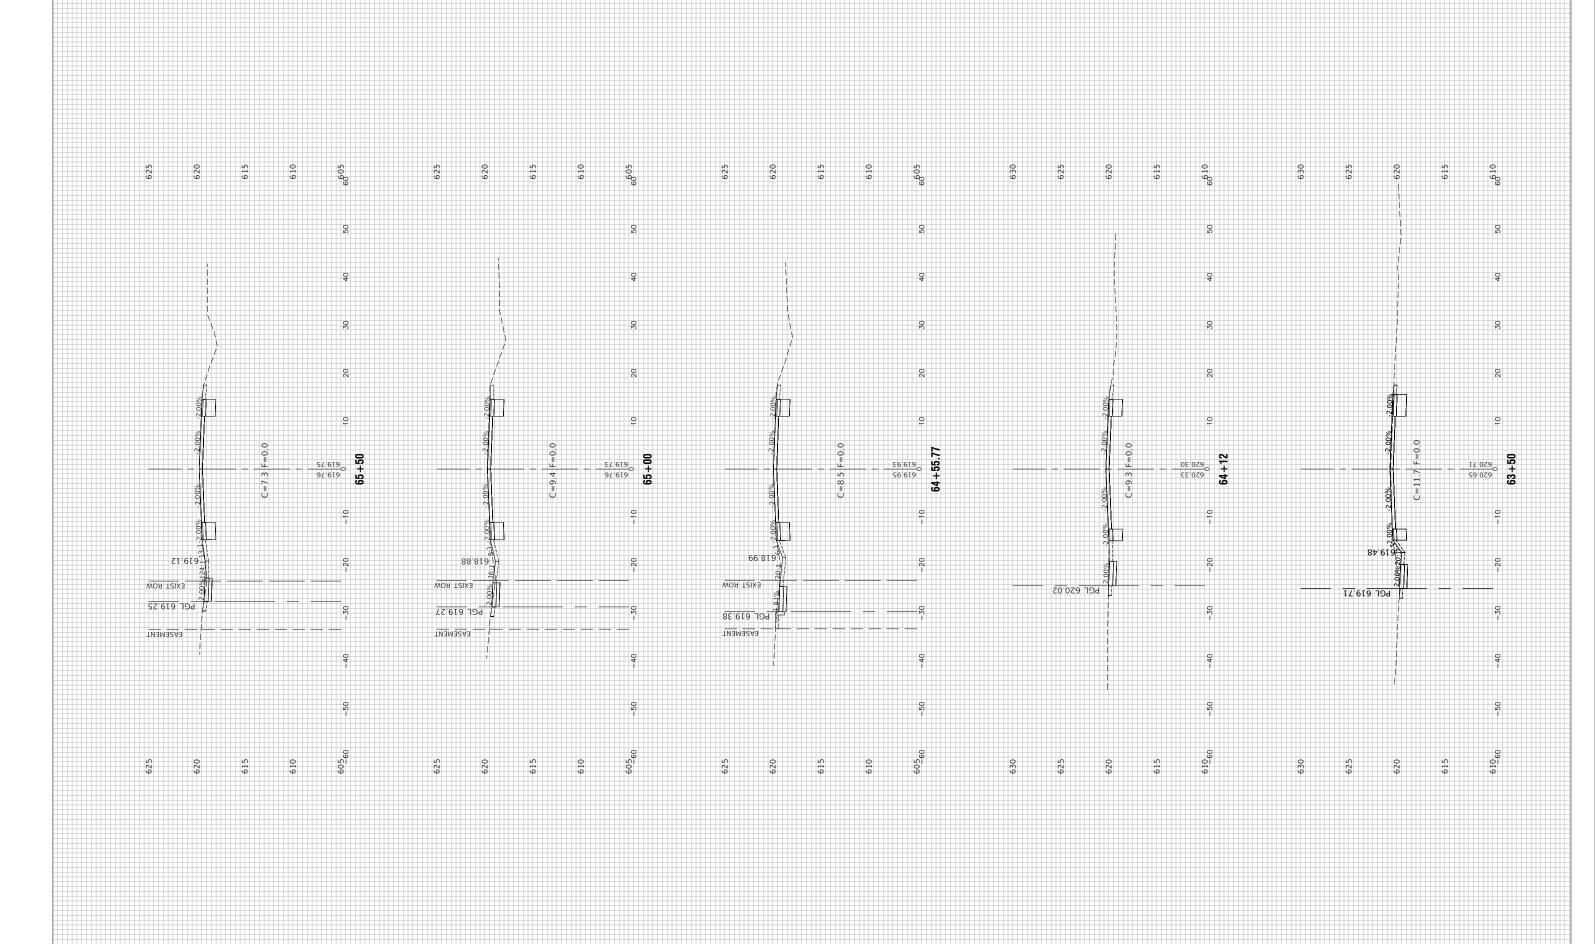


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		CHECKED — WPD	REVISED —	STATE OF ILLINOIS	ROADWA	AY RESURFACING AND PEDESTRIAN ACCOMODATIONS	1049	22-00026-00-RS	соок	49	46
	PLOT SCALE =	DRAWN — MED	REVISED —	DEPARTMENT OF TRANSPORTATION		CROSS SECTIONS			CONTRACT	NO. 61L14	\neg
	PLOT DATE = 12-05-24	CHECKED — AG	REVISED —		SCALE:	SHEET NO. 46 OF 49 SHEETS STA. TO STA.	FED. ROA	AD DIST. NO. 1 ILLINOIS FED. A	AID PROJECT NM5A	(507)	

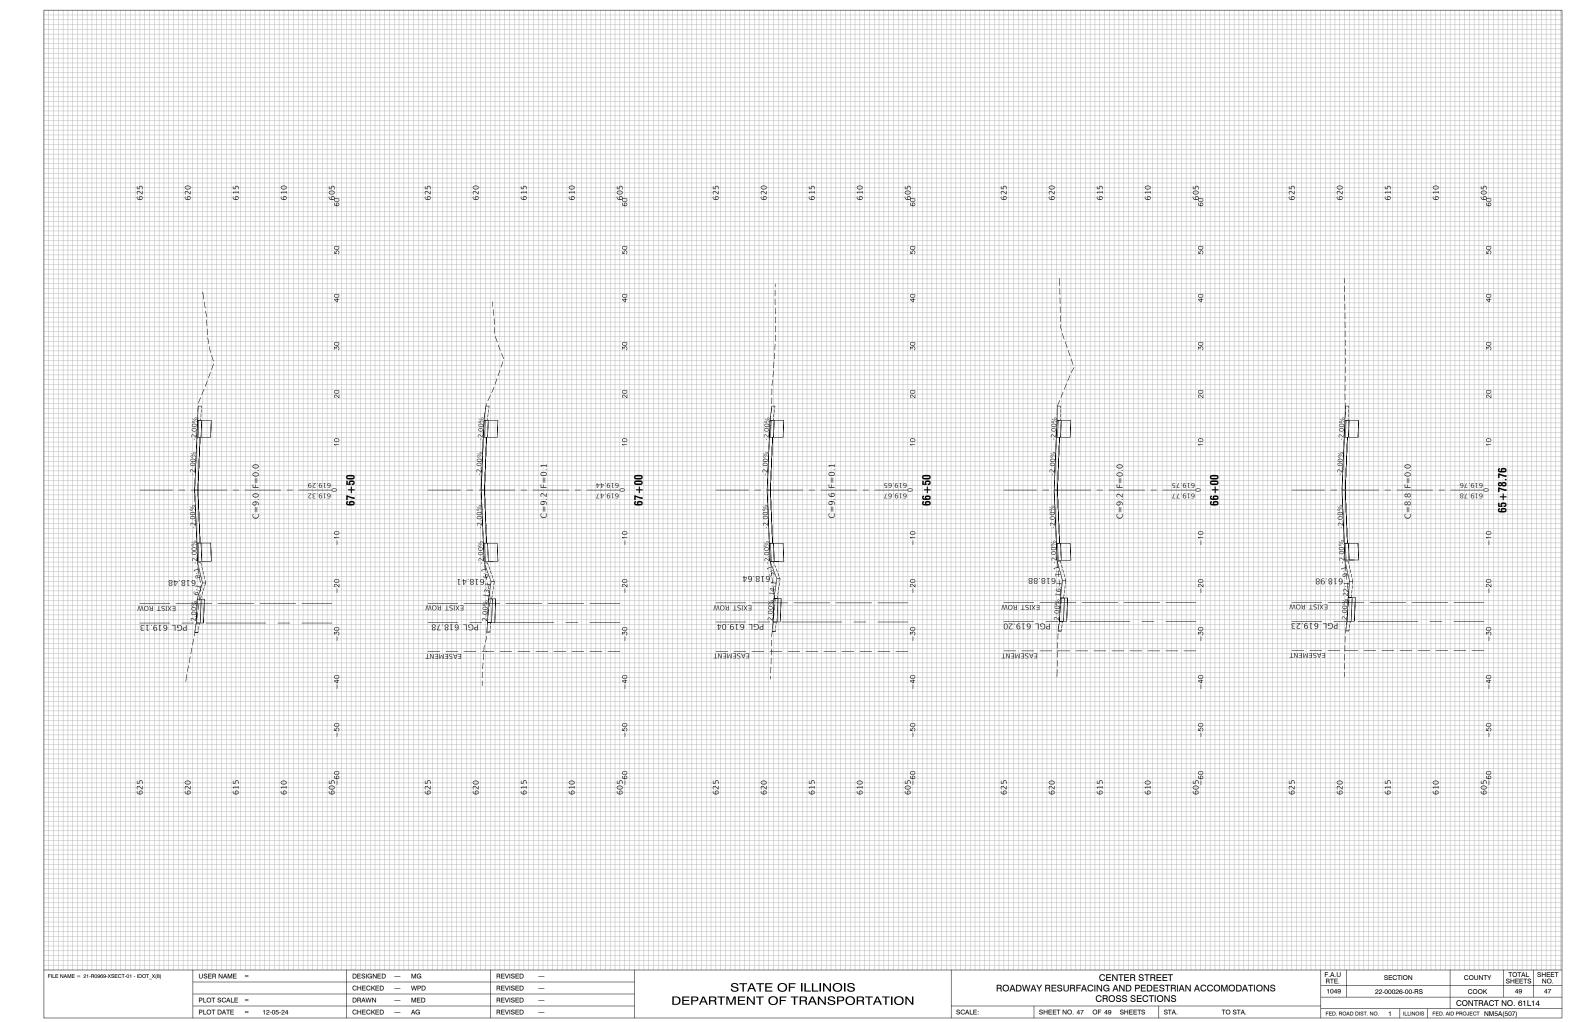


		CHECKED — WPD REVISED — STATE OF ILLINOIS DRAWN — MED REVISED — DEPARTMENT OF TRANSPORTATION		ROADW/	AY RESURFACING AND PE	
	PLOT SCALE =	DRAWN — MED	REVISED —	DEPARTMENT OF TRANSPORTATION		CROSS SE
	PLOT DATE = 12-05-24	CHECKED — AG	REVISED —		SCALE:	SHEET NO. 47 OF 49 SHEETS

			ITER STR			F.A.U RTE.		SEC	ΓΙΟΝ	
ROADWA	AY RESURFA				ACCOMODATIONS	1049	22-	-0002	6-00-RS	
		CRO	SS SECTION	UNS			-			
	SHEET NO. 47	OF 49	SHEETS	STA.	TO STA.	FED BO	AD DIST NO	1	ILLINOIS	F

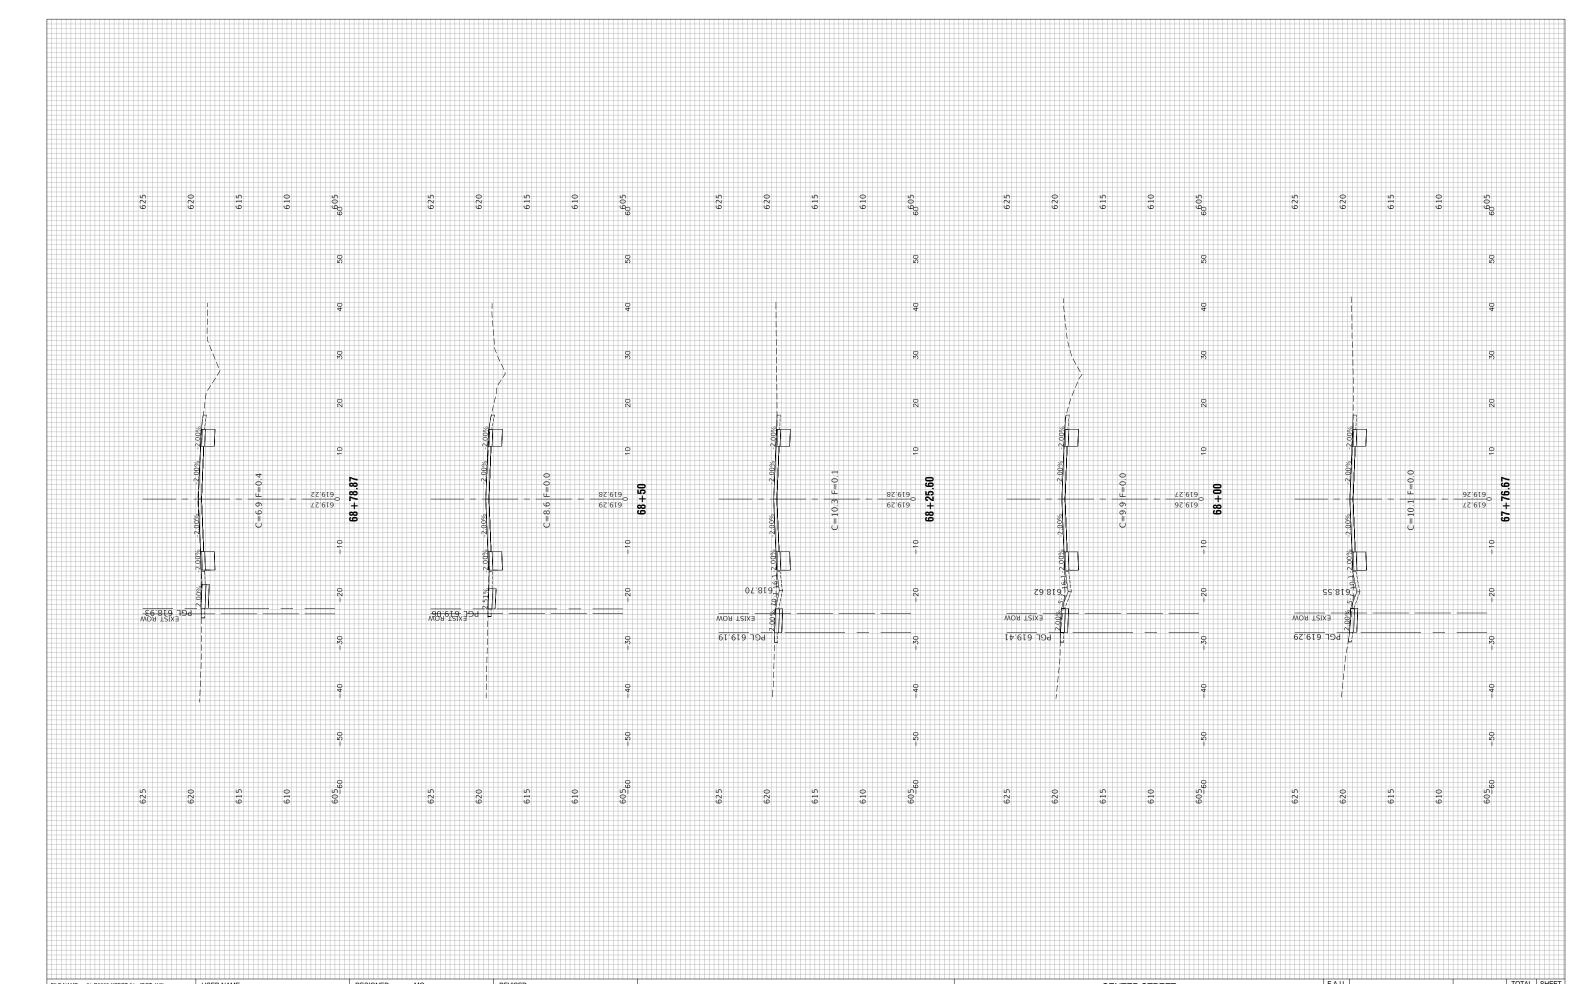

FILE NAME = 21-R0969-XSECT-01 - IDOT_X(9)	USER NAME =	DESIGNED — MG	REVISED —	07475 05 114 114010		CENTER STREET	RTE.	SECTION	COUNTY	SHEETS	
		CHECKED — WPD	REVISED —	STATE OF ILLINOIS	RO.	ADWAY RESURFACING AND PEDESTRIAN ACCOMODATIONS	1049	22-00026-00-RS	соок	49	48
	PLOT SCALE =	DRAWN — MED	REVISED —	DEPARTMENT OF TRANSPORTATION		CROSS SECTIONS			CONTRAC	T NO. 61L1	4
	PLOT DATE = 12-05-24	CHECKED — AG	REVISED —		SCALE:	SHEET NO. 48 OF 49 SHEETS STA. TO STA.	FED. ROA	JAD DIST. NO. 1 ILLINOIS FED	. AID PROJECT NM	/I5A(507)	

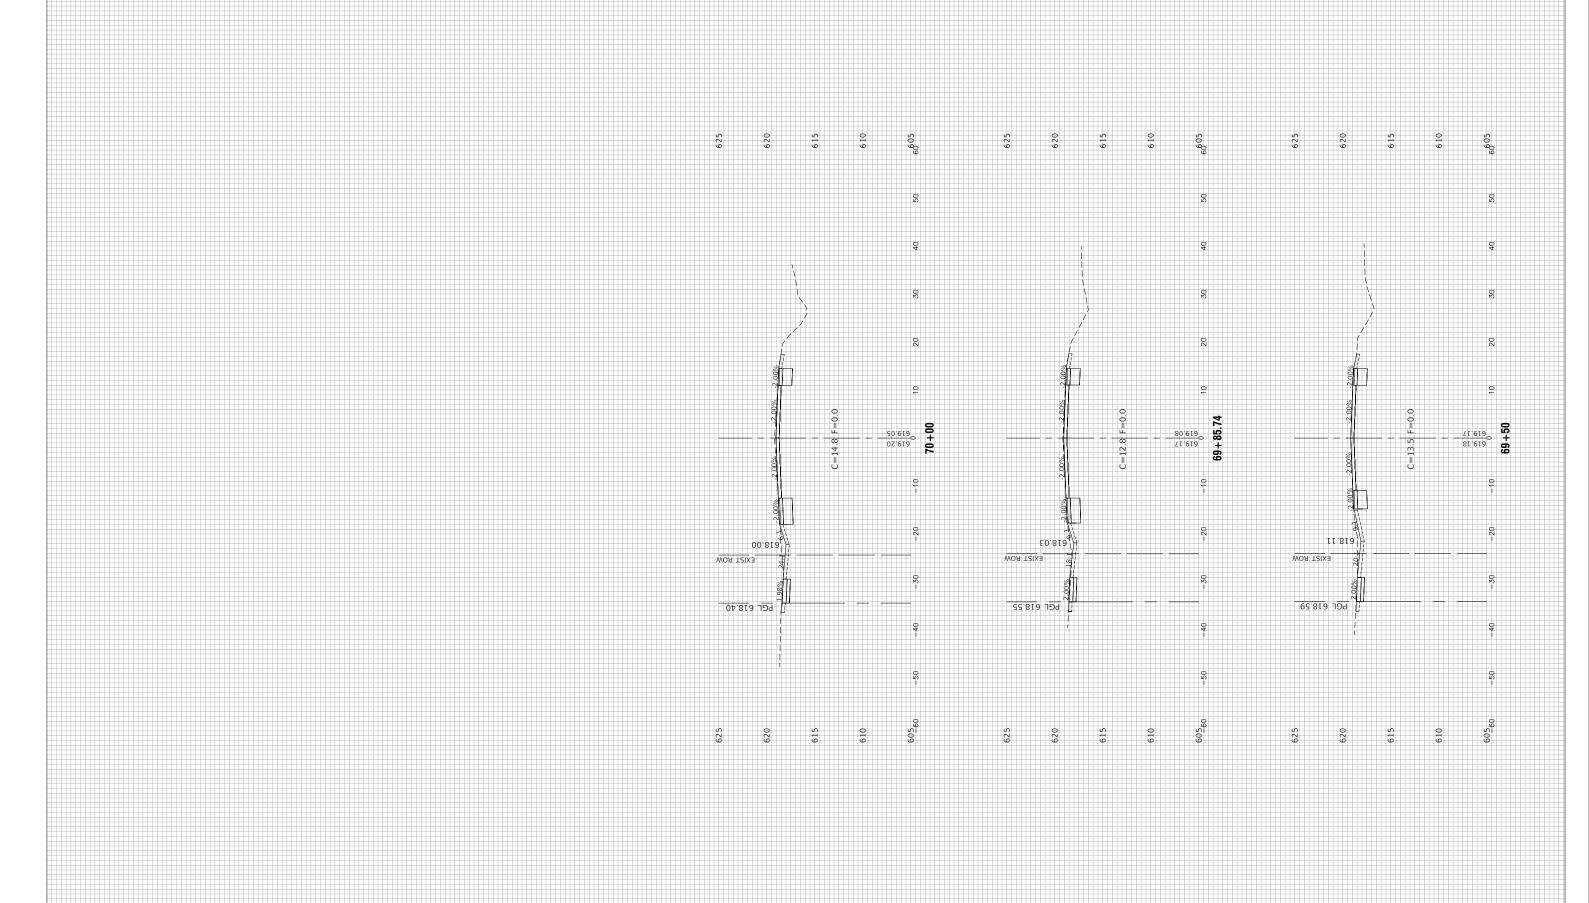

FILE NAME = 21-R0969-XSECT-01 - IDOT_X(10)

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	CHECKED — WPD	REVISED —	
PLOT SCALE =	DRAWN — MED	REVISED —	
PLOT DATE = 12-05-24	CHECKED — AG	REVISED —	

STATE OF ILLINOIS
DEPARTMENT OF TRANSPORTATION

	ROADWA	AY RESURFA	CING A	NTER STRE AND PEDE SS SECTION	STRIAN	I ACCOMODATIONS
SCALE:		SHEET NO. 49	OF 49	SHEETS	STA.	TO STA.

F.A.U RTE.		SEC	TION	COUNTY	TOTAL SHEETS	SHEET NO.		
1049	22	-0002	6-00-RS		соок	49	49	
	•			CONTRACT NO. 61L14				
FED. RC	AD DIST. NO.	1	ILLINOIS	FED. AID PROJECT NM5A(507)				