

F.A.U. RTE.	SECTION	COUNTY	TOTAL SHEETS	SHEET NO.
0347	05-00102-00-PV	KANE	488	1
		ILLINOIS	CONTRACT NO. 61J84	

FOR INDEX OF SHEETS, SEE SHEET NO. 2
FOR LIST OF HIGHWAY STANDARDS SEE SHEET NO. 2

03-07-2025 LETTING ITEM 175

DESIGN DESIGNATION


ILLINOIS RTE 38 (EAST STATE ST.) - PRINCIPAL ARTERIAL
ILLINOIS RTE 25 (BENNETT ST.) - MINOR ARTERIAL
EAST SIDE DRIVE - MAJOR COLLECTOR
ADT ILLINOIS RT 38: 26,600 (2021)
ADT ILLINOIS RT 38: 32,100 (2050)

POSTED SPEED LIMIT ILLINOIS RT 38: 30-35 MPH
DESIGN SPEED LIMIT ILLINOIS RT 38: 40 MPH

STATE OF ILLINOIS
DEPARTMENT OF TRANSPORTATION

**PLANS FOR PROPOSED
FEDERAL-AID HIGHWAY**

FAP RTE 0347 (ILLINOIS ROUTE 38, EAST STATE ST.)
SECTION 05-00102-00-PV
HIGHWAY RECONSTRUCTION
PROJECT #04JQ(635)
CITY OF GENEVA
KANE COUNTY

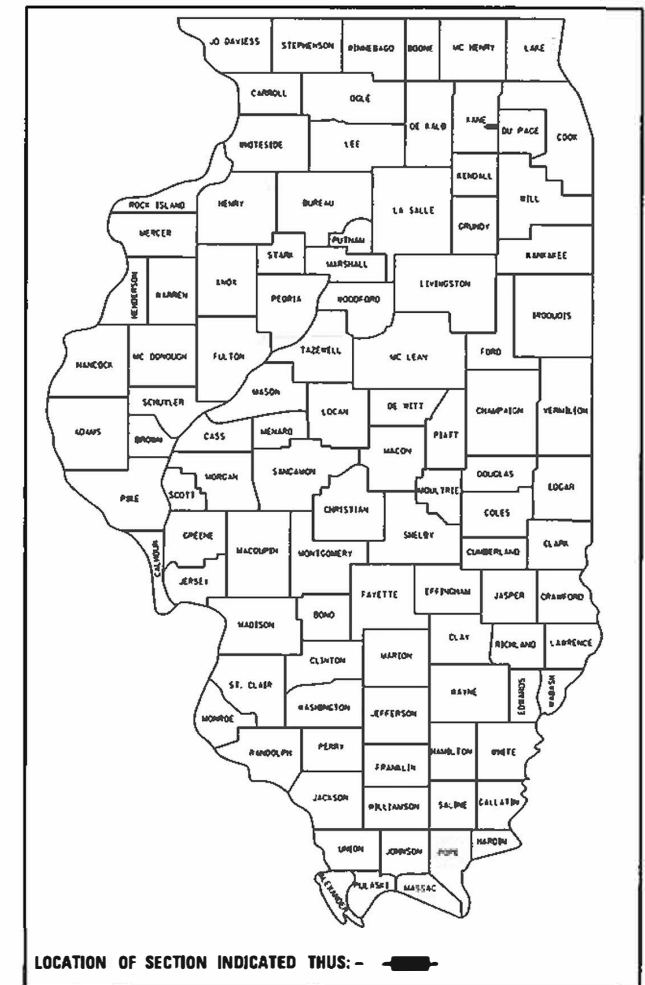

LOCATION OF SECTION INDICATED THUS: - [Black Box] -

EAST SIDE DRIVE IMPROVEMENTS
BEGIN RECONSTRUCTION STA 140+78.00
END RECONSTRUCTION STA 142+22.93
END RESURFACING STA 146+36.93


ILLINOIS ROUTE 25 IMPROVEMENTS
END RECONSTRUCTION STA 328+83.65
END RESURFACING STA 332+05.76

ILLINOIS ROUTE 38 IMPROVEMENTS
BEGIN RECONSTRUCTION STA 118+06.93

S.N. 045-2014

ILLINOIS ROUTE 25 IMPROVEMENTS
BEGIN RESURFACING STA 321+70.00
BEGIN WIDENING & RESURFACING STA 324+17.39
BEGIN RECONSTRUCTION STA 326+77.24


ILLINOIS ROUTE 38 IMPROVEMENTS
END RECONSTRUCTION STA 175+69.60
END MUP CONSTRUCTION STA 185+01.77

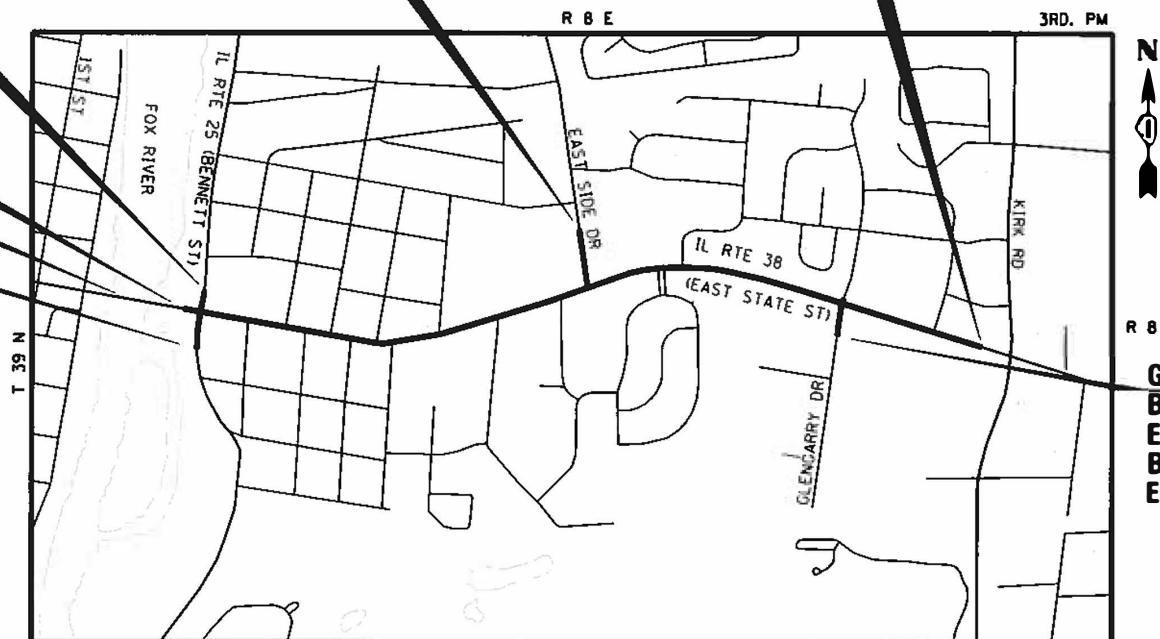

LOCATION MAP

ILLINOIS ROUTE 38 GROSS AND NET LENGTH = 6,694.9 FT. = 1.27 MI.
ILLINOIS ROUTE 25 GROSS AND NET LENGTH = 830 FT. = 0.16 MI.
EAST SIDE DRIVE GROSS AND NET LENGTH = 414 FT. = 0.08 MI.
GLEN GARRY DRIVE GROSS AND NET LENGTH = 287 FT. = 0.05 MI.
TOTAL GROSS AND NET LENGTH = 8,225.9 FT = 1.56 MI.

GLEN GARRY DR. IMPROVEMENTS
BEGIN RESURFACING STA 204+80.25
END RESURFACING STA 206+85.22
BEGIN RESURFACING STA 208+71.49
END RESURFACING STA 209+56.57

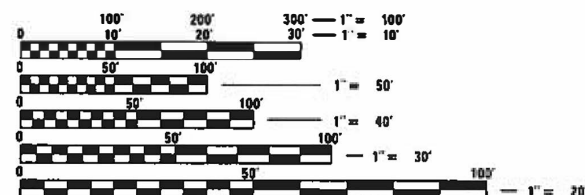

FULL SIZE PLANS HAVE BEEN PREPARED USING STANDARD ENGINEERING SCALES. REDUCED SIZED PLANS WILL NOT CONFORM TO STANDARD SCALES. IN MAKING MEASUREMENTS ON REDUCED PLANS THE ABOVE SCALES MAY BE USED.

J.U.L.I.E.
JOINT UTILITY LOCATION INFORMATION FOR EXCAVATION
1-800-892-0123
OR 811

CONSULTING ENGINEERS **BLA, Inc.**
333 PIERCE ROAD SUITE 200 ITASCA, IL 60143
P:(630) 438 6400 F:(630) 438 6444 www.bla-inc.com

CONTRACT NO. 61J84

DANIEL B. BRUCKELMEYER
ILLINOIS REGISTERED PROFESSIONAL ENGINEER NO. 062.063352
MY LICENSE EXPIRES ON 11-30-25.
DATE 11/7/2024

STATE OF ILLINOIS
DEPARTMENT OF TRANSPORTATION

APPROVED 11/7/2024
[Signature]
CITY OF GENEVA

PASSED Jan 2, 2025
[Signature]
DISTRICT ONE ENGINEER OF LOCAL ROADS & STREETS

RELEASING FOR BID
BASED ON LIMITED
REVIEW 1-6-2025
[Signature]
REGIONAL ENGINEER

**PRINTED BY THE AUTHORITY
OF THE STATE OF ILLINOIS**

FEDERAL AID PROGRAM ENGINEER: CARMEN E. RAMOS, P.E. SCHAUMBURG, IL

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BD-36	FIRE HYDRANT TO BE MOVED
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BE-220	ELECTRICAL SERVICE INSTALLATION AERIAL, REMOTE DISCONNECT
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BE-702	MISCELLANEOUS DETAILS, SHEET A- CABLE SPLICE, POLE WIRING, TRENCH DETAIL
TC-10	TRAFFIC CONTROL AND PROTECTION FOR SIDE ROADS, INTERSECTIONS AND DRIVEWAYS
TC-11	RAISED REFLECTIVE PAVEMENT MARKERS (SNOW PLOW RESISTANT)
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TS-07	DETECTOR LOOP INSTALLATION DETAILS FOR ROADWAY RESURFACING

COMMITMENTS

- ACCESS TO THE FOX RIVER TRAIL SHALL BE MAINTAINED THROUGHOUT THE DURATION OF THE WORK
- CONTRACTOR SHALL COORDINATE WITH THE GENEVA PARK DISTRICT TO PROVIDE ADVANCE NOTIFICATION OF THE CONSTRUCTION WORK.
- ONCE PARKING CLOSURE ALONG WATER STREET HAS BEGUN, CONTRACTORS SHALL DILLIGENTLY PURSUE COMPLETION OF THE WORK TO MINIMIZE DURATION OF THE CLOSURE. PARKING AREA CLOSURES SHALL NOT EXCEED TWO WEEKS IN DURATION.
- OLD MILL PARK SHALL NOT BE USED AS A STAGING AREA FOR EQUIPMENT OR MATERIALS.
- TREES THREE (3) INCHES OR GREATER IN DIAMETER SHALL NOT BE REMOVED FROM APRIL 1st THROUGH OCTOBER 31st OF ANY CONSTRUCTION YEAR.

FILE NAME = FA\951-000 Geneva East State St\CAADD_Sheets\951-000_SHT_GENNOTE.dgn

	USER NAME = gellwanger	DESIGNED - GJE	REVISED -	STATE OF ILLINOIS DEPARTMENT OF TRANSPORTATION	ILLINOIS ROUTE 38 - EAST STATE STREET			F.A.U. RTE.	SECTION	COUNTY	TOTAL SHEETS	SHEET NO.
	DRAWN - GJE	REVISIONS -			0347	05-00102-00-PV	KANE	488	2			
PLLOT SCALE = 100.0000' / 1in.	CHECKED - DBB	REVISIONS -			INDEX, HIGHWAY STANDARDS, GENERAL NOTES, AND COMMITMENTS			CONTRACT NO. 61J84				
PLLOT DATE = 2/6/2025	DATE - 11/7/2024	REVISIONS -			SCALE: N.T.S.	SHEET 1 OF 2 SHEETS	STA. TO STA.	ILLINOIS FED. AID PROJECT				

GENERAL NOTES

1. ALL CONSTRUCTION SHALL BE DONE IN ACCORDANCE WITH THE STANDARD SPECIFICATIONS FOR ROAD AND BRIDGE CONSTRUCTION ADOPTED JANUARY 1, 2022 (HEREIN AFTER REFERRED TO AS THE STANDARD SPECIFICATIONS; THE SUPPLEMENTAL SPECIFICATIONS AND RECURRING SPECIAL PROVISIONS ADOPTED JANUARY 1, 2025; THE LATEST EDITION OF THE ILLINOIS MANUAL ON UNIFORM TRAFFIC CONTROL DEVICES FOR STREETS AND HIGHWAYS; THE STANDARD SPECIFICATIONS FOR WATER & SEWER MAIN CONSTRUCTION IN ILLINOIS, LATEST EDITION; THE DETAILS IN THE PLANS; AND THE SPECIAL PROVISIONS INCLUDED IN THE CONTRACT DOCUMENTS.
2. ANY REFERENCE TO STANDARDS THROUGHOUT THE PLANS OR SPECIAL PROVISIONS SHALL BE INTERPRETED AS THE LATEST STANDARD OF THE ILLINOIS DEPARTMENT OF TRANSPORTATION STANDARD SPECIFICATIONS.
3. BEFORE STARTING ANY EXCAVATION, THE CONTRACTOR SHALL CALL "J.U.L.I.E." AT (800) 892-0123 OR 811 FOR FIELD LOCATIONS OF BURIED ELECTRIC, TELEPHONE AND GAS UTILITIES. 48 HOURS NOTIFICATION IS REQUIRED.
4. 10' TRANSITIONS SHALL BE USED TO MATCH PROPOSED CURB & GUTTER AND MEDIAN ITEMS OF WORK TO EXISTING CURBS & GUTTERS AND MEDIAN IN THE FIELD, UNLESS OTHERWISE SHOWN. THE TRANSITIONS SHALL BE PAID FOR AT THE CONTRACT UNIT PRICE FOR THE PROPOSED ITEMS OF WORK SPECIFIED.
5. THE CONTRACTOR SHALL COORDINATE CONSTRUCTION ACTIVITIES WITH UTILITY COMPANIES AND WITH LOCAL EMERGENCY SERVICES INCLUDING THE CITY OF GENEVA POLICE AND FIRE DEPARTMENT.
6. THE CONTRACTOR WILL NOT BE ALLOWED TO SET UP A YARD OR FIELD OFFICE ON STATE PROPERTY WITHOUT WRITTEN PERMISSION FROM THE DEPARTMENT.
7. WHEN ARTIFICIAL LIGHTING IS UTILIZED IN NIGHT OPERATIONS THE CONTRACTOR SHALL EXERCISE THE UTMOST PRECAUTIONS IN PREVENTING ADVERSE VISIBILITY TO THE MOTORING PUBLIC AND ADJOINING RESIDENTIAL AREAS.
8. THE RESIDENT ENGINEER SHALL CONTACT AREA TRAFFIC FIELD ENGINEER MR. EMAD ALHUSEINI AT EMAD.ALHUSEINI@ILLINOIS.GOV A MINIMUM OF 2 WEEKS PRIOR TO PLACEMENT OF PERMANENT PAVEMENT MARKINGS.
9. THE CONTRACTOR SHALL CONTACT THE TRAFFIC CONTROL SUPERVISOR AT KALPANA.KANNAN-HOSADURGA@ILLINOIS.GOV A MINIMUM OF 72 HOURS IN ADVANCE OF BEGINNING ANY WORK.
10. THE LOCATIONS OF EXISTING UTILITIES SHOWN ON THE PLANS ARE FOR INFORMATIONAL PURPOSES ONLY AND ARE BASED ON FIELD INVESTIGATIONS AND THE BEST INFORMATION AVAILABLE. IT SHALL BE THE CONTRACTOR'S RESPONSIBILITY TO ASCERTAIN THEIR EXACT LOCATIONS FROM THE UTILITY COMPANIES AND BY FIELD INSPECTION.
11. DO NOT SCALE PLANS FOR CONSTRUCTION DIMENSIONS
12. EXISTING MAILBOXES AFFECTED BY CONSTRUCTION SHALL BE RELOCATED AS DIRECTED BY THE LOCAL POSTAL AUTHORITY AND THE ENGINEER. REFER TO PROJECT SPECIFICATIONS AND SPECIAL PROVISIONS.
13. THE CONTRACTOR SHALL TAKE CARE IN REMOVING OR EXCAVATING NEAR ALL EXISTING ITEMS WHICH WILL REMAIN. ANY DAMAGE DONE TO EXISTING ITEMS BY THE CONTRACTOR SHALL BE REPAIRED.
14. ALL OFFSET LOCATIONS GIVEN ON THE DETAILED PLANS FOR ADA RAMPS, PAVEMENT MARKINGS, ETC. ARE FROM THE CENTERLINE AS SHOWN ON THE PLANS.
15. THE CONTRACTOR IS RESPONSIBLE FOR MAINTAINING DRAINAGE THROUGHOUT THE CONSTRUCTION OF THIS PROJECT.
16. NO WORK SHALL COMMENCE UNTIL TRAFFIC CONTROL REQUIREMENTS ARE MET.
17. WHEN CONSTRUCTING SIDEWALK RAMPS FOR THE HANDICAPPED, STATE STANDARDS LISTED IN THE HIGHWAY STANDARD INDEX SHALL APPLY.
18. THE CONTRACTOR SHALL DETERMINE WHEN FLAT SLAB TOPS ARE REQUIRED ON INLETS, MANHOLES, AND CATCH BASINS.

19. EXISTING STORM SEWERS, CULVERTS AND STORM STRUCTURES TO REMAIN WITHIN THE PROJECT LIMITS SHALL BE CLEANED AS SHOWN ON THE PLANS AND AS DIRECTED BY THE ENGINEER. EXISTING PIPE CULVERTS TO BE CLEANED SHALL BE CONSIDERED AS STORM SEWER TO BE CLEANED.
20. ALL WORK INVOLVING SIGNS SHALL BE GOVERNED BY THE FOLLOWING REQUIREMENTS AND IN ACCORDANCE WITH IDOT SIGNING STANDARDS.:
 1. SIGNS SHALL NOT BE MOVED UNTIL PROGRESS OF WORK NECESSITATES IT.
 2. EVERY SIGN REMOVED MUST BE RE-ERECTED AT A TEMPORARY LOCATION AND BE VISIBLE TO TRAFFIC FOR WHICH IT IS NEEDED. ALL SUCH SIGNS MUST BE MAINTAINED STRAIGHT AND CLEAN FOR THE DURATION OF THE TEMPORARY SETTING.
 3. ALL SIGNS SHALL BE RE-ERECTED IN PERMANENT LOCATIONS AS THE ROADWAY IS COMPLETED. HORIZONTAL LOCATION FROM THE EDGE OF PAVEMENT SHALL BE AS DIRECTED BY THE ENGINEER. ALL UNUSED SIGNS WILL BE RETURNED TO IDOT
 4. LONGER POSTS MAY BE REQUIRED AT SOME TEMPORARY OR PERMANENT SIGN LOCATIONS TO MAINTAIN PROPER SIGN ELEVATIONS, THE COST SHALL BE INCLUDED IN THE UNIT BID PRICES OF THE CONTRACT ACCORDING TO ARTICLE 107.25 OF THE STANDARD SPECIFICATIONS.
21. THE SUBGRADE STABILITY SHALL BE VERIFIED BY PROOF ROLLING WITH A FULLY LOADED TANDEM-AXLE TRUCK.
22. GEOTECHNICAL FABRIC FOR GROUND STABILIZATION AND/OR AGGREGATE SUBGRADE IMPROVEMENT (CU YD) HAVE BEEN PROVIDED FOR USE AT THE LOCATIONS INDICATED FOR SOILS THAT TEND TO BE UNSTABLE AND/OR UNSUITABLE. THE ACTUAL NEED FOR REMOVAL AND REPLACEMENT WITH ABOVE ITEM(S) WILL BE DETERMINED IN THE FIELD AT THE TIME OF CONSTRUCTION BY THE GEOTECHNICAL ENGINEER. ALL POTENTIALLY UNSTABLE SOILS SHOULD BE TESTED WITH A STATIC OR DYNAMIC CONE PENETROMETER AND TREATED IN ACCORDANCE WITH ARTICLE 301.04 OF THE SSRBC AND IDOT SUBGRADE STABILITY MANUAL. IF UNSTABLE AND/OR UNSUITABLE SOILS ARE NOT ENCOUNTERED, THEN THE QUANTITY SHALL BE DEDUCTED AND NO ADDITIONAL COMPENSATION WILL BE DUE TO THE CONTRACTOR.
23. ANY AGGREGATE SUBGRADE IMPROVEMENT CONTAMINATED AND/OR DAMAGED BY THE CONTRACTOR'S VEHICLES AND OR EQUIPMENT IS TO BE REMOVED AND REPLACED AS DIRECTED BY THE ENGINEER. BACKFILLING STORM SEWER CONSTRUCTED UNDER THE ROADWAY SPECIFIED UNDER ART. 550.07(b, c) OF THE SSRBC WILL NOT BE ALLOWED.
24. EXISTING VEGETATED AREAS (TREES, SHRUBS, VEGETATIVE BUFFERS, TURF AREAS, ETC.) WHERE DISTURBANCE IS NOT OCCURRING (INCLUDING AREAS OUTSIDE THE PROJECT LIMITS) SHALL NOT BE DISTURBED TO ENSURE THAT EXISTING VEGETATION IS PRESERVED TO MINIMIZE SOIL EROSION AND TO ELIMINATE SOIL COMPACTION. NO MATERIALS ARE TO BE STORED OR VEHICLES DRIVEN OR PARKED WITHIN THESE UNDISTURBED AREAS AT ANY TIME.
25. THE CONTRACTOR SHALL TAKE EXTRA CARE IN GRADING AND EXCAVATING NEAR TREES WHICH ARE NOT MARKED FOR REMOVAL SO AS NOT TO CAUSE INJURY TO THE ROOT SYSTEM OR TRUNKS. HAND EXCAVATION SHALL BE PERFORMED IF MAJOR ROOTS ARE PRESENT. MAJOR ROOTS OF A TREE THAT ARE TO REMAIN IN PLACE EXTENDING INTO THE EXCAVATION AREAS AT AN ELEVATION THAT WOULD INTERFERE WITH ANY PORTION OF THE PLANNED CONSTRUCTION SHALL BE SEVERED AT A POINT IMMEDIATELY OUTSIDE OF THE EXCAVATION AREA IN A MANNER THAT WILL CAUSE THE LEAST AMOUNT OF SYSTEMIC TO THE REMAINING TREE STRUCTURE. THE EXPENSE OF ANY REQUIRED HAND EXCAVATION AND/OR THE CUTTING OF MAJOR TREE ROOTS, AS DESCRIBED ABOVE, SHALL BE CONSIDERED INCIDENTAL TO THE CONTRACT LINE ITEM BEING REMOVED OR INSTALLED AT THAT LOCATION. ANY DAMAGE DONE TO EXISTING ITEMS BY THE CONTRACTOR SHALL BE REPAIRED BY THE CONTRACTOR.
26. PHOSPHORUS FERTILIZER HAS BEEN INTENTIONALLY OMITTED FROM THE CONTRACT DUE TO THE PROXIMITY TO THE FOX RIVER.
27. THE CONTRACTOR SHALL OBSERVE AND COMPLY WITH ALL SECTIONS OF THE ILLINOIS CUSTOM SPRAY LAW, INCLUDING LICENSING. CONTRACTOR PERSONNEL APPLYING HERBICIDES SHALL HAVE A VALID PESTICIDE APPLICATOR LICENSE ISSUED BY THE ILLINOIS DEPARTMENT OF AGRICULTURE. THE LICENSED PESTICIDE APPLICATOR SHALL SUBMIT THEIR CURRENT LICENSE TO THE ENGINEER. THE LICENSED PESTICIDE APPLICATOR SHALL BE QUALIFIED AT A MINIMUM IN RIGHT-OF-WAY AND AQUATICS. THE LICENSED APPLICATOR SHALL WORK ON-SITE.
28. THE AGGREGATE GRADATION FOR THE AGGREGATE SUBGRADE IMPROVEMENT 12" LOWER LIFT SHALL BE CS 1 OR RR 1

PROJECT CONTACTS

CITY OF GENEVA MR. BRIAN DAVIDS, PE 1800 SOUTH STREET GENEVA, ILLINOIS 60134 PH: 630-232-1501	AT&T MR. RICHARD KOPEC 1000 COMMERCE DRIVE OAK BROOK, ILLINOIS 60523 PH: 630-632-3148
COMED MS. CASSIE EVANS 1 LINCOLN CENTER OAKBROOK TERRACE, IL 60181 PH: 773-241-0741	COMCAST MR. TED WYMAN 688 INDUSTRIAL DRIVE ELMHURST, ILLINOIS 60126 PH: 847-652-6074
NICOR MR. SAKIBUL FOARAH 1844 FERRY ROAD NAPERVILLE, ILLINOIS 60563 PH: 630-388-2903	MCI-VERIZON MR. JOE CHANEY 400 INTERNATIONAL PARKWAY RICHARDSON, TX 75081 PH: XXX-XXX-XXXX
METRO FIBERNET LORI KEMPER 3701 COMMUNICATIONS WAY EVANSVILLE, IN 47715 PH: 812-213-1050	

FILE NAME = FA\961-000 Geneva East State St.CADD.Sheets\961-000_SHT_GENNOTE.dgn

	USER NAME = tnestor	DESIGNED - GJE	REVISED -	STATE OF ILLINOIS DEPARTMENT OF TRANSPORTATION	ILLINOIS ROUTE 38 - EAST STATE STREET INDEX, HIGHWAY STANDARDS, GENERAL NOTES, AND COMMITMENTS	F.A.U RTE.	SECTION	COUNTY	TOTAL SHEETS	SHEET NO.
	PLOT SCALE = 100.0000' / in.	CHECKED - DBB	REVISED -			0347	05-00102-00-PV	KANE	488	3
PLOT DATE = 1/13/2025	DATE - 11/7/2024	REVISED -	CONTRACT NO. 61J84							
						SCALE: N.T.S.	SHEET 2 OF 2 SHEETS	STA.	TO STA.	

CODE NO.	ITEM	UNIT	TOTAL QUANTITY	CONSTRUCTION CODE									
				ROADWAY	TRAFFIC SIGNALS	WATERMAIN	SANITARY	ITEP/IAP	LANDSCAPING	STRUCTURAL	TRAINERS		
				0003	0021	0043	0043	0021	0031	0042	0042		
	80% FED 20% LOCAL	80% FED 20% LOCAL	100% LOCAL	100% LOCAL	80% FED 20% LOCAL	80% FED 20% LOCAL	80% FED 20% LOCAL	80% FED 20% LOCAL					
2010010	TREE REMOVAL (6 TO 15 UNITS DIAMETER)	UNIT	500	500									
2010020	TREE REMOVAL (OVER 15 UNITS DIAMETER)	UNIT	200	200									
2010100	TEMPORARY FENCE	FOOT	500	500									
2010100	TREE TRUNK PROTECTION	EACH	15	15									
* 2010120	TREE ROOT PRUNING	EACH	15	15									
* 2010130	TREE PRUNING (11 TO 10 INCH DIAMETER)	EACH	20	20									
* 2010135	TREE PRUNING (OVER 10 INCH DIAMETER)	EACH	20	20									
2020010	EARTH EXCAVATION	CU YD	23,583	23,583									
2020120	REMOVAL AND DISPOSAL OF UNSUITABLE MATERIAL	CU YD	8,371	8,371									
2080015	TRENCH BACKFILL	CU YD	25,877	13,200		6,793	5,884						
2100100	GEOTECHNICAL FABRIC FOR GROUND STABILIZATION	50 YD	19,080	19,080									
2110150	TOPSOIL EXCAVATION AND PLACEMENT	CU YD	3,918						3,918				
* 2500040	NITROGEN FERTILIZER NUTRIENT	POUND	200						200				
* 2500060	POTASSIUM FERTILIZER NUTRIENT	POUND	200						200				
* 2500075	MOWING	ACRE	4						4				

* SPECIALTY ITEM

FILE NAME = F:\ARCH\003_Genres_East_State_556000_Sheets\A101-000-SUMMARY OF QUANTITIES.dwg



USER NAME = tneator	DESIGNED - GJE	REVISED -
PLDT SCALE = 1/8" = 1'-0"	DRAWN - GJE	REVISED -
PLDT DATE = 11/27/2025	CHECKED - DBB	REVISED -
	DATE - 11/7/2024	REVISED -

STATE OF ILLINOIS
DEPARTMENT OF TRANSPORTATION

ILLINOIS ROUTE 38 -- EAST STATE STREET
SUMMARY OF QUANTITIES

SCALE: SHEET 1 OF 24 SHEETS STA. TO STA.

F.A.J. RTE.	SECTION	COUNTY	TOTAL SHEETS	SHEET NO.
0347	05-00102-00-PV	KANE	488	4
CONTRACT NO. 61J84			(ILLINOIS) FED. AID PROJECT	

CODE NO.	ITEM	UNIT	TOTAL QUANTITY	CONSTRUCTION CODE									
				ROADWAY	TRAFFIC SIGNALS	WATERMAIN	SANITARY	ITEP/TAP	LANDSCAPING	STRUCTURAL	TRAINERS		
				0003 80% FED 20% LOCAL	0021 80% FED 20% LOCAL	0043 100% LOCAL	0043 100% LOCAL	0028 80% FED 20% LOCAL	0031 80% FED 20% LOCAL	0044 80% FED 20% LOCAL	0042		
* 25100630	EROSION CONTROL BLANKET	SO YD	13,400	13,400									
* 25200110	SODDING, SALT TOLERANT	SO YD	15,395						15,395				
* 25200200	SUPPLEMENTAL WATERING	UNIT	845						845				
28000250	TEMPORARY EROSION CONTROL SEEDING	POUND	277	277									
28000400	PERIMETER EROSION BARRIER	FOOT	10,236	10,236									
28000500	INLET AND PIPE PROTECTION	EACH	5	5									
28000510	INLET FILTERS	EACH	260	260									
28001100	TEMPORARY EROSION CONTROL BLANKET	SO YD	13,400	13,400									
30300001	AGGREGATE SUBGRADE IMPROVEMENT	CU YD	6,277	6,277									
30300112	AGGREGATE SUBGRADE IMPROVEMENT 12"	SO YD	47,470	47,470									
35101600	AGGREGATE BASE COURSE, TYPE B 4"	SO YD	7,590	7,590									
35101800	AGGREGATE BASE COURSE, TYPE B 6"	SO YD	2,894					2,894					
35300060	PORTLAND CEMENT CONCRETE BASE COURSE, 4"	SO YD	201	201									
35600707	HOT-MIX ASPHALT BASE COURSE WIDENING, 7 3/4"	SO YD	114	114									
40600275	BITUMINOUS MATERIALS (PRIME COAT)	POUND	6,507	6,507									

* SPECIALTY ITEM

FILE NAME = F:\191-000 Genova East State St\CRDD_Sheets\191-000_SHT_SUMMARY OF QUANTITIES.dgn



USER NAME = tnestor	DESIGNED - GJE	REVISED -
PLOT SCALE = 40,000' = 1" = 100'	DRAWN - GJE	REVISED -
PLOT DATE = 1/27/2025	CHECKED - DBB	REVISED -
	DATE - 11/7/2024	REVISED -

STATE OF ILLINOIS
DEPARTMENT OF TRANSPORTATION

ILLINOIS ROUTE 38 - EAST STATE STREET
SUMMARY OF QUANTITIES

SCALE: SHEET 2 OF 24 SHEETS STA. TO STA.

F.A.U. RTE. 0347	SECTION 05-00102-00-PV	COUNTY KANE	TOTAL SHEETS 488	SHEET NO. 5
			CONTRACT NO. 61J84	
ILLINOIS FED. AID PROJECT				

CODE NO.	ITEM	UNIT	TOTAL QUANTITY	CONSTRUCTION CODE									
				ROADWAY	TRAFFIC SIGNALS	WATERMAIN	SANITARY	ITEP/TAP	LANDSCAPING	STRUCTURAL	TRAINEES		
				0003	0021	0043	0043	0028	0031	0044	0042		
				80% FED 20% LOCAL	80% FED 20% LOCAL	100% LOCAL	100% LOCAL	80% FED 20% LOCAL	80% FED 20% LOCAL	80% FED 20% LOCAL			
40600290	BITUMINOUS MATERIALS (TACK COAT)	POUND	5,078	5,078									
40600370	LONGITUDINAL JOINT SEALANT	FOOT	5,520	5,520									
40603200	POLYMERIZED HOT-MIX ASPHALT BINDER COURSE, IL-4.75, N50	TON	271	271									
40604060	HOT-MIX ASPHALT SURFACE COURSE, IL-9.5, MIX "D", N50	TON	489					489					
40604062	HOT-MIX ASPHALT SURFACE COURSE, IL-9.5, MIX "D", N70	TON	642	642									
42000080	PAVEMENT CONNECTOR (PC) FOR BRIDGE APPROACH SLAB	SQ YD	95	95									
42000501	PORTLAND CEMENT CONCRETE PAVEMENT 10" (JOINTED)	SQ YD	45,383	45,383									
42001300	PROTECTIVE COAT	SQ YD	57,397	57,397									
42300400	PORTLAND CEMENT CONCRETE DRIVEWAY PAVEMENT, 8 INCH	SQ YD	126	126									
42400200	PORTLAND CEMENT CONCRETE SIDEWALK 5 INCH	SQ FT	26,853					26,853					
42400800	DETECTABLE WARNINGS	SQ FT	1,337	1,337									
44000100	PAVEMENT REMOVAL	SQ YD	40,468	40,468									
44000159	HOT-MIX ASPHALT SURFACE REMOVAL, 2 1/2"	SQ YD	6,449	6,449									
44000200	DRIVEWAY PAVEMENT REMOVAL	SQ YD	3,791	3,791									
44000300	CURB REMOVAL	FOOT	446	446									

* SPECIALTY ITEM

FILE NAME * F:\961-000 Geneva East State 51\CRDD_Sheets\961-000_SHT_SUMMARY OF QUANTITIES.dgn



USER NAME = creator	DESIGNED - GJE	REVISED -
PLOT SCALE = 10.0000' / in.	DRAWN - GJE	REVISED -
PLOT DATE = 1/27/2025	CHECKED - DBB	REVISED -
	DATE - 11/7/2024	REVISED -

STATE OF ILLINOIS
DEPARTMENT OF TRANSPORTATION

ILLINOIS ROUTE 38 - EAST STATE STREET
SUMMARY OF QUANTITIES

SCALE: SHEET 3 OF 24 SHEETS STA. TO STA.

F.A.U. RTE.	SECTION	COUNTY	TOTAL SHEETS	SHEET NO.
0347	05-00102-00-PV	KANE	488	6
CONTRACT NO. 61J84			ILLINOIS FED. AID PROJECT	

CODE NO.	ITEM	UNIT	TOTAL QUANTITY	CONSTRUCTION CODE								
				ROADWAY	TRAFFIC SIGNALS	WATERMAIN	SANITARY	ITEP/TAP	LANDSCAPING	STRUCTURAL	TRAINEES	
				0003 80% FED 20% LOCAL	0021 80% FED 20% LOCAL	0043 100% LOCAL	0043 100% LOCAL	0028 80% FED 20% LOCAL	0031 80% FED 20% LOCAL	0042 80% FED 20% LOCAL	0042	
4400500	COMBINATION CURB AND GUTTER REMOVAL	FOOT	14,187	14,187								
4400600	SIDEWALK REMOVAL	SO FT	46,723					46,723				
44003100	MEDIAN REMOVAL	SO FT	914	914								
44004000	PAVED DITCH REMOVAL	FOOT	509	509								
44201747	CLASS D PATCHES, TYPE IV, 8 INCH	SO YD	198	198								
48203021	HOT-MIX ASPHALT SHOULDERS, 6"	SO YD	48	48								
50102400	CONCRETE REMOVAL	CU YD	4							4		
50105220	PIPE CULVERT REMOVAL	FOOT	190	190								
50200100	STRUCTURE EXCAVATION	CU YD	21							21		
50300225	CONCRETE STRUCTURES	CU YD	4							4		
50800205	REINFORCEMENT BARS, EPOXY COATED	POUND	1,140							1,140		
52200800	SEGMENTAL CONCRETE BLOCK WALL	SO FT	2,164							2,164		
54213657	PRECAST REINFORCED CONCRETE FLARED END SECTIONS 12"	EACH	1	1								
54213660	PRECAST REINFORCED CONCRETE FLARED END SECTIONS 15"	EACH	1	1								
54213681	PRECAST REINFORCED CONCRETE FLARED END SECTIONS 36"	EACH	1	1								

* SPECIALTY ITEM

FILE NAME = F:\1961-000 Genesee East State 5\ACAD\00_Sheets\161-000_SHT_SUMMARY OF QUANTITIES.dgn



USER NAME = trestor	DESIGNED - GJE	REVISED -
PLOT SCALE = 40.0000' / in.	DRAWN - GJE	REVISED -
PLOT DATE = 1/27/2025	CHECKED - DBB	REVISED -
	DATE - 11/7/2024	REVISED -

STATE OF ILLINOIS
DEPARTMENT OF TRANSPORTATION

ILLINOIS ROUTE 38 - EAST STATE STREET
SUMMARY OF QUANTITIES


SCALE: SHEET 4 OF 24 SHEETS STA. TO STA.

F.A.U. RTE. 0347	SECTION 05-00102-00-PV	COUNTY KANE	TOTAL SHEETS 488	SHEET NO. 7
CONTRACT NO. 61J84			ILLINOIS FED. AID PROJECT	

CODE NO.	ITEM	UNIT	TOTAL QUANTITY	CONSTRUCTION CODE									
				ROADWAY	TRAFFIC SIGNALS	WATERMAIN	SANITARY	IT/EP/TAP	LANDSCAPING	STRUCTURAL	TRAINEES		
				0003	0021	0043	0043	0028	0031	0044	0042		
				80% FED 20% LOCAL	80% FED 20% LOCAL	100% LOCAL	100% LOCAL	80% FED 20% LOCAL	80% FED 20% LOCAL	80% FED 20% LOCAL			
542A0220	PIPE CULVERTS, CLASS A, TYPE 1 15"	FOOT	25	25									
550A0340	STORM SEWERS, CLASS A, TYPE 2 12"	FOOT	3,153	3,153									
550A0360	STORM SEWERS, CLASS A, TYPE 2 15"	FOOT	845	845									
550A0380	STORM SEWERS, CLASS A, TYPE 2 18"	FOOT	672	672									
550A0410	STORM SEWERS, CLASS A, TYPE 2 24"	FOOT	697	697									
550A0420	STORM SEWERS, CLASS A, TYPE 2 27"	FOOT	200	200									
550A0430	STORM SEWERS, CLASS A, TYPE 2 30"	FOOT	201	201									
550A0450	STORM SEWERS, CLASS A, TYPE 2 36"	FOOT	558	558									
550A0480	STORM SEWERS, CLASS A, TYPE 2 48"	FOOT	966	966									
550A5510	STORM SEWERS, CLASS A, TYPE 2 EQUIVALENT ROUND-SIZE 48"	FOOT	252	252									
55100300	STORM SEWER REMOVAL 8"	FOOT	9	9									
55100400	STORM SEWER REMOVAL 10"	FOOT	454	454									
55100500	STORM SEWER REMOVAL 12"	FOOT	4,436	4,436									
55100700	STORM SEWER REMOVAL 15"	FOOT	2,553	2,553									
55100900	STORM SEWER REMOVAL 18"	FOOT	193	193									

* SPECIALTY ITEM

FILE NAME = F:\981-038 Genesee East State SACADD Sheets\981-038_SHT_SUMMARY OF QUANTITIES.dgn

	USER NAME = tneator	DESIGNED - GJE	REVISED -	STATE OF ILLINOIS DEPARTMENT OF TRANSPORTATION	ILLINOIS ROUTE 38 -- EAST STATE STREET SUMMARY OF QUANTITIES	F.A.U. RTE.	SECTION	COUNTY	TOTAL SHEETS	SHEET NO.	
	PLOT SCALE = 40.0000' / 1" =	DRAWN - GJE	REVISED -			0347	05-00102-00-PV	KANE	488	8	
	PLOT DATE = 1/27/2025	CHECKED - DBB	REVISED -			SCALE:		SHEET 5 OF 24 SHEETS	STA.	TO STA.	CONTRACT NO. 61J84
		DATE - 11/7/2024	REVISED -			ILLINOIS FED. AID PROJECT					

CODE NO.	ITEM	UNIT	TOTAL QUANTITY	CONSTRUCTION CODE									
				ROADWAY	TRAFFIC SIGNALS	WATERMAIN	SANITARY	ITEP/TAP	LANDSCAPING	STRUCTURAL	TRAINEES		
				0003 80% FED 20% LOCAL	0021 80% FED 20% LOCAL	0043 100% LOCAL	0043 100% LOCAL	0028 80% FED 20% LOCAL	0031 80% FED 20% LOCAL	0044 80% FED 20% LOCAL	0042		
55101200	STORM SEWER REMOVAL 24"	FOOT	429	429									
55101300	STORM SEWER REMOVAL 27"	FOOT	30	30									
55101600	STORM SEWER REMOVAL 36"	FOOT	626	626									
55101800	STORM SEWER REMOVAL 42"	FOOT	70	70									
55101900	STORM SEWER REMOVAL 48"	FOOT	581	581									
55103030	STORM SEWER REMOVAL, EQUIVALENT ROUND-SIZE 30"	FOOT	30	30									
* 56102900	DUCTILE IRON WATER MAIN 4"	FOOT	214			214							
* 56103000	DUCTILE IRON WATER MAIN 6"	FOOT	919			919							
* 56103100	DUCTILE IRON WATER MAIN 8"	FOOT	796			796							
* 56103200	DUCTILE IRON WATER MAIN 10"	FOOT	182			182							
* 56103300	DUCTILE IRON WATER MAIN 12"	FOOT	4,324			4,324							
* 56104800	WATER VALVES 4"	EACH	4			4							
* 56104900	WATER VALVES 6"	EACH	21			21							
* 56105000	WATER VALVES 8"	EACH	14			14							
* 56105100	WATER VALVES 10"	EACH	1			1							

* SPECIALTY ITEM

FILE NAME: F:\161-000 Genvco East State SACADD_Sheets\161-000_SHT_SUMMARY OF QUANTITIES.dgn



USER NAME = trestor	DESIGNED - GJE	REVISED -
PLDT SCALE = 40,0000 1/4 in.	DRAWN - GJE	REVISED -
PLDT DATE = 1/27/2025	CHECKED - DBB	REVISED -
	DATE - 11/1/2024	REVISED -

STATE OF ILLINOIS
DEPARTMENT OF TRANSPORTATION

ILLINOIS ROUTE 38 - EAST STATE STREET
SUMMARY OF QUANTITIES

F.A.U. RTE. 0347	SECTION 05-00102-00-PV	COUNTY KANE	TOTAL SHEETS 488	SHEET NO. 9
SCALE: SHEET 6 OF 24 SHEETS STA. TO STA.			CONTRACT NO. 61JB4	
(ILLINOIS) FED. AID PROJECT				

CODE NO.	ITEM	UNIT	TOTAL QUANTITY	CONSTRUCTION CODE									
				ROADWAY	TRAFFIC SIGNALS	WATERMAIN	SANITARY	ITEP/TAP	LANDSCAPING	STRUCTURAL	TRAINEES		
				0003 80% FED 20% LOCAL	0021 80% FED 20% LOCAL	0043 100% LOCAL	0043 100% LOCAL	0028 80% FED 20% LOCAL	0031 80% FED 20% LOCAL	0042 80% FED 20% LOCAL	0042		
* 56105200	WATER VALVES 12"	EACH	18			18							
* 56400300	FIRE HYDRANTS TO BE ADJUSTED	EACH	5	5									
* 56400400	FIRE HYDRANTS TO BE RELOCATED	EACH	6	6									
* 56400500	FIRE HYDRANTS TO BE REMOVED	EACH	16			16							
* 56400620	FIRE HYDRANT WITH AUXILIARY VALVE AND VALVE BOX	EACH	22			22							
58600101	GRANULAR BACKFILL FOR STRUCTURES	CU YD	1								1		
59100100	GEOCOMPOSITE WALL DRAIN	SQ YD	19								19		
60108204	PIPE UNDERDRAINS, TYPE 2, 4"	FOOT	2,578	2,578									
60200805	CATCH BASINS, TYPE A, 4'-DIAMETER, TYPE 8 GRATE	EACH	1	1									
60201340	CATCH BASINS, TYPE A, 4'-DIAMETER, TYPE 24 FRAME AND GRATE	EACH	71	71									
60203805	CATCH BASINS, TYPE A, 5'-DIAMETER, TYPE 1 FRAME, OPEN LID	EACH	1	1									
60204505	CATCH BASINS, TYPE A, 5'-DIAMETER, TYPE 8 GRATE	EACH	1	1									
60205040	CATCH BASINS, TYPE A, 5'-DIAMETER, TYPE 24 FRAME AND GRATE	EACH	4	4									
60218400	MANHOLES, TYPE A, 4'-DIAMETER, TYPE 1 FRAME, CLOSED LID	EACH	9	9									
60219540	MANHOLES, TYPE A, 4'-DIAMETER, TYPE 24 FRAME AND GRATE	EACH	1	1									

* SPECIALTY ITEM

FILE NAME: F:\921-003 Genevo East State 55ACADD_Sheets\91-003_SHT_SUMMARY OF QUANTITIES.dgn



USER NAME = trestor	DESIGNED - GJE	REVISED -
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PL0T DATE = 1/27/2025	CHECKED - DBB	REVISED -
	DATE - 11/7/2024	REVISED -

STATE OF ILLINOIS
DEPARTMENT OF TRANSPORTATION

ILLINOIS ROUTE 38 - EAST STATE STREET
SUMMARY OF QUANTITIES

SCALE: SHEET 7 OF 24 SHEETS STA. TO STA.

F.A.U. RTE. 0347	SECTION 05-00102-00-PV	COUNTY KANE	TOTAL SHEETS 488	SHEET NO. 10
CONTRACT NO. 61J84			ILLINOIS FED. AID PROJECT	

CODE NO.	ITEM	UNIT	TOTAL QUANTITY	CONSTRUCTION CODE									
				ROADWAY	TRAFFIC SIGNALS	WATERMAIN	SANITARY	ITEP/TAP	LANDSCAPING	STRUCTURAL	TRAINEES		
				0003 80% FED 20% LOCAL	0021 80% FED 20% LOCAL	0043 100% LOCAL	0043 100% LOCAL	0028 80% FED 20% LOCAL	0031 80% FED 20% LOCAL	0044 80% FED 20% LOCAL	0042		
60221100	MANHOLES, TYPE A, 5'-DIAMETER, TYPE 1 FRAME, CLOSED LID	EACH	9	9									
60223800	MANHOLES, TYPE A, 6'-DIAMETER, TYPE 1 FRAME, CLOSED LID	EACH	21	21									
60224039	MANHOLES, TYPE A, 6'-DIAMETER, TYPE 24 FRAME AND GRATE	EACH	4	4									
60224446	MANHOLES, TYPE A, 7'-DIAMETER, TYPE 1 FRAME, CLOSED LID	EACH	10	10									
60224449	MANHOLES, TYPE A, 7'-DIAMETER, TYPE 24 FRAME AND GRATE	EACH	3	3									
60224455	MANHOLES, TYPE A, 8'-DIAMETER, TYPE 24 FRAME AND GRATE	EACH	2	2									
60224459	MANHOLES, TYPE A, 8'-DIAMETER, TYPE 1 FRAME, CLOSED LID	EACH	6	6									
60224469	MANHOLES, TYPE A, 9'-DIAMETER, TYPE 1 FRAME, CLOSED LID	EACH	2	2									
60235300	INLETS, TYPE A, TYPE 1 FRAME, CLOSED LID	EACH	2	2									
60236200	INLETS, TYPE A, TYPE 8 GRATE	EACH	14	14									
60237470	INLETS, TYPE A, TYPE 24 FRAME AND GRATE	EACH	74	74									
* 60248700	VALVE VAULTS, TYPE A, 4'-DIAMETER, TYPE 1 FRAME, CLOSED LID	EACH	15										
* 60248900	VALVE VAULTS, TYPE A, 5'-DIAMETER, TYPE 1 FRAME, CLOSED LID	EACH	19										
60255500	MANHOLES TO BE ADJUSTED	EACH	4	4									
60260100	INLETS TO BE ADJUSTED	EACH	2	2									

* SPECIALTY ITEM

FILE NAME: F:\961-080 Geneva East State St\ACADD\Sheets\961-080-SHT-SUMMARY OF QUANTITIES.dgn



USER NAME = sneator	DESIGNED - GJE	REVISED -
DRAWN - GJE	CHECKED - DBB	REVISED -
PLOT SCALE = 48.0000' / 1"	DATE - 11/7/2024	REVISED -
PLOT DATE = 1/27/2025		

STATE OF ILLINOIS
DEPARTMENT OF TRANSPORTATION

ILLINOIS ROUTE 38 - EAST STATE STREET
SUMMARY OF QUANTITIES

SCALE: SHEET 8 OF 24 SHEETS STA. TO STA.

F.A.D. RTE.	SECTION	COUNTY	TOTAL SHEETS	SHEET NO.
0347	05-00102-00-PV	KANE	488	11
CONTRACT NO. 61J84			ILLINOIS FED. AID PROJECT	

CODE NO.	ITEM	UNIT	TOTAL QUANTITY	CONSTRUCTION CODE									
				ROADWAY	TRAFFIC SIGNALS	WATERMAIN	SANITARY	ITEP/TAP	LANDSCAPING	STRUCTURAL	TRAINEES		
				0003 80% FED 20% LOCAL	0021 80% FED 20% LOCAL	0043 100% LOCAL	0043 100% LOCAL	0028 80% FED 20% LOCAL	0031 80% FED 20% LOCAL	0044 80% FED 20% LOCAL	0042		
60265700	VALVE VAULTS TO BE ADJUSTED	EACH	15	15									
60266600	VALVE BOXES TO BE ADJUSTED	EACH	4	4									
60500040	REMOVING MANHOLES	EACH	49	49									
60500050	REMOVING CATCH BASINS	EACH	24	24									
60500060	REMOVING INLETS	EACH	56	56									
60600605	CONCRETE CURB, TYPE B	FOOT	3,315	3,315									
60603800	COMBINATION CONCRETE CURB AND GUTTER, TYPE B-6.12	FOOT	2,144	2,144									
60605000	COMBINATION CONCRETE CURB AND GUTTER, TYPE B-6.24	FOOT	12,514	12,514									
60618300	CONCRETE MEDIAN SURFACE, 4 INCH	SO FT	615	615									
60619600	CONCRETE MEDIAN, TYPE SB-6.12	SO FT	2,994	2,994									
* 63000001	STEEL PLATE BEAM GUARDRAIL, TYPE A, 6 FOOT POSTS	FOOT	63	63									
* 63100045	TRAFFIC BARRIER TERMINAL, TYPE 2	EACH	1	1									
* 63100169	TRAFFIC BARRIER TERMINAL, TYPE 1 (SPECIAL) FLARED	EACH	1	1									
63200310	GUARDRAIL REMOVAL	FOOT	139	139									
* 66900200	NON-SPECIAL WASTE DISPOSAL	CU YD	38,500	38,500									

* SPECIALTY ITEM

FILE NAME: P:\161-000 Genres East State SACDD_Sheets\91-911-5HT_SUMMARY OF QUANTITIES.dgn



USER NAME = trestor	DESIGNED - GJE	REVISED -
DRAWN - GJE	CHECKED - DBB	REVISIED -
PLOT SCALE = 1/8" = 1'-0"	DATE - 11/7/2024	REVISIED -

STATE OF ILLINOIS
DEPARTMENT OF TRANSPORTATION

ILLINOIS ROUTE 38 - EAST STATE STREET
SUMMARY OF QUANTITIES

SCALE: SHEET 9 OF 24 SHEETS STA. TO STA.

F.A.U. RTE.	SECTION	COUNTY	TOTAL SHEETS	SHEET NO.
0347	05-00102-00-PV	KANE	438	12
CONTRACT NO. 61J84			ILLINOIS FED. AID PROJECT	

CODE NO.	ITEM	UNIT	TOTAL QUANTITY	CONSTRUCTION CODE								
				ROADWAY	TRAFFIC SIGNALS	WATERMAIN	SANITARY	ITEP/TAP	LANDSCAPING	STRUCTURAL	TRAINEES	
				0003	0021	0043	0043	0028	0031	0042	0042	
				80% FED 20% LOCAL	80% FED 20% LOCAL	100% LOCAL	100% LOCAL	80% FED 20% LOCAL	80% FED 20% LOCAL	80% FED 20% LOCAL		
* 66900530	SOIL DISPOSAL ANALYSIS	EACH	12	12								
* 66901001	REGULATED SUBSTANCES PRE-CONSTRUCTION PLAN	L SUM	1	1								
* 66901003	REGULATED SUBSTANCES FINAL CONSTRUCTION REPORT	L SUM	1	1								
* 66901005	ENGINEERED BARRIER	SO YD	3,200	3,200								
* 66901006	REGULATED SUBSTANCES MONITORING	CAL DA	200	200								
67000400	ENGINEER'S FIELD OFFICE, TYPE A	CAL MD	24	24								
67100100	MOBILIZATION	L SUM	1	1								
70107025	CHANGEABLE MESSAGE SIGN	CAL DA	2,916	2,916								
70300100	SHORT TERM PAVEMENT MARKING	FOOT	20,497	20,497								
70300150	SHORT TERM PAVEMENT MARKING REMOVAL	SO FT	32,479	32,479								
70307100	TEMPORARY PAVEMENT MARKING LETTERS AND SYMBOLS - TYPE IV TAPE	SO FT	392	392								
70307120	TEMPORARY PAVEMENT MARKING - LINE 4" - TYPE IV TAPE	FOOT	83,823	83,823								
70307130	TEMPORARY PAVEMENT MARKING - LINE 6" - TYPE IV TAPE	FOOT	2,414	2,414								
70307210	TEMPORARY PAVEMENT MARKING - LINE 24" - TYPE IV TAPE	FOOT	1,609	1,609								
70400100	TEMPORARY CONCRETE BARRIER	FOOT	6,611	6,611								

* SPECIALTY ITEM

FILE NAME = F:\1961-000 Geneva East State 55ACADD_Summary\961-000_SHT_SUMMARY OF QUANTITIES.dgn



USER NAME = Unstar	DESIGNED - GJE	REVISED -
DRAWN - GJE	CHECKED - DBB	REVISED -
PLLOT SCALE = 40,0000' / in.	DATE - 11/7/2024	REVISED -
PLLOT DATE = 1/27/2025		

STATE OF ILLINOIS
DEPARTMENT OF TRANSPORTATION

ILLINOIS ROUTE 38 - EAST STATE STREET
SUMMARY OF QUANTITIES

SCALE: SHEET 10 OF 24 SHEETS STA. TO STA.

F.A.U. RTE. 0347	SECTION 05-00102-00-PV	COUNTY KANE	TOTAL SHEETS 488	SHEET NO. 13
CONTRACT NO. 61J84			ILLINOIS FED. AID PROJECT	

CODE NO.	ITEM	UNIT	TOTAL QUANTITY	CONSTRUCTION CODE								
				ROADWAY	TRAFFIC SIGNALS	WATERMAIN	SANITARY	ITEP/TAP	LANDSCAPING	STRUCTURAL	TRAINEES	
				0003	0021	0043	0043	0028	0031	0044	0042	
				80% FED 20% LOCAL	80% FED 20% LOCAL	100% LOCAL	100% LOCAL	80% FED 20% LOCAL	80% FED 20% LOCAL	80% FED 20% LOCAL		
70400200	RELOCATE TEMPORARY CONCRETE BARRIER	FOOT	8,504	8,504								
70600255	IMPACT ATTENUATORS, TEMPORARY (FULLY REDIRECTIVE, NARROW), TEST LEVEL 2	EACH	61	61								
70600265	IMPACT ATTENUATORS, TEMPORARY (FULLY REDIRECTIVE, WIDE), TEST LEVEL 2	EACH	2	2								
70600320	IMPACT ATTENUATORS, RELOCATE (FULLY REDIRECTIVE), TEST LEVEL 2	EACH	105	105								
* 72000100	SIGN PANEL - TYPE 1	50 FT	995	923	72							
* 72000200	SIGN PANEL - TYPE 2	50 FT	115		115							
72400100	REMOVE SIGN PANEL ASSEMBLY - TYPE A	EACH	158	158								
* 72900100	METAL POST - TYPE A	FOOT	1,537	1,537								
* 78000100	THERMOPLASTIC PAVEMENT MARKING - LETTERS AND SYMBOLS	50 FT	298	298								
* 78000200	THERMOPLASTIC PAVEMENT MARKING - LINE 4"	FOOT	3,583	3,583								
* 78000400	THERMOPLASTIC PAVEMENT MARKING - LINE 6"	FOOT	735	735								
* 78000500	THERMOPLASTIC PAVEMENT MARKING - LINE 8"	FOOT	566	566								
* 78000600	THERMOPLASTIC PAVEMENT MARKING - LINE 12"	FOOT	167	167								
* 78000650	THERMOPLASTIC PAVEMENT MARKING - LINE 24"	FOOT	10	10								
* 78001100	PAINT PAVEMENT MARKING - LETTERS AND SYMBOLS	50 FT	57	57								

* SPECIALTY ITEM

FILE NAME: F:\981-000 Geneva East State SAC\000-Sheets\161-000-SHT-SUMMARY OF QUANTITIES.dgn



USER NAME = trestor	DESIGNED - GJE	REVISED -
	DRAWN - GJE	REVISED -
PLOT SCALE = 1/8" = 1'-0"	CHECKED - DBB	REVISED -
PLOT DATE = 1/27/2025	DATE - 11/1/2024	REVISED -

STATE OF ILLINOIS
DEPARTMENT OF TRANSPORTATION

ILLINOIS ROUTE 38 - EAST STATE STREET
SUMMARY OF QUANTITIES

F.A.U. RTE.	SECTION	COUNTY	TOTAL SHEETS	SHEET NO.
0347	05-00102-00-PV	KANE	422	14
CONTRACT NO. 61JB4			ILLINOIS FED. AID PROJECT	

SCALE: SHEET 11 OF 24 SHEETS STA. TO STA.

CODE NO.	ITEM	UNIT	TOTAL QUANTITY	CONSTRUCTION CODE									
				ROADWAY	TRAFFIC SIGNALS	WATERMAIN	SANITARY	ITYP/TAP	LANDSCAPING	STRUCTURAL	TRAINEES		
				0003 80% FED 20% LOCAL	0021 80% FED 20% LOCAL	0043 100% LOCAL	0043 100% LOCAL	0028 80% FED 20% LOCAL	0031 80% FED 20% LOCAL	0044 80% FED 20% LOCAL	0042		
* 7800110	PAINT PAVEMENT MARKING - LINE 4"	FOOT	20	20									
* 7800180	PAINT PAVEMENT MARKING - LINE 24"	FOOT	82	82									
* 7800337	PERFORMED PLASTIC PAVEMENT MARKING, TYPE B - STANDARD - LINE 7"	FOOT	2,581	2,581									
* 7800900	MODIFIED URETHANE PAVEMENT MARKING - LETTERS AND SYMBOLS	SQ FT	798	798									
* 7800904	MODIFIED URETHANE PAVEMENT MARKING - LINE 4"	FOOT	11,767	11,767									
* 7800906	MODIFIED URETHANE PAVEMENT MARKING - LINE 6"	FOOT	3,773	3,773									
* 7800908	MODIFIED URETHANE PAVEMENT MARKING - LINE 8"	FOOT	465	465									
* 7800912	MODIFIED URETHANE PAVEMENT MARKING - LINE 12"	FOOT	2,696	2,696									
* 7800924	MODIFIED URETHANE PAVEMENT MARKING - LINE 24"	FOOT	548	548									
* 7801104	GROOVING FOR RECESSED PAVEMENT MARKING 8"	FOOT	2,581	2,581									
* 7810010	RAISED REFLECTIVE PAVEMENT MARKER	EACH	549	549									
* 7820005	GUARDRAIL REFLECTORS, TYPE A	EACH	4	4									
7830020	RAISED REFLECTIVE PAVEMENT MARKER REMOVAL	EACH	726	726									
7830022	PAVEMENT MARKING REMOVAL - WATER BLASTING	SQ FT	3,206	3,206									
* 8040020	ELECTRIC UTILITY SERVICE CONNECTION	L SUM	1					1					

* SPECIALTY ITEM

FILE NAME = F:\961-000 Genava East State St\ADD_Sheets\961-000-SHT_SUMMARY OF QUANTITIES.dwg



USER NAME = tncstar	DESIGNED - GJE	REVISED -
	DRAWN - GJE	REVISED -
PLOT SCALE = 48.0000' / 1"	CHECKED - DBB	REVISED -
PLOT DATE = 1/27/2025	DATE - 11/7/2024	REVISED -

STATE OF ILLINOIS
DEPARTMENT OF TRANSPORTATION

ILLINOIS ROUTE 38 - EAST STATE STREET
SUMMARY OF QUANTITIES

SCALE: SHEET 12 OF 24 SHEETS STA. TO STA.

F.A.U. RTE.	SECTION	COUNTY	TOTAL SHEETS	SHEET NO.
0347	05-00102-00-PV	KANE	488	15
CONTRACT NO. 61J84			ILLINOIS FED. AID PROJECT	

CODE NO.	ITEM	UNIT	TOTAL QUANTITY	CONSTRUCTION CODE							
				ROADWAY	TRAFFIC SIGNALS	WATERMAIN	SANITARY	ITEP/TAP	LANDSCAPING	STRUCTURAL	TRAINEES
				0003	0021	0043	0043	0028	0031	0044	0042
				80% FED 20% LOCAL	80% FED 20% LOCAL	100% LOCAL	100% LOCAL	80% FED 20% LOCAL	80% FED 20% LOCAL	80% FED 20% LOCAL	
* 81028200	UNDERGROUND CONDUIT, GALVANIZED STEEL, 2" DIA.	FOOT	6,973		6,973						
* 81028220	UNDERGROUND CONDUIT, GALVANIZED STEEL, 3" DIA.	FOOT	154		154						
* 81028240	UNDERGROUND CONDUIT, GALVANIZED STEEL, 4" DIA.	FOOT	4,230		1,557			2,673			
* 81028790	UNDERGROUND CONDUIT, COILABLE NONMETALLIC CONDUIT, 4" DIA.	FOOT	3,196		3,196						
* 81400100	HANDHOLE	EACH	29		29						
* 81400200	HEAVY-DUTY HANDHOLE	EACH	11		11						
* 81400300	DOUBLE HANDHOLE	EACH	8		8						
* 81400730	HANDHOLE, COMPOSITE CONCRETE	EACH	3		3						
* 81702460	ELECTRIC CABLE IN CONDUIT, 600V (XLP-TYPE USE) 3-1/C NO. 3/0	FOOT	100					100			
* 82110007	LUMINAIRE, LED, ROADWAY, OUTPUT DESIGNATION G	EACH	66					66			
* 83600300	LIGHT POLE FOUNDATION, 30" DIAMETER	FOOT	462					462			
* 84200500	REMOVAL OF LIGHTING UNIT, SALVAGE	EACH	64					64			
* 84200804	REMOVAL OF POLE FOUNDATION	EACH	65					65			
* 85000200	MAINTENANCE OF EXISTING TRAFFIC SIGNAL INSTALLATION	EACH	2		2						
* 85100500	PAINT NEW TRAFFIC SIGNAL POST	EACH	21		21						

* SPECIALTY ITEM

FILE NAME = F:\1951-DBB Geneva East State St\1000_Sheets\1951-DBB_SHT_SUMMARY OF QUANTITIES.dgn



USER NAME = trestor	DESIGNED - GJE	REVISED -
	DRAWN - GJE	REVISED -
PLOT SCALE = 1/8" = 1' / in.	CHECKED - DBB	REVISED -
PLOT DATE = 1/27/2025	DATE - 11/7/2024	REVISED -

STATE OF ILLINOIS
DEPARTMENT OF TRANSPORTATION

ILLINOIS ROUTE 38 - EAST STATE STREET
SUMMARY OF QUANTITIES


SCALE: SHEET 13 OF 24 SHEETS STA. TO STA.

F.A.U. RTE.	SECTION	COUNTY	TOTAL SHEETS	SHEET NO.
0347	05-00102-00-PV	KANE	482	16
CONTRACT NO. 61JB4			ILLINOIS FED. AID PROJECT	

CODE NO.	ITEM	UNIT	TOTAL QUANTITY	CONSTRUCTION CODE							
				ROADWAY	TRAFFIC SIGNALS	WATERMAIN	SANITARY	ITEP/TAP	LANDSCAPING	STRUCTURAL	TRAINEES
				0003	0021	0043	0043	0028	0031	0044	0042
				80% FED 20% LOCAL	80% FED 20% LOCAL	100% LOCAL	100% LOCAL	80% FED 20% LOCAL	80% FED 20% LOCAL	80% FED 20% LOCAL	
* 85100600	PAINT NEW MAST ARM AND POLE, UNDER 40 FOOT	EACH	7		7						
* 85100701	PAINT NEW MAST ARM AND POLE, 40 FOOT AND OVER	EACH	11		11						
* 87300925	ELECTRIC CABLE IN CONDUIT, TRACER, NO. 14 1C	FOOT	11,891		11,891						
* 87301215	ELECTRIC CABLE IN CONDUIT, SIGNAL NO. 14 2C	FOOT	3,596		3,596						
* 87301225	ELECTRIC CABLE IN CONDUIT, SIGNAL NO. 14 3C	FOOT	6,969		6,969						
* 87301245	ELECTRIC CABLE IN CONDUIT, SIGNAL NO. 14 5C	FOOT	5,143		5,143						
* 87301255	ELECTRIC CABLE IN CONDUIT, SIGNAL NO. 14 7C	FOOT	5,516		5,516						
* 87301305	ELECTRIC CABLE IN CONDUIT, LEAD-IN, NO. 14 1 PAIR	FOOT	4,930		4,930						
* 87301805	ELECTRIC CABLE IN CONDUIT, SERVICE, NO. 6 2 C	FOOT	62		62						
* 87301900	ELECTRIC CABLE IN CONDUIT, EQUIPMENT GROUNDING CONDUCTOR, NO. 6 1C	FOOT	1,696		1,696						
* 87501200	TRAFFIC SIGNAL POST, 16 FT.	EACH	6		6						
* 87501400	TRAFFIC SIGNAL POST, 18 FT.	EACH	1		1						
* 87700120	STEEL MAST ARM ASSEMBLY AND POLE, 16 FT.	EACH	2		2						
* 87700240	STEEL MAST ARM ASSEMBLY AND POLE, 40 FT.	EACH	1		1						
* 87700250	STEEL MAST ARM ASSEMBLY AND POLE, 42 FT.	EACH	1		1						

* SPECIALTY ITEM

FILE NAME: F:\161-000 Geneseo East State 61J800-Sheets\981-886-SHT_SUMMARY OF QUANTITIES.dgn

	USER NAME: <i>treator</i>	DESIGNED: GJE	REVISED: -
		DRAWN: GJE	REVISED: -
	PLOT SCALE: 48.0000' / 1" =	CHECKED: DBB	REVISED: -
	PLOT DATE: 1/27/2025	DATE: 11/7/2024	REVISED: -

STATE OF ILLINOIS
DEPARTMENT OF TRANSPORTATION

ILLINOIS ROUTE 38 - EAST STATE STREET
SUMMARY OF QUANTITIES

SCALE: SHEET 14 OF 24 SHEETS STA. TO STA.

F.A.U. RTE.	SECTION	COUNTY	TOTAL SHEETS	SHEET NO.
0347	05-00102-00-PV	KANE	472	17
			CONTRACT NO. 61J84	
ILLINOIS FED. AID PROJECT				

CODE NO.	ITEM	UNIT	TOTAL QUANTITY	CONSTRUCTION CODE									
				ROADWAY	TRAFFIC SIGNALS	WATERMAIN	SANITARY	ITEP/TAP	LANDSCAPING	STRUCTURAL	TRAINEES		
				0003	0021	0043	0043	0028	0031	0042	0042		
				80% FED 20% LOCAL	80% FED 20% LOCAL	100% LOCAL	100% LOCAL	80% FED 20% LOCAL	80% FED 20% LOCAL	80% FED 20% LOCAL			
* 87700260	STEEL MAST ARM ASSEMBLY AND POLE, 44 FT.	EACH	1		1								
* 87700270	STEEL MAST ARM ASSEMBLY AND POLE, 46 FT.	EACH	1		1								
* 87700280	STEEL MAST ARM ASSEMBLY AND POLE, 48 FT.	EACH	1		1								
* 87700300	STEEL MAST ARM ASSEMBLY AND POLE, 52 FT.	EACH	1		1								
* 87702160	STEEL MAST ARM ASSEMBLY AND POLE WITH DUAL MAST ARMS, 14 FT. AND 50 FT.	EACH	1		1								
* 87702621	STEEL MAST ARM ASSEMBLY AND POLE WITH DUAL MAST ARMS, 40 FT. AND 18 FT.	EACH	1		1								
* 87702240	STEEL MAST ARM ASSEMBLY AND POLE WITH DUAL MAST ARMS, 20 FT. AND 46 FT.	EACH	1		1								
* 87702282	STEEL MAST ARM ASSEMBLY AND POLE WITH DUAL MAST ARMS, 22 FT. AND 46 FT.	EACH	1		1								
* 87702360	STEEL MAST ARM ASSEMBLY AND POLE WITH DUAL MAST ARMS, 26 FT. AND 40 FT.	EACH	1		1								
* 87702480	STEEL MAST ARM ASSEMBLY AND POLE WITH DUAL MAST ARMS, 30 FT. AND 44 FT.	EACH	1		1								
* 87800100	CONCRETE FOUNDATION, TYPE A	FOOT	40		40								
* 87800150	CONCRETE FOUNDATION, TYPE C	FOOT	12		12								
* 87800400	CONCRETE FOUNDATION, TYPE E 30-INCH DIAMETER	FOOT	20		20								
* 87800415	CONCRETE FOUNDATION, TYPE E 36-INCH DIAMETER	FOOT	152		152								
* 87900200	DRILL EXISTING HANDHOLE	EACH	2		2								

* SPECIALTY ITEM

FILE NAME: F:\981-000 Genesee East State 5A\CADD\Drawings\981-000_SHT_SUMMARY OF QUANTITIES.dgn



USER NAME = creator	DESIGNED - GJE	REVISED -
DRAWN - GJE	CHECKED - DBB	REVISIONS -
PLOT SCALE = 40.0000' / 1" =	DATE - 11/7/2024	
PLOT DATE = 1/27/2025		

STATE OF ILLINOIS
DEPARTMENT OF TRANSPORTATION

ILLINOIS ROUTE 38 - EAST STATE STREET
SUMMARY OF QUANTITIES

SCALE: SHEET 15 OF 24 SHEETS STA. TO STA.

F.A.U. RTE.	SECTION	COUNTY	TOTAL SHEETS	SHEET NO.
0347	05-00102-00-PV	XANE	188	18
			CONTRACT NO. 61J84	
ILLINOIS FED. AID PROJECT				

CODE NO.	ITEM	UNIT	TOTAL QUANTITY	CONSTRUCTION CODE									
				ROADWAY	TRAFFIC SIGNALS	WATERMAIN	SANITARY	ITEP/TAP	LANDSCAPING	STRUCTURAL	TRAINEES		
				0003 80% FED 20% LOCAL	0021 80% FED 20% LOCAL	0043 100% LOCAL	0043 100% LOCAL	0028 80% FED 20% LOCAL	0031 80% FED 20% LOCAL	0044 80% FED 20% LOCAL	0042		
* 88030020	SIGNAL HEAD, LED, 1-FACE, 3-SECTION, MAST-ARM MOUNTED	EACH	22		22								
* 88030050	SIGNAL HEAD, LED, 1-FACE, 3-SECTION, BRACKET MOUNTED	EACH	5		5								
* 88030100	SIGNAL HEAD, LED, 1-FACE, 5-SECTION, BRACKET MOUNTED	EACH	8		8								
* 88030110	SIGNAL HEAD, LED, 1-FACE, 5-SECTION, MAST-ARM MOUNTED	EACH	20		20								
* 88102717	PEDESTRIAN SIGNAL HEAD, LED, 1-FACE, BRACKET MOUNTED WITH COUNTDOWN TIMER	EACH	24		24								
* 88200410	TRAFFIC SIGNAL BACKPLATE, LOUVERED, FORMED PLASTIC	EACH	42		42								
* 88500100	INDUCTIVE LOOP DETECTOR	EACH	29		29								
* 88700200	LIGHT DETECTOR	EACH	12		12								
* 88700300	LIGHT DETECTOR AMPLIFIER	EACH	3		3								
* 89000100	TEMPORARY TRAFFIC SIGNAL INSTALLATION	EACH	3		3								
* 89502300	REMOVE ELECTRIC CABLE FROM CONDUIT	FOOT	12,407		12,407								
* 89502375	REMOVE EXISTING TRAFFIC SIGNAL EQUIPMENT	EACH	3		3								
* 89502380	REMOVE EXISTING HANDHOLE	EACH	45		45								
* 89502382	REMOVE EXISTING DOUBLE HANDHOLE	EACH	4		4								
* 89502385	REMOVE EXISTING CONCRETE FOUNDATION	EACH	27		27								

* SPECIALTY ITEM

FILE NAME = F:\951-003 Genave East State SAC\000_Sheets\051-000_SHT_SUMMARY OF QUANTITIES.dgn



USER NAME = tncator	DESIGNED - GJE	REVISED -
	DRAWN - GJE	REVISED -
PLOT SCALE = 1/8" = 1'-0"	CHECKED - DBB	REVISED -
PLOT DATE = 1/27/2025	DATE - 11/7/2024	REVISED -

STATE OF ILLINOIS
DEPARTMENT OF TRANSPORTATION

ILLINOIS ROUTE 38 - EAST STATE STREET
SUMMARY OF QUANTITIES

SCALE: SHEET 16 OF 24 SHEETS STA. TO STA.

F.A.U. RTE.	SECTION	COUNTY	TOTAL SHEETS	SHEET NO.
0347	05-00102-00-PV	KANE	438	19
CONTRACT NO. 61J84				
(ILLINOIS) FED. AID PROJECT				

CODE NO.	ITEM	UNIT	TOTAL QUANTITY	CONSTRUCTION CODE								
				ROADWAY	TRAFFIC SIGNALS	WATERMAIN	SANITARY	ITEP/TAP	LANDSCAPING	STRUCTURAL	TRAINEES	
				0003 80% FED 20% LOCAL	0021 80% FED 20% LOCAL	0043 100% LOCAL	0043 100% LOCAL	0028 80% FED 20% LOCAL	0031 80% FED 20% LOCAL	0044 80% FED 20% LOCAL	0042	
* A2002420	TREE, BETULA NIGRA HERITAGE (HERITAGE RIVER BIRCH), 2-1/2" CALIPER, BALLED AND BURLAPPED	EACH	40							40		
* A2002502	TREE, CARPINUS BETULUS FASTIGIATA (COLUMNAR EUROPEAN HORNBEAM), 3" CALIPER, BALLED AND BURLAPPED	EACH	32							32		
* A2002820	TREE, CATALPA SPECIOSA (NORTHERN CATALPA), 2-1/2" CALIPER, BALLED AND BURLAPPED	EACH	10							10		
* A2002920	TREE, CELTIS OCCIDENTALIS (COMMON HACKBERRY), 2-1/2" CALIPER, BALLED AND BURLAPPED	EACH	34							34		
* A2004416	TREE, GINKGO BILOBA (GINKGO), 2" CALIPER, BALLED AND BURLAPPED	EACH	54							54		
* A2004620	TREE, GLEDITSIA TRIACANTHOS INERMIS (THORNLESS COMMON HONEYLOCUST), 2-1/2" CALIPER, BALLED AND BURLAPPED	EACH	57							57		
* A2006600	TREE, QUERCUS COCCINEA (SCARLET OAK), 1-3/4" CALIPER, BALLED AND BURLAPPED	EACH	63							63		
* K0029534	WEED CONTROL, PRE-EMERGENT GRANULAR HERBICIDE	POUND	54							54		
X0321315	REMOVE STONE PAVERS	50 FT	75					75				
* X0324085	EMERGENCY VEHICLE PRIORITY SYSTEM LINE SENSOR CABLE, NO. 20 3/C	FOOT	3,044		3,044							
* X0324599	ROD AND CLEAN EXISTING CONDUIT	FOOT	1,249		1,249							
X0327611	REMOVE AND REINSTALL BRICK PAVER	50 FT	195					195				
X0540000	BRICK PAVERS	50 FT	14,340					14,340				
* X1200003	WATER SERVICE REPLACEMENT, 2" - SHORT	EACH	2			2						
* X1200015	VALVE VAULTS TO BE ABANDONED	EACH	24			24						

* SPECIALTY ITEM

FILE NAME = F:\961-000 Genavo East State St\1601-000_SHT_SUMMARY OF QUANTITIES.dgn



USER NAME = trestor	DESIGNED - GJE	REVISED -
	DRAWN - GJE	REVISED -
PLOT SCALE = 48.0000' / 1"	CHECKED - DBB	REVISED -
PLOT DATE = 1/27/2025	DATE - 11/7/2024	REVISED -

STATE OF ILLINOIS
DEPARTMENT OF TRANSPORTATION

ILLINOIS ROUTE 38 - EAST STATE STREET
SUMMARY OF QUANTITIES

SCALE: SHEET 17 OF 24 SHEETS STA. TO STA.

F.A.U. RTE. 0347	SECTION 05-00102-00-PV	COUNTY KANE	TOTAL SHEETS 488	SHEET NO. 20
				CONTRACT NO. 61J84
ILLINOIS FED. AID PROJECT				

CODE NO.	ITEM	UNIT	TOTAL QUANTITY	CONSTRUCTION CODE									
				ROADWAY	TRAFFIC SIGNALS	WATERMAIN	SANITARY	ITEP/TAP	LANDSCAPING	STRUCTURAL	TRAINEES		
				0003 80% FED 20% LOCAL	0021 80% FED 20% LOCAL	0043 100% LOCAL	0043 100% LOCAL	0028 80% FED 20% LOCAL	0031 80% FED 20% LOCAL	0044 80% FED 20% LOCAL	0042		
* X1200036	SANITARY SERVICE CLEANOUT	EACH	28				28						
* X1200089	WATER SERVICE REPLACEMENT, 2" - LONG	EACH	2			2							
* X1400101	NETWORK CONFIGURATION	L SUM	1		1								
* X1400102	OUTDOOR RATED NETWORK CABLE	FOOT	787		787								
* X1400150	SERVICE INSTALLATION, GROUND MOUNTED, METERED	EACH	3		3								
* X1400216	LAYER II (DATALINK) SWITCH	EACH	2		2								
* X1400367	PEDESTRIAN SIGNAL POST, 10 FT.	EACH	3		3								
* X1400378	PEDESTRIAN SIGNAL POST, 5 FT.	EACH	6		6								
X2010404	STUMP REMOVAL	EACH	10	10									
X2010512	CLEARING AND GRUBBING	SQ YD	1,746	1,746									
X2130010	EXPLORATION TRENCH (SPECIAL)	FOOT	1,500	500		500	500						
X4021000	TEMPORARY ACCESS (PRIVATE ENTRANCE)	EACH	8	8									
X4022000	TEMPORARY ACCESS (COMMERCIAL ENTRANCE)	EACH	45	45									
X4023000	TEMPORARY ACCESS (ROAD)	EACH	16	16									
X4024100	TEMPORARY ACCESS (WINTERIZED)	SQ YD	3,016	3,016									

* SPECIALTY ITEM

FILE NAME = F:\191-003 Genevo East State St\CADD\Sheets\951-900_SHT_SUMMARY OF QUANTITIES.dgn



USER NAME = Unstor	DESIGNED - GJE	REVISED -
	DRAWN - GJE	REVISED -
PLOT SCALE = 48,0000' / 1" =	CHECKED - DBB	REVISED -
PLOT DATE = 1/27/2025	DATE - 11/7/2024	REVISED -

STATE OF ILLINOIS
DEPARTMENT OF TRANSPORTATION

ILLINOIS ROUTE 38 - EAST STATE STREET
SUMMARY OF QUANTITIES

SCALE: SHEET 18 OF 24 SHEETS STA. TO STA.

F.A.U. RTE. 0347	SECTION 05-00102-00-PV	COUNTY KANE	TOTAL SHEETS 438	SHEET NO. 21
CONTRACT NO. 61J84			ILLINOIS FED. AID PROJECT	

CODE NO.	ITEM	UNIT	TOTAL QUANTITY	CONSTRUCTION CODE								
				ROADWAY	TRAFFIC SIGNALS	WATERMAIN	SANITARY	ITEP/TAP	LANDSCAPING	STRUCTURAL	TRAINEES	
				0003 80% FED 20% LOCAL	0021 80% FED 20% LOCAL	0043 100% LOCAL	0043 100% LOCAL	0028 80% FED 20% LOCAL	0031 80% FED 20% LOCAL	0044 80% FED 20% LOCAL	0042	
X4240460	PORTLAND CEMENT CONCRETE SIDEWALK 6 INCH (SPECIAL)	SO FT	39,730	39,730								
X4400110	TEMPORARY PAVEMENT REMOVAL	SO YD	1,219	1,219								
X4420671	CLASS B PATCHES, TYPE I, 10 INCH (SPECIAL)	SO YD	4	4								
X4420684	CLASS B PATCHES, TYPE IV, 10 INCH (SPECIAL)	SO YD	52	52								
X5021507	DEWATERING	L SUM	1	1								
X5220102	RETAINING WALL REMOVAL	FOOT	40	40								
* X5610700	WATER MAIN REMOVAL	FOOT	225			225						
* X5610744	WATER MAIN LINE STOP 4"	EACH	1			1						
* X5610746	WATER MAIN LINE STOP 6"	EACH	1			1						
* X5610748	WATER MAIN LINE STOP 8"	EACH	2			2						
* X5610750	WATER MAIN LINE STOP 10"	EACH	2			2						
* X5610752	WATER MAIN LINE STOP 12"	EACH	2			2						
* X5610756	WATER MAIN LINE STOP 16"	EACH	2			2						
* X5620102	WATER SERVICE REPLACEMENT, 1.5" - SHORT	EACH	2			2						
* X5620104	WATER SERVICE REPLACEMENT, 1.5" - LONG	EACH	9			9						

* SPECIALTY ITEM

FILE NAME = F:\9191-008 Geneva East State St\2000_Sheets\961-000_SHT_SUMMARY OF QUANTITIES.dgn



USER NAME = tneator	DESIGNED - GJE	REVISED -
PLOT SCALE = 40,0000' / 1"	DRAWN - GJE	REVISED -
PLOT DATE = 1/27/2025	CHECKED - DBB	REVISED -
	DATE - 11/7/2024	REVISED -

STATE OF ILLINOIS
DEPARTMENT OF TRANSPORTATION

ILLINOIS ROUTE 38 - EAST STATE STREET
SUMMARY OF QUANTITIES

SCALE: SHEET 19 OF 24 SHEETS STA. TO STA.

F.A.U. RTE. 0347	SECTION 05-00102-00-PV	COUNTY KANE	TOTAL SHEETS 422	SHEET NO. 22
CONTRACT NO. 61J84			ILLINOIS FED. AID PROJECT	

CODE NO.	ITEM	UNIT	TOTAL QUANTITY	CONSTRUCTION CODE								
				ROADWAY	TRAFFIC SIGNALS	WATERMAIN	SANITARY	ITEP/TAP	LANDSCAPING	STRUCTURAL	TRAINERS	
				0003	0021	0043	0043	0028	0031	0044	0042	
				80% FED 20% LOCAL	80% FED 20% LOCAL	100% LOCAL	100% LOCAL	80% FED 20% LOCAL	80% FED 20% LOCAL	80% FED 20% LOCAL		
* X5620112	WATER SERVICE CONNECTION	EACH	22			22						
* X5630004	CUT AND CAP EXISTING 4" WATER MAIN	EACH	9			9						
* X5630006	CUT AND CAP EXISTING 6" WATER MAIN	EACH	4			4						
* X5630008	CUT AND CAP EXISTING 8" WATER MAIN	EACH	1			1						
* X5630010	CUT AND CAP EXISTING 10" WATER MAIN	EACH	2			2						
* X5630012	CUT AND CAP EXISTING 12" WATER MAIN	EACH	4			4						
* X5630016	CUT AND CAP EXISTING 16" WATER MAIN	EACH	2			2						
* X5630704	CONNECTION TO EXISTING WATER MAIN 4"	EACH	2			2						
* X5630710	CONNECTION TO EXISTING WATER MAIN 10"	EACH	9			9						
X5810103	MEMBRANE WATERPROOFING SYSTEM FOR BURIED STRUCTURES	SQ YD	19								19	
X6020094	MANHOLES, TYPE A, 6"-DIAMETER, TYPE I FRAME, CLOSED LID, RESTRICTOR PLATE	EACH	2	2								
* X6022312	DROP SANITARY MANHOLES, WITH TYPE I FRAME, CLOSED LID	EACH	1				1					
X6026050	SANITARY MANHOLES TO BE ADJUSTED	EACH	4	4								
* X6026055	SANITARY MANHOLE (SPECIAL)	EACH	20				20					
* X6026623	VALVE BOX	EACH	22			22						

* SPECIALTY ITEM

FILE NAME = F:\1951-080 Geneva East State St\AC00_Sheets\181-000_SHT_SUMMARY OF QUANTITIES.dgn



USER NAME = tnestor	DESIGNED - GJE	REVISED -
	DRAWN - GJE	REVISED -
PLOT SCALE = 48,0000' / 1"	CHECKED - DBB	REVISED -
PLOT DATE = 1/27/2025	DATE - 11/7/2024	REVISED -

STATE OF ILLINOIS
DEPARTMENT OF TRANSPORTATION

ILLINOIS ROUTE 38 -- EAST STATE STREET
SUMMARY OF QUANTITIES

SCALE: SHEET 20 OF 24 SHEETS STA. TO STA.

F.A.U. RTE.	SECTION	COUNTY	TOTAL SHEETS	SHEET NO.
0347	05-00102-00-PV	KANE	488	23
CONTRACT NO. 61J84			ILLINOIS FED. AID PROJECT	

CODE NO.	ITEM	UNIT	TOTAL QUANTITY	CONSTRUCTION CODE									
				ROADWAY	TRAFFIC SIGNALS	WATERMAIN	SANITARY	ITEP/TAP	LANDSCAPING	STRUCTURAL	TRAINEES		
				0003 80% FED 20% LOCAL	0021 80% FED 20% LOCAL	0043 100% LOCAL	0043 100% LOCAL	0028 80% FED 20% LOCAL	0031 80% FED 20% LOCAL	0044 80% FED 20% LOCAL	0042		
X6026632	VALVE BOXES TO BE REMOVED	EACH	1	1									
X7010216	TRAFFIC CONTROL AND PROTECTION, (SPECIAL)	L SUM	1	1									
X7240600	REMOVE AND RE-ERECT EXISTING SIGN	EACH	2	2									
* X8250500	LIGHTING UNIT COMPLETE (SPECIAL)	EACH	66					66					
* X8500108	MAINTENANCE OF TEMPORARY TRAFFIC SIGNAL INSTALLATION	EACH	3		3								
* X8570233	FULL-ACTUATED CONTROLLER AND TYPE SUPER P CABINET (SPECIAL)	EACH	3		3								
* X8620200	UNINTERRUPTABLE POWER SUPPLY (SPECIAL)	EACH	3		3								
* X8710031	FIBER OPTIC CABLE 36 FIBERS, SINGLE MODE	FOOT	3,528		3,528								
* X8710039	FIBER OPTIC CABLE 144 FIBERS, SINGLE MODE	FOOT	3,528		3,528								
* X8710200	FIBER OPTIC CABLE IN CONDUIT, NO. 62.5/125, MM12F SM36F	FOOT	8,364		8,364								
* X8760200	ACCESSIBLE PEDESTRIAN SIGNALS	EACH	24		24								
* X8780012	CONCRETE FOUNDATION, TYPE A 12-INCH DIAMETER	FOOT	36		36								
* X8809005	LED SIGNAL FACE, LENS COVER	EACH	55		55								
* X8860107	PREFORMED DETECTOR LOOP	FOOT	2,792		2,792								
* X8891009	VIDEO VEHICLE DETECTION SYSTEM, SINGLE APPROACH	EACH	2		2								

* SPECIALTY ITEM

FILE NAME: F:\901-008 Canavea East State St\ADD_Sheets\951-008-SHT-SUMMARY OF QUANTITIES.dgn



USER NAME = mextor	DESIGNED - GJE	REVISED -
DRAWN - GJE	REVISIONS -	
CHECKED - DBB	REVISIONS -	
DATE - 11/7/2024	REVISIONS -	

STATE OF ILLINOIS
DEPARTMENT OF TRANSPORTATION

ILLINOIS ROUTE 38 - EAST STATE STREET
SUMMARY OF QUANTITIES

SCALE: SHEET 21 OF 24 SHEETS STA. TO STA.

F.A.U. RTE. 0347	SECTION 05-00102-00-PV	COUNTY KANE	TOTAL SHEETS 488	SHEET NO. 24
			CONTRACT NO. 61J84	
(ILLINOIS) FED. AID PROJECT				

CODE NO.	ITEM	UNIT	TOTAL QUANTITY	CONSTRUCTION CODE							
				ROADWAY	TRAFFIC SIGNALS	WATERMAIN	SANITARY	ITEP/TAP	LANDSCAPING	STRUCTURAL	TRAINERS
				0003	0021	0043	0043	0028	0031	0044	0042
				80% FED	80% FED	100% LOCAL	100% LOCAL	80% FED	80% FED	80% FED	
				20% LOCAL	20% LOCAL			20% LOCAL	20% LOCAL	20% LOCAL	
* X8950077	REMOVE AND RELOCATE EXISTING LIGHTING CONTROLLER	EACH	1					1			
* X8950130	MODIFY EXISTING LIGHTING CONTROLLER	EACH	1					1			
* X8950705	TEMPORARY INTERCONNECT	L SUM	1		1						
* XP000179	GROUND ROD, 8', COPPER CLAD	EACH	1					1			
* XX001386	SANITARY SEWER, PVC, 8"	FOOT	2,883				2,883				
* XX001464	SANITARY SEWER, PVC, 6"	FOOT	1,325				1,325				
	XX001621	BRICK PAVER REMOVAL	SQ FT	3,533				3,533			
* XX003516	CONNECTION TO EXISTING WATER MAIN (NON-PRESSURE) - 8"	EACH	2			2					
* XX003517	CONNECTION TO EXISTING WATER MAIN (NON-PRESSURE) - 6"	EACH	4			4					
* XX005107	CONNECTIONS TO EXISTING WATER MAINS (NON PRESSURE) 12"	EACH	1			1					
	XX006821	CONCRETE TRUCK WASHOUT	L SUM	1	1						
* XX007504	SANITARY SEWER SERVICE RISER, 6" PVC	FOOT	250				250				
* XX008910	PAVEMENT MARKING (SPECIAL)	SQ FT	5,963	5,963							
	XX009224	CLASS D PATCHES, SPECIAL	SQ YD	800	800						
	Z0013798	CONSTRUCTION LAYOUT	L SUM	1	1						

* SPECIALTY ITEM

FILE NAME = FN1951-000 Geneva East State St\CA001\Shasta\1951-000_SHT_SUMMARY_OF_QUANTITIES.dgn



USER NAME = trestor	DESIGNED - GJE	REVISED -
	DRAWN - GJE	REVISED -
PLDT SCALE = 40,0000 1/4 in.	CHECKED - DBB	REVISED -
PLDT DATE = 1/27/2025	DATE = 11/7/2024	REVISED -

STATE OF ILLINOIS
DEPARTMENT OF TRANSPORTATION

ILLINOIS ROUTE 38 - EAST STATE STREET
SUMMARY OF QUANTITIES


SCALE: SHEET 22 OF 24 SHEETS STA. TO STA.

F.A.U. RTE. 0347	SECTION 05-00102-00-PV	COUNTY KANE	TOTAL SHEETS 488	SHEET NO. 25
CONTRACT NO. 61J84			ILLINOIS FED. AID PROJECT	

CODE NO.	ITEM	UNIT	TOTAL QUANTITY	CONSTRUCTION CODE								
				ROADWAY	TRAFFIC SIGNALS	WATERMAIN	SANITARY	ITEP/TAP	LANDSCAPING	STRUCTURAL	TRAINEES	
				0003	0021	0043	0043	0028	0031	0044	0042	
	80% FED 20% LOCAL	80% FED 20% LOCAL	100% LOCAL	100% LOCAL	80% FED 20% LOCAL	80% FED 20% LOCAL	80% FED 20% LOCAL					
Z0056616	STORM SEWER (WATER MAIN REQUIREMENTS) 24 INCH	FOOT	129	129								
Z0056618	STORM SEWER (WATER MAIN REQUIREMENTS) 27 INCH	FOOT	61	61								
Z0056620	STORM SEWER (WATER MAIN REQUIREMENTS) 30 INCH	FOOT	610	610								
Z0056622	STORM SEWER (WATER MAIN REQUIREMENTS) 36 INCH	FOOT	1,112	1,112								
Z0056626	STORM SEWER (WATER MAIN REQUIREMENTS) 48 INCH	FOOT	229	229								
Z0062456	TEMPORARY PAVEMENT	SQ YD	1,219	1,219								
* Z0073510	TEMPORARY TRAFFIC SIGNAL TIMING	EACH	5	2	3							
Z0075496	CONCRETE RETAINING WALL REMOVAL	FOOT	140	140								
X5220098	TIMBER RETAINING WALL REMOVAL	FOOT	66	66								
Z0076600	TRAINEES	HOOR	4,000									4,000
Z0076604	TRAINEES TRAINING PROGRAM GRADUATE	HOOR	4,000									4,000
* XX009703	UNIT DUCT, 600V, 2-1C NO. 2, 4-1C NO. 4 1/2 NO. 6 GROUND, (XLP-TYPE USE), 2" DIA. POLYETHYLENE	FOOT	12,675					12,675				
* XX008963	THREE-CELL FABRIC INNERDUCT	FOOT	3,196		3,196							

* SPECIALTY ITEM

FILE NAME: P:\181-030 General East State SATCADD Sheets\181-030-000-SHT-SUMMARY OF QUANTITIES.dgn

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	PLOT SCALE = 48,0000' / 1" =	DRAWN - GJE	REVISED -			0347	05-00102-00-PV	KANE	438	27
	PLOT DATE = 1/27/2025	CHECKED - DBB	REVISED -			CONTRACT NO. 61JB4				
				SCALE: SHEET 24 OF 24 SHEETS STA. TO STA.		ILLINOIS FED. AID PROJECT				

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	DRAWN - GJE	REVISED -
PLOT SCALE = 40.0000' / in.	CHECKED - DBB	REVISED -
PLOT DATE = 1/29/2025	DATE - 11/7/2024	REVISED -

**STATE OF ILLINOIS
DEPARTMENT OF TRANSPORTATION**

**ILLINOIS ROUTE 38 – EAST STATE STREET
SUMMARY OF QUANTITIES**

SCALE: SHEET 25 OF 26 SHEETS STA. TO STA.

F.A.U RTE.	SECTION	COUNTY	TOTAL SHEETS	SHEET NO.
0347	05-00102-00-PV	KANE	488	28
				CONTRACT NO. 61J84
ILLINOIS FED. AID PROJECT				

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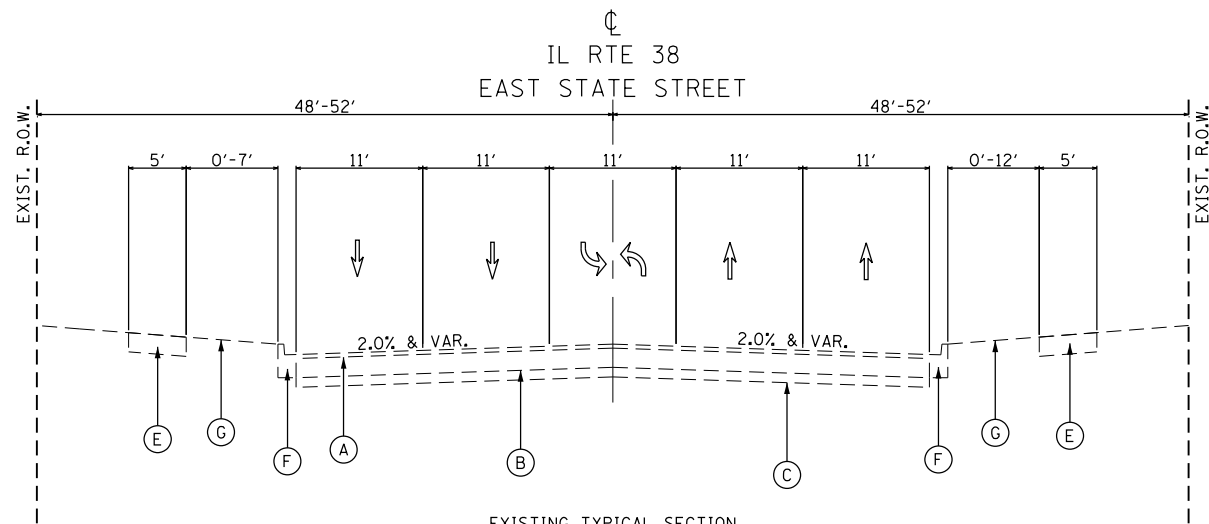
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PLOT DATE = 1/29/2025	DATE - 11/7/2024	REVISED -

**STATE OF ILLINOIS
DEPARTMENT OF TRANSPORTATION**


**ILLINOIS ROUTE 38 – EAST STATE STREET
SUMMARY OF QUANTITIES**

SCALE: SHEET 26 OF 26 SHEETS STA. TO STA.


F.A.U RTE.	SECTION	COUNTY	TOTAL SHEETS	SHEET NO.
0347	05-00102-00-PV	KANE	488	29
CONTRACT NO. 61J84			ILLINOIS FED. AID PROJECT	



EXISTING TYPICAL SECTION
EAST STATE STREET
STA 118+07 TO STA 124+00

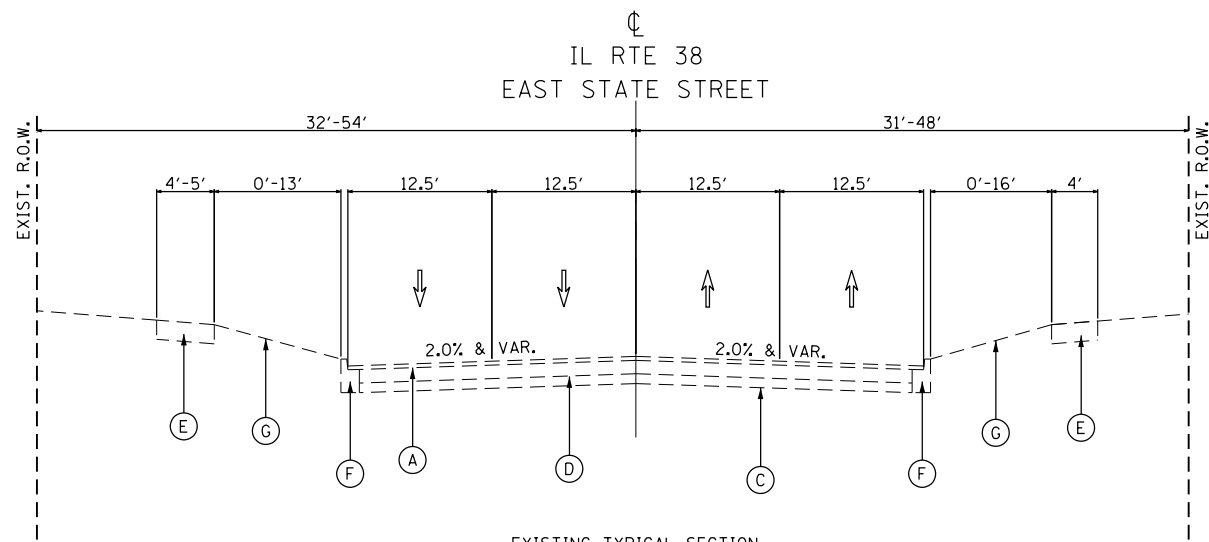


EXISTING TYPICAL SECTION
EAST STATE STREET
STA 124+00 TO STA 144+00

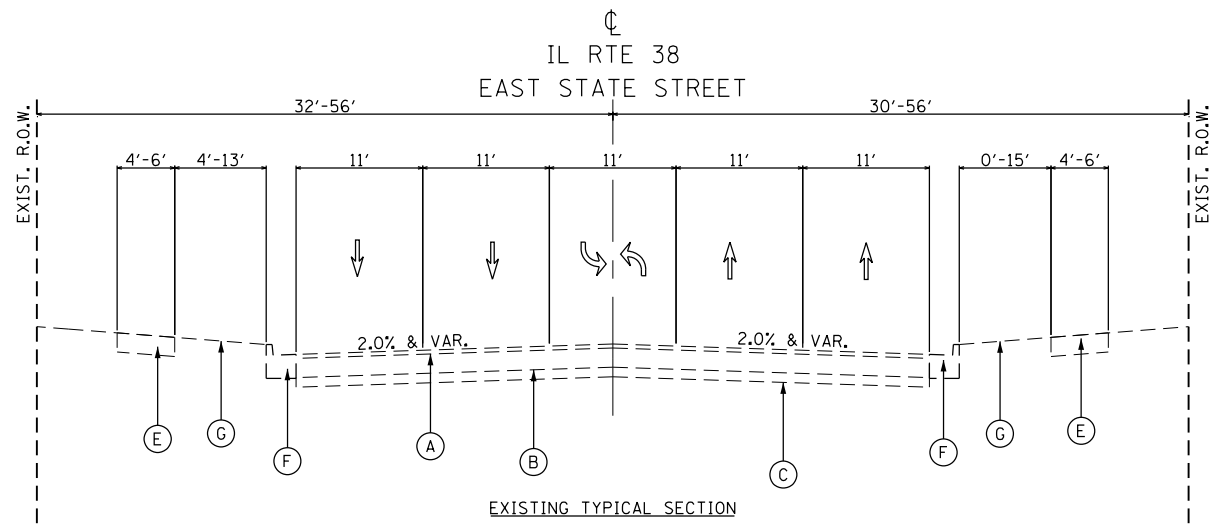


EXISTING TYPICAL SECTION
EAST STATE STREET
STA 144+00 TO STA 154+00

- LEGEND
- (A) EXISTING HOT MIX-ASPHALT (6"-11" VAR)
 - (B) EXISTING CONCRETE BASE COURSE (5"-7" VAR)
 - (C) EXISTING GRANULAR SUB BASE (5"-8" VAR)
 - (D) EXISTING BRICK, COBBLESTONE, OR CONCRETE
 - (E) EXISTING 5" PCC SIDEWALK
 - (F) EXISTING CURB AND GUTTER
 - (G) EXISTING PARKWAY
 - (H) EXISTING PAVED DITCH (REFER TO PLANS FOR LOCATIONS)

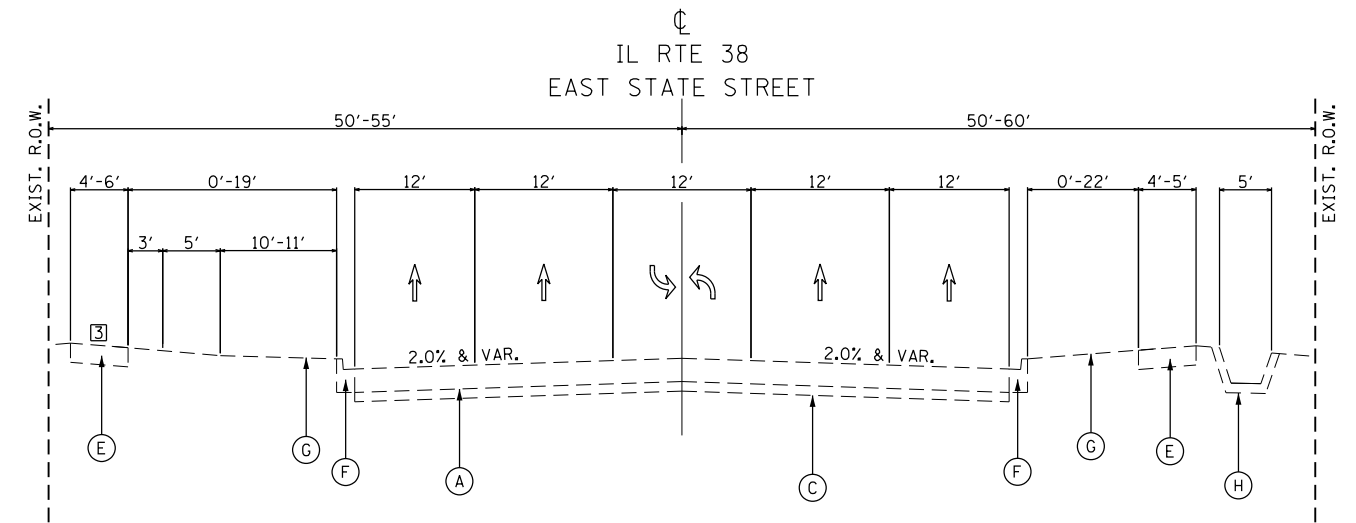

EXISTING TYPICAL SECTION
EAST STATE STREET
STA 154+00 TO STA 155+38 AND STA 167+90 TO STA 179+61

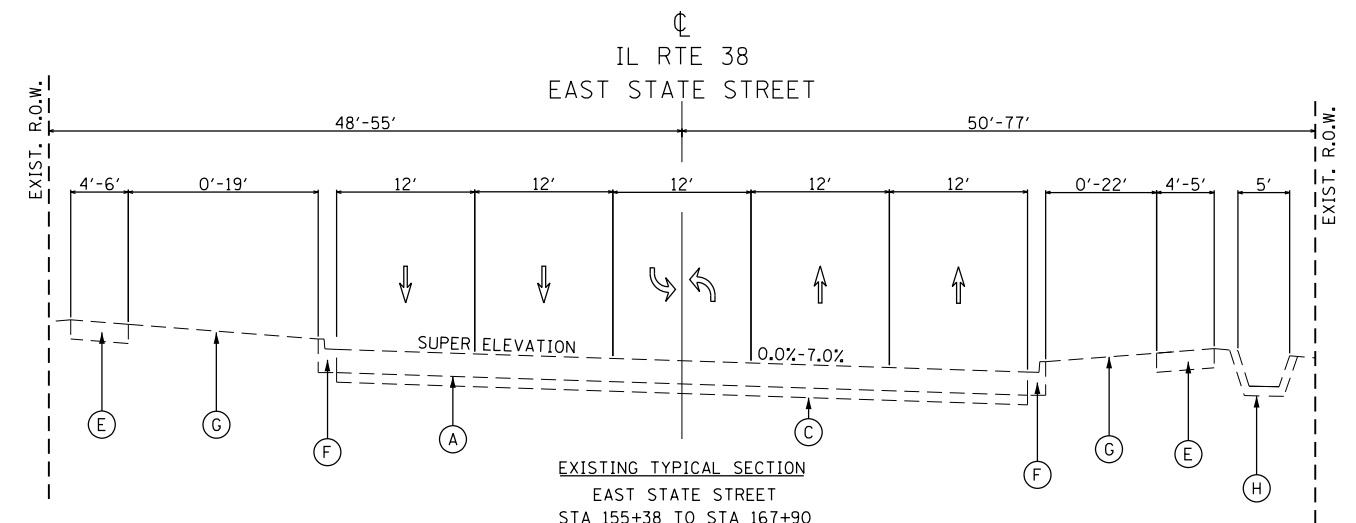

EXISTING TYPICAL SECTION
EAST STATE STREET
STA 155+38 TO STA 167+90

FILE NAME = F:\961-000 Genevo East State St.CADD.Sheets\961-000_SHT_TYP_SEC.dgn




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PLOT SCALE = 100.0000' / 1in.	DRAWN - GJE	REVISED -
PLOT DATE = 1/13/2025	CHECKED - DBB	REVISED -
	DATE - 11/7/2024	REVISED -

STATE OF ILLINOIS
DEPARTMENT OF TRANSPORTATION


ILLINOIS ROUTE 38 - EAST STATE STREET
EXISTING TYPICAL SECTIONS

SCALE: N.T.S. SHEET 1 OF 6 SHEETS STA. TO STA.


F.A.U. RTE.	SECTION	COUNTY	TOTAL SHEETS	SHEET NO.
0347	05-00102-00-PV	KANE	488	30
CONTRACT NO. 61J84			ILLINOIS FED. AID PROJECT	

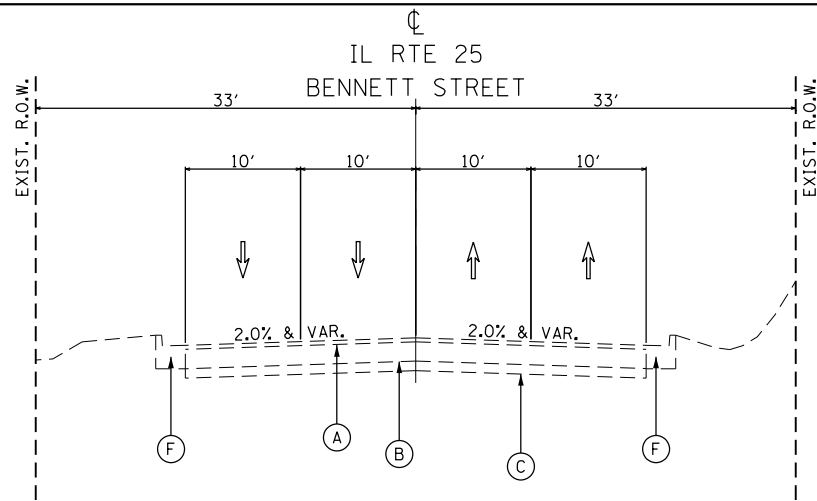

EXISTING TYPICAL SECTION
BENNETT STREET
STA 321+70.00 TO STA 324+17.39

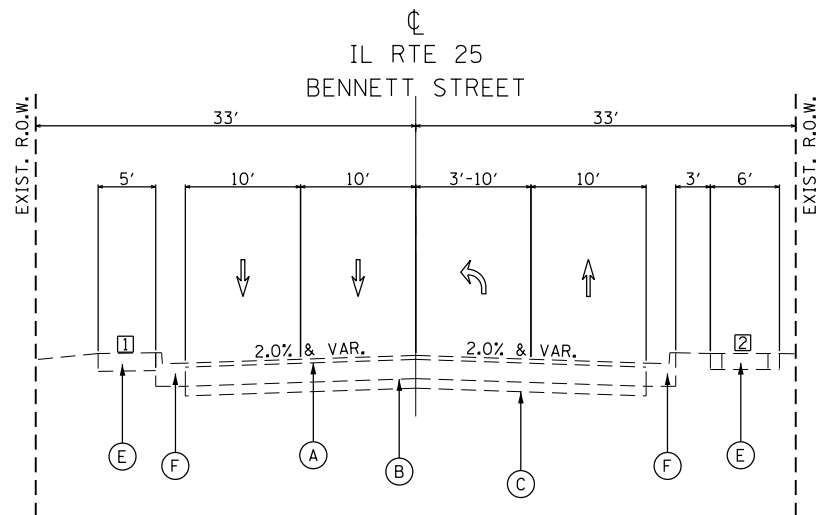


EXISTING TYPICAL SECTION
BENNETT STREET
STA 324+17.39 TO STA 326+77.24

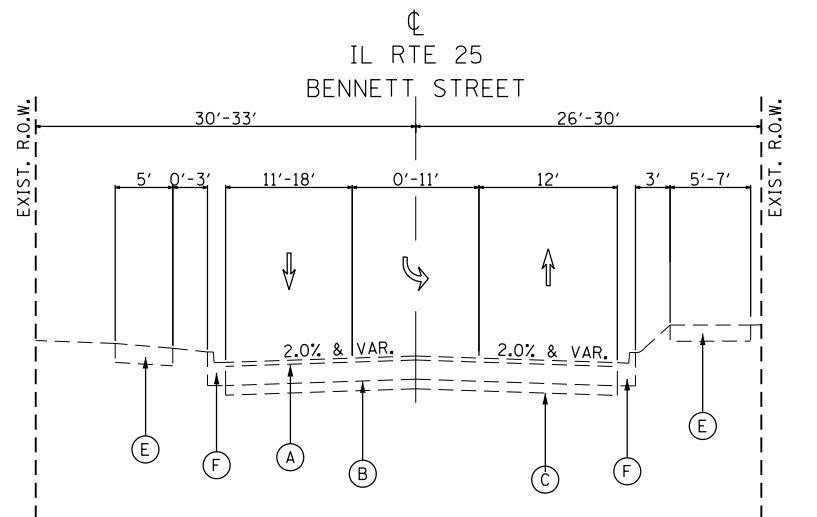


EXISTING TYPICAL SECTION
BENNETT STREET
STA 328+00.00 TO STA 331+68.95

1 - SIDEWALK BEGINS AT STA 325+58.50 LT
2 - SIDEWALK BEGINS AT STA 324+61.91 RT

- LEGEND
- (A) EXISTING HOT MIX-ASPHALT
 - (B) EXISTING CONCRETE
 - (C) EXISTING GRANULAR BASE
 - (D) EXISTING BRICK, COBBLESTONE, OR CONCRETE
 - (E) EXISTING 5" PCC SIDEWALK
 - (F) EXISTING CURB AND GUTTER
 - (G) EXISTING PARKWAY
 - (H) EXISTING PAVED DITCH

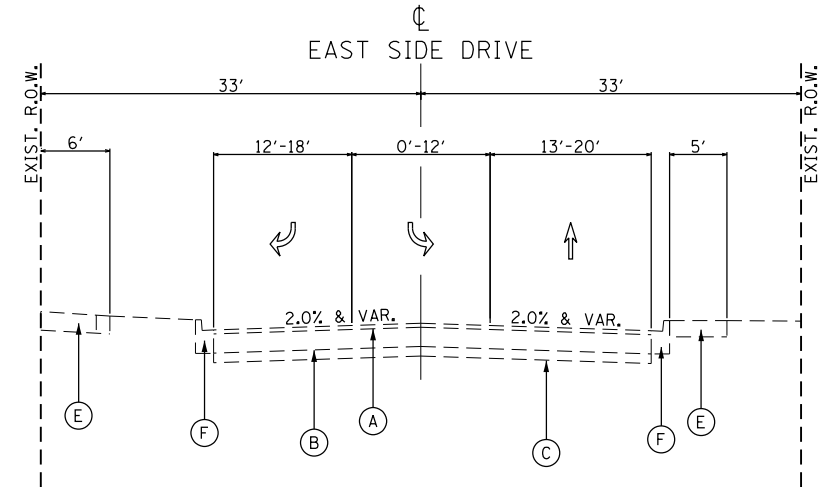

EXISTING TYPICAL SECTION
EAST SIDE DRIVE
STA 140+78.00 TO STA 146+36.93

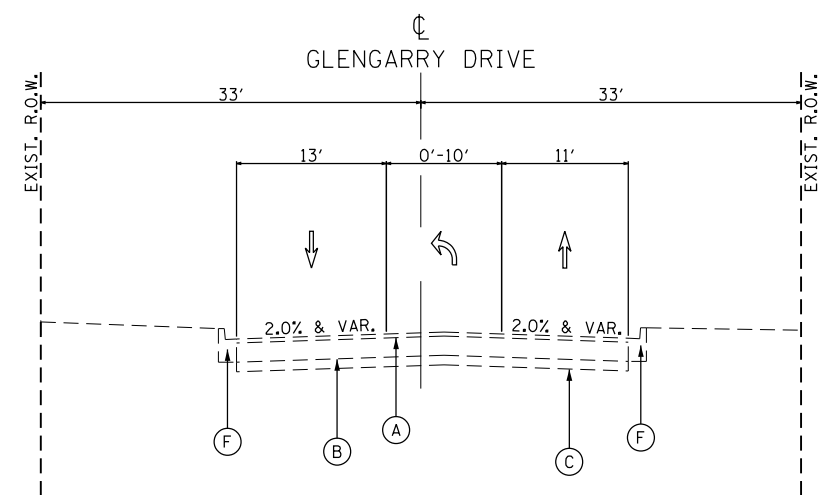

EXISTING TYPICAL SECTION
GLENGARRY DRIVE
STA 204+80.25 TO STA 208+85.32

FILE NAME = F:\961-000 Genevo East State St\CADD_Sheets\961-000_SHT_TYP_SEC.dgn









USER NAME = tnestor	DESIGNED - GJE	REVISED -
PLOT SCALE = 100.0000' / 1in.	DRAWN - GJE	REVISED -
PLOT DATE = 1/13/2025	CHECKED - DBB	REVISED -
	DATE - 11/7/2024	REVISED -

STATE OF ILLINOIS
DEPARTMENT OF TRANSPORTATION

ILLINOIS ROUTE 25 - BENNETT STREET & EAST SIDE DRIVE	
EXISTING TYPICAL SECTIONS	
SCALE: N.T.S.	SHEET 2 OF 6 SHEETS
STA.	TO STA.

F.A.U. RTE.	SECTION	COUNTY	TOTAL SHEETS	SHEET NO.
0347	05-00102-00-PV	KANE	488	31
			CONTRACT NO. 61J84	
ILLINOIS FED. AID PROJECT				

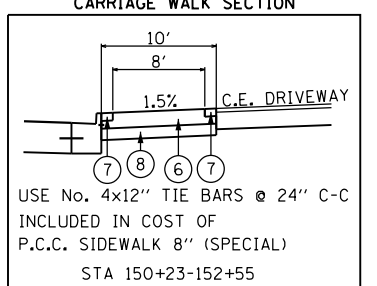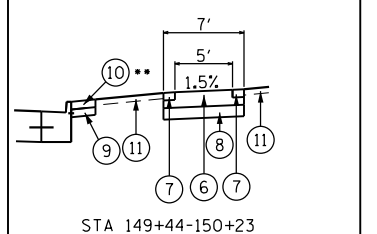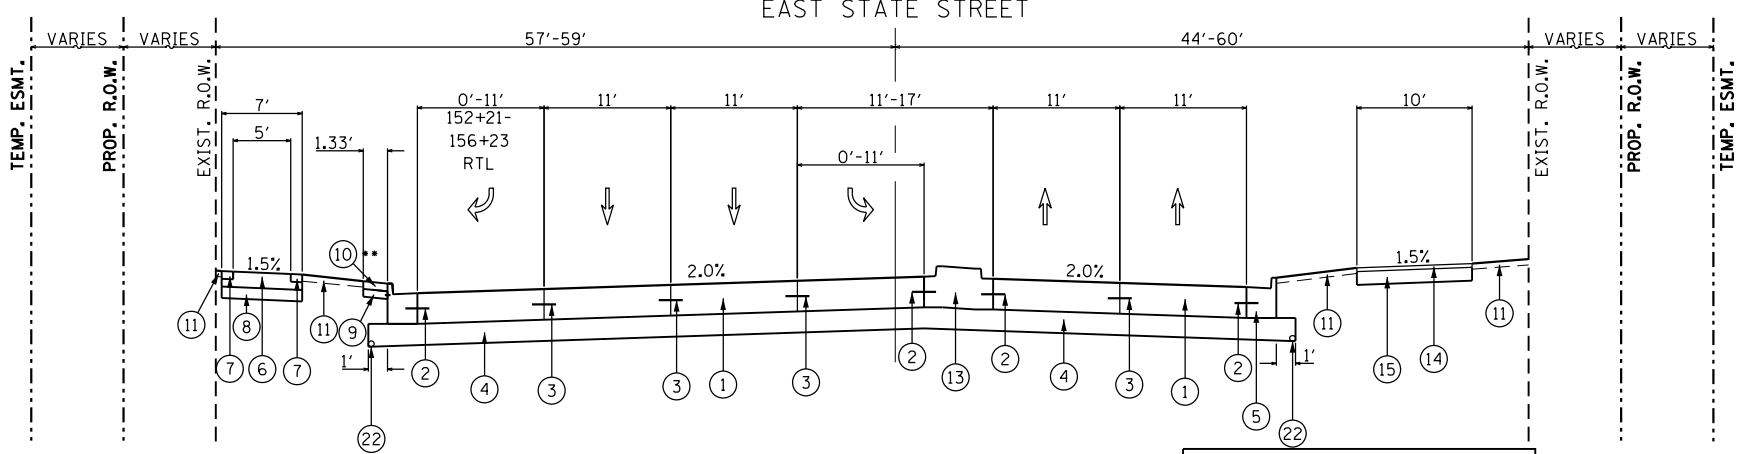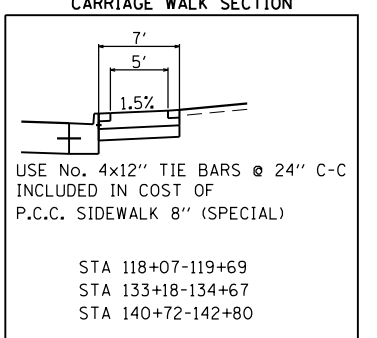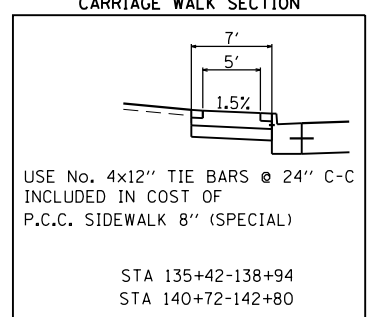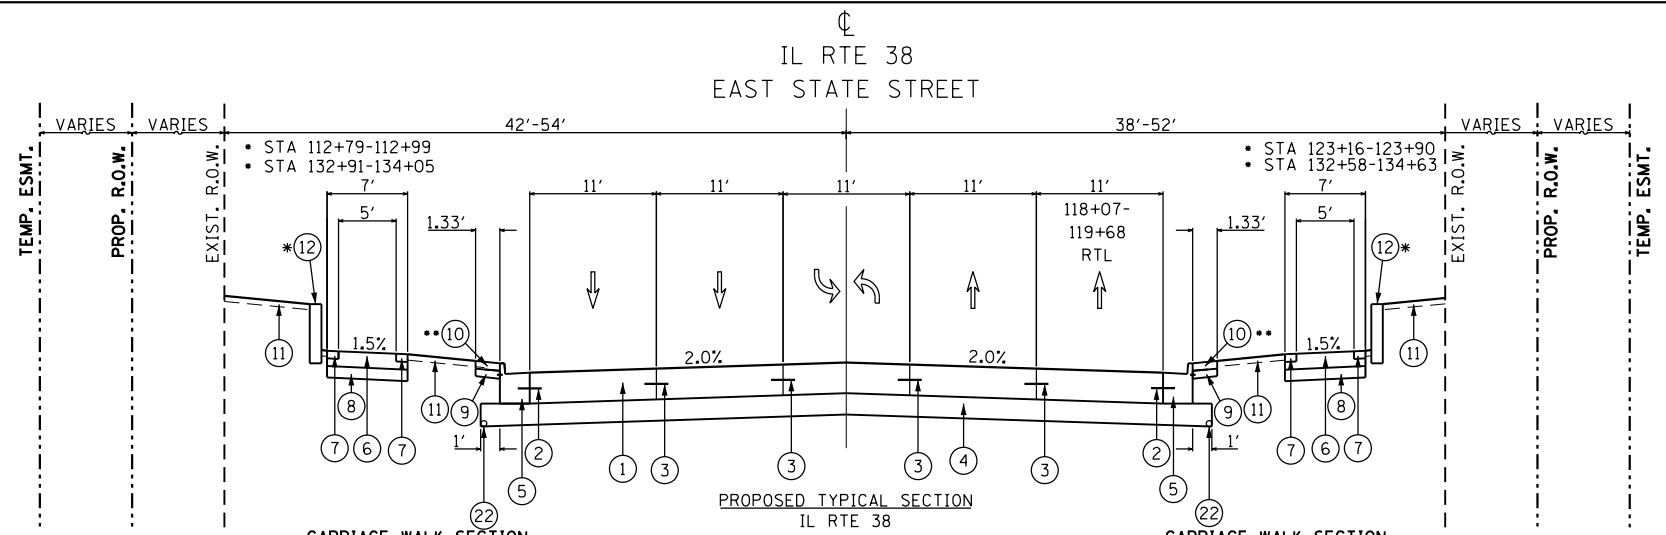

STRUCTURAL PAVEMENT DESIGN INFO BLOCK

STRUCTURAL DESIGN TRAFFIC:	Year	2029
PV = 35,661	SU = 1,534	MU = 1,150
ROAD/STREET CLASSIFICATION:	Class	1
PERCENT OF STRUCTURAL DESIGN TRAFFIC IN DESIGN LANE:		
P = 32%	S = 45%	M = 45%
TRAFFIC FACTOR:	Actual TF = 9.23	
	Minimum TF = 5.02	
SUBGRADE SUPPORT RATING:		
SSR = POOR	(Sta. 118+07 to 175+70)	

PROPOSED TYPICAL SECTION
 IL RTE 38
 EAST STATE STREET
 STA 146+86 TO STA 154+80

•• BANDING EDGE SECTION
 STA 148+86-150+80 LT
 STA 152+23-154+80 LT
 STA 149+44-150+23 RT

PROPOSED

- ① PORTLAND CEMENT CONCRETE PAVEMENT 10" (JOINTED)
- ② PROP. LONGITUDINAL CONSTRUCTION JOINT WITH NO. 6x24" EPOXY COATED TIE BARS @ 24" CENTERS
- ③ PROP. LONGITUDINAL SAWED JOINT WITH NO. 6x30" EPOXY COATED TIE BARS @ 30" CENTERS
- ④ AGGREGATE SUBGRADE IMPROVEMENTS, 12"
- ⑤ CONCRETE CURB & GUTTER, TYPE B-6.24
- ⑥ P.C.C. SIDEWALK, 8" (SPECIAL)
- ⑦ BRICK PAVER BANDING RUNNING BAND, 3 COURSES @ 4" EA
- ⑧ AGGREGATE BASE COURSE, TYPE B, 4"
- ⑨ PROP. P.C.C. BASE COURSE, 4" (FOR BANDING) WITH NO. 4x12" EPOXY COATED TIE BARS @ 24" CENTERS TIE BARS NOT PAID SEPARATELY BUT INCLUDED IN P.C.C. BASE COURSE 4"
- ⑩ BRICK PAVER BANDING RUNNING BAND, 4 COURSES @ 4" EA
- ⑪ TOPSOIL EXCAVATION AND PLACEMENT (4")
- ⑫ SEGMENTAL CONCRETE BLOCK RETAINING WALL SEE STRUCTURAL PLANS
- ⑬ PROP. CONCRETE MEDIAN TY SB-6.12
- ⑭ HOT-MIX ASPHALT SURFACE COURSE, MIX "D", N50, 3"
- ⑮ AGGREGATE BASE COURSE, TYPE B, 6"
- ⑯ P.C.C. SIDEWALK, 5"
- ⑰ CLASS D PATCHES, 8" (SEE PLANS)
- ⑱ HOT-MIX ASPHALT SURFACE COURSE, MIX "D", N70, 1.75"
- ⑲ POLYMERIZED HMA BINDER COURSE, IL-4.75, N50, 0.75"
- ⑳ HOT-MIX ASPHALT BASE COURSE, 7.75"
- ㉑ CONCRETE CURB & GUTTER, TYPE B-6.12
- ㉒ PIPE UNDERDRAINS TYPE 2, 4" (SEE PLANS FOR LOCATIONS)
- ㉓ TOPSOIL EXCAVATION AND PLACEMENT (24")

HMA MIXTURE REQUIREMENTS CHART			
MIXTURE TYPE	AIR VOIDS @ Ndes	THICKNESS	OMP
HMA RESURFACING (IL RTE 25/BENNETT STREET) HOT-MIX ASPHALT SURFACE COURSE, IL-9.5, MIX "D", N70 POLYMERIZED HOT-MIX ASPHALT BINDER COURSE, IL-4.75, N50	4% @ 70 GYR. 3.5% @ 50 GYR.	1.75" 0.75"	LR1030-2 LR1030-2
HMA RESURFACING (EAST SIDE DRIVE & GLENGARRY DRIVE) HOT-MIX ASPHALT SURFACE COURSE, IL-9.5, MIX "D", N70 POLYMERIZED HOT-MIX ASPHALT BINDER COURSE, IL-4.75, N50	4% @ 70 GYR. 3.5% @ 50 GYR.	1.75" 0.75"	LR1030-2 LR1030-2
HMA MULTI-USE PATH HOT-MIX ASPHALT SURFACE COURSE, IL-9.5, MIX "D", N50	4% @ 50 GYR.	3" (2 LIFTS)	LR1030-2
CLASS D PATCHES CLASS D PATCHES (HMA BINDER IL-19.0)	4% @ 70 GYR.		LR1030-2
CLASS D PATCHES, SPECIAL HOT-MIX ASPHALT SURFACE COURSE, IL-9.5, MIX "D", N70 HOT-MIX ASPHALT BINDER COURSE, IL-19.0, N70	4% @ 70 GYR. 4% @ 70 GYR.	2" 3",8"	LR1030-2 LR1030-2
HMA DRIVEWAY PAVEMENT 8" (P.E.) HOT-MIX ASPHALT SURFACE COURSE, IL-9.5, MIX "D", N50 HOT-MIX ASPHALT BASE COURSE (HMA BINDER IL-19.0)	4% @ 50 GYR. 4% @ 50 GYR.	2" 6"	LR1030-2 LR1030-2
HMA DRIVEWAY PAVEMENT 10" (C.E.) HOT-MIX ASPHALT SURFACE COURSE, IL-9.5, MIX "D", N50 HOT-MIX ASPHALT BASE COURSE (HMA BINDER IL-19.0)	4% @ 50 GYR. 4% @ 50 GYR.	2" 8"	LR1030-2 LR1030-2
HMA SHOULDERS 6" (FOR HMA STABILIZATION AT GUARDRAIL) HOT-MIX ASPHALT BINDER COURSE, IL-19.0, N70; 6"	4% @ 70 GYR.	6"	LR1030-2
TEMPORARY PAVEMENT HOT-MIX ASPHALT SURFACE COURSE, IL-9.5, MIX "D", N70 HMA BINDER COURSE, IL-19.0, N70	4% @ 70 GYR. 4% @ 70 GYR.	2" 8"	LR1030-2 LR1030-2
PAVEMENT WIDENING - (IL 25/BENNETT STREET) HOT-MIX ASPHALT SURFACE COURSE, IL-9.5, MIX "D", N70 POLYMERIZED HOT-MIX ASPHALT BINDER COURSE, IL-4.75, N50 HOT-MIX ASPHALT BASE COURSE WIDENING (HMA BINDER IL-19.0)	4% @ 70 GYR. 3.5% @ 50 GYR. 4% @ 70 GYR.	1.75" 0.75" 7.75"	LR1030-2 LR1030-2 LR1030-2

OMP DESIGNATIONS: QUALITY CONTROL/QUALITY ASSURANCE (QC/QA) AS PER LR1030-02

NOTES:
 THE UNIT WEIGHT USED TO CALCULATE ALL HOT MIX ASPHALT SURFACE MIXTURES IS 112 LBS/SO YD/IN.

THE "AC TYPE" FOR POLYMERIZED HMA MIXES SHALL BE "SBS/SBR PG 76-22 AND FOR NON-POLYMERIZED HMA THE "AC TYPE" SHALL BE "PG 64-22" UNLESS MODIFIED BY RECLAIMED MATERIALS SPECIFICATIONS.

THE LONGITUDINAL JOINT SEALANT SHALL BE PLACED ON POLYMERIZED HMA BINDER COURSE IL-4.75 N50.

TEMPORARY PAVEMENT SHALL BE EITHER 10" HOT-MIX ASPHALT OR 8" PORTLAND CEMENT CONCRETE AND IS CONTRACTOR OPTION. PORTLAND CEMENT CONCRETE TEMPORARY PAVEMENT SHALL CONSIST OF CLASS PV CONCRETE MEETING THE REQUIREMENTS OF ARTICLE 1020 OF THE STANDARD SPECIFICATIONS. TEMPORARY PCC PAVEMENT DOES NOT REQUIRE DOWEL BARS.

FILE NAME = F:\961-000 Genevo East State St.CADD.Sheets\961-000_SHT_TYP_SEC.dgn






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	DRAWN - GJE	REVISED -
PLOT SCALE = 100.0000' / in.	CHECKED - DBB	REVISED -
PLOT DATE = 1/13/2025	DATE - 11/7/2024	REVISED -

STATE OF ILLINOIS
DEPARTMENT OF TRANSPORTATION

ILLINOIS ROUTE 38 - EAST STATE STREET	
PROPOSED TYPICAL SECTIONS	
SCALE: N.T.S.	SHEET 3 OF 6 SHEETS STA. TO STA.

F.A.U. RTE.	SECTION	COUNTY	TOTAL SHEETS	SHEET NO.
0347	05-00102-00-PV	KANE	488	32
CONTRACT NO. 61J84				
ILLINOIS FED. AID PROJECT				

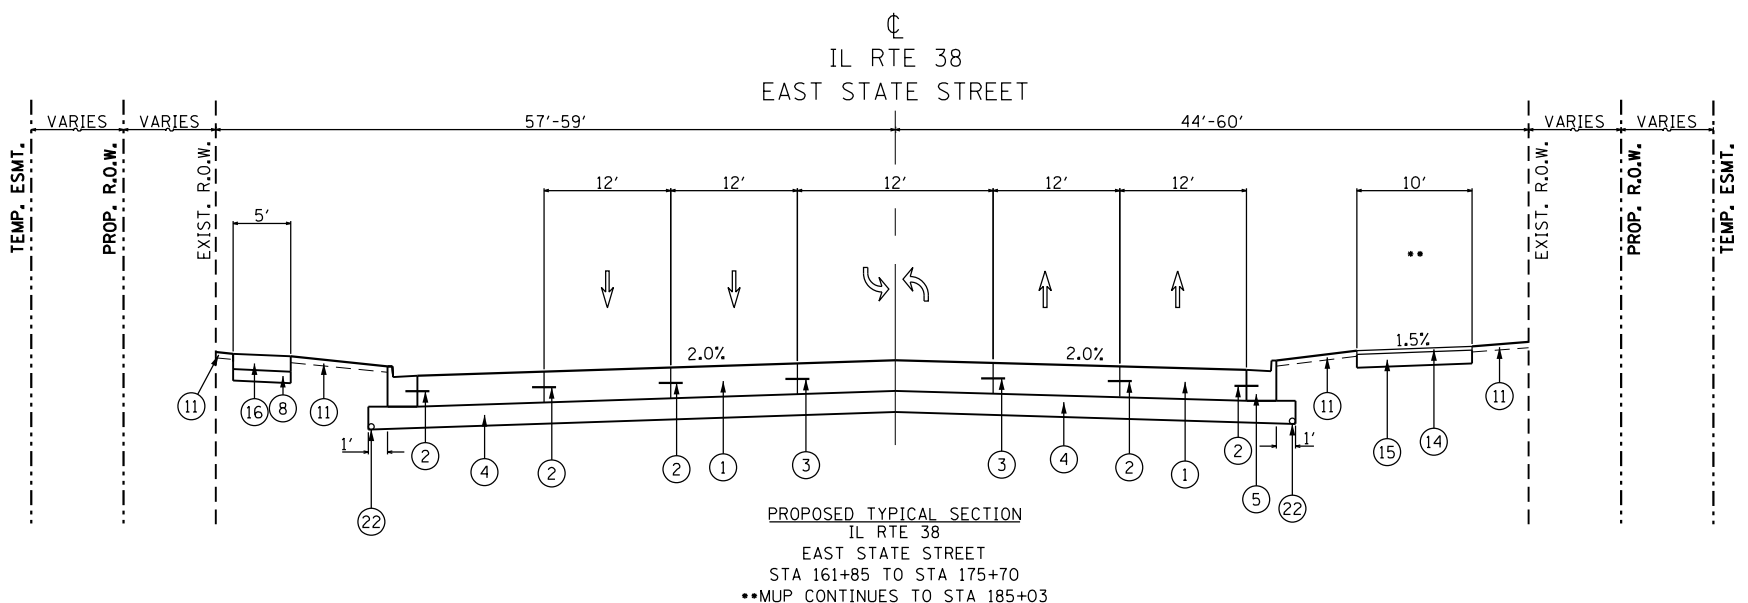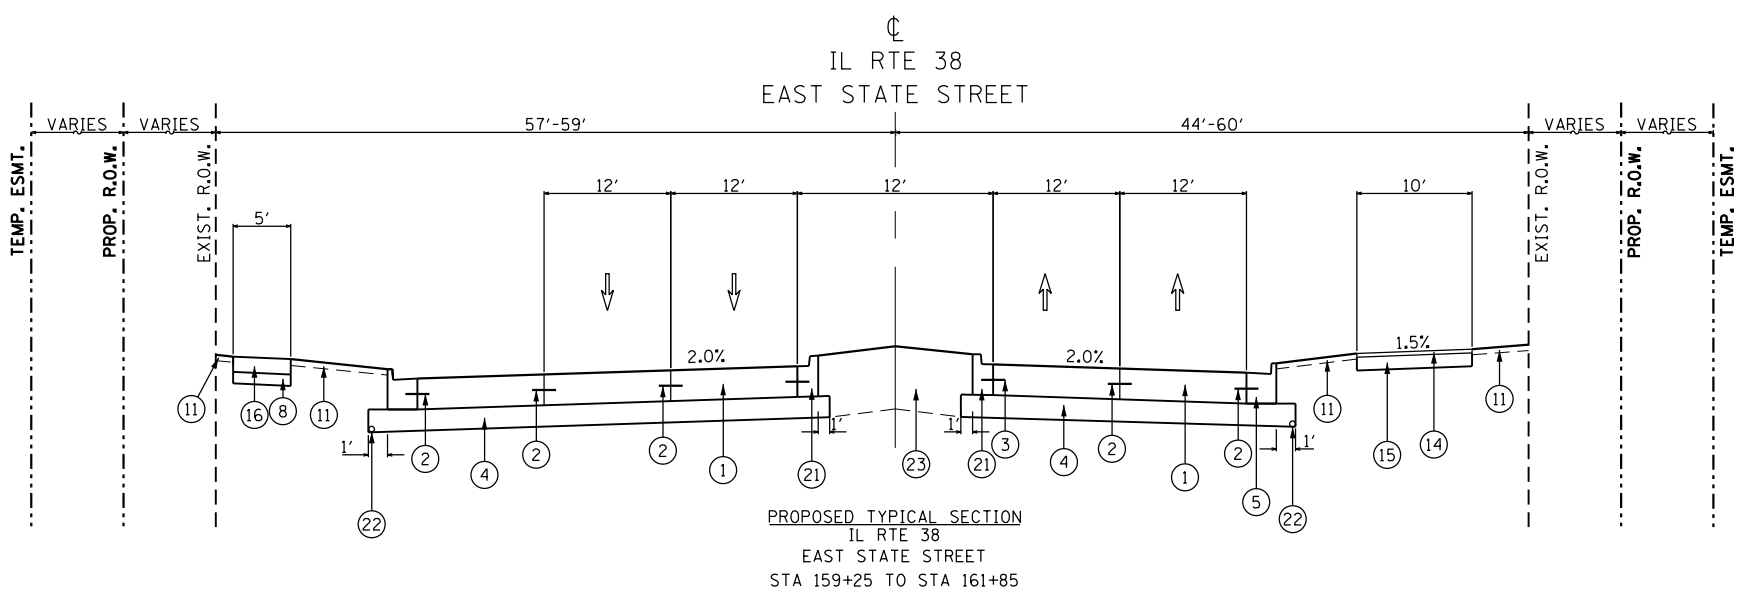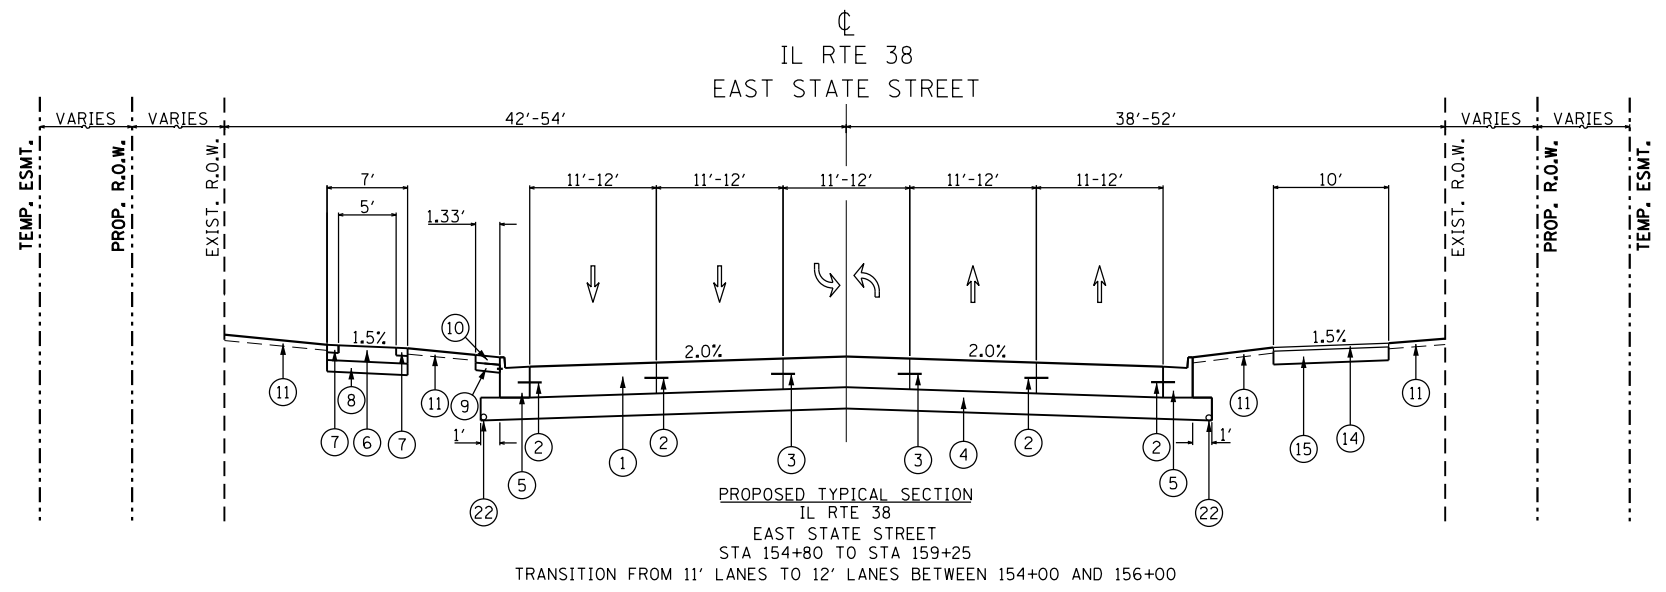

- PROPOSED**
- ① PORTLAND CEMENT CONCRETE PAVEMENT 10" (JOINTED)
 - ② PROP. LONGITUDINAL CONSTRUCTION JOINT WITH NO. 6x24" EPOXY COATED TIE BARS @ 24" CENTERS
 - ③ PROP. LONGITUDINAL SAWED JOINT WITH NO. 6x30" EPOXY COATED TIE BARS @ 30" CENTERS
 - ④ AGGREGATE SUBGRADE IMPROVEMENTS, 12"
 - ⑤ CONCRETE CURB & GUTTER, TYPE B-6.24
 - ⑥ P.C.C. SIDEWALK, 8" (SPECIAL)
 - ⑦ BRICK PAVER BANDING RUNNING BAND, 3 COURSES @ 4" EA
 - ⑧ AGGREGATE BASE COURSE, TYPE B, 4"
 - ⑨ PROP. P.C.C. BASE COURSE, 4" (FOR BANDING) WITH NO. 4x12" EPOXY COATED TIE BARS @ 24" CENTERS TIE BARS NOT PAID SEPARATELY BUT INCLUDED IN P.C.C. BASE COURSE 4"
 - ⑩ BRICK PAVER BANDING RUNNING BAND, 4 COURSES @ 4" EA
 - ⑪ TOPSOIL EXCAVATION AND PLACEMENT (4")
 - ⑫ SEGMENTAL CONCRETE BLOCK RETAINING WALL SEE STRUCTURAL PLANS
 - ⑬ PROP. CONCRETE MEDIAN TY SB-6.12
 - ⑭ HOT-MIX ASPHALT SURFACE COURSE, MIX "D", N50, 3"
 - ⑮ AGGREGATE BASE COURSE, TYPE B, 6"
 - ⑯ P.C.C. SIDEWALK, 5"
 - ⑰ CLASS D PATCHES, 8" (SEE PLANS)
 - ⑱ HOT-MIX ASPHALT SURFACE COURSE, MIX "D", N70, 1.75"
 - ⑲ POLYMERIZED HMA BINDER COURSE, IL-4.75, N50, 0.75"
 - ⑳ HOT-MIX ASPHALT BASE COURSE, 7.75"
 - ㉑ CONCRETE CURB & GUTTER, TYPE B-6.12
 - ㉒ PIPE UNDERDRAINS TYPE 2, 4" (SEE PLANS FOR LOCATIONS)
 - ㉓ TOPSOIL EXCAVATION AND PLACEMENT (24")

FILE NAME = F:\961-000 Genevo East State St.CADD.Sheets\961-000_SHT_TYP_SEC.dgn




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PLOT SCALE = 100.0000' / in.	DRAWN - GJE	REVISED -
PLOT DATE = 1/13/2025	CHECKED - DBB	REVISED -
	DATE - 11/7/2024	REVISED -


**STATE OF ILLINOIS
DEPARTMENT OF TRANSPORTATION**

ILLINOIS ROUTE 38 - EAST STATE STREET	
PROPOSED TYPICAL SECTIONS	
SCALE: N.T.S.	SHEET 4 OF 6 SHEETS
STA.	TO STA.


F.A.U. RTE.	SECTION	COUNTY	TOTAL SHEETS	SHEET NO.
0347	05-00102-00-PV	KANE	488	33
CONTRACT NO. 61J84				
ILLINOIS FED. AID PROJECT				

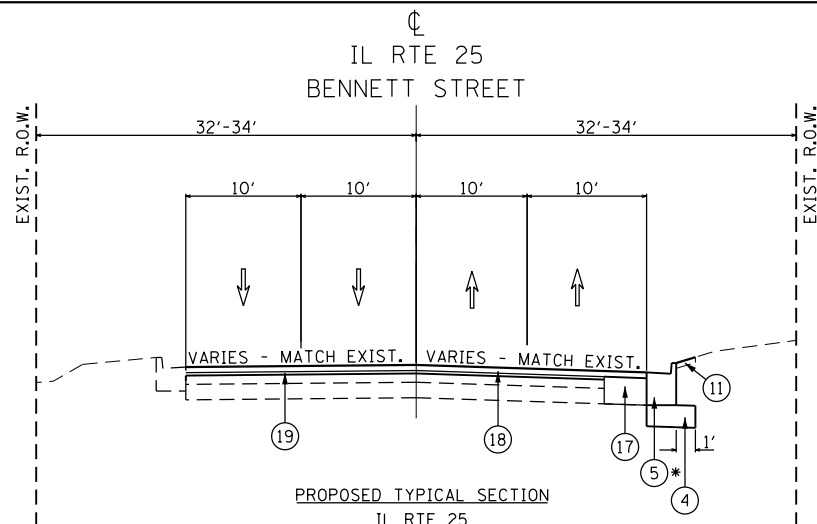


PROPOSED TYPICAL SECTION
IL RTE 25
BENNETT STREET
STA 321+70.00 TO STA 324+17
• BEGIN CURB REPLACEMENT STA 322+50 RT

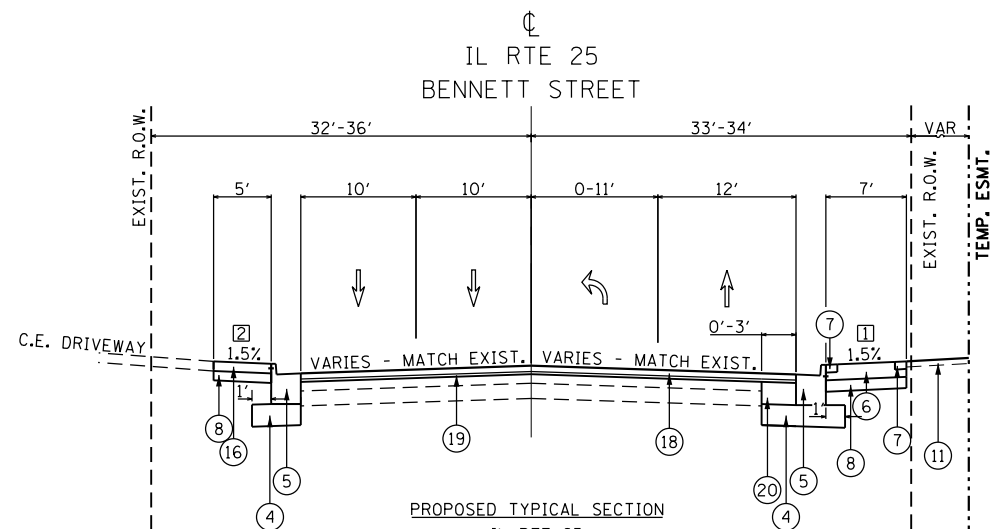

PROPOSED TYPICAL SECTION
IL RTE 25
BENNETT STREET
STA 324+17.39 TO STA 326+77.24
END WIDENING AND RESURFACING STA 326+77.24
USE No. 4x12" TIE BARS @ 24" C-C INCLUDED IN COST OF P.C.C. SIDEWALK 5"
USE No. 4x12" TIE BARS @ 24" C-C INCLUDED IN COST OF P.C.C. SIDEWALK 8" (SPECIAL)
11 - SIDEWALK IMPROVEMENTS STA 324+62 TO STA 326+77 RT
12 - SIDEWALK IMPROVEMENTS STA 325+32 TO STA 326+77 LT

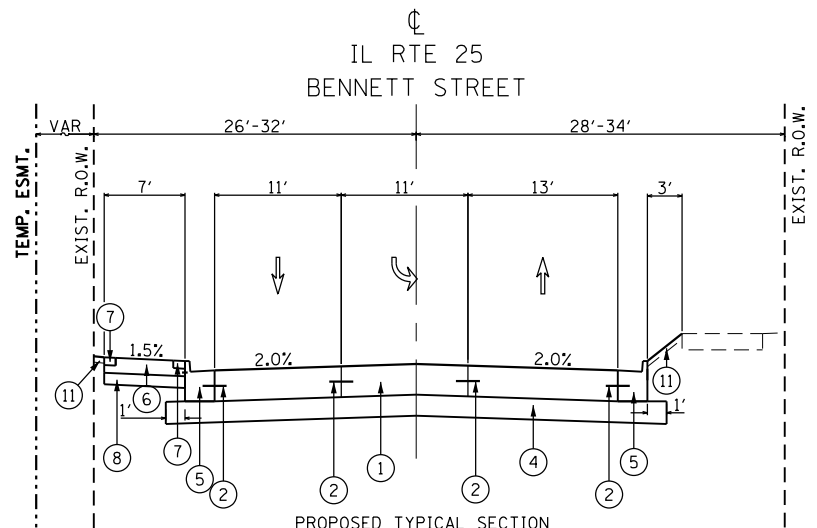

PROPOSED TYPICAL SECTION
IL RTE 25
BENNETT STREET
STA 328+00.00 TO STA 328+83.65
END RECONSTRUCTION STA 328+83.65
USE No. 4x12" TIE BARS @ 24" C-C INCLUDED IN COST OF P.C.C. SIDEWALK 8" (SPECIAL)

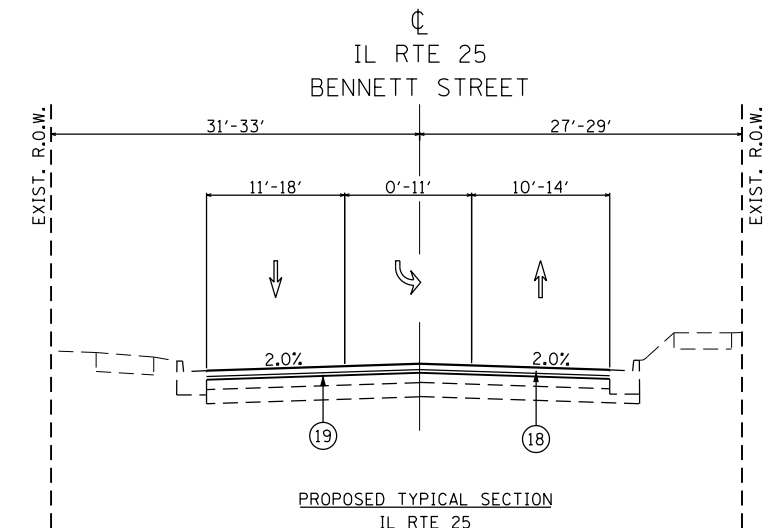

PROPOSED TYPICAL SECTION
IL RTE 25
BENNETT STREET
STA 328+83.65 TO STA 331+68.95
END RESURFACING STA 332+05.76

- PROPOSED
- 1 PORTLAND CEMENT CONCRETE PAVEMENT 10" (JOINTED)
 - 2 PROP. LONGITUDINAL CONSTRUCTION JOINT WITH NO. 6x24" EPOXY COATED TIE BARS @ 24" CENTERS
 - 3 PROP. LONGITUDINAL SAWED JOINT WITH NO. 6x30" EPOXY COATED TIE BARS @ 30" CENTERS
 - 4 AGGREGATE SUBGRADE IMPROVEMENTS, 12"
 - 5 CONCRETE CURB & GUTTER, TYPE B-6.24
 - 6 P.C.C. SIDEWALK, 8" (SPECIAL)
 - 7 BRICK PAVER BANDING RUNNING BAND, 3 COURSES @ 4" EA
 - 8 AGGREGATE BASE COURSE, TYPE B, 4"
 - 9 PROP. P.C.C. BASE COURSE, 4" (FOR BANDING) WITH NO. 4x12" EPOXY COATED TIE BARS @ 24" CENTERS TIE BARS NOT PAID SEPARATELY BUT INCLUDED IN P.C.C. BASE COURSE 4"
 - 10 BRICK PAVER BANDING RUNNING BAND, 4 COURSES @ 4" EA
 - 11 TOPSOIL EXCAVATION AND PLACEMENT (4")
 - 12 SEGMENTAL CONCRETE BLOCK RETAINING WALL SEE STRUCTURAL PLANS
 - 13 PROP. CONCRETE MEDIAN TY SB-6.12
 - 14 HOT-MIX ASPHALT SURFACE COURSE, MIX "D", N50, 3"
 - 15 AGGREGATE BASE COURSE, TYPE B, 6"
 - 16 P.C.C. SIDEWALK, 5"
 - 17 CLASS D PATCHES, 8" (SEE PLANS)
 - 18 HOT-MIX ASPHALT SURFACE COURSE, MIX "D", N70, 1.75"
 - 19 POLYMERIZED HMA BINDER COURSE, IL-4.75, N50, 0.75"
 - 20 HOT-MIX ASPHALT BASE COURSE, 7.75"
 - 21 CONCRETE CURB & GUTTER, TYPE B-6.12
 - 22 PIPE UNDERDRAINS TYPE 2, 4" (SEE PLANS FOR LOCATIONS)
 - 23 TOPSOIL EXCAVATION AND PLACEMENT (24")

FILE NAME = F:\961-000 Genevo East State St\CADD_Sheets\961-000_SHT_TYP_SEC.dgn






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PLOT DATE = 1/13/2025	DATE - 11/7/2024	REVISED -

STATE OF ILLINOIS
DEPARTMENT OF TRANSPORTATION

ILLINOIS ROUTE 25 - BENNETT STREET	
PROPOSED TYPICAL SECTIONS	
SCALE: N.T.S.	SHEET 5 OF 6 SHEETS
STA.	TO STA.

F.A.U. RTE.	SECTION	COUNTY	TOTAL SHEETS	SHEET NO.
0347	05-00102-00-PV	KANE	488	34
CONTRACT NO. 61J84				
ILLINOIS FED. AID PROJECT				

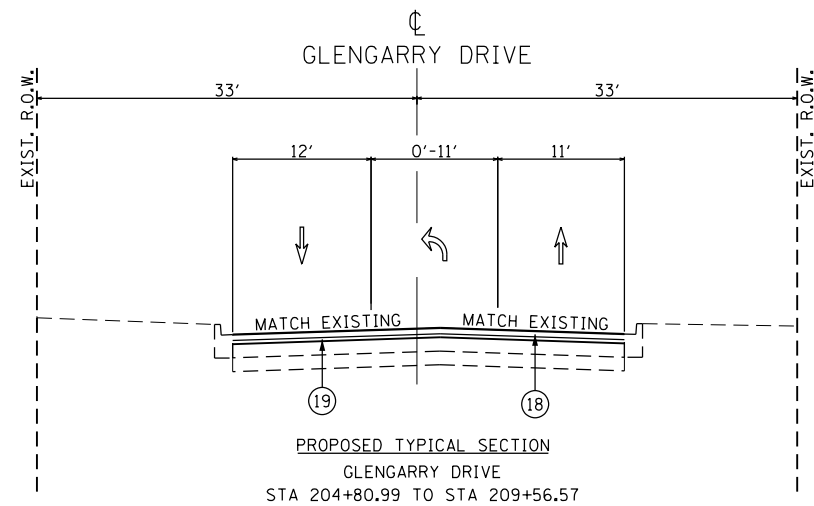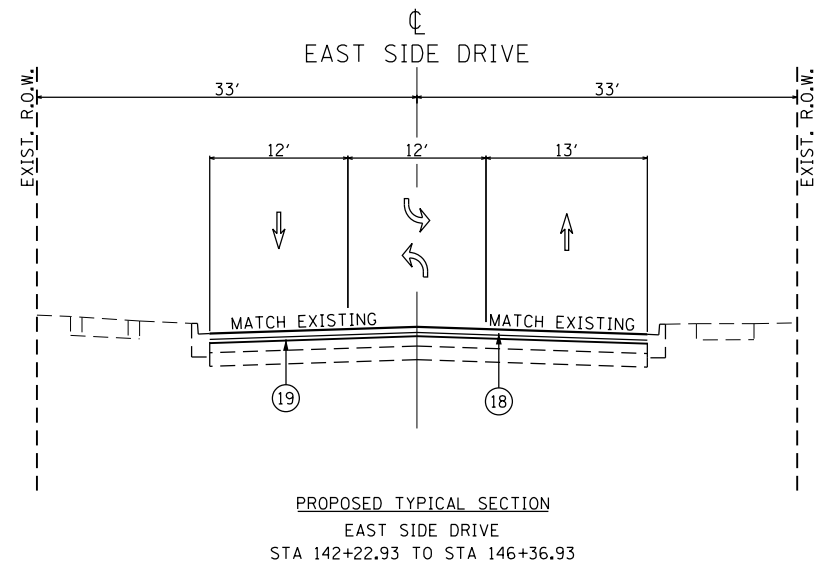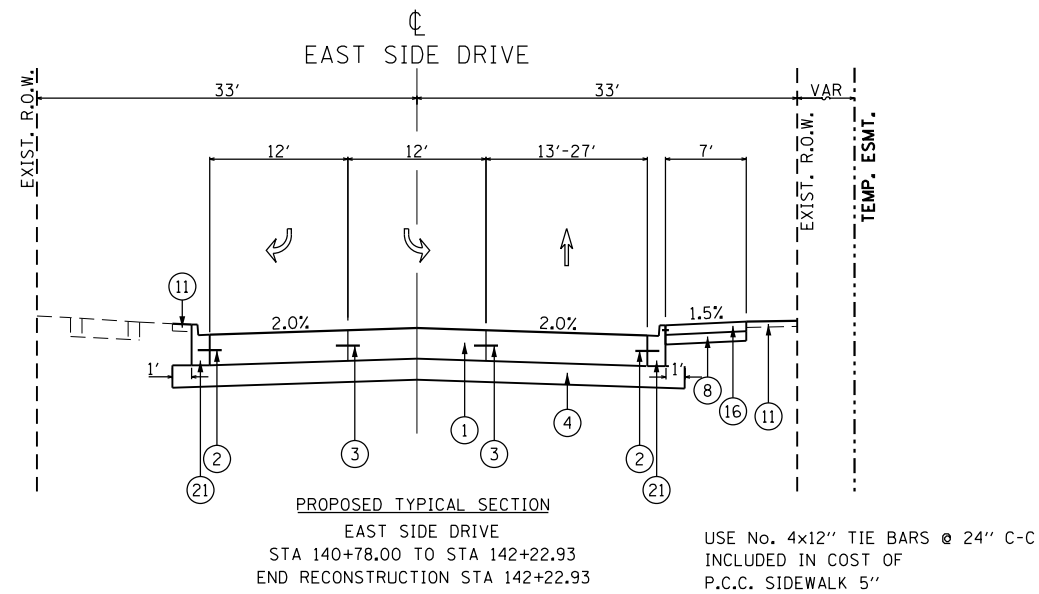

PROPOSED

- ① PORTLAND CEMENT CONCRETE PAVEMENT 10" (JOINTED)
- ② PROP. LONGITUDINAL CONSTRUCTION JOINT WITH NO. 6x24" EPOXY COATED TIE BARS @ 24" CENTERS
- ③ PROP. LONGITUDINAL SAWED JOINT WITH NO. 6x30" EPOXY COATED TIE BARS @ 30" CENTERS
- ④ AGGREGATE SUBGRADE IMPROVEMENTS, 12"
- ⑤ CONCRETE CURB & GUTTER, TYPE B-6.24
- ⑥ P.C.C. SIDEWALK, 8" (SPECIAL)
- ⑦ BRICK PAVER BANDING RUNNING BAND, 3 COURSES @ 4" EA
- ⑧ AGGREGATE BASE COURSE, TYPE B, 4"
- ⑨ PROP. P.C.C. BASE COURSE, 4" (FOR BANDING) WITH NO. 4x12" EPOXY COATED TIE BARS @ 24" CENTERS TIE BARS NOT PAID SEPARATELY BUT INCLUDED IN P.C.C. BASE COURSE 4"
- ⑩ BRICK PAVER BANDING RUNNING BAND, 4 COURSES @ 4" EA
- ⑪ TOPSOIL EXCAVATION AND PLACEMENT (4")
- ⑫ SEGMENTAL CONCRETE BLOCK RETAINING WALL SEE STRUCTURAL PLANS
- ⑬ PROP. CONCRETE MEDIAN TY SB-6.12
- ⑭ HOT-MIX ASPHALT SURFACE COURSE, MIX "D", N50, 3"
- ⑮ AGGREGATE BASE COURSE, TYPE B, 6"
- ⑯ P.C.C. SIDEWALK, 5"
- ⑰ CLASS D PATCHES, 8" (SEE PLANS)
- ⑱ HOT-MIX ASPHALT SURFACE COURSE, MIX "D", N70, 1.75"
- ⑲ POLYMERIZED HMA BINDER COURSE, IL-4.75, N50, 0.75"
- ⑳ HOT-MIX ASPHALT BASE COURSE, 7.75"
- ㉑ CONCRETE CURB & GUTTER, TYPE B-6.12
- ㉒ PIPE UNDERDRAINS TYPE 2, 4" (SEE PLANS FOR LOCATIONS)
- ㉓ TOPSOIL EXCAVATION AND PLACEMENT (24")

FILE NAME = F:\961-000 Genevo East State St\CADD_Sheets\961-000_SHT_TYP_SEC.dgn



USER NAME = tnestor	DESIGNED - GJE	REVISED -
PLOT SCALE = 100.0000' / 1in.	DRAWN - GJE	REVISED -
PLOT DATE = 1/13/2025	CHECKED - DBB	REVISED -
	DATE - 11/7/2024	REVISED -

STATE OF ILLINOIS
DEPARTMENT OF TRANSPORTATION

EAST SIDE DRIVE AND GLENGARRY DRIVE
PROPOSED TYPICAL SECTIONS

SCALE: N.T.S. SHEET 6 OF 6 SHEETS STA. TO STA.

F.A.U. RTE.	SECTION	COUNTY	TOTAL SHEETS	SHEET NO.
0347	05-00102-00-PV	KANE	488	35
ILLINOIS FED. AID PROJECT			CONTRACT NO. 61J84	

LOCATION STATION-STATION	AGGREGATE SUBGRADE IMPROVEMENT, 12" (SQ YD)	AGGREGATE SUBGRADE IMPROVEMENT (CU YD)	PORTLAND CEMENT CONC. PAVEMENT (JOINTED), 10" (SQ YD)	PAVEMENT CONNECTOR (PCC) FOR BRIDGE APPR. SLAB (SQ YD)	PCC BASE COURSE 4" (SQ YD)	HMA SURFACE COURSE, IL-9.5, MIX "D" N70 (TON)	HMA SURFACE COURSE, IL-9.5, MIX "D" N50 (TON)	POLYMERIZED HMA BINDER COURSE, IL-4.75, N50 (TON)	HMA BASE COURSE WIDENING (HMA BINDER IL-19.0), 7.75" (SQ YD)	AGGREGATE BASE COURSE 4" (SQ YD)	AGGREGATE BASE COURSE 6" (SQ YD)
EAST STATE ST.											
118+06.93-119+00	815	272	733	95						122	
119+00-125+00	4927	291	4426							936	
125+00-131+00	4508		4012							865	
131+00-137+00	4562	231	4059							909	
137+00-143+00	4392	231	3887		45					920	
143+00-148+00	3681	652	3258		48					742	
148+00-154+00	5570	2063	5078		59					927	129
154+00-160+00	5098	1540	4545		49			22		515	542
160+00-166+00	4349	499	3765					91		388	523
166+00-171+00	3732		3334					88		404	378
171+00-177+00	4377	498	3334					64		336	447
177+00-183+00			3959					76			650
183+00-185+01.77								110		11	225
BENNETT ST.											
321+70-323+00						72		30			
323+00-326+77.24	325		14			173		73	114	252	
328+83.65-332+05.76	398		330			121		51		114	
EAST SIDE DR.											
140+78-146+36.93	736		649			171		72		65	
GLENGARRY DR.											
204+80.25-206+85.22						76		32		50	
208+71.49-209+56.57						29		13		34	
TOTAL	47470	6277	45383	95	201	642	489	271	114	7590	2894

LOCATION STATION-STATION	HMA DRIVEWAY PAVEMENT 8" (SQ YD)	HMA DRIVEWAY PAVEMENT 10" (SQ YD)	PCC DRIVEWAY PAVEMENT 8" (SQ YD)
EAST STATE ST.			
118+06.93-119+00		12	
119+00-125+00	227	149	11
125+00-131+00	50	129	31
131+00-137+00		90	
137+00-143+00	13	329	
143+00-148+00	16	291	84
148+00-154+00		494	
154+00-160+00		292	
160+00-166+00		62	
166+00-171+00		293	
171+00-177+00	84		
177+00-183+00	49		
183+00-185+01.77			
BENNETT ST.			
321+70-323+00			
323+00-326+77.24		231	
328+83.65-332+05.76			
EAST SIDE DR.			
140+78-146+36.93		39	
GLENGARRY DR.			
204+80.25-206+85.22		40	
208+71.49-209+56.57			
TOTAL	439	2451	126

LOCATION STATION-STATION	PCC SIDEWALK 5" (SQ FT)	PCC SIDEWALK 8" (SPECIAL) (SQ FT)	BRICK PAVERS (SQ FT)
EAST STATE ST.			
118+06.93-119+00	460	625	185
119+00-125+00	2320	6100	1815
125+00-131+00	1660	6120	2125
131+00-137+00	1820	6350	2315
137+00-143+00	1250	6620	2280
143+00-148+00	2190	4050	1790
148+00-154+00	2720	5080	2110
154+00-160+00	1490	2700	1220
160+00-166+00	3645		
166+00-171+00	3630		
171+00-177+00	3020		
177+00-183+00			
183+00-185+01.77	130		
BENNETT ST.			
321+70-323+00			
323+00-326+77.24	1190	1065	280
328+83.65-332+05.76		1020	220
EAST SIDE DR.			
140+78-146+36.93	585		
GLENGARRY DR.			
204+80.25-206+85.22	298		
208+71.49-209+56.57			
WATER ST.			
10+60-14+50	445		
TOTAL	26853	39730	14340

LOCATION STATION-STATION	CONC. CURB & GUTTER TYPE B-6.24 (FOOT)	CONC. CURB & GUTTER TYPE B-6.12 (FOOT)	CONC. CURB TYPE B (FOOT)	CONC. MEDIAN SFC 4" (SQ FT)	CONC. MEDIAN TY B-6.12 (SQ FT)
EAST STATE ST.					
118+06.93-119+00	191		66		
119+00-125+00	1200	124	383		
125+00-131+00	1181	56	355		
131+00-137+00	1262	64	226		
137+00-143+00	1212	20	610		
143+00-148+00	1069	38	474		
148+00-154+00	1215	636	397	124	2994
154+00-160+00	1202	743	238	331	
160+00-166+00	1200		114		
166+00-171+00	1001	85	191	160	
171+00-177+00	830		225		
177+00-183+00	44		36		
183+00-185+01.77	20				
BENNETT ST.					
321+70-323+00	51				
323+00-326+77.24	642				
328+83.65-332+05.76	194				
EAST SIDE DR.					
140+78-146+36.93					
GLENGARRY DR.					
204+80.25-206+85.22		245			
208+71.49-209+56.57					
WATER ST.					
10+60-14+50		133			
TOTAL	12514	2144	3315	615	2994

4" RESPREAD AREAS							
	STATION	STATION	AREA (SF)	SODDING (SY)	THICK (FT)	VOL (CF)	VOL (CY)
EAST STATE ST							
	112+00	119+00	978	109	0.33	323	12
	119+00	125+00	10711	1190	0.33	3535	131
	125+00	131+00	12420	1380	0.33	4099	152
	131+00	137+00	9690	1077	0.33	3198	118
	137+00	143+00	6480	720	0.33	2138	79
	143+00	148+00	3550	394	0.33	1172	43
	148+00	154+00	12000	1333	0.33	3960	147
	154+00	160+00	22040	2449	0.33	7273	269
	160+00	166+00	15790	1754	0.33	5211	193
	166+00	171+00	9150	1017	0.33	3020	112
	171+00	177+00	13625	1514	0.33	4496	167
	177+00	183+00	8325	925	0.33	2747	102
	183+00	186+00	3050	339	0.33	1007	37
BENNETT ST							
	321+00	323+00	480	53	0.33	158	6
	323+00	326+80	2180	242	0.33	719	27
	328+00	334+00	385	43	0.33	127	5
EAST SIDE DR							
	140+80	147+00	1800	200	0.33	594	22
GLENGARRY DR							
	205+00	206+85	2200	244	0.33	726	27
	208+70	210+00	875	97	0.33	289	11
WATER ST							
	10+60	14+60	720	80	0.33	238	9
24" RESPREAD AREAS							
	STATION	STATION	AREA (SF)	THICK (FT)	VOL (CF)		
MEDIAN							
	159+34	161+83	2110	234	2.0	4220	156
TOTAL			TOTAL	15395		TOTAL	1824

FILE NAME = FA\961-000 Genevo East State St.CADD.Sheets\961-000_SHT_SCHEDULE OF QUANTITIES.dgn



USER NAME = tnestor	DESIGNED - GJE	REVISED -
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PLOT SCALE = 48.0000' / in.	CHECKED - DBB	REVISED -
PLOT DATE = 1/13/2025	DATE - 11/7/2024	REVISED -

**STATE OF ILLINOIS
DEPARTMENT OF TRANSPORTATION**

**ILLINOIS ROUTE 38 - EAST STATE STREET
SCHEDULE OF QUANTITIES**

SCALE: SHEET 1 OF 24 SHEETS STA. TO STA.

F.A.U. RTE.	SECTION	COUNTY	TOTAL SHEETS	SHEET NO.
0347	05-00102-00-PV	KANE	488	36
CONTRACT NO. 61J84				
ILLINOIS FED. AID PROJECT				

FILE NAME = FA\961-000 Genevo East State St.CADD.Sheets\961-000_SHT_SCHEDULE OF QUANTITIES.dgn

TEMPORARY ACCESS (COMMERCIAL ENTRANCE)		
STATION	OFFSET	EACH
EAST STATE STREET		
121+20.90	RT	1
121+69.88	RT	1
121+85.26	LT	1
125+55.07	LT	1
125+71.73	RT	1
127+25.85	RT	1
129+81.61	RT	1
130+91.43	RT	1
132+45.25	LT	1
132+82.35	LT	1
135+92.22	LT	1
139+60.36	RT	1
140+45.24	LT	1
141+99.04	RT	1
142+54.08	RT	1
143+03.35	LT	1
143+75.89	LT	1
144+98.88	RT	1
145+41.34	LT	1
145+91.54	RT	1
145+94.53	LT	1
146+41.29	LT	1
146+91.53	LT	1
146+96.47	RT	1
147+28.75	LT	1
147+45.62	RT	1
147+86.49	LT	1
148+56.09	LT	1
150+48.90	RT	1
151+39.75	RT	1
152+70.75	RT	1
153+04.22	LT	1
154+07.78	LT	1
157+40.13	LT	1
162+06.48	RT	1
166+14.02	RT	1
166+14.68	LT	1
169+39.78	RT	1
BENNETT STREET		
324+49.54	RT	1
325+46.41	LT	1
325+46.79	RT	1
325+93.10	RT	1
326+21.91	LT	1
EAST SIDE DRIVE		
141+35.27	RT	1
141+86.95	RT	1
TOTAL		45

TEMPORARY ACCESS (PRIVATE ENTRANCE)		
STATION	OFFSET	EACH
EAST STATE STREET		
121+20.90	LT	1
123+15.75	RT	1
124+12.57	LT	1
128+26.22	LT	1
128+85.51	LT	1
141+57.64	RT	1
141+60.39	LT	1
144+97.76	LT	1
TOTAL		8

TEMPORARY ACCESS (WINTERIZE)				
STATION	QUANTITY (SY)	QUANTITY (SY)	QUANTITY (SY)	QUANTITY (SY)
EAST STATE ST.				
118+06.93-119+00		12		
119+00-125+00	227	149	11	
125+00-131+00	50	129	31	
131+00-137+00		90		
137+00-143+00	13	329		
143+00-148+00	16	291	84	
148+00-154+00		494		
154+00-160+00		292		
160+00-166+00		62		
166+00-171+00		293		
171+00-177+00	84			
177+00-183+00	49			
183+00-185+01.77				
BENNETT ST.				
321+70-323+00				
323+00-326+77.24		231		
328+83.65-332+05.76				
EAST SIDE DR.				
140+78-146+36.93		39		
GLENGARRY DR.				
204+80.25-206+85.22		40		
208+71.49-209+56.57				
SUBTOTAL	439	2451	126	
TOTAL		3016		

TEMPORARY ACCESS (ROAD)				
STREET	STATION	OFFSET	EACH	
EAST STATE STREET				
WATER ST	118+60.14	LT	1	
CRISSEY AVE	124+07.33	RT	1	
GARFIELD ST	127+10.49	LT	1	
KANE ST	128+65.93	RT	1	
SCHOOL ST	130+64.85	LT	1	
NEBRASKA ST	132+26.05	RT	1	
WOODLAWN ST	134+26.66	LT	1	
KANSAS ST	135+51.70	RT	1	
HARRISON ST	139+11.58	LT	1	
SANDHOLM ST	143+88.20	RT	1	
SIMPSON ST	149+19.73	RT	1	
BRIAR LANE	157+16.83	RT	1	
RIDGE LANE	157+56.05	RT	1	
LONG VIEW DR	159+02.49	LT	1	
GLENGARRY DR	171+80.26	LT	1	
GLENGARRY DR	171+80.26	RT	1	
TOTAL			16	

LOCATION STATION-STATION	REMOVING MANHOLES (EACH)	REMOVING CATCH BASINS (EACH)	REMOVING INLETS (EACH)	FIRE HYDRANTS TO BE REMOVED (EACH)	VALVE BOX TO BE REMOVED (EACH)	VALVE VAULTS TO BE ABANDONED (EACH)
EAST STATE ST.						
118+06.93-119+00	2	3		1		2
119+00-125+00	7	6	4	2		5
125+00-131+00	6	1	4	3		3
131+00-137+00	5	1	7	4	1	4
137+00-143+00	3	1	3	1		3
143+00-148+00	3	1	5	2		1
148+00-154+00	3	1	4	1		5
154+00-160+00	8	3	9	2		1
160+00-166+00	2	2	4			
166+00-171+00	1	1	6			
171+00-177+00	8	2	9			
177+00-183+00						
183+00-185+01.77						
BENNETT ST.						
321+00-326+80		2				
WATER ST.						
10+60-14+20	1		1			
TOTAL	49	24	56	16	1	24

LOCATION STATION-STATION	CLASS D PATCHES (SQ YD)	CLASS D PATCHES SPECIAL (SQ YD)	CLASS B PATCHES (SPECIAL) (SQ YD)
THICKNESS			
	8 IN	5 IN	10 IN
TYPE			
	TY IV	-	TY I TY IV
EAST STATE ST.			
118+06.93-119+00			
119+00-125+00		5	
125+00-131+00		285	
131+00-137+00		46	
137+00-143+00		9	
143+00-148+00			
148+00-154+00			
154+00-160+00			
160+00-166+00			
166+00-171+00			
171+00-177+00			4 52
177+00-183+00			
183+00-185+01.77			
BENNETT ST.			
321+70-326+77.24	198	12	
328+83.65-332+05.76			
BENNETT ST. PARKING LOT			
200+23.21-201+42.67		148	
GLENGARRY DR.			
204+80.25-206+85.22		26	
208+71.49-209+56.57		20	
WATER ST.			
10+60-14+50		249	
TOTAL	198	800	4 52

STAGED CONSTRUCTION				
STAGE	STATION	STATION	TEMPORARY PAVEMENT (SY)	TEMPORARY PAVEMENT REMOVAL (SY)
STAGE 0				
	EAST STATE STREET			
	112+00	124+00	0	0
	124+00	139+00	0	0
	139+00	154+00	0	0
	154+00	169+00	0	0
	169+00	184+00	0	0
	BENNETT STREET			
	320+00	335+00	0	0
	EAST SIDE DRIVE			
	140+80	149+00	8	0
STAGE 1				
	EAST STATE STREET			
	112+00	124+00	0	0
	124+00	139+00	0	0
	139+00	154+00	1,089	0
	154+00	169+00	122	0
	169+00	184+00	0	0
	BENNETT STREET			
	320+00	335+00	0	0
	EAST SIDE DRIVE			
	140+80	149+00	8	0
STAGE 2				
	EAST STATE STREET			
	112+00	124+00	0	0
	124+00	139+00	0	0
	139+00	154+00	0	1,089
	154+00	169+00	0	122
	169+00	184+00	0	0
	BENNETT STREET			
	320+00	335+00	0	0
	EAST SIDE DRIVE			
	140+80	149+00	0	8
STAGE 3				
	EAST STATE STREET			
	112+00	124+00	0	0
	124+00	139+00	0	0
	139+00	154+00	0	0
	154+00	169+00	0	0
	169+00	184+00	0	0
	BENNETT STREET			
	320+00	335+00	0	0
	EAST SIDE DRIVE			
	140+80	149+00	0	0
TOTAL			1,219	1,219



USER NAME = tnestor	DESIGNED - GJE	REVISED -
	DRAWN - GJE	REVISED -
PLOT SCALE = 48.0000' / in.	CHECKED - DBB	REVISED -
PLOT DATE = 1/13/2025	DATE - 11/7/2024	REVISED -

**STATE OF ILLINOIS
DEPARTMENT OF TRANSPORTATION**

**ILLINOIS ROUTE 38 - EAST STATE STREET
SCHEDULE OF QUANTITIES**

SCALE: SHEET 2 OF 24 SHEETS STA. TO STA.

F.A.U. RTE.	SECTION	COUNTY	TOTAL SHEETS	SHEET NO.
0347	05-00102-00-PV	KANE	488	37
			CONTRACT NO. 61J84	
ILLINOIS FED. AID PROJECT				

LOCATION STATION-STATION	EPOXY PAVEMENT MARKING						THERMOPLASTIC PAVEMENT MARKING						PAINT PAVEMENT MARKING			PREFORMED PLASTIC PAVEMENT MARKING, TYPE	GROOVING FOR RECESSED PAVEMENT MARKING
	LETTERS & SYMBOLS (SQ FT)	LINE 4" (FOOT)	LINE 6" (FOOT)	LINE 8" (FOOT)	LINE 12" (FOOT)	LINE 24" (FOOT)	LETTERS & SYMBOLS (SQ FT)	LINE 4" (FOOT)	LINE 6" (FOOT)	LINE 8" (FOOT)	LINE 12" (FOOT)	LINE 24" (FOOT)	LETTERS & SYMBOLS (SQ FT)	LINE 4" (FOOT)	LINE 24" (FOOT)	STANDARD-LINE 7" (FOOT)	8" (FOOT)
EAST STATE ST.																	
114+13.00-119+00	42	1479	423	0	77	10										47	47
119+00-125+00	60	1124	352		148	142										208	208
125+00-131+00	88	772	0			39										313	313
131+00-137+00	71	1288	37		361	39										259	259
137+00-143+00	65	1046	152		137	14										247	247
143+00-148+00	62	990	185		140	10										210	210
148+00-154+00	145	510	555		180	131										231	231
154+00-160+00	86	766	436		250	37						39		34		235	235
160+00-166+00	42	898	282		110							9				300	300
166+00-171+00	50	880	523		385							9		10		250	250
171+00-177+00	21	1150	301		21	126								38		173	173
177+00-183+00	42	410	5	465	147											108	108
183+00-185+01.77			295		740												
BENNETT ST.																	
320+00-323+00								590	32					10			
323+00-326+77.24							73	855	253								
328+00-332+05.76		168	84				37	738	154								
EAST SIDE DR.																	
140+80-146+36.93	24	286	143				151	828	197	566	167						
GLENGARRY DR.																	
204+80.25-206+85.22							37	400	34								
208+71.49-209+56.57								172	65								
WATER STREET																	
12+30-12+90														20			
TOTAL	798	11767	3773	465	2696	548	298	3583	735	566	167	10	57	20	82	2581	2581

LOCATION STATION-STATION	PIPE UNDERDRAIN TYPE 2, 4" (FT)
EAST STATE ST.	
118+06.93-118+32.31 RT	26
118+32.31-118+57.58 RT	28
118+57.58-118+70.31 RT	15
118+70.31-119+38.12 RT	76
119+38.12-119+71.91 RT	70
118+92.57-119+70.31 LT	37
150+49.74-150+74.83 RT	78
150+74.83-151+08.19 RT	27
151+08.19-151+95.35 RT	35
151+95.35-153+15.20 RT	89
153+15.20-153+48.16 RT	118
152+32.53-152+75.11 LT	32
152+75.11-153+28.87 LT	45
153+28.87-152+48.15 LT	55
153+48.15 TRANSVERSE	20
153+48.15-153+57.88 LT	128
153+57.88-154+47.63 LT	11
154+51.83-155+60.16 LT	93
155+60.16-155+98.20 LT	112
155+98.20-156+44.00 LT	40
153+48.16-153+57.58 RT	48
153+58.32-154+34.19 RT	11
154+36.35-155+89.63 RT	75
155+90.07-156+49.24 RT	152
168+55.42-168+73.03 RT	59
168+74.22-170+07.56 RT	18
170+07.56-171+15.74 RT	135
171+47.12-171+58.70 RT	108
168+54.90-168+73.10 LT	67
168+73.10-170+00.00 LT	20
170+00.00-171+25.48 LT	127
171+25.48-171+47.39 LT	125
171+47.26 TRANSVERSE	22
171+47.26-171+60.10 LT	35
172+31.23-172+71.41 LT	21
172+71.41-173+90.78 LT	42
173+90.78-174+47.39 LT	121
172+50.45-173+90.78 RT	58
173+90.78-174+47.39 RT	141
TOTAL	2578

LOCATION STATION-STATION	PAVEMENT REMOVAL (SQ YD)	DRIVEWAY PAVEMENT REMOVAL (SQ YD)	HMA SURFACE REMOVAL 2.5" (SQ YD)	SIDEWALK REMOVAL (SQ FT)	COMBINATION CURB AND GUTTER REMOVAL (FOOT)	CURB REMOVAL (FOOT)	BRICK PAVER REMOVAL (SQ FT)	MEDIAN REMOVAL (SQ FT)	PAVED DITCH REMOVAL (FOOT)	GUARDRAIL REMOVAL (FOOT)	CONCRETE RETAINING WALL REMOVAL (FOOT)	RETAINING WALL REMOVAL (FOOT)	TIMBER RETAINING WALL REMOVAL (FOOT)	REMOVE STONE PAVERS (SQ FT)	CLEARING & GRUBBING (SQ YD)
EAST STATE ST.															
118+06.93-119+00	702	27		1214	191	14									
119+00-125+00	4227	401		6409	1404	102	880	80			140			75	150
125+00-131+00	3716	259		5991	1242	68							66		5
131+00-137+00	4082	127		5396	1256	33	40								
137+00-143+00	3559	604		5078	1250	72						40			
143+00-148+00	3065	597		3977	1314		540								21
148+00-154+00	4348	711		4012	1685	13	880	206							155
154+00-160+00	4505	240		4426	1390	93	843	412							426
160+00-166+00	4018	96		2628	1236				293	139					14
166+00-171+00	3356	252		2307	1165			216							318
171+00-177+00	3962	70		2298	1096						81				
177+00-183+00		45		931							135				
183+00-185+01.77															578
BENNETT ST.															
321+70-323+00			724												
323+00-326+77.24		247	1696	1510	560		350								62
328+83.65-332+05.76	330		1228	546	114										17
EAST SIDE DR.															
140+78-146+36.93	598	76	1740		284	51									
GLENGARRY DR.															
204+80.25-206+85.22		39	767												
208+71.49-209+56.57			294												
TOTAL	40468	3791	6449	46723	14187	446	3533	914	509	139	140	40	66	75	1746

FILE NAME = FA\961-000 Genevo East State St.CADD.Sheets\961-000_SHT_SCHEDULE OF QUANTITIES.dgn



USER NAME = tnestor	DESIGNED - GJE	REVISED -
	DRAWN - GJE	REVISED -
PLOT SCALE = 48.0000' / in.	CHECKED - DBB	REVISED -
PLOT DATE = 1/13/2025	DATE - 11/7/2024	REVISED -

**STATE OF ILLINOIS
DEPARTMENT OF TRANSPORTATION**

ILLINOIS ROUTE 38 - EAST STATE STREET SCHEDULE OF QUANTITIES		
SCALE:	SHEET 3 OF 24 SHEETS	STA. TO STA.

F.A.U RTE.	SECTION	COUNTY	TOTAL SHEETS	SHEET NO.
0347	05-00102-00-PV	KANE	488	38
CONTRACT NO. 61J84				
ILLINOIS FED. AID PROJECT				

FILE NAME = FA\961-000 Genevo East State St.CADD.Sheets\961-000_SHT_SCHEDULE OF QUANTITIES.dgn

TEMPORARY PAVEMENT MARKINGS								
STAGE	STATION	STATION	LETTERS AND SYMBOLS TYPE IV TAPE (SQ FT)	LINE 4" TYPE IV TAPE (FOOT)	LINE 6" TYPE IV TAPE (FOOT)	LINE 24" TYPE IV TAPE (FOOT)	PAVEMENT MARKING REMOVAL WATER BLASTING (SQ FT)	SHORT TERM PAVEMENT MARKING (FOOT)
STAGE 0	EAST STATE STREET							
	112+00	124+00	41	2,308	267	68	254	0
	124+00	139+00	0	2,856	0	0	0	0
	139+00	154+00	0	1,998	0	0	27	0
	154+00	169+00	0	169	0	0	0	0
	169+00	184+00	0	0	0	0	0	0
	BENNETT STREET							
	320+00	335+00	0	0	0	0	267	1,689
	EAST SIDE DRIVE							
	140+80	149+00	0	0	0	0	0	0
STAGE 1	EAST STATE STREET							
	112+00	124+00	41	3,359	306	94	598	0
	124+00	139+00	0	4,726	0	0	0	0
	139+00	154+00	21	5,536	149	70	30	0
	154+00	169+00	0	5,012	0	0	104	0
	169+00	184+00	41	5,911	312	115	1,284	0
	BENNETT STREET							
	320+00	335+00	0	0	0	0	71	4,939
	EAST SIDE DRIVE							
	140+80	149+00	0	0	0	0	49	874
STAGE 2	EAST STATE STREET							
	112+00	124+00	41	3,031	258	147	271	0
	124+00	139+00	0	3,631	0	237	0	0
	139+00	154+00	21	5,267	124	169	0	0
	154+00	169+00	0	3,104	0	128	0	0
	169+00	184+00	62	6,437	280	184	177	0
	BENNETT STREET							
	320+00	335+00	0	0	0	0	0	4,098
	EAST SIDE DRIVE							
	140+80	149+00	0	0	0	0	73	2,154
STAGE 3	EAST STATE STREET							
	112+00	124+00	41	3,112	299	88	0	0
	124+00	139+00	0	4,769	0	0	0	0
	139+00	154+00	21	9,256	140	198	0	0
	154+00	169+00	0	6,270	0	0	0	0
	169+00	184+00	62	7,071	279	111	0	0
	BENNETT STREET							
	320+00	335+00	0	0	0	0	0	3,843
	EAST SIDE DRIVE							
	140+80	149+00	0	0	0	0	0	2,900
TOTAL			392	83,823	2,414	1,609	3,206	20,497

WATER MAIN							
STATION	STATION	DUCTILE IRON WATER MAIN 4" (FOOT)	DUCTILE IRON WATER MAIN 6" (FOOT)	DUCTILE IRON WATER MAIN 8" (FOOT)	DUCTILE IRON WATER MAIN 10" (FOOT)	DUCTILE IRON WATER MAIN 12" (FOOT)	TRENCH BACKFILL (CU YD)
EAST STATE STREET							
112+00	119+00	0	0	10	0	76	206
119+00	125+00	46	114	148	0	601	646
125+00	131+00	106	104	218	0	600	1,074
131+00	137+00	46	413	194	0	650	1,390
137+00	143+00	0	13	168	0	736	601
143+00	148+00	16	238	0	0	521	639
148+00	154+00	0	7	34	141	600	355
154+00	160+00	0	30	24	20	540	603
160+00	166+00	0	0	0	0	0	0
166+00	171+00	0	0	0	0	0	0
171+00	177+00	0	0	0	0	0	0
177+00	183+00	0	0	0	0	0	0
183+00	186+00	0	0	0	0	0	0
BENNETT STREET							
321+00	323+00	0	0	0	0	0	0
323+00	328+00	0	0	0	0	0	0
328+00	334+00	0	0	0	0	0	0
EAST SIDE DRIVE							
140+80	147+00	0	0	0	21	0	16
WATER STREET							
10+60	14+50	0	0	0	0	0	0
GLENGARRY DRIVE							
204+80	206+85	0	0	0	0	0	0
TOTAL		214	919	796	182	4,324	5,529

EROSION CONTROL								
STAGE	STATION	STATION	TEMP. EROSION CONTRL SEEDING (POUND)	TEMPORARY EROSION CONTROL BLANKET (SQ SY)	PERIMETER EROSION BARRIER (FOOT)	INLET AND PIPE PROTECTION (EACH)	INLET FILTERS (EACH)	
0	EAST STATE							
	112+00	124+00	0	0	0	0	7	
	124+00	139+00	0	0	0	0	16	
	139+00	154+00	0	0	0	0	15	
	154+00	169+00	0	0	0	0	9	
	169+00	184+00	0	0	0	0	0	
	184+00	186+00	0	0	0	0	0	
	BENNETT STREET							
	320+00	335+00	0	0	0	0	3	
	EAST SIDE DRIVE							
	140+80	149+00	0	0	0	0	2	
	STAGE TOTAL		0	0	0	0	52	
	1	EAST STATE						
		112+00	124+00	7	335	816	0	7
		124+00	139+00	26	1,265	1,676	0	25
139+00		154+00	19	937	1,891	0	21	
154+00		169+00	53	2,577	2,825	0	23	
169+00		184+00	41	1,973	2,126	2	35	
184+00		186+00	4	170	107	0	0	
BENNETT STREET								
320+00		335+00	11	514	569	2	14	
EAST SIDE DRIVE								
140+80		149+00	0	0	225	0	2	
STAGE TOTAL		161	7,773	10,236	4	127		
2		EAST STATE						
		112+00	124+00	0	0	0	1	0
		124+00	139+00	0	0	0	0	0
	139+00	154+00	0	0	0	0	0	
	154+00	169+00	0	0	0	0	0	
	169+00	184+00	0	0	0	0	0	
	184+00	186+00	0	0	0	0	0	
	BENNETT STREET							
	320+00	335+00	0	0	0	0	0	
	EAST SIDE DRIVE							
	140+80	149+00	2	98	0	0	2	
	STAGE TOTAL		2	98	0	1	2	
	3	EAST STATE						
		112+00	124+00	10	480	0	0	6
		124+00	139+00	27	1,319	0	0	23
139+00		154+00	14	690	0	0	25	
154+00		169+00	41	1,989	0	0	16	
169+00		184+00	20	965	0	0	9	
184+00		186+00	0	0	0	0	0	
BENNETT STREET								
320+00		335+00	2	86	0	0	0	
EAST SIDE DRIVE								
140+80		149+00	0	0	0	0	0	
STAGE TOTAL		114	5,529	0	0	79		
TOTAL		277	13,400	10,236	5	260		



USER NAME = tnestor	DESIGNED - GJE	REVISED -
	DRAWN - GJE	REVISED -
PLOT SCALE = 48.0000' / in.	CHECKED - DBB	REVISED -
PLOT DATE = 1/13/2025	DATE - 11/7/2024	REVISED -

STATE OF ILLINOIS
DEPARTMENT OF TRANSPORTATION

ILLINOIS ROUTE 38 - EAST STATE STREET
SCHEDULE OF QUANTITIES

SCALE: SHEET 4 OF 24 SHEETS STA. TO STA.

F.A.U. RTE.	SECTION	COUNTY	TOTAL SHEETS	SHEET NO.
0347	05-00102-00-PV	KANE	488	39
			CONTRACT NO. 61J84	
ILLINOIS FED. AID PROJECT				

WATER SERVICE , 1" (Long)			
STATION	OFFSET	LENGTH (FOOT)	TRENCH BACKFILL (CU YD)
EAST STATE STREET			
133+54.30	35.14 LT	70	57
136+39.32	44.00 LT	82	67
146+68.22	40.04 LT	79	64
TOTAL		231	188

WATER VALVES 4"		
STATION	OFFSET	EACH
EAST STATE STREET		
134+23.18	76.03 LT	1
TOTAL		1

WATER VALVES 10"		
STATION	OFFSET	EACH
EAST STATE STREET		
140+86.04	00.00 LT	1
TOTAL		1

VALVE BOX 6"		
STATION	OFFSET	EACH
EAST STATE STREET		
120+82.69	39.01 RT	1
122+03.80	48.27 LT	1
126+27.32	48.96 LT	1
130+10.73	45.48 RT	1
130+68.52	46.05 RT	1
131+33.49	46.55 LT	1
132+15.75	45.71 LT	1
133+54.30	35.14 LT	1
133+99.21	43.44 RT	1
135+06.55	45.76 LT	1
136+39.32	44.00 LT	1
141+86.89	42.08 RT	1
142+80.96	42.25 RT	1
144+90.96	41.67 LT	1
145+71.29	41.92 LT	1
146+59.86	44.02 RT	1
146+68.22	40.01 LT	1
151+77.93	48.83 RT	1
152+23.93	48.84 RT	1
134+20.07	80.33 LT	1
134+23.18	76.03 LT	1
139+77.62	42.08 RT	1
TOTAL		22

WATER MAIN LINE STOP 16"		
STATION	OFFSET	EACH
EAST STATE STREET		
132+34.79	62.41 RT	1
TOTAL		1

CONNECTION TO EXISTING WATER MAIN 4"		
STATION	OFFSET	EACH
EAST STATE STREET		
123+98.17	61.58 RT	1
126+93.92	53.32 LT	1
128+82.87	57.52 RT	1
130+44.78	54.49 LT	1
132+12.57	62.43 RT	1
134+23.18	76.03 LT	1
135+26.99	53.63 RT	1
139+41.56	94.13 LT	1
143+80.71	43.07 RT	1
TOTAL		9

WATER SERVICE , 1.5" (Long)			
STATION	OFFSET	LENGTH (FOOT)	TRENCH BACKFILL (CU YD)
EAST STATE STREET			
123+39.95	48.77 LT	85	69
123+58.27	48.12 LT	84	68
124+48.72	50.07 LT	88	72
125+28.34	35.28 LT	72	59
127+97.18	51.62 LT	87	71
128+44.46	52.32 LT	88	72
129+22.89	49.00 LT	86	70
133+08.09	44.98 LT	81	66
136+88.94	34.18 LT	79	64
126+27.32	48.96 LT	85	69
135+06.55	45.76 LT	84	68
144+90.96	41.67 LT	78	64
TOTAL		997	812

WATER VALVES 6"		
STATION	OFFSET	EACH
EAST STATE STREET		
120+82.69	39.01 RT	1
122+03.80	48.27 LT	1
126+27.32	48.96 LT	1
130+68.52	46.05 RT	1
130+10.73	45.48 RT	1
133+99.21	43.44 RT	1
136+39.32	44.00 LT	1
135+06.55	45.76 LT	1
134+20.07	80.33 LT	1
133+54.30	35.14 LT	1
132+15.75	45.71 LT	1
131+33.49	46.55 LT	1
139+77.62	42.08 RT	1
141+86.89	42.05 RT	1
142+80.96	42.25 RT	1
146+59.86	44.02 RT	1
146+68.22	40.01 LT	1
145+71.29	41.92 LT	1
144+90.96	41.67 LT	1
151+77.93	48.83 RT	1
152+23.93	48.84 RT	1
TOTAL		21

WATER VALVES 12"		
STATION	OFFSET	EACH
EAST STATE STREET		
118+30.47	43.88 RT	1
120+90.89	35.88 RT	1
123+99.53	36.47 RT	1
126+98.97	35.54 RT	1
128+85.59	36.34 RT	1
130+50.58	36.28 RT	1
132+30.96	36.35 RT	1
132+34.79	62.41 RT	1
134+40.31	36.84 RT	1
135+39.48	37.62 RT	1
138+71.00	42.09 RT	1
139+83.29	38.53 RT	1
143+61.44	41.69 RT	1
144+22.80	36.57 RT	1
149+59.48	43.44 RT	1
152+32.57	43.08 RT	1
157+28.42	63.93 RT	1
159+41.66	62.82 RT	1
TOTAL		18

CUT AND CAP EXISTING 4" WATER MAIN		
STATION	OFFSET	EACH
EAST STATE STREET		
123+98.17	61.58 RT	1
126+93.92	53.32 LT	1
128+82.87	57.52 RT	1
130+44.78	54.49 LT	1
132+12.57	62.43 RT	1
134+23.18	76.03 LT	1
135+26.99	53.63 RT	1
139+41.56	94.13 LT	1
143+80.71	43.07 RT	1
TOTAL		9

CONNECTION TO EXISTING WATER MAIN 6"		
STATION	OFFSET	EACH
EAST STATE STREET		
134+20.07	80.33 LT	1
149+09.35	47.58 RT	1
157+00.00	72.81 RT	1
328+20.81	10.77 LT	1
TOTAL		4

CUT AND CAP EXISTING 6" WATER MAIN		
STATION	OFFSET	EACH
EAST STATE STREET		
134+20.07	80.33 LT	1
149+09.35	47.58 RT	1
157+00.00	72.81 RT	1
328+20.81	10.77 LT	1
TOTAL		4

CONNECTION TO EXISTING WATER MAIN 8"		
STATION	OFFSET	EACH
EAST STATE STREET		
118+30.47	43.88 RT	1
159+26.11	45.51 RT	1
TOTAL		2

WATER SERVICE , 1" (Short)			
STATION	OFFSET	LENGTH (FOOT)	TRENCH BACKFILL (CU YD)
EAST STATE STREET			
122+98.23	38.24 RT	3	2
141+86.89	42.08 RT	5	4
TOTAL		8	7

WATER VALVES 8"		
STATION	OFFSET	EACH
EAST STATE STREET		
120+46.68	32.21 RT	1
123+98.17	61.58 RT	1
126+93.92	53.32 LT	1
128+82.83	69.29 RT	1
130+44.78	54.49 LT	1
126+93.92	53.32 LT	1
132+12.57	62.43 RT	1
135+26.99	53.63 RT	1
134+55.28	57.86 LT	1
139+41.56	94.13 LT	1
143+80.71	43.07 RT	1
149+09.35	47.58 RT	1
157+00.00	72.81 RT	1
159+26.11	45.51 RT	1
BENNETT STREET		
328+20.81	10.77 LT	1
TOTAL		14

VALVE VAULTS, TYPE A, 4'-DIAMETER, TYPE 1 FRAME, CLOSED LID		
STATION	OFFSET	EACH
EAST STATE STREET		
120+46.68	32.21 RT	1
123+98.17	61.58 RT	1
126+93.92	53.32 LT	1
128+82.83	69.29 RT	1
130+44.78	54.49 LT	1
132+12.57	62.43 RT	1
134+55.28	57.86 LT	1
135+26.99	53.63 RT	1
139+41.56	94.13 LT	1
143+80.71	43.07 RT	1
149+09.35	47.58 RT	1
157+00.00	72.81 RT	1
159+26.11	45.51 RT	1
BENNETT STREET		
328+20.81	10.77 LT	1
EAST SIDE DR		
140+86.04	00.00 LT	1
TOTAL		15

VALVE VAULTS, TYPE A, 5'-DIAMETER, TYPE 1 FRAME, CLOSED LID		
STATION	OFFSET	EACH
EAST STATE STREET		
118+30.47	43.88 RT	1
120+90.89	35.88 RT	1
123+99.53	35.47 RT	1
126+98.97	35.54 RT	1
128+85.59	36.34 RT	1
130+50.58	36.28 RT	1
132+30.96	36.35 RT	1
132+34.79	62.41 RT	1
134+40.31	36.84 RT	1
135+39.48	37.62 RT	1
138+71.00	42.09 RT	1
139+83.29	38.53 RT	1
143+61.44	41.69 RT	1
144+22.80	36.58 RT	1
149+59.48	43.44 RT	1
152+32.57	43.08 RT	1
157+28.42	63.93 RT	1
159+41.66	62.82 RT	1
TOTAL		18

CUT AND CAP EXISTING 8" WATER MAIN		
STATION	OFFSET	EACH
EAST STATE STREET		
118+30.47	43.88 RT	1
TOTAL		1

CONNECTION TO EXISTING WATER MAIN 10"		
STATION	OFFSET	EACH
EAST STATE STREET		
140+86.04	0.00 LT	1
159+41.66	62.82 RT	1
TOTAL		2

WATER SERVICE , 1.5" (Short)			
STATION	OFFSET	LENGTH (FOOT)	TRENCH BACKFILL (CU YD)
EAST STATE STREET			
133+56.50	45.6 RT	7	6
141+74.02	42.08 RT	5	4
133+99.21	43.44 RT	5	4
142+80.96	42.25 RT	6	5
146+59.86	44.02 RT	5	4
152+23.93	48.84 RT	4	3
TOTAL		32	26

WATER SERVICE , 2" (Short)			
STATION	OFFSET	LENGTH (FOOT)	TRENCH BACKFILL (CU YD)
EAST STATE STREET			
121+50.32	38.58 RT	3	2
130+10.73	45.48 RT	9	7
130+68.52	46.05 RT	10	8
139+77.62	42.08 RT	4	3
151+77.93	48.83 RT	4	3
N BENNETT STREET			
328+07.06	37.20 RT	5	4
TOTAL		35	29

VALVE VAULTS TO BE ADJUSTED		
STATION	OFFSET	EACH
EAST STATE STREET		
120+45	27.50 LT	1
120+45	49.50 LT	1
TOTAL		2

WATER MAIN LINE STOP 12"		
STATION	OFFSET	EACH
EAST STATE STREET		
138+71.00	42.09 RT	1
139+48.95	74.7 LT	1
TOTAL		2

CUT AND CAP EXISTING 10" WATER MAIN		
STATION	OFFSET	EACH
EAST STATE STREET		
159+41.66	62.82 RT	1
140+86.04	0.00 LT	1
TOTAL		1

CONNECTION TO EXISTING WATER MAIN 12"		
STATION	OFFSET	EACH
EAST STATE STREET		
143+61.44	41.69 RT	1
TOTAL		0

CUT AND CAP EXISTING 12" WATER MAIN		
STATION	OFFSET	EACH
EAST STATE STREET		
139+48.95	74.70 LT	1
139+48.95	74.70 LT	1
43+61.44	41.69 RT	1
138+71.00	42.09 RT	1
TOTAL		1

CUT AND CAP EXISTING 16" WATER MAIN		
STATION	OFFSET	EACH
EAST STATE STREET		
132+34.79	62.41 RT	1
132+34.79	62.41 RT	1
TOTAL		2

FILE NAME = FA\961-000 Genevo East State St.CADD_Sheets\961-000_SHT_SCHEDULE OF QUANTITIES.dgn



NO.	STA.	OFFSET (FT)	STRUCTURE TYPE/SIZE		F&G	INVERT				RIM ELEV
			TYPE	OTHER		(N)	(S)	(E)	(W)	
M19A	118+70.62	26.65 RT	A		1 CL	MATCH EX	MATCH EX			683.05
M19	118+71.81	33.04 RT	A		1 CL	673.83	673.33			683.61

NO.	STA.	OFFSET (FT)	STRUCTURE TYPE/SIZE		F&G	INVERT				RIM ELEV
			TYPE	OTHER		(N)	(S)	(E)	(W)	
M30A	119+96.72	54.20 RT	A		1 CL	677.49 NE	677.29			686.95
M20	120+31.22	0.05 LT	A	DROP CONNECTION	1 CL	677.94	677.94	680.23		688.80
M21	120+31.93	29.48 RT	A		1 CL	677.76	677.76			688.50
M20A	121+07.63	0.06 LT	A		1 CL			683.87	683.87	694.36
M22	124+11.52	0.08 LT	A		1 CL	710.31		710.31	710.31	719.48

NO.	STA.	OFFSET (FT)	STRUCTURE TYPE/SIZE		F&G	INVERT				RIM ELEV
			TYPE	OTHER		(N)	(S)	(E)	(W)	
M23	127+05.84	0.35 RT	A		1CL	720.37		720.37	720.37	731.19
M27	128+56.84	1.29 LT	A		1CL			724.15	724.15	734.30
M28	130+67.06	1.75 RT	A		1CL	728.84		728.84	728.84	737.93

NO.	STA.	OFFSET (FT)	STRUCTURE TYPE/SIZE		F&G	INVERT				RIM ELEV
			MH	OTHER		(N)	(S)	(E)	(W)	
M29	134+25.28	6.68 RT	A		1 CL	731.20		731.20	731.20	740.43
M30	136+70.35	0.01 LT	A		1 CL	732.44		732.44	732.44	741.11

NO.	STA.	OFFSET (FT)	STRUCTURE TYPE/SIZE		F&G	INVERT				RIM ELEV
			MH	OTHER		(N)	(S)	(E)	(W)	
M31	139+10.82	2.68 RT	A		1 CL	733.68		733.68	733.68	742.32
M32	141+44.87	0.49 LT	A		1 CL			734.93	734.93	745.39

NO.	STA.	OFFSET (FT)	STRUCTURE TYPE/SIZE		F&G	INVERT				RIM ELEV
			MH	OTHER		(N)	(S)	(E)	(W)	
M33	143+80.93	0.24 RT	A		1 CL	739.96	739.96		739.96	748.68

NO.	STA.	OFFSET (FT)	STRUCTURE TYPE/SIZE		F&G	INVERT				RIM ELEV
			MH	OTHER		(N)	(S)	(E)	(W)	
M34	143+80.93	0.24 RT	A		1 CL	MATCH EX		MATCH EX	MATCH EX	752.86
M35	157+36.49	33.72 RT	A		1 CL	MATCH EX	MATCH EX	MATCH EX		752.10
M36	161+90.27	31.06 RT	A		1 CL		MATCH EX		MATCH EX	755.89

PIPE LOCATION				DIA. (IN)	L (FT)	TRENCH BACKFILL VOL. (CU. YD.)
NO.	FROM	TO	SLOPE			
SAN1	MH 19A	MH 19	MATCH EX	8	5	9.4
SAN2	118+70.62	26.65 RT	MH 19A	8	7	13.4

PIPE LOCATION				DIA. (IN)	L (FT)	TRENCH BACKFILL VOL. (CU. YD.)	
NO.	FROM	TO	SLOPE				
SAN3	M30A	119+97.15	59.18 R	18	5	6.7	
SAN4	M21	M30A	0.62	18	43	57.7	
SAN5	M20	M21	0.62	18	30	40.2	
SAN6	328+36.68	4.11 LT	M20	MATCH EX	12	94	124.7
SAN7	M20A	M20	4.91	8	75	103.3	
SAN8	M22	M20A	8.31	8	318	403.6	
SAN9	M23	M22	3.43	8	294	395.6	

PIPE LOCATION				DIA. (IN)	L (FT)	TRENCH BACKFILL VOL. (CU. YD.)	
NO.	FROM	TO	SLOPE				
SAN10	M27	M23	2.55	8	148	202.5	
SAN11	127+05.52	64.26 LT	M23	MATCH EX	8	64	88.5
SAN12	M28	M27	2.27	8	207	281.6	
SAN13	M29	M28	0.67	8	354	433.4	
SAN14	130+68.14	75.99 LT	M28	MATCH EX	8	78	104.6

PIPE LOCATION				DIA. (IN)	L (FT)	TRENCH BACKFILL VOL. (CU. YD.)	
NO.	FROM	TO	SLOPE				
SAN15	M30	M29	0.51	8	241	323.2	
SAN16	134+40.75	71.51 LT	M29	MATCH EX	8	80	105.9

PIPE LOCATION				DIA. (IN)	L (FT)	TRENCH BACKFILL VOL. (CU. YD.)	
NO.	FROM	TO	SLOPE				
SAN17	M31	M30	0.50	8	237	317.8	
SAN 18	M32	M31	0.57	8	230	308.4	
SAN 19	139+40.44	91.89 LT	M31	MATCH EX	8	99	132.8
SAN 20	M33	M32	2.16	8	232	311.1	

PIPE LOCATION				DIA. (IN)	L (FT)	TRENCH BACKFILL VOL. (CU. YD.)	
NO.	FROM	TO	SLOPE				
SAN21	EX MH	M34	0.50	8	144	193.1	
SAN22	159+80.32	91.89 LT	M34	MATCH EX	8	5	6.7
SAN23	M34	159+90.42	29.69 R	MATCH EX	8	5	6.7
SAN24	157+37.60	28.84 RT	M35	MATCH EX	8	5	6.7
SAN25	M35	157+41.53	33.96 R	MATCH EX	8	5	6.7
SAN26	157+36.34	38.72 RT	M35	MATCH EX	8	5	6.7
SAN27	161+85.16	29.69 RT	M36	MATCH EX	8	5	6.7
SAN28	M36	161+92.43	35.45 R	MATCH EX	8	5	6.7

SVC. NO.	PIPE LOCATION				OTHER	DIA. (IN)	L (FT)	TRENCH BACKFILL VOL. (CU.)
	FROM		TO					
	STA.	O/S	STA.	O/S				
SS1	118+38.16	69.70 LT	118+55.78	71.30 LT	8"x6" WYE	6	18	24.1

SVC. NO.	PIPE LOCATION				OTHER	DIA. (IN)	L (FT)	TRENCH BACKFILL VOL. (CU.)
	FROM		TO					
	STA.	O/S	STA.	O/S				
SS2	120+93.26	49.50 RT	120+93.22	0.00 RT	8"x6" WYE	6	50	67.1
SS3	121+36.17	50.62 LT	121+36.22	0.06 LT	8"x6" WYE	6	50	71.1
SS4	121+85.17	50.87 LT	122+85.22	0.06 LT	8"x6" WYE, TP	6	50	71.1
SS5	122+13.31	49.04 RT	122+13.31	0.00 RT	8"x6" WYE	6	49	65.7
SS6	123+07.17	51.49 LT	123+07.22	0.07 LT	8"x6" WYE	6	51	64.4
SS7	123+69.17	51.90 LT	123+69.22	0.08 LT	8"x6" WYE	6	52	71.1
SS8	124+36.47	52.56 LT	124+36.52	0.05 LT	8"x6" WYE	6	52	71.1

SVC. NO.	PIPE LOCATION				OTHER	DIA. (IN)	L (FT)	TRENCH BACKFILL VOL. (CU.)
	FROM		TO					
	STA.	O/S	STA.	O/S				
SS9	125+15.52	0.07 RT	125+15.52	46.74 RT	8"x6" WYE	6	47	63.0
SS10	126+72.52	0.30 RT	126+72.82	45.72 RT	8"x6" WYE	6	46	61.7
SS11	128+06.33	53.43 LT	128+06.38	0.91 LT	8"x6" WYE	6	52	71.1
SS12	129+05.85	53.10 LT	129+06.67	0.58 LT	8"x6" WYE	6	52	71.1
SS13	129+06.99	45.26 RT	129+07.36	0.57 LT	8"x6" WYE	6	46	67.1

SVC. NO.	PIPE LOCATION				OTHER	DIA. (IN)	L (FT)	TRENCH BACKFILL VOL. (CU.)
	FROM		TO					
	STA.	O/S	STA.	O/S				
SS14	131+06.76	47.25 RT	131+07.21	1.70 RT	8"x6" WYE	6	46	61.7
SS15	132+80.14	46.51 LT	132+80.21	1.49 RT	8"x6" WYE, TP	6	48	65.7
SS16	132+82.45	43.66 RT	132+82.45	1.49 RT	8"x6" WYE	6	42	57.7
SS17	133+44.21	43.47 RT	133+44.21	1.42 RT	8"x6" WYE	6	42	59.0
SS18	133+88.02	42.81 RT	133+91.03	2.79 RT	8"x6" WYE	6	40	55.0
SS19	134+69.77	1.87 RT	134+72.11	44.42 RT	8"x6" WYE	6	41	59.0
SS20	134+92.12	43.50 LT	134+92.69	1.05 RT	8"x6" WYE	6	44	61.7
SS21	136+53.68	0.09 RT	136+53.96	47.00 RT	8"x6" WYE	6	48	63.0

SVC. NO.	PIPE LOCATION				OTHER	DIA. (IN)	L (FT)	TRENCH BACKFILL VOL. (CU.)
	FROM		TO					
	STA.	O/S	STA.	O/S				
SS22	139+65.71	0.16 RT	139+66.81	43.08 RT	8"x6" WYE	6	44	60.3
SS23	141+62.85	43.08 RT	141+62.93	0.05 LT	8"x6" WYE	6	44	60.3
SS24	142+12.85	43.08 RT	142+12.93	0.00 CL	8"x6" WYE	6	44	60.3
SS25	142+69.85	43.08 RT	142+69.93	0.07 RT	8"x6" WYE	6	44	60.3

SVC. NO.	PIPE LOCATION				OTHER	DIA. (IN)	L (FT)	TRENCH BACKFILL VOL. (CU.)
	FROM		TO					
	STA.	O/S	STA.	O/S				
SS26	144+02.63	43.38 RT	M30B		8"x6" WYE	6	48	64.4
SS27	142+22.40	43.94 LT	M30B		8"x6" WYE	6	60	80.5

SVC. NO.	PIPE LOCATION				OTHER	DIA. (IN)	L (FT)	TRENCH BACKFILL VOL. (CU.)
	FROM		TO					
	STA.	O/S	STA.	O/S				
SS28	175+94.89	RT	EX SAN MH	LT	8"x6" WYE	6	124	166.3

FILE NAME = FA\961-000 Genevo Est. State St.CADD_Sheets\961-000_SHT_SCHEDULE OF QUANTITIES.dgn



USER NAME = tnestor	DESIGNED - GJE	REVISED -
	DRAWN - GJE	REVISED -
PLOT SCALE = 48.0000' / in.	CHECKED - DBB	REVISED -
PLOT DATE = 1/13/2025	DATE - 11/7/2024	REVISED -

STATE OF ILLINOIS
DEPARTMENT OF TRANSPORTATION

ILLINOIS ROUTE 38 - EAST STATE STREET
SCHEDULE OF QUANTITIES

SCALE: SHEET 6 OF 24 SHEETS STA. TO STA.

F.A.U. RTE.	SECTION	COUNTY	TOTAL SHEETS	SHEET NO.
0347	05-00102-00-PV	KANE	488	41
				CONTRACT NO. 61J84

ILLINOIS FED. AID PROJECT

EAST STATE STREET STAGE 1 & 2 - EARTHWORK QUANTITIES

CUT						FILL						UNSUITABLES + TOPSOIL EXCAVATION AND PLACEMENT					
	CUT (SF)	AVE.	LENGTH	TOTAL (CF)	TOTAL (CY)		FILL (SF)	AVE.	LENGTH	TOTAL (CF)	TOTAL (CY)		UNSUITS (SF)	AVE.	LENGTH	TOTAL (CF)	TOTAL (CY)
118+06.93	17.17					118+06.93	1.45					118+06.93	25.65				
		38.24	56.96	2,177.87	80.66			0.73	56.96	41.30	1.53			34.01	56.96	1,936.92	71.74
118+63.89	59.30					118+63.89	0.00					118+63.89	42.36				
		60.71	42.26	2,565.39	95.01			0.00	42.26	0.00	0.00			38.99	42.26	1,647.72	61.03
119+06.15	62.11					119+06.15	0.00					119+06.15	35.62				
		60.36	43.85	2,646.57	98.02			0.00	43.85	0.00	0.00			36.12	43.85	1,583.86	58.66
119+50.00	58.60					119+50.00	0.00					119+50.00	36.62				
		63.78	50.00	3,188.75	118.10			0.00	50.00	0.00	0.00			47.53	50.00	2,376.25	88.01
120+00.00	68.95					120+00.00	0.00					120+00.00	58.43				
		67.54	25.00	1,688.50	62.54			0.00	25.00	0.00	0.00			58.54	25.00	1,463.38	54.20
120+25.00	66.13					120+25.00	0.00					120+25.00	58.64				
		55.13	25.00	1,378.13	51.04			0.25	25.00	6.25	0.23			49.63	25.00	1,240.75	45.95
120+50.00	44.12					120+50.00	0.50					120+50.00	40.62				
		37.94	50.00	1,896.75	70.25			0.25	50.00	12.50	0.46			23.36	50.00	1,168.00	43.26
121+00.00	31.75					121+00.00	0.00					121+00.00	6.10				
		29.29	20.90	612.16	22.67			0.73	20.90	15.15	0.56			3.05	20.90	63.74	2.36
121+20.90	26.83					121+20.90	1.45					121+20.90	0.00				
		27.56	29.10	802.00	29.70			0.73	29.10	21.10	0.78			2.60	29.10	75.66	2.80
121+50.00	28.29					121+50.00	0.00					121+50.00	5.20				
		31.96	19.88	635.27	23.53			0.00	19.88	0.00	0.00			2.60	19.88	51.69	1.91
121+69.88	35.62					121+69.88	0.00					121+69.88	0.00				
		35.36	15.38	543.84	20.14			0.00	15.38	0.00	0.00			2.88	15.38	44.29	1.64
121+85.26	35.10					121+85.26	0.00					121+85.26	5.76				
		35.48	14.74	522.98	19.37			0.00	14.74	0.00	0.00			5.83	14.74	85.93	3.18
122+00.00	35.86					122+00.00	0.00					122+00.00	5.90				
		35.88	50.00	1,793.75	66.44			0.00	50.00	0.00	0.00			6.41	50.00	320.25	11.86
122+50.00	35.89					122+50.00	0.00					122+50.00	6.91				
		36.45	20.46	745.66	27.62			0.00	20.46	0.00	0.00			6.88	20.46	140.66	5.21
122+70.46	37.00					122+70.46	0.00					122+70.46	6.84				
		38.62	29.54	1,140.83	42.25			0.00	29.54	0.00	0.00			6.80	29.54	200.72	7.43
123+00.00	40.24					123+00.00	0.00					123+00.00	6.75				
		60.25	15.75	948.86	35.14			0.00	15.75	0.00	0.00			3.38	15.75	53.16	1.97
123+15.75	80.25					123+15.75	0.00					123+15.75	0.00				
		74.18	34.25	2,540.49	94.09			0.00	34.25	0.00	0.00			3.12	34.25	106.86	3.96
123+50.00	68.10					123+50.00	0.00					123+50.00	6.24				
		141.05	62.57	8,825.50	326.87			0.00	62.57	0.00	0.00			3.12	62.57	195.22	7.23
124+12.57	214.00					124+12.57	0.00					124+12.57	0.00				
		134.89	37.43	5,048.93	187.00			0.00	37.43	0.00	0.00			1.76	37.43	65.88	2.44
124+50.00	55.78					124+50.00	0.00					124+50.00	3.52				
		53.59	39.45	2,114.13	78.30			0.00	39.45	0.00	0.00			1.76	39.45	69.43	2.57
124+89.45	51.40					124+89.45	0.00					124+89.45	0.00				
		47.63	10.55	502.44	18.61			0.00	10.55	0.00	0.00			5.60	10.55	59.08	2.19
125+00.00	43.85					125+00.00	0.00					125+00.00	11.20				
		45.55	50.76	2,312.12	85.63			0.00	50.76	0.00	0.00			9.05	50.76	459.38	17.01
125+50.76	47.25					125+50.76	0.00					125+50.76	6.90				
		46.10	20.97	966.72	35.80			0.00	20.97	0.00	0.00			3.45	20.97	72.35	2.68
125+71.73	44.95					125+71.73	0.00					125+71.73	0.00				
		47.65	28.27	1,347.07	49.89			0.00	28.27	0.00	0.00			3.65	28.27	103.19	3.82
126+00.00	50.35					126+00.00	0.00					126+00.00	7.30				
		61.10	50.00	3,055.00	113.15			0.00	50.00	0.00	0.00			7.31	50.00	365.25	13.53
126+50.00	71.85					126+50.00	0.00					126+50.00	7.31				
		74.85	50.00	3,742.25	138.60			0.00	50.00	0.00	0.00			7.25	50.00	362.50	13.43
127+00.00	77.84					127+00.00	0.00					127+00.00	7.19				
		102.47	25.85	2,648.85	98.11			0.00	25.85	0.00	0.00			3.60	25.85	92.93	3.44
127+25.85	127.10					127+25.85	0.00					127+25.85	0.00				
		103.08	24.15	2,489.26	92.19			0.00	24.15	0.00	0.00			4.90	24.15	118.33	4.38
127+50.00	79.05					127+50.00	0.00					127+50.00	9.80				
		69.03	50.00	3,451.25	127.82			0.00	50.00	0.00	0.00			9.62	50.00	481.00	17.81
128+00.00	59.00					128+00.00	0.00					128+00.00	9.44				
		51.98	26.22	1,362.78	50.47			0.00	26.22	0.00	0.00			9.02	26.22	236.37	8.75
128+26.22	44.95					128+26.22	0.00					128+26.22	8.59				
		48.63	23.78	1,156.30	42.83			0.00	23.78	0.00	0.00			7.65	23.78	181.80	6.73
128+50.00	52.30					128+50.00	0.00					128+50.00	6.70				
		44.55	35.51	1,581.97	58.59			2.12	35.51	75.28	2.79			7.61	35.51	270.23	10.01
128+85.51	36.80					128+85.51	4.24					128+85.51	8.52				
		32.47	14.49	470.49	17.43			2.12	14.49	30.72	1.14			7.53	14.49	109.11	4.04
129+00.00	28.14					129+00.00	0.00					129+00.00	6.54				

FILE NAME = FA\961-000 Genevo East State St.CADD.Sheets\961-000_SHT_SCHEDULE OF QUANTITIES.dgn



USER NAME = tnestor	DESIGNED - GJE	REVISED -
PLOT SCALE = 48.0000' / in.	DRAWN - GJE	REVISED -
PLOT DATE = 1/13/2025	CHECKED - DBB	REVISED -
	DATE - 11/7/2024	REVISED -

STATE OF ILLINOIS
DEPARTMENT OF TRANSPORTATION

ILLINOIS ROUTE 38 - EAST STATE STREET
SCHEDULE OF QUANTITIES

SCALE:	SHEET 7 OF 24 SHEETS	STA.	TO STA.
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F.A.U RTE.	SECTION	COUNTY	TOTAL SHEETS	SHEET NO.
0347	05-00102-00-PV	KANE	488	42
			CONTRACT NO. 61J84	
ILLINOIS FED. AID PROJECT				

EAST STATE STREET STAGE 1 & 2 - EARTHWORK QUANTITIES

	CUT						FILL						UNSUITABLES + TOPSOIL EXCAVATION AND PLACEMENT				
	CUT (SF)	AVE.	LENGTH	TOTAL (CF)	TOTAL (CY)		FILL (SF)	AVE.	LENGTH	TOTAL (CF)	TOTAL (CY)		UNSUIT (SF)	AVE.	LENGTH	TOTAL (CF)	TOTAL (CY)
		19.67	50.00	983.50	36.43			1.97	50.00	98.50	3.65			3.27	50.00	163.50	6.06
129+50.00	11.20	12.81	31.61	404.92	15.00	129+50.00	3.94	1.97	31.61	62.27	2.31	129+50.00	0.00	4.09	31.61	129.13	4.78
129+81.61	14.42	12.71	18.39	233.74	8.66	129+81.61	0.00	0.80	18.39	14.71	0.54	129+81.61	8.17	5.77	18.39	106.11	3.93
130+00.00	11.00	16.43	50.00	821.50	30.43	130+00.00	1.60	0.80	50.00	40.00	1.48	130+00.00	3.37	5.87	50.00	293.50	10.87
130+50.00	21.86	26.28	29.60	777.89	28.81	130+50.00	0.00	0.00	29.60	0.00	0.00	130+50.00	8.37	4.49	29.60	132.76	4.92
130+79.60	30.70	35.58	20.40	725.73	26.88	130+79.60	0.00	0.00	20.40	0.00	0.00	130+79.60	0.60	8.65	20.40	176.46	6.54
131+00.00	40.45	50.68	50.00	2,534.00	93.85	131+00.00	0.00	0.00	50.00	0.00	0.00	131+00.00	16.70	14.16	50.00	708.00	26.22
131+50.00	60.91	78.83	50.00	3,941.50	145.98	131+50.00	0.00	0.00	50.00	0.00	0.00	131+50.00	11.62	12.24	50.00	612.00	22.67
132+00.00	96.75	122.58	26.05	3,193.08	118.26	132+00.00	0.00	0.00	26.05	0.00	0.00	132+00.00	12.86	6.43	26.05	167.50	6.20
132+26.05	148.40	129.20	23.95	3,094.34	114.61	132+26.05	0.00	0.00	23.95	0.00	0.00	132+26.05	0.00	5.78	23.95	138.43	5.13
132+50.00	110.00	94.89	32.35	3,069.69	113.69	132+50.00	0.00	0.60	32.35	19.41	0.72	132+50.00	11.56	8.75	32.35	283.06	10.48
132+82.35	79.78	76.46	17.65	1,349.43	49.98	132+82.35	1.20	2.85	17.65	50.30	1.86	132+82.35	5.94	6.22	17.65	109.78	4.07
133+00.00	73.13	73.82	50.00	3,690.75	136.69	133+00.00	4.50	6.20	50.00	310.00	11.48	133+00.00	6.50	6.66	50.00	332.75	12.32
133+50.00	74.50	76.69	50.00	3,834.25	142.01	133+50.00	7.90	6.25	50.00	312.50	11.57	133+50.00	6.81	6.69	50.00	334.25	12.38
134+00.00	78.87	67.31	26.66	1,794.48	66.46	134+00.00	4.60	4.85	26.66	129.30	4.79	134+00.00	6.56	6.27	26.66	167.16	6.19
134+26.66	55.75	51.03	23.34	1,191.04	44.11	134+26.66	5.10	5.20	23.34	121.37	4.50	134+26.66	5.98	6.00	23.34	139.92	5.18
134+50.00	46.31	40.24	50.00	2,012.00	74.52	134+50.00	5.30	2.65	50.00	132.50	4.91	134+50.00	6.01	7.08	50.00	353.75	13.10
135+00.00	34.17	40.27	51.70	2,081.96	77.11	135+00.00	0.00	0.00	51.70	0.00	0.00	135+00.00	8.14	4.07	51.70	210.42	7.79
135+51.70	46.37	31.94	40.52	1,294.01	47.93	135+51.70	0.00	0.00	40.52	0.00	0.00	135+51.70	0.00	16.87	40.52	683.37	25.31
135+92.22	17.50	17.59	57.78	1,016.06	37.63	135+92.22	0.00	0.00	57.78	0.00	0.00	135+92.22	33.73	33.87	57.78	1,956.72	72.47
136+50.00	17.67	17.60	50.00	879.75	32.58	136+50.00	0.00	0.00	50.00	0.00	0.00	136+50.00	34.00	34.05	50.00	1,702.50	63.06
137+00.00	17.52	16.97	50.00	848.50	31.43	137+00.00	0.00	0.00	50.00	0.00	0.00	137+00.00	34.10	33.93	50.00	1,696.25	62.82
137+50.00	16.42	12.51	50.00	625.50	23.17	137+50.00	0.00	0.00	50.00	0.00	0.00	137+50.00	33.75	33.48	50.00	1,674.00	62.00
138+00.00	8.60	8.99	50.00	449.25	16.64	138+00.00	0.00	6.45	50.00	322.50	11.94	138+00.00	33.21	20.82	50.00	1,041.00	38.56
138+50.00	9.37	7.14	50.00	356.75	13.21	138+50.00	12.90	16.50	50.00	825.00	30.56	138+50.00	8.43	8.38	50.00	419.00	15.52
139+00.00	4.90	13.30	50.00	665.00	24.63	139+00.00	20.10	10.05	50.00	502.50	18.61	139+00.00	8.33	4.17	50.00	208.25	7.71
139+50.00	21.70	22.82	50.00	1,140.75	42.25	139+50.00	0.00	0.55	50.00	27.50	1.02	139+50.00	0.00	0.00	50.00	0.00	0.00
140+00.00	23.93	22.19	45.24	1,003.88	37.18	140+00.00	1.10	3.73	45.24	168.52	6.24	140+00.00	0.00	3.98	45.24	180.06	6.67
140+45.24	20.45	21.03	54.76	1,151.33	42.64	140+45.24	6.35	8.28	54.76	453.14	16.78	140+45.24	7.96	8.53	54.76	467.10	17.30
141+00.00	21.60	25.50	57.64	1,469.82	54.44	141+00.00	10.20	5.10	57.64	293.96	10.89	141+00.00	9.10	4.55	57.64	262.26	9.71
141+57.64	29.40	29.38	41.40	1,216.13	45.04	141+57.64	0.00	0.00	41.40	0.00	0.00	141+57.64	0.00	12.72	41.40	526.40	19.50
141+99.04	29.35	30.05	55.04	1,653.95	61.26	141+99.04	0.00	0.00	55.04	0.00	0.00	141+99.04	25.43	25.43	55.04	1,399.39	51.83
142+54.08	30.75	26.80	49.27	1,320.19	48.90	142+54.08	0.00	0.98	49.27	48.04	1.78	142+54.08	25.42	28.98	49.27	1,427.60	52.87
143+03.35	22.84	45.39	46.65	2,117.44	78.42	143+03.35	1.95	4.19	46.65	195.23	7.23	143+03.35	32.53	50.34	46.65	2,348.36	86.98

FILE NAME = FA\961-000 Genevo East State St.CADD.Sheets\961-000_SHT_SCHEDULE OF QUANTITIES.dgn



USER NAME = tnestor	DESIGNED - GJE	REVISED -
	DRAWN - GJE	REVISED -
PLOT SCALE = 48.0000' / in.	CHECKED - DBB	REVISED -
PLOT DATE = 1/13/2025	DATE - 11/7/2024	REVISED -

STATE OF ILLINOIS
DEPARTMENT OF TRANSPORTATION

ILLINOIS ROUTE 38 - EAST STATE STREET
SCHEDULE OF QUANTITIES

SCALE: SHEET 8 OF 24 SHEETS STA. TO STA.

F.A.U. RTE.	SECTION	COUNTY	TOTAL SHEETS	SHEET NO.
0347	05-00102-00-PV	KANE	488	43
CONTRACT NO. 61J84				
ILLINOIS FED. AID PROJECT				

EAST STATE STREET STAGE 1 & 2 - EARTHWORK QUANTITIES

	CUT						FILL						UNSUITABLES + TOPSOIL EXCAVATION AND PLACEMENT				
	CUT (SF)	AVE.	LENGTH	TOTAL (CF)	TOTAL (CY)		FILL (SF)	AVE.	LENGTH	TOTAL (CF)	TOTAL (CY)		UNSUIT (SF)	AVE.	LENGTH	TOTAL (CF)	TOTAL (CY)
143+50.00	67.94					143+50.00	6.42				143+50.00	68.15					
		78.27	25.89	2,026.41	75.05			3.66	25.89	94.76	3.51		71.38	25.89	1,847.90	68.44	
143+75.89	88.60					143+75.89	0.90					143+75.89	74.60				
		66.65	24.11	1,606.93	59.52			0.45	24.11	10.85	0.40		53.26	24.11	1,284.10	47.56	
144+00.00	44.70					144+00.00	0.00					144+00.00	31.92				
		40.48	50.00	2,023.75	74.95			0.00	50.00	0.00	0.00		31.62	50.00	1,581.00	58.56	
144+50.00	36.25					144+50.00	0.00					144+50.00	31.32				
		28.65	50.21	1,438.27	53.27			0.00	50.21	0.00	0.00		28.34	50.21	1,422.70	52.69	
145+00.21	21.04					145+00.21	0.00					145+00.21	25.35				
		25.98	41.13	1,068.56	39.58			0.00	41.13	0.00	0.00		12.68	41.13	521.32	19.31	
145+41.34	30.92					145+41.34	0.00					145+41.34	0.00				
		29.35	53.19	1,560.86	57.81			0.00	53.19	0.00	0.00		2.69	53.19	143.08	5.30	
145+94.53	27.77					145+94.53	0.00					145+94.53	5.38				
		26.02	46.76	1,216.46	45.05			0.70	46.76	32.73	1.21		2.69	46.76	125.78	4.66	
146+41.29	24.26					146+41.29	1.40					146+41.29	0.00				
		31.09	50.24	1,561.96	57.85			0.70	50.24	35.17	1.30		0.00	50.24	0.00	0.00	
146+91.53	37.92					146+91.53	0.00					146+91.53	0.00				
		35.46	37.22	1,319.82	48.88			0.00	37.22	0.00	0.00		2.72	37.22	101.05	3.74	
147+28.75	33.00					147+28.75	0.00					147+28.75	5.43				
		31.61	16.87	533.26	19.75			0.00	16.87	0.00	0.00		20.92	16.87	352.84	13.07	
147+45.62	30.22					147+45.62	0.00					147+45.62	36.40				
		26.94	40.87	1,100.83	40.77			1.48	40.87	60.28	2.23		39.75	40.87	1,624.58	60.17	
147+86.49	23.65					147+86.49	2.95					147+86.49	43.10				
		24.22	13.51	327.21	12.12			3.30	13.51	44.58	1.65		43.60	13.51	588.97	21.81	
148+00.00	24.79					148+00.00	3.65					148+00.00	44.09				
		27.68	56.09	1,552.57	57.50			1.93	56.09	107.97	4.00		46.50	56.09	2,607.90	96.59	
148+56.09	30.57					148+56.09	0.20					148+56.09	48.90				
		32.54	43.91	1,428.83	52.92			10.45	43.91	458.86	16.99		44.25	43.91	1,943.02	71.96	
149+00.00	34.51					149+00.00	20.70					149+00.00	39.60				
		41.46	19.73	817.91	30.29			10.35	19.73	204.21	7.56		37.30	19.73	735.93	27.26	
149+19.73	48.40					149+19.73	0.00					149+19.73	35.00				
		25.85	30.27	782.48	28.98			3.33	30.27	100.65	3.73		39.78	30.27	1,203.99	44.59	
149+50.00	3.30					149+50.00	6.65					149+50.00	44.55				
		3.35	50.00	167.50	6.20			12.63	50.00	631.25	23.38		45.36	50.00	2,267.75	83.99	
150+00.00	3.40					150+00.00	18.60					150+00.00	46.16				
		4.65	48.90	227.38	8.42			13.98	48.90	683.38	25.31		41.38	48.90	2,023.48	74.94	
150+48.90	5.90					150+48.90	9.35					150+48.90	36.60				
		4.76	51.10	243.24	9.01			6.38	51.10	325.76	12.07		38.32	51.10	1,958.15	72.52	
151+00.00	3.62					151+00.00	3.40					151+00.00	40.04				
		8.46	38.19	323.09	11.97			1.70	38.19	64.92	2.40		38.27	38.19	1,461.53	54.13	
151+38.19	13.30					151+38.19	0.00					151+38.19	36.50				
		16.10	1.56	25.12	0.93			0.15	1.56	0.23	0.01		39.77	1.56	62.03	2.30	
151+39.75	18.90					151+39.75	0.30					151+39.75	43.03				
		27.31	60.25	1,645.13	60.93			0.30	60.25	18.08	0.67		42.62	60.25	2,567.55	95.09	
152+00.00	35.71					152+00.00	0.30					152+00.00	42.20				
		40.16	50.00	2,007.75	74.36			0.15	50.00	7.50	0.28		36.75	50.00	1,837.50	68.06	
152+50.00	44.60					152+50.00	0.00					152+50.00	31.30				
		44.58	50.00	2,228.75	82.55			0.10	50.00	5.00	0.19		32.27	50.00	1,613.50	59.76	
153+00.00	44.55					153+00.00	0.20					153+00.00	33.24				
		47.83	50.00	2,391.25	88.56			0.25	50.00	12.50	0.46		34.21	50.00	1,710.25	63.34	
153+50.00	51.10					153+50.00	0.30					153+50.00	35.17				
		52.98	57.78	3,060.90	113.37			1.88	57.78	108.34	4.01		38.00	57.78	2,195.64	81.32	
154+07.78	54.85					154+07.78	3.45					154+07.78	40.83				
		52.29	42.22	2,207.47	81.76			2.85	42.22	120.33	4.46		43.07	42.22	1,818.20	67.34	
154+50.00	49.72					154+50.00	2.25					154+50.00	45.30				
		53.13	50.00	2,656.25	98.38			1.78	50.00	88.75	3.29		49.58	50.00	2,479.00	91.81	
155+00.00	56.53					155+00.00	1.30					155+00.00	53.86				
		45.12	50.00	2,255.75	83.55			2.05	50.00	102.50	3.80		53.07	50.00	2,653.50	98.28	
155+50.00	33.70					155+50.00	2.80					155+50.00	52.28				
		28.85	50.00	1,442.50	53.43			4.68	50.00	233.75	8.66		51.92	50.00	2,596.00	96.15	
156+00.00	24.00					156+00.00	6.55					156+00.00	51.56				
		21.24	50.00	1,061.75	39.32			11.18	50.00	558.75	20.69		51.41	50.00	2,570.25	95.19	
156+50.00	18.47					156+50.00	15.80					156+50.00	51.25				
		20.66	66.83	1,380.71	51.14			7.90	66.83	527.96	19.55		66.73	66.83	4,459.23	165.16	
157+16.83	22.85					157+16.83	0.00					157+16.83	82.20				
		20.75	23.30	483.47	17.91			11.98	23.30	279.02	10.33		70.17	23.30	1,634.96	60.55	
157+40.13	18.65					157+40.13	23.95					157+40.13	58.14				

FILE NAME = FA\961-000 Genevo East State St\CADD_Sheets\961-000_SHT_SCHEDULE OF QUANTITIES.dgn



USER NAME : tnestor	DESIGNED : GJE	REVISED :
DRAWN : GJE	REVISOR :	
PLOT SCALE : 48.0000' / in.	CHECKED : DBB	REVISOR :
PLOT DATE : 1/13/2025	DATE : 11/7/2024	REVISOR :

**STATE OF ILLINOIS
DEPARTMENT OF TRANSPORTATION**

ILLINOIS ROUTE 38 - EAST STATE STREET
SCHEDULE OF QUANTITIES

SCALE: SHEET 9 OF 24 SHEETS STA. TO STA.

F.A.U. RTE.	SECTION	COUNTY	TOTAL SHEETS	SHEET NO.
0347	05-00102-00-PV	KANE	488	44
CONTRACT NO. 61J84				
ILLINOIS FED. AID PROJECT				

EAST STATE STREET STAGE 1 & 2 - EARTHWORK QUANTITIES

CUT					
	CUT (SF)	AVE.	LENGTH	TOTAL (CF)	TOTAL (CY)
		20.09	15.92	319.83	11.85
157+56.05	21.53				
		26.66	43.95	1,171.71	43.40
158+00.00	31.79				
		33.95	50.00	1,697.25	62.86
158+50.00	36.10				
		37.44	50.00	1,871.75	69.32
159+00.00	38.77				
		30.18	50.00	1,509.00	55.89
159+50.00	21.59				
		21.96	50.00	1,098.00	40.67
160+00.00	22.33				
		15.17	50.00	758.25	28.08
160+50.00	8.00				
		8.48	50.00	423.75	15.69
161+00.00	8.95				
		7.26	50.00	362.75	13.44
161+50.00	5.56				
		21.63	56.48	1,221.38	45.24
162+06.48	37.69				
		31.40	43.52	1,366.53	50.61
162+50.00	25.11				
		25.37	50.00	1,268.25	46.97
163+00.00	25.62				
		27.33	50.00	1,366.50	50.61
163+50.00	29.04				
		29.28	50.00	1,464.00	54.22
164+00.00	29.52				
		33.10	50.00	1,654.75	61.29
164+50.00	36.67				
		42.23	50.00	2,111.25	78.19
165+00.00	47.78				
		54.57	50.00	2,728.25	101.05
165+50.00	61.35				
		65.60	64.00	4,198.40	155.50
166+14.00	69.85				
		69.09	36.00	2,487.24	92.12
166+50.00	68.33				
		65.41	50.00	3,270.25	121.12
167+00.00	62.48				
		46.42	50.00	2,321.00	85.96
167+50.00	30.36				
		28.08	50.00	1,404.00	52.00
168+00.00	25.80				
		25.92	50.00	1,296.00	48.00
168+50.00	26.04				
		27.39	50.00	1,369.25	50.71
169+00.00	28.73				
		29.91	50.00	1,495.50	55.39
169+50.00	31.09				
		30.34	50.00	1,516.75	56.18
170+00.00	29.58				
		30.62	50.00	1,531.00	56.70
170+50.00	31.66				
		30.88	50.00	1,544.00	57.19
171+00.00	30.10				
		41.68	50.00	2,084.00	77.19
171+50.00	53.26				
		78.96	50.00	3,947.75	146.21
172+00.00	104.65				
		74.62	50.00	3,730.75	138.18
172+50.00	44.58				
		41.42	50.00	2,071.00	76.70
173+00.00	38.26				
		37.55	50.00	1,877.25	69.53
173+50.00	36.83				
		33.29	50.00	1,664.50	61.65

FILL					
	FILL (SF)	AVE.	LENGTH	TOTAL (CF)	TOTAL (CY)
		11.98	15.92	190.64	7.06
157+56.05	0.00				
		4.33	43.95	190.08	7.04
158+00.00	8.65				
		8.23	50.00	411.25	15.23
158+50.00	7.80				
		7.10	50.00	355.00	13.15
159+00.00	6.40				
		6.10	50.00	305.00	11.30
159+50.00	5.80				
		5.10	50.00	255.00	9.44
160+00.00	4.40				
		4.53	50.00	226.25	8.38
160+50.00	4.65				
		5.00	50.00	250.00	9.26
161+00.00	5.35				
		6.38	50.00	318.75	11.81
161+50.00	7.40				
		5.00	56.48	282.40	10.46
162+06.48	2.60				
		5.33	43.52	231.74	8.58
162+50.00	8.05				
		7.83	50.00	391.25	14.49
163+00.00	7.60				
		8.00	50.00	400.00	14.81
163+50.00	8.40				
		7.12	50.00	356.00	13.19
164+00.00	5.84				
		3.82	50.00	191.00	7.07
164+50.00	1.80				
		1.60	50.00	80.00	2.96
165+00.00	1.40				
		0.70	50.00	35.00	1.30
165+50.00	0.00				
		0.00	64.00	0.00	0.00
166+14.00	0.00				
		0.00	36.00	0.00	0.00
166+50.00	0.00				
		0.00	50.00	0.00	0.00
167+00.00	0.00				
		0.50	50.00	25.00	0.93
167+50.00	1.00				
		1.40	50.00	70.00	2.59
168+00.00	1.80				
		1.45	50.00	72.50	2.69
168+50.00	1.10				
		0.95	50.00	47.50	1.76
169+00.00	0.80				
		0.40	50.00	20.00	0.74
169+50.00	0.00				
		0.00	50.00	0.00	0.00
170+00.00	0.00				
		0.00	50.00	0.00	0.00
170+50.00	0.00				
		0.00	50.00	0.00	0.00
171+00.00	0.00				
		0.00	50.00	0.00	0.00
171+50.00	0.00				
		0.00	50.00	0.00	0.00
172+00.00	0.00				
		0.45	50.00	22.50	0.83
172+50.00	0.90				
		1.00	50.00	50.00	1.85
173+00.00	1.10				
		2.90	50.00	145.00	5.37
173+50.00	4.70				
		11.75	50.00	587.50	21.76

UNSUITABLES + TOPSOIL EXCAVATION AND PLACEMENT					
	UNSUIT (SF)	AVE.	LENGTH	TOTAL (CF)	TOTAL (CY)
		70.62	15.92	1,124.27	41.64
157+56.05	83.10				
		81.24	43.95	3,570.28	132.23
158+00.00	79.37				
		66.12	50.00	3,305.75	122.44
158+50.00	52.86				
		52.80	50.00	2,640.00	97.78
159+00.00	52.74				
		46.74	50.00	2,336.75	86.55
159+50.00	40.73				
		40.23	50.00	2,011.50	74.50
160+00.00	39.73				
		25.07	50.00	1,253.25	46.42
160+50.00	10.40				
		9.30	50.00	465.00	17.22
161+00.00	8.20				
		7.90	50.00	395.00	14.63
161+50.00	7.60				
		3.80	56.48	214.62	7.95
162+06.48	0.00				
		23.35	43.52	1,016.19	37.64
162+50.00	46.70				
		45.47	50.00	2,273.25	84.19
163+00.00	44.23				
		44.15	50.00	2,207.50	81.76
163+50.00	44.07				
		44.18	50.00	2,209.00	81.81
164+00.00	44.29				
		44.63	50.00	2,231.50	82.65
164+50.00	44.97				
		25.08	50.00	1,254.00	46.44
165+00.00	5.19				
		6.88	50.00	344.00	12.74
165+50.00	8.57				
		4.29	64.00	274.24	10.16
166+14.00	0.00				
		0.45	36.00	16.20	0.60
166+50.00	0.90				
		3.75	50.00	187.50	6.94
167+00.00	6.60				
		6.82	50.00	340.75	12.62
167+50.00	7.03				
		6.87	50.00	343.25	12.71
168+00.00	6.70				
		6.51	50.00	325.25	12.05
168+50.00	6.31				
		6.01	50.00	300.25	11.12
169+00.00	5.70				
		2.85	50.00	142.50	5.28
169+50.00	0.00				
		3.41	50.00	170.50	6.31
170+00.00	6.82				
		6.51	50.00	325.50	12.06
170+50.00	6.20				
		6.05	50.00	302.50	11.20
171+00.00	5.90				
		5.72	50.00	285.75	10.58
171+50.00	5.53				
		2.77	50.00	138.25	5.12
172+00.00	0.00				
		4.65	50.00	232.50	8.61
172+50.00	9.30				
		23.00	50.00	1,150.00	42.59
173+00.00	36.70				
		37.22	50.00	1,861.00	68.93
173+50.00	37.74				
		37.96	50.00	1,898.00	70.30

FILE NAME = FA\961-000 Genevo Est. State St.CADD.Sheets\961-000_SHT_SCHEDULE OF QUANTITIES.dgn



USER NAME = tnestor	DESIGNED - GJE	REVISED -
	DRAWN - GJE	REVISED -
PLOT SCALE = 48.0000' / in.	CHECKED - DBB	REVISED -
PLOT DATE = 1/13/2025	DATE - 11/7/2024	REVISED -

STATE OF ILLINOIS
DEPARTMENT OF TRANSPORTATION

EAST STATE STREET STAGE 1 & 2 - EARTHWORK QUANTITIES

CUT					
	CUT (SF)	AVE.	LENGTH	TOTAL (CF)	TOTAL (CY)
174+00.00	29.75				
		29.34	50.00	1,466.75	54.32
174+50.00	28.92				
		28.84	50.00	1,441.75	53.40
175+00.00	28.75				
		28.69	50.00	1,434.25	53.12
175+50.00	28.62				
		28.06	19.60	549.88	20.37
175+69.60	27.49				
		21.32	36.40	776.05	28.74
176+06.00	15.15				
		8.75	44.00	385.00	14.26
176+50.00	2.35				
		3.43	50.00	171.50	6.35
177+00.00	4.51				
		7.31	50.00	365.25	13.53
177+50.00	10.10				
		8.91	30.46	271.25	10.05
177+80.46	7.71				
		4.92	19.54	96.04	3.56
178+00.00	2.12				
		2.27	50.00	113.25	4.19
178+50.00	2.41				
		2.33	50.00	116.50	4.31
179+00.00	2.25				
		8.94	50.00	446.75	16.55
179+50.00	15.62				
		11.67	50.00	583.50	21.61
180+00.00	7.72				
		5.88	50.00	293.75	10.88
180+50.00	4.03				
		5.49	50.00	274.50	10.17
181+00.00	6.95				
		13.57	50.00	678.50	25.13
181+50.00	20.19				
		19.90	50.00	995.00	36.85
182+00.00	19.61				
		17.60	50.00	879.75	32.58
182+50.00	15.58				
		14.78	50.00	739.00	27.37
183+00.00	13.98				
		8.36	50.00	417.75	15.47
183+50.00	2.73				
		1.62	50.00	80.75	2.99
184+00.00	0.50				
		0.50	50.00	25.00	0.93
184+50.00	0.50				
		1.61	50.00	80.50	2.98
185+00.00	2.72				
				TOTAL	8,774.19

FILL					
	FILL (SF)	AVE.	LENGTH	TOTAL (CF)	TOTAL (CY)
174+00.00	18.80				
		20.53	50.00	1,026.25	38.01
174+50.00	22.25				
		22.33	50.00	1,116.25	41.34
175+00.00	22.40				
		14.75	50.00	737.50	27.31
175+50.00	7.10				
		6.78	19.60	132.79	4.92
175+69.60	6.45				
		3.23	36.40	117.39	4.35
176+06.00	0.00				
		7.70	44.00	338.80	12.55
176+50.00	15.40				
		15.50	50.00	775.00	28.70
177+00.00	15.60				
		16.60	50.00	830.00	30.74
177+50.00	17.60				
		8.80	30.46	268.05	9.93
177+80.46	0.00				
		15.05	19.54	294.08	10.89
178+00.00	30.10				
		19.93	50.00	996.50	36.91
178+50.00	9.76				
		5.26	50.00	262.75	9.73
179+00.00	0.75				
		0.78	50.00	38.75	1.44
179+50.00	0.80				
		0.55	50.00	27.50	1.02
180+00.00	0.30				
		0.35	50.00	17.50	0.65
180+50.00	0.40				
		0.30	50.00	15.00	0.56
181+00.00	0.20				
		0.20	50.00	10.00	0.37
181+50.00	0.20				
		0.30	50.00	15.00	0.56
182+00.00	0.40				
		0.35	50.00	17.50	0.65
182+50.00	0.30				
		0.35	50.00	17.50	0.65
183+00.00	0.40				
		0.50	50.00	25.00	0.93
183+50.00	0.60				
		3.00	50.00	150.00	5.56
184+00.00	5.40				
		6.10	50.00	305.00	11.30
184+50.00	6.80				
		12.15	50.00	607.50	22.50
185+00.00	17.50				
				TOTAL	848.10

UNSUITABLES + TOPSOIL EXCAVATION AND PLACEMENT					
	UNSUIT (SF)	AVE.	LENGTH	TOTAL (CF)	TOTAL (CY)
174+00.00	38.18				
		38.54	50.00	1,926.75	71.36
174+50.00	38.89				
		38.82	50.00	1,941.00	71.89
175+00.00	38.75				
		24.60	50.00	1,229.75	45.55
175+50.00	10.44				
		10.21	19.60	200.02	7.41
175+69.60	9.97				
		4.99	36.40	181.45	6.72
176+06.00	0.00				
		6.93	44.00	304.92	11.29
176+50.00	13.86				
		14.32	50.00	716.00	26.52
177+00.00	14.78				
		14.55	50.00	727.50	26.94
177+50.00	14.32				
		7.16	30.46	218.09	8.08
177+80.46	0.00				
		6.98	19.54	136.29	5.05
178+00.00	13.95				
		13.38	50.00	669.00	24.78
178+50.00	12.81				
		11.63	50.00	581.50	21.54
179+00.00	10.45				
		11.32	50.00	566.00	20.96
179+50.00	12.19				
		11.68	50.00	583.75	21.62
180+00.00	11.16				
		10.92	50.00	546.00	20.22
180+50.00	10.68				
		10.52	50.00	525.75	19.47
181+00.00	10.35				
		11.35	50.00	567.25	21.01
181+50.00	12.34				
		12.30	50.00	615.00	22.78
182+00.00	12.26				
		0.00	50.00	0.00	0.00
182+50.00	10.67				
		0.00	50.00	0.00	0.00
183+00.00	10.05				
		0.00	50.00	0.00	0.00
183+50.00	8.34				
		0.00	50.00	0.00	0.00
184+00.00	9.20				
		0.00	50.00	0.00	0.00
184+50.00	10.08				
		0.00	50.00	0.00	0.00
185+00.00	16.52				
				TOTAL	5,101.01

FILE NAME = FA\961-000 Genevo East State St.CADD.Sheets\961-000_SHT_SCHEDULE OF QUANTITIES.dgn



USER NAME = tnestor	DESIGNED - GJE	REVISED -
	DRAWN - GJE	REVISED -
PLOT SCALE = 48.0000' / in.	CHECKED - DBB	REVISED -
PLOT DATE = 1/13/2025	DATE - 11/7/2024	REVISED -

STATE OF ILLINOIS
DEPARTMENT OF TRANSPORTATION

ILLINOIS ROUTE 38 - EAST STATE STREET
SCHEDULE OF QUANTITIES

SCALE: SHEET 11 OF 24 SHEETS STA. TO STA.

F.A.U. RTE.	SECTION	COUNTY	TOTAL SHEETS	SHEET NO.
0347	05-00102-00-PV	KANE	488	46
CONTRACT NO. 61J84				
ILLINOIS FED. AID PROJECT				

BENNETT STREET STAGE 1 & 2 - EARTHWORK QUANTITIES

	CUT				
	CUT (SF)	AVE.	LENGTH	TOTAL (CF)	TOTAL (CY)
321+70.00	0.00				
		0.00	30.00	0.00	0.00
322+00.00	0.00				
		0.00	33.47	0.00	0.00
322+33.47	0.00				
		2.50	41.53	103.82	3.85
322+75.00	5.00				
		5.26	25.00	131.50	4.87
323+00.00	5.52				
		5.06	50.00	253.00	9.37
323+50.00	4.60				
		4.65	50.00	232.50	8.61
324+00.00	4.70				
		4.60	17.39	79.99	2.96
324+17.39	4.50				
		9.50	32.61	309.80	11.47
324+50.00	14.50				
		15.85	50.00	792.50	29.35
325+00.00	17.20				
		18.30	50.00	915.00	33.89
325+50.00	19.40				
		31.41	50.00	1,570.50	58.17
326+00.00	43.42				
		30.12	22.00	662.53	24.54
326+22.00	16.81				
		18.20	28.00	509.60	18.87
326+50.00	19.59				
		18.47	26.00	480.09	17.78
326+76.00	17.34				
		-	-	-	-
328+00.00	27.30				
		19.28	50.00	963.75	35.69
328+50.00	11.25				
		16.52	33.65	555.73	20.58
328+83.65	21.78				
		10.89	16.35	178.05	6.59
329+00.00	0.00				
		0.00	50.00	0.00	0.00
329+50.00	0.00				
		0.00	50.00	0.00	0.00
330+00.00	0.00				
		0.00	50.00	0.00	0.00
330+50.00	0.00				
		0.00	50.00	0.00	0.00
331+00.00	0.00				
		0.00	50.00	0.00	0.00
331+50.00	0.00				
		0.00	18.95	0.00	0.00
331+68.95	0.00				
				TOTAL	286.61

	FILL				
	FILL (SF)	AVE.	LENGTH	TOTAL (CF)	TOTAL (CY)
321+70.00	0.00				
		0.00	30.00	0.00	0.00
322+00.00	0.00				
		0.00	33.47	0.00	0.00
322+33.47	0.00				
		0.00	41.53	0.00	0.00
322+75.00	0.00				
		0.00	25.00	0.00	0.00
323+00.00	0.00				
		0.00	50.00	0.00	0.00
323+50.00	0.00				
		0.00	50.00	0.00	0.00
324+00.00	0.00				
		0.10	17.39	1.74	0.06
324+17.39	0.20				
		0.20	32.61	6.52	0.24
324+50.00	0.20				
		0.45	50.00	22.50	0.83
325+00.00	0.70				
		0.45	50.00	22.50	0.83
325+50.00	0.20				
		0.20	50.00	10.00	0.37
326+00.00	0.20				
		0.35	22.00	7.70	0.29
326+22.00	0.50				
		0.50	28.00	14.00	0.52
326+50.00	0.50				
		0.50	26.00	13.00	0.48
326+76.00	0.50				
		-	-	-	-
328+00.00	0.60				
		1.15	50.00	57.50	2.13
328+50.00	1.70				
		1.35	33.65	45.43	1.68
328+83.65	1.00				
		0.50	16.35	8.17	0.30
329+00.00	0.00				
		0.00	50.00	0.00	0.00
329+50.00	0.00				
		0.00	50.00	0.00	0.00
330+00.00	0.00				
		0.00	50.00	0.00	0.00
330+50.00	0.00				
		0.00	50.00	0.00	0.00
331+00.00	0.00				
		0.00	50.00	0.00	0.00
331+50.00	0.00				
		0.00	18.95	0.00	0.00
331+68.95	0.00				
				TOTAL	7.74

	UNSUITABLES				
	UNSUIT (SF)	AVE.	LENGTH	TOTAL (CF)	TOTAL (CY)
321+70.00	0.00				
		0.00	30.00	0.00	0.00
322+00.00	0.00				
		0.00	33.47	0.00	0.00
322+33.47	0.00				
		1.05	41.53	43.61	1.62
322+75.00	2.10				
		2.05	25.00	51.25	1.90
323+00.00	2.00				
		1.30	50.00	65.00	2.41
323+50.00	0.60				
		1.05	50.00	52.50	1.94
324+00.00	1.50				
		1.45	17.39	25.22	0.93
324+17.39	1.40				
		2.80	32.61	91.31	3.38
324+50.00	4.20				
		2.10	50.00	105.00	3.89
325+00.00	0.00				
		0.00	50.00	0.00	0.00
325+50.00	0.00				
		0.00	50.00	0.00	0.00
326+00.00	0.00				
		0.00	22.00	0.00	0.00
326+22.00	0.00				
		2.14	28.00	59.92	2.22
326+50.00	4.28				
		4.37	26.00	113.49	4.20
326+76.00	4.45				
		-	-	-	-
328+00.00	16.88				
		16.42	50.00	821.00	30.41
328+50.00	15.96				
		9.18	33.65	308.91	11.44
328+83.65	2.40				
		1.20	16.35	19.62	0.73
329+00.00	0.00				
		0.00	50.00	0.00	0.00
329+50.00	0.00				
		0.00	50.00	0.00	0.00
330+00.00	0.00				
		0.00	50.00	0.00	0.00
330+50.00	0.00				
		0.00	50.00	0.00	0.00
331+00.00	0.00				
		0.00	50.00	0.00	0.00
331+50.00	0.00				
		0.00	18.95	0.00	0.00
331+68.95	0.00				
				TOTAL	65.07

FILE NAME = FA\961-000 Genevo East State St.CADD.Sheets\961-000_SHT_SCHEDULE OF QUANTITIES.dgn



USER NAME = tnestor	DESIGNED - GJE	REVISED -
	DRAWN - GJE	REVISED -
PLOT SCALE = 48.0000' / in.	CHECKED - DBB	REVISED -
PLOT DATE = 1/13/2025	DATE - 11/7/2024	REVISED -

STATE OF ILLINOIS
DEPARTMENT OF TRANSPORTATION

ILLINOIS ROUTE 38 - EAST STATE STREET
SCHEDULE OF QUANTITIES

SCALE: SHEET 12 OF 24 SHEETS STA. TO STA.

F.A.U. RTE.	SECTION	COUNTY	TOTAL SHEETS	SHEET NO.
0347	05-00102-00-PV	KANE	488	47
			CONTRACT NO. 61J84	
ILLINOIS FED. AID PROJECT				

EAST STATE STREET - STAGE 3 & 3A EARTHWORK QUANTITIES

	CUT				
	CUT (SF)	AVE.	LENGTH	TOTAL (CF)	TOTAL (CY)
118+06.93	31.73				
118+63.89	57.44	44.59	56.96	2,539.56	94.06
119+06.15	53.67	55.56	42.26	2,347.75	86.95
119+50.00	68.76	61.22	43.85	2,684.28	99.42
120+00.00	108.70	88.73	50.00	4,436.50	164.31
120+25.00	95.30	102.00	25.00	2,550.00	94.44
120+50.00	80.11	87.71	25.00	2,192.63	81.21
121+00.00	42.88	61.50	50.00	3,074.75	113.88
121+20.90	44.04	43.46	20.90	908.31	33.64
121+50.00	45.70	44.87	29.10	1,305.72	48.36
121+69.88	53.92	49.81	19.88	990.22	36.67
121+85.26	49.31	51.62	15.38	793.84	29.40
122+00.00	49.00	49.16	14.74	724.54	26.83
122+50.00	64.81	56.91	50.00	2,845.25	105.38
122+70.46	224.14	144.48	20.46	2,955.96	109.48
123+00.00	67.75	145.95	29.54	4,311.22	159.67
123+15.75	65.19	66.47	15.75	1,046.90	38.77
123+50.00	60.47	62.83	34.25	2,151.93	79.70
124+12.57	112.91	86.69	62.57	5,424.19	200.90
124+50.00	84.82	98.87	37.43	3,700.52	137.06
124+89.45	72.15	78.49	39.45	3,096.23	114.68
125+00.00	75.90	74.03	10.55	780.96	28.92
125+50.76	112.73	94.32	50.76	4,787.43	177.31
125+71.73	86.34	99.54	20.97	2,087.25	77.31
126+00.00	92.43	89.39	28.27	2,526.91	93.59
126+50.00	106.52	99.48	50.00	4,973.75	184.21
127+00.00	138.54	122.53	50.00	6,126.50	226.91
127+25.85	121.50	130.02	25.85	3,361.02	124.48
127+50.00	79.84	100.67	24.15	2,431.18	90.04
128+00.00	44.26	62.05	50.00	3,102.50	114.91
128+26.22	42.27	43.27	26.22	1,134.41	42.02
128+50.00	30.04	36.16	23.78	859.77	31.84
128+85.51	21.41	25.73	35.51	913.49	33.83
129+00.00	20.18	20.80	14.49	301.32	11.16

	FILL				
	FILL (SF)	AVE.	LENGTH	TOTAL (CF)	TOTAL (CY)
118+06.93	0.30				
118+63.89	0.00	0.15	56.96	8.54	0.32
119+06.15	0.70	0.35	42.26	14.79	0.55
119+50.00	0.00	0.35	43.85	15.35	0.57
120+00.00	0.00	0.00	50.00	0.00	0.00
120+25.00	0.00	0.00	25.00	0.00	0.00
120+50.00	0.00	0.00	25.00	0.00	0.00
121+00.00	0.00	0.00	50.00	0.00	0.00
121+20.90	0.00	0.00	20.90	0.00	0.00
121+50.00	0.00	0.00	29.10	0.00	0.00
121+69.88	0.00	0.00	19.88	0.00	0.00
121+85.26	0.00	0.00	15.38	0.00	0.00
122+00.00	0.00	0.00	14.74	0.00	0.00
122+50.00	0.00	0.00	50.00	0.00	0.00
122+70.46	0.00	0.00	20.46	0.00	0.00
123+00.00	33.70	16.85	29.54	497.75	18.44
123+15.75	17.95	25.83	15.75	406.74	15.06
123+50.00	6.70	12.33	34.25	422.13	15.63
124+12.57	0.00	3.35	62.57	209.61	7.76
124+50.00	0.00	0.00	37.43	0.00	0.00
124+89.45	0.00	0.00	39.45	0.00	0.00
125+00.00	0.00	0.00	10.55	0.00	0.00
125+50.76	0.00	0.00	50.76	0.00	0.00
125+71.73	0.00	0.00	20.97	0.00	0.00
126+00.00	0.00	0.00	28.27	0.00	0.00
126+50.00	0.00	0.00	50.00	0.00	0.00
127+00.00	0.00	0.00	50.00	0.00	0.00
127+25.85	4.90	2.45	25.85	63.33	2.35
127+50.00	0.00	2.45	24.15	59.17	2.19
128+00.00	5.20	2.60	50.00	130.00	4.81
128+26.22	0.00	2.60	26.22	68.17	2.52
128+50.00	15.50	7.75	23.78	184.30	6.83
128+85.51	2.90	9.20	35.51	326.69	12.10
129+00.00	12.50	7.70	14.49	111.57	4.13

	UNSUITABLES + TOPSOIL EXCAVATION AND PLACEMENT				
	UNSUIT (SF)	AVE.	LENGTH	TOTAL (CF)	TOTAL (CY)
118+06.93	40.50				
118+63.89	64.51	52.51	56.96	2,990.68	110.77
119+06.15	40.77	52.64	42.26	2,224.57	82.39
119+50.00	41.88	41.33	43.85	1,812.10	67.11
120+00.00	63.19	52.54	50.00	2,626.75	97.29
120+25.00	65.14	64.17	25.00	1,604.13	59.41
120+50.00	72.28	68.71	25.00	1,717.75	63.62
121+00.00	0.00	36.14	50.00	1,807.00	66.93
121+20.90	8.03	4.02	20.90	83.91	3.11
121+50.00	7.99	8.01	29.10	233.09	8.63
121+69.88	7.48	7.74	19.88	153.77	5.70
121+85.26	0.00	3.74	15.38	57.52	2.13
122+00.00	6.92	3.46	14.74	51.00	1.89
122+50.00	8.73	7.83	50.00	391.25	14.49
122+70.46	0.00	4.37	20.46	89.31	3.31
123+00.00	8.84	4.42	29.54	130.57	4.84
123+15.75	7.62	8.23	15.75	129.62	4.80
123+50.00	5.81	6.72	34.25	229.99	8.52
124+12.57	0.00	2.91	62.57	181.77	6.73
124+50.00	11.16	5.58	37.43	208.86	7.74
124+89.45	7.28	9.22	39.45	363.73	13.47
125+00.00	7.40	7.34	10.55	77.44	2.87
125+50.76	0.00	3.70	50.76	187.81	6.96
125+71.73	8.77	4.39	20.97	91.95	3.41
126+00.00	8.29	8.53	28.27	241.14	8.93
126+50.00	8.58	8.44	50.00	421.75	15.62
127+00.00	0.00	4.29	50.00	214.50	7.94
127+25.85	2.95	1.48	25.85	38.13	1.41
127+50.00	8.25	5.60	24.15	135.24	5.01
128+00.00	6.94	7.60	50.00	379.75	14.06
128+26.22	0.00	3.47	26.22	90.98	3.37
128+50.00	9.10	4.55	23.78	108.20	4.01
128+85.51	0.00	4.55	35.51	161.57	5.98
129+00.00	11.11	5.56	14.49	80.49	2.98

FILE NAME = FA\961-000 Genevo East State St.CADD.Sheets\961-000_SHT_SCHEDULE OF QUANTITIES.dgn



USER NAME = tnestor	DESIGNED - GJE	REVISED -
	DRAWN - GJE	REVISED -
PLOT SCALE = 48.0000' / in.	CHECKED - DBB	REVISED -
PLOT DATE = 1/13/2025	DATE - 11/7/2024	REVISED -

STATE OF ILLINOIS
DEPARTMENT OF TRANSPORTATION

ILLINOIS ROUTE 38 – EAST STATE STREET		
SCHEDULE OF QUANTITIES		
SCALE:	SHEET 13 OF 24 SHEETS	STA. TO STA.

F.A.U. RTE. 0347	SECTION 05-00102-00-PV	COUNTY KANE	TOTAL SHEETS 488	SHEET NO. 48
CONTRACT NO. 61J84				
ILLINOIS FED. AID PROJECT				

EAST STATE STREET - STAGE 3 & 3A EARTHWORK QUANTITIES

	CUT				
	CUT (SF)	AVE.	LENGTH	TOTAL (CF)	TOTAL (CY)
		17.81	50.00	890.25	32.97
129+50.00	15.43				
		14.80	31.61	467.67	17.32
129+81.61	14.16				
		14.38	18.39	264.45	9.79
130+00.00	14.60				
		25.85	50.00	1,292.50	47.87
130+50.00	37.10				
		58.36	29.60	1,727.31	63.97
130+79.60	79.61				
		67.44	20.40	1,375.67	50.95
131+00.00	55.26				
		57.38	50.00	2,868.75	106.25
131+50.00	59.49				
		69.31	50.00	3,465.50	128.35
132+00.00	79.13				
		77.86	26.05	2,028.12	75.12
132+26.05	76.58				
		85.80	23.95	2,054.79	76.10
132+50.00	95.01				
		106.82	32.35	3,455.47	127.98
132+82.35	118.62				
		111.38	17.65	1,965.77	72.81
133+00.00	104.13				
		107.74	50.00	5,386.75	199.51
133+50.00	111.34				
		116.77	50.00	5,838.50	216.24
134+00.00	122.20				
		108.99	26.66	2,905.67	107.62
134+26.66	95.78				
		88.37	23.34	2,062.56	76.39
134+50.00	80.96				
		65.68	50.00	3,283.75	121.62
135+00.00	50.39				
		43.21	51.70	2,233.96	82.74
135+51.70	36.03				
		35.05	48.30	1,692.67	62.69
136+00.00	34.06				
		24.33	50.00	1,216.25	45.05
136+50.00	14.59				
		12.92	50.00	646.00	23.93
137+00.00	11.25				
		8.33	50.00	416.25	15.42
137+50.00	5.40				
		5.46	50.00	273.00	10.11
138+00.00	5.52				
		4.39	50.00	219.50	8.13
138+50.00	3.26				
		11.58	50.00	579.00	21.44
139+00.00	19.90				
		21.70	50.00	1,085.00	40.19
139+50.00	23.50				
		29.04	50.00	1,452.00	53.78
140+00.00	34.58				
		35.70	45.24	1,614.84	59.81
140+45.24	36.81				
		36.86	54.76	2,018.18	74.75
141+00.00	36.90				
		36.80	57.64	2,121.15	78.56
141+57.64	36.70				
		32.70	41.40	1,353.78	50.14
141+99.04	28.70				
		33.95	55.04	1,868.61	69.21
142+54.08	39.20				
		37.60	49.27	1,852.55	68.61
143+03.35	36.00				
		38.40	46.65	1,791.36	66.35

	FILL				
	FILL (SF)	AVE.	LENGTH	TOTAL (CF)	TOTAL (CY)
		13.38	50.00	668.75	24.77
129+50.00	14.25				
		13.58	31.61	429.11	15.89
129+81.61	12.90				
		11.90	18.39	218.84	8.11
130+00.00	10.90				
		6.10	50.00	305.00	11.30
130+50.00	1.30				
		0.65	29.60	19.24	0.71
130+79.60	0.00				
		0.00	20.40	0.00	0.00
131+00.00	0.00				
		0.00	50.00	0.00	0.00
131+50.00	0.00				
		0.00	50.00	0.00	0.00
132+00.00	0.00				
		0.00	26.05	0.00	0.00
132+26.05	0.00				
		0.00	23.95	0.00	0.00
132+50.00	0.00				
		0.00	32.35	0.00	0.00
132+82.35	0.00				
		2.54	17.65	44.74	1.66
133+00.00	5.07				
		3.76	50.00	188.00	6.96
133+50.00	2.45				
		5.30	50.00	265.00	9.81
134+00.00	8.15				
		4.08	26.66	108.64	4.02
134+26.66	0.00				
		0.00	23.34	0.00	0.00
134+50.00	0.00				
		0.00	50.00	0.00	0.00
135+00.00	0.00				
		0.00	51.70	0.00	0.00
135+51.70	0.00				
		0.00	40.52	0.00	0.00
136+00.00	0.00				
		0.00	57.78	0.00	0.00
136+50.00	0.00				
		0.20	50.00	10.00	0.37
137+00.00	0.40				
		1.45	50.00	72.50	2.69
137+50.00	2.50				
		2.05	50.00	102.50	3.80
138+00.00	1.60				
		16.97	50.00	848.50	31.43
138+50.00	32.34				
		29.57	50.00	1,478.50	54.76
139+00.00	26.80				
		18.35	50.00	917.50	33.98
139+50.00	9.90				
		5.45	50.00	272.50	10.09
140+00.00	1.00				
		0.98	45.24	44.11	1.63
140+45.24	0.95				
		0.68	54.76	36.96	1.37
141+00.00	0.40				
		0.20	57.64	11.53	0.43
141+57.64	0.00				
		0.25	41.40	10.35	0.38
141+99.04	0.50				
		0.60	55.04	33.02	1.22
142+54.08	0.70				
		0.35	49.27	17.24	0.64
143+03.35	0.00				
		0.10	46.65	4.66	0.17

	UNSUITABLES + TOPSOIL EXCAVATION AND PLACEMENT				
	UNSUIT (SF)	AVE.	LENGTH	TOTAL (CF)	TOTAL (CY)
		11.12	50.00	556.00	20.59
129+50.00	11.13				
		11.13	31.61	351.82	13.03
129+81.61	11.13				
		11.14	18.39	204.77	7.58
130+00.00	11.14				
		7.82	50.00	391.00	14.48
130+50.00	4.50				
		2.25	29.60	66.60	2.47
130+79.60	0.00				
		4.28	20.40	87.31	3.23
131+00.00	8.56				
		7.83	50.00	391.50	14.50
131+50.00	7.10				
		7.21	50.00	360.50	13.35
132+00.00	7.32				
		6.81	26.05	177.40	6.57
132+26.05	6.30				
		3.15	23.95	75.44	2.79
132+50.00	0.00				
		0.00	32.35	0.00	0.00
132+82.35	0.00				
		4.55	17.65	80.31	2.97
133+00.00	9.10				
		8.87	50.00	443.25	16.42
133+50.00	8.63				
		10.85	50.00	542.50	20.09
134+00.00	13.07				
		6.54	26.66	174.22	6.45
134+26.66	0.00				
		2.55	23.34	59.52	2.20
134+50.00	5.10				
		7.49	50.00	374.50	13.87
135+00.00	9.88				
		7.80	51.70	403.26	14.94
135+51.70	5.72				
		21.26	40.52	861.46	31.91
136+00.00	36.80				
		38.86	57.78	2,245.33	83.16
136+50.00	40.92				
		40.72	50.00	2,036.00	75.41
137+00.00	40.52				
		38.53	50.00	1,926.25	71.34
137+50.00	36.53				
		37.72	50.00	1,885.75	69.84
138+00.00	38.90				
		20.25	50.00	1,012.50	37.50
138+50.00	1.60				
		2.60	50.00	130.00	4.81
139+00.00	3.60				
		10.33	50.00	516.25	19.12
139+50.00	17.05				
		11.61	50.00	580.50	21.50
140+00.00	6.17				
		4.80	45.24	217.15	8.04
140+45.24	3.43				
		4.93	54.76	269.69	9.99
141+00.00	6.42				
		3.21	57.64	185.02	6.85
141+57.64	0.00				
		21.58	41.40	893.41	33.09
141+99.04	43.16				
		43.32	55.04	2,384.33	88.31
142+54.08	43.48				
		40.14	49.27	1,977.70	73.25
143+03.35	36.80				
		37.70	46.65	1,758.70	65.14

FILE NAME = FA\961-000 Genevo East State St\CAADD_Sheets\961-000_SHT_SCHEDULE OF QUANTITIES.dgn



USER NAME = tnestor	DESIGNED - GJE	REVISED -
	DRAWN - GJE	REVISED -
PLOT SCALE = 48.0000' / in.	CHECKED - DBB	REVISED -
PLOT DATE = 1/13/2025	DATE - 11/7/2024	REVISED -

STATE OF ILLINOIS
DEPARTMENT OF TRANSPORTATION

ILLINOIS ROUTE 38 - EAST STATE STREET
SCHEDULE OF QUANTITIES

SCALE: SHEET 14 OF 24 SHEETS STA. TO STA.

F.A.U. RTE.	SECTION	COUNTY	TOTAL SHEETS	SHEET NO.
0347	05-00102-00-PV	KANE	488	49
CONTRACT NO. 61J84				
ILLINOIS FED. AID PROJECT				

EAST STATE STREET - STAGE 3 & 3A EARTHWORK QUANTITIES

STATION	CUT					STATION	FILL					STATION	UNSUITABLES + TOPSOIL EXCAVATION AND PLACEMENT				
	CUT (SF)	AVE.	LENGTH	TOTAL (CF)	TOTAL (CY)		FILL (SF)	AVE.	LENGTH	TOTAL (CF)	TOTAL (CY)		UNSUITS (SF)	AVE.	LENGTH	TOTAL (CF)	TOTAL (CY)
143+50.00	40.80					143+50.00	0.20				143+50.00	38.60					
		45.59	25.89	1,180.20	43.71			0.10	25.89	2.59	0.10		37.70	25.89	976.05	36.15	
143+75.89	50.37					143+75.89	0.00					143+75.89	36.80				
		51.56	24.11	1,243.11	46.04			0.25	24.11	6.03	0.22		36.80	24.11	887.25	32.86	
144+00.00	52.75					144+00.00	0.50					144+00.00	36.80				
		50.03	50.00	2,501.25	92.64			0.25	50.00	12.50	0.46		39.59	50.00	1,979.25	73.31	
144+50.00	47.30					144+50.00	0.00					144+50.00	42.37				
		37.54	50.21	1,884.88	69.81			0.00	50.21	0.00	0.00		40.54	50.21	2,035.26	75.38	
145+00.21	27.78					145+00.21	0.00					145+00.21	38.70				
		33.47	41.13	1,376.62	50.99			0.00	41.13	0.00	0.00		19.35	41.13	795.87	29.48	
145+41.34	39.16					145+41.34	0.00					145+41.34	0.00				
		38.14	53.19	2,028.40	75.13			0.05	53.19	2.66	0.10		0.15	53.19	7.98	0.30	
145+94.53	37.11					145+94.53	0.10					145+94.53	0.30				
		35.83	46.76	1,675.18	62.04			0.70	46.76	32.73	1.21		0.15	46.76	7.01	0.26	
146+41.29	34.54					146+41.29	1.30					146+41.29	0.00				
		29.00	50.24	1,456.71	53.95			1.35	50.24	67.82	2.51		0.00	50.24	0.00	0.00	
146+91.53	23.45					146+91.53	1.40					146+91.53	0.00				
		22.01	37.22	819.03	30.33			1.65	37.22	61.41	2.27		0.00	37.22	0.00	0.00	
147+28.75	20.56					147+28.75	1.90					147+28.75	0.00				
		22.51	16.87	379.66	14.06			1.40	16.87	23.62	0.87		15.53	16.87	261.91	9.70	
147+45.62	24.45					147+45.62	0.90					147+45.62	31.05				
		21.02	40.87	858.88	31.81			1.00	40.87	40.87	1.51		29.23	40.87	1,194.43	44.24	
147+86.49	17.58					147+86.49	1.10					147+86.49	27.40				
		17.99	13.51	243.04	9.00			1.45	13.51	19.59	0.73		29.14	13.51	393.68	14.58	
148+00.00	18.40					148+00.00	1.80					148+00.00	30.88				
		21.50	56.09	1,205.94	44.66			4.20	56.09	235.58	8.73		30.29	56.09	1,698.97	62.92	
148+56.09	24.60					148+56.09	6.60					148+56.09	29.70				
		21.60	43.91	948.46	35.13			3.50	43.91	153.68	5.69		29.22	43.91	1,282.83	47.51	
149+00.00	18.60					149+00.00	0.40					149+00.00	28.73				
		19.50	19.73	384.64	14.25			1.13	19.73	22.20	0.82		31.19	19.73	615.38	22.79	
149+19.73	20.39					149+19.73	1.85					149+19.73	33.65				
		18.37	30.27	555.91	20.59			2.03	30.27	61.30	2.27		32.92	30.27	996.34	36.90	
149+50.00	16.34					149+50.00	2.20					149+50.00	32.18				
		13.52	50.00	676.00	25.04			4.65	50.00	232.50	8.61		32.28	50.00	1,613.75	59.77	
150+00.00	10.70					150+00.00	7.10					150+00.00	32.37				
		9.88	48.90	482.89	17.88			5.25	48.90	256.72	9.51		32.08	48.90	1,568.47	58.09	
150+48.90	9.05					150+48.90	3.40					150+48.90	31.78				
		15.60	51.10	796.90	29.51			1.85	51.10	94.54	3.50		36.51	51.10	1,865.66	69.10	
151+00.00	22.14					151+00.00	0.30					151+00.00	41.24				
		41.39	38.19	1,580.49	58.54			0.15	38.19	5.73	0.21		40.60	38.19	1,550.32	57.42	
151+38.19	60.63					151+38.19	0.00					151+38.19	39.95				
		60.63	1.56	94.58	3.50			0.00	1.56	0.00	0.00		39.95	1.56	62.32	2.31	
151+39.75	60.63					151+39.75	0.00					151+39.75	39.95				
		95.48	60.25	5,752.37	213.05			0.70	60.25	42.18	1.56		56.70	60.25	3,416.18	126.53	
152+00.00	130.32					152+00.00	1.40					152+00.00	73.45				
		135.70	50.00	6,785.00	251.30			0.70	50.00	35.00	1.30		66.96	50.00	3,348.00	124.00	
152+50.00	141.08					152+50.00	0.00					152+50.00	60.47				
		159.93	50.00	7,996.25	296.16			0.00	50.00	0.00	0.00		60.69	50.00	3,034.25	112.38	
153+00.00	178.77					153+00.00	0.00					153+00.00	60.90				
		168.79	50.00	8,439.25	312.56			0.20	50.00	10.00	0.37		55.91	50.00	2,795.50	103.54	
153+50.00	158.80					153+50.00	0.40					153+50.00	50.92				
		174.80	57.78	10,099.94	374.07			0.20	57.78	11.56	0.43		57.38	57.78	3,315.13	122.78	
154+07.78	190.80					154+07.78	0.00					154+07.78	63.83				
		159.18	42.22	6,720.37	248.90			0.00	42.22	0.00	0.00		56.20	42.22	2,372.55	87.87	
154+50.00	127.55					154+50.00	0.00					154+50.00	48.56				
		109.86	50.00	5,493.00	203.44			0.00	50.00	0.00	0.00		45.79	50.00	2,289.50	84.80	
155+00.00	92.17					155+00.00	0.00					155+00.00	43.02				
		92.08	50.00	4,603.75	170.51			0.00	50.00	0.00	0.00		41.11	50.00	2,055.25	76.12	
155+50.00	91.98					155+50.00	0.00					155+50.00	39.19				
		93.08	50.00	4,654.00	172.37			0.00	50.00	0.00	0.00		37.67	50.00	1,883.25	69.75	
156+00.00	94.18					156+00.00	0.00					156+00.00	36.14				
		96.71	50.00	4,835.50	179.09			0.00	50.00	0.00	0.00		35.48	50.00	1,773.75	65.69	
156+50.00	99.24					156+50.00	0.00					156+50.00	34.81				
		84.17	66.83	5,625.08	208.34			0.00	66.83	0.00	0.00		32.78	66.83	2,190.69	81.14	
157+16.83	69.10					157+16.83	0.00					157+16.83	30.75				
		93.00	23.30	2,166.90	80.26			0.10	23.30	2.33	0.09		29.28	23.30	682.11	25.26	
157+40.13	116.90					157+40.13	0.20					157+40.13	27.80				

FILE NAME = FA\961-000 Genevo East State St.CADD.Sheets\961-000_SHT_SCHEDULE OF QUANTITIES.dgn

	USER NAME = tnestor	DESIGNED - GJE	REVISED -	STATE OF ILLINOIS DEPARTMENT OF TRANSPORTATION	ILLINOIS ROUTE 38 - EAST STATE STREET SCHEDULE OF QUANTITIES			F.A.U RTE. 0347	SECTION 05-00102-00-PV	COUNTY KANE	TOTAL SHEETS 488	SHEET NO. 50
	PLOT SCALE = 48.0000' / in.	CHECKED - DBB	REVISED -					CONTRACT NO. 61J84				
	PLOT DATE = 1/13/2025	DATE - 11/7/2024	REVISED -		SCALE:	SHEET 15 OF 24 SHEETS	STA.	TO STA.	ILLINOIS FED. AID PROJECT			

EAST STATE STREET - STAGE 3 & 3A EARTHWORK QUANTITIES

STATION	CUT				
	CUT (SF)	AVE.	LENGTH	TOTAL (CF)	TOTAL (CY)
		111.67	15.92	1,777.79	65.84
157+56.05	106.44				
		107.82	43.95	4,738.69	175.51
158+00.00	109.20				
		109.09	50.00	5,454.50	202.02
158+50.00	108.98				
		131.52	50.00	6,575.75	243.55
159+00.00	154.05				
		138.48	50.00	6,924.00	256.44
159+50.00	122.91				
		128.46	50.00	6,422.75	237.88
160+00.00	134.00				
		119.57	50.00	5,978.25	221.42
160+50.00	105.13				
		98.77	50.00	4,938.50	182.91
161+00.00	92.41				
		89.17	50.00	4,458.50	165.13
161+50.00	85.93				
		87.07	56.48	4,917.43	182.13
162+06.48	88.20				
		87.68	43.52	3,815.62	141.32
162+50.00	87.15				
		82.35	50.00	4,117.50	152.50
163+00.00	77.55				
		72.63	50.00	3,631.25	134.49
163+50.00	67.70				
		59.65	50.00	2,982.50	110.46
164+00.00	51.60				
		52.25	50.00	2,612.50	96.76
164+50.00	52.90				
		59.10	50.00	2,955.00	109.44
165+00.00	65.30				
		70.70	50.00	3,535.00	130.93
165+50.00	76.10				
		81.39	64.00	5,208.64	192.91
166+14.00	86.67				
		86.07	36.00	3,098.34	114.75
166+50.00	85.46				
		82.96	50.00	4,147.75	153.62
167+00.00	80.45				
		72.85	50.00	3,642.25	134.90
167+50.00	65.24				
		59.63	50.00	2,981.25	110.42
168+00.00	54.01				
		48.74	50.00	2,436.75	90.25
168+50.00	43.46				
		44.94	50.00	2,247.00	83.22
169+00.00	46.42				
		38.70	50.00	1,935.00	71.67
169+50.00	30.98				
		30.86	50.00	1,543.00	57.15
170+00.00	30.74				
		33.37	50.00	1,668.50	61.80
170+50.00	36.00				
		39.49	50.00	1,974.50	73.13
171+00.00	42.98				
		48.71	50.00	2,435.25	90.19
171+50.00	54.43				
		67.29	50.00	3,364.25	124.60
172+00.00	80.14				
		65.39	50.00	3,269.50	121.09
172+50.00	50.64				
		50.51	50.00	2,525.25	93.53
173+00.00	50.37				
		50.74	50.00	2,536.75	93.95
173+50.00	51.10				
		48.80	50.00	2,440.00	90.37

STATION	FILL				
	FILL (SF)	AVE.	LENGTH	TOTAL (CF)	TOTAL (CY)
		0.10	15.92	1.59	0.06
157+56.05	0.00				
		0.00	43.95	0.00	0.00
158+00.00	0.00				
		0.00	50.00	0.00	0.00
158+50.00	0.00				
		0.00	50.00	0.00	0.00
159+00.00	0.00				
		0.00	50.00	0.00	0.00
159+50.00	0.00				
		0.00	50.00	0.00	0.00
160+00.00	0.00				
		0.00	50.00	0.00	0.00
160+50.00	0.00				
		0.00	50.00	0.00	0.00
161+00.00	0.00				
		0.00	50.00	0.00	0.00
161+50.00	0.00				
		0.00	56.48	0.00	0.00
162+06.48	0.00				
		0.00	43.52	0.00	0.00
162+50.00	0.00				
		0.00	50.00	0.00	0.00
163+00.00	0.00				
		0.00	50.00	0.00	0.00
163+50.00	0.00				
		1.15	50.00	57.50	2.13
164+00.00	2.30				
		1.50	50.00	75.00	2.78
164+50.00	0.70				
		0.35	50.00	17.50	0.65
165+00.00	0.00				
		0.00	50.00	0.00	0.00
165+50.00	0.00				
		0.00	64.00	0.00	0.00
166+14.00	0.00				
		0.00	36.00	0.00	0.00
166+50.00	0.00				
		0.00	50.00	0.00	0.00
167+00.00	0.00				
		0.43	50.00	21.25	0.79
167+50.00	0.85				
		0.43	50.00	21.25	0.79
168+00.00	0.00				
		0.13	50.00	6.25	0.23
168+50.00	0.25				
		0.30	50.00	15.00	0.56
169+00.00	0.35				
		2.93	50.00	146.25	5.42
169+50.00	5.50				
		4.23	50.00	211.25	7.82
170+00.00	2.95				
		4.00	50.00	199.75	7.40
170+50.00	5.04				
		2.52	50.00	126.00	4.67
171+00.00	0.00				
		0.00	50.00	0.00	0.00
171+50.00	0.00				
		0.00	50.00	0.00	0.00
172+00.00	0.00				
		1.49	50.00	74.50	2.76
172+50.00	2.98				
		1.90	50.00	95.00	3.52
173+00.00	0.82				
		0.90	50.00	45.00	1.67
173+50.00	0.98				
		1.34	50.00	67.00	2.48

STATION	UNSUITABLES + TOPSOIL EXCAVATION AND PLACEMENT				
	UNSUIT (SF)	AVE.	LENGTH	TOTAL (CF)	TOTAL (CY)
		27.80	15.92	442.58	16.39
157+56.05	27.80				
		31.21	43.95	1,371.68	50.80
158+00.00	34.62				
		34.53	50.00	1,726.25	63.94
158+50.00	34.43				
		49.33	50.00	2,466.25	91.34
159+00.00	64.22				
		51.12	50.00	2,555.75	94.66
159+50.00	38.01				
		37.44	50.00	1,871.75	69.32
160+00.00	36.86				
		23.13	50.00	1,156.50	42.83
160+50.00	9.40				
		8.96	50.00	448.00	16.59
161+00.00	8.52				
		8.56	50.00	428.00	15.85
161+50.00	8.60				
		6.79	56.48	383.22	14.19
162+06.48	4.97				
		20.49	43.52	891.51	33.02
162+50.00	36.00				
		36.23	50.00	1,811.50	67.09
163+00.00	36.46				
		36.43	50.00	1,821.50	67.46
163+50.00	36.40				
		35.92	50.00	1,795.75	66.51
164+00.00	35.43				
		35.03	50.00	1,751.25	64.86
164+50.00	34.62				
		21.66	50.00	1,083.00	40.11
165+00.00	8.70				
		8.14	50.00	406.75	15.06
165+50.00	7.57				
		3.79	64.00	242.24	8.97
166+14.00	0.00				
		4.35	36.00	156.60	5.80
166+50.00	8.70				
		8.65	50.00	432.50	16.02
167+00.00	8.60				
		8.65	50.00	432.50	16.02
167+50.00	8.70				
		8.70	50.00	435.00	16.11
168+00.00	8.70				
		8.58	50.00	428.75	15.88
168+50.00	8.45				
		8.49	50.00	424.50	15.72
169+00.00	8.53				
		8.76	50.00	437.75	16.21
169+50.00	8.98				
		9.59	50.00	479.50	17.76
170+00.00	10.20				
		9.60	50.00	480.00	17.78
170+50.00	9.00				
		8.60	50.00	430.00	15.93
171+00.00	8.20				
		9.00	50.00	450.00	16.67
171+50.00	9.80				
		4.90	50.00	245.00	9.07
172+00.00	0.00				
		3.31	50.00	165.50	6.13
172+50.00	6.62				
		26.37	50.00	1,318.50	48.83
173+00.00	46.12				
		46.07	50.00	2,303.50	85.31
173+50.00	46.02				
		46.34	50.00	2,316.75	85.81

FILE NAME = FA\961-000 Genevo East State St.CADD.Sheets\961-000_SHT_SCHEDULE OF QUANTITIES.dgn



USER NAME = tnestor	DESIGNED - GJE	REVISED -
PLOT SCALE = 48.0000' / in.	DRAWN - GJE	REVISED -
PLOT DATE = 1/13/2025	CHECKED - DBB	REVISED -
	DATE - 11/7/2024	REVISED -

STATE OF ILLINOIS
DEPARTMENT OF TRANSPORTATION

ILLINOIS ROUTE 38 - EAST STATE STREET
SCHEDULE OF QUANTITIES

SCALE: SHEET 16 OF 24 SHEETS STA. TO STA.

F.A.U. RTE. 0347	SECTION 05-00102-00-PV	COUNTY KANE	TOTAL SHEETS 488	SHEET NO. 51
CONTRACT NO. 61J84				
ILLINOIS FED. AID PROJECT				

EAST STATE STREET - STAGE 3 & 3A EARTHWORK QUANTITIES

	CUT				
	CUT (SF)	AVE.	LENGTH	TOTAL (CF)	TOTAL (CY)
174+00.00	46.50				
	46.14	50.00	2,306.75	85.44	
174+50.00	45.77				
	44.39	50.00	2,219.25	82.19	
175+00.00	43.00				
	42.10	50.00	2,105.00	77.96	
175+50.00	41.20				
	40.25	19.60	788.90	29.22	
175+69.60	39.30				
	19.90	36.40	724.36	26.83	
176+06.00	0.50				
	0.25	44.00	11.00	0.41	
176+50.00	0.00				
	0.00	50.00	0.00	0.00	
177+00.00	0.00				
	0.00	50.00	0.00	0.00	
177+50.00	0.00				
	0.00	30.46	0.00	0.00	
177+80.46	0.00				
	0.00	19.54	0.00	0.00	
178+00.00	0.00				
	0.00	50.00	0.00	0.00	
178+50.00	0.00				
	0.00	50.00	0.00	0.00	
179+00.00	0.00				
	0.00	50.00	0.00	0.00	
179+50.00	0.00				
	0.00	50.00	0.00	0.00	
180+00.00	0.00				
	0.00	50.00	0.00	0.00	
180+50.00	0.00				
	0.00	50.00	0.00	0.00	
181+00.00	0.00				
	0.00	50.00	0.00	0.00	
181+50.00	0.00				
	0.00	50.00	0.00	0.00	
182+00.00	0.00				
	0.00	50.00	0.00	0.00	
182+50.00	0.00				
	0.00	50.00	0.00	0.00	
183+00.00	0.00				
	0.00	50.00	0.00	0.00	
183+50.00	0.00				
	0.00	50.00	0.00	0.00	
184+00.00	0.00				
	0.00	50.00	0.00	0.00	
184+50.00	0.00				
	0.00	50.00	0.00	0.00	
185+00.00	0.00				
			TOTAL	13,860.12	

	FILL				
	FILL (SF)	AVE.	LENGTH	TOTAL (CF)	TOTAL (CY)
174+00.00	1.70				
	2.12	50.00	105.75	3.92	
174+50.00	2.53				
	3.26	50.00	162.75	6.03	
175+00.00	3.98				
	3.60	50.00	179.75	6.66	
175+50.00	3.21				
	2.19	19.60	42.83	1.59	
175+69.60	1.16				
	0.80	36.40	29.12	1.08	
176+06.00	0.44				
	0.22	44.00	9.68	0.36	
176+50.00	0.00				
	0.00	50.00	0.00	0.00	
177+00.00	0.00				
	0.00	50.00	0.00	0.00	
177+50.00	0.00				
	0.00	30.46	0.00	0.00	
177+80.46	0.00				
	0.00	19.54	0.00	0.00	
178+00.00	0.00				
	0.00	50.00	0.00	0.00	
178+50.00	0.00				
	0.00	50.00	0.00	0.00	
179+00.00	0.00				
	0.00	50.00	0.00	0.00	
179+50.00	0.00				
	0.00	50.00	0.00	0.00	
180+00.00	0.00				
	0.00	50.00	0.00	0.00	
180+50.00	0.00				
	0.00	50.00	0.00	0.00	
181+00.00	0.00				
	0.00	50.00	0.00	0.00	
181+50.00	0.00				
	0.00	50.00	0.00	0.00	
182+00.00	0.00				
	0.00	50.00	0.00	0.00	
182+50.00	0.00				
	0.00	50.00	0.00	0.00	
183+00.00	0.00				
	0.00	50.00	0.00	0.00	
183+50.00	0.00				
	0.00	50.00	0.00	0.00	
184+00.00	0.00				
	0.00	50.00	0.00	0.00	
184+50.00	0.00				
	0.00	50.00	0.00	0.00	
185+00.00	0.00				
			TOTAL	435.87	

	UNSUITABLES + TOPSOIL EXCAVATION AND PLACEMENT				
	UNSUITS (SF)	AVE.	LENGTH	TOTAL (CF)	TOTAL (CY)
174+00.00	46.65				
	46.69	50.00	2,334.25	86.45	
174+50.00	46.72				
	46.57	50.00	2,328.25	86.23	
175+00.00	46.41				
	26.31	50.00	1,315.25	48.71	
175+50.00	6.20				
	6.02	19.60	117.89	4.37	
175+69.60	5.83				
	6.34	36.40	230.78	8.55	
176+06.00	6.85				
	3.43	44.00	150.70	5.58	
176+50.00	0.00				
	0.00	50.00	0.00	0.00	
177+00.00	0.00				
	0.00	50.00	0.00	0.00	
177+50.00	0.00				
	0.00	30.46	0.00	0.00	
177+80.46	0.00				
	0.00	19.54	0.00	0.00	
178+00.00	0.00				
	0.00	50.00	0.00	0.00	
178+50.00	0.00				
	0.00	50.00	0.00	0.00	
179+00.00	0.00				
	0.00	50.00	0.00	0.00	
179+50.00	0.00				
	0.00	50.00	0.00	0.00	
180+00.00	0.00				
	0.00	50.00	0.00	0.00	
180+50.00	0.00				
	0.00	50.00	0.00	0.00	
181+00.00	0.00				
	0.00	50.00	0.00	0.00	
181+50.00	0.00				
	0.00	50.00	0.00	0.00	
182+00.00	0.00				
	0.00	50.00	0.00	0.00	
182+50.00	0.00				
	0.00	50.00	0.00	0.00	
183+00.00	0.00				
	0.00	50.00	0.00	0.00	
183+50.00	0.00				
	0.00	50.00	0.00	0.00	
184+00.00	0.00				
	0.00	50.00	0.00	0.00	
184+50.00	0.00				
	0.00	50.00	0.00	0.00	
185+00.00	0.00				
			TOTAL	4,887.11	

FILE NAME = FA\961-000 Genevo East State St.CADD.Sheets\961-000_SHT_SCHEDULE OF QUANTITIES.dgn



USER NAME = tnestor	DESIGNED - GJE	REVISED -
	DRAWN - GJE	REVISED -
PLOT SCALE = 48.0000' / in.	CHECKED - DBB	REVISED -
PLOT DATE = 1/13/2025	DATE - 11/7/2024	REVISED -

STATE OF ILLINOIS
DEPARTMENT OF TRANSPORTATION

ILLINOIS ROUTE 38 - EAST STATE STREET
SCHEDULE OF QUANTITIES

SCALE: SHEET 17 OF 24 SHEETS STA. TO STA.

F.A.U. RTE.	SECTION	COUNTY	TOTAL SHEETS	SHEET NO.
0347	05-00102-00-PV	KANE	488	52
CONTRACT NO. 61J84				
ILLINOIS FED. AID PROJECT				

BENNETT STREET STAGE 3 & 3A - EARTHWORK QUANTITIES

CUT	CUT				
	CUT (SF)	AVE.	LENGTH	TOTAL (CF)	TOTAL (CY)
321+70.00	0.00				
		0.00	30.00	0.00	0.00
322+00.00	0.00				
		0.00	33.47	0.00	0.00
322+33.47	0.00				
		0.00	41.53	0.00	0.00
322+75.00	0.00				
		0.00	25.00	0.00	0.00
323+00.00	0.00				
		0.00	50.00	0.00	0.00
323+50.00	0.00				
		0.00	50.00	0.00	0.00
324+00.00	0.00				
		2.25	17.39	39.13	1.45
324+17.39	4.50				
		4.88	32.61	158.97	5.89
324+50.00	5.25				
		5.41	50.00	270.25	10.01
325+00.00	5.56				
		7.57	50.00	378.25	14.01
325+50.00	9.57				
		7.81	50.00	390.25	14.45
326+00.00	6.04				
		7.88	22.00	173.25	6.42
326+22.00	9.71				
		8.11	28.00	226.94	8.41
326+50.00	6.50				
		5.81	26.00	151.06	5.59
326+76.00	5.12				
		-	-	-	-
328+00.00	49.93				
		39.26	50.00	1,963.00	72.70
328+50.00	28.59				
		24.77	33.65	833.51	30.87
328+83.65	20.95				
		10.48	16.35	171.27	6.34
329+00.00	0.00				
		0.00	50.00	0.00	0.00
329+50.00	0.00				
		0.00	50.00	0.00	0.00
330+00.00	0.00				
		0.00	50.00	0.00	0.00
330+50.00	0.00				
		0.00	50.00	0.00	0.00
331+00.00	0.00				
		0.00	50.00	0.00	0.00
331+50.00	0.00				
		0.00	18.95	0.00	0.00
331+68.95	0.00				
				TOTAL	176.14

FILL	FILL				
	FILL (SF)	AVE.	LENGTH	TOTAL (CF)	TOTAL (CY)
321+70.00	0.00				
		0.00	30.00	0.00	0.00
322+00.00	0.00				
		0.00	33.47	0.00	0.00
322+33.47	0.00				
		0.00	41.53	0.00	0.00
322+75.00	0.00				
		0.00	25.00	0.00	0.00
323+00.00	0.00				
		0.00	50.00	0.00	0.00
323+50.00	0.00				
		0.00	50.00	0.00	0.00
324+00.00	0.00				
		0.40	17.39	6.96	0.26
324+17.39	0.80				
		0.85	32.61	27.72	1.03
324+50.00	0.90				
		0.95	50.00	47.50	1.76
325+00.00	1.00				
		0.60	50.00	30.00	1.11
325+50.00	0.20				
		0.45	50.00	22.50	0.83
326+00.00	0.70				
		0.50	22.00	11.00	0.41
326+22.00	0.30				
		0.40	28.00	11.20	0.41
326+50.00	0.50				
		0.55	26.00	14.30	0.53
326+76.00	0.60				
		-	-	-	-
328+00.00	1.42				
		1.04	50.00	51.75	1.92
328+50.00	0.65				
		0.65	33.65	21.70	0.80
328+83.65	0.64				
		0.32	16.35	5.23	0.19
329+00.00	0.00				
		0.00	50.00	0.00	0.00
329+50.00	0.00				
		0.00	50.00	0.00	0.00
330+00.00	0.00				
		0.00	50.00	0.00	0.00
330+50.00	0.00				
		0.00	50.00	0.00	0.00
331+00.00	0.00				
		0.00	50.00	0.00	0.00
331+50.00	0.00				
		0.00	18.95	0.00	0.00
331+68.95	0.00				
				TOTAL	9.25

UNSUITABLES	UNSUITABLES				
	UNSUIT (SF)	AVE.	LENGTH	TOTAL (CF)	TOTAL (CY)
321+70.00	0.00				
		0.00	30.00	0.00	0.00
322+00.00	0.00				
		0.00	33.47	0.00	0.00
322+33.47	0.00				
		0.00	41.53	0.00	0.00
322+75.00	0.00				
		0.00	25.00	0.00	0.00
323+00.00	0.00				
		0.00	50.00	0.00	0.00
323+50.00	0.00				
		0.00	50.00	0.00	0.00
324+00.00	0.00				
		0.40	17.39	6.96	0.26
324+17.39	0.80				
		1.20	32.61	39.13	1.45
324+50.00	1.60				
		2.00	50.00	100.00	3.70
325+00.00	2.40				
		1.20	50.00	60.00	2.22
325+50.00	0.00				
		0.00	50.00	0.00	0.00
326+00.00	0.00				
		0.00	22.00	0.00	0.00
326+22.00	0.00				
		0.00	28.00	0.00	0.00
326+50.00	0.00				
		0.00	26.00	0.00	0.00
326+76.00	0.00				
		-	-	-	-
328+00.00	31.99				
		31.07	50.00	1,553.50	57.54
328+50.00	30.15				
		16.08	33.65	540.92	20.03
328+83.65	2.00				
		1.00	16.35	16.35	0.61
329+00.00	0.00				
		0.00	50.00	0.00	0.00
329+50.00	0.00				
		0.00	50.00	0.00	0.00
330+00.00	0.00				
		0.00	50.00	0.00	0.00
330+50.00	0.00				
		0.00	50.00	0.00	0.00
331+00.00	0.00				
		0.00	50.00	0.00	0.00
331+50.00	0.00				
		0.00	18.95	0.00	0.00
331+68.95	0.00				
				TOTAL	85.81

FILE NAME = FA\961-000 Genevo East State St\CADD_Sheets\961-000_SHT_SCHEDULE OF QUANTITIES.dgn



USER NAME = tnestor	DESIGNED - GJE	REVISED -
	DRAWN - GJE	REVISED -
PLOT SCALE = 48.0000' / in.	CHECKED - DBB	REVISED -
PLOT DATE = 1/13/2025	DATE - 11/7/2024	REVISED -

**STATE OF ILLINOIS
DEPARTMENT OF TRANSPORTATION**

**ILLINOIS ROUTE 38 - EAST STATE STREET
SCHEDULE OF QUANTITIES**

SCALE: SHEET 18 OF 24 SHEETS STA. TO STA.

F.A.U. RTE.	SECTION	COUNTY	TOTAL SHEETS	SHEET NO.
0347	05-00102-00-PV	KANE	488	53
			CONTRACT NO. 61J84	
ILLINOIS FED. AID PROJECT				

EAST STATE STREET - STAGE 3B & 3C EARTHWORK QUANTITIES

	CUT						FILL						UNSUITABLES + TOPSOIL EXCAVATION AND PLACEMENT				
	CUT (SF)	AVE.	LENGTH	TOTAL (CF)	TOTAL (CY)		FILL (SF)	AVE.	LENGTH	TOTAL (CF)	TOTAL (CY)		UNSUIT (SF)	AVE.	LENGTH	TOTAL (CF)	TOTAL (CY)
118+06.93	0.00					118+06.93	0.00				118+06.93	0.00					
		0.00	56.96	0.00	0.00			0.00	56.96	0.00	0.00		0.00	56.96	0.00	0.00	
118+63.89	0.00	2.20	42.26	92.97	3.44	118+63.89	0.00	0.00	42.26	0.00	0.00	118+63.89	0.00	0.00	42.26	0.00	0.00
119+06.15	4.40					119+06.15	0.00					119+06.15	0.00				
		2.20	43.85	96.47	3.57			0.00	43.85	0.00	0.00		0.00	43.85	0.00	0.00	
119+50.00	0.00	0.00	50.00	0.00	0.00	119+50.00	0.00	0.00	50.00	0.00	0.00	119+50.00	0.00	0.00	50.00	0.00	0.00
120+00.00	0.00	0.00	25.00	0.00	0.00	120+00.00	0.00	0.00	25.00	0.00	0.00	120+00.00	0.00	0.00	25.00	0.00	0.00
120+25.00	0.00	0.00	25.00	0.00	0.00	120+25.00	0.00	0.00	25.00	0.00	0.00	120+25.00	0.00	0.00	25.00	0.00	0.00
120+50.00	0.00	0.00	50.00	0.00	0.00	120+50.00	0.00	0.00	50.00	0.00	0.00	120+50.00	0.00	0.00	50.00	0.00	0.00
121+00.00	0.00	0.00	20.90	0.00	0.00	121+00.00	0.00	0.00	20.90	0.00	0.00	121+00.00	0.00	0.00	20.90	0.00	0.00
121+20.90	0.00	0.00	29.10	0.00	0.00	121+20.90	0.00	0.00	29.10	0.00	0.00	121+20.90	0.00	0.00	29.10	0.00	0.00
121+50.00	0.00	0.00	19.88	0.00	0.00	121+50.00	0.00	0.00	19.88	0.00	0.00	121+50.00	0.00	0.00	19.88	0.00	0.00
121+69.88	0.00	0.00	15.38	0.00	0.00	121+69.88	0.00	0.00	15.38	0.00	0.00	121+69.88	0.00	0.00	15.38	0.00	0.00
121+85.26	0.00	0.00	14.74	0.00	0.00	121+85.26	0.00	0.00	14.74	0.00	0.00	121+85.26	0.00	0.00	14.74	0.00	0.00
122+00.00	0.00	0.00	50.00	0.00	0.00	122+00.00	0.00	0.00	50.00	0.00	0.00	122+00.00	0.00	0.00	50.00	0.00	0.00
122+50.00	0.00	0.00	20.46	0.00	0.00	122+50.00	0.00	0.00	20.46	0.00	0.00	122+50.00	0.00	0.00	20.46	0.00	0.00
122+70.46	0.00	0.00	29.54	0.00	0.00	122+70.46	0.00	0.00	29.54	0.00	0.00	122+70.46	0.00	0.00	29.54	0.00	0.00
123+00.00	0.00	0.00	15.75	0.00	0.00	123+00.00	0.00	0.00	15.75	0.00	0.00	123+00.00	0.00	0.00	15.75	0.00	0.00
123+15.75	0.00	0.00	34.25	0.00	0.00	123+15.75	0.00	0.00	34.25	0.00	0.00	123+15.75	0.00	0.00	34.25	0.00	0.00
123+50.00	0.00	0.00	62.57	0.00	0.00	123+50.00	0.00	0.00	62.57	0.00	0.00	123+50.00	0.00	0.00	62.57	0.00	0.00
124+12.57	0.00	0.00	37.43	0.00	0.00	124+12.57	0.00	0.00	37.43	0.00	0.00	124+12.57	0.00	0.00	37.43	0.00	0.00
124+50.00	0.00	0.00	39.45	0.00	0.00	124+50.00	0.00	0.00	39.45	0.00	0.00	124+50.00	0.00	0.00	39.45	0.00	0.00
124+89.45	0.00	0.00	10.55	0.00	0.00	124+89.45	0.00	0.00	10.55	0.00	0.00	124+89.45	0.00	0.00	10.55	0.00	0.00
125+00.00	0.00	0.00	50.76	0.00	0.00	125+00.00	0.00	0.00	50.76	0.00	0.00	125+00.00	0.00	0.00	50.76	0.00	0.00
125+50.00	0.00	0.00	20.97	0.00	0.00	125+50.00	0.00	0.00	20.97	0.00	0.00	125+50.00	0.00	0.00	20.97	0.00	0.00
125+71.73	0.00	0.00	28.27	0.00	0.00	125+71.73	0.00	0.00	28.27	0.00	0.00	125+71.73	0.00	0.00	28.27	0.00	0.00
126+00.00	0.00	0.00	50.00	0.00	0.00	126+00.00	0.00	0.00	50.00	0.00	0.00	126+00.00	0.00	0.00	50.00	0.00	0.00
126+50.00	0.00	0.00	50.00	0.00	0.00	126+50.00	0.00	0.00	50.00	0.00	0.00	126+50.00	0.00	0.00	50.00	0.00	0.00
127+10.49	0.00	0.00	25.85	0.00	0.00	127+10.49	0.00	0.00	25.85	0.00	0.00	127+10.49	0.00	0.00	25.85	0.00	0.00
127+25.85	0.00	0.00	24.15	0.00	0.00	127+25.85	0.00	0.00	24.15	0.00	0.00	127+25.85	0.00	0.00	24.15	0.00	0.00
127+50.00	0.00	0.00	50.00	0.00	0.00	127+50.00	0.00	0.00	50.00	0.00	0.00	127+50.00	0.00	0.00	50.00	0.00	0.00
128+00.00	0.00	0.00	26.22	0.00	0.00	128+00.00	0.00	0.00	26.22	0.00	0.00	128+00.00	0.00	0.00	26.22	0.00	0.00
128+26.22	0.00	0.00	23.78	0.00	0.00	128+26.22	0.00	0.00	23.78	0.00	0.00	128+26.22	0.00	0.00	23.78	0.00	0.00
128+65.93	0.00	0.00	35.51	0.00	0.00	128+65.93	0.00	0.00	35.51	0.00	0.00	128+65.93	0.00	0.00	35.51	0.00	0.00
128+85.51	0.00	0.00	14.49	0.00	0.00	128+85.51	0.00	0.00	14.49	0.00	0.00	128+85.51	0.00	0.00	14.49	0.00	0.00
129+00.00	0.00					129+00.00	0.00					129+00.00	0.00				

FILE NAME = FA\961-000 Genevo East State St\CAADD_Sheets\961-000_SHT_SCHEDULE OF QUANTITIES.dgn



USER NAME = tnestor	DESIGNED - GJE	REVISED -
	DRAWN - GJE	REVISED -
PLOT SCALE = 48.0000' / in.	CHECKED - DBB	REVISED -
PLOT DATE = 1/13/2025	DATE - 11/7/2024	REVISED -

STATE OF ILLINOIS
DEPARTMENT OF TRANSPORTATION

ILLINOIS ROUTE 38 - EAST STATE STREET
SCHEDULE OF QUANTITIES

SCALE: SHEET 19 OF 24 SHEETS STA. TO STA.

F.A.U. RTE.	SECTION	COUNTY	TOTAL SHEETS	SHEET NO.
0347	05-00102-00-PV	KANE	488	54
CONTRACT NO. 61J84				
ILLINOIS FED. AID PROJECT				

EAST STATE STREET - STAGE 3B & 3C EARTHWORK QUANTITIES

	CUT						FILL						UNSUITABLES + TOPSOIL EXCAVATION AND PLACEMENT				
	CUT (SF)	AVE.	LENGTH	TOTAL (CF)	TOTAL (CY)		FILL (SF)	AVE.	LENGTH	TOTAL (CF)	TOTAL (CY)		UNSUIT (SF)	AVE.	LENGTH	TOTAL (CF)	TOTAL (CY)
129+50.00	0.00	0.00	50.00	0.00	0.00	129+50.00	0.00	0.00	50.00	0.00	0.00	129+50.00	0.00	0.00	50.00	0.00	0.00
		0.00	31.61	0.00	0.00			0.00	31.61	0.00	0.00			0.00	31.61	0.00	0.00
129+81.61	0.00	0.00	18.39	0.00	0.00	129+81.61	0.00	0.00	18.39	0.00	0.00	129+81.61	0.00	0.00	18.39	0.00	0.00
		0.00	64.85	0.00	0.00			0.00	50.00	0.00	0.00			0.00	50.00	0.00	0.00
130+00.00	0.00	0.00	14.75	0.00	0.00	130+00.00	0.00	0.00	29.60	0.00	0.00	130+00.00	0.00	0.00	29.60	0.00	0.00
		0.00	20.40	0.00	0.00			0.00	20.40	0.00	0.00			0.00	20.40	0.00	0.00
130+64.85	0.00	0.00	50.00	0.00	0.00	130+64.85	0.00	0.00	50.00	0.00	0.00	130+64.85	0.00	0.00	50.00	0.00	0.00
		0.00	50.00	0.00	0.00			0.00	50.00	0.00	0.00			0.00	50.00	0.00	0.00
130+79.60	0.00	0.00	26.05	0.00	0.00	130+79.60	0.00	0.00	26.05	0.00	0.00	130+79.60	0.00	0.00	26.05	0.00	0.00
		0.00	19.20	0.00	0.00			0.00	23.95	0.00	0.00			0.00	23.95	0.00	0.00
131+00.00	0.00	0.00	37.10	0.00	0.00	131+00.00	0.00	0.00	32.35	0.00	0.00	131+00.00	0.00	0.00	32.35	0.00	0.00
		0.00	17.65	0.00	0.00			0.00	17.65	0.00	0.00			0.00	17.65	0.00	0.00
131+50.00	0.00	0.00	50.00	0.00	0.00	131+50.00	0.00	0.00	50.00	0.00	0.00	131+50.00	0.00	0.00	50.00	0.00	0.00
		0.00	50.00	0.00	0.00			0.00	50.00	0.00	0.00			0.00	50.00	0.00	0.00
132+00.00	0.00	0.00	50.00	0.00	0.00	132+00.00	0.00	0.00	50.00	0.00	0.00	132+00.00	0.00	0.00	50.00	0.00	0.00
		0.00	26.66	0.00	0.00			0.00	26.66	0.00	0.00			0.00	26.66	0.00	0.00
132+26.05	0.00	0.00	23.34	0.00	0.00	132+26.05	0.00	0.00	23.34	0.00	0.00	132+26.05	0.00	0.00	23.34	0.00	0.00
		0.00	50.00	0.00	0.00			0.00	50.00	0.00	0.00			0.00	50.00	0.00	0.00
132+45.25	0.00	0.00	50.00	0.00	0.00	132+45.25	0.00	0.00	50.00	0.00	0.00	132+45.25	0.00	0.00	50.00	0.00	0.00
		0.00	50.00	0.00	0.00			0.00	50.00	0.00	0.00			0.00	50.00	0.00	0.00
132+82.35	0.00	0.00	26.66	0.00	0.00	132+82.35	0.00	0.00	26.66	0.00	0.00	132+82.35	0.00	0.00	26.66	0.00	0.00
		0.00	23.34	0.00	0.00			0.00	23.34	0.00	0.00			0.00	23.34	0.00	0.00
133+00.00	0.00	0.00	50.00	0.00	0.00	133+00.00	0.00	0.00	50.00	0.00	0.00	133+00.00	0.00	0.00	50.00	0.00	0.00
		0.00	50.00	0.00	0.00			0.00	50.00	0.00	0.00			0.00	50.00	0.00	0.00
133+50.00	0.00	0.00	50.00	0.00	0.00	133+50.00	0.00	0.00	50.00	0.00	0.00	133+50.00	0.00	0.00	50.00	0.00	0.00
		0.00	26.66	0.00	0.00			0.00	26.66	0.00	0.00			0.00	26.66	0.00	0.00
134+00.00	0.00	0.00	23.34	0.00	0.00	134+00.00	0.00	0.00	23.34	0.00	0.00	134+00.00	0.00	0.00	23.34	0.00	0.00
		0.00	50.00	0.00	0.00			0.00	50.00	0.00	0.00			0.00	50.00	0.00	0.00
134+26.66	0.00	0.00	50.00	0.00	0.00	134+26.66	0.00	0.00	50.00	0.00	0.00	134+26.66	0.00	0.00	50.00	0.00	0.00
		0.00	50.00	0.00	0.00			0.00	50.00	0.00	0.00			0.00	50.00	0.00	0.00
134+50.00	0.00	0.00	51.70	0.00	0.00	134+50.00	0.00	0.00	51.70	0.00	0.00	134+50.00	0.00	0.00	51.70	0.00	0.00
		0.00	40.52	0.00	0.00			0.00	40.52	0.00	0.00			0.00	40.52	0.00	0.00
135+00.00	0.00	0.00	57.78	0.00	0.00	135+00.00	0.00	0.00	57.78	0.00	0.00	135+00.00	0.00	0.00	57.78	0.00	0.00
		0.00	50.00	0.00	0.00			0.00	50.00	0.00	0.00			0.00	50.00	0.00	0.00
135+51.70	0.00	0.00	50.00	0.00	0.00	135+51.70	0.00	0.00	50.00	0.00	0.00	135+51.70	0.00	0.00	50.00	0.00	0.00
		0.00	50.00	0.00	0.00			0.00	50.00	0.00	0.00			0.00	50.00	0.00	0.00
135+92.22	0.00	0.00	50.00	0.00	0.00	135+92.22	0.00	0.00	50.00	0.00	0.00	135+92.22	0.00	0.00	50.00	0.00	0.00
		0.00	50.00	0.00	0.00			0.00	50.00	0.00	0.00			0.00	50.00	0.00	0.00
136+50.00	0.00	0.00	50.00	0.00	0.00	136+50.00	0.00	0.00	50.00	0.00	0.00	136+50.00	0.00	0.00	50.00	0.00	0.00
		0.00	50.00	0.00	0.00			0.00	50.00	0.00	0.00			0.00	50.00	0.00	0.00
137+00.00	0.00	0.00	50.00	0.00	0.00	137+00.00	0.00	0.00	50.00	0.00	0.00	137+00.00	0.00	0.00	50.00	0.00	0.00
		0.00	50.00	0.00	0.00			0.00	50.00	0.00	0.00			0.00	50.00	0.00	0.00
137+50.00	0.00	0.00	50.00	0.00	0.00	137+50.00	0.00	0.00	50.00	0.00	0.00	137+50.00	0.00	0.00	50.00	0.00	0.00
		0.00	50.00	0.00	0.00			0.00	50.00	0.00	0.00			0.00	50.00	0.00	0.00
138+00.00	0.00	0.00	50.00	0.00	0.00	138+00.00	0.00	0.00	50.00	0.00	0.00	138+00.00	0.00	0.00	50.00	0.00	0.00
		0.00	50.00	0.00	0.00			0.00	50.00	0.00	0.00			0.00	50.00	0.00	0.00
138+50.00	0.00	0.00	50.00	0.00	0.00	138+50.00	0.00	0.00	50.00	0.00	0.00	138+50.00	0.00	0.00	50.00	0.00	0.00
		0.00	50.00	0.00	0.00			0.00	50.00	0.00	0.00			0.00	50.00	0.00	0.00
139+11.58	0.00	0.00	50.00	0.00	0.00	139+11.58	0.00	0.00	50.00	0.00	0.00	139+11.58	0.00	0.00	50.00	0.00	0.00
		0.00	50.00	0.00	0.00			0.00	50.00	0.00	0.00			0.00	50.00	0.00	0.00
139+50.00	0.00	0.00	50.00	0.00	0.00	139+50.00	0.00	0.00	50.00	0.00	0.00	139+50.00	0.00	0.00	50.00	0.00	0.00
		0.00	45.24	0.00	0.00			0.00	45.24	0.00	0.00			0.00	45.24	0.00	0.00
140+00.00	0.00	0.00	54.76	0.00	0.00	140+00.00	0.00	0.00	54.76	0.00	0.00	140+00.00	0.00	0.00	54.76	0.00	0.00
		0.00	57.64	0.00	0.00			0.00	57.64	0.00	0.00			0.00	57.64	0.00	0.00
140+45.24	0.00	0.00	41.40	0.00	0.00	140+45.24	0.00	0.00	41.40	0.00	0.00	140+45.24	0.00	0.00	41.40	0.00	0.00
		0.00	55.04	0.00	0.00			0.00	55.04	0.00	0.00			0.00	55.04	0.00	0.00
141+00.00	0.00	0.00	49.27	0.00	0.00	141+00.00	0.00	0.00	49.27	0.00	0.00	141+00.00	0.00	0.00	49.27	0.00	0.00
		0.00	46.65	0.00	0.00			0.00	46.65	0.00	0.00			0.00	46.65	0.00	0.00
141+57.64	0.00	0.00				141+57.64	0.00	0.00				141+57.64	0.00	0.00			
		0.00						0.00						0.00			
141+99.04	0.00	0.00				141+99.04	0.00	0.00				141+99.04	0.00	0.00			
		0.00						0.00						0.00			
142+54.08	0.00	0.00				142+54.08	0.00	0.00				142+54.08	0.00	0.00			
		0.00						0.00						0.00			
143+03.35	0.00	0.00				143+03.35	0.00	0.00				143+03.35	0.00	0.00			
		0.00						0.00						0.00			

FILE NAME = FA\961-000 Genevo East State St\CAADD_Sheets\961-000_SHT_SCHEDULE OF QUANTITIES.dgn



USER NAME = tnestor	DESIGNED - GJE	REVISED -
PLOT SCALE = 48.0000' / in.	DRAWN - GJE	REVISED -
PLOT DATE = 1/13/2025	CHECKED - DBB	REVISED -
	DATE - 11/7/2024	REVISED -

**STATE OF ILLINOIS
DEPARTMENT OF TRANSPORTATION**

ILLINOIS ROUTE 38 - EAST STATE STREET			
SCHEDULE OF QUANTITIES			
SCALE:	SHEET 20 OF 24 SHEETS	STA.	TO STA.

F.A.U. RTE.	SECTION	COUNTY	TOTAL SHEETS	SHEET NO.
0347	05-00102-00-PV	KANE	488	55
CONTRACT NO. 61J84				
ILLINOIS FED. AID PROJECT				

EAST STATE STREET - STAGE 3B & 3C EARTHWORK QUANTITIES

	CUT				
	CUT (SF)	AVE.	LENGTH	TOTAL (CF)	TOTAL (CY)
143+50.00	0.00				
		0.00	25.89	0.00	0.00
143+75.89	0.00				
		0.00	24.11	0.00	0.00
144+00.00	0.00				
		0.00	50.00	0.00	0.00
144+50.00	0.00				
		0.00	50.21	0.00	0.00
145+00.21	0.00				
		0.00	41.13	0.00	0.00
145+41.34	0.00				
		0.00	53.19	0.00	0.00
145+94.53	0.00				
		0.00	46.76	0.00	0.00
146+41.29	0.00				
		0.00	50.24	0.00	0.00
146+91.53	0.00				
		0.00	37.22	0.00	0.00
147+28.75	0.00				
		0.00	16.87	0.00	0.00
147+45.62	0.00				
		0.00	40.87	0.00	0.00
147+86.49	0.00				
		0.00	13.51	0.00	0.00
148+00.00	0.00				
		0.00	56.09	0.00	0.00
148+56.09	0.00				
		1.85	43.91	81.01	3.00
149+00.00	3.69				
		3.57	19.73	70.44	2.61
149+19.73	3.45				
		2.84	30.27	85.97	3.18
149+50.00	2.23				
		3.56	50.00	177.75	6.58
150+00.00	4.88				
		4.17	48.90	203.67	7.54
150+48.90	3.45				
		1.73	51.10	88.15	3.26
151+00.00	0.00				
		0.00	38.19	0.00	0.00
151+38.19	0.00				
		0.00	1.56	0.00	0.00
151+39.75	0.00				
		0.00	60.25	0.00	0.00
152+00.00	0.00				
		0.00	66.00	0.00	0.00
152+66.00	0.00				
		9.39	34.00	319.09	11.82
153+00.00	18.77				
		20.59	50.00	1,029.25	38.12
153+50.00	22.40				
		24.85	57.78	1,435.54	53.17
154+07.78	27.29				
		25.70	42.22	1,084.84	40.18
154+50.00	24.10				
		12.05	50.00	602.50	22.31
155+00.00	0.00				
		0.00	50.00	0.00	0.00
155+50.00	0.00				
		0.00	50.00	0.00	0.00
156+00.00	0.00				
		0.00	50.00	0.00	0.00
156+50.00	0.00				
		0.00	66.83	0.00	0.00
157+16.83	0.00				
		0.00	23.30	0.00	0.00
157+40.13	0.00				

	FILL				
	FILL (SF)	AVE.	LENGTH	TOTAL (CF)	TOTAL (CY)
143+50.00	0.00				
		0.00	25.89	0.00	0.00
143+75.89	0.00				
		0.00	24.11	0.00	0.00
144+00.00	0.00				
		0.00	50.00	0.00	0.00
144+50.00	0.00				
		0.00	50.21	0.00	0.00
145+00.21	0.00				
		0.00	41.13	0.00	0.00
145+41.34	0.00				
		0.00	53.19	0.00	0.00
145+94.53	0.00				
		0.00	46.76	0.00	0.00
146+41.29	0.00				
		0.00	50.24	0.00	0.00
146+91.53	0.00				
		0.00	37.22	0.00	0.00
147+28.75	0.00				
		0.00	16.87	0.00	0.00
147+45.62	0.00				
		0.00	40.87	0.00	0.00
147+86.49	0.00				
		0.00	13.51	0.00	0.00
148+00.00	0.00				
		0.00	56.09	0.00	0.00
148+56.09	0.00				
		0.00	43.91	0.00	0.00
149+00.00	0.00				
		0.00	19.73	0.00	0.00
149+19.73	0.00				
		0.00	30.27	0.00	0.00
149+50.00	0.00				
		0.00	50.00	0.00	0.00
150+00.00	0.00				
		0.00	48.90	0.00	0.00
150+48.90	0.00				
		0.00	51.10	0.00	0.00
151+00.00	0.00				
		0.00	38.19	0.00	0.00
151+38.19	0.00				
		0.00	1.56	0.00	0.00
151+39.75	0.00				
		0.00	60.25	0.00	0.00
152+00.00	0.00				
		0.00	50.00	0.00	0.00
152+66.00	0.00				
		0.00	50.00	0.00	0.00
153+00.00	0.00				
		0.00	50.00	0.00	0.00
153+50.00	0.00				
		0.00	57.78	0.00	0.00
154+07.78	0.00				
		0.00	42.22	0.00	0.00
154+50.00	0.00				
		0.00	50.00	0.00	0.00
155+00.00	0.00				
		0.00	50.00	0.00	0.00
155+50.00	0.00				
		0.00	50.00	0.00	0.00
156+00.00	0.00				
		0.00	50.00	0.00	0.00
156+50.00	0.00				
		0.00	66.83	0.00	0.00
157+16.83	0.00				
		0.00	23.30	0.00	0.00
157+40.13	0.00				

	UNSUITABLES + TOPSOIL EXCAVATION AND PLACEMENT				
	UNSUIT (SF)	AVE.	LENGTH	TOTAL (CF)	TOTAL (CY)
143+50.00	0.00				
		0.00	25.89	0.00	0.00
143+75.89	0.00				
		0.00	24.11	0.00	0.00
144+00.00	0.00				
		0.00	50.00	0.00	0.00
144+50.00	0.00				
		0.00	50.21	0.00	0.00
145+00.21	0.00				
		0.00	41.13	0.00	0.00
145+41.34	0.00				
		0.00	53.19	0.00	0.00
145+94.53	0.00				
		0.00	46.76	0.00	0.00
146+41.29	0.00				
		0.00	50.24	0.00	0.00
146+91.53	0.00				
		0.00	37.22	0.00	0.00
147+28.75	0.00				
		0.00	16.87	0.00	0.00
147+45.62	0.00				
		0.00	40.87	0.00	0.00
147+86.49	0.00				
		0.00	13.51	0.00	0.00
148+00.00	0.00				
		0.00	56.09	0.00	0.00
148+56.09	0.00				
		3.05	43.91	133.93	4.96
149+00.00	6.10				
		6.10	19.73	120.35	4.46
149+19.73	6.10				
		6.10	30.27	184.65	6.84
149+50.00	6.10				
		6.10	50.00	305.00	11.30
150+00.00	6.10				
		6.10	48.90	298.29	11.05
150+48.90	6.10				
		3.05	51.10	155.86	5.77
151+00.00	0.00				
		0.00	38.19	0.00	0.00
151+38.19	0.00				
		0.00	1.56	0.00	0.00
151+39.75	0.00				
		0.00	60.25	0.00	0.00
152+00.00	0.00				
		3.05	50.00	152.50	5.65
152+50.00	6.10				
		3.05	50.00	152.50	5.65
153+00.00	0.00				
		0.00	50.00	0.00	0.00
153+50.00	0.00				
		0.00	57.78	0.00	0.00
154+07.78	0.00				
		0.00	42.22	0.00	0.00
154+50.00	0.00				
		0.00	50.00	0.00	0.00
155+00.00	0.00				
		0.00	50.00	0.00	0.00
155+50.00	0.00				
		0.00	50.00	0.00	0.00
156+00.00	0.00				
		0.00	50.00	0.00	0.00
156+50.00	0.00				
		0.00	66.83	0.00	0.00
157+16.83	0.00				
		0.00	23.30	0.00	0.00
157+40.13	0.00				

FILE NAME = FA\961-000 Genevo East State St.CADD.Sheets\961-000_SHT_SCHEDULE OF QUANTITIES.dgn



USER NAME = tnestor	DESIGNED - GJE	REVISED -
	DRAWN - GJE	REVISED -
PLOT SCALE = 48.0000' / in.	CHECKED - DBB	REVISED -
PLOT DATE = 1/13/2025	DATE - 08/22/2024	REVISED -

**STATE OF ILLINOIS
DEPARTMENT OF TRANSPORTATION**

**ILLINOIS ROUTE 38 - EAST STATE STREET
SCHEDULE OF QUANTITIES**

SCALE: SHEET 21 OF 24 SHEETS STA. TO STA.

F.A.U. RTE.	SECTION	COUNTY	TOTAL SHEETS	SHEET NO.
0347	05-00102-00-PV	KANE	488	56
CONTRACT NO. 61J84			ILLINOIS FED. AID PROJECT	

EAST STATE STREET - STAGE 3B & 3C EARTHWORK QUANTITIES

	CUT				
	CUT (SF)	AVE.	LENGTH	TOTAL (CF)	TOTAL (CY)
	0.00	0.00	15.92	0.00	0.00
157+56.05	0.00	0.00	43.95	0.00	0.00
158+00.00	0.00	0.00	50.00	0.00	0.00
158+50.00	0.00	0.00	50.00	0.00	0.00
159+00.00	0.00	19.73	50.00	986.50	36.54
159+50.00	39.46	40.00	50.00	1,999.75	74.06
160+00.00	40.53	32.83	50.00	1,641.50	60.80
160+50.00	25.13	24.87	50.00	1,243.50	46.06
161+00.00	24.61	23.77	50.00	1,188.50	44.02
161+50.00	22.93	11.47	56.48	647.54	23.98
162+06.48	0.00	0.00	43.52	0.00	0.00
162+50.00	0.00	0.00	50.00	0.00	0.00
163+00.00	0.00	0.00	50.00	0.00	0.00
163+50.00	0.00	0.00	50.00	0.00	0.00
164+00.00	0.00	0.00	50.00	0.00	0.00
164+50.00	0.00	0.00	50.00	0.00	0.00
165+00.00	0.00	0.00	50.00	0.00	0.00
165+50.00	0.00	0.00	64.00	0.00	0.00
166+14.00	0.00	0.00	36.00	0.00	0.00
166+50.00	0.00	0.00	50.00	0.00	0.00
167+00.00	0.00	0.00	50.00	0.00	0.00
167+50.00	0.00	0.00	50.00	0.00	0.00
168+00.00	0.00	0.00	50.00	0.00	0.00
168+50.00	0.00	0.00	50.00	0.00	0.00
169+00.00	0.00	0.00	50.00	0.00	0.00
169+50.00	0.00	0.40	50.00	20.00	0.74
170+00.00	0.80	0.50	50.00	25.00	0.93
170+50.00	0.20	0.10	50.00	5.00	0.19
171+00.00	0.00	0.00	50.00	0.00	0.00
171+50.00	0.00	0.00	50.00	0.00	0.00
172+00.00	0.00	0.00	50.00	0.00	0.00
172+50.00	0.00	0.00	50.00	0.00	0.00
173+00.00	0.00	0.00	50.00	0.00	0.00
173+50.00	0.00	0.00	50.00	0.00	0.00

	FILL				
	FILL (SF)	AVE.	LENGTH	TOTAL (CF)	TOTAL (CY)
	0.00	0.00	15.92	0.00	0.00
157+56.05	0.00	0.00	43.95	0.00	0.00
158+00.00	0.00	0.00	50.00	0.00	0.00
158+50.00	0.00	0.00	50.00	0.00	0.00
159+00.00	0.00	0.00	50.00	0.00	0.00
159+50.00	0.00	0.00	50.00	0.00	0.00
160+00.00	0.00	0.00	50.00	0.00	0.00
160+50.00	0.00	0.00	50.00	0.00	0.00
161+00.00	0.00	0.00	50.00	0.00	0.00
161+50.00	0.00	0.00	56.48	0.00	0.00
162+06.48	0.00	0.00	43.52	0.00	0.00
162+50.00	0.00	0.00	50.00	0.00	0.00
163+00.00	0.00	0.00	50.00	0.00	0.00
163+50.00	0.00	0.00	50.00	0.00	0.00
164+00.00	0.00	0.00	50.00	0.00	0.00
164+50.00	0.00	0.00	50.00	0.00	0.00
165+00.00	0.00	0.00	50.00	0.00	0.00
165+50.00	0.00	0.00	64.00	0.00	0.00
166+14.00	0.00	0.00	36.00	0.00	0.00
166+50.00	0.00	0.00	50.00	0.00	0.00
167+00.00	0.00	0.00	50.00	0.00	0.00
167+50.00	0.00	0.00	50.00	0.00	0.00
168+00.00	0.00	0.00	50.00	0.00	0.00
168+50.00	0.00	0.00	50.00	0.00	0.00
169+00.00	0.00	0.00	50.00	0.00	0.00
169+50.00	0.00	0.00	50.00	0.00	0.00
170+00.00	0.00	0.00	50.00	0.00	0.00
170+50.00	0.00	0.00	50.00	0.00	0.00
171+00.00	0.00	0.00	50.00	0.00	0.00
171+50.00	0.00	0.00	50.00	0.00	0.00
172+00.00	0.00	0.00	50.00	0.00	0.00
172+50.00	0.00	0.00	50.00	0.00	0.00
173+00.00	0.00	0.00	50.00	0.00	0.00
173+50.00	0.00	0.00	50.00	0.00	0.00

	UNSUITABLES + TOPSOIL EXCAVATION AND PLACEMENT				
	UNSUIT (SF)	AVE.	LENGTH	TOTAL (CF)	TOTAL (CY)
	0.00	0.00	15.92	0.00	0.00
157+56.05	0.00	0.00	43.95	0.00	0.00
158+00.00	0.00	0.00	50.00	0.00	0.00
158+50.00	0.00	0.00	50.00	0.00	0.00
159+00.00	0.00	0.00	50.00	0.00	0.00
159+50.00	0.00	0.00	50.00	0.00	0.00
160+00.00	0.00	0.00	50.00	0.00	0.00
160+50.00	0.00	0.00	50.00	0.00	0.00
161+00.00	0.00	0.00	50.00	0.00	0.00
161+50.00	0.00	0.00	56.48	0.00	0.00
162+06.48	0.00	0.00	43.52	0.00	0.00
162+50.00	0.00	0.00	50.00	0.00	0.00
163+00.00	0.00	0.00	50.00	0.00	0.00
163+50.00	0.00	0.00	50.00	0.00	0.00
164+00.00	0.00	0.00	50.00	0.00	0.00
164+50.00	0.00	0.00	50.00	0.00	0.00
165+00.00	0.00	0.00	50.00	0.00	0.00
165+50.00	0.00	0.00	64.00	0.00	0.00
166+14.00	0.00	0.00	36.00	0.00	0.00
166+50.00	0.00	0.00	50.00	0.00	0.00
167+00.00	0.00	0.00	50.00	0.00	0.00
167+50.00	0.00	0.00	50.00	0.00	0.00
168+00.00	0.00	0.00	50.00	0.00	0.00
168+50.00	0.00	0.00	50.00	0.00	0.00
169+00.00	0.00	0.00	50.00	0.00	0.00
169+50.00	0.00	0.00	50.00	0.00	0.00
170+00.00	0.00	0.00	50.00	0.00	0.00
170+50.00	0.00	0.00	50.00	0.00	0.00
171+00.00	0.00	0.00	50.00	0.00	0.00
171+50.00	0.00	0.00	50.00	0.00	0.00
172+00.00	0.00	0.00	50.00	0.00	0.00
172+50.00	0.00	0.00	50.00	0.00	0.00
173+00.00	0.00	0.00	50.00	0.00	0.00
173+50.00	0.00	0.00	50.00	0.00	0.00

FILE NAME = FA\961-000 Genevo East State St\CADD_Sheets\961-000_SHT_SCHEDULE OF QUANTITIES.dgn



USER NAME = tnestor	DESIGNED - GJE	REVISED -
	DRAWN - GJE	REVISED -
PLOT SCALE = 48.0000' / in.	CHECKED - DBB	REVISED -
PLOT DATE = 1/13/2025	DATE - 11/7/2024	REVISED -

STATE OF ILLINOIS
DEPARTMENT OF TRANSPORTATION

ILLINOIS ROUTE 38 - EAST STATE STREET
SCHEDULE OF QUANTITIES

SCALE: SHEET 22 OF 24 SHEETS STA. TO STA.

F.A.U. RTE.	SECTION	COUNTY	TOTAL SHEETS	SHEET NO.
0347	05-00102-00-PV	KANE	488	57
CONTRACT NO. 61J84				
ILLINOIS FED. AID PROJECT				

EAST STATE STREET - STAGE 3B & 3C EARTHWORK QUANTITIES

	CUT				
	CUT (SF)	AVE.	LENGTH	TOTAL (CF)	TOTAL (CY)
174+00.00	0.00				
		0.00	50.00	0.00	0.00
174+50.00	0.00				
		0.00	50.00	0.00	0.00
175+00.00	0.00				
		0.00	50.00	0.00	0.00
175+50.00	0.00				
		0.00	19.60	0.00	0.00
175+69.60	0.00				
		0.00	36.40	0.00	0.00
176+06.00	0.00				
		0.00	44.00	0.00	0.00
176+50.00	0.00				
		0.00	50.00	0.00	0.00
177+00.00	0.00				
		0.00	50.00	0.00	0.00
177+50.00	0.00				
		0.00	30.46	0.00	0.00
177+80.46	0.00				
		0.00	19.54	0.00	0.00
178+00.00	0.00				
		0.00	50.00	0.00	0.00
178+50.00	0.00				
		0.00	50.00	0.00	0.00
179+00.00	0.00				
		0.00	50.00	0.00	0.00
179+50.00	0.00				
		0.00	50.00	0.00	0.00
180+00.00	0.00				
		0.00	50.00	0.00	0.00
180+50.00	0.00				
		0.00	50.00	0.00	0.00
181+00.00	0.00				
		0.00	50.00	0.00	0.00
181+50.00	0.00				
		0.00	50.00	0.00	0.00
182+00.00	0.00				
		0.00	50.00	0.00	0.00
182+50.00	0.00				
		0.00	50.00	0.00	0.00
183+00.00	0.00				
		0.00	50.00	0.00	0.00
183+50.00	0.00				
		0.00	50.00	0.00	0.00
184+00.00	0.00				
		0.00	50.00	0.00	0.00
184+50.00	0.00				
		0.00	50.00	0.00	0.00
185+00.00	0.00				
				TOTAL	486.11

	FILL				
	FILL (SF)	AVE.	LENGTH	TOTAL (CF)	TOTAL (CY)
174+00.00	0.00				
		0.00	50.00	0.00	0.00
174+50.00	0.00				
		0.00	50.00	0.00	0.00
175+00.00	0.00				
		0.00	50.00	0.00	0.00
175+50.00	0.00				
		0.00	19.60	0.00	0.00
175+69.60	0.00				
		0.00	36.40	0.00	0.00
176+06.00	0.00				
		0.00	44.00	0.00	0.00
176+50.00	0.00				
		0.00	50.00	0.00	0.00
177+00.00	0.00				
		0.00	50.00	0.00	0.00
177+50.00	0.00				
		0.00	30.46	0.00	0.00
177+80.46	0.00				
		0.00	19.54	0.00	0.00
178+00.00	0.00				
		0.00	50.00	0.00	0.00
178+50.00	0.00				
		0.00	50.00	0.00	0.00
179+00.00	0.00				
		0.00	50.00	0.00	0.00
179+50.00	0.00				
		0.00	50.00	0.00	0.00
180+00.00	0.00				
		0.00	50.00	0.00	0.00
180+50.00	0.00				
		0.00	50.00	0.00	0.00
181+00.00	0.00				
		0.00	50.00	0.00	0.00
181+50.00	0.00				
		0.00	50.00	0.00	0.00
182+00.00	0.00				
		0.00	50.00	0.00	0.00
182+50.00	0.00				
		0.00	50.00	0.00	0.00
183+00.00	0.00				
		0.00	50.00	0.00	0.00
183+50.00	0.00				
		0.00	50.00	0.00	0.00
184+00.00	0.00				
		0.00	50.00	0.00	0.00
184+50.00	0.00				
		0.00	50.00	0.00	0.00
185+00.00	0.00				
				TOTAL	0.00

	UNSUITABLES + TOPSOIL EXCAVATION AND PLACEMENT				
	UNSUIT (SF)	AVE.	LENGTH	TOTAL (CF)	TOTAL (CY)
174+00.00	0.00				
		0.00	50.00	0.00	0.00
174+50.00	0.00				
		0.00	50.00	0.00	0.00
175+00.00	0.00				
		0.00	50.00	0.00	0.00
175+50.00	0.00				
		0.00	19.60	0.00	0.00
175+69.60	0.00				
		0.00	36.40	0.00	0.00
176+06.00	0.00				
		0.00	44.00	0.00	0.00
176+50.00	0.00				
		0.00	50.00	0.00	0.00
177+00.00	0.00				
		0.00	50.00	0.00	0.00
177+50.00	0.00				
		0.00	30.46	0.00	0.00
177+80.46	0.00				
		0.00	19.54	0.00	0.00
178+00.00	0.00				
		0.00	50.00	0.00	0.00
178+50.00	0.00				
		0.00	50.00	0.00	0.00
179+00.00	0.00				
		0.00	50.00	0.00	0.00
179+50.00	0.00				
		0.00	50.00	0.00	0.00
180+00.00	0.00				
		0.00	50.00	0.00	0.00
180+50.00	0.00				
		0.00	50.00	0.00	0.00
181+00.00	0.00				
		0.00	50.00	0.00	0.00
181+50.00	0.00				
		0.00	50.00	0.00	0.00
182+00.00	0.00				
		0.00	50.00	0.00	0.00
182+50.00	0.00				
		0.00	50.00	0.00	0.00
183+00.00	0.00				
		0.00	50.00	0.00	0.00
183+50.00	0.00				
		0.00	50.00	0.00	0.00
184+00.00	0.00				
		0.00	50.00	0.00	0.00
184+50.00	0.00				
		0.00	50.00	0.00	0.00
185+00.00	0.00				
				TOTAL	55.67

FILE NAME = FA\961-000 Genevo East State St.CADD.Sheets\961-000_SHT_SCHEDULE OF QUANTITIES.dgn





USER NAME = tnestor	DESIGNED - GJE	REVISED -
	DRAWN - GJE	REVISED -
PLOT SCALE = 48.0000' / in.	CHECKED - DBB	REVISED -
PLOT DATE = 1/13/2025	DATE - 11/7/2024	REVISED -

STATE OF ILLINOIS
DEPARTMENT OF TRANSPORTATION

ILLINOIS ROUTE 38 - EAST STATE STREET
SCHEDULE OF QUANTITIES

SCALE: SHEET 23 OF 24 SHEETS STA. TO STA.

F.A.U. RTE.	SECTION	COUNTY	TOTAL SHEETS	SHEET NO.
0347	05-00102-00-PV	KANE	488	58
			CONTRACT NO. 61J84	
ILLINOIS FED. AID PROJECT				

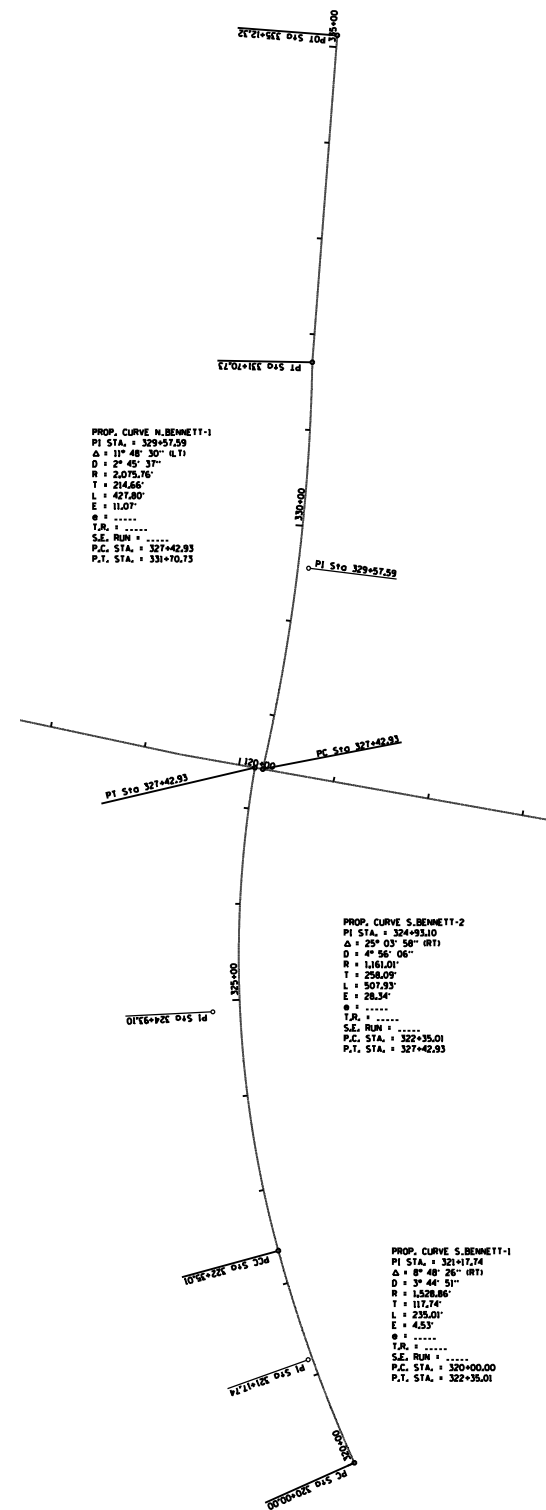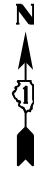

Chain	Station	Datapoint	Bearing	Distance	Northing	Easting
N_BENNETT	327+42.93	PC	see curve data, N_BENNETT-1		1901394.4784	993208.1041
N_BENNETT	329+57.59	PI			1901603.7678	993255.8201
N_BENNETT	331+70.73	PI	N 04°21'57.09" E	341.59	1901818.3928	993259.6979
N_BENNETT	335+12.32	POT			1902158.9930	993285.7015

Chain	Station	Datapoint	Bearing	Distance	Northing	Easting
S_BENNETT	320+00.00	PC	see curve data, S_BENNETT-1		1900671.6500	993303.5000
S_BENNETT	321+17.74	PI			1900779.1048	993255.3830
S_BENNETT	322+35.01	PCC			1900892.6598	993224.2858
S_BENNETT	324+93.10	PI	see curve data, N_BENNETT-2		1901141.5867	993156.1167
S_BENNETT	327+42.93	PT			1901395.9503	993199.8290

FILE NAME = F:\961-000 Genevo East State St.CADD_Sheets\961-000_SHT_ALIGN_BENNETT.dgn




USER NAME = tnestor	DESIGNED - GJE	REVISED -
DRAWN - GJE	REVISED -	
PLOT SCALE = 200.0000' / in.	CHECKED - DBB	REVISED -
PLOT DATE = 1/13/2025	DATE - 11/7/2024	REVISED -

STATE OF ILLINOIS
DEPARTMENT OF TRANSPORTATION

ILLINOIS ROUTE 25 – BENNETT STREET
ALIGNMENT

SCALE: 1"=100' SHEET 1 OF 6 SHEETS STA. TO STA.

F.A.U. RTE.	SECTION	COUNTY	TOTAL SHEETS	SHEET NO.
0347	05-00102-00-PV	KANE	488	60
CONTRACT NO. 61J84			ILLINOIS FED. AID PROJECT	

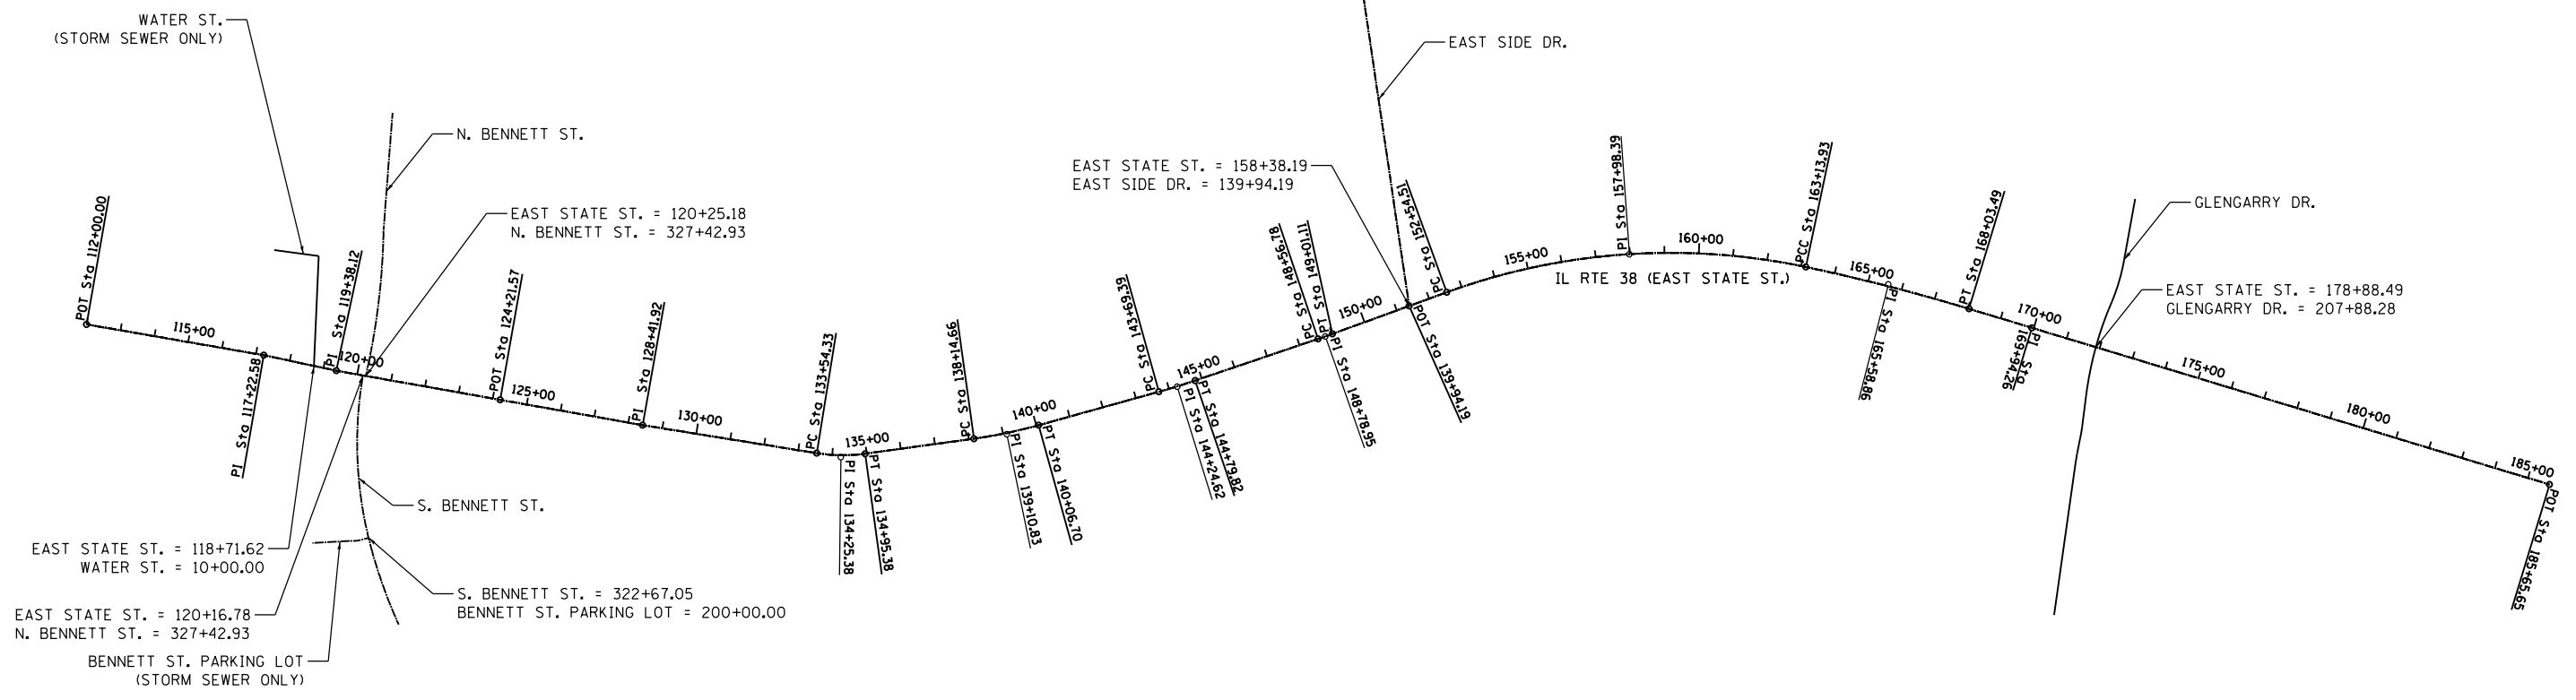

PROP. CURVE E.STATE.CL-1
 PI STA. = 134+25.38
 $\Delta = 17^\circ 00' 49''$ (LT)
 $D = 12^\circ 03' 44''$
 $R = 475.00'$
 $T = 71.05'$
 $L = 141.05'$
 $E = 5.28'$
 $\theta = \dots$
 $T.R. = \dots$
 $S.E. RUN = \dots$
 P.C. STA. = 133+54.33
 P.T. STA. = 134+95.38

PROP. CURVE E.STATE.CL-2
 PI STA. = 139+10.83
 $\Delta = 7^\circ 41' 41''$ (LT)
 $D = 4^\circ 00' 24''$
 $R = 1,430.00'$
 $T = 96.17'$
 $L = 192.04'$
 $E = 3.23'$
 $\theta = \dots$
 $T.R. = \dots$
 $S.E. RUN = \dots$
 P.C. STA. = 138+14.66
 P.T. STA. = 140+06.70

PROP. CURVE E.STATE.CL-3
 PI STA. = 144+24.62
 $\Delta = 3^\circ 09' 48''$ (LT)
 $D = 2^\circ 51' 53''$
 $R = 2,000.00'$
 $T = 55.23'$
 $L = 110.42'$
 $E = 0.76'$
 $\theta = \dots$
 $T.R. = \dots$
 $S.E. RUN = \dots$
 P.C. STA. = 143+69.39
 P.T. STA. = 144+79.82

PROP. CURVE E.STATE.CL-4
 PI STA. = 148+78.95
 $\Delta = 1^\circ 16' 12''$ (LT)
 $D = 2^\circ 51' 53''$
 $R = 2,000.00'$
 $T = 22.17'$
 $L = 44.33'$
 $E = 0.12'$
 $\theta = \dots$
 $T.R. = \dots$
 $S.E. RUN = \dots$
 P.C. STA. = 148+56.78
 P.T. STA. = 149+01.11

PROP. CURVE E.STATE.CL-5
 PI STA. = 157+98.39
 $\Delta = 31^\circ 56' 52''$ (RT)
 $D = 3^\circ 00' 56''$
 $R = 1,900.00'$
 $T = 543.88'$
 $L = 1,059.43'$
 $E = 76.31'$
 $\theta = \dots$
 $T.R. = \dots$
 $S.E. RUN = \dots$
 P.C. STA. = 152+54.51
 P.T. STA. = 163+13.93

PROP. CURVE E.STATE.CL-6
 PI STA. = 165+58.86
 $\Delta = 4^\circ 51' 28''$ (RT)
 $D = 0^\circ 59' 32''$
 $R = 5,774.15'$
 $T = 244.92'$
 $L = 489.55'$
 $E = 5.19'$
 $\theta = \dots$
 $T.R. = \dots$
 $S.E. RUN = \dots$
 P.C. STA. = 163+13.93
 P.T. STA. = 168+03.49

Chain	Station	Datapoint	Bearing	Distance	Northing	Easting
E.STATE_CL	112+00.00	POT	S80°07'58.36" E	522.58	1901544.3067	992396.7511
E.STATE_CL	117+22.58	PI	S77°56'28.74" E	215.54	1901454.7561	992911.5966
E.STATE_CL	119+38.12	PI	S79°54'49.49" E	483.45	1901409.7263	993122.3835
E.STATE_CL	124+21.57	POT	S79°54'49.49" E	420.35	1901325.0592	993598.3633
E.STATE_CL	128+41.92	PI	S80°51'29.49" E	512.41	1901251.4431	994012.2169
E.STATE_CL	133+54.33	PC	see curve data, E.STATE_CL-1		1901170.0322	994518.1182
E.STATE_CL	134+25.38	PI	see curve data, E.STATE_CL-1		1901158.7443	994588.2625
E.STATE_CL	134+95.38	PT	N 82°07'41.64 E	319.28	1901168.4747	994658.6398
E.STATE_CL	138+14.66	PC	see curve data, E.STATE_CL-2		1901212.2026	994974.9150
E.STATE_CL	139+10.83	PI	see curve data, E.STATE_CL-2		1901225.3732	995070.1751
E.STATE_CL	140+06.70	PT	N 82°07'41.64 E	362.69	1901251.1798	995162.8140
E.STATE_CL	143+69.39	PC	see curve data, E.STATE_CL-3		1901348.5086	995512.1980
E.STATE_CL	144+24.62	PI	see curve data, E.STATE_CL-3		1901363.3287	995565.3985
E.STATE_CL	144+79.82	PT	N 71°16'12.76 E	376.97	1901381.0622	995617.7001
E.STATE_CL	148+56.78	PC	see curve data, E.STATE_CL-4		1901502.1087	995974.7054
E.STATE_CL	148+78.95	PI	see curve data, E.STATE_CL-4		1901509.2260	995995.6966
E.STATE_CL	149+01.11	PT	N 70°00'01.08 E	353.39	1901516.8068	996016.5250
E.STATE_CL	152+54.51	PC	see curve data, E.STATE_CL-5		1901637.6724	996348.6060
E.STATE_CL	157+98.39	PI	see curve data, E.STATE_CL-5		1901823.6875	996859.6866
E.STATE_CL	163+13.93	PCC	see curve data, E.STATE_CL-6		1901711.0905	997391.7834
E.STATE_CL	165+58.86	PI	see curve data, E.STATE_CL-6		1901660.3850	997631.4015
E.STATE_CL	168+03.49	PT	S73°11'38.92 E	190.77	1901711.0905	997391.7834
E.STATE_CL	169+94.26	PI	S73°08'58.06 E	1571.39	1901534.4140	998048.4833
E.STATE_CL	185+65.65	POT	-	-	1901078.9056	999552.4044

FILE NAME = F:\961-000 Genevo East State St.CADD_Sheets\961-000_SHT_ALIGN.ESTATE.dgn





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PLOT SCALE = 500.0000' / in.	DRAWN - GJE	REVISED -
PLOT DATE = 1/13/2025	CHECKED - DBB	REVISED -
	DATE - 11/7/2024	REVISED -

**STATE OF ILLINOIS
DEPARTMENT OF TRANSPORTATION**

**ILLINOIS ROUTE 38 - EAST STATE STREET
ALIGNMENT**

SCALE: 1"=250' SHEET 2 OF 6 SHEETS STA. TO STA.


F.A.U. RTE.	SECTION	COUNTY	TOTAL SHEETS	SHEET NO.
0347	05-00102-00-PV	KANE	488	61
CONTRACT NO. 61J84				
ILLINOIS FED. AID PROJECT				

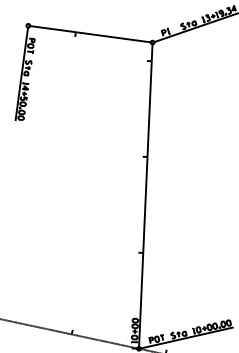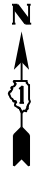

Chain	Station	Datapoint	Bearing	Distance	Northing	Easting
SS_WATER_ST	10+00.00	POT	S02°33'16.97\" E	319.34	1901423.6181	993057.3553
SS_WATER_ST	13+19.34	PI	N 82°17'49.70\" W	130.66	1901742.6389	993071.5893
SS_WATER_ST	14+50.00	POT	-	-	1901760.1522	992942.1064

EAST STATE ST.

**WATER STREET
(STORM SEWER ONLY)**

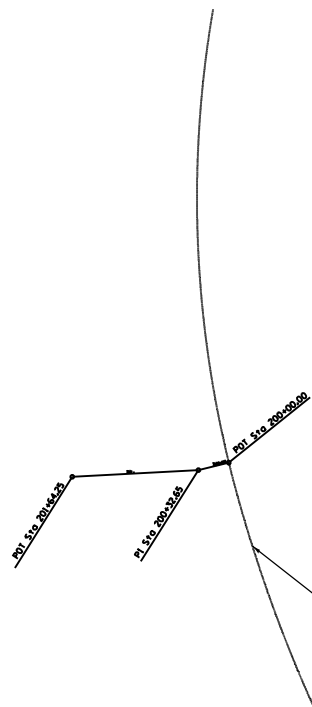

Chain	Station	Datapoint	Bearing	Distance	Northing	Easting
SS_S_BENNETT_LOT	200+00.00	POT	S76°15'57.79\" W	32.65	1900923.6739	993216.2508
SS_S_BENNETT_LOT	200+32.65	PI	S86°57'53.68\" W	130.66	1900915.9225	993184.5351
SS_S_BENNETT_LOT	201+84.25	POT	-	-	1900908.9544	993053.1158

S. BENNETT ST.

**PARKING LOT, SOUTH BENNETT STREET
(STORM SEWER ONLY)**

Chain	Station	Datapoint	Bearing	Distance	Northing	Easting
GLENGARRY	200+00.00	POT	N 08°03'41.42\" E	447.6767	1900699.6003	998113.1403
GLENGARRY	204+47.68	PC	see curve data, GLENGARRY-1		1901142.8531	998175.9207
GLENGARRY	204+60.33	PI			1901155.3800	998177.6950
GLENGARRY	204+72.98	PT	N 10°57'37.79\" E	46.92	1901167.8011	998180.1005
GLENGARRY	205+19.90	PC	see curve data, GLENGARRY-2		1901213.8669	998189.0219
GLENGARRY	205+36.69	PI			1901229.3686	998192.0240
GLENGARRY	205+51.47	PT	N 07°20'34.71\" E	93.78	1901245.0287	998194.0420
GLENGARRY	206+45.24	PC	see curve data, GLENGARRY-3		1901338.0377	998206.0277
GLENGARRY	207+75.17	PI			1901466.9016	998222.6338
GLENGARRY	209+03.66	PT	N 22°08'55.87\" E	27.36	1901587.2433	998271.6190
GLENGARRY	209+31.01	PC			1901612.5842	998281.9341
GLENGARRY	209+63.94	PI	see curve data, GLENGARRY-4		1901670.8615	998305.6559
GLENGARRY	210+56.40	PT	N 10°10'32.56\" E	27.36	1901732.7922	998316.7719
GLENGARRY	212+35.45	POT	-	-	1901909.0300	998348.4050


POT Sta 149+00.79

POT Sta 139+00.38

EAST STATE ST.

Chain	Station	Datapoint	Bearing	Distance	Northing	Easting
EAST_SIDE	139+94.19	POT	N 08°24'39.92\" W	906.61	1901597.8896	996239.3018
EAST_SIDE	149+00.79	POT	-	-	1902494.7430	996106.6887

EAST SIDE DRIVE

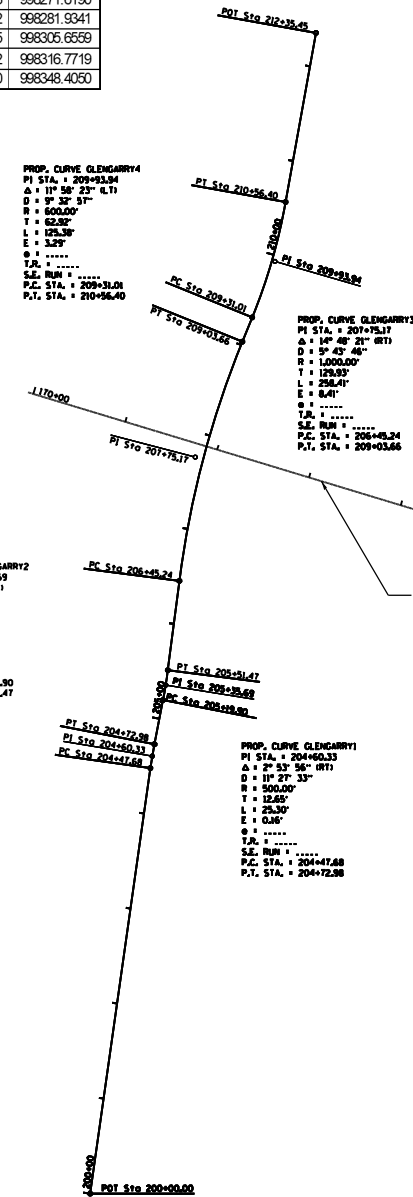

GLENGARRY DRIVE

FILE NAME = FA\961-000 Genevo East State St.CADD_Sheets\961-000_SHT_ALIGN_GLENGARRY_WATER.dgn



USER NAME = tnestor	DESIGNED - GJE	REVISED -
	DRAWN - GJE	REVISED -
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PLOT DATE = 1/13/2025	DATE - 11/7/2024	REVISED -


**STATE OF ILLINOIS
DEPARTMENT OF TRANSPORTATION**

**ADDITIONAL ROADWAYS
ALIGNMENT**


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F.A.U. RTE.	SECTION	COUNTY	TOTAL SHEETS	SHEET NO.
0347	05-00102-00-PV	KANE	488	62
CONTRACT NO. 61J84				


ILLINOIS FED. AID PROJECT

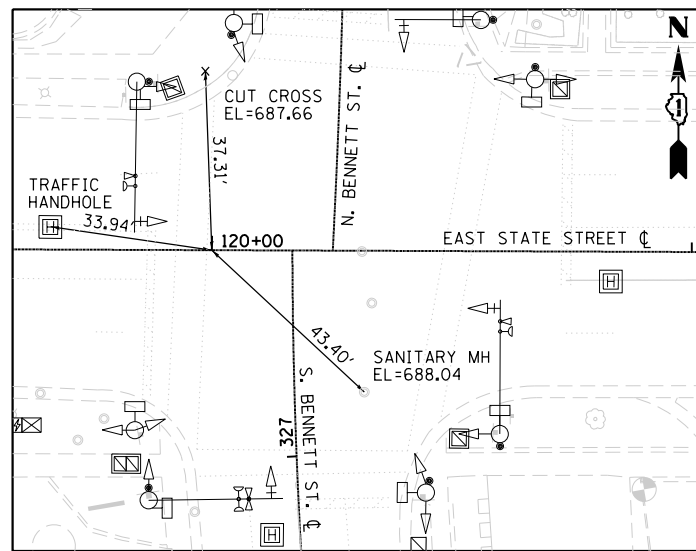


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 STA 120+00.00
 N: 1901398.8890
 E: 993183.3085

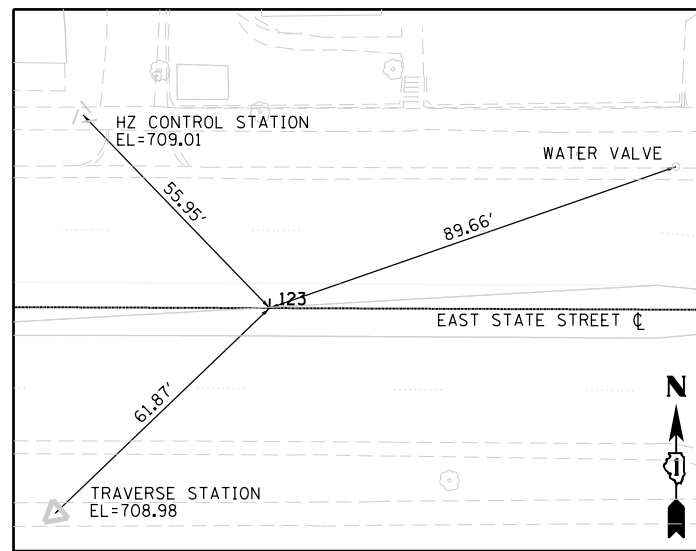


EAST STATE STREET
 STA 123+00.00
 N: 1901346.3498
 E: 993478.6721

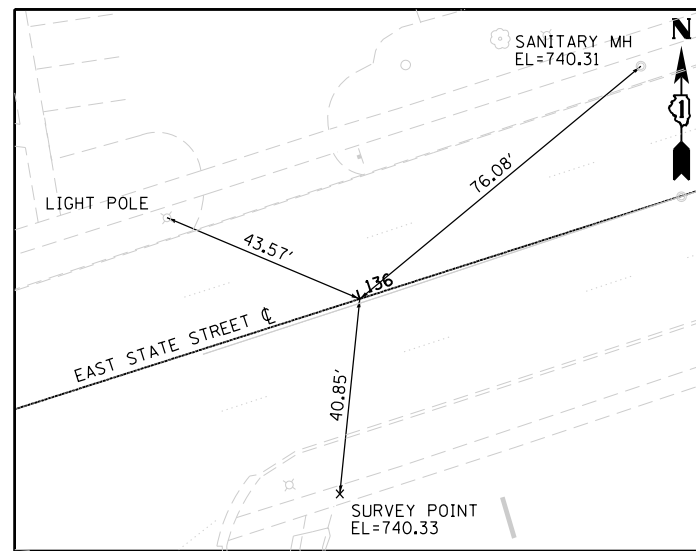


EAST STATE STREET
 STA 136+00.00
 N: 1901182.8033
 E: 994762.2762

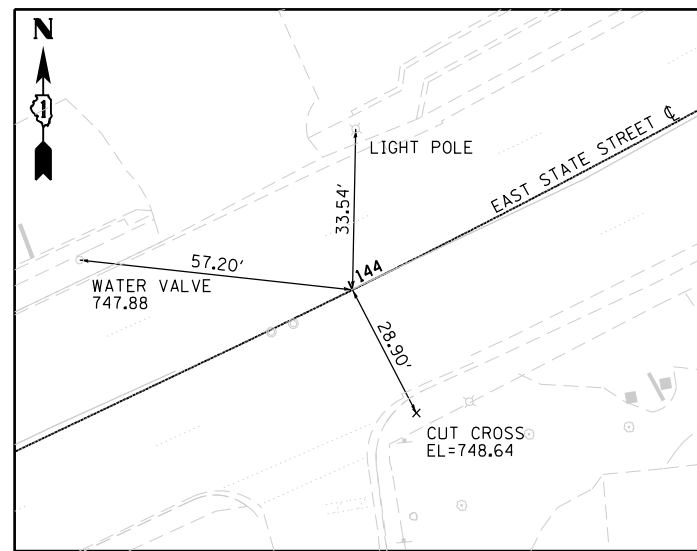


EAST STATE STREET
 STA 144+00.00
 N: 1901356.9476
 E: 995541.6191

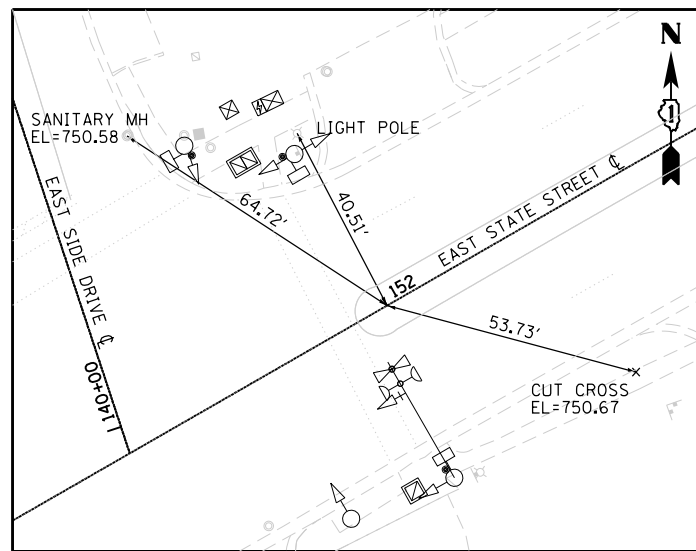


EAST STATE STREET
 STA 152+00.00
 N: 1901619.0307
 E: 996297.3875

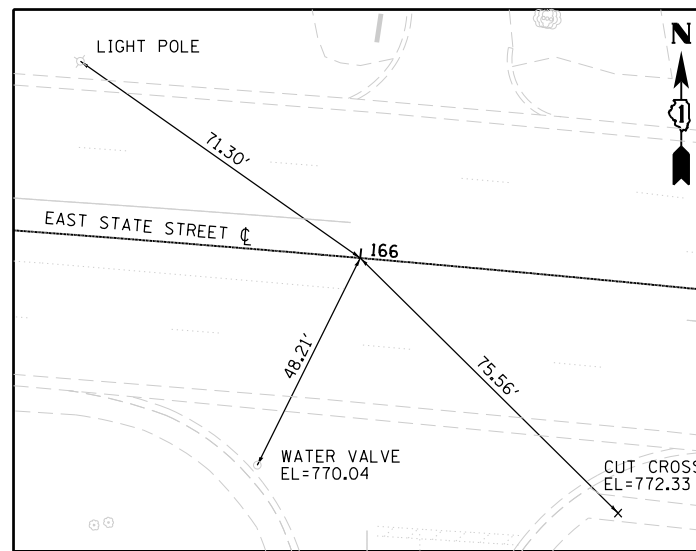

EAST STATE STREET
 STA 166+00.00
 N: 1901644.9606
 E: 997670.0702

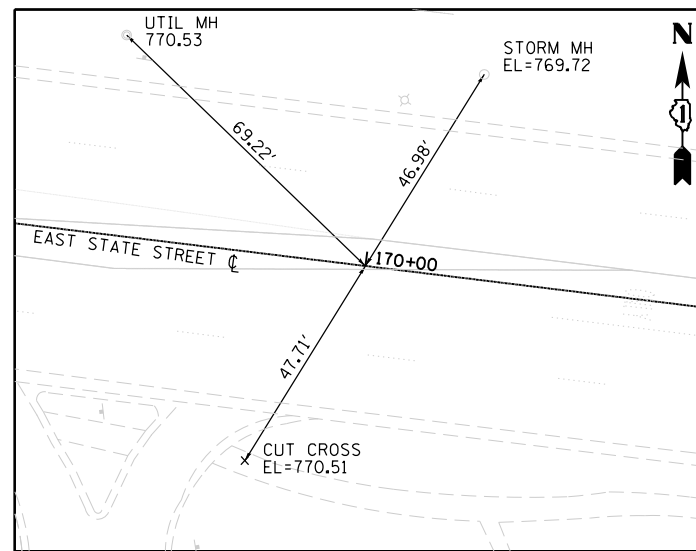

EAST STATE STREET
 STA 170+00.00
 N: 1901532.7488
 E: 998053.9811

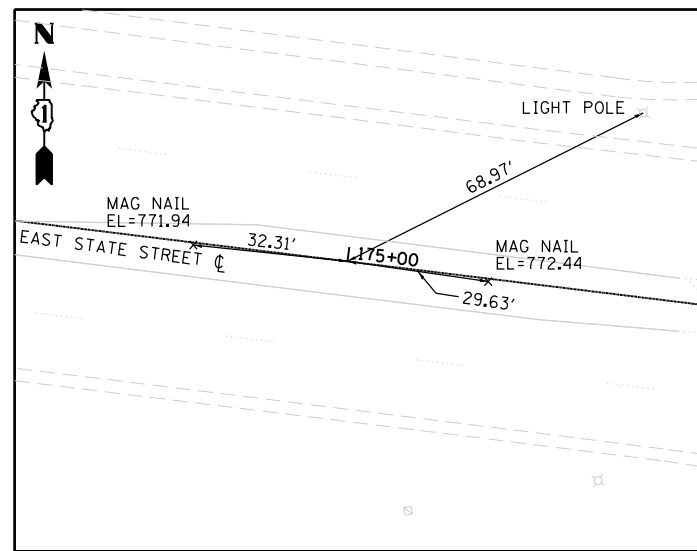

EAST STATE STREET
 STA 175+00.00
 N: 1901387.8108
 E: 998532.5132

FILE NAME = F:\961-000 Genevo East State St.CADD_Sheets\961-000_SHT_ALIGN_TIES.dwg




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DRAWN - GJE	REVISED -	
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PLOT DATE = 1/13/2025	DATE - 11/7/2024	REVISED -

STATE OF ILLINOIS
 DEPARTMENT OF TRANSPORTATION


ILLINOIS ROUTE 38 - EAST STATE STREET
 ALIGNMENT TIES

SCALE: 1"=20' SHEET 4 OF 6 SHEETS STA. TO STA.


F.A.U. RTE.	SECTION	COUNTY	TOTAL SHEETS	SHEET NO.
0347	05-00102-00-PV	KANE	488	63
CONTRACT NO. 61J84				
ILLINOIS FED. AID PROJECT				

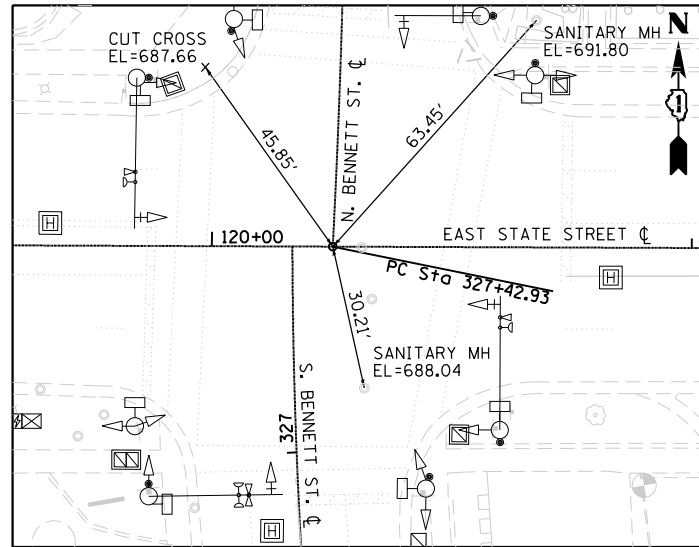


N. BENNETT STREET
 STA 327+42.93
 N: 1901394.4784
 E: 993208.1041

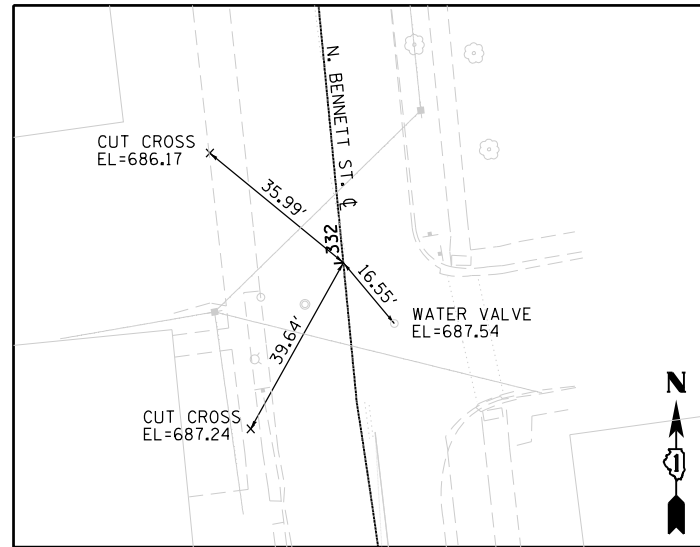


N. BENNETT STREET
 STA 332+00.00
 N: 1901847.5786
 E: 993261.9261

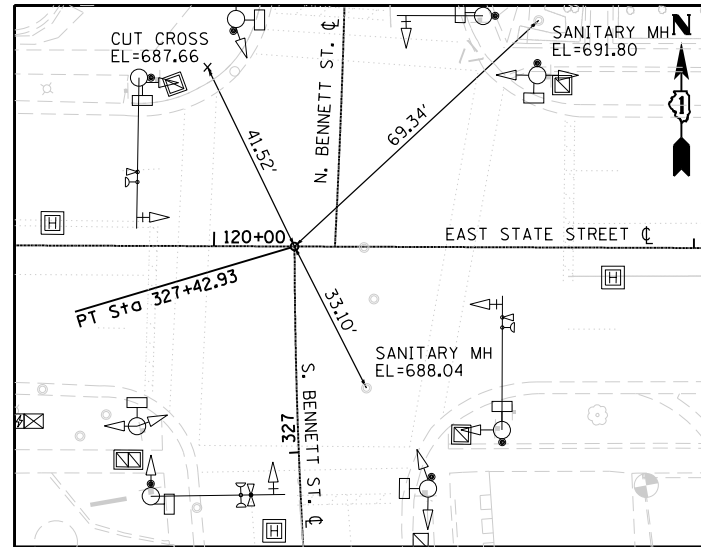

S. BENNETT STREET
 STA 327+42.93
 N: 1901395.9503
 E: 993199.8290

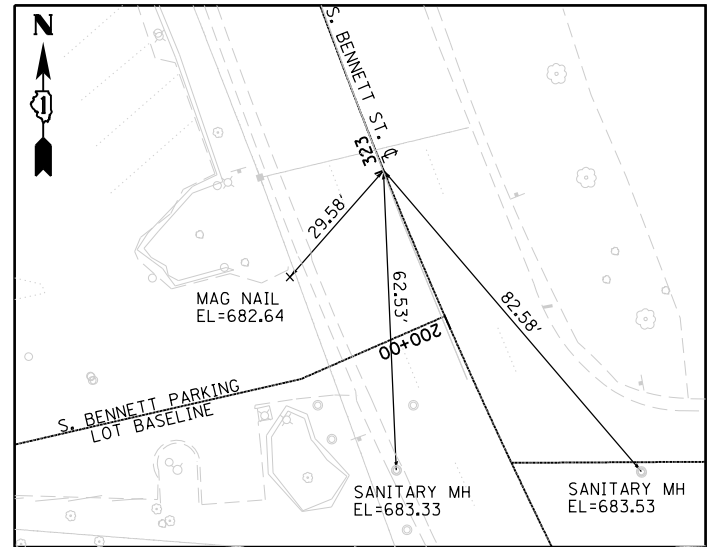


S. BENNETT ST.
 STA 323+00.00
 N: 1900955.7911
 E: 993208.8827

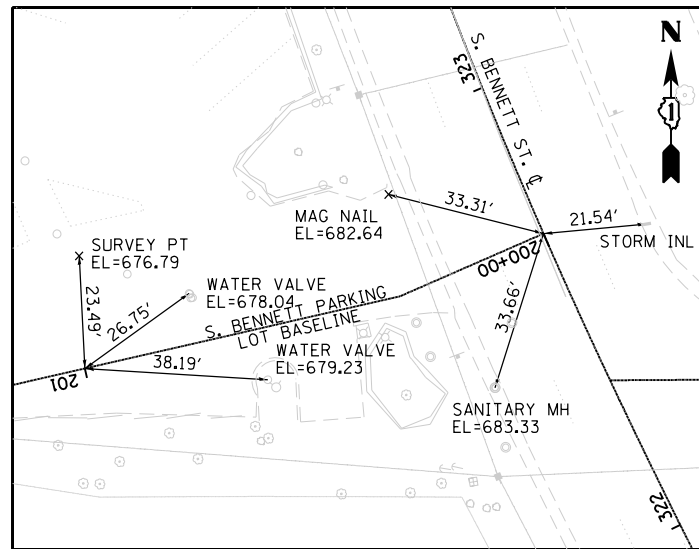


S. BENNETT ST.
 PARKING LOT BASELINE
 STA 200+00.00
 N: 1900923.6739
 E: 993216.2508

S. BENNETT ST.
 PARKING LOT BASELINE
 STA 201+00.00
 N: 1900912.3564
 E: 993117.2788

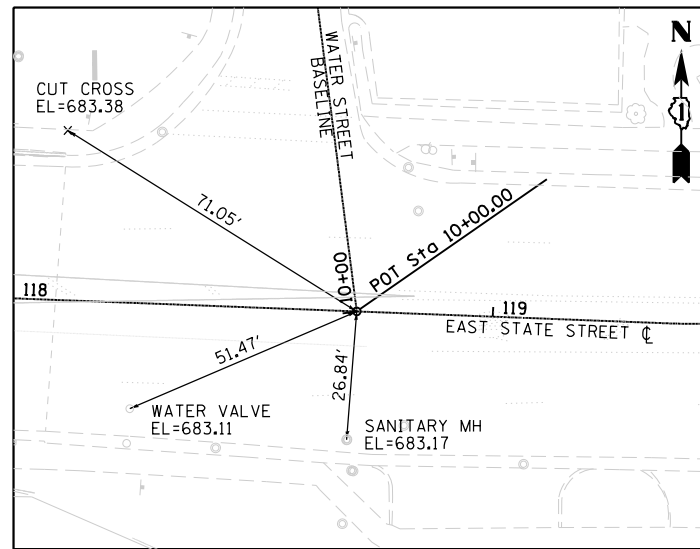

WATER STREET BASELINE
 STA 10+00.00
 N: 1901423.6181
 E: 993057.3553

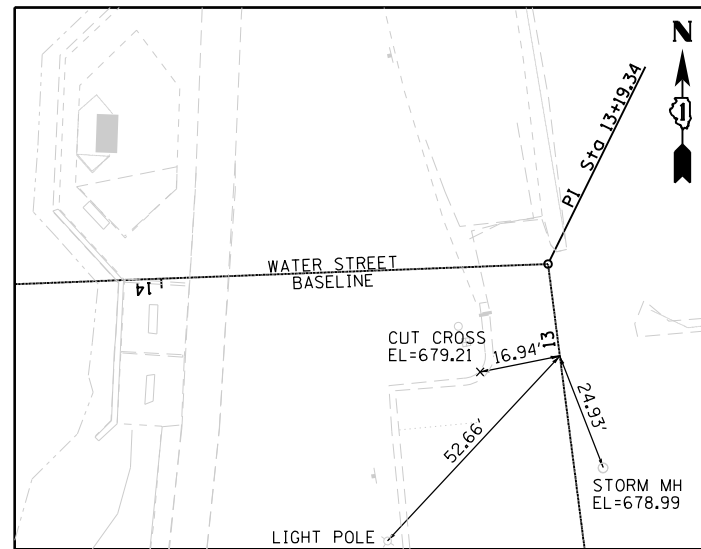

WATER STREET BASELINE
 STA 13+00.00
 N: 1901723.3200
 E: 993070.7273

FILE NAME = F:\961-000 Genevo East State St.CADD_Sheets\961-000_SHT_ALIGN_TIES.02.dgn




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DRAWN - GJE	REVISED -	
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PLOT DATE = 1/13/2025	DATE - 11/7/2024	REVISED -

STATE OF ILLINOIS
 DEPARTMENT OF TRANSPORTATION


ILLINOIS ROUTE 38 - EAST STATE STREET
 ALIGNMENT TIES

SCALE: 1"=20' SHEET 5 OF 6 SHEETS STA. TO STA.


F.A.U. RTE.	SECTION	COUNTY	TOTAL SHEETS	SHEET NO.
0347	05-00102-00-PV	KANE	488	64
CONTRACT NO. 61J84				
ILLINOIS FED. AID PROJECT				

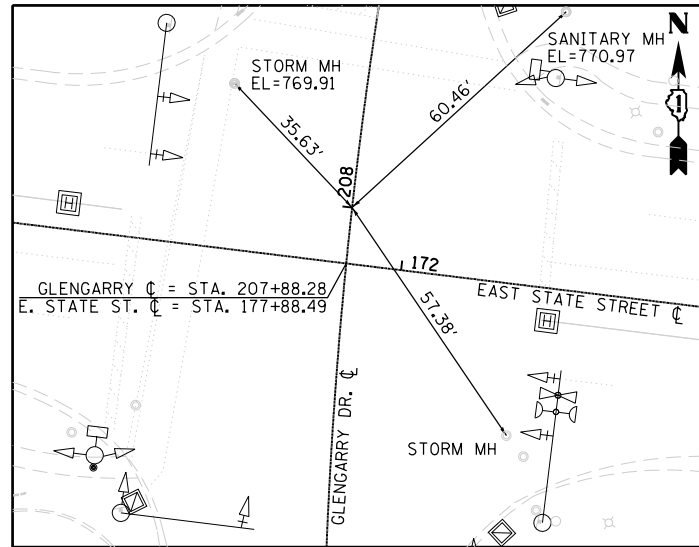


GLENGARRY DRIVE
 STA 208+00.00
 N: 1901489.3854
 E: 998237.5809

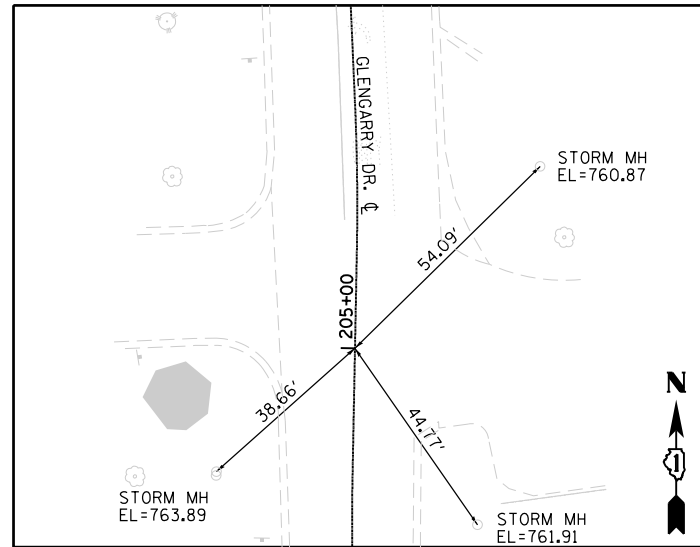

GLENGARRY DRIVE
 STA 205+00.00
 N: 1901194.3330
 E: 998185.2388

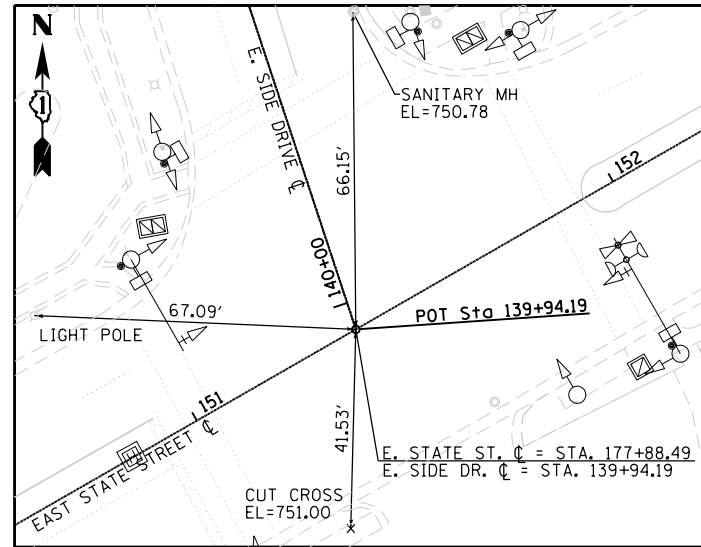

EAST SIDE DRIVE
 STA 139+94.19
 N: 1901597.8896
 E: 996239.3018

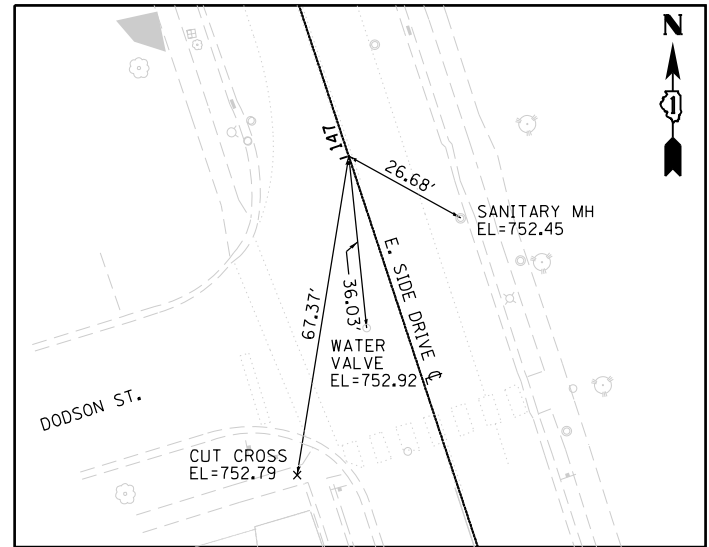

EAST SIDE DRIVE
 STA 147+00.00
 N: 1902296.1079
 E: 996136.0598

FILE NAME = F:\961-000 Genevo East State St.CADD_Sheets\961-000_SHT_ALIGN_TIES_03.dgn



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DRAWN - GJE	REVISIONS -	
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PLOT DATE = 1/13/2025	DATE - 11/7/2024	REVISED -





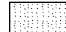

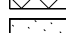
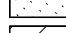
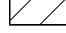

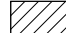


STATE OF ILLINOIS
 DEPARTMENT OF TRANSPORTATION


ILLINOIS ROUTE 38 - EAST STATE STREET
 ALIGNMENT TIES

SCALE: 1"=20' SHEET 6 OF 6 SHEETS STA. TO STA.

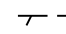F.A.U. RTE.	SECTION	COUNTY	TOTAL SHEETS	SHEET NO.
0347	05-00102-00-PV	KANE	488	65
CONTRACT NO. 61J84				
ILLINOIS FED. AID PROJECT				

LEGEND

-  LINEAR ITEM REMOVAL (STM, FENCE, ETC.)
-  STRUCTURE TO BE REMOVED
-  STRUCTURE TO BE ADJUSTED
-  STRUCTURE TO BE ABANDONED
-  HMA PAVEMENT REMOVAL
-  DRIVEWAY PAVEMENT REMOVAL
-  HOT-MIX ASPHALT SURFACE REMOVAL, 2.5"
-  SIDEWALK REMOVAL
-  CONCRETE REMOVAL
-  BRICK PAVER REMOVAL
-  PLANTER BED REMOVAL
PAID AS CLEARING AND GRUBBING
-  FEATURE TO BE REMOVED (TREE/POLE/ETC.)
-  TREE TRUNK PROTECTION &
TEMPORARY FENCE

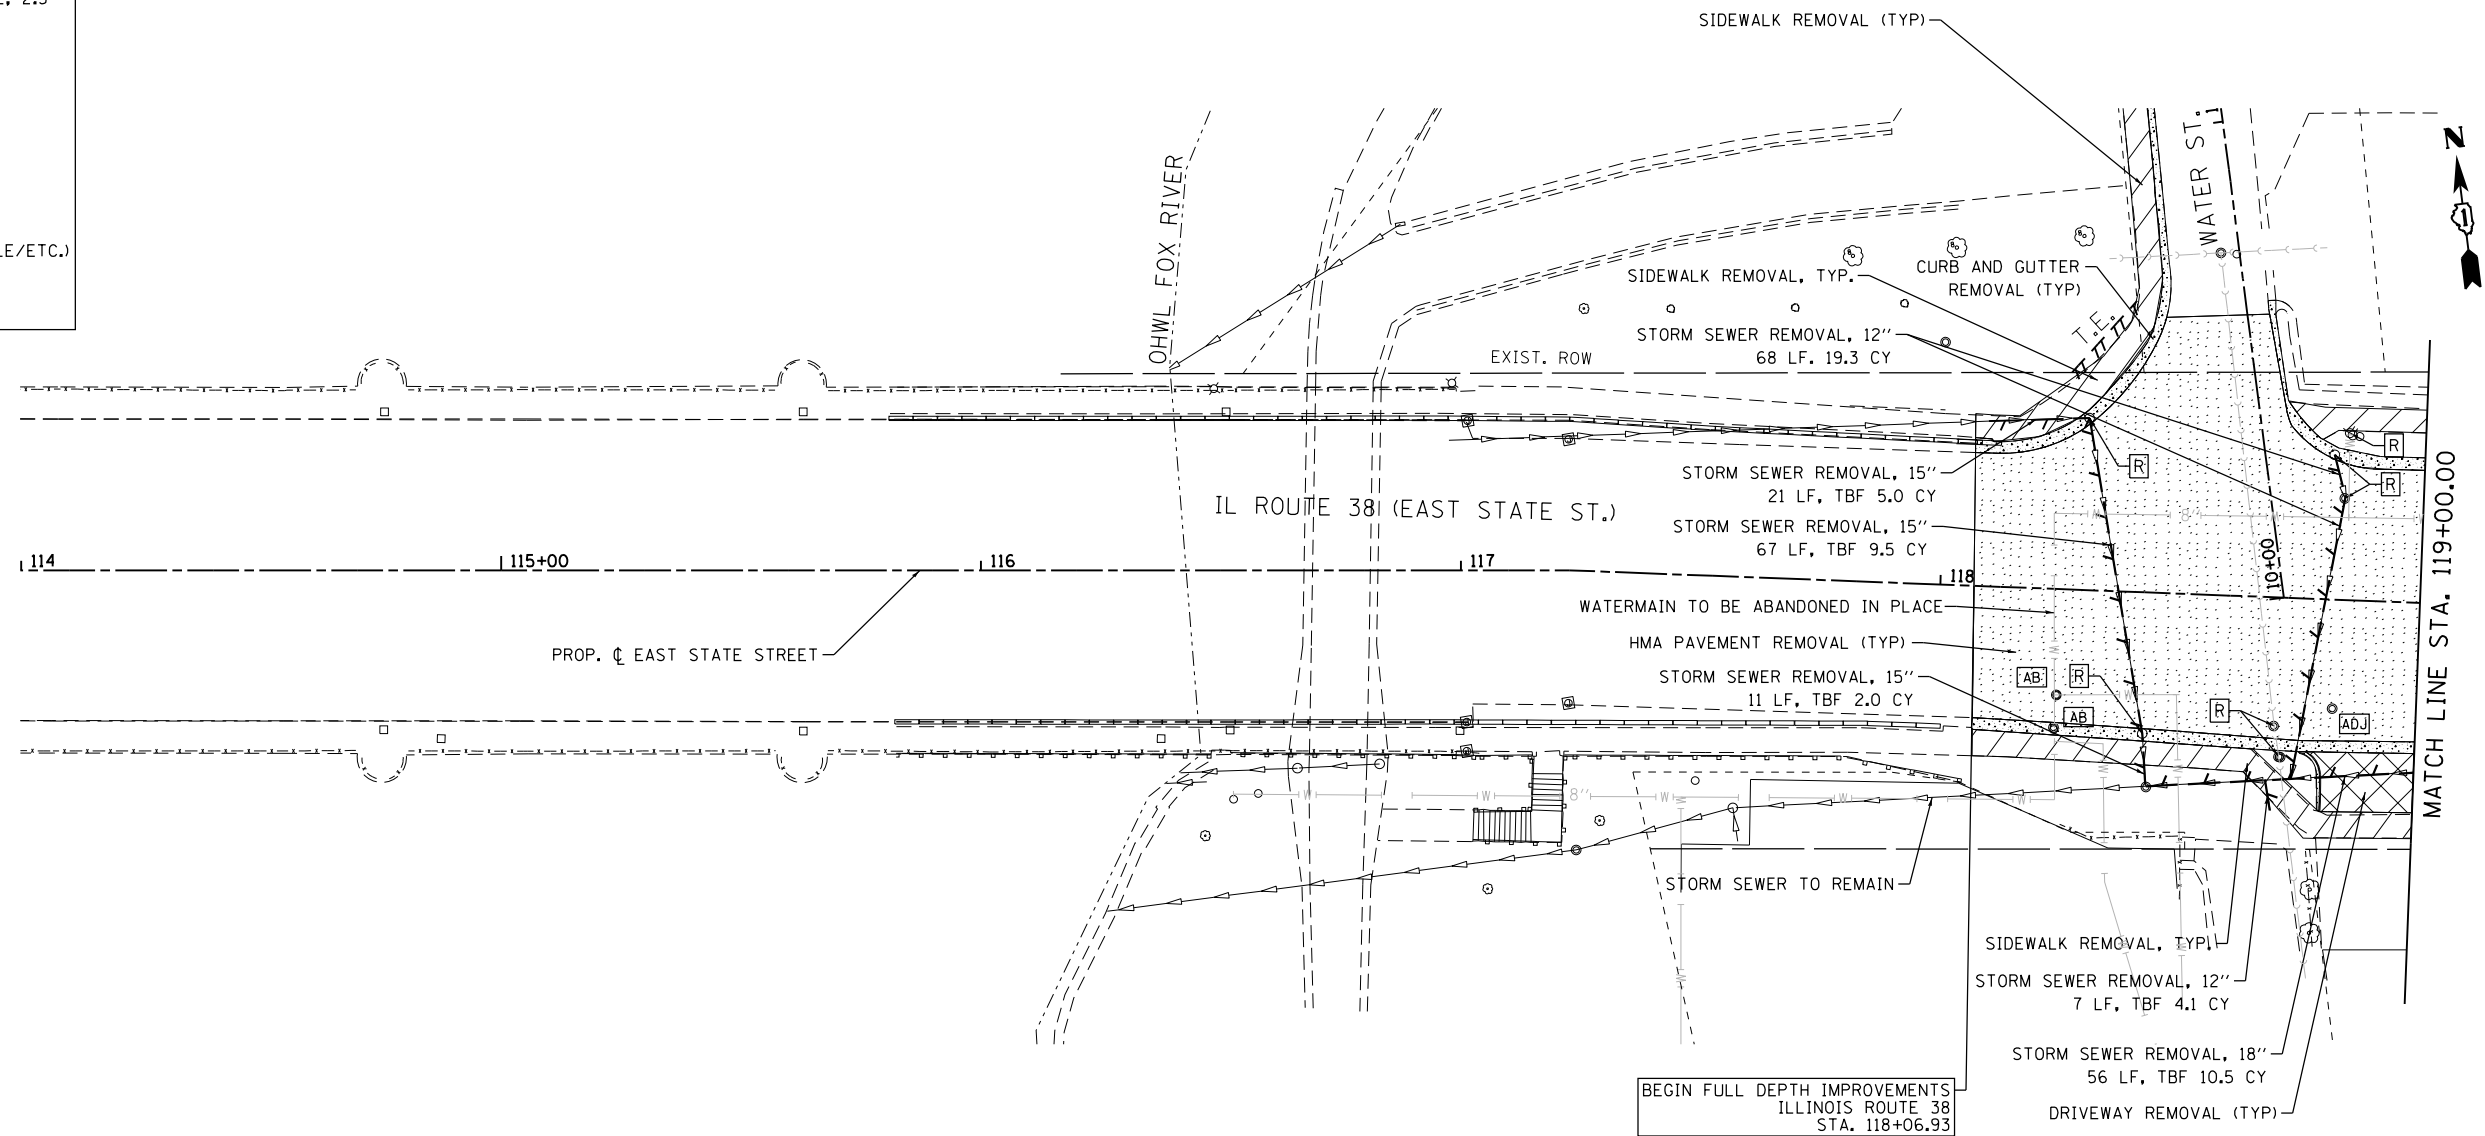

FILE NAME = FA\961-000 Genevo East State St.CADD_Sheets\961-000_SHT_REMOVAL.dwg



USER NAME = tnestor	DESIGNED - GJE	REVISED -
DRAWN - GJE	REVISIONS -	
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PLOT DATE = 1/13/2025	DATE - 11/7/2024	REVISED -



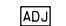
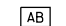






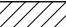

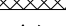
STATE OF ILLINOIS
DEPARTMENT OF TRANSPORTATION


ILLINOIS ROUTE 38 - EAST STATE STREET
REMOVAL PLAN

SCALE: 1"=20' SHEET 1 OF 11 SHEETS STA. 114+00.00 TO STA. 119+00.00

F.A.U. RTE.	SECTION	COUNTY	TOTAL SHEETS	SHEET NO.
0347	05-00102-00-PV	KANE	488	66
CONTRACT NO. 61J84				
ILLINOIS FED. AID PROJECT				

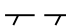LEGEND

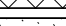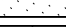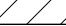-  LINEAR ITEM REMOVAL (STM, FENCE, ETC.)
-  STRUCTURE TO BE REMOVED
-  STRUCTURE TO BE ADJUSTED
-  STRUCTURE TO BE ABANDONED
-  HMA PAVEMENT REMOVAL
-  DRIVEWAY PAVEMENT REMOVAL
-  HOT-MIX ASPHALT SURFACE REMOVAL, 2.5"
-  SIDEWALK REMOVAL
-  CONCRETE REMOVAL
-  BRICK PAVER REMOVAL
-  PLANTER BED REMOVAL PAID AS CLEARING AND GRUBBING
-  FEATURE TO BE REMOVED (TREE/POLE/ETC.)
-  TREE TRUNK PROTECTION & TEMPORARY FENCE

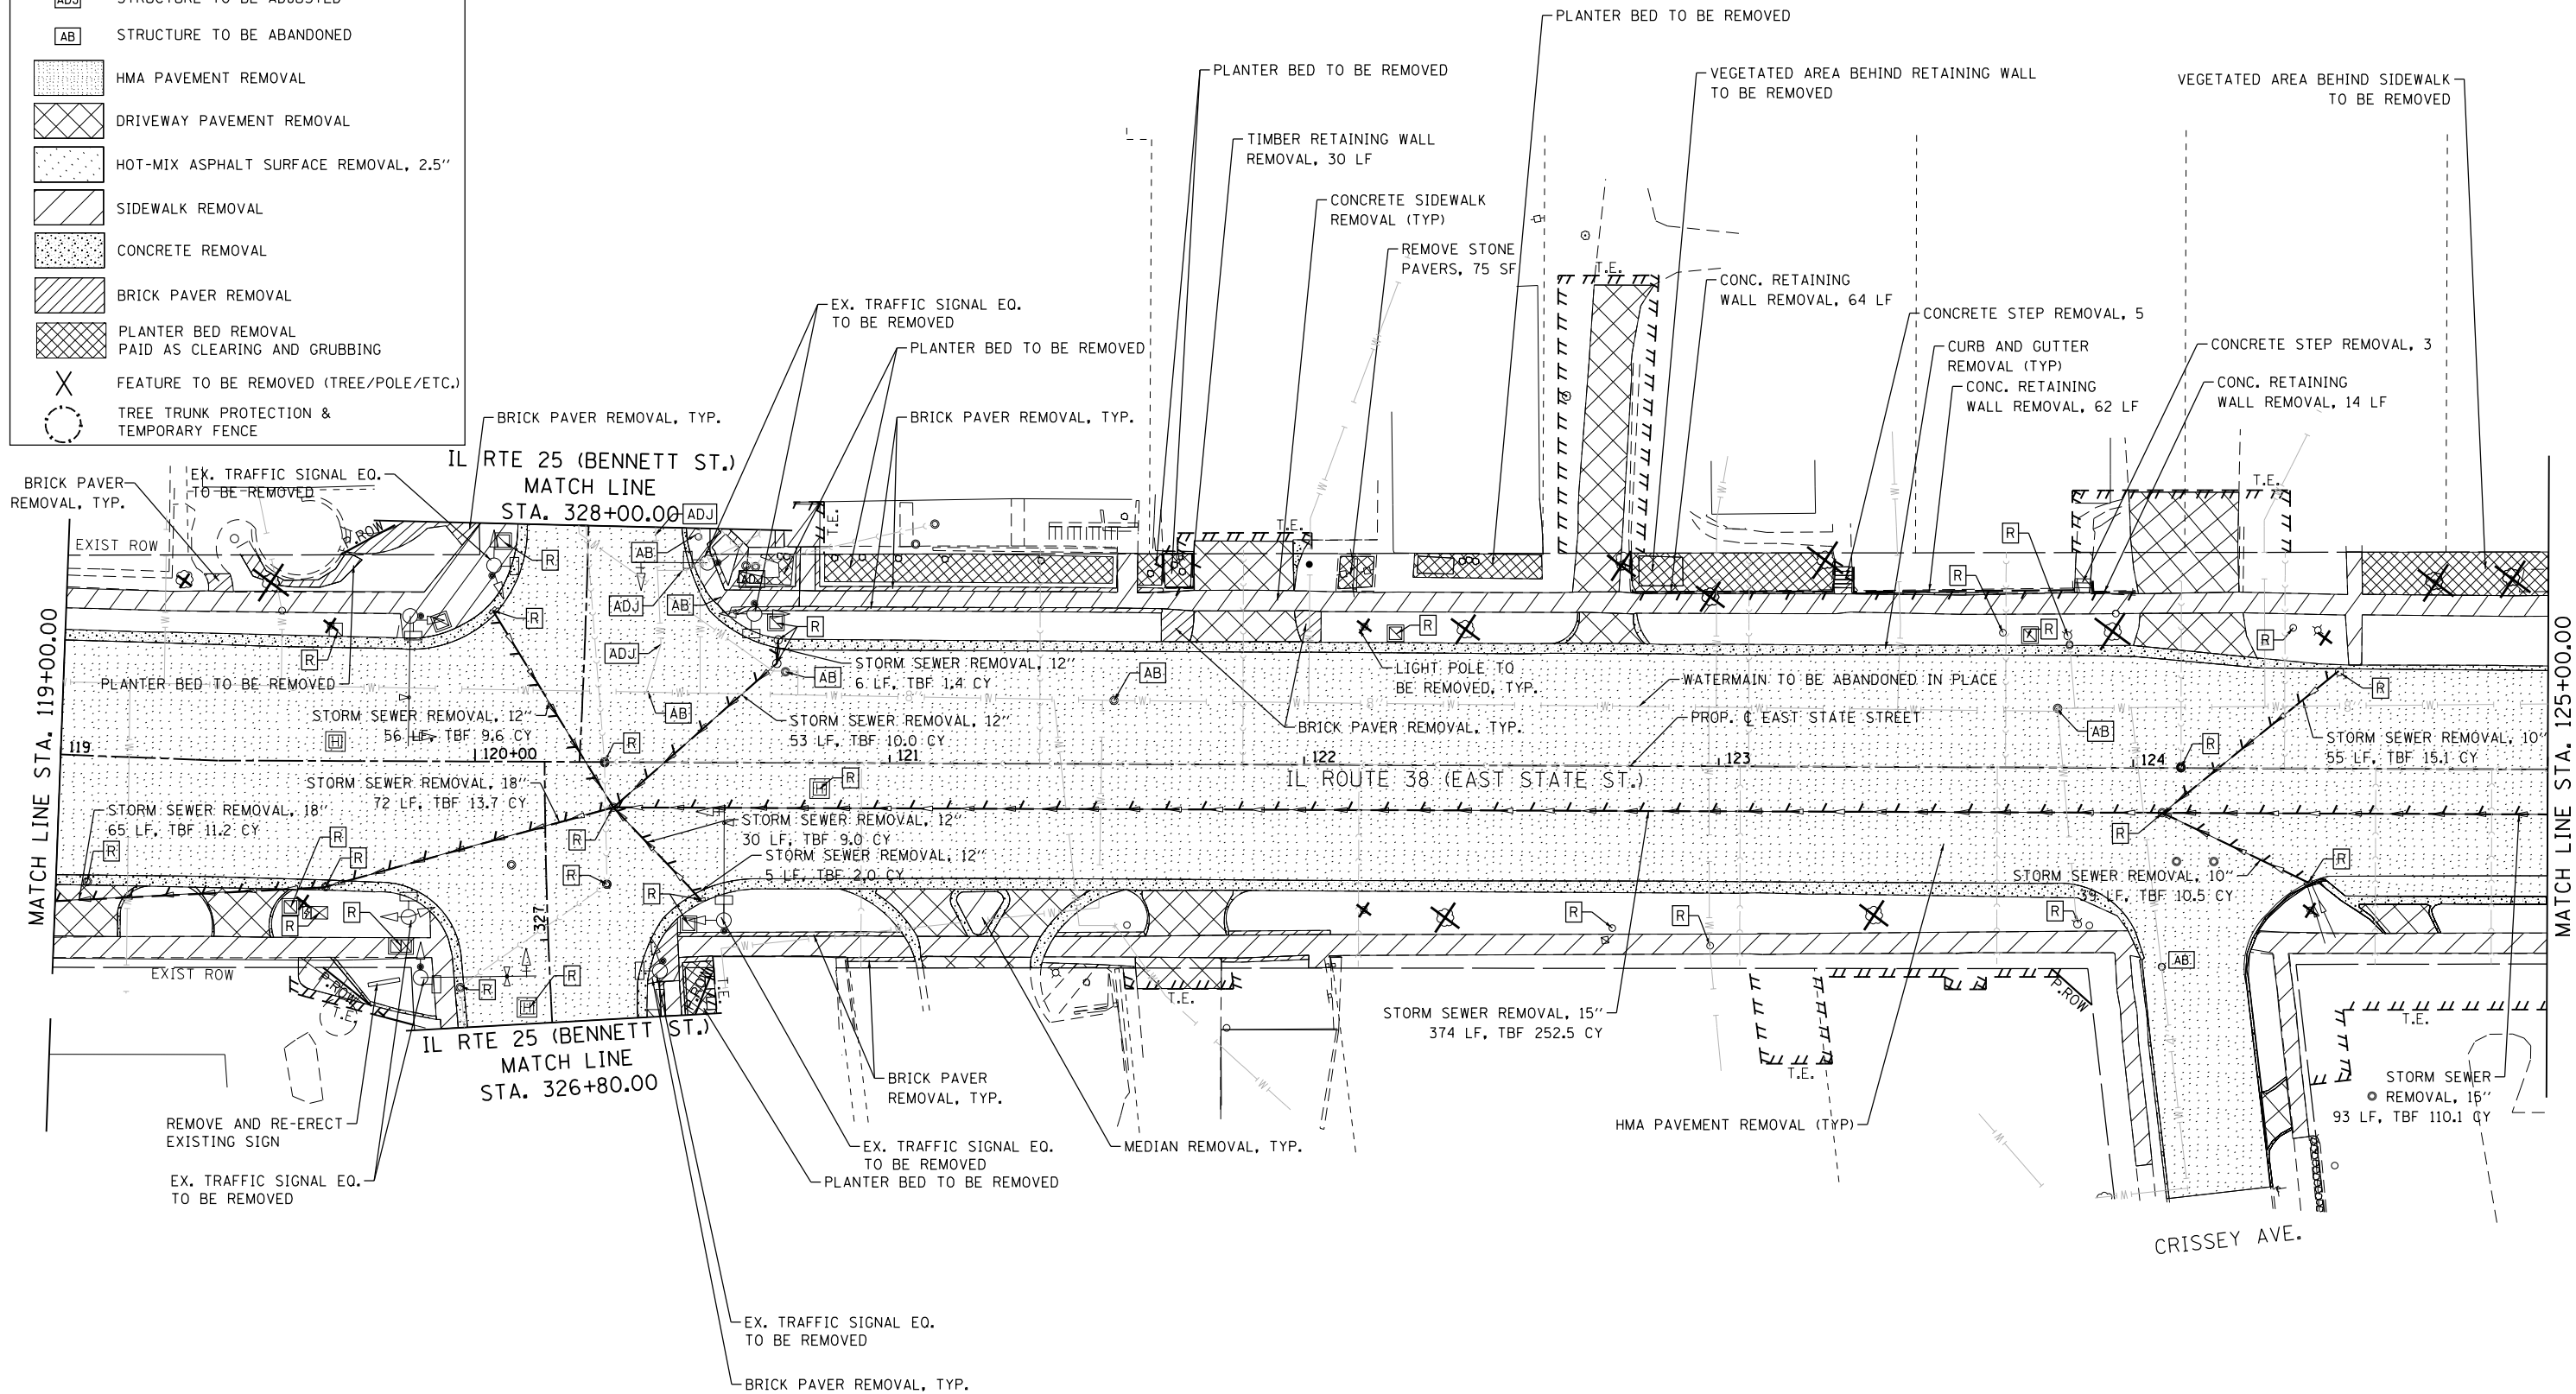

FILE NAME = FA\961-000 Genevo East State St.CADD.Sheets\961-000_SHT_REMOVAL_02.dgn






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PLOT DATE = 1/13/2025	CHECKED - DBB	REVISED -
	DATE - 11/7/2024	REVISED -

STATE OF ILLINOIS
DEPARTMENT OF TRANSPORTATION

ILLINOIS ROUTE 38 - EAST STATE STREET
REMOVAL PLAN

SCALE: 1"=20' SHEET 2 OF 11 SHEETS STA. 119+00.00 TO STA. 125+00.00

F.A.U. RTE.	SECTION	COUNTY	TOTAL SHEETS	SHEET NO.
0347	05-00102-00-PV	KANE	488	67
CONTRACT NO. 61J84				
ILLINOIS FED. AID PROJECT				

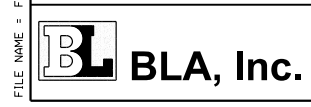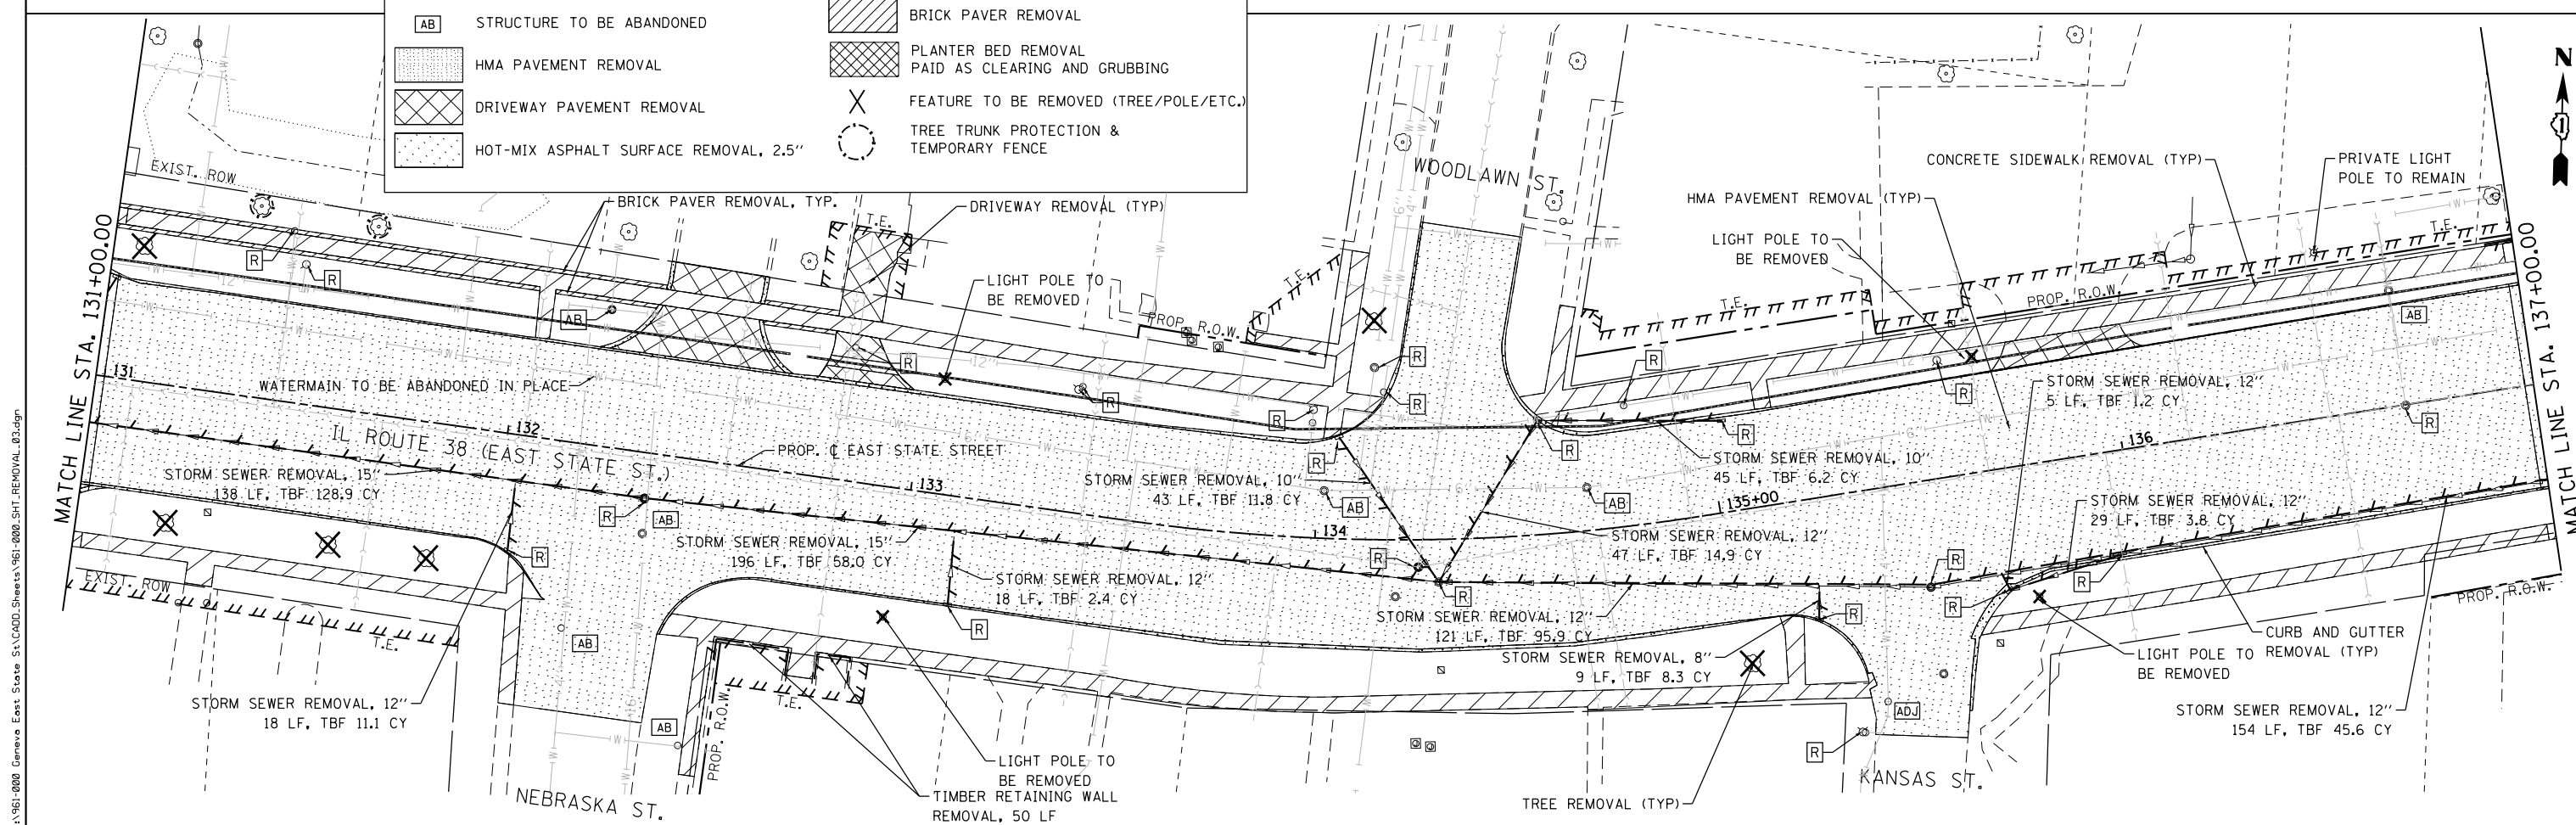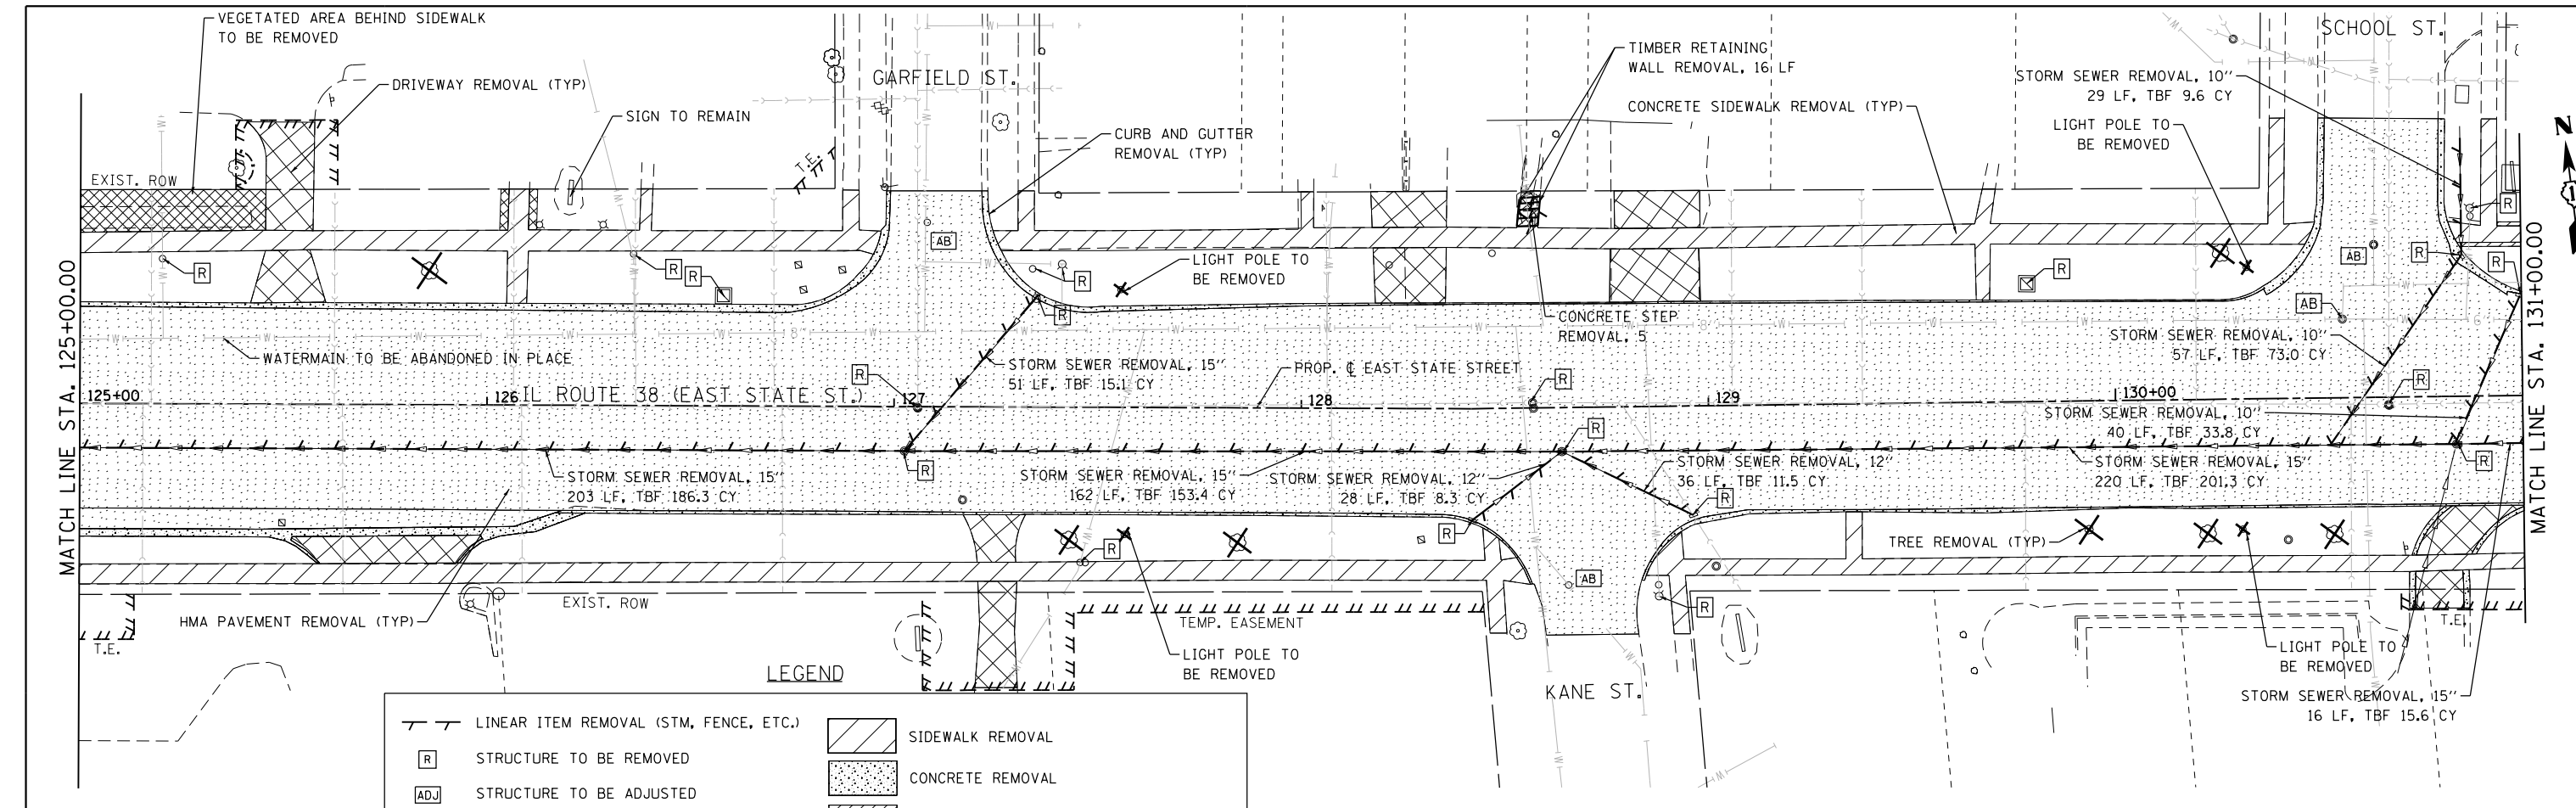

USER NAME = tnestor	DESIGNED - GJE	REVISED -
	DRAWN - GJE	REVISED -
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PLOT DATE = 1/13/2025	DATE - 11/7/2024	REVISED -



**STATE OF ILLINOIS
DEPARTMENT OF TRANSPORTATION**

**ILLINOIS ROUTE 38 - EAST STATE STREET
REMOVAL PLAN**

SCALE: 1"=20' SHEET 3 OF 11 SHEETS STA. 125+00.00 TO STA. 137+00.00

F.A.U. RTE.	SECTION	COUNTY	TOTAL SHEETS	SHEET NO.
0347	05-00102-00-PV	KANE	488	68
CONTRACT NO. 61J84				
ILLINOIS FED. AID PROJECT				

FILE NAME = FA\961-000 Genevo East State St.CADD.Sheets\961-0000_SHT_REMOVAL_03.dgn

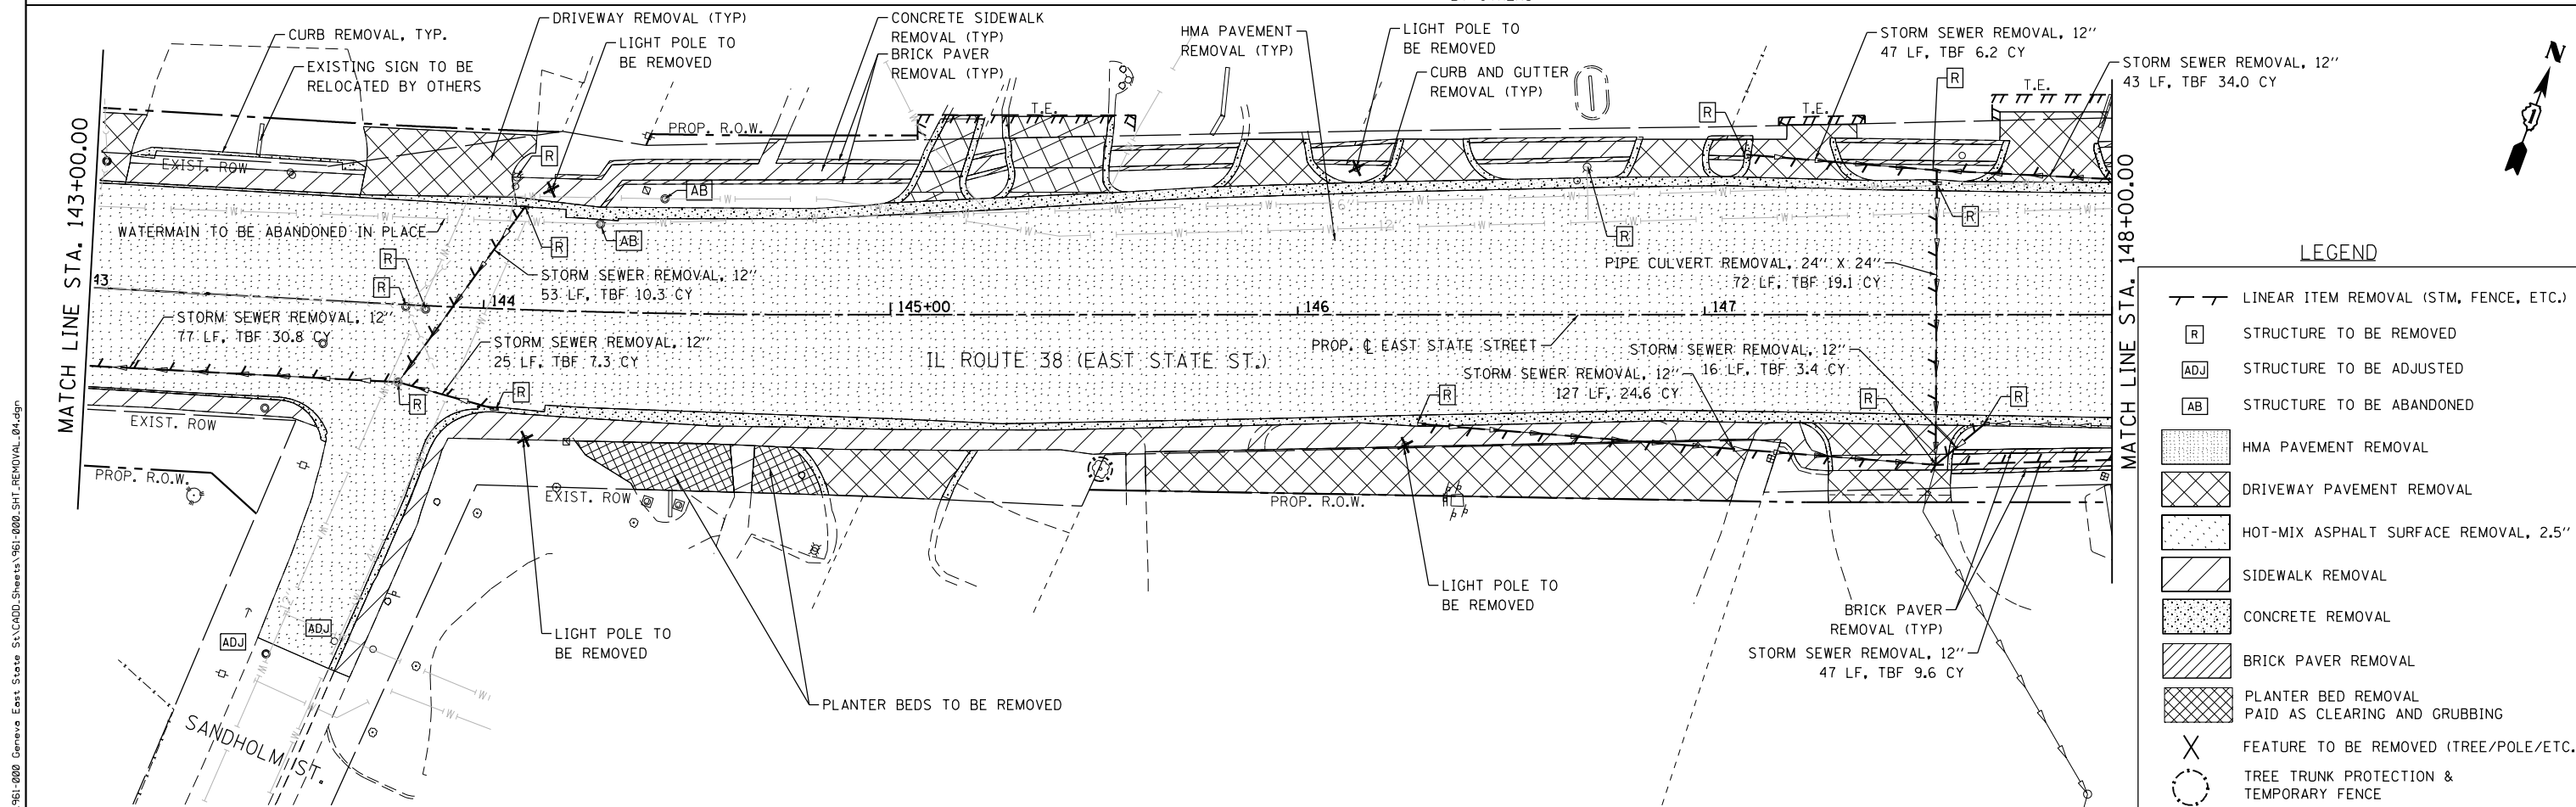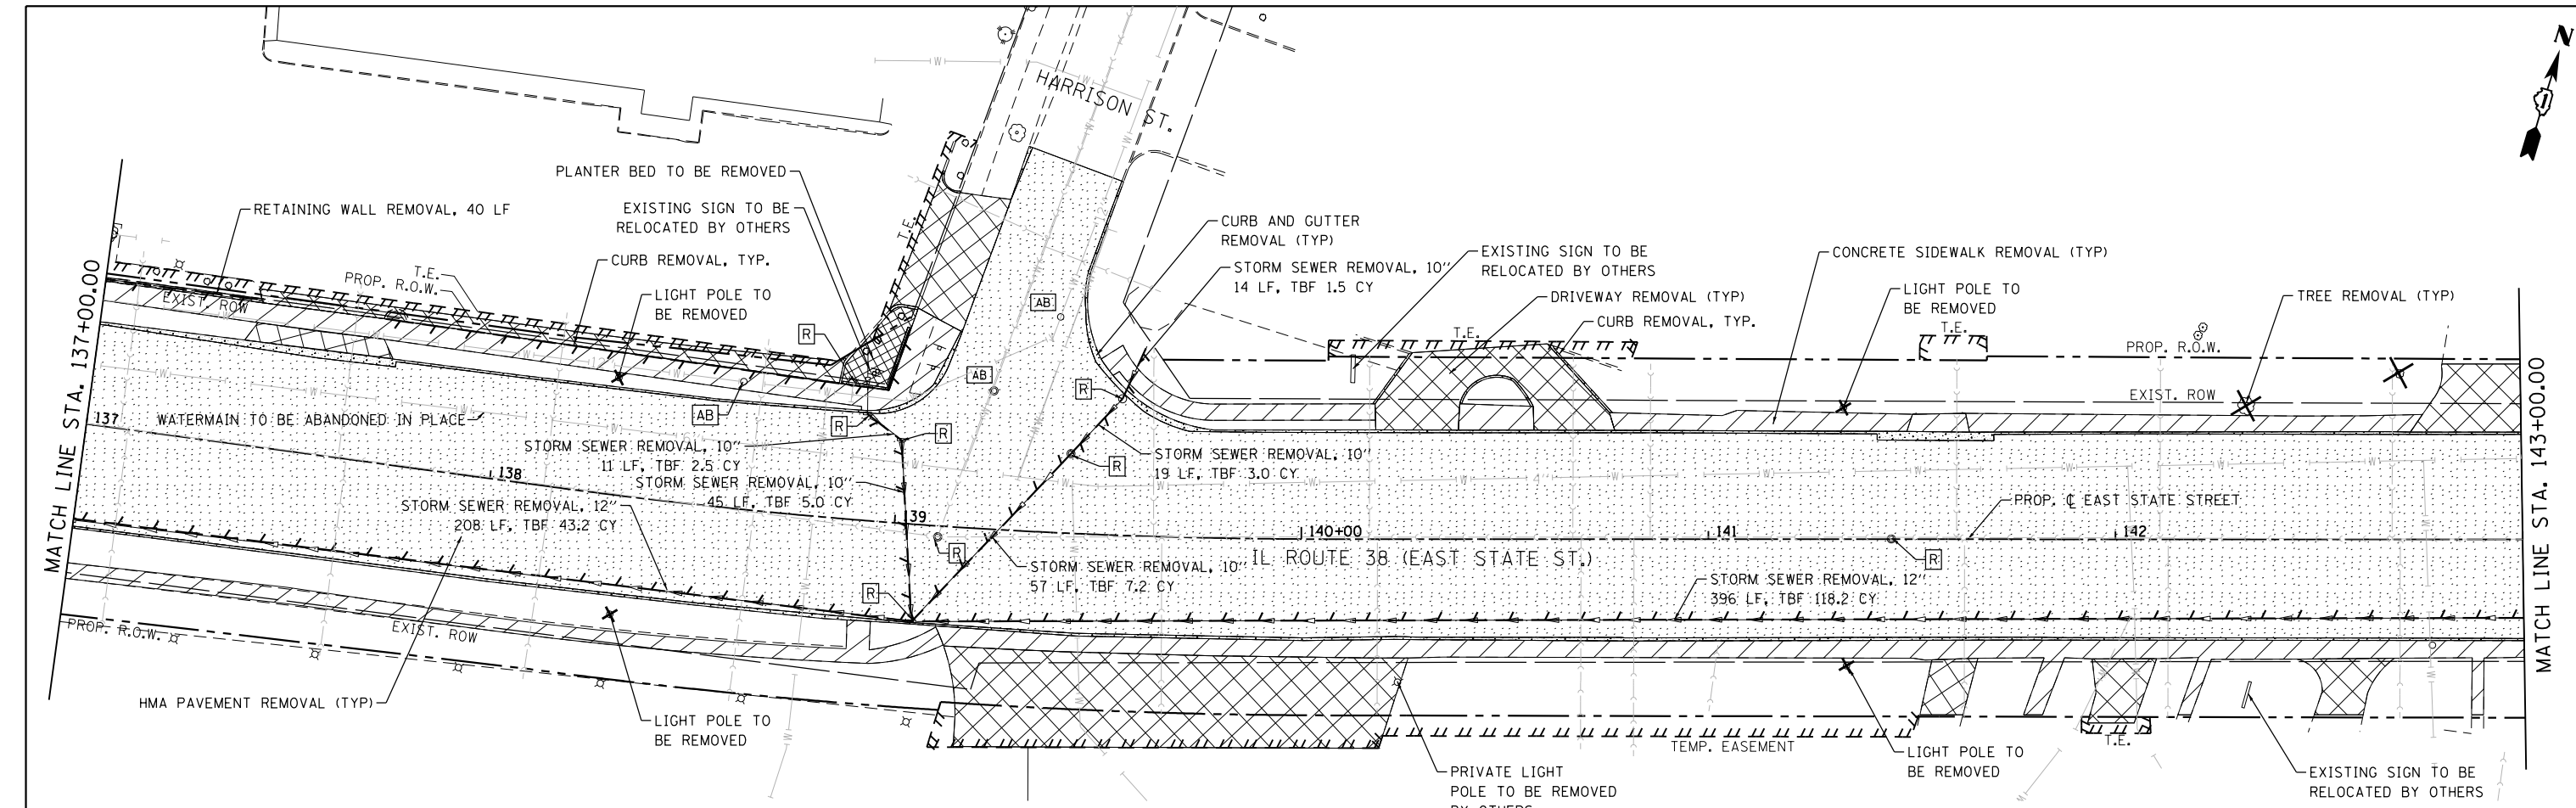

LEGEND

- LINEAR ITEM REMOVAL (STM, FENCE, ETC.)
- STRUCTURE TO BE REMOVED
- STRUCTURE TO BE ADJUSTED
- STRUCTURE TO BE ABANDONED
- HMA PAVEMENT REMOVAL
- DRIVEWAY PAVEMENT REMOVAL
- HOT-MIX ASPHALT SURFACE REMOVAL, 2.5"
- SIDEWALK REMOVAL
- CONCRETE REMOVAL
- BRICK PAVER REMOVAL
- PLANTER BED REMOVAL PAID AS CLEARING AND GRUBBING
- FEATURE TO BE REMOVED (TREE/POLE/ETC.)
- TREE TRUNK PROTECTION & TEMPORARY FENCE

FILE NAME = F:\961-000 Genevo East State St.CADD.Sheets\961-000_SHT_REMOVAL_04.dgn




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PLOT DATE = 1/13/2025	CHECKED - DBB	REVISED -
	DATE - 11/7/2024	REVISED -

**STATE OF ILLINOIS
DEPARTMENT OF TRANSPORTATION**

**ILLINOIS ROUTE 38 - EAST STATE STREET
REMOVAL PLAN**

SCALE: 1"=20' SHEET 4 OF 11 SHEETS STA. 137+00.00 TO STA. 148+00.00

F.A.U. RTE.	SECTION	COUNTY	TOTAL SHEETS	SHEET NO.
0347	05-00102-00-PV	KANE	488	69
CONTRACT NO. 61J84				
ILLINOIS FED. AID PROJECT				

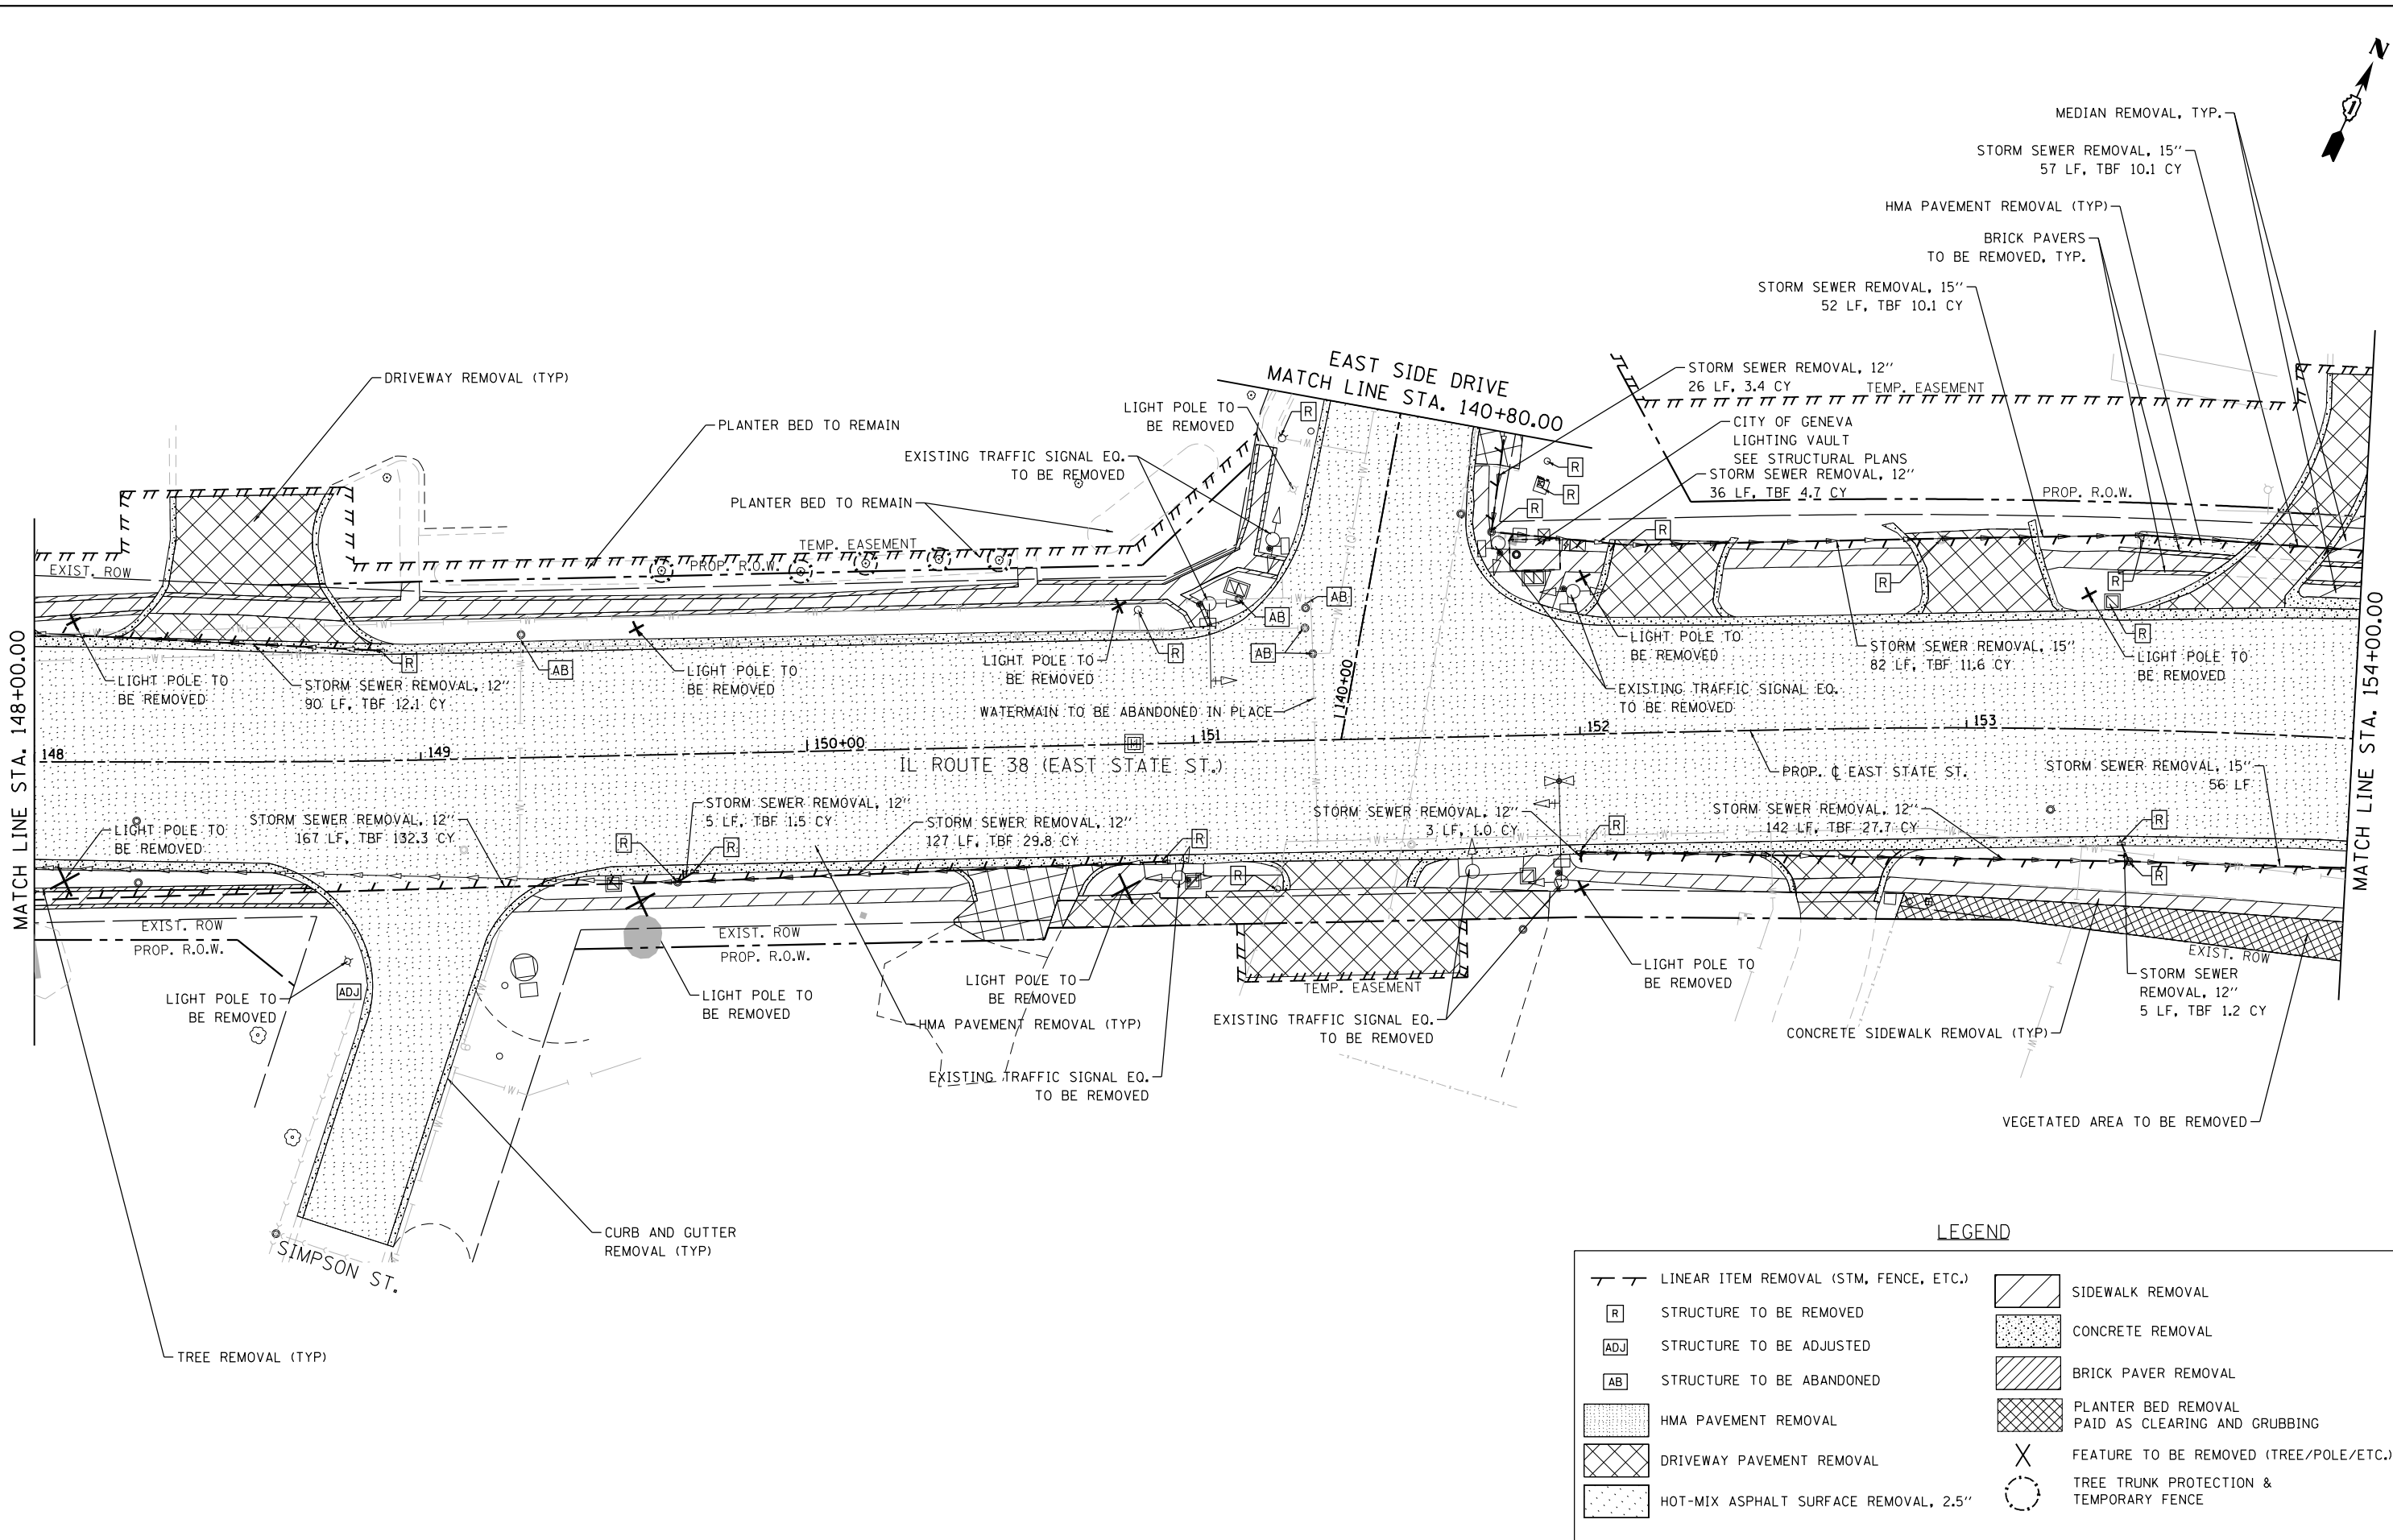

LEGEND

	LINEAR ITEM REMOVAL (STM, FENCE, ETC.)		SIDEWALK REMOVAL
	STRUCTURE TO BE REMOVED		CONCRETE REMOVAL
	STRUCTURE TO BE ADJUSTED		BRICK PAVER REMOVAL
	STRUCTURE TO BE ABANDONED		PLANTER BED REMOVAL PAID AS CLEARING AND GRUBBING
	HMA PAVEMENT REMOVAL		FEATURE TO BE REMOVED (TREE/POLE/ETC.)
	DRIVEWAY PAVEMENT REMOVAL		TREE TRUNK PROTECTION & TEMPORARY FENCE
	HOT-MIX ASPHALT SURFACE REMOVAL, 2.5"		

FILE NAME = F:\961-000-Genevo East State St.CADD_Sheets\961-000_SHT_REMOVAL_05.dgn




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PLOT DATE = 1/13/2025	DATE - 11/7/2024	REVISED -

**STATE OF ILLINOIS
DEPARTMENT OF TRANSPORTATION**

**ILLINOIS ROUTE 38 - EAST STATE STREET
REMOVAL PLAN**

SCALE: 1"=20' SHEET 5 OF 11 SHEETS STA. 148+00.00 TO STA. 154+00.00

F.A.U. RTE.	SECTION	COUNTY	TOTAL SHEETS	SHEET NO.
0347	05-00102-00-PV	KANE	488	70
CONTRACT NO. 61J84				
ILLINOIS FED. AID PROJECT				

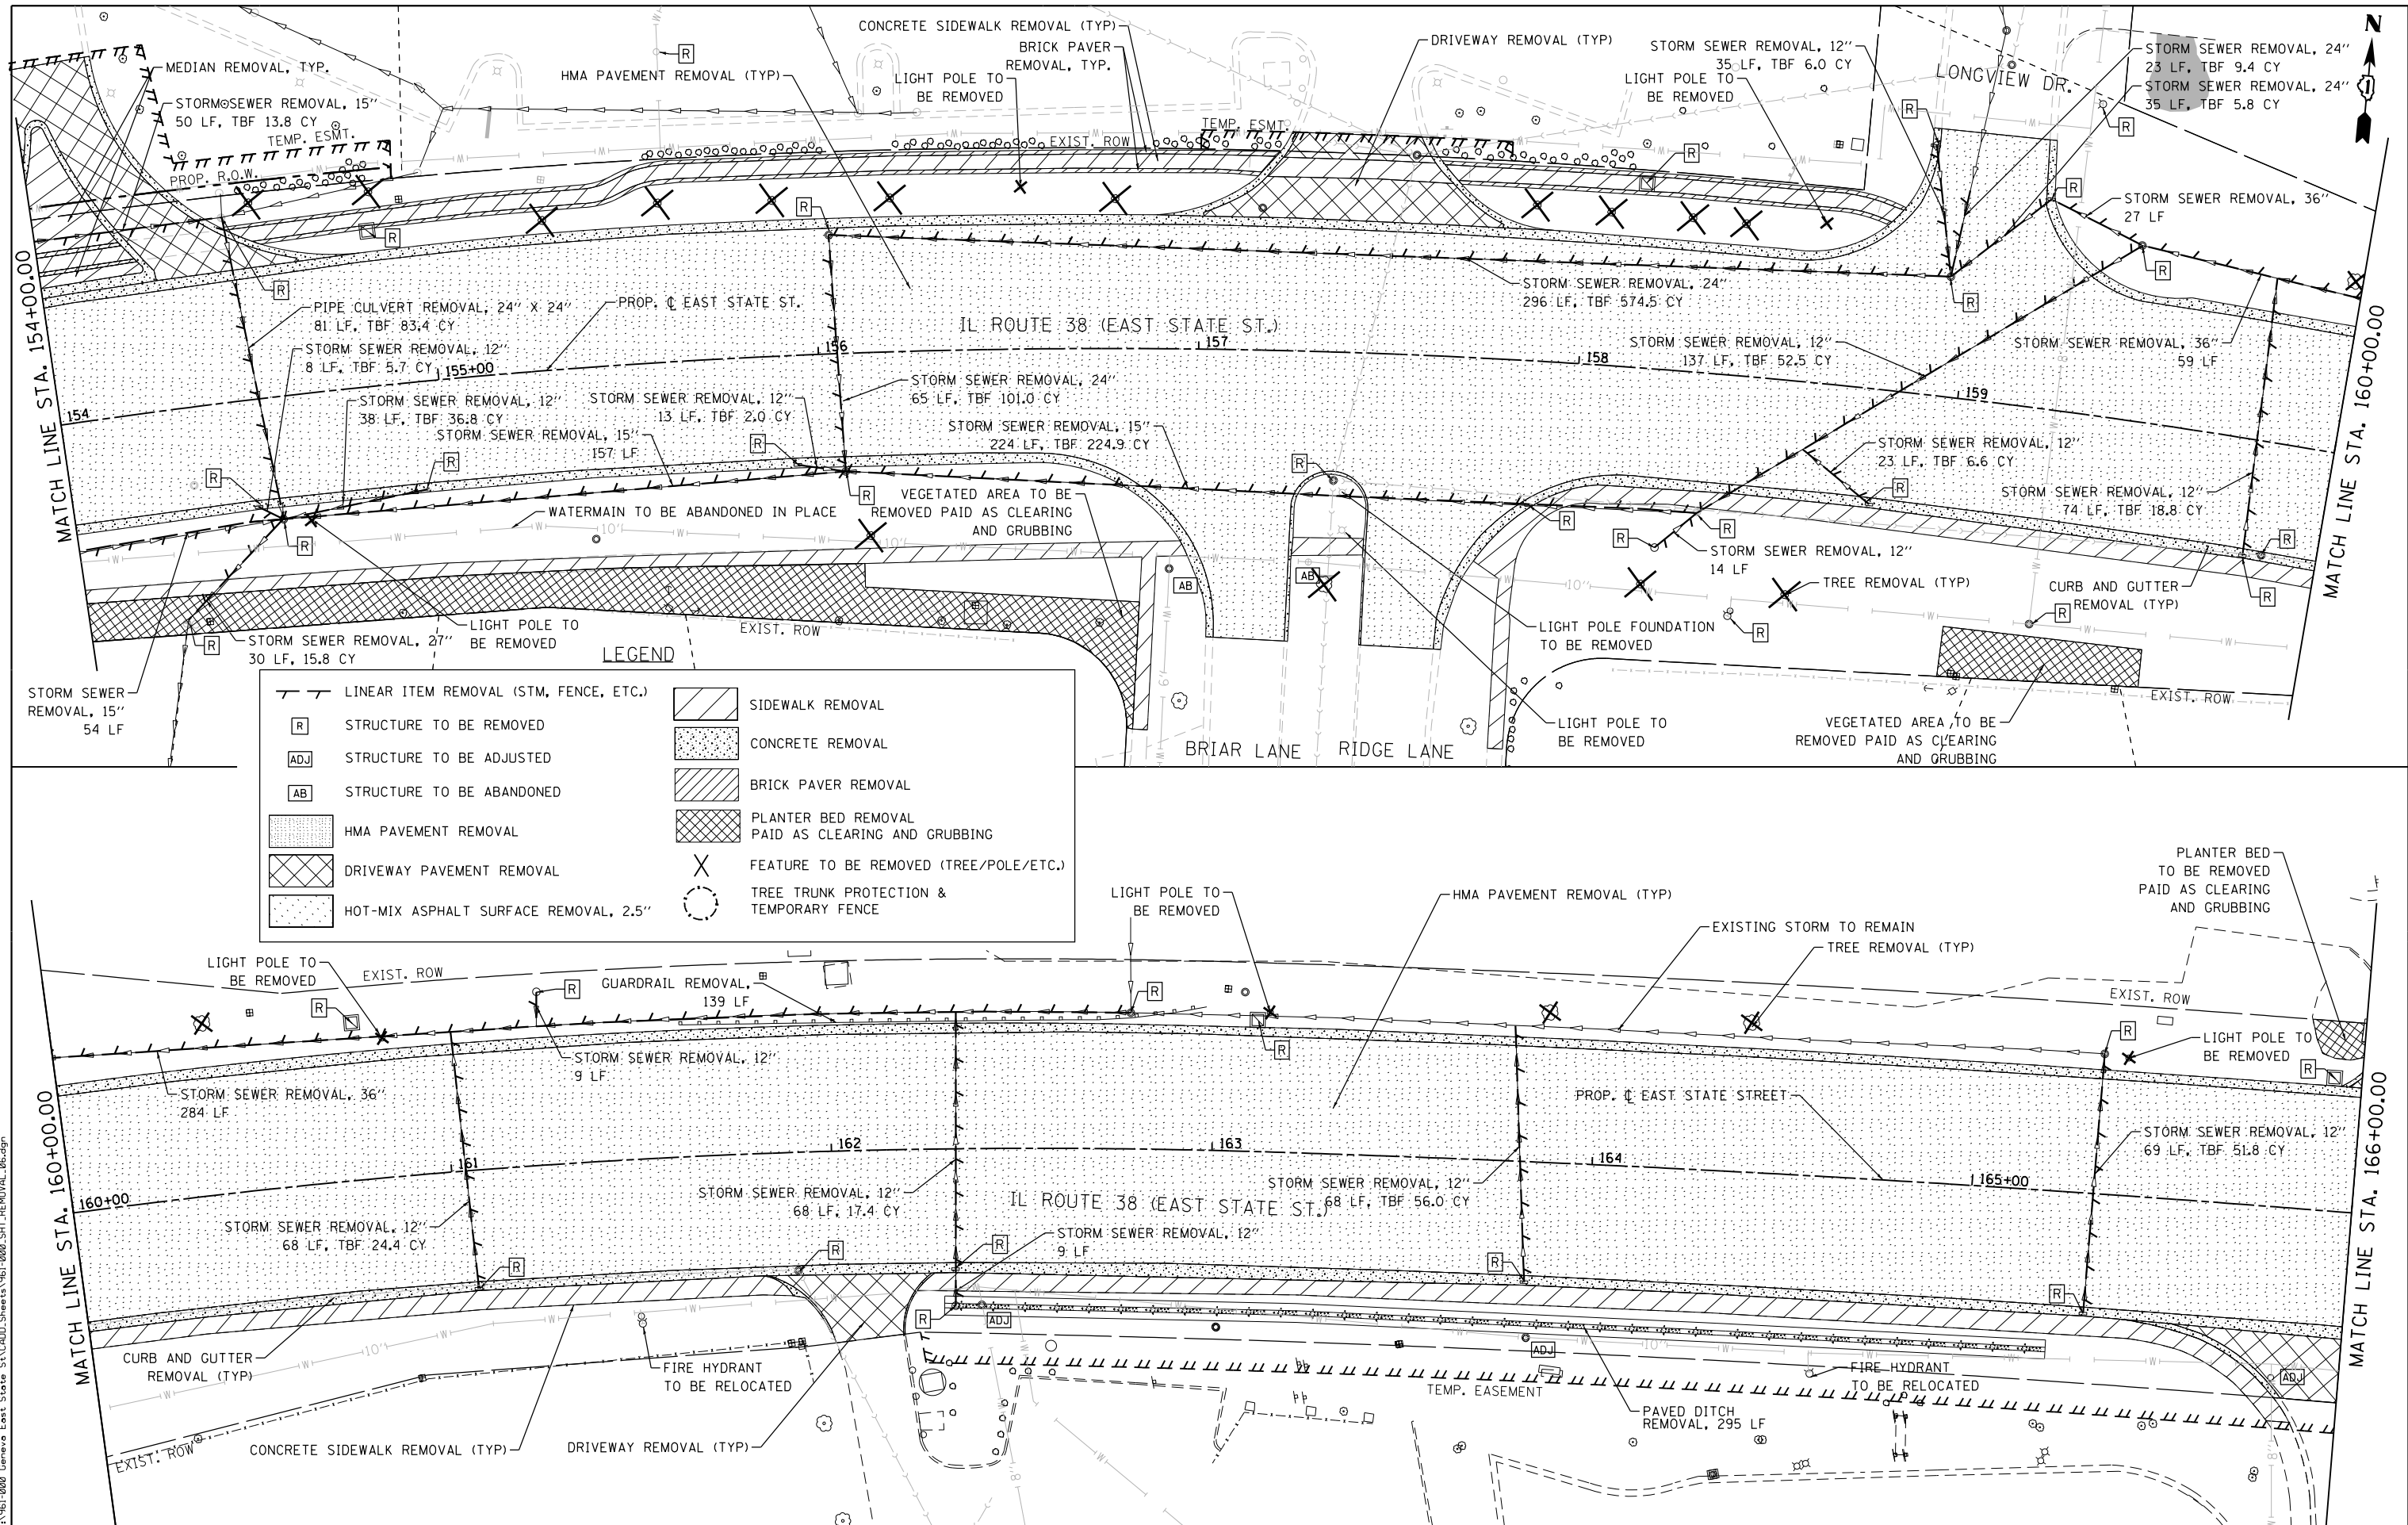

FILE NAME = FA\961-0000 Genevo East State St.CADD_Sheets\961-0000_SHT_REMOVAL_06.dgn



USER NAME = tnestor	DESIGNED - GJE	REVISED -
DRAWN - GJE	REVISED -	
CHECKED - DBB	REVISED -	
DATE - 11/7/2024	REVISED -	



**STATE OF ILLINOIS
DEPARTMENT OF TRANSPORTATION**

**ILLINOIS ROUTE 38 - EAST STATE STREET
REMOVAL PLAN**

SCALE: 1"=20'

SHEET 6 OF 11 SHEETS STA. 154+00.00 TO STA. 166+00.00

F.A.U. RTE. 0347	SECTION 05-00102-00-PV	COUNTY KANE	TOTAL SHEETS 488	SHEET NO. 71
CONTRACT NO. 61J84			ILLINOIS FED. AID PROJECT	

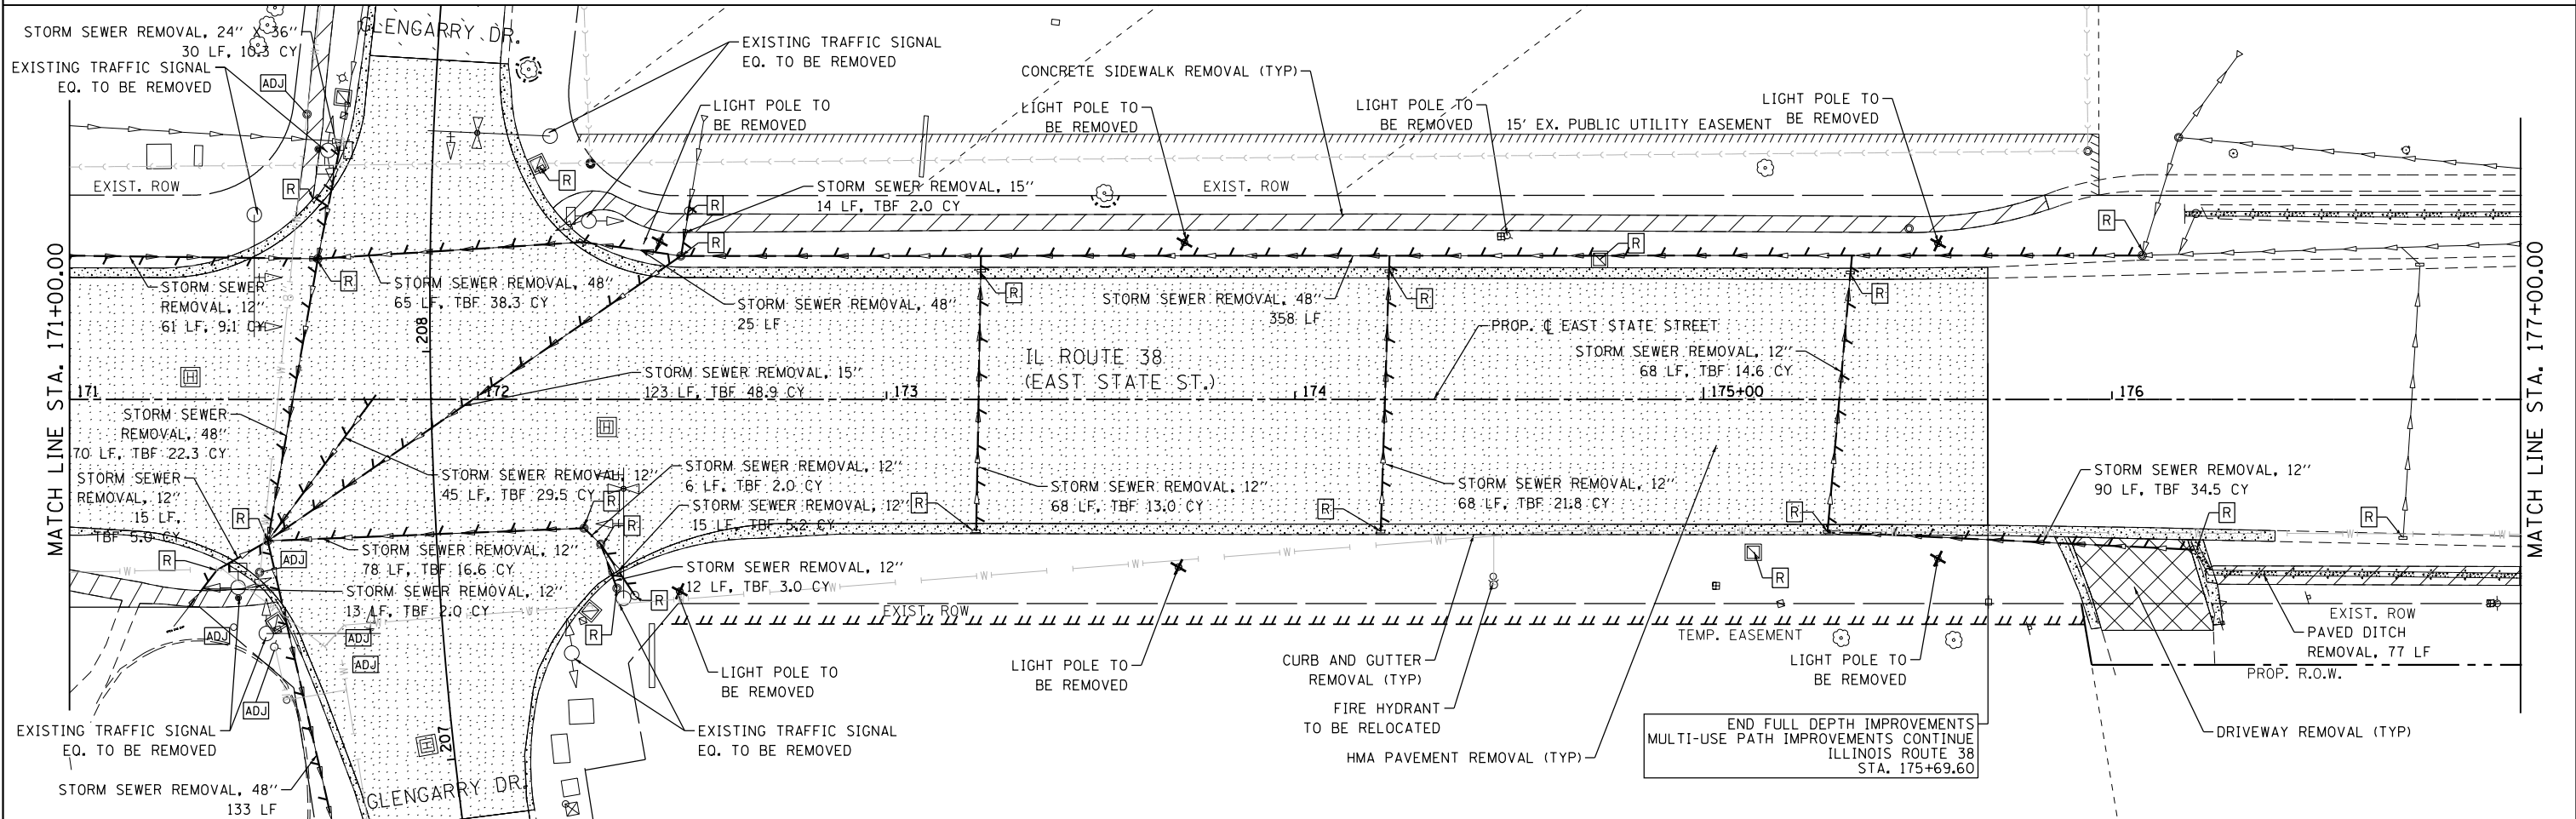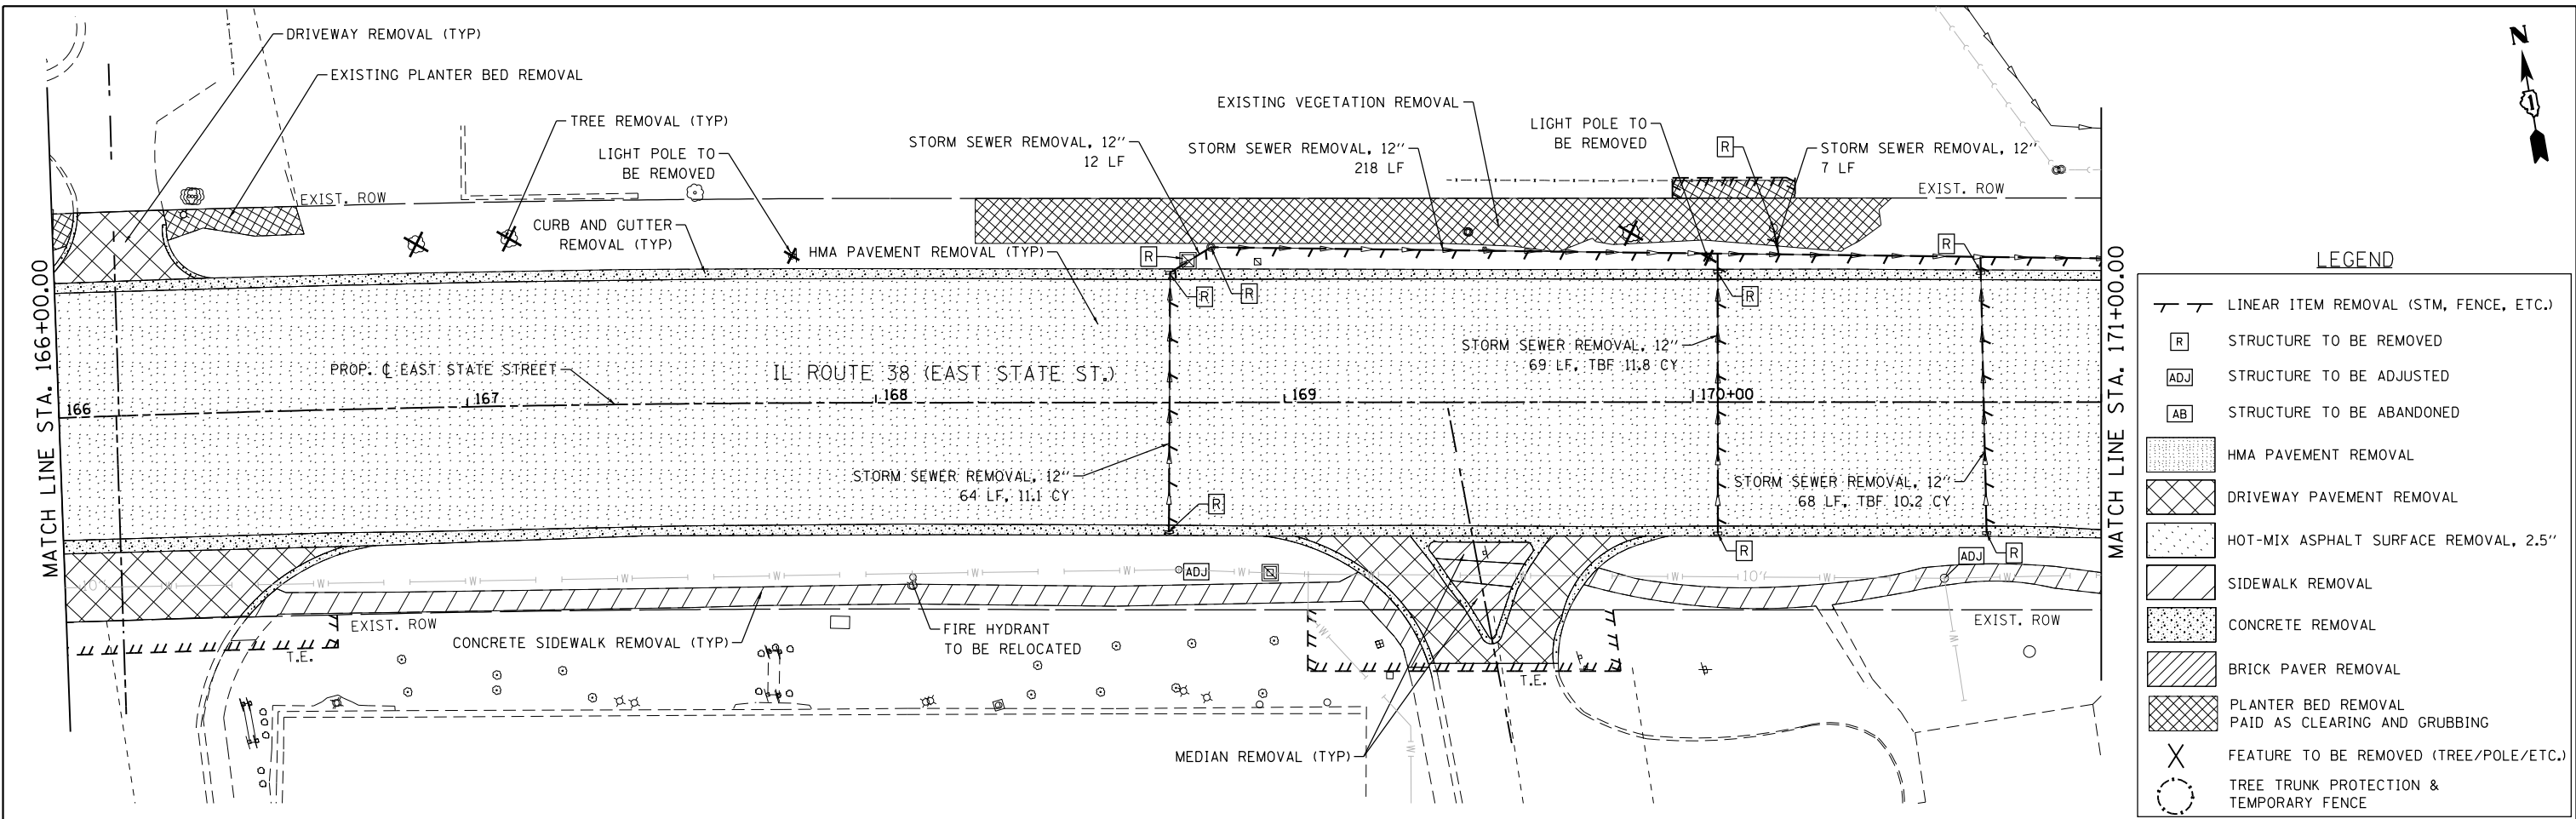

FILE NAME = FA\961-0000 Genevo East State St.CADD_Sheets\961-0000_SHT_REMOVAL_07.dgn





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PLOT DATE = 1/13/2025	DATE - 11/7/2024	REVISED -

**STATE OF ILLINOIS
DEPARTMENT OF TRANSPORTATION**

**ILLINOIS ROUTE 38 - EAST STATE STREET
REMOVAL PLAN**

SCALE: 1"=20' SHEET 7 OF 11 SHEETS STA. 166+00.00 TO STA. 177+00.00

F.A.U. RTE.	SECTION	COUNTY	TOTAL SHEETS	SHEET NO.
0347	05-00102-00-PV	KANE	488	72
CONTRACT NO. 61J84				
ILLINOIS FED. AID PROJECT				

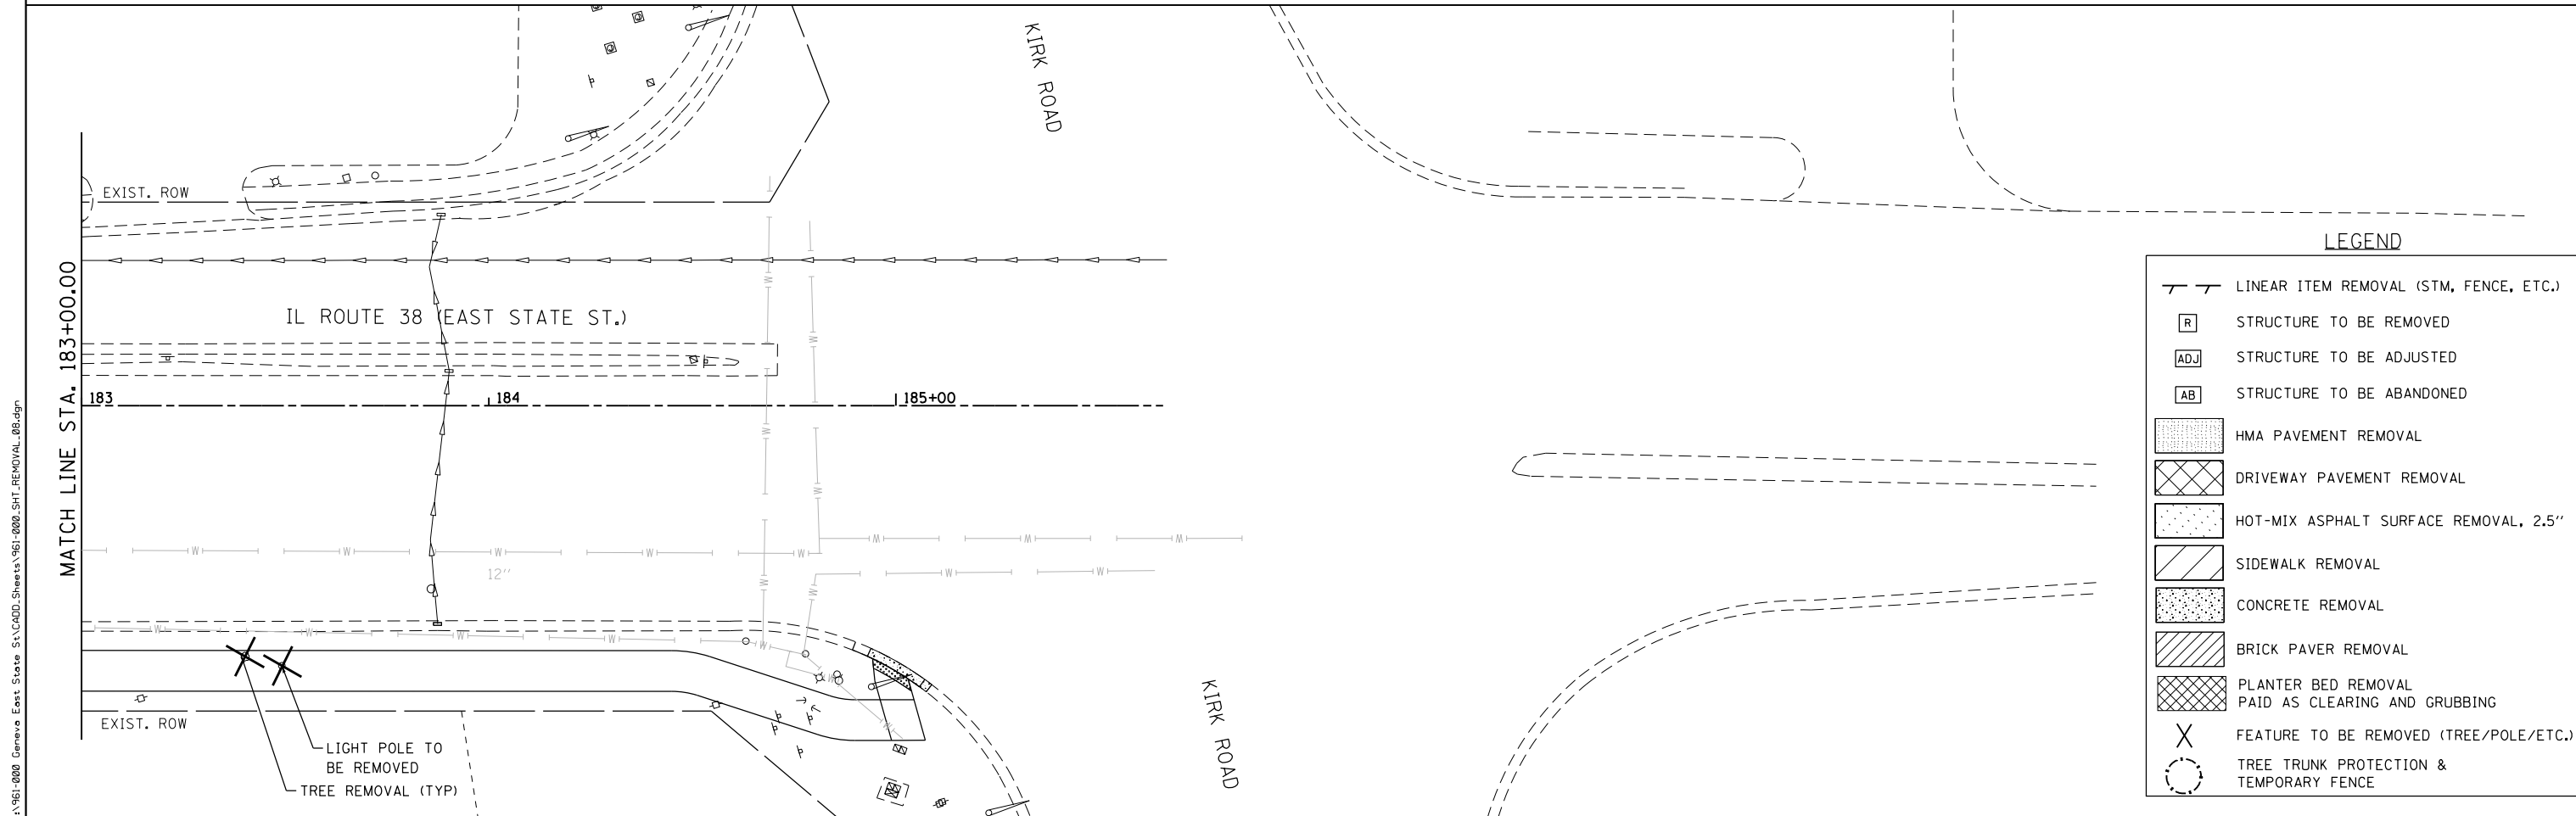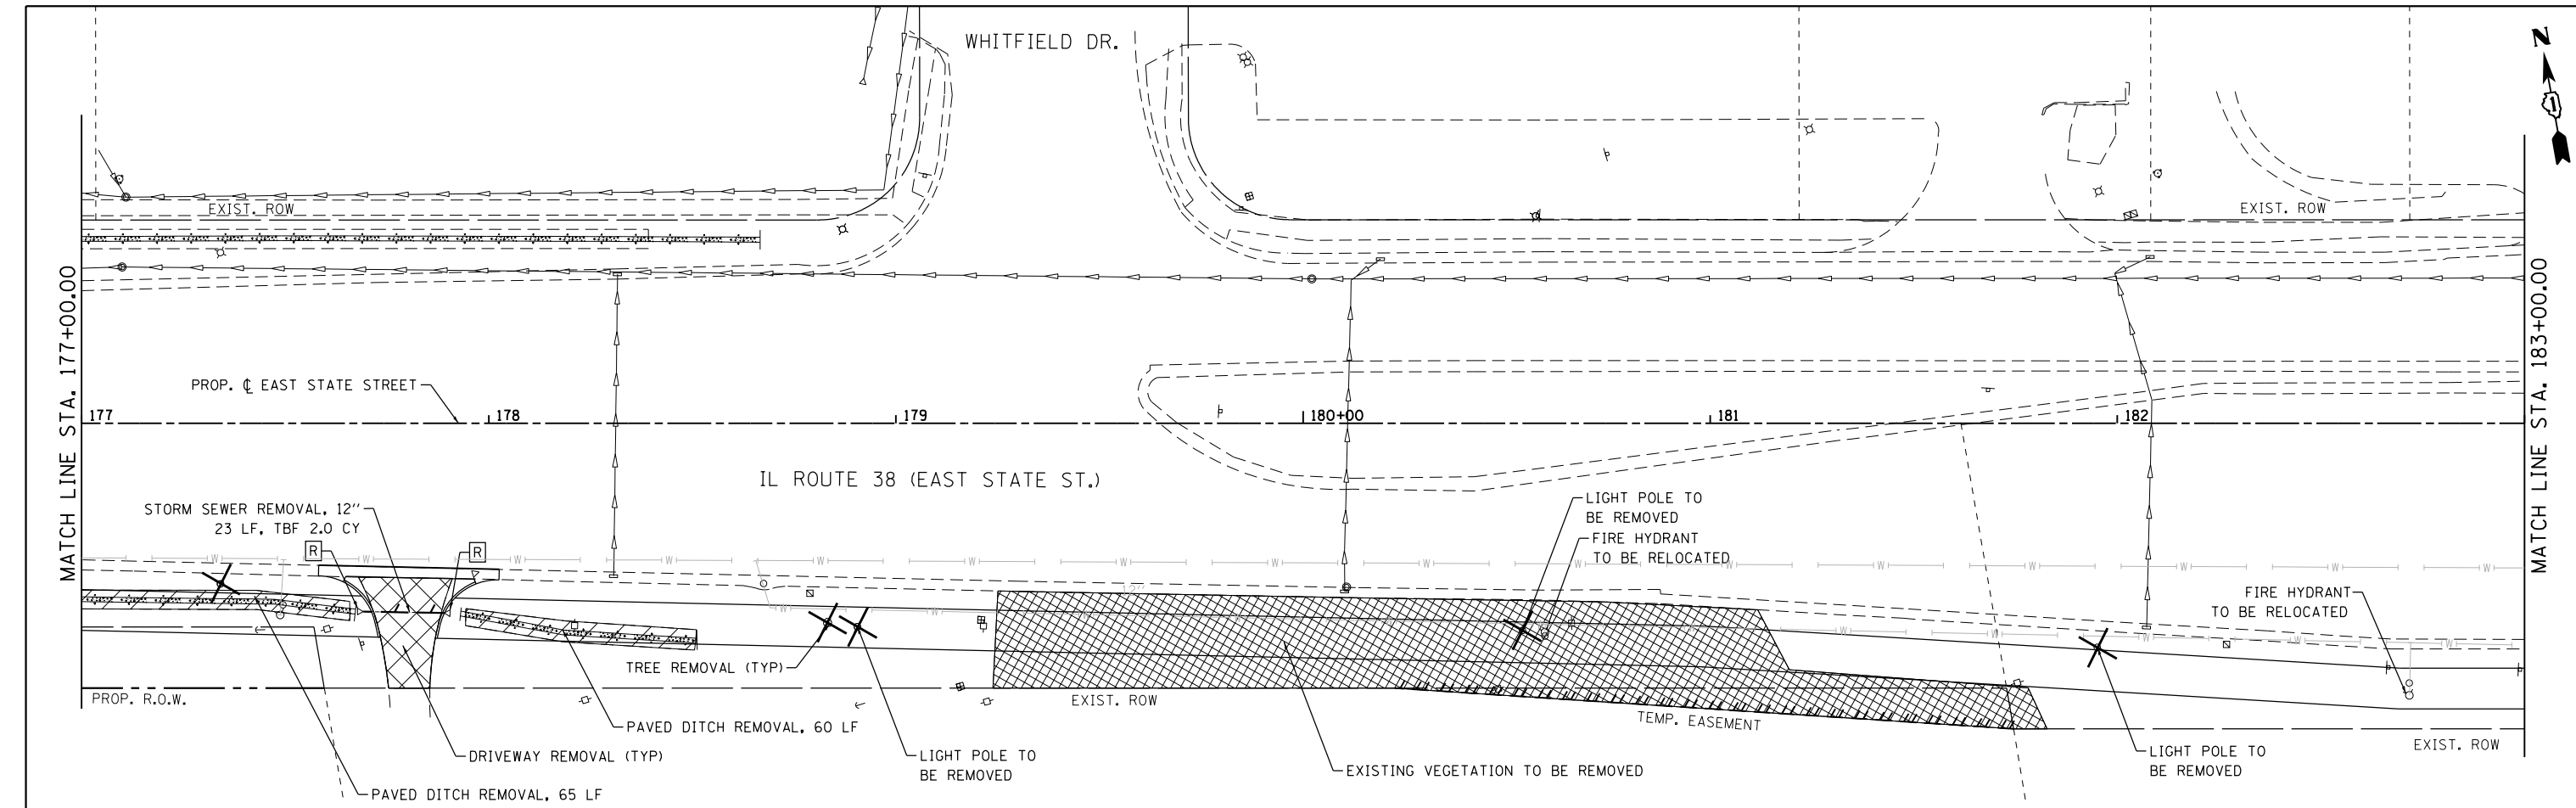

LEGEND

	LINEAR ITEM REMOVAL (STM, FENCE, ETC.)
	STRUCTURE TO BE REMOVED
	STRUCTURE TO BE ADJUSTED
	STRUCTURE TO BE ABANDONED
	HMA PAVEMENT REMOVAL
	DRIVEWAY PAVEMENT REMOVAL
	HOT-MIX ASPHALT SURFACE REMOVAL, 2.5"
	SIDEWALK REMOVAL
	CONCRETE REMOVAL
	BRICK PAVER REMOVAL
	PLANTER BED REMOVAL PAID AS CLEARING AND GRUBBING
	FEATURE TO BE REMOVED (TREE/POLE/ETC.)
	TREE TRUNK PROTECTION & TEMPORARY FENCE



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	PLOT DATE = 1/13/2025	CHECKED - DBB	REVISED -
		DATE - 11/7/2024	REVISED -

**STATE OF ILLINOIS
DEPARTMENT OF TRANSPORTATION**

**ILLINOIS ROUTE 38 - EAST STATE STREET
REMOVAL PLAN**

SCALE: 1"=20' SHEET 8 OF 73 SHEETS STA. 177+00.00 TO STA. 186+00.00

F.A.U. RTE.	SECTION	COUNTY	TOTAL SHEETS	SHEET NO.
0347	05-00102-00-PV	KANE	488	73
CONTRACT NO. 61J84				
ILLINOIS FED. AID PROJECT				

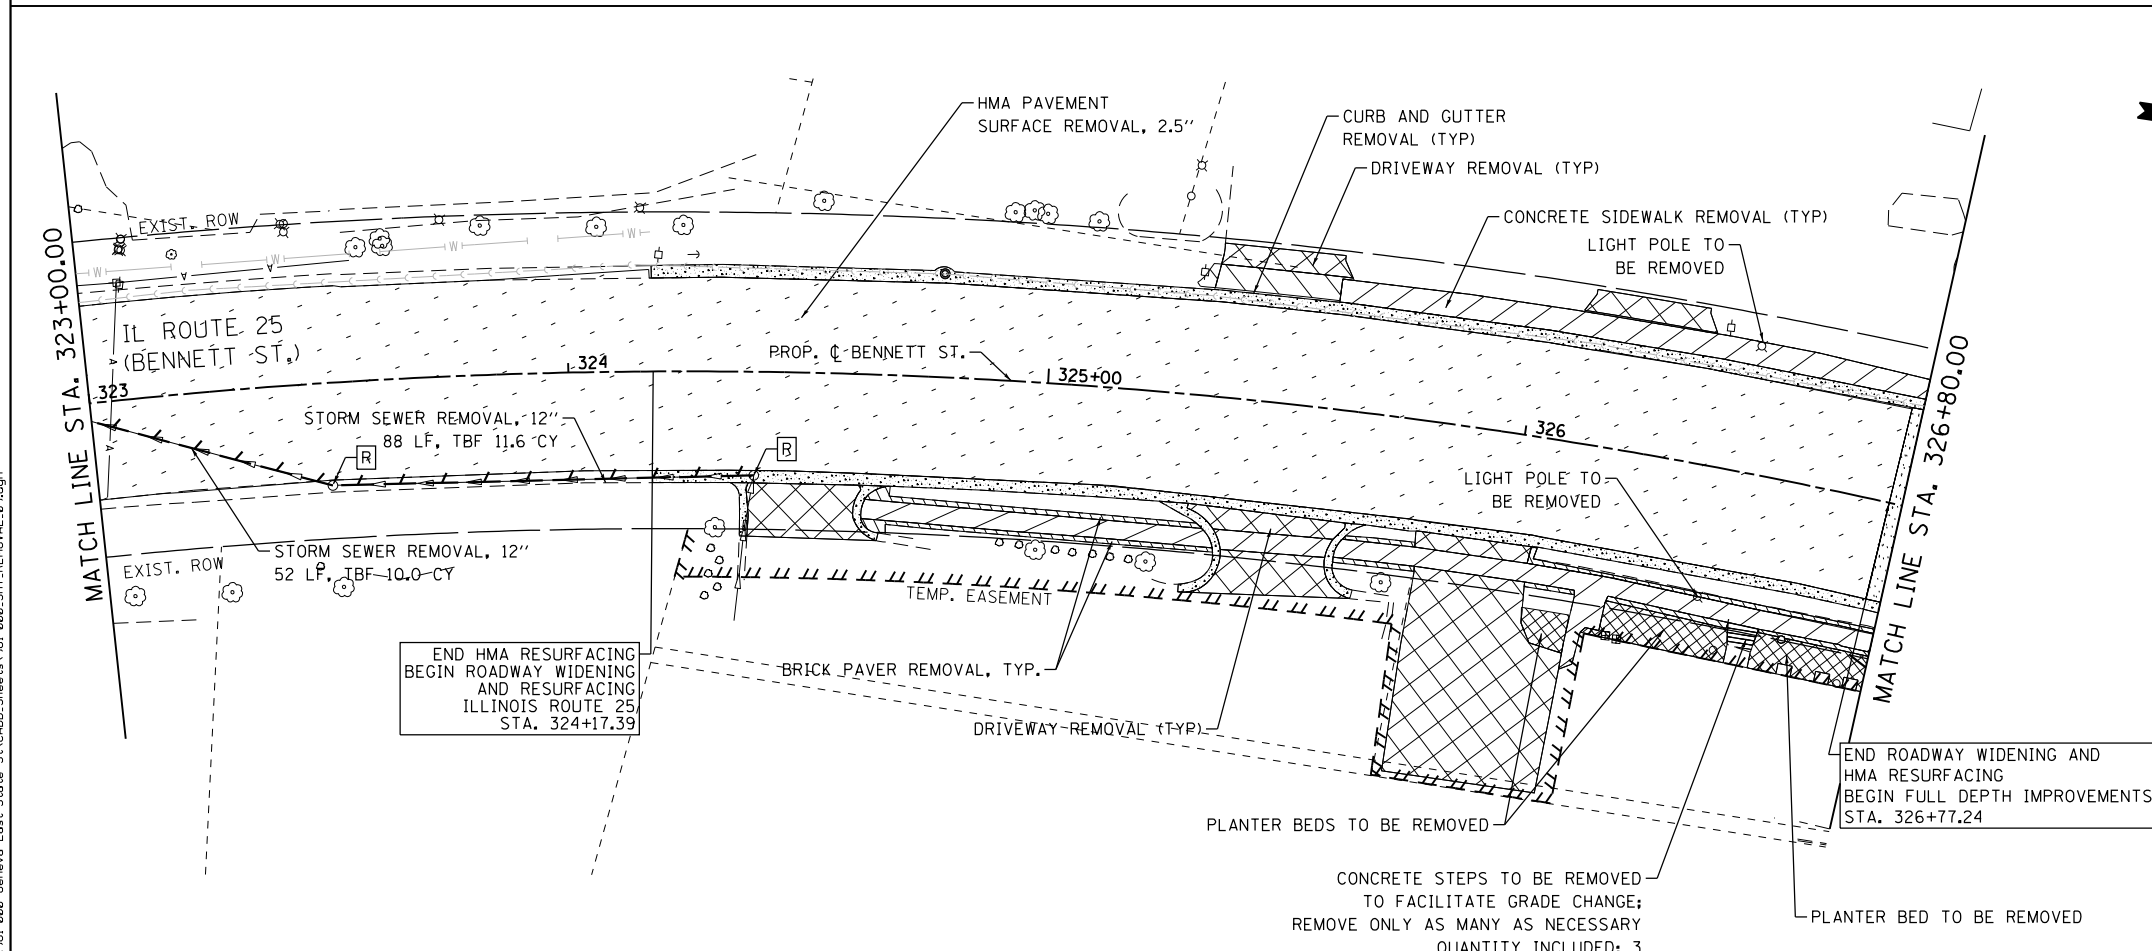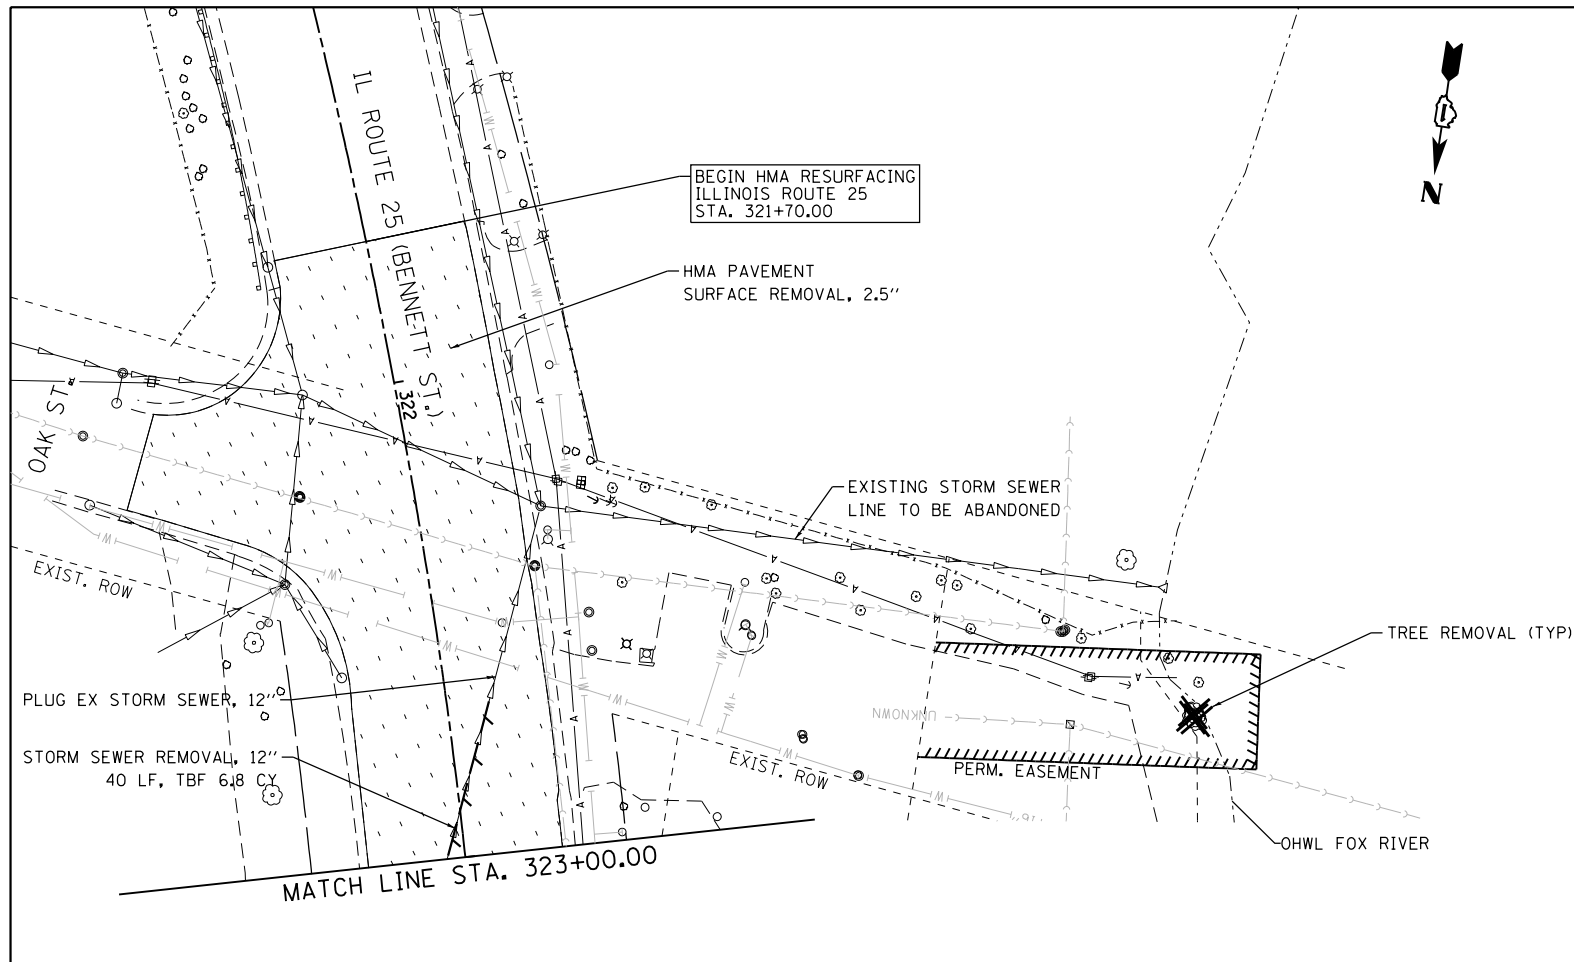

LEGEND

	LINEAR ITEM REMOVAL (STM, FENCE, ETC.)
	STRUCTURE TO BE REMOVED
	STRUCTURE TO BE ADJUSTED
	STRUCTURE TO BE ABANDONED
	HMA PAVEMENT REMOVAL
	DRIVEWAY PAVEMENT REMOVAL
	HOT-MIX ASPHALT SURFACE REMOVAL, 2.5"
	SIDEWALK REMOVAL
	CONCRETE REMOVAL
	BRICK PAVER REMOVAL
	PLANTER BED REMOVAL PAID AS CLEARING AND GRUBBING
	FEATURE TO BE REMOVED (TREE/POLE/ETC.)
	TREE TRUNK PROTECTION & TEMPORARY FENCE

FILE NAME = F:\961-000 Genevo East State St.CADD_Sheets\961-000_SHT_REMOVAL_09.dgn





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PLOT DATE = 1/13/2025	CHECKED - DBB	REVISED -
	DATE - 11/7/2024	REVISED -

**STATE OF ILLINOIS
DEPARTMENT OF TRANSPORTATION**

**ILLINOIS ROUTE 25 - BENNETT STREET
REMOVAL PLAN**

SCALE: 1"=20' SHEET 9 OF 11 SHEETS STA. 321+50.00 TO STA. 326+80.00

F.A.U. RTE.	SECTION	COUNTY	TOTAL SHEETS	SHEET NO.
0347	05-00102-00-PV	KANE	488	74
CONTRACT NO. 61J84				
ILLINOIS FED. AID PROJECT				

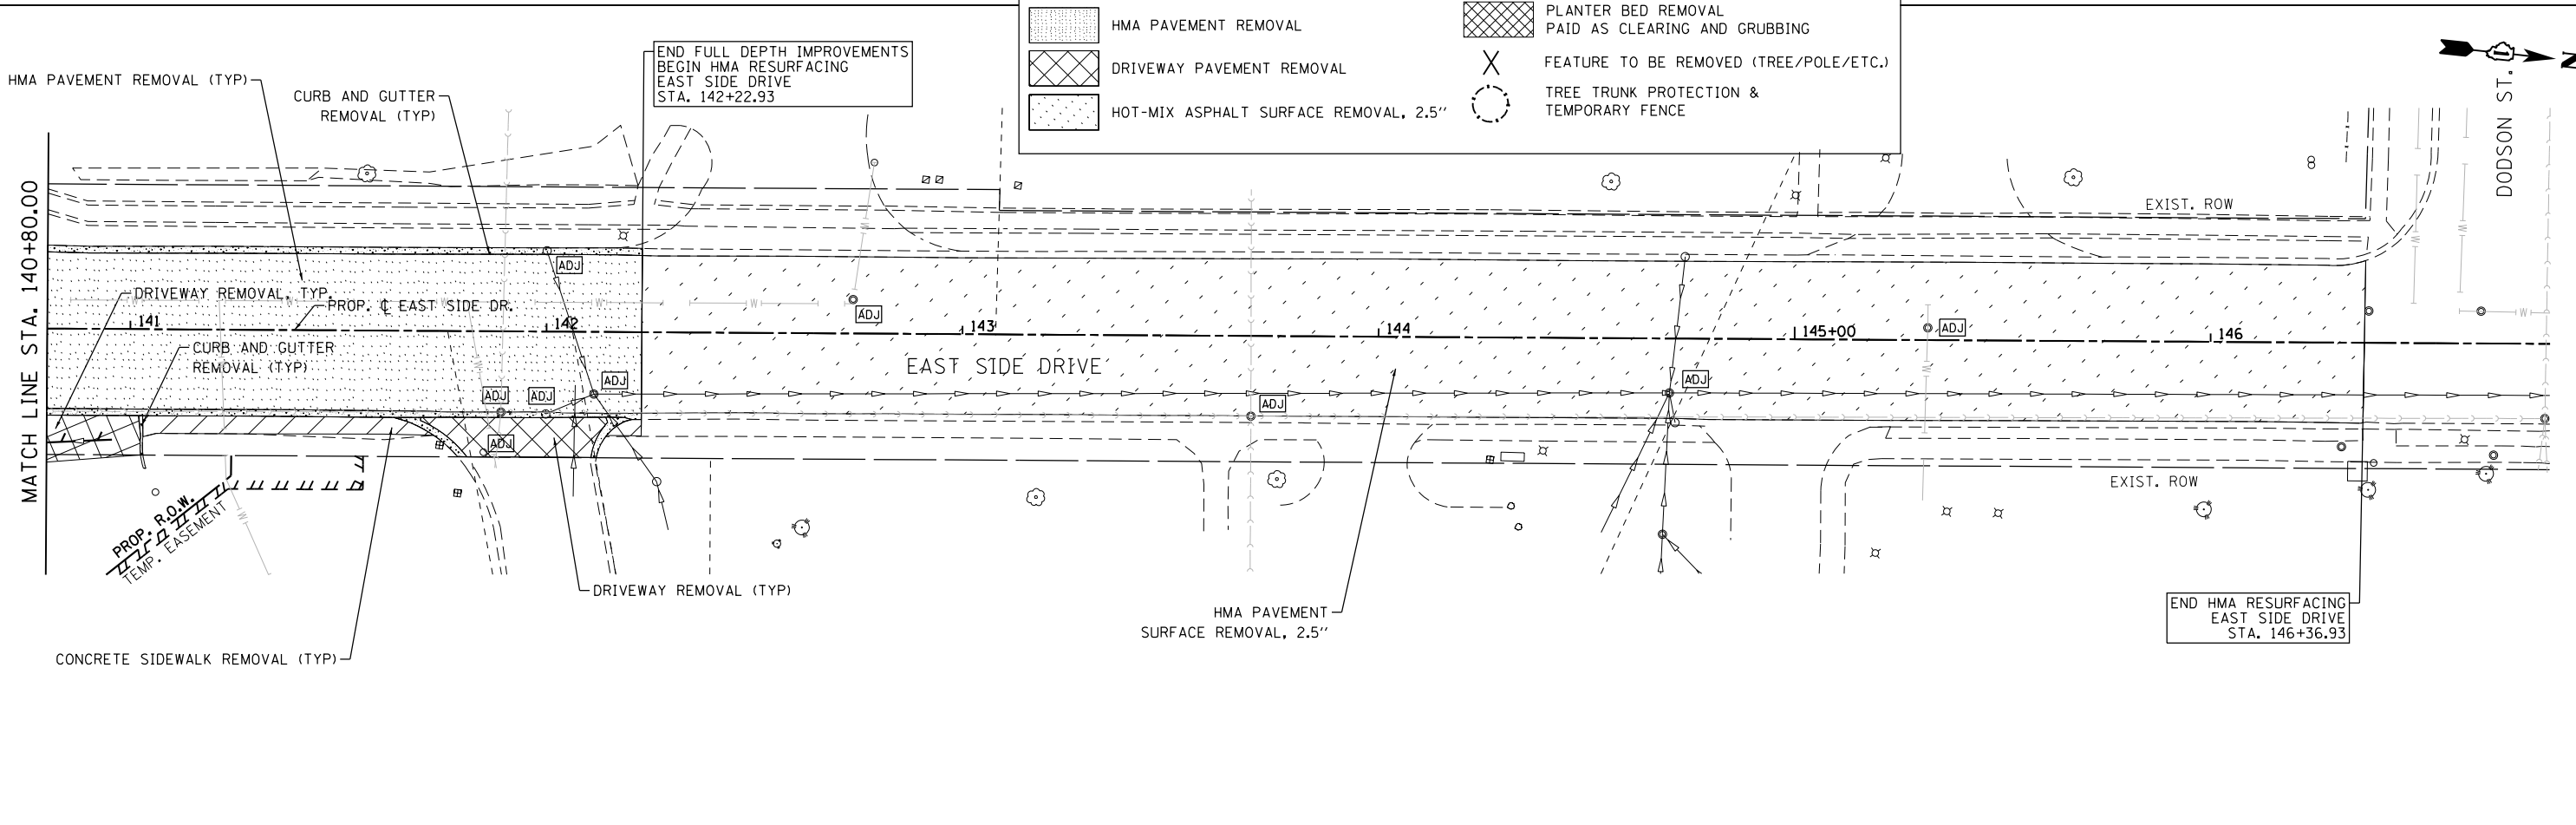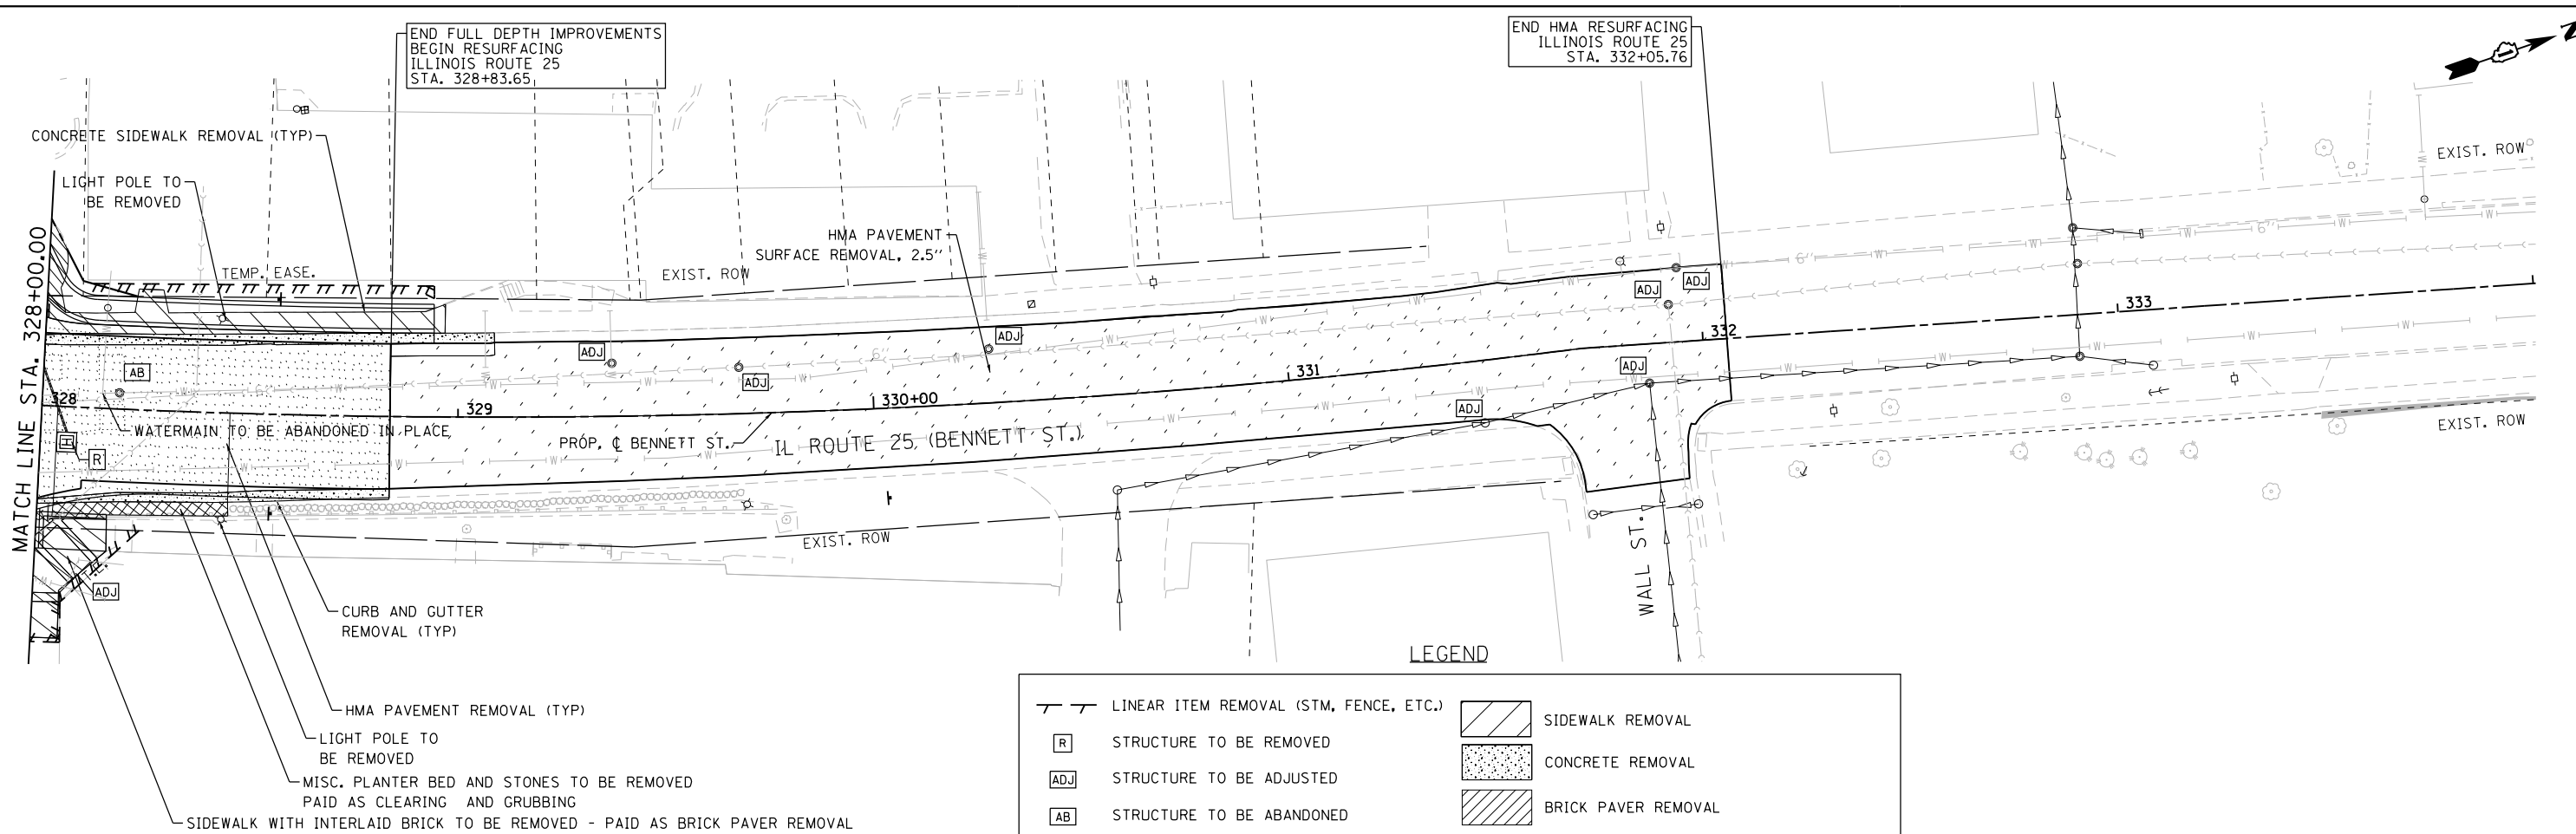

LEGEND

	LINEAR ITEM REMOVAL (STM, FENCE, ETC.)		SIDEWALK REMOVAL
	STRUCTURE TO BE REMOVED		CONCRETE REMOVAL
	STRUCTURE TO BE ADJUSTED		BRICK PAVER REMOVAL
	STRUCTURE TO BE ABANDONED		PLANTER BED REMOVAL PAID AS CLEARING AND GRUBBING
	HMA PAVEMENT REMOVAL		FEATURE TO BE REMOVED (TREE/POLE/ETC.)
	DRIVEWAY PAVEMENT REMOVAL		TREE TRUNK PROTECTION & TEMPORARY FENCE
	HOT-MIX ASPHALT SURFACE REMOVAL, 2.5"		

FILE NAME = FA\961-000 Genevo East State St\CADD_Sheets\961-000_SHT_REMOVAL_10.dgn




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PLOT SCALE = 48.0000' / in.	DRAWN - GJE	REVISED -
PLOT DATE = 1/13/2025	CHECKED - DBB	REVISED -
	DATE - 11/7/2024	REVISED -

**STATE OF ILLINOIS
DEPARTMENT OF TRANSPORTATION**

**ILLINOIS ROUTE 25 - BENNETT STREET AND EAST SIDE DRIVE
REMOVAL PLAN**


SCALE: 1"=20' SHEET 10 OF 11 SHEETS STA. TO STA.

F.A.U. RTE.	SECTION	COUNTY	TOTAL SHEETS	SHEET NO.
0347	05-00102-00-PV	KANE	488	75
CONTRACT NO. 61J84				
ILLINOIS FED. AID PROJECT				

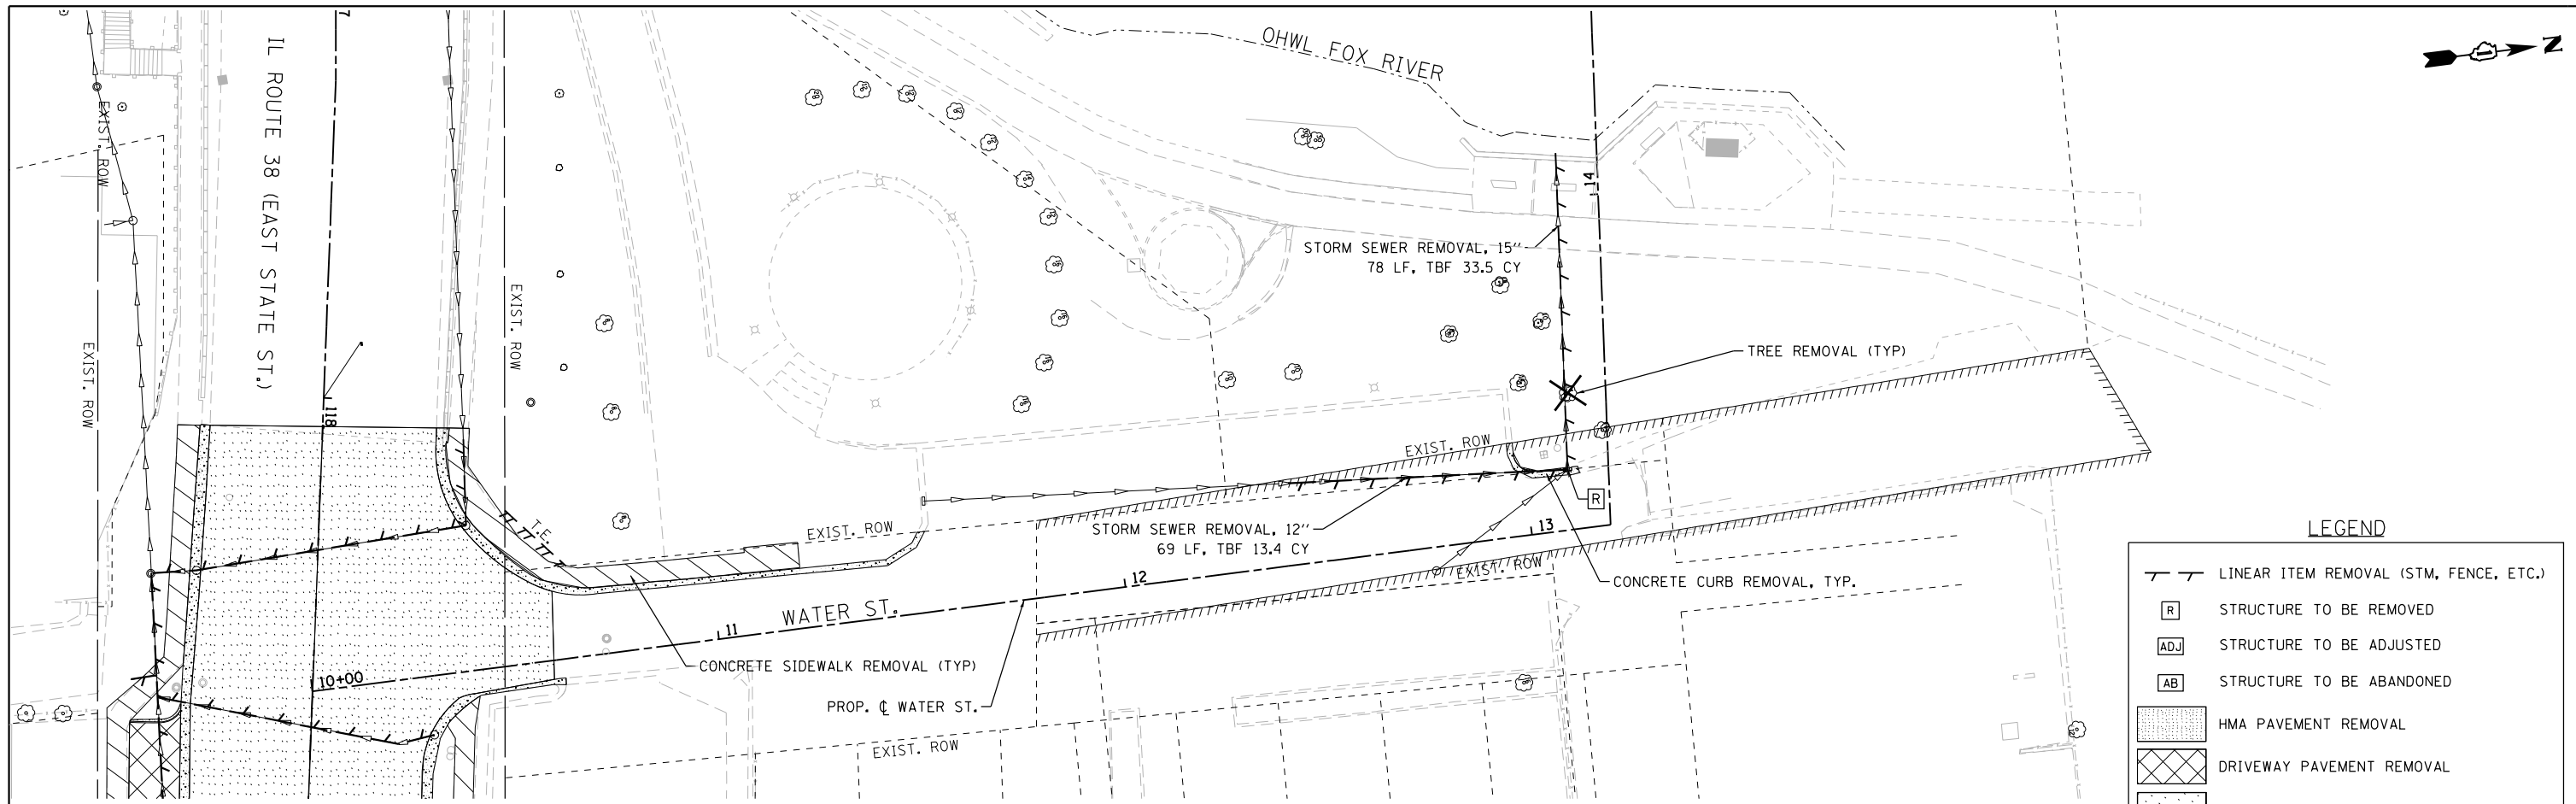

LEGEND

	LINEAR ITEM REMOVAL (STM, FENCE, ETC.)
	STRUCTURE TO BE REMOVED
	STRUCTURE TO BE ADJUSTED
	STRUCTURE TO BE ABANDONED
	HMA PAVEMENT REMOVAL
	DRIVEWAY PAVEMENT REMOVAL
	HOT-MIX ASPHALT SURFACE REMOVAL, 2.5"
	SIDEWALK REMOVAL
	CONCRETE REMOVAL
	BRICK PAVER REMOVAL
	PLANTER BED REMOVAL PAID AS CLEARING AND GRUBBING
	FEATURE TO BE REMOVED (TREE/POLE/ETC.)
	TREE TRUNK PROTECTION & TEMPORARY FENCE

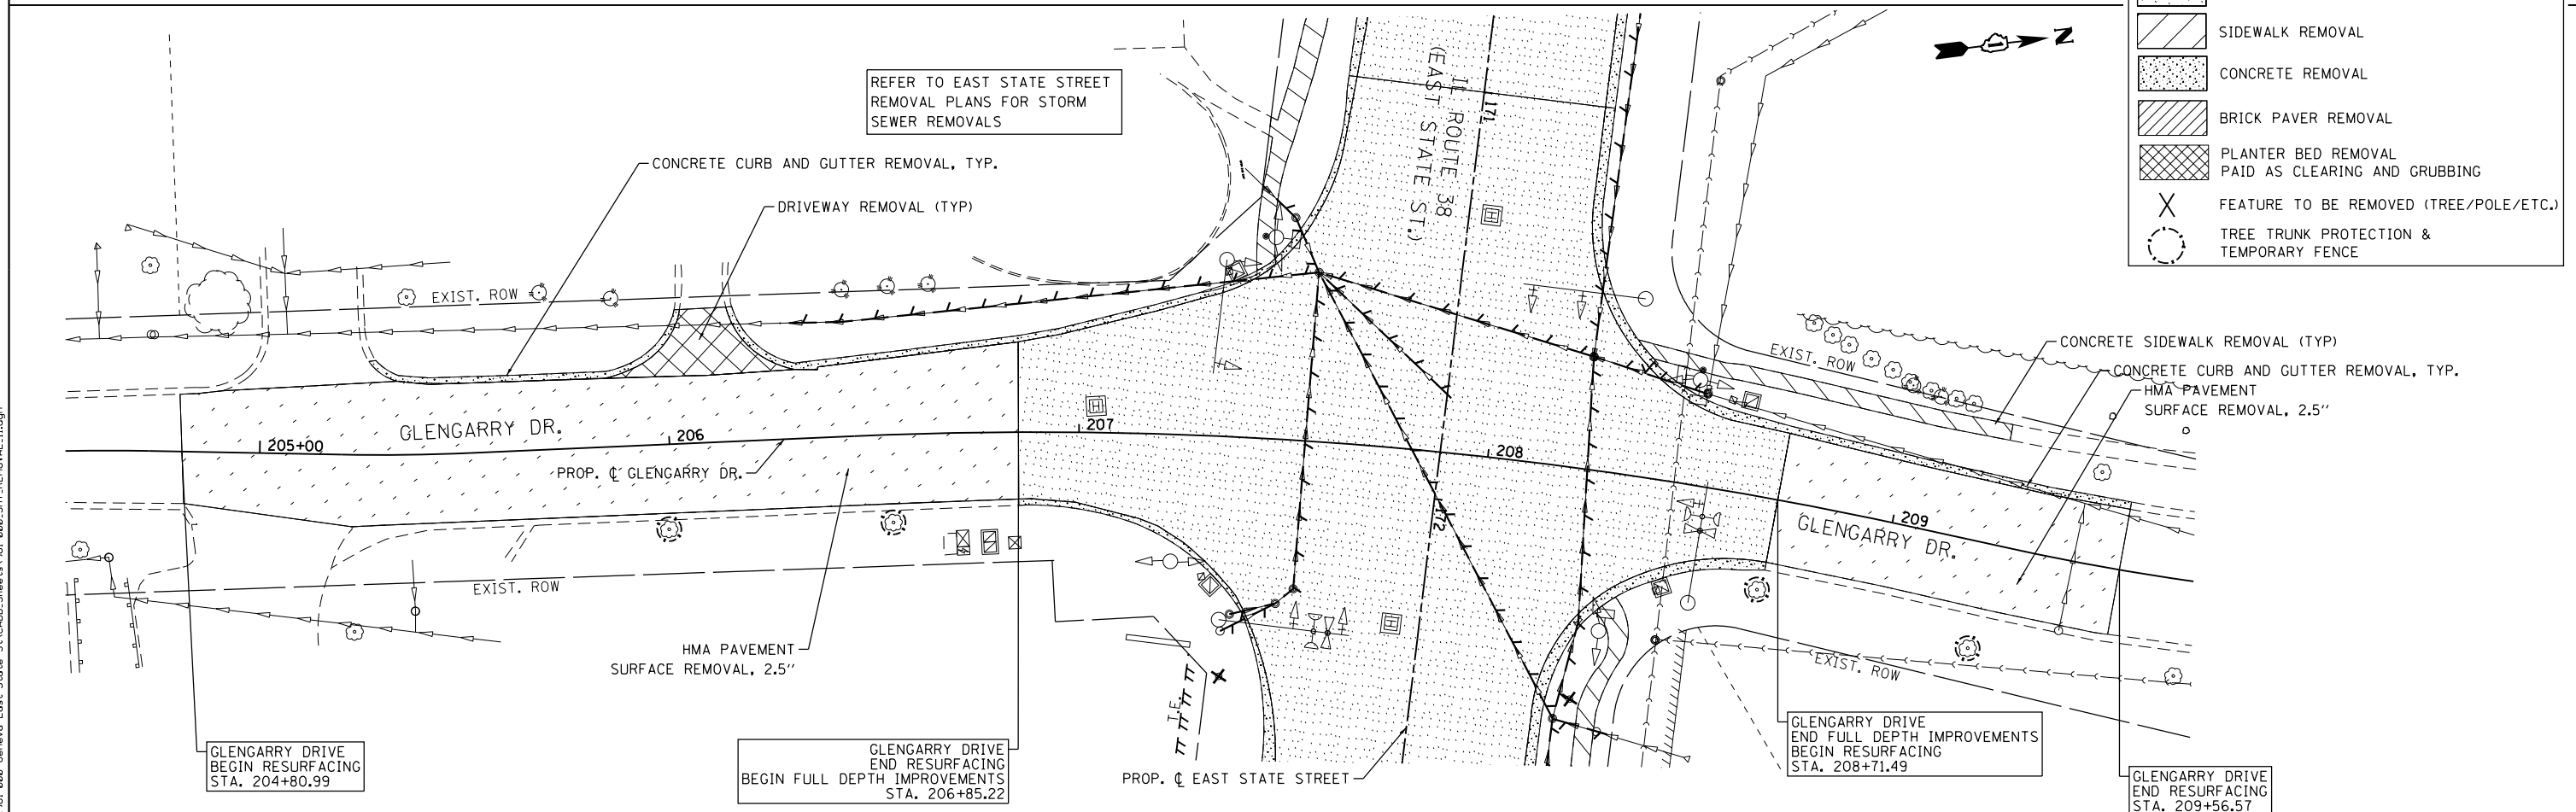

FILE NAME = FA\961-000 Genevo East State St.CADD_Sheets\961-000_SHT_REMOVAL_11.dgn

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		DATE - 11/7/2024	REVISED -

**STATE OF ILLINOIS
DEPARTMENT OF TRANSPORTATION**

**WATER STREET AND GLENGARRY DRIVE
REMOVAL SHEET**

SCALE: 1"=20' SHEET 11 OF 11 SHEETS STA. TO STA.



F.A.U. RTE.	SECTION	COUNTY	TOTAL SHEETS	SHEET NO.
0347	05-00102-00-PV	KANE	488	76
CONTRACT NO. 61J84				
ILLINOIS FED. AID PROJECT				

- NOTES:
 1) ALL ADA RAMPS AND LANDINGS SHALL BE PAID AS PCC SIDEWALK 5"
 2) ALL SIDEWALKS THROUGH DRIVEWAYS SHALL BE PAID AS PCC SIDEWALK 5"
 3) ALL SIDEWALK WITH BRICK PAVER RUNNING BAND SHALL BE PAID AS PCC SIDEWALK 8" (SPECIAL)

PLAN	SURVEYED	DATE
	PLOTTED	
	NOTE BOOK	
	NO.	
	BY	
	DATE	

PROFILE	SURVEYED	DATE
	PLOTTED	
	NOTE BOOK	
	NO.	
	BY	
	DATE	


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	USER NAME = tnestor	DESIGNED - GJE	REVISED -	STATE OF ILLINOIS DEPARTMENT OF TRANSPORTATION	ILLINOIS ROUTE 38 - EAST STATE STREET PLAN AND PROFILE	F.A.U. RTE. 0347	SECTION 05-00102-00-PV	COUNTY KANE	TOTAL SHEETS 488	SHEET NO. 77
	PLOT SCALE = 40.0000' / in.	CHECKED - DBB	REVISED -			SCALE: 1"=20'	SHEET 1 OF 20 SHEETS	STA. 114+00.00 TO STA. 119+00.00	CONTRACT NO. 61J84	
	PLOT DATE = 1/13/2025	DATE = 11/7/2024	REVISED -							

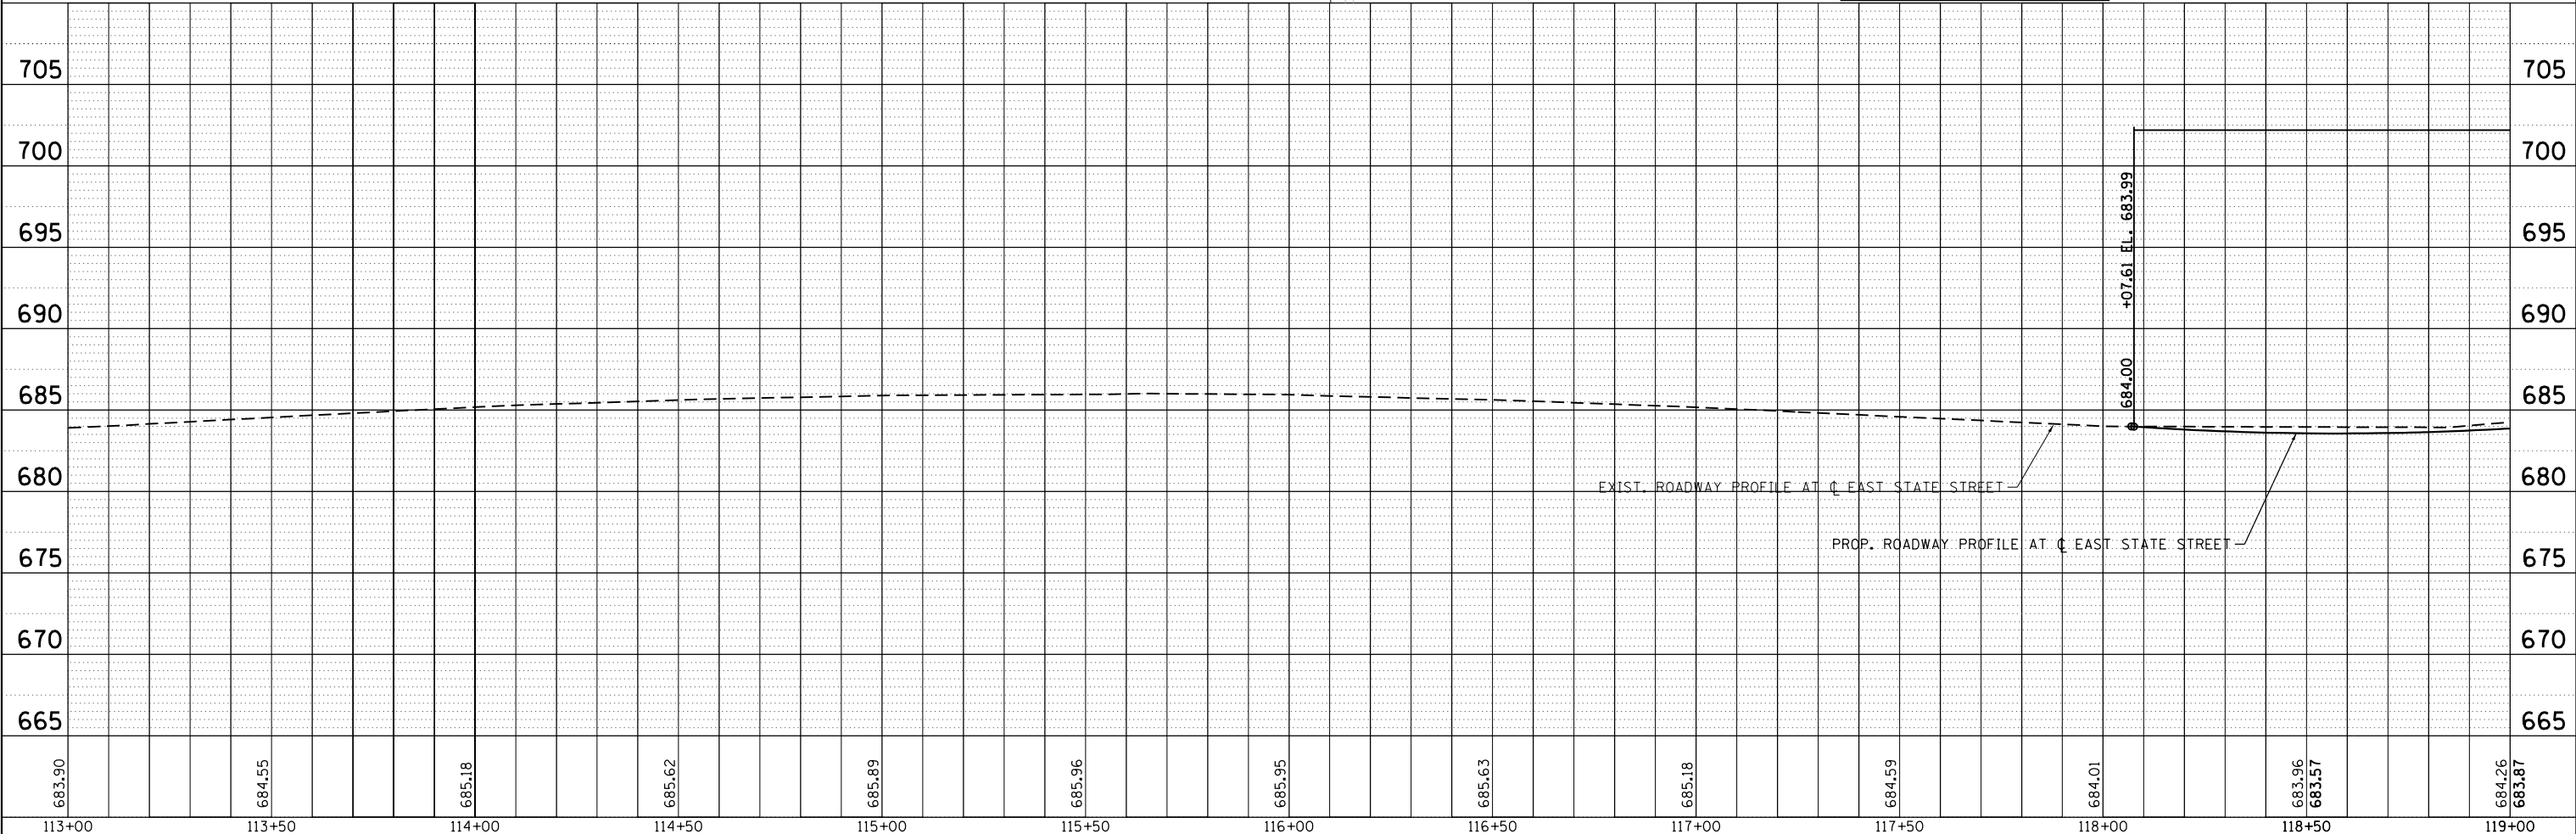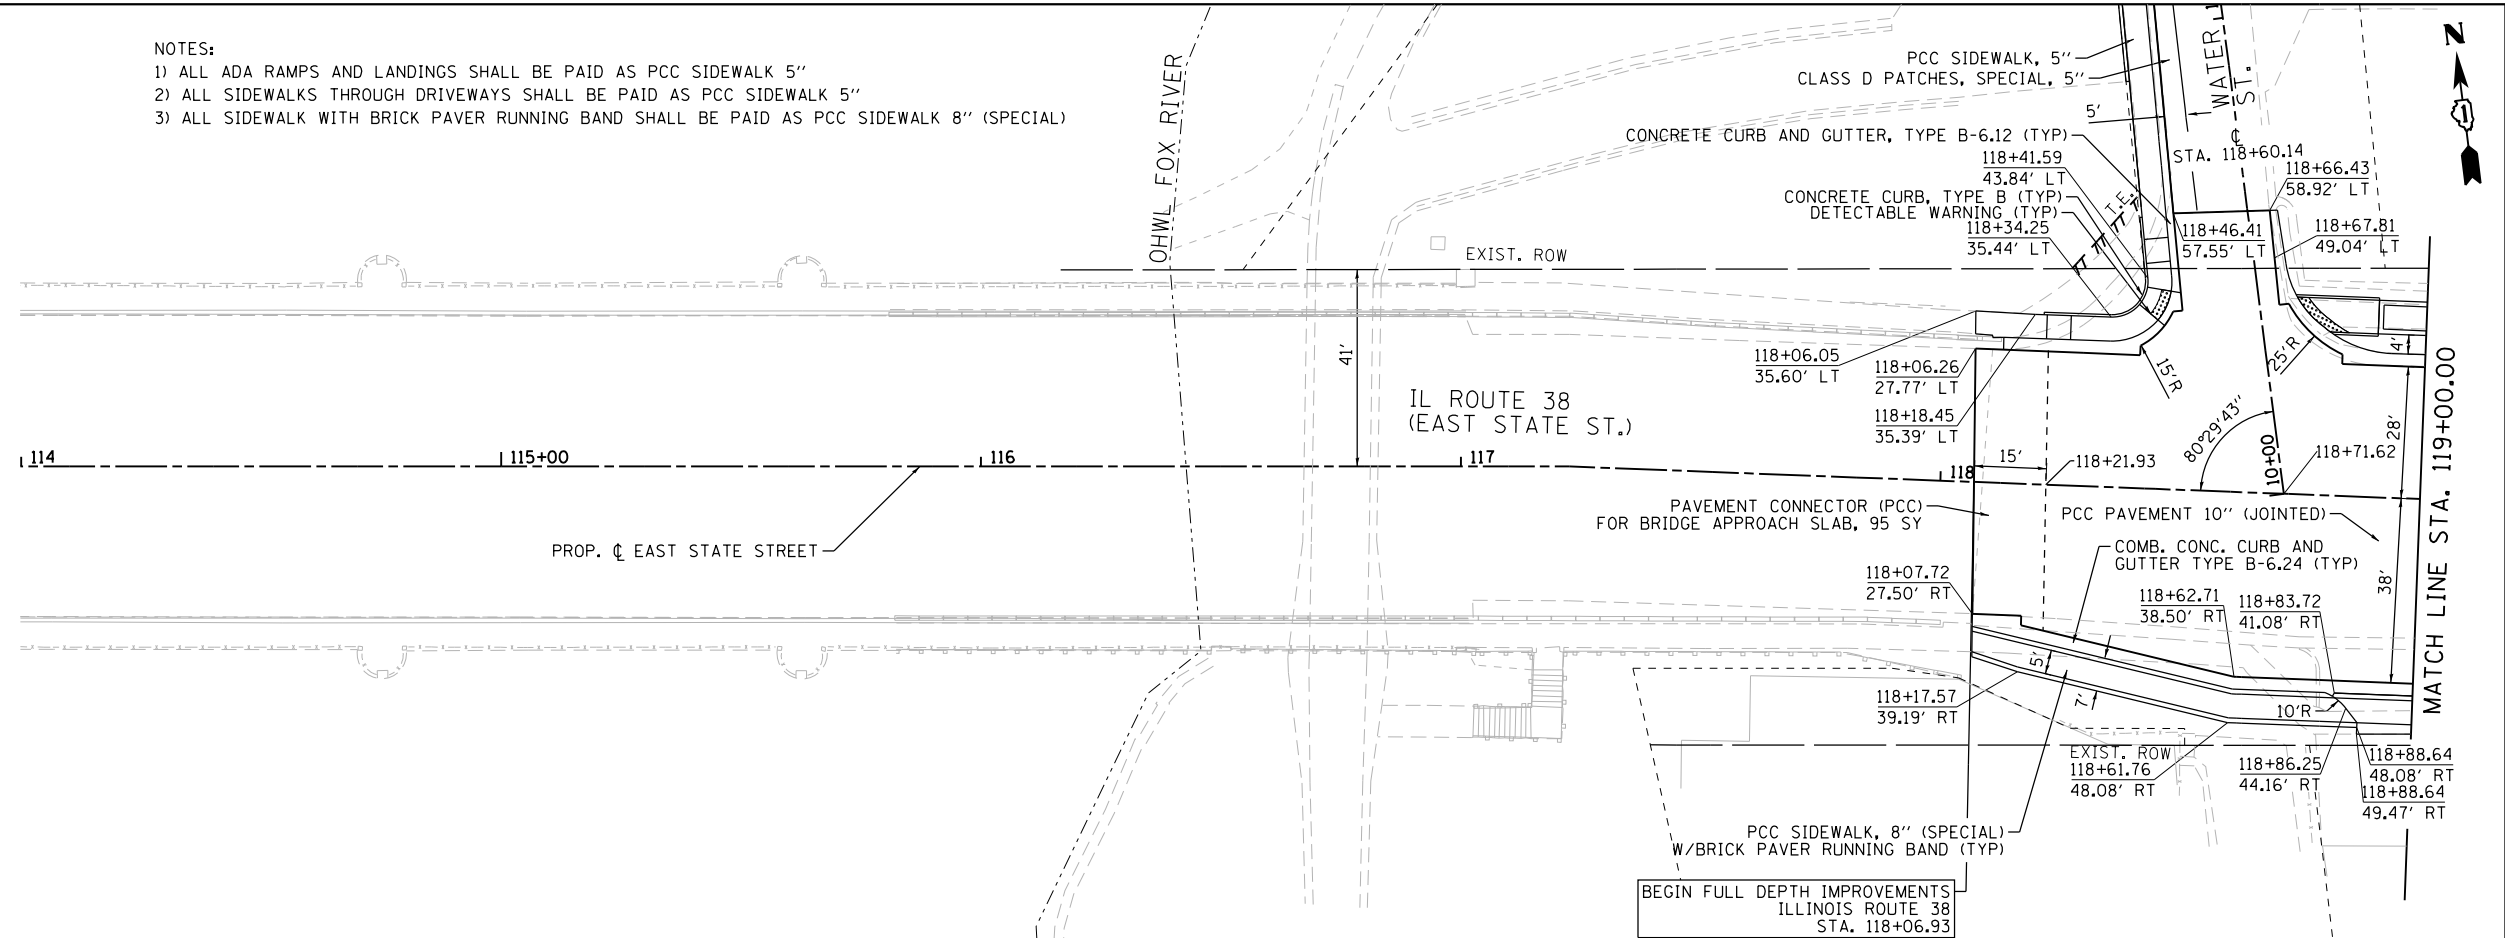

- NOTES:
- 1) ALL ADA RAMPS AND LANDINGS SHALL BE PAID AS PCC SIDEWALK 5"
 - 2) ALL SIDEWALKS THROUGH DRIVEWAYS SHALL BE PAID AS PCC SIDEWALK 5"
 - 3) ALL SIDEWALK WITH BRICK PAVER RUNNING BAND SHALL BE PAID AS PCC SIDEWALK 8" (SPECIAL)



FILE NAME = FA\961-000 Genevo East State St.CADD_Sheets\961-000_SHT_PLNPRF_02.dgn

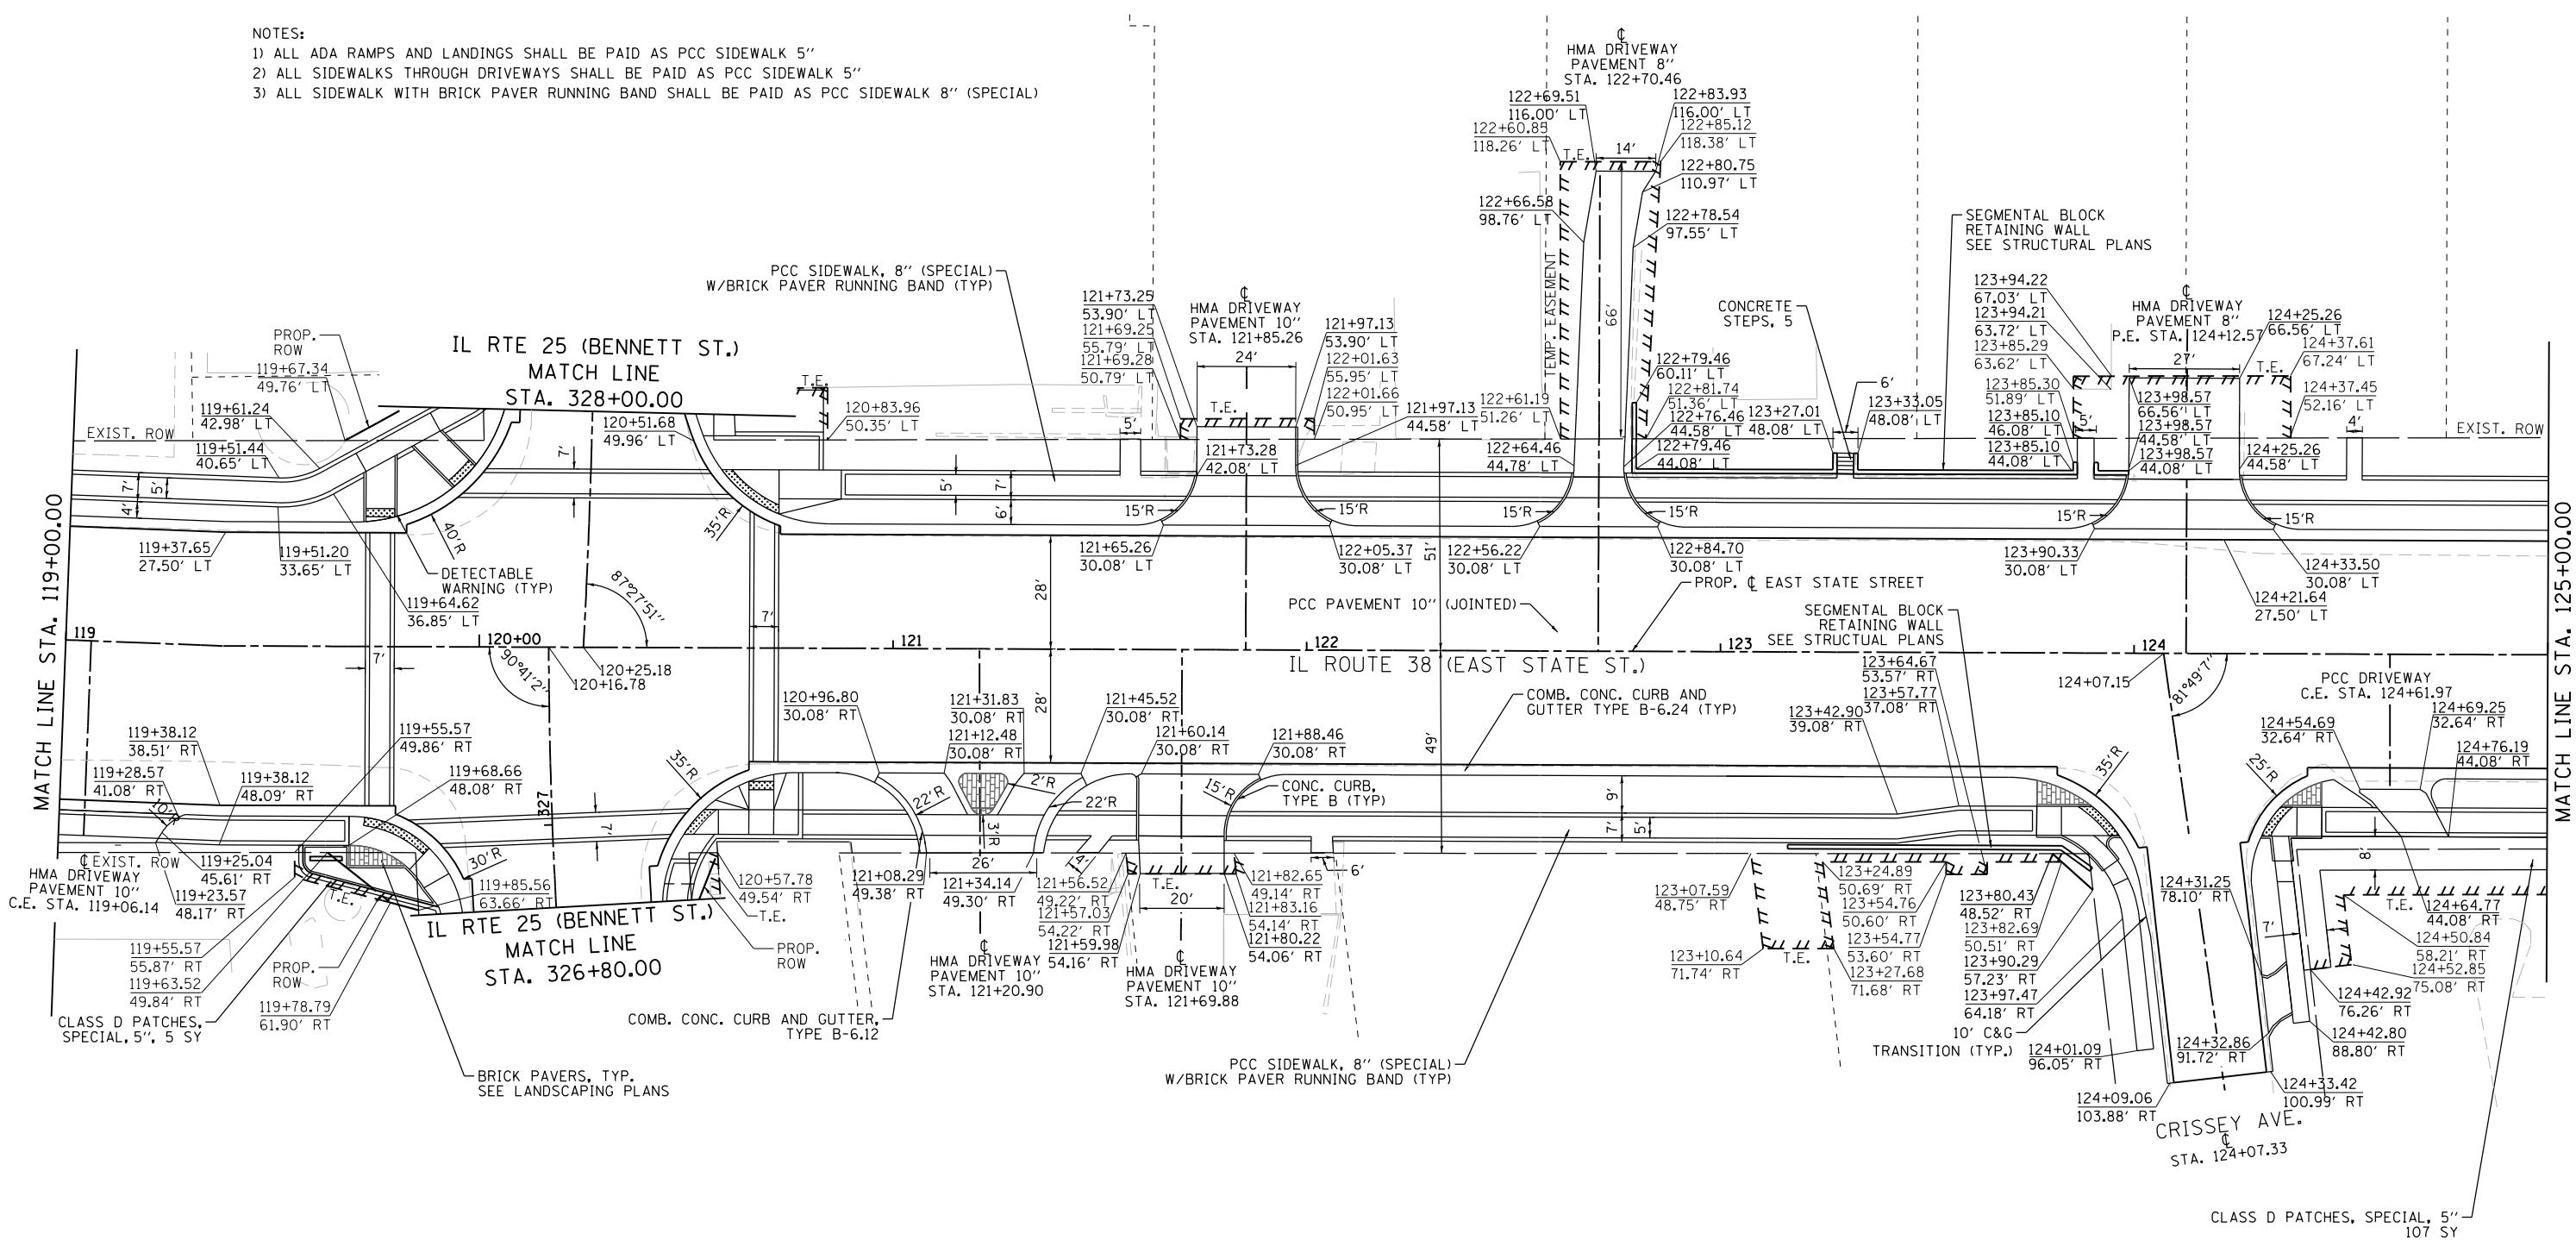

USER NAME = tnestor	DESIGNED - GJE	REVISED -
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PLOT DATE = 1/13/2025	DATE - 11/7/2024	REVISED -

**STATE OF ILLINOIS
DEPARTMENT OF TRANSPORTATION**


**ILLINOIS ROUTE 38 - EAST STATE STREET
PLAN**

SCALE: 1"=20' SHEET 2 OF 20 SHEETS STA. 119+00.00 TO STA. 125+00.00

F.A.U. RTE.	SECTION	COUNTY	TOTAL SHEETS	SHEET NO.
0347	05-00102-00-PV	KANE	488	78
CONTRACT NO. 61J84				
ILLINOIS FED. AID PROJECT				

PLAN	SURVEYED	BY	DATE
	PLOTTED		
	GRADES CHECKED		
	ALIGNMENT CHECKED		
	STRUCTURE NOTATIONS CHECKED		
	NOTE BOOK NO.		
	CADD FILE NAME		

PROFILE	SURVEYED	BY	DATE
	PLOTTED		
	GRADES CHECKED		
	ALIGNMENT CHECKED		
	STRUCTURE NOTATIONS CHECKED		
	NOTE BOOK NO.		
	CADD FILE NAME		

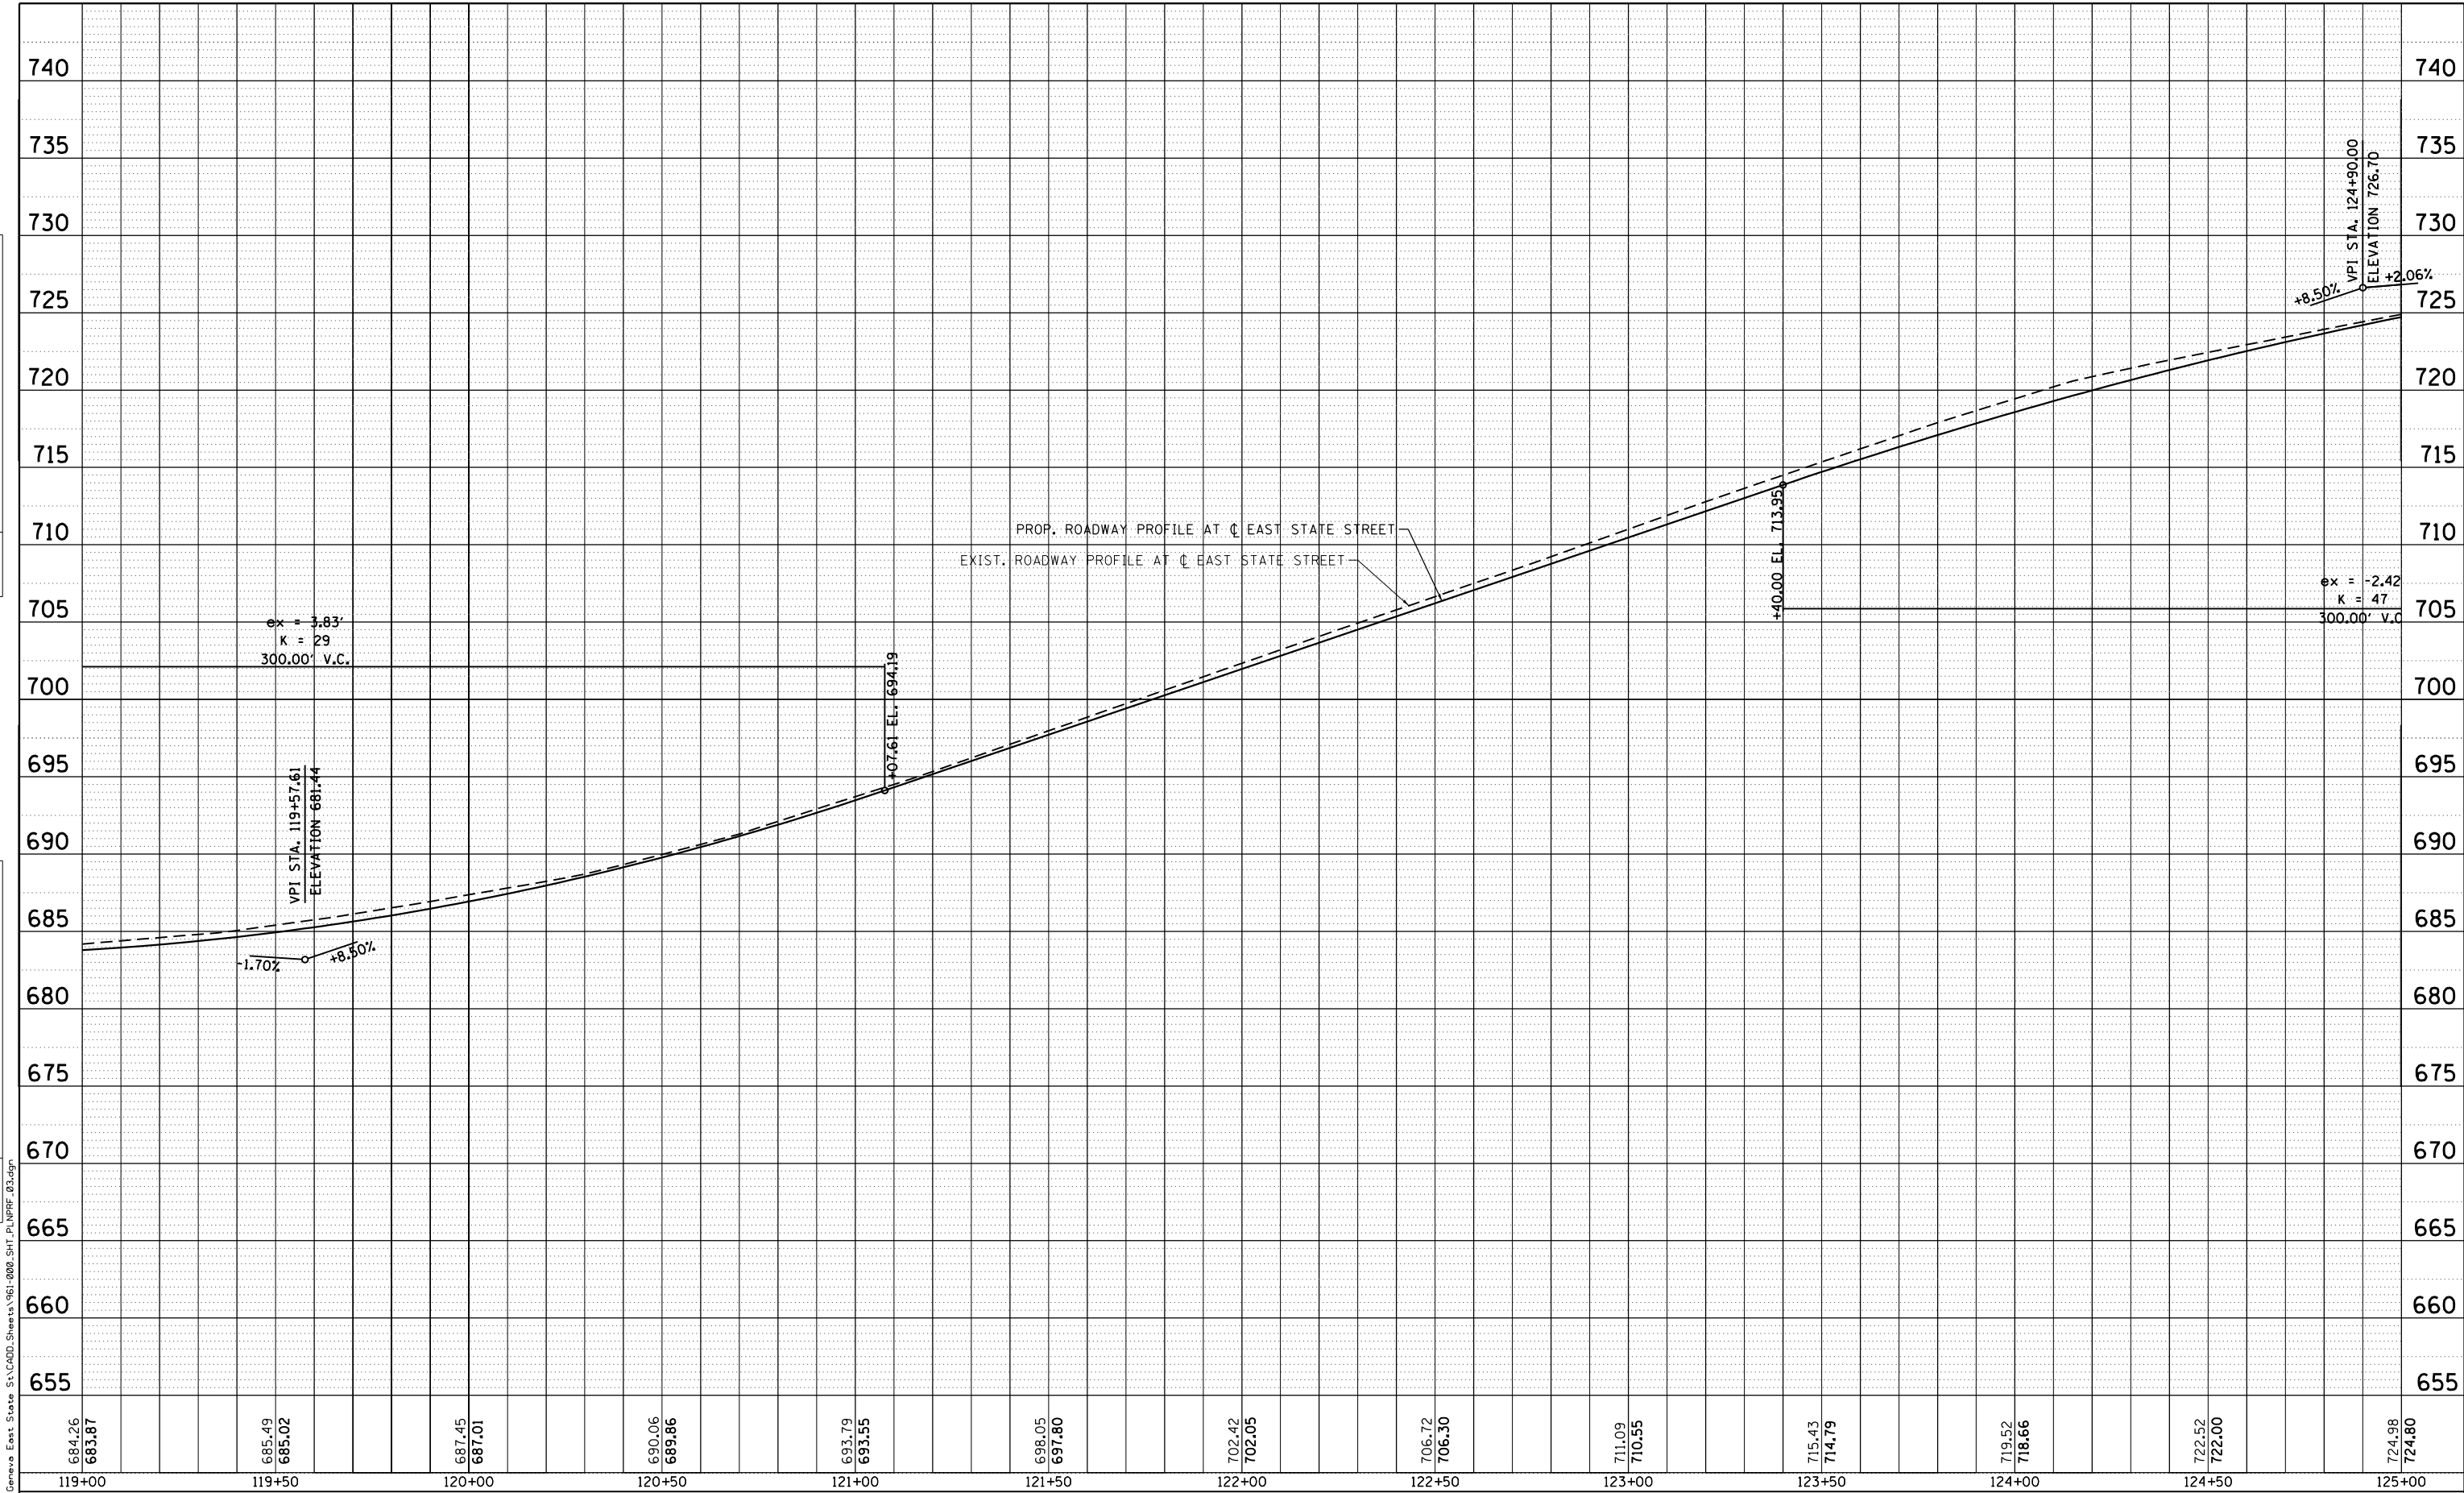

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119+00		119+50		120+00		120+50		121+00		121+50		122+00		122+50		123+00		123+50		124+00		124+50		125+00	



USER NAME = tnestor	DESIGNED - GJE	REVISED -
PLOT SCALE = 40.0000' / in.	DRAWN - GJE	REVISED -
PLOT DATE = 1/13/2025	CHECKED - DBB	REVISED -
	DATE - 11/7/2024	REVISED -

STATE OF ILLINOIS
DEPARTMENT OF TRANSPORTATION


ILLINOIS ROUTE 38 - EAST STATE STREET
PROFILE

SCALE: 1"=20' SHEET 3 OF 20 SHEETS STA. 119+00.00 TO STA. 125+00.00


F.A.U. RTE.	SECTION	COUNTY	TOTAL SHEETS	SHEET NO.
0347	05-00102-00-PV	KANE	488	79
CONTRACT NO. 61J84				
ILLINOIS FED. AID PROJECT				

PLAN	SURVEYED	DATE
	PLOTTED	BY
	NOTED	
	CHECKED	
	FILED	
	NO.	

PROFILE	SURVEYED	DATE
	PLOTTED	BY
	NOTED	
	CHECKED	
	FILED	
	NO.	

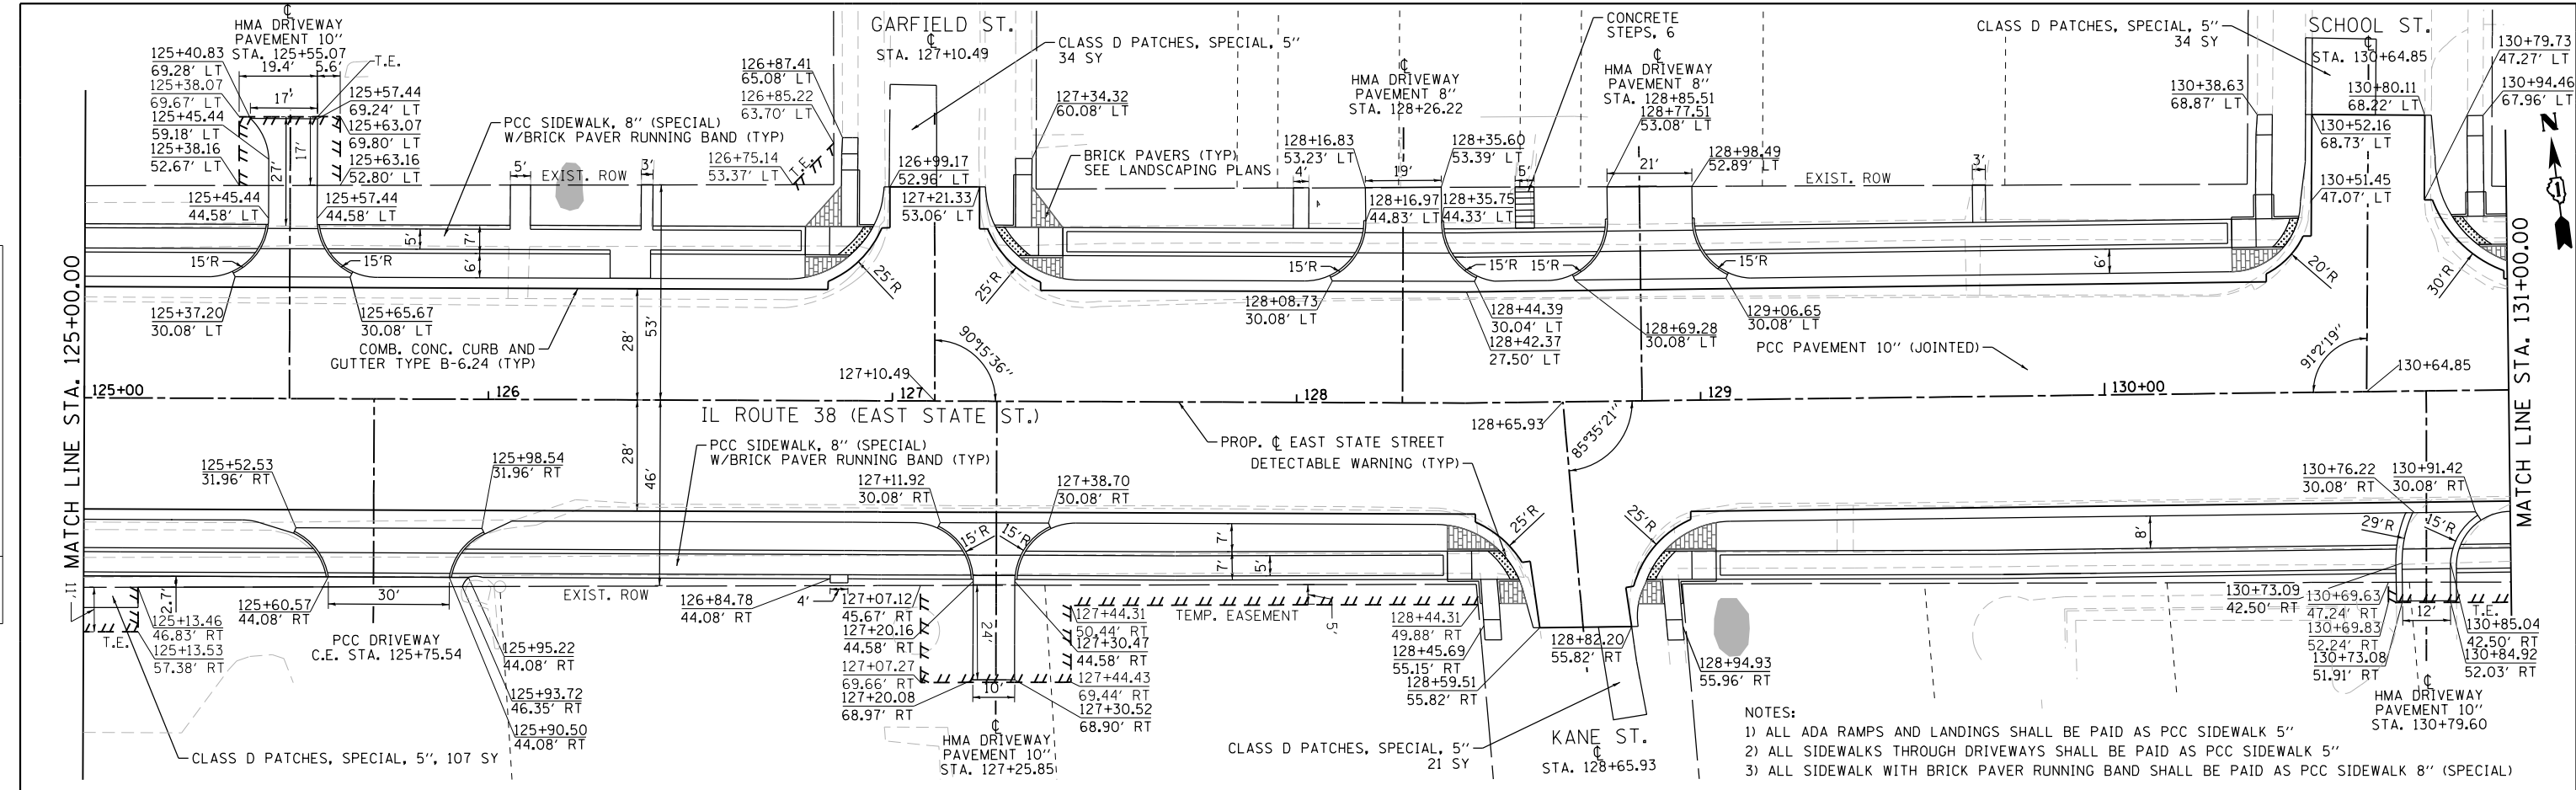

- NOTES:
- 1) ALL ADA RAMPS AND LANDINGS SHALL BE PAID AS PCC SIDEWALK 5"
 - 2) ALL SIDEWALKS THROUGH DRIVEWAYS SHALL BE PAID AS PCC SIDEWALK 5"
 - 3) ALL SIDEWALK WITH BRICK PAVER RUNNING BAND SHALL BE PAID AS PCC SIDEWALK 8" (SPECIAL)

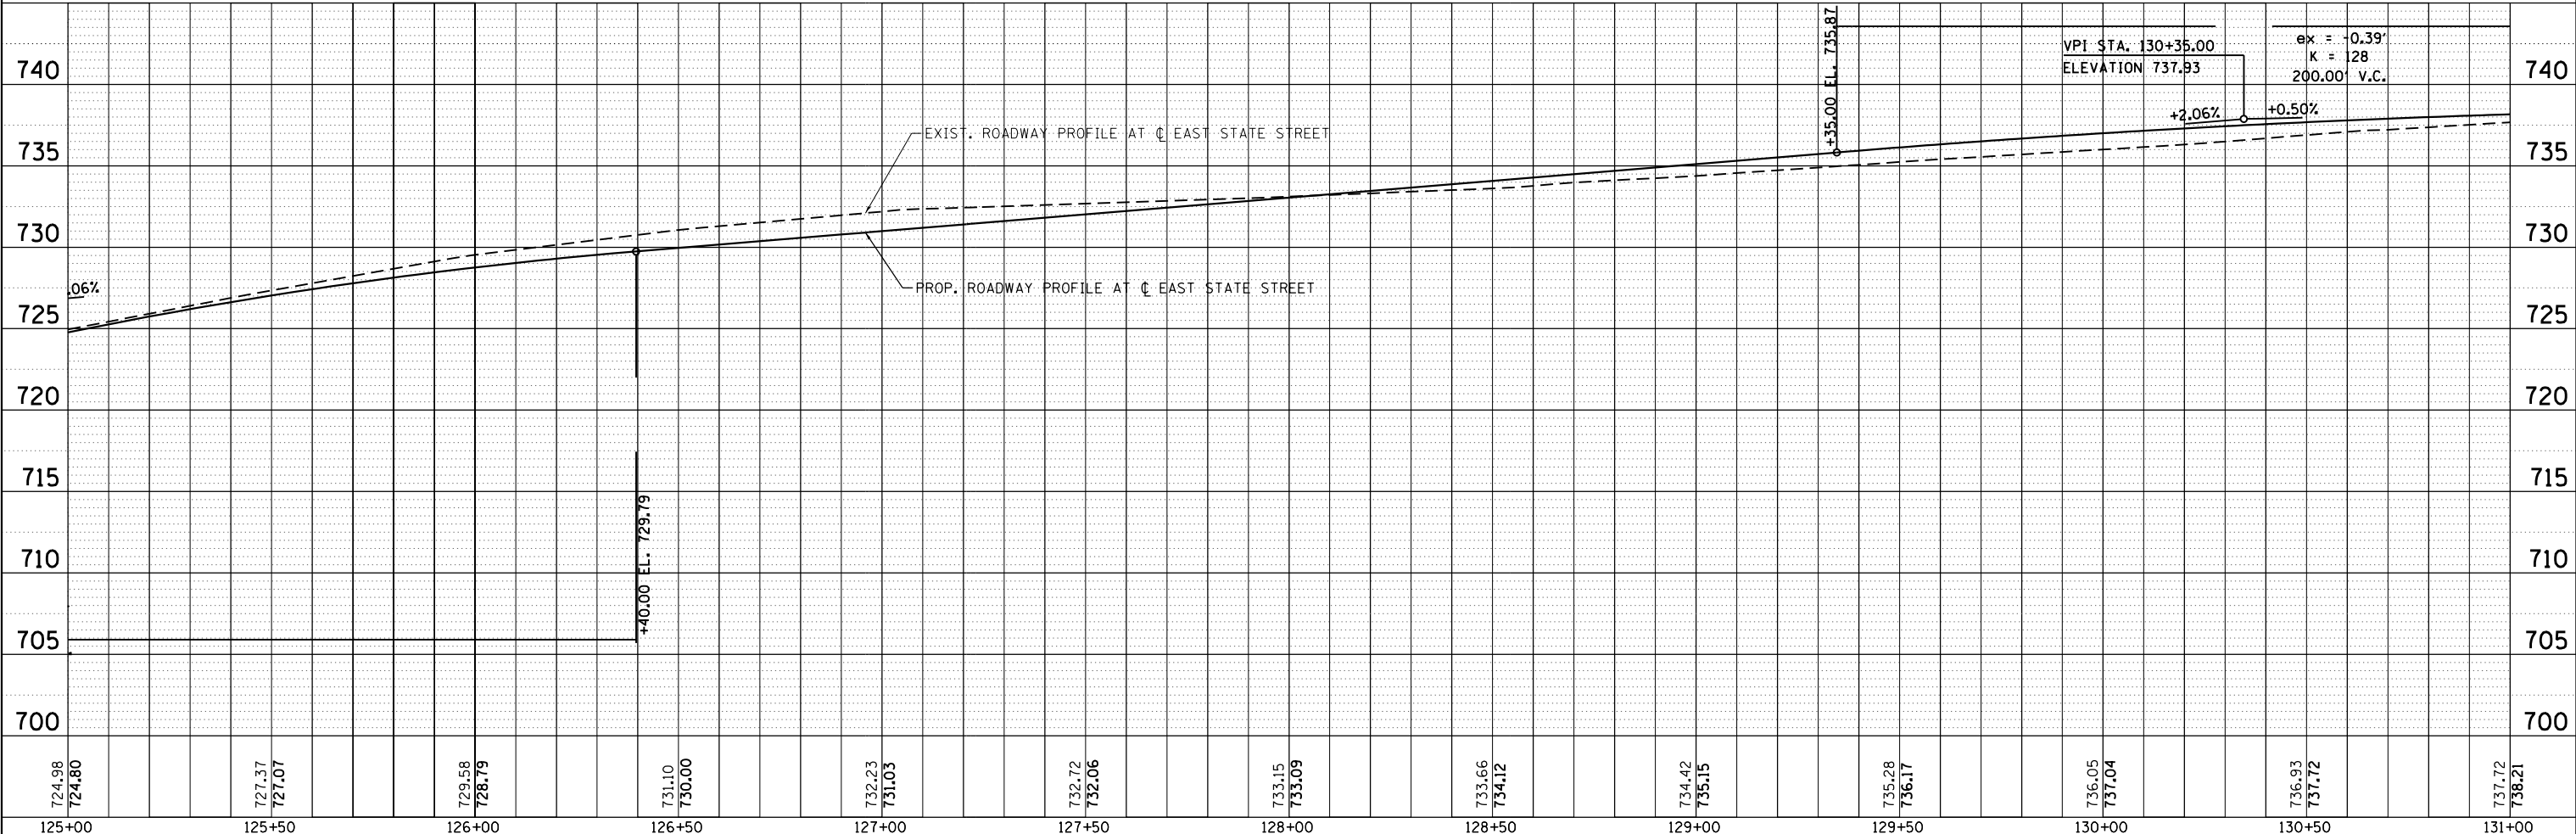

724.98 724.80	727.37 727.07	729.58 728.79	731.10 730.00	732.23 731.03	732.72 732.06	733.15 733.09	733.66 734.12	734.42 735.15	735.28 736.17	736.05 737.04	736.93 737.72	737.72 738.21
125+00	125+50	126+00	126+50	127+00	127+50	128+00	128+50	129+00	129+50	130+00	130+50	131+00



USER NAME = tnestor	DESIGNED - GJE	REVISED -
	DRAWN - GJE	REVISED -
PLOT SCALE = 48.0000' / in.	CHECKED - DBB	REVISED -
PLOT DATE = 1/13/2025	DATE - 11/7/2024	REVISED -



STATE OF ILLINOIS
DEPARTMENT OF TRANSPORTATION

ILLINOIS ROUTE 38 - EAST STATE STREET
PLAN AND PROFILE
SCALE: 1"=20'
SHEET 4 OF 20 SHEETS
STA. 125+00.00 TO STA. 131+00.00

F.A.U. RTE. 0347	SECTION 05-00102-00-PV	COUNTY KANE	TOTAL SHEETS 488	SHEET NO. 80
CONTRACT NO. 61J84			ILLINOIS FED. AID PROJECT	

PLAN	SURVEYED	DATE
	PLOTTED	BY
	NOTED	
	CHECKED	
	FILED	
	NO.	

PROFILE	SURVEYED	DATE
	PLOTTED	BY
	NOTED	
	CHECKED	
	FILED	
	NO.	

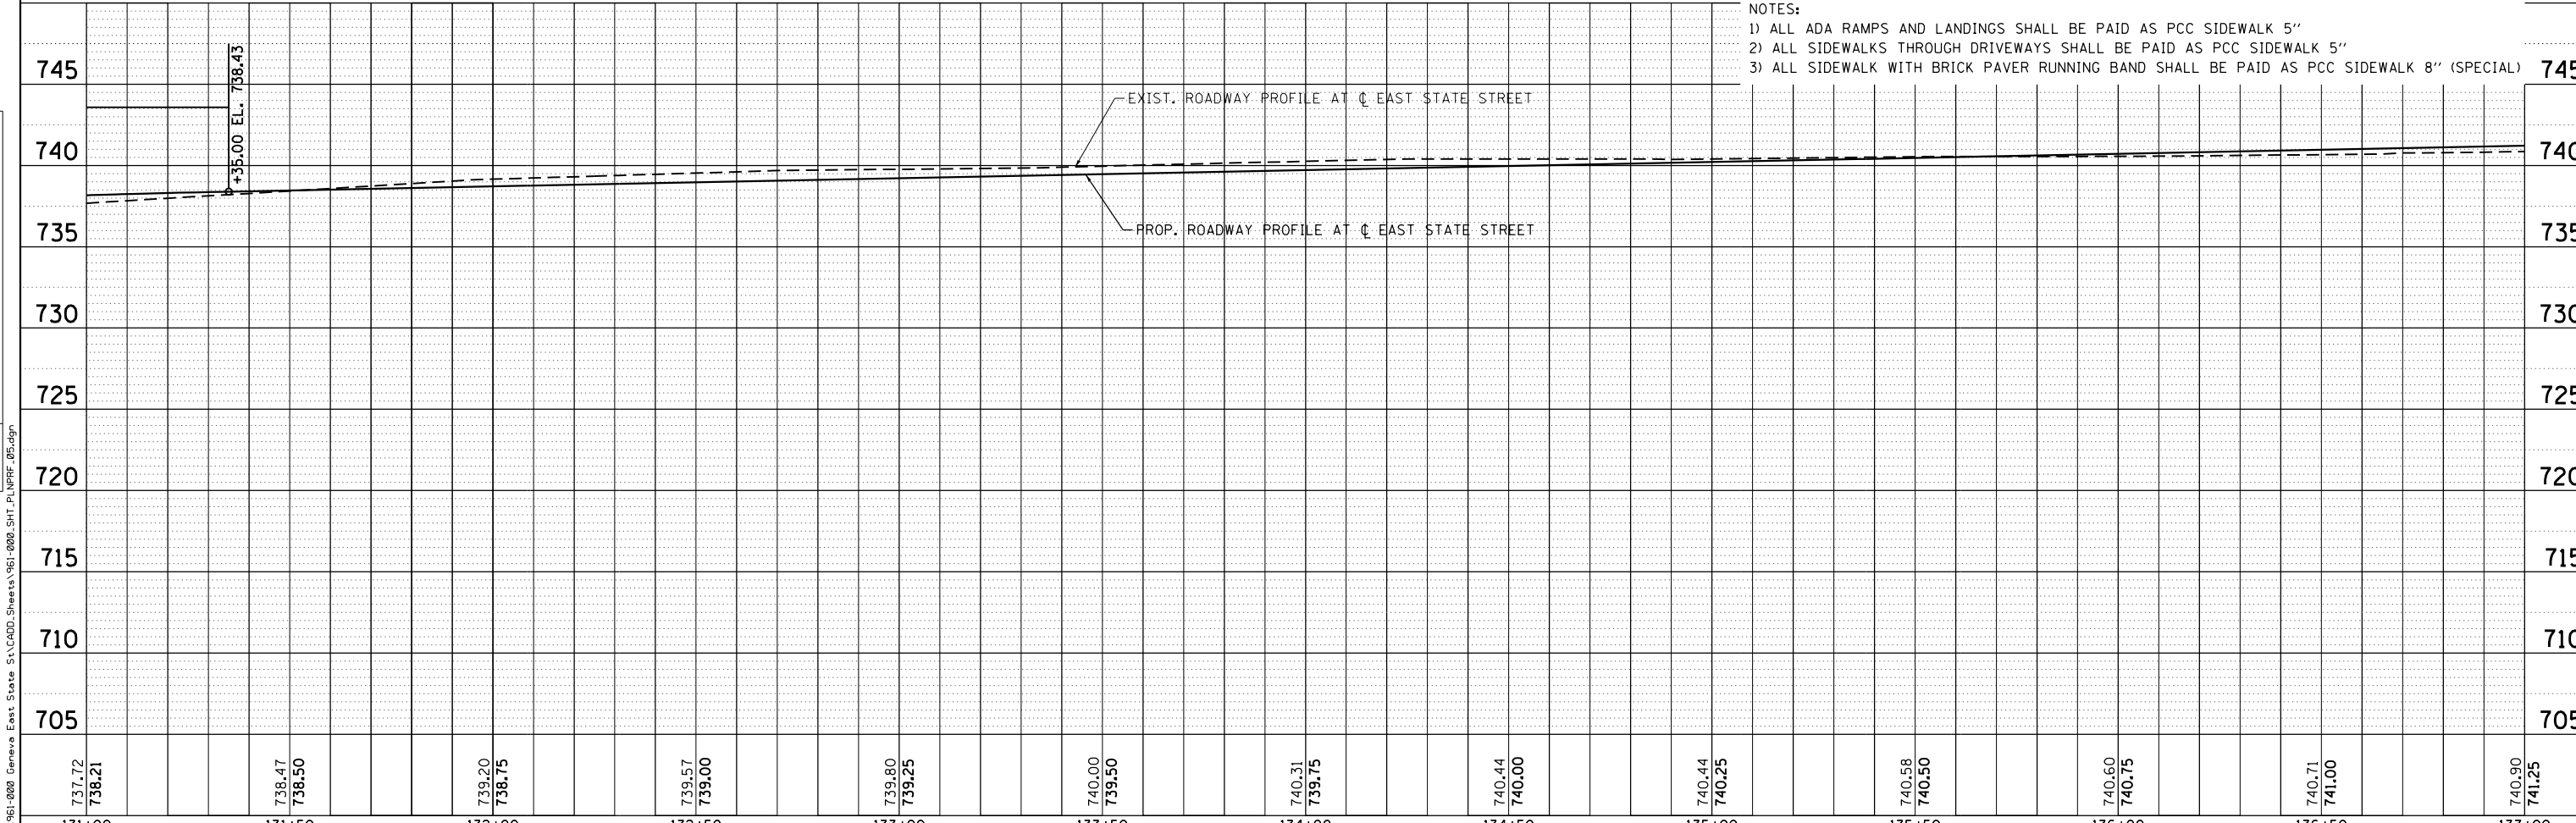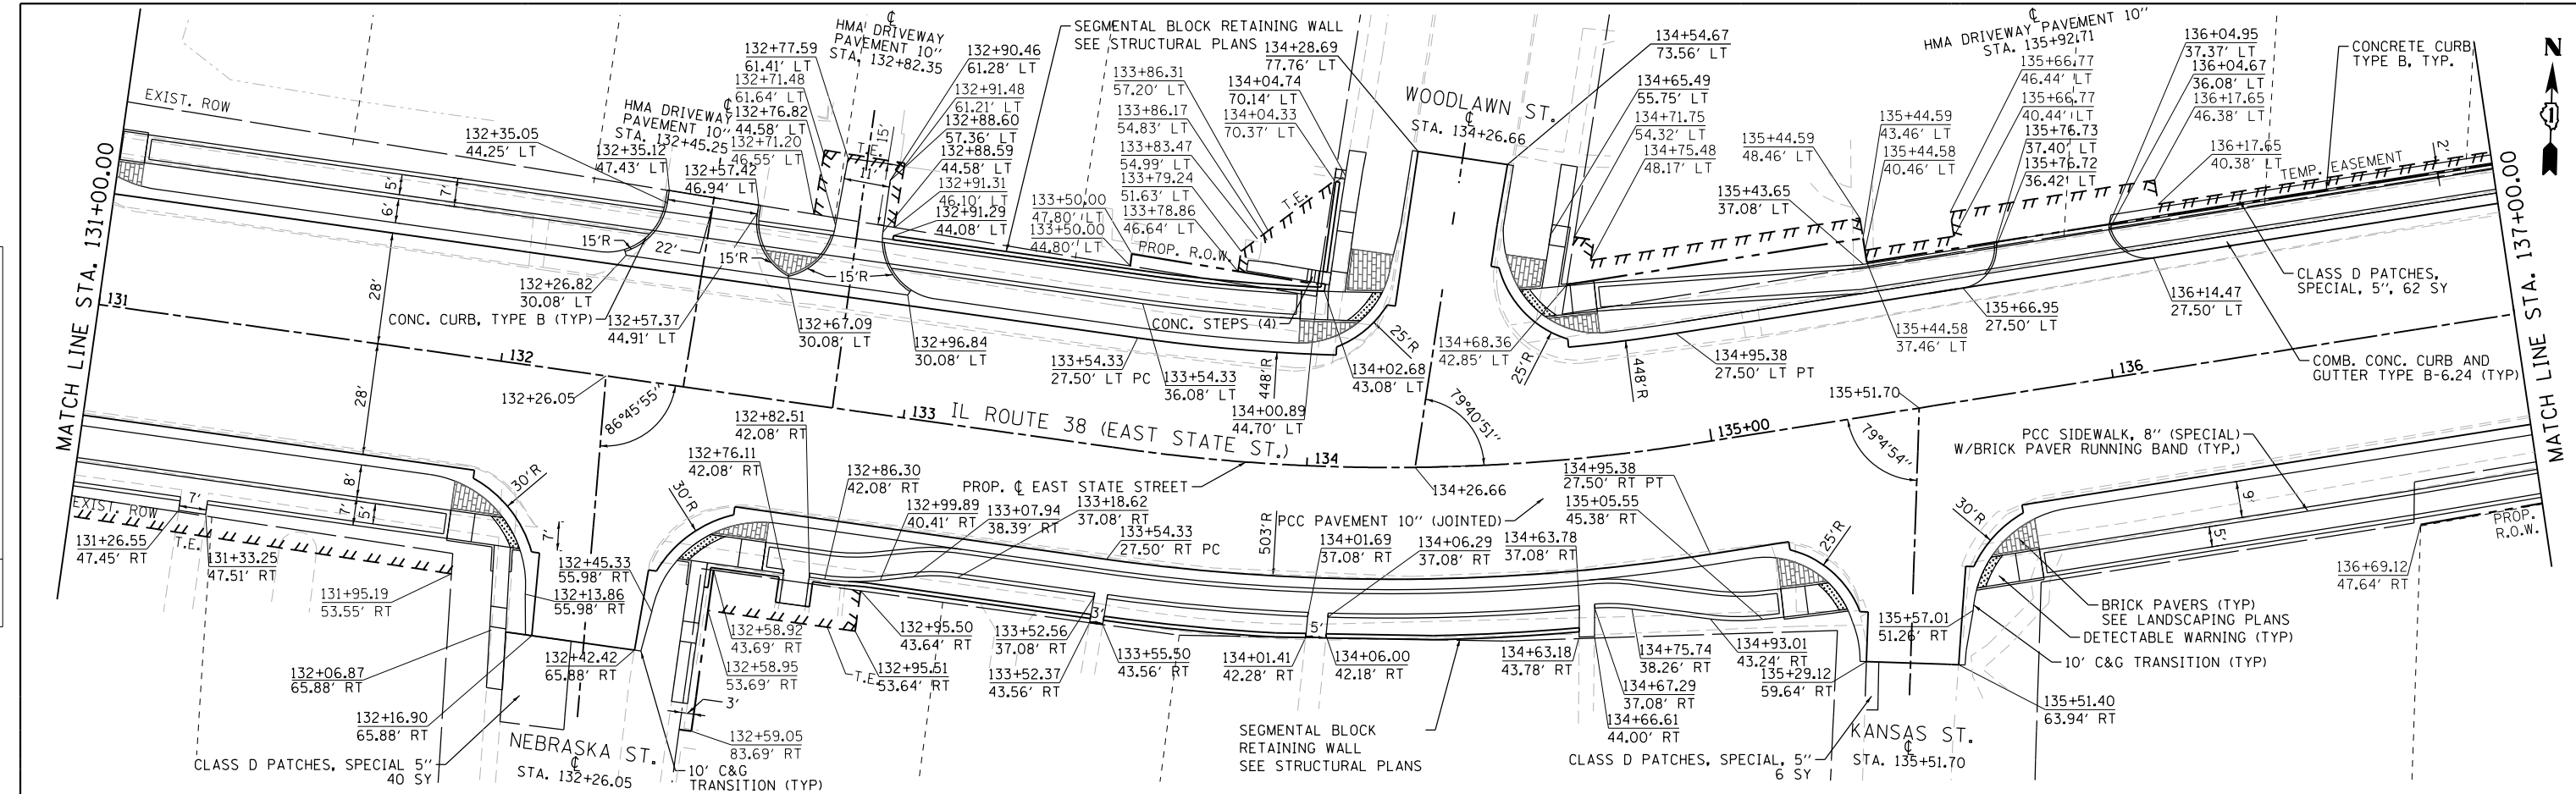

- NOTES:
- 1) ALL ADA RAMPS AND LANDINGS SHALL BE PAID AS PCC SIDEWALK 5"
 - 2) ALL SIDEWALKS THROUGH DRIVEWAYS SHALL BE PAID AS PCC SIDEWALK 5"
 - 3) ALL SIDEWALK WITH BRICK PAVER RUNNING BAND SHALL BE PAID AS PCC SIDEWALK 8" (SPECIAL)

737.72 738.21	738.47 738.50	739.20 738.75	739.57 739.00	739.80 739.25	740.00 739.50	740.31 739.75	740.44 740.00	740.44 740.25	740.58 740.50	740.60 740.75	740.71 741.00	740.90 741.25
131+00	131+50	132+00	132+50	133+00	133+50	134+00	134+50	135+00	135+50	136+00	136+50	137+00



USER NAME = tnestor	DESIGNED - GJE	REVISED -
	DRAWN - GJE	REVISED -
PLOT SCALE = 40.0000' / in.	CHECKED - DBB	REVISED -
PLOT DATE = 1/13/2025	DATE - 11/7/2024	REVISED -

STATE OF ILLINOIS
DEPARTMENT OF TRANSPORTATION


ILLINOIS ROUTE 38 - EAST STATE STREET
PLAN AND PROFILE

SCALE: 1"=20' SHEET 5 OF 20 SHEETS STA. 131+00.00 TO STA. 137+00.00


F.A.U. RTE.	SECTION	COUNTY	TOTAL SHEETS	SHEET NO.
0347	05-00102-00-PV	KANE	488	81
CONTRACT NO. 61J84				
ILLINOIS FED. AID PROJECT				

PLAN	SURVEYED	DATE
	PLOTTED	
	ALIGNED	
	CHECKED	
	FILED	
	NO.	
	NO.	

PROFILE	SURVEYED	DATE
	PLOTTED	
	GRADES	
	CHECKED	
	STRUCTURE	
	NOTATIONS	
	NO.	
	NO.	

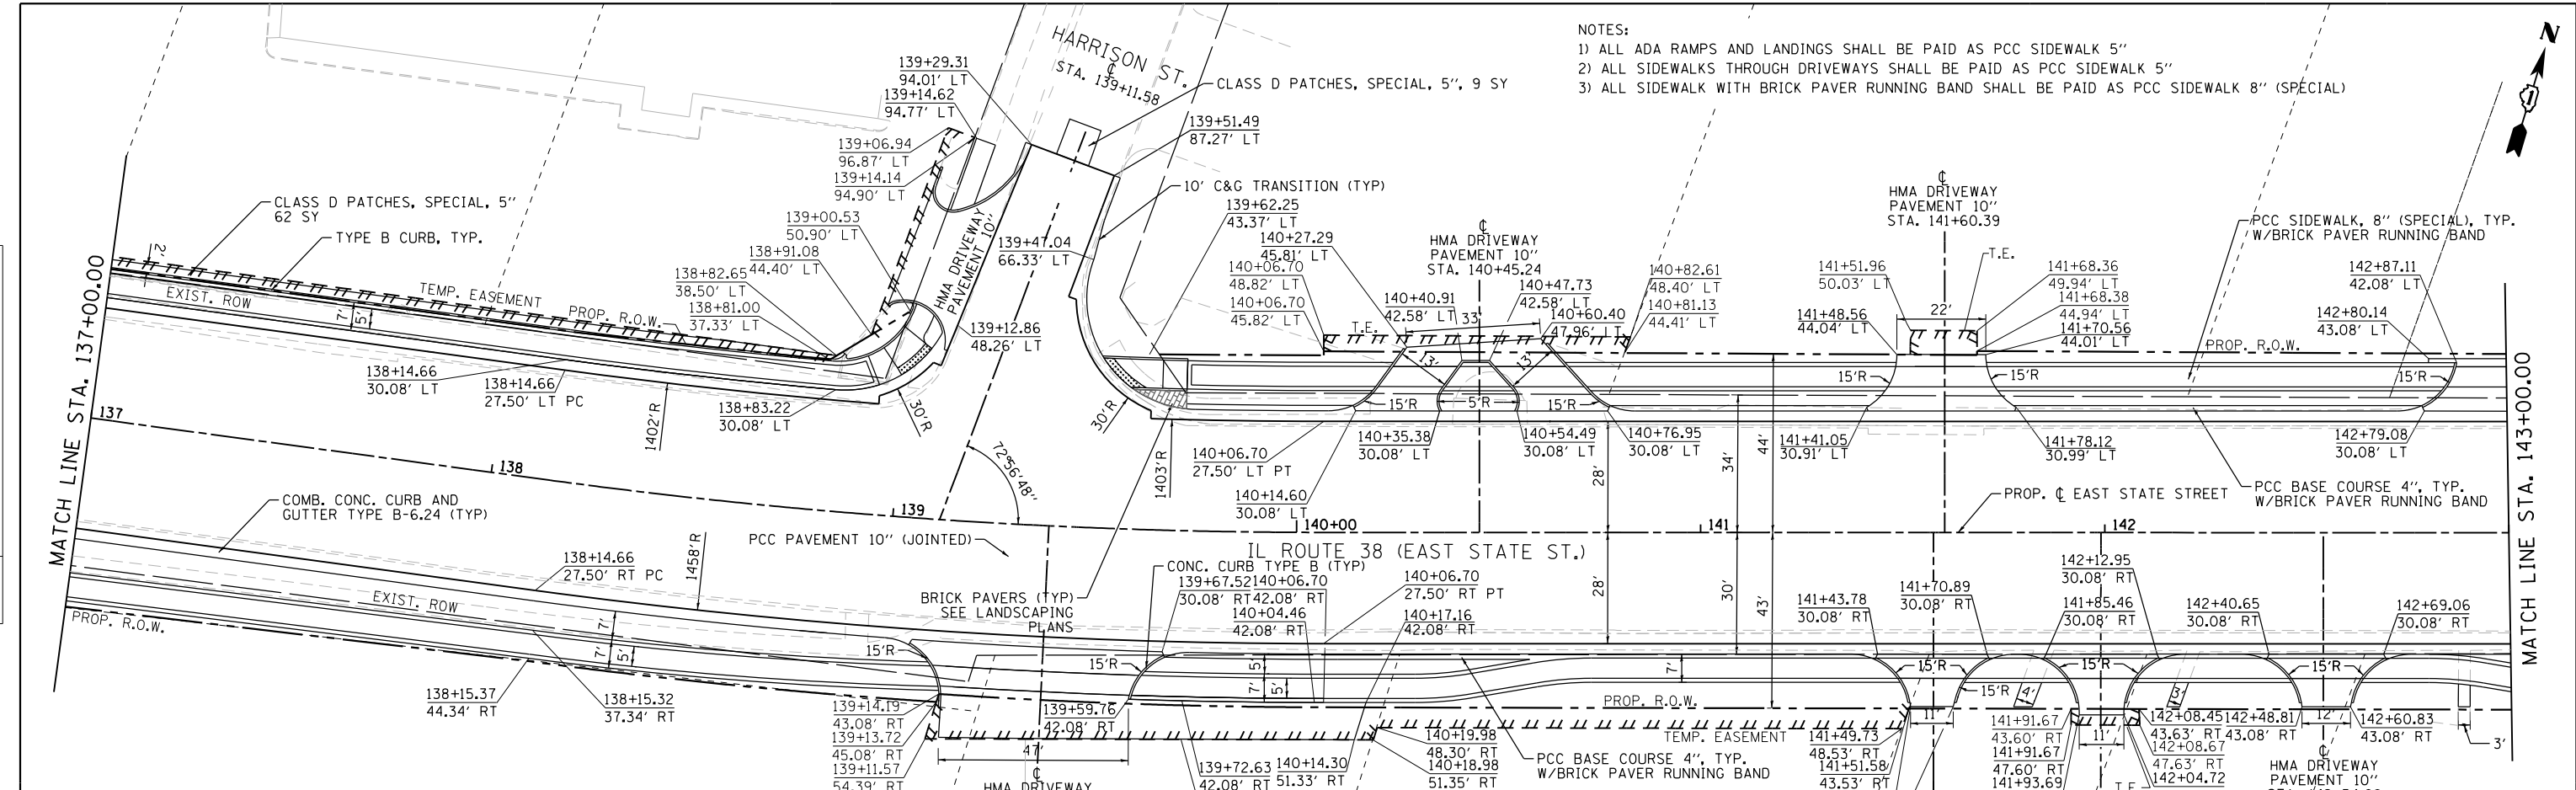

- NOTES:
- 1) ALL ADA RAMPS AND LANDINGS SHALL BE PAID AS PCC SIDEWALK 5"
 - 2) ALL SIDEWALKS THROUGH DRIVEWAYS SHALL BE PAID AS PCC SIDEWALK 5"
 - 3) ALL SIDEWALK WITH BRICK PAVER RUNNING BAND SHALL BE PAID AS PCC SIDEWALK 8" (SPECIAL)

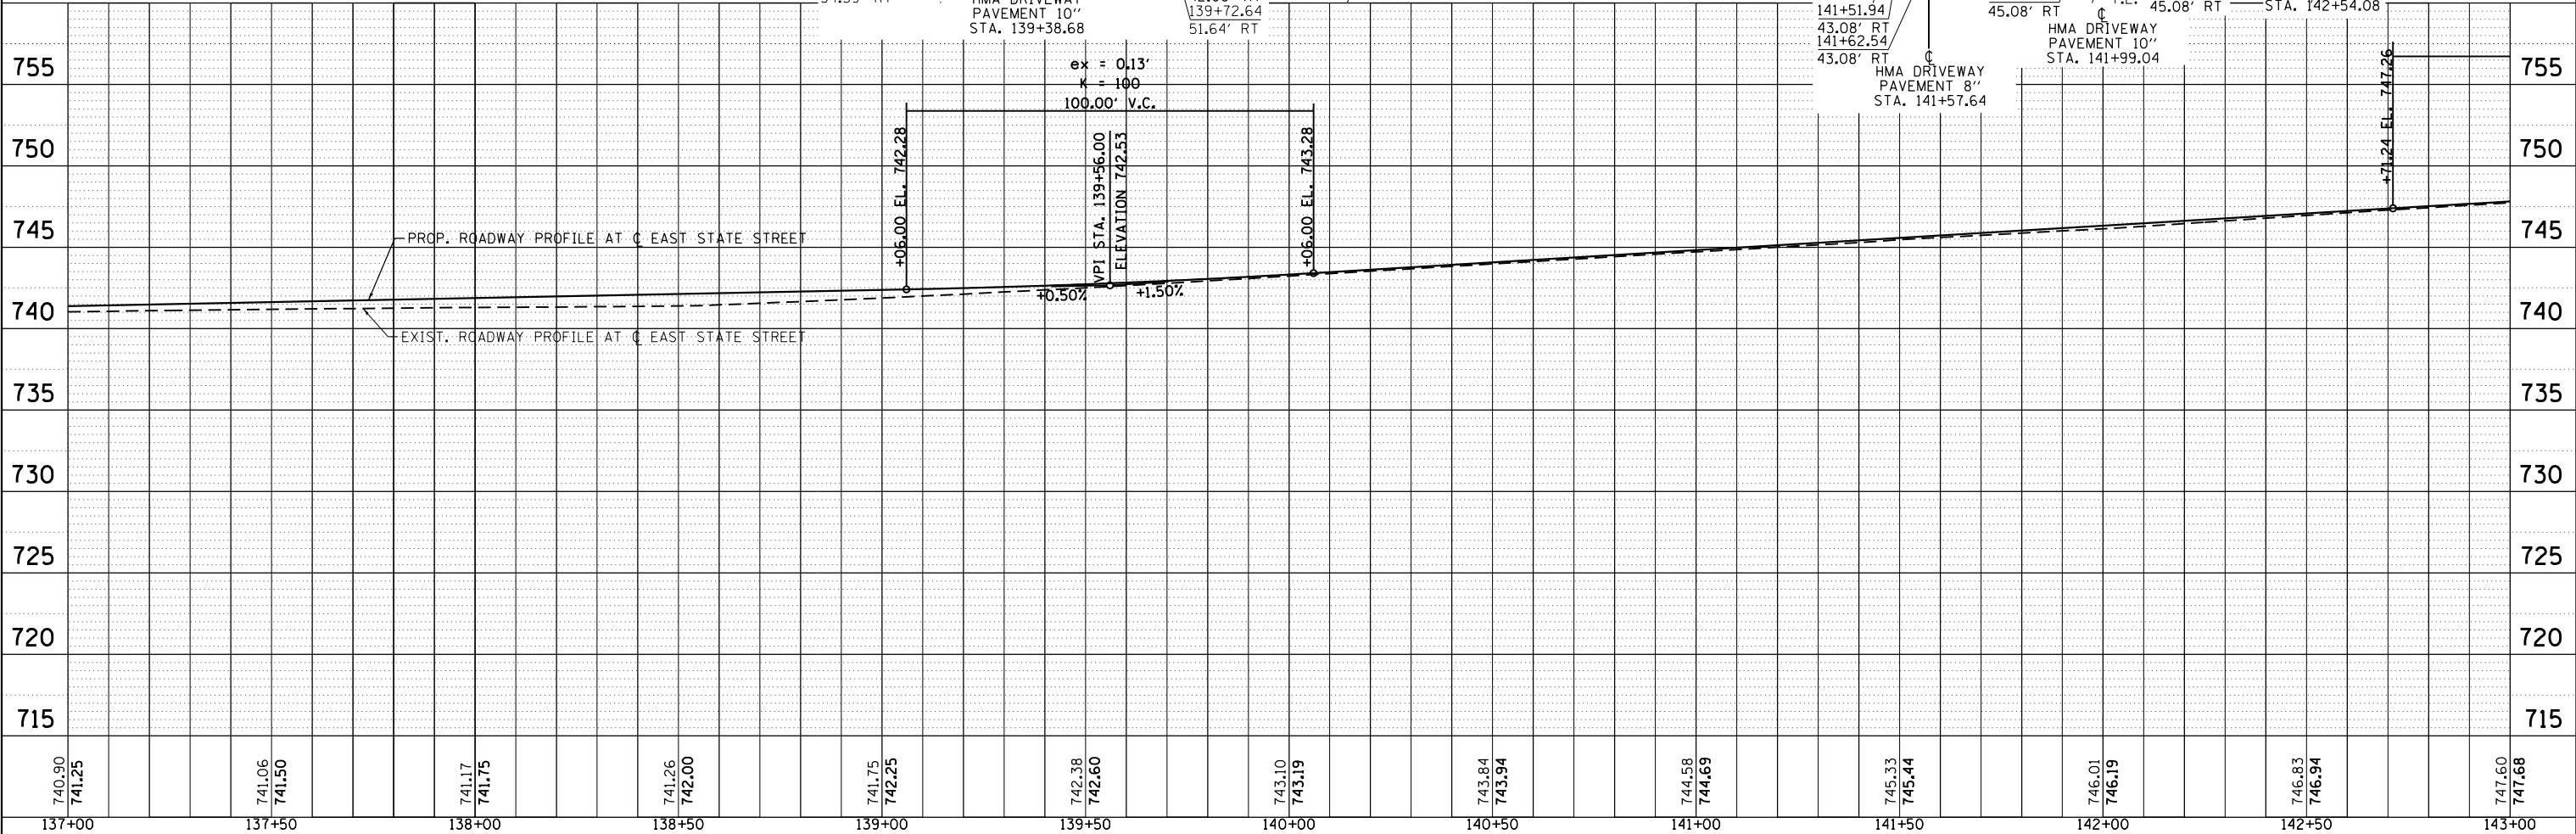

137+00	137+50	138+00	138+50	139+00	139+50	140+00	140+50	141+00	141+50	142+00	142+50	143+00
740.90 741.25	741.06 741.50	741.17 741.75	741.26 742.00	741.75 742.25	742.38 742.60	743.10 743.19	743.84 743.94	744.58 744.69	745.33 745.44	746.01 746.19	746.83 746.94	747.60 747.68



USER NAME = tnestor	DESIGNED - GJE	REVISED -
	DRAWN - GJE	REVISED -
PLOT SCALE = 48.0000' / in.	CHECKED - DBB	REVISED -
PLOT DATE = 1/13/2025	DATE - 11/7/2024	REVISED -

STATE OF ILLINOIS
DEPARTMENT OF TRANSPORTATION

ILLINOIS ROUTE 38 - EAST STATE STREET
PLAN AND PROFILE


SCALE: 1"=20' SHEET 6 OF 20 SHEETS STA. 137+00.00 TO STA. 143+00.00

F.A.U. RT.E.	SECTION	COUNTY	TOTAL SHEETS	SHEET NO.
0347	05-00102-00-PV	KANE	488	82
CONTRACT NO. 61J84				
ILLINOIS FED. AID PROJECT				





DATE	
BY	
PLAN	SURVEYED
	PLOTTED
	ALIGNED
	CHECKED
	DESIGNED
	NOTED
	FILED
	NO.

DATE	
BY	
PROFILE	SURVEYED
	PLOTTED
	GRADES
	CHECKED
	STRUCTURE
	NOTED
	FILED
	NO.

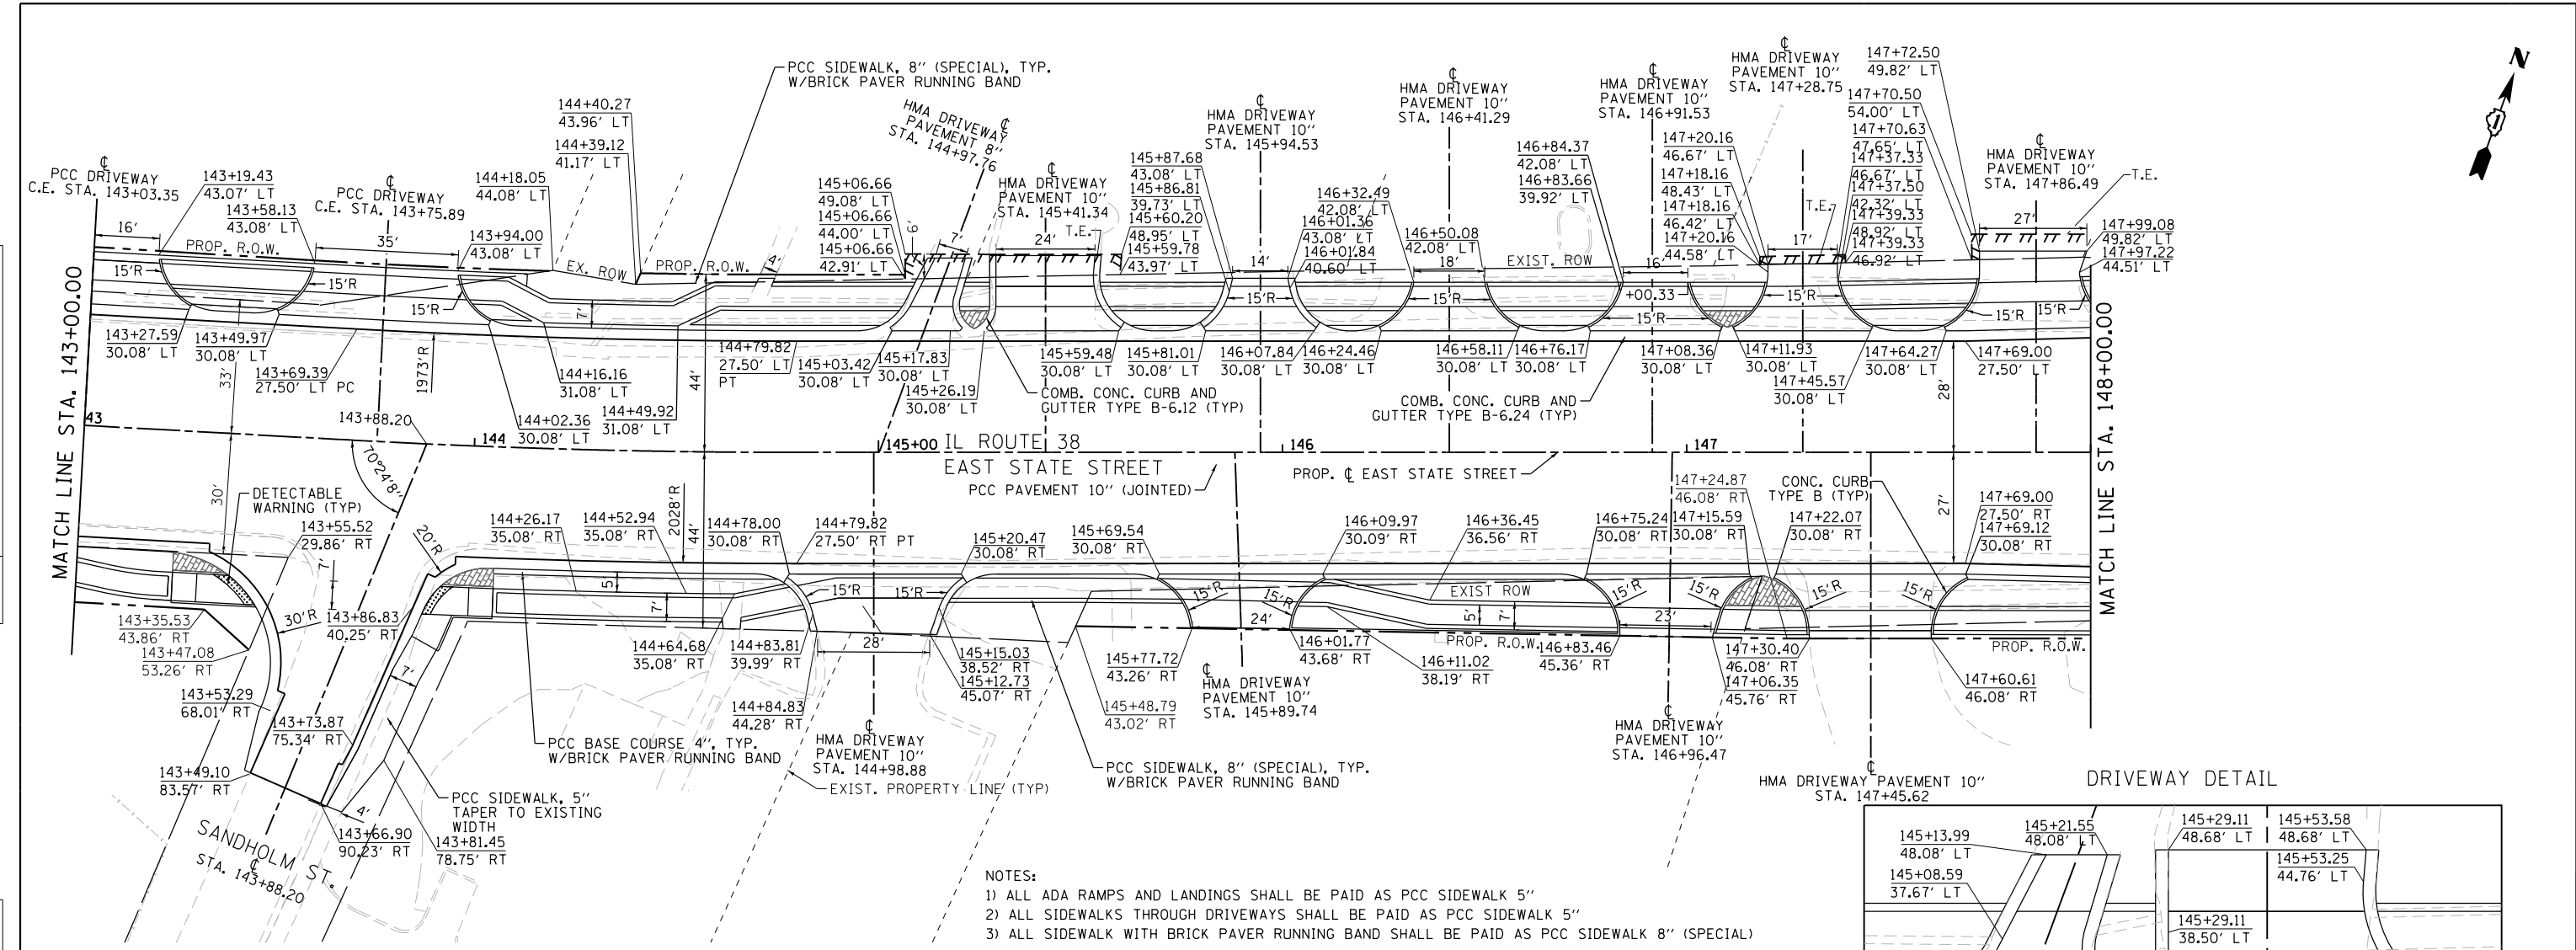

- NOTES:
- 1) ALL ADA RAMPS AND LANDINGS SHALL BE PAID AS PCC SIDEWALK 5"
 - 2) ALL SIDEWALKS THROUGH DRIVEWAYS SHALL BE PAID AS PCC SIDEWALK 5"
 - 3) ALL SIDEWALK WITH BRICK PAVER RUNNING BAND SHALL BE PAID AS PCC SIDEWALK 8" (SPECIAL)

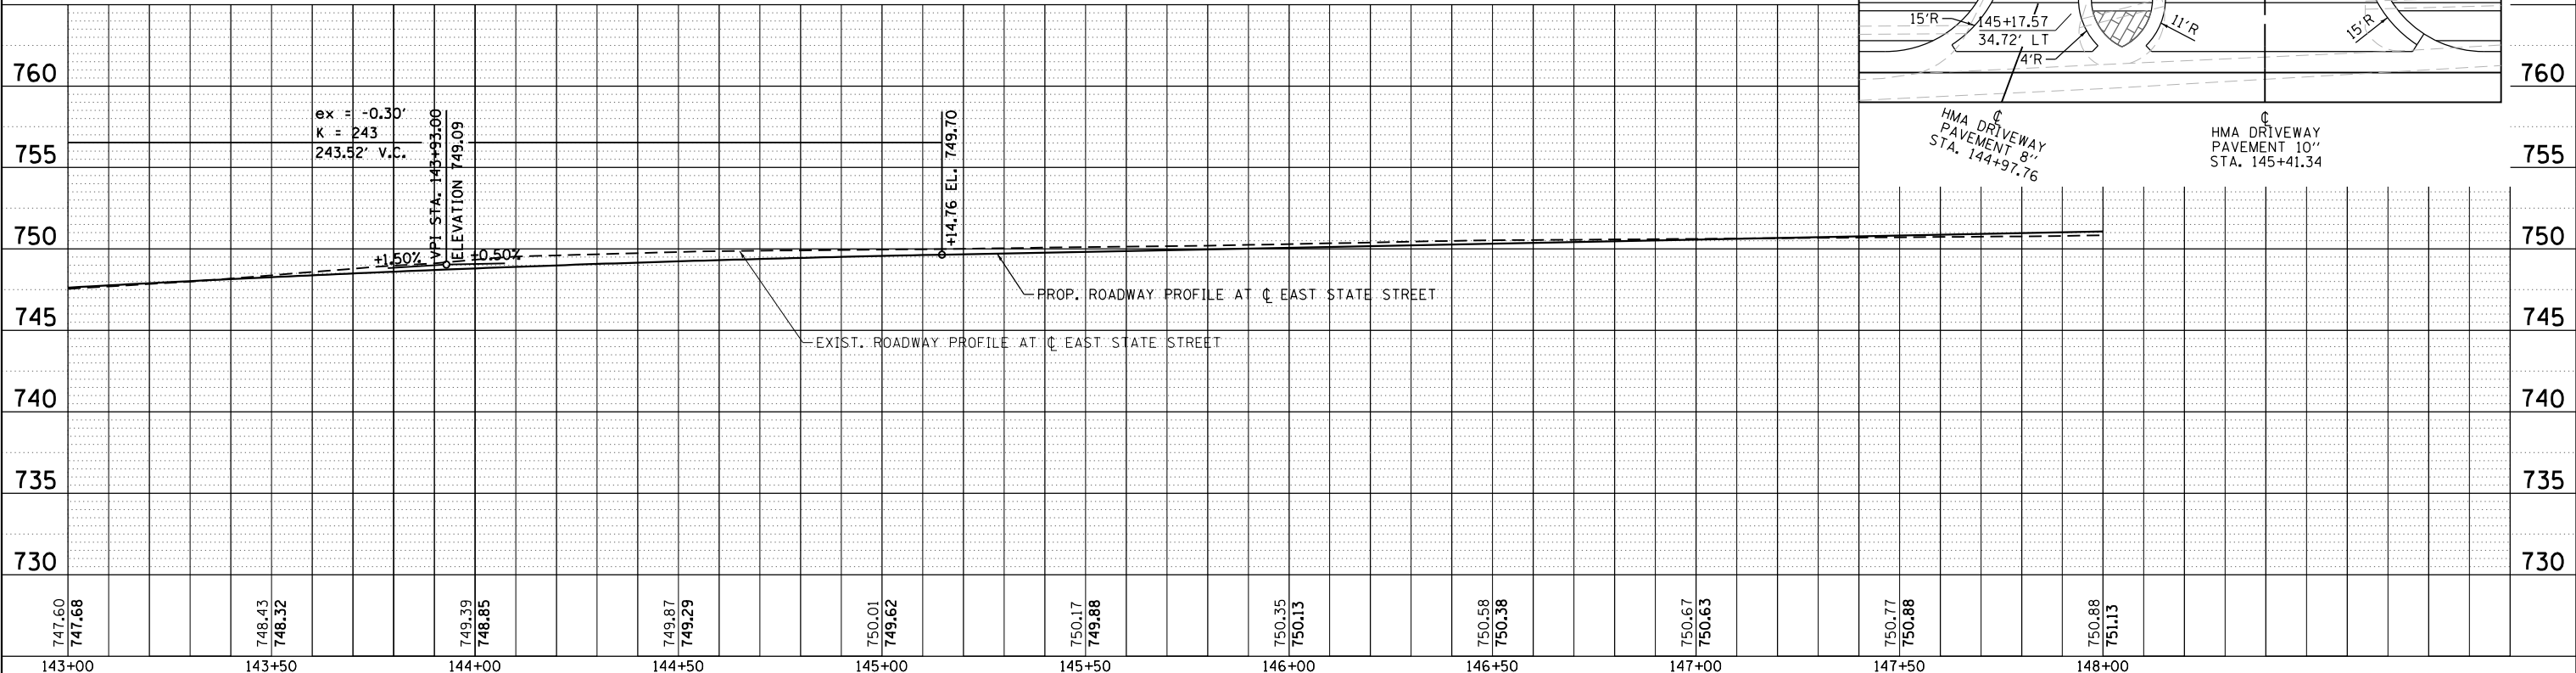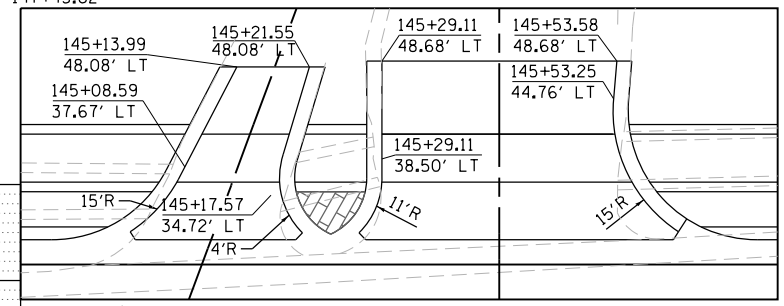

747.60 747.68	748.43 748.52	749.39 748.85	749.87 749.29	750.01 749.62	750.17 749.88	750.35 750.13	750.58 750.38	750.67 750.63	750.77 750.88	750.88 751.13
143+00	143+50	144+00	144+50	145+00	145+50	146+00	146+50	147+00	147+50	148+00



USER NAME = tnestor	DESIGNED - GJE	REVISED -
	DRAWN - GJE	REVISED -
PLOT SCALE = 48.0000' / in.	CHECKED - DBB	REVISED -
PLOT DATE = 1/13/2025	DATE - 11/7/2024	REVISED -


STATE OF ILLINOIS
DEPARTMENT OF TRANSPORTATION

ILLINOIS ROUTE 38 - EAST STATE STREET	
PLAN AND PROFILE	
SCALE: 1"=20'	SHEET 7 OF 20 SHEETS STA. 143+00.00 TO STA. 148+00.00


F.A.U. R.T.E. 0347	SECTION 05-00102-00-PV	COUNTY KANE	TOTAL SHEETS 488	SHEET NO. 83
CONTRACT NO. 61J84				ILLINOIS FED. AID PROJECT

DATE	
BY	
PLAN	SURVEYED
	PLOTTED
	ALIGNED
	CHECKED
	DESIGNED
	NO. _____
	FILE NAME

DATE	
BY	
PROFILE	SURVEYED
	PLOTTED
	GRADES CHECKED
	STRUCTURE NOTATIONS CHECKED
	NO. _____
	FILE NAME

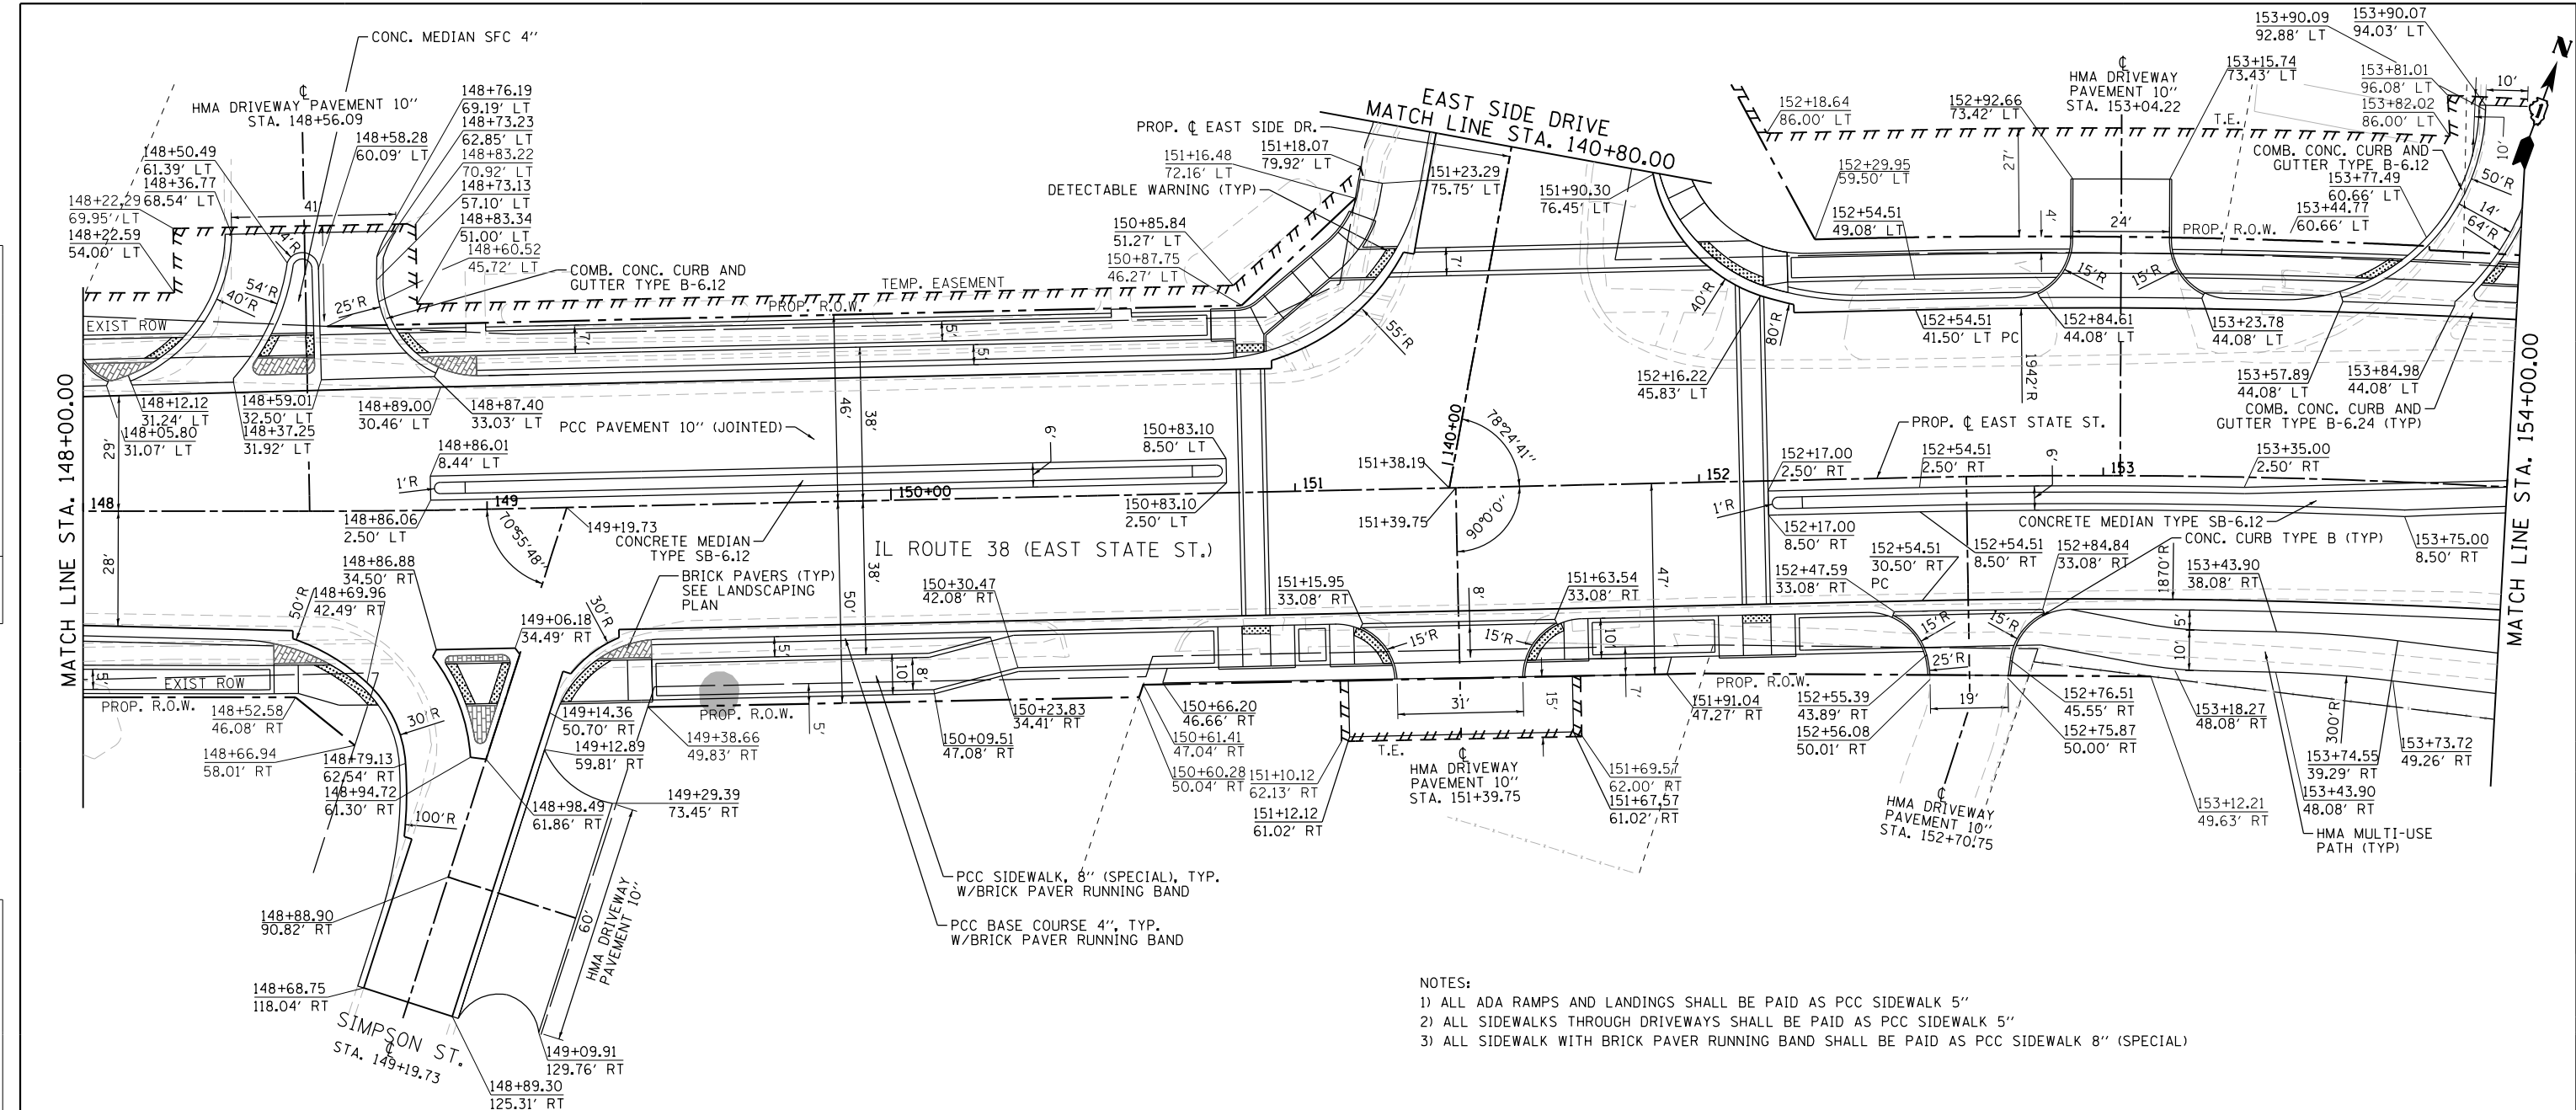

- NOTES:
- 1) ALL ADA RAMP AND LANDINGS SHALL BE PAID AS PCC SIDEWALK 5"
 - 2) ALL SIDEWALKS THROUGH DRIVEWAYS SHALL BE PAID AS PCC SIDEWALK 5"
 - 3) ALL SIDEWALK WITH BRICK PAVER RUNNING BAND SHALL BE PAID AS PCC SIDEWALK 8" (SPECIAL)

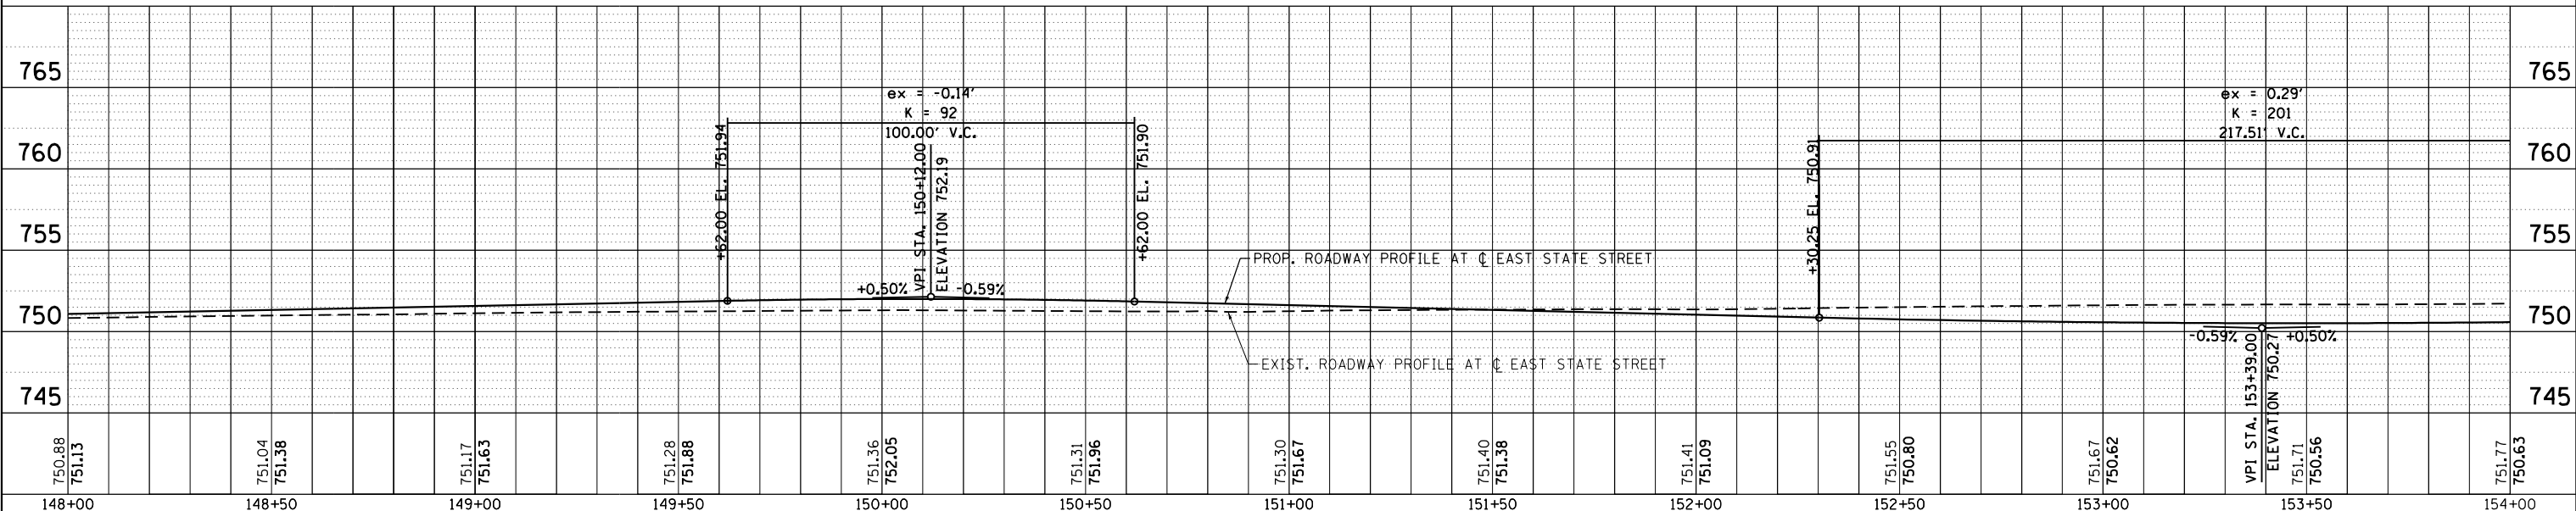

FILE NAME = F:\1961-2020 - Genesee East State St\CAD\Drawings\1961-2020-SHT_PL\PRF_08.dwg

750.88 751.13	751.04 751.38	751.17 751.63	751.28 751.88	751.36 752.05	751.31 751.96	751.30 751.67	751.40 751.38	751.41 751.09	751.55 750.80	751.67 750.62	VPI STA. 153+39.00 ELEVATION 750.2 751.71 750.56	751.77 750.63
148+00	148+50	149+00	149+50	150+00	150+50	151+00	151+50	152+00	152+50	153+00	153+50	154+00



USER NAME = tnestor	DESIGNED - GJE	REVISED -
	DRAWN - GJE	REVISED -
PLOT SCALE = 48.0000' / in.	CHECKED - DBB	REVISED -
PLOT DATE = 1/13/2025	DATE - 11/7/2024	REVISED -


**STATE OF ILLINOIS
DEPARTMENT OF TRANSPORTATION**

ILLINOIS ROUTE 38 - EAST STATE STREET			
PLAN AND PROFILE			
SCALE: 1"=20'	SHEET 8	OF 20 SHEETS	STA. 148+00.00 TO STA. 154+00.00


F.A.U. R.T.E. 0347	SECTION 05-00102-00-PV	COUNTY KANE	TOTAL SHEETS 488	SHEET NO. 84
CONTRACT NO. 61J84				
ILLINOIS FED. AID PROJECT				

PLAN	SURVEYED	DATE
	PLOTTED	BY
	NOTE BOOK	
	NO.	
	NO.	
	NO.	

PROFILE	SURVEYED	DATE
	PLOTTED	BY
	NOTE BOOK	
	NO.	
	NO.	
	NO.	

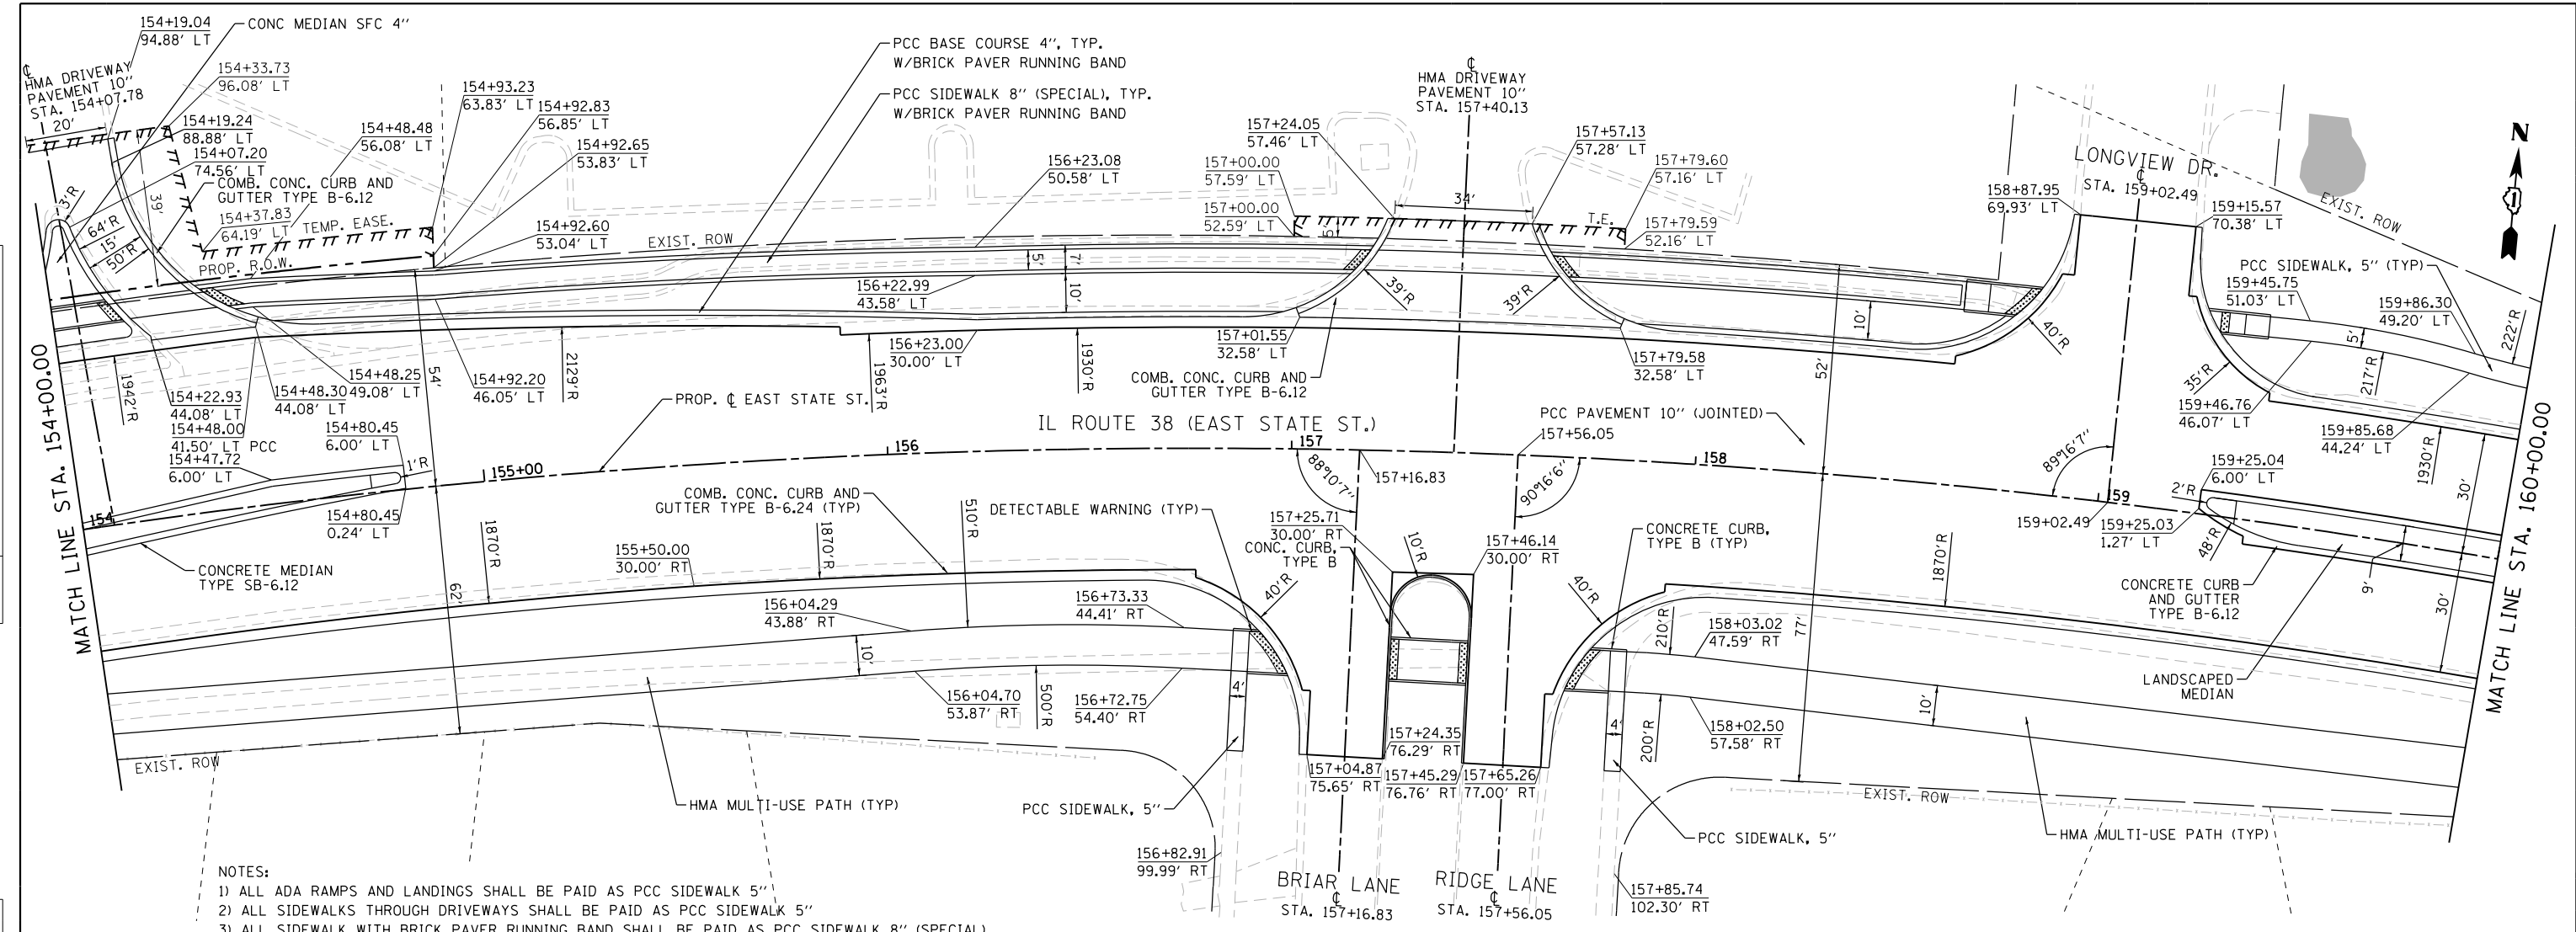

- NOTES:
- 1) ALL ADA RAMPS AND LANDINGS SHALL BE PAID AS PCC SIDEWALK 5"
 - 2) ALL SIDEWALKS THROUGH DRIVEWAYS SHALL BE PAID AS PCC SIDEWALK 5"
 - 3) ALL SIDEWALK WITH BRICK PAVER RUNNING BAND SHALL BE PAID AS PCC SIDEWALK 8" (SPECIAL)

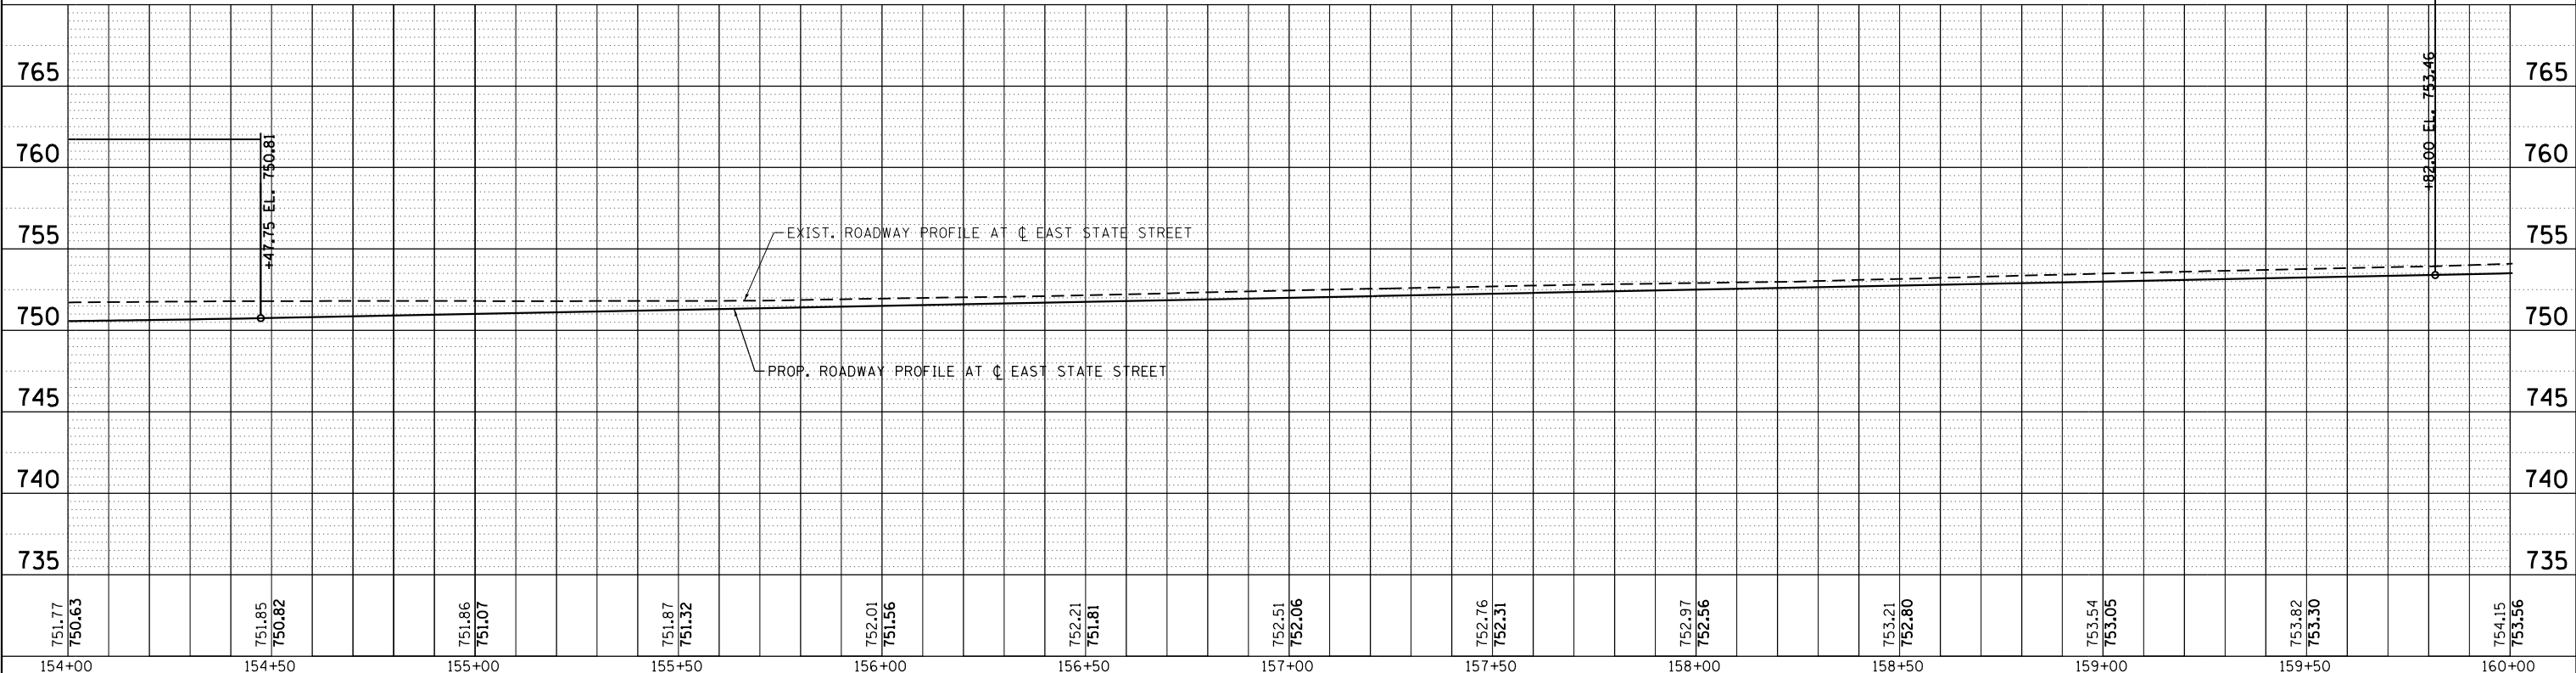

751.77	751.85	751.86	751.87	752.01	752.21	752.51	752.76	752.97	753.21	753.54	753.82	754.15
750.63	750.82	751.07	751.32	751.56	751.81	752.06	752.31	752.56	752.80	753.05	753.30	753.56
154+00	154+50	155+00	155+50	156+00	156+50	157+00	157+50	158+00	158+50	159+00	159+50	160+00



USER NAME = tnestor	DESIGNED - GJE	REVISED -
PLOT SCALE = 40.0000' / in.	DRAWN - GJE	REVISED -
PLOT DATE = 1/13/2025	CHECKED - DBB	REVISED -
	DATE - 11/7/2024	REVISED -



STATE OF ILLINOIS
DEPARTMENT OF TRANSPORTATION

ILLINOIS ROUTE 38 - EAST STATE STREET	
PLAN AND PROFILE	
SCALE: 1"=20'	SHEET 9 OF 20 SHEETS STA. 154+00.00 TO STA. 160+00.00


F.A.U. RTE. 0347	SECTION 05-00102-00-PV	COUNTY KANE	TOTAL SHEETS 488	SHEET NO. 85
CONTRACT NO. 61J84				
ILLINOIS FED. AID PROJECT				

PLAN	SURVEYED	DATE
	PLOTTED	BY
	GRADES CHECKED	
	STRUCTURE NOTATIONS CHECKED	
	NO.	

PROFILE	SURVEYED	DATE
	PLOTTED	BY
	GRADES CHECKED	
	STRUCTURE NOTATIONS CHECKED	
	NO.	

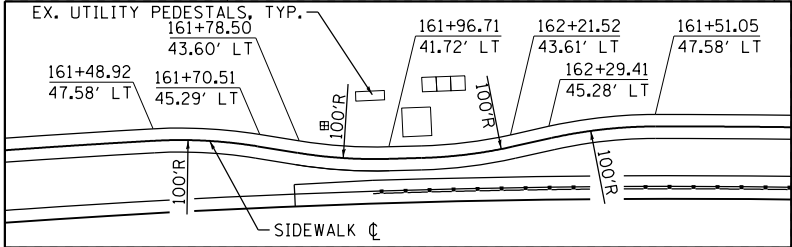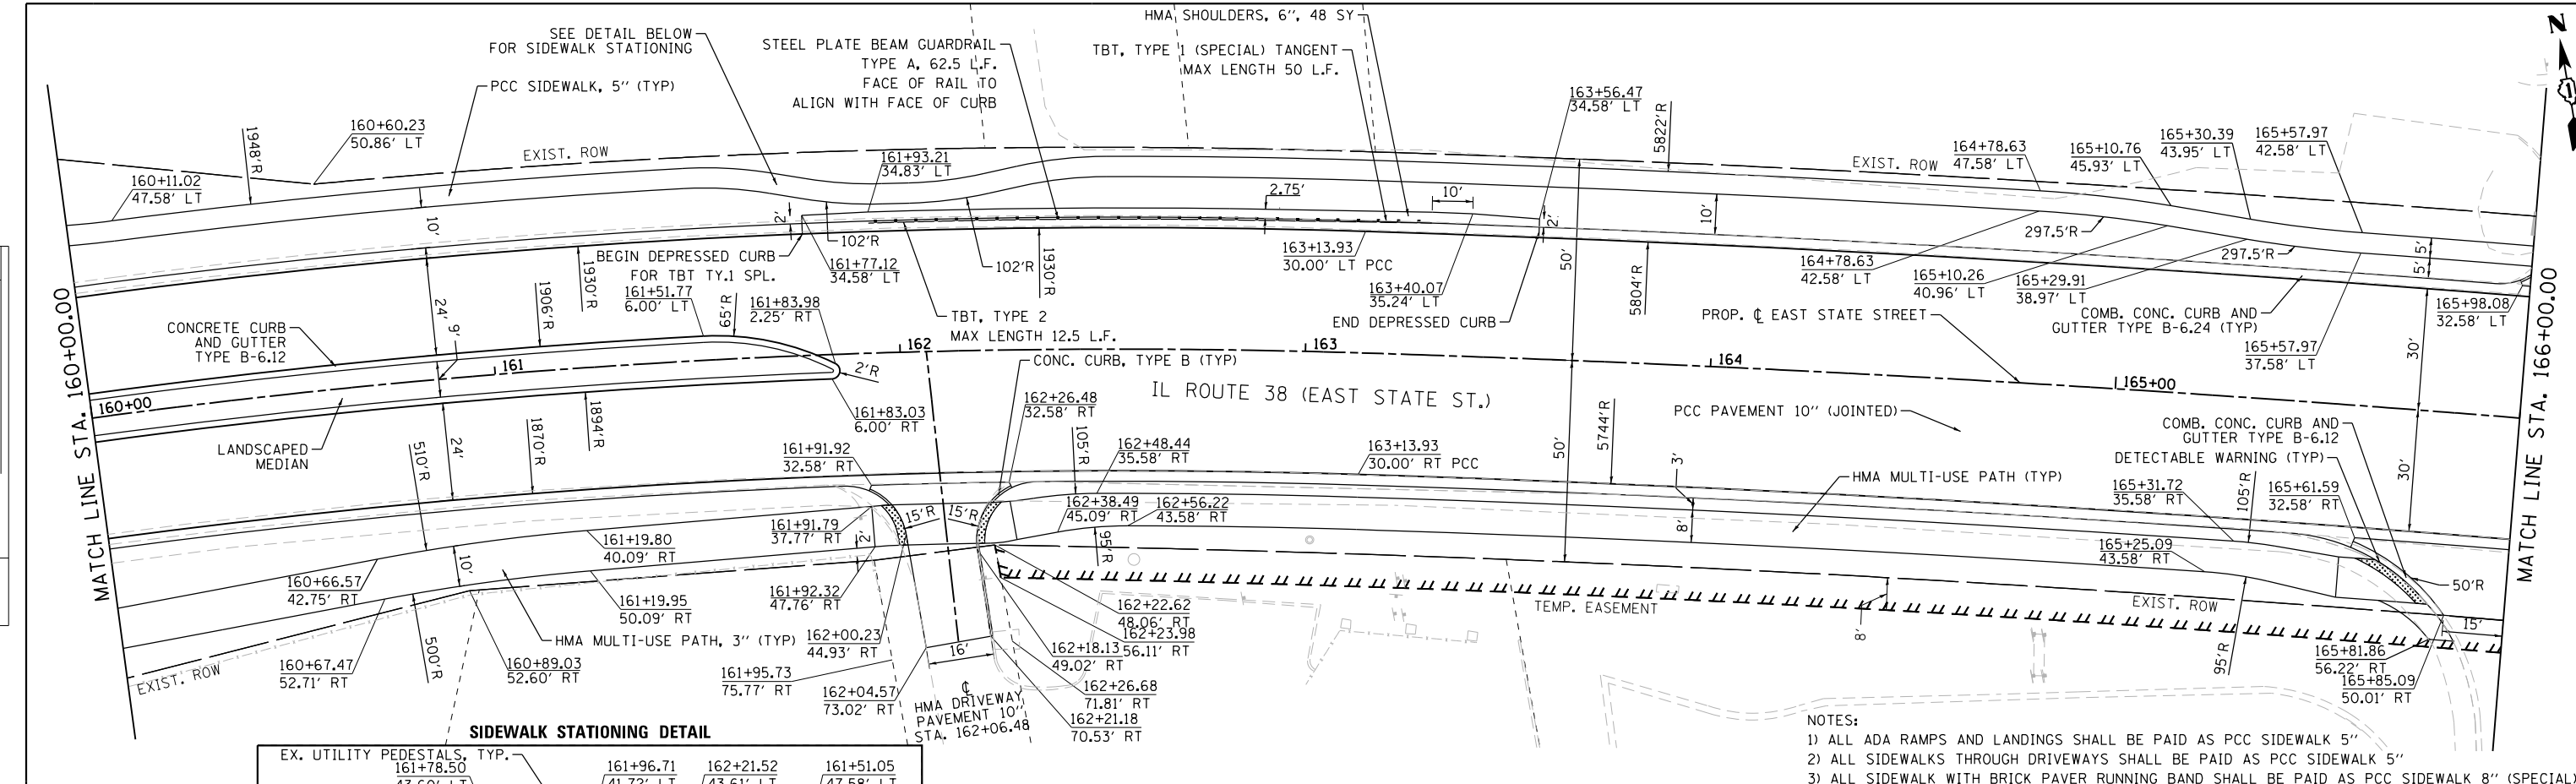

- NOTES:
- 1) ALL ADA RAMPS AND LANDINGS SHALL BE PAID AS PCC SIDEWALK 5"
 - 2) ALL SIDEWALKS THROUGH DRIVEWAYS SHALL BE PAID AS PCC SIDEWALK 5"
 - 3) ALL SIDEWALK WITH BRICK PAVER RUNNING BAND SHALL BE PAID AS PCC SIDEWALK 8" (SPECIAL)

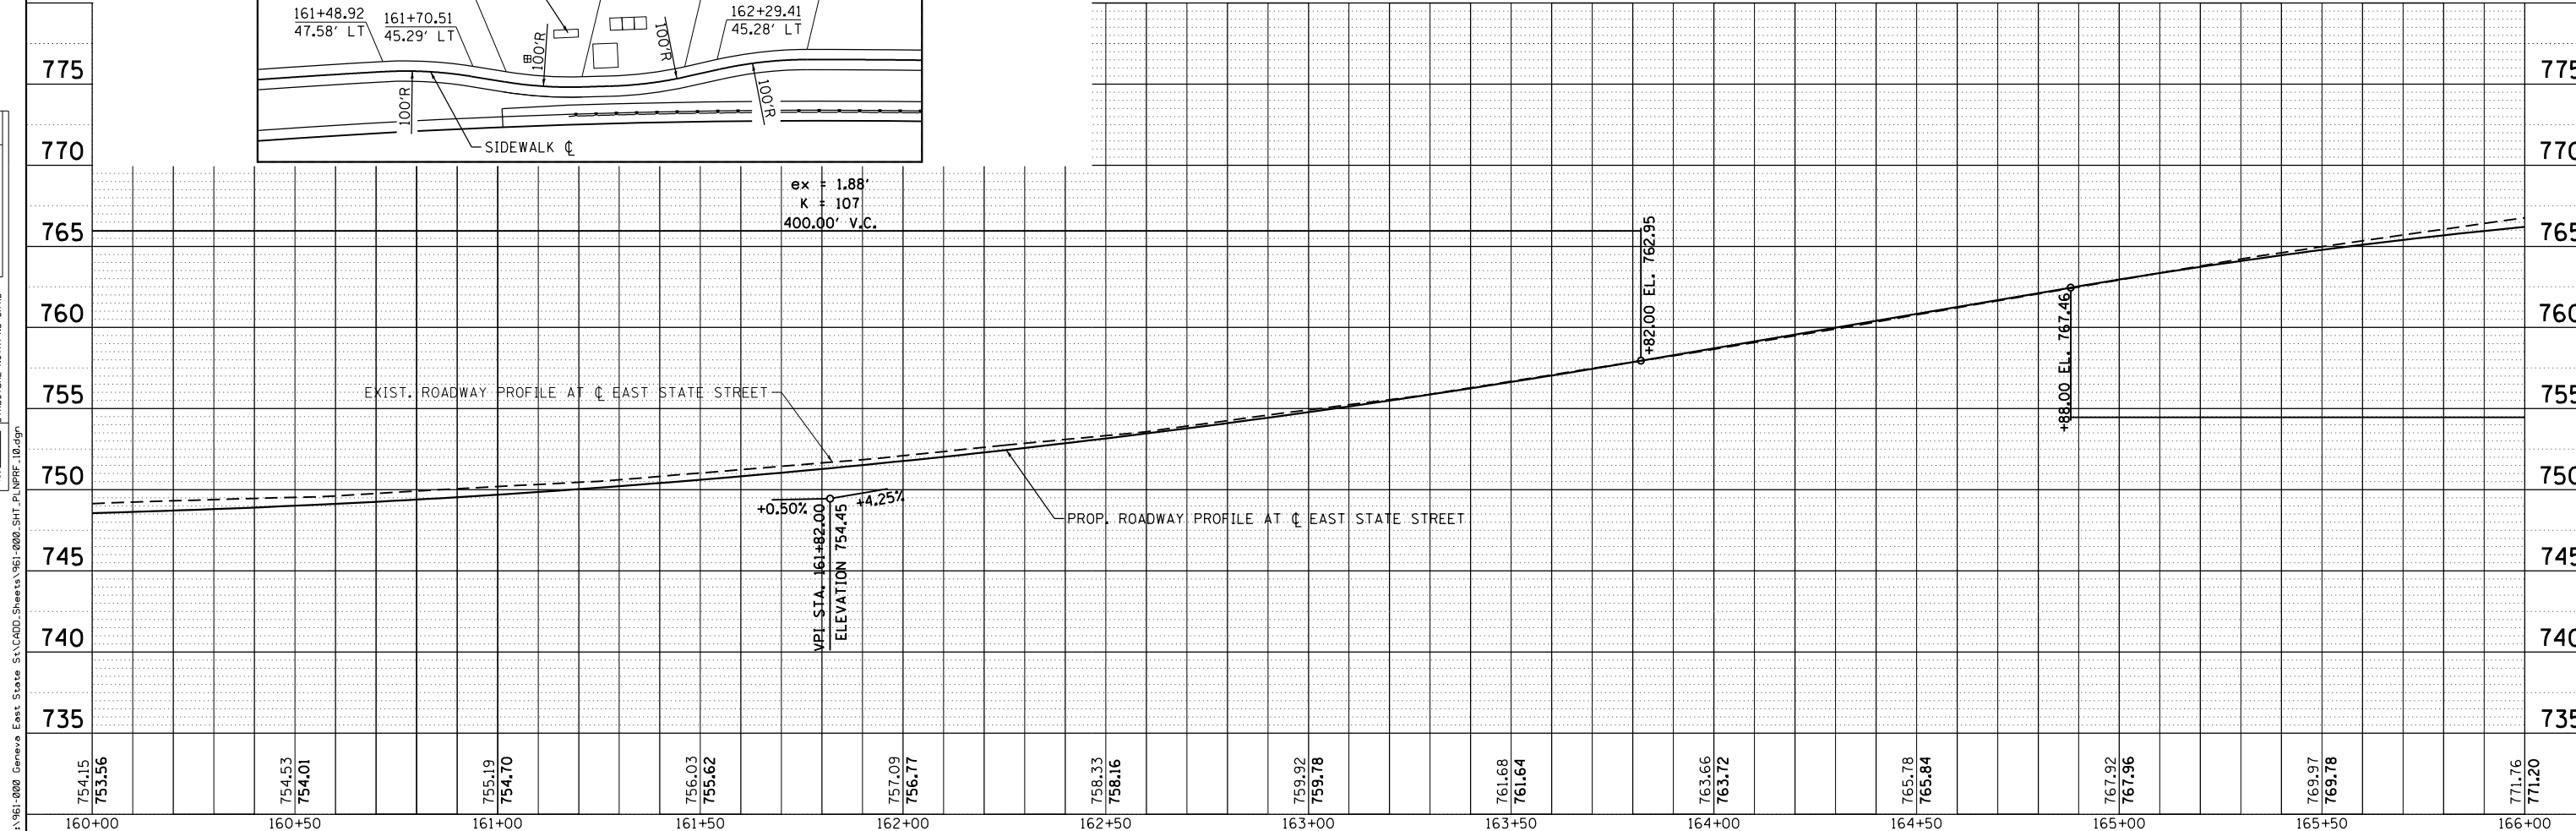

754.15	753.56	754.53	754.01	755.19	754.70	756.03	755.62	757.09	756.77	758.33	758.16	759.92	759.78	761.68	761.64	763.66	763.72	765.78	765.84	767.92	767.96	769.97	769.78	771.76	771.20
160+00	160+50	161+00	161+50	162+00	162+50	163+00	163+50	164+00	164+50	165+00	165+50	166+00													



USER NAME = tnestor	DESIGNED - GJE	REVISED -
	DRAWN - GJE	REVISED -
PLOT SCALE = 48.0000' / in.	CHECKED - DBB	REVISED -
PLOT DATE = 1/13/2025	DATE = 11/7/2024	REVISED -

STATE OF ILLINOIS
DEPARTMENT OF TRANSPORTATION


ILLINOIS ROUTE 38 - EAST STATE STREET	
PLAN AND PROFILE	
SCALE: 1"=20'	SHEET 10 OF 20 SHEETS STA. 160+00.00 TO STA. 166+00.00

F.A.U. RTE. 0347	SECTION 05-00102-00-PV	COUNTY KANE	TOTAL SHEETS 488	SHEET NO. 86
CONTRACT NO. 61J84			ILLINOIS FED. AID PROJECT	




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	PLOTTED	BY
	GRADES CHECKED	
	STRUCTURE NOTATIONS CHECKED	
	NO. _____	
	FILE NAME	

PROFILE	SURVEYED	DATE
	PLOTTED	BY
	GRADES CHECKED	
	STRUCTURE NOTATIONS CHECKED	
	NO. _____	
	FILE NAME	

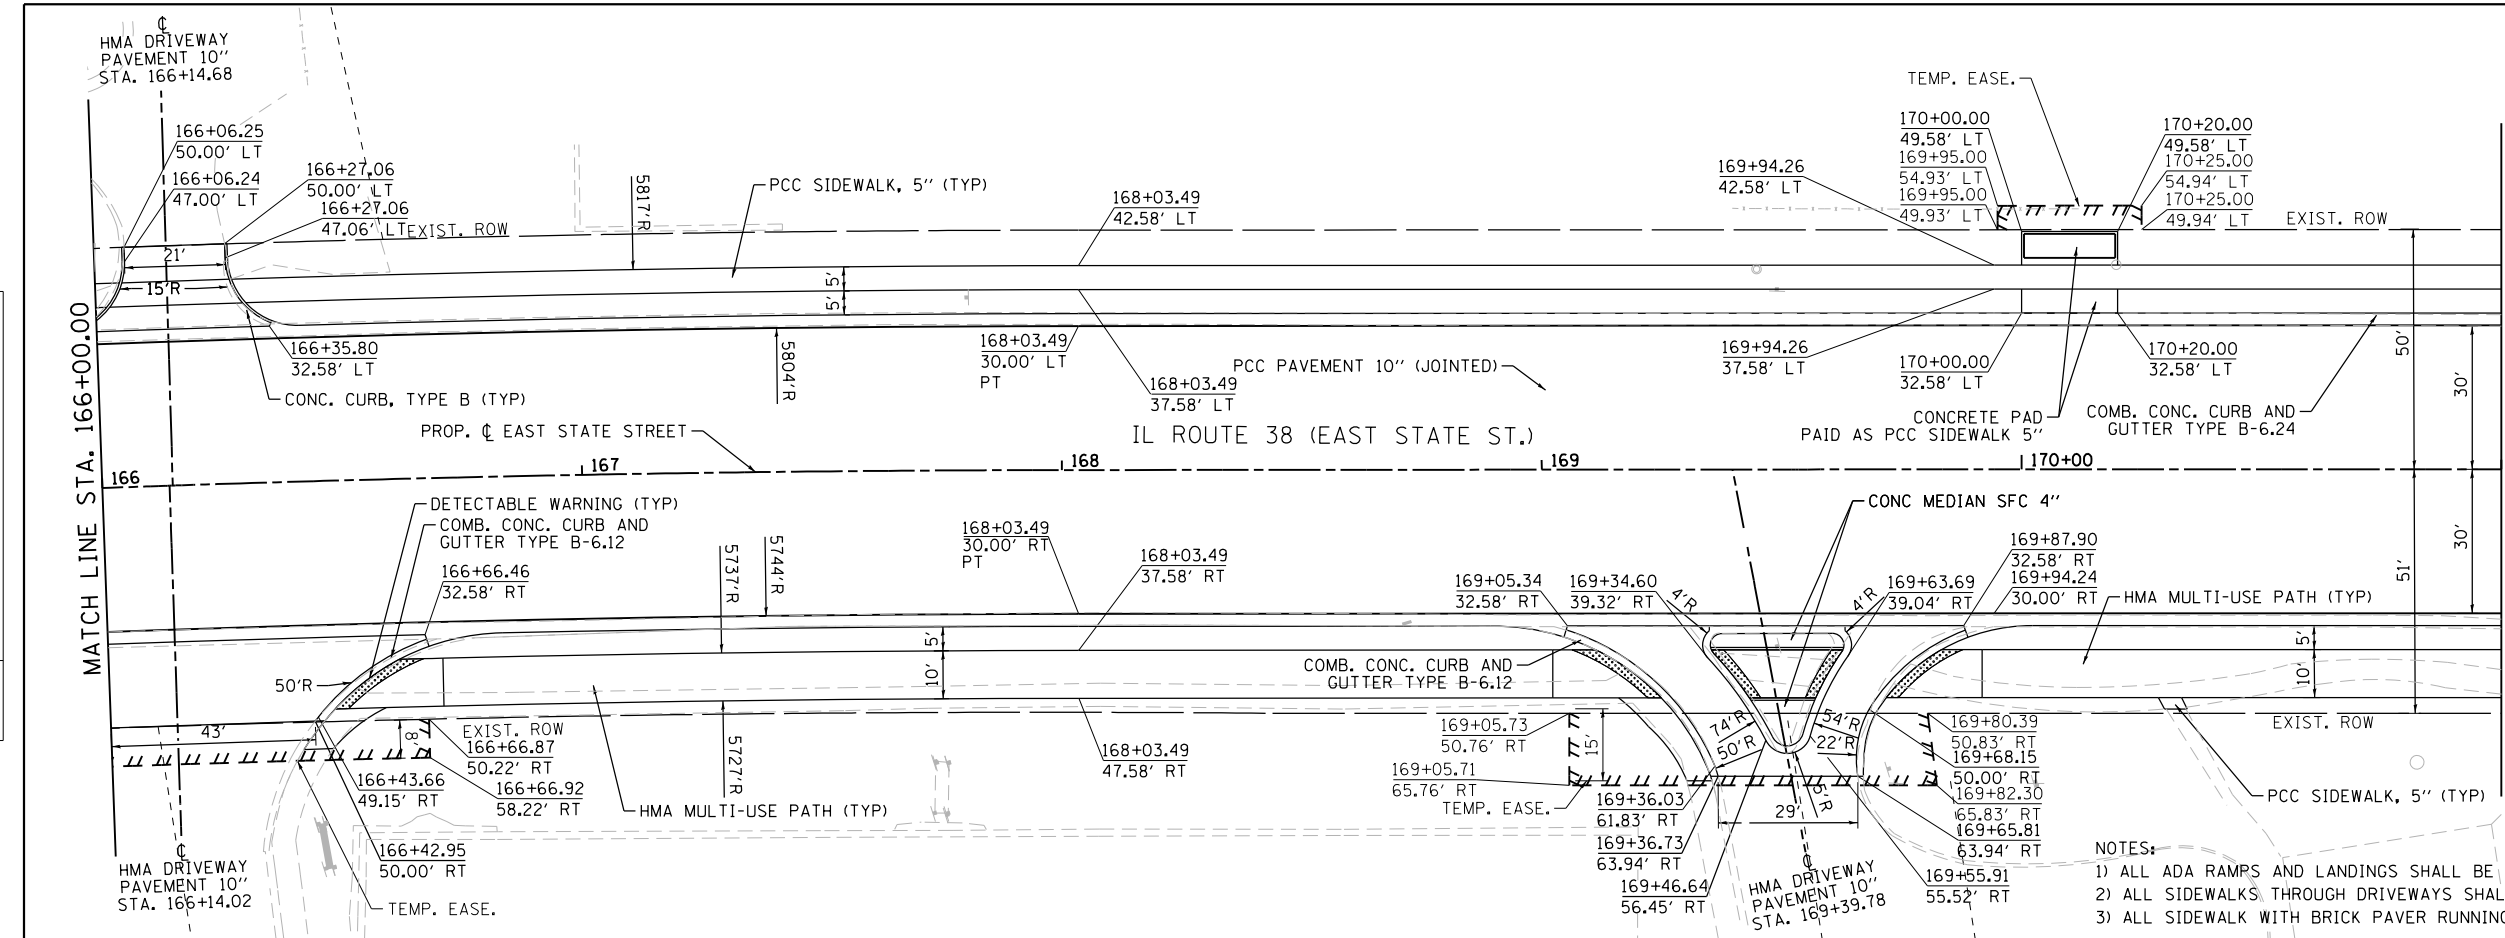

- NOTES:
- 1) ALL ADA RAMPS AND LANDINGS SHALL BE PAID AS PCC SIDEWALK 5"
 - 2) ALL SIDEWALKS THROUGH DRIVEWAYS SHALL BE PAID AS PCC SIDEWALK 5"
 - 3) ALL SIDEWALK WITH BRICK PAVER RUNNING BAND SHALL BE PAID AS PCC SIDEWALK 8" (SPECIAL)

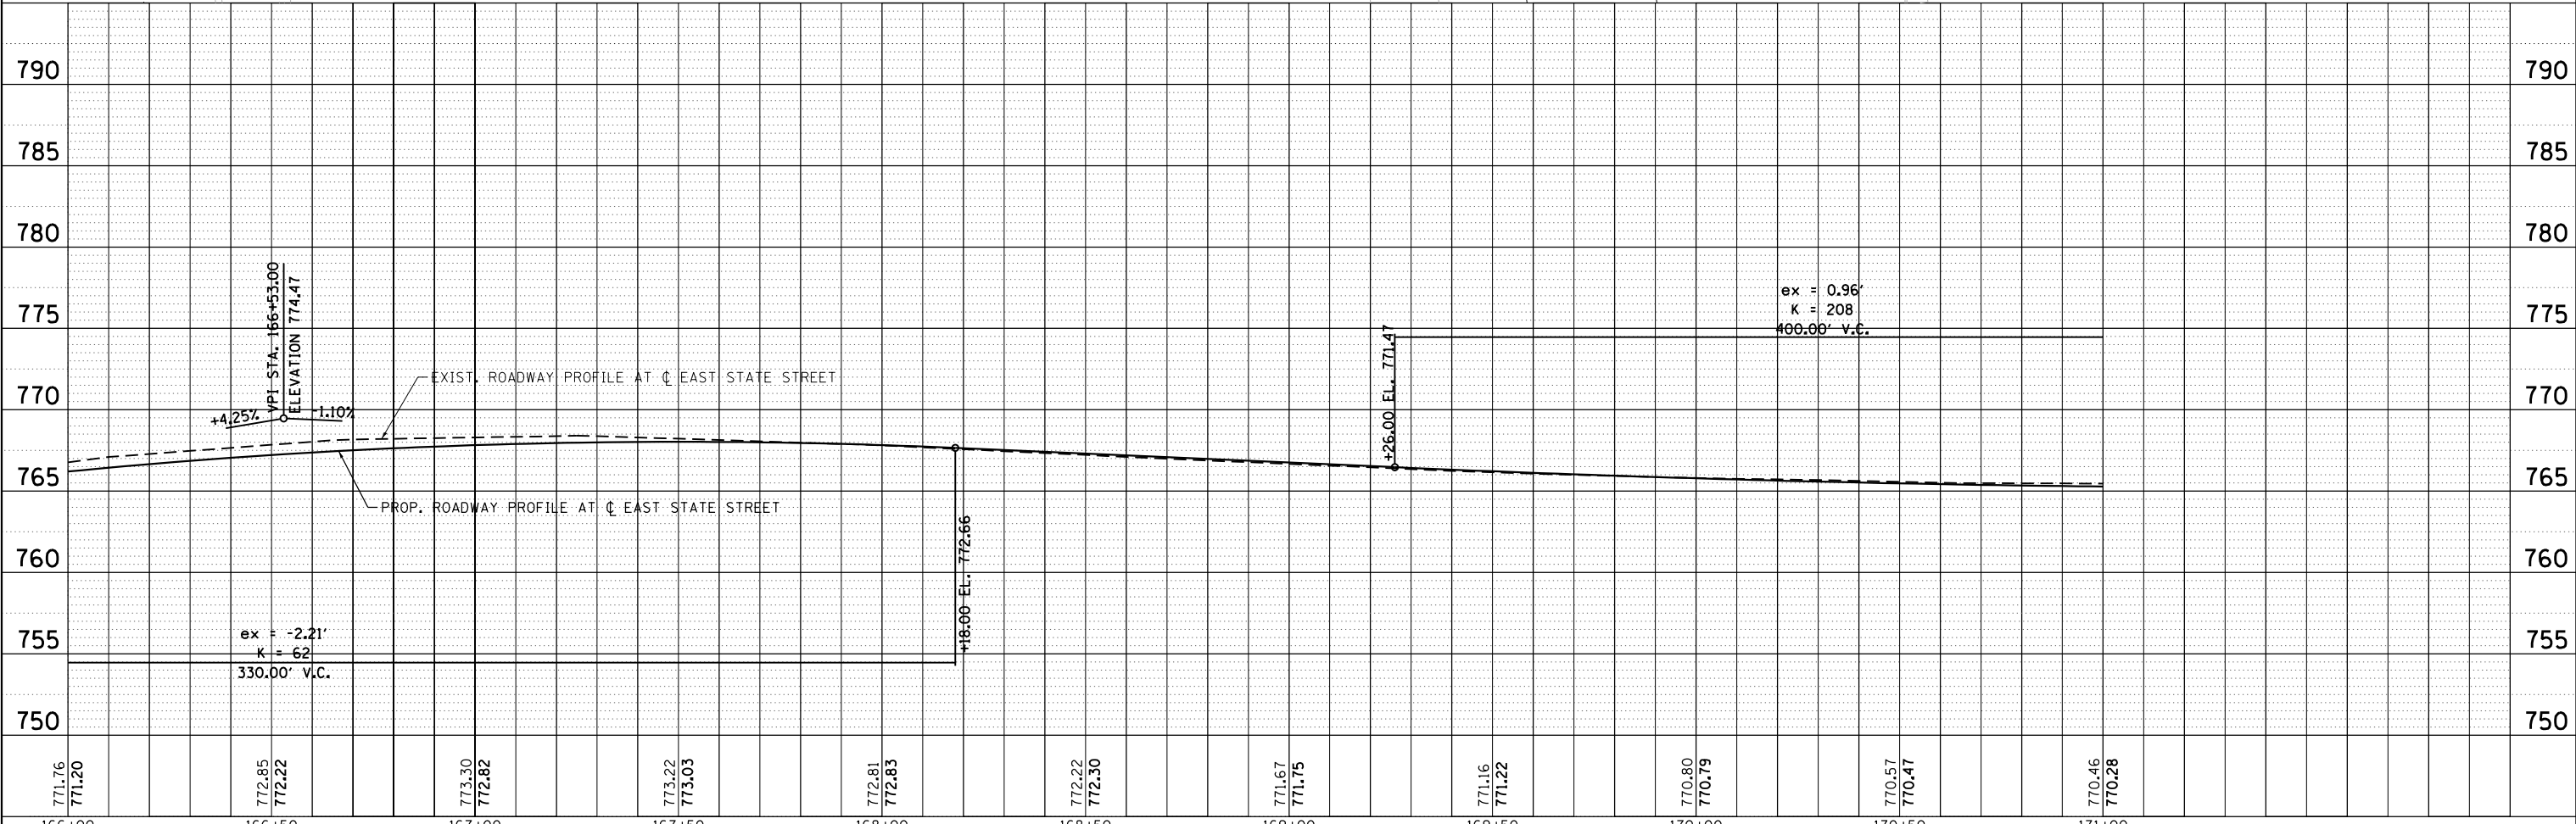


FILE NAME = F:\961-000-Genava East State St\CADD_Sheets\961-000-SHT_PLUPRF_11.dgn

771.76 771.20	772.95 772.22	773.30 772.82	773.22 773.03	772.81 772.83	772.22 772.30	771.67 771.75	771.16 771.22	770.80 770.79	770.57 770.47	770.46 770.28	166+00	166+50	167+00	167+50	168+00	168+50	169+00	169+50	170+00	170+50	171+00	
USER NAME = tnestor		DESIGNED - GJE	REVISED -	STATE OF ILLINOIS DEPARTMENT OF TRANSPORTATION		ILLINOIS ROUTE 38 - EAST STATE STREET PLAN AND PROFILE		F.A.U. RTE. 0347	SECTION 05-00102-00-PV	COUNTY KANE	TOTAL SHEETS 488	SHEET NO. 87	CONTRACT NO. 61J84		SCALE: 1"=20'		SHEET 11 OF 20 SHEETS		STA. 166+00.00 TO STA. 171+00.00		ILLINOIS FED. AID PROJECT	




PLAN	SURVEYED	DATE
	PLOTTED	BY
	GRADES CHECKED	
	ALIGNMENT CHECKED	
	STRUCTURE NOTATIONS CHECKED	
	NO. _____	
	DATE _____	

PROFILE	SURVEYED	DATE
	PLOTTED	BY
	GRADES CHECKED	
	ALIGNMENT CHECKED	
	STRUCTURE NOTATIONS CHECKED	
	NO. _____	
	DATE _____	

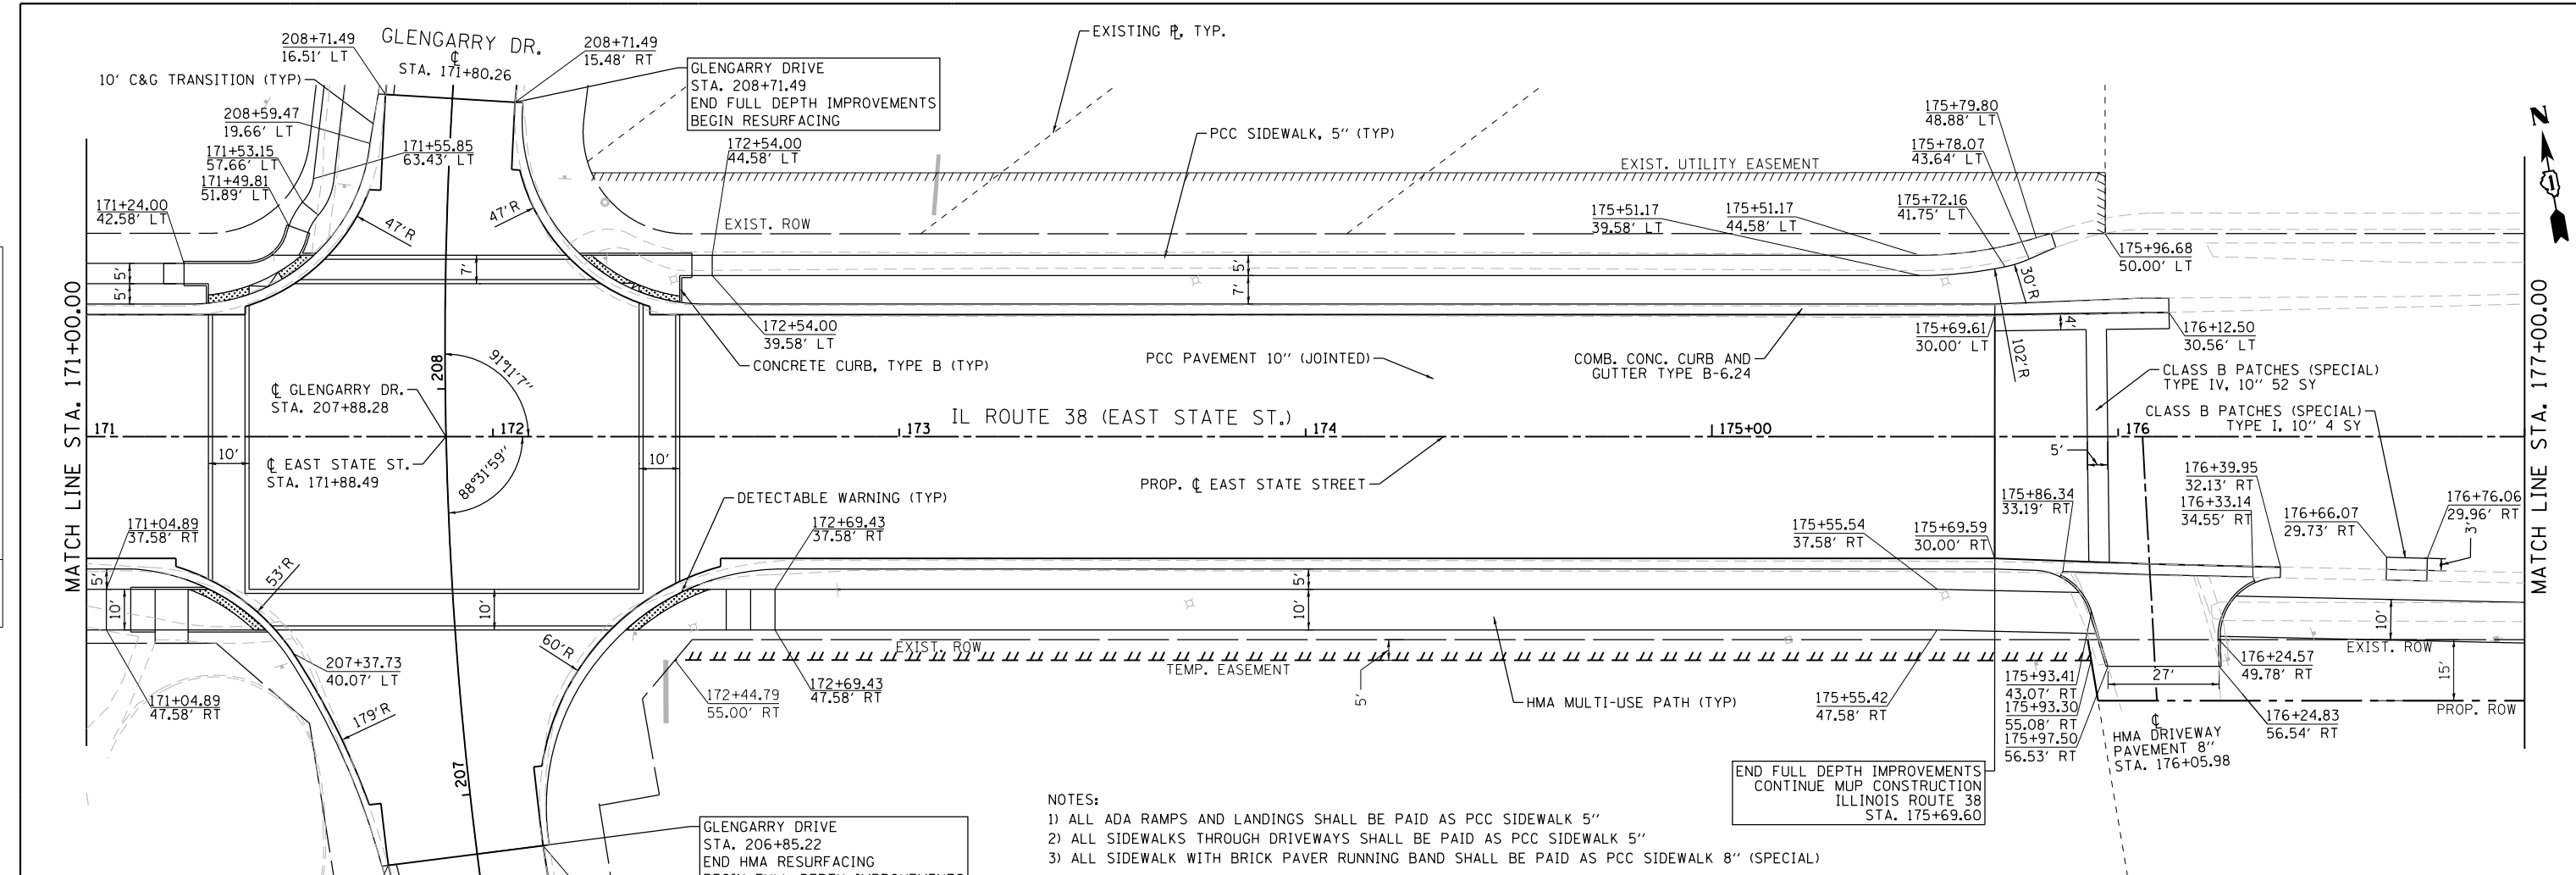

- NOTES:
- 1) ALL ADA RAMPS AND LANDINGS SHALL BE PAID AS PCC SIDEWALK 5"
 - 2) ALL SIDEWALKS THROUGH DRIVEWAYS SHALL BE PAID AS PCC SIDEWALK 5"
 - 3) ALL SIDEWALK WITH BRICK PAVER RUNNING BAND SHALL BE PAID AS PCC SIDEWALK 8" (SPECIAL)

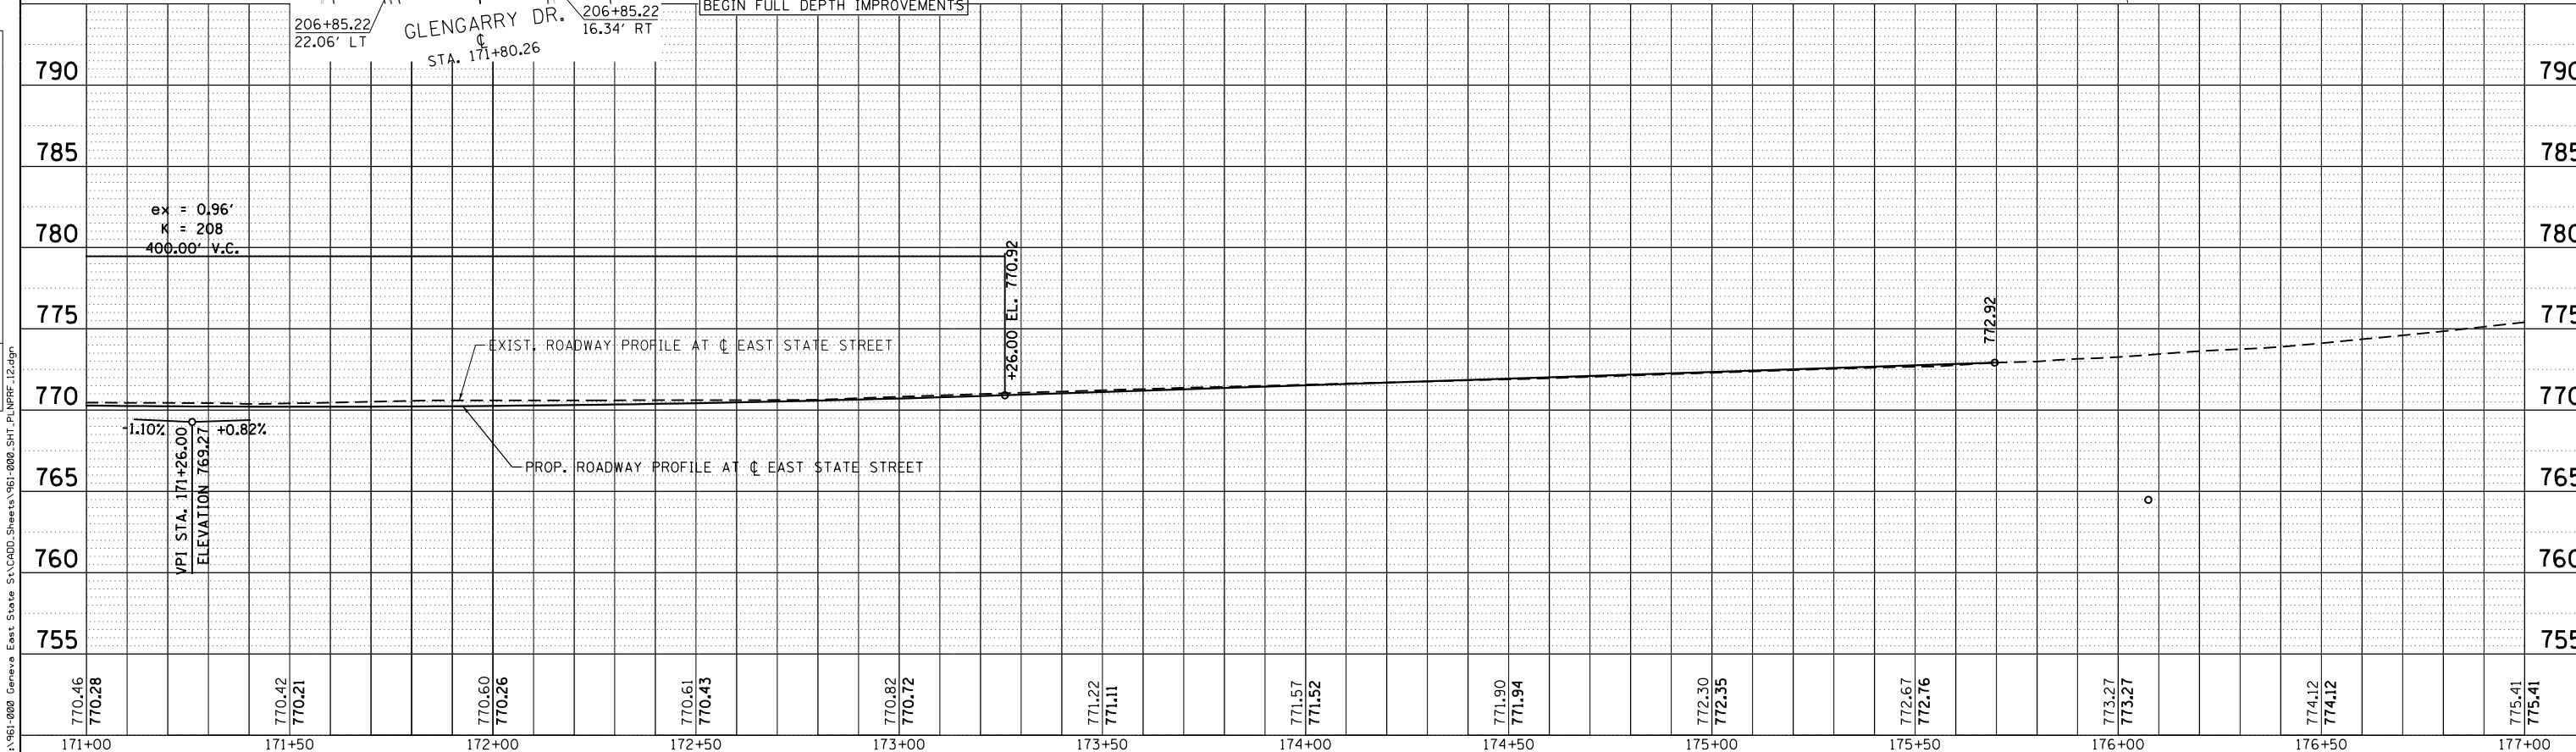

770.46 770.28	770.42 770.21	770.60 770.26	770.61 770.43	770.82 770.72	771.22 771.11	771.57 771.52	771.90 771.94	772.30 772.35	772.67 772.76	773.27 773.27	774.12 774.12	775.41 775.41
171+00	171+50	172+00	172+50	173+00	173+50	174+00	174+50	175+00	175+50	176+00	176+50	177+00



USER NAME = tnestor	DESIGNED - GJE	REVISED -
PLOT SCALE = 48.0000' / in.	DRAWN - GJE	REVISED -
PLOT DATE = 1/13/2025	CHECKED - DBB	REVISED -
	DATE - 11/7/2024	REVISED -


STATE OF ILLINOIS
DEPARTMENT OF TRANSPORTATION

ILLINOIS ROUTE 38 - EAST STATE STREET	
PLAN AND PROFILE	
SCALE: 1"=20'	SHEET 12 OF 20 SHEETS STA. 171+00.00 TO STA. 177+00.00


F.A.U. RT.E.	SECTION	COUNTY	TOTAL SHEETS	SHEET NO.
0347	05-00102-00-PV	KANE	488	88
CONTRACT NO. 61J84				
ILLINOIS FED. AID PROJECT				

PLAN	SURVEYED	DATE
	PLOTTED	
	ALIGNED	
	CHECKED	
	FILED	
	NO.	

PROFILE	SURVEYED	DATE
	PLOTTED	
	GRADES	
	CHECKED	
	STRUCTURE	
	NOTATIONS	
	CHKD	
	NO.	

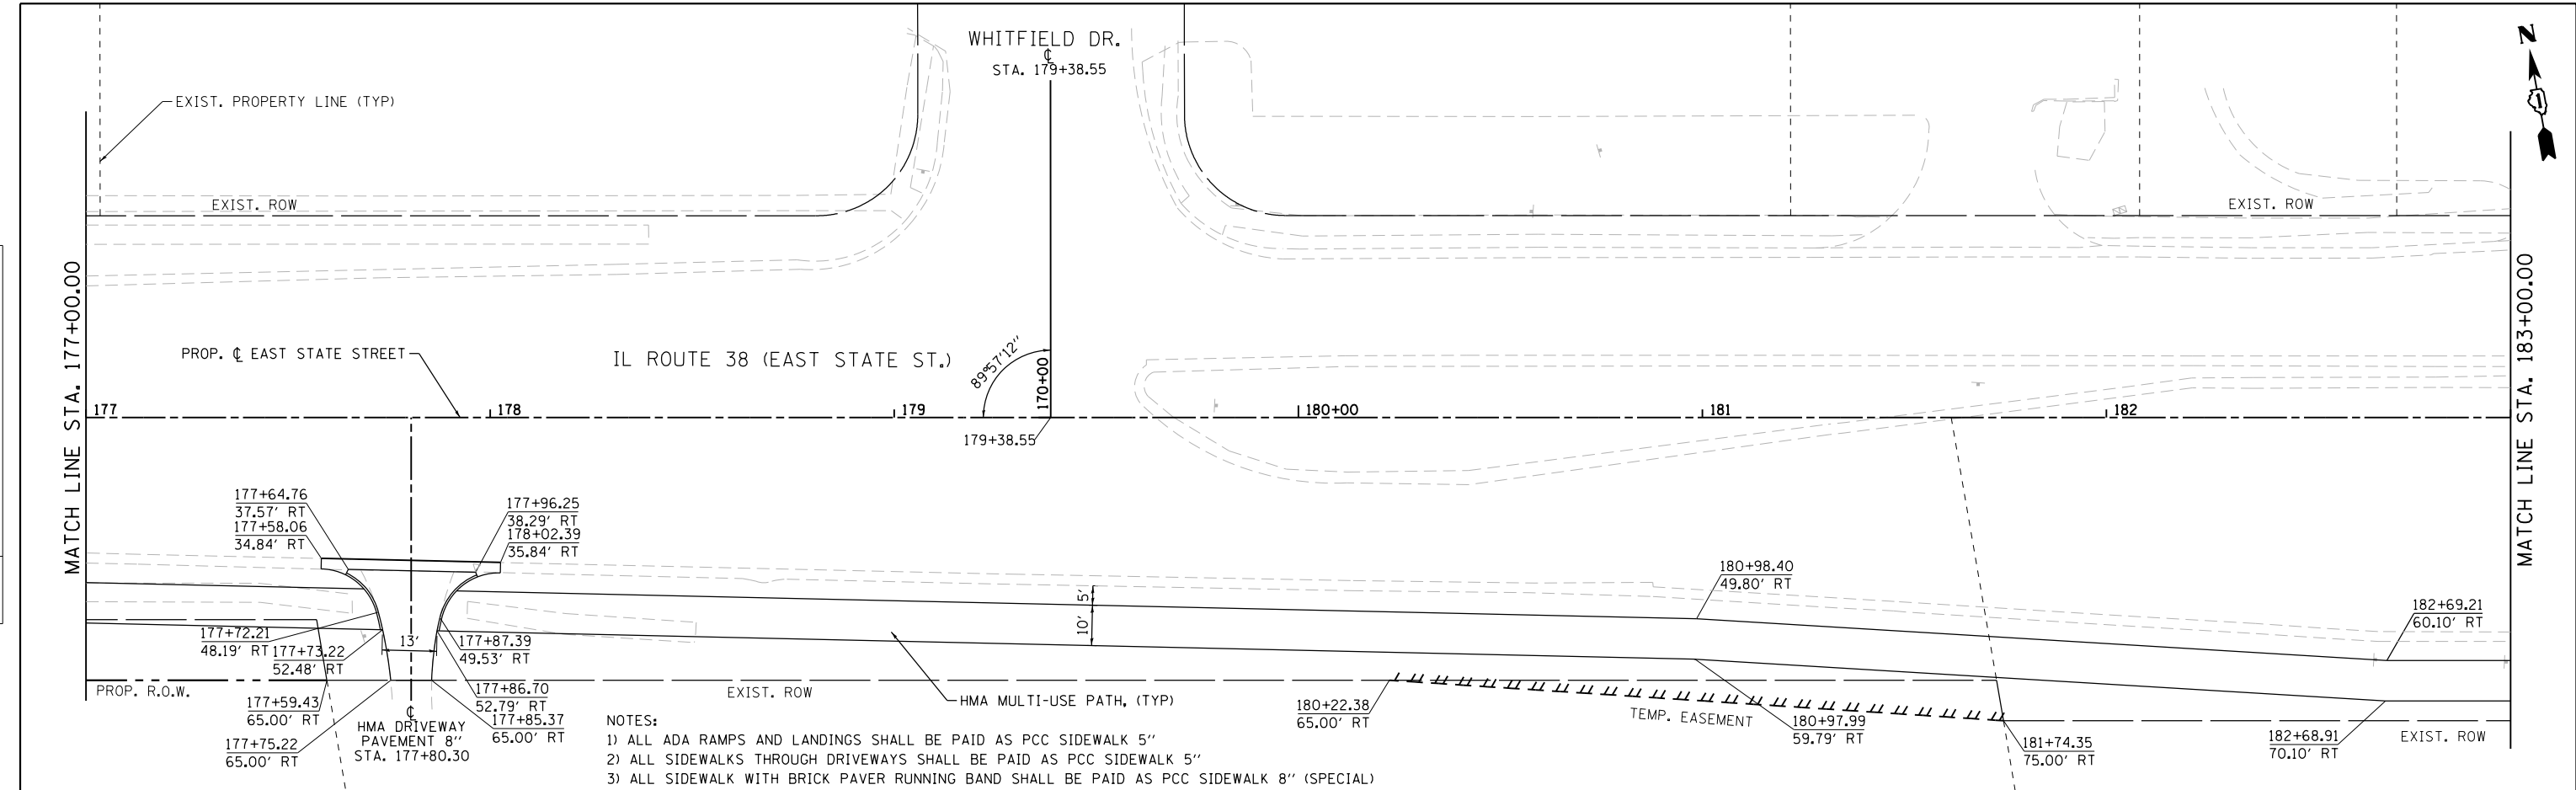

- NOTES:
- 1) ALL ADA RAMPS AND LANDINGS SHALL BE PAID AS PCC SIDEWALK 5"
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 - 3) ALL SIDEWALK WITH BRICK PAVER RUNNING BAND SHALL BE PAID AS PCC SIDEWALK 8" (SPECIAL)

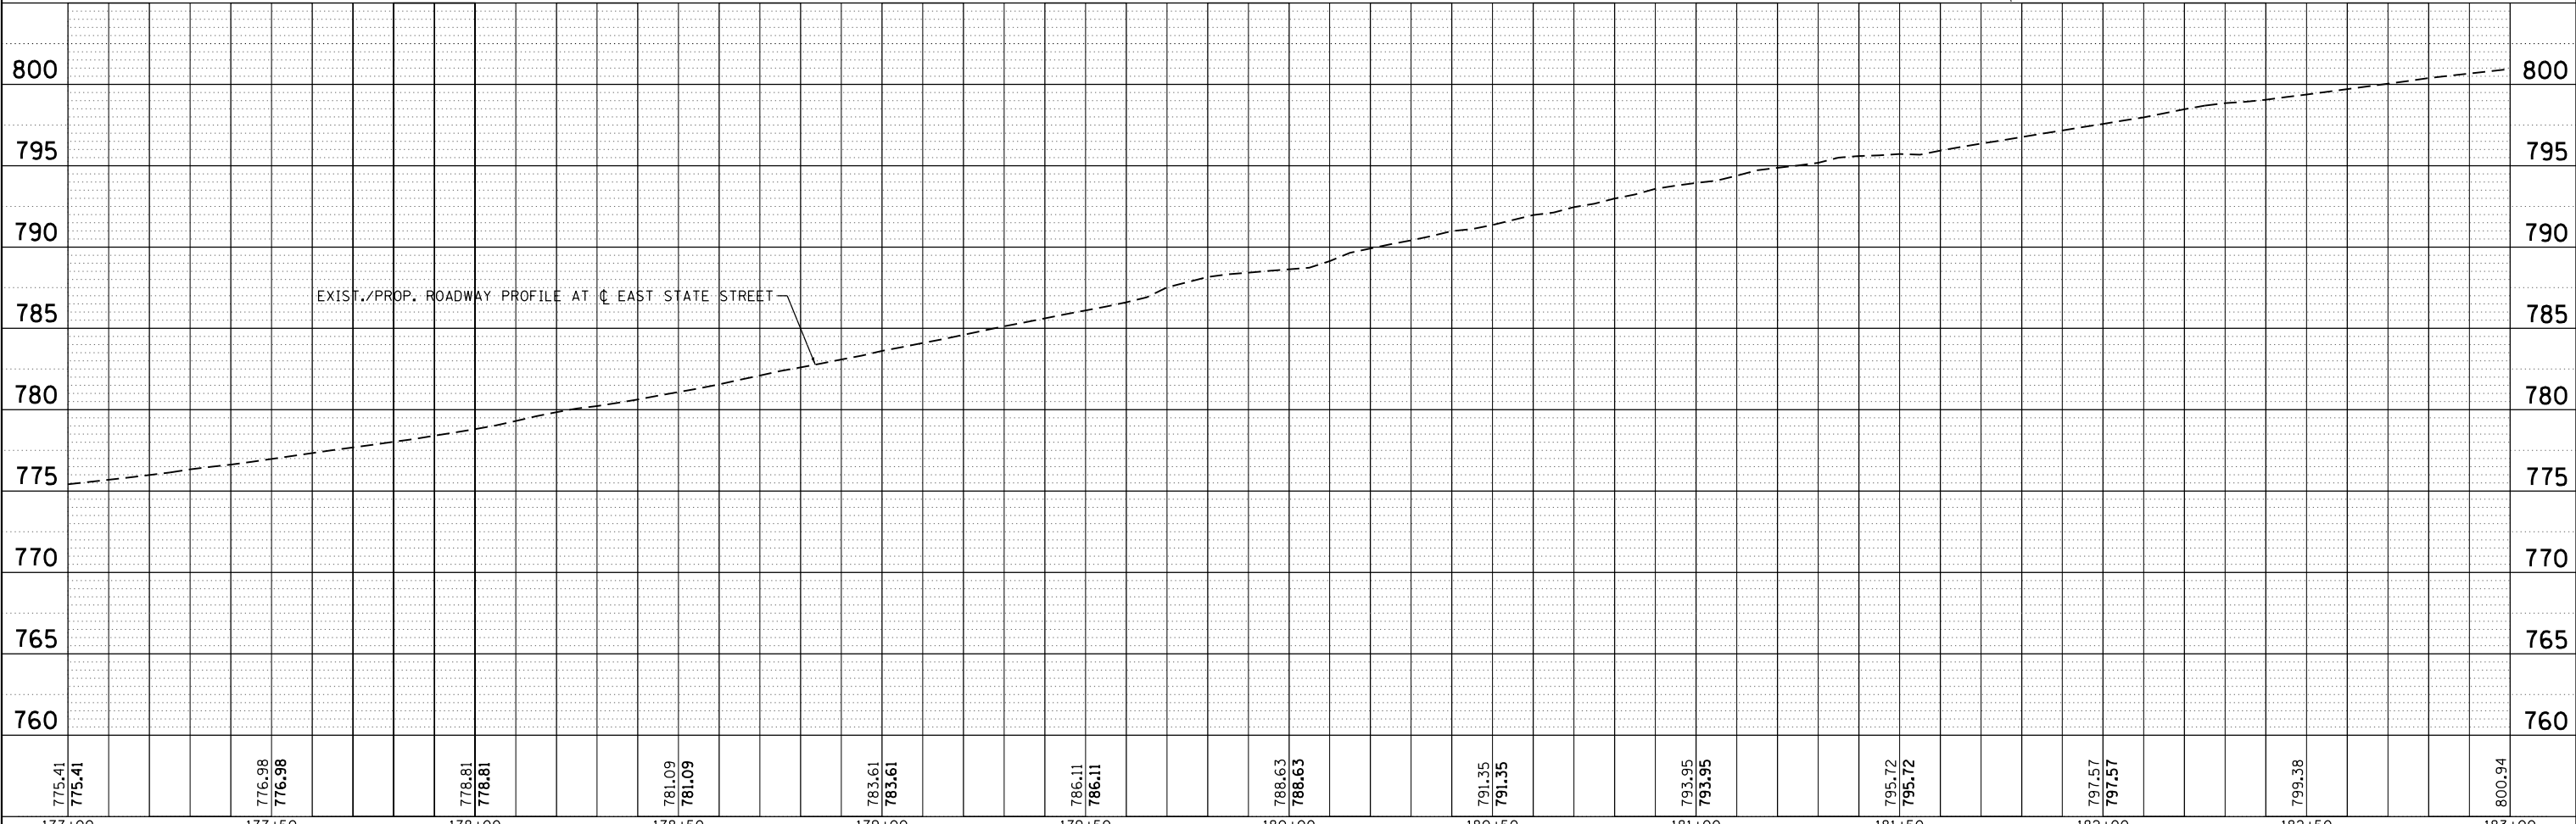

FILE NAME = F:\961-000-Genesys East State St\CADD_Sheets\961-000-SHT_PLNPRF\13.dgn

775.41 775.41	776.98 776.98	778.81 778.81	781.09 781.09	783.61 783.61	786.11 786.11	788.63 788.63	791.35 791.35	793.95 793.95	795.72 795.72	797.57 797.57	799.38	800.94
177+00	177+50	178+00	178+50	179+00	179+50	180+00	180+50	181+00	181+50	182+00	182+50	183+00



USER NAME = tnestor	DESIGNED - GJE	REVISED -
	DRAWN - GJE	REVISED -
PLOT SCALE = 48.0000' / in.	CHECKED - DBB	REVISED -
PLOT DATE = 1/13/2025	DATE - 11/7/2024	REVISED -

STATE OF ILLINOIS
DEPARTMENT OF TRANSPORTATION


ILLINOIS ROUTE 38 - EAST STATE STREET
PLAN AND PROFILE
SCALE: 1"=20'
SHEET 13 OF 20 SHEETS STA. 177+00.00 TO STA. 183+00.00

F.A.U. RTE.	SECTION	COUNTY	TOTAL SHEETS	SHEET NO.
0347	05-00102-00-PV	KANE	488	89
CONTRACT NO. 61J84				
ILLINOIS FED. AID PROJECT				




PLAN	SURVEYED	BY	DATE
	PLOTTED		
	NOTE BOOK		
	NO.		
	ALIGNED		
	CHECKED		
	FILE NAME		

PROFILE	SURVEYED	BY	DATE
	PLOTTED		
	GRADES CHECKED		
	NO.		
	STRUCTURE		
	NOTATIONS		

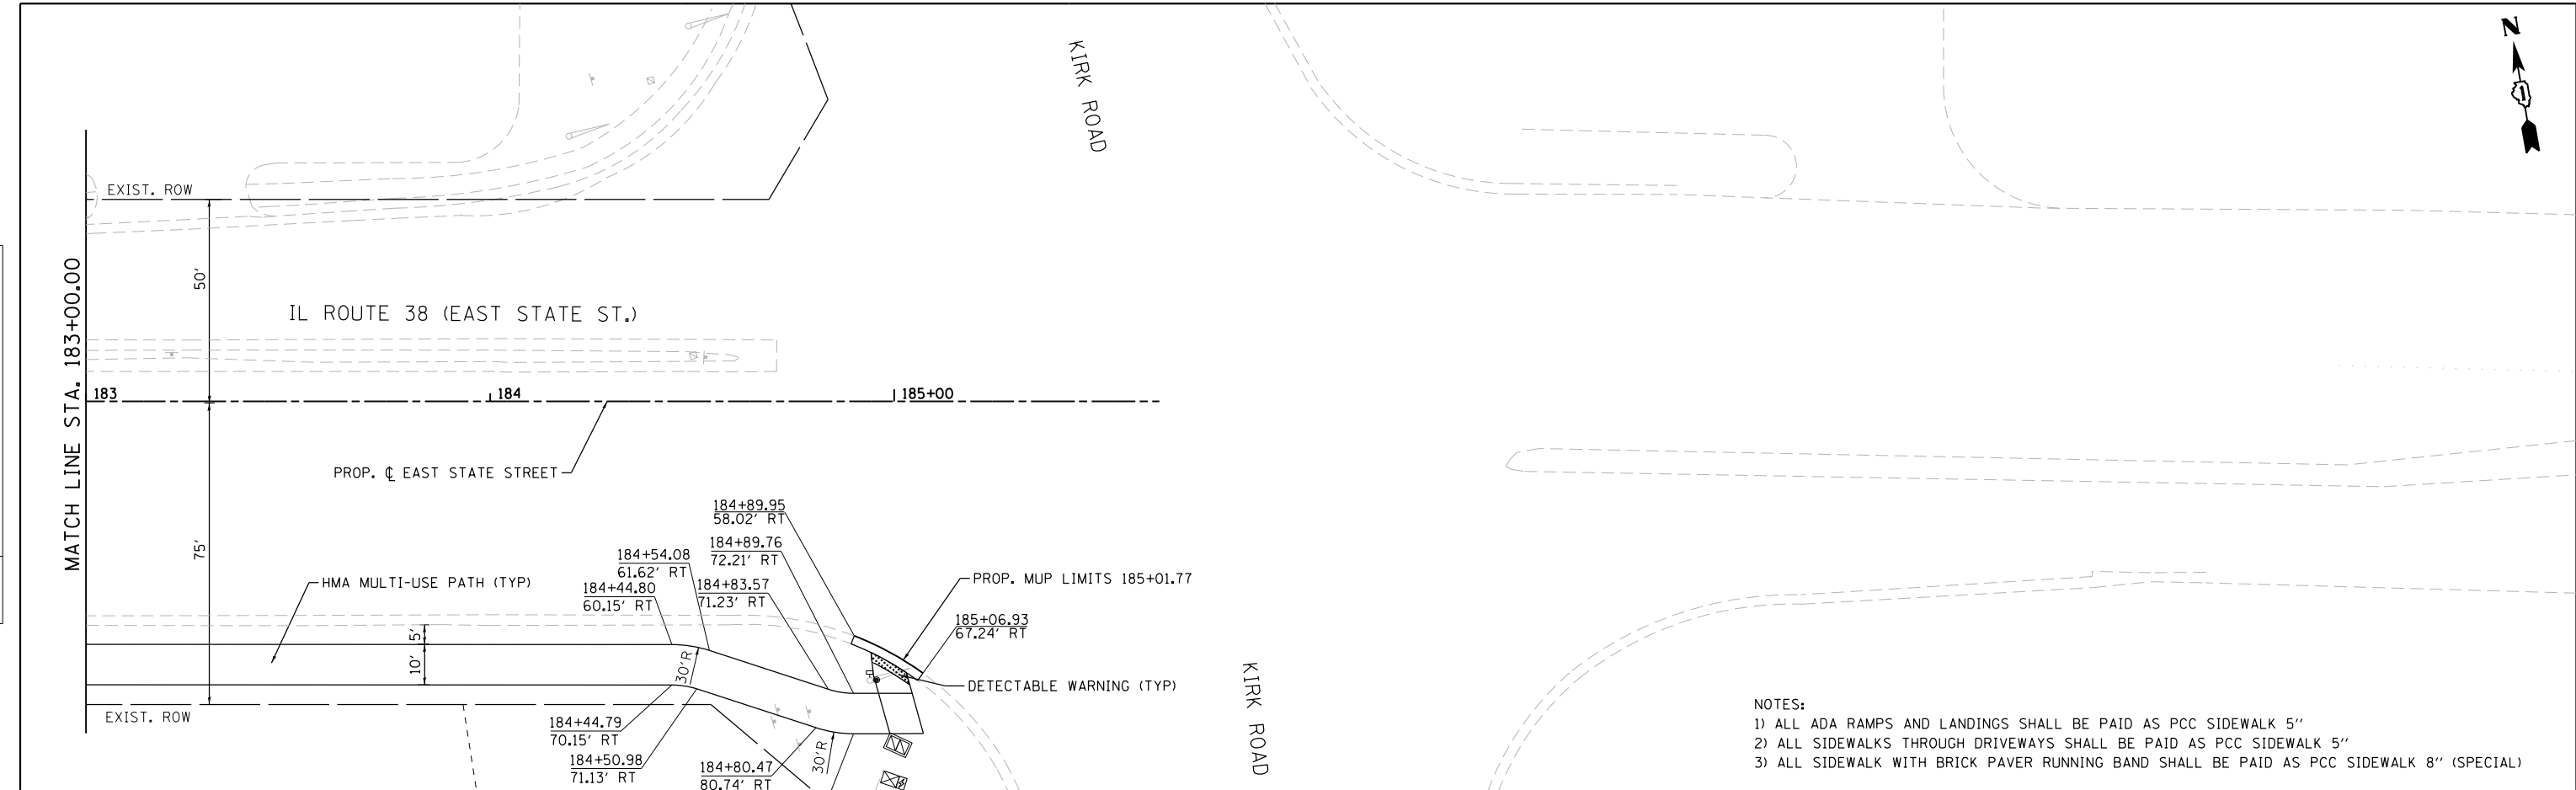

- NOTES:
- 1) ALL ADA RAMPS AND LANDINGS SHALL BE PAID AS PCC SIDEWALK 5"
 - 2) ALL SIDEWALKS THROUGH DRIVEWAYS SHALL BE PAID AS PCC SIDEWALK 5"
 - 3) ALL SIDEWALK WITH BRICK PAVER RUNNING BAND SHALL BE PAID AS PCC SIDEWALK 8" (SPECIAL)

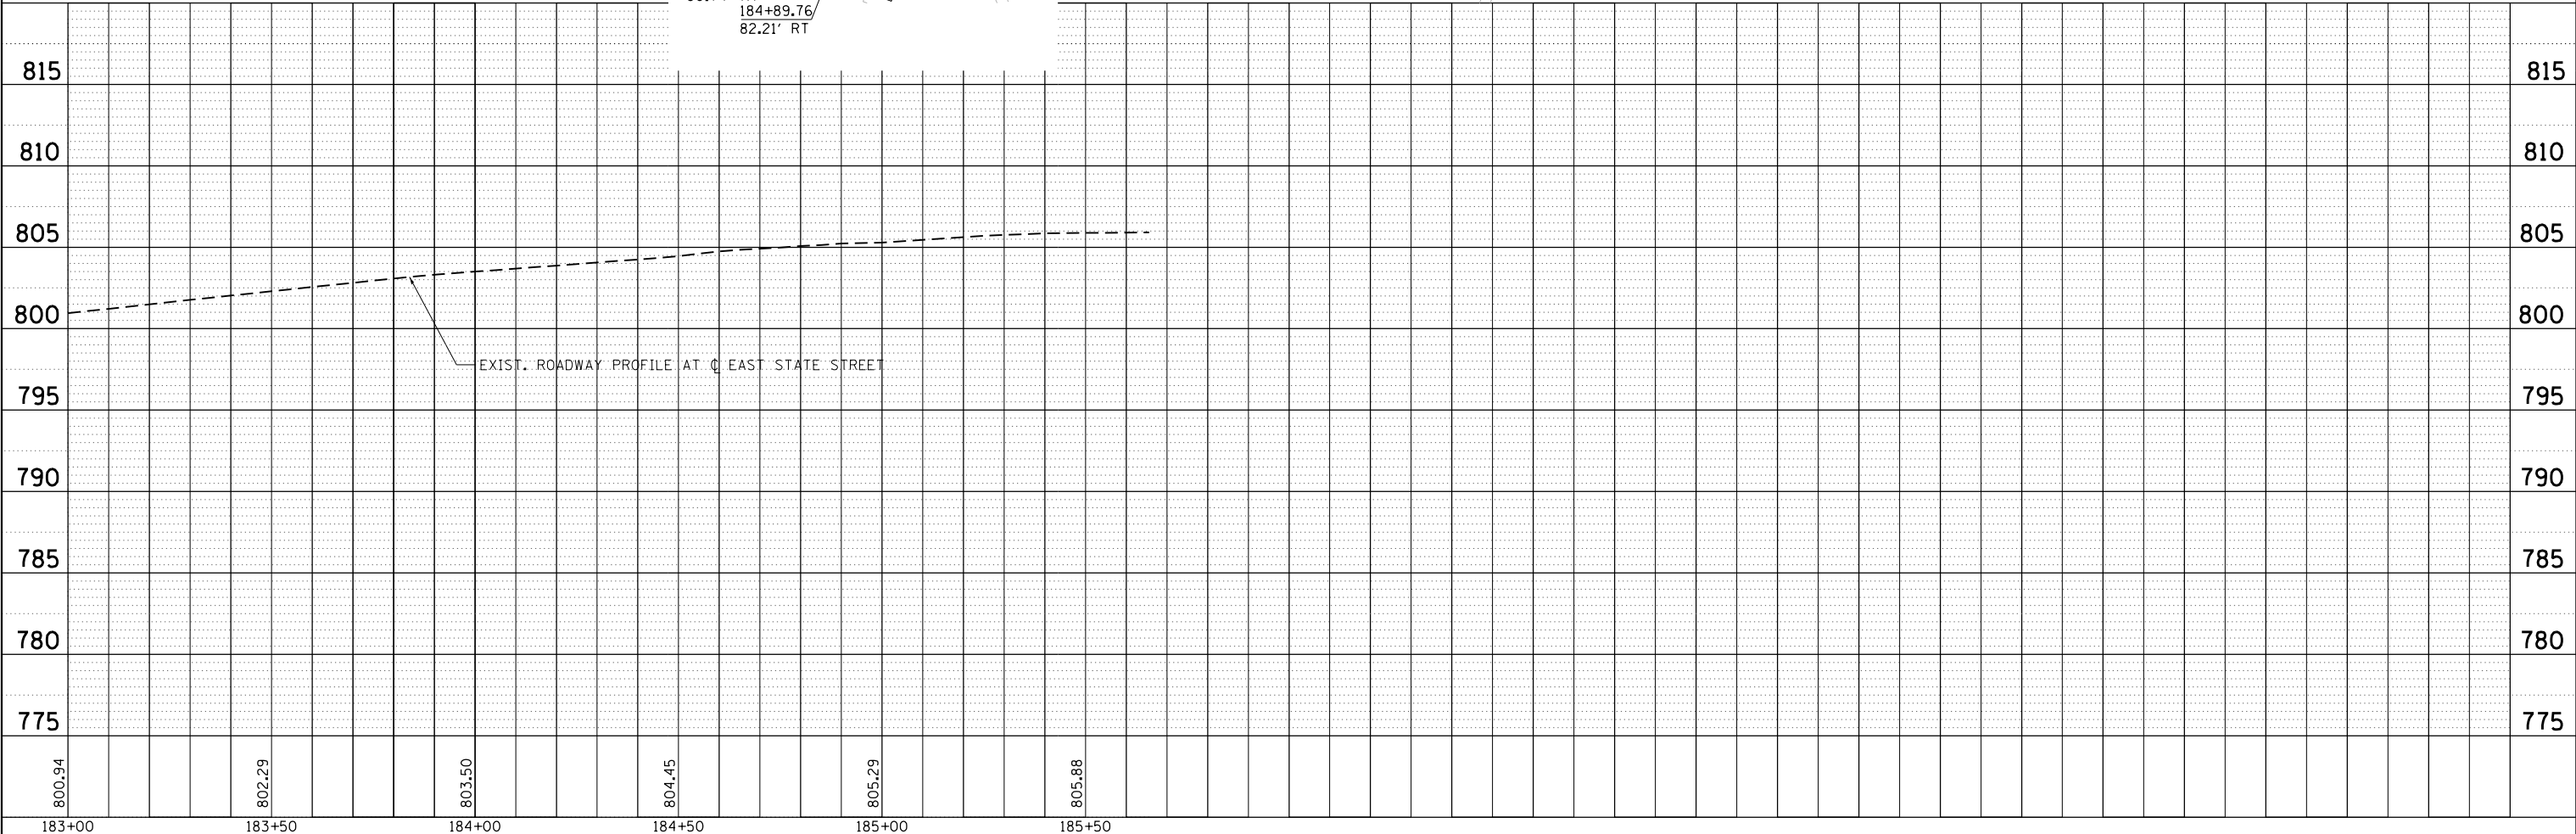

FILE NAME = F:\961-000-Genesys East State St\CADD_Sheets\961-000-SHT_PLNPRF-14.dgn

DESIGNED - GJE	REVISIONS
DRAWN - GJE	REVISIONS
CHECKED - DBB	REVISIONS
DATE - 11/7/2024	REVISIONS

**STATE OF ILLINOIS
DEPARTMENT OF TRANSPORTATION**

**ILLINOIS ROUTE 38 - EAST STATE STREET
PLAN AND PROFILE**


SCALE: 1"=20' SHEET 14 OF 20 SHEETS STA. 183+00.00 TO STA. 186+00.00

F.A.U. RTE.	SECTION	COUNTY	TOTAL SHEETS	SHEET NO.
0347	05-00102-00-PV	KANE	488	90
CONTRACT NO. 61J84				
ILLINOIS FED. AID PROJECT				




PLAN	SURVEYED	BY	DATE
	PLOTTED		
	NOTE BOOK		
	NO.		
	CHECKED		
	FILE NAME		

PROFILE	SURVEYED	BY	DATE
	PLOTTED		
	GRADES		
	NO.		
	CHECKED		
	NOTATIONS		
	CHPND		

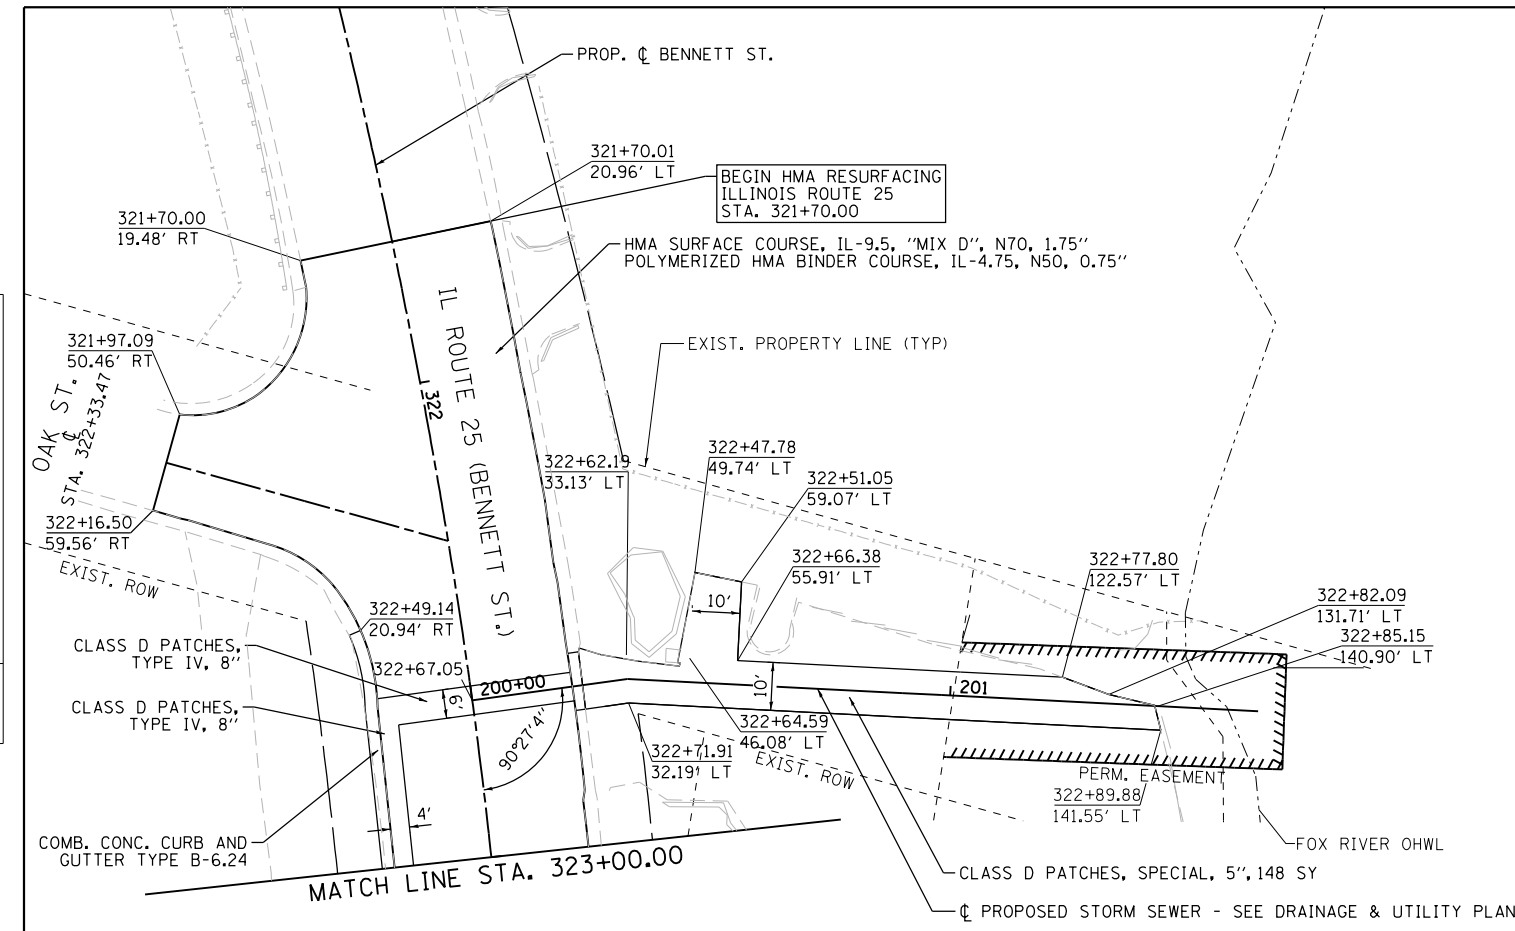

- NOTES:
- 1) ALL ADA RAMP AND LANDINGS SHALL BE PAID AS PCC SIDEWALK 5"
 - 2) ALL SIDEWALKS THROUGH DRIVEWAYS SHALL BE PAID AS PCC SIDEWALK 5"
 - 3) ALL SIDEWALK WITH BRICK PAVER RUNNING BAND SHALL BE PAID AS PCC SIDEWALK 8" (SPECIAL)

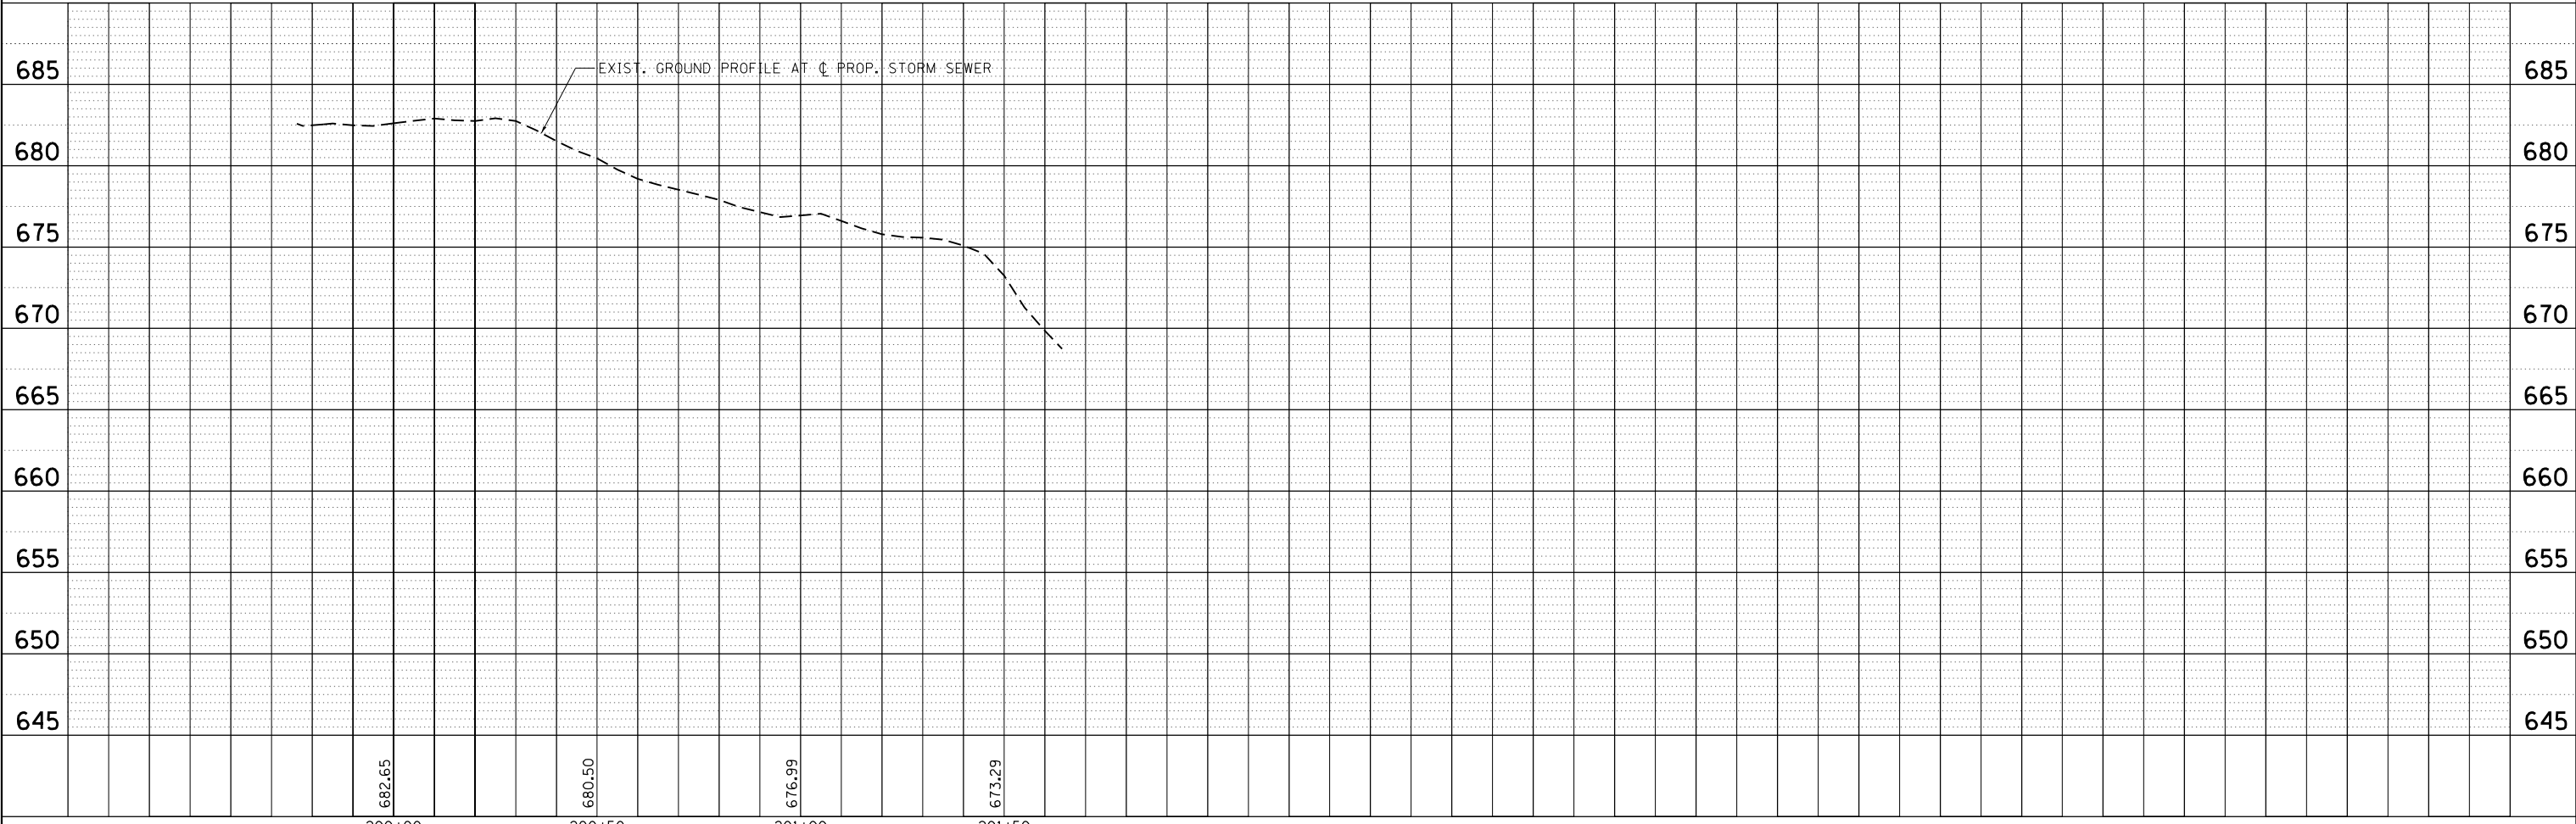


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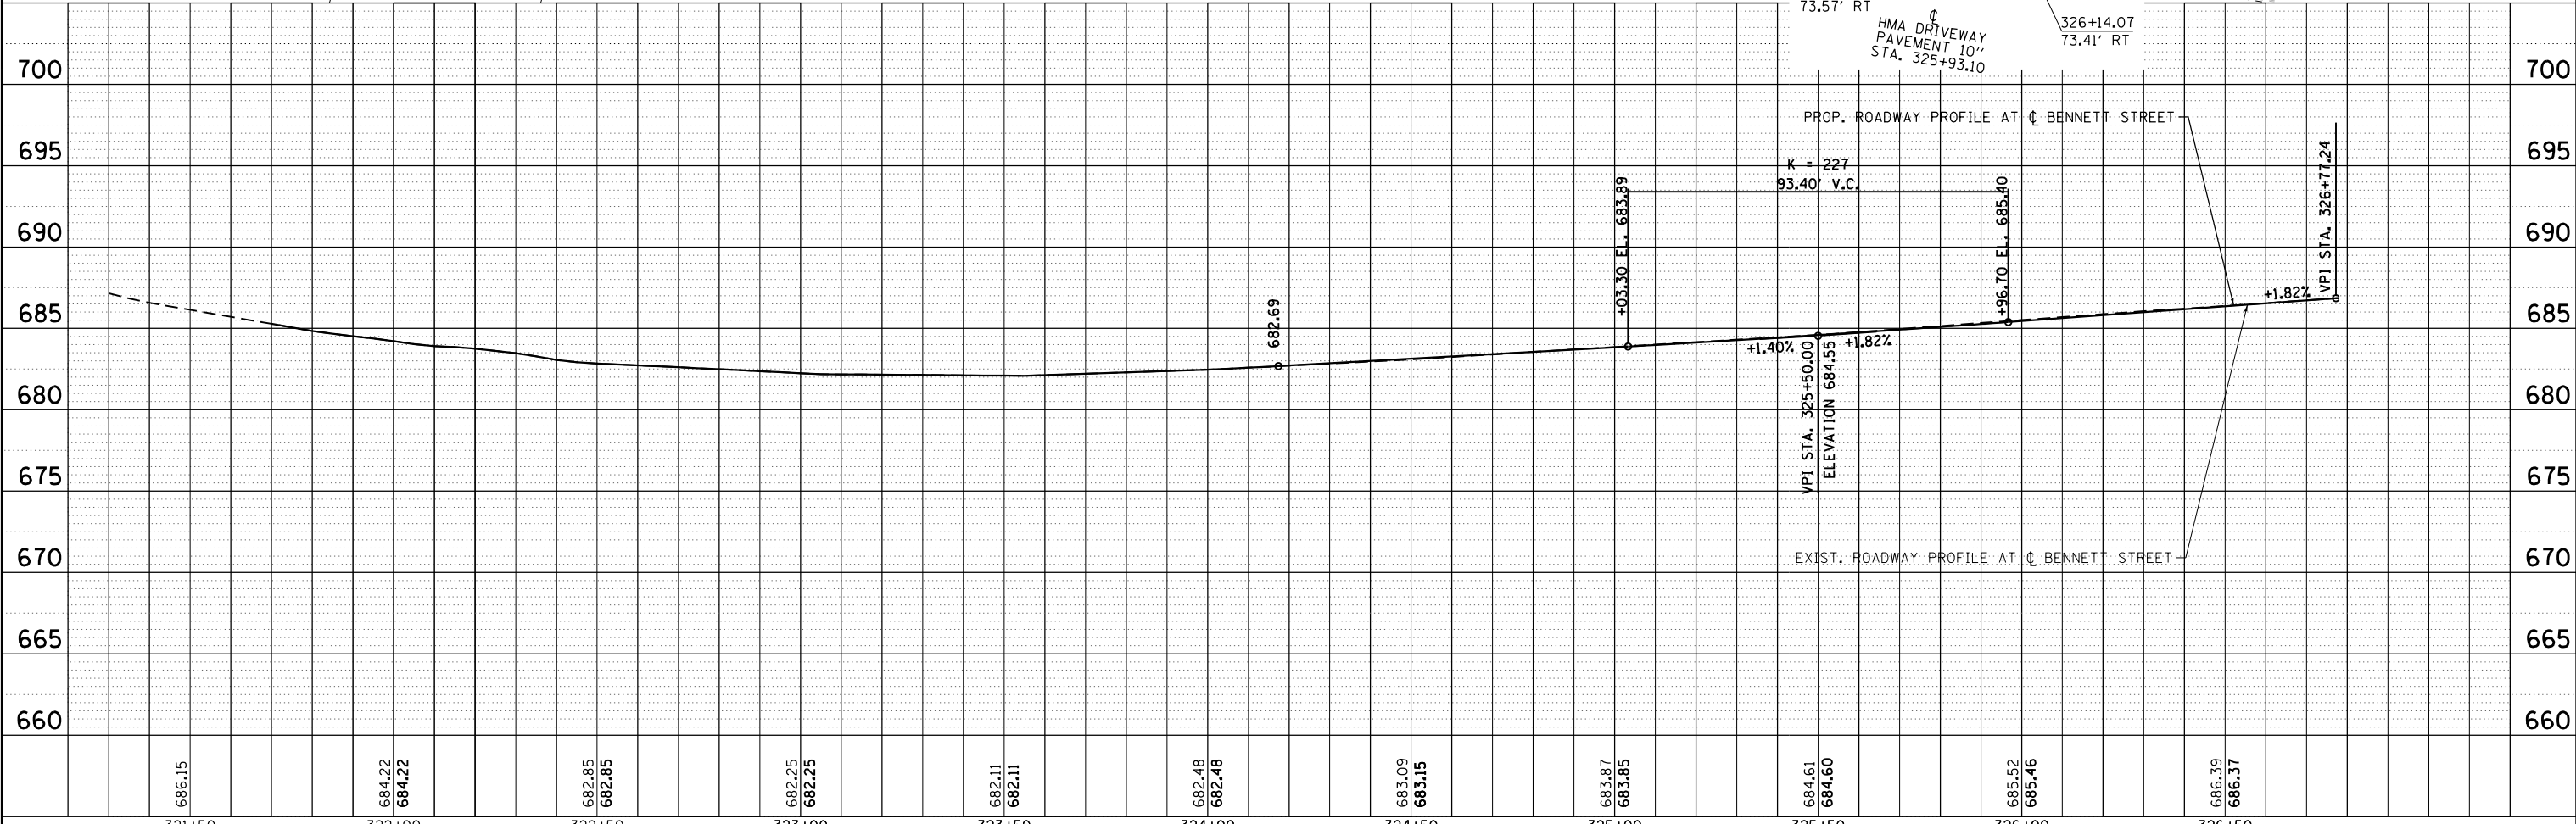
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	PLOT SCALE = 48.0000' / in.	CHECKED - DBB	REVISED -			CONTRACT NO. 61J84				
PLOT DATE = 1/13/2025	DATE - 11/7/2024	REVISED -	ILLINOIS FED. AID PROJECT							

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GRADES	
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STRUCTURE	
NOT AT THIS OFFICE	



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PLOT DATE = 1/13/2025	DATE - 11/7/2024	REVISED -

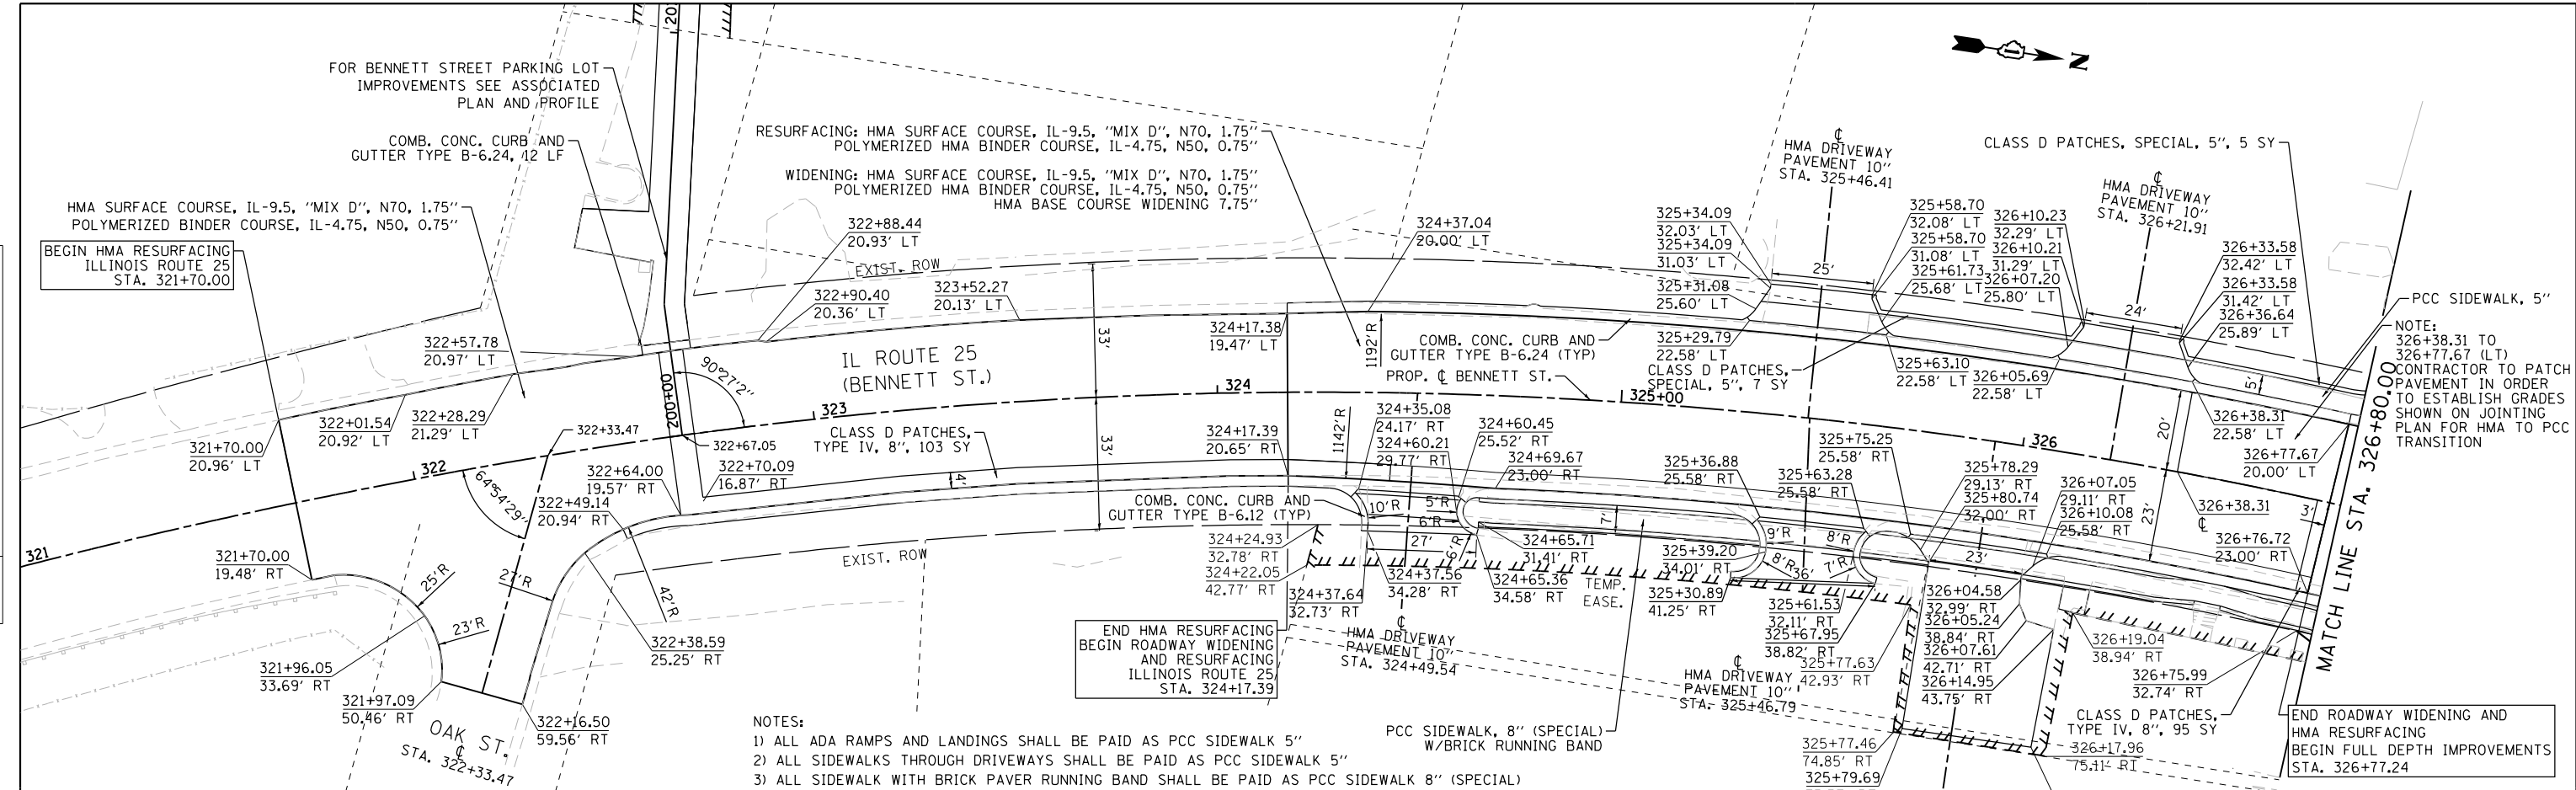STATE OF ILLINOIS
DEPARTMENT OF TRANSPORTATION


ILLINOIS ROUTE 25 - BENNETT STREET
PLAN AND PROFILE

SCALE: 1"=20' SHEET 16 OF 20 SHEETS STA. 323+00.00 TO STA. 326+80.00


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CONTRACT NO. 61J84				ILLINOIS FED. AID PROJECT

PLAN	SURVEYED	DATE
	PLOTTED	
	GRADES CHECKED	
	STRUCTURE NOTATIONS CHECKED	
	NOTE BOOK NO.	
	FILE NAME	

PROFILE	SURVEYED	DATE
	PLOTTED	
	GRADES CHECKED	
	STRUCTURE NOTATIONS CHECKED	
	NOTE BOOK NO.	
	FILE NAME	

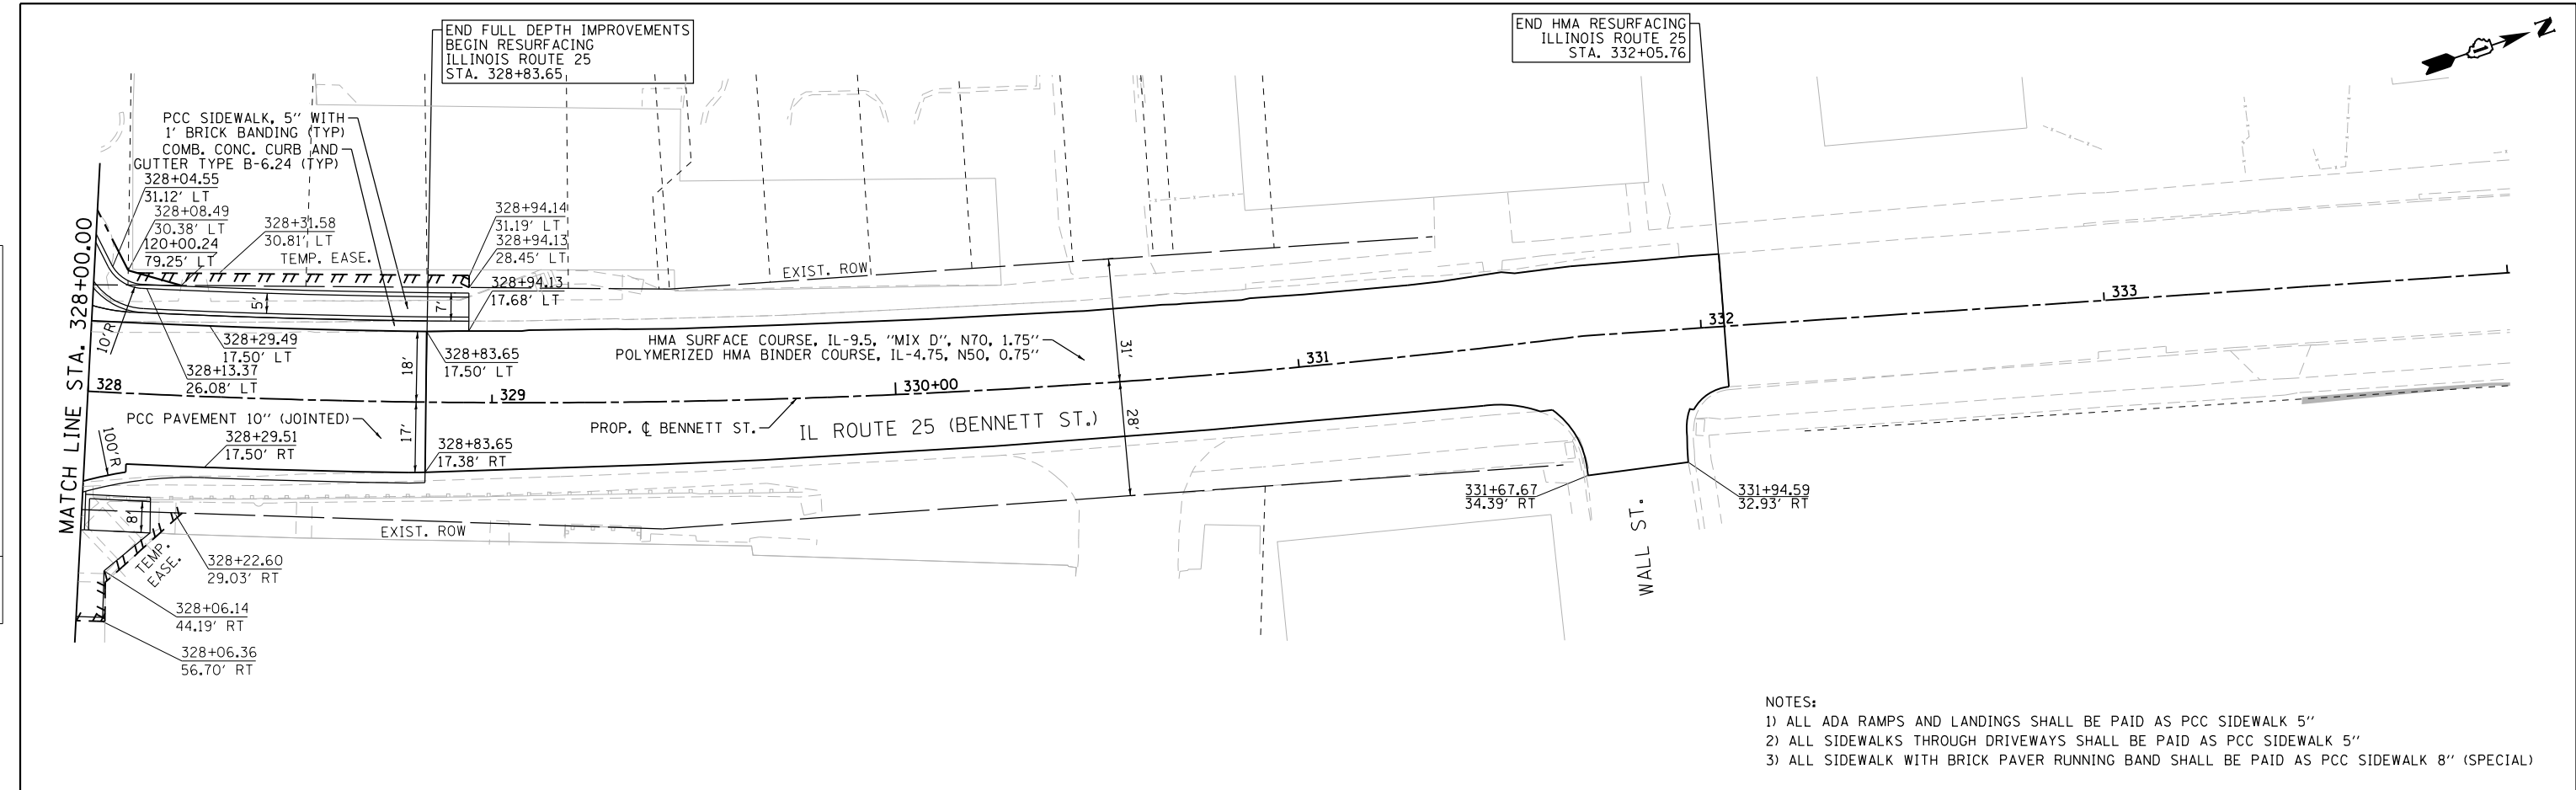

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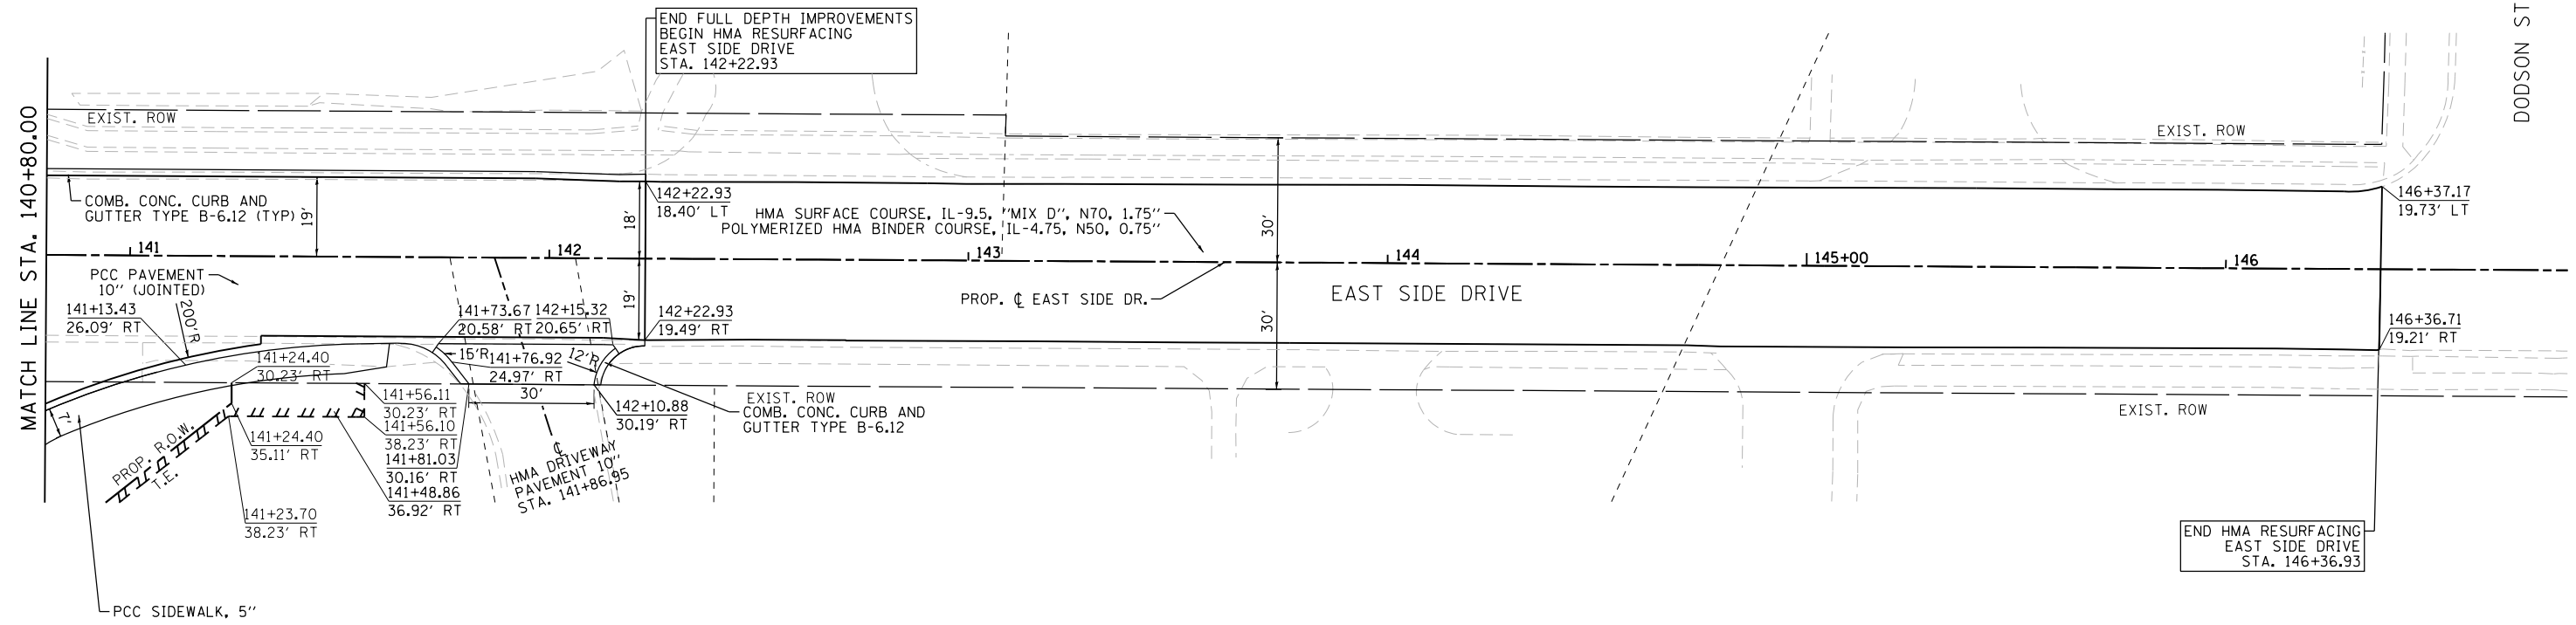
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	PLOT SCALE = 48.0000' / in.	CHECKED - DBB	REVISED -			SCALE: 1"=20'	SHEET 17 OF 20 SHEETS	STA. 328+00.00 TO STA. 334+00.00	CONTRACT NO. 61J84	
	PLOT DATE = 1/13/2025	DATE = 11/7/2024	REVISED -							

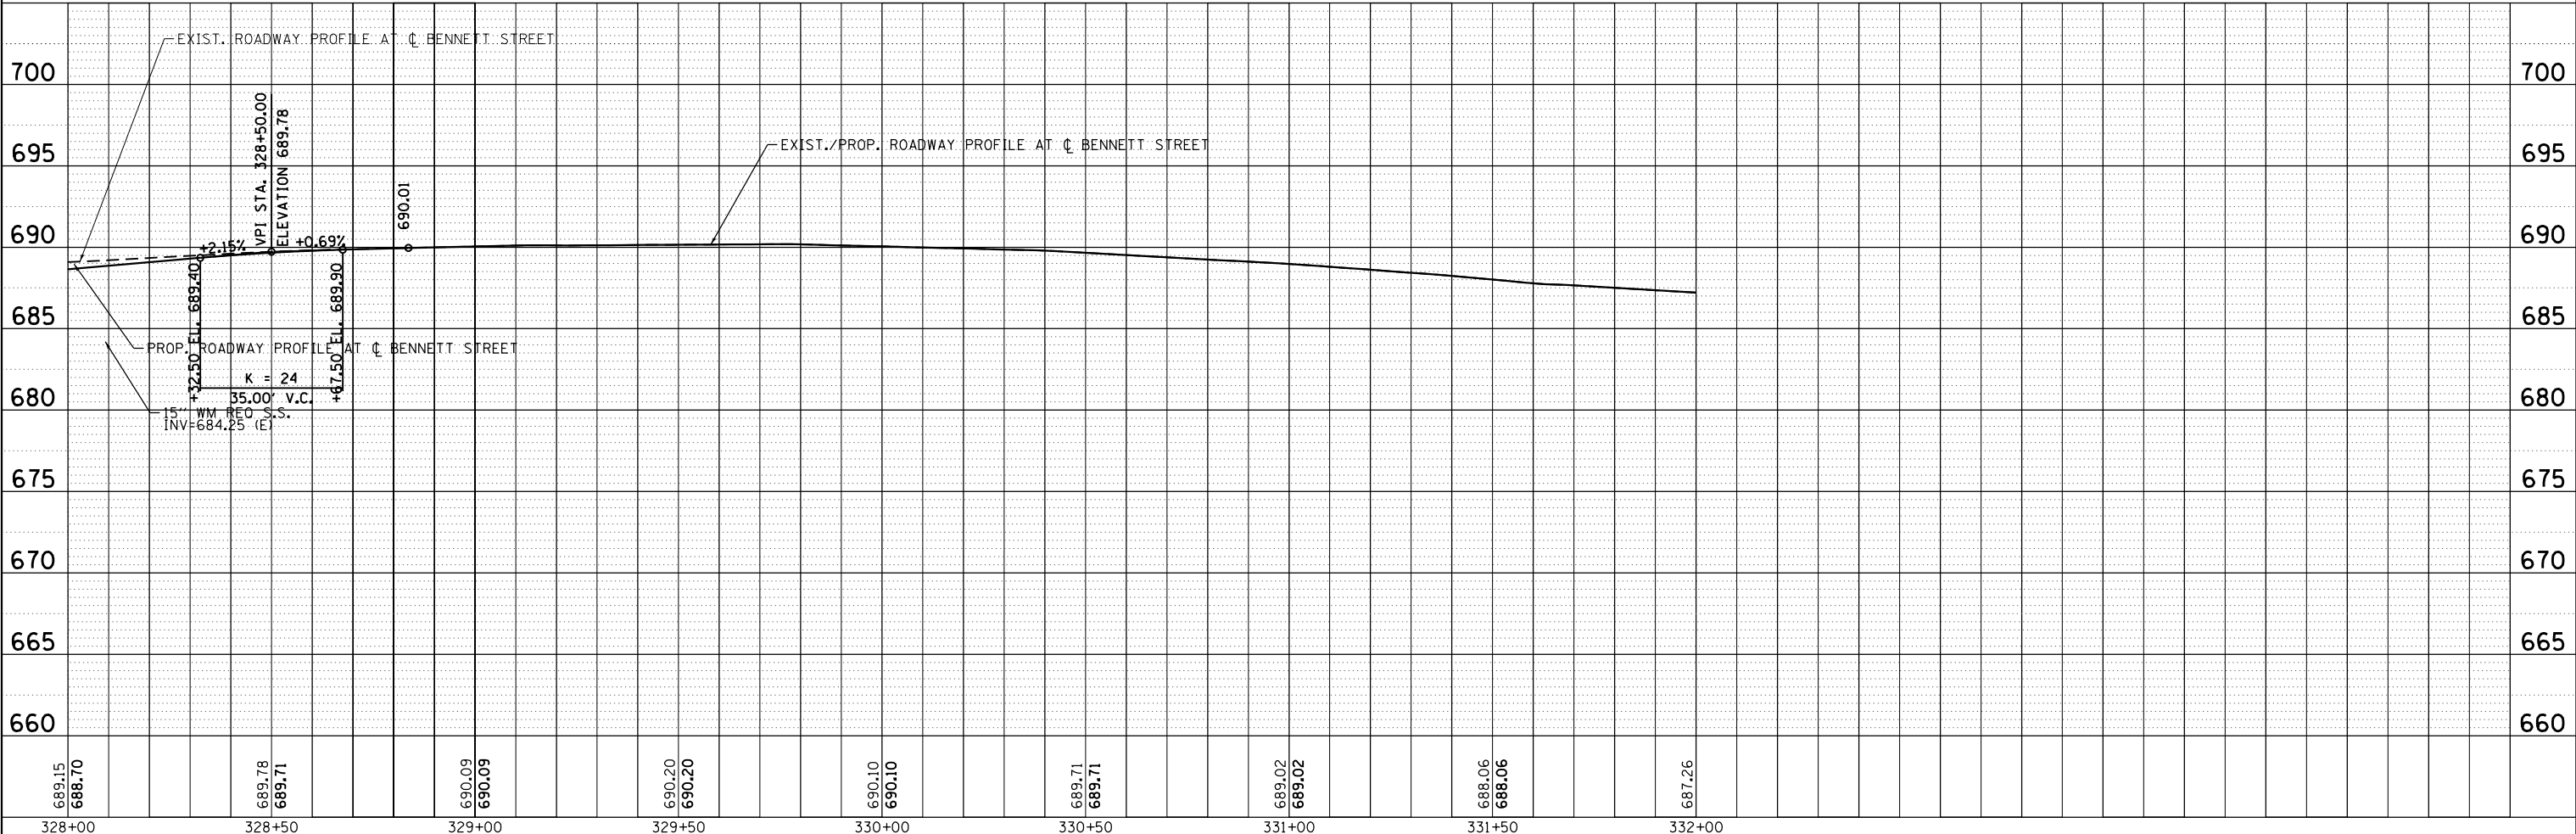
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141+00	141+50	142+00	142+50	143+00	143+50	144+00	144+50	145+00	145+50	146+00	146+50
750.72 750.48	750.46 750.38	750.29 750.28	750.48 750.48	750.84 750.84	751.23 751.23	751.62 751.62	751.98 751.98	752.28 752.28	752.54 752.54	752.78 752.78	753.04



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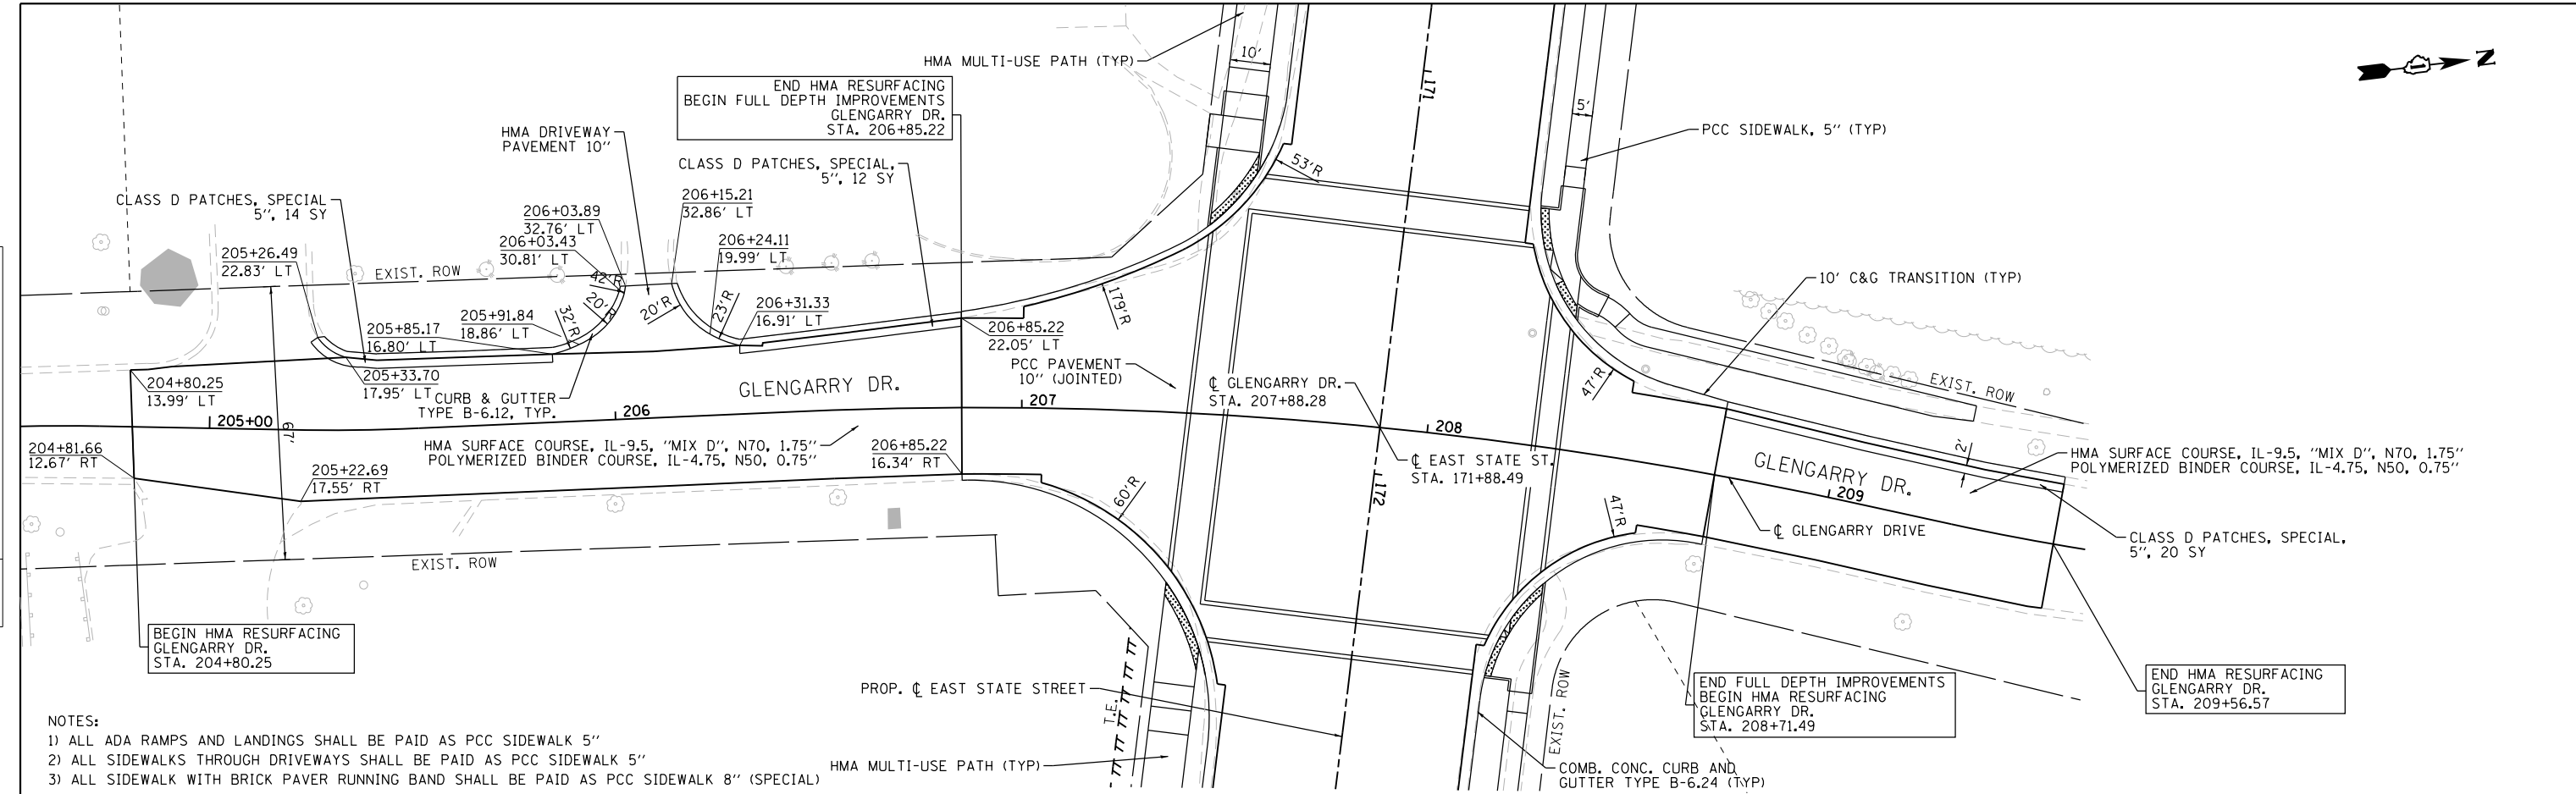
STATE OF ILLINOIS
DEPARTMENT OF TRANSPORTATION

EAST SIDE DRIVE PLAN AND PROFILE	
SCALE: 1"=20'	SHEET 18 OF 20 SHEETS
STA. 140+80.00 TO STA. 147+00.00	


F.A.U. RTE. 0347	SECTION 05-00102-00-PV	COUNTY KANE	TOTAL SHEETS 488	SHEET NO. 94
CONTRACT NO. 61J84			ILLINOIS FED. AID PROJECT	

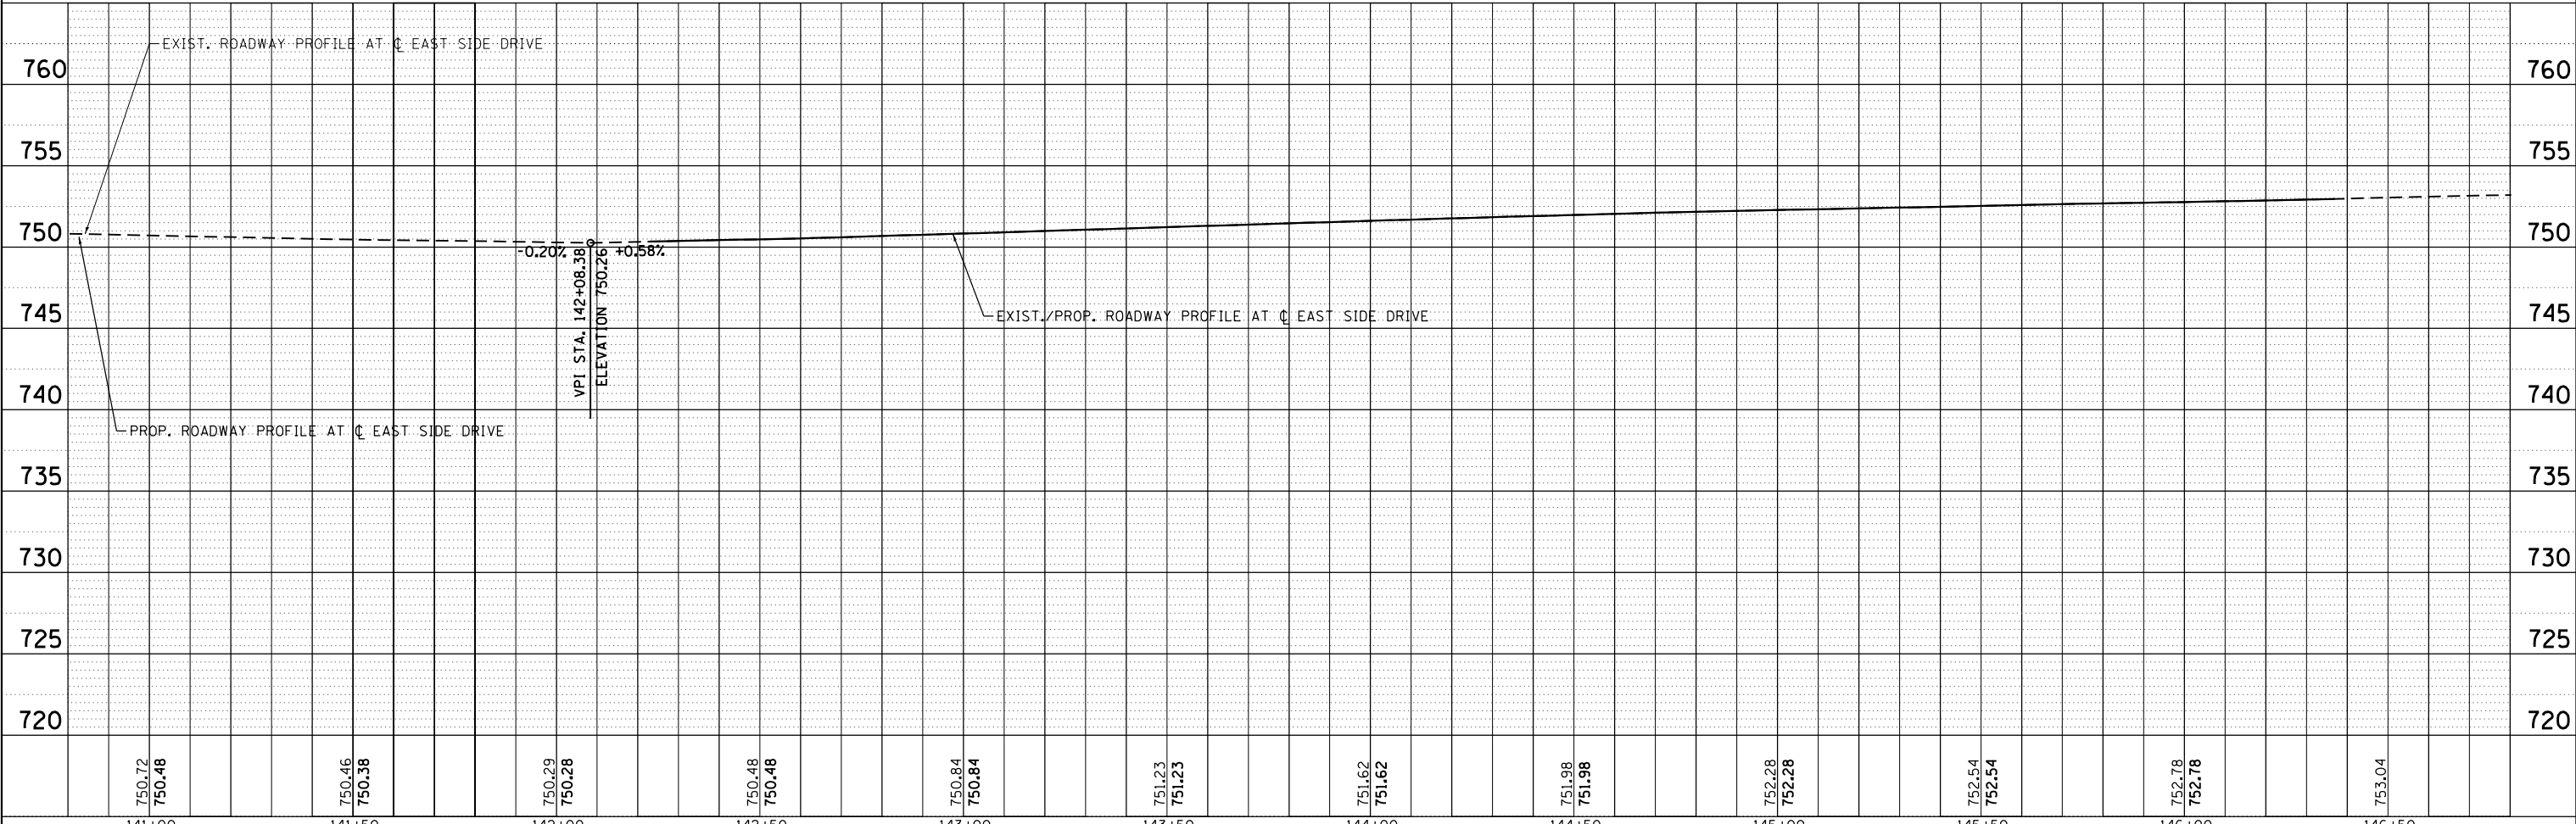PLAN	SURVEYED	DATE
	PLOTTED	
	GRADES CHECKED	
	STRUCTURE NOTATIONS CHECKED	
	NO.	

PROFILE	SURVEYED	DATE
	PLOTTED	
	GRADES CHECKED	
	STRUCTURE NOTATIONS CHECKED	
	NO.	



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205+00	205+50	206+00	206+50	207+00	207+50	208+00	208+50	209+00	209+50	210+00	210+50

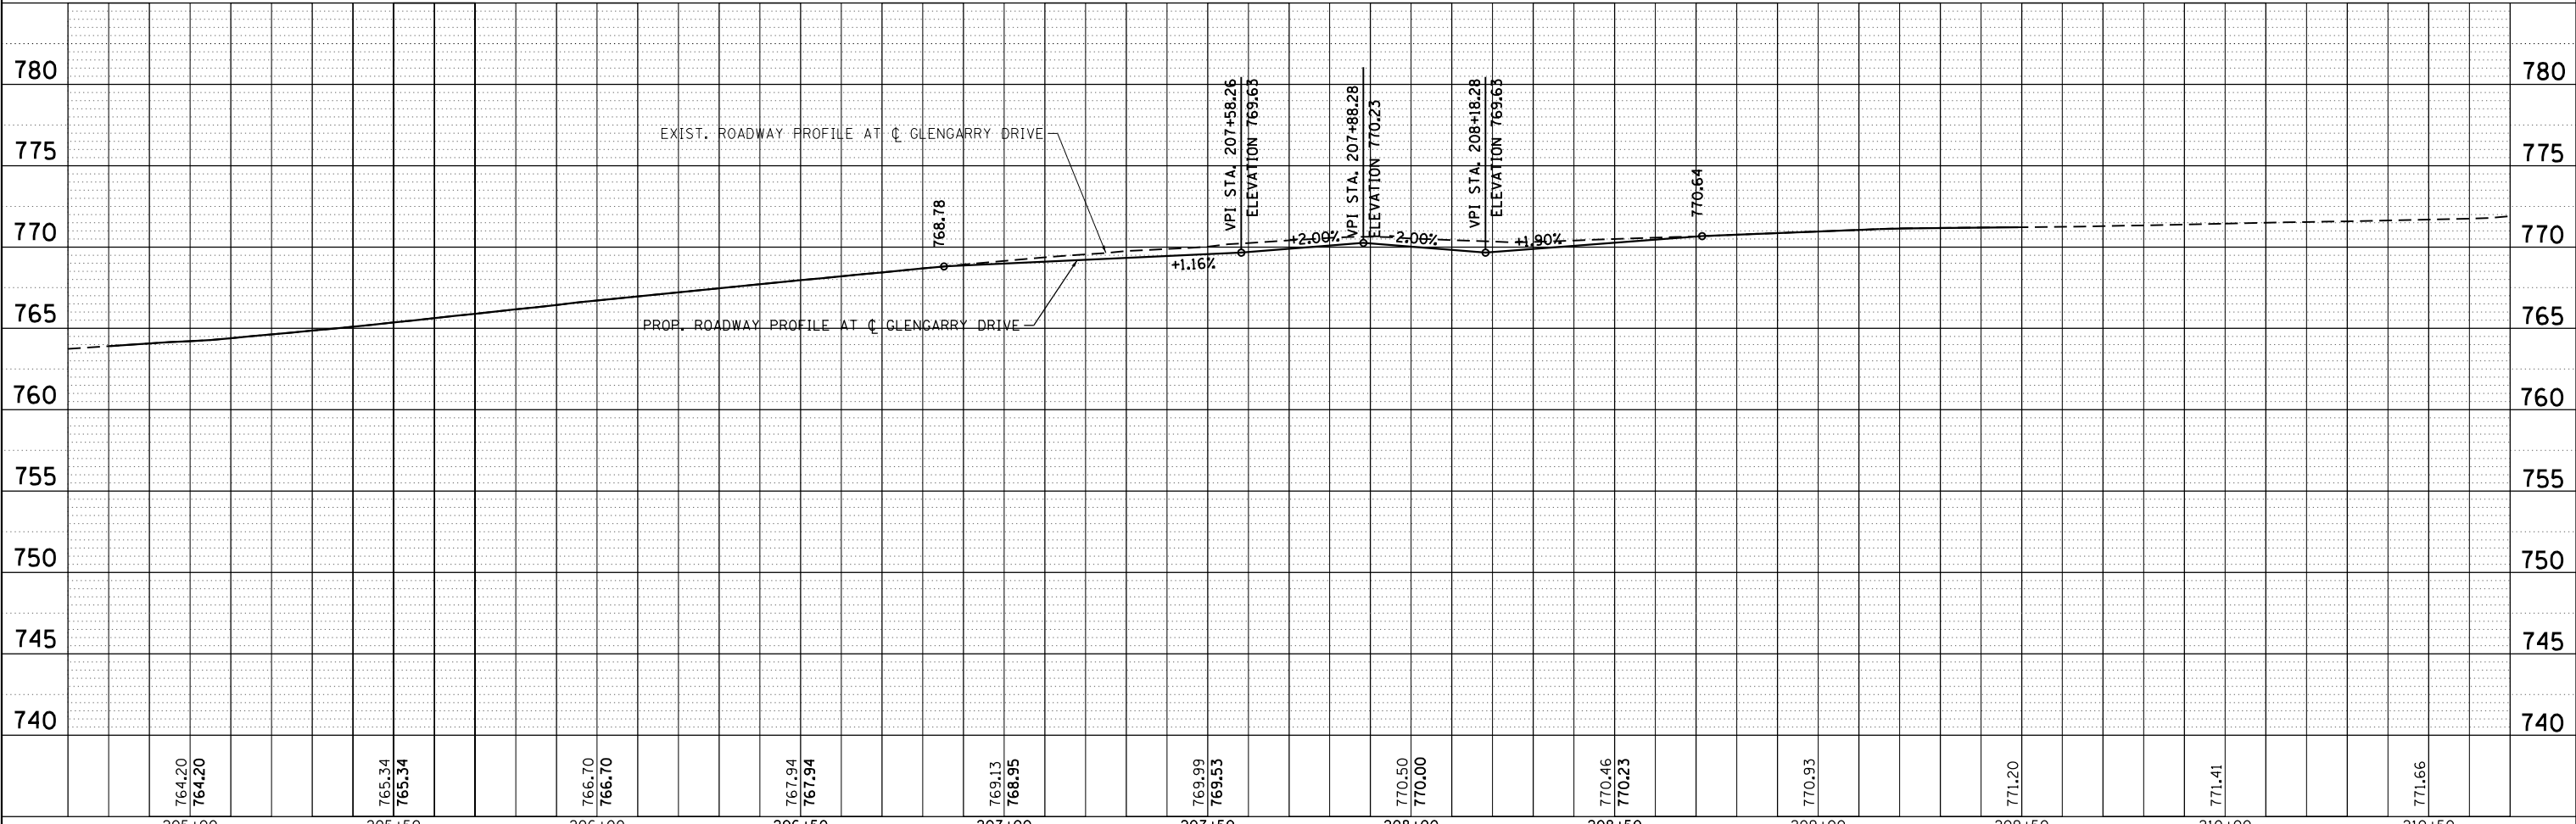BLA, Inc.

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**STATE OF ILLINOIS
DEPARTMENT OF TRANSPORTATION**

GLENGARRY DRIVE PLAN AND PROFILE	
SCALE: 1"=20'	SHEET 20 OF 20 SHEETS STA. 204+50.00 TO STA. 209+00.00

F.A.U. RTE. 0347	SECTION 05-00102-00-PV	COUNTY KANE	TOTAL SHEETS 488	SHEET NO. 96
CONTRACT NO. 61J84			ILLINOIS FED. AID PROJECT	

STAGE CONSTRUCTION GENERAL NOTES

ALL OF THE TRAFFIC CONTROL DEVICES SHALL BE IN PLACE BEFORE CONSTRUCTION IS STARTED FOR EACH APPLICABLE PHASE. THE TRAFFIC CONTROL PLANS SHALL SERVE AS A GUIDE FOR THE SAFE DIVERSION OF TRAFFIC DURING THE EXECUTION OF THIS CONTRACT.

A MINIMUM OF ONE LANE (11 FEET) IN EACH DIRECTION OF EAST STATE STREET AND ALL SHOWN TURN LANES SHALL BE KEPT OPEN TO THROUGH TRAFFIC AT ALL TIMES EXCEPT AS NOTED IN PLANS. ANY LANE CLOSURES MUST BE APPROVED BY THE ENGINEER. ANY WORK THAT RESTRICTS CONTINUOUS TWO-WAY TRAFFIC THRU MAJOR OR SIGNALIZED INTERSECTIONS SHALL BE COORDINATED BY THE CONTRACTOR AND SHALL NOT BE PERFORMED BETWEEN 7-9 AM AND EASTBOUND AND 4-6 PM WESTBOUND OR THIS NECESSARY COORDINATION AND EXECUTION SHALL BE INCLUDED IN THE LUMP SUM COST FOR MAINTENANCE OF TRAFFIC.

WHEN PERFORMING SIDE STREET APPROACH RECONSTRUCTION WORK, TRAFFIC SHALL NOT BE RESTRICTED IN ACCESSING TWO CONSECUTIVE STREETS ON THE NORTH OR SOUTH SIDE OF EAST STATE STREET AT ANY TIME. TEMPORARY MOBILE DETOUR SIGNS SHALL BE MAINTAINED ON EACH SIDE OF THE TEMPORARY RESTRICTION AT ALL TIMES AND SHALL BE INCLUDED IN THE LUMP SUM COST OF SPECIAL MAINTENANCE OF TRAFFIC.

TAPER LENGTH FOR TRAFFIC CONTROL DEVICES IS DEFINED BY:

$$L = \frac{W \times S^2}{60}$$

WHERE EQUATION IS FOR SPEED LIMIT OF 45 MPH OR LESS. THE TERMS ARE DEFINED AS FOLLOWS:

L = TAPER LENGTH IN FEET
W = WIDTH OF OFFSET IN FEET
S = POSTED SPEED IN MPH.

ALL W21 WORKER SIGNS ARE TO BE REMOVED WHEN THE CONTRACTOR IS ABSENT FOR MORE THAN 1 HOUR.

ALL EXISTING LANE LINE PAVEMENT MARKINGS AND RAISED REFLECTIVE PAVEMENT MARKER REFLECTORS LOCATED WITHIN TEMPORARY LANE CLOSURE TAPERS, LANE SHIFT TAPERS OR IN LOCATIONS THAT CONFLICT WITH THE TEMPORARY PAVEMENT MARKING TAPE USED FOR STAGING SHALL BE REMOVED VIA WATER BLASTING WITH VACUUM RECOVERY IF THE STAGING WILL REMAIN IN PLACE FOR MORE THAN 14 DAYS. THE EXISTING PAVEMENT MARKINGS AND RAISED REFLECTIVE PAVEMENT MARKER REFLECTORS THAT WERE REMOVED SHALL BE RESTORED IN KIND AFTER THE COMPLETION OF THE STAGING.

ALL EXISTING PAVEMENT MARKINGS IN CONFLICT WITH THE PAVEMENT MARKING TAPE, TYPE IV (AND/OR MODIFIED URETHANE) USED FOR STAGING SHALL BE REMOVED. THIS WORK SHALL BE PAID FOR AS "PAVEMENT MARKING REMOVAL-WATER BLASTING"

TEMPORARY CONCRETE BARRIER SHALL BE INSTALLED IN ACCORDANCE WITH SECTION 704 OF THE IDOT STANDARD SPECIFICATIONS. ALL TEMPORARY CONCRETE BARRIER APPROACH AND DEPARTING END UNITS SHALL BE ANCHORED TO THE PAVEMENT USING SIX ANCHOR PINS AS SHOWN IN IDOT STANDARD 704001. PINNING OF ADDITIONAL BARRIER UNITS WITH THREE ANCHOR PINS ON THE TRAFFIC SIDE HOLES WITHIN THE INSTALLATION SHALL BE REQUIRED WHEN EQUIPMENT, VEHICLES, MATERIALS, FIXED OBJECTS, OR A DROP-OFF IS LOCATED WITHIN 24" BEHIND THE BARRIER. THE 24" OF CLEAR PAVEMENT MEASUREMENT SHALL BE FROM THE BASE OF THE NON-TRAFFIC SIDE OF THE BARRIER. TRAFFIC SIDE PINNED BARRIER SHALL HAVE A MINIMUM OF 6" OF CLEAR PAVEMENT BEHIND THE BARRIER. WHERE BOTH PINNED AND UNPINNED BARRIER UNITS ARE USED IN A CONTINUOUS INSTALLATION, A TRANSITION SHALL BE PROVIDED BETWEEN THEM. THE TRANSITION FROM PINNED TO UNPINNED BARRIER SHALL CONSIST OF TWO ANCHOR PINS INSTALLED IN THE END HOLES ON THE TRAFFIC SIDE OF THE FIRST BARRIER BEYOND THE PINNED SECTION AND ONE ANCHOR PIN INSTALLED IN THE MIDDLE HOLE OF THE TRAFFIC SIDE OF THE SECOND BARRIER BEYOND THE PINNED SECTION. THE THIRD BARRIER BEYOND THE PINNED SECTION SHALL THEN BE UNPINNED.

CHANGEABLE MESSAGE SIGNS SHALL BE INSTALLED TWO WEEKS PRIOR TO ALL ROAD CLOSURE, TRAFFIC STAGE CHANGES, AND NEW TRAFFIC SIGNAL TURN-ON EVENTS ON EACH APPROACH OF THE EFFECTED ROADWAY TO WARN MOTORISTS OF THE UPCOMING EVENT. THE SIGNS SHALL BE REMOVED TWO WEEKS THEREAFTER UNLESS THE SIGNS ARE NEEDED AGAIN FOR A SUBSEQUENT FUTURE EVENT THAT WILL OCCUR WITHIN 2 WEEKS ON THE SAME APPROACH OF THE EFFECTED ROADWAY. THE SIGN LOCATIONS SHALL BE (DETERMINED BY THE ENGINEER) PLACED AS DIRECTED BY THE ENGINEER.

DROP-OFFS ADJACENT TO THE TRAVEL LANE SHALL BE KEPT TO A MINIMUM. PROTECTION OF THE DROP-OFF SHALL BE ACCORDING TO THE IDOT BUREAU OF SAFETY PROGRAMS AND ENGINEERING, SAFETY ENGINEERING POLICY MEMORANDUM 4-21. DROP-OFFS GREATER THAN OR EQUAL TO 24" WILL NOT BE ALLOWED AT LOCATIONS WHERE THE DROP-OFF IS LOCATED WITHIN 8 FT OF THE EDGE OF THE TRAVEL LANE. THE CONTRACTOR SHALL BE RESPONSIBLE FOR ENSURING THAT THE DROP-OFF AREAS MEET THE OFFSET, HEIGHT, AND DURATION REQUIREMENTS TO USE BARRICADES AT THE END OF EACH WORKDAY. THIS MAY REQUIRE THE CONTRACTOR TO REPLACE OR PLACE SUFFICIENT MATERIAL IN THE EXCAVATION TO REDUCE THE DROP-OFF TO BE COMPLIANT WITH THE REQUIREMENTS FOR USE OF BARRICADES. NO ADDITIONAL COMPENSATION SHALL BE ALLOWED TO COMPLY WITH THIS REQUIREMENT, WHERE POSITIVE PROTECTION (TEMPORARY CONCRETE BARRIER PER STD. 704001) IS PROVIDED, THIS REQUIREMENT IS NULLIFIED.

THE "ROAD CONSTRUCTION AHEAD" SIGNS SHALL REMAIN INSTALLED UNTIL THE COMPLETION OF THE PROJECT OR WHEN NO ROADWAY HAZARDS REMAIN WITHIN THE WORK ZONE.

WHEN WORKING ADJACENT TO THE ROAD AND UTILIZING DAILY LANE CLOSURES, DROP-OFFS ADJACENT TO THE TRAVEL LANES SHALL BE KEPT TO A MINIMUM. DROP-OFFS GREATER THAN (OR GREATER THAN OR EQUAL TO) 24" WILL NOT BE ALLOWED AT LOCATIONS WHERE THE DROP-OFF IS LOCATED WITHIN 8 FT OF THE EDGE OF THE TRAVEL LANE. THE CONTRACTOR WILL BE REQUIRED TO PERFORM THE EXCAVATION REQUIRED FOR THE CONSTRUCTION DURING THE TIME THAT THE ADJACENT LANE IS CLOSED. AS NOTED ABOVE, PRIOR TO REOPENING THE LANE TO TRAFFIC THE CONTRACTOR SHALL PLACE SUFFICIENT MATERIAL TO REDUCE THE DROP-OFF TO LESS THAN 12". THE CONTRACTOR SHALL BE RESPONSIBLE TO DETERMINE THE AMOUNT OF WORK THAT CAN BE COMPLETED WITHIN THE TIME OF THE DAILY LANE CLOSURE. NO ADDITIONAL COMPENSATION SHALL BE ALLOWED TO COMPLY WITH THIS REQUIREMENT.

TEMPORARY INFORMATION SIGNS ON TEMPORARY SUPPORTS SHALL BE PROVIDED FOR ALL COMMERCIAL DRIVEWAYS THAT ARE LOCATED WITHIN A WORK AREA. THIS WORK SHALL BE PAID FOR PER DISTRICT 1 DETAIL TC-26. THESE SIGNS SHALL BE RELOCATED AS REQUIRED FOR EACH CONSTRUCTION STAGE AND SHALL BE PLACED AS DIRECTED BY THE ENGINEER. THIS SIGN RELOCATION WORK WILL NOT BE PAID FOR SEPARATELY AND SHALL BE INCLUDED IN THE CONTRACT UNIT PRICE PER SQUARE FOOT FOR TEMPORARY INFORMATION SIGNING.

ACCESS TO BUSINESS AND RESIDENCES WITHIN THE WZ NEED TO BE MAINTAINED AT ALL TIMES.

THE CONTRACTOR SHALL MAINTAIN ACCESS TO ALL SIDE STREETS AND DRIVEWAYS BY UTILIZING STAGED CONSTRUCTION, FLAGGERS, TEMPORARY ACCESS, OR OTHER METHODS APPROVED BY THE ENGINEER

TRAFFIC CONTROL AND PROTECTION

DAILY LANE CLOSURES WILL BE ALLOWED WHEN SNOW REMOVAL OPERATIONS WILL NOT BE EFFECTED.

EXISTING TRAFFIC CONTROL SIGNS AND DEVICES WILL BE REMOVED BY THE CITY OF GENEVA PUBLIC WORKS DEPARTMENT AFTER THE TRAFFIC CONTROL REQUIREMENTS ARE MET OR AS AUTHORIZED BY THE ENGINEER; ANY SIGNS OR DEVICES LEFT IN PLACE AT THIS TIME ARE TO BE RELOCATED, MAINTAINED AND PROTECTED FROM DAMAGE BY THE CONTRACTOR AND ANY DAMAGED OR LOST SIGNS WILL BE REPLACED BY THE CONTRACTOR.

BARRICADES THAT MUST BE PLACED IN EXCAVATED AREAS SHALL HAVE LEG EXTENSIONS INSTALLED SUCH THAT THE TOP OF THE BARRICADE IS IN COMPLIANCE WITH THE HEIGHT REQUIREMENTS OF STANDARD 701901.

TYPE II AND/OR III BARRICADES WITH TWO-WAY FLASHING LIGHTS WILL BE REQUIRED TO GUIDE TRAFFIC AWAY FROM PAVEMENT AREAS CLOSED FOR CONSTRUCTION.

THE COST OF SUPPLYING, ERECTING, AND MAINTAINING BARRICADES, WARNING LIGHTS, AND SIGNS WILL BE INCLUDED IN THE CONTRACT LUMP SUM PRICE FOR TRAFFIC CONTROL AND PROTECTION, SPECIAL.

WHERE REQUIRED, TRAFFIC SIGNS SHALL BE RELOCATED FOR EACH STAGE OF CONSTRUCTION.

ARROW BOARDS WILL BE REQUIRED WHEN IMPLEMENTING ANY LANE CLOSURES.

SIGN LEGEND

CONSTRUCTION STAGING

THE FOLLOWING IS THE CONSTRUCTION STAGING FOR THE PROJECT. THE PURPOSE OF THIS STAGING IS TO MINIMIZE DELAYS TO THE MOTORIST. THE CONTRACTOR MAY ALTER THE SEQUENCE OF CONSTRUCTION WITH THE PRIOR APPROVAL OF THE ENGINEER. PRIOR TO THE START OF CONSTRUCTION, REQUIRED TRAFFIC CONTROL DEVICES SHALL BE IN PLACE. SUBSTAGE SIDE ROADS AND ENTRANCES TO MAINTAIN TRAFFIC FLOW.

PRE-STAGE

INSTALL ALL TRAFFIC CONTROL
INSTALL EROSION CONTROL NECESSARY FOR PRE-STAGE
REMOVE AND REPLACE IL RTE 38 MAINLINE SANITARY SEWER MANHOLES
INSTALL STAGE 1 TEMPORARY PAVEMENT WITH DAYTIME CLOSURES AS NEEDED

STAGE 1

INSTALL ALL TRAFFIC CONTROL FOR STAGE 1
INSTALL EROSION CONTROL NECESSARY FOR STAGE 1
REMOVE EXISTING CURB & GUTTER, PAVEMENT, SIDEWALKS AND SHOULDER AS SHOWN IN THE STAGE 1 MOT PLANS
INSTALL STORM SEWER, SANITARY AND WATERMAIN SERVICES TO EDGE OF STAGE 1 WORK ZONE
CONSTRUCT STAGE 1 SUBBASE, PAVEMENT, CURB & GUTTER, SIDEWALK, BIKE PATH, APPROPRIATE TRAFFIC SIGNAL AND LIGHTING EQUIPMENT AND GRADING
PLACE TOPSOIL AND COMPLETE STAGE 1 LANDSCAPING

STAGE 2

INSTALL ALL TRAFFIC CONTROL FOR STAGE 2
INSTALL ALL NECESSARY EROSION CONTROL FOR STAGE 2
REMOVE STAGE 1 TEMPORARY PAVEMENT
REMOVE EXISTING CURB & GUTTER, PAVEMENT, SIDEWALKS AND SHOULDER AS SHOWN IN THE STAGE 2 MOT PLANS
INSTALL STORM SEWER, WATERMAIN, SANITARY AND WATERMAIN SERVICES TO EDGE OF STAGE 2 WORK ZONE
CONSTRUCT STAGE 2 SUBBASE, PAVEMENT, CURB & GUTTER, SIDEWALK, APPROPRIATE TRAFFIC SIGNAL AND LIGHTING EQUIPMENT AND GRADING
PLACE TOPSOIL AND COMPLETE STAGE 2 LANDSCAPING

STAGE 3

INSTALL ALL TRAFFIC CONTROL FOR STAGE 3
INSTALL ALL NECESSARY EROSION CONTROL FOR STAGE 3
INSTALL REMAINING STORM SEWER
CONSTRUCT MEDIANS AT EAST SIDE DRIVE
COMPLETE TRAFFIC SIGNAL AND LIGHTING INSTALLATIONS

STAGE 4

PLACE FINAL SURFACE COURSE, PERMANENT PAVEMENT MARKINGS, SIGNAGE
COMPLETE FINAL LANDSCAPING
REMOVE ALL EROSION CONTROL ITEMS

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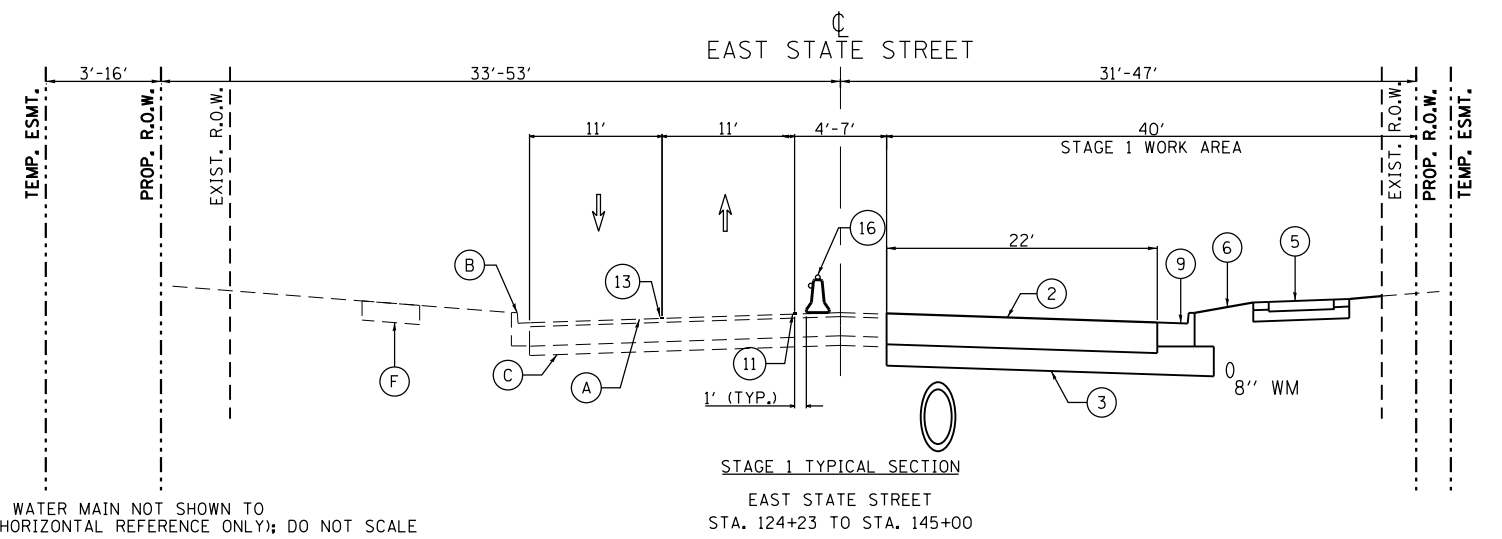
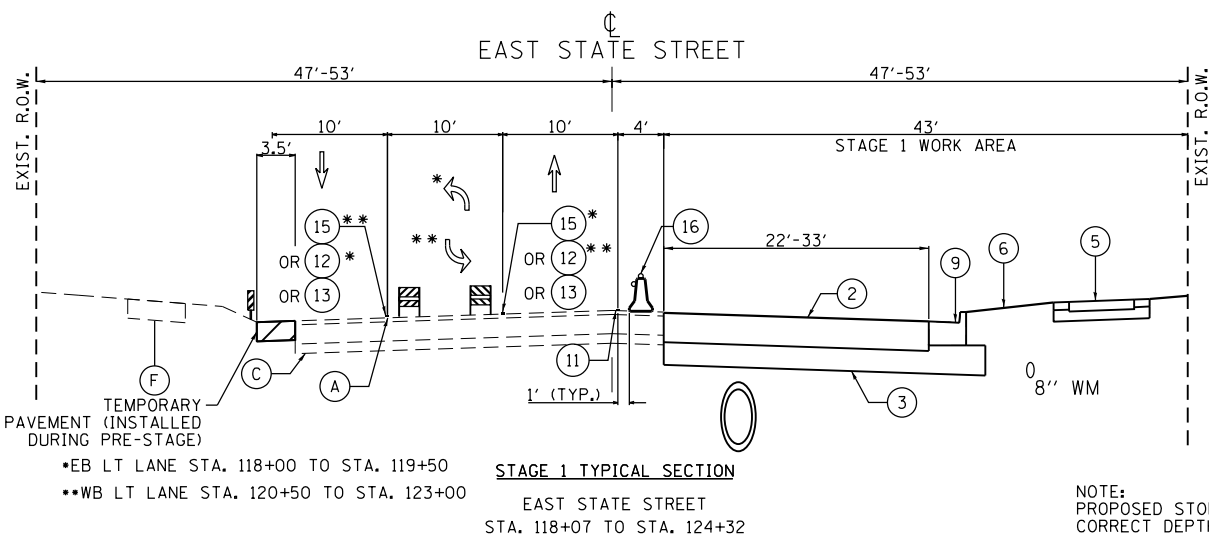
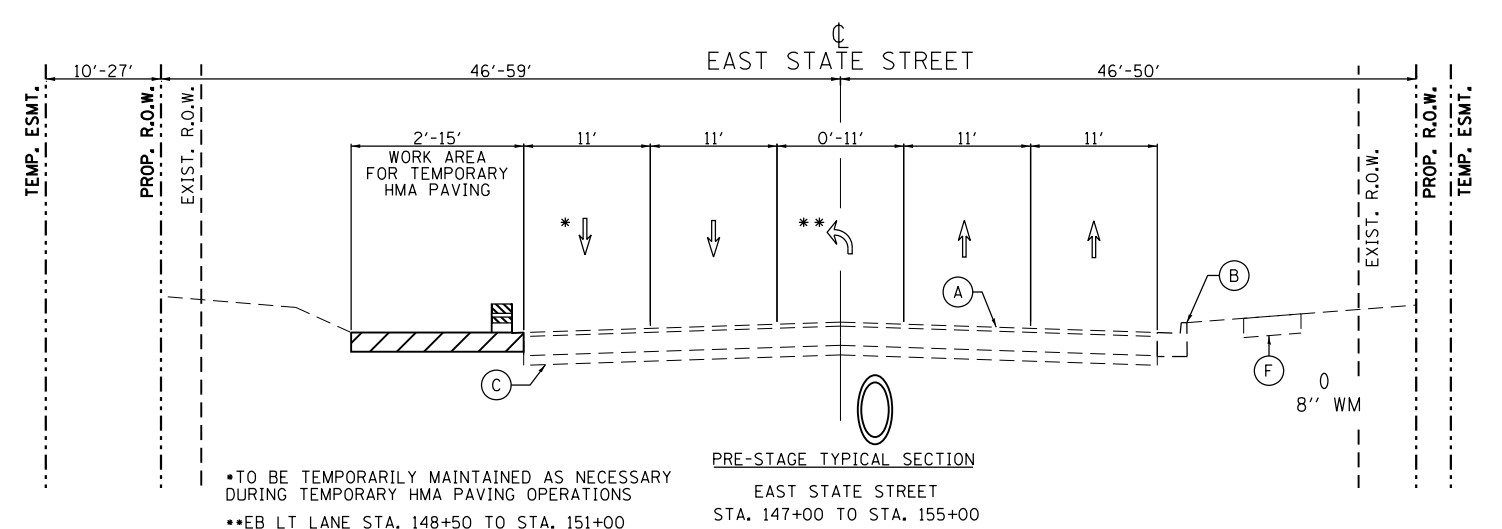
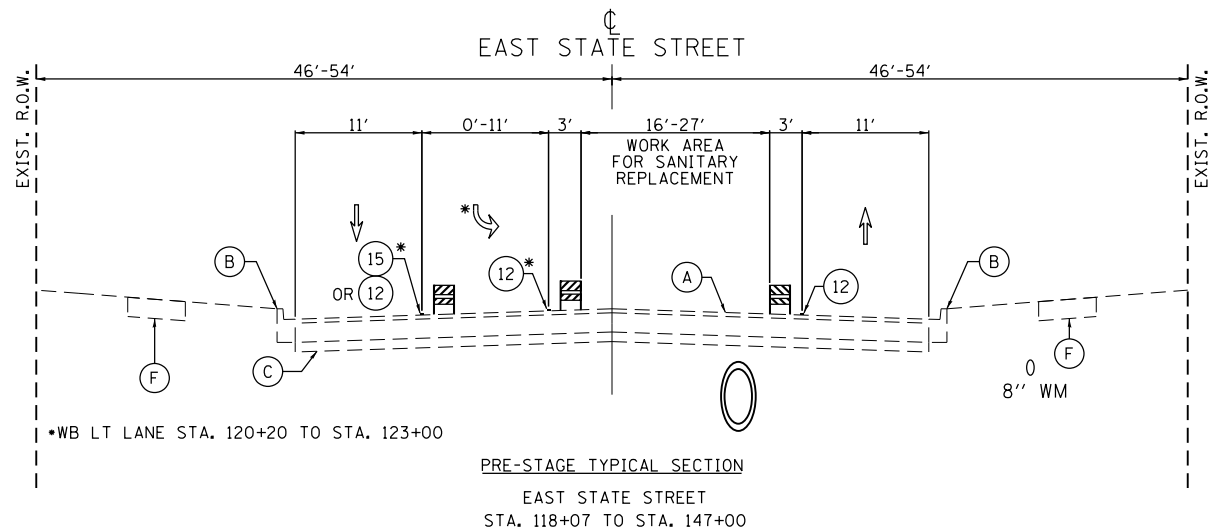
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**STATE OF ILLINOIS
DEPARTMENT OF TRANSPORTATION**



**IL ROUTE 38 - EAST STATE STREET
MAINTENANCE OF TRAFFIC - GENERAL NOTES**

SCALE: NONE SHEET 1 OF 49 SHEETS STA. TO STA.

F.A.U. RTE.	SECTION	COUNTY	TOTAL SHEETS	SHEET NO.
0347	05-00102-00-PV	KANE	488	97
CONTRACT NO. 61J84				
ILLINOIS FED. AID PROJECT				



NOTE:
PROPOSED STORM AND PROPOSED WATER MAIN NOT SHOWN TO CORRECT DEPTH (FOR RELATIVE HORIZONTAL REFERENCE ONLY); DO NOT SCALE
TEMPORARY HMA WEDGE MAY BE REQUIRED WHERE EXISTING AND PROPOSED PAVEMENT MEET AT VARIOUS LOCATIONS DURING STAGED CONSTRUCTION.

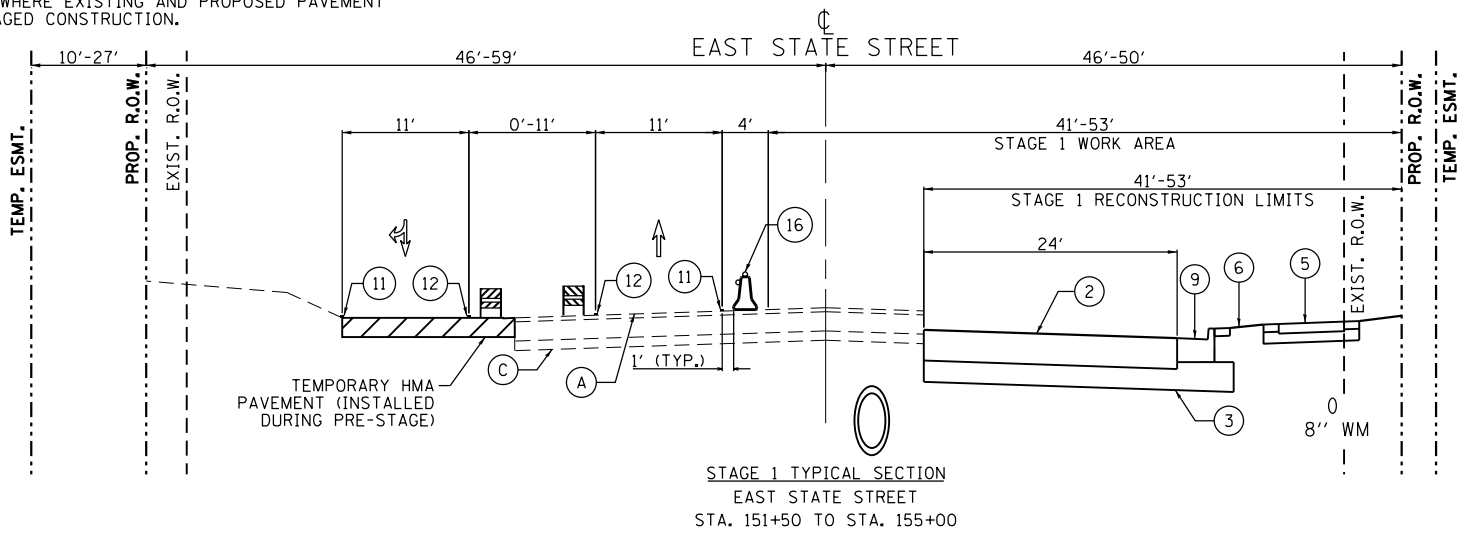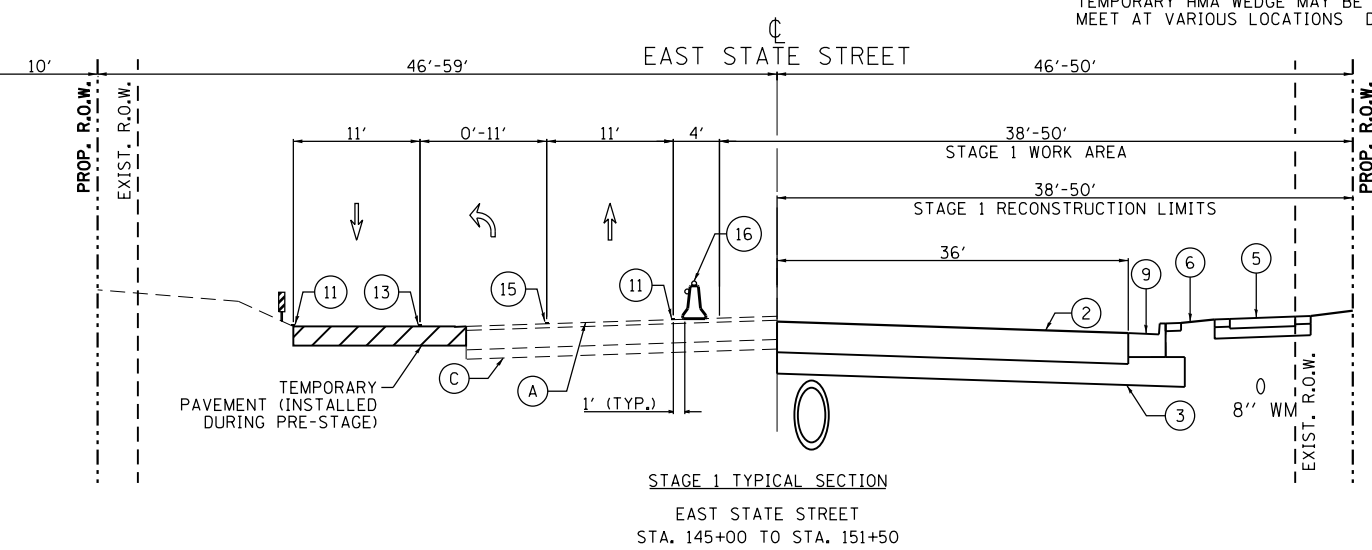

- LEGEND**
- | | | | | | | |
|---------------------------------------|--|-----------------------------------|---|--|---|---|
| (A) EXISTING PAVEMENT | (F) EXISTING SIDEWALK | (5) PROPOSED PCC SIDEWALK | (10) PROPOSED MEDIAN | (15) TEMP. PAVEMENT MARKING, 6" (WHITE) | [Hatched Box] TEMP. HMA @ 440 LB/SYS OR AS DIRECTED BY ENGINEER | [Barricade Symbol] TYPE II BARRICADE OR DRUM |
| (B) EXISTING CONCRETE CURB AND GUTTER | (1) PROPOSED HMA MULTI-USE PATH | (6) PROPOSED SODDING OVER TOPSOIL | (11) TEMP. PAVEMENT MARKING, 4" (WHITE) | (16) MONO-DIRECTIONAL CRYSTAL, TYPE C REFLECTORS | [White Box] WORK ZONE | [Barrier Wall Symbol] TEMPORARY BARRIER WALL |
| (C) EXISTING GRANULAR SUBBASE | (2) PROPOSED PAVEMENT | (7) PROPOSED NOISE WALL | (12) TEMP. PAVEMENT MARKING, 4" (YELLOW) | (17) MONO-DIRECTIONAL AMBER, TYPE C REFLECTORS | [Dashed Box] WORK ZONE PAVEMENT MARKING | [Light Symbol] VERTICAL PANEL WITH STEADY BURNING LIGHT |
| (D) EXISTING MEDIAN | (3) PROPOSED SUBBASE GRANULAR MATERIAL | (8) PROPOSED RETAINING WALL | (13) TEMP. PAVEMENT MARKING, 4" (DOUBLE YELLOW) 11" C-C | [Arrow Symbol] DIRECTION OF TRAFFIC | [Up Arrow Symbol] PROPOSED WATER MAIN | [Storm Manhole Symbol] PROPOSED RCP STORM (SIZE VARIES) |
| (E) EXISTING HMA SHOULDER | (4) PROPOSED HMA SHOULDER | (9) PROPOSED COMB. CONC. C&G | (14) TEMP. PAVEMENT MARKING, 4" (WHITE SKIP-DASH) | | | |

FILE NAME = F:\961-000 Genevo East State St.CADD.Sheets\961-000_SHT_MOT_TYP_SEC.dgn






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**STATE OF ILLINOIS
DEPARTMENT OF TRANSPORTATION**

**ILLINOIS ROUTE 38 - EAST STATE STREET
MAINTENANCE OF TRAFFIC TYPICAL SECTIONS - PRESTAGE & STAGE 1**

SCALE: SHEET 2 OF 49 SHEETS STA. TO STA.

F.A.U. RTE.	SECTION	COUNTY	TOTAL SHEETS	SHEET NO.
0347	05-00102-00-PV	KANE	488	98
CONTRACT NO. 61J84				
ILLINOIS FED. AID PROJECT				

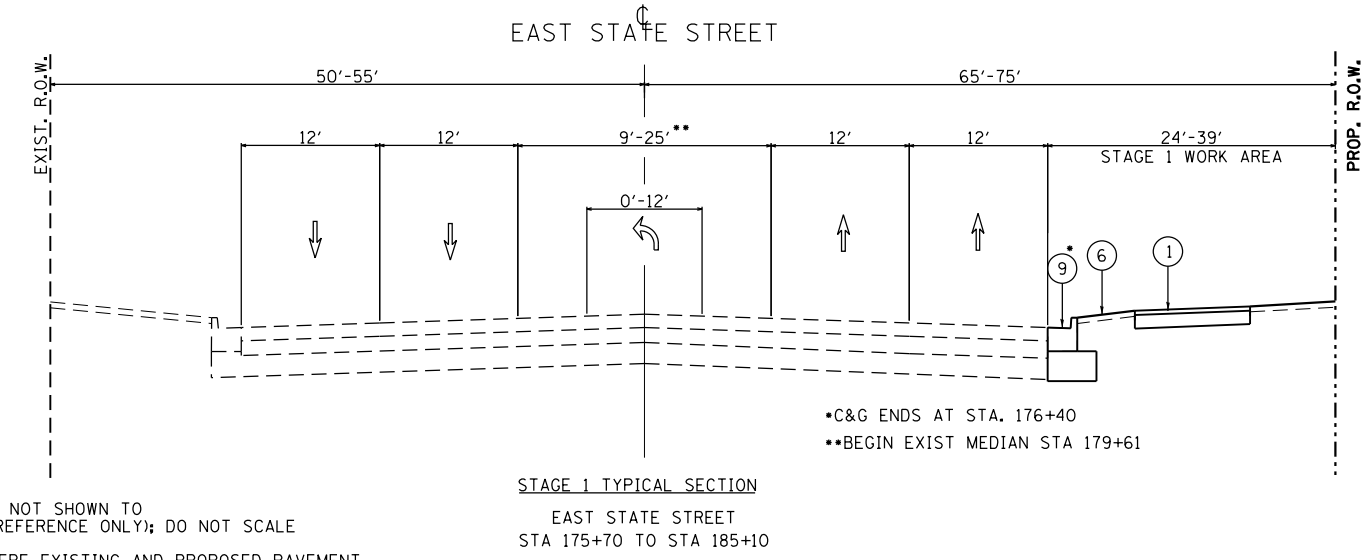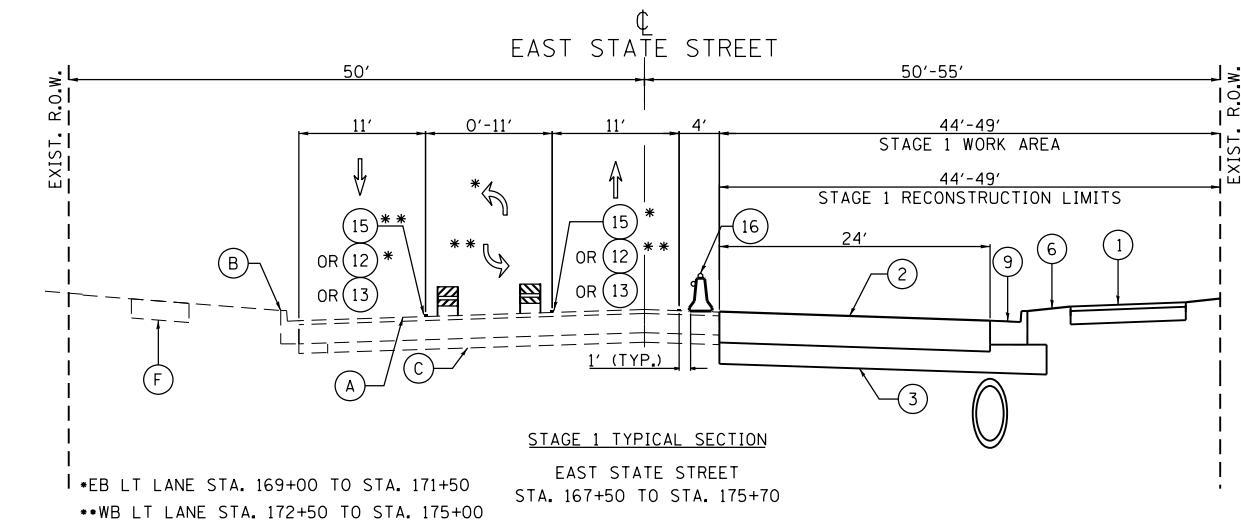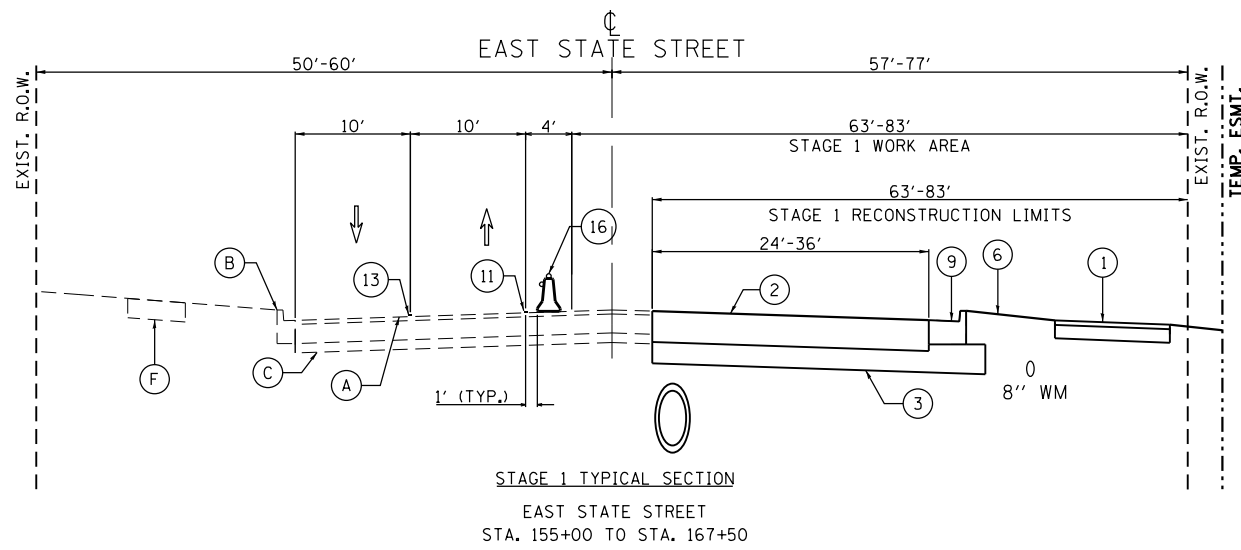

NOTE:
 PROPOSED STORM AND PROPOSED WATER MAIN NOT SHOWN TO CORRECT DEPTH (FOR RELATIVE HORIZONTAL REFERENCE ONLY); DO NOT SCALE
 TEMPORARY HMA WEDGE MAY BE REQUIRED WHERE EXISTING AND PROPOSED PAVEMENT MEET AT VARIOUS LOCATIONS DURING STAGED CONSTRUCTION.

LEGEND

- | | | | | | | |
|---------------------------------------|--|-----------------------------------|---|--|---|--|
| (A) EXISTING PAVEMENT | (F) EXISTING SIDEWALK | (5) PROPOSED PCC SIDEWALK | (10) PROPOSED MEDIAN | (15) TEMP. PAVEMENT MARKING, 6" (WHITE) | TEMP. HMA @ 440 LB/SYS OR AS DIRECTED BY ENGINEER | TYPE II BARRICADE OR DRUM |
| (B) EXISTING CONCRETE CURB AND GUTTER | (1) PROPOSED HMA MULTI-USE PATH | (6) PROPOSED SODDING OVER TOPSOIL | (11) TEMP. PAVEMENT MARKING, 4" (WHITE) | (16) MONO-DIRECTIONAL CRYSTAL, TYPE C REFLECTORS | WORK ZONE | TEMPORARY BARRIER WALL |
| (C) EXISTING GRANULAR SUBBASE | (2) PROPOSED PAVEMENT | (7) PROPOSED NOISE WALL | (12) TEMP. PAVEMENT MARKING, 4" (YELLOW) | (17) MONO-DIRECTIONAL AMBER, TYPE C REFLECTORS | WORK ZONE PAVEMENT MARKING | VERTICAL PANEL WITH STEADY BURNING LIGHT |
| (D) EXISTING MEDIAN | (3) PROPOSED SUBBASE GRANULAR MATERIAL | (8) PROPOSED RETAINING WALL | (13) TEMP. PAVEMENT MARKING, 4" (DOUBLE YELLOW) 11" C-C | DIRECTION OF TRAFFIC | PROPOSED WATER MAIN | PROPOSED RCP STORM (SIZE VARIES) |
| (E) EXISTING HMA SHOULDER | (4) PROPOSED HMA SHOULDER | (9) PROPOSED COMB. CONC. C&G | (14) TEMP. PAVEMENT MARKING, 4" (WHITE SKIP-DASH) | | | |

FILE NAME = F:\961-000 Genevo East State St\CADD_Sheets\961-000_SHT_MOT_TYP_SEC.dgn









USER NAME = tnestor	DESIGNED - GJE	REVISED -
DRAWN - GJE	REVISOR -	
PLOT SCALE = 100.0000' / in.	CHECKED - DBB	REVISOR -
PLOT DATE = 1/13/2025	DATE - 11/7/2024	REVISOR -

STATE OF ILLINOIS
 DEPARTMENT OF TRANSPORTATION

ILLINOIS ROUTE 38 - EAST STATE STREET
 MAINTENANCE OF TRAFFIC TYPICAL SECTIONS - STAGE 1
 SCALE: SHEET 3 OF 49 SHEETS STA. TO STA.

F.A.U. RTE.	SECTION	COUNTY	TOTAL SHEETS	SHEET NO.
0347	05-00102-00-PV	KANE	488	99
CONTRACT NO. 61J84				
ILLINOIS FED. AID PROJECT				

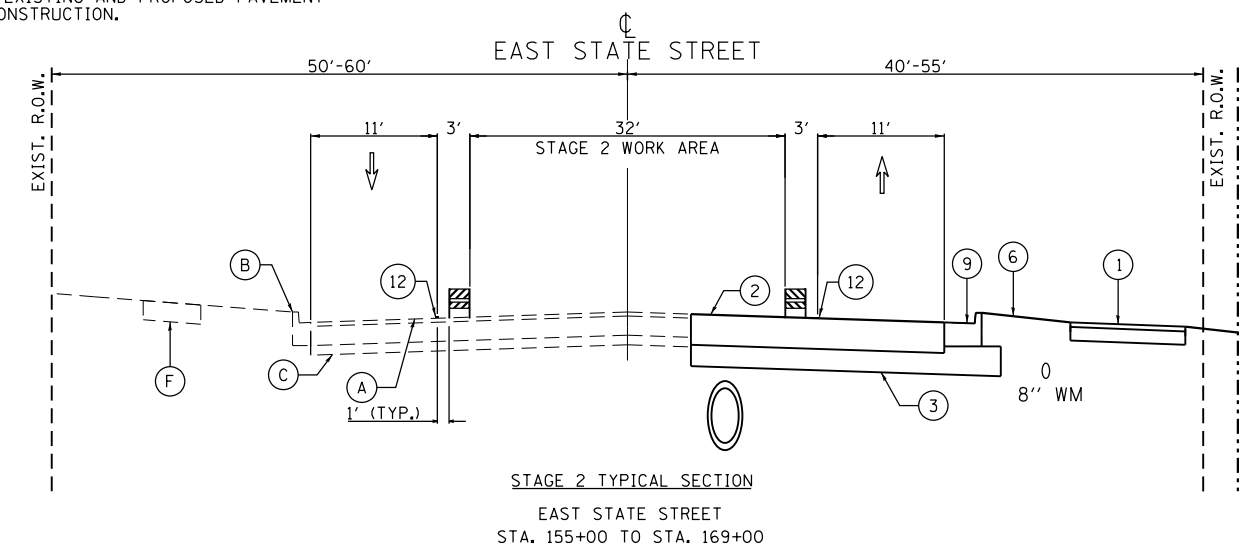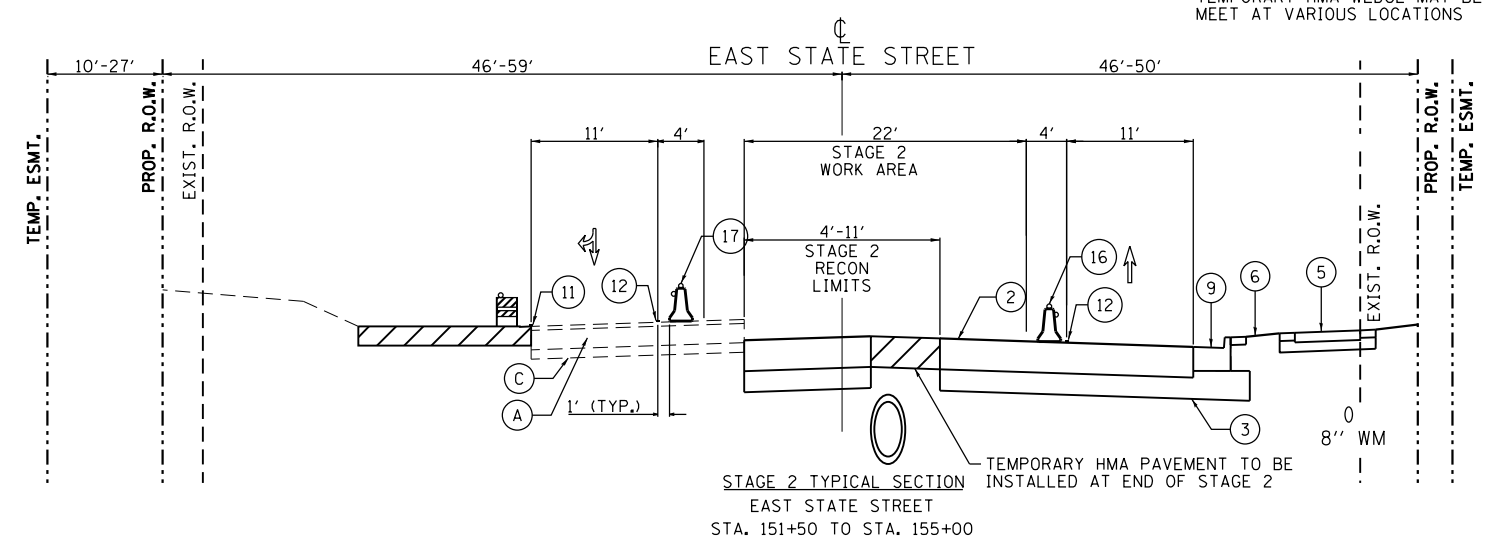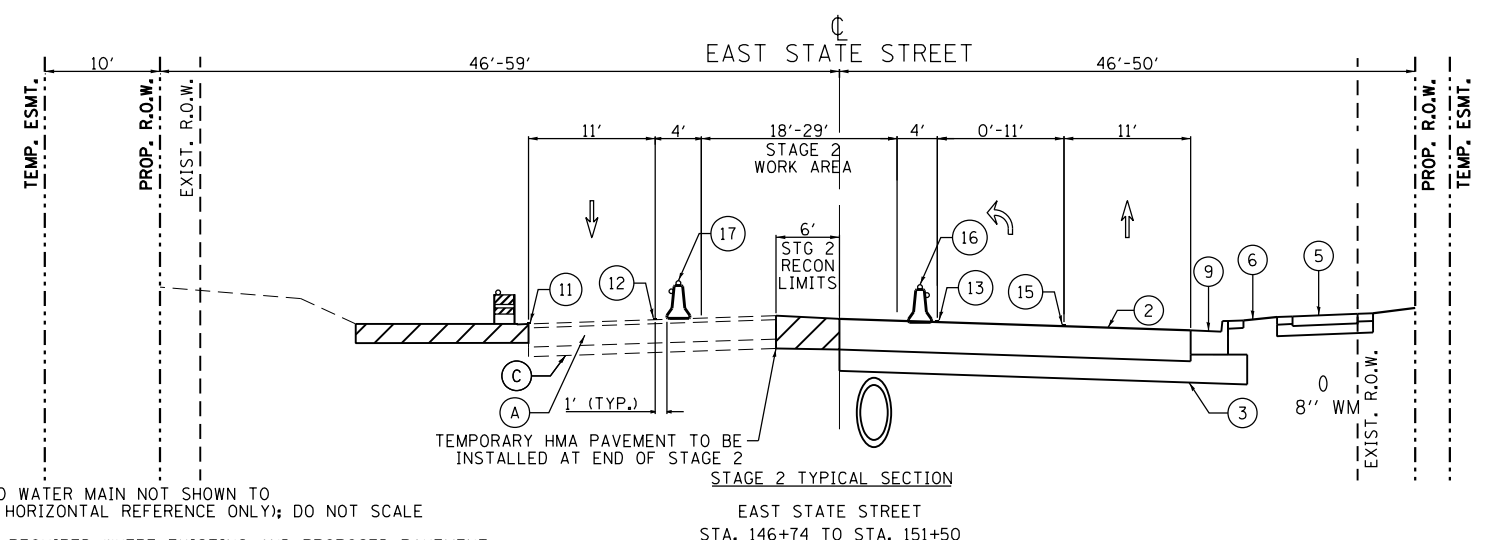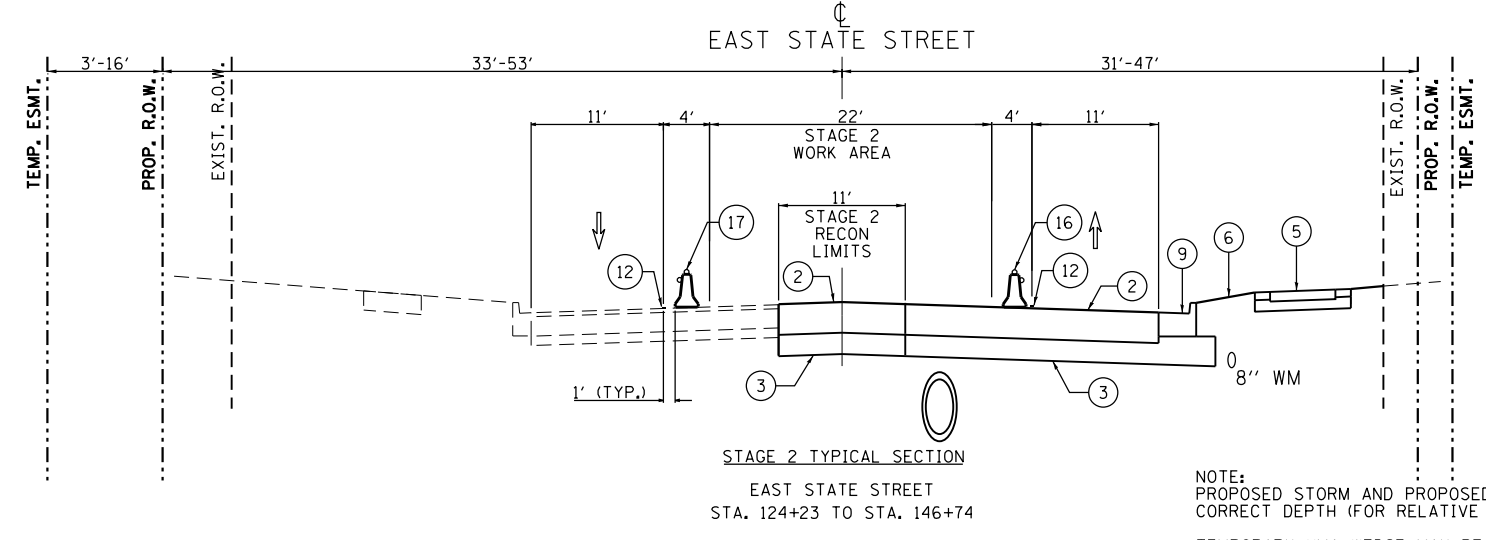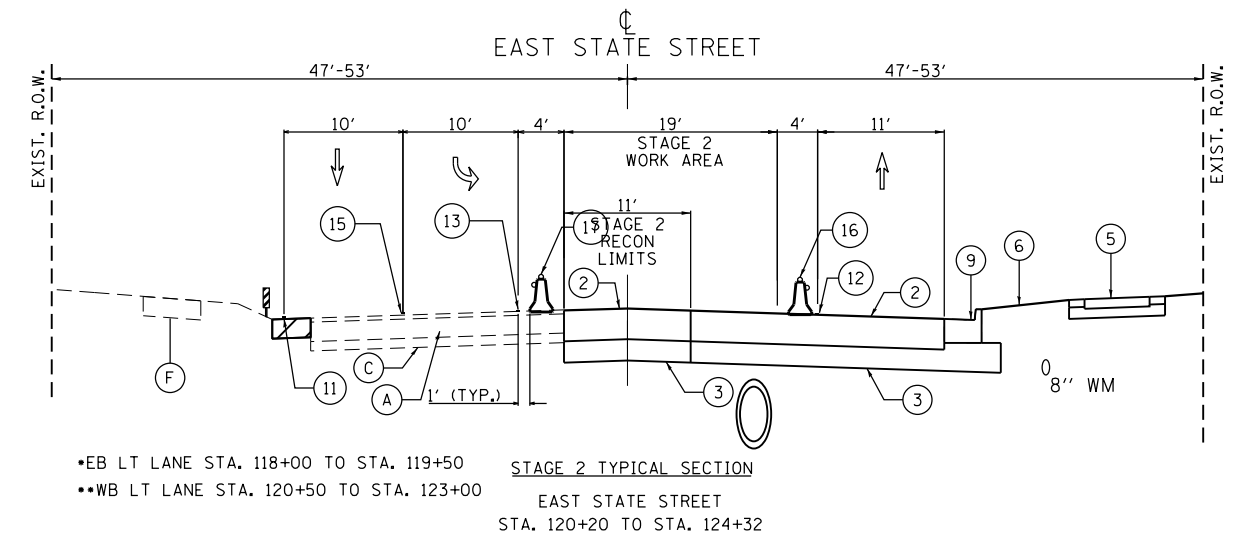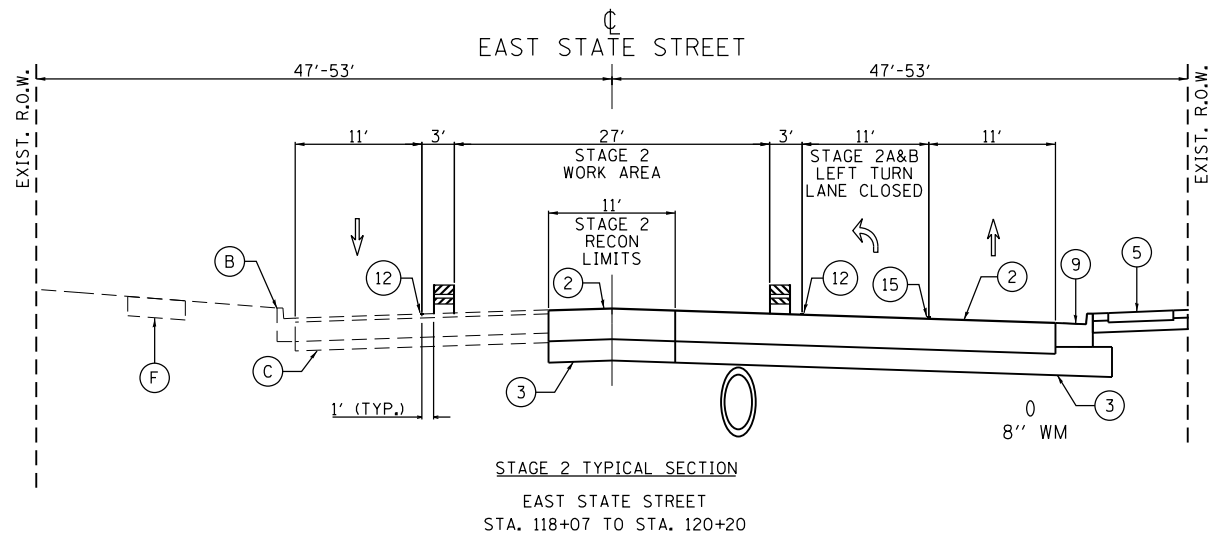

NOTE:
PROPOSED STORM AND PROPOSED WATER MAIN NOT SHOWN TO CORRECT DEPTH (FOR RELATIVE HORIZONTAL REFERENCE ONLY); DO NOT SCALE
TEMPORARY HMA WEDGE MAY BE REQUIRED WHERE EXISTING AND PROPOSED PAVEMENT MEET AT VARIOUS LOCATIONS DURING STAGED CONSTRUCTION.

- LEGEND**
- | | | | | | | |
|---------------------------------------|--|-----------------------------------|---|--|---|--|
| (A) EXISTING PAVEMENT | (F) EXISTING SIDEWALK | (5) PROPOSED PCC SIDEWALK | (10) PROPOSED MEDIAN | (15) TEMP. PAVEMENT MARKING, 6" (WHITE) | [Hatched Box] TEMP. HMA @ 440 LB/SYS OR AS DIRECTED BY ENGINEER | [Diagonal Lines Box] TYPE II BARRICADE OR DRUM |
| (B) EXISTING CONCRETE CURB AND GUTTER | (1) PROPOSED HMA MULTI-USE PATH | (6) PROPOSED SODDING OVER TOPSOIL | (11) TEMP. PAVEMENT MARKING, 4" (WHITE) | (16) MONO-DIRECTIONAL CRYSTAL, TYPE C REFLECTORS | [White Box] WORK ZONE | [Bell Icon] TEMPORARY BARRIER WALL |
| (C) EXISTING GRANULAR SUBBASE | (2) PROPOSED PAVEMENT | (7) PROPOSED NOISE WALL | (12) TEMP. PAVEMENT MARKING, 4" (YELLOW) | (17) MONO-DIRECTIONAL AMBER, TYPE C REFLECTORS | [Dashed Box] WORK ZONE PAVEMENT MARKING | [Vertical Panel Icon] VERTICAL PANEL WITH STEADY BURNING LIGHT |
| (D) EXISTING MEDIAN | (3) PROPOSED SUBBASE GRANULAR MATERIAL | (8) PROPOSED RETAINING WALL | (13) TEMP. PAVEMENT MARKING, 4" (DOUBLE YELLOW) 11" C-C | [Arrow Icon] DIRECTION OF TRAFFIC | [Circle with 0 Icon] PROPOSED WATER MAIN | [Circle with 0 Icon] PROPOSED RCP STORM (SIZE VARIES) |
| (E) EXISTING HMA SHOULDER | (4) PROPOSED HMA SHOULDER | (9) PROPOSED COMB. CONC. C&G | (14) TEMP. PAVEMENT MARKING, 4" (WHITE SKIP-DASH) | | | |

FILE NAME = F:\961-000_Genevo_East_State_St_CADD_Sheets\961-000_SHT_MOT_TYP_SEC.dgn

BLA, Inc.	USER NAME = tnestor	DESIGNED - GJE	REVISED -	STATE OF ILLINOIS DEPARTMENT OF TRANSPORTATION	ILLINOIS ROUTE 38 - EAST STATE STREET MAINTENANCE OF TRAFFIC TYPICAL SECTIONS - STAGE 2	F.A.U. RTE. 0347	SECTION 05-00102-00-PV	COUNTY KANE	TOTAL SHEETS 488	SHEET NO. 100
	PLOT SCALE = 100.0000' / in.	CHECKED - DBB	REVISED -			SCALE: SHEET 4 OF 49 SHEETS STA. TO STA.	CONTRACT NO. 61J84			
	PLOT DATE = 1/13/2025	DATE - 11/7/2024	REVISED -	ILLINOIS FED. AID PROJECT						