03-07-2025 LETTING ITEM 187

STATE OF ILLINOIS DEPARTMENT OF TRANSPORTATION

PROPOSED HIGHWAY PLANS

MS ROUTE 3019: MAY ST.
HILLSIDE MAINTENANCE YARD
4160 MAY ST., HILLSIDE
SECTION: 2023-943-I
PARKING IMPROVEMENT
COOK COUNTY

C-91-183-24

R 12 E

Madison St

Madison St

Millow Ave

Millow

PROVISO TOWNSHIP

FOR INDEX OF SHEETS, SEE SHEET NO.

THE PROJECT IS LOCATED IN THE VILLAGE OF HILLSIDE

HILLSIDE MAINTENANCE YARD 4160 MAY ST., HILLSIDE

0 100' 200' 300' — 1"= 100'
0 10' 20' 30' — 1"= 10'
0 50' 100' 1"= 50'
0 50' 100' 1"= 40'
0 50' 100' 1"= 20'

FULL SIZE PLANS HAVE BEEN PREPARED USING STANDARD ENGINEERING SCALES. REDUCED SIZED PLANS WILL NOT CONFORM TO STANDARD SCALES. IN MAKING MEASUREMENTS ON REDUCED PLANS. THE ABOVE SCALES MAY BE USED.

J.U.L.I.E.
JOINT UTILITY LOCATION INFORMATION FOR EXCAVATION
1-800-892-0123
OR 811

PROJECT ENGINEER: RODRIGO LEDEZMA (847) 705-4580 PROJECT MANAGER: ALAIN MIDY (847) 221-3056

CONTRACT NO. 62W63

STATE OF ILLINOIS
DEPARTMENT OF TRANSPORTATION

SUBMITTED

REGIONAL ENGINEER

JAQUARY 31

20

ENGINEER OF DESIGN AND ENVINONMENT

January 31

25

DIRECTOR OF HIGHWAYS PROJECT INFLEMENTATION

PRINTED BY THE AUTHORITY OF THE STATE OF ILLINOIS

INDEX OF SHEETS

STATE STANDARDS

NO. DESCRIPTION							
1	TITLE SHEET						
2	INDEX OF SHEETS, STATE STANDARDS, AND GENERAL NOTES						
3	SUMMARY OF QUANTITIES						
4	EXISTING AND PROPOSED TYPICAL SECTIONS						
5	EXISTING SITE AND REMOVAL PLAN						
6	PROPOSED SITE AND PAVEMENT MARKING PLAN						
7	PROPOSED GRADING PLAN						
8	DRIVEWAY DETAILS - DISTANCE BETWEEN R.O.W AND FACE OF CURB & EDGE OF SHOULDER >= 15' (4.5 M) (BD-01)						

DISTRICT ONE TYPICAL PAVEMENT MARKING (TC-13)

SHEET

STANDARD NO. DESCRIPTION

 000001-08
 STANDARD SYMBOLS, ABBREVIATIONS, AND PATTERNS

 604001-05
 FRAME AND LIDS TYPE 1

 701006-05
 OFF-RD OPERATIONS, 2L, 2W, 15' (4.5M) TO 24" (600MM) FROM PAVEMENT EDGE

GENERAL NOTES

- 1. BEFORE STARING ANY EXCAVATION, THE CONTRACTOR SHALL CALL "JULIE" AT (800) 892-0123 OR 811 FOR FIELD LOCATIONS OF BURIED ELECTRIC TELEPHONE, AND GAS FACILITIES. (48 HOURS NOTIFICATION REQUIRED)
- 2. THE CONTRACTOR SHALL COORDINATE CONSTRUCTION ACTIVITIES WITH THE HILLSIDE TEAM SECTION TECHNICIAN FRANK M VITAGLIANO AT 708-544-9372.
- 3. THE CONTRACTOR WILL NOT BE ALLOWED TO SET UP A YARD OR FIELD OFFICE ON STATE (OR TOLLWAY) PROPERTY WITHOUT WRITTEN PERMISSION FROM THE DEPARTMENT (OR ISTHA).
- 4. BEFORE BEGINNING ANY WORK, THE CONTRACTOR SHALL RETAIN AND RECORD FOR FUTURE REFERENCE, ALL EXISTING PAVEMENT MARKING LINES IN ORDER THAT THESE LOCATIONS CAN BE RE-ESTABLISHED FOR STRIPING. EXACT LOCATIONS OF ALL PAVEMENT MARKINGS SHALL BE AS DIRECTED BY THE ENGINEER.
- IT SHALL BE THE CONTRACTOR'S RESPONSIBILITY TO VERIFY ALL DIMENSIONS AND CONDITIONS EXISTING IN THE FIELD PRIOR TO CONSTRUCTION AND ORDERING OF MATERIALS.
- THE CONTRACTOR SHALL BE REQUIRED TO PROVIDE ACCESS TO ABUTTING PROPERTY AT ALL TIMES DURING THE CONSTRUCTION OF THIS PROJECT.
- 7. EXISTING BROKEN FRAMES AND LIDS SHALL BE REMOVED AND DISPOSED OF BY THE CONTRACTORS AND SHALL BE REPLACED AS DIRECTED BY THE ENGINEER. REPLACEMENT FRAMES AND LIDS WILL BE PAID FOR ACCORDING TO ARTICLE 109.04 OF THE STANDARD SPECIFICATIONS UNLESS A SEPARATE PAY ITEM HAS BEEN PROVIDED.
- 8. BUTT JOINTS SHALL BE INSTALLED AT THE ENDS OF ALL RESURFACING (WHERE RESURFACING MEETS EXISTING PAVEMENT) ACCORDING TO THE "BUTT JOINT AND HOT-MIX ASPHALT TAPER DETAILS SHEET INCLUDED IN THE PLANS, UNLESS OTHERWISE SPECIFIED.
- 9. THE CONTRACTOR WILL BE REQUIRED TO KEEP A RECORD OF THE LOCATION OF PLATED STRUCTURE BY STATION AND OFFSET OR RIGHT OF THE CENTERLINE OF PAVEMENT
- 10. ALL MILLED SURFACE SHALL BE A UNIFORM CROSS SLOPE PER LANE AND FREE OF RIDGES BETWEEN PASSES, ANY DEVIATIONS SHALL BE CORRECTED AT NO COST TO THE DEPARTMENT.
- 11. THE CONTRACTOR SHALL BE REQUIRED TO KEEP A RECORD OF THE LOCATIONS OF THE BURIED STRUCTURES ACCORDING TO THE STATIONS AND DISTANCE LEFT OR RIGHT OF THE CENTERLINE OF PAVEMENT. UPON COMPLETION OF THE WORK, THE CONTRACTOR SHALL DELIVER THE RECORD TO THE ENGINEER.

			_
USER NAME = addis.abebaw	DESIGNED -	REVISED -	Ī
	DRAWN -	REVISED -	
PLOT SCALE = \$SCALE\$	CHECKED -	REVISED -	
PLOT DATE = 12/10/2024	DATE -	REVISED -	L

STATE OF ILLINOIS
DEPARTMENT OF TRANSPORTATION

SCALE:

INDEX OF SHEETS, STATE STANDARDS, GENERAL NOTES
HILLSIDE MAINTENANCE YARD

SHEET OF SHEETS STA. TO STA.


INDEX OF SHEETS STA.

COUNTY


			CONSTRUCTION TYPE CODE							
		SUM	MARY OF QUANT	ITIES			100% STATE			
CODE NO.			ITEM		UNIT	TOTAL QUANTITY	0004 URBAN			
20200100	EARTH EXC	AVATION		77	CUYD	1918	1918	0		0
31101400	SUBBASE G	RANULAR MATERIAL, TYPE B 6			SQ YD	11507	11507	0		0
40600275	BITUMINOUS	MATERIALS (PRIME COAT)			POUND	25891	25891	0		0
40600290	BITUMINOUS	MATERIALS (TACK COAT)			POUND	2574	2574	0		0
40603085	HOT-MIX ASI	PHALT BINDER COURSE, IL-19.	0, N70		TON	1922	1922	0		0
40604062	HOT-MIX ASI	PHALT SURFACE COURSE, IL-9	.5, MIX "D", N70	_	TON	961	961	0		0
42000060	WELDED W	IRE REINFORCEMENT			SQ YD	316	316	0		0
42000300	PORTLAND	CEMENT CONCRETE PAVEMEN	NT 8"		SQ YD	316	316	0		0
42001300	PROTECTIV	E COAT			SQ YD	316	316	0		0
44000100	PAVEMENT	REMOVAL			SQ YD	11508	11508	0		0
66900200	NON-SPECIAL WASTE DISPOSAL					1625	1625	0		0
66900530	SOIL DISPO	SAL ANALYSIS			EACH	3	3	0		0
66901001	REGULATED) SUBSTANCES PRE-CONSTRU	JCTION PLAN		L SUM	1	1	0		0
66901006	REGULATED	SUBSTANCES MONITORING			CAL DA	6	6	0		0
67100100	MOBILIZATIO	N			L SUM	1	1	0		0
78000200	THERMOPLA	ASTIC PAVEMENT MARKING - LII	NE 4"	_	FOOT	250	250	0		0
X5537800	STORMSEV	VERS TO BE CLEANED 12"			FOOT	400	400	0		0
X6700407	ENGINEER'S	FIELD OFFICE, TYPE A (D1)			CAL MO	6	6	0		0
Z0013798	CONSTRUC	TION LAYOUT			L SUM	1	1	0		0
Z0018400	DRAINAGE S	STRUCTURES TO BE ADJUSTE	0		EACH	4	4	0		0
Z0018500	DRAINAGE S	STRUCTURES TO BE CLEANED			EACH	6	6	0		0
		USER NAME = addis.abebaw	DESIGNED - DRAWN -	REVISED - REVISED -		STATE C	OF ILLINOIS			SU HILL
		PLOT SCALE = \$SCALE\$ PLOT DATE = 12/4/2024	CHECKED - DATE -	REVISED - REVISED -	_	DEPARTMENT OF	TRANSPORTATION		SCALE:	SHEET

* SPECIALTY ITEMS

SUMMARY OF QUANTITIES					SECTION		COUNTY	TOTAL SHEETS	SHEET NO.
HILLSIDE MAINTENANCE YARD				3019	2023 - 943-l		соок	9	3
							CONTRACT	ΓNO.	62W63
OF	SHEETS	STA.	TO STA.		ILLING	S FED. A	ID PROJECT		

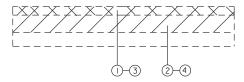

EXISTING TYPICAL SECTION (PAVEMENT RECONSTRUCTION)

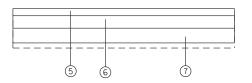

PROP. TYPICAL SECTION (PAVEMENT RECONSTRUCTION)

LEGEND


- EXISTING HMA PAVEMENT 5"
- 2 EXISTING SUBGRADE
- (3) PROPOSED PAVEMENT REMOVAL
- (4) PROPOSED SUBGRADE REMOVAL (EARTH EXCAVATION)- 6"
- (5) PROPOSED HOT-MIX ASPHALT SURFACE COURSE, MIX 'D', N70 (IL-9.5 MM), I-1/2"
- 6 PROPOSED HOT-MIX ASPHALT BINDER COURSE, IL-19.0, N70, 3"
- 7 PROPOSED SUBBASE GRANULAR MATERIAL TYPE B, 6"

HOT-MIX ASPHALT MIXTURE REQUIREMENTS		OUALITY MANAGEMENT			
MIXTURE TYPE	AIR VOIDS(%) • Noes.	PROGRAM (OMP)			
PAVEMENT RECONSTRUCTION					
HOT-MIX ASPHALT SURFACE COURSE, MIX "D", N70 (IL-9.5 MM), I1/2"	4% @ 70 GYR	QC/QA			
HOT-MIX ASPHALT BINDER COURSE, IL-19.0, N70, 3°	4% @ 70 GYR	QC/QA			
QMP DESIGNATION: QUALITY CONTROL/QUALITY ASSURANCE(QA/QC); QUALITY CONTROL F PAY FOR PERFORMANCE(PFP)	FOR PERFORMANCE	(QCP);			

THE UNIT WEIGHT USED TO CALCULATE ALL HMA SURFACE MIXTURE QUANTITIES IS 112 LBS/SQ YD/IN.

THE "AC TYPE" FOR POLYMERIZED HMA MIXES SHALL BE "SBS/SBR PG 76-22" AND FOR NON-POLYMERIZED HMA THE "AC TYPE" SHALL BE "PG 64-22" UNLESS MODIFIED BY RECLAIMED MATERIALS SPECIFICATIONS.

USER NAME = addis.abebaw	DESIGNED -	REVISED -	STATE OF ILLINOIS	HILLSIDE MAINTENANCE YARD						MS RTF	SECTION	COUNT	Y TOTAL	. SHEET
	DRAWN -	REVISED -	STATE OF ILLINOIS							3019	2023 - 943-I	соок	9	4
	CHECKED -	REVISED -	DEPARTMENT OF TRANSPORTATION	TIFICAL SECTION							CONTR	ACT NO.	62W63	
PLOT DATE = 11/22/2024	DATE -	REVISED -		SCALE:	SHEET	OF	SHEETS STA. TO STA.			ILLINOIS	ED. AID PROJECT			

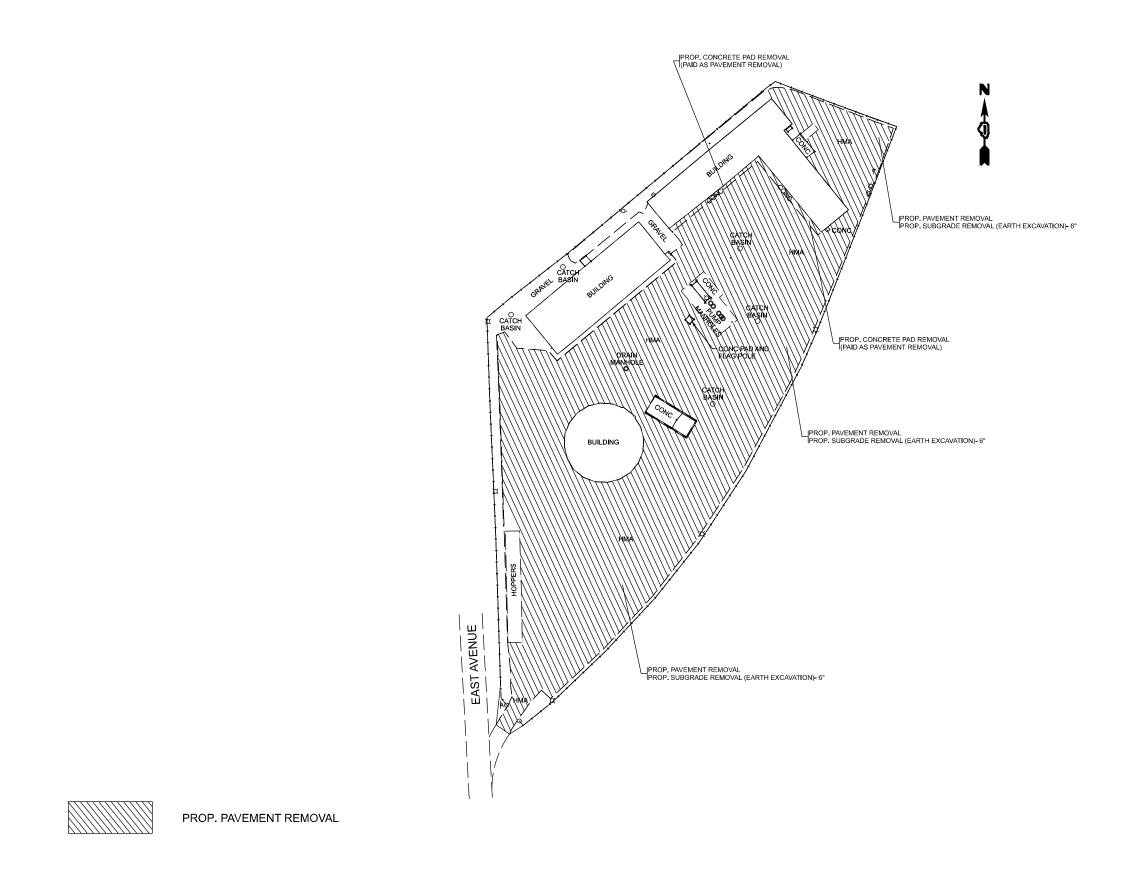

.: Hillside Maintenance Yard [Sheet] AMF: c:\nw_work\nwidot\abebawa\d1019427\D11562.

 USER NAME
 = addis.abebaw
 DESIGNED
 REVISED

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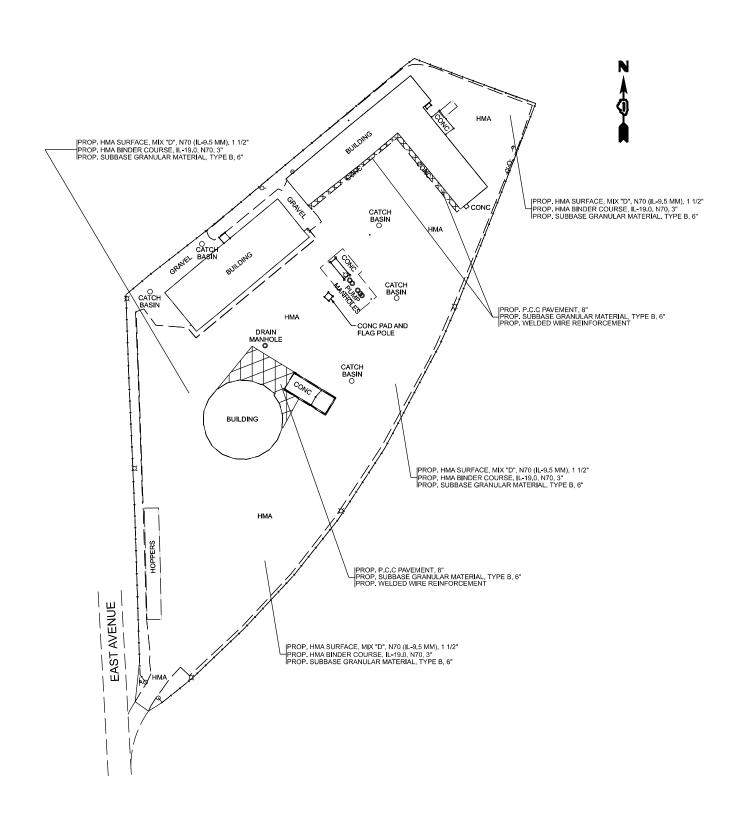
 CHECKED
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 PLOT DATE
 = 12/4/2024
 DATE
 REVISED

STATE OF ILLINOIS
DEPARTMENT OF TRANSPORTATION

HILLSIDE MAINTENANCE YARD
EXISTING SITE AND REMOVAL PLAN

SHEET OF 2 SHEETS STA. TO STA.





PROP. PCC PAVEMENT

 USER NAME
 = addis.abebaw
 DESIGNED
 REVISED


 DRAWN
 REVISED

 CHECKED
 REVISED

 PLOT DATE
 = 12/4/2024
 DATE
 REVISED

STATE OF ILLINOIS DEPARTMENT OF TRANSPORTATION HILLSIDE MAINTENANCE YARD PROPOSED SITE PLAN

SHEET OF SHEETS STA. TO STA.

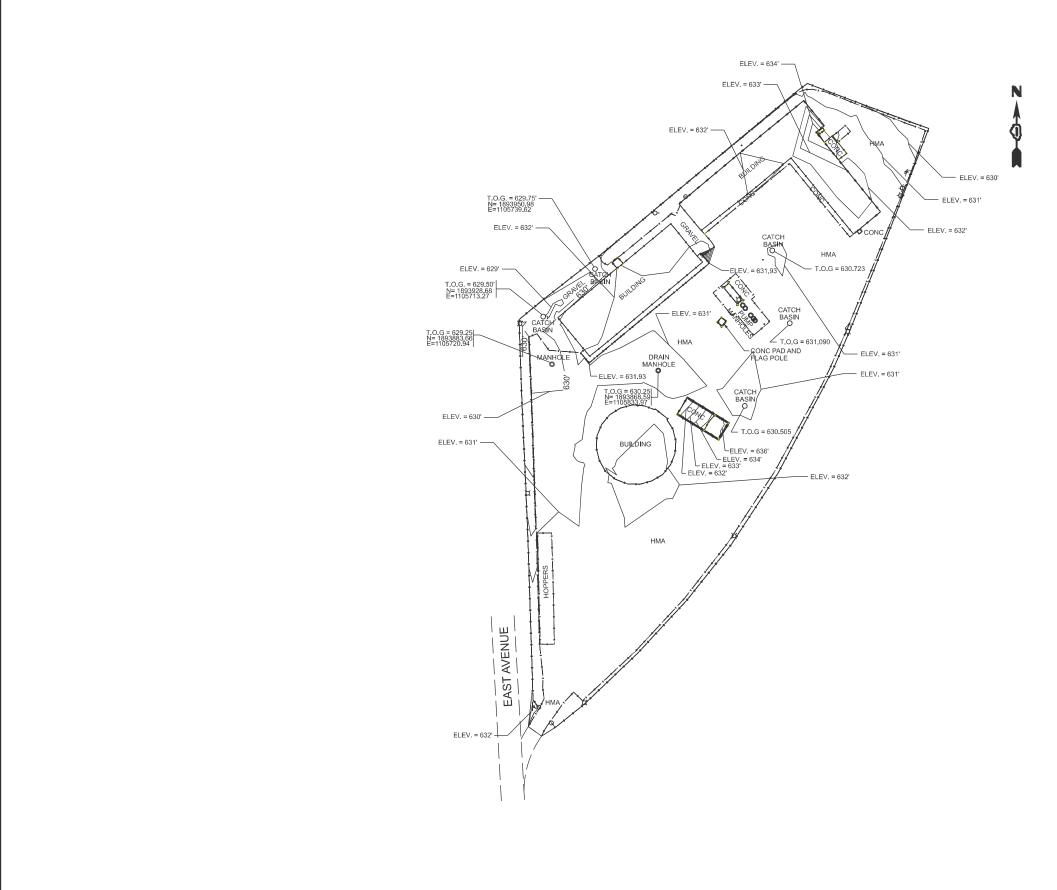

MODEL: Landscape Plan [Sneet]
FILE NAME: c:\pw_work\pwidot\abebawa\c

 USER NAME
 = addis.abebaw
 DESIGNED
 REVISED

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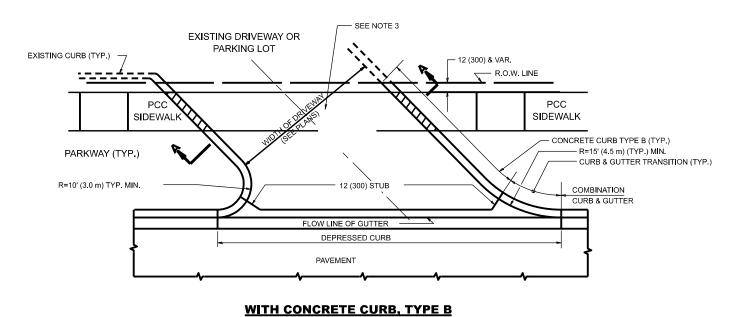
 PLOT DATE
 = 11/26/2024
 DATE
 REVISED


STATE OF ILLINOIS
DEPARTMENT OF TRANSPORTATION


HILLSIDE MAINTENANCE YARD
GRADING PLAN


SHEET OF 2 SHEETS STA. TO STA.

WITH CONCRETE CURB, TYPE B



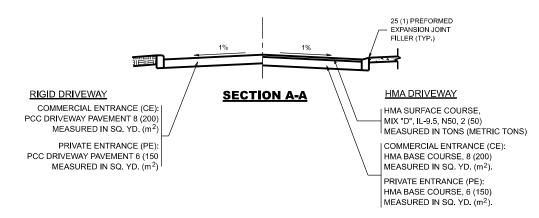

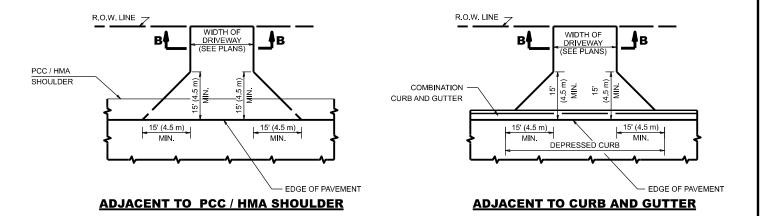

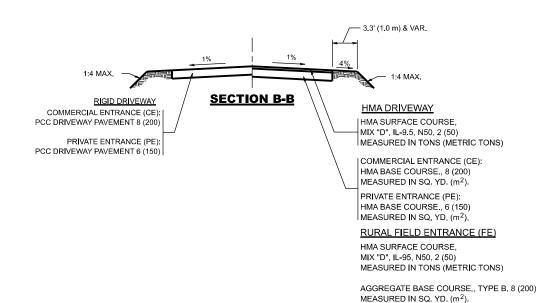



GENERAL NOTES

- DRIVEWAY SLOPES, LOCATIONS, & GEOMETRIC LAYOUT SHALL BE IN ACCORDANCE WITH THE LATEST EDITION OF THE "HANDBOOK FOR POLICY ON PERMITS FOR ACCESS DRIVEWAYS TO STATE HIGHWAYS". FOR FURTHER LAYOUT REQUIREMENTS, REFER TO ILLUSTRATIONS IN THE PERMIT HANDBOOK. DRIVEWAYS SHALL BE REPLACED IN KIND, UNLESS OTHERWISE NOTED ON THE PLANS.
- 2. COMMERCIAL DRIVEWAYS SHALL BE CONSTRUCTED WITH CONCRETE CURB, TYPE B RETURNS EXCEPT WHEN THE SIDEWALK EDGE IS 4 FEET (1.2 METERS) OR LESS FROM THE BACK OF CURB, CONSTRUCT A FLARE DRIVEWAY WITHOUT CURB.


ALL DIMENSIONS ARE IN INCHES (MILLIMETERS) UNLESS OTHERWISE NOTED.

USER NAME = eric.l.thomas	DESIGNED - R. SHAH	REVISED - R. BORO 06-11-08		DRIVEWAY DETAILS - DISTANCE BETWEEN R.O.W.					MS RTF	SECTION	COUNTY	TOTAL	SHEET NO.	
	DRAWN -	REVISED - R. BORO 09-06-11	STATE OF ILLINOIS							3019	2023-943-I	соок	9	8
PLOT SCALE = \$SCALE\$	CHECKED -	REVISED - K. SMITH 08-28-19	DEPARTMENT OF TRANSPORTATION	ANDF	AND FACE OF CURB & EDGE OF SHOULDER >15'(4.5m)		AND FACE OF CURB & EDGE OF SHOULDER >15 (4.5m)		:K >15 (4.5M)	BD40	0-01 (BD-01)	CONTRACT	ΓNO. 62V	V63
PLOT DATE = 8/30/2023	DATE - 11-04-95	REVISED - K. SMITH 11-18-22		SCALE: NONE	SHEET 1	OF 1	SHEETS	STA.	TO STA.			D PROJECT		

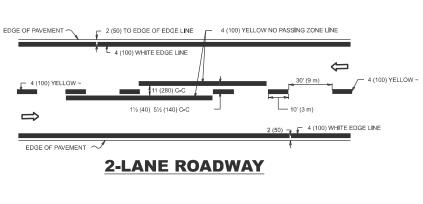


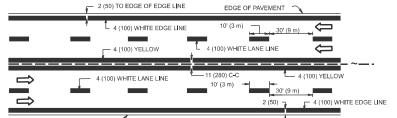

MULTI-LANE UNDIVIDED

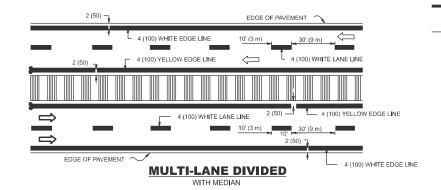

TYPICAL LANE AND EDGE LINE MARKING

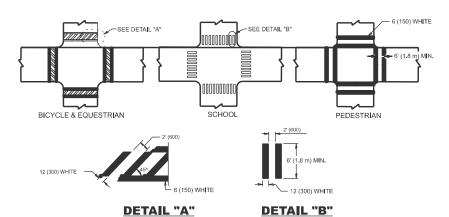


TYPICAL CROSSWALK MARKING

* MARKINGS SHALL BE INSTALLED PARALLEL TO THE CENTERLINE OF THE ROAD WHICH IT CROSSES

TWO-4 (100) YELLOW @ 11 (280) C-C 4' (1.2 m) OUTS IDE TO


4' (1.2 m) WIDE MEDIANS ONLY

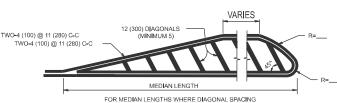


CANNOT BE ATTAINED, USE 5 (FIVE) EQUALLY SPACED DIAGONAL LINES.

50' (15 m) C-C (LESS THAN 30MPH (50 km/h)) 75' (25 m) C-C 30MPH (50 km/h) TO 45MPH (70 km/h)) 150' (45 m) C-C (MORE THAN 45MPH (70 km/h))


MEDIANS OVER 4' (1.2 m) WIDE

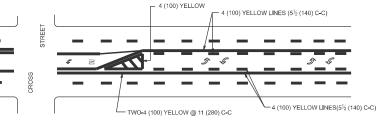

A MINIMUM OF TWO PAIRS OF TURN ARROWS SHALL BE USED, WHITE IN COLOR. ADDITIONAL PAIRS SHALL BE PLACED AT 200' (60 m) TO 300' (90 m) INTERVALS.

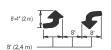

MEDIAN WITH TWO-WAY LEFT TURN LANE TYPICAL PAINTED MEDIAN MARKING

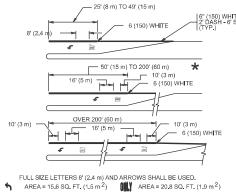


★ TURN LANES IN EXCESS OF 400' (120 m) IN LENGTH MAY HAVE AN ADDITIONAL SET OF ARROW - "ONLY" INSTALLED MIDWAY BETWEEN THE OTHER TWO SETS OF


TYPICAL LEFT (OR RIGHT) TURN LANE

TYPICAL TURN LANE MARKING


@ 10' (3 m) OR LESS SPACING **ISLAND OFFSET FROM PAVEMENT EDGE**

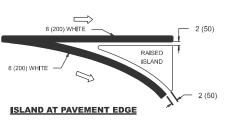

TYPICAL ISLAND MARKING

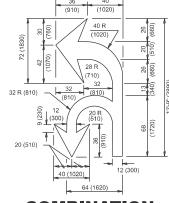

COMBINATION **LEFT AND U-TURN**

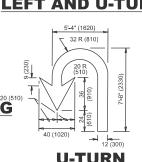

LANE REDUCTION TRANSITION

SPEED LIMIT

		U-	<u>rurn</u>	★ LANE REDUCTION ARROWS REQUIRED AT SPEEDS OF 45 MPH OF GREATER OR WHEN SPECIFIED IN PLANS.
TYPE OF MARKING	WIDTH OF LINE	PATTERN	COLOR	SPACING / REMARKS
CENTERLINE ON 2 LANE PAVEMENT	4 (100)	SKIP-DASH	YELLOW	10' (3 m) LINE WITH 30' (9 m) SPACE
CENTERLÍNE ON MULTI-LANE UNDÍVÍDED PAVEMENT	2 @ 4 (100)	SOLID	YELLOW	11 (280) C-C
NO PASSING ZONE LINES: FOR ONE DIRECTION FOR BOTH DIRECTIONS	4 (100) 2 @ 4 (100)	SOLID SOLID	YELLOW YELLOW	5½ (140) C-C FROM SKIP-DASH CENTERLINE 11 (280) C-C OMIT SKIP-DASH CENTERLINE BETWEEN
LANE LINES	4 (100) 5 (125) ON FREEWAYS	SKIP-DASH SKIP-DASH	WHITE WHITE	10' (3 m) LINE WITH 30' (9 m) SPACE
DOTTED LINES (EXTENSIONS OF CENTER, LANE OR TURN LANE MARKINGS)	SAME AS LINE BEING EXTENDED	SKIP-DASH	SAME AS LINE BEING EXTENDED	2' (600) LINE WITH 6' (1.8 m) SPACE
EDGE LINES	4 (100)	SOLID	YELLOW-LEFT WHITE-RIGHT	OUTLINE MEDIANS IN YELLOW
TURN LANE MARKINGS	6 (150) LINE; FULL SIZE LETTERS & SYMBOLS (8' (2.4m))	SOLID	WHITE	SEE TYPICAL TURN LANE MARKING DETAIL
TWO WAY LEFT TURN MARKING	2 @ 4 (100) EACH DIRECTION 8' (2.4m) LEFT ARROW	SKIP-DASH AND SOLID IN PAIRS	YELLOW	10' (3 m) LINE WITH 30' (9 m) SPACE FOR SKIP-DASH; 5'5 (140) C-C BETWEEN SOLID LINE AND SKIP-DASH LINE SEE TYPICAL TWO-WAY LEFT TURN MARKING DETAIL
CROSSWALK LINES (PEDESTRIAN) A. DIAGONALS (BIKE & EQUESTRIAN) B. LONGITUDINAL BARS (SCHOOL)	2 @ 6 (150) 12 (300) @ 45° 12 (300) @ 90°	SOLID SOLID SOLID	WHITE WHITE WHITE	NOT LESS THAN 6' (1.8 m) APART 2' (600) APART 2' (600) APART SEE TYPICAL CROSSWALK MARKING DETAILS.
STOP LINES	24 (600)	SOLID	WHITE	PILACE 4" (12 m) IN ADVANCE OF AND PARALLEL TO CROSSWAM, IF PRESENT, OTHERWISE, PLACE AT DESIRED STOPPING POINT, PARALLEL TO CROSSROAD CENTERLINE, WHERE POSSIBLE
PAINTED MEDIANS	2 @ 4 (100) WITH 12 (300) DIAGONALS @ 45° NO DIAGONALS USED FOR 4' (1.2 m) WIDE MEDIANS	SOLID	YELLOW: TWO WAY TRAFFIC WHITE: ONE WAY TRAFFIC	11 (280) C-C FOR THE DOUBLE LINE SEE TYPICAL PAINTED MEDIAN MARKING.
GORE MARKING AND CHANNELIZING LINES	8 (200) WITH 12 (300) DIAGONALS @ 45°	SOLID	WHITE	DIAGONALS: 15' (4.5 m) C-C (LESS THAN 30MPH (50 km/h)) 20' (6 m) C-2 30MPH (50 km/h) TO 45MPH (70 km/h)) 30' (9 m) C-C (OVER 45MPH (70 km/h))
RAILROAD CROSSING	24 (600) TRANSVERSE LINES; "RR" IS 6' (1.8 m) LETTERS; 16 (400) LINE FOR "X"	SOLID	WHITE	SEE STATE STANDARD 780001 AREA OF: "X"=3.6 SQ. FT. (0.33 m ²) EACH "X"=54.0 SQ. FT. (5.0 m ²)
SHOULDER DIAGONALS (REQUIRED FOR SHOULDERS $\geq 8^{\circ}$)	12 (300) @ 45°	SOLID	WHITE - RIGHT YELLOW - LEFT	50' (15 m) C-C (LESS THAN 30MPH (50 km/h)) 75' (25 m) C-C (30 MPH (50 km/h) TO 45MPH (70 km/h)) 150' (45 m) C-C (OVER 45MPH (70 km/h))
U TURN ARROW	SEE DETAIL	SOLID	WHITE	16.3 SF
2 ARROW COMBINATION LEFT AND U TURN	SEE DETAIL	SOLID	WHITE	30.4 SF

FOR FURTHER DETAILS ON PAVEMENT MARKING REFER TO STANDARD SPECIFICATIONS FOR ROAD AND BRIDGE CONSTRUCTION AND STATE STANDARD 780001.

All dimensions are in inches (millimeters) unless otherwise shown.

USER NAME = eric.l.thomas	DESIGNED - EVERS	REVISED	-	C. JUCIUS 09-09-09
	DRAWN -	REVISED	-	C. JUCIUS 07-01-13
PLOT SCALE = \$SCALE\$	CHECKED -	REVISED	-	C. JUCIUS 12-21-15
PLOT DATE = 8/30/2023	DATE - 03-19-90	REVISED	_	C. JUCIUS 04-12-16

STATE OF ILLINOIS DEPARTMENT OF TRANSPORTATION

	DIS	TRICT O	NE		MS RTE.	SECTION		COUNTY	TOTAL SHEETS	SHEE NO.	
TYPICAL PAVEMENT MARKINGS				3019	2023-943-	COOK	9	9			
I I FICAL PAVEIMENT MARKINGS					TC-13 CONTRACT NO. 6						
HEET 1	OF 1	SHEETS	STA.	TO STA.		ILLING	S FED. AI	D PROJECT			