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STATE OF ILLINOIS
DEPARTMENT OF TRANSPORTATION

D-91-026-18



LOCATION OF SECTION INDICATED THUS:

PROPOSED HIGHWAY PLANS


**FAP 307 : IL ROUTE 64** 

EAST OF IL ROUTE 47 TO RANDALL ROAD

SECTION: 2018-084-RS

PROJECT: NHPP-50H4(804)
RESURFACING (SMART) & PEDESTRIAN RAMPS

KANE COUNTY C-91-225-19

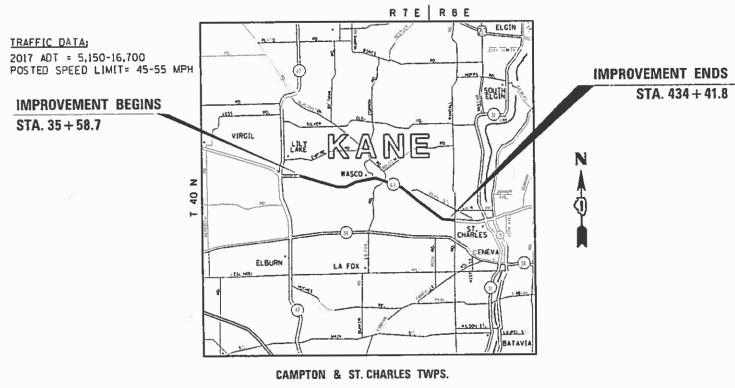

GROSS LENGTH OF IMPROVEMENT = 39,883 LINEAL FT = 7.55 MILES

NET LENGTH OF IMPROVEMENT = 39,883 LINEAL FT = 7.55 MILES

FOR INDEX OF SHEETS, SEE SHEET NO. 2

THE PROJECT IS LOCATED IN VILLAGES OF LILY LAKE, CAMPTON HILLS AND CITY OF ST. CHARLES

0 100' 200' 300' -- 1" = 100'
0 10' 20' 30' -- 1" = 10'
0 50' 100' 1" = 50'
0 50' 100' -- 1" = 40'
0 58' 100' -- 1" = 30'

FULL SIZE PLANS HAVE BEEN PREPARED USING STANDARD ENGINEERING SCALES. REDUCED SIZED PLANS WILL NOT CONFORM TO STANDARD SCALES. IN MAKING MEASUREMENTS ON REDUCED PLANS, THE ABOVE SCALES MAY BE USED.

J.U.L.I.E.
JOINT UTILITY LOCATION INFORMATION FOR EXCAVATION
1-800-892-0123
OR 811

PROJECT MANAGER FAWAD AQUEEL (847) 705-4247
PROJECT ENGINEER DANIEL WILGREEN (847) 705-4240

CONTRACT NO. 62H32

STATE OF ILLINGIS
DEPARTMENT OF TRANSPORTATION

SUBMITTED DESIGN AND ENVIRONMENT

ENGINEER OF DESIGN AND ENVIRONMENT

PRINTED BY THE AUTHORITY OF THE STATE OF ILLINOIS

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**HIGHWAY STANDARDS** 

### **GENERAL NOTES**

BEFORE STARTING ANY EXCAVATION, THE CONTRACTOR SHALL CALL "J.U.L.I.E." AT (800) 892-0123 OR 811 FOR FIELD LOCATIONS OF BURIED ELECTRIC, TELEPHONE AND GAS UTILITIES. 48 HOUR NOTIFICATION IS REQUIRED.

THE CONTRACTOR SHALL COORDINATE CONSTRUCTION ACTIVITIES WITH UTILITY COMPANIES, CITY OF ST. CHARLE, VILLAGES OF LILY LAKE AND CAMPTON HILLS.

THE CONTRACTOR SHALL CONTACT THE DISTRICT ONE TRAFFIC CONTROL SUPERVISOR AT (847) 705-4470 A MINIMUM OF 72 HOURS IN ADVANCE OF BEGINNING WORK.

THE CONTRACTOR WILL NOT BE ALLOWED TO SET UP A YARD OR FIELD OFFICE ON STATE PROPERTY WITHOUT WRITTEN PERMISSION FROM THE DEPARTMENT.

ALL DAMAGE TO EXISTING PAVEMENT MARKINGS OR RAISED REFLECTIVE PAVEMENT MARKERS OUTSIDE THE REMOVAL LINE SHOWN ON THE PLANS SHALL BE REPLACED AT NO ADDITIONAL COST TO THE DEPARTMENT.

BEFORE BEGINNING ANY WORK, THE CONTRACTOR SHALL RETAIN AND RECORD FOR FUTURE REFERENCE, ALL EXISTING PAVEMENT MARKING LINES (AND RAISED REFLECTIVE PAVEMENT MARKERS) IN ORDER THAT THESE LOCATIONS CAN BE RE-ESTABLISHED FOR STRIPING. EXACT LOCATIONS OF ALL PAVEMENT MARKINGS SHALL BE AS DIRECTED BY THE ENGINEER.

ALL PAVEMENT PATCHING, CURB AND GUTTER REMOVAL AND REPLACEMENT, DRAINAGE ADJUSTMENT LOCATIONS WILL BE DETERMINED IN THE FIELD BY THE RESIDENT ENGINEER.

IT SHALL BE THE CONTRACTOR'S RESPONSIBILITY TO VERIFY ALL DIMENSIONS AND CONDITIONS EXISTING IN THE FIELD PRIOR TO CONSTRUCTION AND ORDERING OF MATERIALS.

THE RESIDENT ENGINEER SHALL CONTACT DON CHIARUGI, IDOT'S AREA TRAFFIC FIELD ENGINEER FOR KANE COUNTY, VIA E-MAIL AT DON.CHIARUGI@ILLINOIS.GOV AND AT (847) 741-9857, A MINIMUM OF TWO (2) WEEKS PRIOR TO THE PLACEMENT OF PERMANENT PAVEMENT MARKINGS.

THE CONTRACTOR SHALL BE REQUIRED TO PROVIDE ACCESS TO ABUTTING PROPERTY AT ALL TIMES DURING THE CONSTRUCTION OF THIS PROJECT.

DO NOT SCALE PLANS FOR CONSTRUCTION DIMENSIONS.

TEN (10) FOOT TRANSITIONS SHALL BE USED TO MATCH PROPOSED CURB AND GUTTER AND MEDIAN ITEMS OF WORK TO EXISTING CURBS AND GUTTER AND MEDIANS IN THE FIELD, UNLESS OTHERWISE SHOWN. THE TRANSITIONS SHALL BE PAID FOR AT THE CONTRACT UNIT PRICE FOR THE PROPOSED ITEMS OF WORK SPECIFIED.

PAVEMENT MARKING TAPE, TYPE III SHALL BE USED FOR SHORT TERM PAVEMENT MARKINGS ON ALL FINAL SURFACES. THE COST OF THE PAVEMENT MARKINGS TAPE, TYPE III REMOVAL SHALL BE INCLUDED IN THE COST OF TEMPORARY PAVEMENT MARKING REMOVAL.

WHEN THE MILLED PAVEMENT IS OPEN TO TRAFFIC THE MAXIMUM GRADE DIFFERENTIAL BETWEEN PASSES OF THE MILLING MACHINE SHALL NOT EXCEED 1½INCHES (40 mm) WHERE THE SPEED LIMIT IS 40 MPH (80 km/h) OR LESS AND 1 INCH (25 mm) WHERE THE SPEED LIMIT IS GREATER THAN 40 MPH (80 km/h). WITH WRITTEN APPROVAL OF THE ENGINEER, A MAXIMUM GRADE DIFFERENTIAL OF 3 INCHES (75 mm) MAY BE ALLOWED IF THE EDGE OF THE MILLING IS SLOPED A MINIMUM 1:3 (V:H).

BUTT JOINTS WILL BE INSTALLED AT THE ENDS OF ALL RESURFACING (WHERE RESURFACING MEETS EXISTING PAVEMENT) ACCORDING TO THE "BUTT JOINT AND HOT-MIX ASPHALT TAPER DETAILS" SHEET INCLUDED IN THE PLANS, UNLESS OTHERWISE SPECIFIED.

EXISTING BROKEN FRAMES AND LIDS SHALL BE REMOVED AND DISPOSED OF BY THE CONTRACTOR AND SHALL BE REPLACED AS DIRECTED BY THE ENGINEER, REPLACEMENT FRAMES AND LIDS WILL BE PAID FOR ACCORDING TO ARTICLE 109.04 OF THE STANDARD SPECIFICATIONS UNLESS A SEPARATE PAY ITEM HAS BEEN PROVIDED.

UNLESS OTHER CONDITIONS WARRANT EXTENDED LANE CLOSURE AS DETERMINED AND APPROVED IN WRITTING BY THE ENGINEER OR AS PROVIDED FOR IN THE CONTRACT SPECIFIATIONS, OVERNIGHT CLOSURES SHALL NOT BE ALLOWED FOR REHABILITATION PROJECTS INVOLVING DAYTIME MILLING AND RESURFACING OPERATIONS AND CLASS D PATCHING.

PROPOSED SIDEWALK RAMPS SHALL CONFORM TO CURRENT ADA REQUIREMENTS AND APPLICABLE STATE HIGHWAY STANDARDS OR AS DETERMINED BY THE ENGINEER.

THE BEGINNING OF STRIPED NO-PASSING ZONES SHALL COINCIDE WITH THE EXISTING SIGNING PANELS.

ALL PAVEMENT MARKING SHALL BE INSTALLED ACCORDING TO IDOT'S DISTRICT ONE DETAIL TC-13.

RAISED REFLECTIVE PAVEMENT MARKERS SHALL BE INSTALLED ACCORDING TO IDOT'S DISTRICT ONE DETAIL TC-11.

CONTACT THE IDOT ROADSIDE DEVELOPMENT UNIT AT 847-705-4171 AT LEAST 2 WEEKS PRIOR TO BEGINNING LANDSCAPE AND FORESTRY WORK FOR LAYOUT.

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# STATE OF ILLINOIS DEPARTMENT OF TRANSPORTATION

CODE NO 20100110	SUMMARY OF QUANTITIES  ITEM				CO	NSTRUCT:	ION TYPE CODE								CC	NSTRUCTI	ON TYPE	CODE	
	ITEM						TON THE CODE			SUMMA	RY OF QUANTITIES						ON THE	JULE	
20100110		UNIT	TOTAL QUANTITIES	80% FED 20%STATE					CODE NO		ITEM	UNIT	TOTAL	80% FED 20%STATE					
20100110				0005					40007505					0005					
	TREE REMOVAL (6 TO 15 UNITS DIAMETER)	UNIT	103	103					40603565	POLYMERIZED	HOT-MIX ASPHALT SURFACE	TON	20820	20820					_
										COURSE, MIX	"E", N70								
20100210	TREE REMOVAL (OVER 15 UNITS DIAMETER)	UNIT	156	156															
									42001300	PROTECTIVE C	COAT	SQ YD	100	100					
20101350	TREE PRUNING (OVER 10 INCH DIAMETER)	EACH	2	2															
									42400200	PORTLAND CEM	MENT CONCRETE SIDEWALK 5	SO FT	740	740					
20200100	EARTH EXCAVATION	CU YD	36	36						INCH									
	TOPSOIL FURNISH AND PLACE, 4"	SO YD	52	52				,	* 42400800	DETECTABLE W	WARNINGS	SO FT	88	88					
21400100	GRADING AND SHAPING DITCHES	FOOT	750	750															
25000400	NITROGEN FERTILIZER NUTRIENT	POUND	1	1					44000156	HOT-MIX ASPH	HALT SURFACE REMOVAL, 1	SQ YD	212445	212445					
25000210	SEEDING, CLASS 2A	ACRE	0.04	0.04						3/4"									
25000500	PHOSPHORUS FERTILIZER NUTRIENT	POUND	1	1															
									44000600	SIDEWALK REM	MOVAL	SO FT	450	450					
25000600	POTASSIUM FERTILIZER NUTRIENT	POUND	1	1															
									44004250	PAVED SHOULD	DER REMOVAL	SQ YD	6	6					
25003312	INTERSEEDING, CLASS 4A	ACRE	3. 638	3. 638															
25100630	EROSION CONTROL BLANKET	SQ YD	170	170					44201765	CLASS D PATO	CHES. TYPE II. 10 INCH	SQ YD	37	37					
25200110	SODDING, SALT TOLERANT	SQ YD	52	52															
									44201803	CLASS D PATO	CHES, TYPE II, 13 INCH	SQ YD	100	100					
25200200	SUPPLEMENTAL WATERING	UNIT	1	1															
									44201807	CLASS D PATO	CHES, TYPE III, 13 INCH	SO YD	20	20					
40600290	BITUMINOUS MATERIALS (TACK COAT)	POUND	95600	95600															
									48102100	AGGREGATE WE	EDGE SHOULDER, TYPE B	TON	2	2					
40600400	MIXTURE FOR CRACKS, JOINTS, AND	TON	319	319					60250200	CATCH BASIN TO	O BE ADJUSTED	EACH	10	10					
	FLANGEWAYS								64200108	SHOULDER RUN	MBLE STRIPS, 8 INCH	FOOT	7500	7500					
40600982	HOT-MIX ASPHALT SURFACE REMOVAL - BUTT	SO YD	930	930				;	* 66900200	NON-SPECIAL	WASTE DISPOSAL	CU YD	36	36					
	JOINT																		
									<del>*</del> 66900530	SOIL DISPOSA	AL ANALYSIS	EACH	3	3					
									*	SPECIALTY IT	TEMS								
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		ECKED -		REVISED REVISED			DEPARTM	TENT OF T	RANSPORTA <sup>-</sup>	ΓΙΟΝ	SCALE: SHEET NO. OF			TO STA.			ILLINOIS FED. AI	CONTRACT	T NO. 62H32

			URBAN					T T				UKBAN					
	SUMMARY OF QUANTITIES		<u> </u>	CONSTRUC	CTION TYPE	CODE	Τ	_	SUMMAF	RY OF QUANTITIES				CONS	RUCTION TYPE	CODE	
CODE NO	ITEM	UNIT	TOTAL 80% FED OUANTITIES 20%STATE	E				CODE NO		ITEM	UNIT	TOTAL QUANTITIES	80% FED 20%STATE				
			0005										0005				
66901001	REGULATED SUBSTANCES PRE-CONSTRUCTION	LSUM	1 1					70102635	TRAFFIC CONT	ROL AND PROTECTION,	L SUM	1	1				
	PLAN								STANDARD 701	701							
66901002	ON-SITE MONITORING OF REGULATED	CAL DA	10 10					70102640	TRAFFIC CONT	ROL AND PROTECTION,	L SUM	1	1				
	SUBSTANCES								STANDARD 701	801							
66901003	REGULATED SUBSTANCES FINAL CONSTRUCTION	LSUM	1 1					70300100	SHORT TERM P	AVEMENT MARKING	FOOT	33085	33085				
	REPORT																
								70300150	SHORT TERM P	AVEMENT MARKING REMOVAL	SQ FT	11028	11028				
67000400	ENGINEER'S FIELD OFFICE. TYPE A	CAL MO	6 6														
								70300210	TEMPORARY PA	VEMENT MARKING LETTERS AND	SQ FT	2260	2260				
67100100	MOBILIZATION	L SUM	1 1						SYMBOLS								
70100450	TRAFFIC CONTROL AND PROTECTION.	L SUM	1 1					70300220	TEMPORARY PA	VEMENT MARKING - LINE 4"	FOOT	158560	158560				
	STANDARD 701201																
								70300240	TEMPORARY PA	VEMENT MARKING - LINE 6"	FOOT	10235	10235				
70100460	TRAFFIC CONTROL AND PROTECTION,	L SUM	1 1														
	STANDARD 701306							70300250	TEMPORARY PA	VEMENT MARKING - LINE 8"	FOOT	1050	1050				
70100600	TRAFFIC CONTROL AND PROTECTION.	L SUM	1 1					70300260	TEMPORARY PA	VEMENT MARKING - LINE 12"	FOOT	2175	2175				
	STANDARD 701336																
								70300280	TEMPODADY DA	VEMENT MARKING - LINE 24"	FOOT	950	950				
								70300280	IEMPORARI FA	VEMENT MARKING - LINE 24	7001	330	350				
70102622	TRAFFIC CONTROL AND PROTECTION,	L SUM	1 1														
	STANDARD 701502							70300520	PAVEMENT MAR	KING TAPE, TYPE III 4"	FOOT	16542	16542				
70102625	TRAFFIC CONTROL AND PROTECTION.	L SUM	1 1					* 78000100	THERMOPLASTI	C PAVEMENT MARKING -	SO FT	2260	2260				
	STANDARD 701606								LETTERS AND	SYMBOLS							
70102632	TRAFFIC CONTROL AND PROTECTION,	L SUM	1 1					<b>*</b> 78000200	THERMOPLASTI	C PAVEMENT MARKING - LINE	FOOT	158560	158560				
	STANDARD 701602							*	4"	FMS							
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	PLOT DATE = 12/12/2018 DA	TE -	REVISED	-						SCALE: SHEET NO. OF	SHEETS STA.	T	O STA.	FED. ROAD DI	ST. NO. 1   ILLINOIS   FED.		

### CODE NUMBER: 20100110

TREE REMOVAL (6 T	O 15 UNITS DIAME	TER)
STATION	QUANTITY	REMARKS
55+10 RT	7 UNITS	
82+80 LT	46 UNITS	14", 12", 12", 8"
186+70 LT	10 UNITS	
312+15 LT	40 UNITS	7'', 13'', 10'', 10''
TOTAL	103 UNITS	

### CODE NUMBER: 20100210

TREE REMOVAL (OV	ER 15 UNITS DIAM	ETER)
STATION	QUANTITY	REMARKS
90+80 RT	33 UNITS	15′′• 18′′
115+60 LT	42 UNITS	
311+15 LT	28 UNITS	
312+15 LT	53 UNITS	16", 20", 17"
TOTAL	156 UNITS	

### CODE NUMBER: 20101350

TREE PRUNING (OVER 10 INCH DIAMETER)									
STATION	QUANTITY	REMARKS							
56+20 LT	1 EACH	NORWAY MAPLE							
222+85 LT	1 EACH	BLACK WALNUT							
TOTAL	2 EACH								

### CODE NUMBER: X2010350

TREE REMOVAL	, ACRES (SPECIAL)	
STATION	QUANTITY	AREA
58+50 TO 66+50 RT	0.344 ACRE	20 FT X 750 F1
67+00 TO 74+40 LT	0.192 ACRE	10 FT X 840 FT
77+50 TO 81+15 LT	0.084 ACRE	10 FT X 365 FT
131+30 TO 133+55 RT	0.077 ACRE	15 FT X 225 FT
137+00 TO 138+40 LT	0.064 ACRE	20 FT X 140 FT
144+80 TO 145+30 RT	0.022 ACRE	20 FT X 50 FT
163+25 TO 164+25 RT	0.022 ACRE	10 FT X 100 FT
195+30 TO 196+80 LT	0.035 ACRE	10 FT X 150 FT
200+40 TO 217+10 LT	0.958 ACRE	25 FT X 1670 F
223+50 TO 227+90 RT	0.202 ACRE	20 FT X 440 F
245+80 TO 248+70 LT	0.166 ACRE	25 FT X 290 F
278+70 TO 292+00 LT	0.458 ACRE	15 FT X 1330 F
291+20 TO 296+90 RT	0.240 ACRE	18 FT X 570 FT
299+00 TO 306+00 LT	0.241 ACRE	15 FT X 700 F
336+00 TO 344+50 RT	0.293 ACRE	15 FT X 850 F
392+40 TO 393+60 LT	0.055 ACRE	20 FT X 120 FT
409+40 TO 410+10 LT	0.032 ACRE	20 FT X 70 FT
TOTAL	3.638 ACRE	

### CODE NUMBER: 25003312


INTERSEEDING, CLASS 4A								
STATION	QUANTITY	REMARKS						
AREAS OF TREE REMOVAL, ACRES (SPECIAL)	3.638 ACRE							


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NOTE: CONTACT THE IDOT ROADSIDE DEVELOPMENT UNIT AT 847-705-4171 AT LEAST 2 WEEKS PRIOR TO BEGINNING LANDSCAPE AND FORESTRY WORK FOR LAYOUT.


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ı		PLOT DATE = 12/11/2018	DATE -	REVISED -	

		SC	HEDU	LE OF Q	FAP RTE.	SECTION	COUNTY		
ROIII	TF 64	/FAST	OF I	L ROUTE	307	2018-084-RS	KANE		
		(LAOI	01 1	LIIOOIL	77 10	HANDALL HOAD,			CONTRAC
	SHEET	NO	OF	SHEETS	STA	TO STA.	EED D	OAD DICT NO 1 THE INDIC EED AT	D BBO IECT



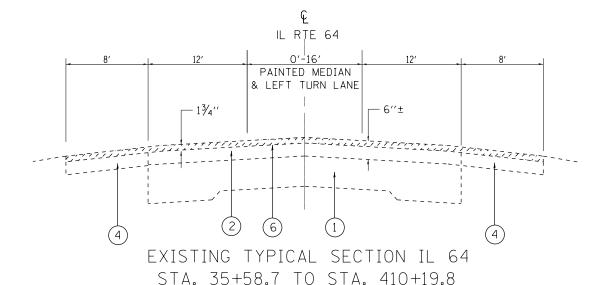

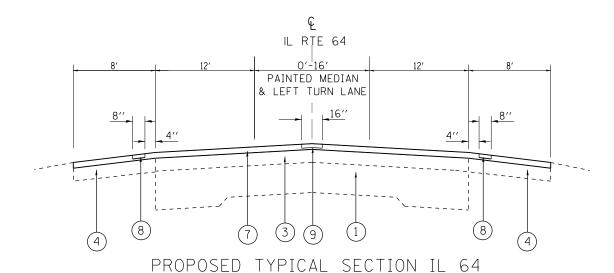STA. 35+58.7 TO STA. 80+00

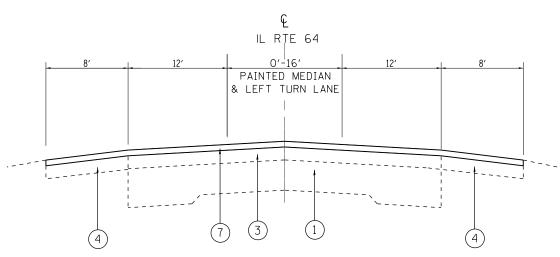

PROPOSED TYPICAL SECTION IL 64 STA. 80+00 TO STA. 410+19.8

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# STATE OF ILLINOIS DEPARTMENT OF TRANSPORTATION

## LEGEND

- 1) EXISTING P.C.C. PAVEMENT, 9"±
- 2) EXISTING HOT-MIX ASPHALT SURFACE, 6"±
- (3) EXISTING HMA SURFACE OVERLAY AFTER MILLING, 4 1/4"±
- (4) EXISTING HOT-MIX ASPHALT SHOULDER, 8"
- (5) EXISTING COMB. CONCRETE CURB AND GUTTER
- (6) PROPOSED HMA SURFACE REMOVAL, 1 3/4"
- (7) PROPOSED POLY. HOT-MIX ASPHALT SURFACE COURSE, MIX "E", N70, 1 3/4"
- (8) PROPOSED SHOULDER RUMBLE STRIPS, (8" WIDE)
- 9 PROPOSED CENTER LINE RUMBLE STRIPS, (16" WIDE)

### NOTES:

FOR THE EXISTING HMA SURFACE, THE CONTRACTOR SHALL DO PAVEMENT MILLING FIRST, THEN PATCHING THE ROADWAY PER BD-22 DETAIL.

THE LONGITUDINAL JOINT SEALANT SHALL BE PLACED OVER THE MILLED SURFACE WHERE THE SURFACE JOINT WILL BE LOCATED.


CENTERLINE RUMBLE STRIPS ARE TO BE PLACED ACCORDING TO DISTRICT DETAIL "RUMBLE STRIPS FOR CENTERLINE, NON-FREEWAY".

SHOULDER RUMBLE STRIPS SHALL BE PLACED ACCORDING TO HIGHWAY STANDARD 642006.


HOT-MIX ASPHALT MIXTURE REQUIREMENTS										
MIXTURE USES	DESIGN AIR @ N <sub>D</sub>		QMP							
PAVEMENT RESURFACING										
POLY. HMA SURFACE COURSE, MIX "E", N70, (IL-9.5 mm)	4% AT 70	GYR.	PFP							
PAVEMENT PATCHING										
CLASS D PATCH (HMA BINDER IL-19 mm)	4% AT 70	GYR.	QC/QA							
QMP DESIGNATION: QUALITY CONTROL/QUALITY ASSURANCE (QC/QA); QUALITY CONTROL FOR PERFORMANCE (QCP); PAY FOR PERFORMANCE (PFP)										
NOTES:  THE UNIT WEIGHT USED TO CALCULATE ALL HMA SURFACE MIXTURE IS 112 LBS/SQ YD/IN.  THE "AC TYPE FOR POLYMERIZED HMA MIXES SHALL BE "SBS/SBR AND FOR NON-POLYMERIZED HMA THE "AC TYPE" SHALL BE "PG 64 MODIFIED BY DISTRICT ONE SPECIAL PROVISIONS. FOR USE OF RECYCLED MATERIALS SEE DISTRICT ONE SPECIAL PROUALITY MANAGEMENT PROGRAM (OMP) IDENTIFIES THE PARTICULAR SPECIFICATION THAT APPLIES TO THE HMA MIXTURE.	PG 76-22" I-22" UNLES	S								

<b>EXISTING AND PROPOSED TYPICAL SECTIONS</b>											
IL ROUTE 64 (EAST OF IL ROUTE 47 TO RANDALL ROAD)											
SCALE: 1"= 50"	SHEET	OF	SHEETS	STA.	TO STA.						

FAP RTE.	SECTION	COUNTY	TOTAL SHEETS	SHEE.
307	2018-084-RS	KANE	47	7
		CONTRACT	NO. 6	2H32
	ILLINOIS FED. A	ID PROJECT		

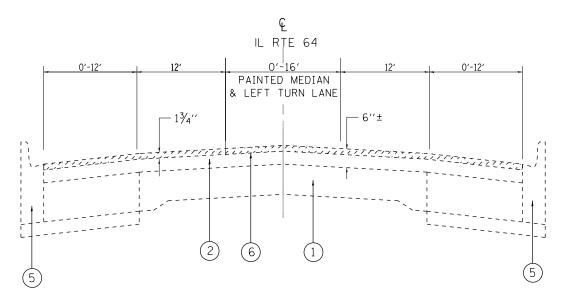

EXISTING TYPICAL SECTION IL 64 STA. 410+19.8 TO STA. 434+41.8

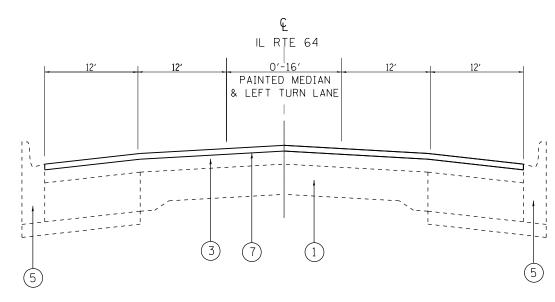

PROPOSED TYPICAL SECTION IL 64 STA. 410+19.8 TO STA. 434+41.8

### LEGEND

- 1 EXISTING P.C.C. PAVEMENT, 9"±
- 2) EXISTING HOT-MIX ASPHALT SURFACE, 6"±
- (3) EXISTING HMA SURFACE OVERLAY AFTER MILLING, 4 1/4"±
- (4) EXISTING HOT-MIX ASPHALT SHOULDER, 8"
- 5) EXISTING COMB. CONCRETE CURB AND GUTTER
- 6) PROPOSED HMA SURFACE REMOVAL, 1 3/4"
- 7) PROPOSED POLY. HOT-MIX ASPHALT SURFACE COURSE, MIX "E", N70, 1 3/4"
- (8) PROPOSED SHOULDER RUMBLE STRIPS, (8" WIDE)
- (9) PROPOSED CENTER LINE RUMBLE STRIPS, (16" WIDE)

### NOTES:

FOR THE EXISTING HMA SURFACE, THE CONTRACTOR SHALL DO PAVEMENT MILLING FIRST, THEN PATCHING THE ROADWAY PER BD-22 DETAIL.

THE LONGITUDINAL JOINT SEALANT SHALL BE PLACED OVER THE MILLED SURFACE WHERE THE SURFACE JOINT WILL BE LOCATED.

CENTERLINE RUMBLE STRIPS ARE TO BE PLACED ACCORDING TO DISTRICT DETAIL "RUMBLE STRIPS FOR CENTERLINE, NON-FREEWAY".


SHOULDER RUMBLE STRIPS SHALL BE PLACED ACCORDING TO HIGHWAY STANDARD 642006.


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Default	PLOT DATE = 12/11/2018	DATE -	REVISED -


STATE OF ILLINOIS	
DEPARTMENT OF TRANSPORTATION	


EXISTING AND PROPOSED TYPICAL SECTIONS										
IL ROU	TE 64 (E.	AST OF I	L ROUTE	47 TO	RANDALL ROAD)					
SCALE: 1"= 50"	SHEET	OF	SHEETS	STA.	TO STA.					


FAP RTE.	SECTION	COUNTY	TOTAL SHEETS	SHEE NO.
307	2018-084-RS	KANE	47	8
		CONTRACT	NO. 6	2H32
	TILINOIS EED AT	ID PROJECT		

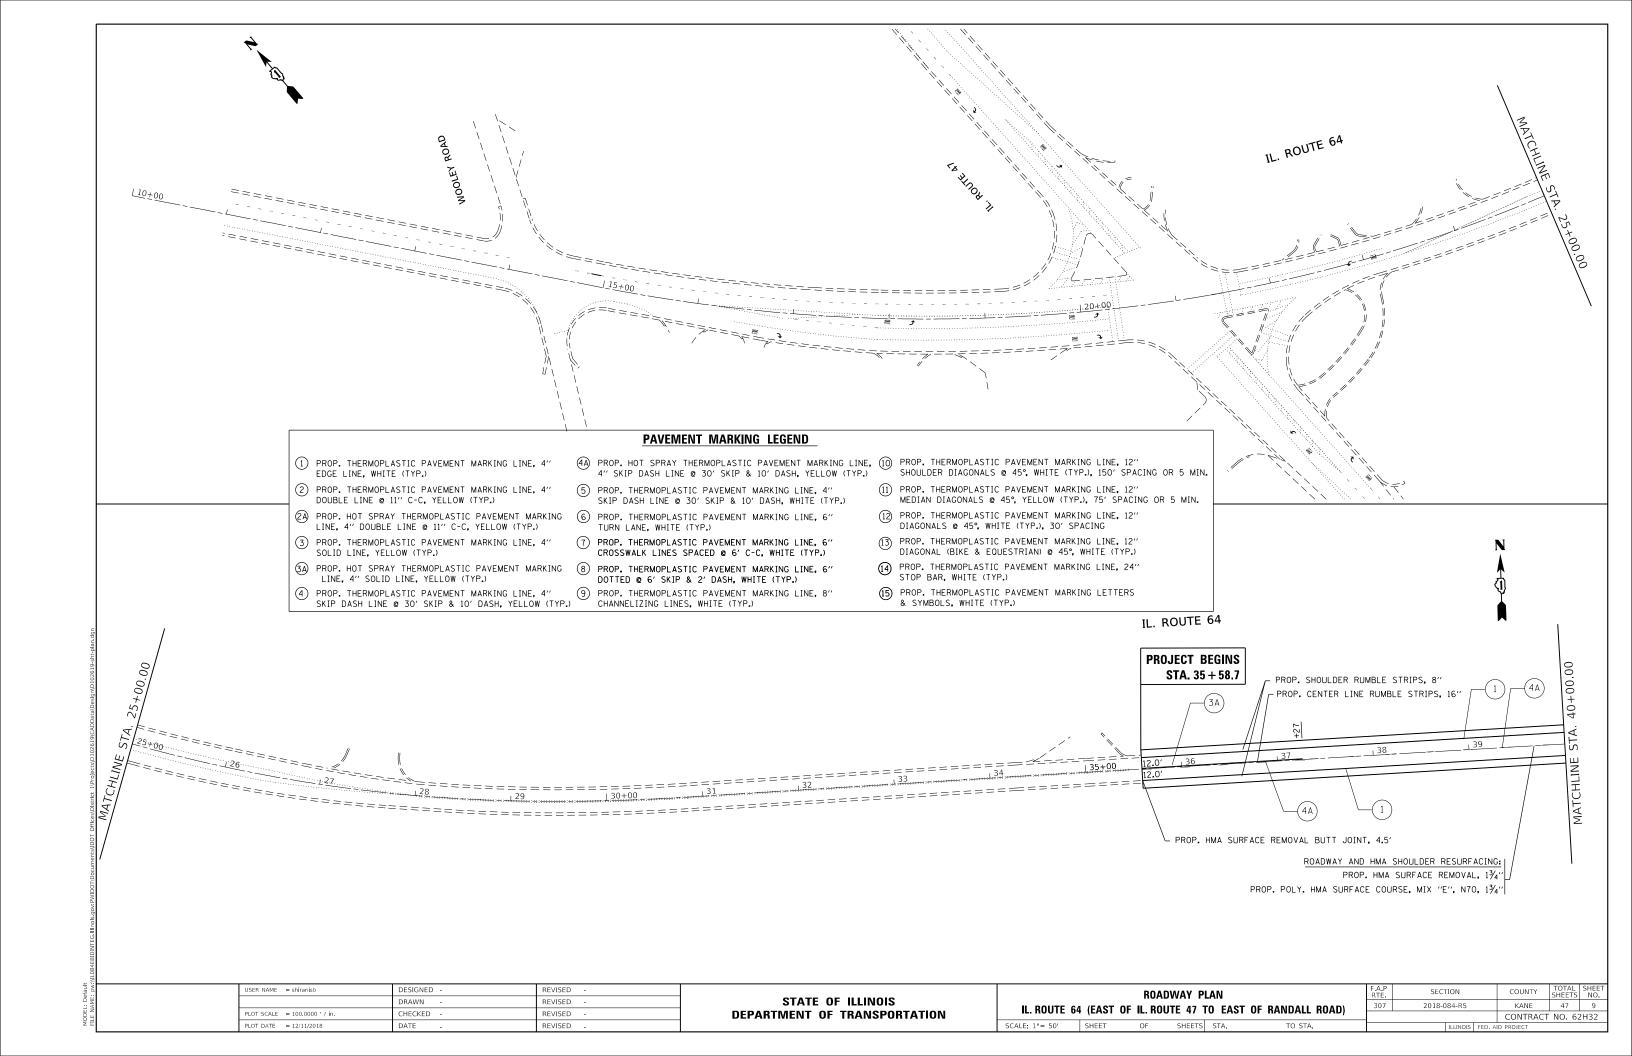


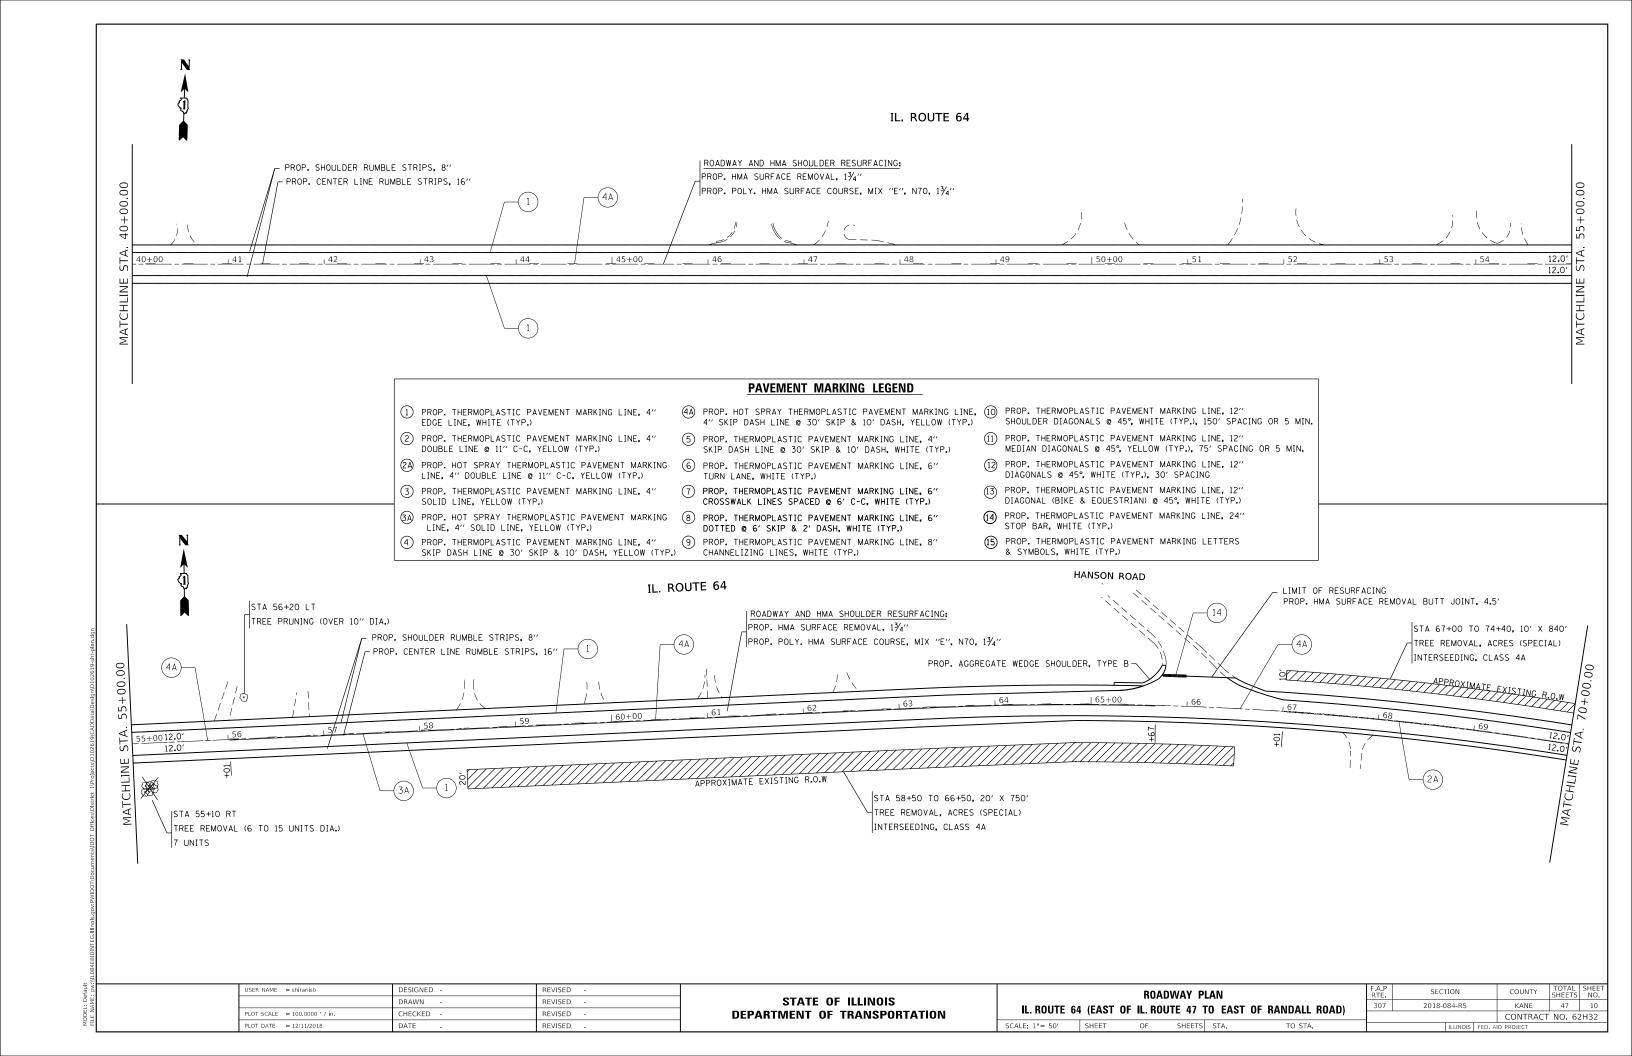


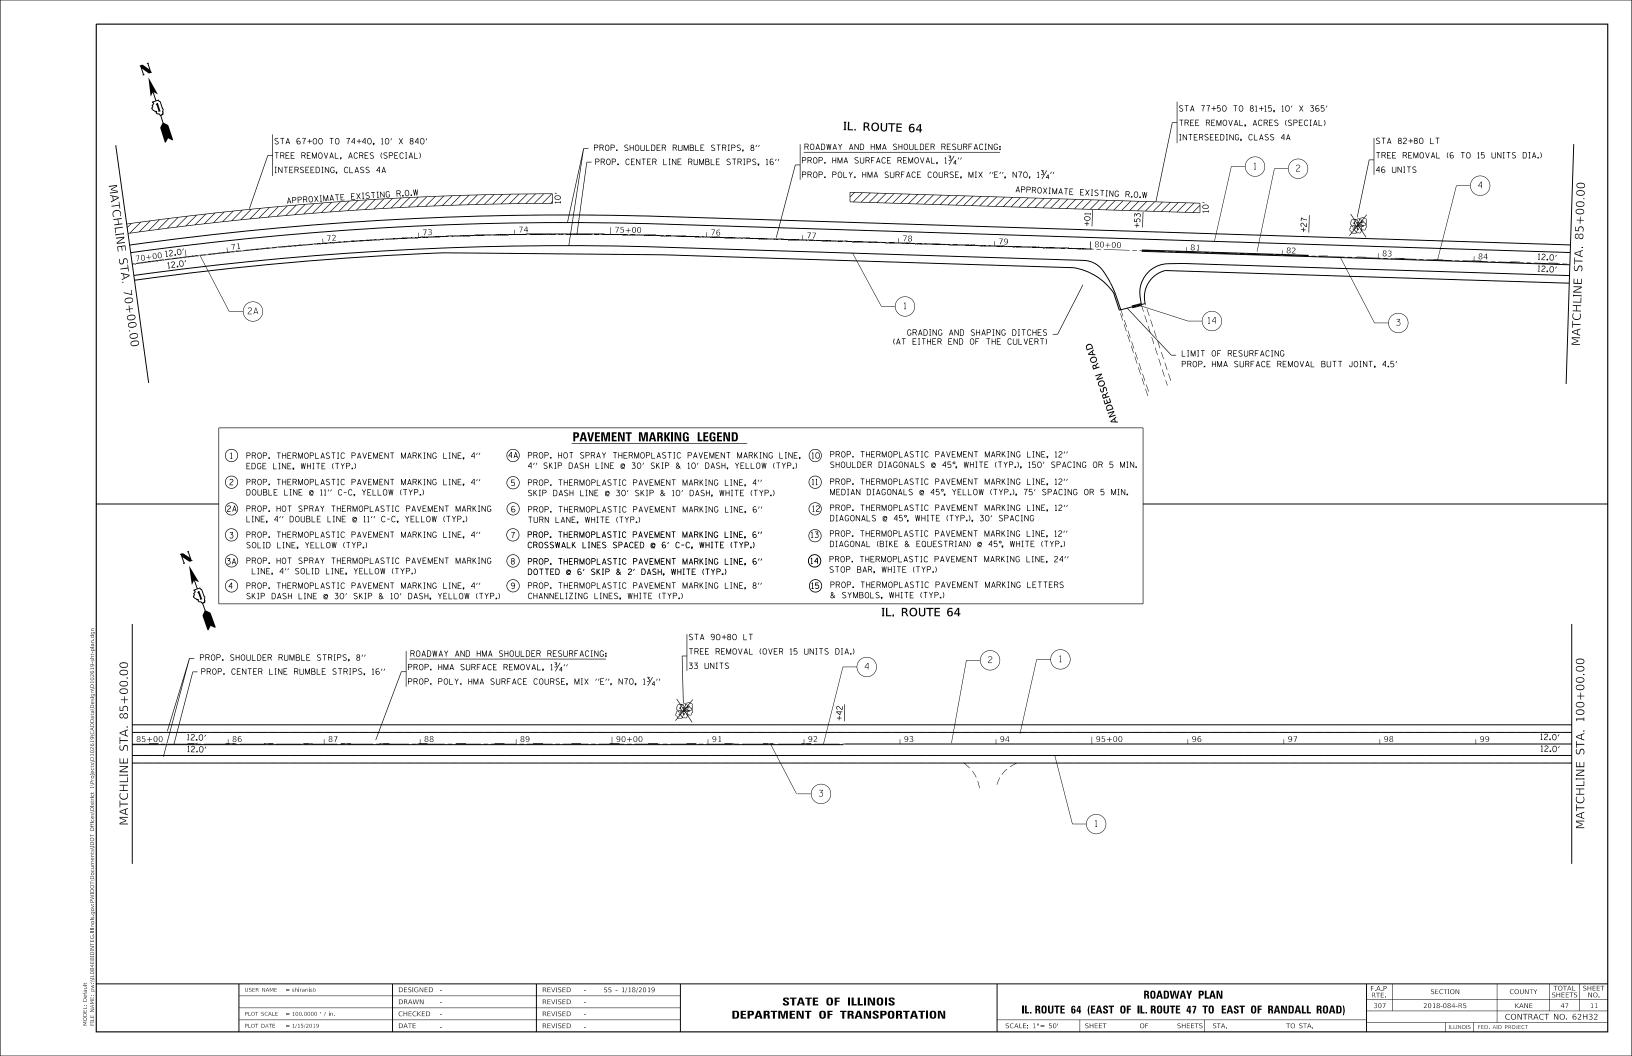


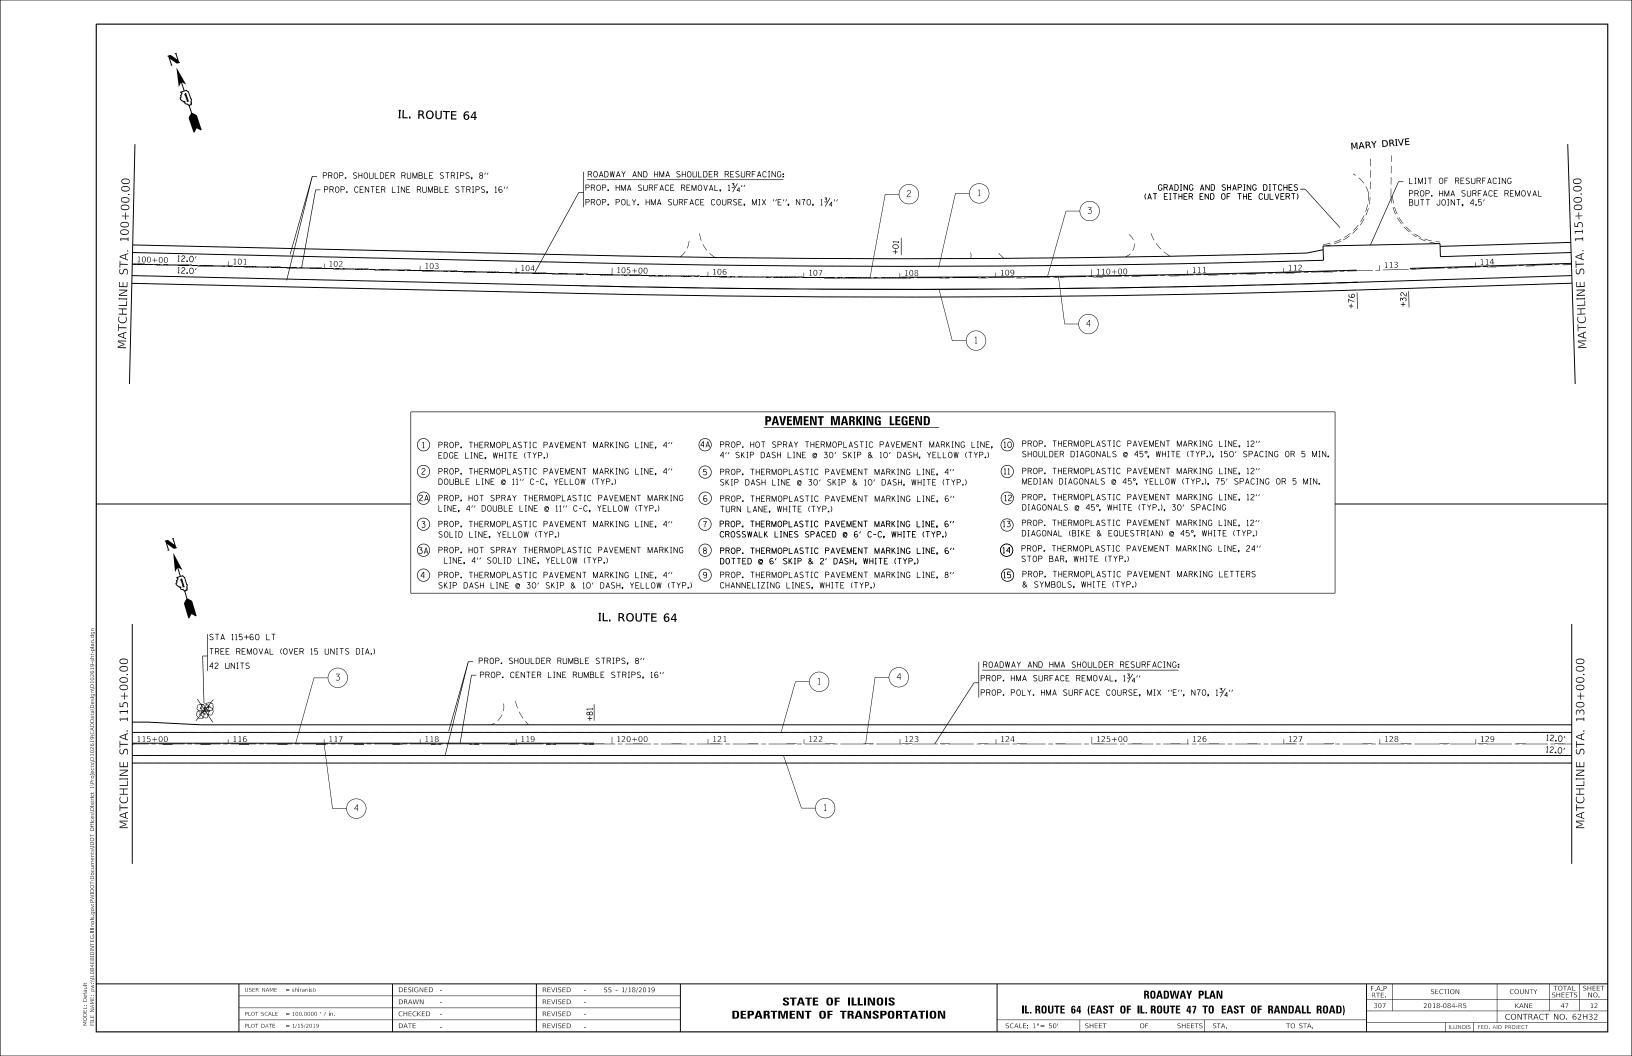


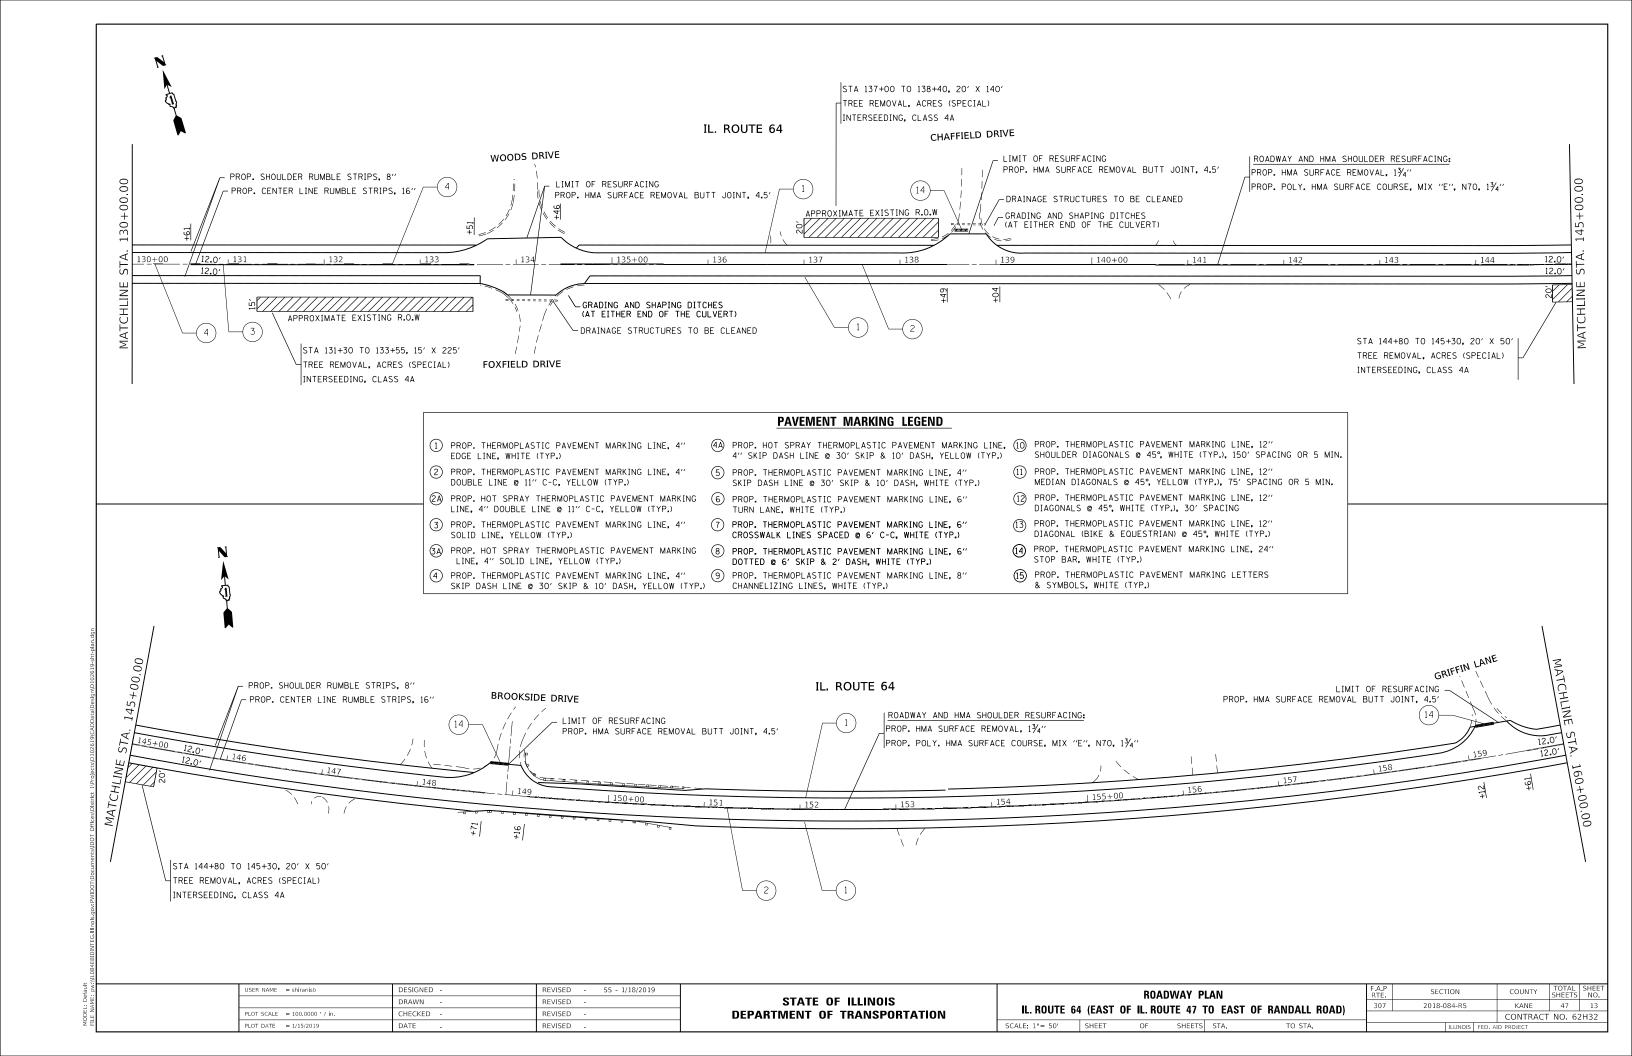


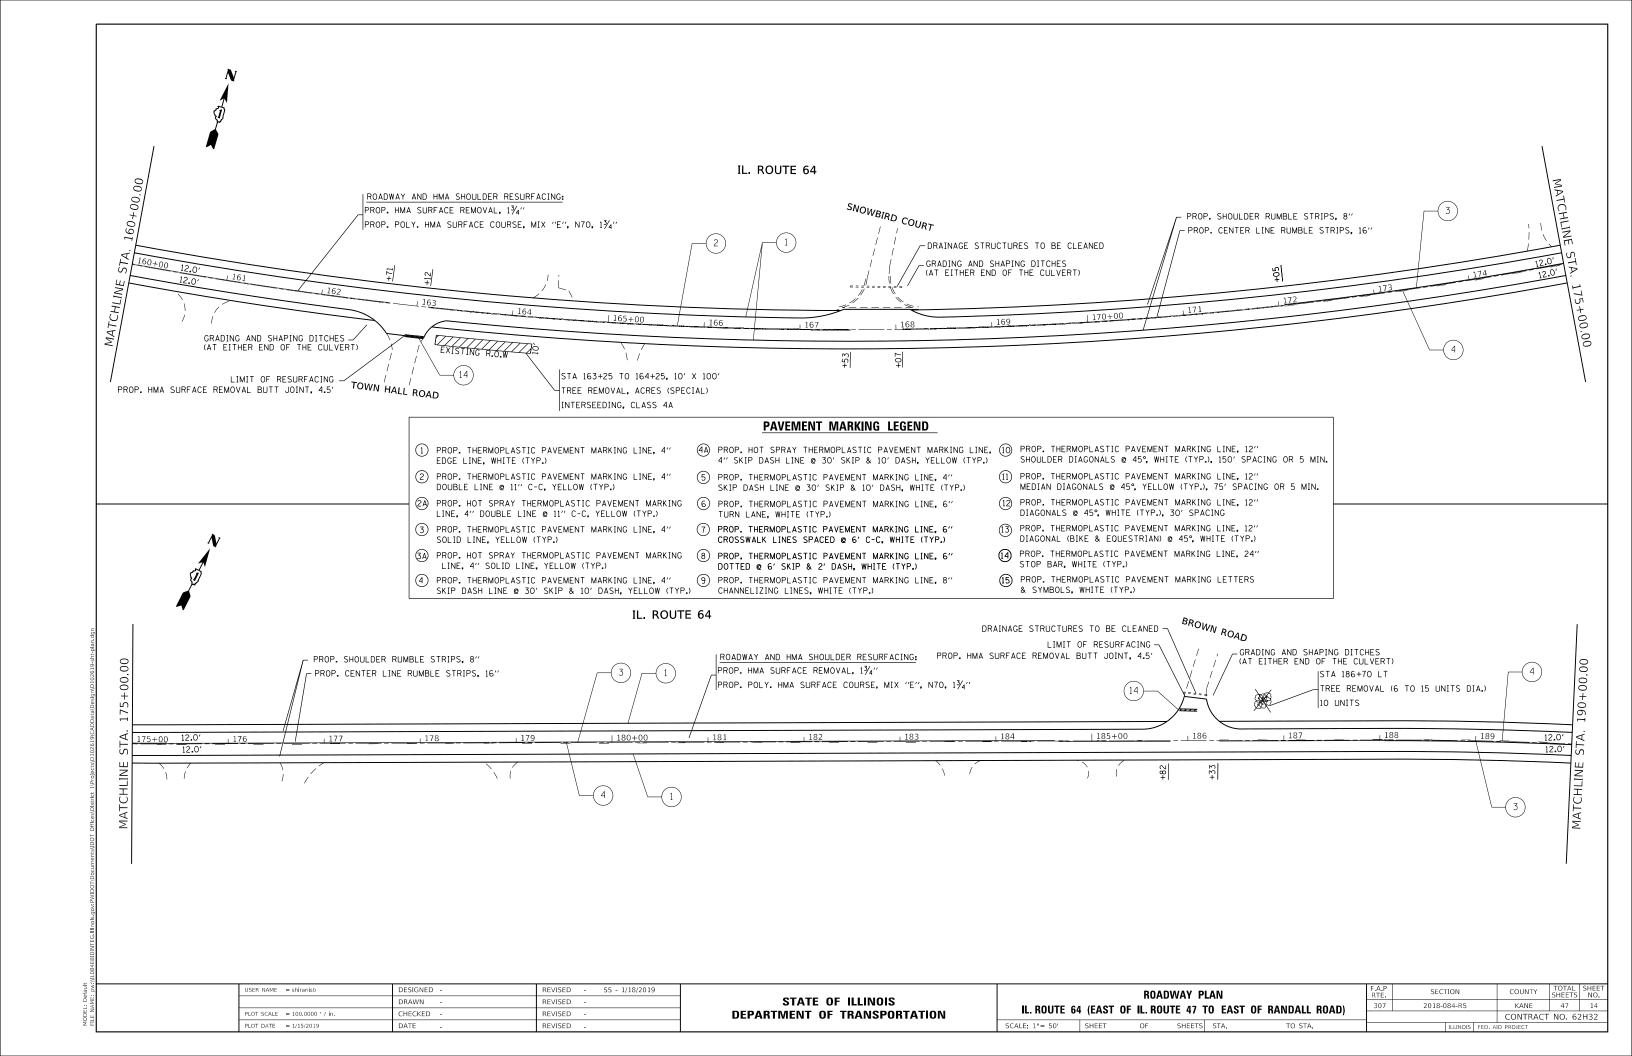


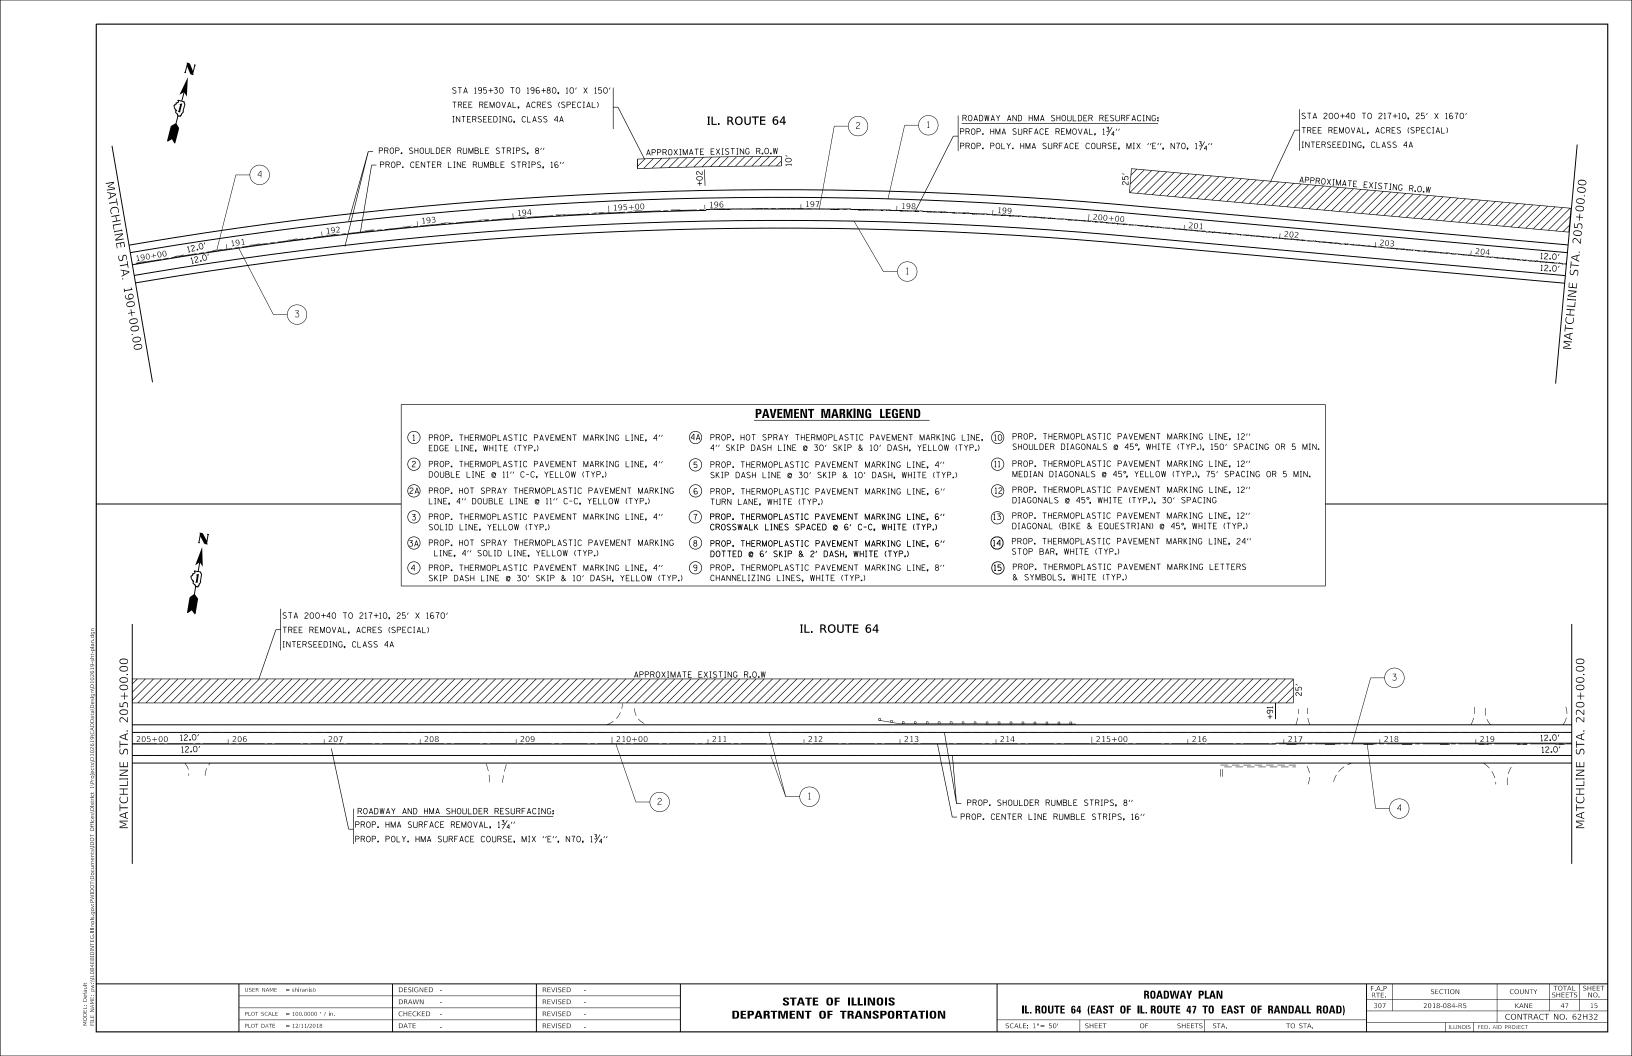


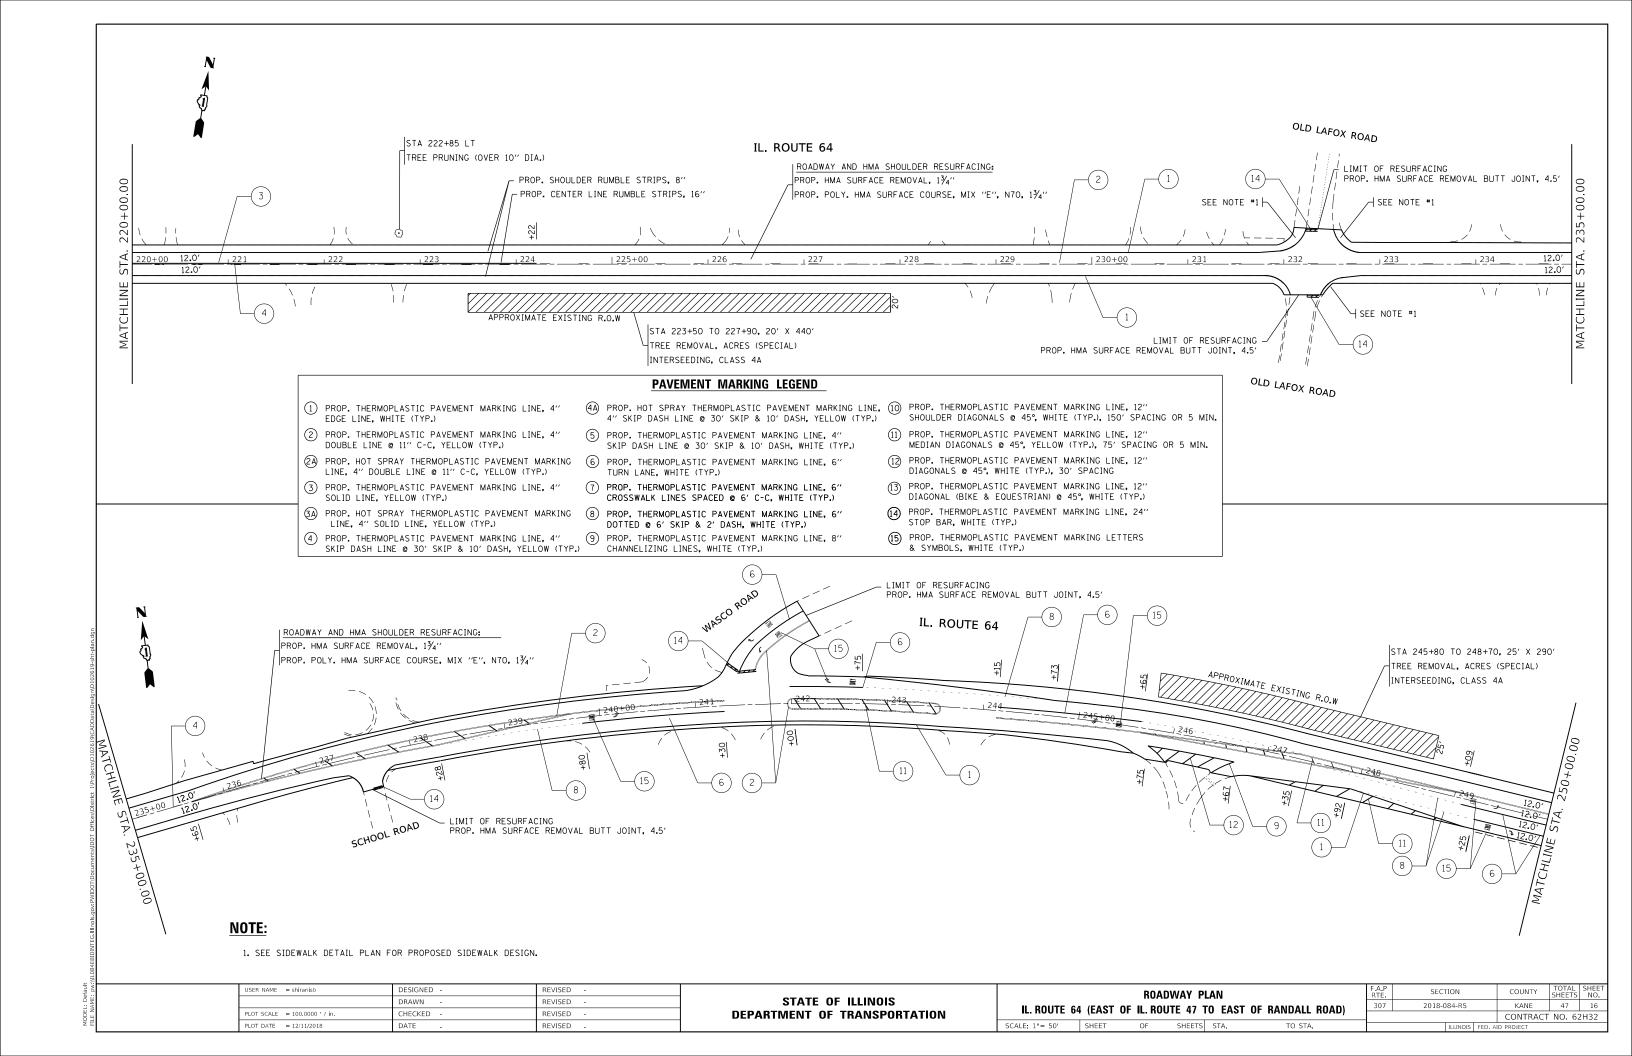


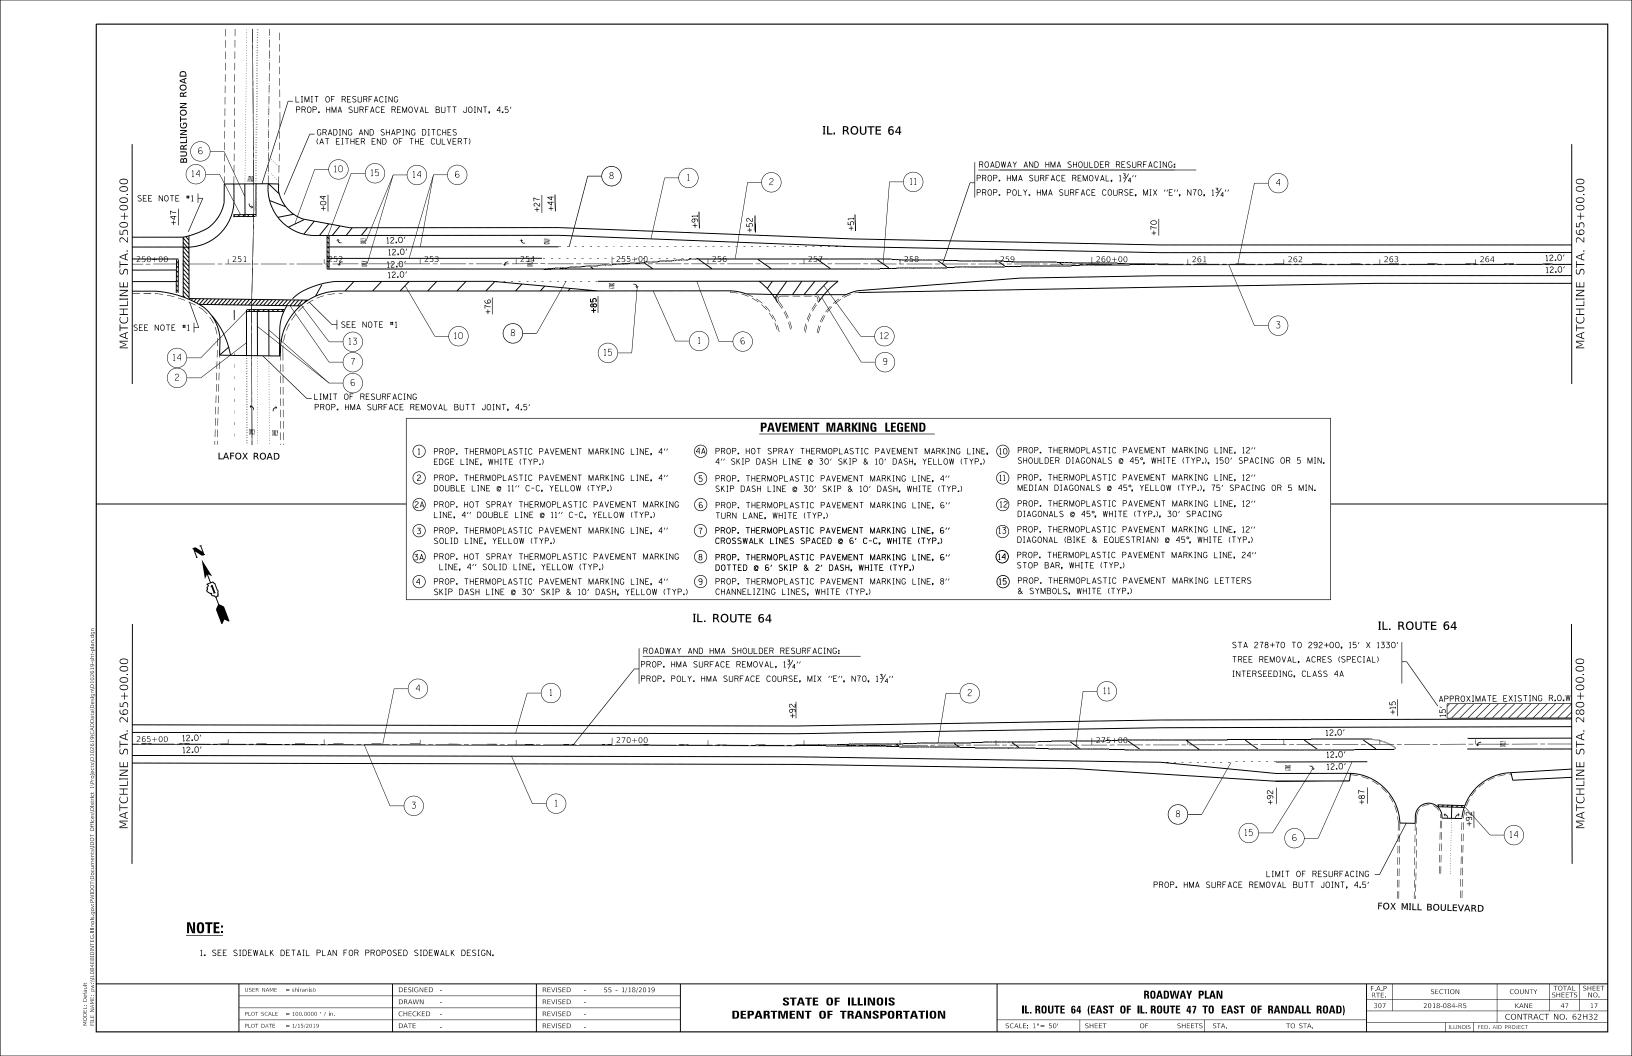


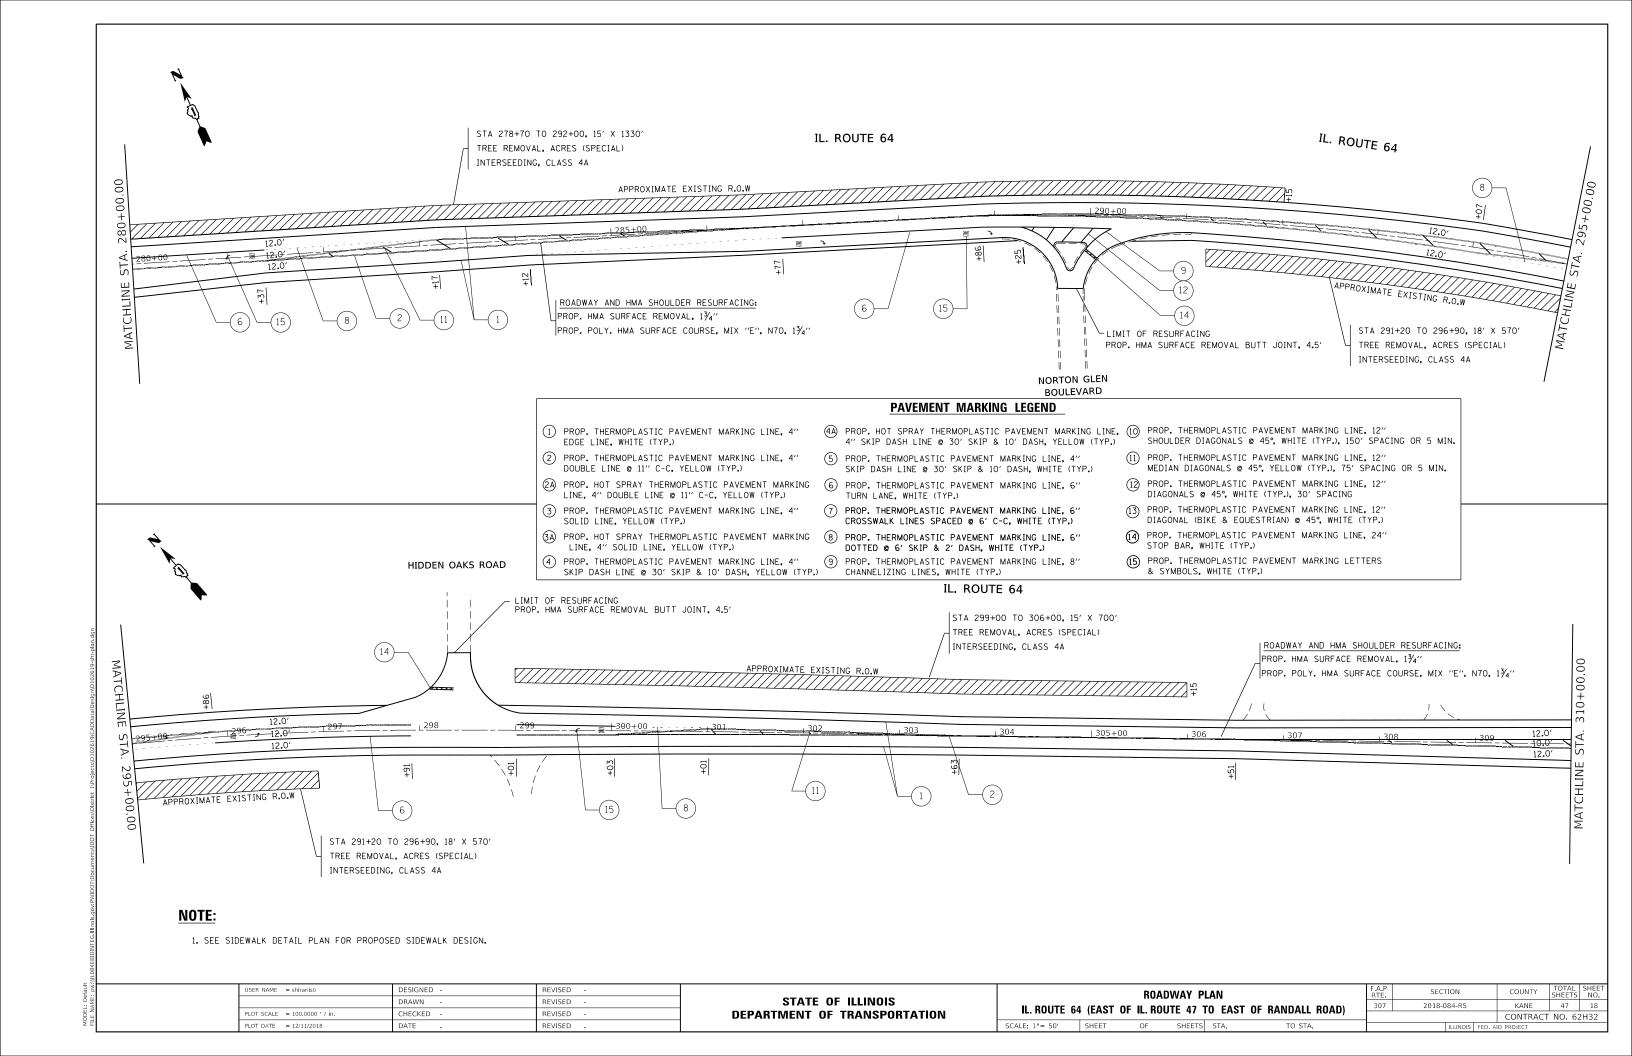


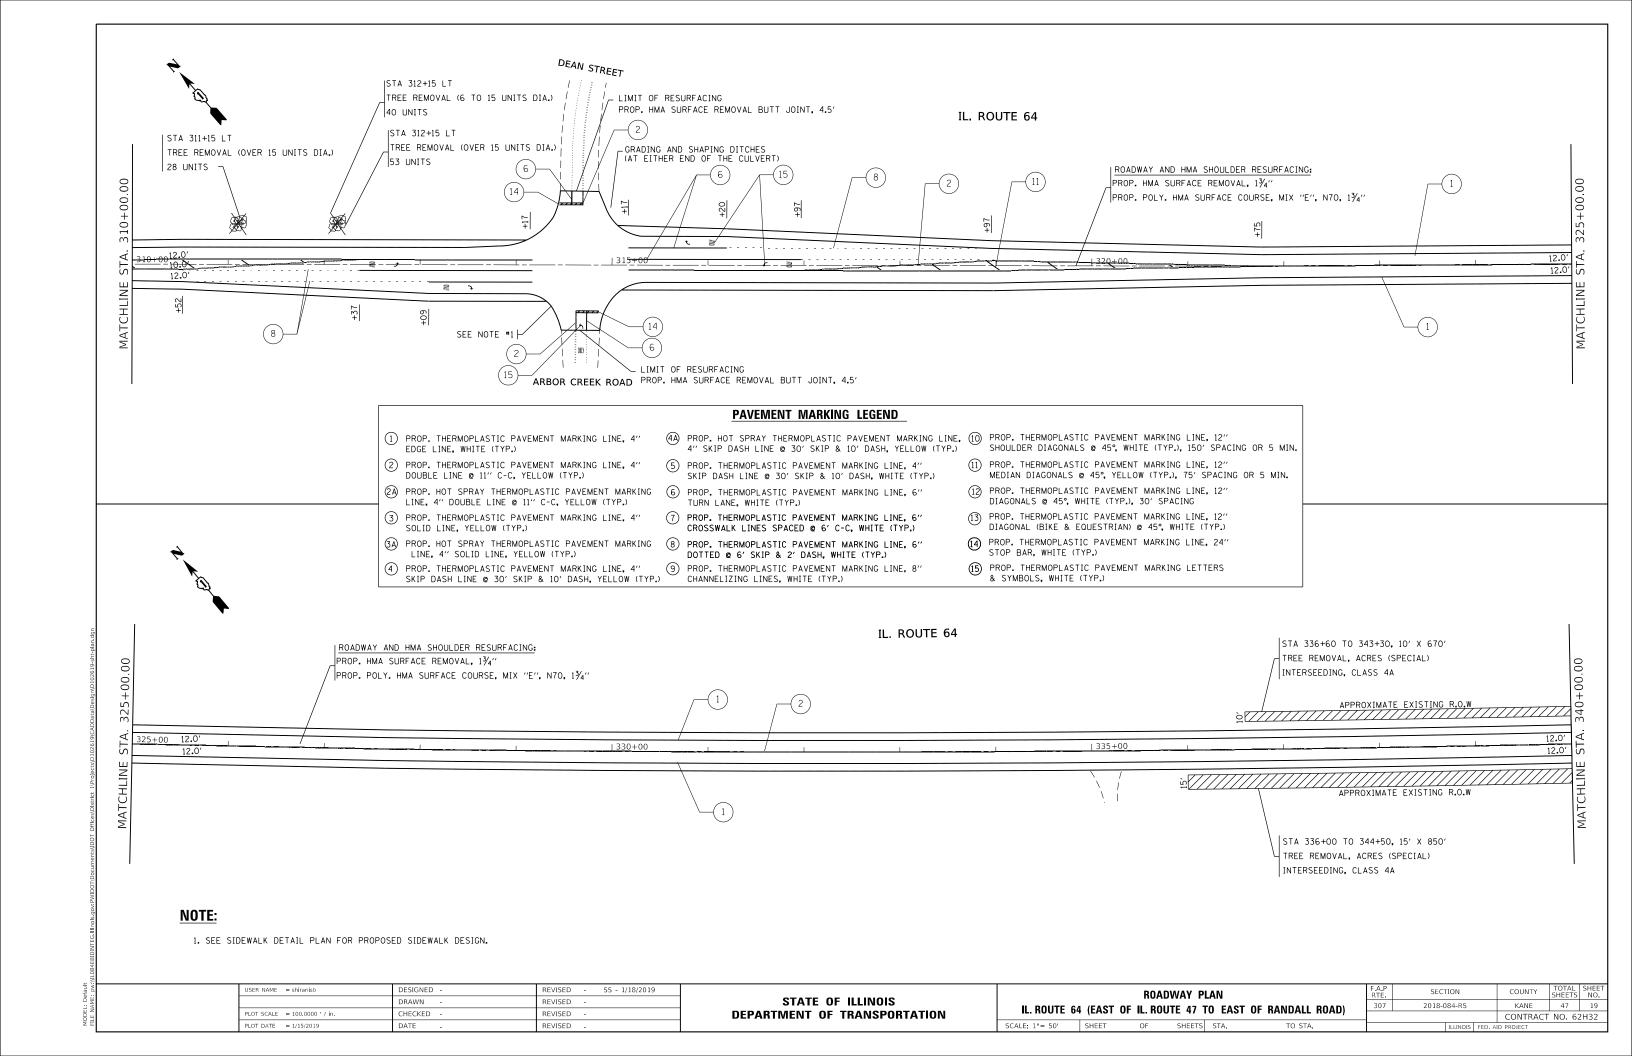

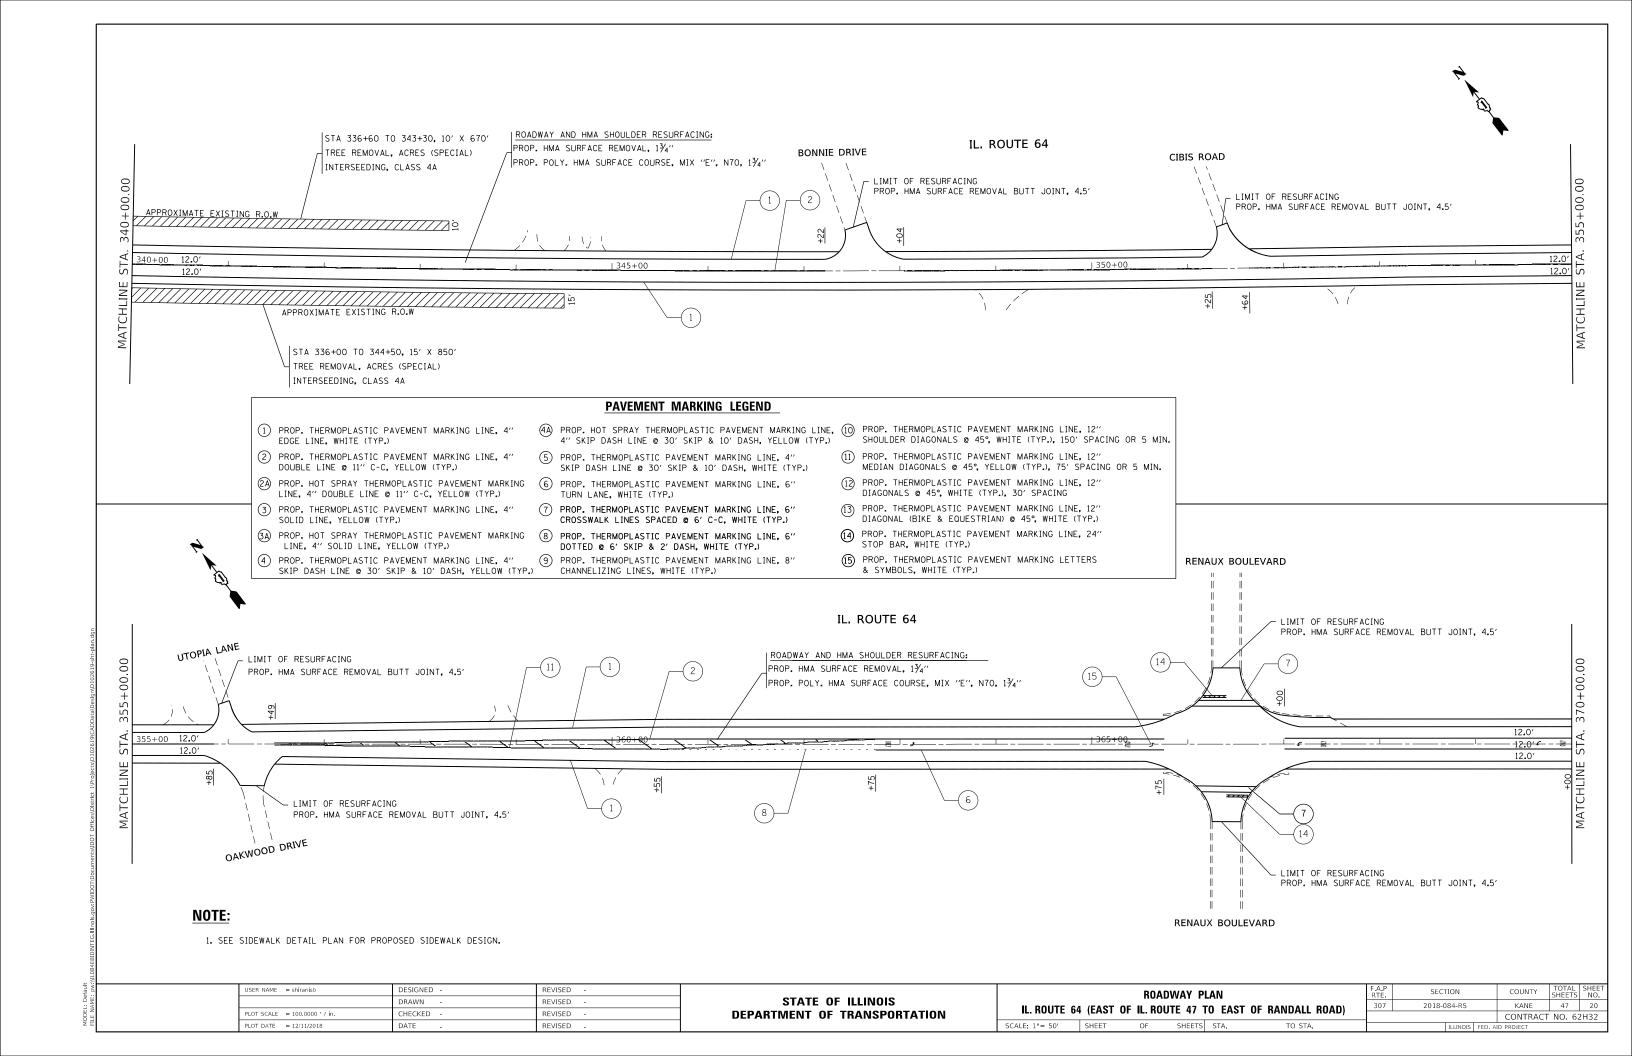

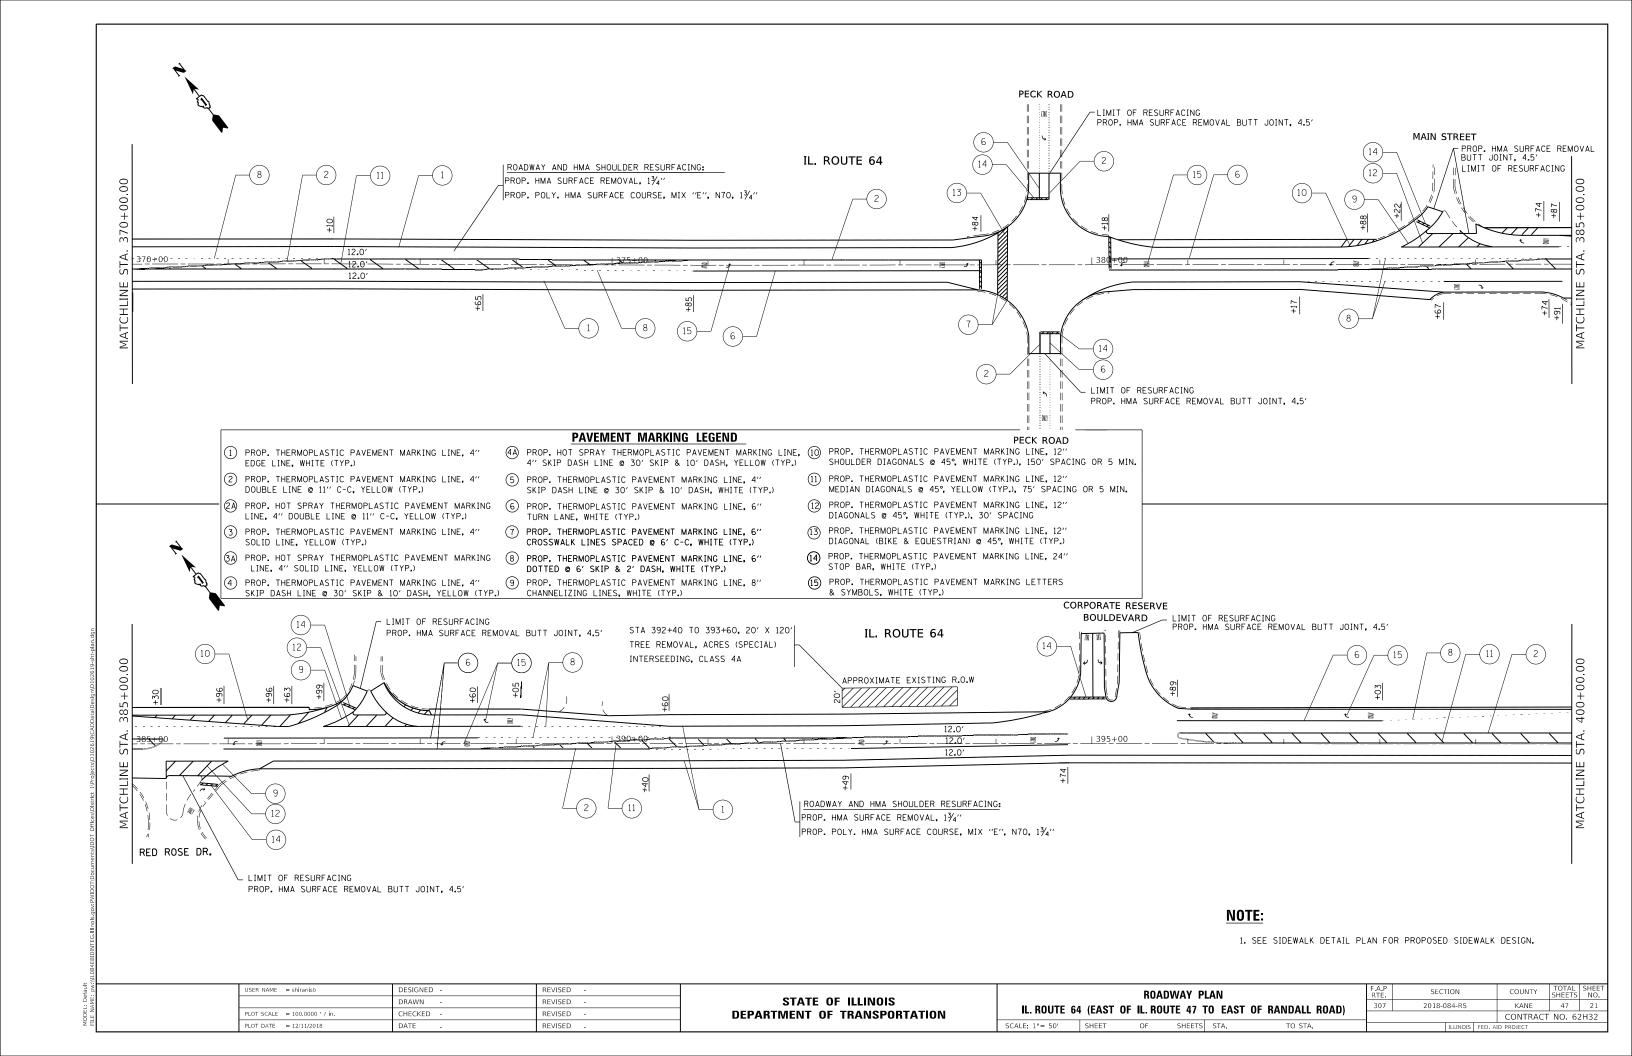

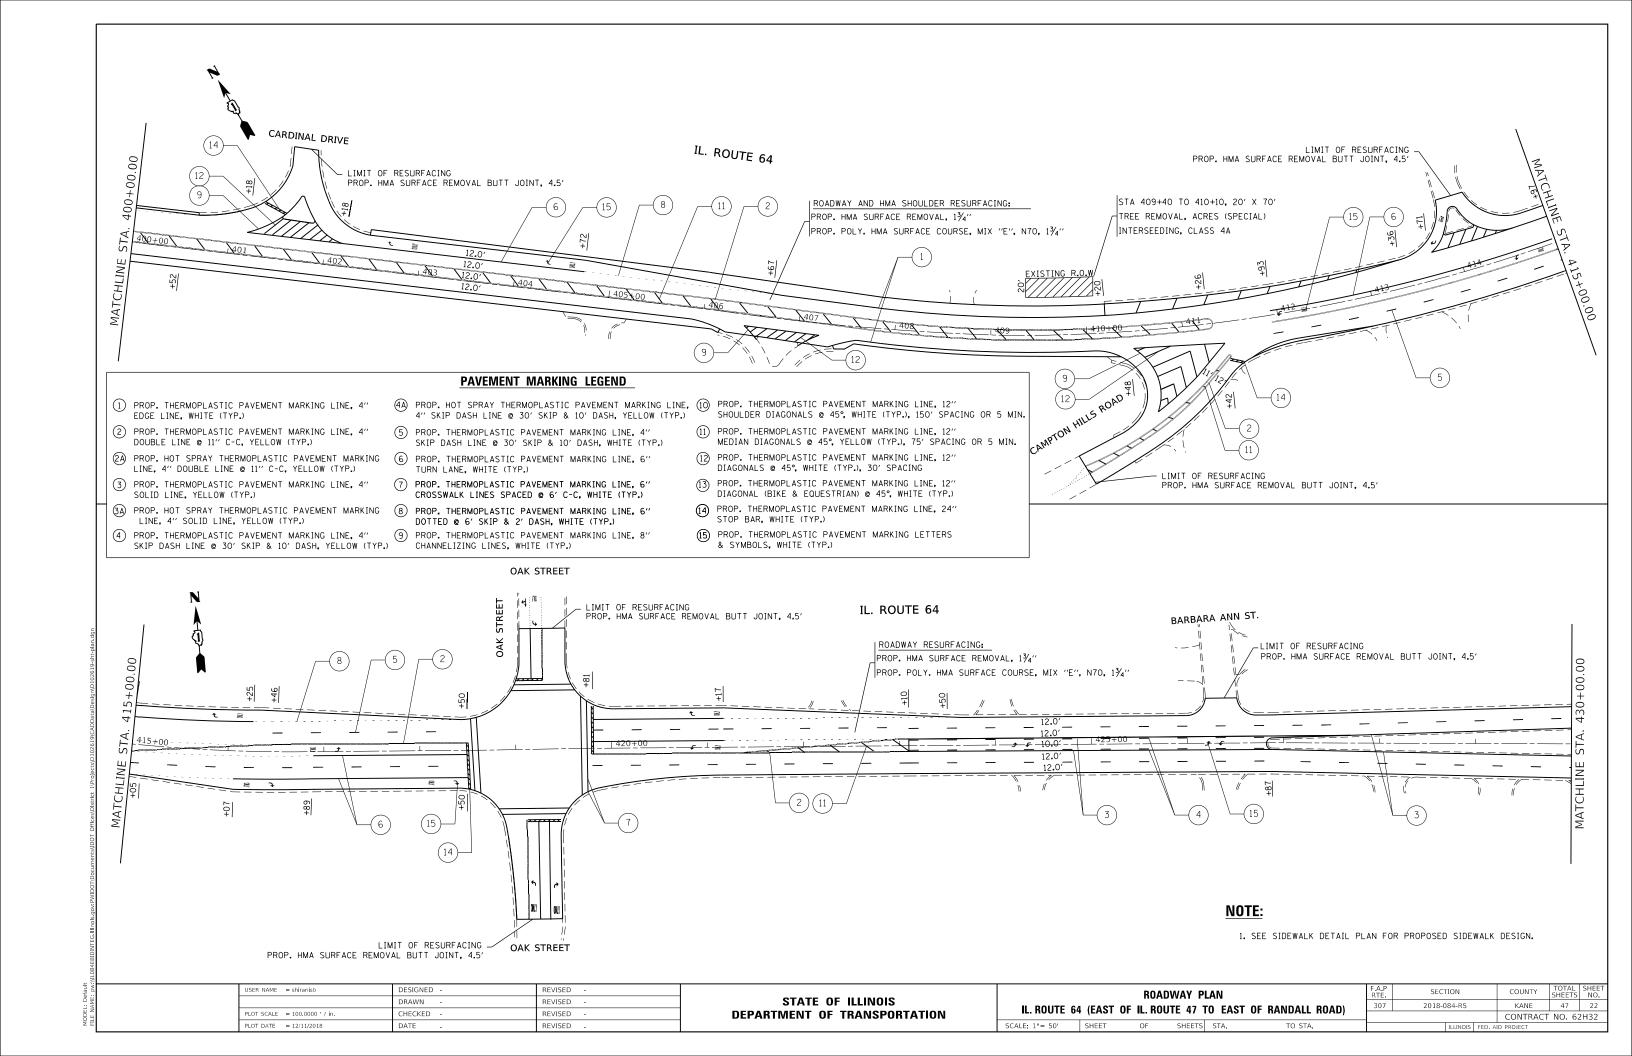

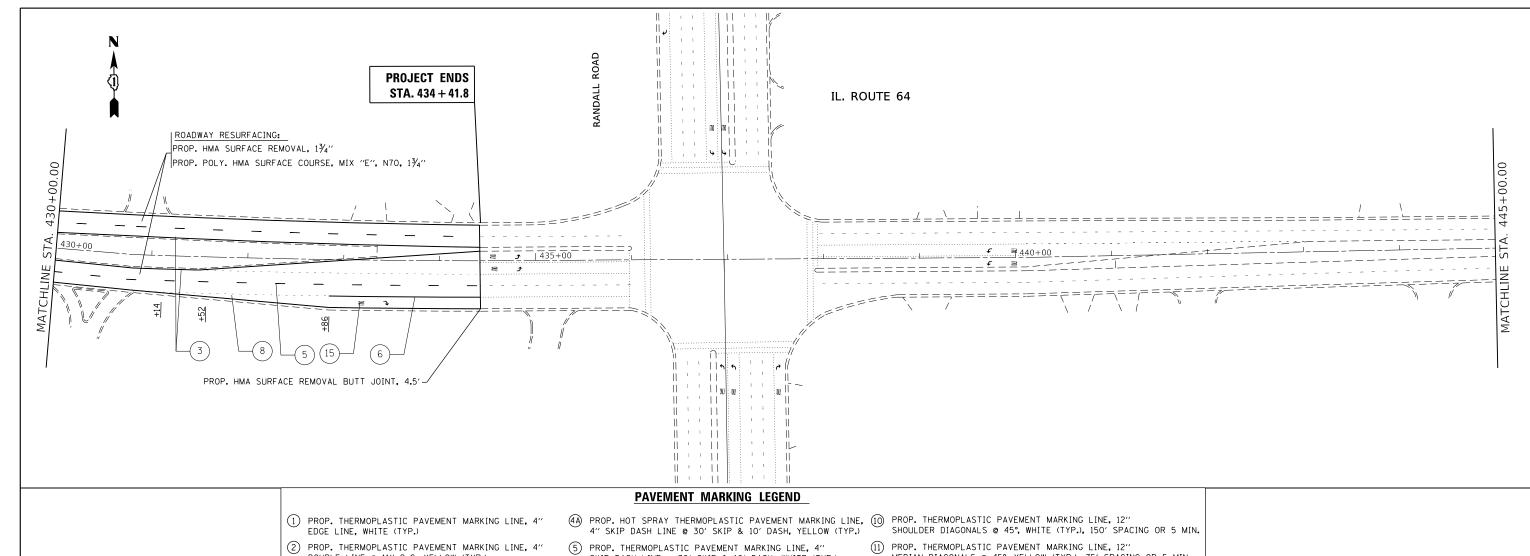

- DOUBLE LINE @ 11" C-C, YELLOW (TYP.)
- (2A) PROP. HOT SPRAY THERMOPLASTIC PAVEMENT MARKING LINE, 4" DOUBLE LINE @ 11" C-C, YELLOW (TYP.)
- 3 PROP. THERMOPLASTIC PAVEMENT MARKING LINE, 4" SOLID LINE, YELLOW (TYP.)
- (a) PROP. HOT SPRAY THERMOPLASTIC PAVEMENT MARKING (B) PROP. THERMOPLASTIC PAVEMENT MARKING LINE, 6" LINE, 4" SOLID LINE, YELLOW (TYP.)
- PROP. THERMOPLASTIC PAVEMENT MARKING LINE, 4"
  SKIP DASH LINE @ 30' SKIP & 10' DASH, YELLOW (TYP.)
- SKIP DASH LINE @ 30' SKIP & 10' DASH, WHITE (TYP.)
- 6 PROP. THERMOPLASTIC PAVEMENT MARKING LINE, 6" TURN LANE, WHITE (TYP.)
- PROP. THERMOPLASTIC PAVEMENT MARKING LINE, 6" CROSSWALK LINES SPACED @ 6' C-C, WHITE (TYP.)
- DOTTED @ 6' SKIP & 2' DASH, WHITE (TYP.)
- 9 PROP. THERMOPLASTIC PAVEMENT MARKING LINE, 8" CHANNELIZING LINES, WHITE (TYP.)
- MEDIAN DIAGONALS @ 45°, YELLOW (TYP.), 75' SPACING OR 5 MIN.
- 12 PROP. THERMOPLASTIC PAVEMENT MARKING LINE, 12" DIAGONALS @ 45°, WHITE (TYP.), 30' SPACING
- (3) PROP. THERMOPLASTIC PAVEMENT MARKING LINE, 12" DIAGONAL (BIKE & EQUESTRIAN) @ 45°, WHITE (TYP.)
- PROP. THERMOPLASTIC PAVEMENT MARKING LINE, 24"
- (5) PROP. THERMOPLASTIC PAVEMENT MARKING LETTERS & SYMBOLS, WHITE (TYP.)

1. SEE SIDEWALK DETAIL PLAN FOR PROPOSED SIDEWALK DESIGN.

USER NAME = shiranisb	DESIGNED -	REVISED -	
	DRAWN -	REVISED -	
PLOT SCALE = 100.0000 ' / in.	CHECKED -	REVISED -	
PLOT DATE = 12/11/2018	DATE -	REVISED -	

STATE OF ILLINOIS **DEPARTMENT OF TRANSPORTATION** 

ROADWAY PLAN										
IL. ROUTE 64	(EAST	OF IL. ROU	TE 47 T	O EAST	OF RANDALL ROAD)					
ALE: 1"= 50"	SHEET	OF	SHEETS	STA.	TO STA.					

SECTION 2018-084-RS KANE 47 23 CONTRACT NO. 62H32

IL ROUTE 64 INTERSECTION	00100000 EARTH EXCAVATION	TOPSOIL FURNISH AND PLACE, 4"	SODDING, SALT TOLERANT	PROTECTIVE COAT	PORTLAND CEMENT CONCRETE SIDEWALK, 5"	DETECTABLE WARNINGS	SIDEWALK REMOVAL	PAVED SHOULDER REMOVAL	CLASS D PATCHES, TYPE II, 10 INCH	REBUILT EXISTING HANDHOLE	SO TD BIKE PATH REMOVAL	COMBINATION CONC. CURB & GUTTER REMOVAL AND REPLACEMENT
OLD LAFOX ROAD	3.3	9	9	33	291	30	257	6.0	27	0	0	0
BURLINGTON ROAD	3.7	15	15	41	369	43	193	0	4	1	20	40
ARBOR CREEK ROAD	0.8	2	2	9	78	15	0	0	6	0	10	0
TOTAL	8.0	26	26	83	738	88	450	6.0	37	1	30	40

STATE OF ILLINOIS

DEPARTMENT OF TRANSPORTATION

FILE NAME =

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PLOT DATE = 12/11/2018

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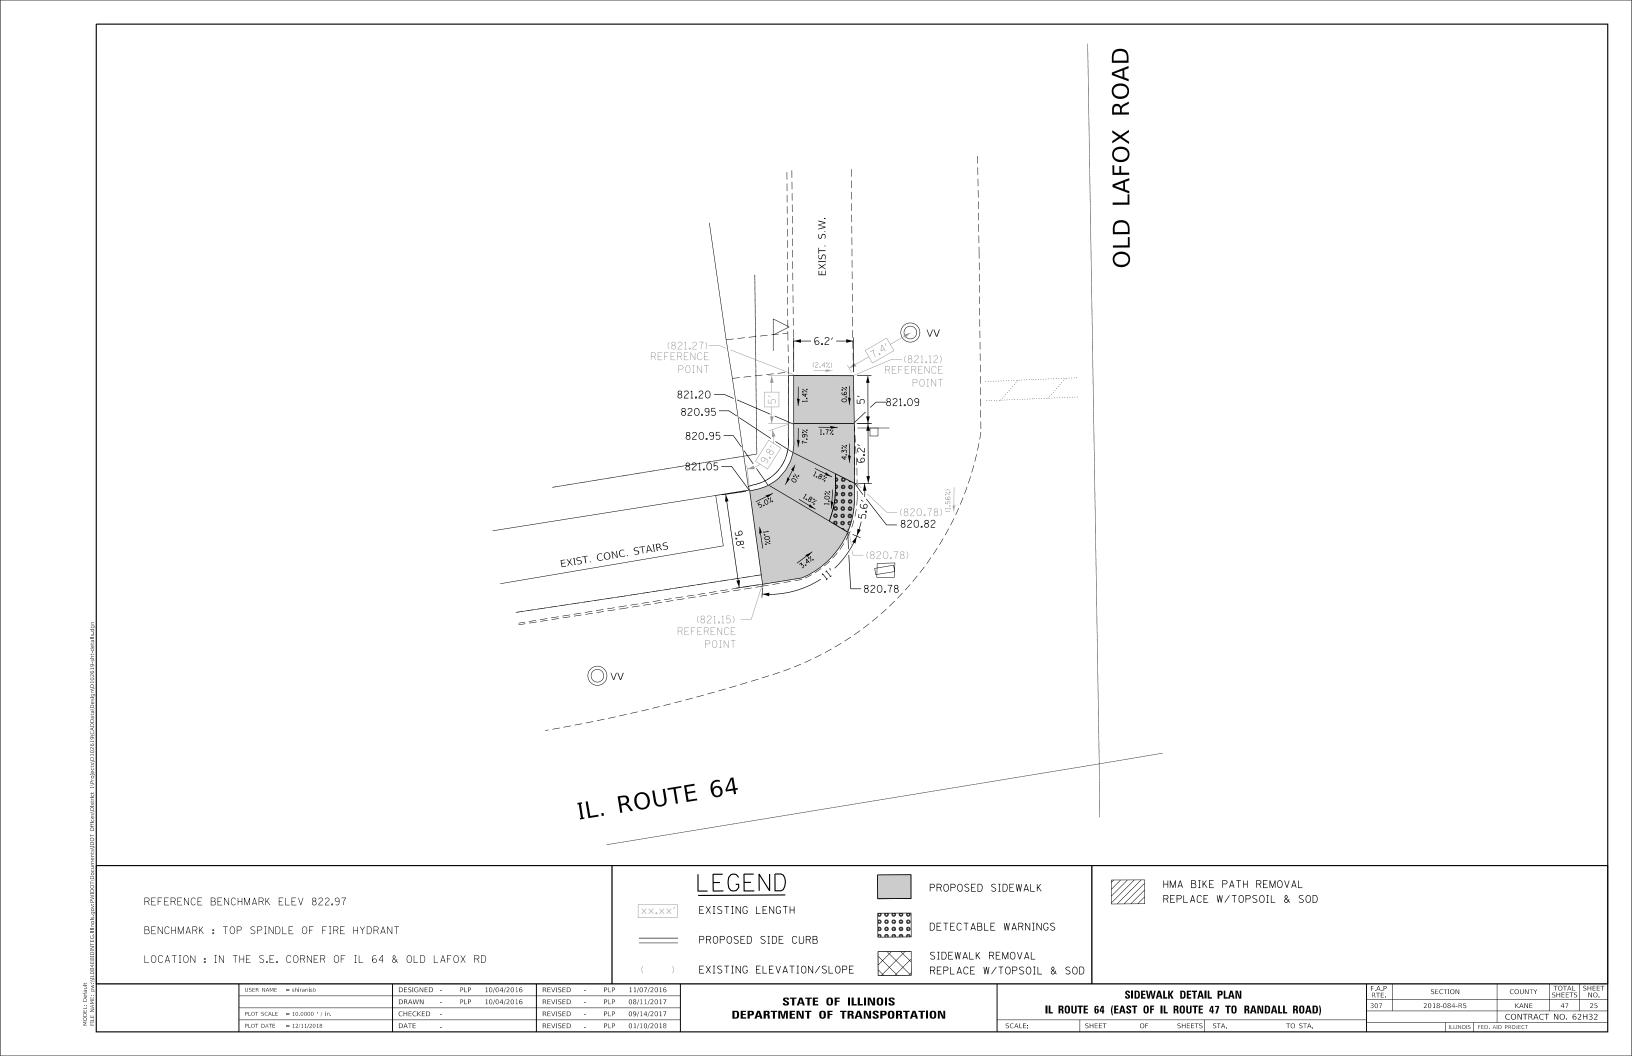
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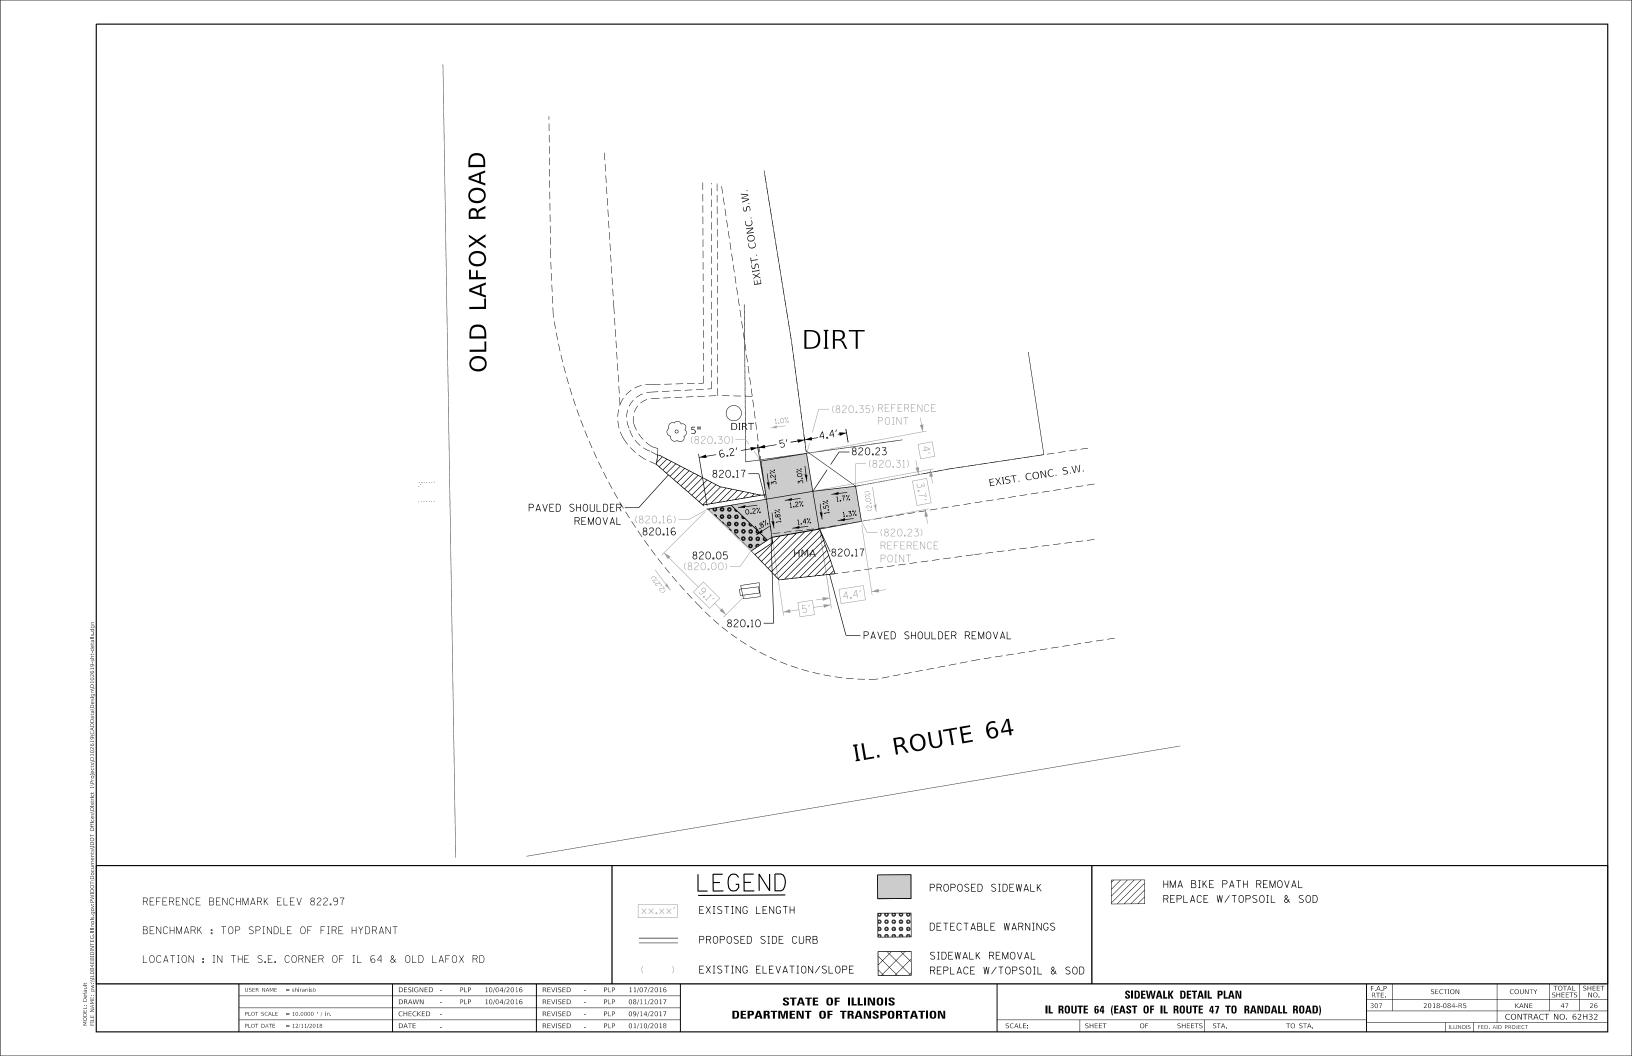
SIDEWALK DETAIL PLAN - SCHEDULE OF QUANTITIES


IL ROUTE 64 (EAST OF IL ROUTE 47 TO RANDALL ROAD)


SHEET NO. OF SHEETS STA.

SCALE:





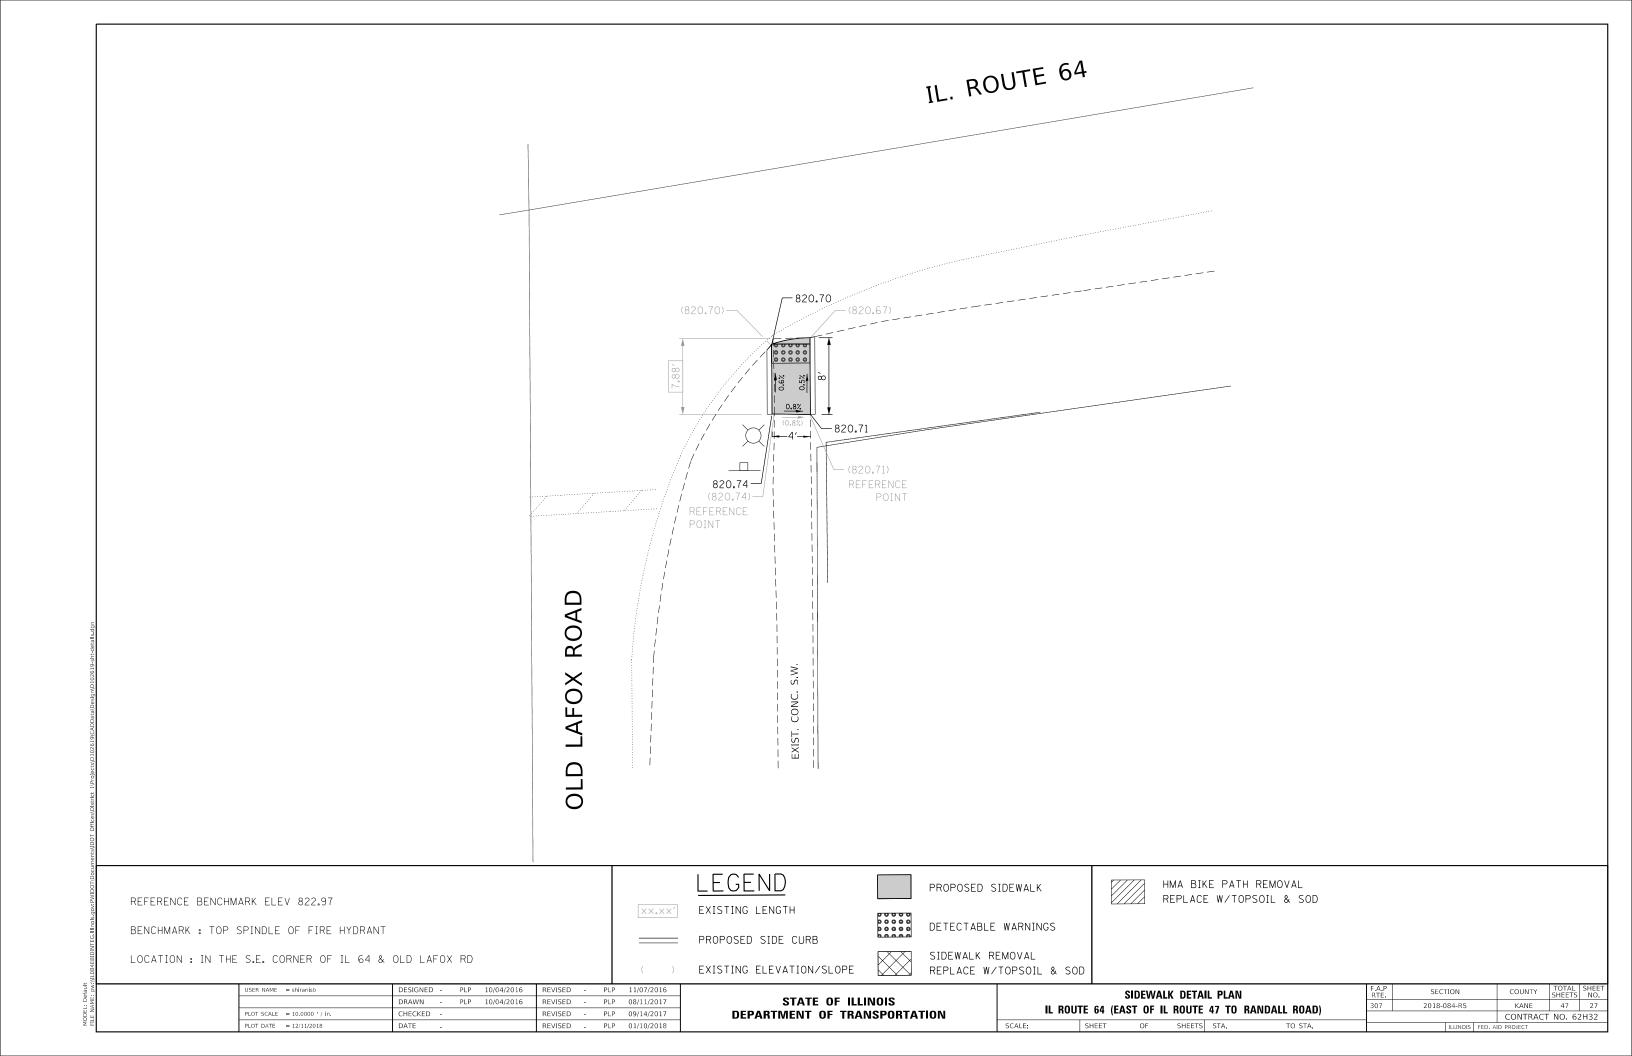

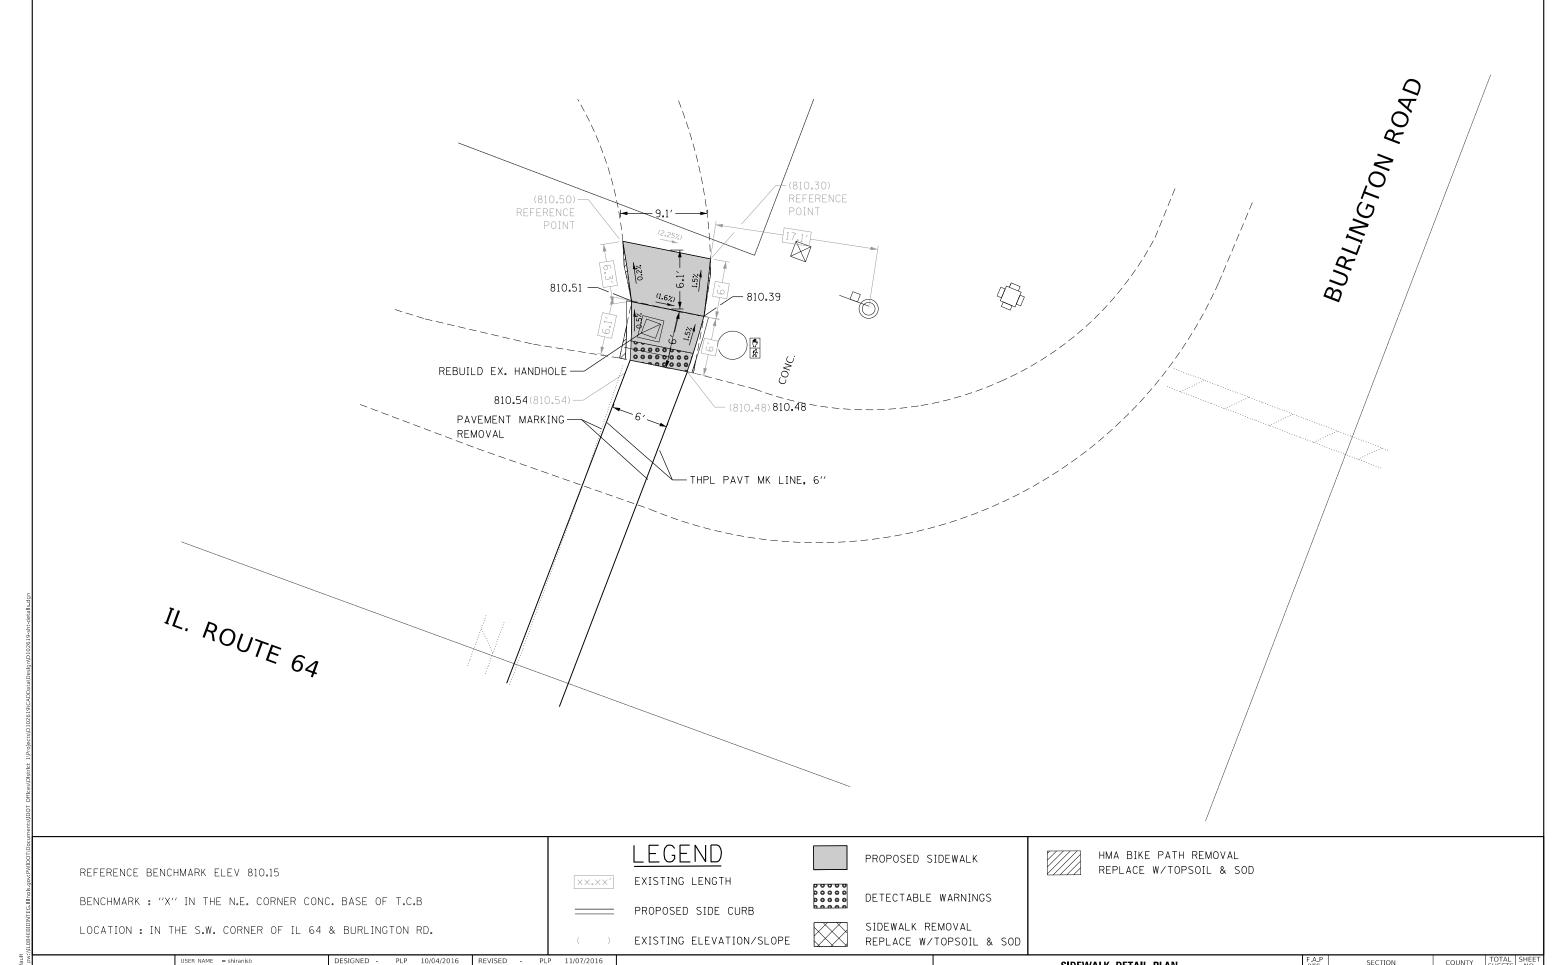


MODEL: Default

STATE OF ILLINOIS DEPARTMENT OF TRANSPORTATION SIDEWALK DETAIL PLAN

IL ROUTE 64 (EAST OF IL ROUTE 47 TO RANDALL ROAD)

SHEET OF SHEETS STA. TO STA.

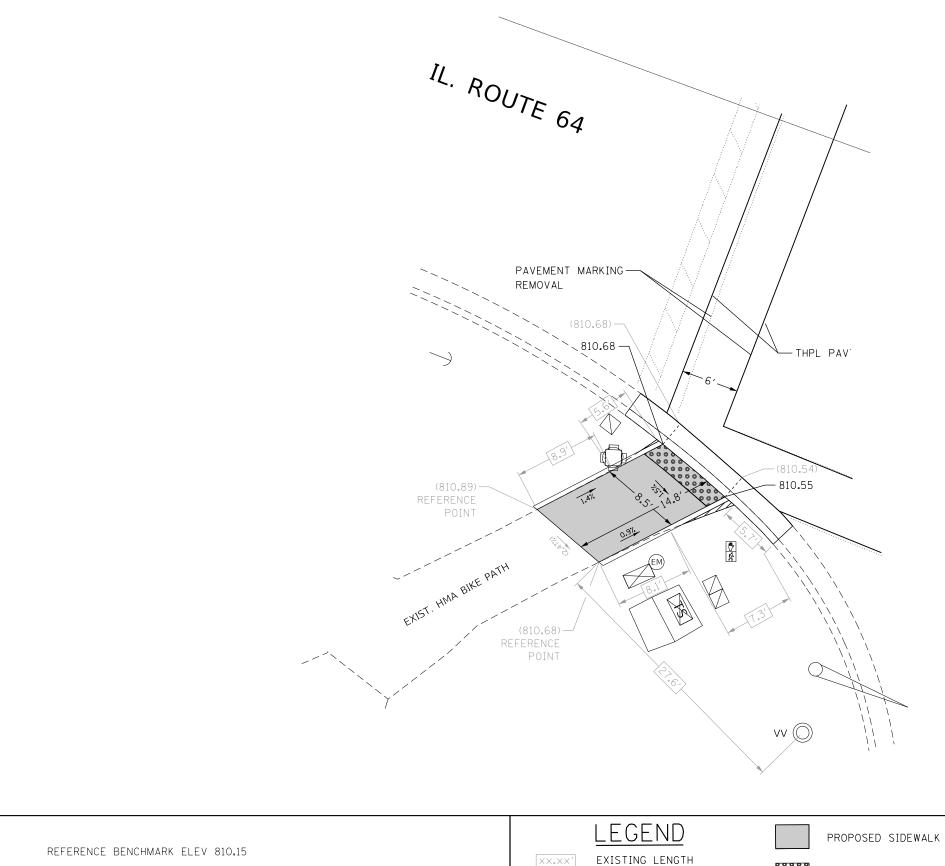

BURLINGTON ROAD

BENCHMARK: "X" IN THE N.E. CORNER CONC. BASE OF T.C.B

LOCATION: IN THE S.W. CORNER OF IL 64 & BURLINGTON RD.



DETECTABLE WARNINGS

SIDEWALK REMOVAL REPLACE W/TOPSOIL & SOD



HMA BIKE PATH REMOVAL REPLACE W/TOPSOIL & SOD

JSER NAME = shiranisb PLP 11/07/2016 DRAWN -PLP 10/04/2016 REVISED -PLP 08/11/2017 PLOT SCALE = 10.0000 ' / in. CHECKED -REVISED - PLP 09/14/2017 PLOT DATE = 12/11/2018 DATE REVISED - PLP 01/10/2018

STATE OF ILLINOIS **DEPARTMENT OF TRANSPORTATION** 


PROPOSED SIDE CURB

EXISTING ELEVATION/SLOPE

SIDEWALK DETAIL PLAN IL ROUTE 64 (EAST OF IL ROUTE 47 TO RANDALL ROAD) OF SHEETS STA.

SECTION COUNTY SHEETS NO.

KANE 47 29 2018-084-RS CONTRACT NO. 62H32

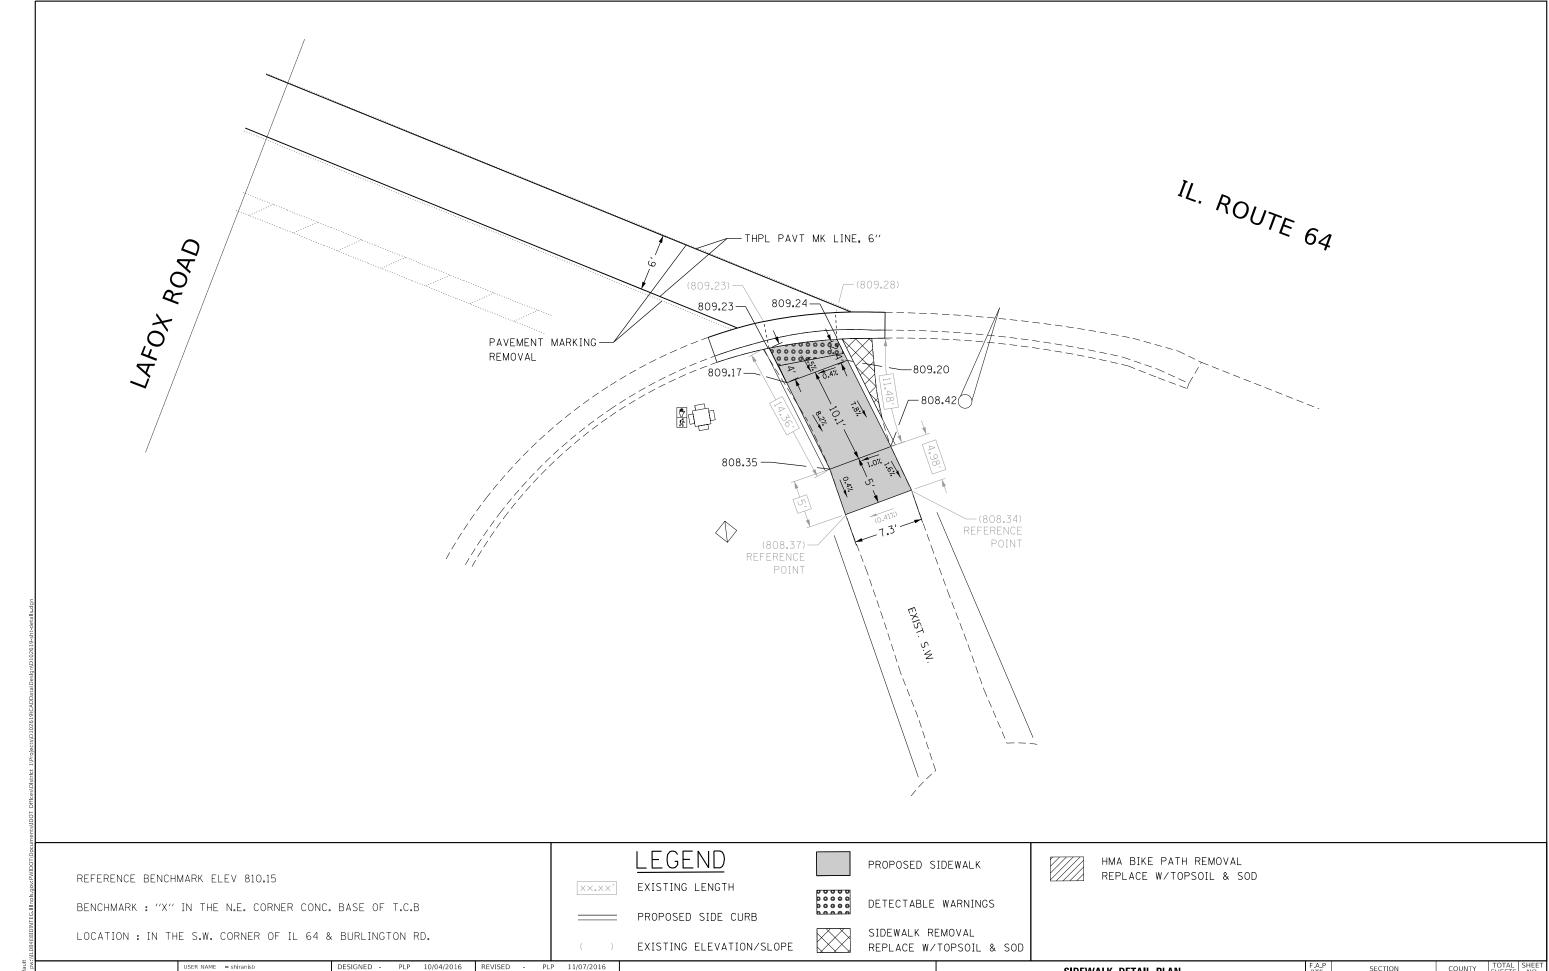

MODEL: Default

PLP 10/04/2016 REVISED - PLP 08/11/2017

REVISED - PLP 09/14/2017

REVISED - PLP 01/10/2018

DRAWN -

CHECKED -

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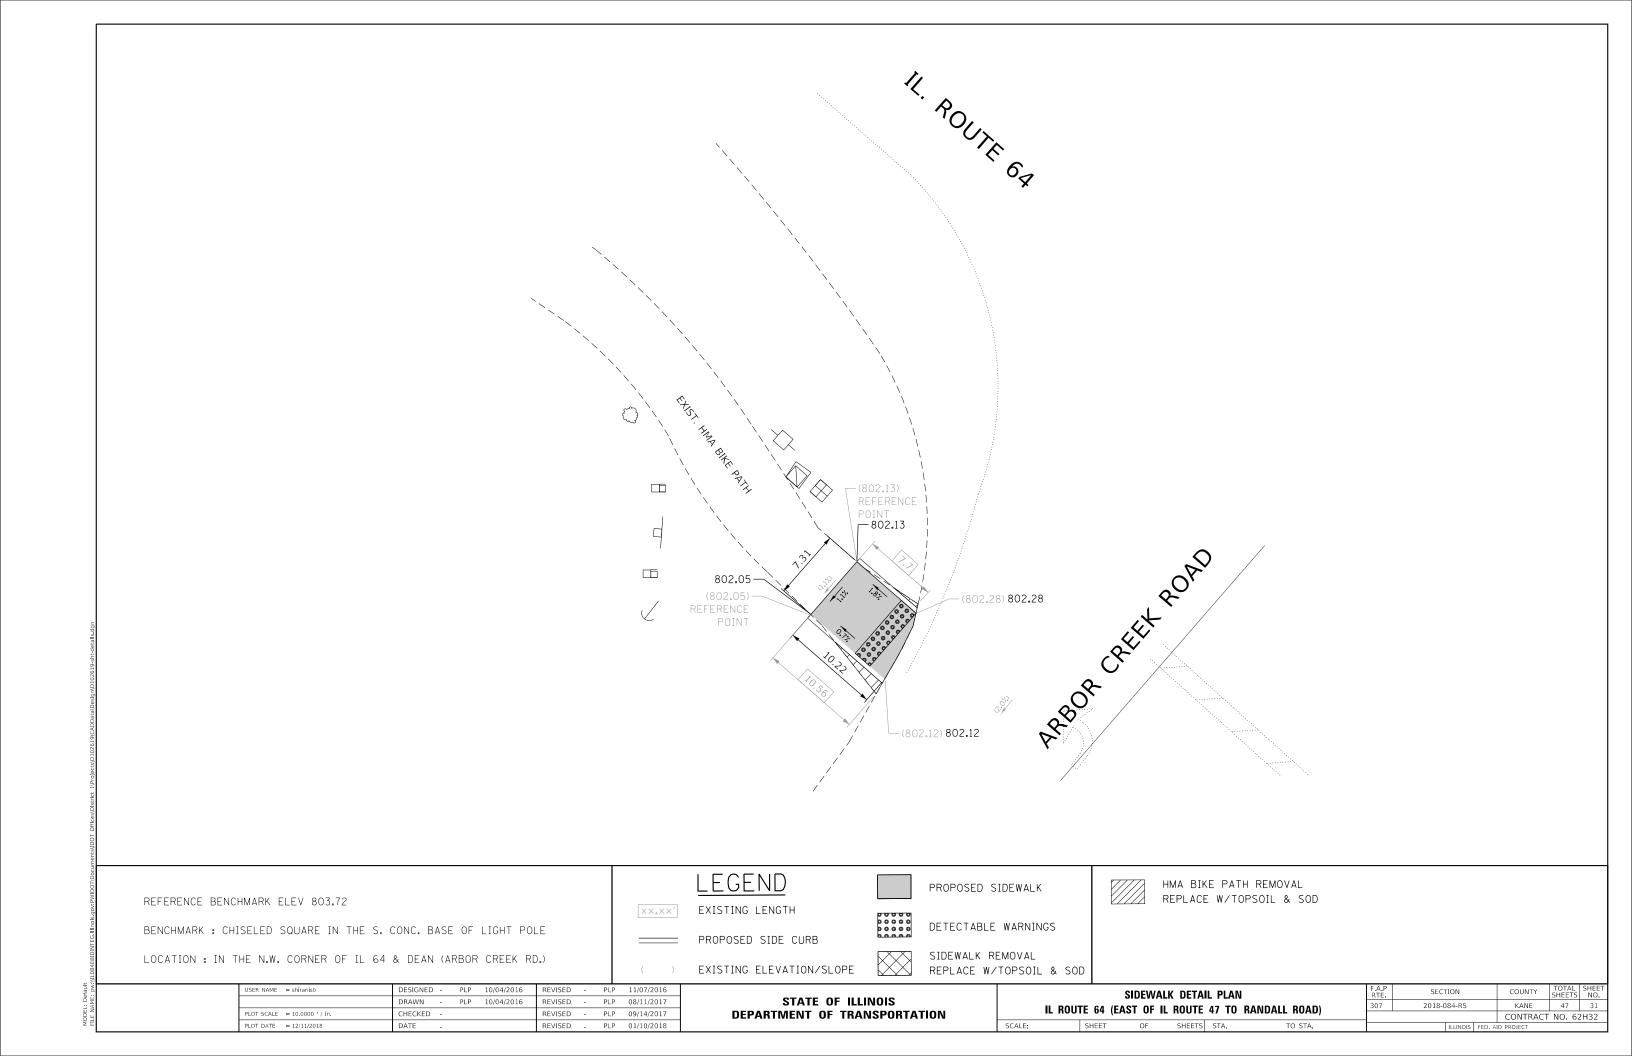
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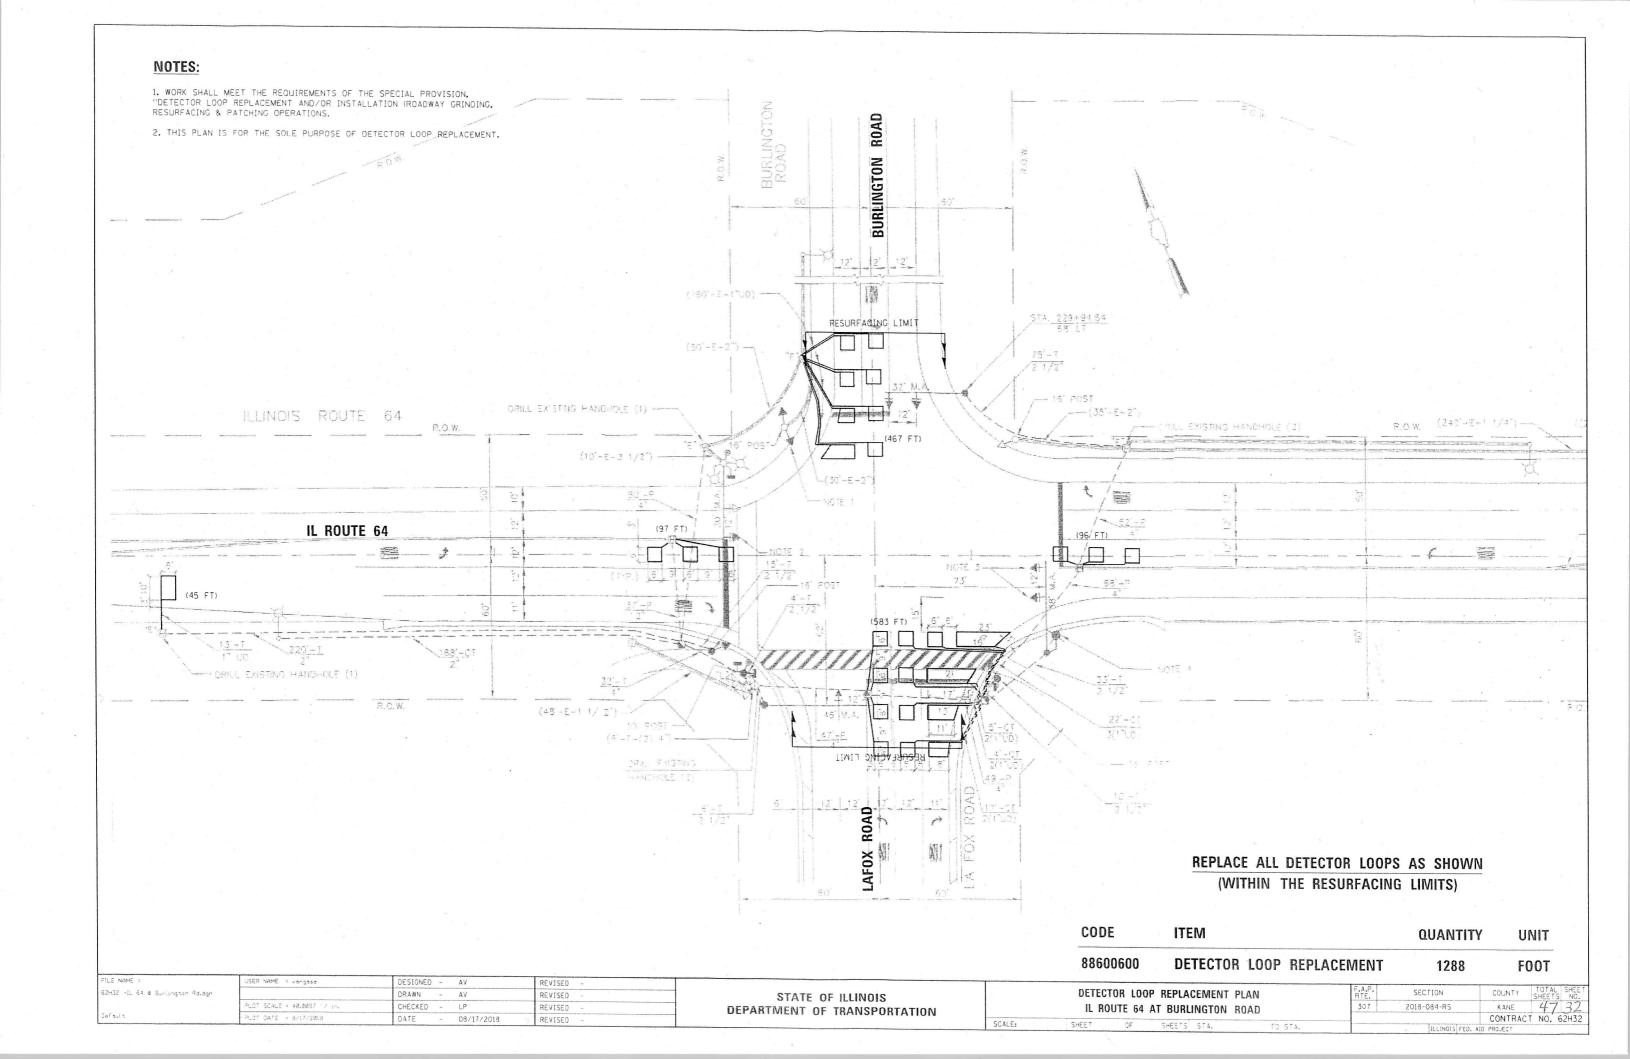
STATE OF ILLINOIS
DEPARTMENT OF TRANSPORTATION


SIDEWALK DETAIL PLAN


IL ROUTE 64 (EAST OF IL ROUTE 47 TO RANDALL ROAD)


SHEET OF SHEETS STA. TO STA.







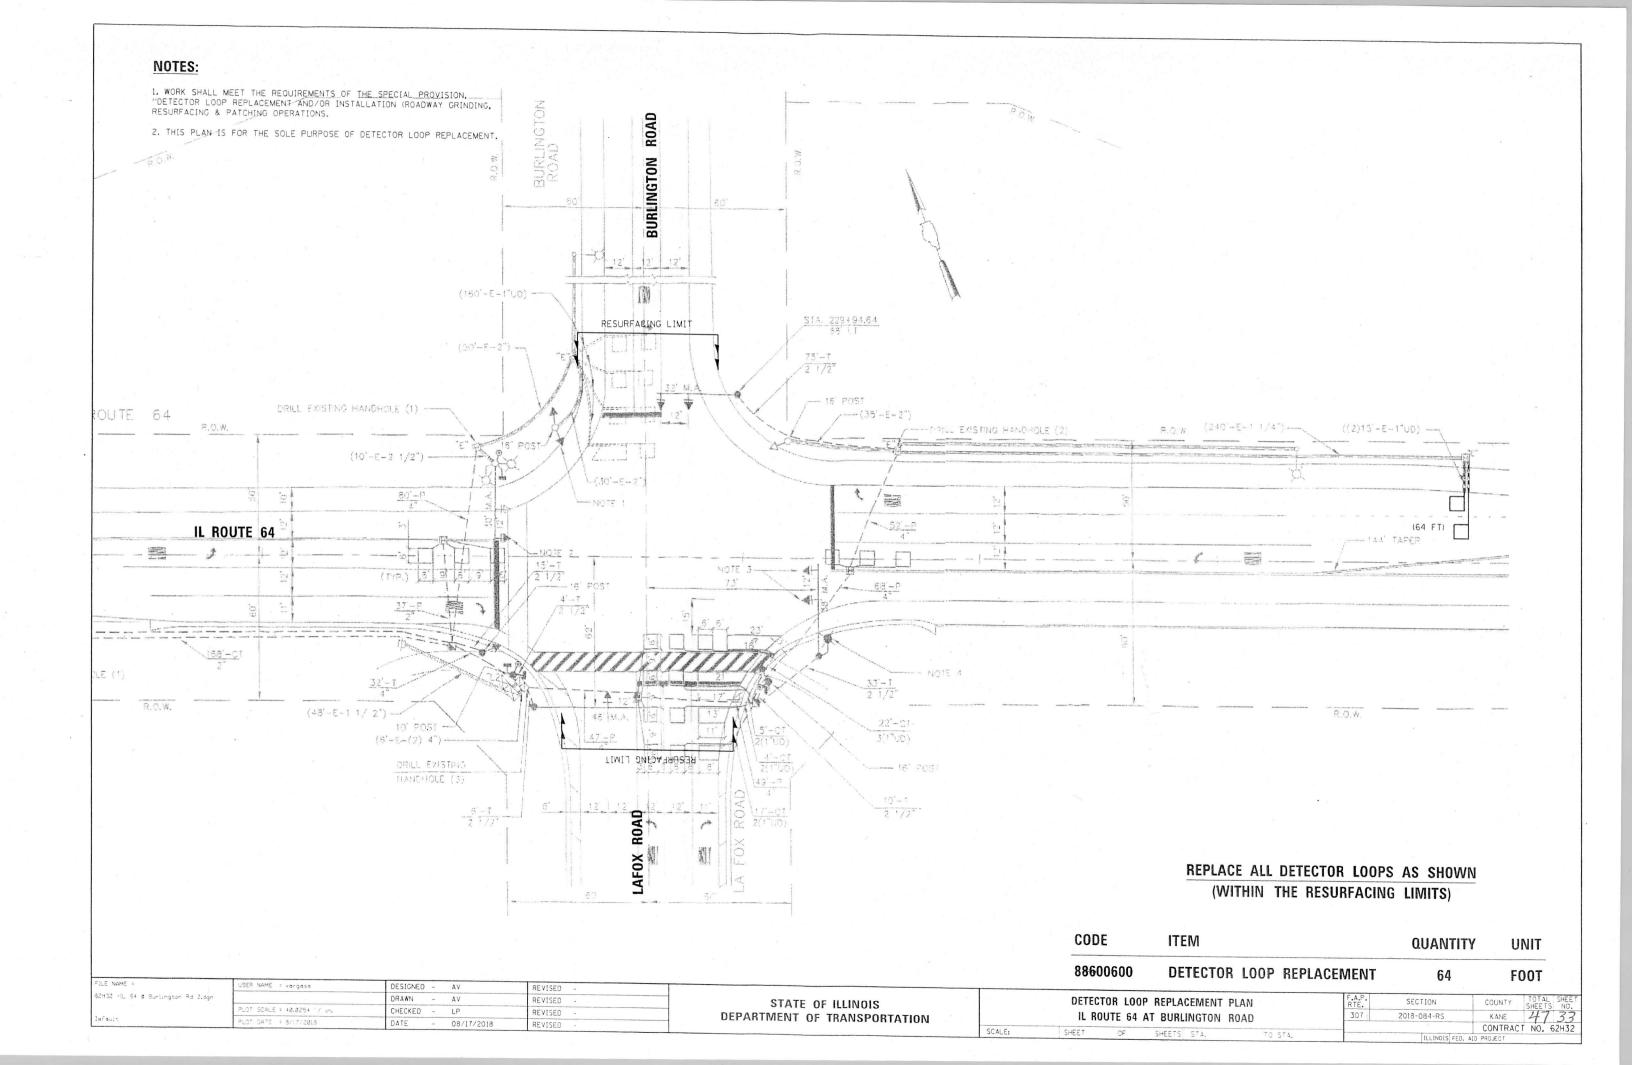


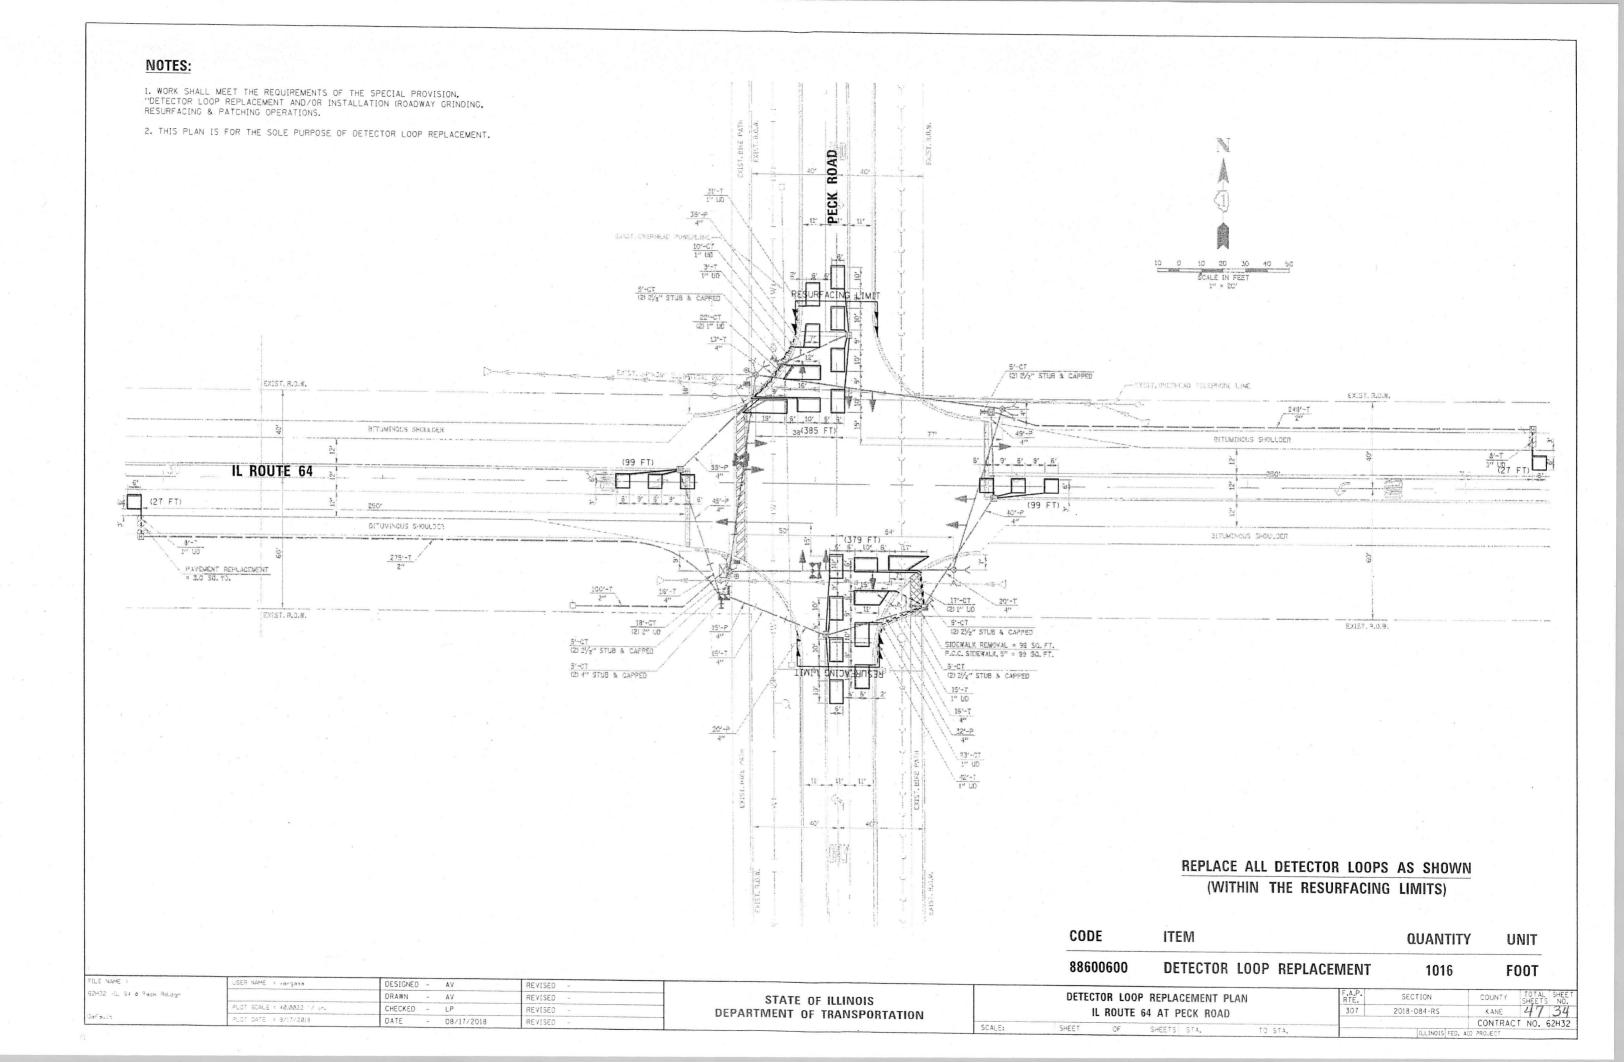

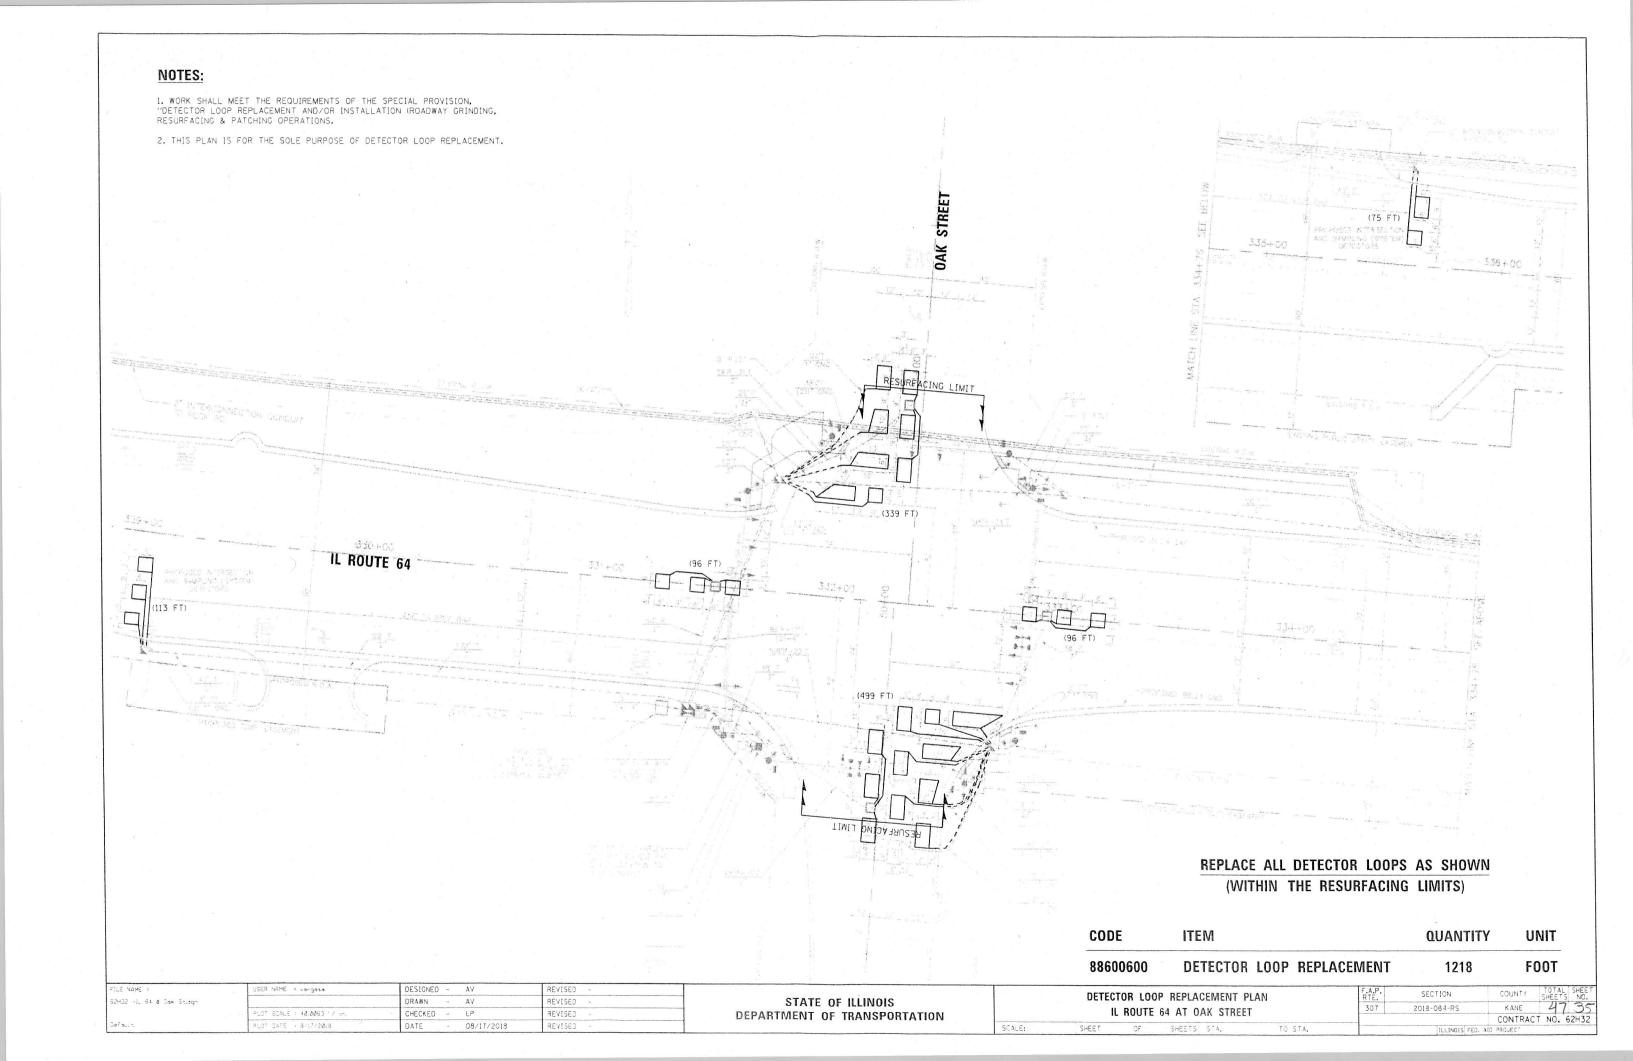

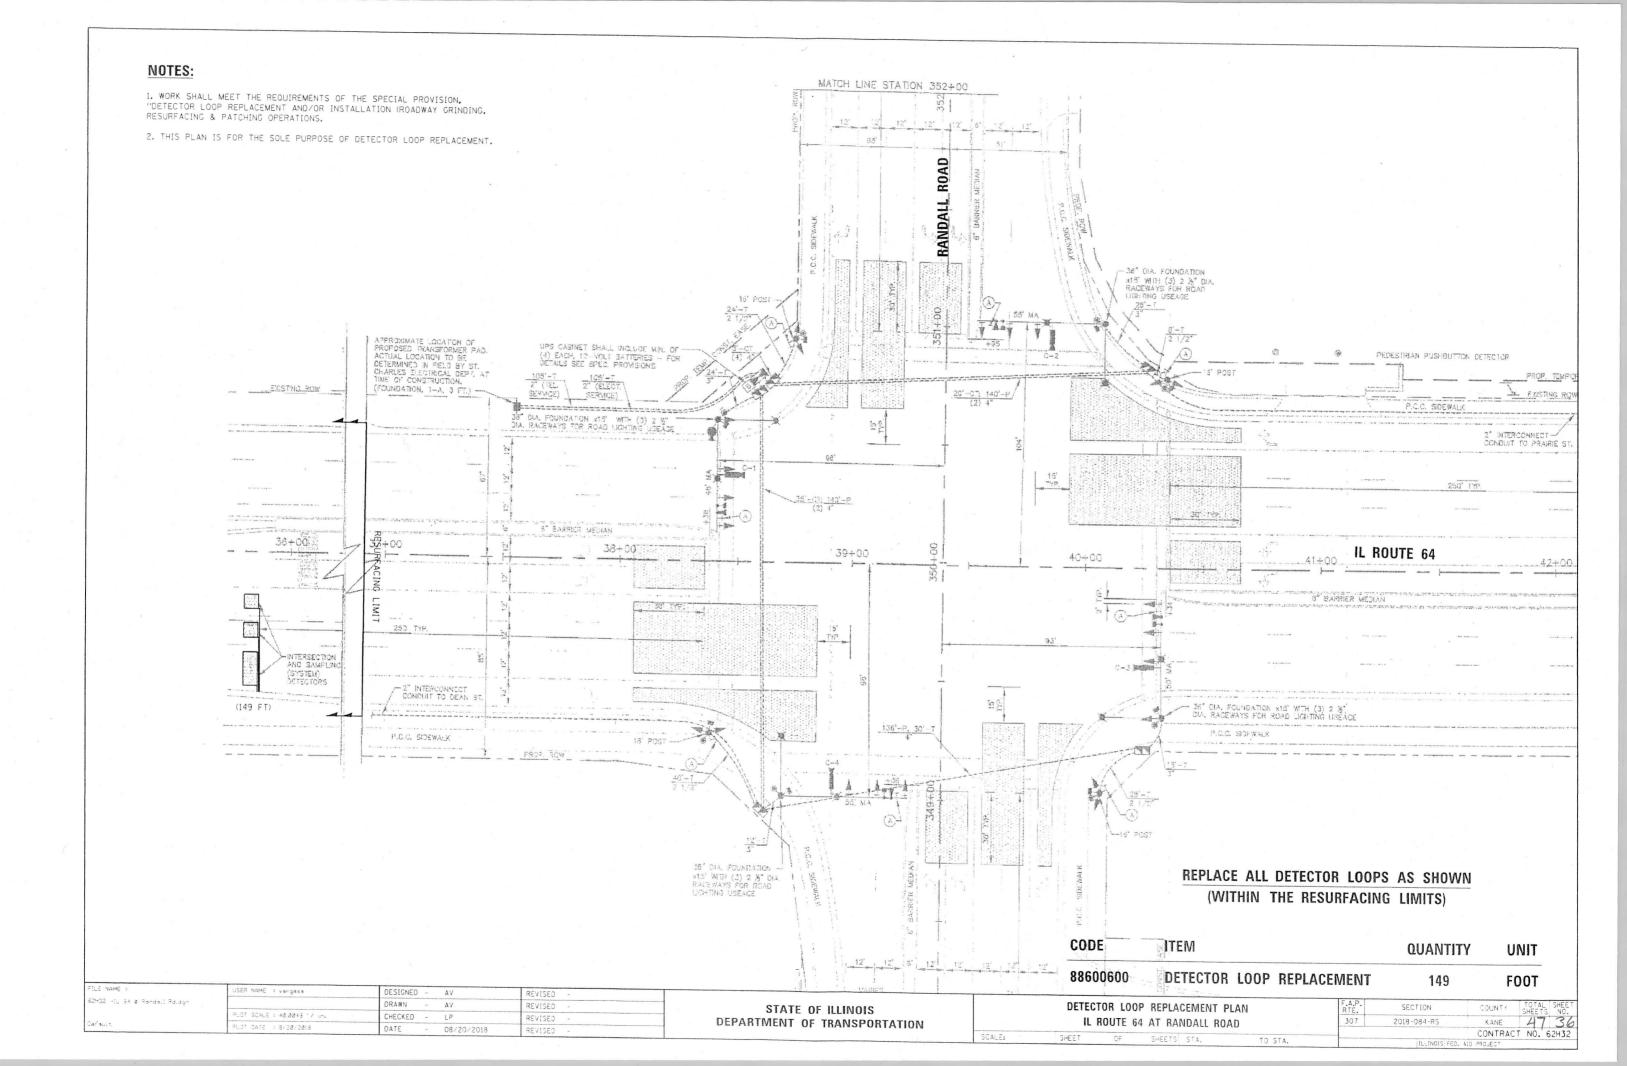

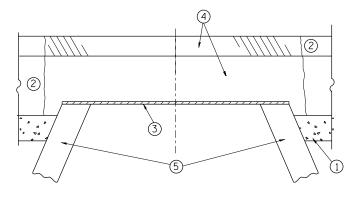

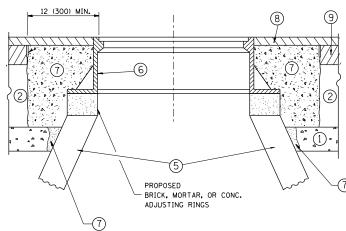

### NOTES:

EXISTING BROKEN FRAMES AND LIDS SHALL BE REMOVED AND DISPOSED OF BY THE CONTRACTOR AND SHALL BE REPLACED AS DIRECTED BY THE ENGINEER. REPLACEMENT FRAMES AND LIDS WILL BE PAID FOR IN ACCORDANCE WITH ARTICLE 109,04 OF THE STANDARD SPECIFICATIONS UNLESS A SEPARATE PAY ITEM HAS BEEN PROVIDED.

IF THE EXISTING LIDS ARE OPEN, THE FRAME WILL BE ADJUSTED TO THE ELEVATION OF THE MILLED PAVEMENT SURFACE PRIOR TO THE MILLING OPERATION. THE FRAME WILL NOT BE REMOVED AND COVERED BY THE METAL PLATE.

CITY OF CHICAGO CASTINGS ARE THE PROPERTY OF THE CITY AND THE CONTRACTOR SHALL NOTIFY THE CITY FOR REMOVAL AND DISPOSITION OF THE CASTINGS.

THE METAL PLATE USED TO COVER THE STRUCTURE SHALL REMAIN THE PROPERTY OF THE CONTRACTOR.

WHEN STRUCTURES ARE TO BE ADJUSTED OR RECONSTRUCTED. THE LOWERING AND RAISING OF THE FRAMES AND LIDS WILL NOT BE PAID FOR SEPARATELY BUT WILL BE INCLUDED IN THE COST OF THE CORRESPONDING PAY ITEM.

### CONSTRUCTION PROCEDURES

### STAGE 1 (BEFORE PAVEMENT MILLING)

- A) REMOVE A MINIMUM OF 12 (300) OF THE PAVEMENT FROM AROUND THE STRUCTURE.
- B) REMOVE THE EXISTING FRAME AND LID FROM THE STRUCTURE.
- C) COVER THE STRUCTURE OPENING WITH A 36 (900) DIAMETER METAL PLATE.

  D) BACKFILL WITH CRUSHED STONE AND A MINIMUM 11/2 (40)
- D) BACKFILL WITH CRUSHED STONE AND A MINIMUM 11/2 (40) THICK HMA SURFACE MIX APPROVED BY THE ENGINEER.

### STAGE 2 (AFTER PAVEMENT MILLING)

- A) REMOVE THE HMA SURFACE MIX AND CRUSHED STONE.
- B) INSTALL THE FRAME AND LID; ADJUST THE FRAME TO ITS FINAL SURFACE ELEVATION.
- C) THE SURROUNDING SPACE SHALL BE FILLED WITH CLASS PP-1\*
  CONCRETE TO THE ELEVATION OF THE SURFACE OF THE EXISTING
  BASE COURSE OR THE BINDER COURSE.
- \* UNLESS OTHERWISE SPECIFIED IN THE PLANS.

THE PROCEDURE EXPLAINED ABOVE SHALL CONFORM TO THE APPLICABLE PORTIONS OF SECTIONS 353, 406, 602, AND 603 OF THE STANDARD SPECIFICATIONS EXCEPT THAT "THE CONTRACTOR SHALL ADJUST THE STRUCTURES TO THE FINISHED PAVEMENT ELEVATION NO MORE THAN 5 CALENDAR DAYS PRIOR TO PLACEMENT OF THE FINAL LIFT OF SURFACE UNLESS APPROVED BY THE FINGINEFR."

### LEGEND

- 1 SUB-BASE GRANULAR MATERIAL
- (6) FRAME AND LID (SEE NOTES)
- 2 EXISTING PAVEMENT

(5) EXISTING STRUCTURE

- (7) CLASS PP-1\* CONCRETE
- 3 36 (900) DIAMETER METAL PLATE
- (8) PROPOSED HMA SURFACE COURSE
- PROPOSED CRUSHED STONE AND HMA SURFACE MIX
- (9) PROPOSED HMA BINDER COURSE

### LOCATION OF STRUCTURES:

THE CONTRACTOR WILL BE REQUIRED TO KEEP A RECORD OF THE LOCATIONS OF THE BURIED STRUCTURES ACCORDING TO THE STATION AND DISTANCE LEFT OR RIGHT OF THE CENTERLINE OF PAYEMENT. UPON COMPLETION OF THE WORK, THE CONTRACTOR WILL DELIVER THE RECORD TO THE ENGINEER.

### BASIS OF PAYMENT:

REMOVING FRAMES AND LIDS ON DRAINAGE AND UTILITY STRUCTURES IN THE PAVEMENT PRIOR TO MILLING, AND ADJUSTING TO FINAL GRADE PRIOR TO PLACING THE SURFACE COURSE, WILL BE PAID FOR AT THE CONTRACT UNIT PRICE EACH FOR "FRAMES AND LIDS TO BE ADJUSTED (SPECIAL,"

THIS WORK WILL NOT BE PAID FOR WHEN DRAINAGE AND UTILITY STRUCTURES ARE SPECIFIED FOR PAYMENT AS STRUCTURE RECONSTRUCTION.

NEW FRAMES AND LIDS, WHEN SPECIFIED, WILL BE PAID FOR SEPARATELY.

# DETAILS FOR FRAMES AND LIDS ADJUSTMENT WITH MILLING


ALL DIMENSIONS ARE IN INCHES (MILLIMETERS) UNLESS OTHERWISE SHOWN

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FILE NAME =	USER NAME = shiranisb	DESIGNED - R. SHAH	REVISED - R. WIEDEMAN 05-14-04
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	PLOT SCALE = 100.0000 '/ in.	CHECKED -	REVISED - R. BORO 03-09-11
	PLOT DATE = 12/11/2018	DATE - 10-25-94	REVISED - R. BORO 12-06-11

STATE OF ILLINOIS
DEPARTMENT OF TRANSPORTATION

DETAILS FOR	FAP RTE.	SECTION	COUNTY	TOTAL SHEETS	
FRAMES AND LIDS ADJUSTMENT WITH MILLING	307	2018-084-RS	KANE	47	Γ
		BD600-03 (BD-8)	CONTRACT	NO. 6	5
SCALE: NONE   SHEET NO. 1 OF 1 SHEETS   STA. TO STA.	FED. R	OAD DIST, NO. 1 ILLINOIS FED. AL	D PROJECT		Т

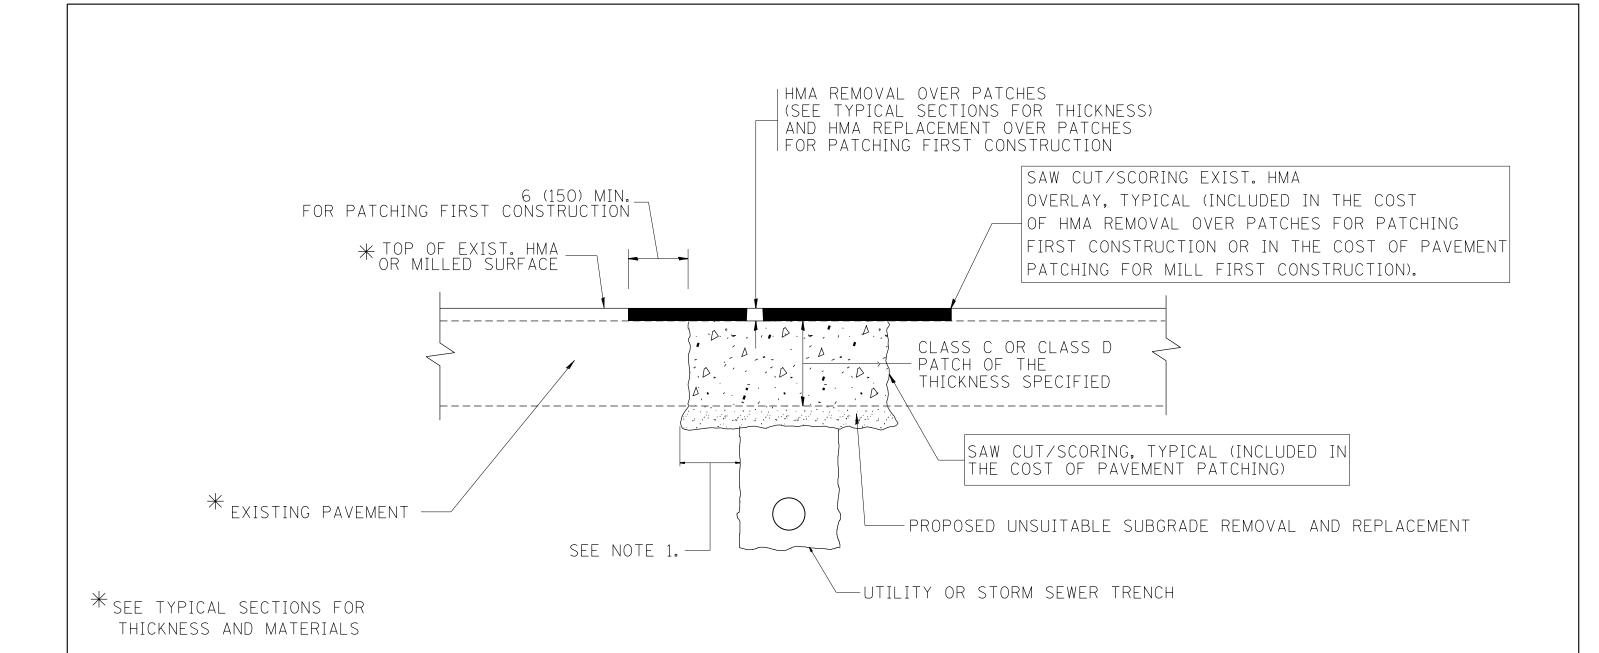

### NOTES:

- 1. THE WIDTH OF THE FULL DEPTH PATCH OVER A TRENCH SHALL BE 12 (300) WIDER ON EACH SIDE OF THE TRENCH.
- 2. FOR METHOD OF MEASUREMENT AND BASIS OF PAYMENT, SEE RECURRING SPECIAL PROVISION "PATCHING WITH HOT-MIX ASPHALT OVERLAY REMOVAL".

### SEQUENCE OF CONSTRUCTION (PATCHING FIRST)


- 1. REMOVE THE EXISTING HMA MATERIAL OVER THE AREA TO BE PATCHED.
- 2. REMOVE AND REPLACE WITH CLASS C OR D PATCH.
- 3. REPLACE HMA MATERIAL OVER THE AREA TO BE PATCHED.

### SEQUENCE OF CONSTRUCTION (MILLING FIRST)

- 1. MILL HMA FIRST IF THERE IS AT LEAST 41/2 INCHES OR MORE OF HMA MATERIAL ON TOP OF THE EXISTING PAVEMENT OR IF THE PAVEMENT IS FULL DEPTH HMA. A MINIMUM OF 2 INCHES OF HMA MATERIAL SHALL BE IN PLACE AFTER MILLING.
- 2. REMOVE AND REPLACE WITH FULL DEPTH CLASS D PATCHES TO TOP OF MILLED SURFACE.

ALL DIMENSIONS ARE IN INCHES (MILLIMETERS) UNLESS OTHERWISE SHOWN.


FILE NAME =	USER NAME = shiranisb	DESIGNED - R. SHAH	REVISED -	A. ABBAS 04-27-98			PAVEMENT PATCHING FOR		FAP	SECTION	COUNTY	TOTAL SH SHEETS 1	EET
pw:\\IL084EBIDINTEG.ıllınoıs.gov:PWIDOT\Do	cuments\IDOT Offices\District 1\Projects\D10	261 <b>9RAWIN</b> ata\Design\DistStd.dgn	REVISED -	R. BORO 01-01-07	STATE OF ILLINOIS				307	2018-084-RS	KANE	47	38
	PLOT SCALE = 100.0000 '/ in.	CHECKED -	REVISED -	R. BORO 09-04-07	DEPARTMENT OF TRANSPORTATION	HMA SURFACED PAVEMENT		В	3D400-04 (BD-22)	CONTRACT	NO. 621	132	
	PLOT DATE = 12/11/2018	DATE - 10-25-94	REVISED -	K. ENG 10-27-08		SCALE: NONE	SHEET NO. 1 OF 1 SHEETS STA.	TO STA.	FED. ROA	D DIST, NO. 1 ILLINOIS FED. AL			$\neg$

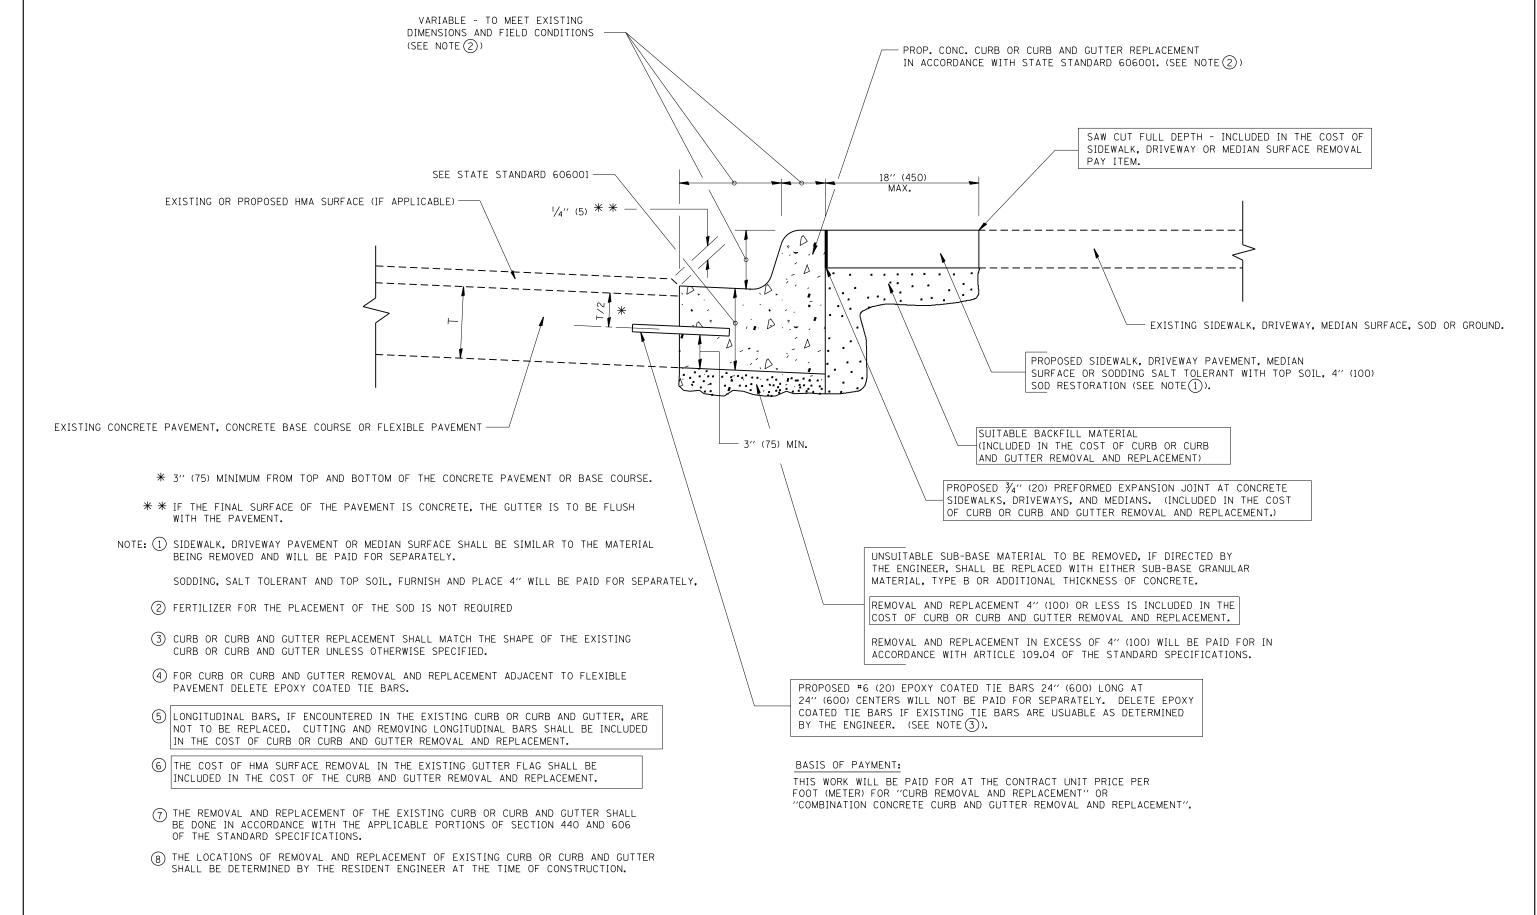


# CURB OR CURB AND GUTTER REMOVAL AND REPLACEMENT

ALL DIMENSIONS ARE IN INCHES (MILLIMETERS) UNLESS OTHERWISE SHOWN.

FILE NAME =	USER NAME = shiranisb	DESIGNED - A. HOUSEH	REVISED - R. SHAH 10-03-96			CURB OR CURB AND GUTTER	FAP	SECTION	COUNTY	SHEETS	NO.
pw:\\IL084EBIDINTEG.ıllınoıs.gov:PWIDOT\Do	:uments\IDOT Offices\District 1\Projects\D102	61 <b>9R0AWIN</b> ata\Design\DistStd.dgn	REVISED - A. ABBAS 03-21-97	STATE OF ILLINOIS			307	7 2018-084-RS	KANE	47	39
	PLOT SCALE = 100.0000 '/ in.	CHECKED -	REVISED - M. GOMEZ 01-22-01	DEPARTMENT OF TRANSPORTATION		REMOVAL AND REPLACEMENT		BD600-06 (BD-24)	CONTRAC	CT NO. 62	2H32
	PLOT DATE = 12/11/2018	DATE - 03-11-94	REVISED - R. BORO 12-15-09		SCALE: NONE	SHEET NO. 1 OF 1 SHEETS STA. TO STA.	FED.		S FED. AID PROJECT	,, ,,,,,,,,,,,,,,,,,,,,,,,,,,,,,,,,,,,	

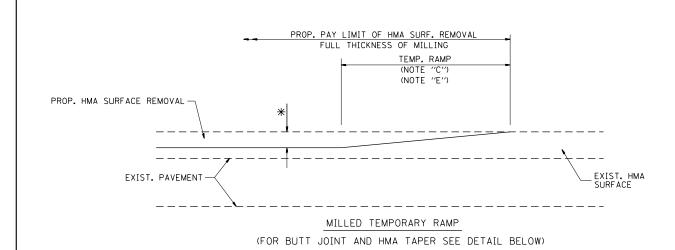


### OPTION 1

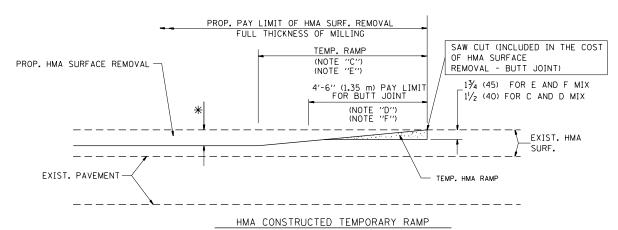

(FOR BUTT JOINT AND HMA TAPER SEE DETAIL BELOW)

# OPTION 2

### TYPICAL TEMPORARY RAMP

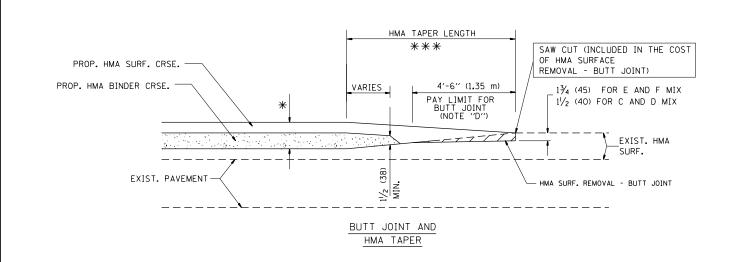



# TYPICAL BUTT JOINT AND HMA TAPER FOR MILLING AND RESURFACING

STATE OF ILLINOIS
DEPARTMENT OF TRANSPORTATION

ALL DIMENSIONS ARE IN INCHES (MILLIMETERS) UNLESS

OTHERWISE SHOWN.

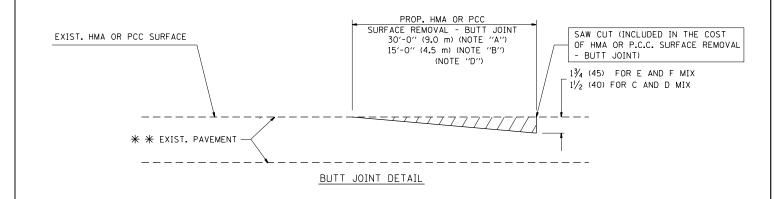

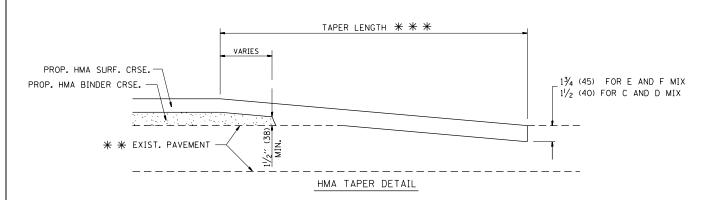

# TYPICAL BUTT JOINT AND HMA TAPER FOR RESURFACING ONLY


\* \* PC CONCRETE, HMA OR HMA RESURFACED PAVEMENT.

### NOTES


- A: MAINLINE ROADWAYS AND MAJOR SIDE ROADS.
- : MINOR SIDE ROADS.
- C: THE TEMP. RAMP SHALL BE CONSTRUCTED IMMEDIATELY UPON REMOVAL OF THE EXISTING HMA SURFACE.
- D: THE BUTT JOINT SHALL BE CONSTRUCTED IMMEDIATELY PRIOR TO PLACING THE PROPOSED HMA COURSES.
- E: TAPER THE TEMP. RAMP AT A RATE OF 3'-0" (900 mm) PER 1 INCH (25 mm) OF MILLING THICKNESS.
- F: INSTALLATION AND REMOVAL OF THE 4'-6" (1.35 m) TEMP. RAMP IS INCLUDED IN COST OF HMA SURFACE REMOVAL BUTT JOINT
- G: SEE ARTICLE 406.08 AND 406.14 OF THE STANDARD SPECIFICATIONS FOR "HMA AND/OR PCC SURFACE REMOVAL, BUTT JOINT".
- \* SEE TYPICAL SECTIONS FOR MILLING THICKNESS.


### BASIS OF PAYMENT:

THE BUTT JOINT WILL BE PAID FOR AT THE CONTRACT UNIT PRICE PER SQUARE YARD (SQUARE METER) FOR "HOT-MIX ASPHALT SURFACE REMOVAL - BUTT JOINT" OR FOR "PORTLAND CEMENT CONCRETE SURFACE REMOVAL- BUTT JOINT".

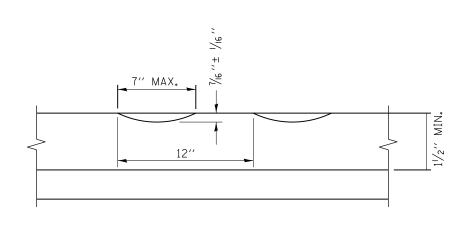

### SECTION A-A

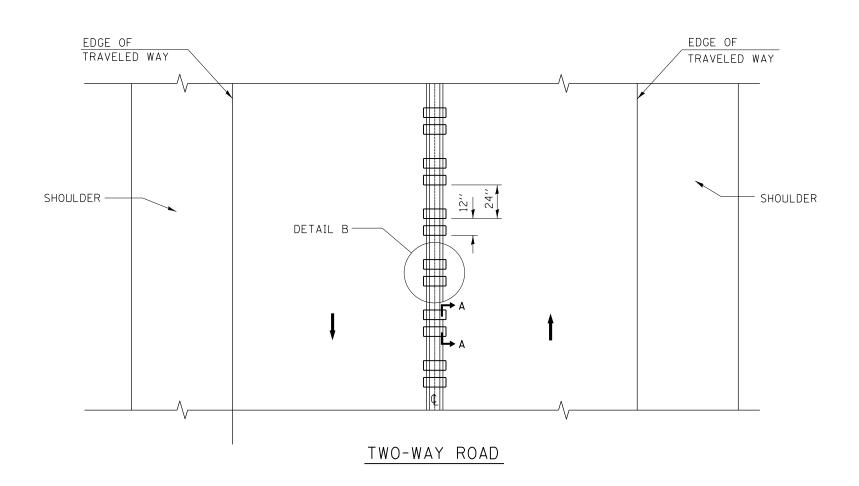

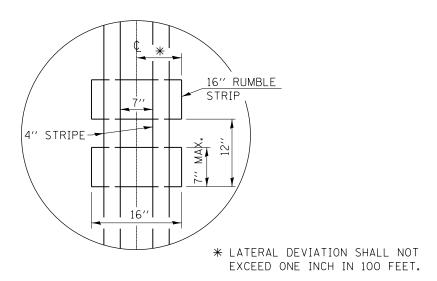

### DETAIL B

### GENERAL NOTES

CENTERLINE RUMBLE STRIPS SHALL BE CONSTRUCTED ACCORDING TO SECTION 642 ALONG THE CENTERLINE OF PAVEMENT.

SEE STANDARD 780001 FOR OTHER STRIPING LAYOUTS.
RUMBLE STRIPS SHALL NOT BE PLACED ON BRIDGES.

ALL RUMBLE STRIPS SHALL BE MILLED.

CENTERLINE RUMBLE STRIPS SHALL BE CONTINUOUS THROUGH CONNECTIONS OF SIDEROADS WITH NO LEFT TURN LANES.

DISCONTINUE CENTERLINE RUMBLE STRIPS THROUGH THE LIMITS OF ALL LEFT TURN LANES, INCLUDING ANY LANE TAPER SECTIONS.

AFTER RUMBLE STRIPS ARE INSTALLED, THE PAVEMENT SURFACE SHALL BE SWEPT CLEAN PRIOR TO THE PLACEMENT OF THE NEW PAVEMENT MARKINGS.

WHERE USED, ADJUST SPACING OF RAISED REFLECTIVE PAVEMENT MARKERS TO FALL IN WIDER GAP BETWEEN RUMBLE STRIPS.


### BASIS OF PAYMENT

THIS WORK WILL BE PAID FOR AT THE CONTRACT UNIT PRICE PER FOOT FOR CENTERLINE-RUMBLE STRIP OF THE WIDTH SPECIFIED.

HOT-SPRAY THERMOPLASTIC PAVEMENT MARKING WILL BE USED OVER THE RUMBLE STRIPS, AND WILL BE PAID FOR SEPARATELY.

FILE NAME =	USER NAME = shiranisb	DESIGNED - K. BORO	KENIZED -			
pw:\\IL084EBIDINTEG.:111:no:s.gov:PWIDOT\Do	cuments\IDOT Offices\District 1\Projects\D102	6 <b>19R0AMD</b> 9ata\Design\DistStd.dgn	REVISED -	STATE OF ILLINOIS		RUMBLE STRIPES
	PLOT SCALE = 100.0000 '/ in.	CHECKED -	REVISED -	DEPARTMENT OF TRANSPORTATION		
	PLOT DATE = 12/11/2018	DATE - 08-06-2012	REVISED -		SCALE: NONE	SHEET NO. 1 OF

ı	RUMBLE STRIPES FOR	R CENTER	LINE, NON	F.A.P RTE. 307	SECTION 2018-084-RS <b>BD 55</b>	COUNTY  KANE  CONTRACT	TOTAL SHEETS 47	SHEET NO. 41 2H32	
SHEET NO. 1 OF 1 SHEETS STA. TO STA.						AD DIST. NO. 1   ILLINOIS FED. A		1102	21132

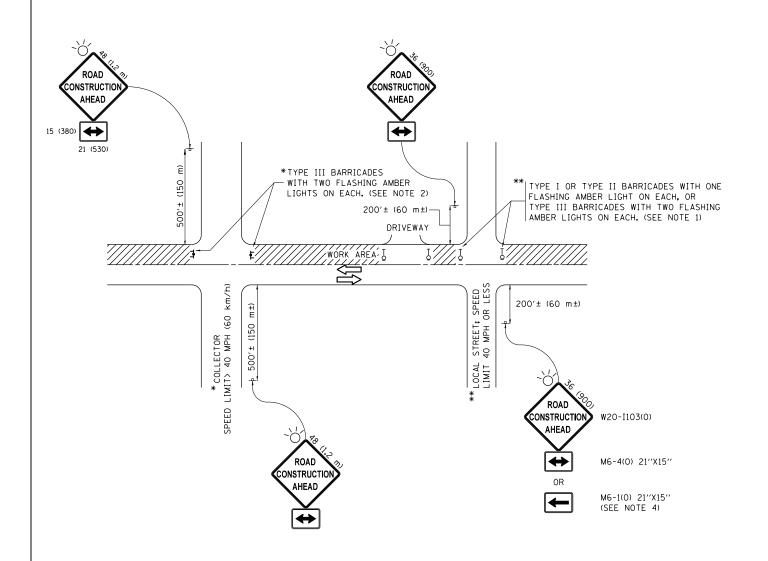

### **NOTES:**

- SIDE ROAD WITH A SPEED LIMIT OF 40 MPH (60 km/h) OR LESS AS SHOWN ON THE DRAWING AND AS DIRECTED BY THE ENGINEER:
  - a) ONE "ROAD CONSTRUCTION AHEAD" SIGN 36 x 36 (900x900) WITH A FLASHER MOUNTED ON IT APPROXIMATELY 200" (60 m) IN ADVANCE OF THE MAIN ROUTE.
  - b) THE CLOSED PORTION OF THE MAIN ROUTE SHALL BE PROTECTED BY BLOCKING WITH TYPE I, TYPE II OR TYPE III BARRICADES, 1/3 OF THE CROSS SECTION OF THE CLOSED PORTION.
- SIDE ROAD WITH A SPEED LIMIT GREATER THAN 40 MPH (60 km/h) AS SHOWN ON THE DRAWING AND AS DIRECTED BY THE ENGINEER:
  - a) ONE "ROAD CONSTRUCTION AHEAD" SIGN 48 x 48 (1.2 m x 1.2 m) WITH A FLASHER MOUNTED ON IT APPROXIMATELY 500" (150 m) IN ADVANCE OF THE MAIN ROUTE.
  - b) THE CLOSED PORTION OF THE MAIN ROUTE SHALL BE PROTECTED BY BLOCKING WITH TYPE III BARRICADES, 1/2 OF THE CROSS SECTION OF THE CLOSED PORTION.
- 3. CONES MAY BE SUBSTITUTED FOR BARRICADES OR DRUMS AT HALF THE SPACING DURING DAY OPERATIONS. CONES SHALL BE A MINIMUM OF 28 (710) IN HEICHT
- 4. WHEN THE SIDE ROAD LIES BETWEEN THE BEGINNING OF THE MAINLINE SIGNING AND THE WORK ZONE, A SINGLE HEADED ARROW (M6-1) SHALL BE USED IN LIEU OF THE DOUBLE HEADED ARROW (M6-4).

SCALE: NONE

- 5. WHEN WORK IS BEING PERFORMED ON A SIDE ROAD OR DRIVEWAY, FOLLOW THE APPLICABLE STANDARD(S). THE DIRECTIONAL ARROW (M6-1 OR M6-4) SHALL BE COVERED OR REMOVED WHEN NO LONGER CONSISTENT WITH THE TRAFFIC CONTROL SET-UP.
- 6. ADVANCE WARNING SIGNS ARE TO BE OMITTED ON DRIVEWAYS UNLESS OTHERWISE SPECIFIED IN THE PLANS OR BY THE ENGINFER.
- 7. THE TRAFFIC CONTROL AND PROTECTION FOR SIDE ROADS, INTERSECTIONS, AND DRIVEWAYS SHALL BE INCLUDED IN THE COST OF SPECIFIED TRAFFIC CONTROL STANDARDS OR ITEMS.


All dimensions are in inches (millimeters) unless otherwise shown.

FILE NAME =	USER NAME = shiranisb	DESIGNED - L.H.A.	REVISED	- A. HOUSEH 10-15-96
pw:\\IL084EBIDINTEG.:1ll:no:s.gov:PWIDOT\Do	cuments\IDOT Offices\District 1\Projects\D102	6 <b>DRAMD</b> ata\Design\DistStd.dgn	REVISED	-T. RAMMACHER 01-06-00
	PLOT SCALE = 100.0000 '/ in.	CHECKED -	REVISED	- A. SCHUETZE 07-01-13
Default	PLOT DATE = 12/11/2018	DATE - 06-89	REVISED	- A. SCHUETZE 09-15-16

STATE OF ILLINOIS	
<b>DEPARTMENT OF TRANSPORTATION</b>	


SI						TION FOR DRIVEWAYS	
	SHEET 1	OF	1	SHEETS	STA.	TO STA.	-


	ILLINOIS FED. AI	D PROJECT		
	TC-10	CONTRACT	NO. 6	2H32
307	2018-084-RS	KANE	47	42
FAP RTE.	SECTION	COUNTY	TOTAL SHEETS	SHEE NO.

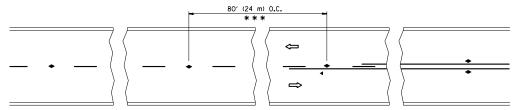


\*\*\* REDUCE TO 40' (12 m) O.C. ON CURVES WITH POSTED OR ADVISORY SPEED 45 M.P.H. (70 km/h) OR LESS.

TWO-LANE/TWO-WAY

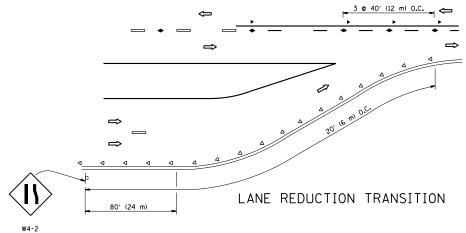


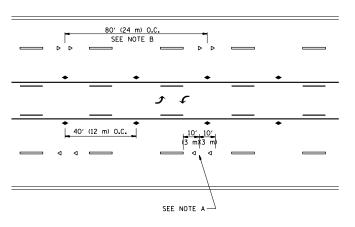

TWO-WAY LEFT TURN

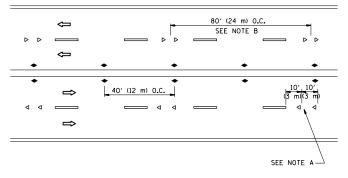

MULTI-LANE/UNDIVIDED

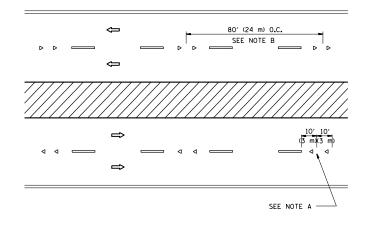

MULTI-LANE/DIVIDED

### GENERAL NOTES

- MARKERS USED WITH DASHED LINES SHALL BE CENTERED IN THE GAP BETWEEN SEGMENTS.
- 2. MARKERS USED ADJACENT TO SOLID LINES SHALL BE OFFSET 2 TO 3 (50 TO 75) TOWARD TRAFFIC AS SHOWN.
- 3. MARKERS THROUGH TANGENTS LESS THAN 500' (150 m) IN LENGTH BETWEEN CURVES SHALL BE INSTALLED AT THE LESSER OF THE TWO CURVE SPACINGS.

### LANE MARKER NOTES

A. USE DOUBLE LANE LINE MARKERS SPACED AS SHOWN.

B. REDUCE TO 40' (12 m) O.C. ON CURVES WHERE ADVISORY SPEEDS ARE 10 M.P.H (20 km/h) LOWER THAN POSTED SPEEDS.

### SYMBOLS

---- YELLOW STRIPE

---- WHITE STRIPE

- ONE-WAY AMBER MARKER
- ONE-WAY CRYSTAL MARKER (₩/O)
- ◆ TWO-WAY AMBER MARKER

### DESIGN NOTES

- 1. DOUBLE LANE LINE MARKERS SHALL BE USED UNLESS SPECIFIED OTHERWISE.
- 2. EXCEPT AS SHOWN ON THE LANE REDUCTION TRANSITION AND FREEWAY EXIT RAMP DETAIL, MARKERS ARE NOT TO BE SPECIFIED ON RIGHT EDGE LINES.
- 3. THE EXACT MARKER LIMITS, SPACING, AND COLOR SHALL BE INCLUDED IN THE PLANS WHEN STANDARD SPECIFICATIONS ARE NOT BEING USED.
- 4. MARKERS SHOULD NOT BE USED ALONGSIDE CURBS EXCEPT FOR EXTREMELY SHORT SECTIONS OF CURBS WHERE NOT MORE THAN TWO MARKERS WOULD BE INVOLVED.

# SEE TWO-LANE/TWO-WAY WHERE MARKERS CONTINUE


\*\* WHERE THE MEDIAN WIDTH IS 6' (2 m) OR LESS

USE TWO-WAY MARKERS.

LEFT TURN

All dimensions are in inches (millimeters) unless otherwise shown.

FILE NAME =	USER NAME = shiranisb	DESIGNED -	REVISED - T. RAMMACHER 09-19-94		TYPICAL APPLICATIONS	FAP RTF.	SECTION	COUNTY	TOTAL SHEE	T
pw:\\IL084EBIDINTEG.:ll:nois.gov:PWIDOT\Do	cuments\IDOT Offices\District 1\Projects\D102		REVISED -T. RAMMACHER 03-12-99	STATE OF ILLINOIS	RAISED REFLECTIVE PAVEMENT MARKERS (SNOW-PLOW RESISTANT)	307	2018-084-RS	KANE	47 43	٦
	PLOT SCALE = 100.0000 ' / in.	CHECKED -	REVISED -T. RAMMACHER 01-06-00	DEPARTMENT OF TRANSPORTATION	, , , , , , , , , , , , , , , , , , , ,		TC-11	CONTRAC	CT NO. 62H32	2
	PLOT DATE = 12/11/2018	DATE -	REVISED - C. JUCIUS 09-09-09		SCALE: NONE   SHEET NO. 1 OF 1 SHEETS   STA. TO STA.	FED. ROA	AD DIST. NO. 1 ILLINOIS	FED. AID PROJECT		П

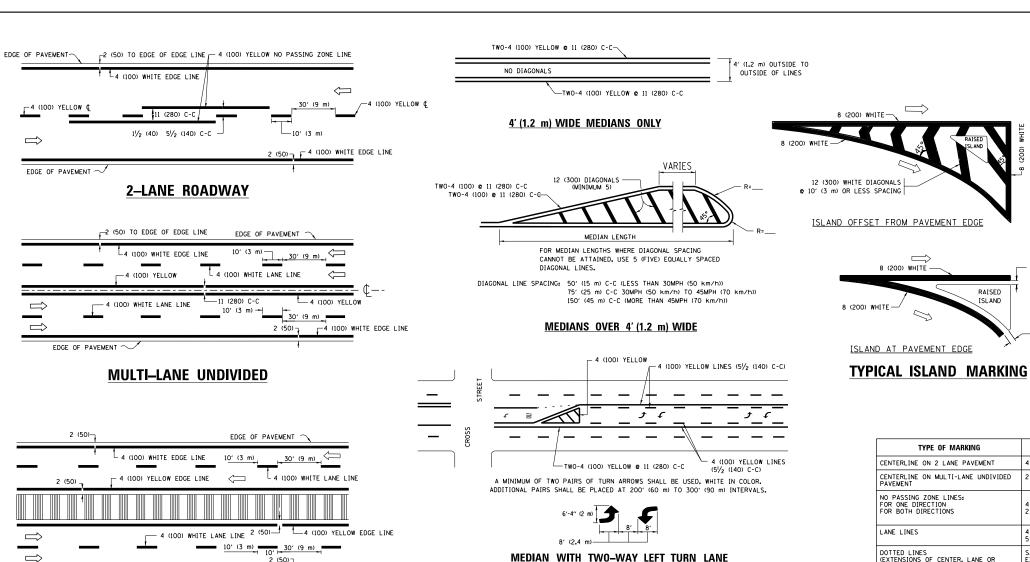


(100) WHITE EDGE LINE

### TYPICAL LANE AND EDGE LINE MARKING

**MULTI-LANE DIVIDED** WITH MEDIAN


EDGE OF PAVEMENT ~

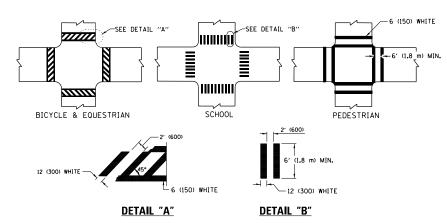

### TYPICAL CROSSWALK MARKING

₩ MARKINGS SHALL BE INSTALLED PARALLEL TO THE CENTERLINE OF THE ROAD WHICH IT CROSSES

## MEDIAN WITH TWO-WAY LEFT TURN LANE TYPICAL PAINTED MEDIAN MARKING

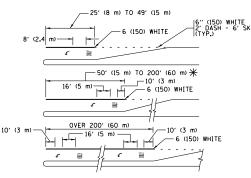


FULL SIZE LETTERS 8' (2.4 m) AND ARROWS SHALL BE USED. AREA = 15.6 SO. FT. (1.5 m<sup>2</sup>) ONLY AREA = 20.8 SO. FT. (1.9 m<sup>2</sup>)

\* TURN LANES IN EXCESS OF 400' (120 m) IN LENGTH MAY HAVE AN ADDITIONAL SET OF ARROW - "ONLY" INSTALLED MIDWAY BETWEEN THE OTHER TWO SETS OF ARROW - "ONLY".

TYPICAL LEFT (OR RIGHT) TURN LANE

### TYPICAL TURN LANE MARKING

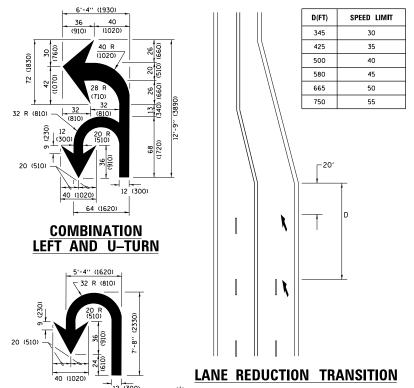

 $\divideontimes$  LANE REDUCTION ARROWS REQUIRED AT SPEEDS OF 45 MPH OR GREATER OR WHEN SPECIFIED IN PLANS.

TYPE OF MARKING	WIDTH OF LINE	PATTERN	COLOR	SPACING /REMARKS
CENTERLINE ON 2 LANE PAVEMENT	4 (100)	SKIP-DASH	YELLOW	10' (3 m) LINE WITH 30' (9 m) SPACE
CENTERLINE ON MULTI-LANE UNDIVIDED PAVEMENT	2 @ 4 (100)	SOLID	YELLOW	11 (280) C-C
NO PASSING ZONE LINES: FOR ONE DIRECTION FOR BOTH DIRECTIONS	4 (100) 2 <b>Q</b> 4 (100)	SOLID SOLID	YELLOW YELLOW	5½ (140) C-C FROM SKIP-DASH CENTERLINE 11 (280) C-C OMIT SKIP-DASH CENTERLINE BETWEEN
LANE LINES	4 (100) 5 (125) ON FREEWAYS	SKIP-DASH SKIP-DASH	WHITE WHITE	10' (3 m) LINE WITH 30' (9 m) SPACE
DOTTED LINES (EXTENSIONS OF CENTER, LANE OR TURN LANE MARKINGS)	SAME AS LINE BEING EXTENDED	SKIP-DASH	SAME AS LINE BEING EXTENDED	2' (600) LINE WITH 6' (1.8 m) SPACE
EDGE LINES	4 (100)	SOLID	YELLOW-LEFT WHITE-RIGHT	OUTLINE MEDIANS IN YELLOW
TURN LANE MARKINGS	6 (150) LINE: FULL SIZE LETTERS & SYMBOLS (8' (2.4m))	SOLID	WHITE	SEE TYPICAL TURN LANE MARKING DETAIL
TWO WAY LEFT TURN MARKING	2 @ 4 (100) EACH DIRECTION 8' (2.4m) LEFT ARROW	SKIP-DASH AND SOLID IN PAIRS	YELLOW	10' (3 m) LINE WITH 30' (9 m) SPACE FOR SKIP-DASH; 5½ (140) C-C BETWEEN SOLID LINE AND SKIP-DASH LINE SEE TYPICAL TWO-WAY LEFT TURN MARKING DETAIL
CROSSWALK LINES (PEDESTRIAN) A. DIAGONALS (BIKE & EQUESTRIAN) B. LONGITUDINAL BARS (SCHOOL)	2 <b>e</b> 6 (150) 12 (300) <b>e</b> 45° 12 (300) <b>e</b> 90°	SOLID SOLID SOLID	WHITE WHITE WHITE	NOT LESS THAN 6' (1.8 m) APART 2' (600) APART 2' (600) APART 5EE TYPICAL CROSSWALK MARKING DETAILS.
STOP LINES	24 (600)	SOLID	WHITE	PLACE 4' (1.2 m) IN ADVANCE OF AND PARALLEL TO CROSSMALK, IF PRESENT. OTHERMISE, PLACE AT DESIRED STOPPING POINT. PARALLEL TO CROSSROAD CENTERLINE, WHERE POSSIBLE
PAINTED MEDIANS	2 @ 4 (100) WITH 12 (300) DIAGONALS @ 45° NO DIAGONALS USED FOR 4' (1.2 m) WIDE MEDIANS	SOLID	YELLOW: TWO WAY TRAFFIC WHITE: ONE WAY TRAFFIC	11 (280) C-C FOR THE DOUBLE LINE SEE TYPICAL PAINTED MEDIAN MARKING.
GORE MARKING AND CHANNELIZING LINES	8 (200) WITH 12 (300) DIAGONALS @ 45°	SOLID	WHITE	DIAGONALS: 15' (4,5 m) C-C (LESS THAN 30MPH (50 km/h)) 20' (6 m) C-C 30MPH (50 km/h) TO 45MPH (70 km/h)) 30' (9 m) C-C (OVER 45MPH (70 km/h))
RAILROAD CROSSING	24 (600) TRANSVERSE LINES; "RR" IS 6' (1.8 m) LETTERS; 16 (400) LINE FOR "X"	SOLID	WHITE	SEE STATE STANDARD 780001 AREA OF: "R":3.6 SO, FT. (0.33 m²) EACH "X":54.0 SO, FT. (5.0 m²)
SHOULDER DIAGONALS (REQUIRED FOR SHOULDERS > 8')	12 (300) <b>@</b> 45°	SOLID	WHITE - RIGHT YELLOW - LEFT	50' (15 m) C-C (LESS THAN 30MPH (50 km/h)) 75' (25 m) C-C (30 MPH (50 km/h) T0 45MPH (70 km/h); 150' (45 m) C-C (0VER 45MPH (70 km/h))
U TURN ARROW	SEE DETAIL	SOLID	WHITE	16.3 SF
2 ARROW COMBINATION	SEE DETAIL	SOLID	WHITE	30,4 SF

— 2 (50)

RAISED

ISLAND

8 (200) WHITE -

FOR FURTHER DETAILS ON PAVEMENT MARKING REFER TO STANDARD SPECIFICATIONS FOR ROAD AND BRIDGE CONSTRUCTION AND STATE STANDARD 780001.


SCALE: NONE

DESIGNED - EVERS REVISED - C. JUCIUS 09-09-09 USER NAME = shiranisb ow:\\ILØ84EBIDINTEG.ıllınoıs uments\IDOT Offices\District 1\Projects\D102619RQANDNata\Design\DistStd.dgn REVISED -C. JUCIUS 07-01-13 CHECKED REVISED -C. JUCIUS 12-21-15 REVISED - C. JUCIUS 04-12-16 PLOT DATE = 12/11/2018 DATE 03-19-90

STATE OF ILLINOIS **DEPARTMENT OF TRANSPORTATION** 


		OIST	RICT O	NE		FAP RTE.	SECTION	COUNTY	TOTAL SHEETS	SHEET NO.
DISTRICT ONE TYPICAL PAVEMENT MARKINGS				307	2018-084-RS	KANE	47	44		
	UAL I	~					TC-13	CONTRACT	NO. 6	2H32
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# TURN BAY ENTRANCE AT START OF LANE CLOSURE TAPER

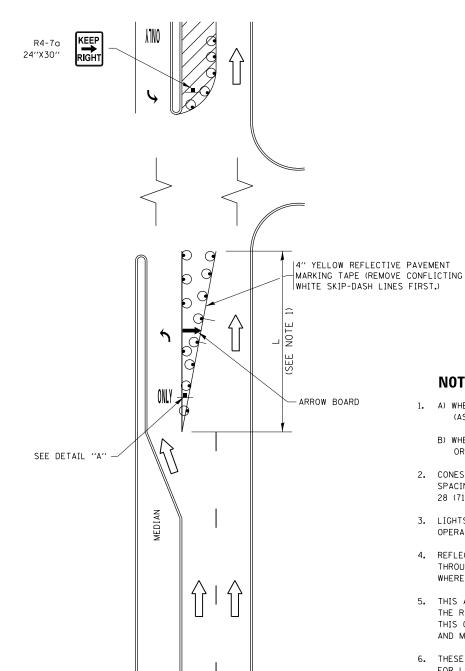


# FIGURE 1

# TURN BAY ENTRANCE WITHIN A LANE CLOSURE

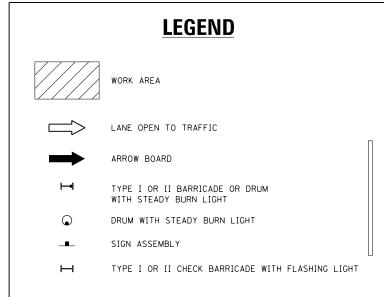

### NOTES:


- 1. A) WHEN "L" IS < THE STORAGE LENGTH OF THE TURN LANE (AS SHOWN IN FIG. 1), USE FIGURE 1.
  - B) WHEN "L" IS > THE STORAGE LENGTH OF THE TURN LANE OR THE TURN LANE IS WITHIN THE LANE CLOSURE, USE FIGURE 2.
- 2. CONES MAY BE SUBSTITUTED FOR BARRICADES OR DRUMS AT HALF THE SPACING DURING DAY OPERATIONS. CONES SHALL BE A MINIMUM OF 28 (710) IN HEIGHT.
- 3. LIGHTS WILL NOT BE REQUIRED ON BARRICADES OR DRUMS FOR DAY OPERATIONS. ALL LIGHTS SHALL BE MONODIRECTIONAL.
- 4. REFLECTIVE TEMPORARY PAVEMENT MARKINGS SHALL BE PLACED THROUGHOUT THE BARRICADED AREAS OF EACH TURN BAY AS SHOWN WHERE THE CLOSURE TIME IS GREATER THAN FOURTEEN (14) DAYS.
- 5. THIS APPLICATION ALSO APPLIES WHEN WORK IS BEING PERFORMED IN THE RIGHT LANE(S) AND THE RIGHT TURN BAY IS TO REMAIN OPEN. UNDER THIS CONDITION, "RIGHT TURN LANE" R3-1100R 24 x 24 (600 x 600) AND M6-2R 21  $\times$  15 (530  $\times$  380) SHALL BE USED.
- 6. THESE CONTROLS SHALL SUPPLEMENT MAINLINE TRAFFIC CONTROL FOR LANE CLOSURES.
- 7. THE SIGNS SHALL BE MOUNTED ABOVE THE BARRICADES/DRUMS ON SEPARATE SIGN SUPPORTS THAT MEET NCHRP 350 OR MASH PREQUIREMENTS.
- 8. TRAFFIC CONTROL AND PROTECTION AT TURN BAYS (TO REMAIN OPEN TO TRAFFIC) SHALL BE INCLUDED IN THE COST OF SPECIFIED TRAFFIC CONTROL STANDARDS OR ITEMS.

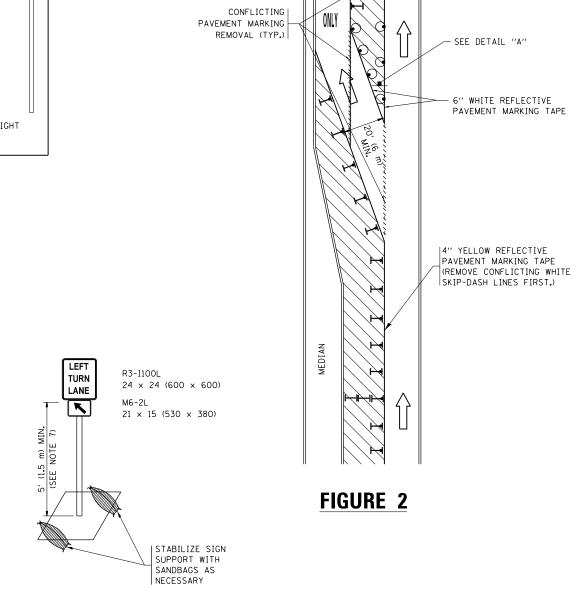

# **DETAIL A**


All dimensions are in inches (millimeters) unless otherwise shown.

FILE NAME = REVISED -T. RAMMACHER 09-08-94 REVISED - R. BORO 09-14-09 USER NAME = shiranisb SECTION COUNTY TRAFFIC CONTROL AND PROTECTION AT TURN BAYS SHEETS NO. STATE OF ILLINOIS w:\\ILØ84EBIDINTEG.,111r nents\IDOT Offices\District 1\Projects\Di026REW4SEAbo\Design\@isHBUSEH 11-07-95 REVISED - A. SCHUETZE 07-01-13 2018-084-RS KANE (TO REMAIN OPEN TO TRAFFIC) REVISED - A. HOUSEH 10-12-96 REVISED - A. SCHUETZE 09-15-16 DEPARTMENT OF TRANSPORTATION TC-14 CONTRACT NO. 62H32 SCALE: NONE SHEET 1 OF 1 SHEETS STA. TO STA. PLOT DATE = 12/11/2018 REVISED -T. RAMMACHER 01-06-00 REVISED

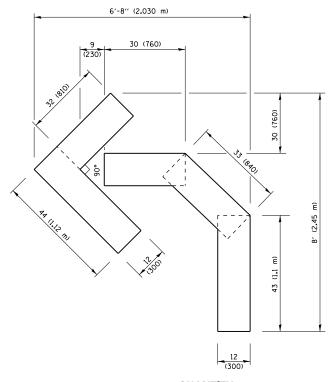


### QUANTITY

4 (100) LINE = 45.5 ft. (13.9 m) 15.2 sq. ft. (1.41 sq. m)

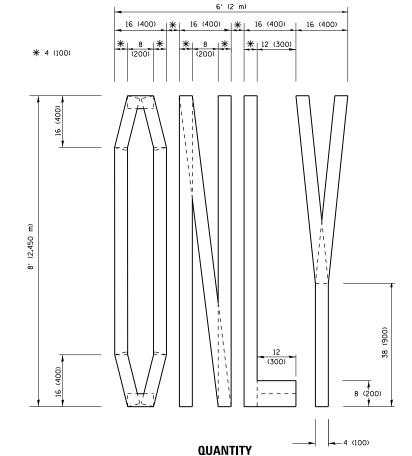

4 (100) LINE = 64.1 ft. (19.5 m) 21.4 sq. ft. (1.99 sq. m)

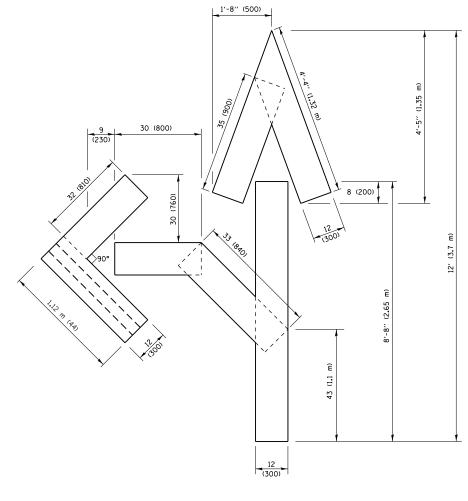


### QUANTITY

4 (100) LINE = 82.5 ft. (25.1 m) 27.5 sq. ft. (2.53 sq. m)

### NOTE:


ALL QUANTITIES OF PLACEMENT ARE REPRESENTED IN LINEAR FEET OF 4" LINES TO MATCH THE 4" TEMPORARY TAPE PAY ITEM AND REPRESENTS THE TOTAL QUANTITY OF 4" TAPE REQUIRED.

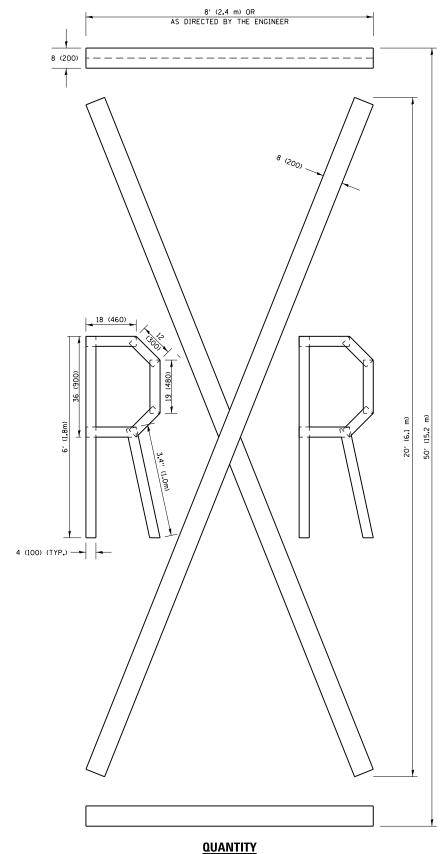

4 (100) LINE = 225.9 ft. (68.9 m) 75.3 sq. ft. (6.99 sq. m)

> All dimensions are in inches (millimeters) unless otherwise shown.

FILE NAME =	USER NAME = shiranisb	DESIGNED -	REVISED	-T. RAMMACHER 03-02-98					FAP	SECTION	COUNTY	TOTAL	SHEET
pw:\\ILØ84EBIDINTEG.:ll:nois.gov:PWIDOT\Do	cuments\IDOT Offices\District 1\Projects\D102	6 <b>19R0AWIN</b> ata\Design\DistStd.dgn	REVISED	-E. GOMEZ 08-28-00	STATE OF ILLINOIS	SHO	ORT TERM PAVEMENT MARKING LETTERS	AND SYMBOLS	307	2018-084-RS	KANE	47	46
	PLOT SCALE = 100.0000 ' / in.	CHECKED -	REVISED	-E. GOMEZ 08-28-00	DEPARTMENT OF TRANSPORTATION					TC-16	CONTRAC	T NO. 1	52H32
	PLOT DATE = 12/11/2018	DATE - 09-18-94	REVISED	- A. SCHUETZE 09-15-16		SCALE: NONE	SHEET NO. 1 OF 1 SHEETS STA.	TO STA.	FED. ROAD D	DIST. NO. 1 ILLINOIS FED. A	D PROJECT		

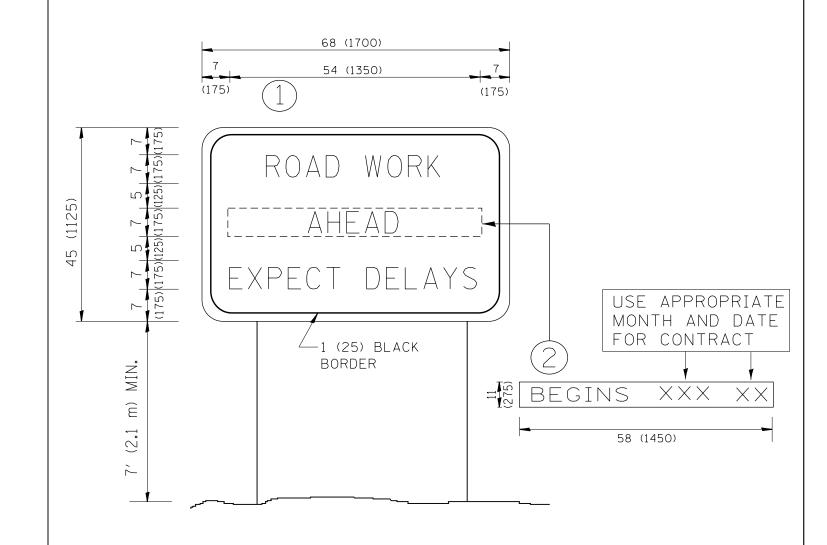

# NOTES:

- 1. USE BLACK LETTERING ON ORANGE BACKGROUND.
- 2. ERECT SIGNS IN ADVANCE OF THE LOCATION FOR THE "ROAD CONSTRUCTION AHEAD" SIGN AT LOCATIONS AS DIRECTED BY THE ENGINEER.
- 3. ERECT SIGN (1) WITH INSTALLED PANEL (2) ONE WEEK PRIOR TO THE START OF CONSTRUCTION.
- 4. REMOVE PANEL (2) SOON AFTER THE START OF CONSTRUCTION.
- 5. SEE SPECIAL PROVISION FOR "TEMPORARY INFORMATION SIGNING" FOR ADDITIONAL INFORMATION.
- 6. ONE SIGN ASSEMBLY EQUALS 25.70 SQ. FT. (2.3 SQ. M.)
- 7. SHALL BE PAID FOR AS TEMPORARY INFORMATION SIGNING.

ALL DIMENSIONS ARE IN INCHES (MILLIMETERS) UNLESS OTHERWISE SHOWN.

FILE NAME =	USER NAME = shiranisb	DESIGNED -	REVISED	- R. MIRS 09-15-97	27477 27 1141912		ARTERIAL ROAD		FAP RTE.	SECTION	COUNTY	TOTAL	SHEET NO.
I'	PLOT SCALE = 100.0000 '/ in.	2619R0AMD0ata\Design\DistStd.dgn CHECKED -	REVISED	- R. MIRS 12-11-97	STATE OF ILLINOIS	ARTERIAL ROAD INFORMATION SIGN  SCALE: NONE SHEET NO. 1 OF 1 SHEETS STA. TO STA.		307	2018-084-RS	KANE	47	47	
		CHECKED -	REVISED	- T. RAMMACHER 02-02-99	DEPARTMENT OF TRANSPORTATION					TC-22	CONTRAC	T NO. 6	2H32
	PLOT DATE = 12/11/2018	DATE -	REVISED	- C. JUCIUS 01-31-07		SCALE: NONE	SHEET NO. 1 OF 1 SHEETS   STA.	IO STA.	FED. ROA	AD DIST. NO. 1   ILLINOIS   FED. AI	D PROJECT		