PROJECT IS LOCATED IN CAPITAL AND WILLIAMS TOWNSHIPS

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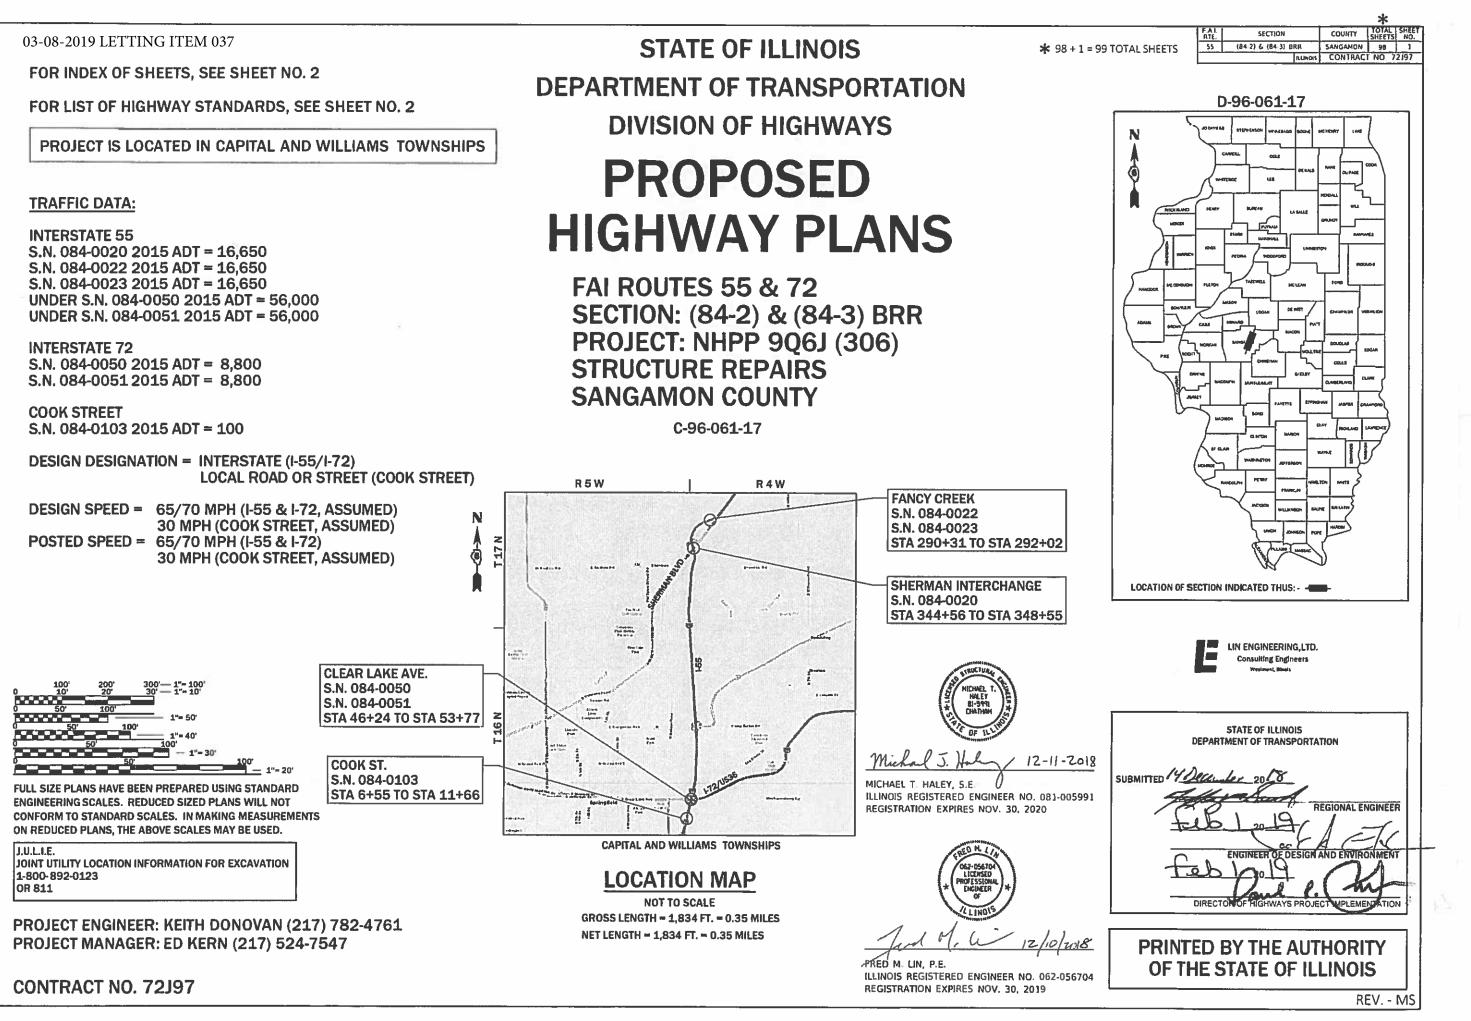
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INTERSTATE 55 S.N. 084-0020 2015 ADT = 16.650 S.N. 084-0022 2015 ADT = 16,650 S.N. 084-0023 2015 ADT = 16,650

COOK STREET

PROPOSED



INDEX OF SHEETS

- 1 COVER SHEET
- INDEX OF SHEETS AND GENERAL NOTES
- 3-9 SUMMARY OF QUANTITIES
- 10-11 SCHEDULES OF QUANTITIES
- 12-47 STAGING PLANS
- 48-52 ROADWAY PLANS

★ 53-98 STRUCTURAL PLANS

★ INCLUDES SHEET 91A

HIGHWAY STANDARDS

000001-07	STANDARD SYMBOLS, ABBREVIATIONS AND PATTERNS
001006	DECIMAL OF AN INCH AND OF A FOOT
610001-08	SHOULDER INLET WITH CURB
630001-12	STEEL PLATE BEAM GUARDRAIL
631011-10	TRAFFIC BARRIER TERMINAL, TYPE 2
631031-15	TRAFFIC BARRIER TERMINAL, TYPE 6
701321-17	LANE CLOSURE, 2L, 2W, BRIDGE REPAIR WITH BARRIER
701326-04	LANE CLOSURE, 2L, 2W, PAVEMENT WIDENING, FOR SPEEDS >= 45
	МРН
701400-09	APPROACH TO LANE CLOSURE, FREEWAY/EXPRESSWAY
701401-12	LANE CLOSURE, FREEWAY/EXPRESSWAY
701402-12	LANE CLOSURE, FREEWAY/EXPRESSWAY, WITH BARRIER
701406-12	LANE CLOSURE, FREEWAY/EXPRESSWAY, DAY OPERATIONS ONLY
701411-09	LANE CLOSURE, MULTILANE, AT ENTRANCE OR EXIT RAMP, FOR SPEEDS
	>= 45 MPH
701422-10	LANE CLOSURE, MULTILANE, FOR SPEEDS >= 45 MPH to 55 MPH
701423-10	LANE CLOSURE, MULTILANE, WITH BARRIER, FOR SPEEDS >= 45 MPH
	lo 55 MPH
701451-05	RAMP CLOSURE FREEWAY/EXPRESSWAY
701901-08	TRAFFIC CONTROL DEVICES
704001-08	TEMPORARY CONCRETE BARRIER
725001-01	OBJECT AND TERMINAL MARKERS
782006	GUARDRAIL AND BARRIER WALL REFLECTOR MOUNTING DETAILS

DISTRICT STANDARDS

780001a DISTRICT 6 PAVEMENT MARKING GUIDE

HOT-	MIX ASPHALT MIXTUR	RE REQUIREMENTS	
MIXTURE USE:	HMA SURFACE	HMA BASE	HMA SHOULDERS
PG GRADE:	SBS PG 70-22	PG 64-22	PG 64-22
DESIGN AIR VOIDS:	4.0% @ N90	4.0% @ N70	4.0% @ N50
MIXTURE COMPOSITION:	IL-9.5	IL-19.0	IL-9.5
FRICTION AGGREGATE:	MIX "E"	N/A	MIX "C"
QUALITY MANAGEMENT:	QC/QA	QC/QA	QC/QA
SUBLOT:	N/A	N/A	N/A

THE FOLLOWING RATES OF APPLICATION HAVE BEEN USED IN CALCULATING PLAN QUANTITIES:

HMA BITUMINOUS MATERIALS (TACK COAT)	0.05 LB/SQFT (MILLED SURFACE) 0.025 LB/SQFT (BETWEEN HMA LIFTS)
HMA SURFACE/BASE/SHOULDER	112 LB/SQYD/IN
NITROGEN FERTILIZER NUTRIENTS	90 LB/ACRE
PHOSPHORUS FERTILIZER NUTRIENTS	90 LB/ACRE
POTASSIUM FERTILIZER NUTRIENTS	90 LB/ACRE
AGRICULTURAL GROUND LIMESTONE	2 TON/ACRE

GENERAL NOTES

- 1. ALL WORK SHALL BE PERFORMED IN ACCORDANCE WITH THE APRIL 1, 2016 EDITION OF THE ILLINOIS DEPARTMENT OF TRANSPORTATION'S "STANDARD SPECIFICATIONS FOR ROAD AND BRIDGE CONSTRUCTION", AND IN ACCORDANCE WITH IDOT'S "SUPPLEMENTAL SPECIFICATION AND RECURRING SPECIAL PROVISIONS"ADOPTED JANUARY 1, 2019. THE ENGINEER WILL RESOLVE ANY CONFLICT WHICH MAY EXIST BETWEEN THESE SPECIFICATIONS.
- 2. ANY AND ALL REFERENCES TO "ENGINEER" SHALL BE INTERPRETED AS THE RESIDENT ENGINEER.
- 3. PLAN DIMENSIONS AND DETAILS RELATIVE TO EXISTING PLANS ARE SUBJECT TO VARIATIONS FOUND IN THE FIELD. THE CONTRACTOR SHALL FIELD VERIFY EXISTING DIMENSIONS AND DETAILS AFFECTING NEW CONSTRUCTION AND MAKE NECESSARY ADJUSTMENTS PRIOR TO CONSTRUCTION OR ORDERING MATERIALS. ANY ADJUSTMENTS PROPOSED BY THE CONTRACTOR MUST BE APPROVED BY THE ENGINEER. SUCH VARIATIONS SHALL NOT BE CAUSE FOR ADDITIONAL COMPENSATION FOR A CHANGE IN THE SCOPE OF WORK, HOWEVER THE CONTRACTOR WILL BE PAID FOR THE QUANTITY ACTUALLY FURNISHED BASED UPON THE UNIT PRICE.
- 4. THE CONTRACTOR SHALL MAKE A REASONABLE EFFORT TO MINIMIZE THE SIZE OF DISTURBED AREAS. ALL AREAS DISTURBED BY THE CONTRACTOR OUTSIDE THE PROPOSED CONSTRUCTION LIMITS SHALL BE RESTORED AT THE CONTRACTOR'S EXPENSE.
- 5. IN ADDITION TO THE REQUIREMENTS OF ARTICLE 107.16, THE CONTRACTOR SHALL PROTECT THE SURFACE OF ALL BRIDGE DECKS AND BRIDGE APPROACH PAVEMENTS IN A MANNER SATISFACTORY TO THE ENGINEER BEFORE ANY EQUIPMENT IS ALLOWED TO CROSS THE STRUCTURE. PROTECTION SHALL BE PROVIDED FOR ALL EQUIPMENT AS DEFINED IN ARTICLE 107.16 REGARDLESS IF TRACK MOUNTED OR WHEELED.
- EXISTING PAVEMENT CROSS SLOPES, SUPERELEVATION RATES, TRANSITION LENGTHS, AND SHOULDER CROSS SLOPES SHALL BE RETAINED WITH THE PROPOSED RESURFACING AND TEMPORARY PAVEMENT CONSTRUCTION.
- 7. THE CONTRACTOR WILL NOT BE ALLOWED TO SET UP A YARD OR FIELD OFFICE ON STATE, COUNTY, OR MUNICIPAL PROPERTY WITHOUT WRITTEN PERMISSION FROM THE JURISDICTIONAL AGENCY OR MUNICIPALITY.
- 8. DO NOT SCALE PLANS FOR CONSTRUCTION DIMENSIONS.
- THE CONTRACTOR SHALL TAKE ALL NECESSARY MEASURES TO ASSURE THAT NO DEBRIS FALLS INTO THE WATERWAYS. THE COST OF THIS WORK SHALL BE INCLUDED IN THE COST OF THE VARIOUS PAY ITEMS.
- 10. CONCRETE WASHOUT AREAS SHALL BE ADEQUATELY SIGNED AND MAINTAINED. CONCRETE WASHOUT SHALL NOT ENTER ANY DRAINAGE STRUCTURE.
- 11. THE CONTRACTOR SHALL ENSURE THAT ALL MUD, SEDIMENT, AND DEBRIS RESULTING FROM CONSTRUCTION RELATED ACTIVITIES SHALL BE CONTAINED WITHIN THE PROJECT LIMITS.
- 12. SAW CUTTING PRIOR TO ANY REMOVAL ITEMS NOTED ON THE PLANS OR DIRECTED BY THE ENGINEER SHALL BE CONSIDERED INCLUDED IN THE COST OF THE ITEMS BEING REMOVED.
- 13. THE CONTRACTOR SHALL USE CARE IN REMOVING OR EXCAVATING NEAR ALL EXISTING ITEMS WHICH WILL REMAIN. ANY DAMAGE DONE TO EXISTING ITEMS BY THE CONTRACTOR SHALL BE REPAIRED AT THE CONTRACTOR'S EXPENSE.

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	USER NAME = Lin	DESIGNED - RC	REVISED -			I-55/I-72 STRUCTURE RE
LIN ENGINEERING, LTD.		DRAWN - RC	REVISED -	STATE OF ILLINOIS		· · · · · · · · · · · · · · · · · · ·
Consulting Engineers	PLOT SCALE = 100.0000 ' / in.	CHECKED - FL	REVISED -	DEPARTMENT OF TRANSPORTATION		NDEX OF SHEETS AND GENE
Westmont, Illinois	PLOT DATE = 12/11/2018	DATE - 12/2018	REVISED -		SCALE: N.T.S.	SHEET 1 OF 1 SHEETS STA.

COMMITMENTS

NONE

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ED Decembe	$\frac{2}{20}$ $\frac{4}{18}$ 20 $\frac{18}{18}$
RAM DEVELOPMEN	VT ENGINEER
REPAIRS	F.A.I. SECTION COUNTY TOTAL SHEET SHEETS NO.
A. TO STA.	55 (84-2) & (84-3) BRR SANGAMON 98 2 CONTRACT NO. 72197 ILLINOIS FED. AID PROJECT

						CONSTR	UCTION CODE		
				6-01029-0000	6-01029-0000	6-01029-0000	6-01126-0000	6-01126-0000	6-01126-000
			URBAN	90% FED 10% ST					
				BRIDGE	BRIDGE	BRIDGE	BRIDGE	BRIDGE	BRIDGE
CODE NO .	ITEM	UNIT	TOTAL QUANTITY	0047	0047	0047	0047	0047	0047
NO .				084-0020	084-0022	084-0023	084-0050	084-0051	084-0103
20200500	EARTH EXCAVATION (WIDENING)	CU YD	65				25	40	
20400800	FURNISHED EXCAVATION	CU YD	9				3	6	
25000400	NITROGEN FERTILIZER NUTRIENT	POUND	30				12	18	
25000500	PHOSPHORUS FERTILIZER NUTRIENT	POUND	30				12	18	
25000600	POTASSIUM FERTILIZER NUTRIENT	POUND	30				12	18	
25000700	AGRICULTURAL GROUND LIMESTONE	TON	0.5				0.2	0.3	
25100115	MULCH, METHOD 2	ACRE	0.25				0.10	0.15	
35501324	HOT-MIX ASPHALT BASE COURSE, 10"	SQ YD	7 , 396	1,311	1,982	2,126	871	874	232
40600290	BITUMINOUS MATERIALS (TACK COAT)	POUND	2 , 400	121	123	155	881	885	235
40600982	HOT-MIX ASPHALT SURFACE REMOVAL - BUTT JOINT	SQ YD	2,276	320	340	435	598	583	
40603570	POLYMERIZED HOT-MIX ASPHALT SURFACE COURSE, MIX "E", N90	TON	565	22	20	25	249	249	
44004250	PAVED SHOULDER REMOVAL	SQ YD	7,164	1,311	1,982	2,126	871	874	
48102100	AGGREGATE WEDGE SHOULDER, TYPE B	TON	38				19	19	
48203100	HOT-MIX ASPHALT SHOULDERS	TON	758	147	222	238	76	75	

	USER NAME = Lin	DESIGNED - RC	REVISED -			I-55/I-72 STRUCTURE
LIN ENGINEERING, LTD.		DRAWN - RC	REVISED -	STATE OF ILLINOIS		•
Consulting Engineers	PLOT SCALE = 100.0000 ' / in.	CHECKED - FL	REVISED -	DEPARTMENT OF TRANSPORTATION		SUMMARY OF QUA
Westmont, Illinois	PLOT DATE = 12/13/2018	DATE - 12/2018	REVISED -		SCALE: N.T.S.	SHEET 1 OF 7 SHEETS S
westmont, minois	PLOT DATE = 12/13/2018	DATE - 12/2018	REVISED -		SCALE: N.T.S.	SHEET 1 OF 7 SHEE

				CONSTRUCTION CODE					
				6-01029-0000	6-01029-0000	6-01029-0000	6-01126-0000	6-01126-0000	6-01126-0000
				90% FED	90% FED	90% FED	90% FED	90% FED	90% FED
			URBAN	10% ST	10% ST	10% ST	10% ST	10% ST	10% ST
CODE	ITEM	UNIT	TOTAL	BR I DGE	BRIDGE 0047	BR I DGE 0047	BR I DGE	BRIDGE 0047	BR I DGE 0047
NO .		ONT	QUANTITY	084-0020	084-0022	084-0023	084 - 0050	084-0051	084-0103
50102400	CONCRETE REMOVAL	CU YD	64.5	10.0	7.2	8.7	17.7	18.3	2.6
				10.0		0.7	17.7	10.5	2.0
50157300	PROTECTIVE SHIELD	SQ YD	2,575	780			759	759	277
50300225	CONCRETE STRUCTURES	CU YD	47.6				23.8	23.8	
50300255	CONCRETE SUPERSTRUCTURE	CU YD	73.1	11.3	8.2	10.0	19.7	21.3	2.6
50300255			/ / / /	11.5			19.7	21.5	2.0
50300300	PROTECTIVE COAT	SQ YD	8,339	2,045	859	1,052	1,775	1,775	833
50800205	REINFORCEMENT BARS, EPOXY COATED	POUND	13,090	1,110	900	1,090	4,820	4,810	360
		5400	104	24	12	12	24	24	
50800515	BAR SPLICERS	EACH	104	24	12	12	24	24	8
52000110	PREFORMED JOINT STRIP SEAL	FOOT	605	119	94	118	109	109	56
59300100	CONTROLLED LOW-STRENGTH MATERIAL	CU YD	9.0			3.0	4.5	1.5	
63000001		FOOT	575.0				225.0	350.0	
65000001	STEEL PLATE BEAM GUARDRAIL, TYPE A, 6 FOOT POSTS	F001	575.0				225.0	550.0	
			1						
63100045	TRAFFIC BARRIER TERMINAL, TYPE 2	EACH	2				1	1	
63100085	TRAFFIC BARRIER TERMINAL, TYPE 6	EACH	6				3	3	
62100107									
63100167	TRAFFIC BARRIER TERMINAL, TYPE 1 (SPECIAL) TANGENT	EACH	4				2	2	
63200310	GUARDRAIL REMOVAL	FOOT	1,425				712.5	712.5	

		USER NAME = Lin	DESIGNED -	RC	REVISED _			I-55/I-72 STRUCTURE REPAIRS		F.A.I. RTE.	SECTION	COUNTY TO	OTAL SHEET HEETS NO.
	LIN ENGINEERING,LID.		DRAWN -	RC	REVISED -	STATE OF ILLINOIS	· · · · · · · · · · · · · · · · · · ·			55	(84-2) & (84-3) BRR	SANGAMON	98 4
	PLOT SCALE = 100.0000 ' / in.	CHECKED -	FL	REVISED -	DEPARTMENT OF TRANSPORTATION	SUMMARY OF QUANTITIES					CONTRACT NO	D. 72J97	
	Westmont, Illinois	PLOT DATE = 12/13/2018	DATE -	12/2018	REVISED _		SCALE: N.T.S.	SHEET 2 OF 7 SHEETS STA.	TO STA.		ILLINOIS FED.	AID PROJECT	

						CONSTR	RUCTION CODE		
				6-01029-0000	6-01029-0000	6-01029-0000	6-01126-0000	6-01126-0000	6-01126-000
				90% FED	90% FED				
			URBAN	10% ST	10% ST				
CODE			TOTAL	BRIDGE	BRIDGE	BRIDGE	BRIDGE	BRIDGE	BRIDGE
NO .	ITEM	UNIT	QUANTITY	0047	0047	0047	0047	0047	0047
				084-0020	084-0022	084-0023	084-0050	084-0051	084-0103
67000400	ENGINEER'S FIELD OFFICE, TYPE A	CAL MO	12	1	2	2	3	3	1
07000400						2			
67100100	MOBILIZATION	L SUM	1	0.08	0.17	0.17	0.25	0.25	0.08
70100205	TRAFFIC CONTROL AND PROTECTION, STANDARD 701401	EACH	2				1	1	
70100207	TRAFFIC CONTROL AND PROTECTION, STANDARD 701402	EACH	5	1	1	1	1	1	
70100215			2						
70100315	TRAFFIC CONTROL AND PROTECTION, STANDARD 701422	EACH	2				1	1	
70100325	TRAFFIC CONTROL AND PROTECTION, STANDARD 701423	EACH	2				1	1	
70100405	TRAFFIC CONTROL AND PROTECTION, STANDARD 701321	EACH	1						1
70100420	TRAFFIC CONTROL AND PROTECTION, STANDARD 701411	EACH	3	1			1	1	
70100500	TRAFFIC CONTROL AND PROTECTION, STANDARD 701326	L SUM	1						
/0100500	TRAFFIC CONTROL AND PROTECTION, STANDARD 701520		1						1
70100701	TRAFFIC CONTROL AND PROTECTION, STANDARD 701406	EACH	3	1	1	1			
70100820	TRAFFIC CONTROL AND PROTECTION, STANDARD 701451	L SUM	1						1
70103815	TRAFFIC CONTROL SURVEILLANCE	CAL DA	30	5	5	5	5	5	5
70106500	TEMPORARY BRIDGE TRAFFIC SIGNALS	EACH	1				0.5	0.5	
70107025	CHANGEABLE MESSAGE SIGN	CAL DA	475	40	35	70	150	150	30

LIN ENGINEERING,LTD.	USER NAME = Lin	DESIGNED - RC	REVISED -		I-55/I-72 STRUCTURE REPAIRS	F.A.I. RTE.	SECTION	COUNTY TOTAL SHEETS
Consulting Engineers		DRAWN - RC CHECKED - EL	REVISED -	STATE OF ILLINOIS	SUMMARY OF QUANTITIES	55	(84-2) & (84-3) BRR	SANGAMON 98
Westmont, Illinois	PLOT DATE = 12/13/2018	DATE - 12/2018	REVISED -	DEPARTMENT OF TRANSPORTATION	SCALE: N.T.S. SHEET 3 OF 7 SHEETS STA. TO STA.		ILLINOIS FED.	CONTRACT NO. 72J9

						CONSTR	RUCTION CODE		
				6-01029-0000	6-01029-0000	6-01029-0000	6-01126-0000	6-01126-0000	6-01126-000
			URBAN	90% FED 10% ST					
				BRIDGE	BRIDGE	BRIDGE	BRIDGE	BRIDGE	BRIDGE
CODE NO .	ITEM	UNIT	TOTAL QUANTITY	0047	0047	0047	0047	0047	0047
NO.				084-0020	084-0022	084-0023	084-0050	084-0051	084-0103
70200100	NIGHTTIME WORK ZONE LIGHTING	L SUM	1				0.5	0.5	
, 0200100									
70300100	SHORT TERM PAVEMENT MARKING	FOOT	4,970	756	1,091	1,495	694	694	240
70300150	SHORT TERM PAVEMENT MARKING REMOVAL	SQ FT	10,350	1,575	2,272	3,114	1,445	1,445	499
			47.061	7,200	10.520	14 421			2.240
70300230	TEMPORARY PAVEMENT MARKING - LINE 5"	FOOT	47,961	7,300	10,528	14,431	6,696	6,696	2,310
70300250	TEMPORARY PAVEMENT MARKING - LINE 8"	FOOT	1,717	1,717					
70300280	TEMPORARY PAVEMENT MARKING - LINE 24"	FOOT	18						18
70400100			4 625 0	F 0.7 F	275.0	425 0	1.025.0	075 0	1 227 5
70400100	TEMPORARY CONCRETE BARRIER	FOOT	4,625.0	587.5	375.0	425.0	1,025.0	975.0	1,237.5
70400200	RELOCATE TEMPORARY CONCRETE BARRIER	FOOT	3,575.0	525.0	300.0	387.5	975.0	975.0	412.5
70600250	IMPACT ATTENUATORS, TEMPORARY (NON-REDIRECTIVE), TEST LEVEL 3	EACH	5				1	1	3
70600260	IMPACT ATTENUATORS, TEMPORARY (FULLY REDIRECTIVE, NARROW), TEST LEVEL 3	EACH	4	1	1	1			1
70600332	IMPACT ATTENUATORS, RELOCATE (FULLY REDIRECTIVE, NARROW), TEST LEVEL 3	EACH	3	1	1	1			
70600350	IMPACT ATTENUATORS, RELOCATE (NON-REDIRECTIVE), TEST LEVEL 3	EACH	4				1	1	2
72501000	TERMINAL MARKER - DIRECT APPLIED	EACH	4				2	2	
78009005	MODIFIED URETHANE PAVEMENT MARKING - LINE 5"	FOOT	15,647	4,553	4,376	6,718			

	USER NAME = Lin	DESIGNED - RC	REVISED -		I-55/I-72 STRUCTURE REPAIRS	F.A.I. SECTION	COUNTY TOTAL SHEET SHEETS NO.
		DRAWN - RC	REVISED -	STATE OF ILLINOIS	SUMMARY OF QUANTITIES	55 (84-2) & (84-3) BRR	SANGAMON 98 6
Westmont, Illing	PLOT SCALE = 100.0000 ' / in.	CHECKED - FL	REVISED -	DEPARTMENT OF TRANSPORTATION		, , ,	CONTRACT NO. 72J97
	PLOT DATE = 12/13/2018	DATE - 12/2018	REVISED -		SCALE: N.T.S. SHEET 4 OF 7 SHEETS STA. TO STA.	ILLINOIS FED.	AID PROJECT

							CONSTR	UCTION CODE		
					6-01029-0000	6-01029-0000	6-01029-0000	6-01126-0000	6-01126-0000	6-01126-000
				URBAN	90% FED 10% ST					
Г					BRIDGE	BRIDGE	BRIDGE	BRIDGE	BRIDGE	BRIDGE
	CODE	ITEM	UNIT	TOTAL	0047	0047	0047	0047	0047	0047
	NO .			QUANTITY	084-0020	084-0022	084-0023	084-0050	084-0051	084-0103
	78009008	MODIFIED URETHANE PAVEMENT MARKING - LINE 8"	FOOT	1,013	1,013					
	78100300	REPLACEMENT REFLECTOR	EACH	223	41	104	38	20	20	
	78200005	GUARDRAIL REFLECTORS, TYPE A	EACH	24				9	15	
	78200010	BARRIER WALL REFLECTORS, TYPE B	EACH	57	24	15	18			
	,0200010									
	78300200	RAISED REFLECTIVE PAVEMENT MARKER REMOVAL	EACH	65				32	33	
	X0225740									
	X0325748	ACRYLIC COATING	SQ YD	6 .8						6.8
	X0325749	FIBER WRAP	SQ FT	54.8						54.8
	X0327979	PAVEMENT MARKING REMOVAL - GRINDING	SQ FT	8,503	2,572	1,824	2 , 799	576	578	154
	X0931400	INLET BOXES TO BE ADJUSTED (SPECIAL)	EACH	12	4	2	2	2	2	
	X2501000	SEEDING, CLASS 2 (SPECIAL)	ACRE	0.25				0.10	0.15	
	X5030250	BRIDGE DECK GROOVING (LONGITUDINAL)	SQ YD	6,229	1,670	694	883	1,491	1,491	
	X7010206	TRAFFIC CONTROL AND PROTECTION, STANDARD 701401 (SPECIAL)	EACH	2				1	1	
	X7010216	TRAFFIC CONTROL AND PROTECTION, (SPECIAL)	L SUM	1	0 .08	0 .1 7	0.17	0.25	0.25	0 .08
	X7200201	WIDTH RESTRICTION SIGNING	L SUM	1	0.56	0.11	0.11			0.22

		DESIGNED -	RC	REVISED -			I-55/I-72 STRUCTURE REPAIRS		F.A.I. RTE.	SECTION	COUNTY	TOTAL SHEET SHEETS NO.			
,		DRAWN -	RC	REVISED -	STATE OF ILLINOIS	SUMMARY OF QUANTITIES		55	(84-2) & (84-3) BRR	SANGAMON	98 7				
Consulting Engineers	PLOT SCALE = 100.0000 ' / in.	CHECKED -	FL	REVISED -	DEPARTMENT OF TRANSPORTATION		51	UNINA		INTITES			. , . ,	CONTRACT	NO. 72197
Westmont, Illinois	PLOT DATE = 12/13/2018	DATE -	12/2018	REVISED -		SCALE: N.T.S.	SHEET	5 OF	7 SHEETS	STA.	TO STA.		ILLINOIS FED.	AID PROJECT	

						CONSTR	UCTION CODE		
				6-01029-0000	6-01029-0000	6-01029-0000	6-01126-0000	6-01126-0000	6-01126-000
			URBAN	90% FED 10% ST					
				BRIDGE	BRIDGE	BRIDGE	BRIDGE	BRIDGE	BRIDGE
CODE NO .	ITEM	UNIT	TOTAL QUANTITY	0047	0047	0047	0047	0047	0047
				084-0020	084-0022	084-0023	084-0050	084-0051	084-0103
X7830050	RAISED REFLECTIVE PAVEMENT MARKER, REFLECTOR REMOVAL	EACH	223	41	104	38	20	20	
Z0001800	APPROACH SLAB REPAIR (PARTIAL DEPTH)	SQ YD	7.6	1.7	3.0	2.9			
Z0007101	CONTAINMENT AND DISPOSAL OF LEAD PAINT CLEANING RESIDUES NO. 1	L SUM	1				1		
Z0007102	CONTAINMENT AND DISPOSAL OF LEAD PAINT CLEANING RESIDUES NO. 2	L SUM	1					1	
Z0010501	CLEANING AND PAINTING STEEL BRIDGE NO. 1	L SUM	1				1		
Z0010502	CLEANING AND PAINTING STEEL BRIDGE NO. 2	L SUM	1					1	
Z0012130	BRIDGE DECK SCARIFICATION 3/4"	SQ YD	6,393	1,726	713	900	1,527	1,527	
Z0012166	BRIDGE DECK MICROSILICA CONCRETE OVERLAY 2 3/4"	SQ YD	6,393	1,726	713	900	1,527	1,527	
Z0012754	STRUCTURAL REPAIR OF CONCRETE (DEPTH EQUAL TO OR LESS THAN 5")	SQ FT	124	26		12	28	16	42
Z0016001	DECK SLAB REPAIR (FULL DEPTH TYPE I)	SQ YD	3.4	0.5		1.0	0.9	0.6	0.4
Z0016002	DECK SLAB REPAIR (FULL DEPTH TYPE II)	SQ YD	181.7	14.0	20.0	75.0	26.0	42.2	4.5
Z0016200	DECK SLAB REPAIR (PARTIAL)	SQ YD	73.4						73.4
Z0016702	DETOUR SIGNING	L SUM	1				0.5	0.5	
Z0018051	DRAINAGE SCUPPER TO BE ADJUSTED	EACH	4	2			1	1	

	USER NAME = Lin	DESIGNED - RC	REVISED -		I-55/I-72 STRUCTURE REPAIRS		SECTION	COUNTY TOTAL S	HEET NO.
		DRAWN - RC	REVISED -	STATE OF ILLINOIS	SUMMARY OF QUANTITIES	55	(84-2) & (84-3) BRR	SANGAMON 98	8
Consulting Engineers Westmont, Illinois	PLOT SCALE = 100.0000 ' / in.	CHECKED - FL	REVISED -	DEPARTMENT OF TRANSPORTATION	SUMIMART OF QUANTITIES			CONTRACT NO. 72J9	7
	PLOT DATE = 12/13/2018	DATE - 12/2018	REVISED -		SCALE: N.T.S. SHEET 6 OF 7 SHEETS STA. TO STA.		ILLINOIS FED. A	ID PROJECT	

						CONSTR	UCTION CODE		
				6-01029-0000	6-01029-0000	6-01029-0000	6-01126-0000	6-01126-0000	6-01126-0000
			URBAN	90% FED 10% ST					
				BRIDGE	BRIDGE	BRIDGE	BRIDGE	BRIDGE	BRIDGE
CODE NO.	ITEM	UNIT	TOTAL QUANTITY	0047	0047	0047	0047	0047	0047
				084-0020	084-0022	084-0023	084-0050	084-0051	084-0103
Z0021903	SILICONE JOINT SEALER, 3/4"	FOOT	30						30
Z0029090	DIAMOND GRINDING (BRIDGE SECTION)	SQ YD	6,029	1,604	675	868	1,441	1,441	
70020850	TEMPORARY INFORMATION SIGNING			80	120	64			
Z0030850		SQ FT	272	80	128	64			
Z0043800	PRECAST PRESTRESSED CONCRETE I-BEAM REPAIR	SQ FT	3.7						3.7
Z0048665	RAILROAD PROTECTIVE LIABILITY INSURANCE	L SUM	1	1					
Z0065730	SLOPE WALL SLURRY PUMPING	CU YD	27.2				27.2		
Z0073200	TEMPORARY SHORING AND CRIBBING	EACH	2						2
ð z0076600	TRAINEES	HOUR	2500	2500					
y z0076604	TRAINEES TRAINING PROGRAM GRADUATE	HOUR	2500	2500					
SPECIALTY IT	тем Ø 0042								

INEERING.LTD.	USER NAME = Lin	DESIGNED -	RC	REVISED -		ATE OF ILLINOIS INT OF TRANSPORTATION SCALE: N.T.S. SHEET 7 OF 7 SHEETS STA. TO STA.		F. R	.A.I. RTE.	SECTION	COUNTY TOTAL SHEET SHEETS NO.
Interning, LTD.		DRAWN -	RC	REVISED -				55	(84-2) & (84-3) BRR	SANGAMON 98 9	
stmont, Illinois	PLOT SCALE = 100.0000 ' / in.	CHECKED -	FL	REVISED -	DEPARTMENT OF TRANSPORTATION						CONTRACT NO. 72J97
 stmont, minois	PLOT DATE = 12/13/2018	DATE -	12/2018	REVISED -				O STA.		ILLINOIS FED. A	AID PROJECT

BITUMINOUS MATERIALS (TACK COAT)

FROM STATION	TO STATION	LT/RT	# OF LIFTS	POUND
289+80.07	290+15.07	RT	1	48.4
289+96.68	290+31.68	LT	1	38.6
290+15.07	290+35.07	RT	1	28.6
290+31.68	290+51.68	LT	1	22.9
291+89.72	292+09.72	RT	1	28.9
291+99.11	292+19.11	LT	1	22.9
292+09.72	292+44.72	RT	1	49.4
292+19.11	292+54.11	LT	1	37.8
344+19.20	344+54.20	LT	1	36.9
344+54.20	344+74.20	LT	1	24.9
348+35.64	348+55.64	LT	1	24.3
348+55.64	348+90.64	LT	1	35.2
	CLEAR	LAKE AVE/CO	OK ST TOTAL	2,001
		ROUNE	DED TOTAL	2,400

HOT-MIX ASPHALT SURFACE REMOVAL - BUTT JOINT

FROM STATION	TO STATION	LT/RT	SQ YD			
289+80.07	290+15.07	RT	214.9			
289+96.68	290+31.68	LT	171.6			
292+09.72	292+44.72	RT	219.7			
292+19.11	292+54.11	LT	167.9			
344+19.20	344+54.20	LT	163.9			
348+55.64	348+90.64	LT	156.6			
CLEAR	CLEAR LAKE AVE/COOK ST TOTA					
	ROUNDED TOTA					

IMPACT ATTENUATORS, TEMPORARY (FULLY REDIRECTIVE, NARROW), TEST LEVEL 3

STATION	LT/RT	EACH			
288+00.60	RT	1			
293+37.89	LT	1			
349+90.59	LT	1			
	CLEAR LAKE AVE/ COOK ST TOTAL				
	TOTAL	4			

POLYMERIZED HOT-MIX ASPHALT SURFACE COURSE, MIX "E", N90

FROM	TO STATION	LT/RT	TON			
290+15.07	290+35.07	RT	12.47			
290+31.68	290+51.68	LT	9.95			
291+89.72	292+09.72	RT	12.57			
291+99.11	292+19.11	LT	9.98			
344+54.20	344+74.20	LT	10.85			
348+35.64	348+55.64	LT	10.60			
CLEAR	CLEAR LAKE AVE/COOK ST TOTA					
	ROUNDED TOTAL					

PAVED SHOULDER REMOVAL

FROM STATION	TO STATION	LT/RT	SQ YD		
284+98.00	290+55.80	LT	694.10		
286+00.21	290+41.37	RT	494.14		
286+36.59	290+49.02	LT	345.36		
286+38.20	290+35.08	RT	443.12		
291+85.16	295+94.23	RT	480.36		
291+92.83	297+96.38	RT	707.99		
291+96.87	294+10.35	LT	202.28		
291+99.23	298+36.14	LT	739.74		
342+01.76	344+93.44	LT	323.88		
342+50.85	344+67.47	LT	251.01		
348+16.94	352+15.10	LT	438.85		
348+53.94	351+77.84	LT	297.61		
CLEAR	1,745				
	ROUNDED TOTAL				

IMPACT ATTENUATORS, RELOCATE (FULLY REDIRECTIVE, NARROW), TEST LEVEL 3

STATION	LT/RT	EACH
287+69.47	RT	1
294+20.26	LT	1
350+62.84	LT	1
	TOTAL	3

HOT-MIX ASPHALT BASE COURSE, 10

FROM STATION	TO STATION	LT/RT	SQ YD		
	STAC	GE 1			
284+98.00	290+55.80	LT	694.10		
286+38.20	290+35.08	RT	443.12		
291+85.16	295+94.23	RT	480.36		
291+99.23	298+36.14	LT	739.74		
342+50.85	344+67.47	LT	251.01		
348+16.94	352+15.10	LT	438.85		
	STAC	GE 2			
286+00.21	290+41.37	RT	494.14		
286+36.59	290+49.02	LT	345.36		
291+92.83	297+96.38	RT	707.99		
291+96.87	294+10.35	LT	202.28		
342+01.76	344+93.44	LT	323.88		
348+53.94	351+77.84	LT	297.61		
CLEAR	CLEAR LAKE AVE/COOK ST TOTAL				
	RO	JNDED TOTAL	7,396		

HOT-MIX ASPHALT SHOULDERS

FROM STATION	TO STATION	LT/RT	TON	
	STAC	GE 1		
284+98.00	290+55.80	LT	77.74	
286+38.20	290+35.08	RT	49.63	
291+85.16	295+94.23	RT	53.80	
291+99.23	298+36.14	LT	82.85	
342+50.85	344+67.47	LT	28.11	
348+16.94	352+15.10	LT	49.15	
	STAC	GE 2		
286+00.21	290+41.37	RT	55.34	
286+36.59	290+49.02	LT	38.68	
291+92.83	297+96.38	RT	79.29	
291+96.87	294+10.35	LT	22.65	
342+01.76	344+93.44	LT	36.27	
348+53.94	351+77.84	LT	33.33	
CLEAR	151			
	ROUNDED TOTAL			

	USER NAME = Lin	DESIGNED - RC	REVISED -		I-55/I-72 STRUCTURE REPAIRS	F.A.I. SECTION COUNTY TOTAL SHEET NO.
Consulting Engineers		DRAWN - RC	REVISED -	STATE OF ILLINOIS	SCHEDULE OF QUANTITIES	55 (84-2) & (84-3) BRR SANGAMON 98 10
Westmont, Illinois	PLOT SCALE = 100.0000 ' / in.	CHECKED - FL	REVISED -	DEPARTMENT OF TRANSPORTATION		CONTRACT NO. 72J97
	PLOT DATE = 12/11/2018	DATE - 12/2018	REVISED -		SCALE N.T.S. SHEET 1 OF 2 SHEETS STA. TO STA.	ILLINOIS FED. AID PROJECT

TEMPORARY CONCRETE BARRIER

FROM STATION	TO STATION	LT/RT	FOOT		
	STA	GE 1			
287+97.94	291+89.97	RT	387.50		
290+41.06	293+37.87	LT	300.00		
344+71.80	349+90.49	LT	525.00		
	STAGE 2				
287+69.59	292+00.11	RT	37.50		
290+48.20	294+20.20	LT	75.00		
344+82.57	350+62.76	LT	62.50		
CLEAR	CLEAR LAKE AVE/COOK ST TOTAL				
	4,625.0				

RELOCATE TEMPORARY CONCRETE BARRIER

FROM STATION	TO STATION	LT/RT	FOOT		
	STAGE 2				
287+69.59	292+00.11	RT	387.50		
290+48.20	294+20.20	LT	300.00		
344+82.57	350+62.76	LT	525.00		
CLEAR	2,362.5				
	RO	JNDED TOTAL	3,575.0		

BARRIER WALL REFLECTORS, TYPE B

FROM STATION	TO STATION	LT/RT	EACH			
	STA	GE 1				
287+97.94	291+89.97	RT	16			
290+41.06	293+37.87	LT	12			
344+71.80	349+90.49	LT	21			
	STAGE 2					
287+69.59	292+00.11	RT	2			
290+48.20	294+20.20	LT	3			
344+82.57	350+62.76	LT	3			
		TOTAL	57			

TEMPORARY PAVEMENT MARKING - LINE 5

FROM STATION	TO STATION	LT/RT	FOOT	
	STAG	GE 1		
270+88.33	297+12.64	RT	2,582.68	
270+88.33	285+88.82	RT	368.94	
270+88.33	297+12.64	RT	2,596.53	
283+65.60	298+60.80	LT	1,508.05	
283+65.60	298+60.80	LT	1,505.55	
283+65.60	298+60.80	LT	1,503.07	
285+88.82	297+12.64	RT	1,113.49	
339+06.44	353+82.07	LT	1,113.49	
339+06.44	353+82.07	LT	1,478.78	
340+25.33	342+50.77	LT	56.35	
342+50.77	353+82.07	LT	1,139.67	
STAGE 2				
268+42.88	298+28.50	RT	2,954.04	
268+43.20	283+43.96	RT	371.07	
268+43.34	298+28.37	RT	2,967.16	
283+43.96	298+28.43	RT	1,476.64	
286+36.54	338+04.02	LT	5,232.71	
286+36.57	294+10.35	LT	778.80	
340+75.04	342+02.51	LT	31.87	
342+01.76	351+77.84	LT	978.35	
342+02.51	366+77.84	LT	2,501.55	
CLEAR	LAKE AVE/CO	OK ST TOTAL	15,702	
	ROU	JNDED TOTAL	47,961	

MODIFIED URETHANE PAVEMENT MARKING-LINE 5

FROM STATION	TO STATION	LT/RT	FOOT
268+42.89	298+28.50	RT	2,985.61
268+42.89	298+28.50	RT	2,985.61
268+42.89	298+28.50	RT	746.40
283+65.60	298+60.80	LT	1,495.20
283+65.60	298+60.80	LT	1,495.20
283+65.60	298+60.80	LT	373.80
298+60.80	339+06.44	LT	1,011.41
339+06.44	353+82.07	LT	1,475.63
339+06.44	353+82.07	LT	368.91
340+74.15	343+66.14	LT	73.00
343+66.14	353+82.07	LT	1,015.93
353+82.07	366+77.84	LT	1,295.77
353+82.07	366+77.84	LT	323.94
	15,647		

TEMPORARY PAVEMENT MARKING - LINE 8

FROM STATION	TO STATION	LT/RT	FOOT
	STA	GE 1	
337+97.48	340+25.33	LT	223.03
337+98.25	342+50.77	LT	446.79
339+06.44	340+25.33	LT	116.55
	STA	GE 2	
338+05.27	340+75.04	LT	266.36
338+05.27	340+75.04	LT	271.02
338+05.27	342+02.16	LT	392.83
	RO	JNDED TOTAL	1,717

MODIFIED URETHANE PAVEMENT MARKING-LINE 8"

FROM STATION	TO STATION	LT/RT	FOOT		
337+97.48	340+74.15	LT	276.67		
337+98.25	343+66.14	LT	567.89		
339+06.44	340+74.15	LT	167.71		
	ROUNDED TOTAL				

TEMPORARY INFORMATION SIGNING

DESCRIPTION	LT/RT	HE I GHT	WIDTH	SQ FT
W4-1B	RT	4.00	4.00	16.00
W4-1B	RT	4.00	4.00	16.00
W4-1B	RT	4.00	4.00	16.00
W4-1B	RT	4.00	4.00	16.00
W4-1B	LT	4.00	4.00	16.00
W4-1B	LT	4.00	4.00	16.00
W4-1B	LT	4.00	4.00	16.00
W4-1B	LT	4.00	4.00	16.00
W4-1B	LT	4.00	4.00	16.00
W4-1B	LT	4.00	4.00	16.00
W4-1B	LT	4.00	4.00	16.00
W4-1R	LT	4.00	4.00	16.00
W4-1R	LT	4.00	4.00	16.00
W4-1L	LT	4.00	4.00	16.00
W4-1L	LT	4.00	4.00	16.00
W4-1R	LT	4.00	4.00	16.00
W4-1L	LT	4.00	4.00	16.00
		RO	UNDED TOTAL	272

REPLACEMENT REFLECTOR

FROM STATION	TO STATION	LT/RT	EACH
268+42.89	298+28.50	RT	38
283+65.60	366+77.84	LT	104
337+97.48	340+74.15	LT	7
337+98.25	343+66.14	LT	29
339+06.44	340+74.15	LT	5
CLEAR	LAKE AVE/CO	OK ST TOTAL	40
		TOTAL	223

RAISED REFLECTIVE PAVEMENT MARKER, REFLECTOR REMOVAL

FROM STATION	TO STATION	LT/RT	EACH
268+42.89	298+28.50	RT	38
283+65.60	366+77.84	LT	104
337+97.48	340+74.15	LT	7
337+98.25	343+66.14	LT	29
339+06.44	340+74.15	LT	5
CLEAR	LAKE AVE/CO	OK ST TOTAL	40
		TOTAL	223

LIN ENGINEERING,LTD.	USER NAME = Lin	DESIGNED -	RC	REVISED -		I-55/I-72 STRUCTURE REPAIRS	F.A.I. RTE	SECTION	COUNTY TOTAL SHEET SHEETS NO.
		DRAWN -	RC	REVISED -	STATE OF ILLINOIS DEPARTMENT OF TRANSPORTATION	SCHEDULE OF OUANTITIES	55	(84-2) & (84-3) BRR	SANGAMON 98 11
	PLOT SCALE = 100.0000 / in.	CHECKED -	FL	REVISED -		SCHEDULE OF QUANTITIES		CONTRACT NO.	
Westmont, Illinois	PLOT DATE = 12/11/2018	DATE -	12/2018	REVISED -		SCALE: N.T.S. SHEET 2 OF 2 SHEETS STA. TO STA.		ILLINOIS FED.	AID PROJECT

AVEMENT MARKING REMOVAL - GRINDING													
FROM STATION	TO STATION	LT/RT	WIDTH (IN.)	SQ FT									
	EXISTIN	G PAVEMENT M	1ARK I NGS										
268+42.89	298+28.50	RT	5	1,244.00									
268+42.89	298+28.50	RT	5	1,244.00									
268+42.89	298+28.50	RT	5	311.00									
283+65.60	298+60.80	LT	5	623.00									
283+65.60	298+60.80	LT	5	623.00									
283+65.60	298+60.80	LT	5	155.75									
298+60.80	339+06.44	LT	5	421.42									
337+97.48	340+74.15	LT	8	184.45									
337+98.25	343+66.14	LT	8	378.59									
339+06.44	340+74.15	LT	8	111.81									
339+06.44	353+82.07	LT	5	614.85									
339+06.44	353+82.07	LT	5	153.71									
340+74.15	343+66.14	LT	5	30.42									
343+66.14	353+82.07	LT	5	423.30									
353+82.07	366+77.84	LT	5	539.90									
353+82.07	366+77.84	LT	5	134.98									
	CLEAR	LAKE AVE/CO	OK ST TOTAL	1,308.00									
		RO	JNDED TOTAL	8,503									

PAVEMENT MARKING REMOVAL - GRINDING

MAINTENANCE OR TRAFFIC GENERAL NOTES

BRIDGE REPAIRS

- 1. THE MAINTENANCE OF TRAFFIC PLANS SHALL SERVE AS A GUIDE FOR THE SAFE DIVERSION OF TRAFFIC DURING THE EXECUTION OF THIS CONTRACT. THE CONTRACTOR MAY MODIFY THE MAINTENANCE OF TRAFFIC PLANS TO MEET CONSTRUCTION NEEDS BUT NOT AT EXPENSE OF PUBLIC SAFETY OR CONVENIENCE, ANY CHANGES TO THE TRAFFIC CONTROL PLANS SHALL BE SUBMITTED TO THE ENGINEER FOR APPROVAL.
- 2. EXISTING PAVEMENT MARKINGS THAT CONFLICT WITH TEMPORARY MARKINGS SHALL BE REMOVED. THIS WORK WILL BE PAID FOR AT THE CONTRACT UNIT PRICE PER SQUARE FOOT FOR PAVEMENT MARKING REMOVAL.
- 3. BEFORE BEGINNING ANY WORK, THE CONTRACTOR SHALL RETAIN AND RECORD FOR FUTURE REFERENCE, ALL EXISTING PAVEMENT MARKING LINES (RAISED REFLECTIVE PAVEMENT MARKERS) IN ORDER THAT THESE LOCATIONS CAN BE RE-ESTABLISHED FOR STRIPING. EXACT LOCATIONS OF ALL PAVEMENT MARKINGS SHALL BE AS DIRECTED BY THE ENGINEER. THE COST OF THIS WORK SHALL BE INCLUDED IN THE COST OF THE RELATED PAVEMENT MARKING PAY ITEMS.
- 4. EXISTING RAISED REFLECTIVE PAVEMENT MARKER REFLECTORS THAT CONFLICT WITH THE REVISED TRAFFIC PATTERN SHALL BE REMOVED FROM THE EXISTING CASTINGS LOCATED IN THE PAVEMENT THIS WORK WILL BE PAID FOR AT THE CONTRACT UNIT PRICE FACH FOR RAISED REFLECTIVE PAVEMENT MARKER, REFLECTOR REMOVAL.
- 5. THE CONTRACTOR SHALL REMOVE ALL TEMPORARY PAVEMENT MARKINGS THAT CONFLICT WITH THE FOLLOWING STAGE OR THE FINAL PAVEMENT MARKING THIS WORK WILL BE PAID FOR AT THE CONTRACT UNIT PRICE PER SQUARE FOOT FOR PAVEMENT MARKING REMOVAL.
- 6. ALL TRAFFIC CONTROL DEVICES SHALL BE REFLECTORIZED PRIOR TO INSTALLATION AND CLEANED AS SPECIFIED IN THE TRAFFIC CONTROL SPECIAL PROVISIONS OR AS DIRECTED BY THE ENGINEER.
- 7. ALL DRUMS, VERTICAL PANELS, AND BARRICADES ADJACENT TO THE EDGE OF THE TRAVELED WAY SHALL BE EQUIPPED WITH MONO-DIRECTIONAL STEADY BURNING LIGHTS.
- 8. FOR STABILIZATION, ALL TYPE III BARRICADES SHALL REQUIRE A MINIMUM OF FOUR SAND BAGS PER BARRICADE.
- 9. EXISTING SIGNS WITHIN THE LIMITS OF TRAFFIC CONTROL WHICH ARE OBSTRUCTED BY OR OTHERWISE INTERFERED WITH BY CONSTRUCTION OPERATIONS OF DESIGNATED TRAFFIC CONTROL, SHALL BE COVERED OR REMOVED BY THE CONTRACTOR UNLESS SPECIFIED IN THE PLANS OR WHEN DIRECTED BY THE ENGINEER. THIS WORK SHALL BE AS SPECIFIED IN ARTICLE 107.25 OF THE STANDARD SPECIFICATIONS.
- 10. CHANGEABLE MESSAGE SIGNS SHALL BE INSTALLED AS DIRECTED BY THE ENGINEER PRIOR TO THE START OF CONSTRUCTION.
- 11. SEE STRUCTURAL PLANS FOR ADDITIONAL BRIDGE STAGING INFORMATION.
- 12. THE CONTRACTOR SHALL CONTACT THE DISTRICT 6 TRAFFIC CONTROL SECTION OF THE BUREAU OF OPERATIONS AT (217) 785-5312 AT LEAST 21 DAYS PRIOR TO IMPLEMENTING ANY LANE CLOSURES, 48 HOURS PRIOR TO A SWITCH IN TRAFFIC STAGING, AND ONE WEEK PRIOR TO CLOSING A RAMP.

SUGGESTED SEQUENCE OF OPERATIONS

PRE-STAGE 1

1. CONSTRUCT TEMPORARY PAVEMENT ALONG NB AND SB OUTSIDE SHOULDERS AT LOCATIONS SHOWN ON STAGING TYPICAL SECTIONS AND STAGING PLANS WITH HIGHWAY STANDARD 701406.

PRE-STAGE 2

1. CONSTRUCT TEMPORARY PAVEMENT ALONG NB AND SB INSIDE SHOULDERS AT LOCATIONS SHOWN ON STAGING TYPICAL SECTIONS AND STAGING PLANS WITH HIGHWAY STANDARD 701406.

STAGE 1

- 1. CLOSE NB INSIDE LANE AND SHOULDER AT S.N. 084-0020 & 084-0022 & SB INSIDE LANE AND SHOULDER AT S.N. 084-0023. INSTALL TRAFFIC CONTROL DEVICES AND TEMPORARY PAVEMENT MARKINGS AS SHOWN ON THE PLAN SHEETS "STAGING PLAN - STAGE 1" AND UTILIZING HIGHWAY STANDARDS 701400 & 701411.
- 2. REMOVE CONCRETE DECK AND PARAPETS AT THE EXPANSION JOINTS IN ORDER TO REPLACE STRIP SEAL JOINTS.
- 3. APPLY 3/4" HYDRO-SCARIFICATION TO DECK SLAB.
- 4. PERFORM DECK AND APPROACH SLAB REPAIRS.
- 5. PLACE NEW SUPERSTRUCTURE CONCRETE AND PREFORMED JOINT STRIP SEAL AT ABUTMENTS
- 6. PLACE 2 3/4" MICROSILICA CONCRETE OVERLAY ON DECK SLAB.
- 7. PERFORM 1/2" DIAMOND GRINDING.
- 8. PERFORM BRIDGE DECK GROOVING ON NEW DECK SURFACE.
- 9. APPLY PROTECTIVE COAT TO NEW CONCRETE SURFACES.
- 10. REPAIR DETERIORATED CONCRETE ON SUBSTRUCTURE AND FILL VOIDS UNDER SHOULDER AND FIX BROKEN APPROACH CURB AS INDICATED.

STAGE 2

- AT ABUTMENTS.

FINAL PHASE

	USER NAME = Lin	DESIGNED - RC	REVISED -		I-55/I-72 STRUCTURE REPAIRS	F.A.I. SECTION	COUNTY TOTAL SHEET SHEETS NO.
Consulting Engineers		DRAWN - RC	REVISED -	STATE OF ILLINOIS	STAGING GENERAL NOTES - 084-0020, S.N. 084-0022 & 084-0023	55 (84-2) & (84-3) BRR	SANGAMON 98 12
Consulting Engineers Westmont, Illinois	PLOT SCALE = 100.0000 / in.	CHECKED - FL	REVISED -	DEPARTMENT OF TRANSPORTATION	STACING GENERAL NOTES - 084-0020, S.N. 084-0022 & 084-0023		CONTRACT NO. 72J97
	PLOT DATE = 12/12/2018	DATE - 12/2018	REVISED -		SCALE: 1"=50' SHEET 1 OF 16 SHEETS STA. TO STA.	ILLINOIS FED. A	AID PROJECT

1. CLOSE NB OUTSIDE LANE AND SHOULDER AT S.N. 084-0020 & 084-0022 & SB OUTSIDE LANE AND SHOULDER AT S.N. 084-0023, INSTALL TRAFFIC CONTROL DEVICES AND TEMPORARY PAVEMENT MARKINGS AS SHOWN ON THE PLAN SHEETS "STAGING PLAN - STAGE 2" AND UTILIZING HIGHWAY STANDARDS 701400, 701402, & 701411.

2. WHEN S.N. 084-0020 & S.N. 084-0022 ARE UNDER CONSTRUCTION AND NB I-55 TRAFFIC IS MAINTAINED USING A SINGLE LANE OF TRAFFIC, THE LANE CLOSURE SHALL BE MAINTAINED BETWEEN S.N. 084-0020 & S.N. 084-0022.

3. REMOVE CONCRETE DECK AND PARAPETS AT THE EXPANSION JOINTS IN ORDER TO REPLACE STRIP SEAL JOINTS.

4. APPLY 3/4 HYDRO-SCARIFICATION TO DECK SLAB.

5. PERFORM DECK AND APPROACH SLAB REPAIRS.

6. PLACE NEW SUPERSTRUCTURE CONCRETE AND PREFORMED JOINT STRIP SEAL

7. PLACE 2 3/4 MICROSILICA CONCRETE OVERLAY ON DECK SLAB.

8. PERFORM 1/2" DIAMOND GRINDING.


9. PERFORM BRIDGE DECK GROOVING ON NEW DECK SURFACE.

10. APPLY PROTECTIVE COAT TO NEW CONCRETE SURFACES.

11. REPAIR DETERIORATED CONCRETE ON SUBSTRUCTURE AND FILL VOIDS UNDER SHOULDER AND FIX BROKEN APPROACH CURB AS INDICATED.

1. PLACE TRAFFIC IN THE PERMANENT LANES.

2. REPLACE ALL EXISTING PAVEMENT MARKINGS THAT MAY HAVE BEEN REMOVED OR DAMAGED DURING CONSTRUCTION AND REPLACE REFLECTORS IN RAISED REFLECTIVE PAVEMENT MARKERS WITH HIGHWAY STANDARD 701406.

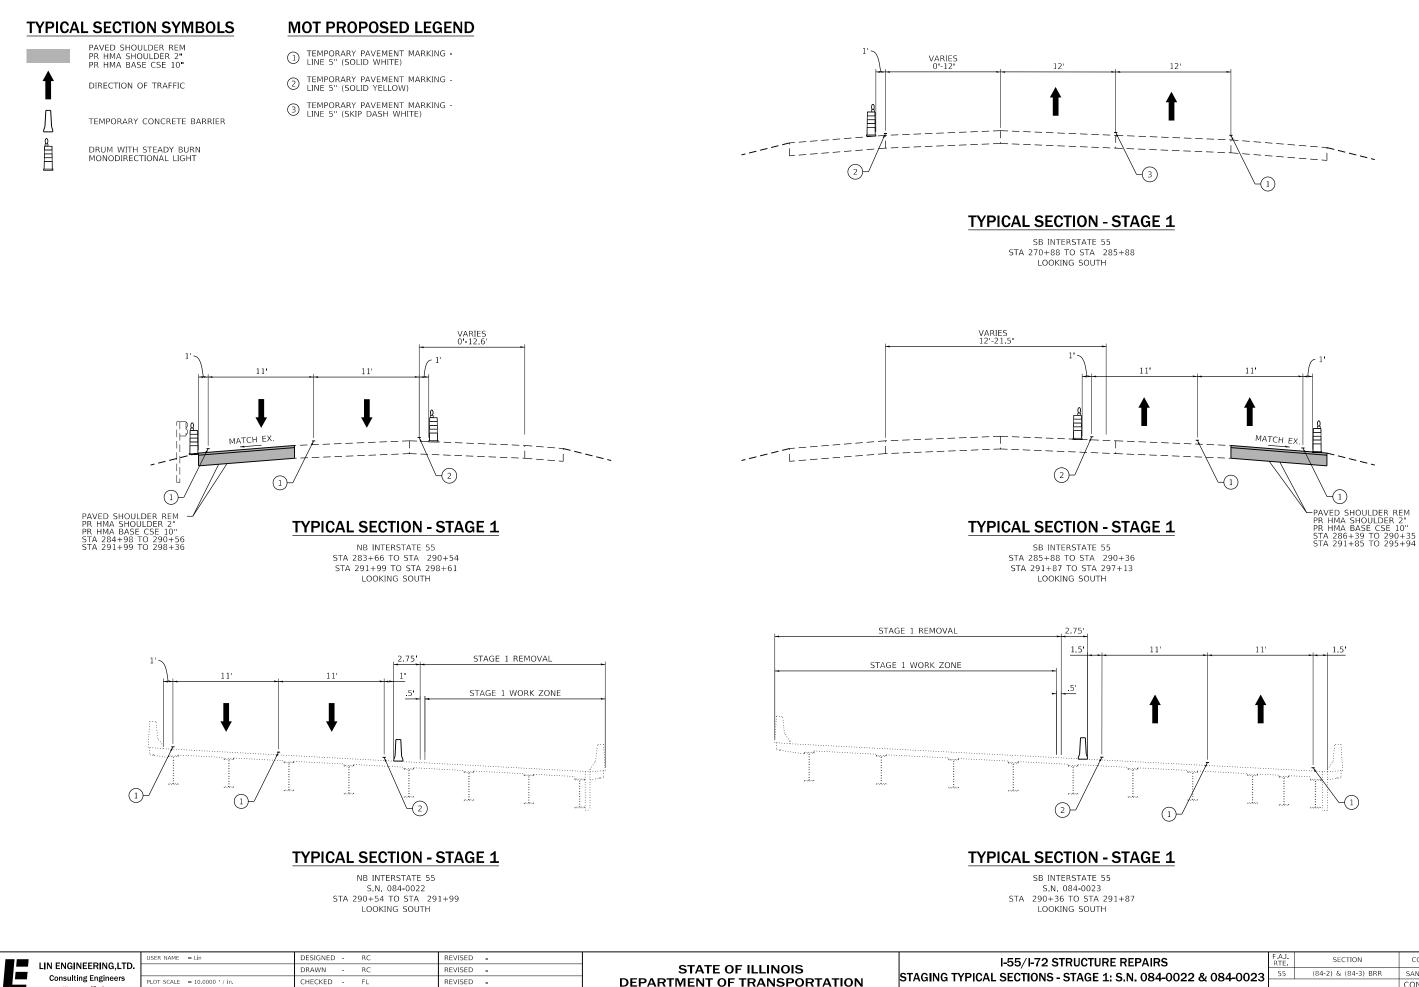

Westmont, IIInols PLOT DATE = 12/11/2018

DATE

12/2018

REVISED -

SCALE: 1"=50' SHEET 2 OF 16 SHEET

JR	JRE REPAIRS			SECTION	COUNTY	TOTAL SHEETS	SHEET NO.
1: S.N. 084-0022 & 084-0023			55	(84-2) & (84-3) BRR	SANGAMON	98	13
	1:5.N. 084-0022 & 084-0023				CONTRACT	NO. 72	J97
ΤS	STA.	TO STA.		ILLINOIS FED. AI	D PROJECT		


TYPICAL SECTION SYMBOLS


PAVED SHOULDER REM PR HMA SHOULDER 2" PR HMA BASE CSE 10"

DIRECTION OF TRAFFIC

MOT PROPOSED LEGEND

- TEMPORARY PAVEMENT MARKING LINE 5" (SOLID WHITE)
- TEMPORARY PAVEMENT MARKING -LINE 5" (SOLID YELLOW)
- ③ TEMPORARY PAVEMENT MARKING -LINE 5" (SKIP DASH WHITE)

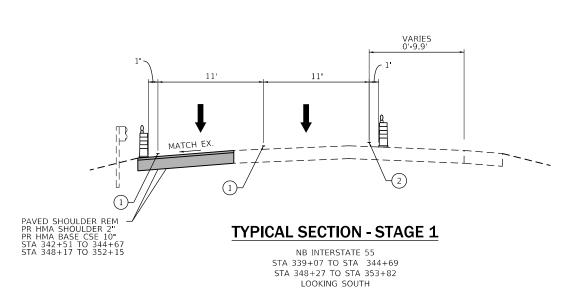

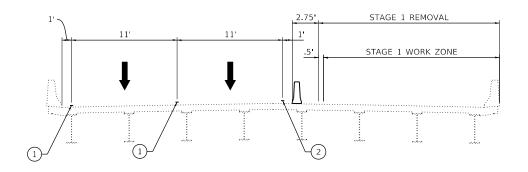


TYPICAL SECTION - STAGE 1

NB INTERSTATE 55 S.N. 084-0020 STA 344+69 TO STA 348+27 LOOKING SOUTH

LIN ENGINEERING,LTD. Consulting Engineers Westmont, Illnois	USER NAME = Lin	DESIGNED - RC	REVISED -		I-55/I-72 STRUCTURE REPAIRS	F.A.I. SECTION	COUNTY TOTAL SHEET
		DRAWN - RC	REVISED -	STATE OF ILLINOIS	STAGING TYPICAL SECTIONS - STAGE 1: S.N. 084-0020	55 (84-2) & (84-3) BRR	SANGAMON 98 14
	PLOT SCALE = 10.0000 ' / in.	CHECKED - FL	REVISED -	DEPARTMENT OF TRANSPORTATION	STAGING TYPICAL SECTIONS - STAGE 1: S.N. 084-0020		CONTRACT NO. 72J97
	PLOT DATE = 12/11/2018	DATE - 12/2018	REVISED -		SCALE: 1"=50' SHEET 3 OF 16 SHEETS STA. TO STA.	ILLINOIS FED.	AID PROJECT

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TEMPORARY CONCRETE BARRIER DRUM WITH STEADY BURN MONODIRECTIONAL LIGHT

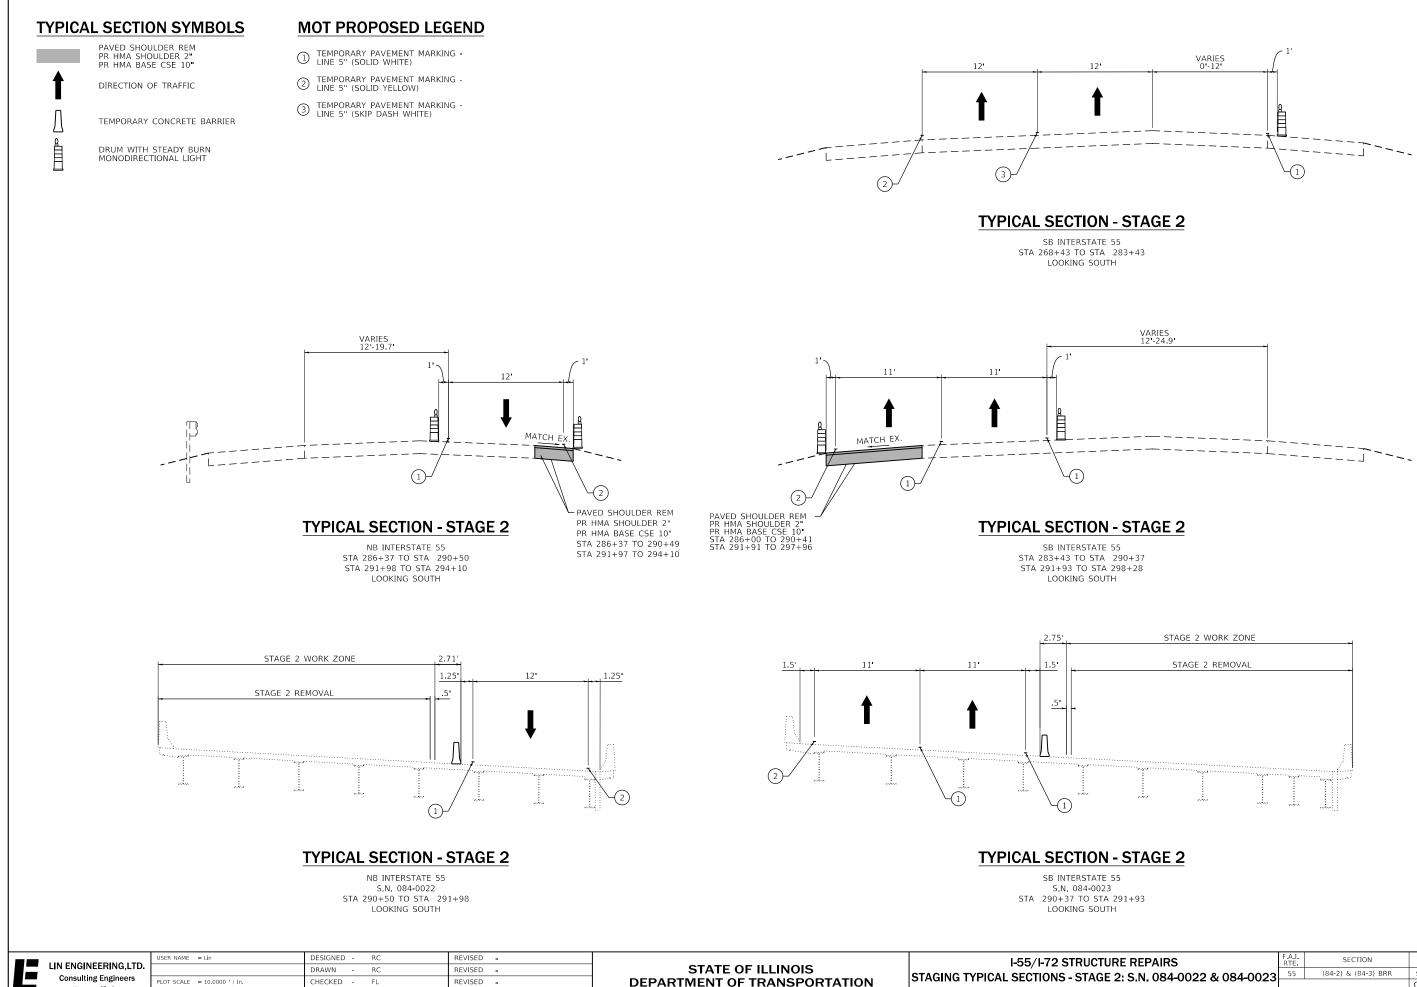

SCALE: 1"=50 SHEET 4 OF 16 SHEET

DATE 12/2018

REVISED -

Westmont, Illinois

PLOT DATE = 12/11/2018

UR	JRE REPAIRS			A.I. SECTION		COUNTY	TOTAL SHEETS	SHEET NO.	
E 2: S.N. 084-0022 & 084-0023			55	(84-2) & (84-3) BRR		SANGAMON	98	15	
	2: 5.N. 084-0022 & 084-0023				CONTRACT NO. 72J97				
TS	STA.	TO STA.			ILLINOIS	FED. AI	D PROJECT		

TYPICAL SECTION SYMBOLS

PAVED SHOULDER REM PR HMA SHOULDER 2" PR HMA BASE CSE 10"

DIRECTION OF TRAFFIC

 \int


TEMPORARY CONCRETE BARRIER

DRUM WITH STEADY BURN MONODIRECTIONAL LIGHT

MOT PROPOSED LEGEND


TEMPORARY PAVEMENT MARKING -LINE 5" (SOLID WHITE)


- TEMPORARY PAVEMENT MARKING -LINE 5" (SOLID YELLOW)
- ③ TEMPORARY PAVEMENT MARKING -LINE 5" (SKIP DASH WHITE)

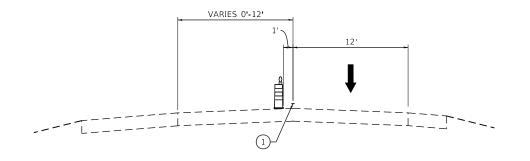



NB INTERSTATE 55 STA 294+10 TO STA 342+02 STA 351+78 TO STA 366+78 LOOKING SOUTH

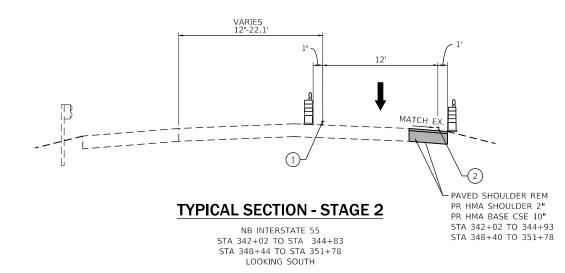


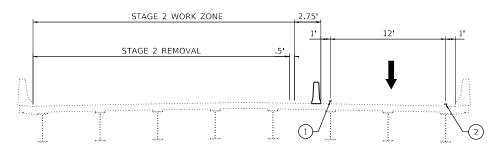

TYPICAL SECTION - STAGE 2

NB INTERSTATE 55 S.N. 084-0020 STA 344+83 TO STA 348+44 LOOKING SOUTH

LIN ENGINEERING,LTD.	USER NAME = Lin	DESIGNED - RC	REVISED -		I-55/I-72 STRUCTURE REPAIRS	F.A.I. SECTION	COUNTY TOTAL SHEET
		DRAWN - RC	REVISED -	STATE OF ILLINOIS		55 (84-2) & (84-3) BRR	SANGAMON 98 16
	PLOT SCALE = 10.0000 ' / in.	CHECKED - FL	REVISED -	DEPARTMENT OF TRANSPORTATION	STAGING TYPICAL SECTIONS - STAGE 2: S.N. 084-0020		CONTRACT NO. 72J97
Westmont, Illinois	PLOT DATE = 12/11/2018	DATE - 12/2018	REVISED -		SCALE: 1"=50' SHEET 5 OF 16 SHEETS STA. TO STA.	ILLINOIS FED.	AID PROJECT

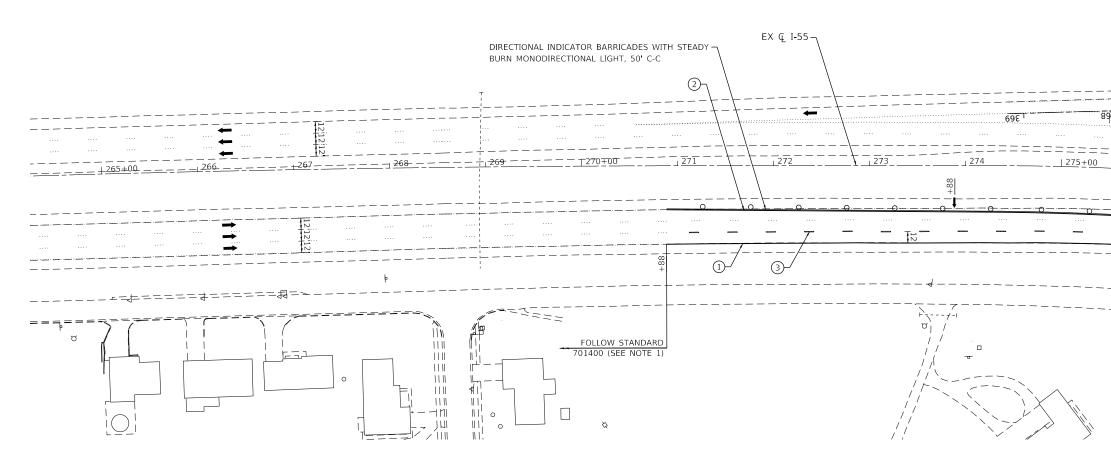


MAINTENANCE OF TRAFFIC LEGEND 77777


	WORK ZONE	(1)	TEMPORARY PAVEMENT MARKING - LINE 5" (SOLID WHITE)				
	PAVED SHOULDER REMOVAL, PR HMA SHOULDER 2", PR HMA BASE CSE 10'	2	TEMPORARY PAVEMENT MARKING - LINE 5" (SOLID YELLOW)				
→	DIRECTION OF TRAFFIC	3	TEMPORARY PAVEMENT MARKING - LINE 5" (SKIP-DASH, WHITE 10' DASH, 30' SKIP)				
þ	SIGN						
-0	DIRECTIONAL INDICATOR BARRICADE, DRUM, OR T2 BARRICADE (SEE PLAN SHEET FOR SPACING-STEADY	4	TEMPORARY PAVEMENT MARKING - LINE 5" (SKIP-DASH, WHITE 2' DASH, 6' SKIP)				
	BURN MONODIRECTIONAL LIGHT IN TAPERS ONLY)	(5)	TEMPORARY PAVEMENT MARKING - LINE 8" (SOLID WHITE)				
9 9	TYPE III BARRICADE WITH FLASHING LIGHTS	\cup					
t	ARROW BOARD	6	IMPACT ATTENUATORS, TEMPORARY (FULLY REDIRECTIVE, NARROW), TEST LEVEL 3				
	TEMPORARY CONCRETE BARRIER	$\overline{\mathcal{A}}$	IMPACT ATTENUATORS, RELOCATE (FULLY REDIRECTIVE, NARROW), TEST LEVEL 3				
4	MONODIRECTIONAL BARRIER WALL REFLECTOR	3 v 4 v 5 t 6 z 7 z	NARROW), TEST LEVEL 3				
	IMPACT ATTENUATORS, TEMPORARY (FULLY REDIRECTIVE, NARROW), TEST LEVEL 3	8	TEMPORARY CONCRETE BARRIER				

	LIN ENGINEERING.LTD.	USER NAME = Lin	DESIGNED -	RC	REVISED -			I-55/I-72 STRUCTURE REPAIRS	F.A.I. RTE	SECTION	COUNTY TOTAL SHEET SHEETS NO.
Consulting Engineers		DRAWN -	RC	REVISED -	STATE OF ILLINOIS	STAGING PLAN - STAGE 1: S.N. 084-0022 & 084-0023			(84-2) & (84-3) BRR	SANGAMON 98 17	
	Westmont, Illinois	PLOT SCALE = 100.0000 ' / in.	CHECKED -	FL	REVISED -	DEPARTMENT OF TRANSPORTATION	STAILET STALE 1. S.N. 05+0022 & 05+0023		_		CONTRACT NO. 72J97
	Hestinoni, Minolo	PLOT DATE = 12/11/2018	DATE -	12/2018	REVISED -		SCALE: 1"=50'	SHEET 6 OF 16 SHEETS STA 264+00.00 TO STA 279+00.00		ILLINOIS FED. 4	AID PROJECT

NOTES:


"ROAD CONSTRUCTION AHEAD 2 MILES" AND WORK ZONE SPEED LIMIT ARRAY SIGNS SHALL BE ERECTED BY THE CONTRACTOR ALONG THE SB ENTRANCE RAMP OF THE WEIGH STATION UPSTREAM OF THE WORK ZONE. LOCATIONS SHALL BE AS DETERMINED BY THE ENGINEER.

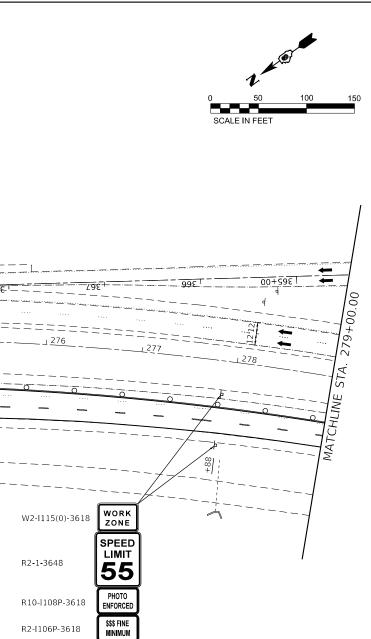

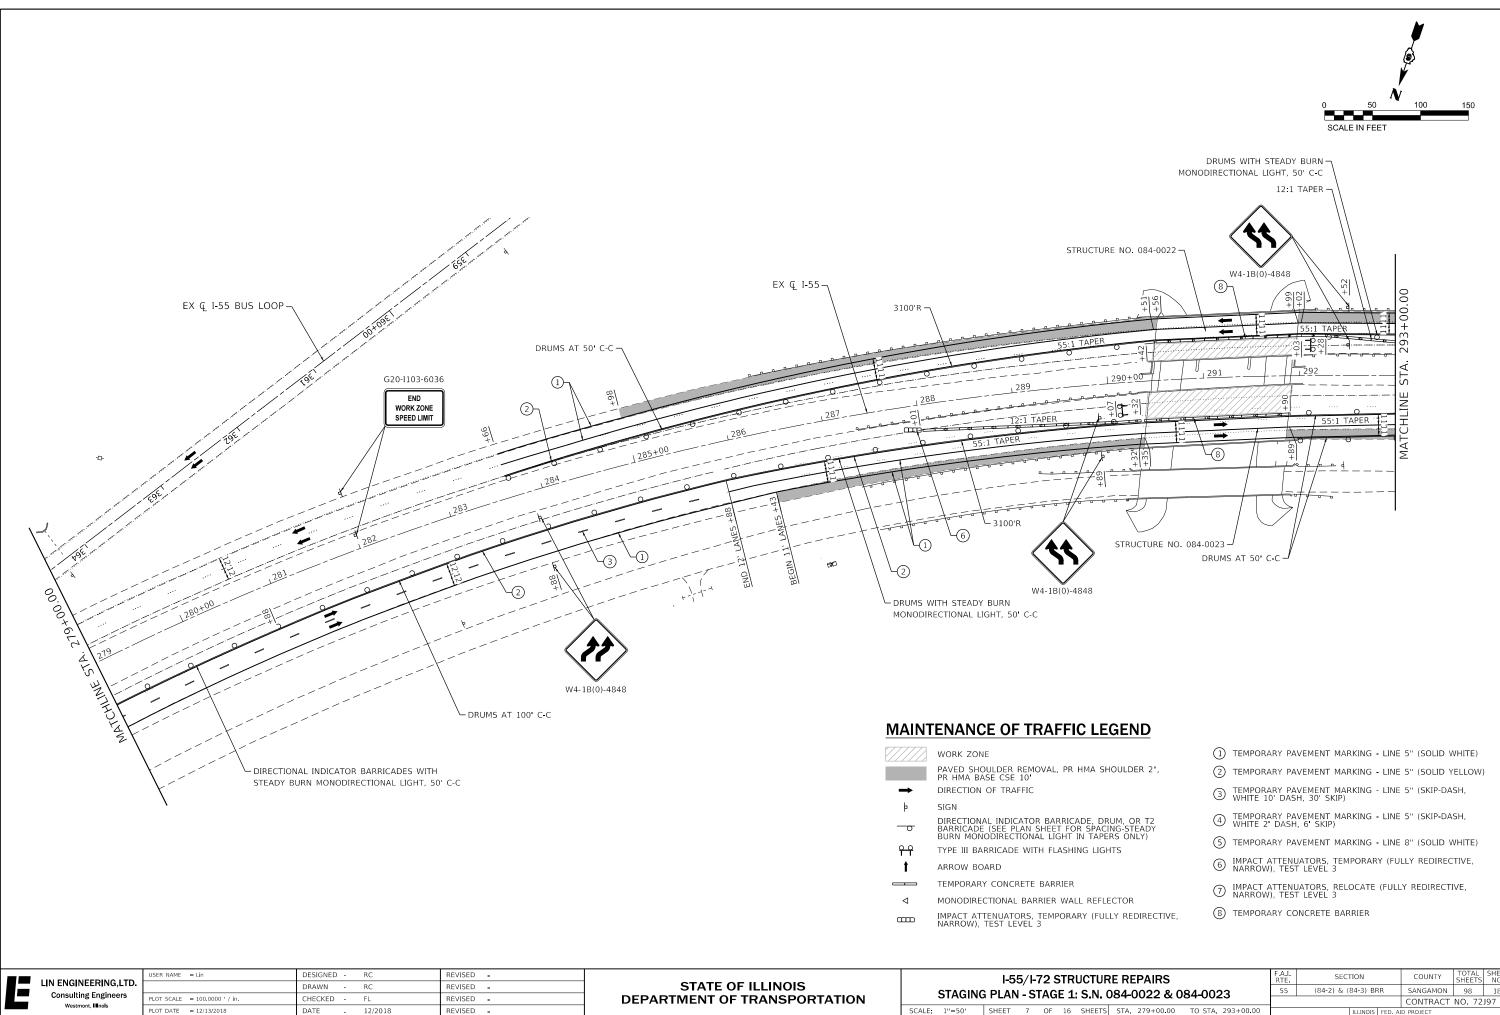


	(1)	TEMPORARY PAVEMENT MARKING - LINE 5" (SOLID WHITE)
SHOULDER 2",	2	TEMPORARY PAVEMENT MARKING - LINE 5" (SOLID YELLOW)
	3	TEMPORARY PAVEMENT MARKING - LINE 5" (SKIP-DASH, WHITE 10' DASH, 30' SKIP)
DRUM, OR T2 ACING-STEADY	4	TEMPORARY PAVEMENT MARKING - LINE 5" (SKIP-DASH, WHITE 2' DASH, 6' SKIP)
APERS ONLY) IGHTS	5	TEMPORARY PAVEMENT MARKING - LINE 8" (SOLID WHITE)
	6	IMPACT ATTENUATORS, TEMPORARY (FULLY REDIRECTIVE, NARROW), TEST LEVEL 3
FLECTOR	7	IMPACT ATTENUATORS, RELOCATE (FULLY REDIRECTIVE, NARROW), TEST LEVEL 3
FULLY REDIRECTIVE,	8	TEMPORARY CONCRETE BARRIER

URE REPAIRS	F.A.I. RTE	SECTION	COUNTY	TOTAL SHEETS	SHEET NO.
. 084-0022 & 084-0023	55	(84-2) & (84-3) BRR	SANGAMON	98	18
1:00+0022 & 00+0023			CONTRACT	NO. 72	J97
TS STA. 279+00.00 TO STA. 293+00.00		ILLINOIS FEI	D. AID PROJECT		

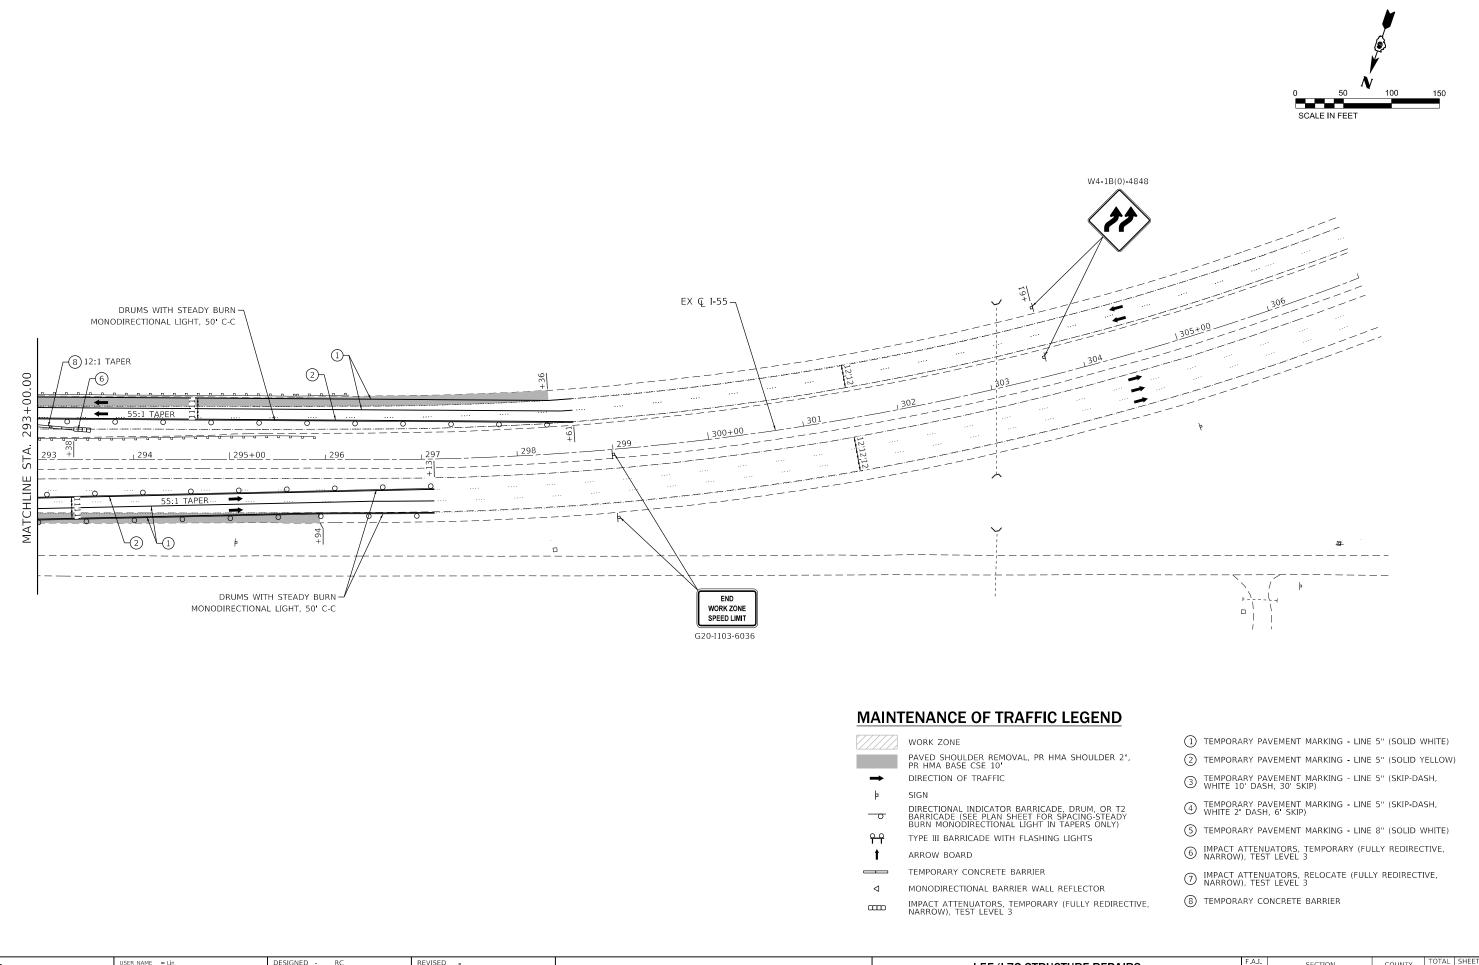

	USER NAME = Lin	DESIGNED -	RC	REVISED -		I-55/I-72 STRUCTURE REPAIRS	F.A.I. BTE	SECTION	COUNTY TOTAL SHEET
		DRAWN -	RC	REVISED -	STATE OF ILLINOIS	STAGING PLAN - STAGE 1: S.N. 084-0022 & 084-0023	55	(84-2) & (84-3) BRR	SANGAMON 98 19
Consulting Engineers Westmont, III nols	PLOT SCALE = 100.0000 ' / in.	CHECKED -	FL	REVISED -	DEPARTMENT OF TRANSPORTATION	STAUING FLAN - STAGE 1: 5.N. 004-0022 & 004-0025			CONTRACT NO. 72J97
westmont, minors	PLOT DATE = 12/11/2018	DATE -	12/2018	REVISED -		SCALE: 1"=50' SHEET 8 OF 16 SHEETS STA 293+00.00 TO STA 307+00.00		ILLINOIS FED.	AID PROJECT

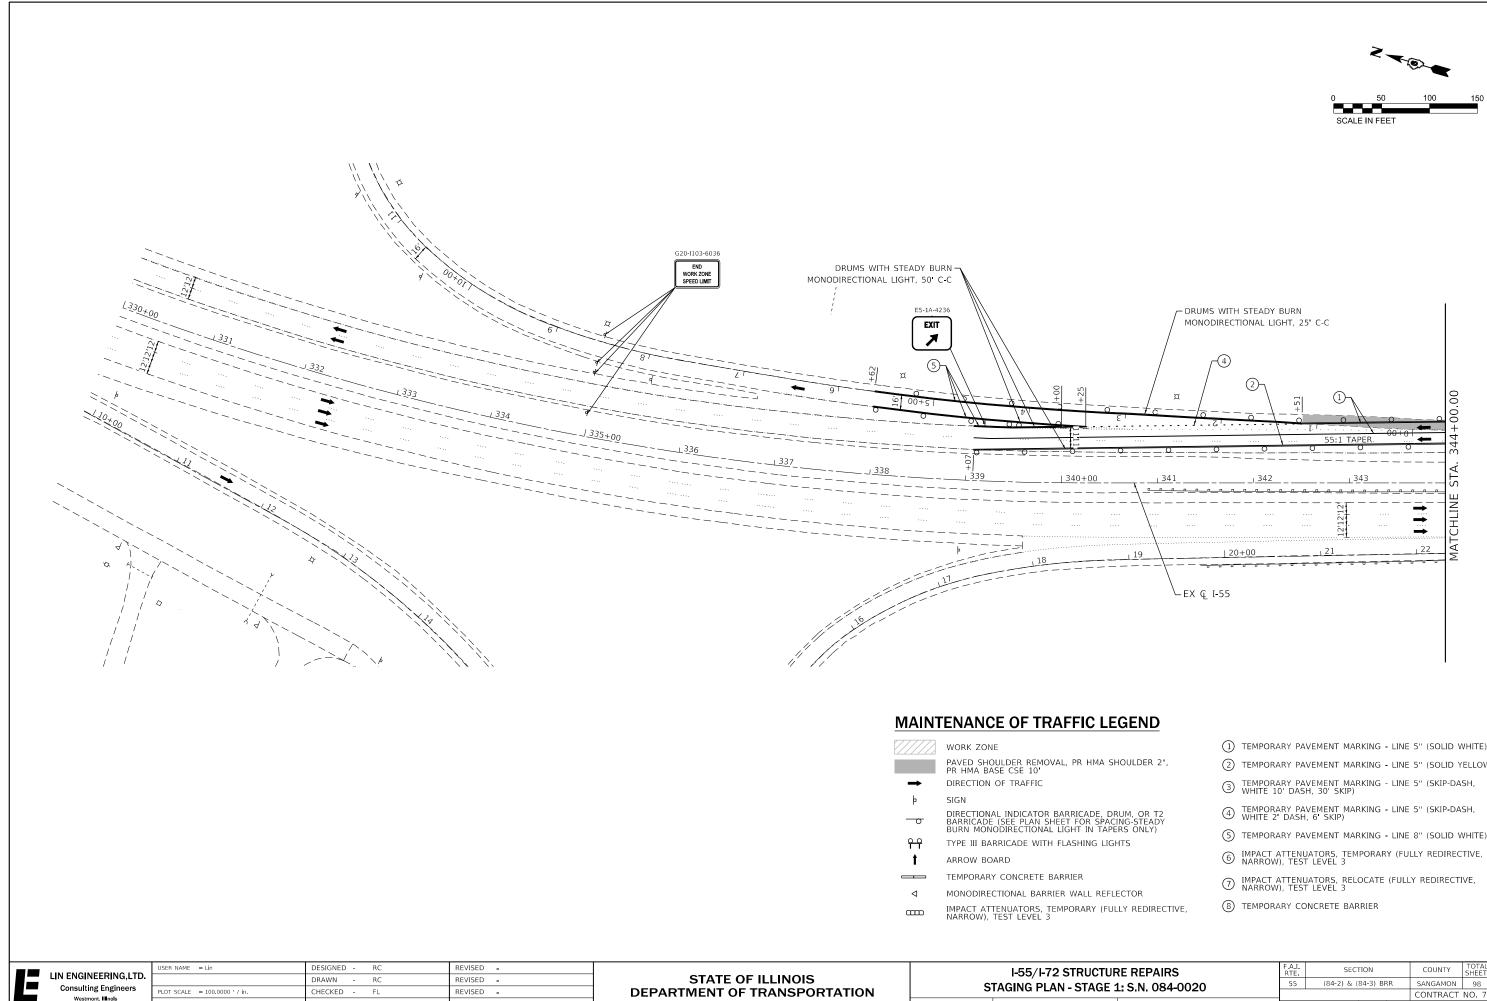

Westmont, Illinois

PLOT DATE = 12/11/2018

DATE


12/2018

REVISED -

SCALE: 1"=50' SHEET 9 OF 16 SHEET

	(1)	TEMPORARY PAVEMENT MARKING - LINE 5" (SOLID WHITE)
1A SHOULDER 2",	2	TEMPORARY PAVEMENT MARKING - LINE 5" (SOLID YELLOW)
	3	TEMPORARY PAVEMENT MARKING - LINE 5" (SKIP-DASH, WHITE 10' DASH, 30' SKIP)
E, DRUM, OR T2 SPACING-STEADY	4	TEMPORARY PAVEMENT MARKING - LINE 5" (SKIP-DASH, WHITE 2' DASH, 6' SKIP)
TAPERS ONLY)	5	TEMPORARY PAVEMENT MARKING - LINE 8" (SOLID WHITE)
	6	IMPACT ATTENUATORS, TEMPORARY (FULLY REDIRECTIVE, NARROW), TEST LEVEL 3
REFLECTOR	7	IMPACT ATTENUATORS, RELOCATE (FULLY REDIRECTIVE, NARROW), TEST LEVEL 3
(FULLY REDIRECTIVE,	8	TEMPORARY CONCRETE BARRIER

UR	E REPAIR	6	F.A.I. RTE	SEC	ΠΟΝ		COUNTY	TOTAL SHEETS	SHEET NO.
F 1	: S.N. 084	0020	55	(84-2) & (84-3) BF	RR	SANGAMON	98	20
		-0020					CONTRACT	NO. 72	J97
TS	STA. 330+00	00 TO STA. 344+00.0	0		ILLINOIS	FED. AI	D PROJECT		

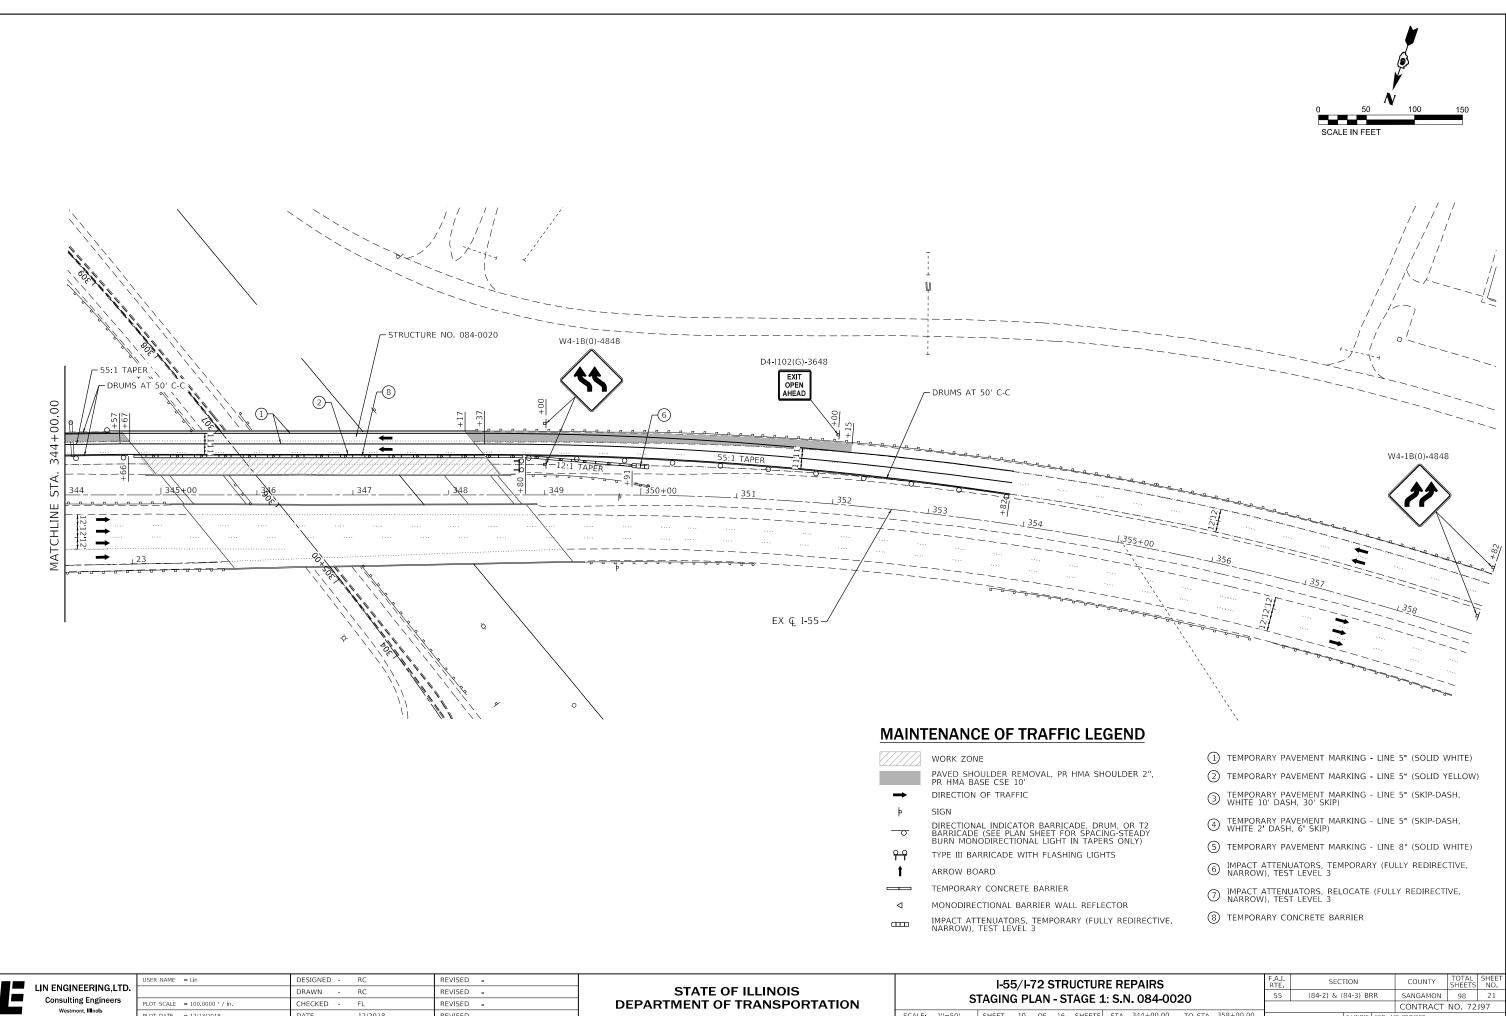


LOT DATE = 12/13/2018

DATE

12/2018

REVISED -

CONTRACT NO. 72J97 SCALE: 1"=50' SHEET 10 OF 16 SHEETS STA 344+00.00 TO STA 358+00.00

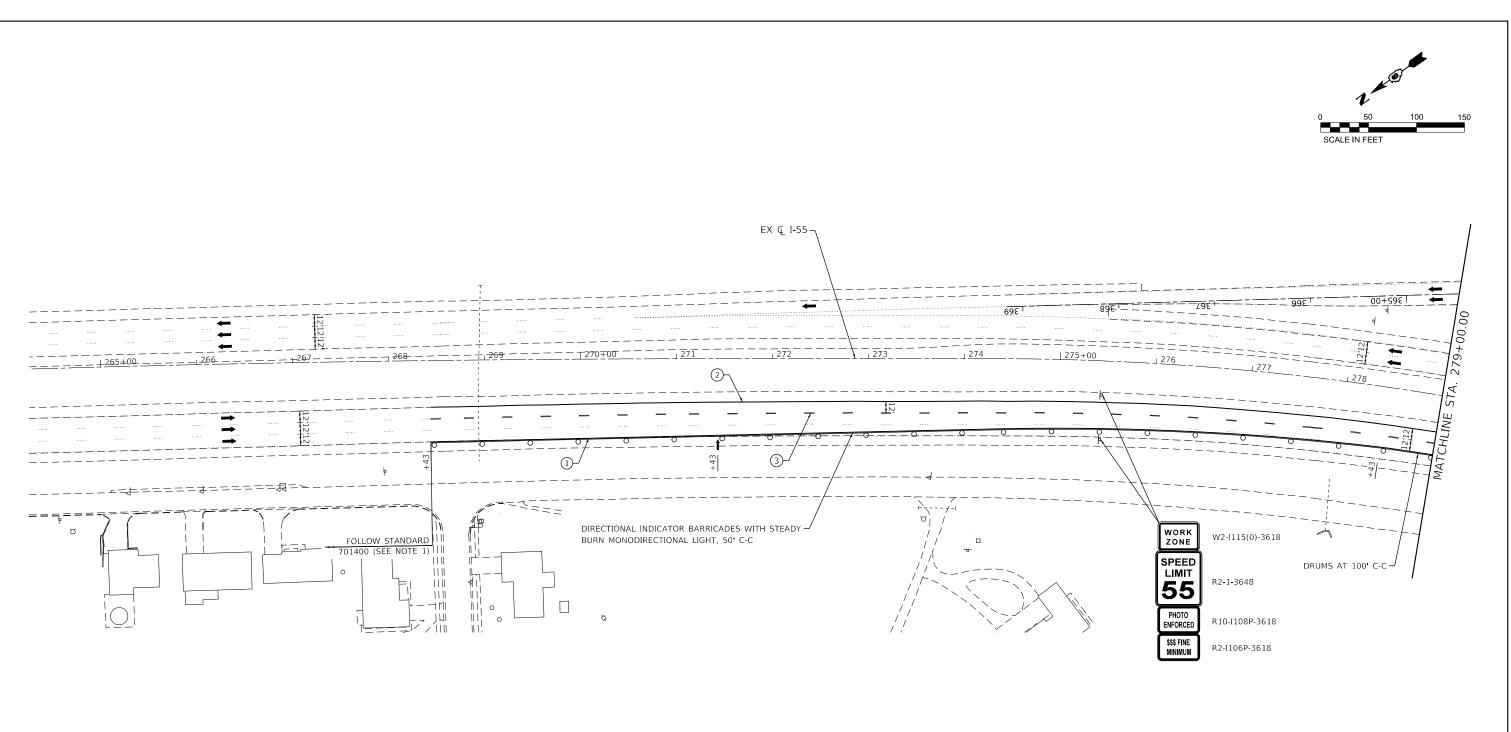

NOTES:


"ROAD CONSTRUCTION AHEAD 2 MILES" AND WORK ZONE SPEED LIMIT ARRAY SIGNS SHALL BE ERECTED BY THE CONTRACTOR ALONG THE SB ENTRANCE RAMP OF THE WEIGH STATION UPSTREAM OF THE WORK ZONE. LOCATIONS SHALL BE AS DETERMINED BY THE ENGINEER.

MAINTENANCE OF TRAFFIC LEGEND

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	WORK ZONE	(1)	TEMPORARY PAVEMENT MARKING - LINE 5" (SOLID WHITE)
	PAVED SHOULDER REMOVAL, PR HMA SHOULDER 2", PR HMA BASE CSE 10	2	TEMPORARY PAVEMENT MARKING - LINE 5" (SOLID YELLOW)
→	DIRECTION OF TRAFFIC	3	TEMPORARY PAVEMENT MARKING - LINE 5" (SKIP-DASH, WHITE 10' DASH, 30' SKIP)
þ	SIGN		
<u> </u>	DIRECTIONAL INDICATOR BARRICADE, DRUM, OR T2 BARRICADE (SEE PLAN SHEET FOR SPACING-STEADY	4	TEMPORARY PAVEMENT MARKING - LINE 5" (SKIP-DASH, WHITE 2' DASH, 6' SKIP)
	BURN MONODIRECTIONAL LIGHT IN TAPERS ONLY)	(5)	TEMPORARY PAVEMENT MARKING - LINE 8" (SOLID WHITE)
የ የ	TYPE III BARRICADE WITH FLASHING LIGHTS	\cup	
t	ARROW BOARD	6	IMPACT ATTENUATORS, TEMPORARY (FULLY REDIRECTIVE, NARROW), TEST LEVEL 3
	TEMPORARY CONCRETE BARRIER	\overline{O}	IMPACT ATTENUATORS, RELOCATE (FULLY REDIRECTIVE, NARROW), TEST LEVEL 3
\triangleleft	MONODIRECTIONAL BARRIER WALL REFLECTOR	U	NARROW), TEST LEVEL 3
	IMPACT ATTENUATORS, TEMPORARY (FULLY REDIRECTIVE, NARROW), TEST LEVEL 3	8	TEMPORARY CONCRETE BARRIER

LIN ENGINEERING.LTD.	USER NAME = Lin	DESIGNED - RC	REVISED -		I-55/I-72 STRUCTURE REPAIRS	F.A.I. SECTION	COUNTY TOTAL SHEET SHEETS NO.
		DRAWN - RC	REVISED -	STATE OF ILLINOIS	STAGING PLAN - STAGE 2: S.N. 084-0022 & 084-0023	55 (84-2) & (84-3) BRR	SANGAMON 98 22
Consulting Engineers	PLOT SCALE = 100.0000 ' / in.	CHECKED - FL	REVISED -	DEPARTMENT OF TRANSPORTATION	STAGING PLAN - STAGE 2: S.N. 084-0022 & 084-0023		CONTRACT NO. 72J97
Westmont, Illinois	PLOT DATE = 12/11/2018	DATE - 12/2018	REVISED -		SCALE: 1"=50' SHEET 11 OF 16 SHEETS STA. 264+00.00 TO STA. 279+00.00	ILLINOIS FE	D. AID PROJECT

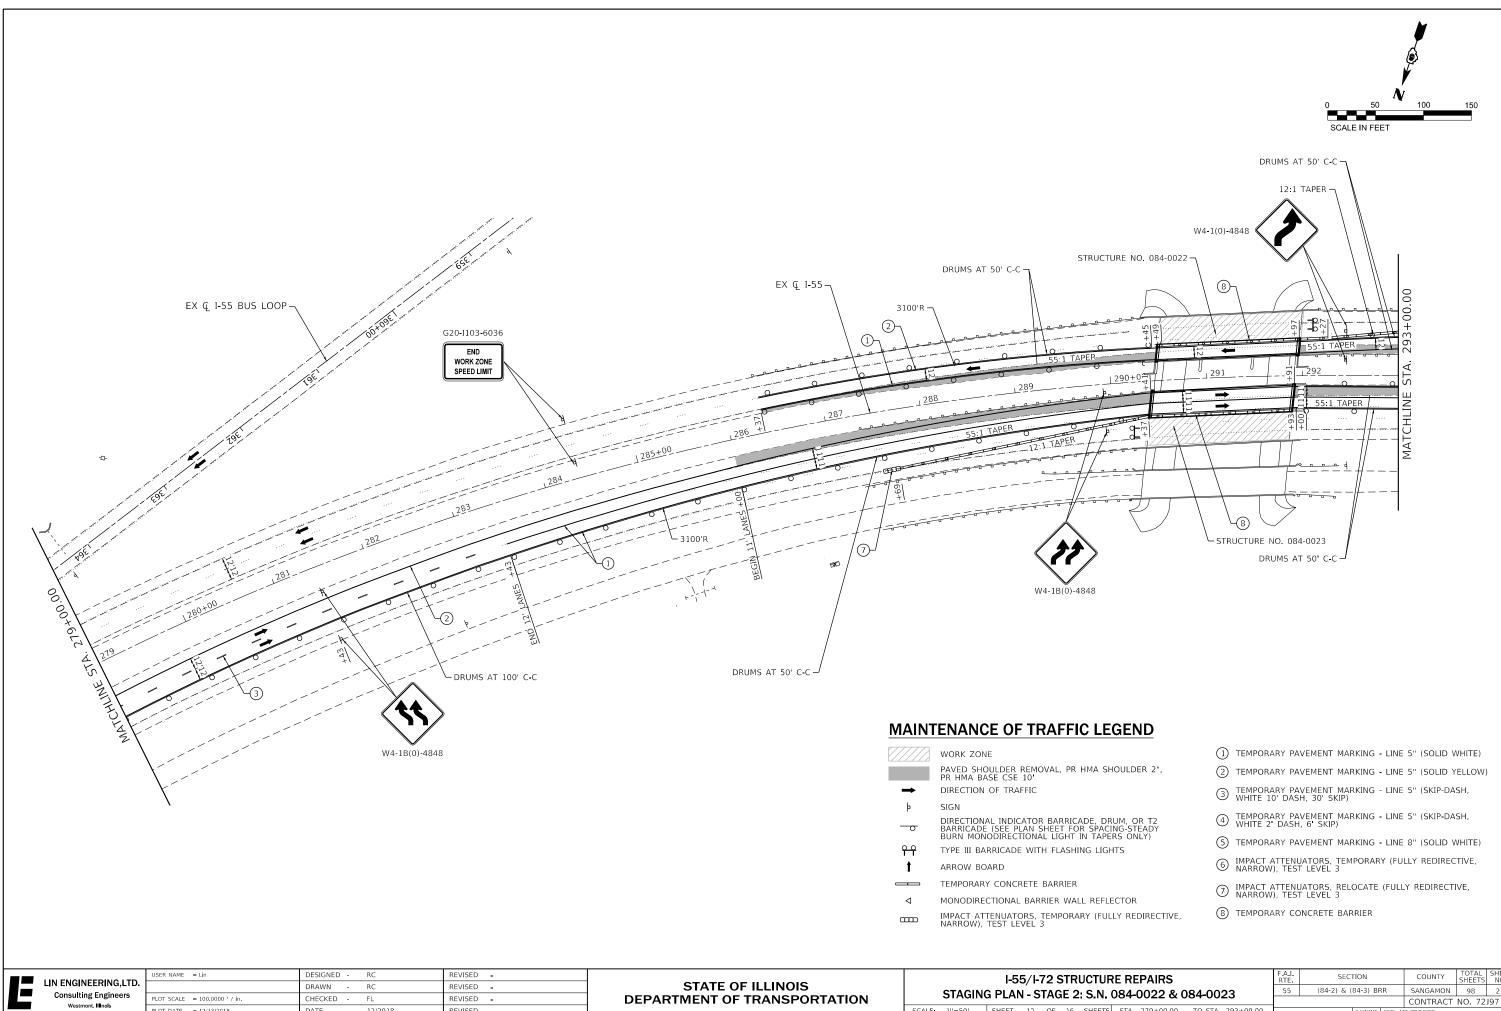

PLOT DATE = 12/13/2018


DATE

12/2018

REVISED -

	(1)	TEMPORARY PAVEMENT MARKING - LINE 5" (SOLID WHITE)
SHOULDER 2",	2	TEMPORARY PAVEMENT MARKING - LINE 5" (SOLID YELLOW)
	3	TEMPORARY PAVEMENT MARKING - LINE 5" (SKIP-DASH, WHITE 10' DASH, 30' SKIP)
DRUM, OR T2 ACING-STEADY	4	TEMPORARY PAVEMENT MARKING - LINE 5" (SKIP-DASH, WHITE 2' DASH, 6' SKIP)
APERS ONLY) IGHTS	5	TEMPORARY PAVEMENT MARKING - LINE 8" (SOLID WHITE)
	6	IMPACT ATTENUATORS, TEMPORARY (FULLY REDIRECTIVE, NARROW), TEST LEVEL 3
FLECTOR	7	IMPACT ATTENUATORS, RELOCATE (FULLY REDIRECTIVE, NARROW), TEST LEVEL 3
FULLY REDIRECTIVE,	8	TEMPORARY CONCRETE BARRIER

		I-5	5/1-	72 5	STR	UCTUR	E REPAIRS		F.A.I. RTE	SECTION	COUNTY	TOTAL SHEETS	SHEET NO.
	STAGIN		a _ c	TΔG	F 2	SNO	084-0022 &	084-0023	55	(84-2) & (84-3) BRR	SANGAMON	98	23
	STAUR		1-0	IAU			00 4 -0022 a	00+0025			CONTRACT	NO. 72	J97
SCALE:	1"=50'	SHEET	12	OF	16	SHEETS	STA. 279+00.00	TO STA. 293+00.00		ILLINOIS FED. A	ID PROJECT		

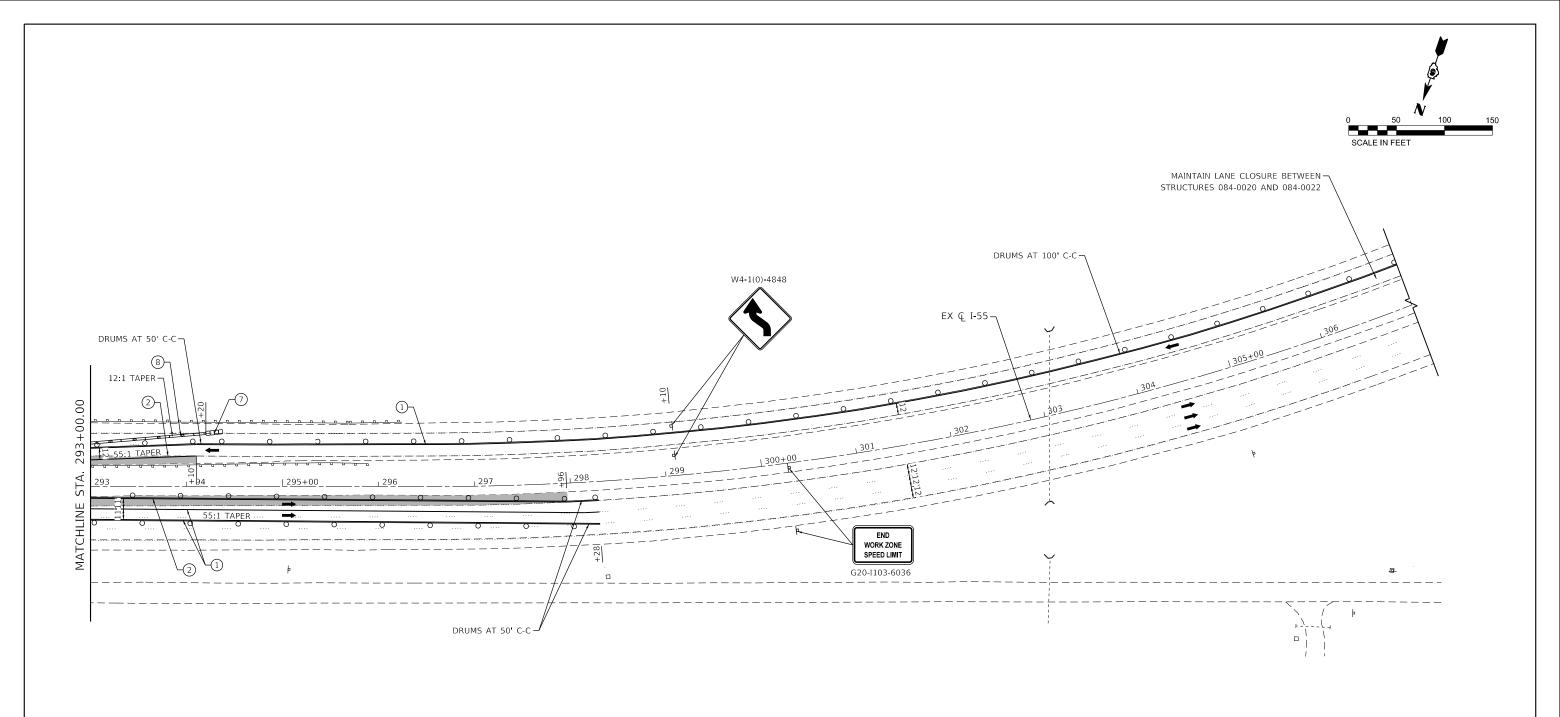

MAINTENANCE OF TRAFFIC LEGEND

	WORK ZONE
	PAVED SHOULDER REMOVAL, PR HMA PR HMA BASE CSE 10'
→	DIRECTION OF TRAFFIC
þ	SIGN
-0	DIRECTIONAL INDICATOR BARRICADE, BARRICADE (SEE PLAN SHEET FOR SP. BURN MONODIRECTIONAL LIGHT IN TA
$\frac{1}{2}$	TYPE III BARRICADE WITH FLASHING L
t	ARROW BOARD
	TEMPORARY CONCRETE BARRIER
\triangleleft	MONODIRECTIONAL BARRIER WALL RE
	IMPACT ATTENUATORS, TEMPORARY (F NARROW), TEST LEVEL 3

	USER NAME = Lin	DESIGNED - RC	REVISED -		I-55/I-72 STRUCTURE REPAIRS	F.A.I. SECTION	COUNTY TOTAL SHEET
LIN ENGINEERING,LTD.		DRAWN - RC	REVISED -	STATE OF ILLINOIS	STAGING PLAN - STAGE 2: S.N. 084-0022 & 084-0023	55 (84-2) & (84-3) BRR	SANGAMON 98 24
Westmont, Illinois	PLOT DATE = 12/13/2018	DATE - 12/2018	REVISED -	DEPARTMENT OF TRANSPORTATION	SCALE: 1"=50' SHEET 13 OF 16 SHEETS STA. 293+00.00 TO STA. 307+00.00	ILLINOIS FEI	CONTRACT NO. 72J97

SHOULDER 2",


E, DRUM, OR T2 PACING-STEADY TAPERS ONLY) LIGHTS

REFLECTOR (FULLY REDIRECTIVE, TEMPORARY PAVEMENT MARKING - LINE 5" (SKIP-DASH, WHITE 10' DASH, 30' SKIP)

1 TEMPORARY PAVEMENT MARKING - LINE 5" (SOLID WHITE)

(2) TEMPORARY PAVEMENT MARKING - LINE 5" (SOLID YELLOW)

- (4) TEMPORARY PAVEMENT MARKING LINE 5" (SKIP-DASH, WHITE 2' DASH, 6' SKIP)
- 5 TEMPORARY PAVEMENT MARKING LINE 8" (SOLID WHITE)
- IMPACT ATTENUATORS, TEMPORARY (FULLY REDIRECTIVE, NARROW), TEST LEVEL 3
- \bigcirc IMPACT ATTENUATORS, RELOCATE (FULLY REDIRECTIVE, NARROW), TEST LEVEL 3
- (8) TEMPORARY CONCRETE BARRIER

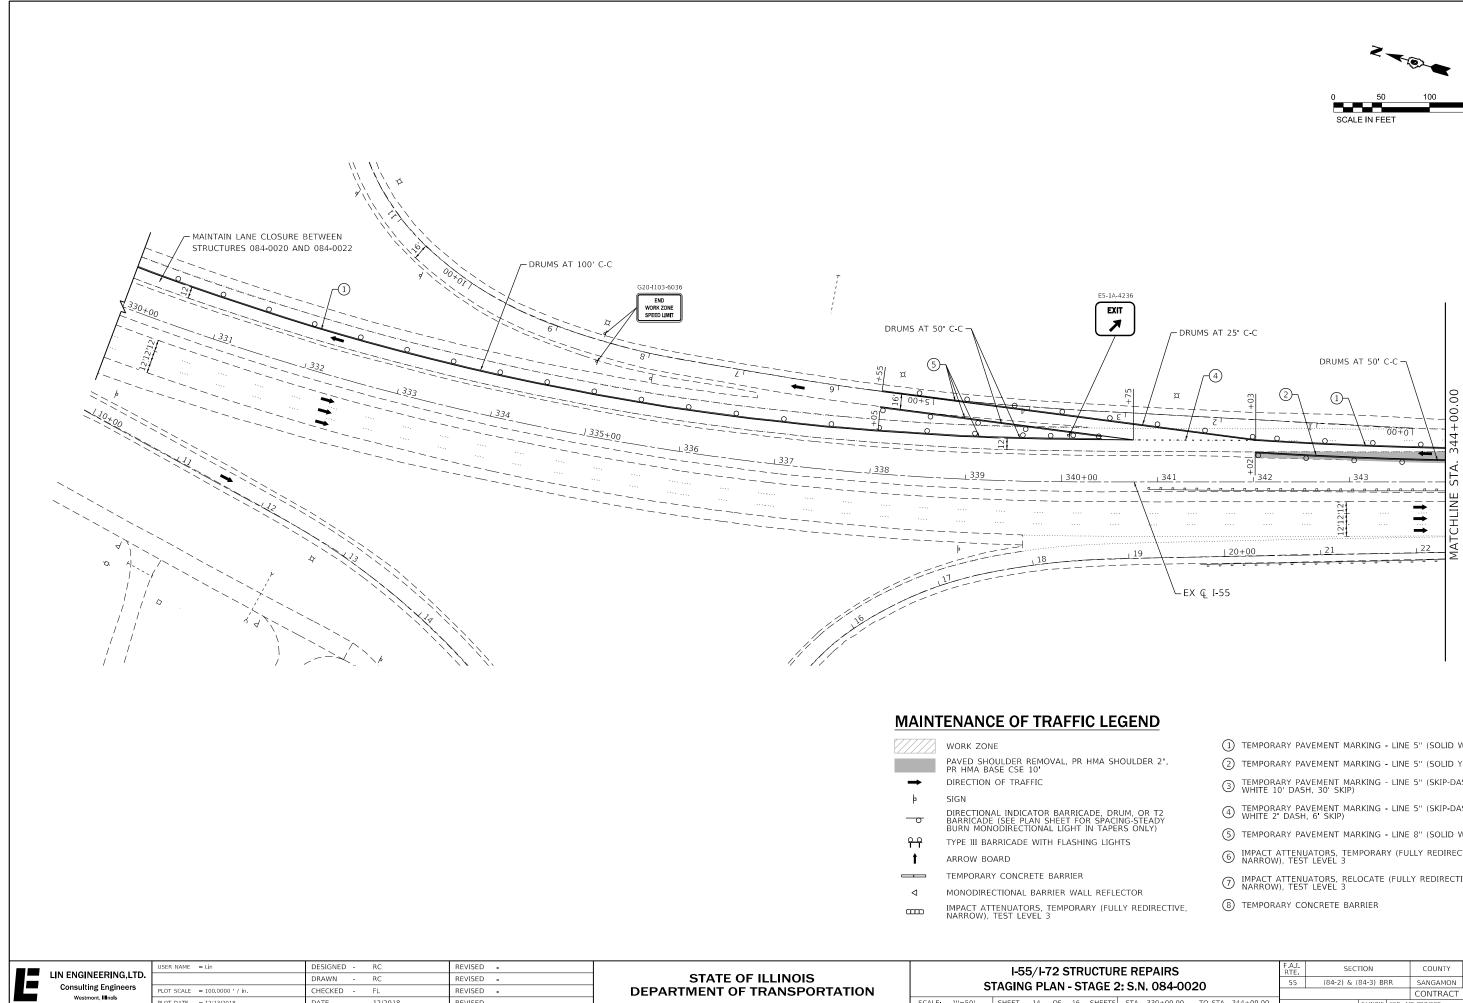


PLOT DATE = 12/13/2018

DATE


12/2018

REVISED -

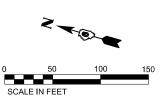

	(1)	TEMPORARY PAVEMENT MARKING - LINE 5" (SOLID WHITE)
1A SHOULDER 2",	2	TEMPORARY PAVEMENT MARKING - LINE 5" (SOLID YELLOW)
	3	TEMPORARY PAVEMENT MARKING - LINE 5" (SKIP-DASH, WHITE 10' DASH, 30' SKIP)
E, DRUM, OR T2 SPACING-STEADY	4	TEMPORARY PAVEMENT MARKING - LINE 5" (SKIP-DASH, WHITE 2' DASH, 6' SKIP)
TAPERS ONLY)	(5)	TEMPORARY PAVEMENT MARKING - LINE 8" (SOLID WHITE)
	6	IMPACT ATTENUATORS, TEMPORARY (FULLY REDIRECTIVE, NARROW), TEST LEVEL 3
REFLECTOR	7	IMPACT ATTENUATORS, RELOCATE (FULLY REDIRECTIVE, NARROW), TEST LEVEL 3
(FULLY REDIRECTIVE,	8	TEMPORARY CONCRETE BARRIER

		I-5	5/1-	72 5	STR	UCTUR	ERE	PAIRS			F.A.I. RTE	SEC	ΠON		COUNTY	TOTAL SHEETS	SHEET NO.
	I-55/I-72 STRUCTURE REPAIRS STAGING PLAN - STAGE 2: S.N. 084-0020											(84-2) & (84-3) BRR	۲.	SANGAMON	98	25
		IAdin		-711	- 51		. 0.1	. 0000	20						CONTRACT	NO. 72	J97
SCALE:	1"=50'	SHEET	14	OF	16	SHEETS	STA.	330+00.00	TO STA. 3	344+00.00			ILLINOIS F	FED. All	D PROJECT		

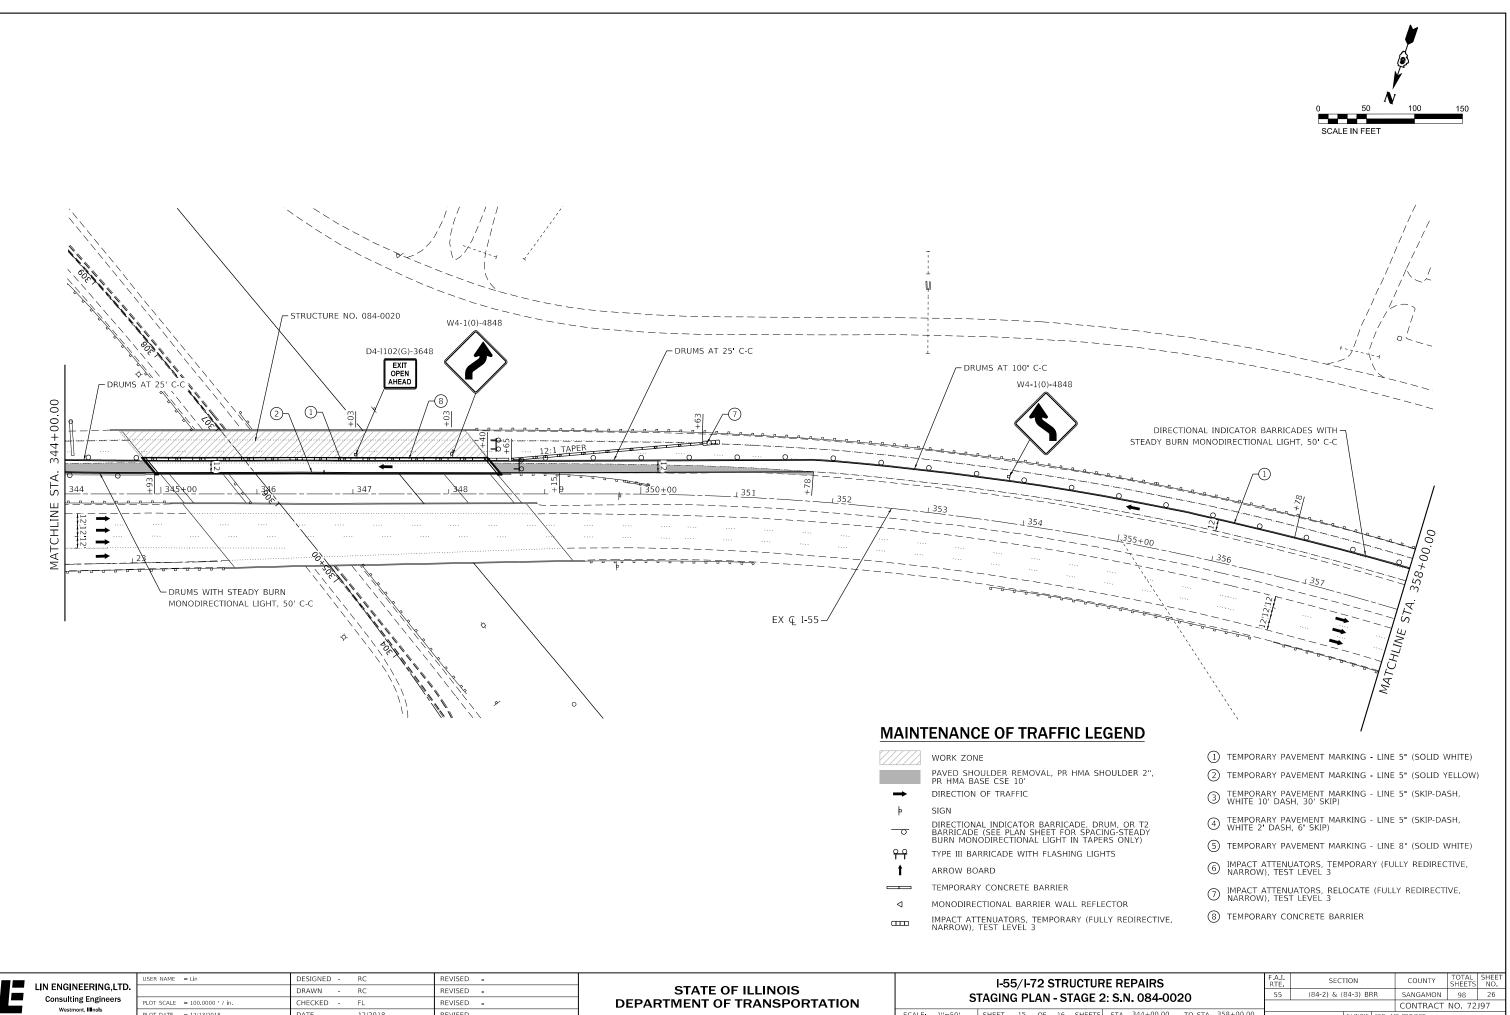


REVISED -


12/2018

SCALE: 1"=50' SHEET 15 OF 16 SHEET

RE REPAIRS	F.A.I. RTE	SECTION	ON		COUNTY	TOTAL SHEETS	SHEET NO.
2: S.N. 084-0020	55	(84-2) & (84	4-3) BR	R	SANGAMON	98	26
					CONTRACT	NO. 72	J97
S STA 344+00.00 TO STA 358+00.00		П	LLINOIS	FED. AI	D PROJECT		

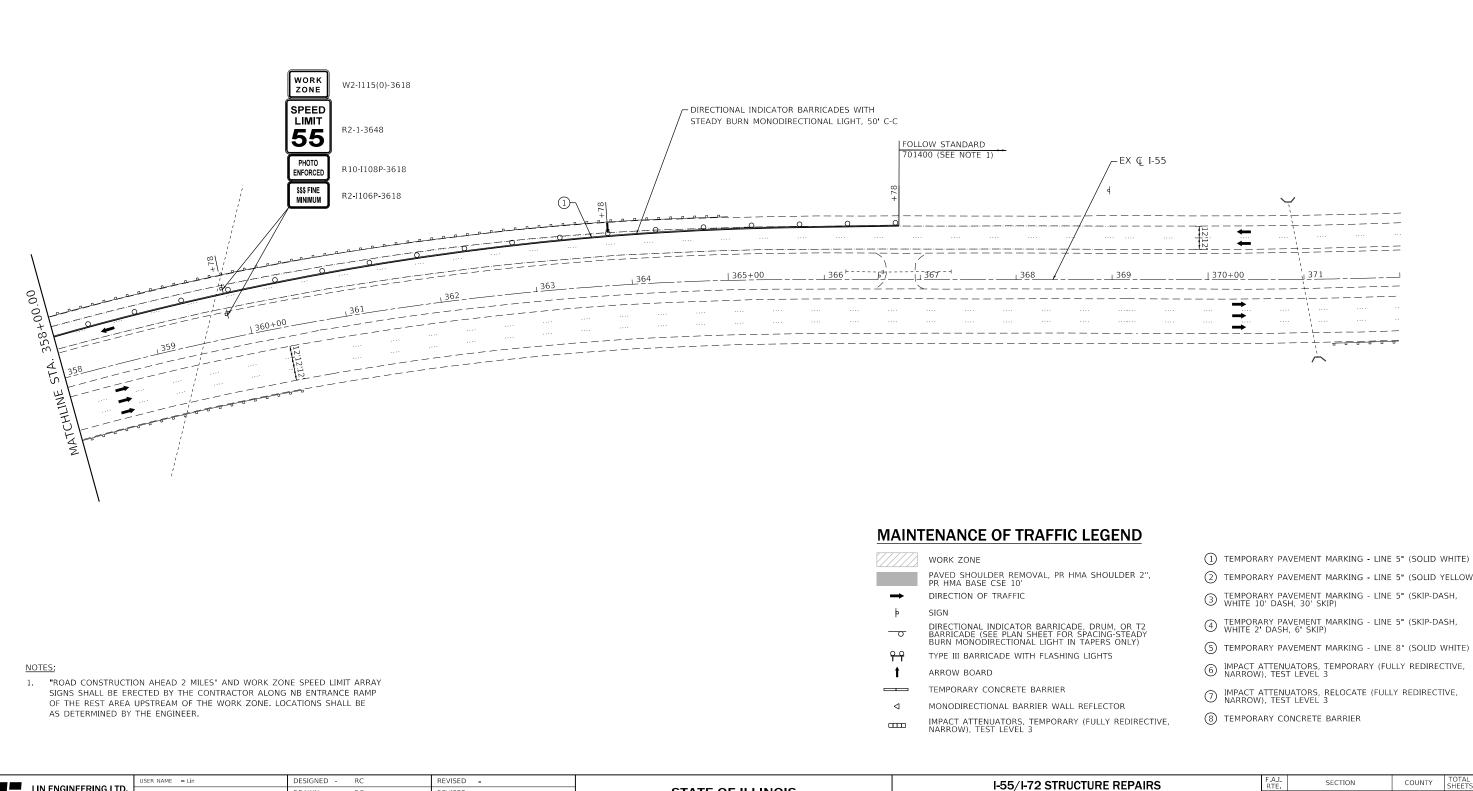

LIN ENGINEERING, LTD.	USER NAME = Lin	DESIGNED - DRAWN -	RC RC	REVISED - REVISED -	STATE OF ILLINOIS		I-55/I-72 STRUCTURE TAGING PLAN - STAGE 2:
Consulting Engineers	PLOT SCALE = 100.0000 ' / in.	CHECKED -	FL	REVISED -	DEPARTMENT OF TRANSPORTATION	3	TAGING PLAN - STAGE 2
Westmont, Illinois	PLOT DATE = 12/11/2018	DATE -	12/2018	REVISED -		SCALE: 1"=50'	SHEET 16 OF 16 SHEETS

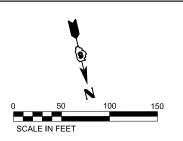

	(1)	TEMPORARY PAVEMENT MARKING - LINE 5" (SOLID WHITE)
, III ,	2	TEMPORARY PAVEMENT MARKING - LINE 5" (SOLID YELLOW)
	3	TEMPORARY PAVEMENT MARKING - LINE 5" (SKIP-DASH, WHITE 10' DASH, 30' SKIP)
2 Y	4	TEMPORARY PAVEMENT MARKING - LINE 5" (SKIP-DASH, WHITE 2' DASH, 6' SKIP)

- $\textcircled{\mbox{\footnotesize 0}}$ IMPACT ATTENUATORS, TEMPORARY (FULLY REDIRECTIVE, NARROW), TEST LEVEL 3

R	UCTUR		AIRS			F.A.I. RTE	SEC	FION		COUNTY	TOTAL SHEETS	SHEET NO.
STAGE 2: S.N. 084-0020						55	(84-2) & (84-3) BF	RR	SANGAMON	98	27
_										CONTRACT	NO. 72	197
6	SHEETS	STA. 3	58+00.00	TO STA.	372+00.00			ILLINOIS	FED. AI	D PROJECT		

MAINTENANCE OR TRAFFIC GENERAL NOTES

BRIDGE REPAIRS

- 1. THE MAINTENANCE OF TRAFFIC PLANS SHALL SERVE AS A GUIDE FOR THE SAFE DIVERSION OF TRAFFIC DURING THE EXECUTION OF THIS CONTRACT. THE CONTRACTOR MAY MODIFY THE MAINTENANCE OF TRAFFIC PLANS TO MEET CONSTRUCTION NEEDS BUT NOT AT THE EXPENSE OF PUBLIC SAFETY OR CONVENIENCE. ANY CHANGES TO THE TRAFFIC CONTROL PLANS SHALL BE SUBMITTED TO THE ENGINEER FOR APPROVAL.
- 2. EXISTING PAVEMENT MARKINGS THAT CONFLICT WITH TEMPORARY MARKINGS SHALL BE REMOVED. THIS WORK WILL BE PAID FOR AT THE CONTRACT UNIT PRICE PER SOUARE FOOT FOR PAVEMENT MARKING REMOVAL.
- 3. EXISTING RAISED REFLECTIVE PAVEMENT MARKER REFLECTORS THAT CONFLICT WITH THE REVISED TRAFFIC PATTERN SHALL BE REMOVED FROM THE EXISTING CASTINGS LOCATED IN THE PAVEMENT. THIS WORK WILL BE PAID FOR AT THE CONTRACT UNIT PRICE EACH FOR RAISED REFLECTIVE PAVEMENT MARKER, REFLECTOR REMOVAL.
- 4. THE CONTRACTOR SHALL REMOVE ALL TEMPORARY PAVEMENT MARKINGS THAT CONFLICT WITH THE FOLLOWING STAGE OR THE FINAL PAVEMENT MARKING. THIS WORK WILL BE PAID FOR AT THE CONTRACT UNIT PRICE PER FOOT FOR PAVEMENT MARKING REMOVAL.
- ALL TRAFFIC CONTROL DEVICES SHALL BE REFLECTORIZED PRIOR TO INSTALLATION AND CLEANED AS SPECIFIED IN THE TRAFFIC CONTROL SPECIAL PROVISIONS OR AS DIRECTED BY THE ENGINEER.
- 6. ALL DRUMS, VERTICAL PANELS, AND BARRICADES ADJACENT TO THE EDGE OF THE TRAVELED WAY SHALL BE EQUIPPED WITH MONO-DIRECTIONAL STEADY BURNING LIGHTS.
- 7. EXISTING SIGNS WITHIN THE LIMITS OF TRAFFIC CONTROL WICH ARE OBSTRUCTED BY OR OTHERWISE INTERFERED WITH BY CONSTRUCTION OPERATIONS OF DESIGNATED TRAFFIC CONTROL, SHALL BE COVERED OR REMOVED BY THE CONTRACTOR UNLESS SPECIFIED IN THE PLANS OR WHEN DIRECTED BY THE ENGINEER. THIS WORK SHALL BE AS SPECIFIED IN ARTICLE 107.25 OF THE STANDARD SPECIFICATIONS.
- 8. CHANGEABLE MESSAGE SIGNS SHALL BE INSTALLED AS SPECIFIED IN THE SPECIAL PROVISIONS PRIOR TO THE START OF CONSTRUCTION.
- 9. SEE STRUCTURAL PLANS FOR ADDITIONAL BRIDGE STAGING INFORMATION.
- 10. THE CONTRACTOR SHALL CONTACT THE DISTRICT 6 TRAFFIC CONTROL SECTION OF THE BUREAU OF OPERATIONS AT (217) 785-5312 AT LEAST 21 DAYS PRIOR TO IMPLEMENTING ANY LANE CLOSURES, 48 HOURS PRIOR TO A SWITCH IN TRAFFIC STAGING, AND ONE WEEK PRIOR TO CLOSING A RAMP.

SUGGESTED SEQUENCE OF OPERATIONS

STAGE 2

LANES.

FINAL PHASE

<u>PRE-STAGE 1</u>

- 1. CLOSE EB OUTSIDE LANE WITH STANDARDS 701422 AND 701411.
- 2. REMOVE PAVED SHOULDERS AND CONSTRUCT HMA BASE COURSE 10" 2. WIT
- 3. CLOSE WB OUTSIDE LANE WITH STANDARDS 701400, 701401, AND 701411.
- 4. REMOVE PAVED SHOULDERS AND CONSTRUCT HMA BASE COURSE 10"

STAGE 1

- INSTALL TRAFFIC CONTROL DEVICES AS SHOWN ON THE PLAN SHEETS "MAINTENANCE OF TRAFFIC STAGE 1" AND SHIFT TRAFFIC TO THE OUTSIDE LANES.
- 2. RECONSTRUCT EXPANSION JOINTS.
- 3. SCARIFY DECK AND CONSTRUCT FULL DEPTH PATCHES.
- 4. CONSTRUCT MICROSILICA CONCRETE OVERLAY
- 5. ADJUST SHOULDER INLETS
- 6. MILL BUTT JOINTS AND RESURFACE PAVEMENT AND SHOULDERS.
- 7. CONSTRUCT AGGREGATE WEDGE SHOULDERS.
- INSTALL PROPOSED GUARDRAIL, TRAFFIC BARRIER TERMINALS, TERMINAL MARKERS, AND GUARDRAIL MARKERS.
- 9. CONSTRUCT DIAMOND GRINDING (BRIDGE SECTION) AND BRIDGE DECK GROOVING.



Cummins	JOB = 2304.7	DESIGNED - NAK	REVISED -		S N 084-00	050, 084–0051, & 084–0103 MAINTENANCE OR TRAFFIC	F.A.I. SECTION	COUNTY TOTAL SHEET
	FILE NAME = d672H44-sht-prestagel.dgn	DRAWN - SJS	REVISED -	STATE OF ILLINOIS		NOTES AND SUGGESTED SEQUENCE OF OPERATIONS	55 (84-2) & (84-3) BRR	SANGAMON 98 28
Corporation	PLOT SCALE = 100.0000 ' / in.	CHECKED - NAK	REVISED -	DEPARTMENT OF TRANSPORTATION	GENERAL	NUTES AND SUGGESTED SEQUENCE OF OPERATIONS		CONTRACT NO. 72J97
uctural Engineering	PLOT DATE = 12/11/2018	DATE - 6/21/2016	REVISED -		SCALE:	SHEET NO. OF SHEETS STA. TO STA.	FED. ROAD DIST. NO. ILLINOIS FED. A	NID PROJECT

1. INSTALL DETOUR SIGNING AND CLOSE THE FOUR LOOP RAMPS.

2. WITH THE FOUR LOOP RAMPS CLOSED, INSTALL TRAFFIC CONTROL DEVICES AND TEMPORARY PAVEMENT MARKINGS AS SHOWN ON THE PLANS SHEETS "MAINTENANCE OF TRAFFIC STAGE 2", AND SHIFT TRAFFIC TO THE MEDIAN

3. RECONSTRUCT EXPANSION JOINTS.

4. SCARIFY DECK AND CONSTRUCT FULL DEPTH PATCHES.

5. CONSTRUCT MICROSILICA CONCRETE OVERLAY

6. ADJUST SHOULDER INLETS

7. MILL BUTT JOINTS AND RESURFACE PAVEMENT AND SHOULDERS.


8. CONSTRUCT AGGREGATE WEDGE SHOULDERS.

9. INSTALL PROPOSED GUARDRAIL, TRAFFIC BARRIER TERMINALS, TERMINAL MARKERS, AND GUARDRAIL MARKERS.


10. CONSTRUCT DIAMOND GRINDING (BRIDGE SECTION) AND BRIDGE DECK GROOVING

1. PLACE TRAFFIC IN THE PERMANENT LANES AND OPEN LOOP RAMPS

2. INSTALL PAVEMENT MARKINGS AND REPLACE REFLECTORS IN RAISED REFLECTIVE PAVEMENT MARKERS.

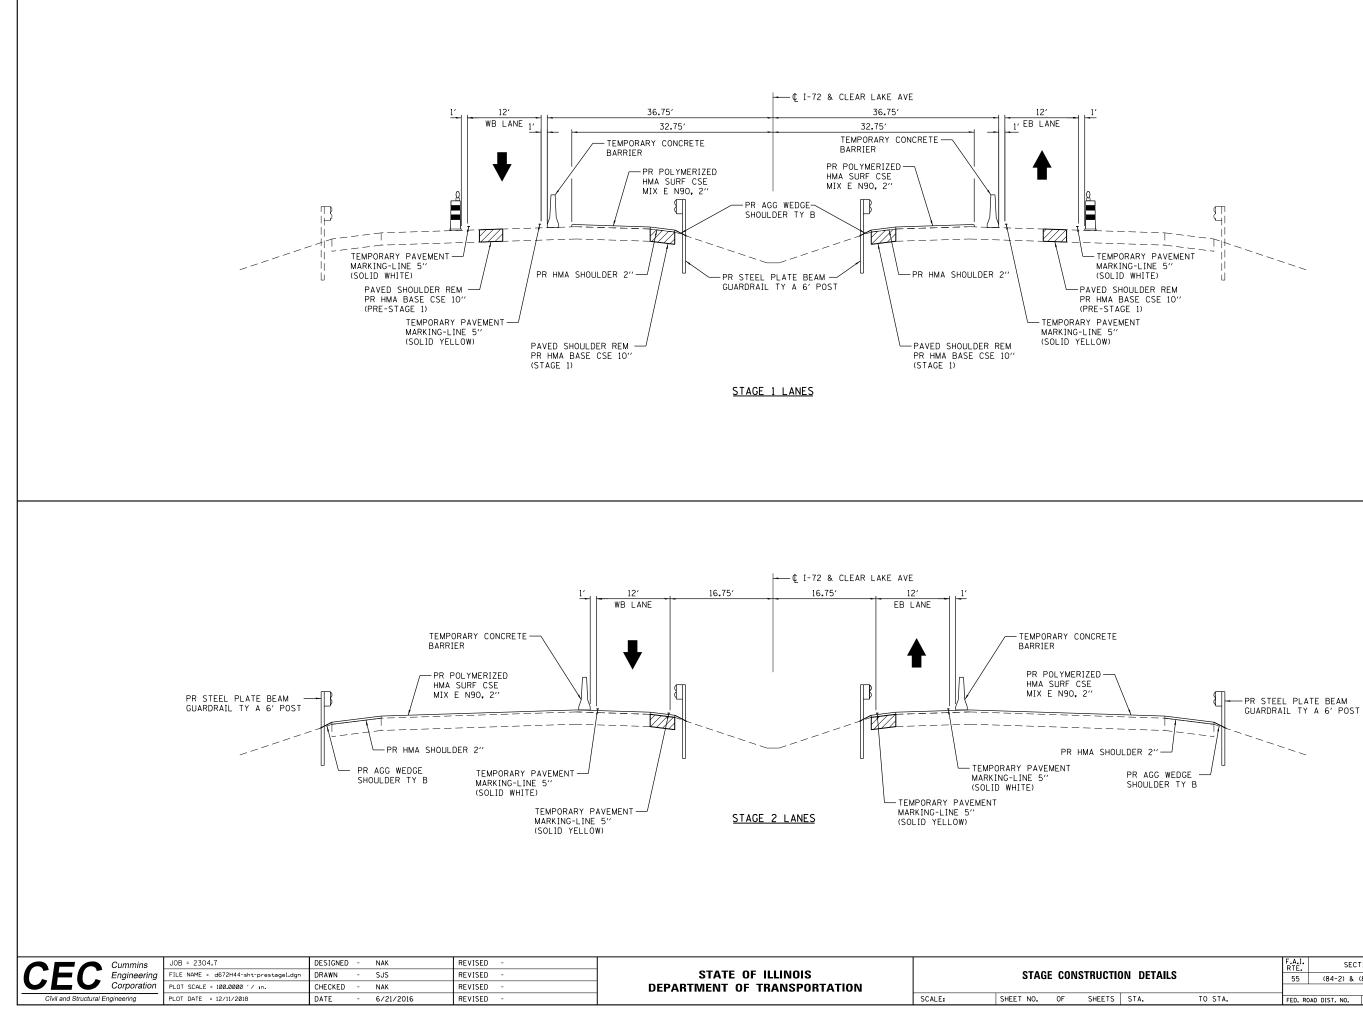


			F.A. RTE		SE	сті	ON		COUNTY	TOTAL SHEETS	SHEET NO.
IC	ON DETAILS		55	((84-2) & (84-3) BRR				SANGAMON	98	29
_								CONTRACT	NO. 7	'2J97	
	STA.	TO STA.	FED.	ROAD D	IST. NO.	I	LLINOIS	FED. AI	PROJECT		

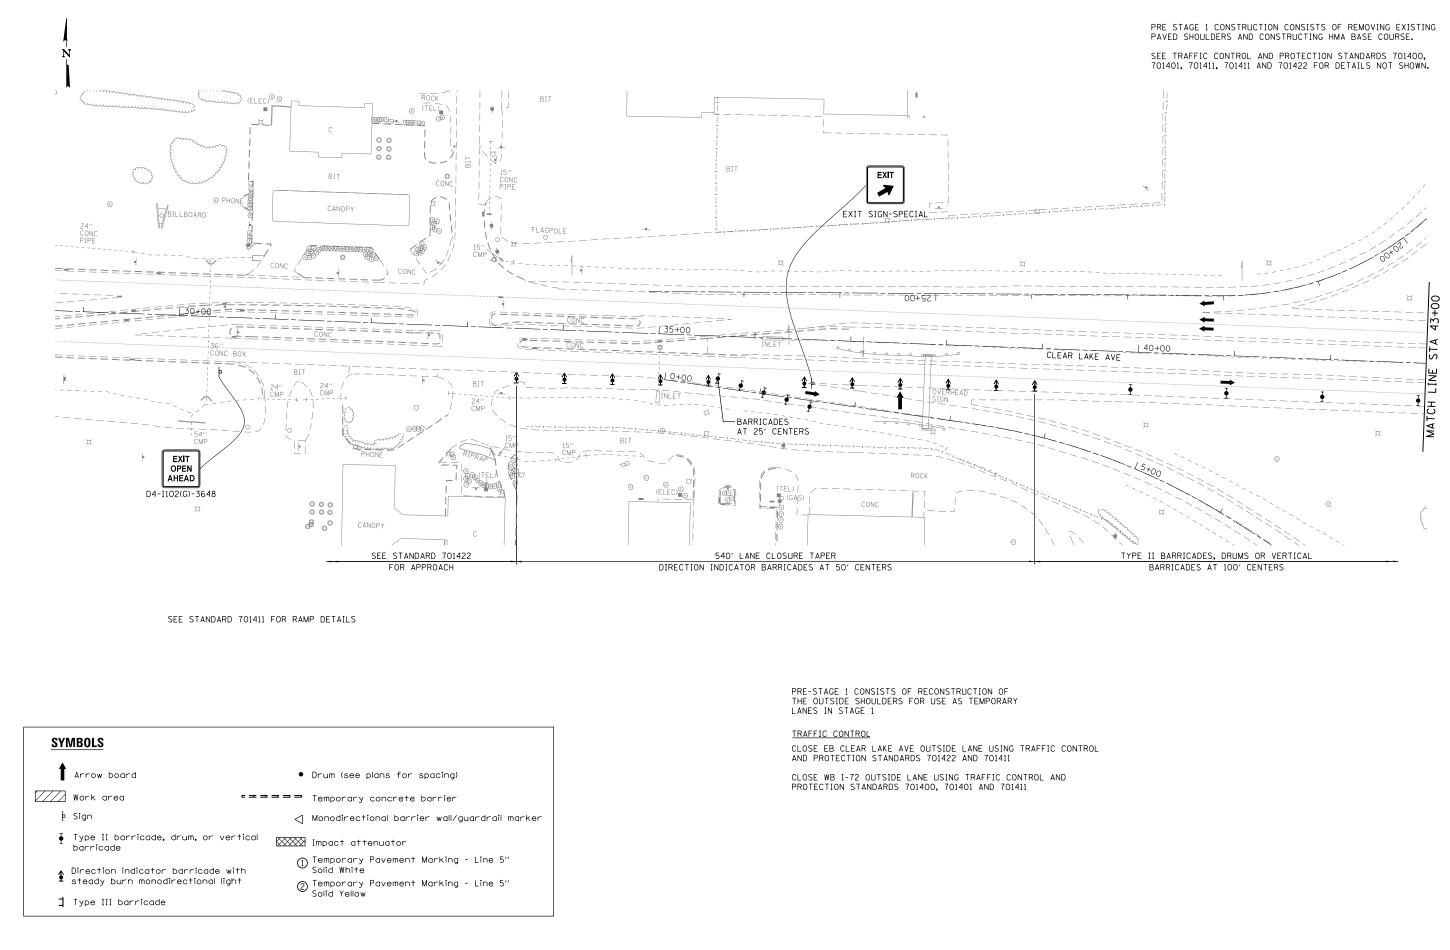

	Cummins	JOB = 2304.7	DESIGNED -	NAK	REVISED -				
3– (Engineering	FILE NAME = d672H44-sht-prestagel.dgn	DRAWN -	SJS	REVISED -	STATE OF ILLINOIS	1	PRE – STAGE 1 MAIN	NTEN/
	Corporation	PLOT SCALE = 100.0000 ' / in.	CHECKED -	NAK	REVISED -	DEPARTMENT OF TRANSPORTATION			
Civil and Structur	ral Engineering	PLOT DATE = 12/13/2018	DATE -	6/21/2016	REVISED -		SCALE:	SHEET NO. OF SHE	HEETS

			F.A.I RTE	• SEC	TION	COUNTY	TOTAL SHEETS	SHEET NO.
IANCE OF TRAFFIC				(84-2) &	(84-3) BRR	SANGAMON	98	30
						CONTRACT	NO. 7	72J97
	STA.	TO STA.	FED.	ROAD DIST. NO.	ILLINOIS FED.	AID PROJECT		

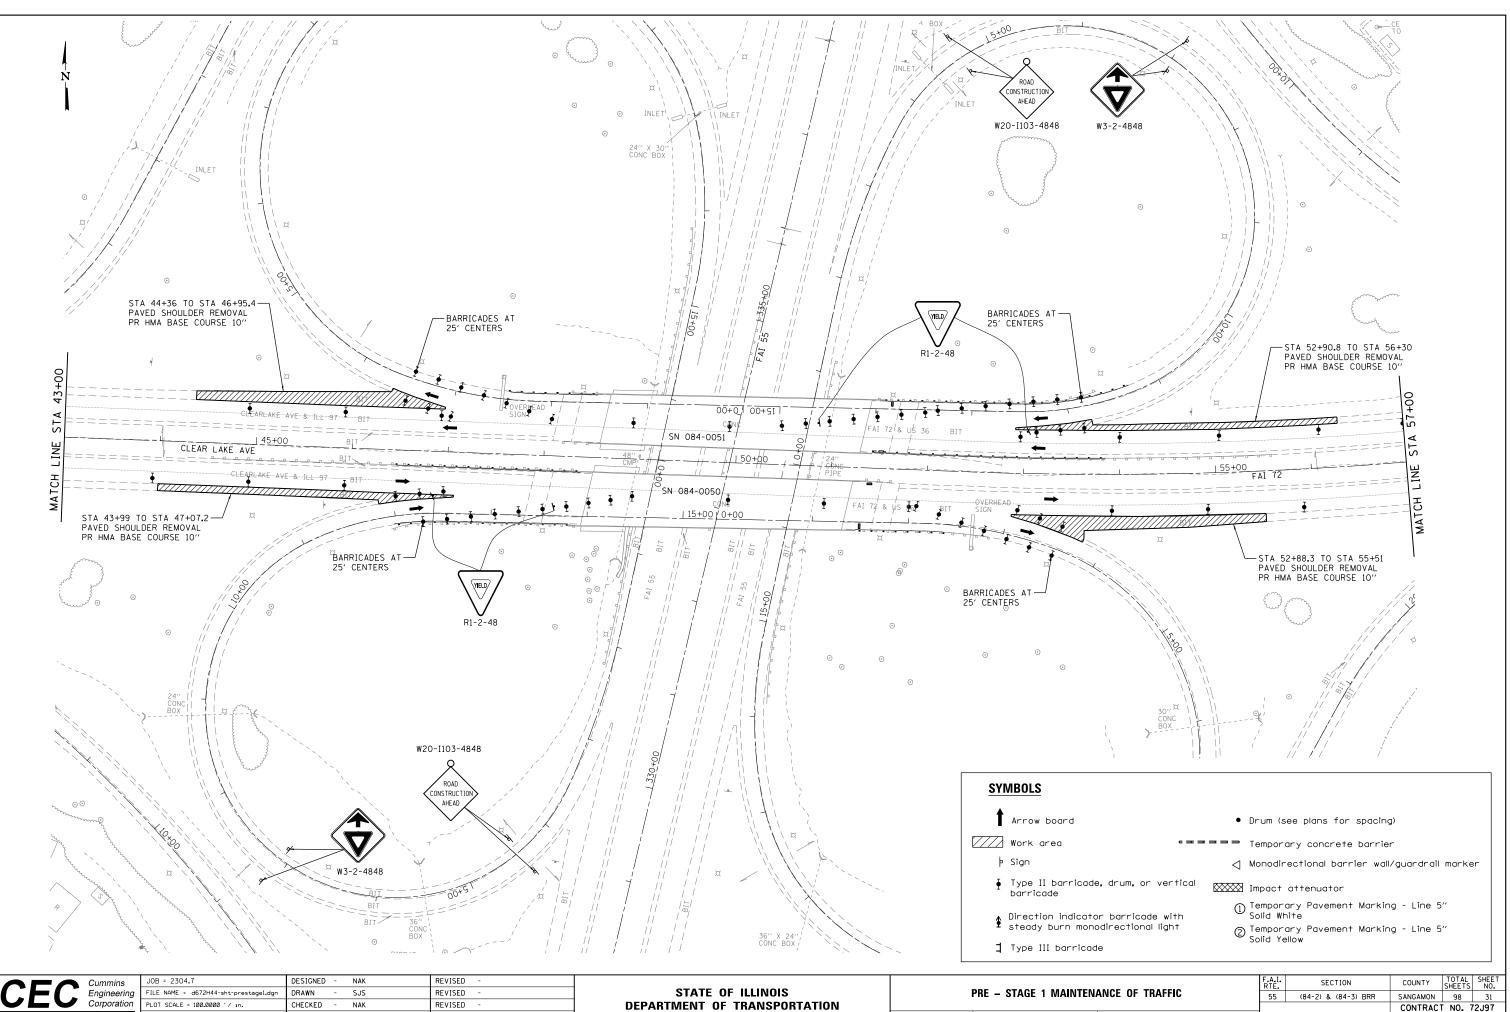

Civil and Structural Engineering

PLOT DATE = 12/13/2018


6/21/2016

DATE

REVISED

SCALE:

						F.A.I. RTE	SEC	TION		COUNTY	TOTAL SHEETS	SHEET NO.
PKE –	RE – STAGE 1 MAINTENANCE OF TRAFFIC						(84-2) &	(84-3) B	RR	SANGAMON	98	31
										CONTRAC	T NO. 7	72J97
SHEET	N0.	OF	SHEETS	STA.	TO STA.	FED. RC	AD DIST. NO.	ILLINOIS	FED. AI	D PROJECT		

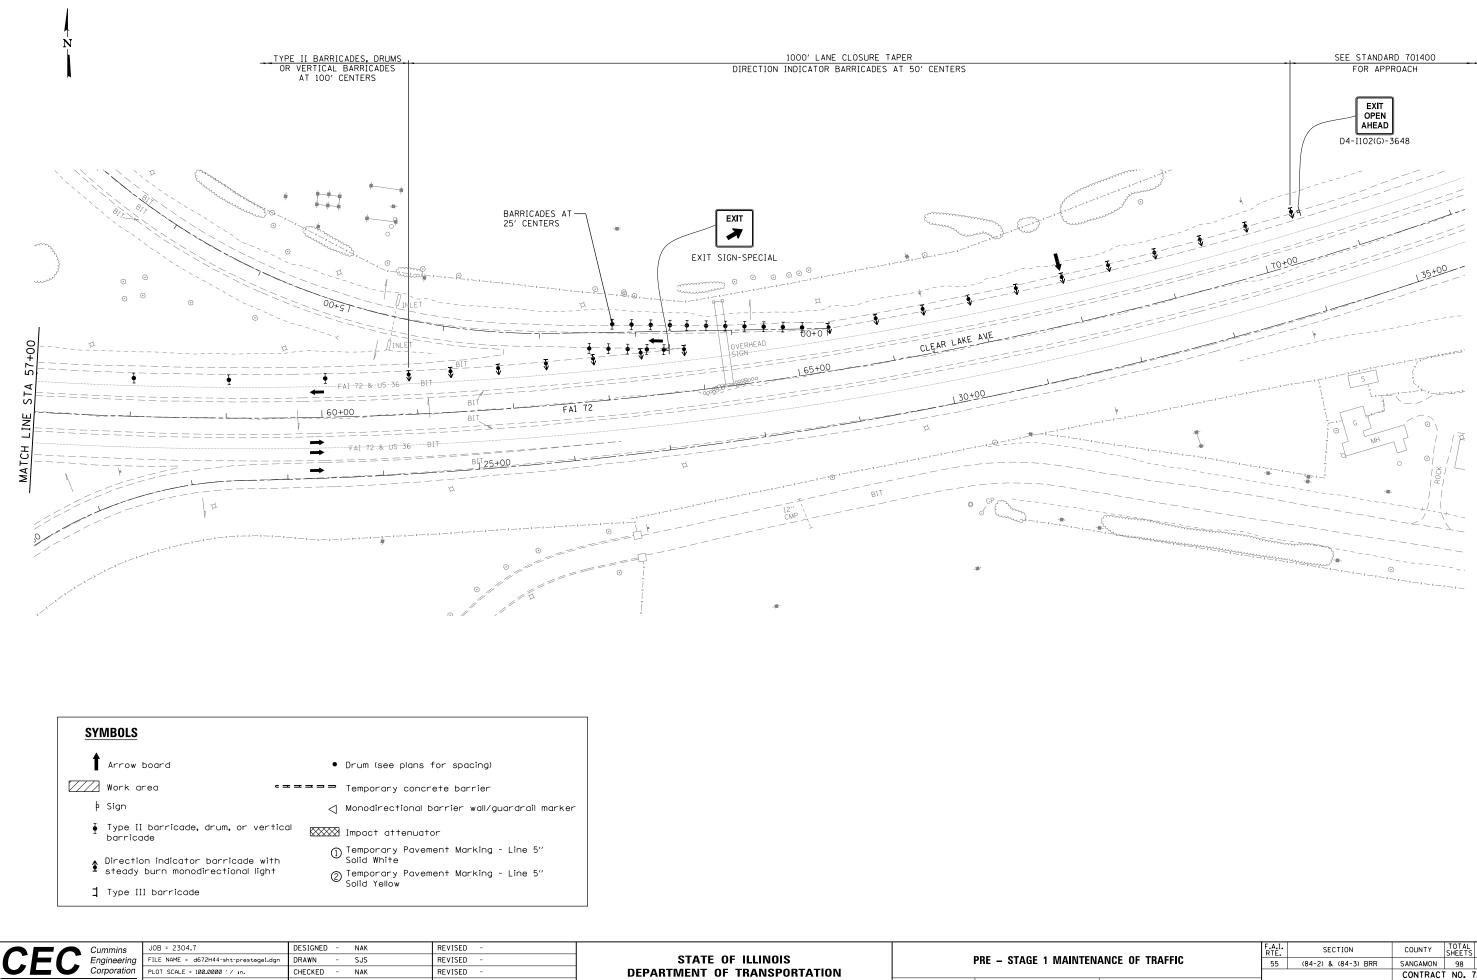

PLOT DATE = 12/13/2018


Civil and Structural Engineering


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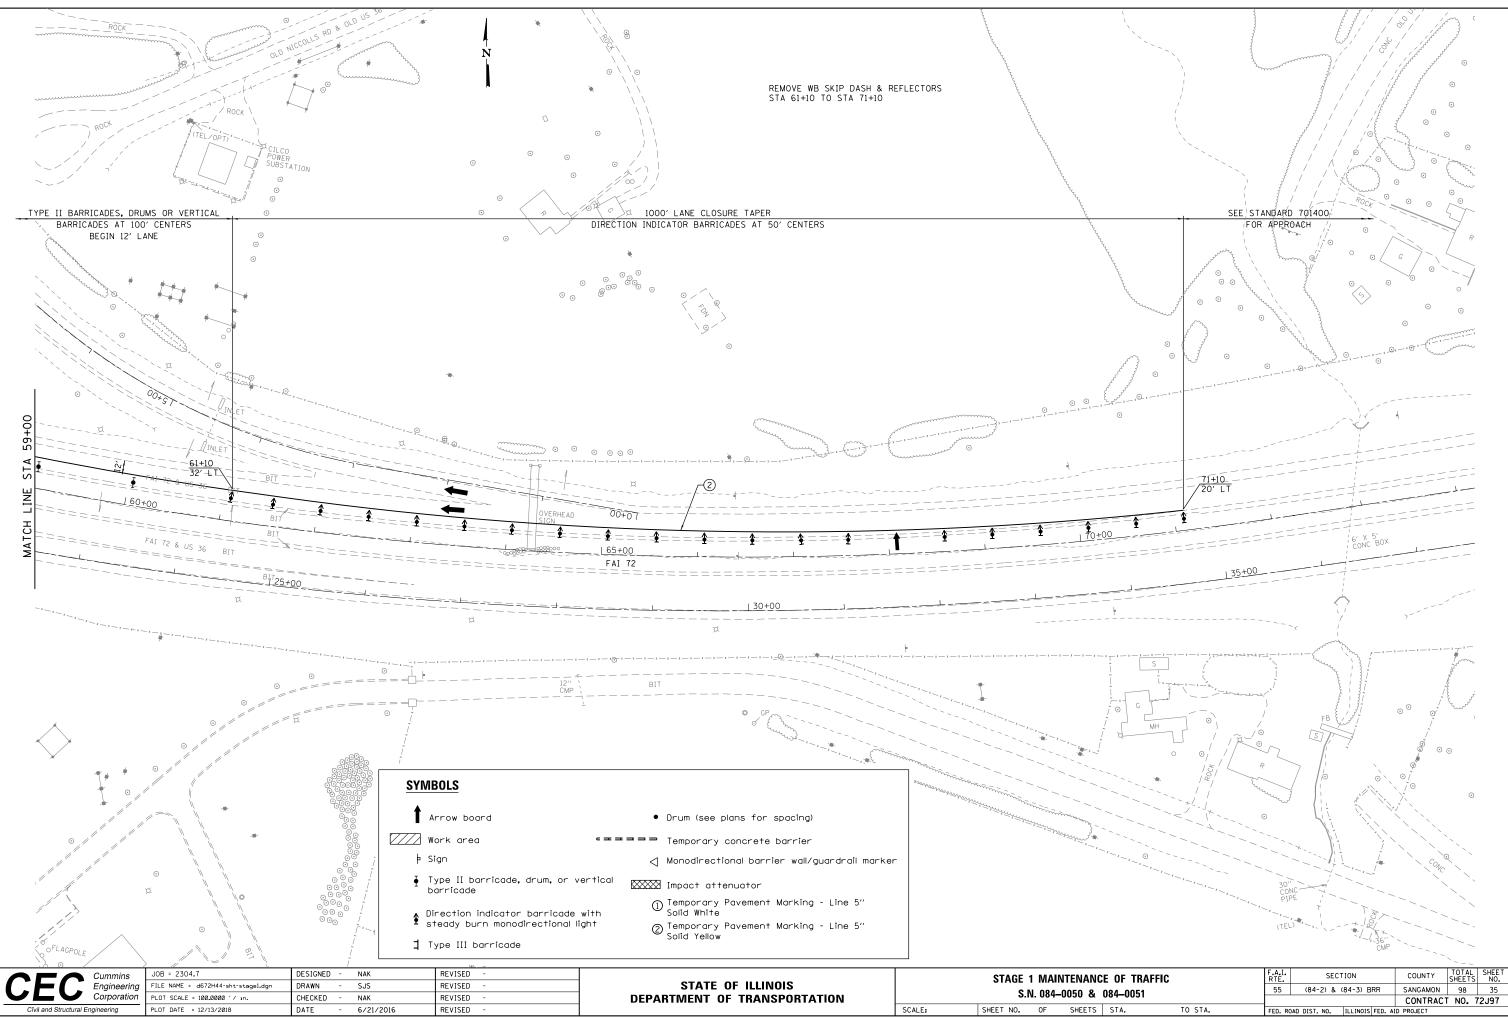
- 6/21/2016

REVISED


			F.A.I. RTE	SECT	ION		COUNTY	TOTAL SHEETS	SHEET NO.
IANCE OF TRAFFIC		55	(84-2) &	(84-3) BRF	۲	SANGAMON	98	32	
_							CONTRACT	NO. 7	72J97
	STA.	TO STA.	FED. F	OAD DIST. NO.	ILLINOIS FE	ED. AIC	PROJECT		




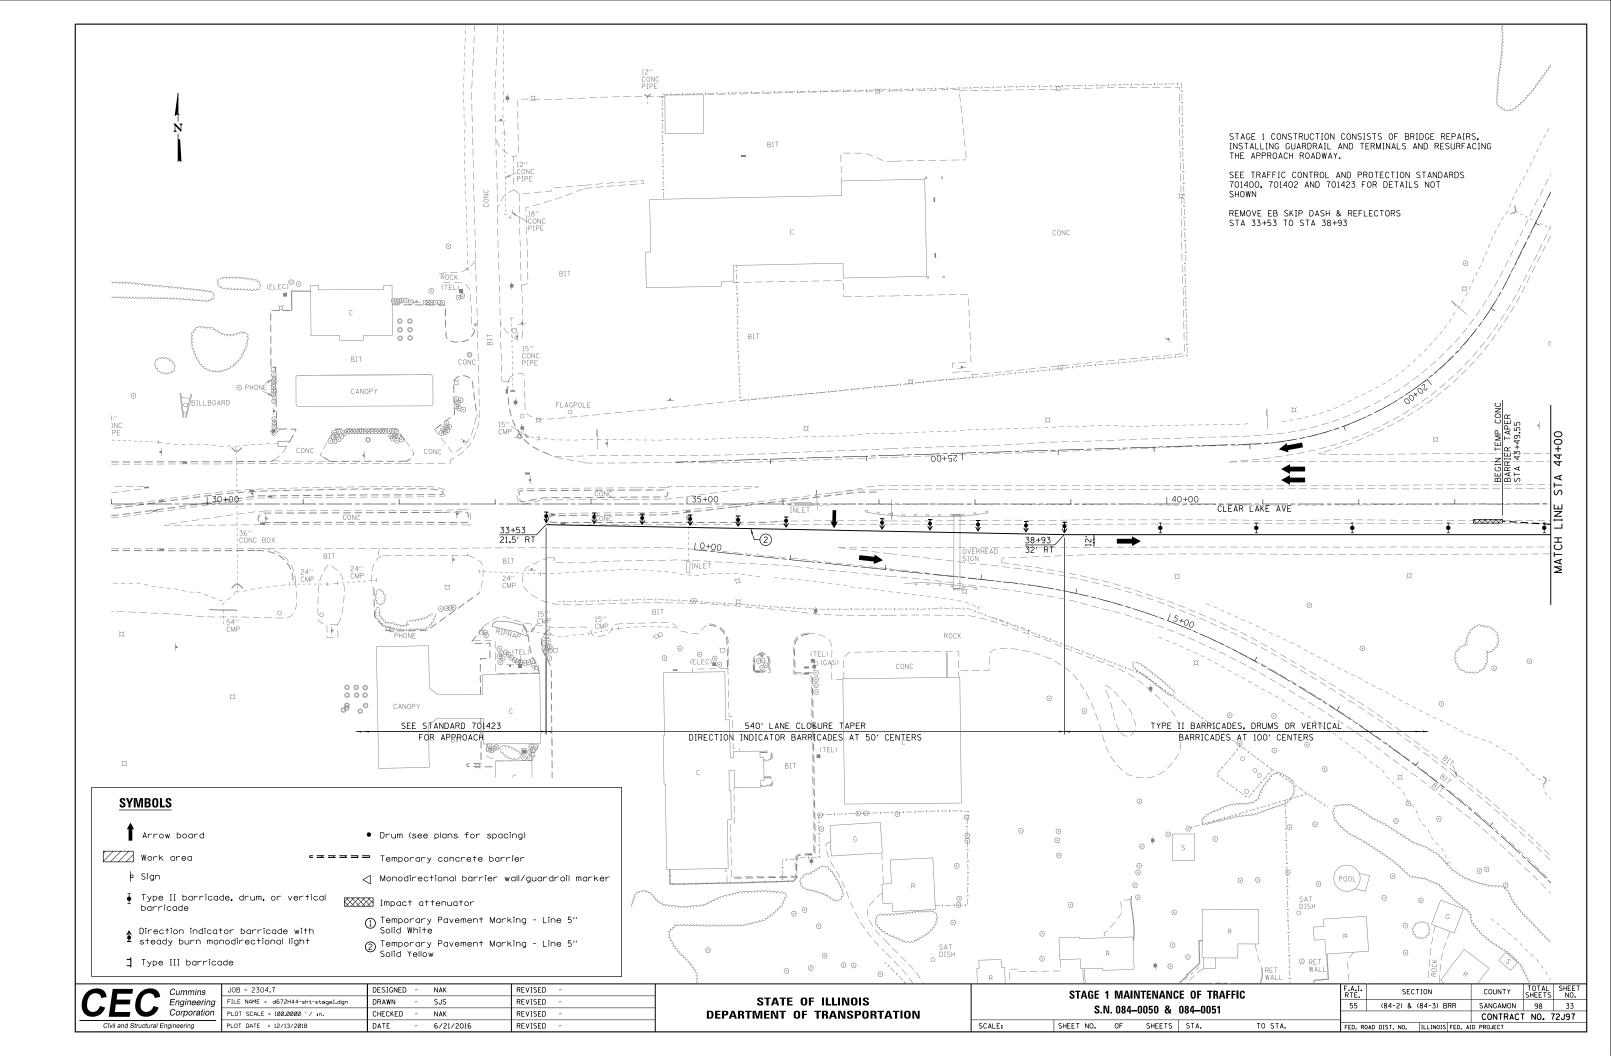


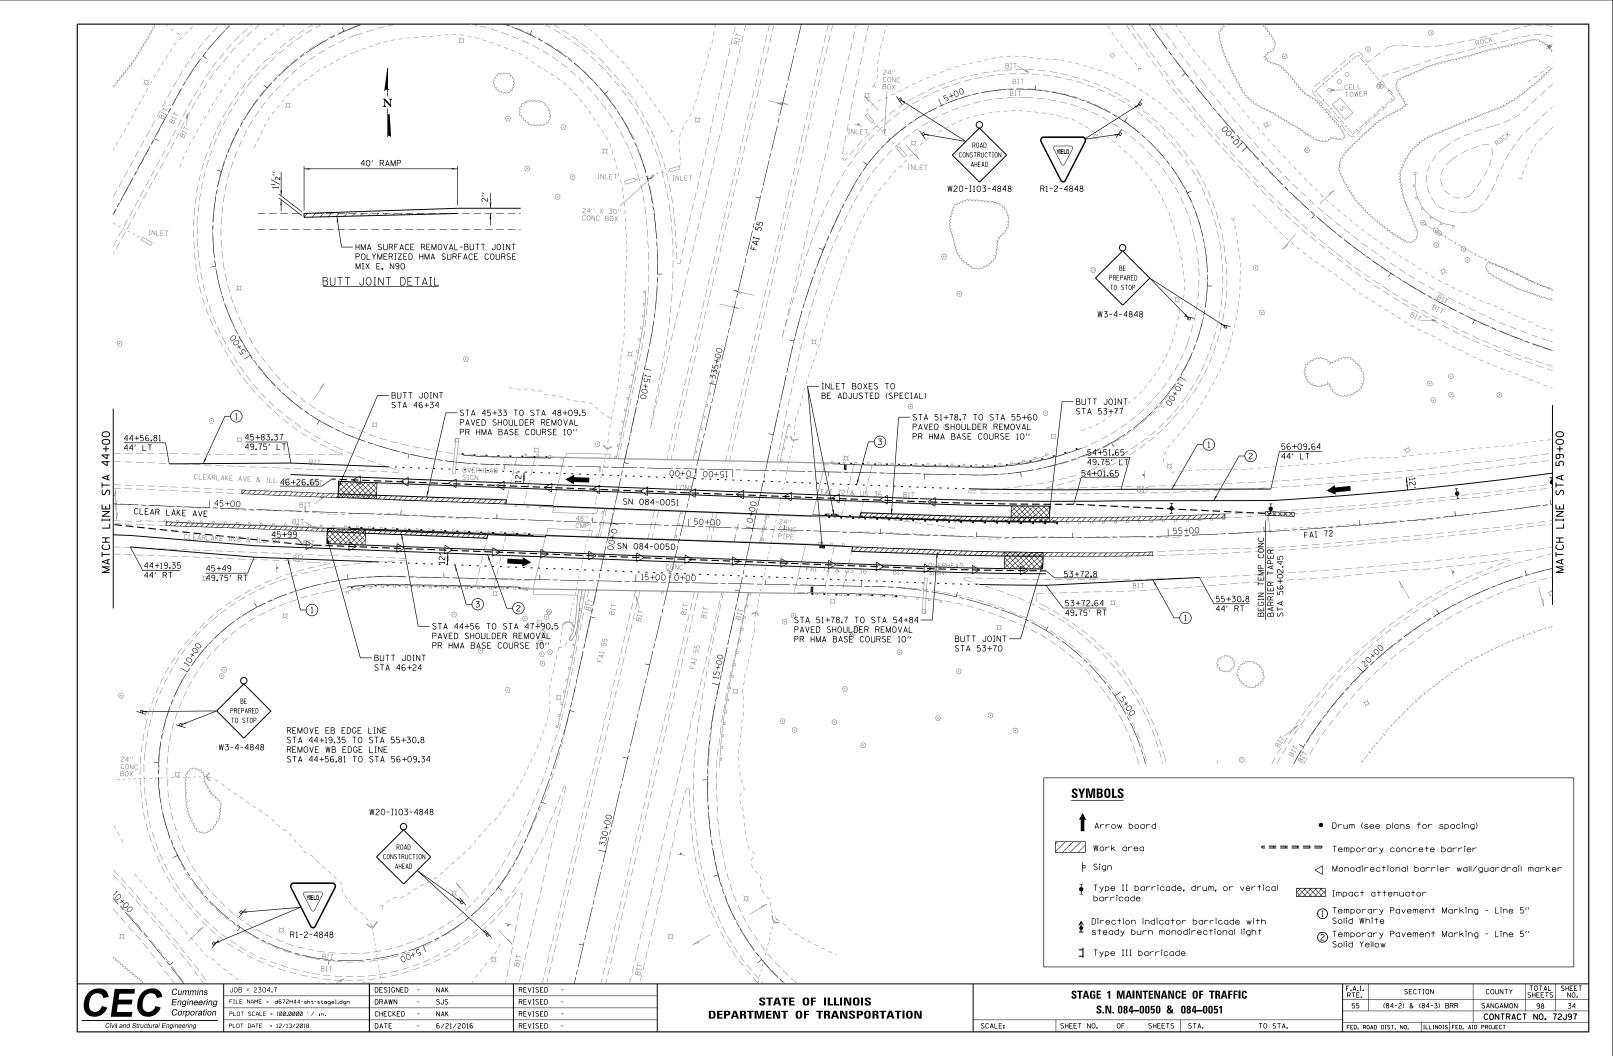


E OF TRAFFIC	F.A. RTE	I.		SEC	сті	ON			COUNTY	TOTAL SHEETS	SHEET NO.
084-0051	55		(84-	2) &	(8	84-3) B	RR		SANGAMON	98	35
00+-0031									CONTRAC	T NO. 7	72J97
STA. TO STA.	FED.	ROAD	DIST.	NO.	I	ILLINOIS	FED.	AID	PROJECT		

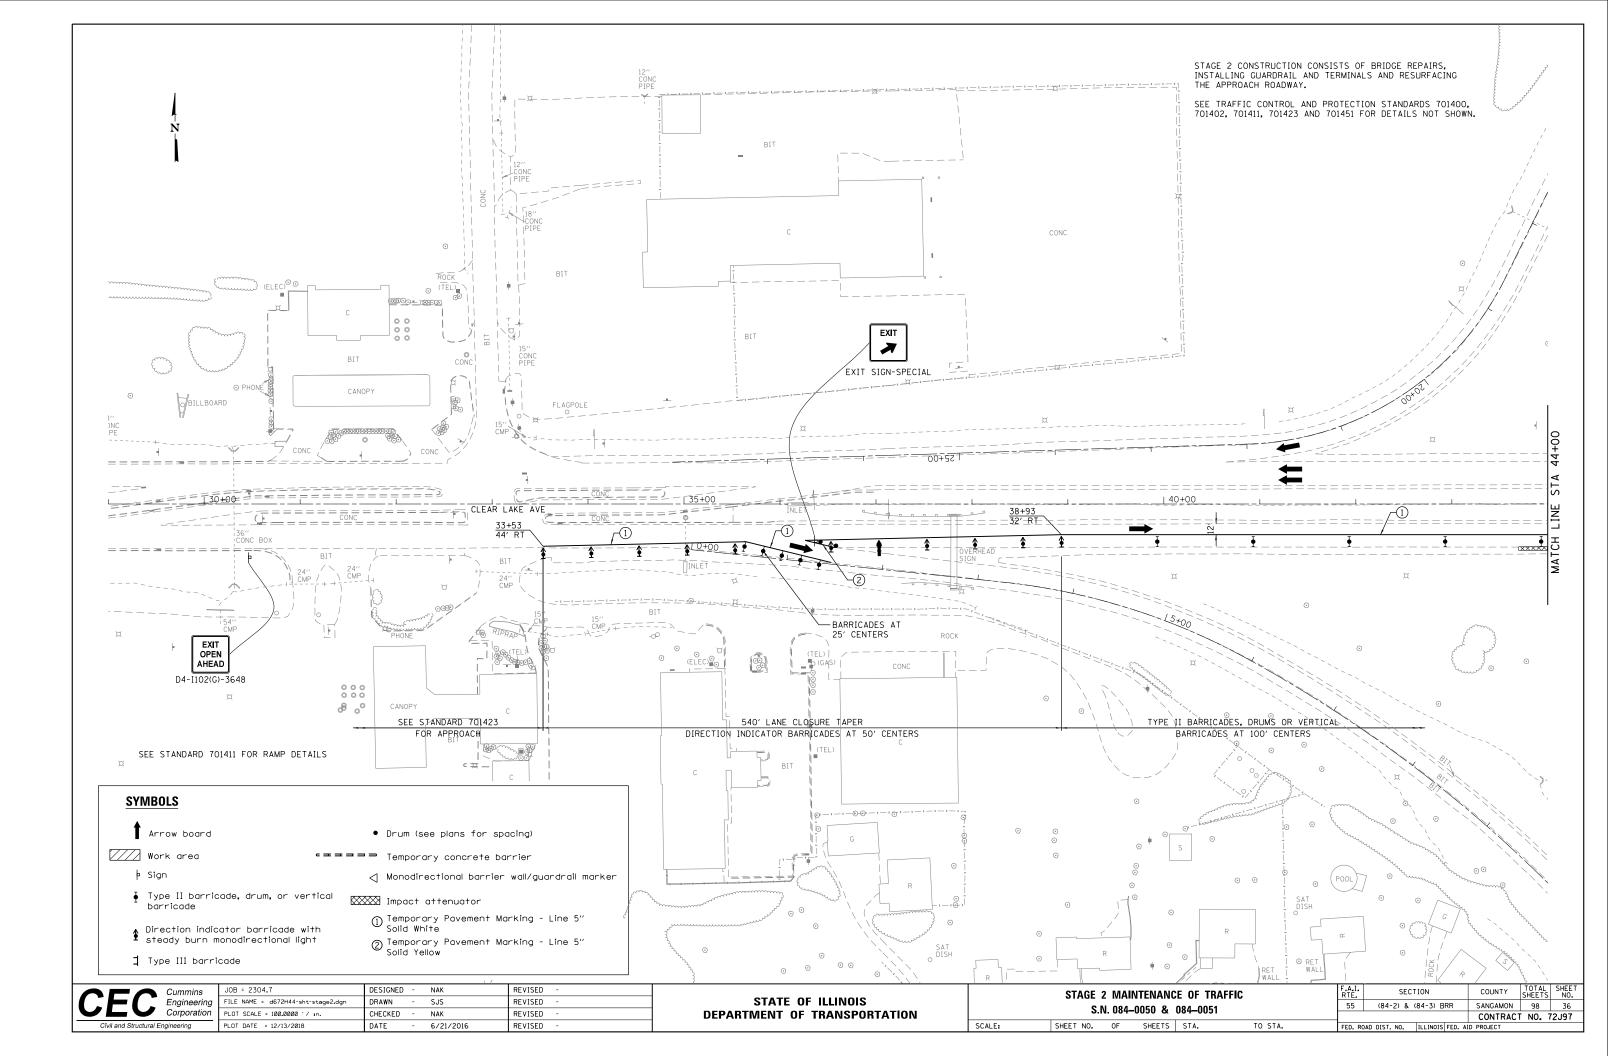


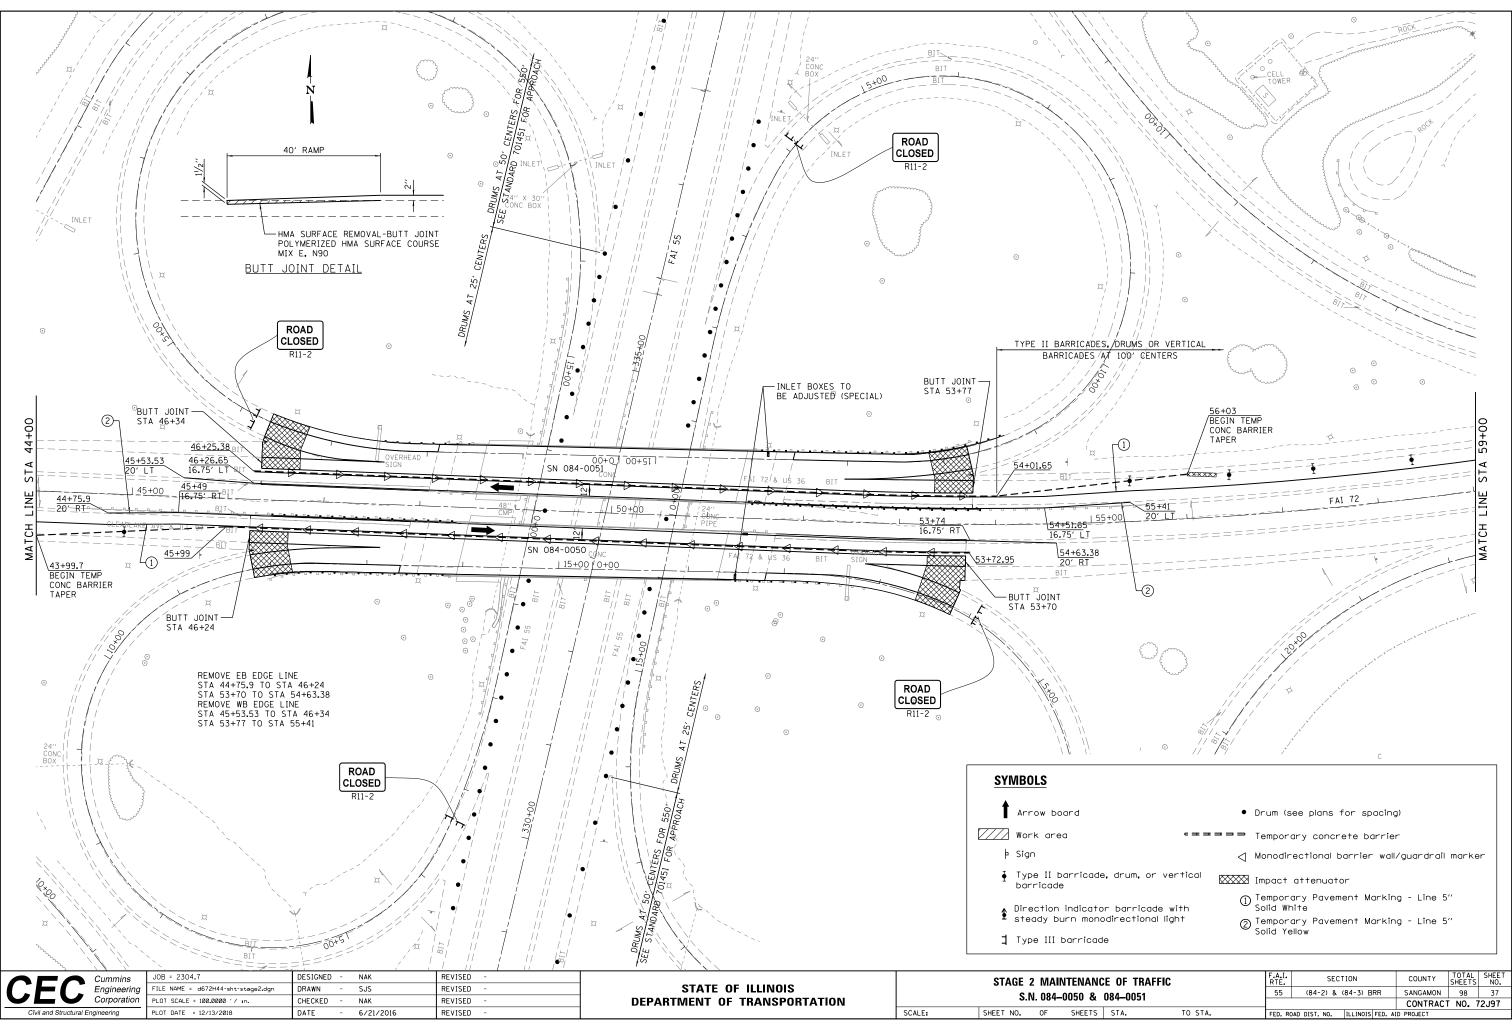

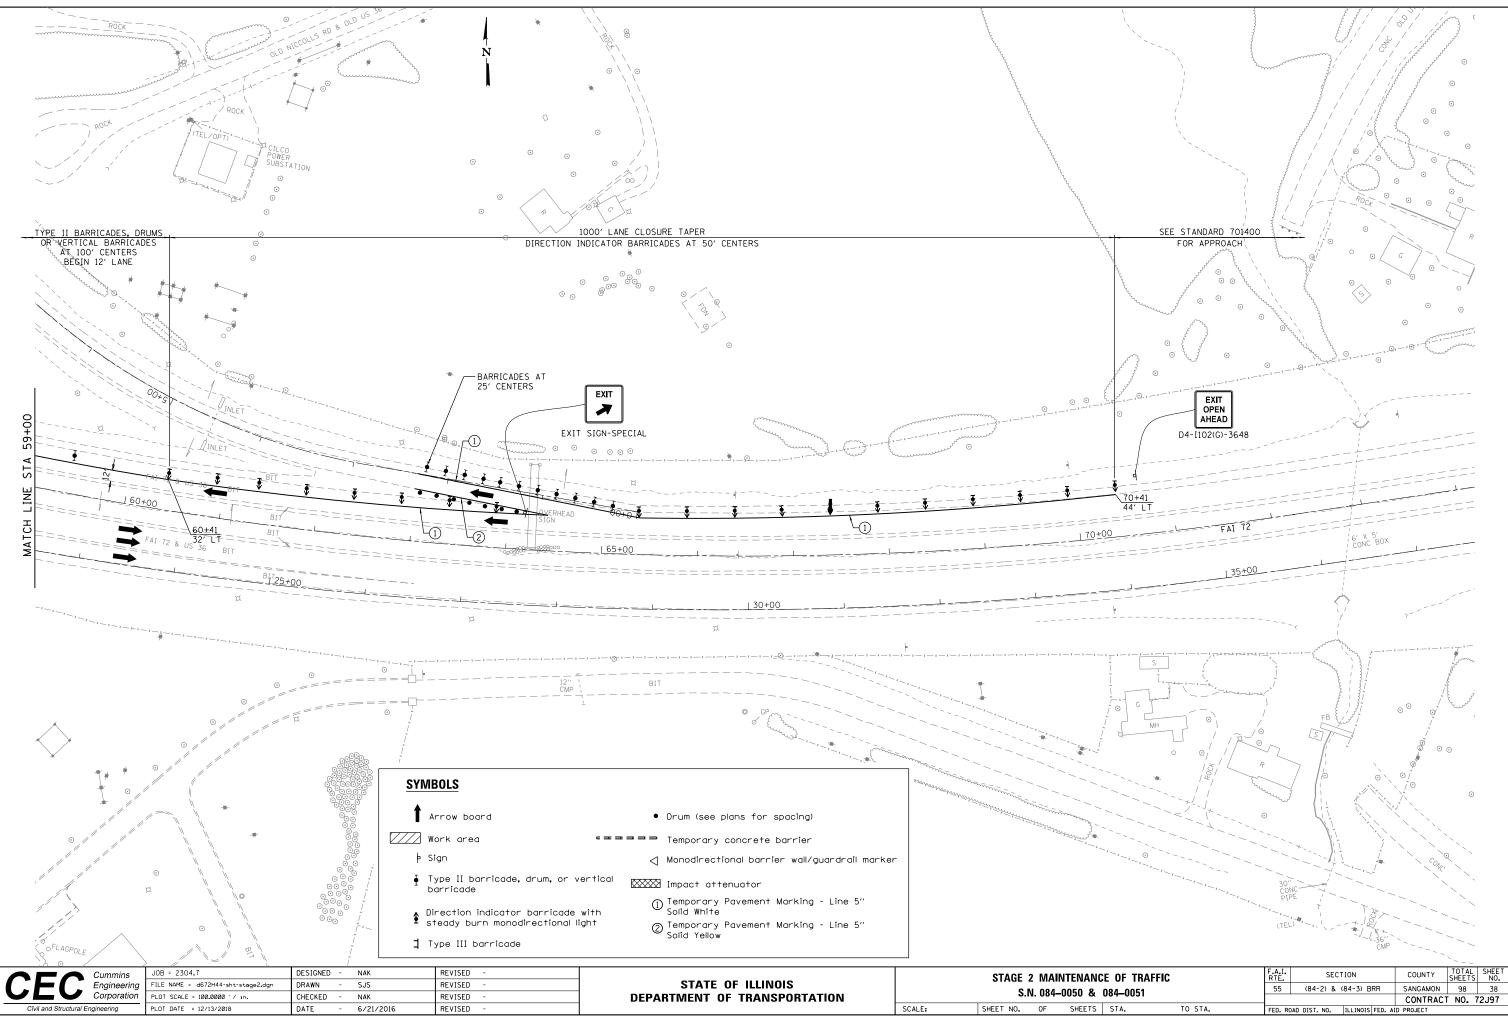



CE OF TRAFFIC			F.A. RTE		SECTION				COUNTY	TOTAL SHEETS	SHEET NO.
084-0051		55		(84-2) & (84-3) BRR				SANGAMON	98	38	
	004-0031		_						CONTRACT NO. 72J97		
	STA.	TO STA.	FED.	ROAD	DIST.	NO.	ILLINOI	S FED. AI	D PROJECT		

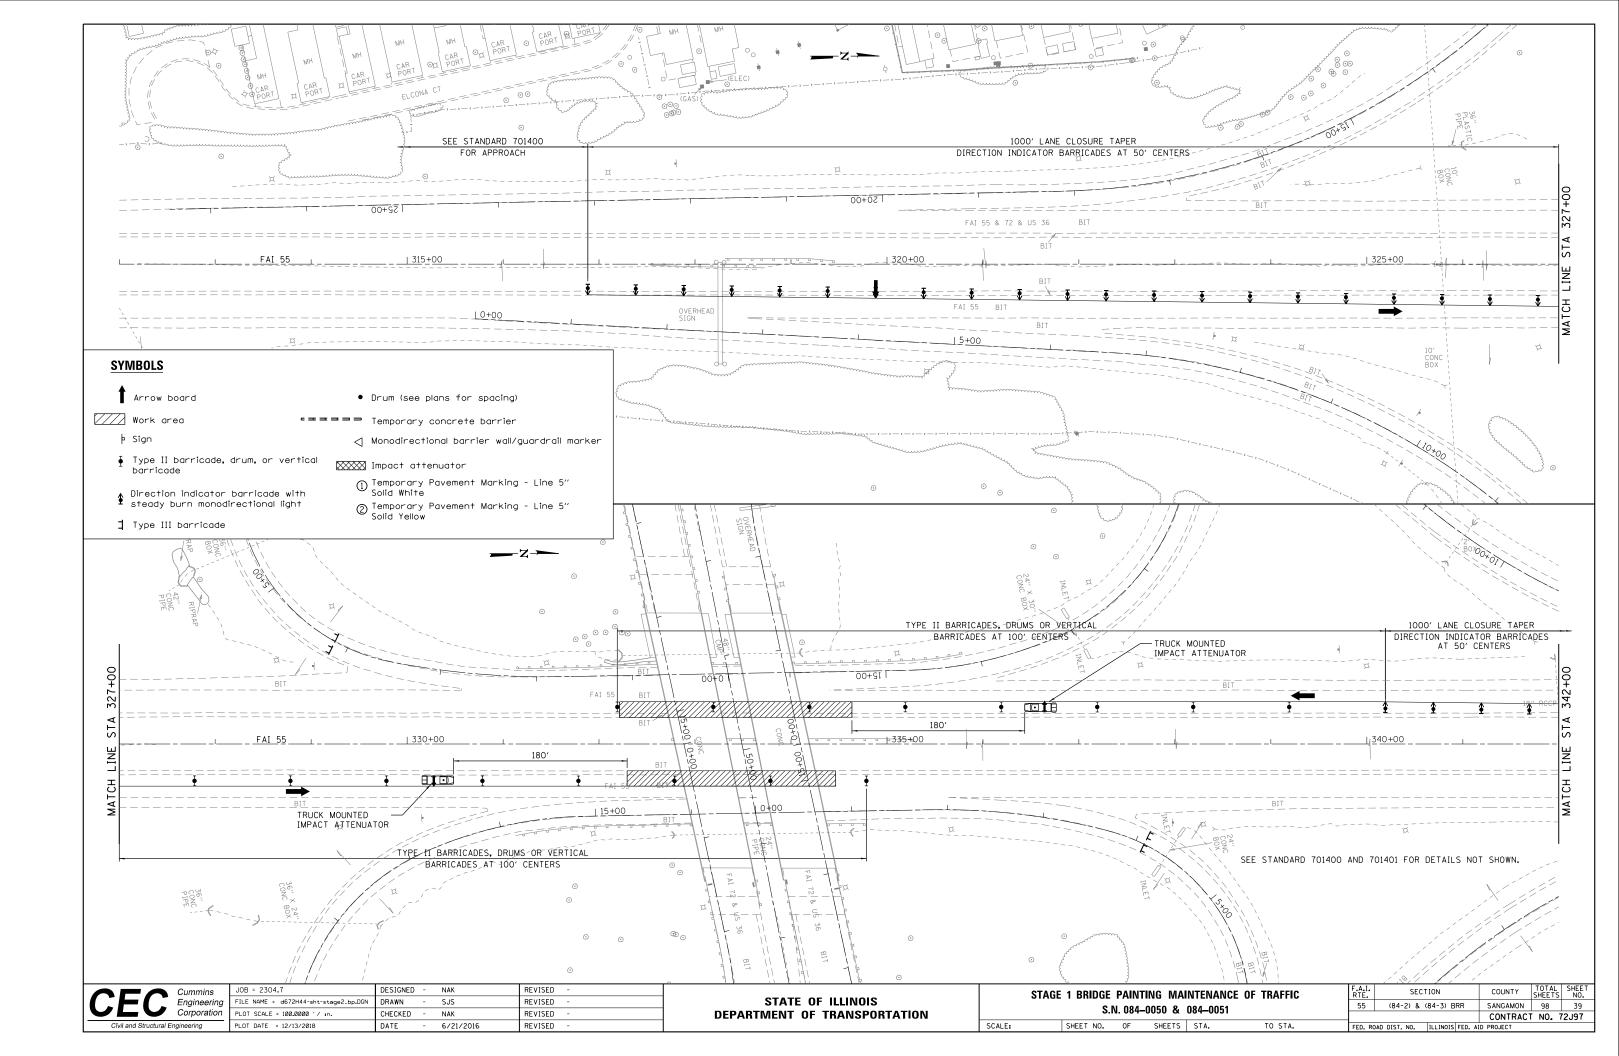

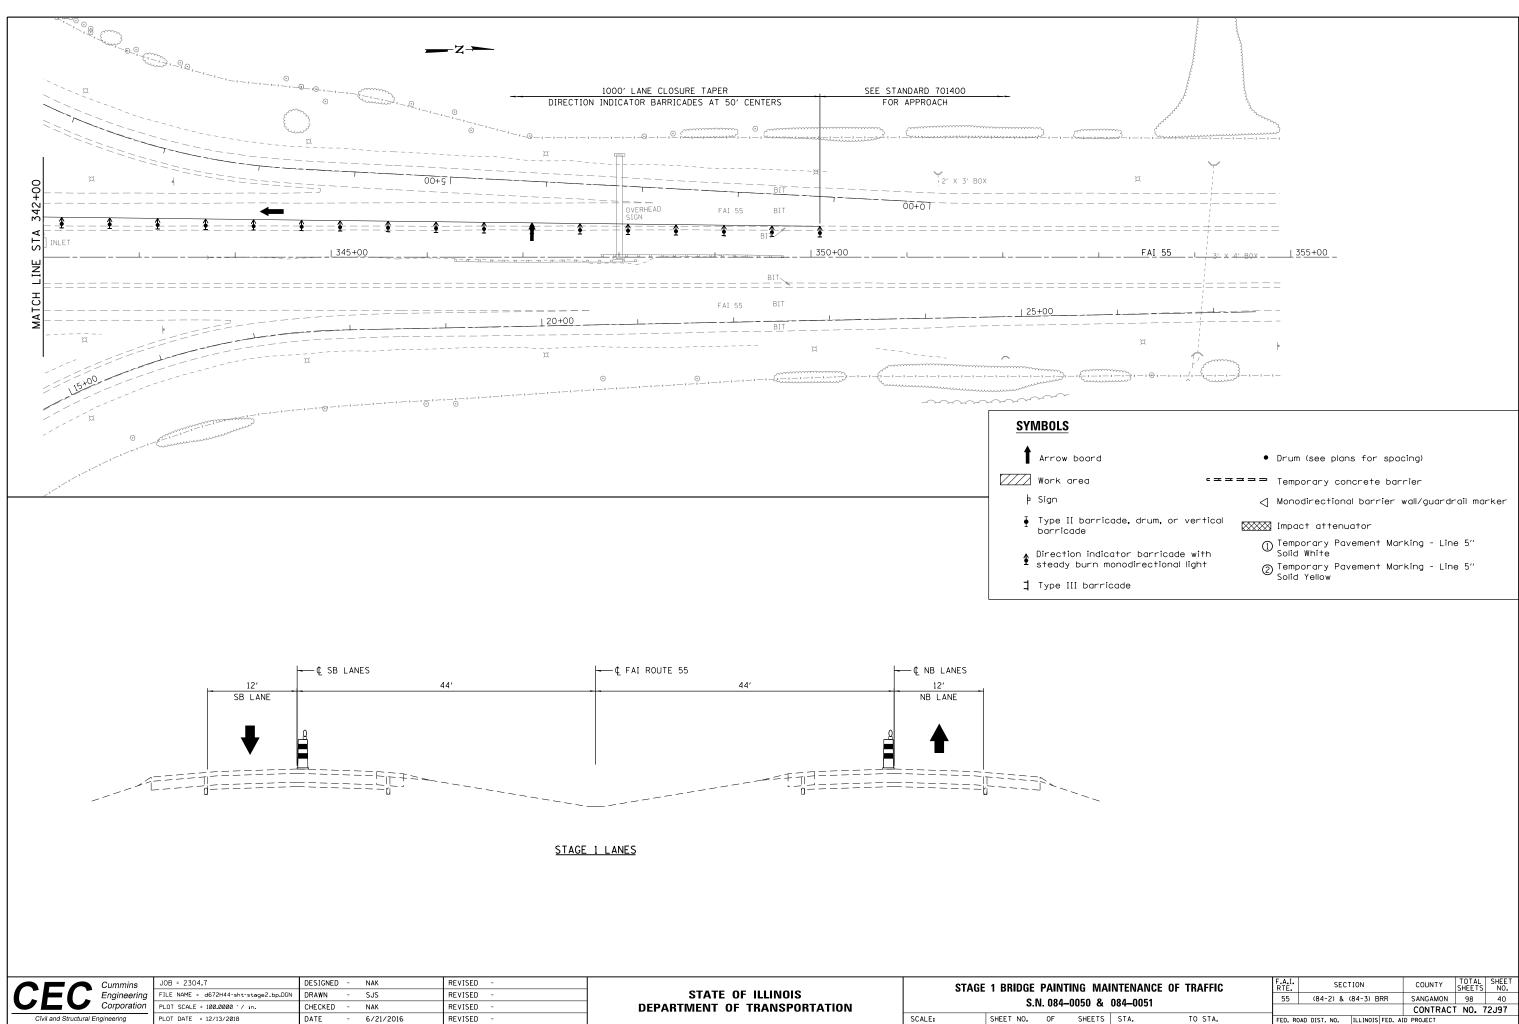


I	INTENANCE OF TRAFFIC 084-0051			SEC	LION	COUNTY	TOTAL SHEETS	SHEET NO.
				(84-2) &	(84-3) BRR	SANGAMON 98 40		
	004-0031					CONTRACT	NO. 7	72J97
	STA.	TO STA.	FED. RO	DAD DIST. NO.	ILLINOIS FED. AI	D PROJECT		

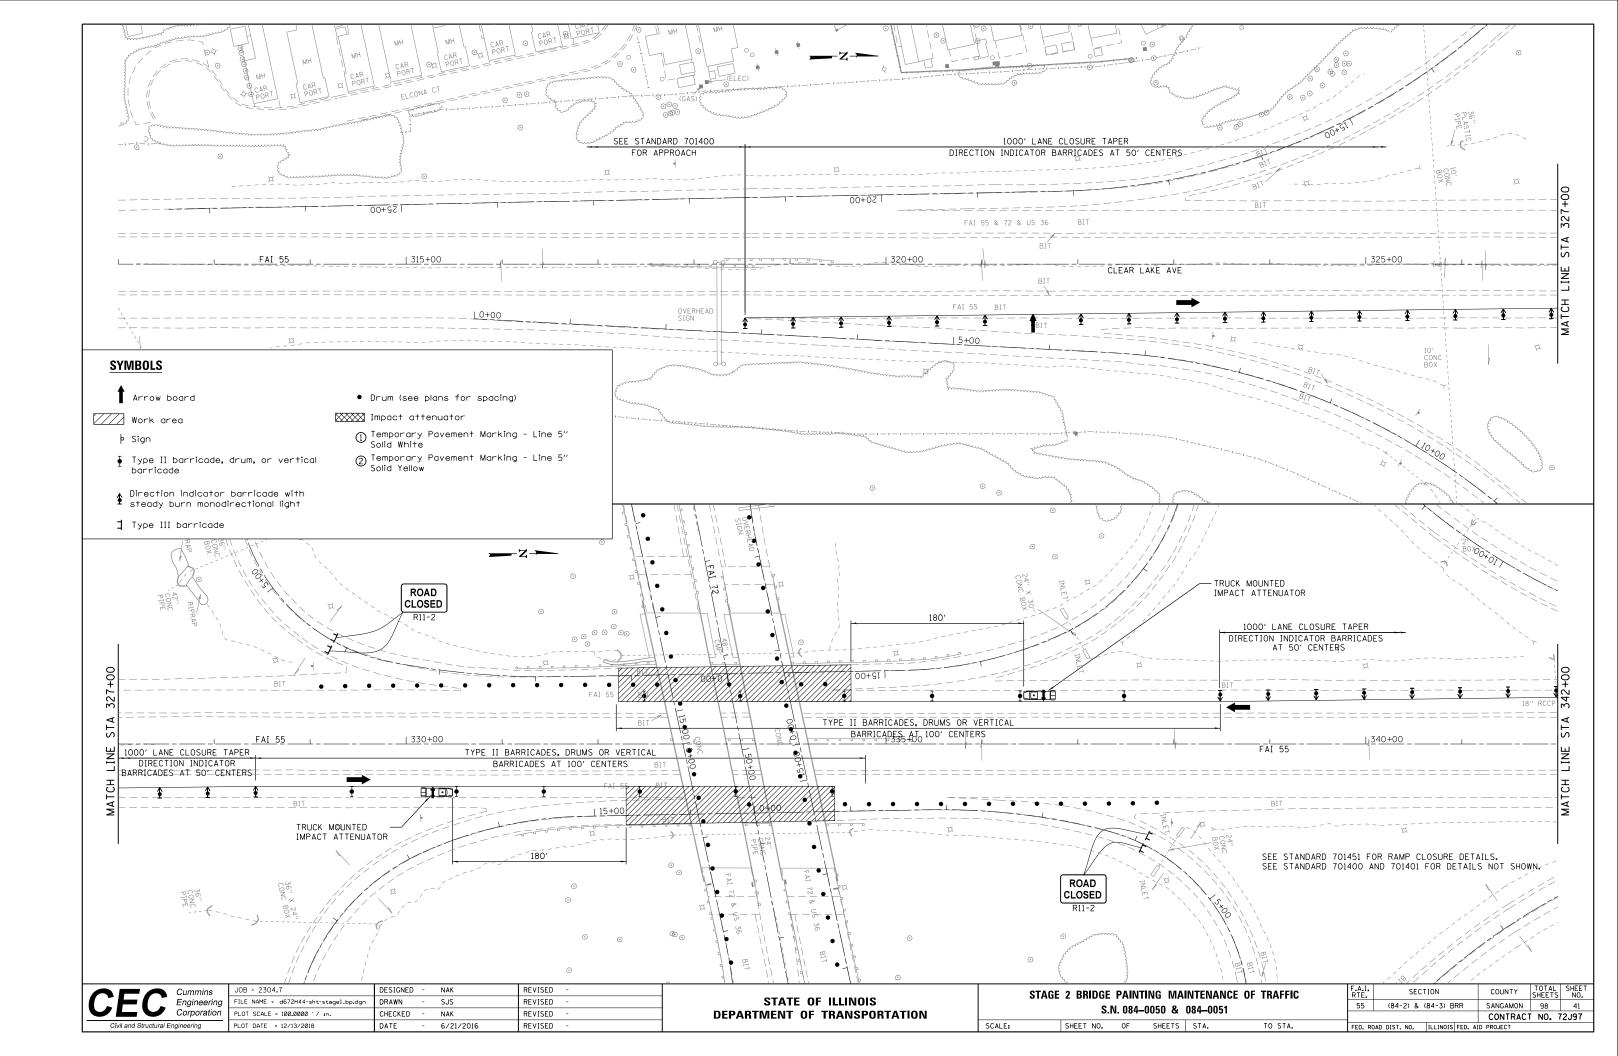


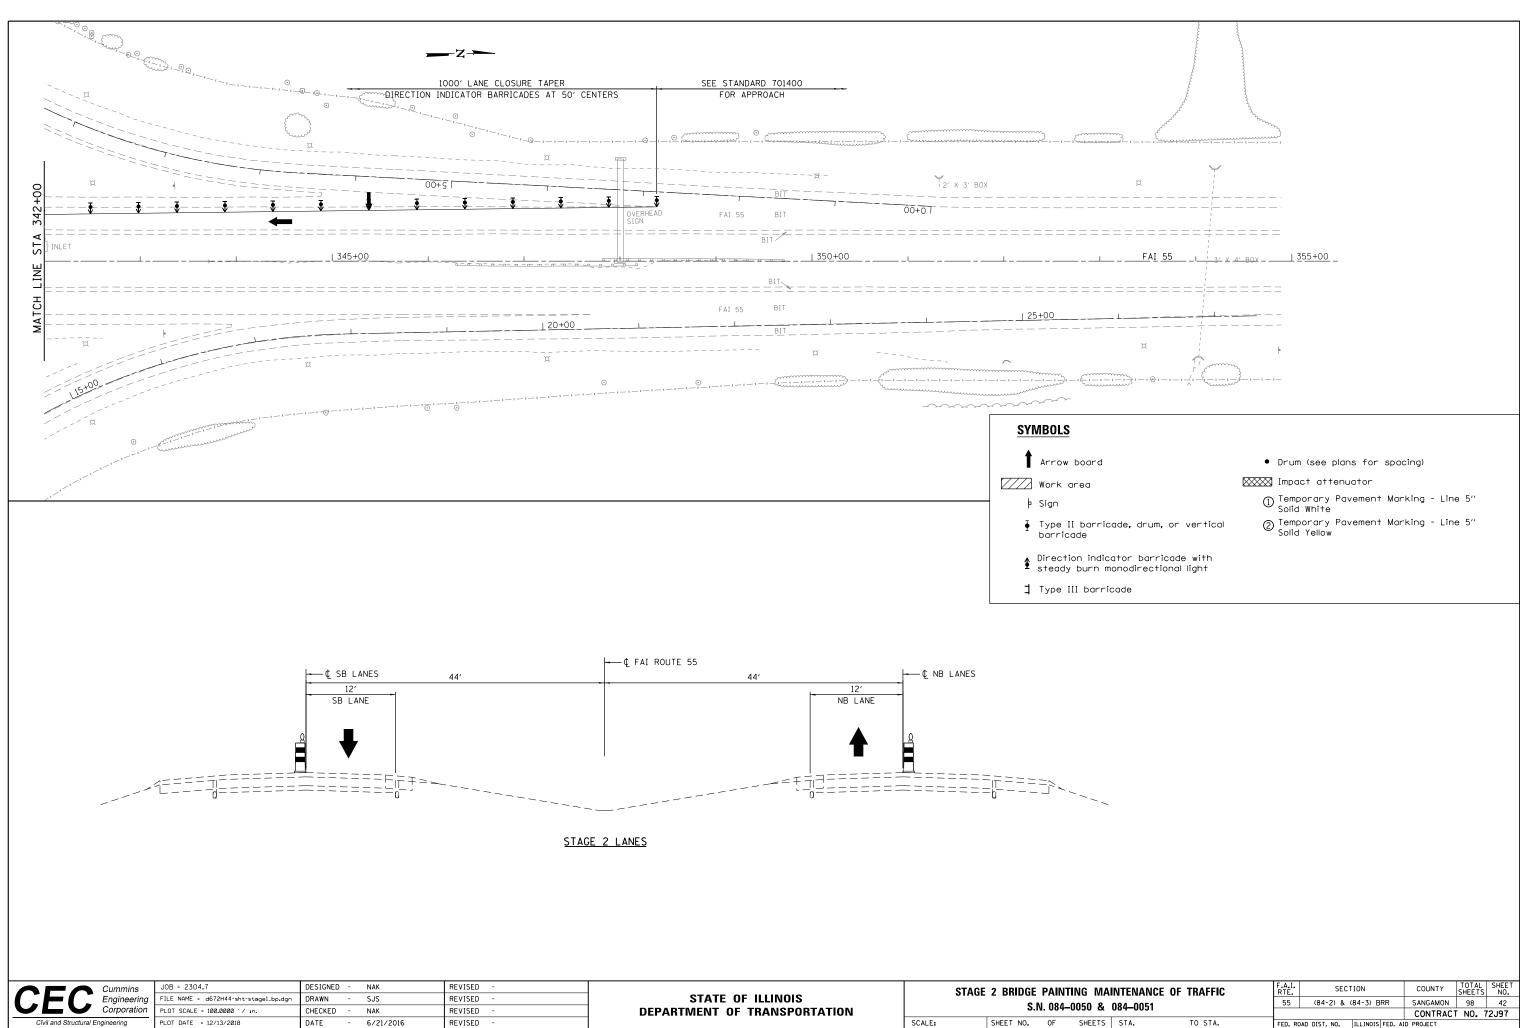

١	INTENANCE OF TRAFFIC			SEC	TION	COUNTY	TOTAL SHEETS	SHEET NO.
084-0051			55	(84-2) &	(84-3) BRR	SANGAMON	98	42
_	004-0051					SANGAMON 98 42 CONTRACT NO. 72J9		
	STA.	TO STA.	FED. RC	AD DIST. NO.	ILLINOIS FED. AI	D PROJECT		

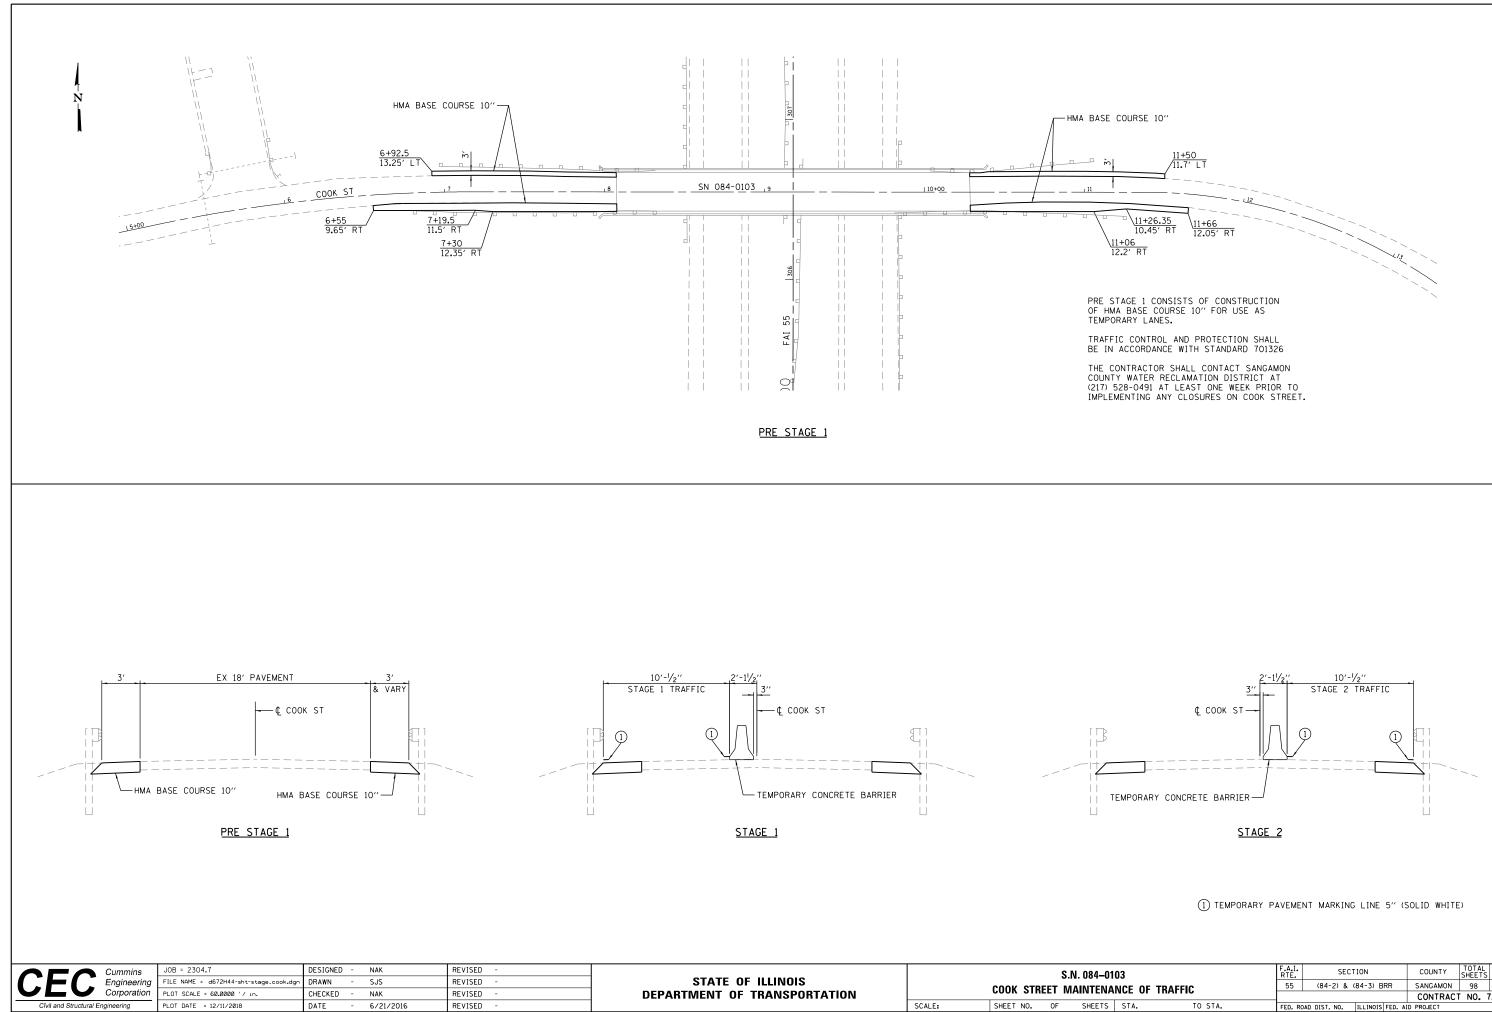

103	F.A.I. RTE	SECT	COUNTY	TOTAL SHEETS	SHEET NO.	
NCE OF TRAFFIC	55	(84-2) & ((84-3) BRR	SANGAMON	98	43
	_			CONTRACT NO. 72J97		
STA. TO STA.	FED. R	DAD DIST. NO.	ILLINOIS FED. A	D PROJECT		

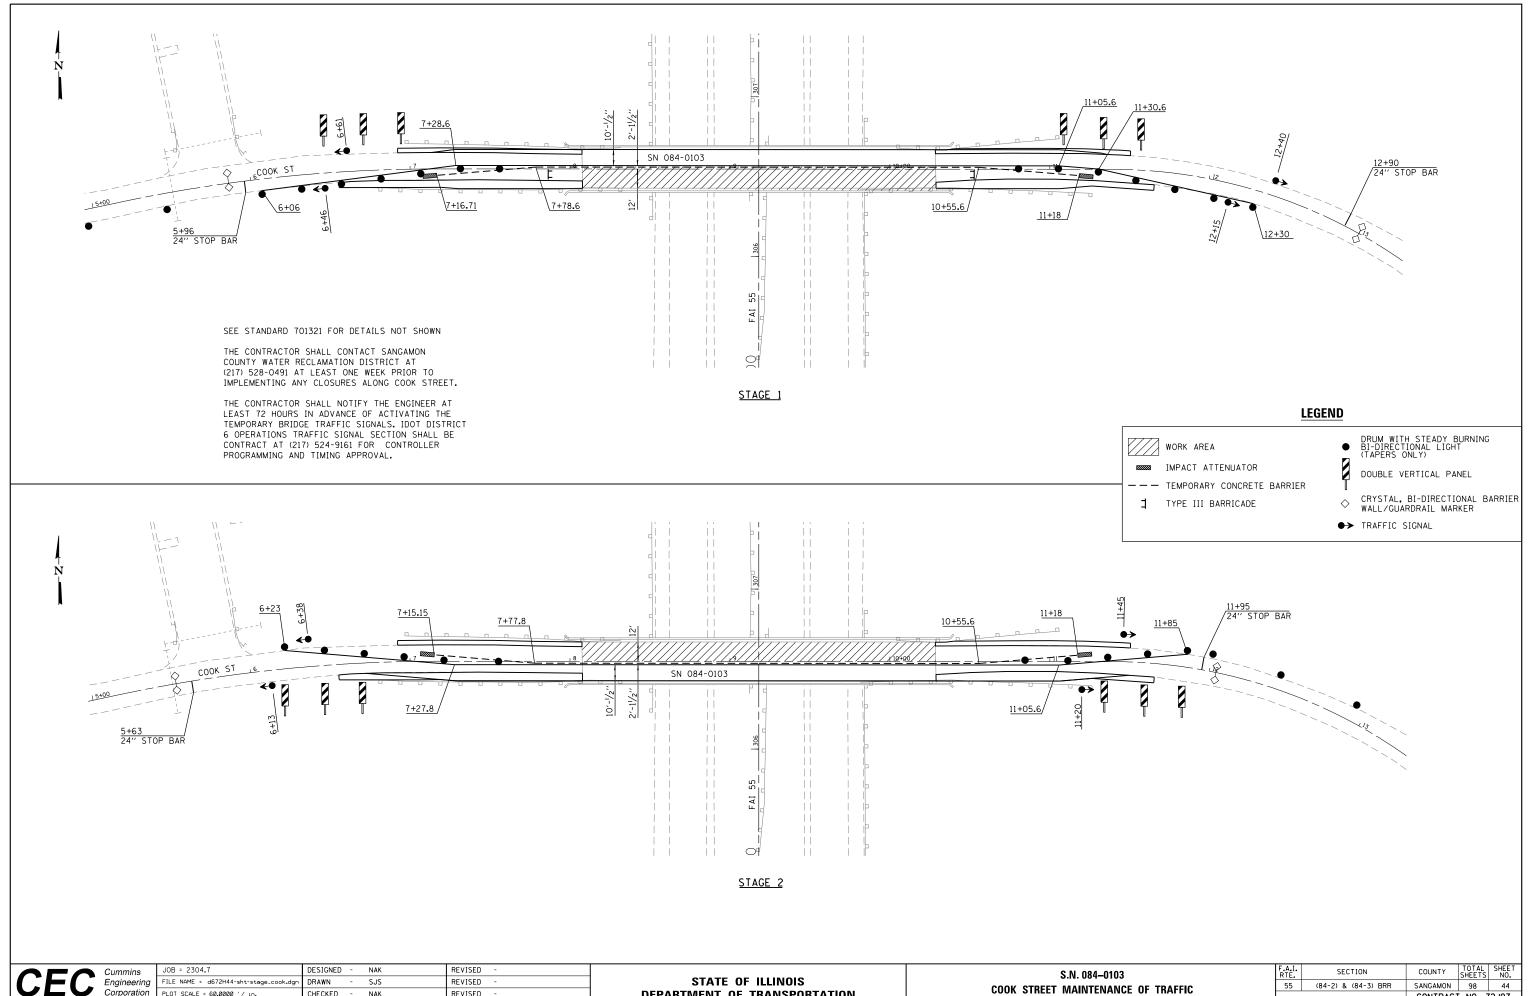

DEPARTMENT OF TRANSPORTATION

SCALE:

SHEET NO. OF SHEETS

Corporation

Civil and Structural Engineering

PLOT SCALE = 60.0000 '/ in.

PLOT DATE = 12/11/2018

CHECKED

DATE


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6/21/2016

REVISED


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1	03		F.A.I. RTE.	SEC	TION	COUNTY	TOTAL SHEETS	SHEET NO.
ANCE OF TRAFFIC			55	(84-2) &	(84-3) BRR	SANGAMON 98		
1			_			SANGAMON 98 44 CONTRACT NO. 72J97		
	STA.	TO STA.	FED. R	DAD DIST. NO.	ILLINOIS FED. AI	D PROJECT		




<u>SYMBOLS</u>	
	Work area
Þ	Sign
· = = = = = = =	Temporary concrete barrier
	Monodirectional barrier wall/guardrail marker
	Impact attenuator
1	

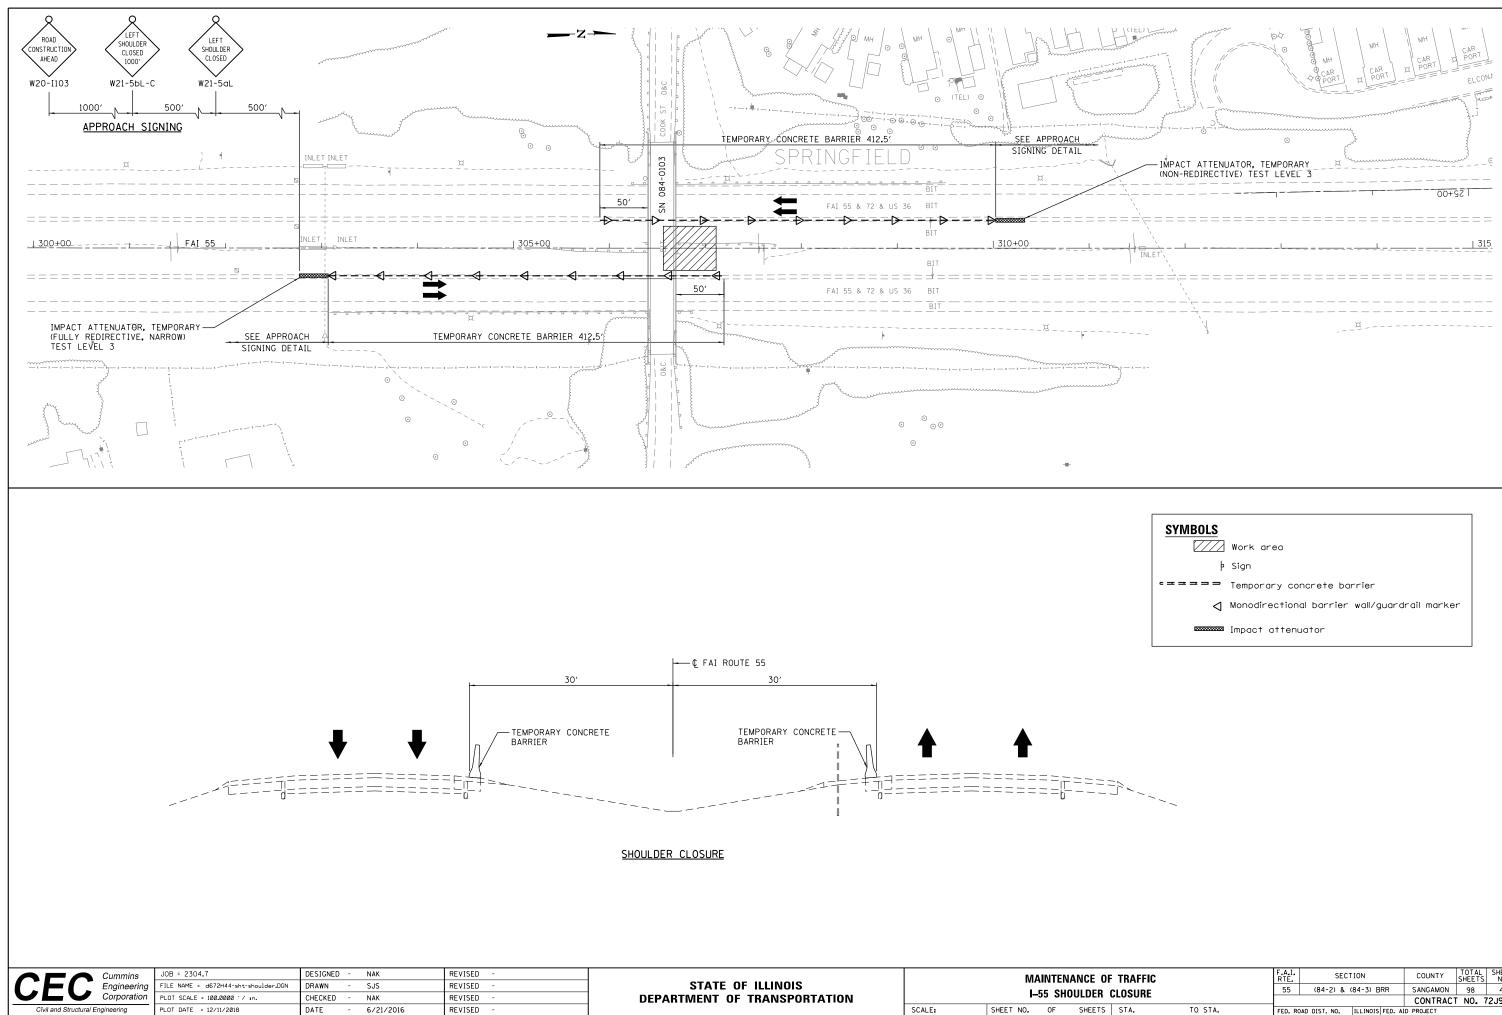
TRAFFIC		F.A.I. RTE.	SECTION	COUNTY	TOTAL SHEETS	SHEET NO.
CLOSURE		55	(84-2) & (84-3) BRR	SANGAMON	98	45
				CONTRAC	T NO. 7	'2J97
STA.	TO STA.	FED BO	AD DIST. NO. ILLINOIS FED. A			

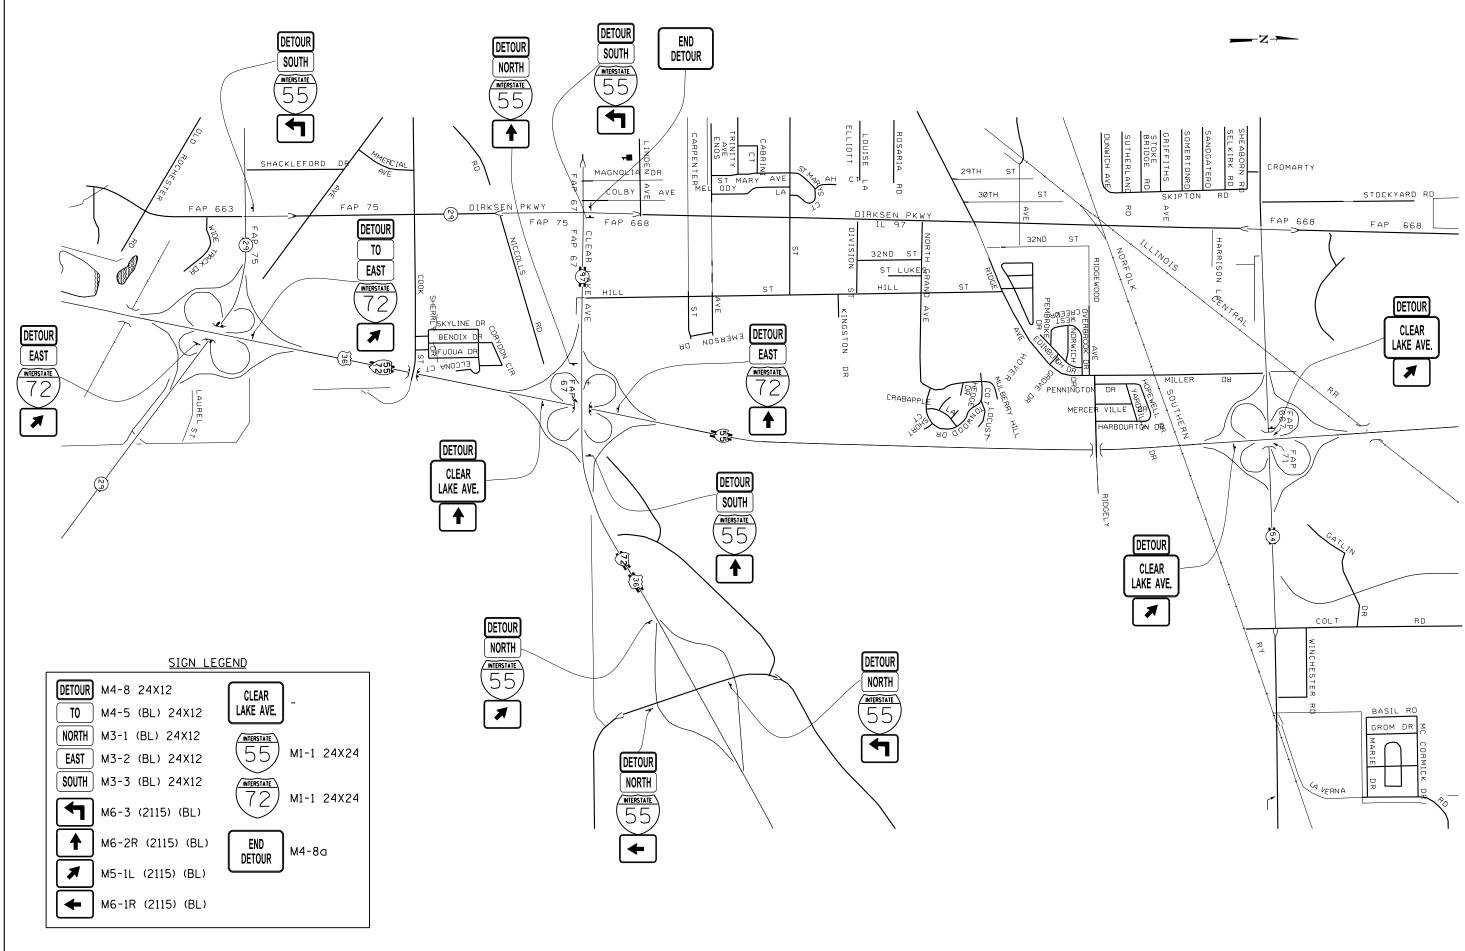


	.IOB = 2304 7	DESIGNED - NAK	REVISED -	1	1		F.A.I.	COUNTY TOTAL SHEET
	g FILE NAME = d672H44-sht-detour.dgn	DRAWN - SJS	REVISED -	STATE OF ILLINOIS		DETOUR PLAN	RTE. SECTION	COUNTY SHEETS NO.
	n PLOT SCALE = 1500.0000 '/ in.	CHECKED - NAK	REVISED -	DEPARTMENT OF TRANSPORTATION		LOOP RAMPS CLOSED (S.N. 084–0050 & 084–0051)		CONTRACT NO. 72J97
Civil and Structural Engineering	PLOT DATE = 12/13/2018	DATE - 6/21/2016	REVISED -		SCALE:	SHEET NO. OF SHEETS STA. TO STA.	FED. ROAD DIST. NO. ILLINOIS FED. 4	AID PROJECT

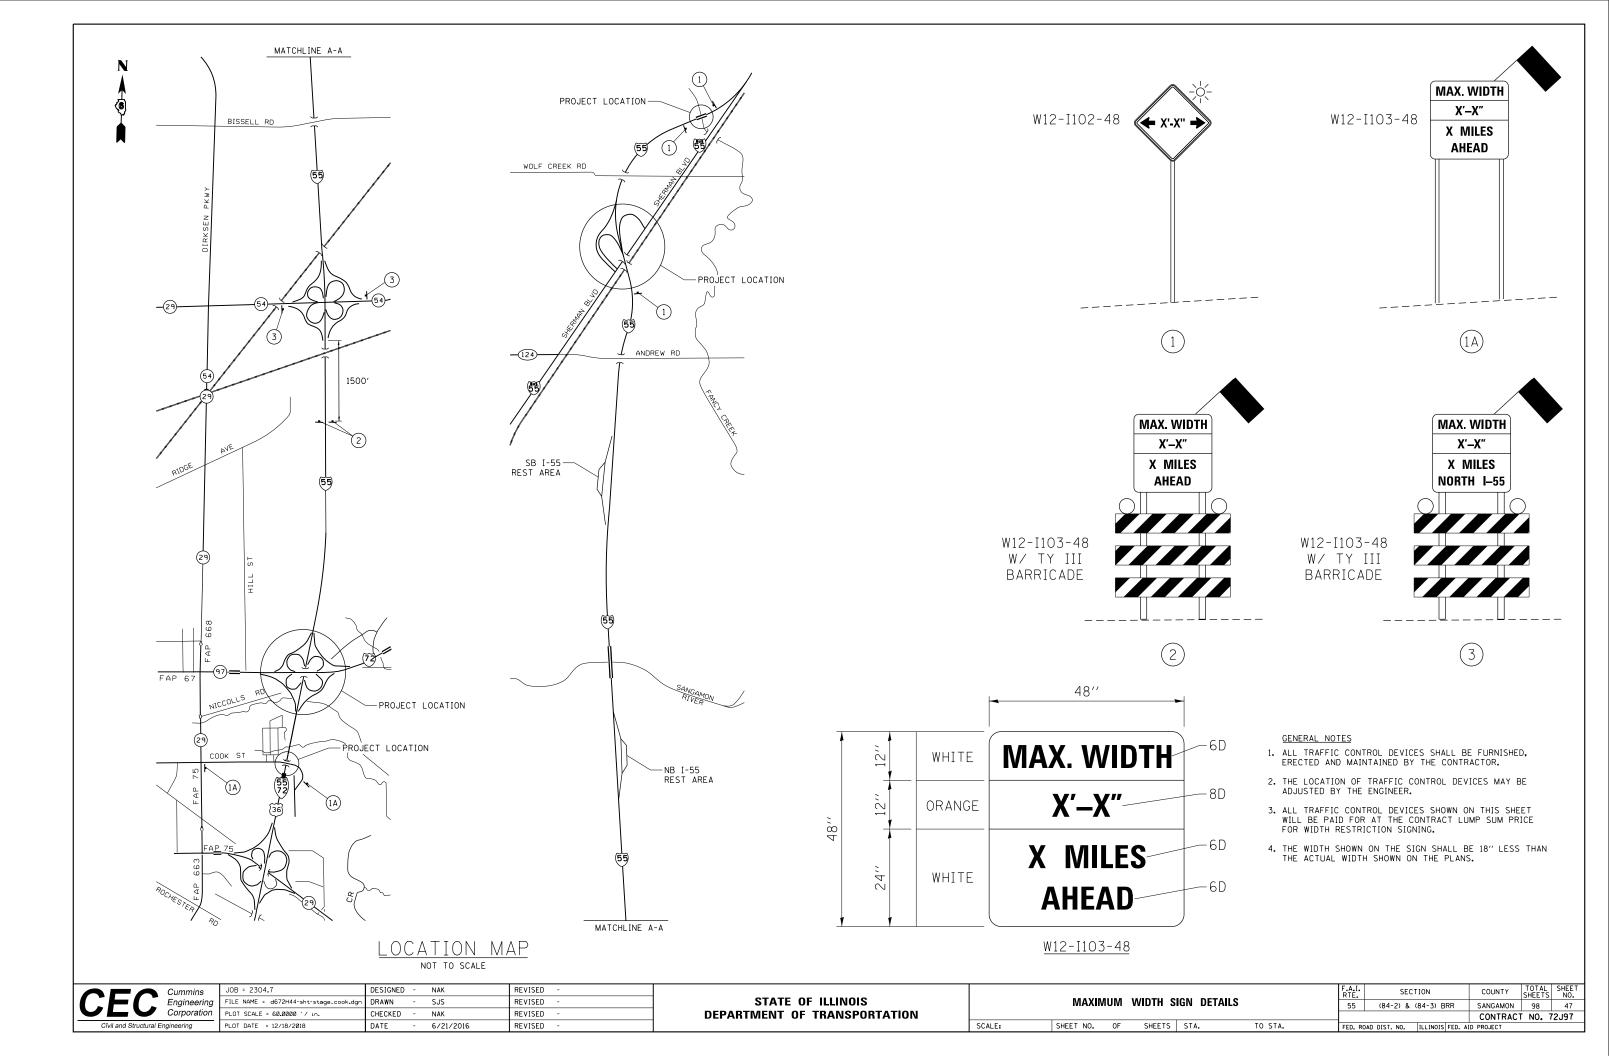


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SEE BUTT JOINT DETAIL			
1			
RE REPAIRS	F.A.I. RTE	SECTION	COUNTY TOTAL SHEET SHEETS NO.
PLAN	RTE. 55	(84-2) & (84-3) BRR	SANGAMON 98 48
S STA. 288+00.00 TO STA. 294+00.00	<u> </u>	ILLINOIS FED. A	CONTRACT NO. 72J97
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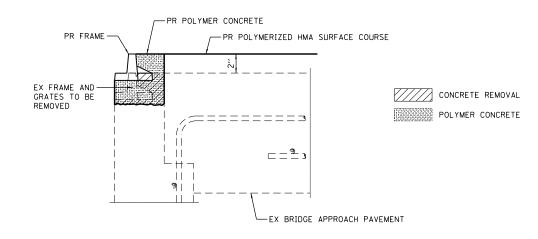
JR	E REPAIRS	IRE REPAIRS				SECTION			SHEET NO.
PLAN			55	(84-2) & (84-3) BRR			SANGAMON	98	49
						CONTRACT NO. 72J97			197
S	STA. 343+50.00	TO STA. 349+50.00	ILLINOIS FED. AID PROJECT						

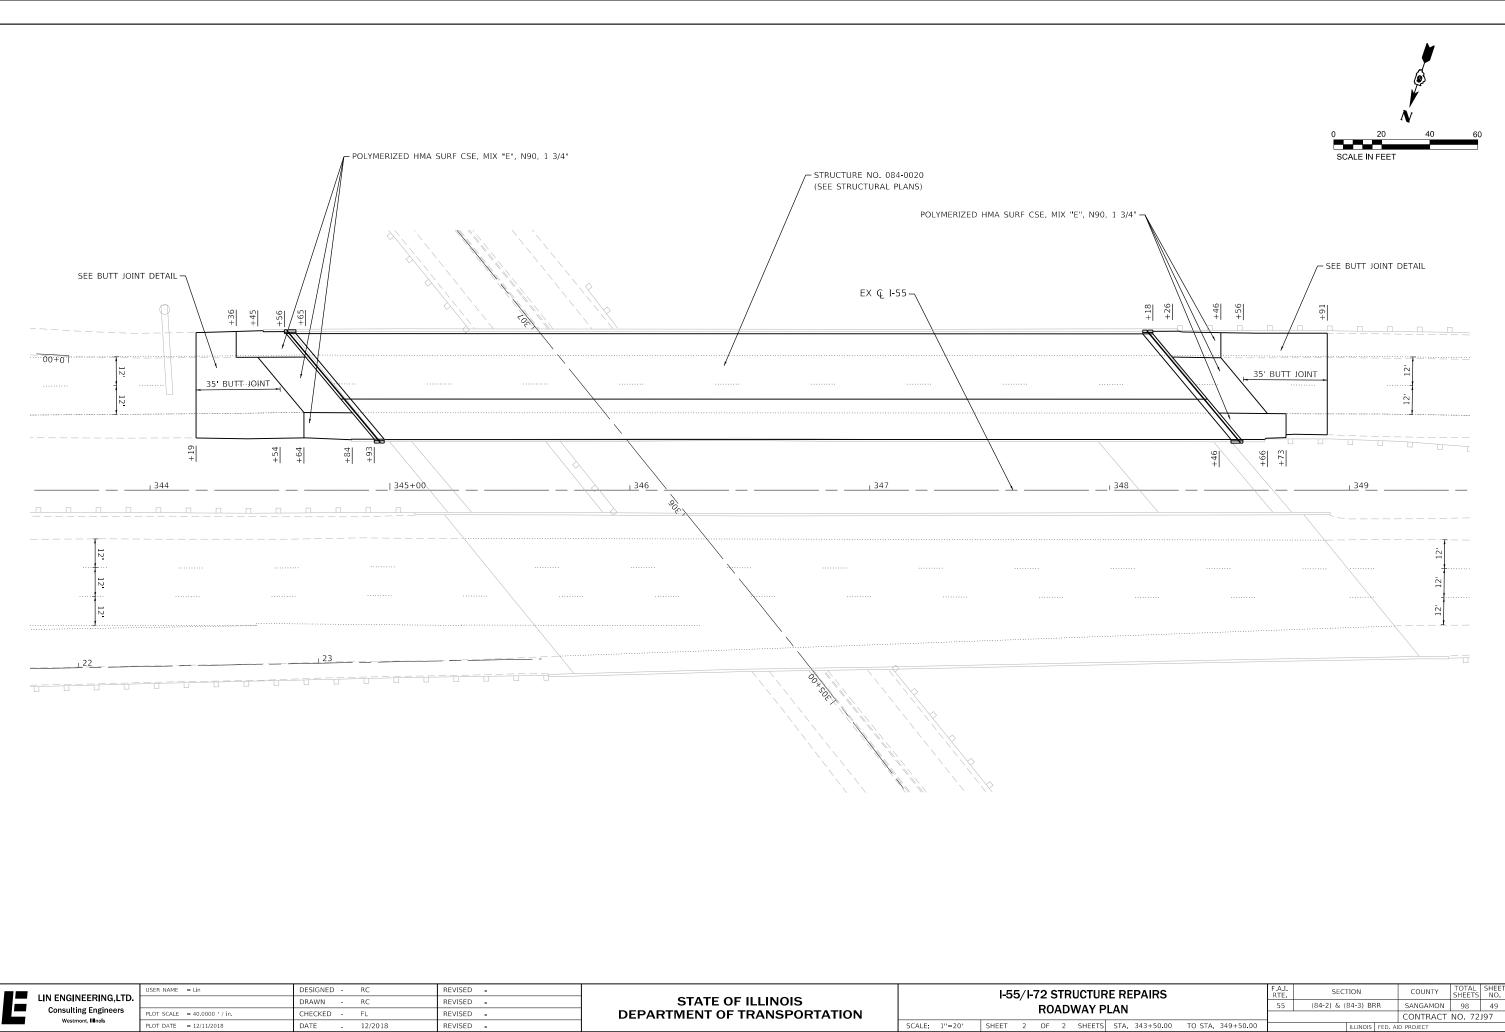

F.A.I. RTE	SECTION			COUNTY	TOTAL SHEETS	SHEET NO.
55	(84-2) & (84-3) BRR			SANGAMON	98	50
				CONTRACT NO. 72J97		
		ILLINOIS	FED. AI	ID PROJECT		
RE REPAIRS DETAIL s sta. to sta.			55 (84-2) & (84-3) BF	55 (84-2) & (84-3) BRR	55 (84-2) & (84-3) BRR SANGAMON CONTRACT	55 (84-2) & (84-3) BRR SANGAMON 98 CONTRACT NO. 72

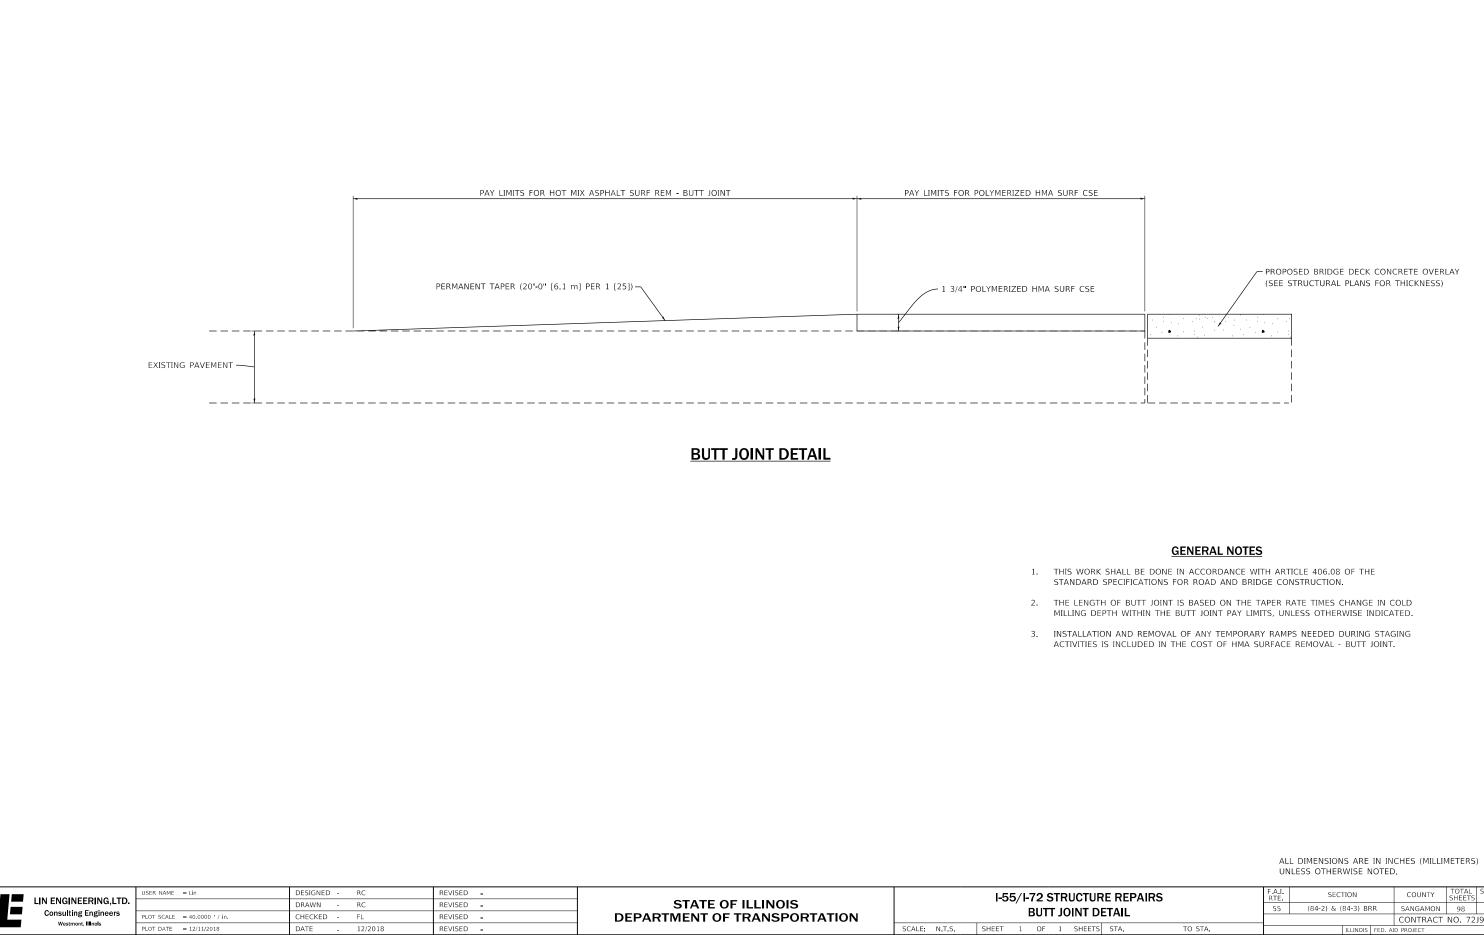




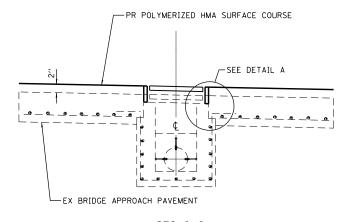


<u>DETAIL A</u>

GENERAL NOTES


THE CONTRACTOR SHALL FURNISH AND INSTALL A NEW CAST FRAME AND CAST GRATES AS SPECIFIED ON STANDARD 610001 FOR THE TYPE F INLET BOX (OUTSIDE SHOULDERS) OR TYPE G INLET BOX (MEDIAN SHOULDERS)

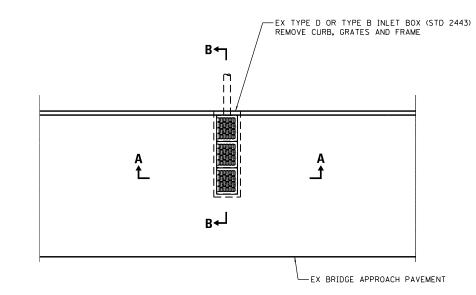

<u>PLAN</u>

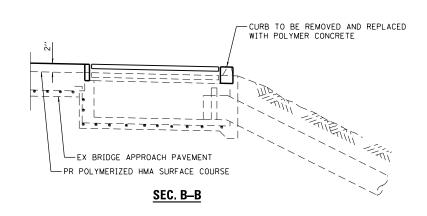


C	Cummins Engineering Corporation	JOB = 2304.7 FILE NAME = d672H44-sht-inlet.dgn PLOT SCALE = 40.0000 '/ in.	DESIGNED - NAK DRAWN - SJS CHECKED - NAK	REVISED - REVISED - REVISED -	STATE OF ILLINOIS DEPARTMENT OF TRANSPORTATION		INLET BOX ADJUSTMENT DETAILS	F.A.I. RTE. SECTION 55 (84-2) & (84-3) BRR	COUNTYTOTAL SHEETSSHEET NO.SANGAMON9851CONTRACTNO.72J97
	Civil and Structural Engineering	PLOT DATE = 12/11/2018	DATE - 6/29/2015	REVISED -		SCALE:	SHEET NO. OF SHEETS STA. TO STA.	FED. ROAD DIST. NO. ILLINOIS FED. AID	PROJECT

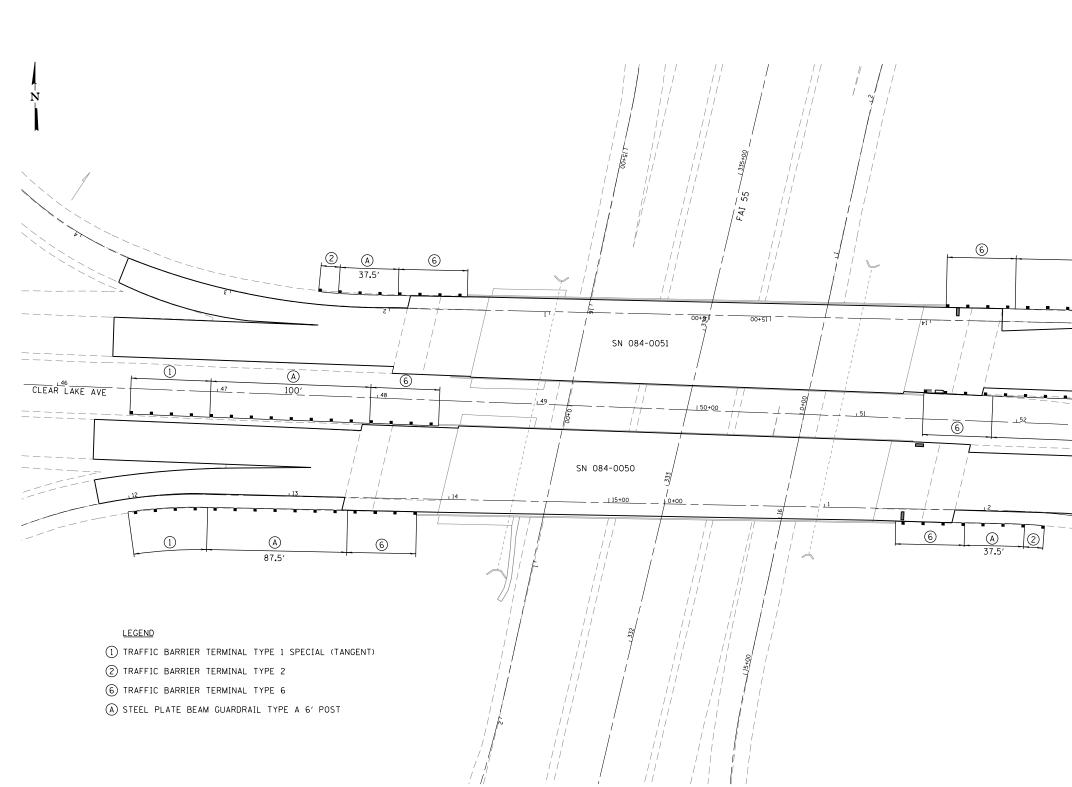

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	Engineering	FILE NAME = d672H44-sht-rail.dgn	DRAWN -	SJS	REVISED -	STATE OF ILLINOIS	1		GUARD	DRAIL DI	ETA
	Corporation	PLOT SCALE = 60.0000 '/ in.	CHECKED -	NAK	REVISED -	DEPARTMENT OF TRANSPORTATION	1				
	Civil and Structural Engineering	PLOT DATE = 12/11/2018	DATE -	6/21/2016	REVISED -		SCALE:	SHEET NO.	OF	SHEETS	S

s	(A) 162.5'	- 15				
<u>(</u>)		- -	5 <u>4</u> FA	I 72		
DETAILS	TO STA.	F.A.I. RTE. 55 FED. RC	 T10N (84-3) BRR]ILLIN0IS FED, A)	COUNTY SANGAMON CONTRACT D PROJECT	TOTAL SHEETS 98 T NO. 7	52

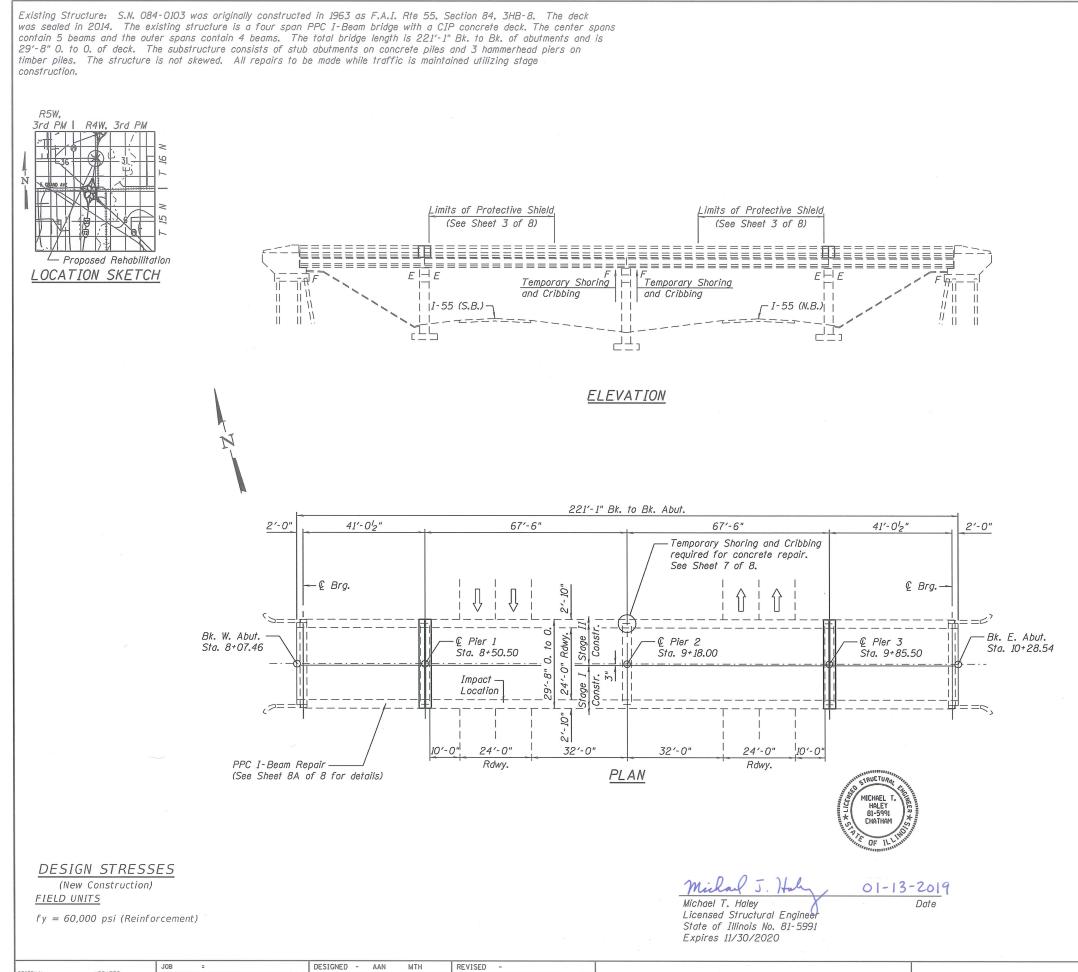

UPDATED: FILE = 0840103-72J97-001-GP&E.dor CHECKED - MDC STATE OF ILLINOIS VPT REVISED CEC Cummins Engineering Corporation DATE = 1/13/2019 DRAWN - SJS DAS REVISED DEPARTMENT OF TRANSPORTATION CHECKED - MDC MTH REVISED SHEET NO. 1 OF

Pla cons deta to c addit Cont for Jo wher Th SCOPE OF WORK

- 1. Repair North end of Pier 2 utilizing Temporary Shoring and Cribbing.
- 2. Remove and replace joints at Piers 1 and 3.
- 3. Remove and replace silicone joint sealer at Pier 2.
- 4. Complete Deck Slab Repairs.
- 5. Perform PPC I-Beam Repairs.

INDEX OF SHEETS

- 1. General Plan and Elevation
- 2. Stage Construction Details
- 3. Deck Slab Repair Plan Details
- 4. Expansion Joint Replacement Details
- 5. Parapet and Joint Replacement Details
- 6. Preformed Joint Strip Seal
- 7. Pier 2 Repair Details
- 8. Bar Splicer Assembly and Mechanical Splicer Details
- 8A. PPC I-Beam Repair Details

GENERAL NOTES

Reinforcement bars designated (E) shall be epoxy coated.

Plan dimensions and details relative to existing plans are subject to nominal construction variations. The Contractor shall field verify existing dimensions and details affecting new construction and make necessary approved adjustments prior to construction or ordering of materials. Such variations shall not be cause for additional compensation for a change in scope of the work, however, the Contractor will be paid for the quantity actually furnished at the unit price bid for the work.

Joint openings shall be adjusted according to Article 520.04 of the Std. Specs. when the deck is poured at an ambient temperature other than 50° F. The deck surface shall have its final finish tined according to Article 420.09(e)(1) of the Standard Specifications. Cost included with Concrete Superstructure.


ITEM	UNIT	TOTAL
Concrete Removal	Cu. Yd.	2.6
Protective Shield	Sq. Yd.	277
Concrete Superstructure	Cu. Yd.	2.6
Protective Coat	Sq. Yd.	833
Reinforcement Bars, Epoxy Coated	Pound	360
Bar Splicers	Each	8
Preformed Joint Strip Seal	Foot	56
Structural Repair of Concrete	Sq. Ft.	42
(Depth Equal To Or Less Than 5 Inches)		~
Deck Slab Repair (Full Depth Type I)	Sq. Yd.	0.4
Deck Slab Repair (Full Depth Type II)	Sq. Yd.	4.5
Deck Slab Repair (Partial)	Sq. Yd.	73.4
Temporary Shoring and Cribbing	Each	2
Silicone Joint Sealer, ${}^{3}_{4}$ "	Foot	30
Fiber Wrap	Sq. Ft.	54.8
Acrylic Coating	Sq. Yd.	6.8
Precast Prestressed Concrete I-Beam Repair	Sa. Ft.	3.7

TOTAL BILL OF MATERIAL

*Apply to top and inside faces of parapets and sidewalks, and top of deck slab including new concrete adjacent to expansion joints.


GENERAL PLAN AND ELEVATION COOK STREET OVER F.A.I. 55 SECTION (84-3-2) RS-2, BP, BDR SANGAMON COUNTY STRUCTURE NO. 084-0103

	F.A.I. RTE.	SECTION	COUNTY	TOTAL SHEETS	SHEET NO.	
	55	(84-3-2) RS-2, BP, BDR	SANGAMON	98	53	
			CONTRACT	Γ NO. 7	72J97	
F 8 SHEETS	ILLINOIS FED. AID PROJECT					
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	UPDATED:	JOB = DESIGNED - AAN MTH REVISED -		STAGE CONSTRUCTION DETAILS	F.A.I. SECTION	COUNTY TOTAL SHEET SHEETS NO.		
		FILE = 0840103-72J97-002-Stage.dgn DATE = 12/10/2018	CHECKED - MDC VPT REVISED -		STATE OF ILLINOIS DEPARTMENT OF TRANSPORTATION	STRUCTURE NO. 084–0103	55 (84-3-2) RS-2, BP, BDR	SANGAMON 98 54
	anng Consulting Engineers abon sprigitis Bats		DRAWN - SJS DAS	REVISED -				CONTRACT NO. 72J97
on and oracinate chyricanig			CHECKED - MDC MTH	REVISED -		SHEET NO. 2 OF 8 SHEETS	ILLINOIS FED. A	AID PROJECT

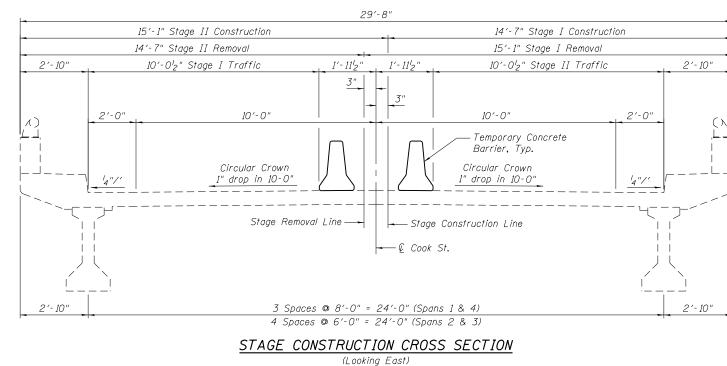



DECK REPAIR PLAN

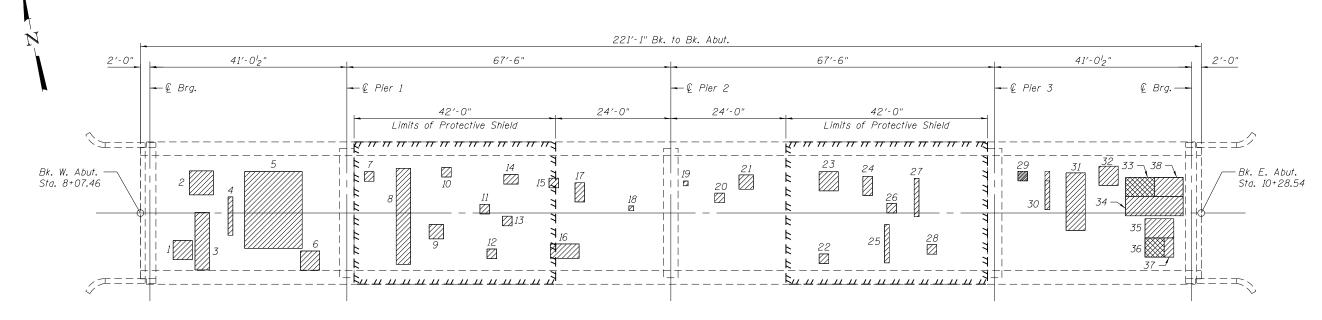ANTICIPATED DECK SLAB REPAIR S.N. 084-0103

PATCH NO.	LENGTH (FT.)	WIDTH (FT.)	AREA (SQ. YD.)
1	4	4	1.8
2	5	5	2.8
3	3	12	4.0
4	1	8	0.9
5	12	16	21.3
6	4	4	1.8
7	2	2	0.4
8	3	20	6.7
9	3	3	1.0
10	2	2	0.4
11	2	2	0.4
12	2	2	0.4
13	2	2	0.4
14	3	2	0.7
15	2	2	0.4
16	6	3	2.0
17	2	4	0.9
18	1	1	0.1
19	1	1	0.1
			Continued

ANTICIPATED DECK SLAB REPAIR S.N. 084-0103

PATCH NO.	LENGTH (FT.)	WIDTH (FT.)	AREA (SQ. YD.)
20	2	2	0.4
21	3	3	1.0
22	2	2	0.4
23	4	4	1.8
24	2	4	0.9
25	1	8	0.9
26	2	2	0.4
27	1	8	0.9
28	2	2	0.4
29	2	2	0.4
30	1	8	0.9
31	4	12	5.3
32	4	4	1.8
33	6	4	2.7
34	12	4	5.3
35	6	4	2.7
36	4	4	1.8
37	2	4	0.9
38	6	4	2.7
			Total= 78.3



F

Note: Areas of deck repairs shown are estimated. The Engineer shall document actual locations of deck repairs on As-Built Plans.

0.0		UPDATED:	JOB =	DESIGNED - A	AN MTH	REVISED -		DECK SLAB REPAIR PLAN DETAILS	F.A.I. RTF.	SECTION	COUNTY	TOTAL SHEET SHEETS NO.
	CECC Cummins Engineering Corporation Consulting Engineers		D. FILE = 0840103-72J97-003-RepairPlan.dgn	CHECKED IV	DC VPT	REVISED -	STATE OF ILLINOIS	STRUCTURE NO. 084–0103	55	(84-3-2) RS-2, BP, BDR	SANGAMON	98 55
		Consulting Engineers Spring Mit. Block	DATE = 12/10/2018	DRAWN - S	JS DAS	REVISED -	DEPARTMENT OF TRANSPORTATION		_		CONTRAC	T NO. 72J97
	City and Structural Engineering			CHECKED - N	DC MTH	REVISED -		SHEET NO. 3 OF 8 SHEETS		ILLINOIS FED. A	D PROJECT	

LEGEND

Deck Slab Repair (Full Depth, Type I)


Deck Slab Repair (Full Depth, Type II)

Deck Slab Repair (Partial)

Protective Shield

TOTAL BILL OF MATERIAL


ITEM	UNIT	TOTAL
Deck Slab Repair (Full Depth, Type I)	Sq. Yd.	0.4
Deck Slab Repair (Full Depth, Type II)	Sq. Yd.	4.5
Deck Slab Repair (Partial)	Sq. Yd.	73.4
Protective Shield	Sq. Yd.	277

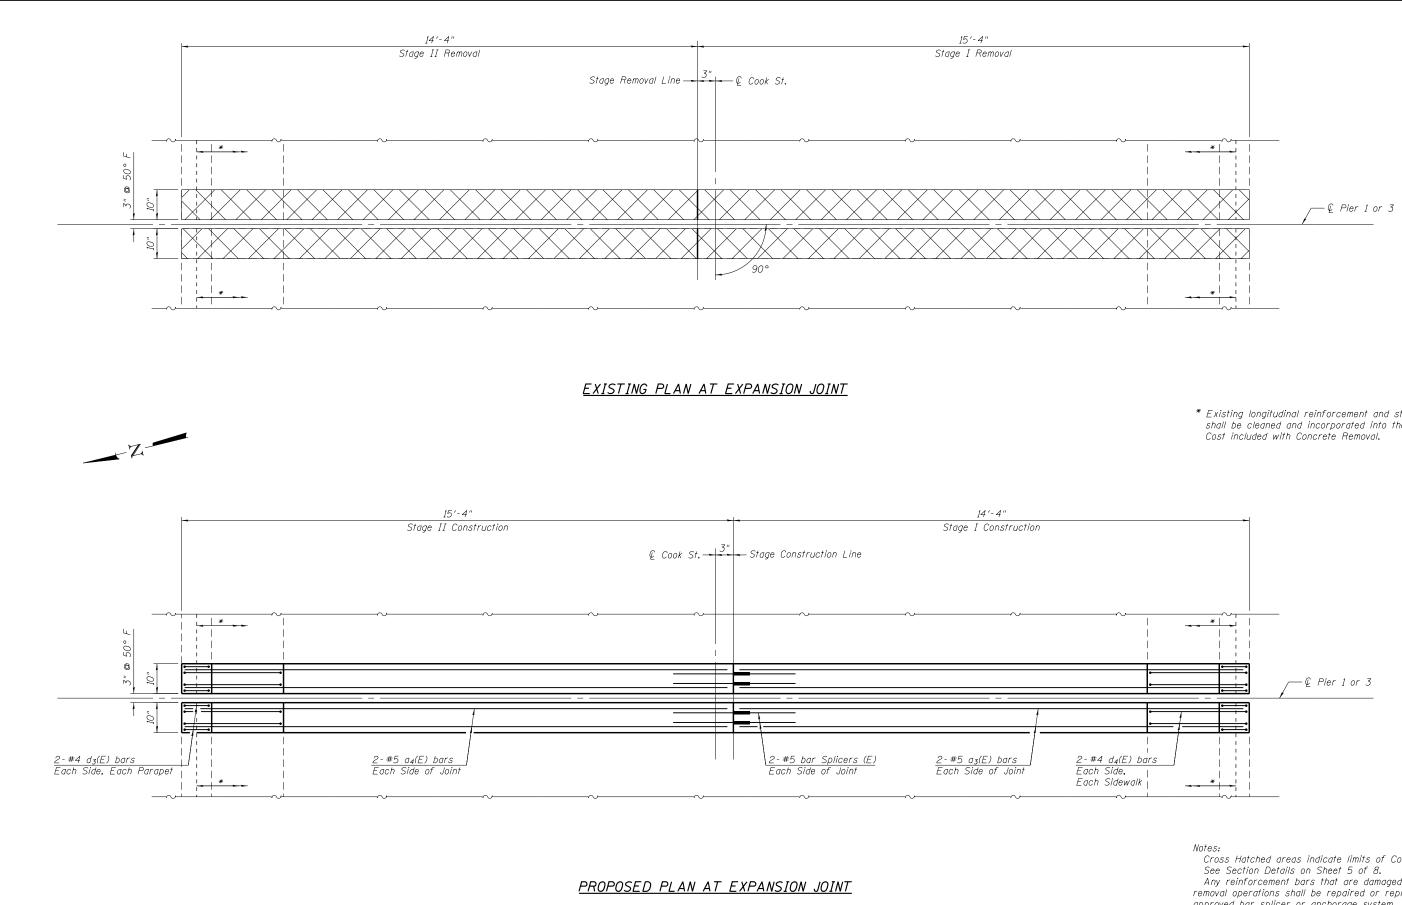

ORIGINAL: UPDATED:	JOB =	DESIGNED - AAN	MTH	REVISED -		EXPANSION JOINT REPLACEMENT DETAILS	F.A.I. RTE.	SECTION	COUNTY	TOTAL SH SHEETS N	.ET 0.
	FILE = 0840103-72J97-004_005-JointRep.dgn	CHECKED - MDC	VPT	REVISED -	STATE OF ILLINOIS	STRUCTURE NO. 084–0103	55	(84-3-2) RS-2, BP, BDR	SANGAMON	98 5	6
Child and Structural Engineering	DATE = 12/10/2018	DRAWN - SJS CHECKED - MDC	DAS MTH	REVISED - REVISED -	DEPARTMENT OF TRANSPORTATION	SHEET NO. 4 OF 8 SHEETS		ILLINOIS FED. A	CONTRACT D PROJECT	T NO. 72J) 7

* Existing longitudinal reinforcement and stirrups in diaphragm shall be cleaned and incorporated into the new construction. Cost included with Concrete Removal.

Cross Hatched areas indicate limits of Concrete Removal. Any reinforcement bars that are damaged during concrete removal operations shall be repaired or replaced using an approved bar splicer or anchorage system. Cost included with "Concrete Removal".

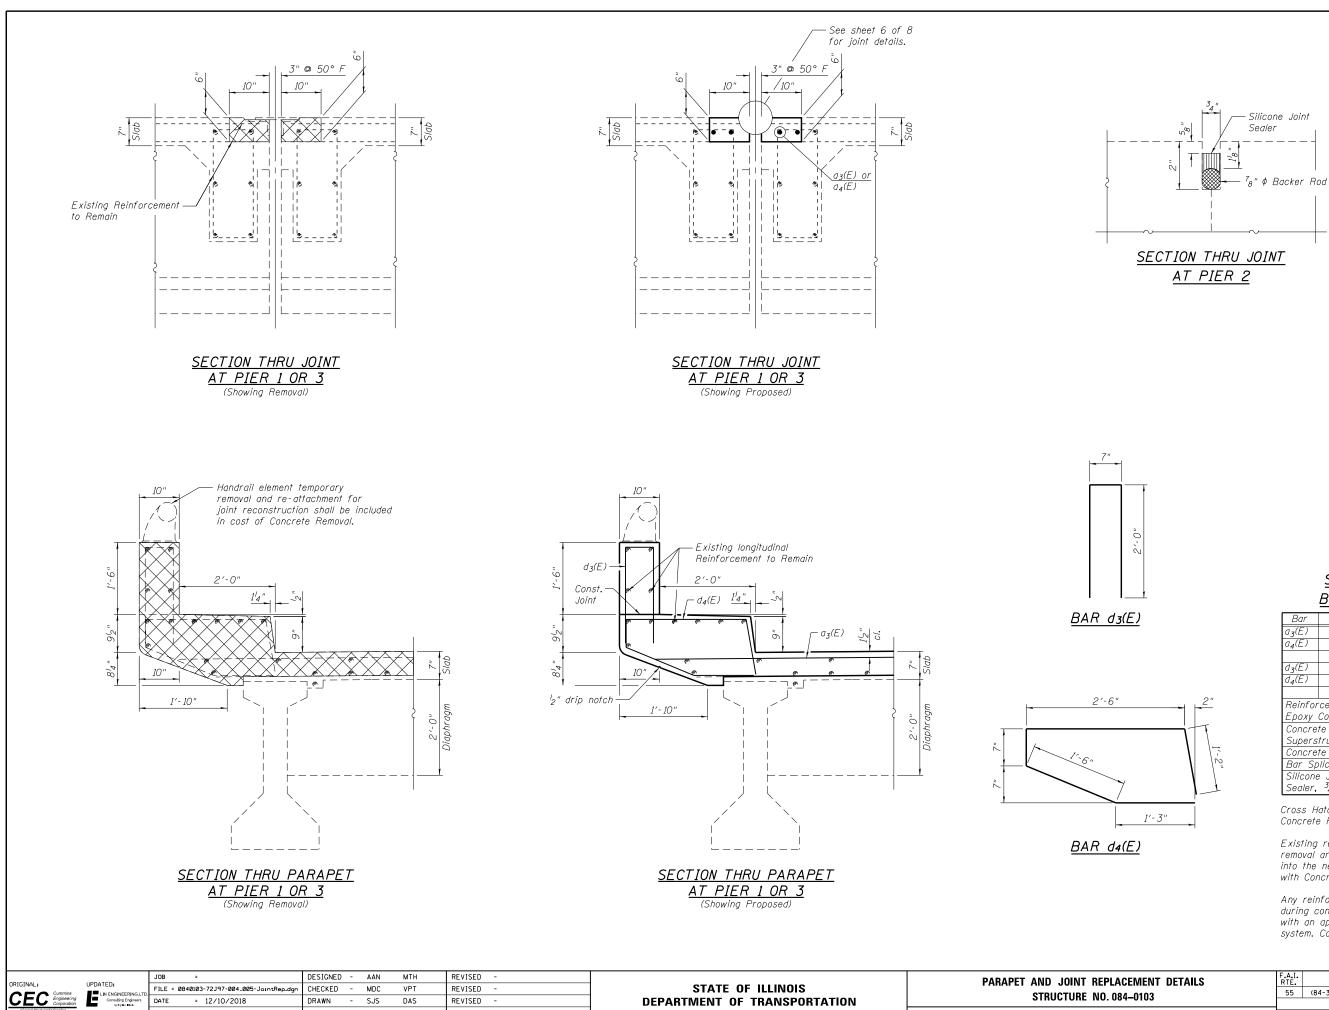

MTH

REVISED

<u>SUPERSTRUCTURE</u> BILL OF MATERIAL


				_
Bar	No.	Size	Length	Shape
а _з (Е)	8	#5	13′-7″	
a ₄ (E)	8	#5	14 ' - 1"	
d3(E)	16	#4	4'-7"	
d ₄ (E)	16	#4	7'-0"	0
Reinfor	cement	Bars,	Pound	360
Ероху	Coated		1 00/10	500
Concre	te		Cu. Yd.	2.6
Supers	tructure	•		
Concre	te Remo	oval	Cu. Yd.	2.6
Bar Sp	licers		Each	8
Silicone			Foot	30
Sealer,	3 ₄ "		Foot	50

Cross Hatched areas indicate limits of Concrete Removal.

Existing reinforcement extending into the removal area shall be cleaned and incorporated into the new construction. Cost included with Concrete Removal.

Any reinforcement bars that are damaged during concrete removal shall be replaced with an approved bar splicer or anchorage system. Cost included with Concrete Removal.

PLACEMENT DETAILS	F.A.I. RTE.	SECTION	COUNTY	TOTAL SHEETS	SHEET NO.
. 084–0103	55	(84-3-2) RS-2, BP, BDR	SANGAMON	98	57
. 004-0103			CONTRACT	NO. 7	2J97
8 SHEETS		ILLINOIS FED. A	D PROJECT		

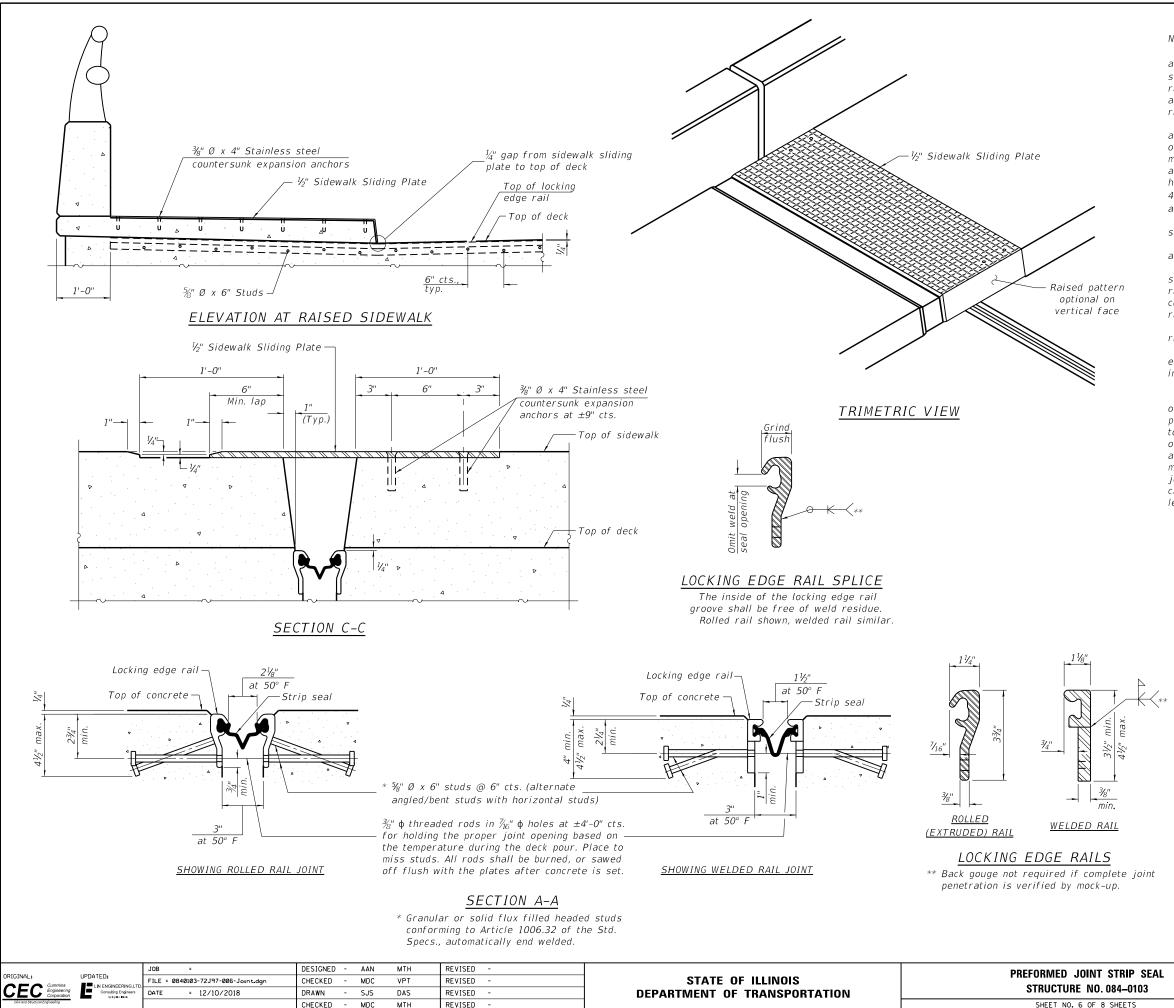

Notes:

The strip seal shall be made continuous and shall have a minimum thickness of $\frac{1}{4}$ ". The configuration of the strip seal shall match the configuration of the locking edge rails. Open or "webbed" strip seal gland configurations are not permitted. The gland shall be sized for a maximum rated movement of 4 inches.

The locking edge rails depicted are configured for typical applications and are conceptual only. The actual configuration of the locking edge rails and matching strip seal may vary from manufacturer to manufacturer provided they fit the application and meet the minimum anchorage shown. Flanged edge rails, however, will not be allowed. Locking edge rails may exceed the $4 l_2^{\prime\prime}$ maximum depth provided the anchorage system is revised according to the manufacturer's recommendation.

The manufacturer's recommended installation methods shall be followed.

All steel components shall be galvanized after fabrication according to Article 520.03 of the Standard Specifications.

The Maximum space between locking edge rail segments shall be $\frac{3}{16}$ " and sealed with a suitable sealant; however, any rail joint within 10' measured perpendicular to the face of the curb or parapet shall be welded as shown in the locking edge rail splice detail.

The top surface of sidewalk sliding plates shall have a raised pattern according to ASTM A786.

Cost of parapet sliding plates, sidewalk sliding plates, embedded plates, anchorage studs, and expansion anchors included with Preformed Joint Strip Seal.


34" F-shape barrier shown, 42" F-shape similar as noted. The concrete opening below the strip seal will vary based on the locking edge rail chosen by the Contractor. Deck and parapet lengths shown elsewhere in the plans are dimensioned to the concrete opening, not the joint opening, and are based on the rolled locking edge rail. If the Contractor elects to use a different locking edge rail, dimensional adjustments may be required. One exception to this would be the strip seal joint at the end of the precast bridge approach slab. For these cases the pavement connector length shall be adjusted, not the length of the bridge approach slab.

PLAN AT RAISED SIDEWALK

Шı


<u>BILL OF MAT</u>	ERIAL	
Item	Unit	Total
Preformed Joint Strip Seal	Foot	56

r strip seal	F.A.I. RTE.	SECTION	COUNTY	TOTAL SHEETS	SHEET NO.
. 084–0103	55	(84-3-2) RS-2, BP, BDR	SANGAMON	98	58
. 004-0105			CONTRACT	T NO. 7	2J97
8 SHEETS	ILLINOIS FED. AID PROJECT				

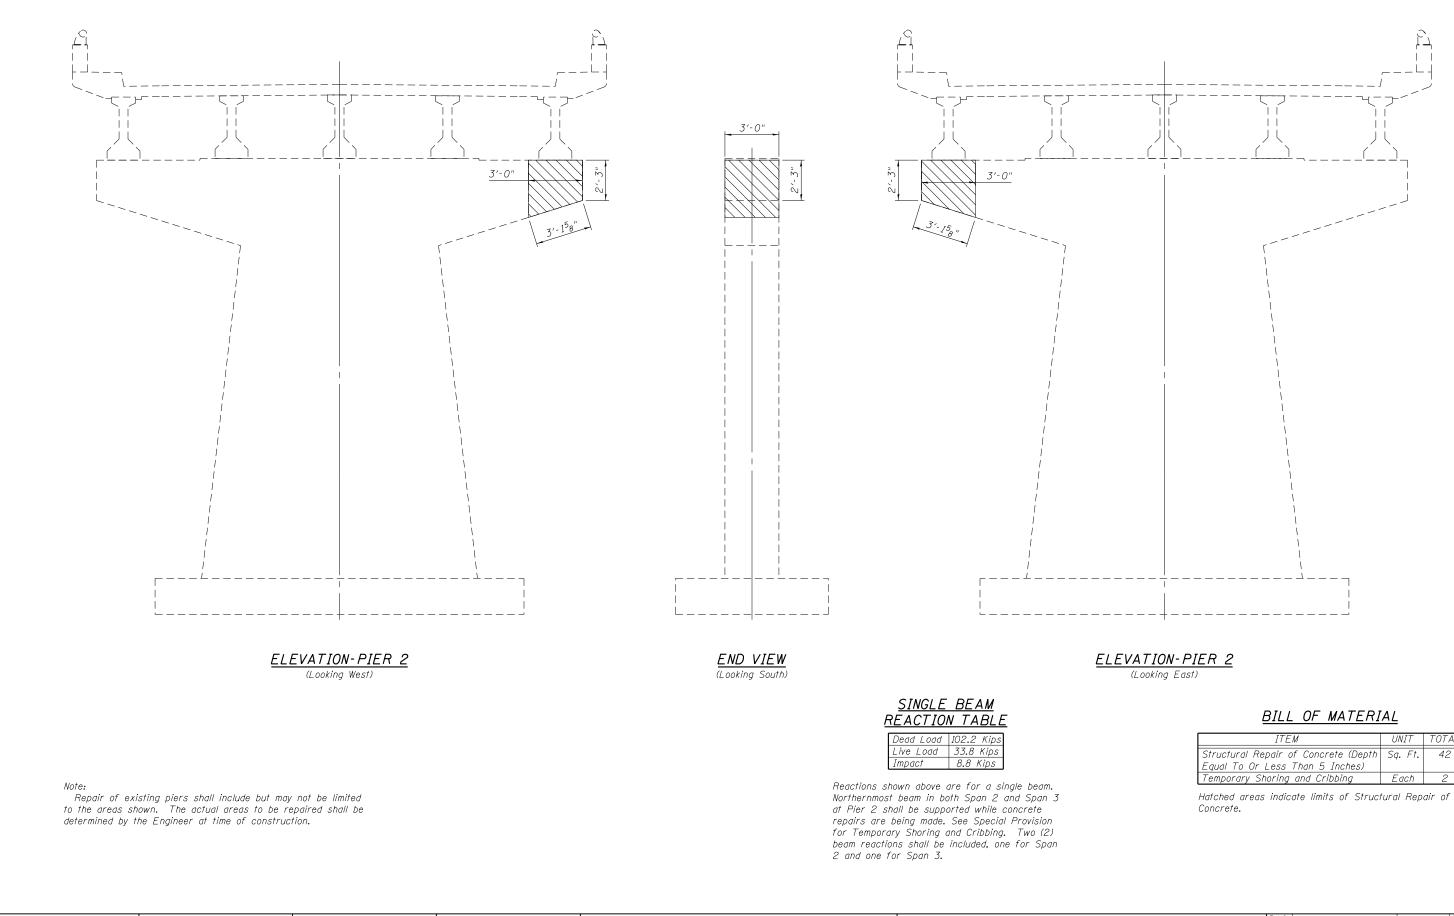

	UPDATED:	JOB =	DESIGNED - AAN MTH	REVISED -		PIER 2 REPAIR DETAILS	F.A.I. SECTION	COUNTY TOTAL SHEET
		FILE = 0840103-72J97-007-Pier.dgn	CHECKED - MDC VPT	REVISED -	STATE OF ILLINOIS	STRUCTURE NO. 084–0103	55 (84-3-2) RS-2, BP, BDR	SANGAMON 98 59
Chilland Structural Engineering	Consulting Engineers SpringHallingk	DATE = 12/10/2018	DRAWN - SJS DAS CHECKED - MDC MTH	REVISED -	DEPARTMENT OF TRANSPORTATION	SHEET NO. 7 OF 8 SHEETS		CONTRACT NO. 72J97
			CHECKED - MDC MTH	REVISED -		SHEET NO. 7 OF 8 SHEETS	ILLINOIS FED. A	AID PROJECT


ITEM	UNIT	TOTAL
Structural Repair of Concrete (Depth	Sq. Ft.	42
Equal To Or Less Than 5 Inches)		
Temporary Shoring and Cribbing	Each	2

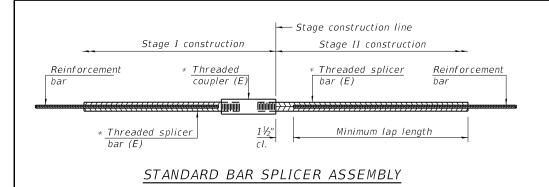

Threaded splicer bar length = min. lap length + $1\frac{1}{2}$ " + thread length

* Epoxy not required on Bar Splicer Assembly components used in conjunction with black bars.


Location	Bar size	No. assemblies required	Minimum Iap length
Joints	#5	8	3′-6″

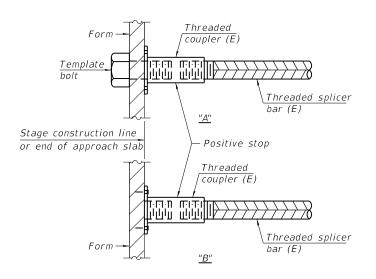

INSTALLATION AND SETTING METHODS

"A" : Set bar splicer assembly by means of a template bolt. "B" : Set bar splicer assembly by nailing to wood forms or


(E) : Indicates epoxy coating.

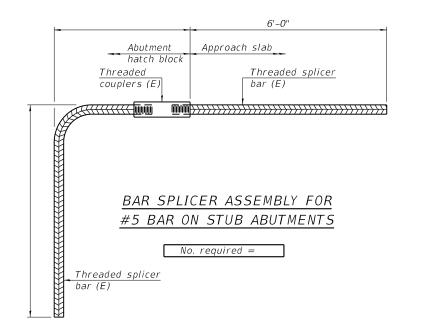

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2-17-2017

050-1	2-17-2017						
ORIGINAL: UPDATED:	JOB =	DESIGNED - AAN MTH	REVISED -		BAR SPLICER ASSEMBLY AND MECHANICAL SPLICER DETAILS	F.A.I. SECTION	COUNTY TOTAL SHEET
Cummins UPDATED:	FILE = 0840103-72J97-008-Splicer.dgn	CHECKED - MDC VPT	REVISED -	STATE OF ILLINOIS		55 (84-3-2) RS-2, BP, BDR	SANGAMON 98 60
CEC Engineering Consulting Engineer	DATE = 12/10/2018	DRAWN - SJS DAS	REVISED -	DEPARTMENT OF TRANSPORTATION	STRUCTURE NO. 084–0103		CONTRACT NO. 72J97
Civil and Structural Engineering		CHECKED - MDC MTH	REVISED -		SHEET NO. 8 OF 8 SHEETS	ILLINOIS FED. A	AID PROJECT

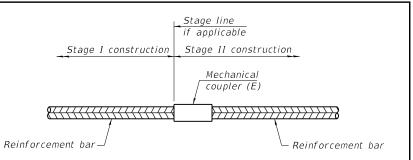


STANDARD MECHANICAL SPLICER

Location	Bar	No. assemblies
Location	size	required

<u>NOTES</u>

Splicer bars shall be deformed with threaded ends and have a minimum 60 ksi yield strength.

All reinforcement shall be lapped and tied to the splicer bars. Bar splicer assemblies shall be epoxy coated according to the requirements for reinforcement bars. See Section 508 of the Standard Specifications. See approved list of bar splicer assemblies and mechanical splicers for alternatives.

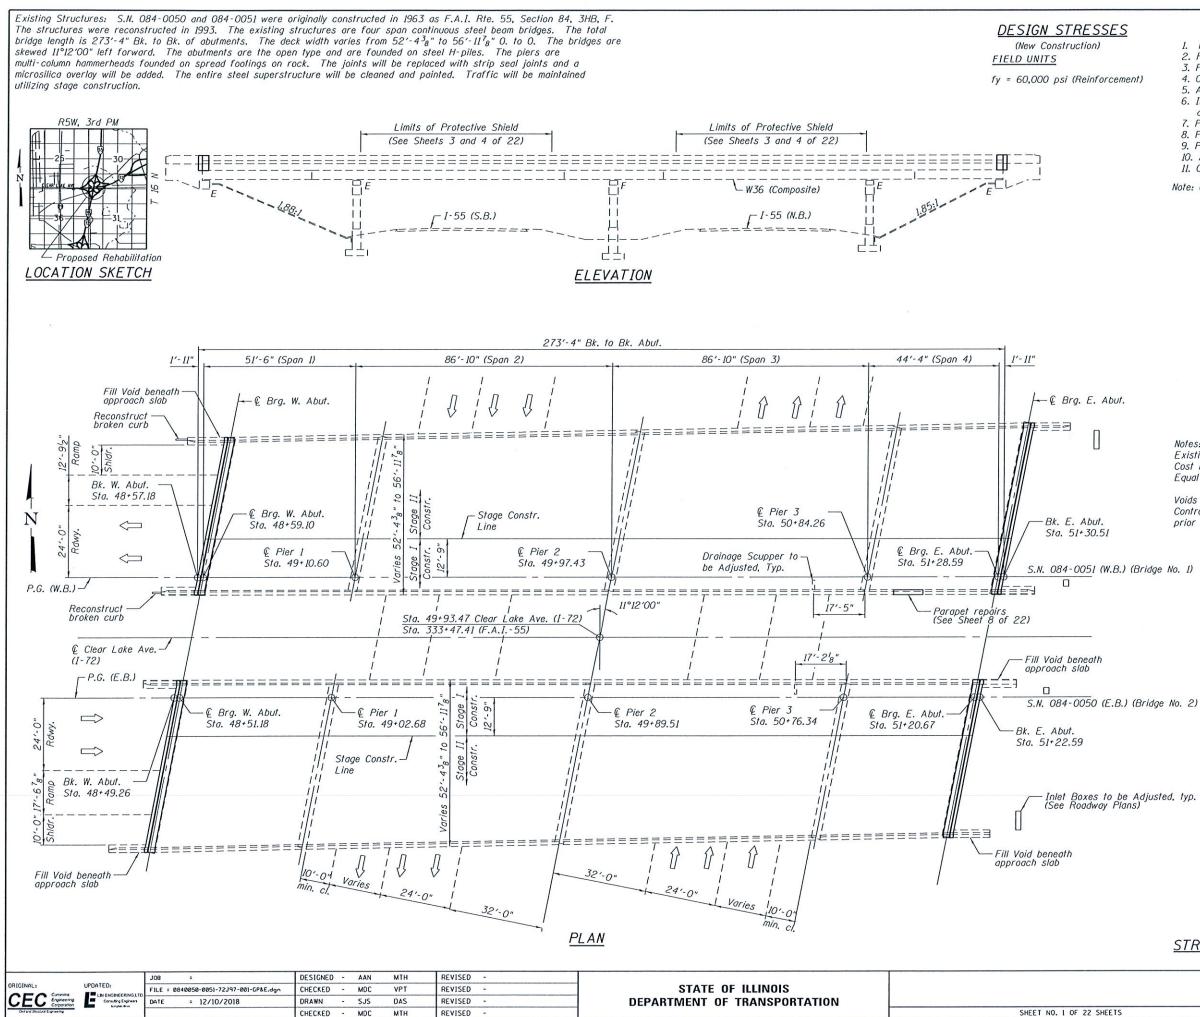

SCOPE OF WORK

- 1. Remove existing neoprene joints at Abutments.
- 2. Remove concrete near expansion joints at Abutments.
- 3. Perform bridge deck scarification.
- 4. Complete deck slab repairs.
- 5. Adjust drainage scuppers.
- 6. Install new concrete and strip seal expansion joints at both abutments.
- 7. Pour new microsilica concrete overlay.
- 8. Perform Diamond Grinding.
- 9. Perform bridge deck grooving on new deck surface. 10. Apply protective coat.
- 11. Clean and Paint Structural Steel

Note: Up to ${}^{l}_{4}$ " will be ground off the microsilica overlay.

INDEX OF SHEETS

1.	General Plan and Elevation
2.	General Data
3 4.	Deck Slab Repair Plan Details
5.	Adjusting Existing Scuppers
6 7.	Expansion Joint Replacement Details
8.	Parapet and Joint Replacement Details
9.	Preformed Joint Strip Seal
10.	Slopewall Repairs
11.	Bar Splicer Details
12 17.	Pier Crashwall Extension
1822.	Existing Plans

Notes:

Existing curbs shall be re-constructed as per the Engineer. Cost included with Structural Repair of Concrete (Depth Equal to or Less than 5 Inches).

Voids beneath the approach slab shall be filled with Controlled Low-Strength Material as directed by the Engineer. prior to Stage I Traffic being shifted.




12-11-2018 Milal J Date

Michael T. Haley Licensed Structural Engineer State of Illinois No. 81-5991 Expires 11/30/2020

<u>GENERAL PLAN AND ELEVATION</u>
F.A.P. 67 OVER F.A.I. 55
<u>SECTION (84-3-2) RS-2, BP, BDR</u>
SANGAMON COUNTY
<u>STRUCTURE NO. 084-0050 (EB) & 0051 (WB)</u>

	F.A.P. RTE.	SECTION	COUNTY	TOTAL	SHEET NO.
	67	(84-3-2) RS-2, BP, E	SOR SANGAMON CONTRAC	98 T NO 1	61
S		ILLINOIS F	ED. AID PROJECT	1 1102	2051

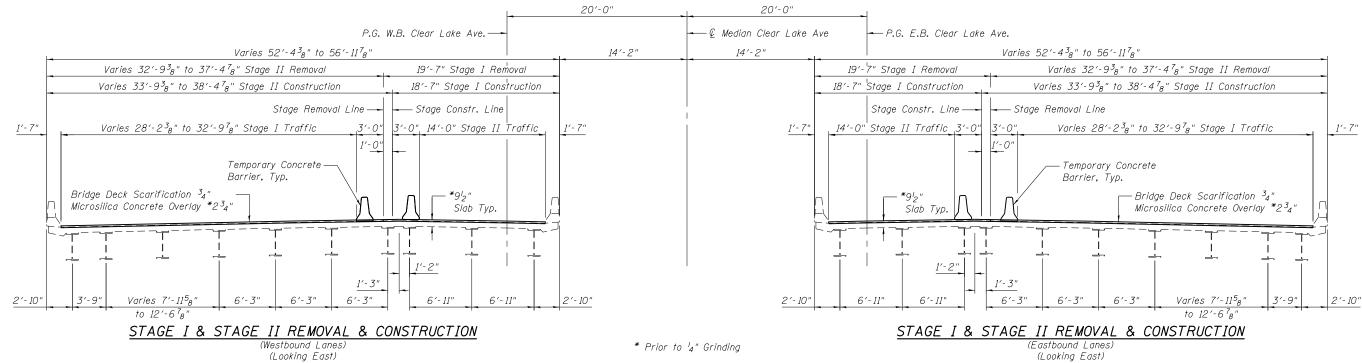

GENERAL NOTES


Reinforcement bars designated (E) shall be epoxy coated. Prior to pouring the new concrete deck, all heavy or loose rust, loose mill scale, and other loose or potentially detrimental foreign material shall be removed from the surfaces in contact with concrete. Tightly adhered paint may remain unless otherwise noted. Removal shall be accomplished by methods that will not damage the steel and the cost will be included in the pay item covering removal of the existing concrete.

Plan dimensions and details relative to existing plans are subject to nominal construction variations. The Contractor shall field verify existing dimensions and details affecting new construction and make necessary approved adjustments prior to construction or ordering of materials. Such variations shall not be cause for additional compensation for a change in scope of the work, however, the Contractor will be paid for the quantity actually furnished at the unit price bid for the work.

The existing structural steel coating contains lead. The Contractor shall take appropriate precautions to deal with the presence of lead on this project.

Cleaning and painting of the existing structural steel shall be as specified in the special provision for "Cleaning and Painting Existing Steel Structures". All existing steel shall be cleaned per Near White Blast Cleaning - SSPC-SP10. All existing steel cleaned shall be painted according to the requirements of Paint System 1-0Z/E/U. The color of the final finish coat for all interior steel surfaces shall be Gray, Munsell No 5B 7/1. The color of the final finish coat for the exterior and bottom flange of the fascia beams shall be Interstate Green, Munsell No 7.5G 4/8.

Synthetic fibers shall be added to the Bridge Deck Microsilica Concrete Overlay. See Special Provisions.

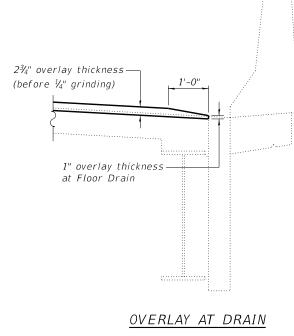


ITEM	UNIT	SN 084-0050	SN 084-0051	TOTA
Concrete Removal	Cu. Yd.	17.7	18.3	36.0
Protective Shield	Sq. Yd.	759	759	1,518
Concrete Structures	Cu. Yd.	23.8	23.8	47.6
Concrete Superstructure	Cu. Yd.	19.7	21.3	41.0
Bridge Deck Grooving (Longitudinal)	Sq. Yd.	1,491	1,491	2,98
Reinforcement Bars, Epoxy Coated	Pound	4,820	4,810	9,63
Bar Splicers	Each	24	24	48
Preformed Joint Strip Seal	Foot	109	109	218
Controlled Low-Strength Material	Cu. Yd.	4.5	1.5	6.0
Containment and Disposal of Lead Paint Cleaning Residues No. 1	L. Sum	1	-	1
Containment and Disposal of Lead Paint Cleaning Residues No. 2	L. Sum	-	1	1
Cleaning and Painting Steel Bridge No. 1	L. Sum	1	-	1
Cleaning and Painting Steel Bridge No. 2	L. Sum	-	1	1
Bridge Deck Scarification ³ 4"	Sq. Yd.	1,527	1,527	3,05
Bridge Deck Microsilica Concrete Overlay 2 3/4"	Sq. Yd.	1,527	1,527	3,05
Structural Repair of Concrete (Depth Equal to or Less than 5 Inches)	Sq. Ft.	28	16	44
Deck Slab Repair (Full Depth Type I)	Sq. Yd.	0.9	0.6	1.5
Deck Slab Repair (Full Depth Type II)	Sq. Yd.	26.0	42.2	68.2
Drainage Scupper to be Adjusted	Each	1	1	2
Diamond Grinding (Bridge Section)	Sq. Yd.	1,441	1,441	2,88
Slope Wall Slurry Pumping	Cu. Yd.	27.2	0	27.2
Protective Coat	Sq. Yd.	1,775	1,775	3,55

deck slab including new concrete adjacent to expansion joints.

ODICINAL		JOB =	DESIGNED - AAN	мтн	REVISED -		GENERAL DATA	F.A.P.	SECTION	COUNTY	TOTAL SHEET
	UPDATED:	FILE = 0840050-0051-72J97-002-Stage.dgn	CHECKED - MDC	VPT	REVISED -	STATE OF ILLINOIS	STRUCTURE NO. 084–0050 (EB) & 0051 (WB)	67 0	(84-3-2) RS-2, BP, BDR	SANGAMON	98 62
	Consulting Engineers Sertigids These	DATE = 12/10/2018	DRAWN - SJS	DAS	REVISED -	DEPARTMENT OF TRANSPORTATION				CONTRAC	T NO. 72J97
Civil and Structural Engineering			CHECKED - MDC	MTH	REVISED -		SHEET NO. 2 OF 22 SHEETS		ILLINOIS FED. AI	ID PROJECT	

TOTAL BILL OF MATERIAL

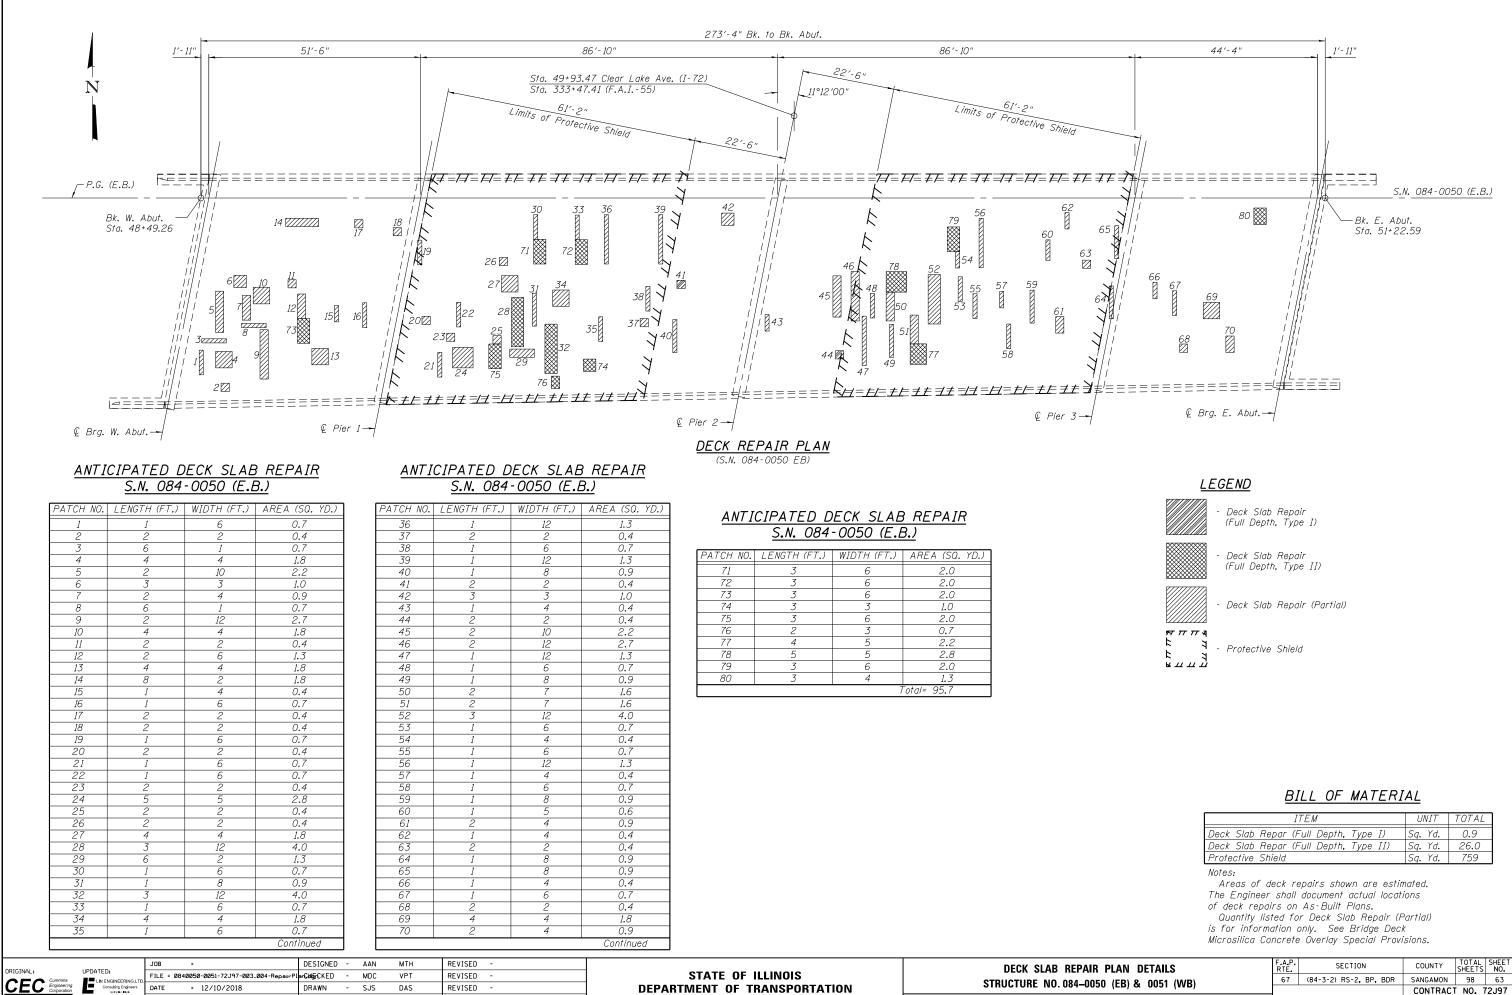


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REVISED

SHEET NO. 3 OF 2

ITEM	UNIT	TOTAL
Deck Slab Repar (Full Depth, Type I)	Sq. Yd.	0.9
Deck Slab Repar (Full Depth, Type II)	Sq. Yd.	26.0
Protective Shield	Sq. Yd.	759

PLAN DETAILS	F.A.P. RTE	SECTION	COUNTY	TOTAL SHEETS	SHEET NO.	
0 (EB) & 0051 (WB)	67	(84-3-2) RS-2, BP, BDR	SANGAMON	98	63	
			CONTRACT	NO. 7	'2J97	
22 SHEETS	ILLINOIS FED. AID PROJECT					

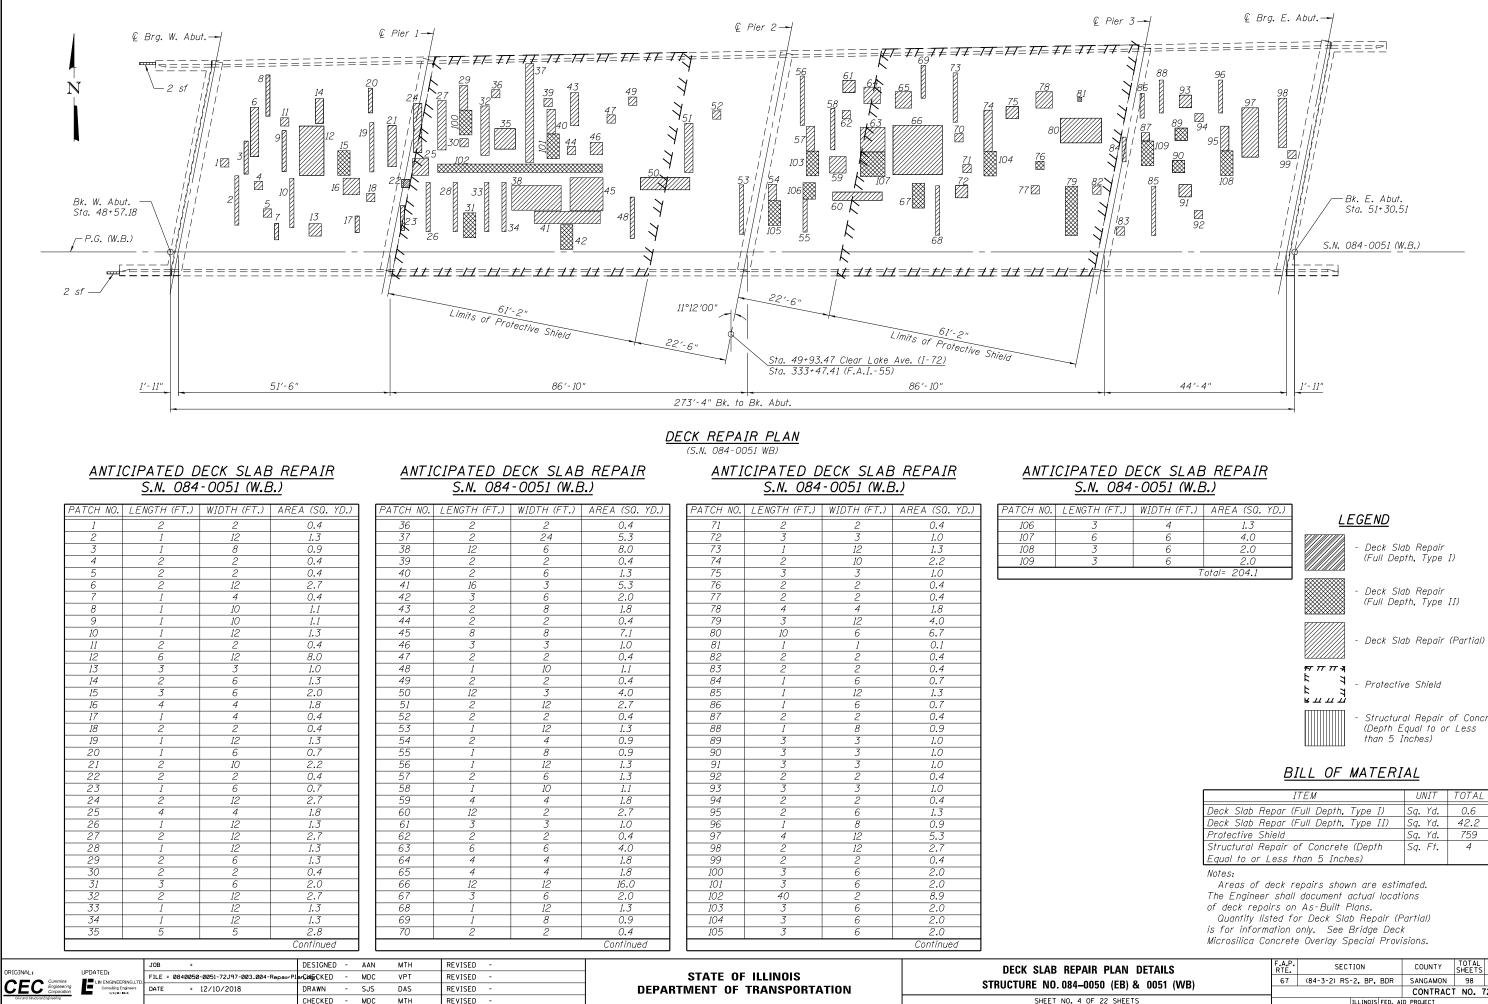


(FT.)	WIDTH (FT.)	AREA (SQ. YD.)
	4	1.3
	6	4.0
	6	2.0
	6	2.0
	7	otal= 204.1

- Structural Repair of Concrete (Depth Equal to or Less

ITEM	UNIT	TOTAL
Deck Slab Repar (Full Depth, Type I)	Sq. Yd.	0.6
Deck Slab Repar (Full Depth, Type II)	Sq. Yd.	42.2
Protective Shield	Sq. Yd.	759
Structural Repair of Concrete (Depth	Sq. Ft.	4
Equal to or Less than 5 Inches)		

PLAN DETAILS	F.A.P. RTE.	SECTION	COUNTY	TOTAL SHEETS	SHEET NO.
0 (EB) & 0051 (WB)	67	(84-3-2) RS-2, BP, BDR	SANGAMON	98	64
			CONTRACT	NO. 7	2J97
22 SHEETS	ILLINOIS FED. AID PROJECT				

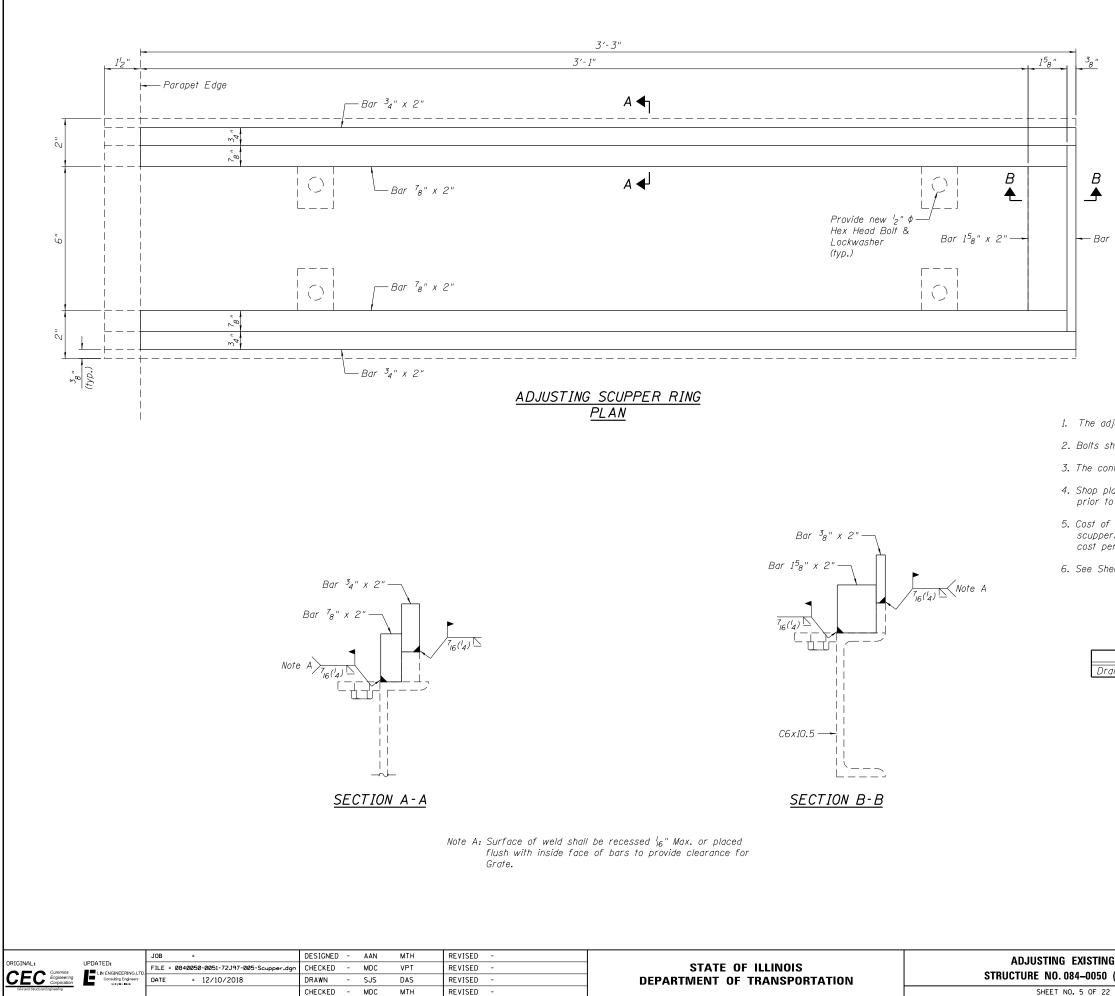

- Bar ³8" x 2"

NOTES:

1. The adjusting scupper ring shall be galvanized.

2. Bolts shall be l_2 " ϕ , AASHTO M164 Type I, mechanically galvanized.

3. The contractor shall ensure that no damage is done to existing grates to be reused.

4. Shop plans for proposed adjusting scupper ring shall be submitted for approval prior to fabrication.


5. Cost of all labor and materials necessary to remove existing grates, clean existing scuppers, install adjusting scupper rings and reinstalling grates is included in the cost per unit each for Drainage Scupper to be Adjusted.


6. See Sheet 1 of 22 for Scupper locations.

BILL OF MATERIAL


ITEM	UNIT	TOTAL
rainage Scupper to be Adjusted	Each	2

NG SCUPPERS	F.A.P. RTE	SECTION	COUNTY	TOTAL SHEETS	SHEET NO.
0 (EB) & 0051 (WB)	67	(84-3-2) RS-2, BP, BDR	SANGAMON	98	65
0 (EB) & 0031 (WB)			CONTRACT	NO. 7	2J97
22 SHEETS	ILLINOIS FED. AID PROJECT				

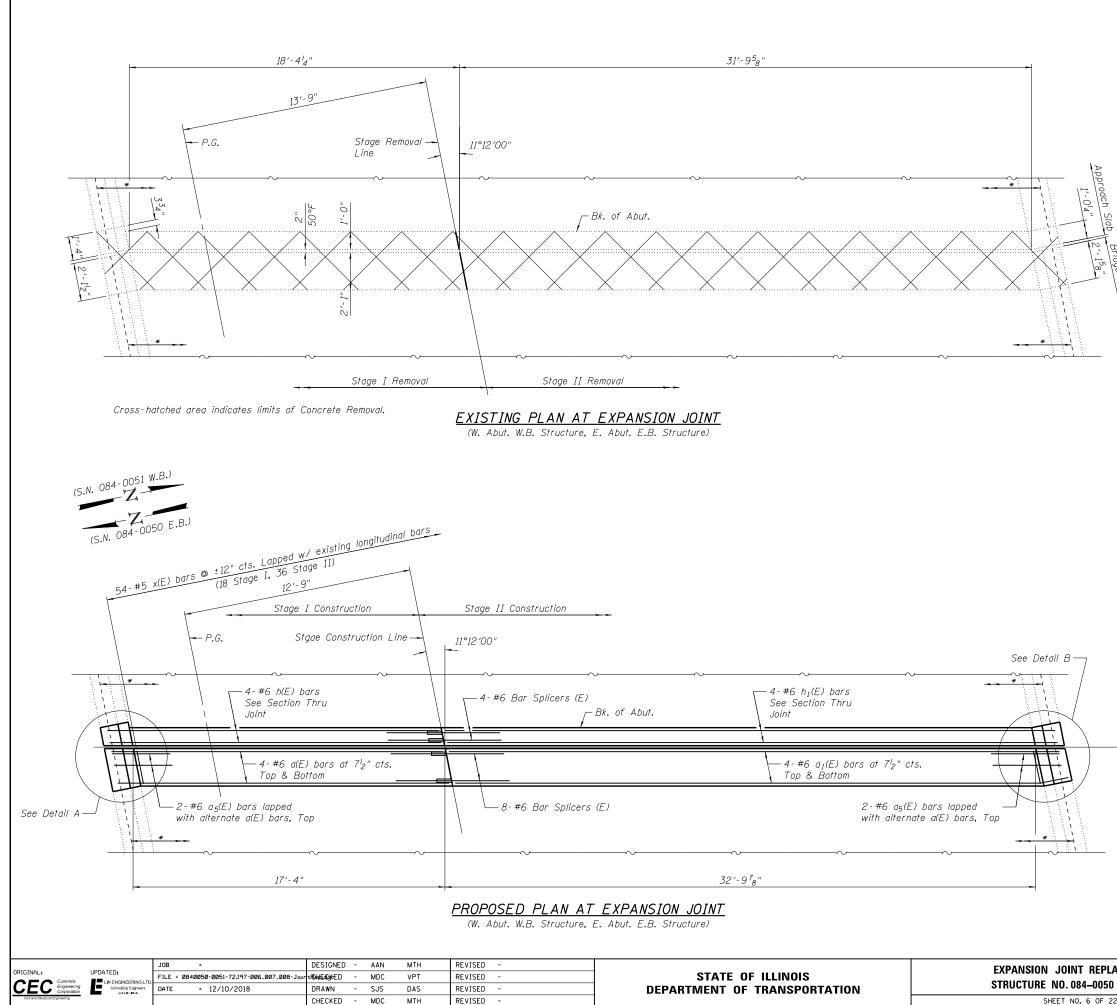


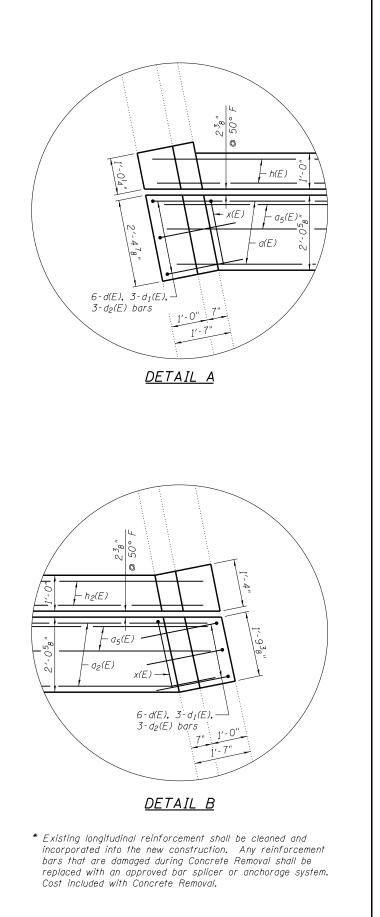


ACEMENT DETAILS	F.A.P. RTE	SECTION	COUNTY	TOTAL SHEETS	SHEET NO.
D (EB) & 0051 (WB)	67	(84-3-2) RS-2, BP, BDR	SANGAMON	98	66
			CONTRACT	NO. 7	72J97
22 SHEETS	ILLINOIS FED. AID PROJECT				

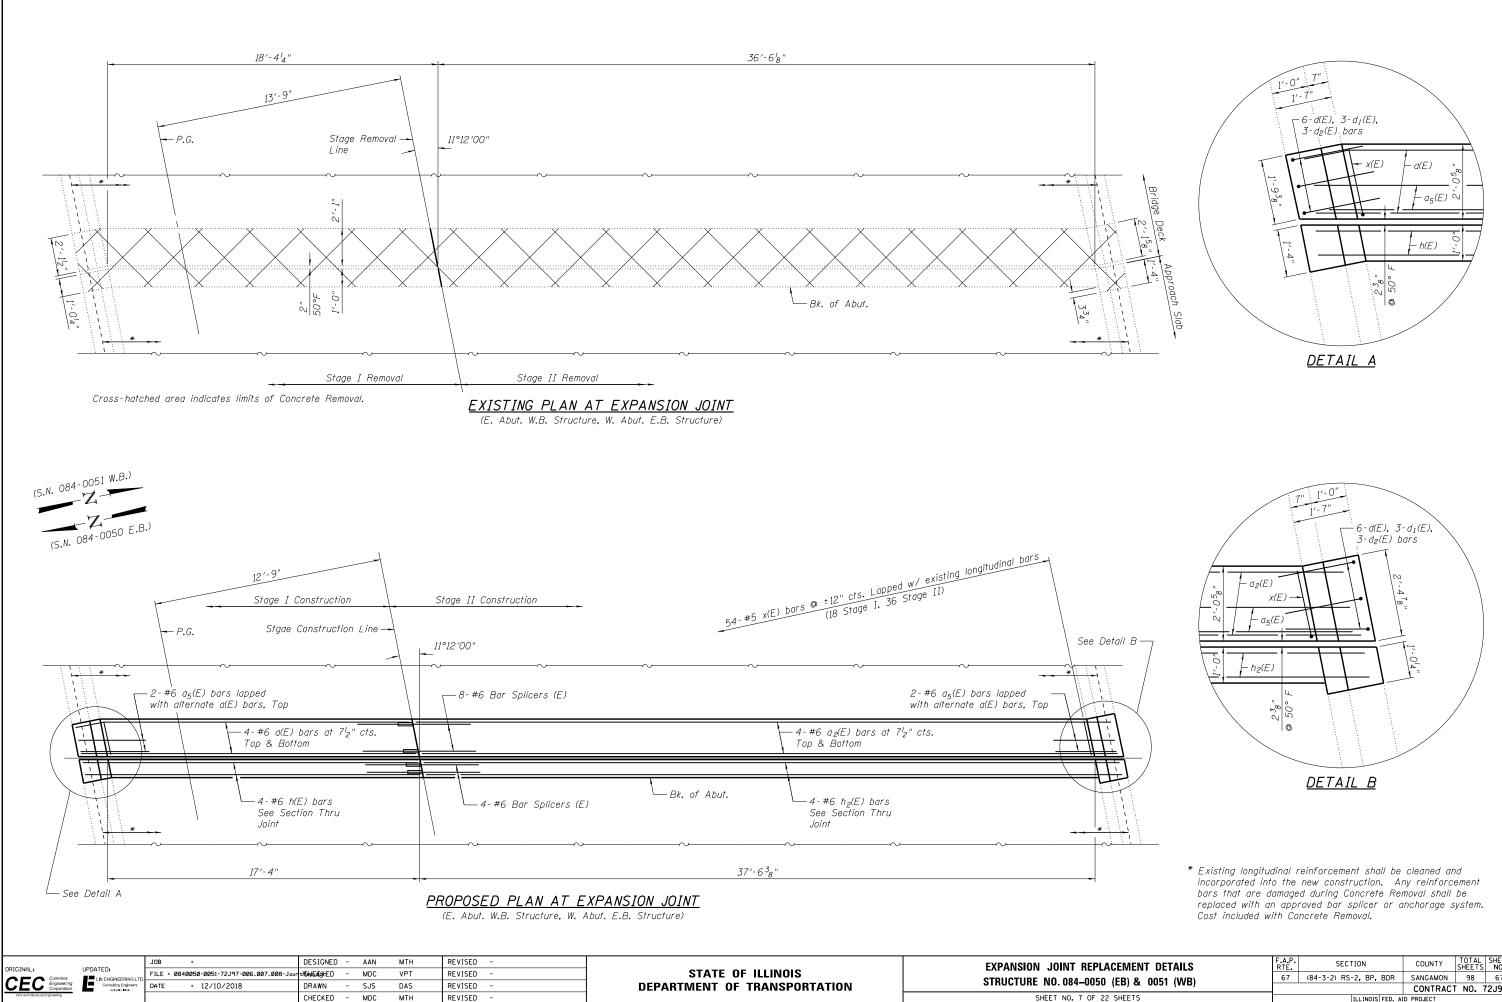

ACEMENT DETAILS	F.A.P. RTE	SECTION	COUNTY	TOTAL SHEETS	SHEET NO.
0 (EB) & 0051 (WB)	67	(84-3-2) RS-2, BP, BDR	SANGAMON	98	67
			CONTRACT	NO. 7	2J97
22 SHEETS	ILLINOIS FED. AID PROJECT				

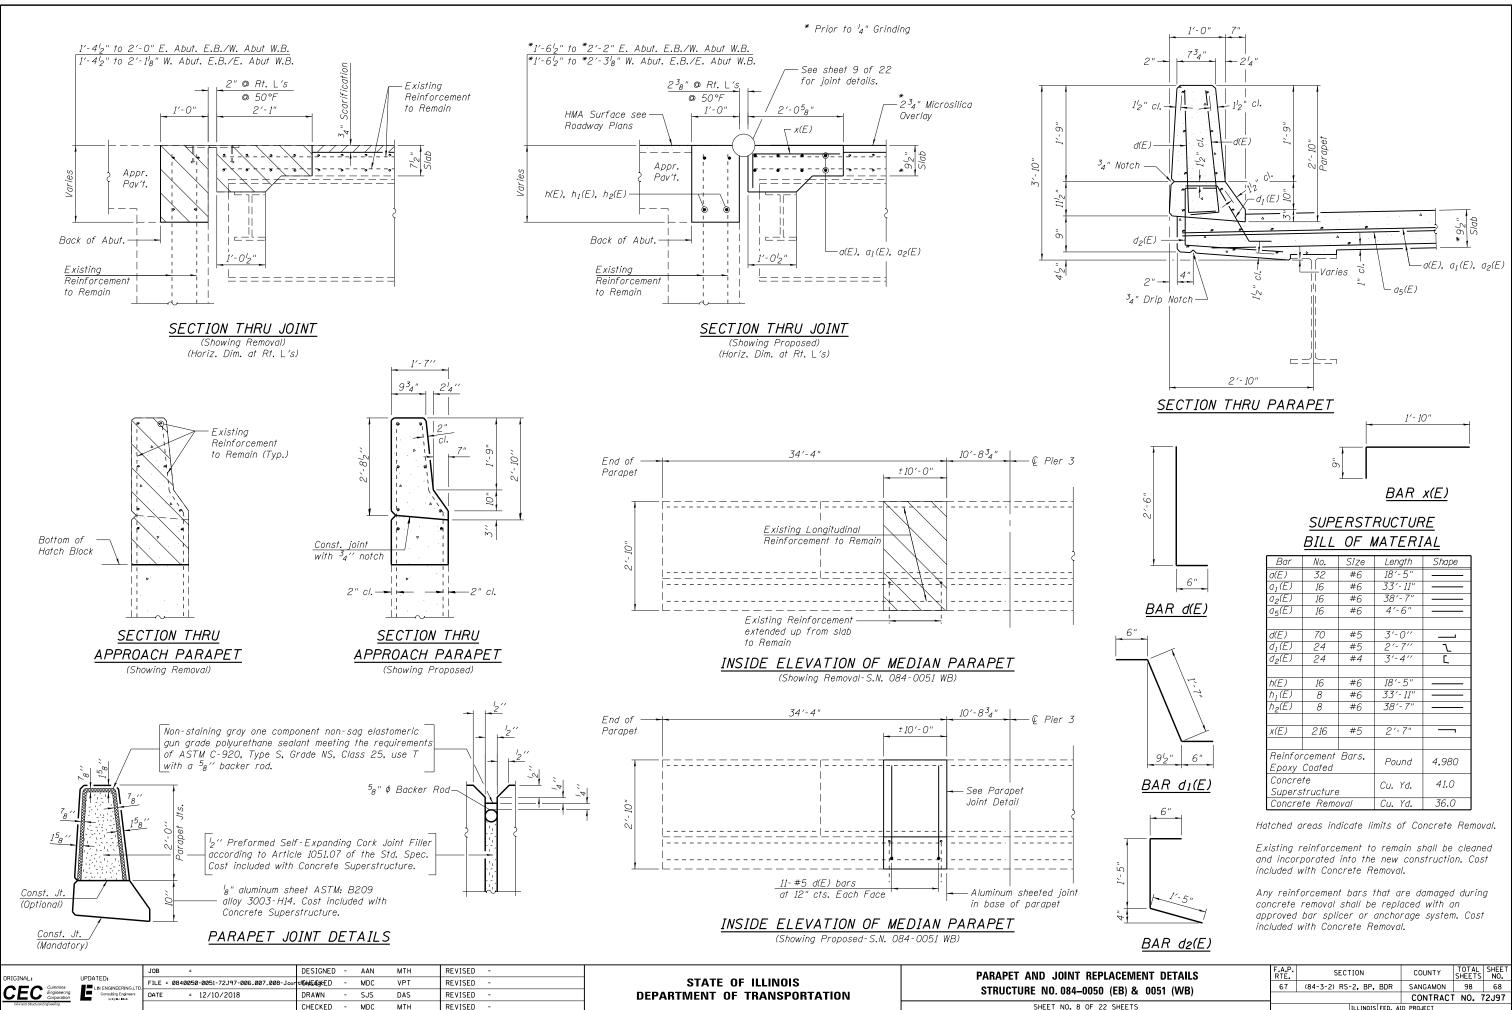

PLACEMENT DETAILS	F.A.P. RTE.	SECTION	COUNTY	TOTAL SHEETS	SHEET NO.
) (EB) & 0051 (WB)	67	(84-3-2) RS-2, BP, BDR	SANGAMON	98	68
			CONTRACT	NO.	72J97
2 SHEETS		ILLINOIS FED. A	ID PROJECT		

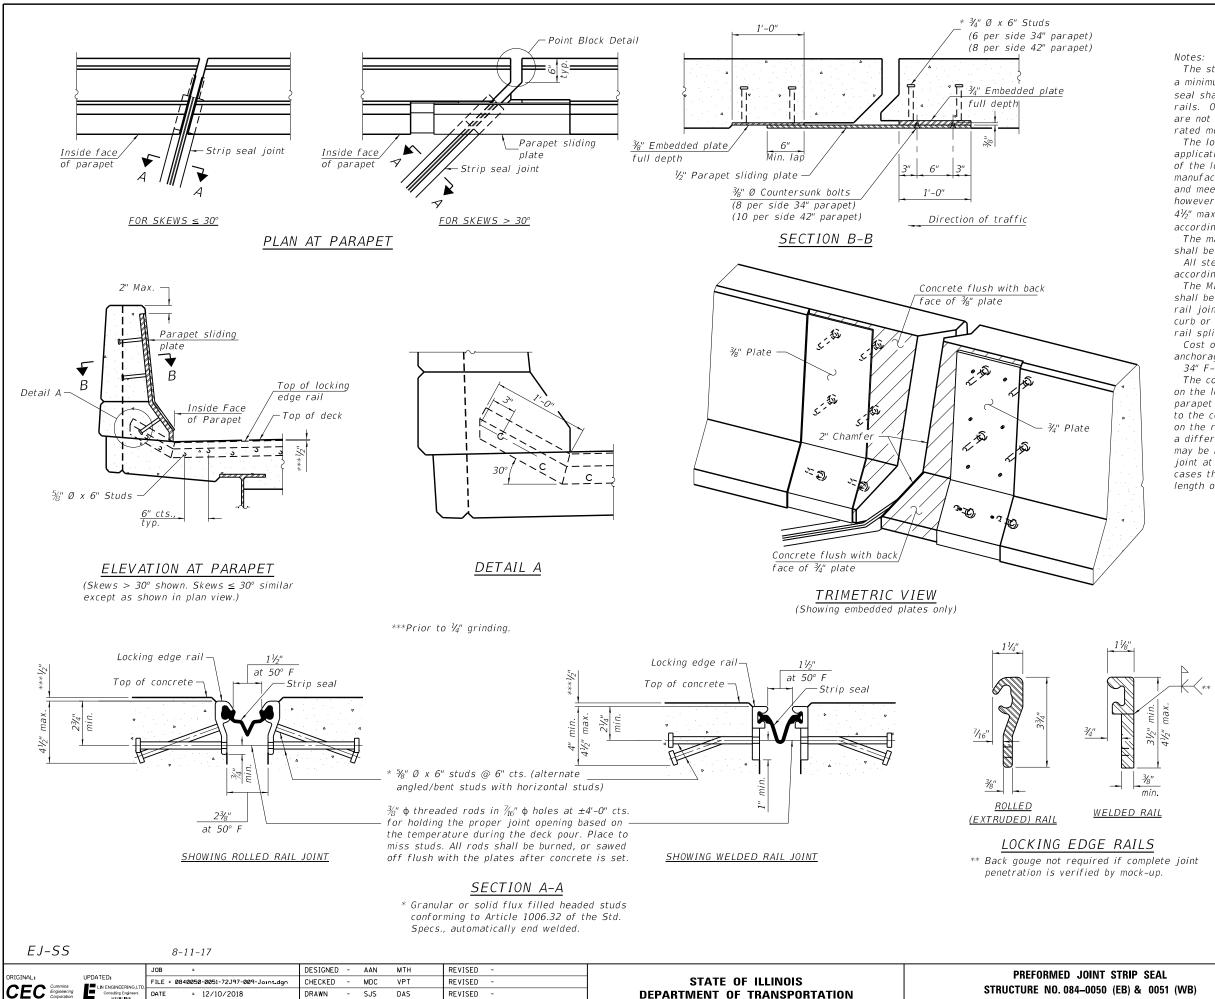

MTH

REVISED

SHEET NO. 9 OF 22

The strip seal shall be made continuous and shall have a minimum thickness of $\frac{1}{4}$ ". The configuration of the strip seal shall match the configuration of the locking edge rails. Open or "webbed" strip seal gland configurations are not permitted. The gland shall be sized for a maximum rated movement of 4 inches.

The locking edge rails depicted are configured for typical applications and are conceptual only. The actual configuration of the locking edge rails and matching strip seal may vary from manufacturer to manufacturer provided they fit the application and meet the minimum anchorage shown. Flanged edge rails, however, will not be allowed. Locking edge rails may exceed the $4 \ensuremath{\mathcal{V}}_{\!\!2}{}''$ maximum depth provided the anchorage system is revised according to the manufacturer's recommendation.


The manufacturer's recommended installation methods shall be followed.

All steel components shall be galvanized after fabrication according to Article 520.03 of the Standard Specifications.

The Maximum space between locking edge rail segments shall be $\frac{3}{16}$ " and sealed with a suitable sealant; however, any rail joint within 10' measured perpendicular to the face of the curb or parapet shall be welded as shown in the locking edge rail splice detail.

Cost of parapet sliding plates, embedded plates, and anchorage studs included with Preformed Joint Strip Seal.

34" F-shape barrier shown, 42" F-shape similar as noted. The concrete opening below the strip seal will vary based on the locking edge rail chosen by the Contractor. Deck and parapet lengths shown elsewhere in the plans are dimensioned to the concrete opening, not the joint opening, and are based on the rolled locking edge rail. If the Contractor elects to use a different locking edge rail, dimensional adjustments may be required. One exception to this would be the strip seal joint at the end of the precast bridge approach slab. For these cases the pavement connector length shall be adjusted, not the length of the bridge approach slab.

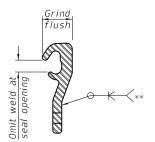


LOCKING EDGE RAIL SPLICE

The inside of the locking edge rail groove shall be free of weld residue. Rolled rail shown, welded rail similar.

BILL OF MATERIAL

Item	Unit	Total
Preformed Joint Strip Seal	Foot	218

STRIP SEAL		SECTION	COUNTY	TOTAL SHEETS	SHEET NO.		
0 (EB) & 0051 (WB)	67	(84-3-2) RS-2, BP, BDR	SANGAMON	98	69		
	CONTRACT NO. 72J97						
22 SHEETS	ILLINOIS FED. AID PROJECT						

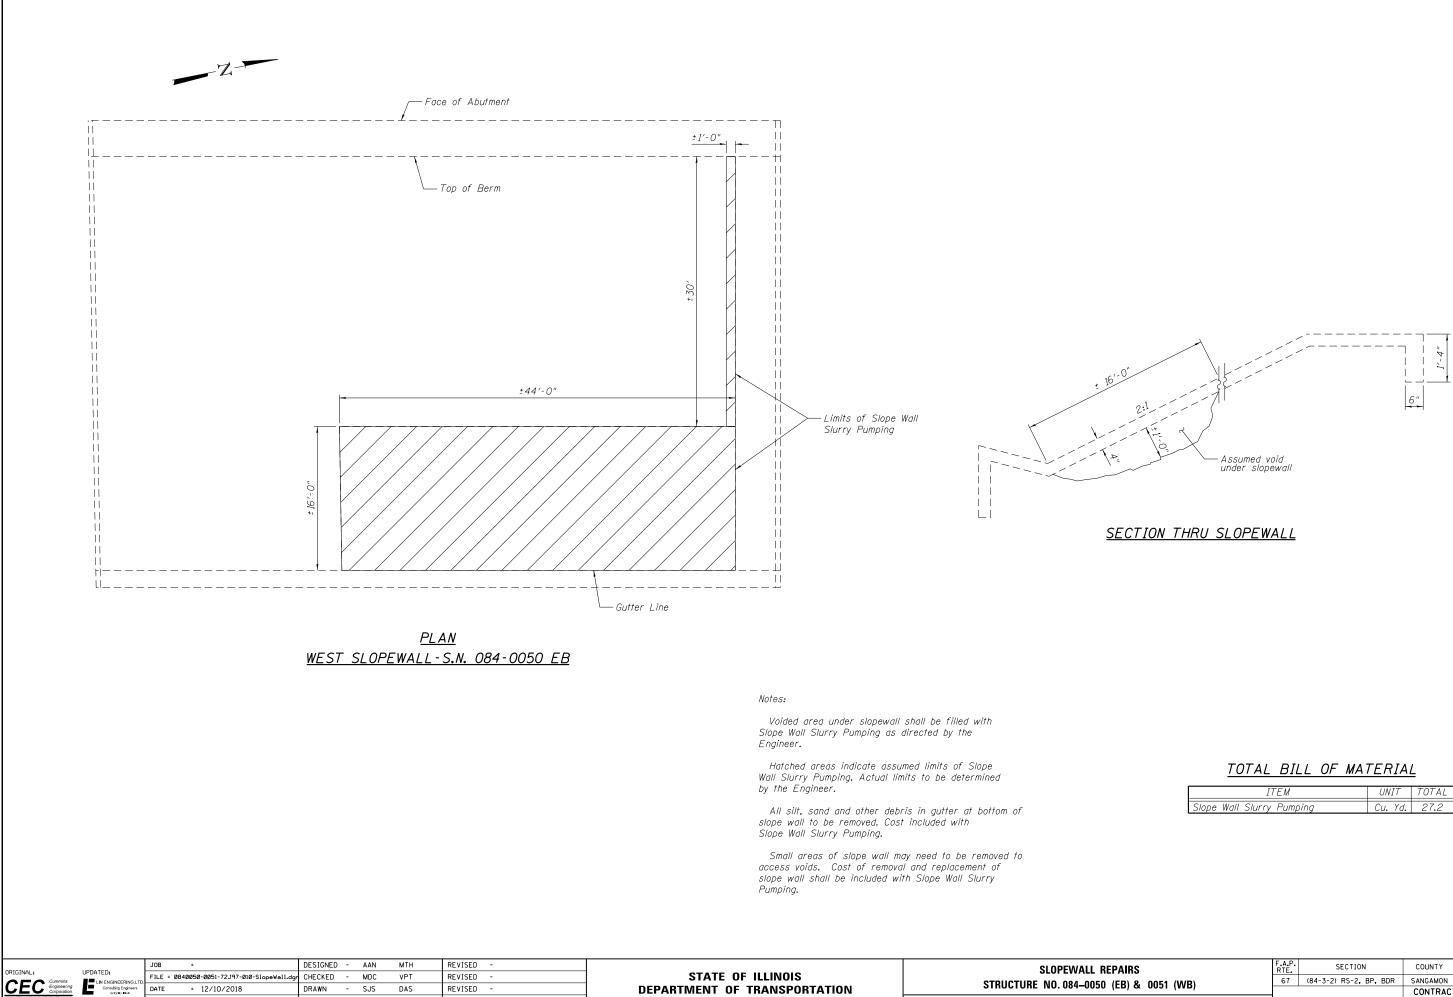


MTH

REVISED

ITEM	UNIT	TOTAL
Slope Wall Slurry Pumping	Cu. Yd.	27.2


REPAIRS		SECTION	COUNTY	TOTAL SHEETS	SHEET NO.	
i0 (EB) & 0051 (WB)	67	(84-3-2) RS-2, BP, BDR	SANGAMON	98	70	
	CONTRACT NO. 72J97					
22 SHEETS	ILLINOIS FED. AID PROJECT					

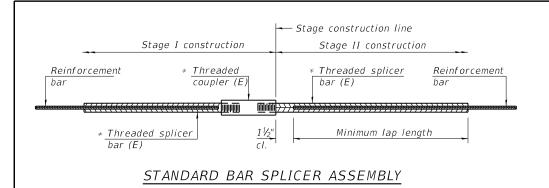

Threaded splicer bar length = min. lap length + $1\frac{1}{2}$ " + thread length

* Epoxy not required on Bar Splicer Assembly components used in conjunction with black bars.


Location	Bar	No. assemblies	Minimum
Eccation	size	required	lap length
Hatch Block	#6	16	4'-0"
End of Deck	#6	32	3′-7″

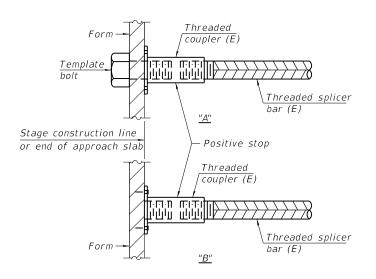

INSTALLATION AND SETTING METHODS

"A" : Set bar splicer assembly by means of a template bolt. "B" : Set bar splicer assembly by nailing to wood forms or


cementing to steel forms. (E) : Indicates epoxy coating.

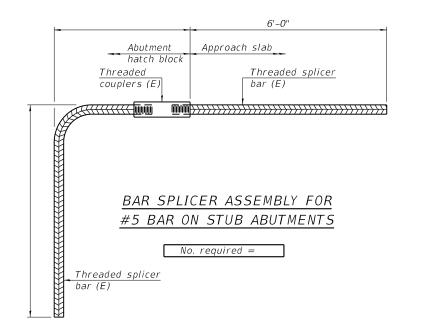

BSD-1

2-17-2017

		2-17-2017											
	JPDATED:	JOB =	DESIGNED -	AAN	MTH	REVISED -		BAR SPLICER ASSEMBLY AND MECHANICAL SPLICER DETAILS	F.A.P. RTF.	SECTION	COUNTY	TOTAL SHEETS	SHEET NO.
		FILE = 0840050-0051-72J97-011-Splicer.dgn	CHECKED -	MDC	VPT	REVISED -	STATE OF ILLINOIS		67	(84-3-2) RS-2, BP, BDR	SANGAMON	98	71
	Consulting Engineers	DATE = 12/10/2018	DRAWN -	SJS	DAS	REVISED -	DEPARTMENT OF TRANSPORTATION	STRUCTURE NO.084-0050 (EB) & 0051 (WB)			CONTRACT	T NO. 7	/2J97
Civil and Structural Engineering			CHECKED -	MDC	MTH	REVISED -		SHEET NO. 11 OF 22 SHEETS		ILLINOIS FED. AID PROJECT			

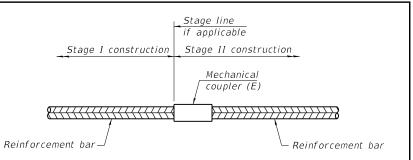


STANDARD MECHANICAL SPLICER

Location	Bar size	No. assemblies required

NOTES

Splicer bars shall be deformed with threaded ends and have a minimum 60 ksi yield strength.


All reinforcement shall be lapped and tied to the splicer bars. Bar splicer assemblies shall be epoxy coated according to the requirements for reinforcement bars. See Section 508 of the Standard Specifications. See approved list of bar splicer assemblies and mechanical splicers for alternatives.

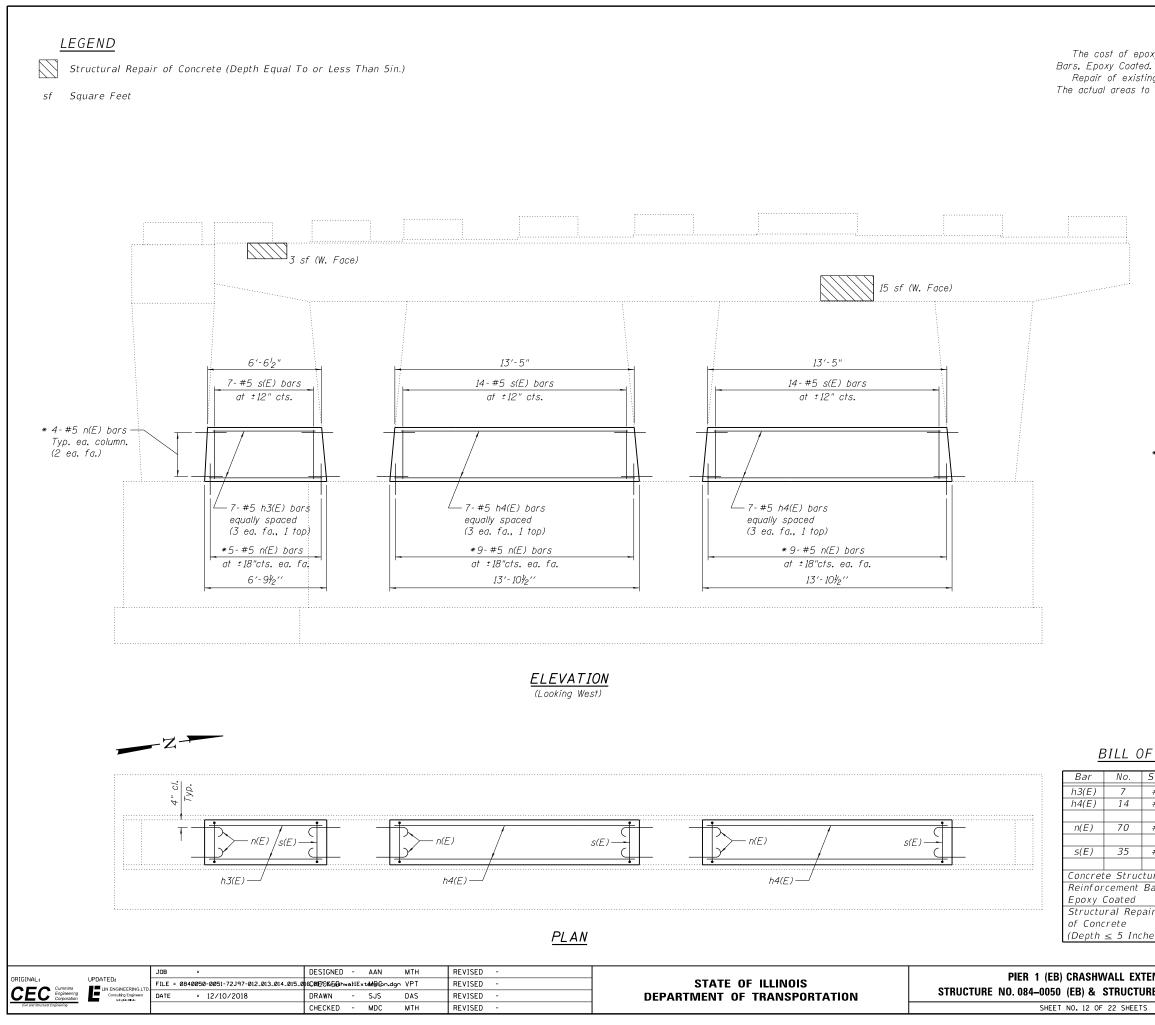

<u>NOTES</u>

The cost of epoxy grouting threaded rods shall be included with Reinforcement


Repair of existing piers shall include but may not be limited to the areas shown. The actual areas to be repaired shall be determined by the Engineer at time of construction.

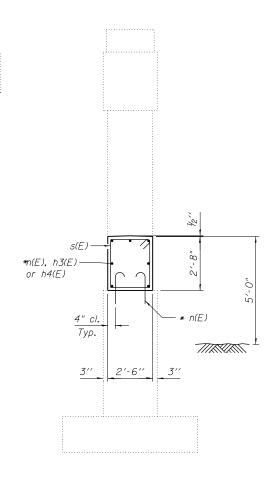


* Epoxy grout n(E) bars in 9" min. holes according to Article 584 of the Standard Specifications.

BILL OF MATERIAL

No.	Size	Length	Shape
7	#5	6'-1''	
14	#5	13'-1"	
70	#5	2'-5"	
35	#5	9'-11"	
Struc	tures	Cu.Yd.	8.4
ement Bars, pated		Pound	730
al Repair			
ete		Sq. Ft.	18
: 5 Inc	hes)		

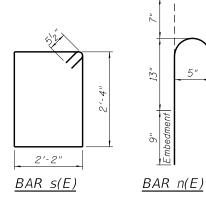


ALL EXTENSION		SECTION		COUNTY	TOTAL SHEETS	SHEET NO.
TRUCTURE NO. 084–0051 (WB)	67	(84-3-2) RS-2, BP	. BDR	SANGAMON	98	72
INUCIONE NO. 084-0031 (WB)				CONTRACT	T NO. 7	2J97
22 SHEETS		ILLINO	S FED. A	ID PROJECT		

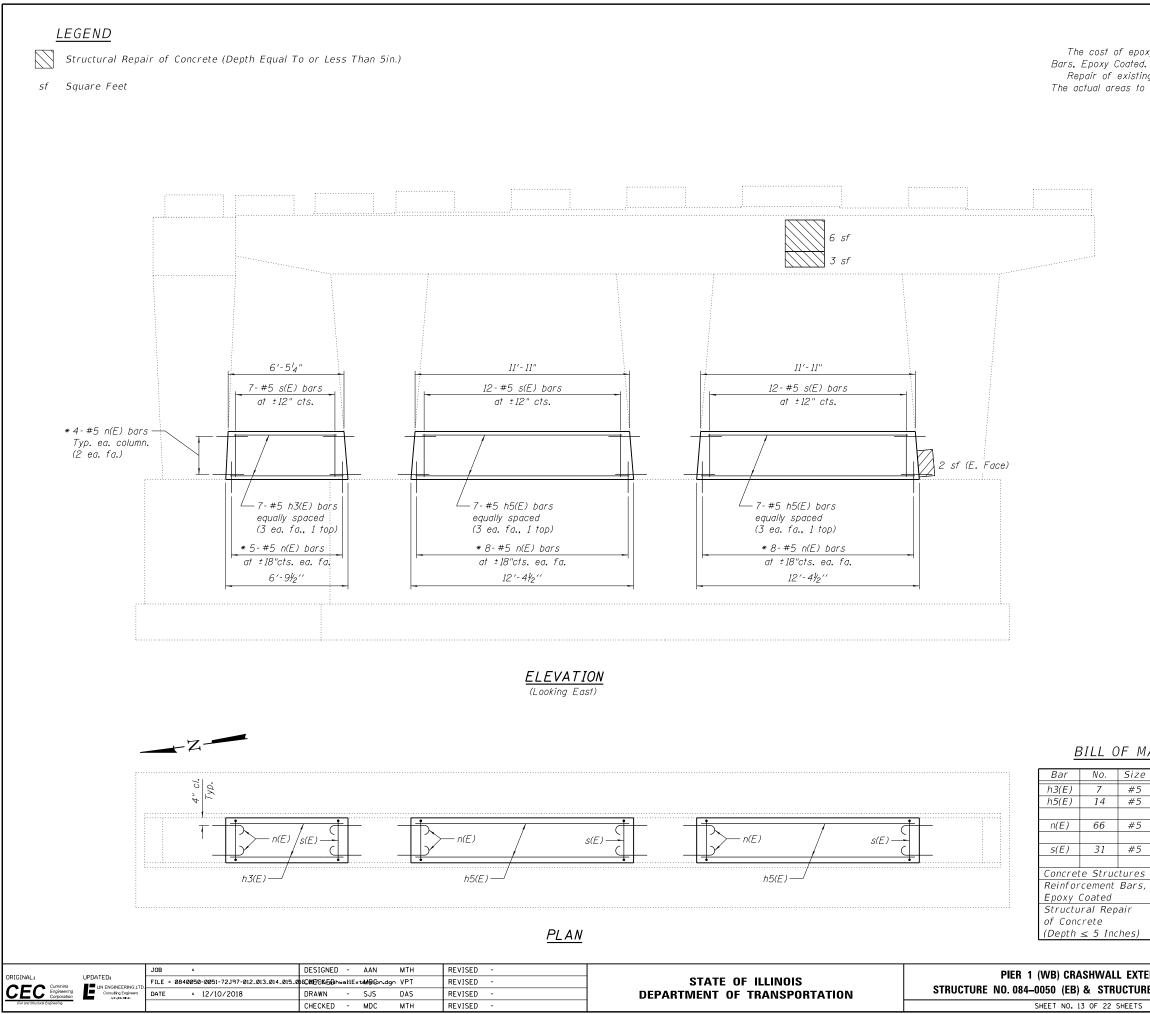


The cost of epoxy grouting threaded rods shall be included with Reinforcement

Repair of existing piers shall include but may not be limited to the areas shown. The actual areas to be repaired shall be determined by the Engineer at time of construction.

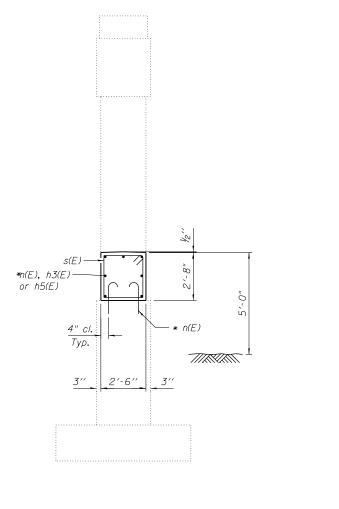


* Epoxy grout n(E) bars in 9" min. holes according to Article 584 of the Standard Specifications.

	Size	Length	Shape
	#5	6'-1"	
	#5	11'-7"	
	#5	2'-5"	
	#5	9'-11"	
°ис	tures	Cu.Yd.	7.6
nt	Bars,	Pound	700
d		Tound	,00
lep	air		
		Sq. Ft.	11
Inc	hes)		

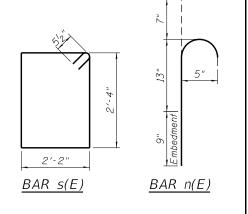



/ALL EXTENSION	F.A.P. RTE.	SECT	ION		COUNTY	TOTAL SHEETS	SHEET NO.
TRUCTURE NO. 084–0051 (WB)		67 (84-3-2) RS-2, BP, BDR		SANGAMON	98	73	
					CONTRACT	T NO. 7	2J97
22 SHEETS			ILLINOIS	FED. A	ID PROJECT		

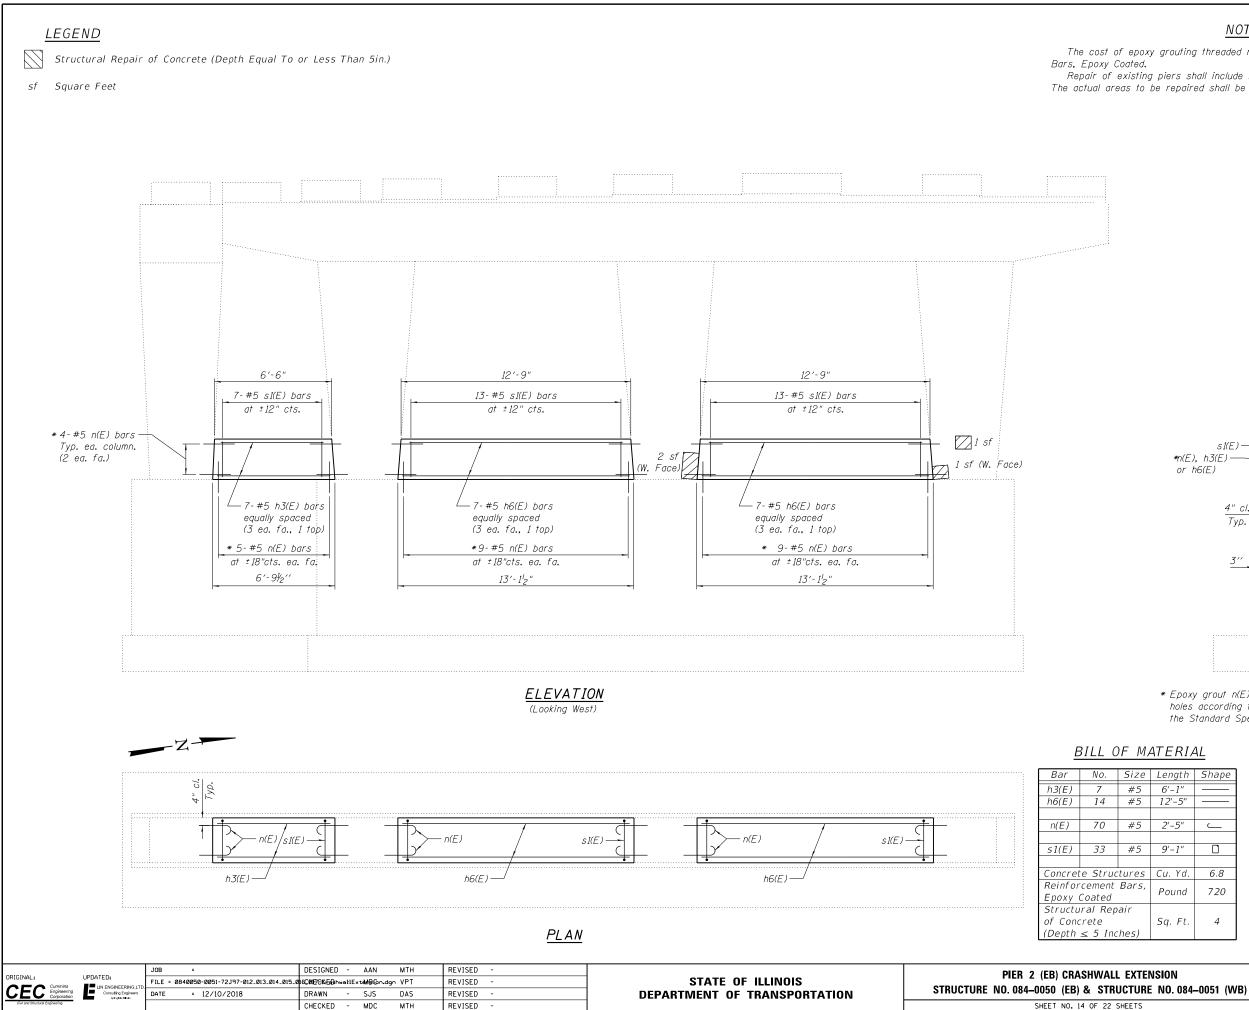

The cost of epoxy grouting threaded rods shall be included with Reinforcement


Repair of existing piers shall include but may not be limited to the areas shown. The actual areas to be repaired shall be determined by the Engineer at time of construction.

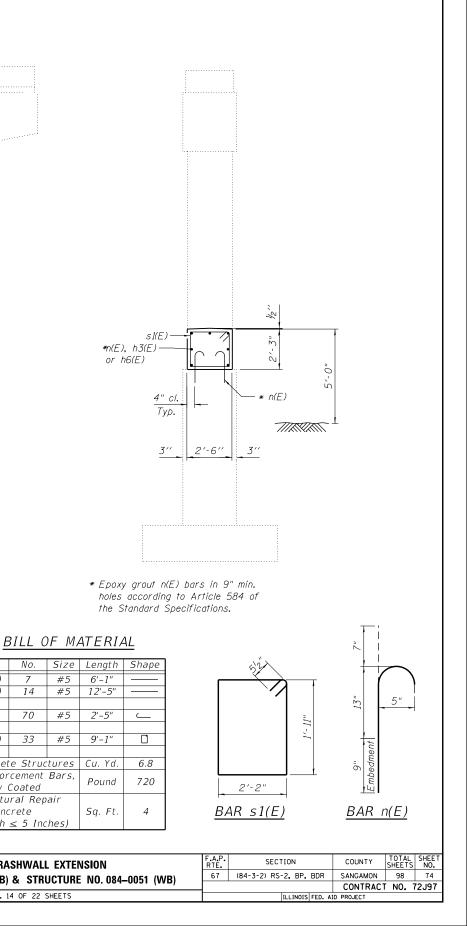


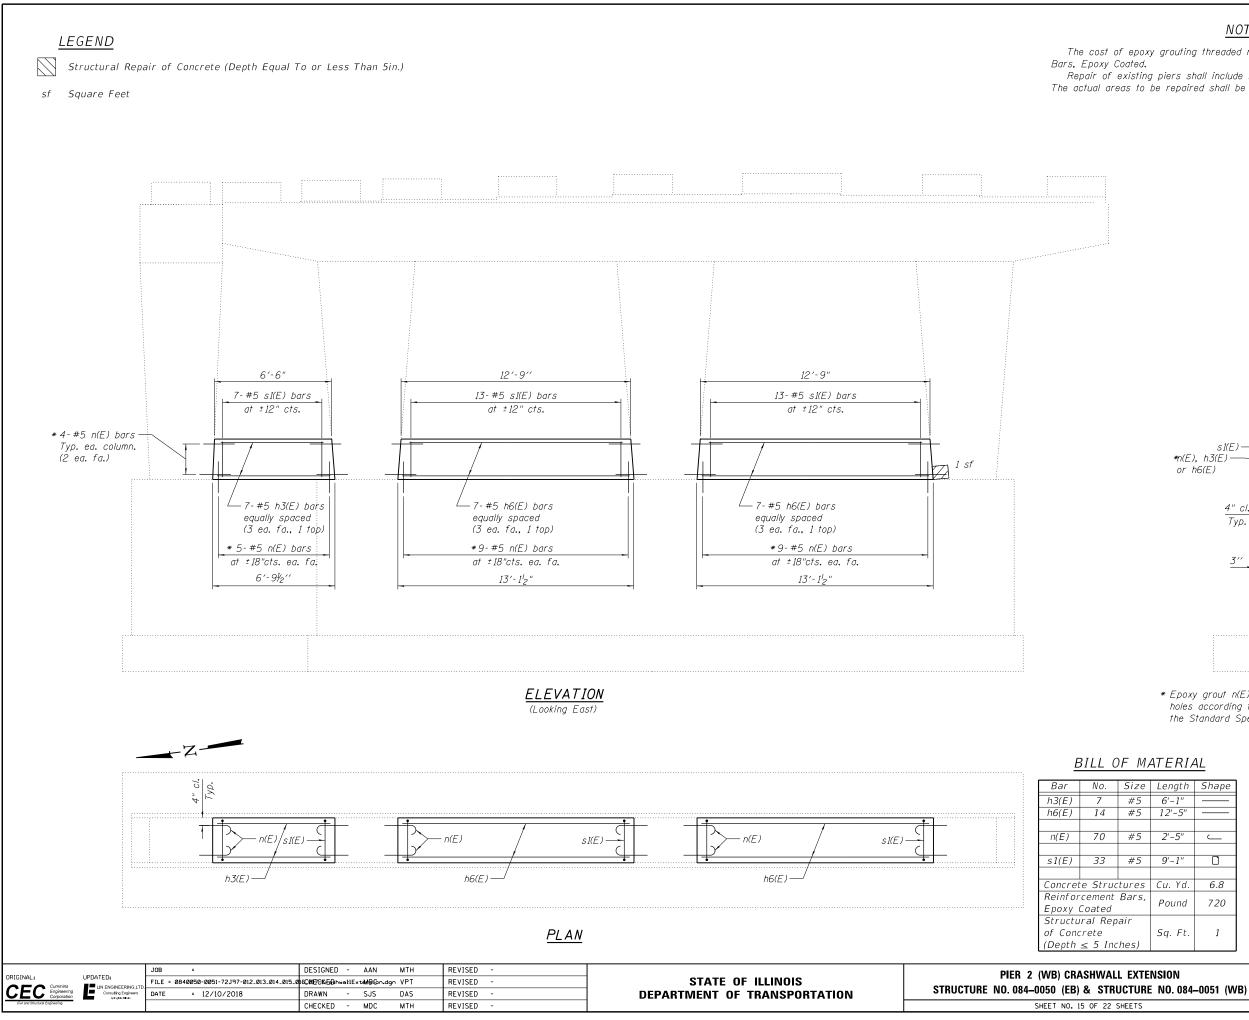

The cost of epoxy grouting threaded rods shall be included with Reinforcement


Repair of existing piers shall include but may not be limited to the areas shown. The actual areas to be repaired shall be determined by the Engineer at time of construction.

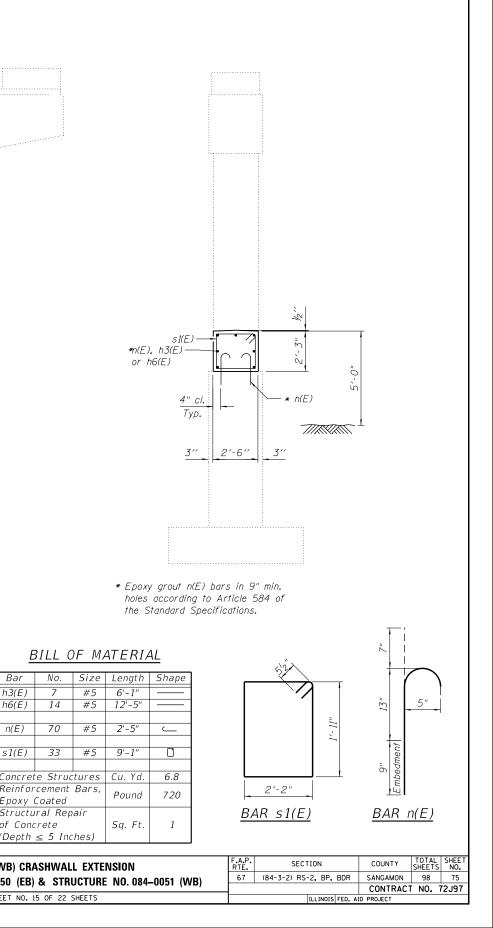

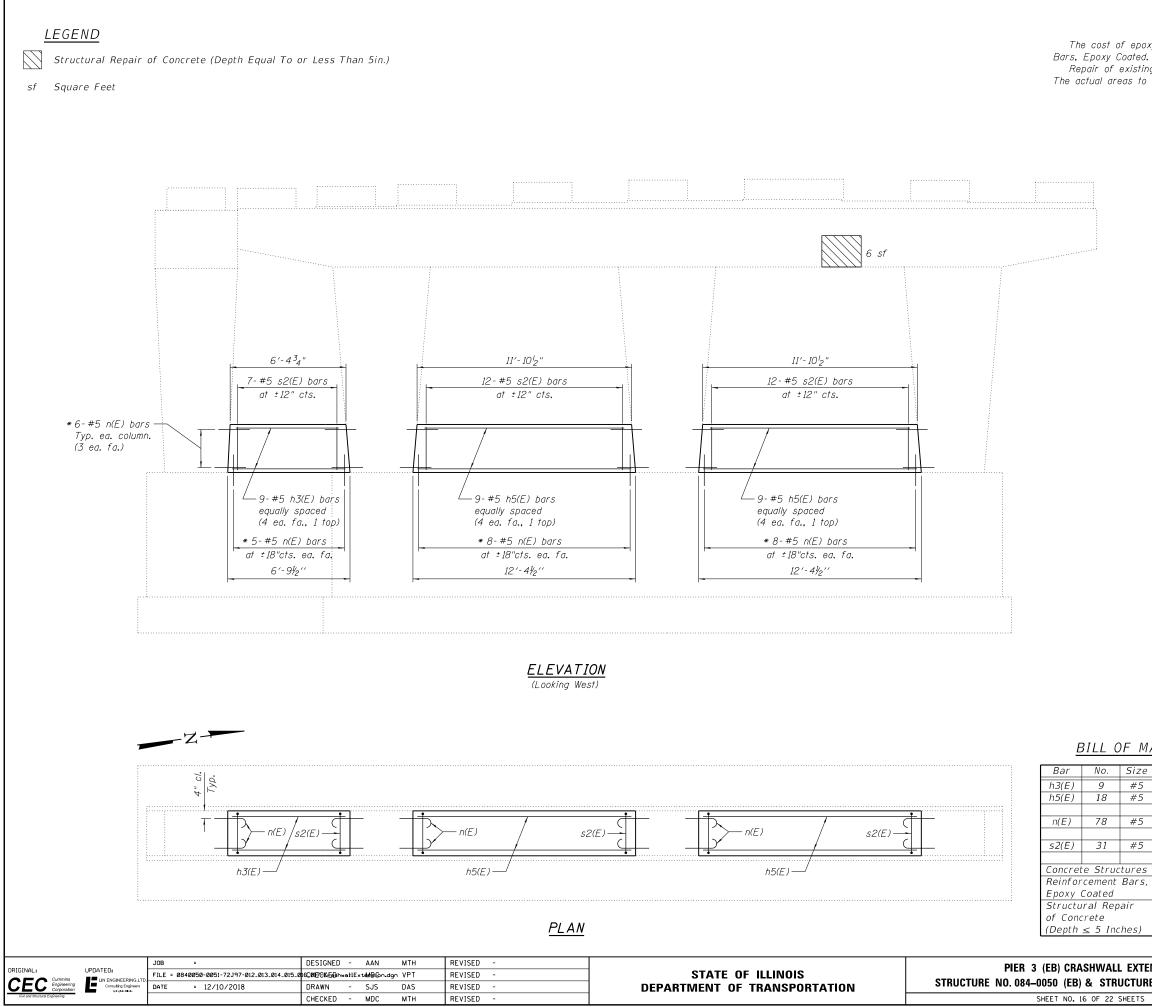


The cost of epoxy grouting threaded rods shall be included with Reinforcement

Repair of existing piers shall include but may not be limited to the areas shown. The actual areas to be repaired shall be determined by the Engineer at time of construction.

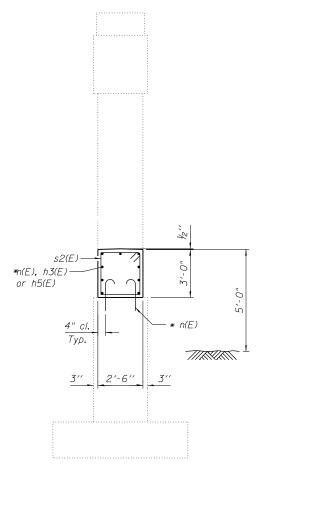


* Epoxy grout n(E) bars in 9" min. holes according to Article 584 of the Standard Specifications.

	Size	Length	Shape
	#5	6'-1"	
	#5	11'-7"	
	#5	2'-5"	
	#5	10'-7"	
	tures	Cu.Yd.	8.6
nt d	Bars,	Pound	880
ер	air		
		Sq. Ft.	6
Inc	hes)		

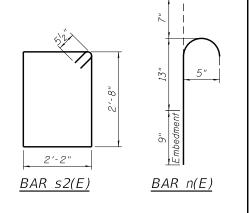


ALL EXTENSION	F.A.P. RTE	SECT	ION		COUNTY	TOTAL SHEETS	SHEET NO.
TRUCTURE NO. 084–0051 (WB)	67 (84-3-2) RS-2, BP, BDR		SANGAMON	98	76		
TRUCTURE NO. 084-0051 (VVB)					CONTRACT	NO. 7	2J97
22 SHEETS			ILLINOIS	FED. AI	D PROJECT		

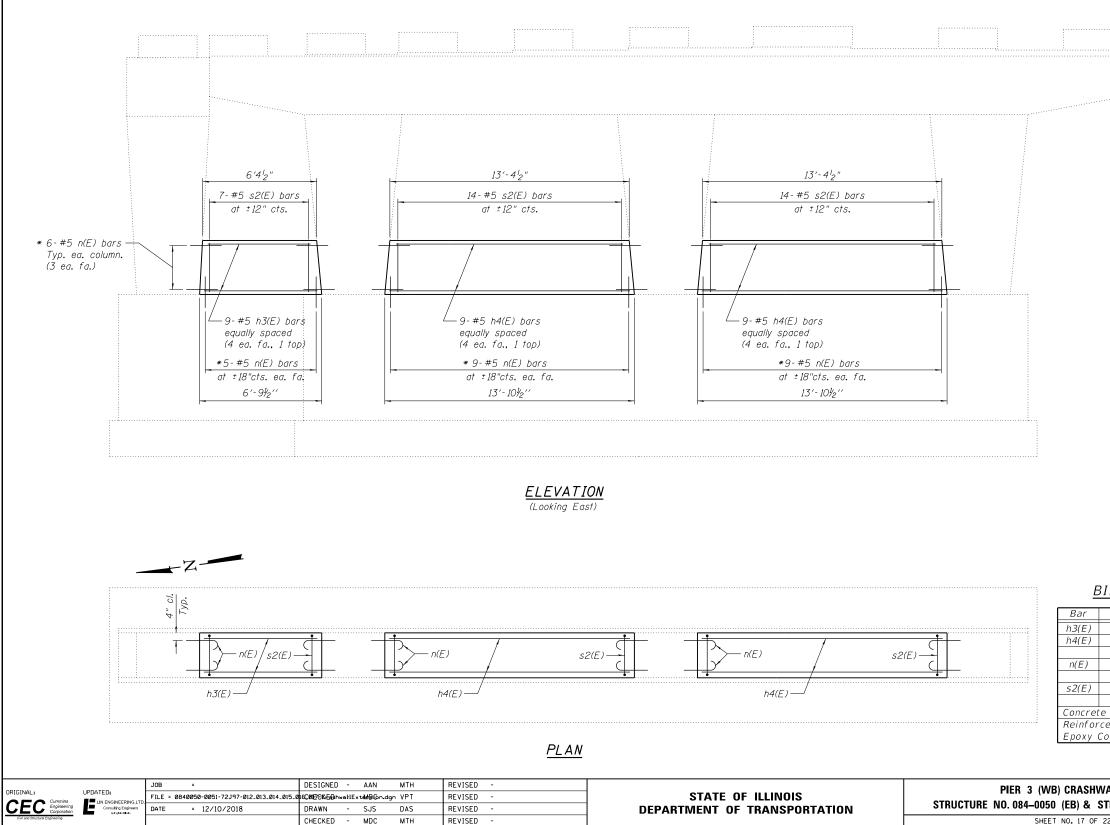

SHEET NO. 17 OF 22


NOTES

The cost of epoxy grouting threaded rods shall be included with Reinforcement

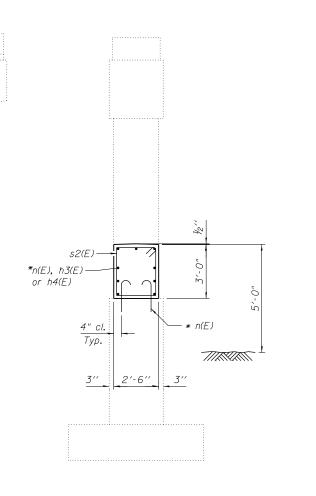



* Epoxy grout n(E) bars in 9" min. holes according to Article 584 of the Standard Specifications.


No.	Size	Length	Shape
9	#5	6'-1"	
18	#5	13'-1"	
82	#5	2'-5"	Ĺ
35	#5	10'-7"	
Struc	tures	Cu.Yd.	9.4
ement oated	Bars,	Pound	900

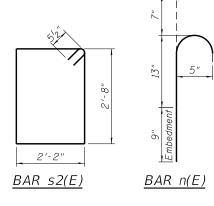


ALL EXTENSION	F.A.P. RTE.	SECT	TION		COUNTY	TOTAL SHEETS	SHEET NO.
TRUCTURE NO. 084–0051 (WB)		67 (84-3-2) RS-2, BP, BDR		SANGAMON	98	77	
					CONTRAC	T NO. 7	2J97
22 SHEETS			ILLINOIS	FED. A	ID PROJECT		

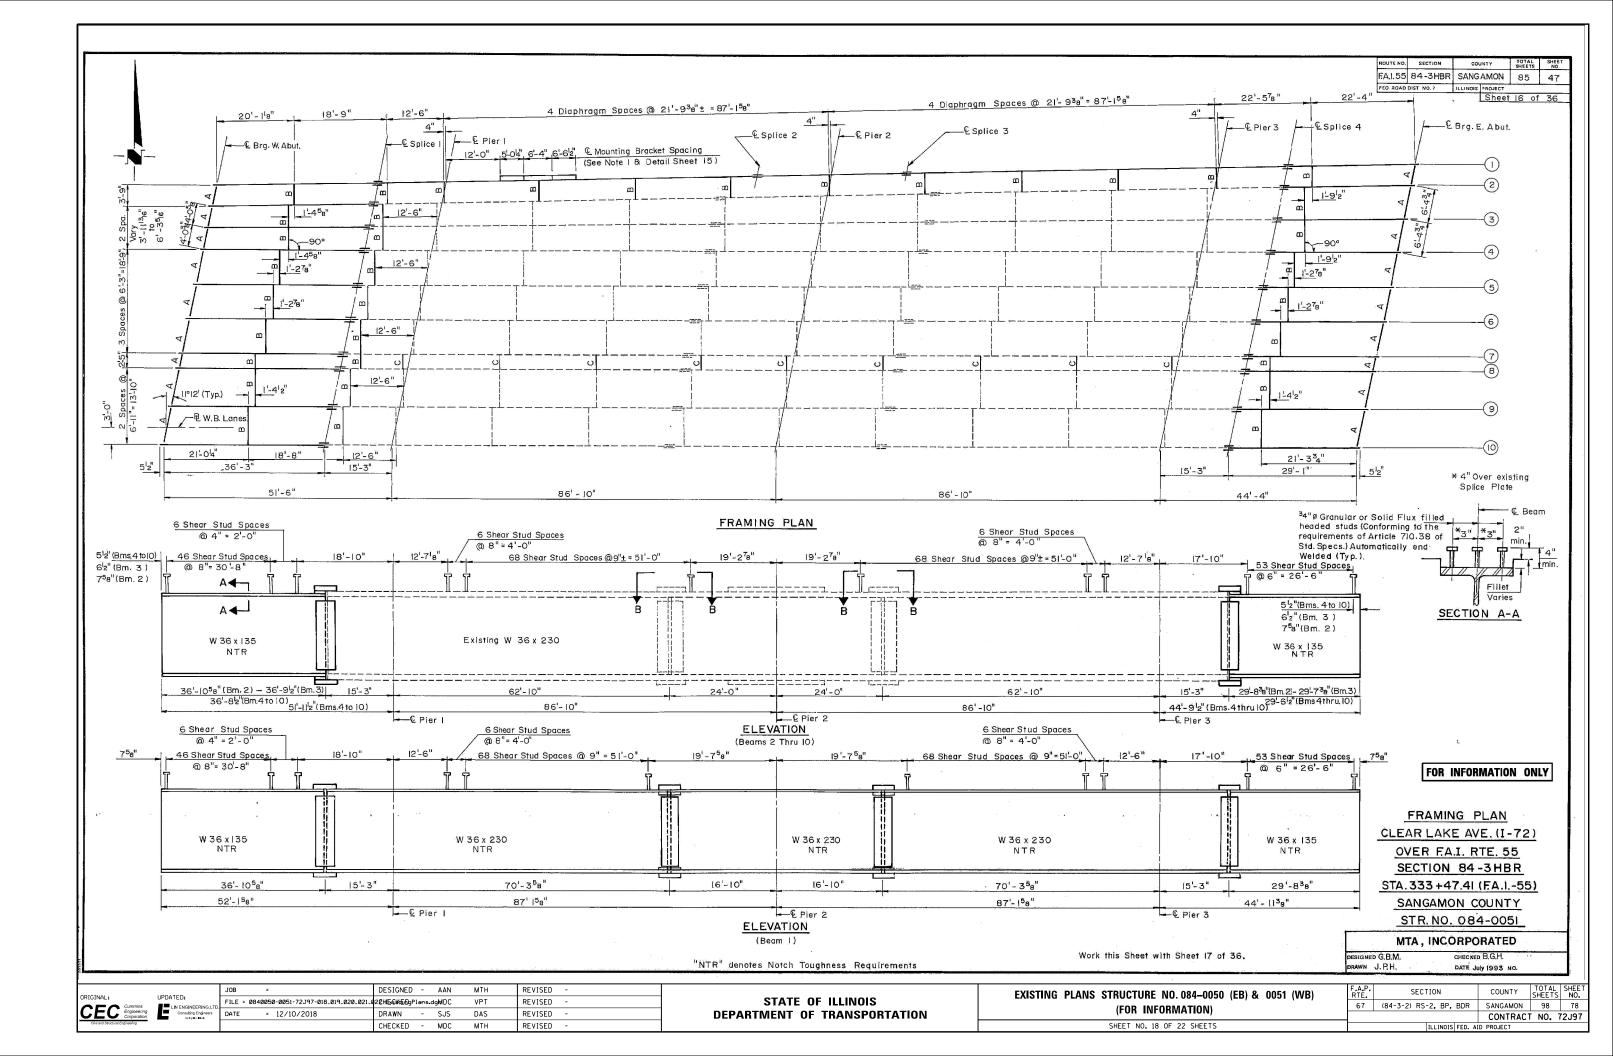


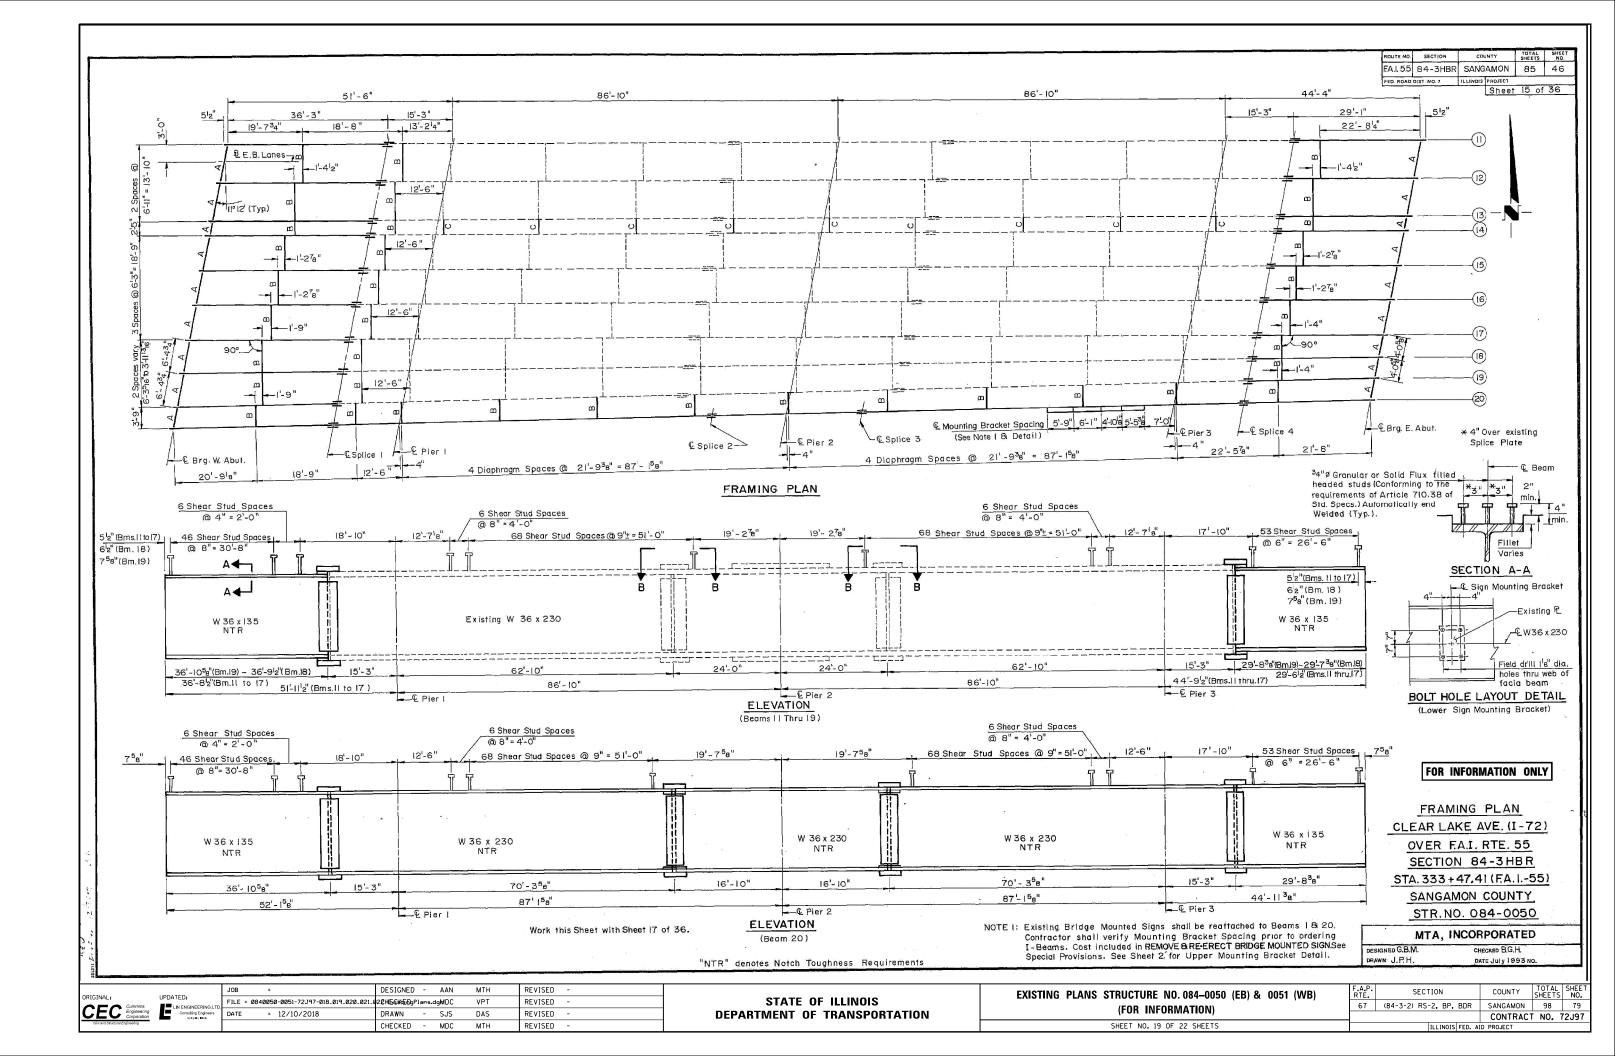

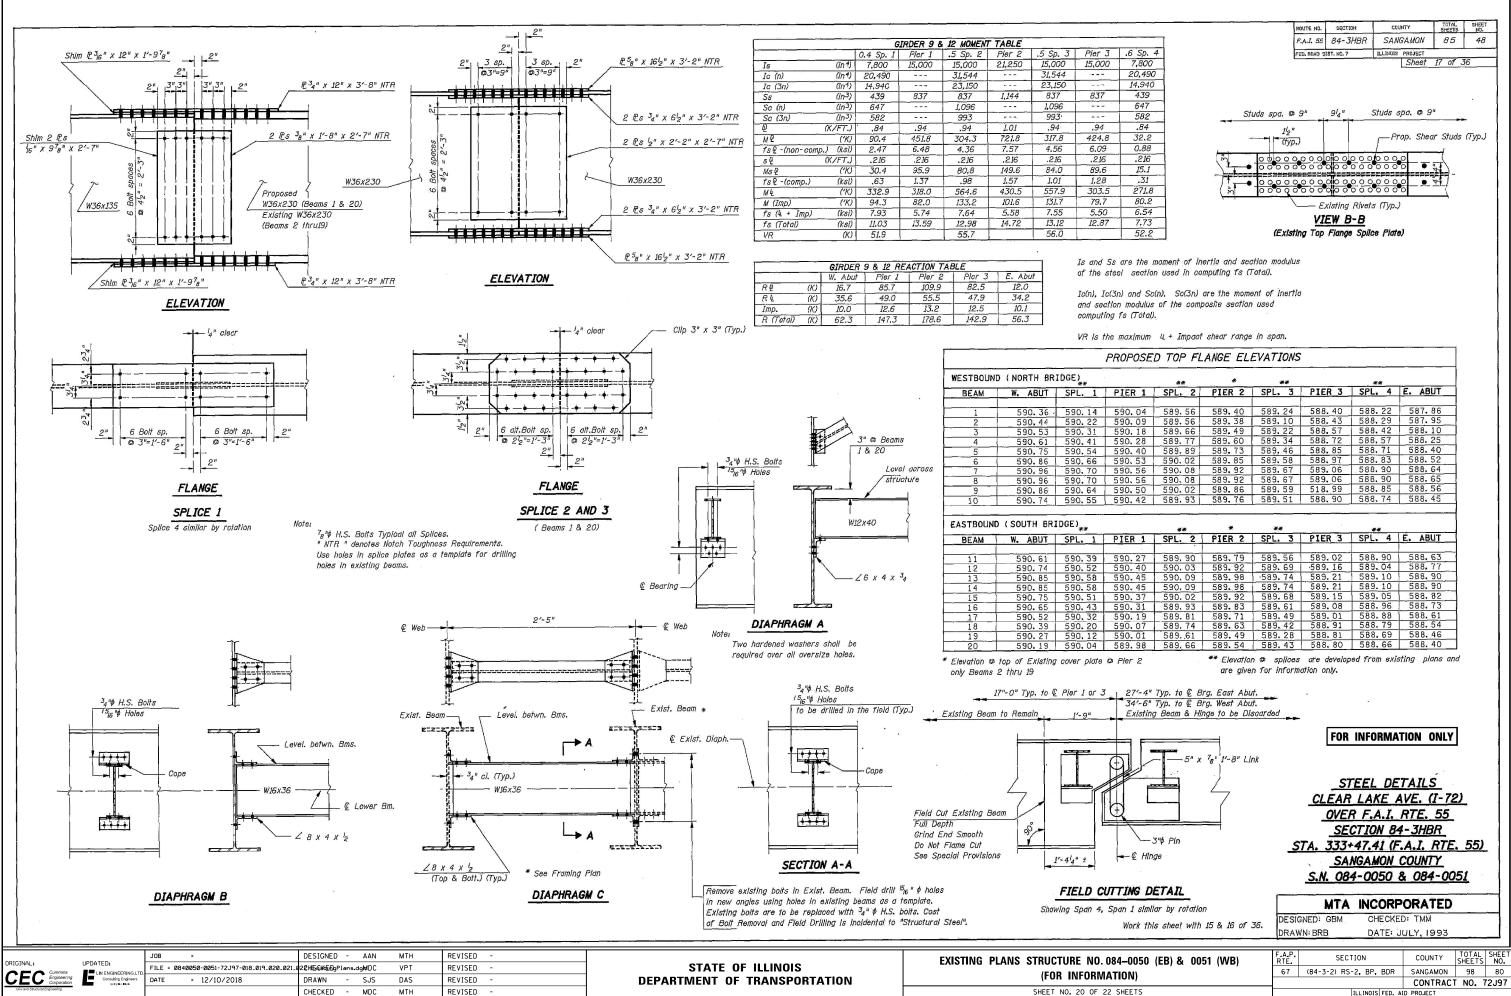


he maximum	4 + Impact	shear range	in span.				ī
PROPOSE	D TOP FL	ANGE ELI	EVATIONS				
	**	*	**		**		
PIER 1	SPL, 2	PIER 2	SPL. 3	PIER 3	SPL. 4	E. ABUT	1
							4
590.04	589.56	589.40	589.24	588.40	588.22	587.86	-
590.09	589.56	589.38	589.10	588.43	588.29	587.95	4
590.18	589,66	589,49	589.22	588.57	588.42	588.10	4
590.28	589.77	589.60	589.34	588.72	588.57	588.25	-
590.40	589.89	589,73	589.46	588.85	588.71	588,40	4
590.53	590.02	589.85	589,58	588.97	588.83	588.52	-
590.56	590.08	589.92	589.67 589.67	589.06 589.06	588.90 588.90	588.64	-
590, 56 590, 50	<u>590,08</u> 590,02	589.92 589.86	589.59	518.99	588.85	588.56	1
590.42	589,93	589.76	589.51	588,90	588,74	588.45	1
330.42	303, 33]	003.10		500.50	00000		1
			· · · · · · · · · · · · · · · · · · ·				1
	**	*	**	·	**		4
PIER 1	SPL. 2	PIER 2	SPL. 3	PIER 3	SPL, 4	E. ABUT	4
590.27	589, 90	589,79	589.56	589.02	588.90	588.63	1
590.40	590.03	589.92	589,69	589.16	589.04	588,77	1
590.45	590.09	589.98	.589.74	589.21	589.10	588,90	1
590.45	590,09	589,98	589.74	589.21	589.10	588.90	1
590.37	590.02	589.92	589.68	589.15	589,05	588, 82	1
590.31	589,93	589.83	589.61	589.08	588,96	588.73	1
590.19	589.81	589.71	589.49	589.01	588.88	588.61	1
590.07	589,74	589.63	589.42	588.91	588.79	588.54	
590.01	589.61	589.49	589.28	588.81	588.69	588.46	1
589.98	589,66	589.54	589.43	588.80	588.66	588.40]
		rg. West Abu nge to be Dis		FOR	INFORMA	TION ONLY]
	- 5" x	78" 1'-8" Lii	nk	CLEAR		TAILS AVE. (I-72 RTE. 55	<u>2)</u>
					CTION 8		
	3"¢ Pin		S			A.I. RTE	55)
-€ Hing	je -			and and and	NGAMON	servers allowers and reader servers	
				and the second second	The second second second second	& 084-00	51
TTING DI	ETAIL			<u> </u>	7 0000	<u>a 007 00</u>	<u></u>
Span 1 simil	ar by rotatio	n	Ĩ	MTA	INCOR	PORATED	
		15 & 16 of .	DESIG	NED: GBM	CHECKE	D: TMM	
			DRAW	N: BRB	DATE:	JULY, 1993	
	(F.A.P. RTE.	SEC	TION	COUNTY	TOTAL
184-0050	(EB) & 00	51 (WB)					SHEETS
TION)			67	(84-3-2) RS	-2, BP, BDR	SANGAMON	98
						CONTRAC	T NO. 7

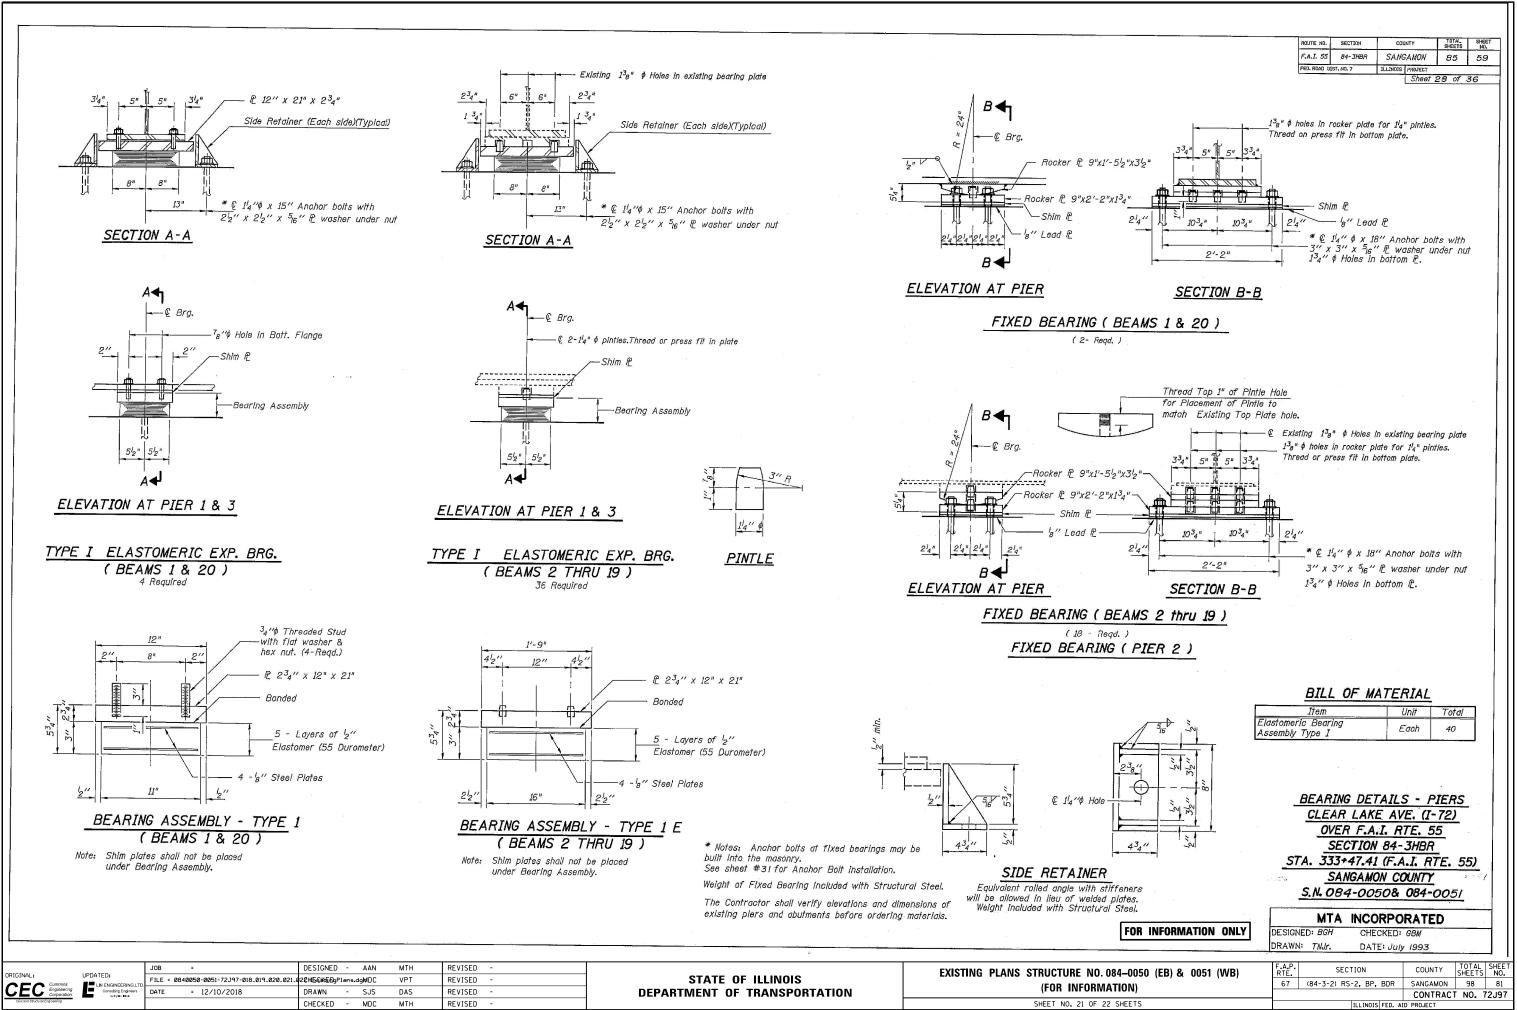

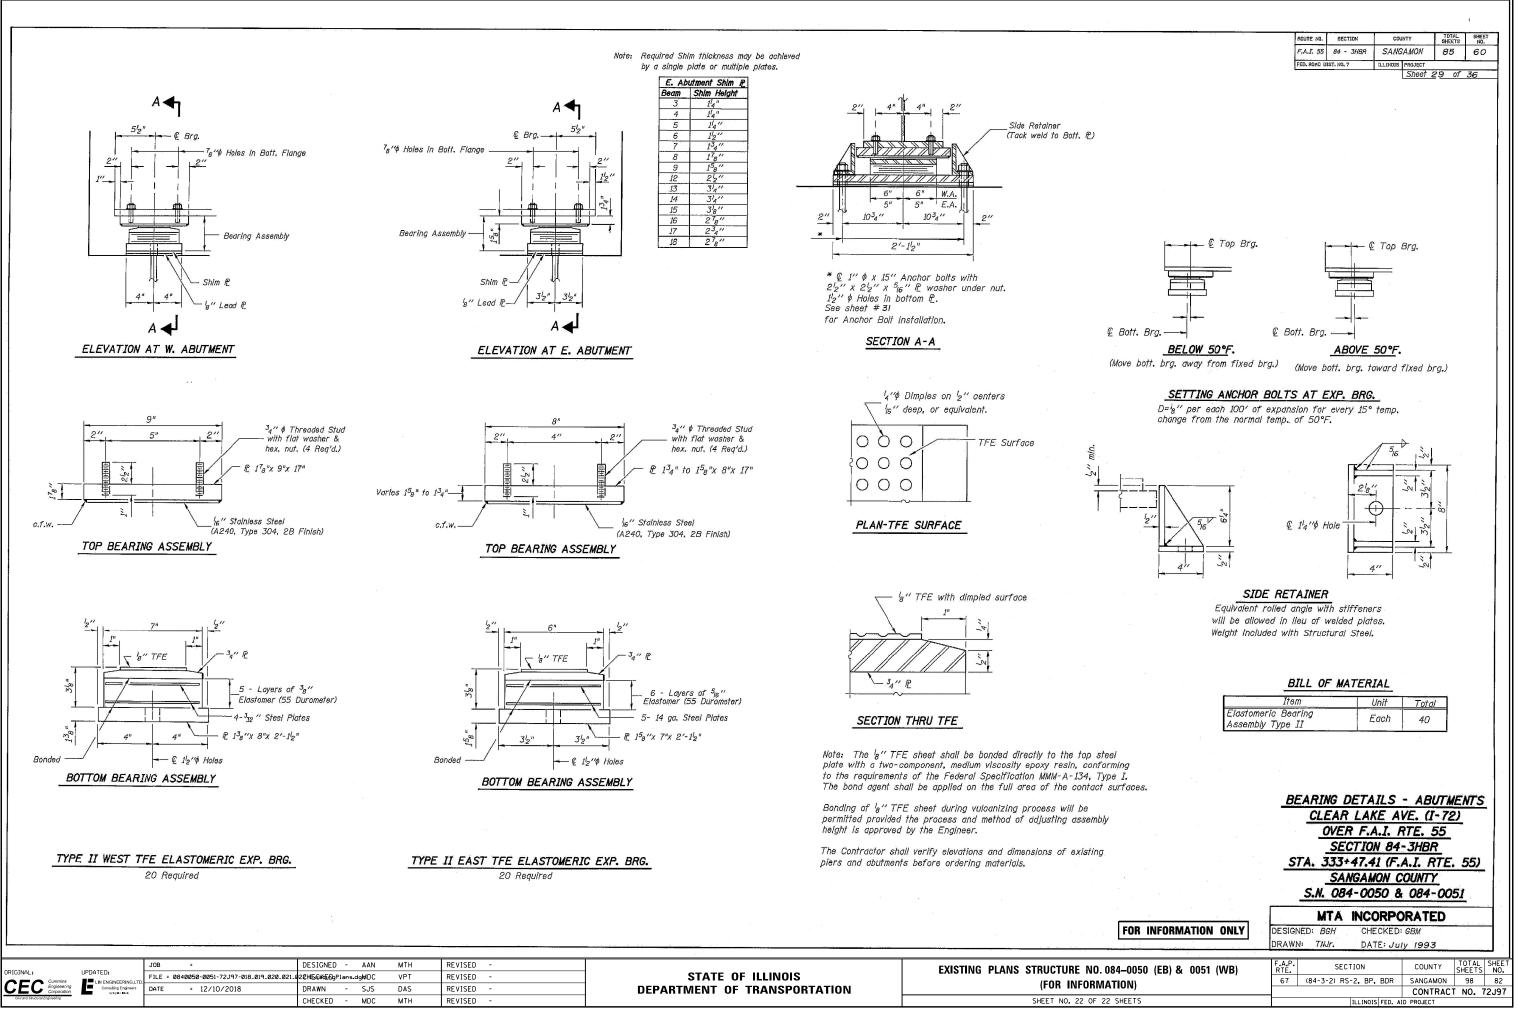

GINAL: U	LIN ENGINEERING, LTD.	JOB = FILE = 0840050-0051-72J97-018.019.020.021.0 DATE = 12/10/2018	DESIGNED - AAN 928HE&&&&&DgPlons.dgMDC DRAWN - SJS	MTH VPT DAS	REVISED - REVISED - REVISED -	STATE OF ILLINOIS DEPARTMENT OF TRANSPORTATION	EXISTING PLANS STRUCTURE NO.0 (For informa
Civil and Structural Engineering			CHECKED - MDC	мтн	REVISED -		SHEET NO. 22 OF 22

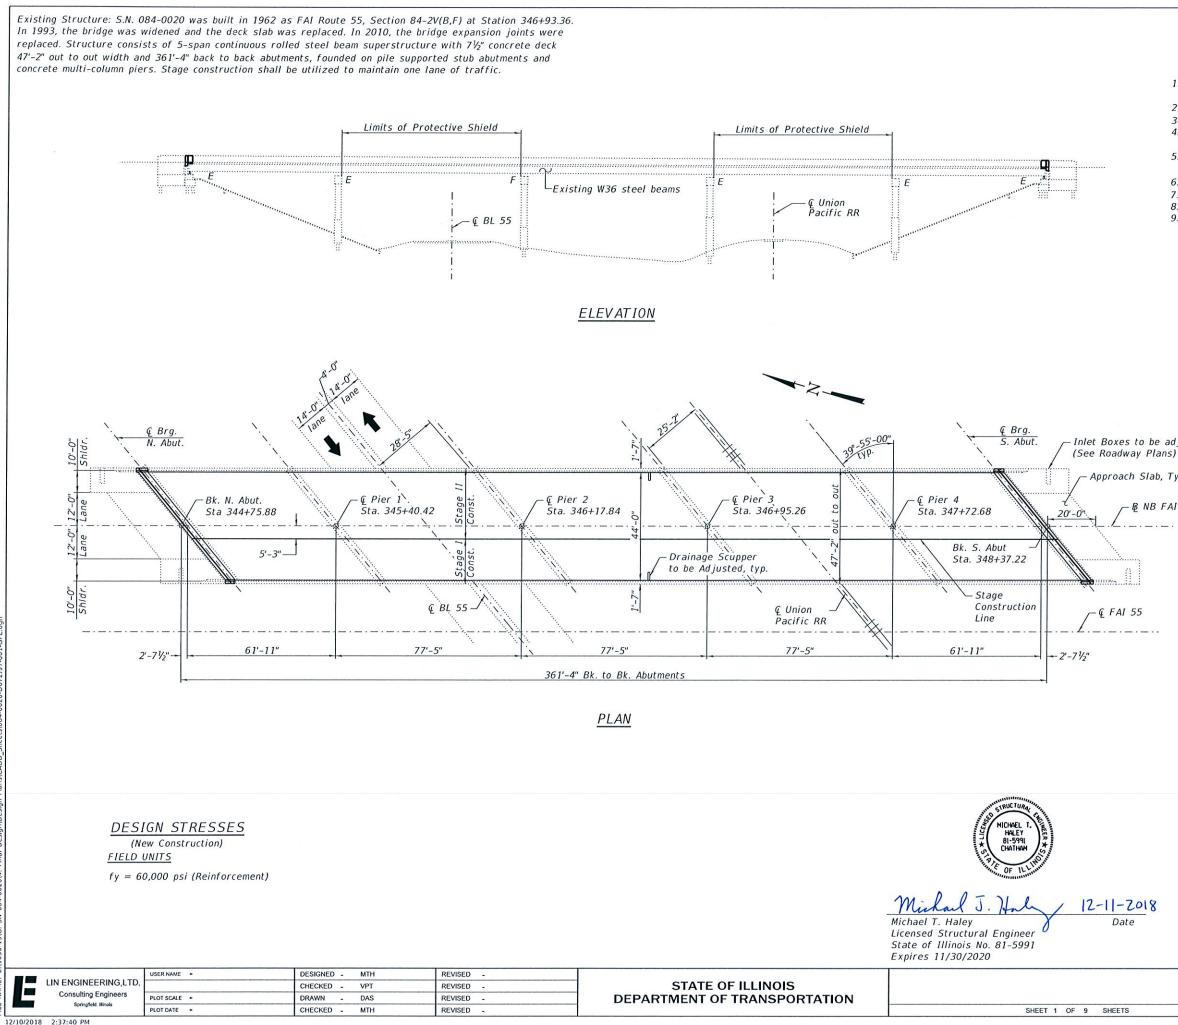

SCOPE OF WORK

- 1. Remove concrete deck and parapets at the expansion
- joints in order to replace strip seal joints.
- 2. Apply 3/4" hydro-scarification to deck slab.
- 3. Perform deck and approach slab repairs.
- 4. Place new superstructure concrete and preformed joint strip seal at abutments.
- 5. Place 2³/₄" microsilica concrete overlay on deck slab.
- 6. Perform 1/4" Diamond Grinding.
- 7. Perform bridge deck grooving on new deck surface.
- 8. Apply protective coat.
- 9. Repair deteriorated concrete on substructure.


INDEX OF SHEETS


- General Plan and Elevation
- General Data 2
- Deck Slab Repair Plan 3
- Adjusting Existing Scupper Details 4
- Joint Replacement Details
- Expansion Joint Strip Seal 6 Pier Repair Details
- 7.-8. Bar Splicer Details
- 9.

Inlet Boxes to be adjusted, Typ.

Approach Slab, Typ.

B NB FAI 55

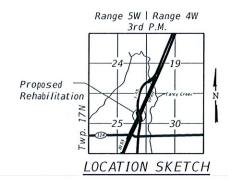

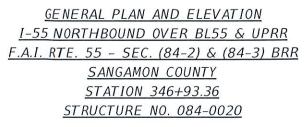

	F.A.I RTE.	SEC	TION	COUNTY	TOTAL SHEETS	SHEET NO.
	55	(84-2) & (84-3) BRR	SANGAMON	98	83
				CONTR	ACT NO.	72J97
TS			ILLINOIS	FED. AID PROJECT		

GENERAL NOTES

No field welding is permitted except as specified in the contract documents. Reinforcement bars designated (E) shall be epoxy coated.

Prior to pouring the new concrete deck, all heavy or loose rust, loose mill scale, and other loose or potentially detrimental foreign material shall be removed from the surfaces in contact with concrete. Tightly adhered paint may remain unless otherwise noted. Removal shall be accomplished by methods that will not damage the steel and the cost will be included in the pay item covering removal of the existing concrete.

Plan dimensions and details relative to existing plans are subject to nominal construction variations. The Contractor shall field verify existing dimensions and details affecting new construction and make necessary approved adjustments prior to construction or ordering of materials. Such variations shall not be cause for additional compensation for a change in scope of the work, however, the Contractor will be paid for the quantity actually furnished at the unit price bid for the work.


Cleaning and field painting of structural steel shall be done under a separate painting contract.

The existing structural steel coating contains lead. The Contractor shall take appropriate precautions to deal with the presence of lead on this project.

Existing reinforcement bars extending into the removal area shall be cleaned, straightened and incorporated into the new construction. Any reinforcement bars that are damaged during concrete removal shall be replaced with an approved bar splicer or anchorage system. Cost included with Concrete Removal.


Joint openings shall be adjusted according to Article 520.04 of the Std. Specs. when the deck is poured at an ambient temperature other than 50° F.

Synthetic fibers shall be added to the Bridge Deck Microsilica Concrete Overlay. See Special Provisions.

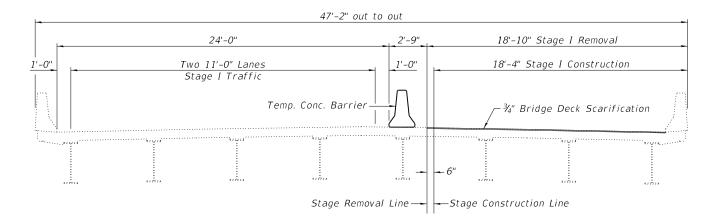

STAGE I REMOVAL & CONSTRUCTION

(Looking South)

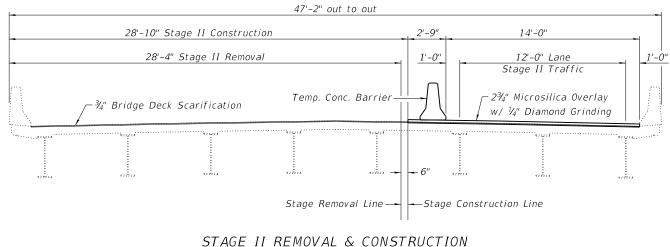

(Looking South)

TOTAL BILL OF MATERIAL

	ITEM	UNIT	TOTAL
	Concrete Removal	Cu.Yd.	10.0
	Protective Shield	Sq. Yd.	780
	Concrete Superstructure	Cu.Yd.	11.3
*	Protective Coat	Sq. Yd.	2,045
	Reinforcement Bars, Epoxy Coated	Pound	1,110
	Bar Splicers	Each	24
	Preformed Joint Strip Seal	Foot	119
	Bridge Deck Grooving (Longitudinal)	Sq. Yd.	1,670
	Bridge Deck Scarification 3/4"	Sq. Yd.	1,726
	Drainage Scupper to be Adjusted	Each	2
	Bridge Deck Microsilica Concrete Overlay, 2¾"	Sq. Yd.	1,726
	Structural Repair of Concrete (Depth Equal	Sq. Ft.	26
	to or Less than 5 Inches)		
	Deck Slab Repair (Full Depth, Type I)	Sq. Yd.	0.5
	Deck Slab Repair (Full Depth, Type II)	Sq. Yd.	14.0
	Approach Slab Repair (Partial Depth)	Sq. Yd.	1.7
	Diamond Grinding (Bridge Section)	Sq. Yd.	1,604

* Apply to top and inside faces of parapets, and to top of

deck slab including new concrete adjacent to expansion joints.

Note:


See Roadway Plans for Temporary Concrete Barrier quantities.

	USER NAME =	DESIGNED - MTH	REVISED -		GENERAL DATA	F.A.I SECTION	COUNTY TOTAL SHEET
		CHECKED - VPT	REVISED -	STATE OF ILLINOIS	STRUCTURE NO. 084-0020	55 (84-2) & (84-3) BRR	SANGAMON 98 84
Consulting Engineers Springfield, Illinois	PLOT SCALE =	DRAWN - DAS	REVISED -	DEPARTMENT OF TRANSPORTATION	SIRUCIURE NO, 084-0020		CONTRACT NO. 72J97
	PLOT DATE =	CHECKED - MTH	REVISED -		SHEET 2 OF 9 SHEETS	ILLINOIS FE	D. AID PROJECT

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Springfield, Illinois


PLOT DATE =

CHECKED - MTH

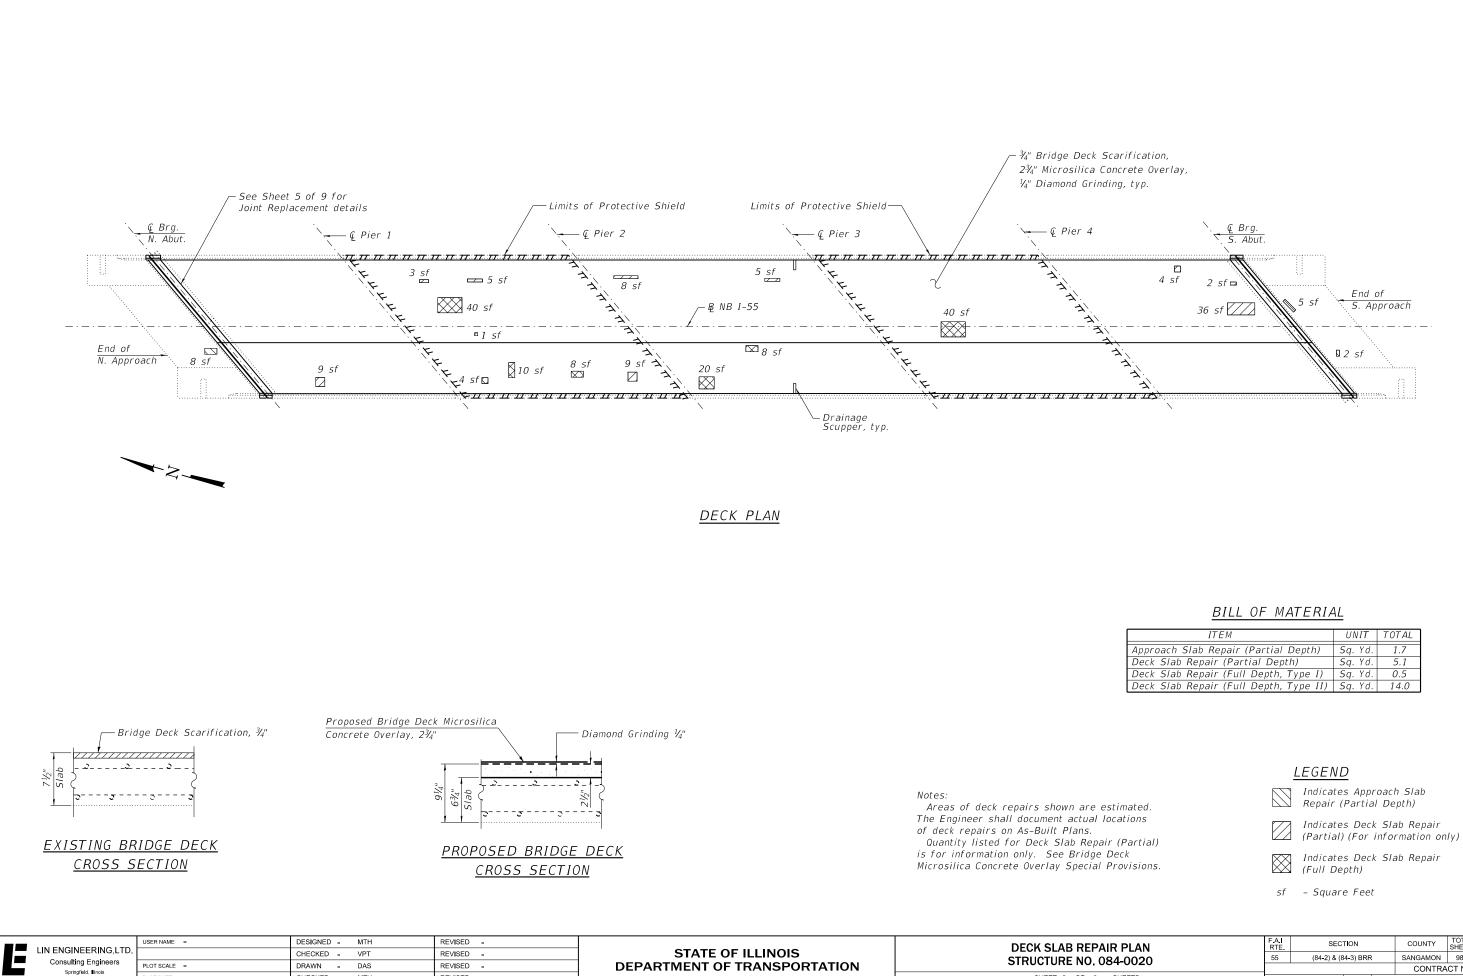REVISED -

ITEM	UNIT	TOTAL
Approach Slab Repair (Partial Depth)	Sq. Yd.	1.7
Deck Slab Repair (Partial Depth)	Sq. Yd.	5.1
Deck Slab Repair (Full Depth, Type I)	Sq. Yd.	0.5
Deck Slab Repair (Full Depth, Type II)	Sq. Yd.	14.0

PAIR PLAN 0. 084-0020		SECTION		COUNTY	TOTAL SHEETS	SHEET NO.	
		(84-2) & (84-3) BRR		SANGAMON	98	85	
					CONTRA	CT NO.	72J97
9 SHEETS			ILLINOIS	FED. A	D PROJECT		

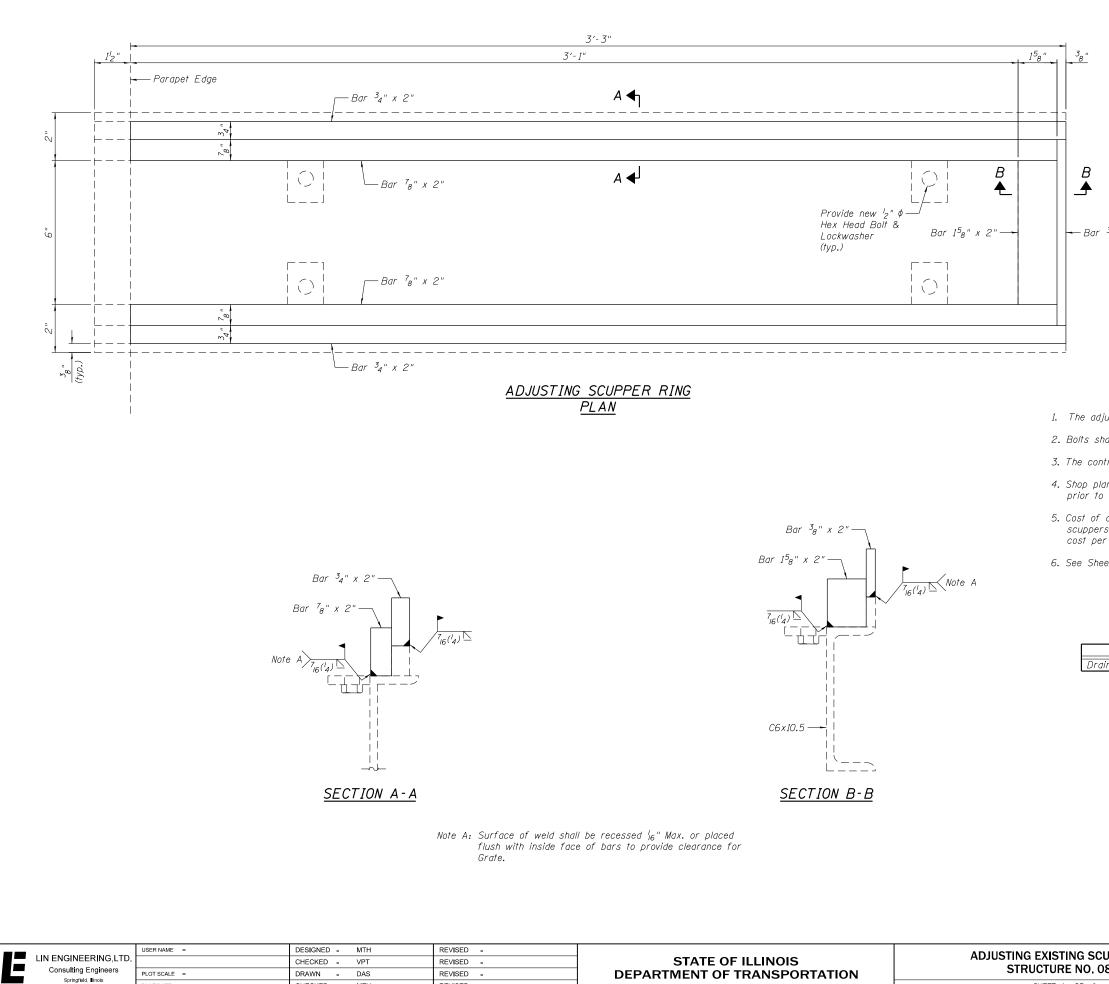

Springfield, Illinois

PLOT DATE =

CHECKED - MTH

REVISED -

- Bar ³8" x 2"

NOTES:

1. The adjusting scupper ring shall be galvanized.

2. Bolts shall be l_2 " ϕ , AASHTO M164 Type I, mechanically galvanized.

3. The contractor shall ensure that no damage is done to existing grates to be reused.


4. Shop plans for proposed adjusting scupper ring shall be submitted for approval prior to fabrication.

5. Cost of all labor and materials necessary to remove existing grates, clean existing scuppers, install adjusting scupper rings and reinstalling grates is included in the cost per unit each for Drainage Scupper to be Adjusted.

6. See Sheet 1 of 9 for Scupper locations.

ITEM	UNIT	TOTAL
rainage Scupper to be Adjusted	Each	2


CUPPER DETAILS . 084-0020		SECTION			COUNTY	TOTAL SHEETS	SHEET NO.
		(84-2) & (84-3) BRR			SANGAMON	98	86
					CONTRA	CT NO.	72J97
9 SHEETS			ILLINOIS	FED. A	D PROJECT		

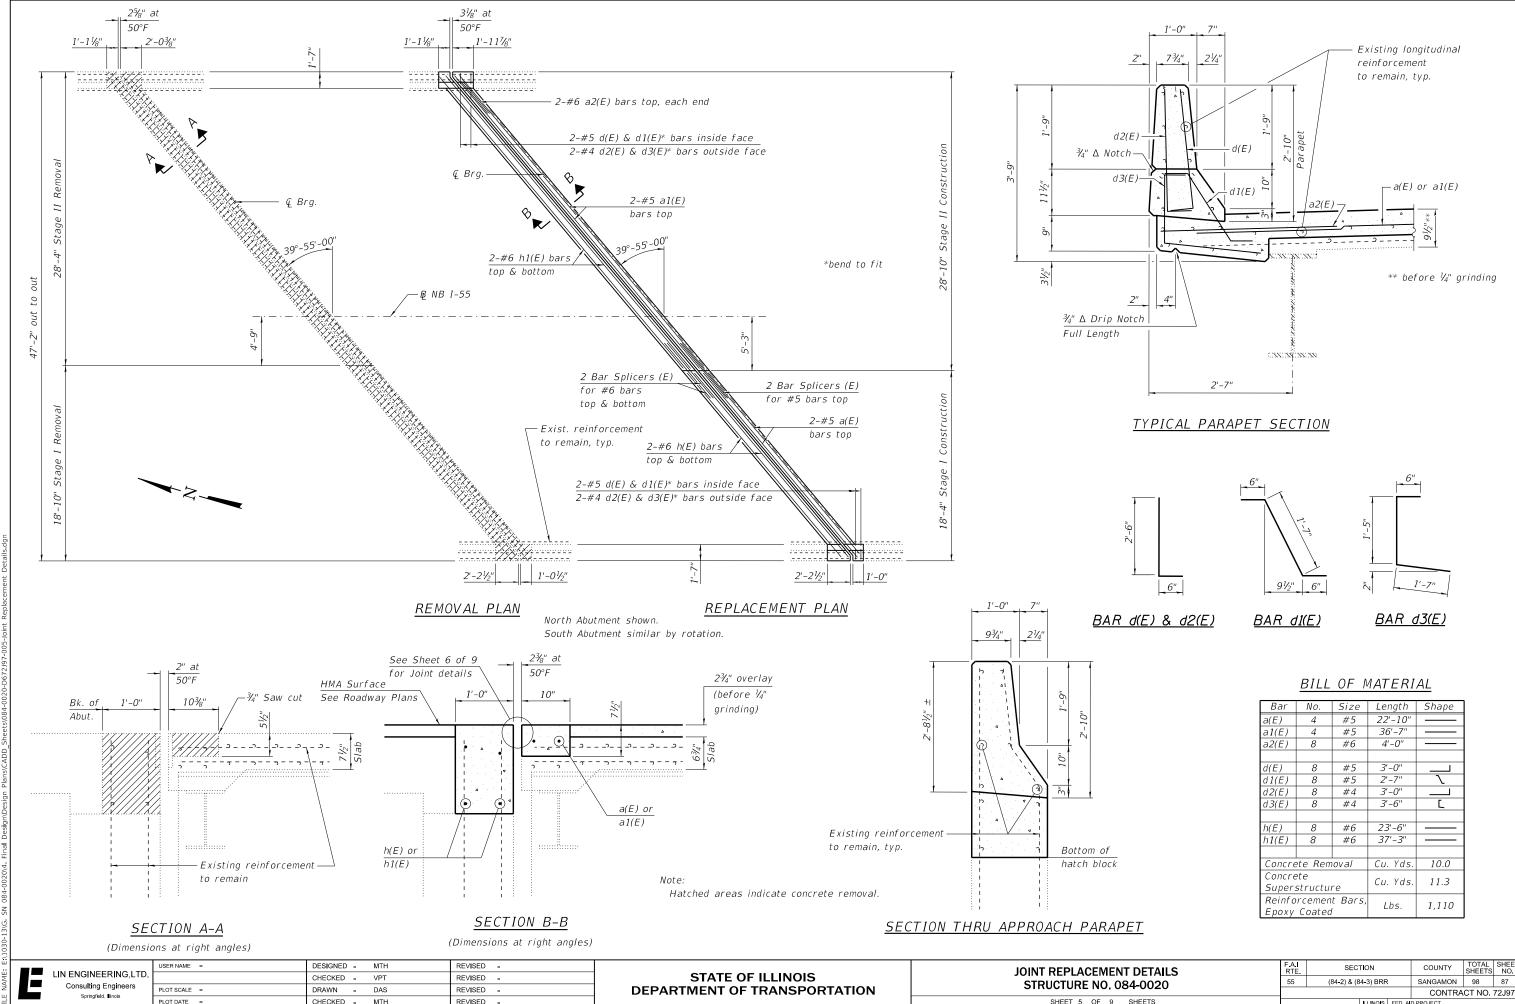

1/14/2019 11:01:07 AM

SHEET 5 OF 9

F.A.I RTE	SECTION			COUNTY	TOTAL SHEETS	SHEET NO.
55	(84-2) & (84-3) BRR		SANGAMON	98	87	
				CONTRA	CT NO.	72J97
ILLINOIS FED.				D PROJECT		
	RTE.	RTE. SEC 55 (84-2) & (8	RTE. SECTION 55 (84-2) & (84-3) BRR	RTE. SECTION 55 (84-2) & (84-3) BRR	RTE. SECTION COUNTY 55 (84-2) & (84-3) BR SANGAMON CONTRA	RTE SECTION COUNTY SHEETS 55 (84-2) & (84-3) BRR SANGAMON 98 CONTRACT NO.

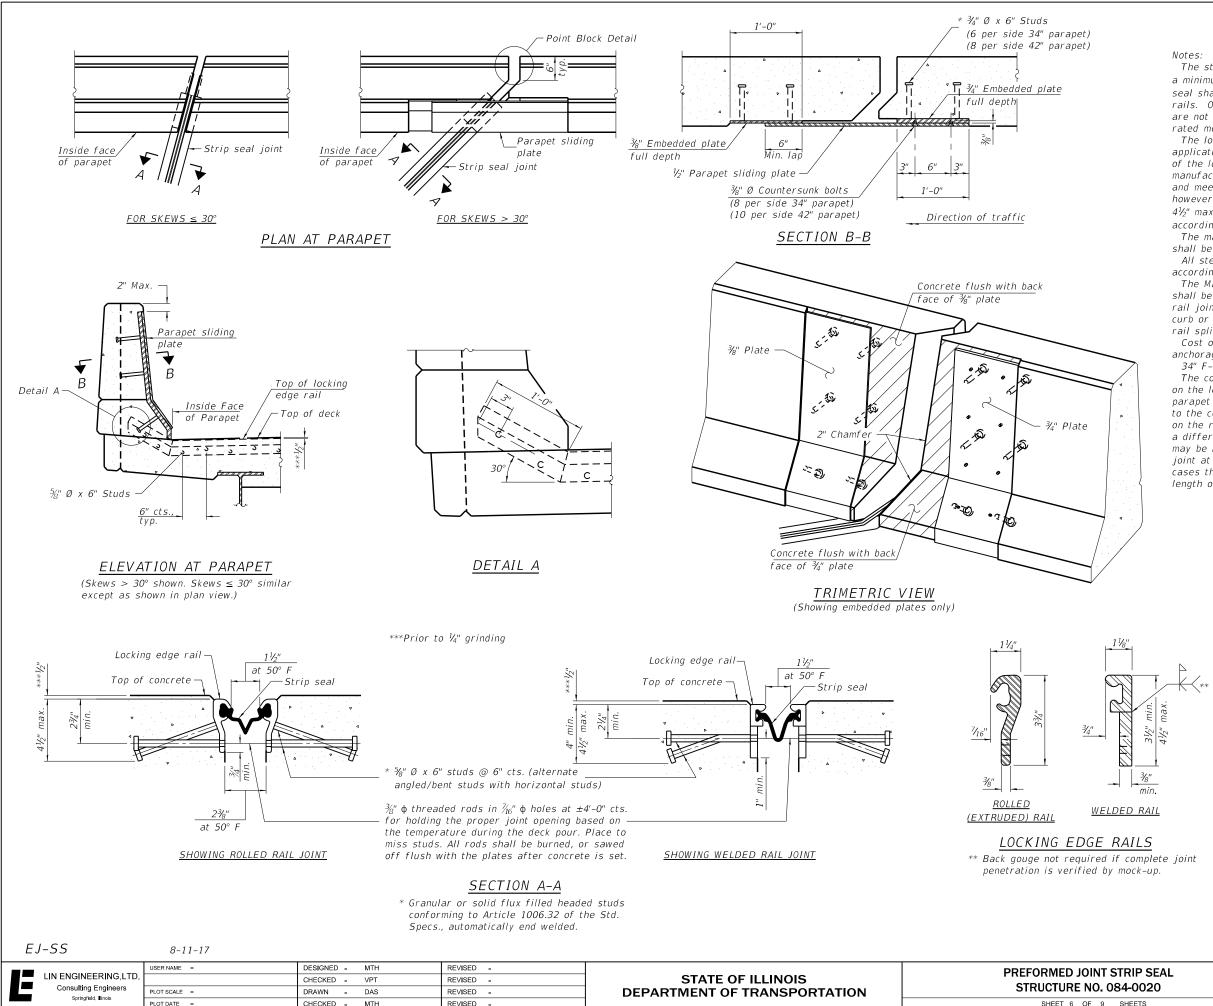

12/10/2018 2:38:04 PM

SHEET 6 OF 9

The strip seal shall be made continuous and shall have a minimum thickness of $\frac{1}{4}$ ". The configuration of the strip seal shall match the configuration of the locking edge rails. Open or "webbed" strip seal gland configurations are not permitted. The gland shall be sized for a maximum rated movement of 4 inches.

The locking edge rails depicted are configured for typical applications and are conceptual only. The actual configuration of the locking edge rails and matching strip seal may vary from manufacturer to manufacturer provided they fit the application and meet the minimum anchorage shown. Flanged edge rails, however, will not be allowed. Locking edge rails may exceed the $4 \ensuremath{\mathcal{V}}_{\!\!2}{}''$ maximum depth provided the anchorage system is revised according to the manufacturer's recommendation.


The manufacturer's recommended installation methods shall be followed.

All steel components shall be galvanized after fabrication according to Article 520.03 of the Standard Specifications.

The Maximum space between locking edge rail segments shall be $\frac{3}{16}$ " and sealed with a suitable sealant; however, any rail joint within 10' measured perpendicular to the face of the curb or parapet shall be welded as shown in the locking edge rail splice detail.

Cost of parapet sliding plates, embedded plates, and anchorage studs included with Preformed Joint Strip Seal.

34" F-shape barrier shown, 42" F-shape similar as noted. The concrete opening below the strip seal will vary based on the locking edge rail chosen by the Contractor. Deck and parapet lengths shown elsewhere in the plans are dimensioned to the concrete opening, not the joint opening, and are based on the rolled locking edge rail. If the Contractor elects to use a different locking edge rail, dimensional adjustments may be required. One exception to this would be the strip seal joint at the end of the precast bridge approach slab. For these cases the pavement connector length shall be adjusted, not the length of the bridge approach slab.

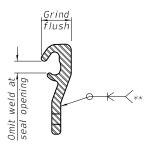



LOCKING EDGE RAIL SPLICE

The inside of the locking edge rail groove shall be free of weld residue. Rolled rail shown, welded rail similar.

Item	Unit	Total
Preformed Joint Strip Seal	Foot	119


IT STRIP SEAL . 084-0020		SECTION			COUNTY	TOTAL SHEETS	SHEET NO.
		(84-2) & (84-3) BRR			SANGAMON	98	88
					CONTRA	CT NO.	72J97
9 SHEETS			ILLINOIS	FED. A	D PROJECT		

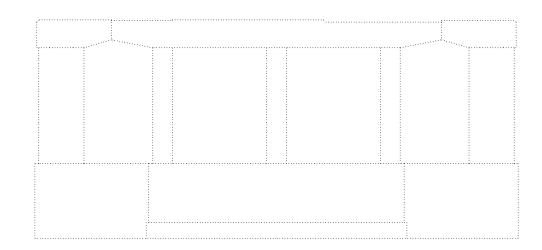


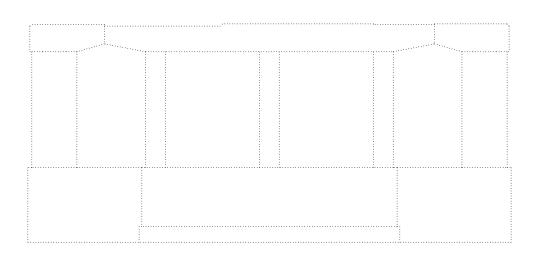

<u>PIER 1 ELEVATION</u>

(Looking North)

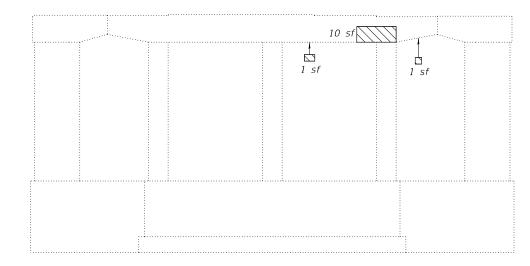

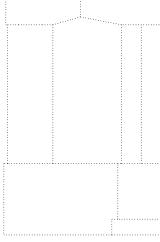

PIER 2 ELEVATION (Looking North)

<u>LEGEND</u>

- Structural Repair of Concrete (Depth Equal To or Less Than 5in.)
- sf Square Feet

Note:

Repair of existing piers shall include but may not be limited to the areas shown. The actual areas to be repaired shall be determined by the Engineer at time of construction.

Elai		USER NAME =	DESIGNED - MTH	н	REVISED -		PIER REPAIR DETAIL
	LIN ENGINEERING,LTD.		CHECKED - VPT	т	REVISED -	STATE OF ILLINOIS	
NZ EL		PLOT SCALE =	DRAWN - DAS	s	REVISED -	DEPARTMENT OF TRANSPORTATION	STRUCTURE NO. 084-
EILE	Springfield, Illinois	PLOT DATE =	CHECKED - MTH	н	REVISED -		SHEET 7 OF 9 SH
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<u>PIER 1 ELEVATION</u> (Looking South)


PIER 2 ELEVATION

(Looking South)

TOTAL BILL OF MATERIAL

ITEM	UNIT	TOTAL
Structural Repair of Concrete (Depth Equal To or Less Than 5 Inches)	Sq. Ft.	12

ETAILS-1 084-0020		SECTION			COUNTY	TOTAL SHEETS	SHEET NO.
		(84-2) & (84-3) BRR			SANGAMON	98	89
004-0020					CONTRA	CT NO.	72J97
9 SHEETS			ILLINOIS	FED. A	D PROJECT		

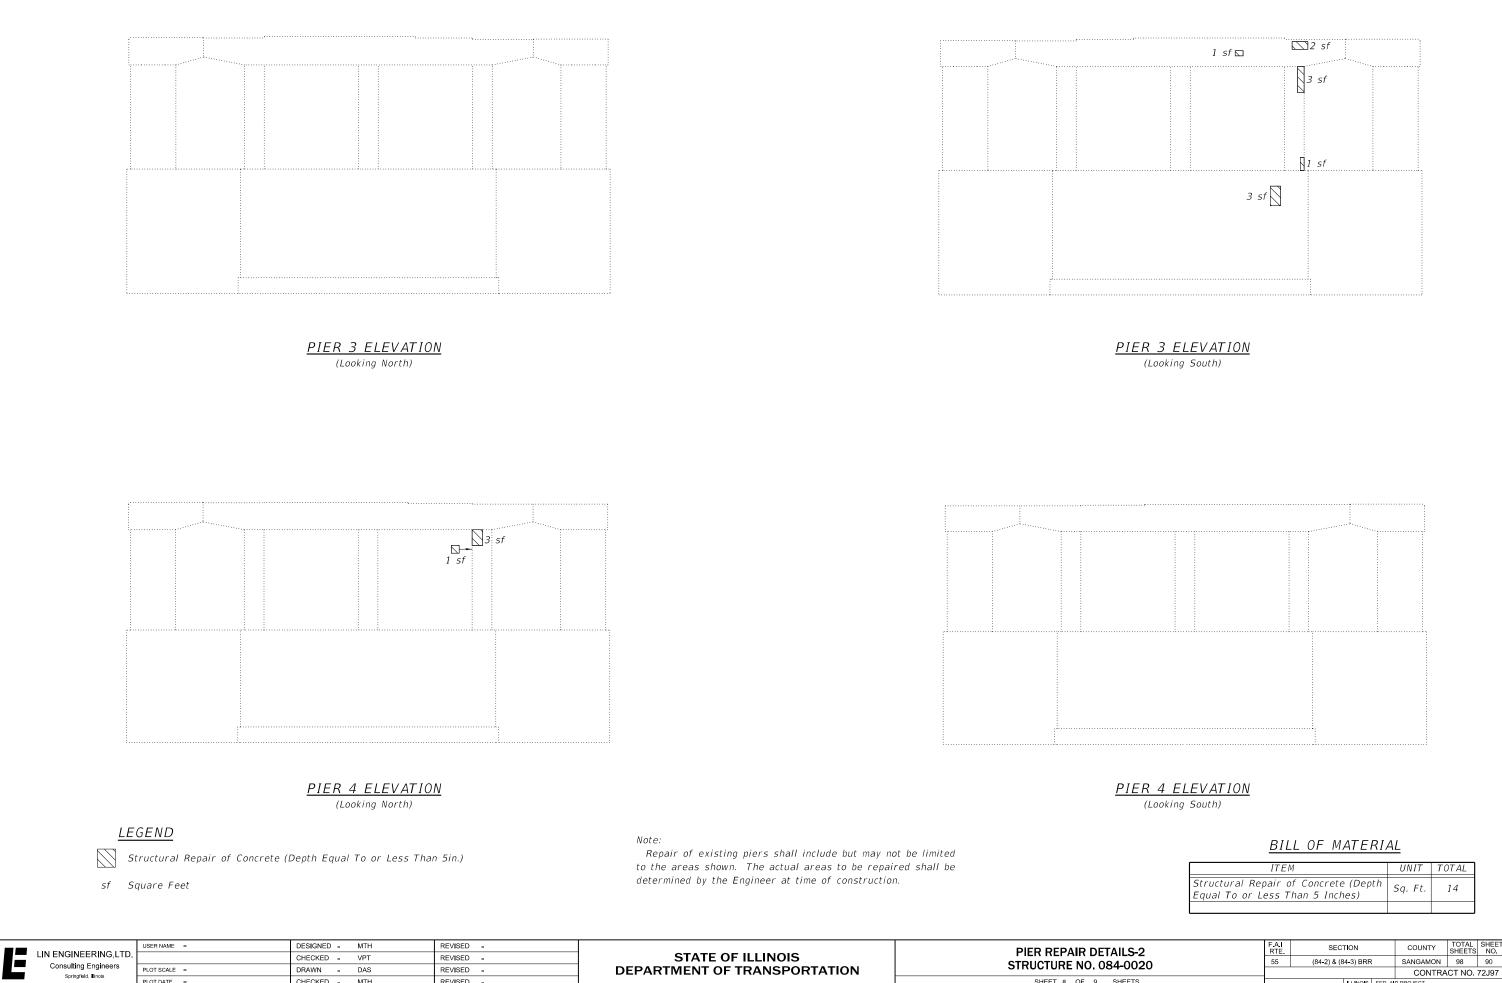

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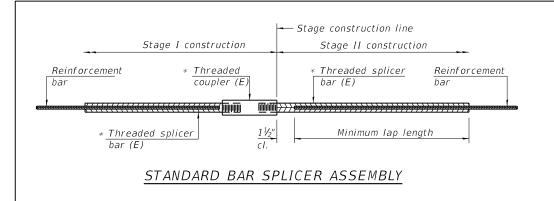
REVISED -

STRUCTURE NO.

ITEM	UNIT	TOTAL
Structural Repair of Concrete (Depth Equal To or Less Than 5 Inches)	Sq. Ft.	14

DETAILS-2		SECTION		COUNTY	TOTAL SHEETS	SHEET NO.	
		(84-2) & (84-3) BRR			SANGAMON	98	90
00+0020					CONTRA	CT NO.	72J97
9 SHEETS	ILLINOIS F			FED. A	D PROJECT		


SHEET 8 OF 9



Threaded splicer bar length = min. lap length + $1\frac{1}{2}$ " + thread length

* Epoxy not required on Bar Splicer Assembly components used in conjunction with black bars.

Location	Bar	No. assemblies	Minimum
Location	size	required	lap length
North Abutment	#5	8	3'-6"
North Abutment	#6	4	4'-0''
South Abutment	#5	8	3'-6"
South Abutment	#6	4	4'-0''

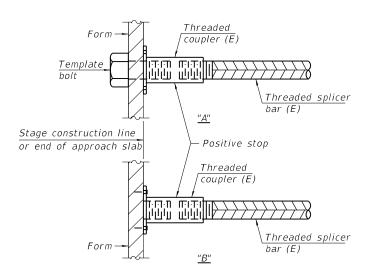

INSTALLATION AND SETTING METHODS


"A" : Set bar splicer assembly by means of a template bolt.

"B" : Set bar splicer assembly by nailing to wood forms or cementing to steel forms. (E) : Indicates epoxy coating.

6'-0'' Abutment Approach slab hatch block Threaded Threaded splicer couplers (E) bar (E) mim BAR SPLICER ASSEMBLY FOR #5 BAR ON STUB ABUTMENTS No. required = Threaded splicer bar (E)

lit \1030	BSD-1	2-17-2017								
efat		USER NAME =	DESIGNED - MTH	REVISED -		BAR SPLICER ASSEMBLY AND MECHANICAL SPLICER DETAILS	F.A.I RTE	SECTION		OTAL SHEET HEETS NO.
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I S E	Consulting Engineers	PLOT SCALE =	DRAWN - DAS	REVISED -	DEPARTMENT OF TRANSPORTATION	STRUCTURE NO. 084-0020		(***=/**(****)=****	CONTRACT	T NO. 72J97
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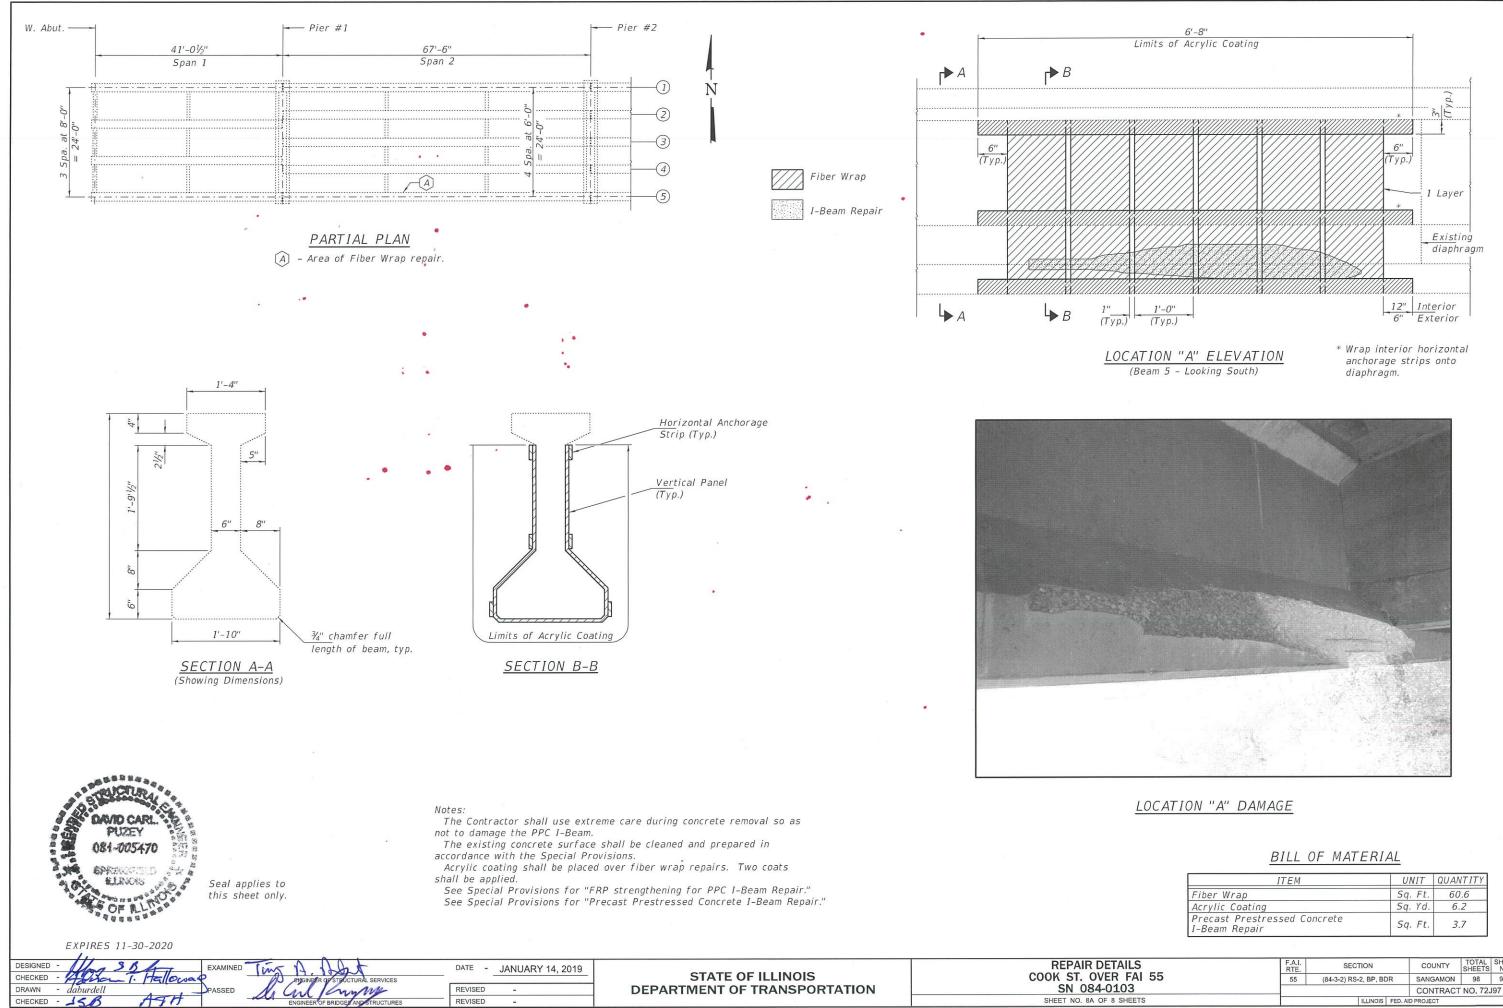
STANDARD MECHANICAL SPLICER

Location	Bar	No. assemblies
Location	size	required

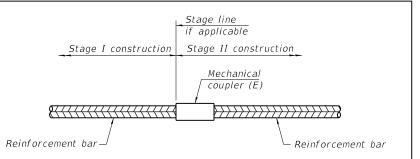NOTES


Splicer bars shall be deformed with threaded ends and have a minimum 60 ksi yield strength.

All reinforcement shall be lapped and tied to the splicer bars. Bar splicer assemblies shall be epoxy coated according to the requirements for reinforcement bars. See Section 508 of the Standard Specifications. See approved list of bar splicer assemblies and mechanical splicers for alternatives.



ITEM	UNIT	QUANTITY
Fiber Wrap	Sq. Ft.	60.6
Acrylic Coating	Sq. Yd.	6.2
Precast Prestressed Concrete I-Beam Repair	Sq. Ft.	3.7

AILS	F.A.I. RTE.	SECTION		COUNTY	TOTAL SHEETS	SHEET NO.
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				CONTRACT NO. 72J97		
SHEETS		ILLINOIS FED. AID PROJECT				

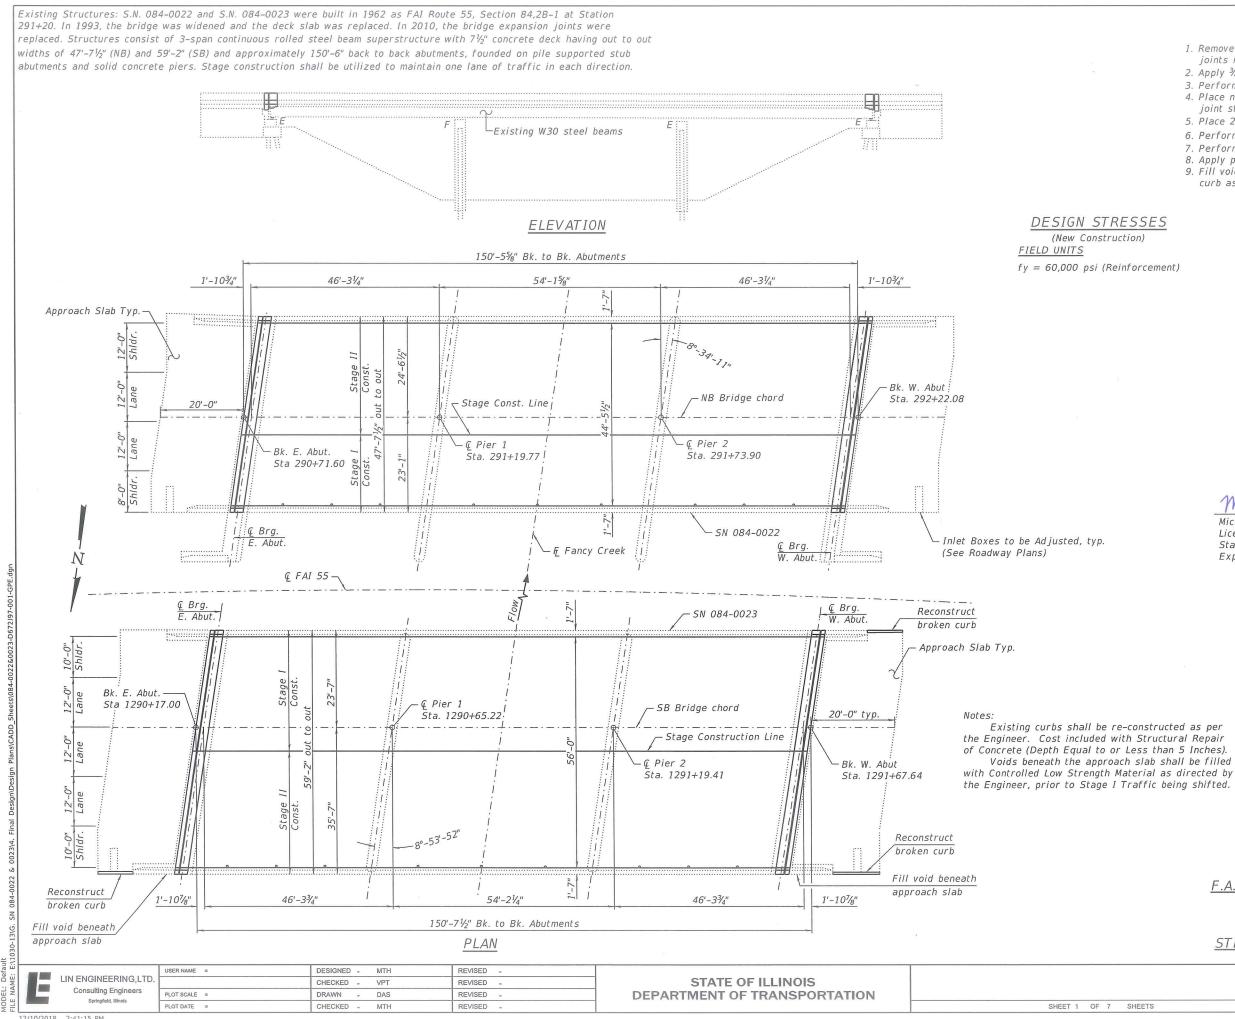

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SCOPE OF WORK

- 1. Remove concrete deck and parapets at the expansion joints in order to replace strip seal joints.
- 2. Apply $\frac{3}{4}$ " hydro-scarification to deck slab.
- 3. Perform deck and approach slab repairs. 4. Place new superstructure concrete and preformed joint strip seal at abutments.
- 5. Place 2³/₄" microsilica concrete overlay on deck slab.
- 6. Perform 1/4" Diamond Grinding.
- 7. Perform bridge deck grooving on new deck surface.
- 8. Apply protective coat.
- 9. Fill voids under shoulder and fix broken approach curb as indicated.

INDEX OF SHEETS

- General Plan and Elevation
- General Data
- Deck Slab Repair Plan
- 4.-5. Joint Replacement Details
- Preformed Joint Strip Seal 6. 7.
- Bar Splicer Details




12-11-2018 Date

Michael T. Haley Licensed Structural Engineer State of Illinois No. 81-5991 Expires 11/30/2020

> Range 5W | Range 4W 3rd P.M. Proposed Rehabilitation LOCATION SKETCH

GENERAL PLAN AND ELEVATION
<u>1-55 OVER FANCY CREEK</u>
<u>F.A.I. RTE. 55 – SEC. (84–2) & (84–3)BRR</u>
<u>SANGAMON COUNTY</u>
<u>STATION 291+20.00</u>
<u>STRUCTURE NOS. 084-0022 & 084-0023</u>

	F.A.I. RTE.	SECTION	COUNTY	TOTAL	SHEET NO.	
	55	(84-2) & (84-3) BRR	SANGAMON	98	92	
			CONTRA	CT NO.	72J97	
SHEETS	ILLINOIS FED. AID PROJECT					

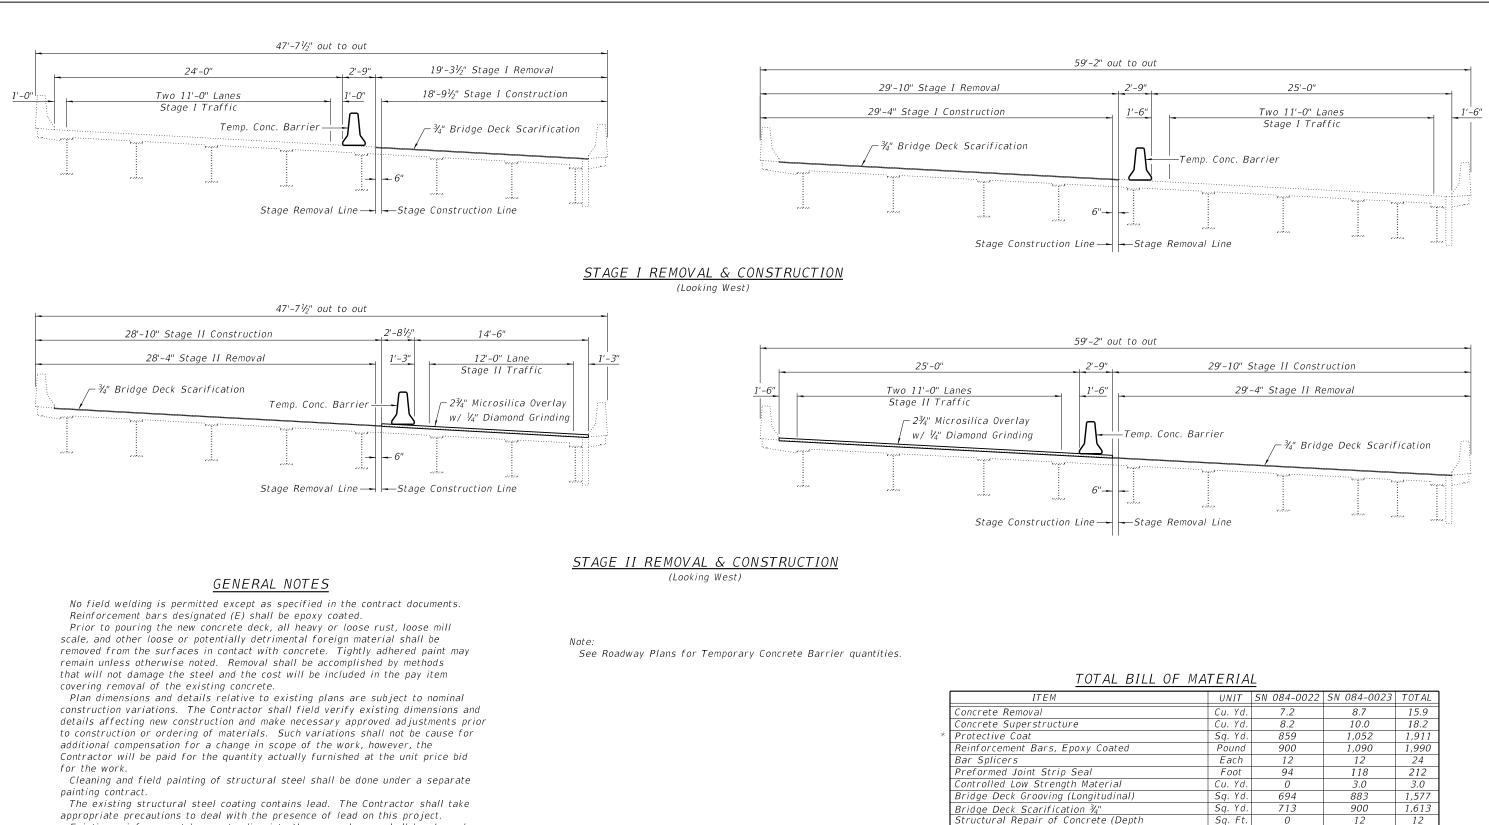

Existing reinforcement bars extending into the removal area shall be cleaned, straightened and incorporated into the new construction. Any reinforcement bars that are damaged during concrete removal shall be replaced with an approved bar splicer or anchorage system. Cost included with Concrete Removal.


Joint openings shall be adjusted according to Article 520.04 of the Std. Specs. when the deck is poured at an ambient temperature other than 50° F. Synthetic fibers shall be added to the Bridge Deck Microsilica Concrete Overlay.


See Special Provisions.

ITEM	UNIT	SN 084-0022	SN 084-0023	TOTAL
Concrete Removal	Cu. Yd.	7.2	8.7	15.9
Concrete Superstructure	Cu. Yd.	8.2	10.0	18.2
Protective Coat	Sq. Yd.	859	1,052	1,911
Reinforcement Bars, Epoxy Coated	Pound	900	1,090	1,990
Bar Splicers	Each	12	12	24
Preformed Joint Strip Seal	Foot	94	118	212
Controlled Low Strength Material	Cu. Yd.	0	3.0	3.0
Bridge Deck Grooving (Longitudinal)	Sq. Yd.	694	883	1,577
Bridge Deck Scarification 3/4"	Sq. Yd.	713	900	1,613
Structural Repair of Concrete (Depth	Sq. Ft.	0	12	12
Equal to or Less than 5 Inches)				
Bridge Deck Microsilica Concrete Overlay, $2rac{3}{4}$ "	Sq. Yd.	713	900	1,613
Deck Slab Repair (Full Depth, Type I)	Sq. Yd.	0	1.0	1.0
Deck Slab Repair (Full Depth, Type II)	Sq. Yd.	20.0	75.0	95.0
Approach Slab Repair (Partial Depth)	Sq. Yd.	3.0	2.9	5.9
Diamond Grinding (Bridge Section)	Sq. Yd.	675	868	1,543

Apply to top and inside faces of parapets, and to top of deck slab including new concrete adjacent to expansion joints.

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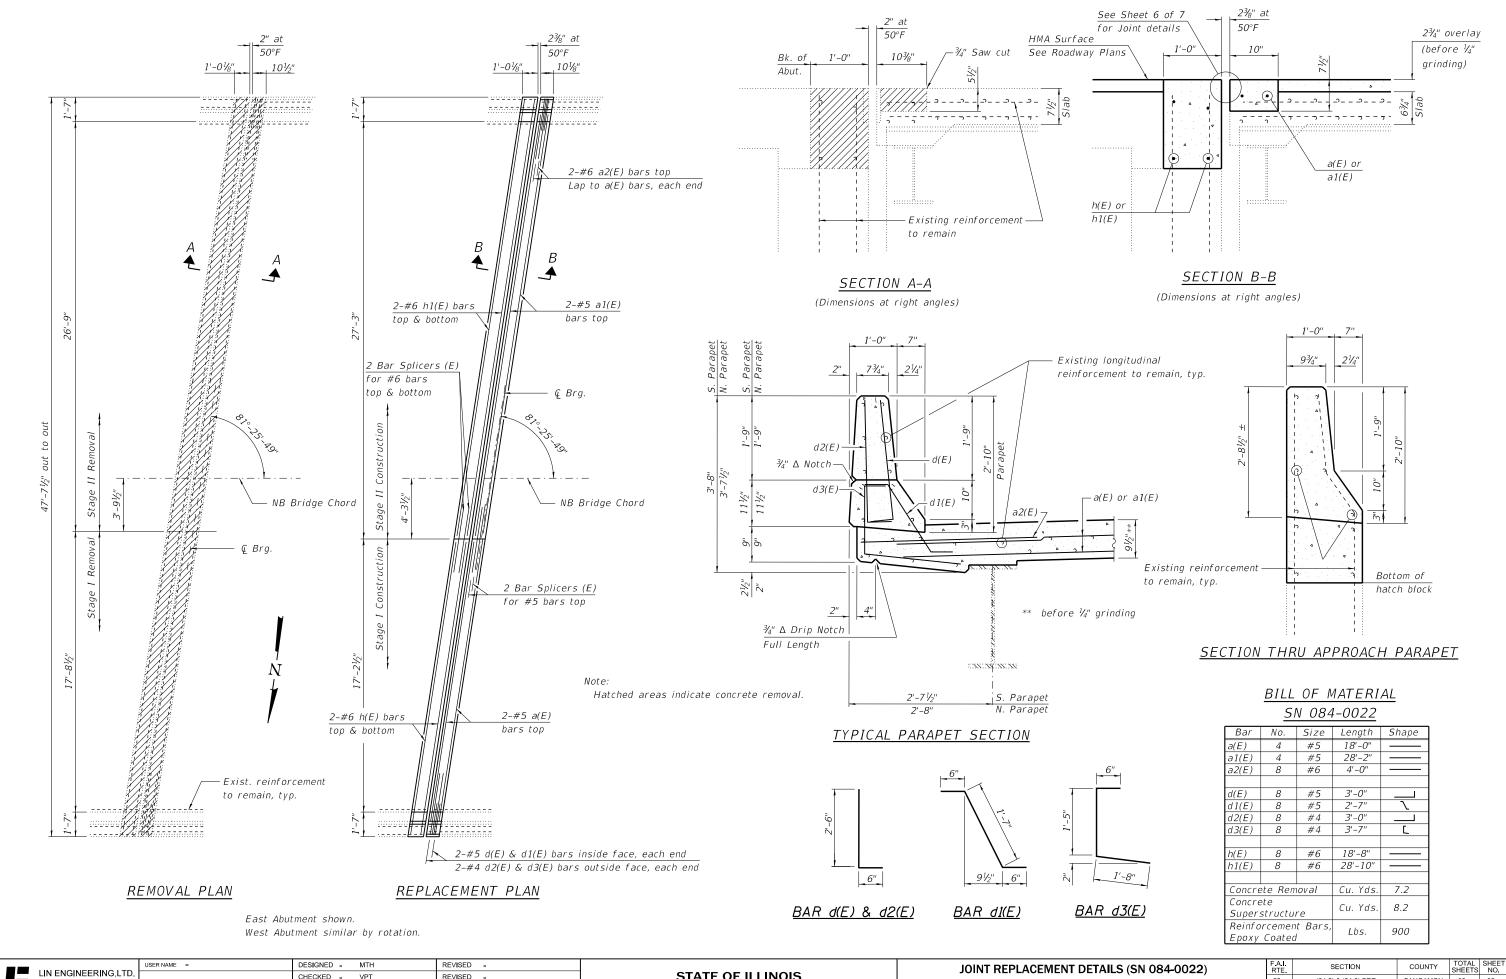
BILL OF MATERIAL

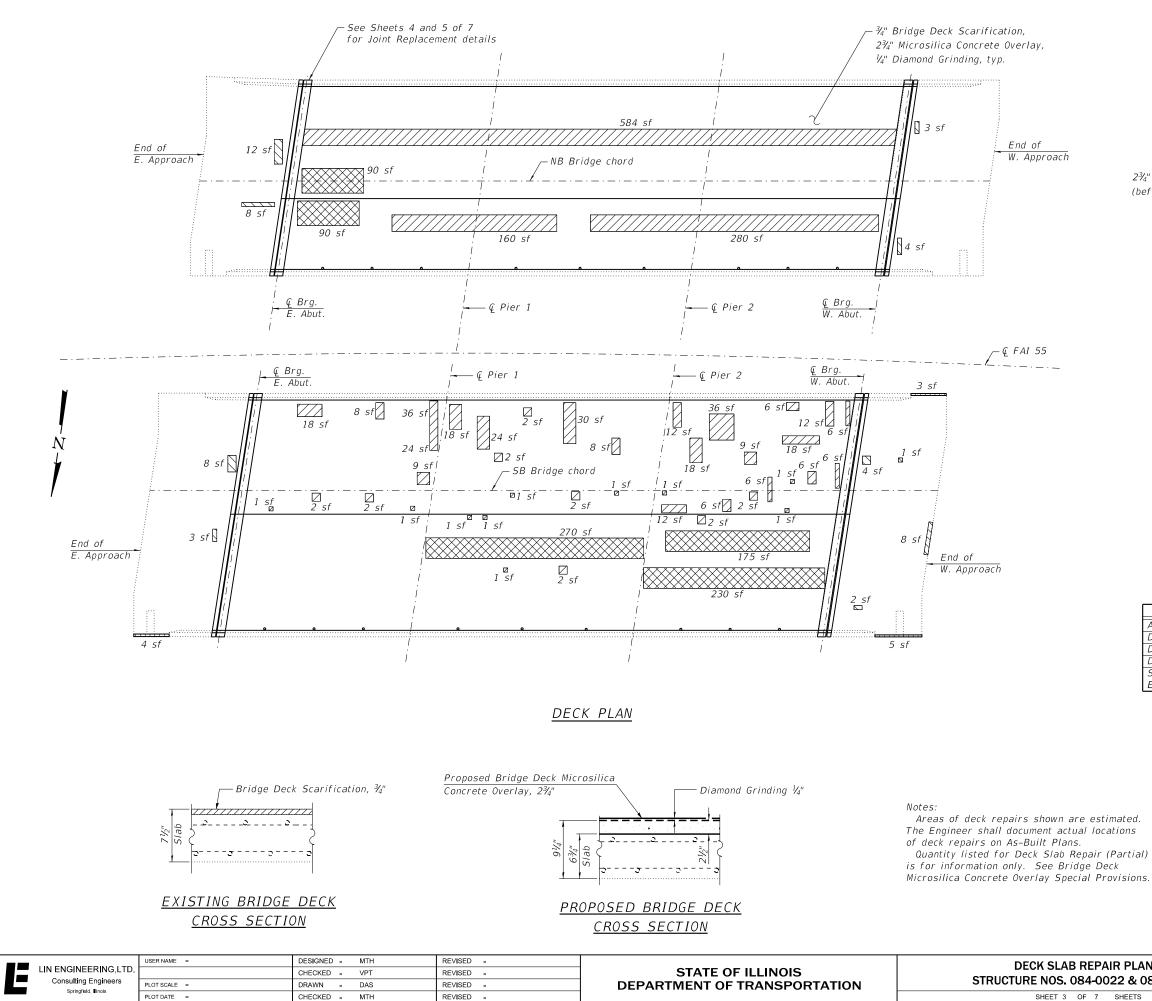ITEM	UNIT	TOTAL
Approach Slab Repair (Partial Depth)	Sq. Yd.	5.9
Deck Slab Repair (Partial Depth)	Sq. Yd.	153.4
Deck Slab Repair (Full Depth, Type I)	Sq. Yd.	1.0
Deck Slab Repair (Full Depth, Type II)	Sq. Yd.	95.0
Structural Repair of Concrete (Depth	Sq. Ft.	12
Equal to or Less than 5 Inches)		

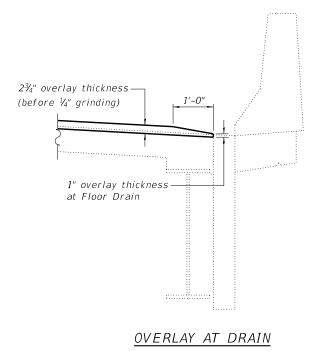LEGEND

	Indicates Approach Slab Repair (Partial Depth)
	Indicates Deck Slab Repair (Partial) (For information only)
\bigotimes	Indicates Deck Slab Repair (Full Depth)
	Indicates Structural Repair of Concrete (Depth Equal to or Less than 5 Inches)
sf	– Square Feet

PAIR PLAN 0022 & 084-0023		SECTION			COUNTY TOTAL SHEETS		SHEET NO.
		(84-2) & (84-3) BRR			SANGAMON	98	94
					CONTRACT NO. 72J		
7 SHEETS	ILLINOIS FED. AID PROJECT						




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SECTION		Bar	No.	Size	Length	Shape			
<u>SECTION</u>		a(E)	4	#5	18'-0"				
		a1(E)	4	#5	28'-2"				
	6"	a2(E)	8	#6	4'-0"				
~									
		d(E)	8	#5	3'-0"				
	-	d1(E)	8	#5	2'-7"	٦			
		d2(E)	8	#4	3'-0"				
		d3(E)	8	#4	3'-7"	Ĺ			
\mathbf{N}									
		h(E)	8	#6	18'-8"				
		h1(E)	8	#6	28'-10"				
9 ¹ / ₂ " 6"	₹\								
	I		ete Ren	ioval	Cu. Yds.	7.2			
	BAR d3(E)	Concre			Cu. Yds.	8.2			
N <u>R d1(E)</u>	DAN UJ(L)		structu						
				t Bars,	Lbs.	900			
		Epoxy	Coated	1			l I		
DINT REPLACE	MENT DETAILS (SN 084-0022)		F.A.I. RTE	5	SECTION	COUN	ITY TOTA	L SHEE TS NO.	Г
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SINCOLLIN						0		72 107	-1


CONTRACT NO. 72J97

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		_						
	Bar	No.	Size	Length	SI	hape		
	a2(E)	8	#6	4'-0''				
	a3(E)	4	#5	28'-8"	-			
6"	a4(E)	4	#5	29'-2"	_			
	d(E)	8	#5	3'-0"	_			
	d1(E)	8	#5	2'-7"		1		
	d2(E)	8	#4	3'-0"				
	d4(E)	4	#4	4'-8''		Ĺ		
	d5(E)	4	#4	3'-11"		Ĺ		
	h2(E)	8	#6	29'-4"				
$\frac{2'-9''}{d4(E)}$	h3(E)	8	#6	29'-10"				
<u>2'-9"</u> 2'-0" d4(E) d5(E)		ete Rer	noval	Cu. Yds.	8	3.7		
<u>d4(E) & d5(E)</u>	Concre Super:		ire	Cu. Yds.	1	10.0		
	Reinfo Epoxy		nt Bars, d	Lbs.	1	,090		
TAILS (SN 084-0023)		F.A.I. RTE	5	SECTION		COUNTY	TOTAL SHEETS	SHEET NO.
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TAILS (SN 084-0023)		SECTION		COUNTY	TOTAL SHEETS	SHEET NO.	
-0022 & 084-0023		(84-2) & (84-3) BRR		र	SANGAMON	98	96
-0022 & 084-0025					CONTRA	CT NO.	72J97
7 SHEETS			ILLINOIS	FED. A	D PROJECT		

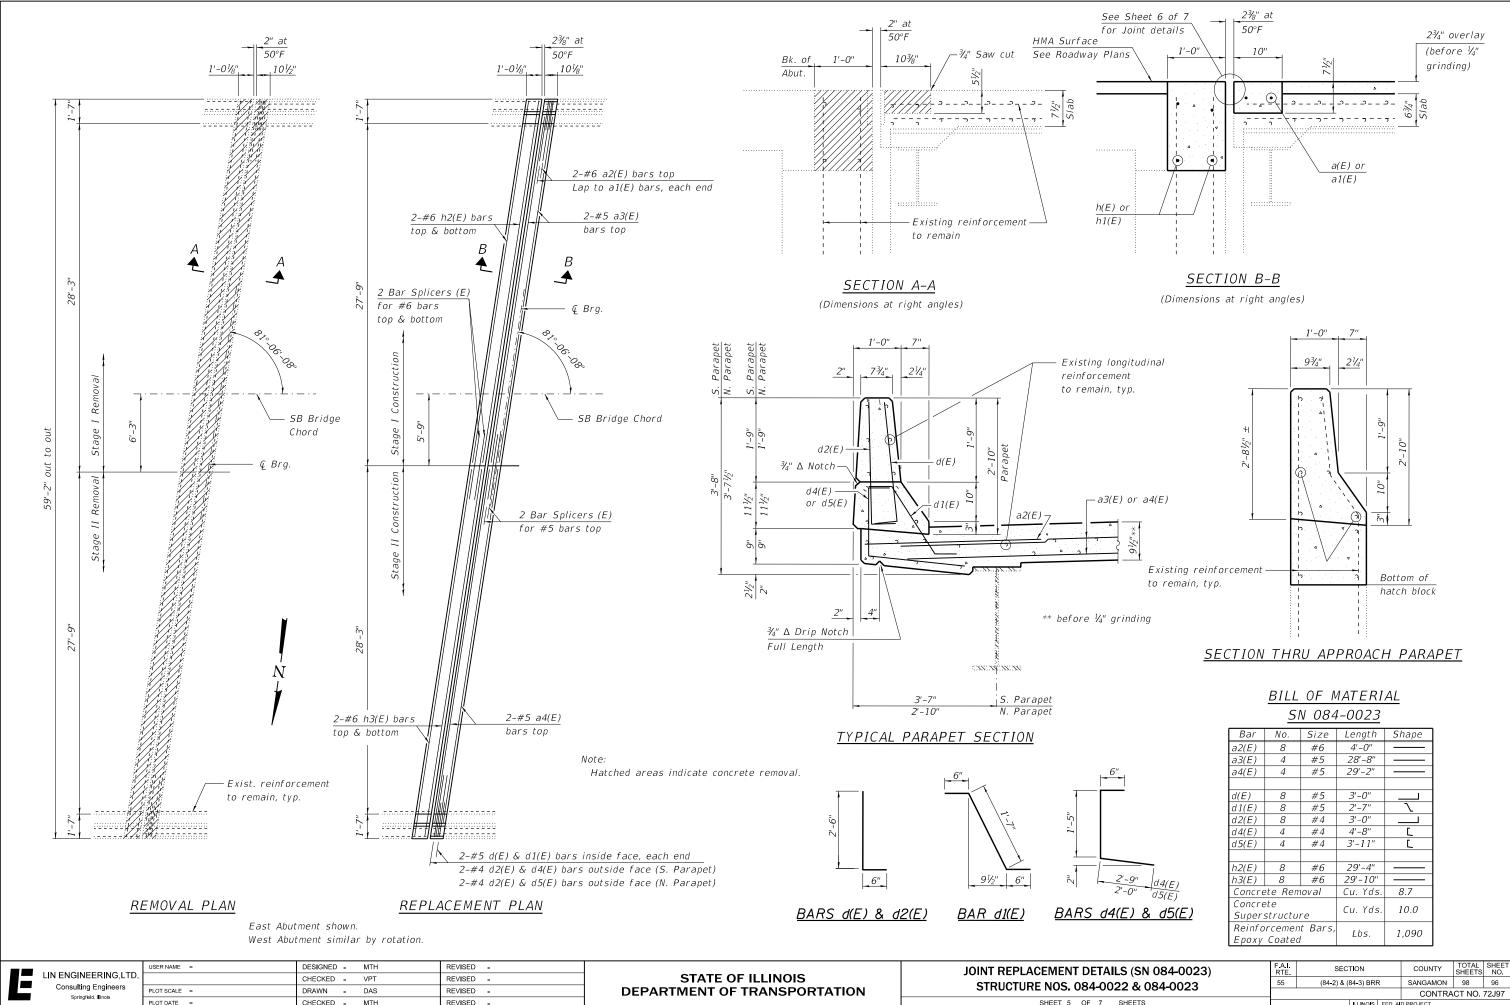

The strip seal shall be made continuous and shall have a minimum thickness of $\frac{1}{4}$ ". The configuration of the strip seal shall match the configuration of the locking edge rails. Open or "webbed" strip seal gland configurations are not permitted. The gland shall be sized for a maximum rated movement of 4 inches.

The locking edge rails depicted are configured for typical applications and are conceptual only. The actual configuration of the locking edge rails and matching strip seal may vary from manufacturer to manufacturer provided they fit the application and meet the minimum anchorage shown. Flanged edge rails, however, will not be allowed. Locking edge rails may exceed the 4¹/₂" maximum depth provided the anchorage system is revised according to the manufacturer's recommendation.

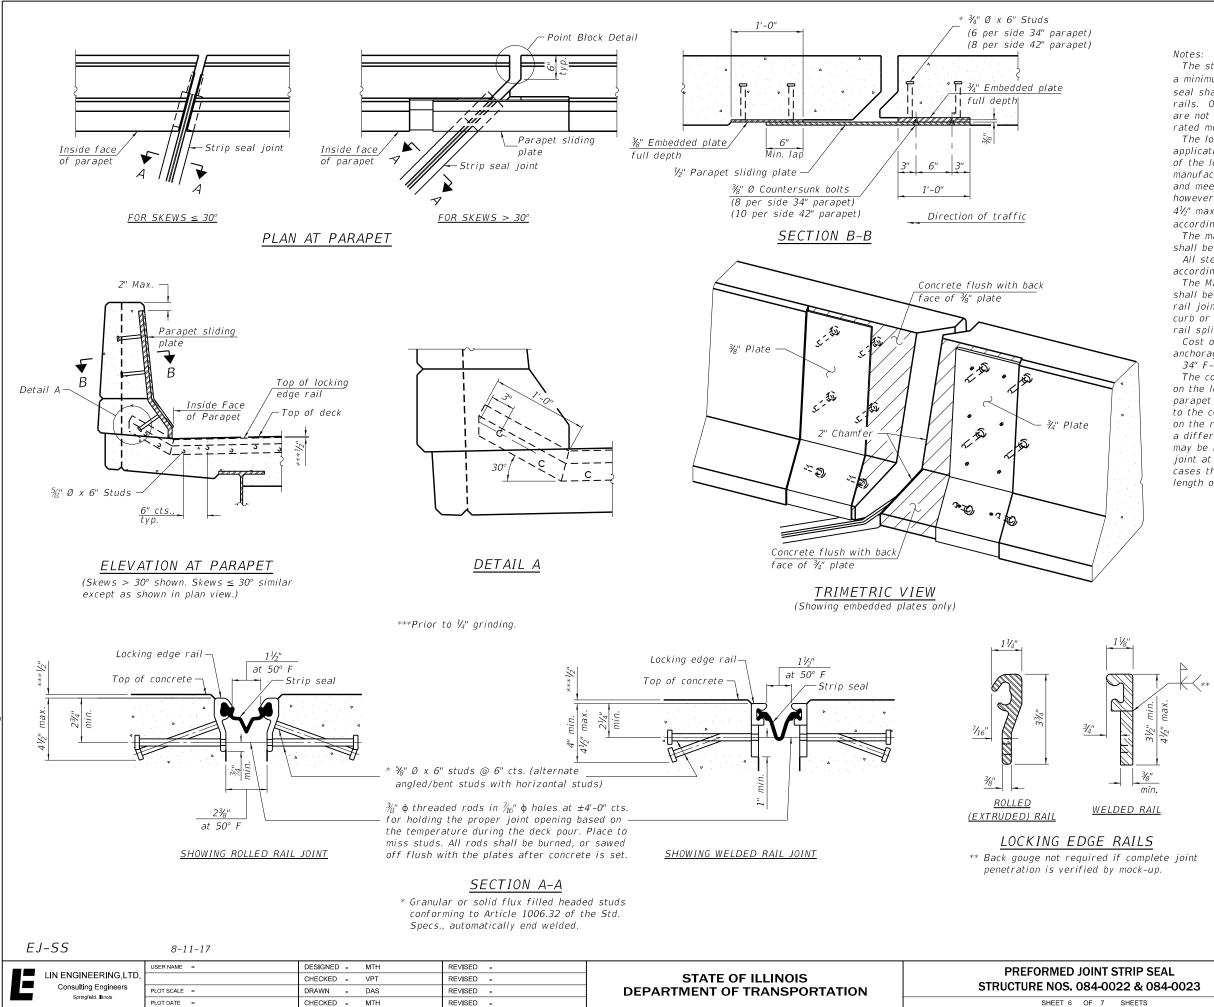
The manufacturer's recommended installation methods shall be followed.

All steel components shall be galvanized after fabrication according to Article 520.03 of the Standard Specifications.

The Maximum space between locking edge rail segments shall be $\frac{3}{16}$ " and sealed with a suitable sealant; however, any rail joint within 10' measured perpendicular to the face of the curb or parapet shall be welded as shown in the locking edge rail splice detail.

Cost of parapet sliding plates, embedded plates, and anchorage studs included with Preformed Joint Strip Seal.

34" F-shape barrier shown, 42" F-shape similar as noted. The concrete opening below the strip seal will vary based on the locking edge rail chosen by the Contractor. Deck and parapet lengths shown elsewhere in the plans are dimensioned to the concrete opening, not the joint opening, and are based on the rolled locking edge rail. If the Contractor elects to use a different locking edge rail, dimensional adjustments may be required. One exception to this would be the strip seal joint at the end of the precast bridge approach slab. For these cases the pavement connector length shall be adjusted, not the length of the bridge approach slab.

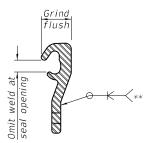


LOCKING EDGE RAIL SPLICE

The inside of the locking edge rail groove shall be free of weld residue. Rolled rail shown, welded rail similar.

Item	Unit	Total
Preformed Joint Strip Seal	Foot	212


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0022 & 084-0023					CONTRACT NO. 72J97			
7 SHEETS			ILLINOIS	FED. A	D PROJECT			

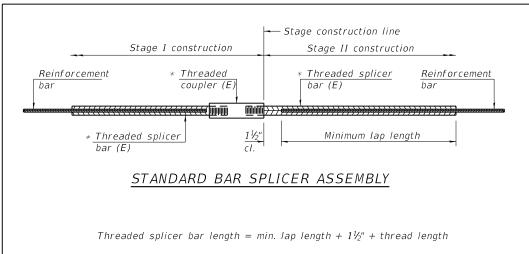

* Epoxy not required on Bar Splicer Assembly components used in conjunction with black bars.

**Location	**Bar	No. assemblies	**Minimum
Location	size	required**	lap length
West Abutment	#5	2	3'-6"
West Abutment	#6	4	4'-0"
East Abutment	#5	2	3'-6"
East Abutment	#6	4	4'-0''


** Typical each structure

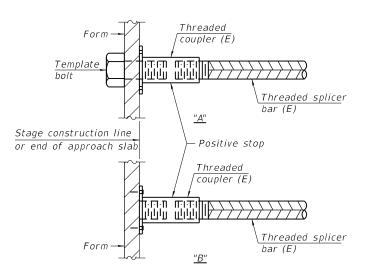


INSTALLATION AND SETTING METHODS


"A" : Set bar splicer assembly by means of a template bolt.

"B" : Set bar splicer assembly by nailing to wood forms or cementing to steel forms.

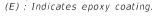

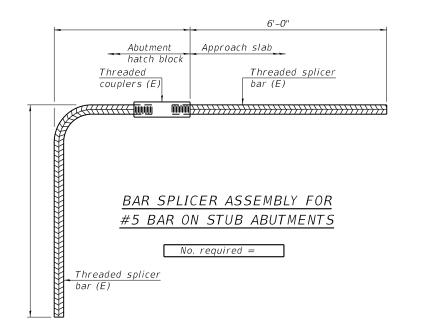

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STANDARD MECHANICAL SPLICER

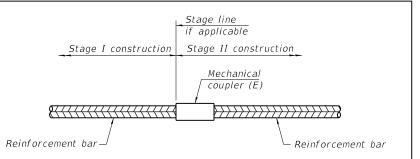Location	Bar size	No. assemblies required

NOTES

Splicer bars shall be deformed with threaded ends and have a minimum 60 ksi yield strength.

All reinforcement shall be lapped and tied to the splicer bars. Bar splicer assemblies shall be epoxy coated according to the requirements for reinforcement bars. See Section 508 of the Standard Specifications. See approved list of bar splicer assemblies and mechanical splicers for alternatives.