03-08-2019 LETTING ITEM 172

FOR INDEX OF SHEETS, SEE SHEET NO. 2 FOR LIST OF STANDARDS, SEE SHEET NO. 2


DESIGN DESIGNATION


IL ROUTE 29 (MAIN STREET) OTHER PRINCIPAL ARTERIAL ADT = 22,200 (2015) PV = 93%MU = 2%SU = 5%

STATE OF ILLINOIS DEPARTMENT OF TRANSPORTATION DIVISION OF HIGHWAYS **PROPOSED**

HIGHWAY PLANS

FAP ROUTE 669 (US 24/IL 29/MAIN STREET) SECTION 16-00045-01-SW FEDERAL PROJECT 05E2(122) RESURFACING, SIDEWALK AND LIGHTING CONSTRUCTION VILLAGE OF CREVE COEUR TAZEWELL COUNTY C-94-018-17 ITEP# 441011

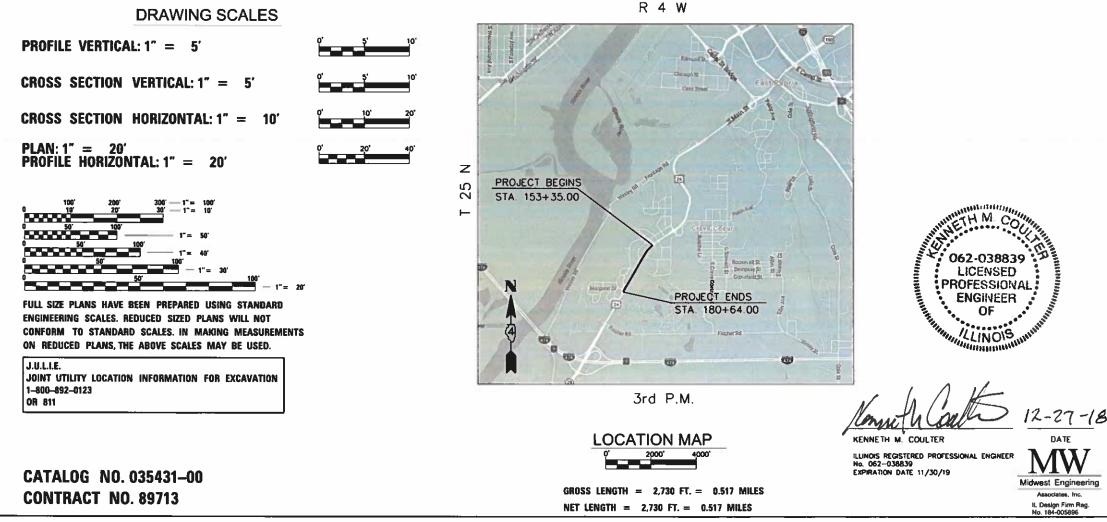

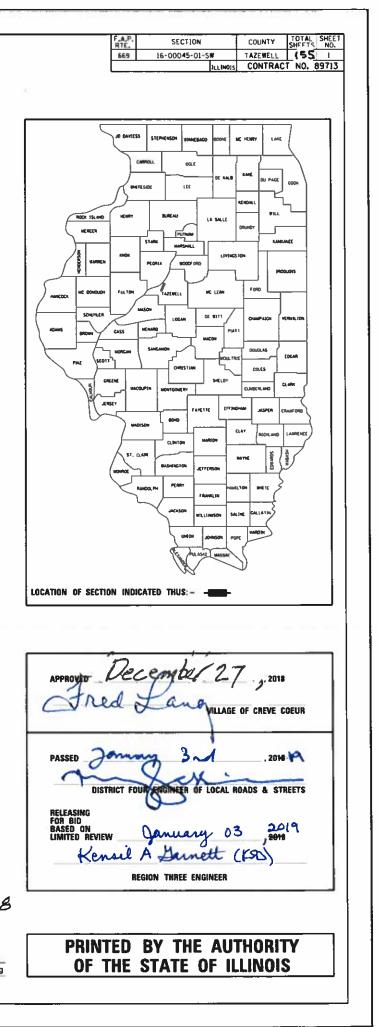

INDEX OF SHEETS

<u>SHT. NO.</u>	DESCRIPTION	 CONTRACTOR SHALL CONTACT PRO PRIOR TO BEGINNING WORK AT THIS DF CONTACT INFORMATION.
1 2 3-4 5 6-16 17 18 19-21 22 23-28 29-34 35-41 42-47 48-52 53-58 59-64 65-75 76-85 86 87-90 91 92-94 95-96	COVER SHEET INDEX OF SHEETS, LIST OF STANDARDS AND COMMITMENTS GENERAL NOTES STATUS OF UTILITIES SUMMARY OF QUANITIES EXISTING TYPICAL SECTION PROPOSED TYPICAL SECTIONS SCHEDULE OF QUANITIES LINE DIAGRAM, ALIGNMENT TIES AND BENCHMARKS REMOVAL PLANS STA. 153+35 TO STA. 180+54 ROADWAY PLANS AND PROFILES STA. 153+35 TO STA. 180+54 MAINTENANCE OF TRAFFIC - STAGES 1, 2, 3, 4, 5, AND 6 DRAINAGE PLANS AND PROFILES - LEFT STA. 153+35 TO STA. 180+54 DRAINAGE PLANS AND PROFILES - LEFT STA. 153+50 TO STA. 180+54 RIGHT OF WAY PLANS PAVEMENT MARKING, SIGNING AND EROSION CONTROL PLANS LIGHTING PLANS WATER MAIN PLANS AND PROFILES WATER MAIN DETAILS ADA RAMP DETAILS ADA RAMP DETAILS IDOT DISTRICT 4 STANDARD 205001 SLOPE STEPS DETAIL IDOT DISTRICT 4 STANDARD 423101 URBAN ENTRANCES, ACCESSIBLE TO THE DISABLED, FOR CURBLINE SIDEWALKS	2) 10 INDIVIDUAL TREES AND 0.21 AC SHALL BE REPLACED WITH 8 BALLED A SEEDLINGS PER THE PLANS. THE DIST CONTACTED AND PRIOR APPROVAL OBT THE LIMITS/LOCATION INCLUDED IN THE 3) THE CONTRACTOR MAY ONLY WORK ENTRANCES TO THORNTONS (STA. 174- WILL BE REQUIRED TO WORK ON ONLY THE EXCEPTION OF WHEN THE STORM SE AT THE TIME OF THE STORM SEWER AN TRENCH WILL BE BACKFILLED IMMEDIATI AND THE TRENCH WILL BE COVERED AN CONSTRUCTION AT THE ENTRANCES WIL AND 3 P.M. THE OWNER SHALL BE NO START OF ANY NEW CONSTRUCTION AT
97-98 99-100 101 102 103 104 105 106 107 108 109-110 111 112-155	IDOT DISTRICT 4 STANDARD 423106 URBAN ENTRANCES, ACCESSIBLE TO THE DISABLED, FOR SEPARATED SIDEWALKS IDOT DISTRICT 4 STANDARD 423116 URBAN ENTRANCES, SPECIAL DESIGN FOR CLOSELY SPACED ENTRANCES IDOT DISTRICT 4 STANDARD 424106 COMBINATION CONCRETE CURB-SIDEWALK 4" (SPECIAL) IDOT DISTRICT 4 STANDARD 440001 HOT MIX ASPHALT SURFACE REMOVAL (COLD MILLING) IDOT DISTRICT 4 STANDARD 602001 INLETS, TYPE G1 IDOT DISTRICT 4 STANDARD 602011 INLETS, TYPE G1 DOUBLE IDOT DISTRICT 4 STANDARD 602021 INLET-MANHOLE, TYPE G1 IDOT DISTRICT 4 STANDARD 602021 INLET-MANHOLE, TYPE G1 IDOT DISTRICT 4 STANDARD 602011 PRECAST REINFORCED CONCRETE FLAT SLAB TOP FOR INLET-MANHOLE, TYPE G-1, SPECIAL IDOT DISTRICT 4 STANDARD 604001 FRAME & GRATES FOR TYPE G-1 AND TYPE G-1, SPECIAL DRAINAGE STRUCTURES IDOT DISTRICT 4 STANDARD 667106 PERMANENT SURVEY MARKER TYPE II (SPECIAL) IDOT DISTRICT 4 STANDARD 780001 TYPICAL PAVEMENT MARKINGS PIPE HANDRAIL DETAIL CROSS SECTIONS RT 29	LIST OF STANDARDS000001-07602301-04280001-07602401-06353001-05620406-10406201-01602601-06424001-11602701-02424006-04604001-04424011-04604006-05424021-05604011-05424026-03606001-07



	USER NAME = IDOT	DESIGNED -	КМС	REVISED -					L. RTE. 29		F.A.P.	SECTION	COUNTY TO	OTAL SHEET
5		DRAWN -	KRS DLC	REVISED -	STATE OF ILLINOIS		е опесто		_		669	16-00045-01-SW	TAZEWELL 1	155 2
	PLOT SCALE = 2.000 FT / in.	CHECKED -	RDC	REVISED -	DEPARTMENT OF TRANSPORTATION	INDEX OF SHEETS, LIST OF STANDARDS AND COMMITMENTS							CONTRACT N	NO. 89713
	PLOT DATE = 1/29/2019	DATE +	\$DATE	REVISED -		SCALE: NONE	SHEET	OF	SHEETS STA.	TO STA.		ILLINOIS FEE	AID PROJECT 05E2(12	22)

PROPERTY OWNER AT STATION 166+00 LEFT, DRIVEWAY. ENGINEER WILL PROVIDE

COMMITMENTS

442201-0**3**

542301-03

667101-02

ACRES OF TREES ARE BEING REMOVED AND D AND BURLAPPED TREES AND 6 UNITS OF DISTRICT 4 TREE COMMITTEE SHALL BE OBTAINED FOR ANY TREE REMOVAL BEYOND THE PLANS.

YORK ON ONE ENTRANCE AT A TIME AT THE 74+75 TO STA. 176+75). THE CONTRACTOR ALLY HALF OF EACH ENTRANCE AT A TIME WITH RM SEWER AND WATER MAIN IS INSTALLED. R AND WATER MAIN INSTALLATION, THE DRIVEWAY WATELY AFTER THE PIPE IS PROPERLY IN PLACE O AND OPENED TO TRAFFIC. STORM SEWER WILL OCCUR BETWEEN THE HOURS OF 9 A.M. E NOTIFIED AT LEAST 30 DAYS PRIOR TO THE AT THE ROUTE 29 ENTRANCES.

701101-05	814001-03
701106-02	814006-02
701427-05	821101-02
701602-10	825021-04
701701-10	830001-03
701801-06	830011-03
701901-08	836001-04
720001-01	838001-01
720006-04	
720011-01	
728001-01	
729001-01	
731001-01	
780001-05	
781001-04	

105.06 AVAILABILITY OF ELECTRONIC FILES

Micro Station and GEOPAK files of this project will be made available to the Contractor after contract award. If there is a conflict between the electronic files and the printed contract plans and documents, the printed contract plans and documents shall take precedence over the electronic files. The Contractor shall accept all risk associated with using the electronic files and shall hold the Department harmless for any errors or omissions in the electronic files and the data contained therein. Errors or delays resulting from the use of the electronic files by the Contractor shall not result in an extension of time for any interim or final completion date or shall not be considered cause for additional compensation. The Contractor shall not use, share, or distribute these electronic files except for the purpose of constructing this contract. Any claims by third parties due to use or errors shall be the responsibility of the Contractor. The Contractor shall include this disclaimer with the transfer of these electronic files to any other parties and shall include appropriate language binding them to similar responsibilities.

105,07 TREE REMOVAL – UTILITY RELOCATION

Tree removal may be necessary prior to utility companies being able to relocate their facilities outside the construction limits. The Contractor should coordinate any contract tree removal activities with the utility companies to eliminate conflicts and potential delays caused by utility tree removal activities or incomplete utility relocations.

105.09A PLAN ELEVATIONS - U. S. G. S. MEAN SEA LEVEL DATUM

1. All elevations shown on the plans are established from U.S.G.S. mean sea level datum.

PROPERTY OWNER ACCESS REQUIREMENTS 107.09

Access must be maintained to all existing properties during construction per Article 107.09 unless arrangements are made in writing by the Contractor with the property owners with a copy to the Engineer for short-term closures.

107.09 **CONSECUTIVE SIDE STREET (ROAD) CLOSURE – PROHIBITED**

1. No two consecutive side streets (roads) may be closed at the same time during construction. The Contractor must alternate streets (roads).

2. Adjacent sideroads will not be closed simultaneously. BLR Standard 21 shall be used for all local road closures without any entrances within the closed area. BLR Standard 22 can be used where it is necessary to allow local traffic access.

202.08 EARTH EXCAVATION – INCIDENTAL TO CURB, GUTTER & DRIVEWAY

Earth excavation and backfill for proposed curb and gutters and driveway pavements shall be included in the unit cost of the various items.

204.00 ENVIRONMENTAL REVIEWS

Prior to the use of any proposed borrow areas, use areas (temporary access roads, detours, run-arounds, etc.) and/or waste areas, the Contractor shall file the required environmental resource request surveys according to Section 107.22 of the Standard Specifications. These surveys are required in order for the Department to conduct cultural and biological resource surveys for the proposed site.

Prior to any waste materials being removed from the construction site the required environmental resource surveys will need to be obtained and filed by the Contractor. Excess waste products removed from the construction site shall be disposed of as required in Section 202.03 of the Standard Specifications.

Any protruding metal bars shall be removed prior to the disposal of broken concrete at approved disposal sites.

The required environmental resource documentation shall include the following:

- **BDE Form 2289 (Environmental Survey Request)**
- BDE Form 2290 (Waste/Use Area Review)
- Color photographs depicting the use area
- Borrow Area Entry Agreement form–D4 PI0101

Please note that a minimum of four weeks shall be allowed for the District to obtain the required environmental clearances and six weeks for the required borrow site environmental clearances.

7	USER NAME = IDOT	DESIGNED - KMC	REVISED -				IL	RTE. 29			F.A.P. RTE.	SECTION	COUNTY	TOTAL SHEET SHEETS NO.
/		DRAWN - KRS DLC	REVISED -	STATE OF ILLINOIS				RAL NO			669	16-00045-01-SW	TAZEWELL	155 3
ering	PLOT SCALE = 2.0000 '/ in.	CHECKED - RDC	REVISED -	DEPARTMENT OF TRANSPORTATION			GLINE						CONTRAC	T NO. 89713
•	PLOT DATE = 1/22/2019	DATE – \$DATE	REVISED -		SCALE:	SHEET	OF	SHEETS	STA.	TO STA.		ILLINOIS FE	. AID PROJECT OF	E2(122)

A location map showing the size limits and location of the use area

351.08 AGGREGATE FOR DRIVEWAY REPLACEMENT

The material used for construction of permanent aggregate driveways shall be gravel or crushed stone, as directed by the Engineer, to replace in kind the existing aggregate driveways. No additional compensation shall be provided for this requirement but shall be considered as included in the cost of the pay item for the aggregate as specified on the plans.

406.10 HOT-MIX ASPHALT MIXTURE REQUIREMENTS

Location(s):	IL ROUTE 29	IL ROUTE 29	DRIVEV	VAYS		at all times (
Mixture Use(s):	Polymer Surface Course 1.5"	Polymer Leveling Binder 1"	HMA Base Course, 4" or 6"	HMA Surface Course, 2"		No interrupt
PG:	SBS or SBR 76–28	SBS or SBR 76–22	PG 64–22	PG 64–22		
Design Air Voids:	4.0% @ N=70	4.0% @ N=50	4.0% @ N=50	4.0% @ N=50	542.00	ORDERING L
Mixture Composition:						
(Gradation Mixture):	IL 9.5	IL 4.75	IL 19.0	IL 9.5		The Contract
Friction Aggregate:	Mix E	N⁄A	N/A	Mix C		of the box⁄pi
Mixture Weight:	112#/SQ_YD/IN	112#/SQ_YD/IN	112#/SQ_YD/IN	112#/SQ_YD/IN		ordering the
Quality Management:						
Program	0C/0A	0C/0A	0C/0A	0C⁄0A	c02.00	
Sublot Size	N⁄A	N⁄A	N⁄A	N⁄A	602.00	EXISTING D
Number of Roller						In an and a set
Passes	N⁄A	N⁄A	N⁄A	N⁄A		In accordance
						connecting a

Notes:

1. Individual lift thickness of each mix type will be no less than 3 times nominal maximum aggregate size and no more than 6 times nominal aggregate size.

2. For design purposes, mixure weight is determined to be 112.0 lb/s.y./in., unless otherwise noted.

3. Sublot sizes for PFP and QCP mixes will be 700 tons, unless otherwise agreed to by the Engineer and the paving contractor.

406.18

Butt joints shall not be milled more than three (3) days prior to placement of the HMA surface course.

406.19 **PAVING SURFACE COURSE**

> Continuous paving operations on the main roadway shall be maintained during the construction of the hot-mix asphalt surface. ptions for side roads, entrances, turn lanes, etc. will be allowed.

actor shall consult with the Engineer in regard to the exact length pipe culverts, storm sewers, and/or pipe drains required prior to iese items.

DRAINAGE PIPES CONNECTED TO NEW STRUCTURES

nce with Section 602 of the Standard Specifications, the of existing drain tiles, pipe culverts, or storm sewers to the proposed drainage system structures will not be paid for separately but shall be considered as included in the pay items provided.

670.00 ENGINEERS FIELD OFFICE

Add the following sentence to the end of paragraph 670.02 (i) and 670.04 (e): All of the telephone lines provided shall have unpublished numbers.

720.00 SIGNING

Sign locations may vary from the stations shown on the plans in accordance with directions from the Engineer at the time of construction. Sign locations may be adjusted in the field to avoid any found utilities.

All wood post locations shall be verified with the Bureau of Operations, Traffic Section, before installation.

MW
Midwest Engineering
Associates Inc

	USER NAME = IDOT	DESIGNED - KMC	REVISED -				ш	RTE. 29
		DRAWN - KRS DLC	REVISED - ·	STATE OF ILLINOIS			_	
	PLOT SCALE = 2.0000 ' / m.	CHECKED - RDC	REVISED - ·	DEPARTMENT OF TRANSPORTATION			GENE	RAL NOT
_	PLOT DATE = 1/22/2019	DATE – ·\$DATE	REVISED - ·		SCALE:	SHEET	0F	SHEETS

BUTT JOINT CUTTING TIME RESTRICTION

LENGTH CONFIRMATION – DRAINAGE ITEMS

29 OTES		F.A.P. RTE.	SECTION		COUNTY	TOTAL SHEETS	SHEET NO.	
		669	16-00045-01-SW		TAZEWELL	155	4	
					CONTRAC	T NO. 8	<u>39713</u>	
S	STA	TO STA		ILLINOIS	FED.	AID PROJECT 05	E2(122)	

AMEREN GAS (REFER TO NOTES 1 AND 2)

(REFER TO NOTES 1 AND 2)							
STATION	OFFSET LT / RT	PROPOSED CONFLICT ITEM	DISPOSTION				
154+39.07	38.37 LT	WATER LINE TO HYDRANT	CAUTION OR RELOCATE				
156+18.33	37.05 LT	8" WATER MAIN	CAUTION OR RELOCATE				
159+84.88	33.07 LT	G1 STORM INLET	CAUTION OR RELOCATE				
162+19.84	33.42 LT	G1 STORM INLET	CAUTION OR RELOCATE				
162+31.13	32.91 LT	24" STORM SEWER PIPE	CAUTION OR RELOCATE				
164+06.95	37.86 LT	24" STORM SEWER PIPE	CAUTION OR RELOCATE				
164+39.55	64.77 RT	8" WATER MAIN	CAUTION OR RELOCATE				
166+99.00	38.12 LT	4' DIA. STORM MANHOLE	RELOCATE				
167+30.52	38.01 LT	4' DIA. STORM MANHOLE	RELOCATE				
168+77.22	31.80 LT	G1 STORM INLET	RELOCATE				
168+76.80	36.23 RT	12" STORM SEWER PIPE	CAUTION OR RELOCATE				
168+76.82	50.43 RT	8" WATER MAIN	CAUTION OR RELOCATE				
169+18.41	32.51 RT	5' DIA. INLET - MANHOLE	CAUTION OR RELOCATE				
171+28.88	37.31 RT	12" STORM SEWER PIPE	CAUTION OR RELOCATE				
172+15.97	37.20 RT	4' DIA. STORM MANHOLE	RELOCATE				
172+96.54	38.41' RT	12" STORM SEWER PIPE	CAUTION OR RELOCATE				
174+60.12	37.56' RT	12" STORM SEWER PIPE	CAUTION OR RELOCATE				
175+69.23	37.46 RT	12" STORM SEWER PIPE	CAUTION OR RELOCATE				
176+82.00	37.38 RT	12" STORM SEWER PIPE	CAUTION OR RELOCATE				
177+89.05	37.47 RT	12" STORM SEWER PIPE	CAUTION OR RELOCATE				
178+43.68	38.68 RT	18" STORM SEWER PIPE	CAUTION OR RELOCATE				
178+66.62	42.19 RT	30" DIA. LIGHT POLE FOUND.	CAUTION OR RELOCATE				
179+40.27	55.58 RT	8" WATER MAIN	CAUTION OR RELOCATE				
179+48.26	59.46 RT	8" WATER MAIN	CAUTION OR RELOCATE				
180+17.89	44.26 RT	G1 STORM INLET	CAUTION OR RELOCATE				
180+41.21	42.32 RT	8" WATER MAIN	CAUTION OR RELOCATE				

ITV3 FIBER OPTIC (REFER TO NOTES 1 AND 2)

	U 2)		
STATION	OFFSET LT / RT	PROPOSED CONFLICT ITEM	DISPOSITION
173+85.94	49.81 RT	8" WATER LINE	CAUTION OR RELOCATE
174+54.45	41.10 RT	30" LIGHT FOUNDATION	RELOCATE
174+60.28	40.86 RT	12" STORM SEWER	CAUTION OR RELOCATE
175+32.81	41.29 RT	30" LIGHT FOUNDATION	RELOCATE
176+04.44	41.83 RT	12" STORM SEWER	CAUTION OR RELOCATE
176+06.94	41.08 RT	30" LIGHT FOUNDATION	RELOCATE
176+22.51	44.06 RT	STORM INLET	CAUTION OR RELOCATE
176+58.28	43.96 RT	STORM INLET	CAUTION OR RELOCATE
176+82.00	44.08 RT	4' DIA. STORM MANHOLE	RELOCATE
176+96.01	41.08 RT	30" LIGHT FOUNDATION	RELOCATE
177+78.80	41.20 RT	30" LIGHT FOUNDATION	CAUTION OR RELOCATE
178+00.00	44.32 RT	4' DIA. STORM MANHOLE	RELOCATE
175+94 to			
178+17	44.0 RT	12" STORM SEWER	CAUTION OR RELOCATE
178+66.72	41.49 RT	30" LIGHT FOUNDATION	CAUTION OR RELOCATE
179+45.41	44.49 RT	12" STORM SEWER	CAUTION OR RELOCATE
179+65.39	42.66 RT	5' DIA. STORM MANHOLE	RELOCATE
180+17.70	42.96 RT	STORM INLET	RELOCATE
180+41.20	42.52 RT	8" WATER LINE	CAUTION OR RELOCATE
179+58 to			
180+15	42.75 RT	12" STORM SEWER	CAUTION OR RELOCATE
			CAUTION OR RELOCATE
			(FIBER IN ATT DUCT.
			LOCATION AND DEPTH NOT
153+35 to			DETERMINED AT ALL
180+64	LEFT	VARIOUS	LOCATIONS)

AMEREN POWER POLES (REFER TO NOTES 1 AND 2)

	(=.	ER TO NOTES 1 EXISTING	····,
STATION	OFFSET	DISTANCE	DISPOSITION
on mon	LT / RT	FROM CURB	
154+34.74	42.02 LT	7.24	CAUTION OR RELOCATE
154+64.55	38.34 RT	5.8	RELOCATE
155+31.01	40.07 LT	6.9	CAUTION OR RELOCATE
155+75.13	41.53 RT	9.3	
156+76.93	43.64 LT	10.65	
157+19.67	38.41 RT	6.4	RELOCATE
158+19.42	40.55 RT	8.2	CAUTION OR RELOCATE
158+24.38	40.54 LT	7.5	CAUTION OR RELOCATE
159+14.85	37.79 RT	5.2	RELOCATE
160+67.27	39.00 RT	6.6	RELOCATE
160+75.36	44.07 LT	7.9	REMOVE
162+27.13	40.46 RT	8.4	CAUTION OR RELOCATE
163+47.77	39.43 RT	7.6	CAUTION OR RELOCATE
164+68.97	40.02 RT	8	CAUTION OR RELOCATE
166+13.59	39.80 RT	7.4	CAUTION OR RELOCATE
166+26.40	50.25 LT	17.5	CAUTION
167+22.8	49.30 LT	16.2	CAUTION
167+62.38	40.52 RT	7.8	CAUTION OR RELOCATE
169+20.33	41.11 RT	8.8	CAUTION OR RELOCATE
169+32.40	35.80 LT	3.7	RELOCATE
169+36.04	36.87 LT	4	RELOCATE
171+65.23	39.98 RT	7.4	CAUTION OR RELOCATE
171+85.98	50.55 LT	18.1	CAUTION OR RELOCATE
173+07.45	49.94 LT	17.7	CAUTION OR RELOCATE
173+15.77	37.34 RT	6	RELOCATE
173+95.94	40.24 RT	6.4	CAUTION OR RELOCATE
174+34.88	50.78 LT	18.2	CAUTION
175+74.60	41.24 RT	7.1	CAUTION OR RELOCATE
177+57.06	41.71 RT	9.3	CAUTION OR RELOCATE
179+03.83	43.90 LT	10.4	CAUTION
179+42.61	40.75 RT	6.6	CAUTION OR RELOCATE

AT&T (REFER TO NOTES 1 AND 2)

VARIOUS

UTILITY PROPOSED CONFLICT ITEM

OFFSET LT / RT

LEFT

DUCT

CARRYING

FIBER

STATION

153+35 to

180+64

IDOT FIBER OPTIC (REFER TO NOTES 1 AND 2)

1

1

1

1

		(REFER TO NOTES 1 AN	D 2)
STATION	OFFSET LT / RT	PROPOSED CONFLICT ITEM	RELOCATION REQUIRED
159+77.68	34.58 RT	STORM INLET	CAUTION OR RELOCATE
161+61.49	35.48 RT	24" STORM SEWER	CAUTION OR RELOCATE
161+65.38	31.26 RT	4' DIA. STORM MANHOLE	CAUTION OR RELOCATE
163+75.44	35.36 RT	24" STORM SEWER	CAUTION OR RELOCATE
165+12.28	35.13 RT	12" STORM SEWER	CAUTION OR RELOCATE
165+30.01	33.27 RT	STORM INLET	CAUTION OR RELOCATE
166+63.02	40.75 RT	30" LIGHT FOUNDATION	CAUTION OR RELOCATE
167+65.63	40.72 RT	30" LIGHT FOUNDATION	CAUTION OR RELOCATE
167+89.99	44.00 RT	4' DIA. STORM MANHOLE	CAUTION OR RELOCATE
167+92.03	39.56 RT	12" STORM SEWER	CAUTION OR RELOCATE
168+31.95	40.25 RT	12" STORM SEWER	CAUTION OR RELOCATE
168+56.15	40.86 RT	30" LIGHT FOUNDATION	RELOCATE
169+27.32	45.24 RT	FIRE HYDRANT	CAUTION OR RELOCATE
169+68.87	40.97 RT	30" LIGHT FOUNDATION	RELOCATE
170+68.15	40.89 RT	30" LIGHT FOUNDATION	RELOCATE
171+28.48	40.57 RT	12" STORM SEWER	CAUTION OR RELOCATE
171+34.09	41.20 RT	30" LIGHT FOUNDATION	RELOCATE
172+11.75	41.05 RT	30" LIGHT FOUNDATION	RELOCATE
172+15.98	39.21 RT	4' DIA. STORM MANHOLE	RELOCATE
172+96.34	38.82 RT	12" STORM SEWER	CAUTION OR RELOCATE
173+00.35	41.00 RT	30" LIGHT FOUNDATION	CAUTION OR RELOCATE
173+75.89	41.00 RT	30" LIGHT FOUNDATION	CAUTION OR RELOCATE
174+54.45	41.00 RT	30" LIGHT FOUNDATION	CAUTION OR RELOCATE
174+60.15	38.08 RT	12" STORM SEWER	CAUTION OR RELOCATE
175+32.81	41.29 RT	30" LIGHT FOUNDATION	CAUTION OR RELOCATE
175+78.92	38.68 RT	12" STORM SEWER	CAUTION OR RELOCATE
176+06.94	41.08 RT	30" LIGHT FOUNDATION	CAUTION OR RELOCATE
176+82	39.19 RT	12" STORM SEWER	CAUTION OR RELOCATE
176+96.01	41.09 RT	30" LIGHT FOUNDATION	RELOCATE
177+78.81	41.21 RT	30" LIGHT FOUNDATION	RELOCATE
177+93.26	40.11 RT	12" STORM SEWER	CAUTION OR RELOCATE
178+00.00	44.32 RT	4' DIA. STORM MANHOLE	RELOCATE
178+28.41	40.63 RT	12" STORM SEWER	CAUTION OR RELOCATE
178+66.79	41.45 RT	30" LIGHT FOUNDATION	RELOCATE
179+35.13	41.82 RT	12" STORM SEWER	CAUTION OR RELOCATE
179+65.42	42.59 RT	5' DIA. STORM MANHOLE	RELOCATE
180+18.74	41.59 RT	STORM INLET	RELOCATE
180+41.21	40.11 RT	8" WATER MAIN	CAUTION OR RELOCATE

NOTES:

1) IDOT EMAILED PRELIMINARY PLAN INFORMATION TO MULTIPLE UTILITY COMPANIES IN FEBRUARY 2018. MIDWEST ENGINEERING ASSOCIATES DID NOT RECIEVE AT&T'S EXISTING UTLITY INFORMATION UNTIL JANUARY 2019. SINCE FINAL PLANS WERE SUBMITTED PRIOR TO RECEIPT OF AT&T'S INFORMATION, ONLY THE PLAN AND PROFILE SHEETS HAVE BEEN UPDATED TO INCLUDE INFORMATION RECEIVED FROM AT&T; THE AT&T INFORMATION IS NOT SHOWN ON THE CROSS SECTIONS.

2) REFER TO PLAN AND PROFIL AT&T'S KNOWN UTILITIES.

Utility Name	Contact	Telephone Number	Additional Information
Ameren - Gas	Joshua Donlan	309-677-5368	JDonlan@ameren.com
Ameren - Gas		305-077-3308	
Ameren - Electric	Edward Creighton	309-693-4774	ECreighton@ameren.com
ITV3 - Fiber	Lukas Dye	309-670-0400	engineering@itv-3.com
Comcast - Cable TV	James Vonbrethorst	309-686-2600	James Vonbrethorst@comcast.com

DISPOSITION

CAUTION OR RELOCATE

(LOCATION AND DEPTH NOT

DETERMINED AT ALL

LOCATIONS)

MW	
Midwest Engineerin	0
Associates, Inc.	

I	USER NAME = IDOT	DESIGNED - KMC	REVISED -		IL. RTE. 29				F.A.P.	SECTION	COUNTY TOTAL SHEE
V		DRAWN - KRS DLC	REVISED -	STATE OF ILLINOIS			STATUS OF UTILITIES		669	16-00045-01-SW	TAZEWELL 155 5
ering	PLOT SCALE = 2.000 FT / in.	CHECKED - RDC	REVISED -	DEPARTMENT OF TRANSPORTATION			STATUS OF UTIENTES				CONTRACT NO. 89713
ə.	PLOT DATE = 1/22/2019	DATE - \$DATE	REVISED -		SCALE: NONE	SHEET	OF SHEETS STA.	TO STA.		ILLINOIS FED	. AID PROJECT 05E2(122)

STATION	OFFSET	CONFLICT ITEM	DISPOSITION
	LT / RT		
167+95.00	18.50 RT	12" STORM SEWER	CAUTION OR RELOCATE
168+18.93	31.36 LT	12" STORM SEWER	CAUTION OR RELOCATE
168+61.80	40.49 LT	30" LIGHT FOUNDATION	CAUTION OR RELOCATE
168+72.46	40.56 LT	30" LIGHT FOUNDATION	CAUTION OR RELOCATE
169+37.89	42.97 LT	30" LIGHT FOUNDATION	CAUTION OR RELOCATE
176+78.99	52.81 RT	8" WATER MAIN	CAUTION OR RELOCATE
176+79.11	44.08 RT	12" STORM SEWER	CAUTION OR RELOCATE
176+79.27	31.71 RT	STORMINLET	CAUTION OR RELOCATE
176+80.34	46.54 LT	8" WATER MAIN	CAUTION OR RELOCATE
176+80.45	54.02 LT	12" STORM SEWER	CAUTION OR RELOCATE

CABLE TV (REFER TO NOTES 1 AND 2)

2) REFER TO PLAN AND PROFILE SHEETS FOR APPROXIMATE LOCATION OF

		SUMMARY OF QUANTITIES			FUNDING CAT	EGORY\CC
SPECIALTY ITEM	PAY CODE	PAYITEM	UNIT	TOTAL QUANTITY	ITEP 50/50 0031	<u>ITEP 80</u> 0028
	20100110	TREE REMOVAL (6 TO 15 UNITS DIAMETER)	UNIT	47		47
	20100210	TREE REMOVAL (OVER 15 UNITS DIAMETER)	UNIT	130		130
	20100500	TREE REMOVAL, ACRES	ACRE	0.25		0.25
	20200100	EARTH EXCAVATION	CUYD	1905		1905
	20800150	TRENCH BACKFILL	CU YD	2574		1382
	21101505	TOPSOIL EXCAVATION AND PLACEMENT	CU YD	250	· · · · · · · · · · · · · · · · · · ·	250
	21101615	TOPSOIL FURNISH AND PLACE, 4"	SQ YD	4894		4894
	21301084	EXPLORATION TRENCH 84" DEPTH	FOOT	100	· · · · · · · · · · · · · · · · · · ·	· · · · · · · · · · · · · · · · · · ·
*	25000110	SEEDING, CLASS 1A	ACRE	1.25		1.25
*	25000400	NITROGEN FERTILIZER NUTRIENT	POUND	91		91
*	25000500	PHOSPHORUS FERTILIZER NUTRIENT	POUND	91		91
*	25000600	POTASSIUM FERTILIZER NUTRIENT	POUND	91		91
*	25100115	MULCH, METHOD 2	ACRE	1.25		1.25
*	25301800	SEEDLINGS	UNIT	6.0		6.0
	28000250	TEMPORARY EROSION CONTROL SEEDING	POUND	200		200

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Associates, Inc.

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	-	669 16-00045	-01-SW	TAZEWELL CONTRACT	155

	SUMMARY OF QUANTITIES						EGORY\C
SPECIALTY ITEM	PAY CODE	PAYITEM	UNIT	TOTAL QUANTITY	<u>ITEP 50/50</u> 0031	<u>ITEP 80</u> 0028	
	28000400	PERIMETER EROSION BARRIER		FOOT	3966		3966
	28000500	INLET AND PIPE PROTECTION		EACH	2		
	28000510	INLET FILTERS		EACH	42		
	28100825	STONE DUMPED RIPRAP, CLASS B3		TON	151		151
	28200200	FILTER FABRIC		SQ YD	190		190
	35101600	AGGREGATE BASE COURSE, TYPE B, 4"		SQ YD	4026		4026
· · · · · · · · · · · · · · · · · · ·	40600295	POLYMERIZED BITUMINOUS MATERIAL (TACK COAT)		POUND	14403		
	40600827	POLYMERIZED LEVELING BINDER (MACHINE METHOD	D), IL-4.75, N50	TON	1009		
	40600982	HOT-MIX ASPHALT SURFACE REMOVAL - BUTT JOINT	-	SQ YD	134		
	40600990	TEMPORARY RAMP		SQ YD	225		
	40603565	POLYMERIZED HOT-MIX ASPHALT SURFACE COURSE	E, MIX "E", N70	TON	1513		
	40701801	HOT-MIX ASPHALT PAVEMENT (FULL-DEPTH), 6"		SQ YD	155		155
	42300200	PORTLAND CEMENT CONCRETE DRIVEWAY PAVEME	PAVEMENT, 6 INCH SQ		361		245
	42300400	PORTLAND CEMENT CONCRETE DRIVEWAY PAVEME	AND CEMENT CONCRETE DRIVEWAY PAVEMENT, 8 INCH		1243		845
	42400100	PORTLAND CEMENT CONCRETE SIDEWALK 4 INCH		SQ FT	20748		1410
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		SUMMARY OF QUANTITIES					
SPECIALTY ITEM	PAY CODE	PAYITEM	UNIT	TOTAL QUANTITY	<u>ITEP 50/50</u> 0031	<u>ITEP 80</u> 0028	
	42400800	DETECTABLE WARNINGS	SQ FT	152		152	
	44000100	PAVEMENT REMOVAL	SQ YD	154		154	
	44000159	HOT-MIX ASPHALT SURFACE REMOVAL, 2 1/2"	SQ YD	17869			
	44000200	DRIVEWAY PAVEMENT REMOVAL	SQ YD	2202		2202	
	44000500	COMBINATION CURB AND GUTTER REMOVAL	FOOT	5930			
	44000600	SIDEWALK REMOVAL	SQ FT	379		379	
	44003100	MEDIAN REMOVAL	SQ FT	31		31	
-	44201427	CLASS C PATCHES, TYPE II, 16 INCH	SQ YD	110		-	
	44201431	CLASS C PATCHES, TYPE III, 16 INCH	SQ YD	139			
	44201433	CLASS C PATCHES, TYPE IV, 16 INCH	SQ YD	1121			
	44213200	SAW CUTS	FOOT	3375			
	44213204	TIE BARS 3/4"	EACH	1204			
*	50901760	PIPE HANDRAIL	FOOT	410		410	
	52200800	SEGMENTAL CONCRETE BLOCK WALL	SQ FT	1766		1766	
	54213669	PRECAST REINFORCED CONCRETE FLARED END SECTIONS 24"	EACH	2			



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		SUMMARY OF QUANTITIES			FUNDING CAT		RUCTION TYPE CODE	
SPECIALTY ITEM	PAY CODE	PAYITEM	UNIT	TOTAL QUANTITY	<u>ITEP 50/50</u> 0031	ITEP 80/20 0028	NON-PARTICIPATING 0043	STATE ONLY 100% STATE 0005
······································	550A0050	STORM SEWERS, CLASS A, TYPE 1 12"	FOOT	1671				1671
	550A0090	STORM SEWERS, CLASS A, TYPE 1 18"	FOOT	393				393
	550A0120	STORM SEWERS, CLASS A, TYPE 1 24"	FOOT	166				166
	550A0340	STORM SEWERS, CLASS A, TYPE 2 12"	FOOT	75				75
	550A0410	STORM SEWERS, CLASS A, TYPE 2 24"	FOOT	88				88
	550A0430	STORM SEWERS, CLASS A, TYPE 2 30"	FOOT	6			· · · ·	6
	550A0450	STORM SEWERS, CLASS A, TYPE 2 36"	FOOT	102				102
	55100500	STORM SEWER REMOVAL 12"	FOOT	310				310
	55100700	STORM SEWER REMOVAL 15"	FOOT	372				372
	55101200	STORM SEWER REMOVAL 24"	FOOT	153				153
	55101900	STORM SEWER REMOVAL 48"	FOOT	38				38
*	56100015	DUCTILE IRON WATER MAIN TEE, 8" X 6"	EACH	1			1	
*	56100020	DUCTILE IRON WATER MAIN TEE, 8" X 8"	EACH	2			2	
*	56100600	WATER MAIN 6"	FOOT	154			154	
*	56100700	WATER MAIN 8"	FOOT	3573			3573	

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* 561 * 561 * 562	6105000 6108800	PAY ITEM WATER VALVES 8" TAPPING VALVES AND SLEEVES 6"	UNIT EACH	TOTAL QUANTITY 15	<u>ITEP 50/50</u> 0031	ITEP 80/20 0028	NON-PARTICIPATING 0043	STATE ONLY 100% STATE
* 561 * 561 * 561	5108800		EACH	15				0005
* 561		TAPPING VALVES AND SLEEVES 6"					15	
* 562	6108900		EACH	1			1	
		TAPPING VALVES AND SLEEVES 8"	EACH	3			3	
* 562	6200300	WATER SERVICE LINE 1"	FOOT	170		·····	170	
	6200700	WATER SERVICE LINE 2"	FOOT	40			40	
* 562	6201400	CORPORATION STOPS 1"	EACH	12			12	
* 562	5201800	CORPORATION STOPS 2"	EACH	4			4	
* 564	3400400	FIRE HYDRANTS TO BE RELOCATED	EACH	1			1	
* 564	6400820	FIRE HYDRANT WITH AUXILIARY VALVE AND VALVE BOX	EACH	13			13	
593	9300100	CONTROLLED LOW-STRENGTH MATERIAL	CU YD	97		97		
602	0218400	MANHOLES, TYPE A, 4'-DIAMETER, TYPE 1 FRAME, CLOSED LID	EACH	14				14
602	0219570	MANHOLES, TYPE A, 4'-DIAMETER, TYPE 3V FRAME AND GRATE	EACH	1				1
602	0221100	MANHOLES, TYPE A, 5'-DIAMETER, TYPE 1 FRAME, CLOSED LID	EACH	8				8
603	0300305	FRAMES AND LIDS TO BE ADJUSTED	EACH	23				23
605	0500060	REMOVING INLETS	EACH	16				16

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		SUMMARY OF QUANTITIES			FUNDING CAT	EGORY\C
SPECIALTY ITEM	PAY CODE	PAYITEM	UNIT	TOTAL QUANTITY	<u>ITEP 50/50</u> 0031	<u>ITEP 8</u> 002
	60601805	CONCRETE CURB TRANSITION	FOOT	63		63
	60603800	COMBINATION CONCRETE CURB AND GUTTER, TYPE B-6.12	FOOT	16		
	60605000	COMBINATION CONCRETE CURB AND GUTTER, TYPE B-6.24	FOOT	5224		
	60626500	TRANSITIONAL COMBINATION CONCRETE CURB AND GUTTER	FOOT	357		236
*	66900200	NON-SPECIAL WASTE DISPOSAL	CU YD	310		310
*	66900530	SOIL DISPOSAL ANALYSIS	EACH	2		2
*	66901003	REGULATED SUBSTANCES FINAL CONSTRUCTION REPORT	LSUM	1		1
	67000500	ENGINEER'S FIELD OFFICE, TYPE B	CAL MO	12	<u> </u>	7.2
	67100100	MOBILIZATION	LSUM	1		0.6
	70103815	TRAFFIC CONTROL SURVEILLANCE	CAL DA	200		120
	70107025	CHANGEABLE MESSAGE SIGN	CAL DA	180		108
	70300100	SHORT TERM PAVEMENT MARKING	FOOT	5100		
	70300150	SHORT TERM PAVEMENT MARKING REMOVAL	SQ FT	1700		
*	78009000	MODIFIED URETHANE PAVEMENT MARKING - LETTERS AND SYMBOLS	SQ FT	413		
*	78009004	MODIFIED URETHANE PAVEMENT MARKING - LINE 4"	FOOT	5538		
	O FINAL	QUANTITIES SHALL BE SPLIT 40% STATE ONLY / 60% ITEP 80/20		<u> </u>		
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		SUMMARY OF QUANTITIES					
SPECIALTY ITEM	PAY CODE	PAYITEM	UNIT	TOTAL QUANTITY	<u>ITEP 50/50</u> 0031	<u>ITEP 80</u> 0028	
*	78009006	MODIFIED URETHANE PAVEMENT MARKING - LINE 6"	FOOT	1108			
*	78009024	MODIFIED URETHANE PAVEMENT MARKING - LINE 24"	FOOT	100			
*	78100100	RAISED REFLECTIVE PAVEMENT MARKER	EACH	183			
*	78300200	RAISED REFLECTIVE PAVEMENT MARKER REMOVAL	EACH	178			
*	80400100	ELECTRIC SERVICE INSTALLATION	EACH	2	2		
*	81028350	UNDERGROUND CONDUIT, PVC, 2" DIA.	FOOT	5944	5944		
*	81028390	UNDERGROUND CONDUIT, PVC, 4" DIA.	FOOT	216	216		
*	81400700	HANDHOLE, PORTLAND CEMENT CONCRETE	EACH	6	6		
*	81702110	ELECTRIC CABLE IN CONDUIT, 600V (XLP-TYPE USE) 1/C NO. 10	FOOT	8670	8670		
*	81702120	ELECTRIC CABLE IN CONDUIT, 600V (XLP-TYPE USE) 1/C NO. 8	FOOT	4203	4203		
*	81702130	ELECTRIC CABLE IN CONDUIT, 600V (XLP-TYPE USE) 1/C NO. 6	FOOT	6372	6372		
*	81702140	ELECTRIC CABLE IN CONDUIT, 600V (XLP-TYPE USE) 1/C NO. 4	FOOT	12429	12429		
*	81702145	ELECTRIC CABLE IN CONDUIT, 600V (XLP-TYPE USE) 1/C NO. 3	FOOT	2085	2085		
*	81702150	ELECTRIC CABLE IN CONDUIT, 600V (XLP-TYPE USE) 1/C NO. 2	FOOT	3207	3207		
*	81702155	ELECTRIC CABLE IN CONDUIT, 600V (XLP-TYPE USE) 1/C NO. 1	FOOT	120	120		



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		SUMMARY OF QUANTITIES			FUNDING CAT			
PECIALTY ITEM	PAY CODE	PAYITEM	UNIT	TOTAL QUANTITY	<u>ITEP 50/50</u> 0031	<u>ITEP 80/20</u> 0028	NON-PARTICIPATING 0043	STATE ONLY 100% STATE 0005
*	82500350	LIGHTING CONTROLLER, BASE MOUNTED, 240VOLT, 100AMP	EACH	2	2			
*	83009600	LIGHT POLE, ALUMINUM, 45 FT. M.H., 15 FT. MAST ARM	EACH	27	27			
*	83600200	LIGHT POLE FOUNDATION, 24" DIAMETER	FOOT	285	285			
*	83600300	LIGHT POLE FOUNDATION, 30" DIAMETER	FOOT	176	176			
*	84200500	REMOVAL OF LIGHTING UNIT, SALVAGE	EACH	1	1			
	X0322916	PROPOSED STORM SEWER CONNECTION TO EXISTING STORM SEWER	EACH	4				4
*	X0325379	DIRECTIONAL BORING	FOOT	490			490	
*	X0326654	ORNAMENTAL LIGHT UNIT, COMPLETE	EACH	57	57		· · · · · · · · · · · · · · · · · · ·	
*	X0326659	CURED-IN-PLACE PIPE LINER, 18"	FOOT	528				528
*	X0326662	CURED-IN-PLACE PIPE LINER, 24"	FOOT	246				246
	X0326694	PLUG EXISTING STORM SEWERS	CU YD	5				5
*	X0327024	FIRE HYDRANTS TO BE REMOVED & SALVAGED	EACH	3			3	
	X0327301	RELOCATE EXISTING MAILBOX	EACH	7		7		
*	X0327555	TEMPORARY WATER SERVICE CONNECTION, (2" DIA. OR LESS)	EACH	15			15	
*	X0327747	WATER MAIN ENCASEMENT	FOOT	563			563	



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		669	16-00045-01-SW	TAZEWELL	155	13
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		SUMMARY OF QUANTITIES			FUNDING CATEGORY \ (
SPECIALTY ITEM	PAY CODE	PAYITEM	UNIT	TOTAL QUANTITY	<u>ITEP 50/50</u> 0031	<u>ITEP 8</u> 002	
*	X0327785	CURED-IN-PLACE PIPE LINER, 12"	FOOT	34			
	X1200050	BOX CULVERT REMOVAL	FOOT	183			
	X1200073	MANHOLE REMOVAL	EACH	11			
	X1200209	TRENCH DRAIN REMOVAL	FOOT	74		74	
	X4240420	PORTLAND CEMENT CONCRETE SIDEWALK 4 INCH, SPECIAL	SQ FT	14670		997	
	X4240440	PORTLAND CEMENT CONCRETE SIDEWALK 6 INCH, SPECIAL	SQ FT	820		820	
	X4400196	HOT-MIX ASPHALT SURFACE REMOVAL, SPECIAL	SQ YD	300			
	X5012650	CONCRETE HEADWALL REMOVAL SPECIAL	EACH	2	· · · ·		
*	X5610640	PLUG EX WATER MAIN	EACH	6			
*	X5610647	PLUG WATER MAIN 8"	EACH	1			
*	X5610748	WATER MAIN LINE STOP 8"	EACH	1			
	X6020082	INLETS, TYPE G-1	EACH	34			
	X6021814	INLET-MANHOLE, TYPE G-1, 4' DIAMETER	EACH	8			
	X6021815	INLET-MANHOLE, TYPE G-1, 5' DIAMETER	EACH	2			
	X6060505	CONCRETE CURB (SPECIAL)	FOOT	20		20	

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		SUMMARY OF QUANTITIES			FUNDING CAT	EGORY \ C
SPECIALTY ITEM	PAY CODE	PAYITEM	UNIT	TOTAL QUANTITY	ITEP 50/50 0031	<u>ITEP 8</u> 002
	X6060714	CONCRETE MEDIAN (SPECIAL)	SQ FT	157		15
	X7010216	TRAFFIC CONTROL AND PROTECTION, (SPECIAL)	LSUM	1		0.6
*	X7830060	GROOVING FOR RECESSED PAVEMENT MARKING, LETTERS AND SYMBOLS	S SQ FT	479		
*	X7830070	GROOVING FOR RECESSED PAVEMENT MARKING 5"	FOOT	5538		
*	X7830074	GROOVING FOR RECESSED PAVEMENT MARKING 7"	FOOT	1108	······································	
*	X7830090	GROOVING FOR RECESSED PAVEMENT MARKING 25"	FOOT	100		
*	X8211125	LUMINAIRE, LED, HORIZONTAL MOUNT, SPECIAL	EACH	27	27	
	XX000541	EXPLORATORY EXCAVATION	CU YD	62	······································	
*	XX006570	TREES (SPECIAL)	EACH	8		8
	XZ127900	RETAINING WALL REMOVAL	FOOT	232		232
	Z0004522	HOT-MIX ASPHALT DRIVEWAY PAVEMENT, 6"	SQ YD	749		749
*	Z0007601	BUILDING REMOVAL NO. 1	LSUM	1		1
*	Z0007602	BUILDING REMOVAL NO. 2	LSUM	1	An a sha	1
	Z0013798	CONSTRUCTION LAYOUT	LSUM	1		0.6
*	Z0015000	CURB STOPS 1"	EACH	12		
MM	O FINAL	QUANTITIES SHALL BE SPLIT 40% STATE ONLY / 60% ITEP 80/20 OTCAD DESIGNED - KMC REVISED - STATE OF IL OTCAD DRAWN - KRS DLC REVISED - STATE OF IL		 		IL. RTE. 29

<u>30/20</u> 28	NON-PARTICIPATING 0043	<u>STATE ONLY</u> 100% STATE 0005
7		
}		0.4
		479
		5538
		1108
		100
		62
	· · · · · · · · · · · · · · · · · · ·	····
)		0.4
	12	

		RTE.	SECTION	COUNTY	SHEETS	NO.
ES		669	16-00045-01-5W	TAZEWELL	155	15
				CONTRAC	Γ NO. :	89713
	TO STA.		ILLINOIS FED.	ALD PROJECT OS	2(122)	


		SUMMARY OF QUANTITIES			FUNDING CATI	EGORY \ C
SPECIALTY ITEM	PAY CODE	PAYITEM	UNIT	TOTAL QUANTITY	ITEP 50/50 0031	<u>ITEP 80</u> 0028
*	Z0015300	CURB STOPS 2"	EACH	3		annan ann ann ann an bhline ar an ann an deirigeacha
	Z0023600	FILLING EXISTING CULVERTS	EACH	2		
	Z0033700	LONGITUDINAL JOINT SEALANT	FOOT	13500		
	Z0034105	MATERIAL TRANSFER DEVICE	TON	1513		
	Z0041500	PLUG EXISTING CULVERTS	EACH	1		
*	Z0049901	REMOVAL AND DISPOSAL OF NON-FRIABLE ASBESTOS, BUILDING NO. 1	LSUM	1		1
	Z0056648	STORM SEWERS, TYPE 1, WATER MAIN QUALITY PIPE, 12"	FOOT	197		
	Z0056652	STORM SEWERS, TYPE 1, WATER MAIN QUALITY PIPE, 18"	FOOT	30		
	Z0056668	STORM SEWERS, TYPE 2, WATER MAIN QUALITY PIPE, 12"	FOOT	327		
	Z0056678	STORM SEWERS, TYPE 2, WATER MAIN QUALITY PIPE, 36"	FOOT	35		

MW	
Midwest Engineering	
Aussistant Area	

USER NAME = IDOTCAD	DESIGNED - KMC	REVISED -							IL, RTE, 29		
	DRAWN - KRS DLC	REVISED -	STATE OF ILLINOIS								
PLOT SCALE = 2.000 FT / In.	CHECKED - RDC	REVISED -	DEPARTMENT OF TRANSPORTATION				SUMIMAR	Y OF UU	ANTITIES		
 PLOT DATE = 1/22/2019	DATE - \$DATE	REVISED -		SCALE:	NONE	SHEET 11	OF 11	SHEETS	5 STA.		

<u>)/20</u> }	NON-PAR	<u>TICIP</u> 043	ATING		ATE ON 00% ST 0005	
	****	3		iii Wiii tomaaa ee	Andre Service and a service	
					2	
					13500	
					1513	
					1	
					197	
					30	
					327	
					35	

			L			
		F.A.P. RTE.				TOTAL SHEETS

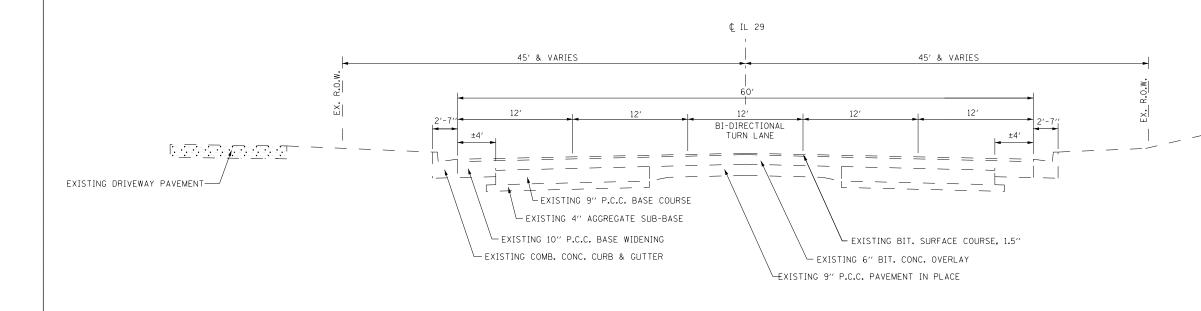


EXISTING TYPICAL SECTION - POPLAR ST. TO MARGARET DRIVE

STA. 153+35 TO STA. 180+64

	MW	USER NAME = IDOT	DESIGNED - DRAWN -	KMC KRS DLC	REVISED - REVISED -	STATE OF ILLINOIS				RTE. 29	
N	idwest Engineering	PLOT SCALE = 20.0000 '/ in.	CHECKED -	RDC	REVISED -	DEPARTMENT OF TRANSPORTATION		EX	STING T	YPICAL	. SE
_	Associates, Inc.	PLOT DATE = 1/22/2019	DATE -	\$DATE	REVISED -		SCALE:	SHEET 1	OF 1	SHEETS	ST

29	 F.A.P. RTE.	SECTION	 COUNTY	TOTAL	SHEET NO.
29 AL SECTION	 F.A.P. RTE. 669	SECTION 16-00045-01-SW	COUNTY TAZEWELL CONTRAC	SHEETS 155	NO. 17

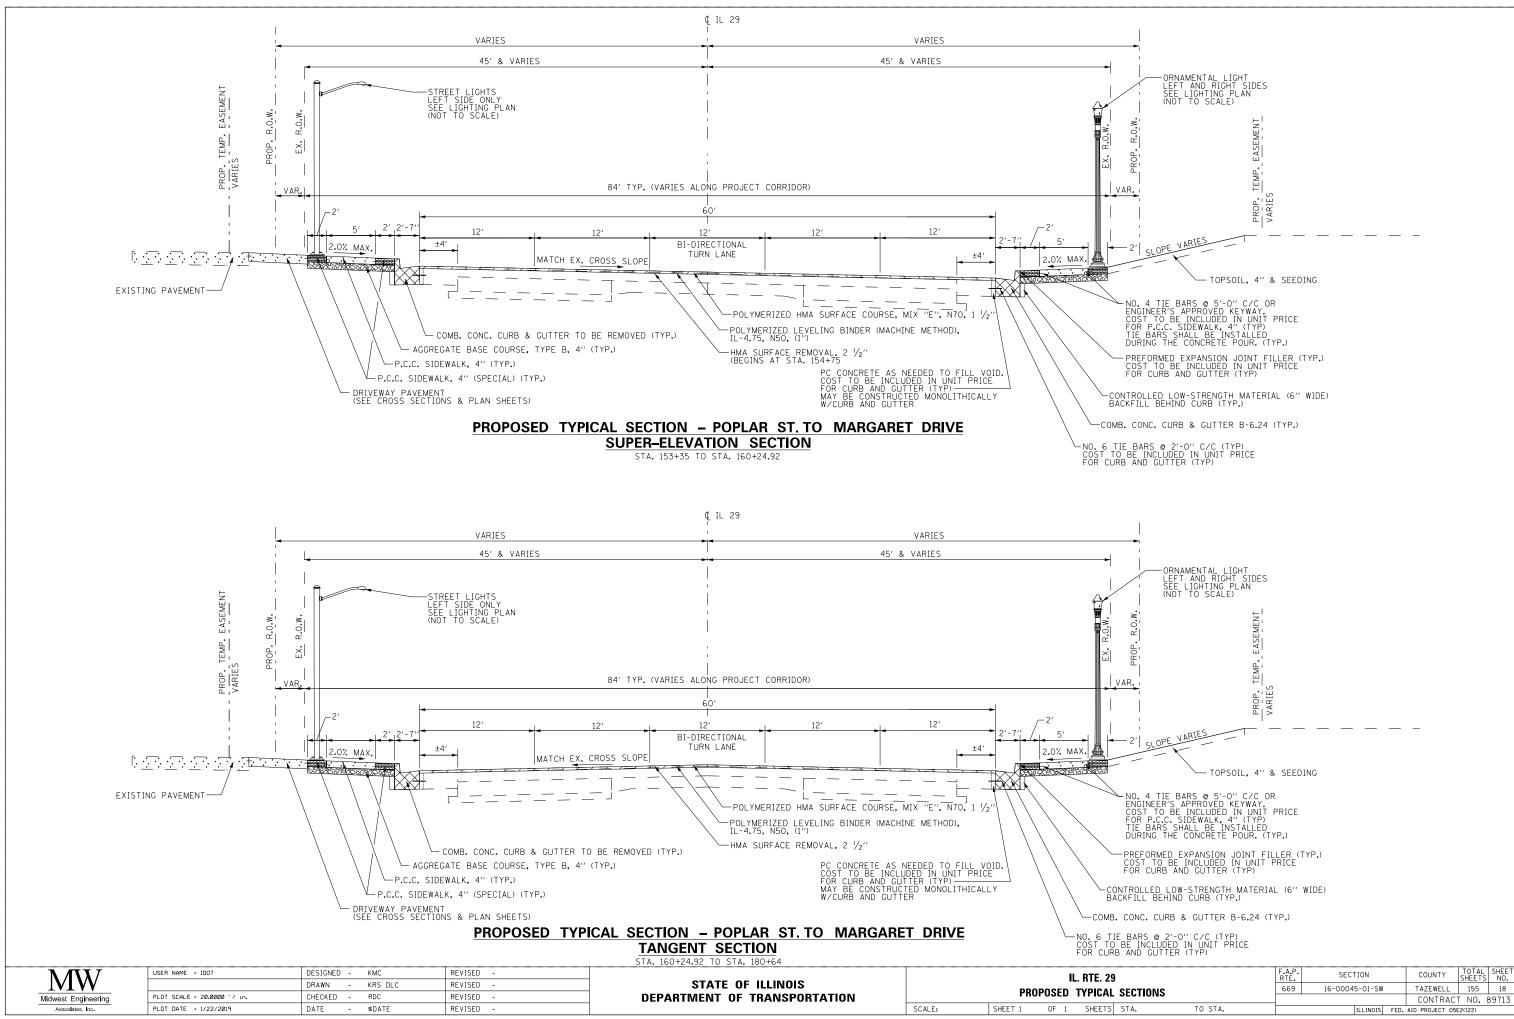

23			INIC.					SHEETS	NU.
лі	SECTIONS	INIS		16-0004	5-01-SW		TAZEWELL	155	18
							CONTRAC	T NO.	39713
TS	STA.	TO STA.			ILLINOIS	FED.	AID PROJECT 058	2(122)	

WAST	E REN	IOVAL	NON-SPECIAL WASTE DISPOSAL	SPECIAL WASTE PLANS AND REPORTS	SOIL DISPOSAL ANALSIS	REGULATED SUBSTANCES FINAL CONSTRUCTION REPORT
VARIOU	S LO	CATIONS	CUYD	L SUM	EACH	L SUM
STA. 154+75.00	TO	STA. 180+64.00	310	1	2	1
		TOTAL	310	1	2	1

SHORT TERM	PAVEN	IENT MARKING	SHORT TERM PAVEMENT MARKING	SHORT TERM PAVEMENT MARKING REMOVAL
L	OCATI	ON	FOOT	FOOT
STA. 153+35	TO	STA. 180+64	5100	1700
		TOTAL	5,100	1,700

CURB AND C	CURB AND GUTTER REMOVAL									
LC	CATI	ON	FOOT							
STA 153+35.00	ТО	STA. 158+50.00	929							
STA. 158+50.00	TO	STA. 163+50.00	1006							
STA. 163+50.00	TO	STA. 168+50.00	1020							
STA. 168+50.00	TO	STA. 173+50.00	1225							
STA. 173+50.00	TO	STA. 178+50.00	1275							
STA. 178+50.00	ТО	STA. 180+64.00	475							
		TOTAL	5,930							

MEDIA	MEDIAN REMOVAL		
LC	SQ FT		
STA. 168+50.00	TO	STA. 173+50.00	31
		TOTAL	31

	EXPLORA		I TRENCH	EXPLORATION TRENCH 84" DEPTH	EXPLORATORY EXCAVATION
	LO	CAT	ON	FOOT	CY YD
	STA. 155+43		40' RT.		2
	STA. 164+08		40' LT.		10
	STA. 177+18		60' RT.		50
	STA. 178+00	TO	STA. 179+00	100	
1					
			TOTAL	100	62

	tree f	REMOVAL		TREE REMOVAL (6 TO 15 UNITS DIAMETER)	TREE REMOVAL (OVER 15 UNITS DIAMETER)	tree Removal, Acres
STATION		OFFSET FT.	LT /RT	UNIT	UNIT	ACRES
STA. 156+65.00		49.0	LT		36	
STA. 157+28.24		57.3	LT		24	
STA. 157+52.09		57.3	LT		22	
STA. 159+75.40		37.7	LT		26	
STA. 159+96.70		38.9	LT		22	
STA. 160+96.20		45.9	RT	10		
STA. 161+14.10		47.5	RT	7		
STA. 161+23.60		45.0	RT	8		
STA. 161+34.00		45.1	RT	12		
STA. 161+49.00		42.7	RT	10		
STA. 162+50.00	ТО	STA. 165+45.00	LT			0.06
STA. 166+35.00	ТО	STA. 168+10.00	LT			0.04
STA. 166+95.00	ТО	STA. 167+75.00	RT			0.06
			TOTAL	47	130	0.25

	D HOT	-MIX ASPHALT AL	HOT-MIX ASPHALT SURFACE REMOVAL - BUTT JOINT	TEMPORARY RAMP	PAVEMENT REMOVAL
LC	CATI	ON	SQ YD	SQ YD	SQ YD
STA 153+35.00	TO	STA. 158+50.00	67		
STA. 158+50.00	TO	STA. 163+50.00		50	
STA. 163+50.00	TO	STA. 168+50.00		63	
STA. 168+50.00	TO	STA. 173+50.00		45	154.3
STA. 173+50.00	TO	STA. 178+50.00			
STA. 178+50.00	TO	STA. 180+64.00	67	67	
		TOTAL	134	225	155

DRIVEWAY AN	ID SI D	DRIVEWAY PAVEMENT REMOVAL	SIDEWALK REMOVAL	
LOCATION		SQ YD	SQ FT	
STA 153+35.00	TO	STA. 158+50.00	266	
STA. 158+50.00	TO	STA. 163+50.00	138	
STA. 163+50.00	TO	STA. 168+50.00	120	133
STA. 168+50.00	TO	STA. 173+50.00	801	124
STA. 173+50.00	TO	STA. 178+50.00	452	
STA. 178+50.00	TO	STA. 180+64.00	425	122
		TOTAL	2,202	379

STORM SEWER REMOVAL			STORM SEWER REMOVAL 12"	STORM SEWER REMOVAL 15"	STORM SEWER REMOVAL 24"	STORM SEWER REMOVAL 48"	REMOVING INLETS	BOX CULVERT REMOVAL	Manhole Removal	CONCRETE HEADWALL REMOVAL SPECIAL	FILLING EXISTING CULVERTS	PLUG EXISTING CULVERTS	trench Drain Removal
LOCATION			FOOT	FOOT	FOOT	FOOT	EACH	FOOT	EACH	EACH	EACH	EACH	FOOT
STA 153+35.00	TO	STA. 158+50.00	5				2		2				
STA. 158+50.00	TO	STA. 163+50.00	71		47		3	91	3	1			
STA. 163+50.00	TO	STA. 168+50.00	103				6	92	3	1	2	1	
STA. 168+50.00	TO	STA. 173+50.00	46	262			1		1				74
STA. 173+50.00	TO	STA. 178+50.00	37	110			2						
STA. 178+50.00	TO	STA. 180+64.00	48		106	38	2		2				
		TOTAL	310	372	153	38	16	183	11	2	2	1	74

MISCELLAN	IEOUS	REMOVALS	RAISED REFLECTIVE PAVEMENT MARKER REMOVAL	REMOVAL OF LIGHTING UNIT, SALVAGE	Building Removal No. 1	Building Removal No. 2	RELOCATE EXISTING MAILBOX	FIRE HYDRANTS TO BE REM OVED & SAL VAGED	PLUG EX WATER MAIN	PLUG WATERMAIN 8"	RETAINING WALL REMOVAL
LOCATION			EACH	EACH	LSUM	LSUM	EACH	EACH	EACH	EACH	FOOT
STA 153+35.00	TO	STA. 158+50.00	29				2	1	1		
STA. 158+50.00	TO	STA. 163+50.00	34	1			1				
STA. 163+50.00	TO	STA. 168+50.00	34		1	1	1		1		232
STA. 168+50.00	TO	STA. 173+50.00	34				1	1	1		
STA. 173+50.00	TO	STA. 178+50.00	34				2	1			
STA. 178+50.00	TO	STA. 180+64.00	13						3	1	
		TOTAL	178	1	1	1	7	3	6	1	232

SIGN F	SIGN REMOVAL									
STATION	STATION OFFSET FT. LT /RT									
179+92	40	LT	1							
		TOTAL	1							

MW
Midwest Engineering
Associates, Inc.

USER NAME = IDOT	DESIGNED - KMC	REVISED -		IL. RTE. 29	F.A.P. RTF.	SECTION	COUNTY	TOTAL SHEET SHEETS NO.
	DRAWN - KRS DLC	REVISED -	STATE OF ILLINOIS	SCHEDULE OF QUANTITIES	669	16-00045-01-SW	TAZEWELL	155 19
PLOT SCALE = 2.000 FT / in.	CHECKED - RDC	REVISED -	DEPARTMENT OF TRANSPORTATION	SCHEDOLE OF UDANTITIES			CONTRACT	T NO. 89713
PLOT DATE = 1/22/2019	DATE - \$DATE	REVISED -		SCALE: NONE SHEET 1 OF 3 SHEETS STA. TO STA.		ILLINOIS FED.	. AID PROJECT 05E2(122)	

FRAM E	SAND LIDS		FRAMES AND LIDS TO BE ADJUSTED
STATION	OFFSET FT.	LT/RT	EACH
154+54.3	39.0	RT	1
154+66.8	35.7	RT	1
154+71.5	47.3	LT	1
156+80.2	38.2	LT	1
158+83.0	34.0	LT	1
160+41.0	32.4	LT	1
161+95.3	13.4	LT	1
163+09.1	32.7	LT	1
163+59.7	36.8	RT	1
164+43.1	31.8	RT	1
165+99.2	31.4	RT	1
168+89.8	31.8	RT	1
169+33.7	43.1	LT	1
171+16.2	31.8	LT	1
172+28.8	32.0	RT	1
173+95.8	37.7	RT	1
175+08.3	31.8	LT	1
175+78.2	32.4	RT	1
177+68.4	39.7	RT	1
178+96.5	37.1	RT	1
179+06.6	31.5	LT	1
179+44.4	44.4	RT	1
180+07.0	35.6	LT	1
		TOTAL	23

EARTHWORK SUMMARY	TOPSOIL FURNISH AND PLACE, 4"	EARTH EXCAVATION	EARTH EXCAVATION ADJUSTED FOR SHRINKAGE	EM BANKM ENT	EARTH BALANCE WASTE (+) SHORTAGE (-)	TOPSOIL EXCAVATION AND PLACEMENT
LOCATION	SQ YD	CUYD	CU YD	CU YD	CU YD	CU YD
STA 153+35.00 TO STA. 158+50.00	784.8	393.4	314.7	0.0	314.7	
STA. 158+50.00 TO STA. 163+50.00	918.8	253.8	203.0	30.9	172.1	
STA. 163+50.00 TO STA. 168+50.00	1,105.2	516.5	413.2	35.5	377.7	
STA. 168+50.00 TO STA. 173+50.00	761.4	307.9	246.3	4.9	241.4	
STA. 173+50.00 TO STA. 178+50.00	1003.5	355.0	284.0	3.2	280.8	
STA. 178+50.00 TO STA. 180+64.00	319.5	78	62.40	0.6	61.8	
ENTIRE PROJECT						250
TOTAL	4,894	1,905	1,524	76	1,449	250

DRIVEW	AY S	CHEDULE	PORTLAND CEMENT CONCRETE DRIVEWAY PAVEMENT, 6 INCH	PORTLAND CEMENT CONCRETE DRIVEWAY PAVEMENT, 8 INCH
LOCATION (STA	A. AT	BACK OF CURB)	SQ YD	SQ YD
LEFT SIDE				
STA. 153+42.40	то	STA. 153+81.8		41.6
STA. 153+86.90	то	STA. 154+30.40		52.9
STA. 154+42.70	TO	STA. 154+97.30		44.4
STA. 155+57.30	то	STA. 156+00.00		33.1
STA. 156+43.60	TO	STA. 156+77.20	24.0	
STA. 156+97.10	то	STA. 157+70.20	63.0	
31A. 150+97.10	10	31A. 157+70.20	03.0	
STA. 158+57.20	то	STA. 158+87.50	20.8	
STA. 159+02.50	то	STA. 159+76.30	57.9	
STA, 161+38,30	то	STA. 161+80.30		101.4
STA. 165+42.90	TO	STA. 165+76.00	31.8	
STA. 165+78.10	то	STA. 166+50.10	57.5	
STA. 105+70.10	10	31A. 100+30.10	51.5	
STA. 168+12.80	TO	STA. 168+54.80		33.0
STA. 168+79.50	то	074 400-00 40		43.8
STA. 168+79.50	10	STA. 169+32.40		43.8
STA. 169+34.70	то	STA. 169+87.70		84.4
	-			100.0
STA. 169+97.90	то	STA. 170+73.40		120.6
STA. 171+08.40	то	STA. 172+04.60		103.1
STA. 174+12.00	то	STA. 174+97.90	76.9	
STA. 175+21.50	то	STA. 175+74.60		80.5
STA. 176+52.50	TO	STA. 177+05.50		96.8
STA. 179+42.10	то	STA. 179+95.10		42.9
31A. 178+42.10	10	31A. 178+85.10		42.5
RIGHT SIDE				
STA. 164+21.70	то	STA. 164+33.30	29.0	
51A. 164+21.70	10	51A. 164+33.30	29.0	
STA. 170+08.20	то	STA. 170+61.20		44.0
074 475 55 5	-	074 473 17 17		
STA. 170+82.90	то	STA. 171+17.10		57.0
STA. 172+26.70	то	STA. 172+93.40		57.8
STA. 174+61.40	то	STA. 175+14.40		101.6
STA. 176+13.90	то	STA. 176+67.00		104.1
		TOTAL	361	1,243

EROSI	ON COI	TEMPORARY DITCH CHECKS	PERIMETER EROSION BARRIER	
L	DCATIO	FOOT	FOOT	
STA 153+35.00	TO	STA. 158+50.00		499
STA. 158+50.00	TO	STA. 163+50.00	5	976
STA. 163+50.00	TO	STA. 168+50.00		950
STA. 168+50.00	TO	STA. 173+50.00		355
STA. 173+50.00	TO	STA. 178+50.00		774
STA. 178+50.00	TO	STA. 180+64.00		412
		5	3,966	

MW Midwest Engineering Associates, Inc.

INLE	T FILTER SCHE	DULE	INLET AND PIPE PROTECTION	INLET FILTERS
STR. NO.	LOCATION	OFFSET	EACH	EACH
S2	154+28.31	32.00' LT.		1
S3	156+37.00	30.43' LT.		1
S4	156+87.90	30.32' LT.		1
S7	158+04.00	30.37' LT.		1
S8	159+77.71	30.06' RT.		1
S10	159+85.00	30.00' LT.		1
S11	161+01.00	59.00' RT.	1	
S13	161+65.40	30.00' RT.		1
S15	162+19.83	30.34' LT.		1
S16	164+04.40	30.20' LT.		1
S18	163+85.86	45.13' RT.		1
S19	164+35.50	51.30' RT.		1
S20	165+30.00	30.20' RT.		1
S21	165+35.00	30.05' LT.		1
\$22	166+25.00	30.20' RT.		1
S23	167+03.20	30.10' RT.		1
S24	167+10.20	30.10' RT.		1
S25	167+01.00	84.00' RT.	1	
S29	167+95.00	30.15' RT.		1
S30	166+59.90	30.20' LT.		1
S32	167+15.23	30.10' LT.		1
S33	167+22.24	30.10' LT.		1
S35	167+95.00	30.07' LT.		1
S36	168+76.00	29.88' LT.		1
S37	168+46.70	30.20' RT.		1
S38	169+18.00	31.00' RT.		1
S39	170+00.00	30.30' RT.		1
S40	170+75.00	30.30' RT.		1
S41	171+30.00	30.60' RT.		1
S43	173+00.00	30.50' RT.		1
S44	173+00.00	29.80' LT.		1
S45	174+00.00	29.80' LT.		1
S46	174+00.00	30.50' RT.		1
S48	175+25.00	30.52' RT.		1
S49	176+22.50	44.10' RT.		1
S50	175+58.20	44.10' RT.		1
S51	176+82.00	30.50' RT.		1
S53	177+78.00	30.50' RT.		1
S55	178+95.50	30.80' RT.		1
S56	179+59.90	47.20' RT.		1
S57	180+18.10	40.60' RT.		1
S59	175+85.00	29.80' LT.		1
S62	177+16.00	29.90' LT.		1
S65	178+90.50	29.60' LT.		1
	-			

SID	ewal	.K RIG	HT SIDE			PORTLANE CEMENT CONCRETE SIDEWALK 4 INCH	CEN CON SIDE 4 II SPE	FLAND MENT CRETE WALK WALK NCH, ICIAL CURB	PORTLAN CEMENT CONCRET SIDEWALI 4 INCH, SPECIAL AT BK/WAI	E CONCRETE CEMENT CONCRETE SIDEWALK 6 INCH,			CTABLE		SIDEWA	ALK LE	æT
	LO	САТЮ	N		BK/CURB or BK/WALK	SQ FT	so	₽ FT	SQ FT	SQ FT	SQ YD	s	Q FT		L	осаті	ON
STA. 154+4	8.0						-					<u> </u>	16.1				
STA. 154+5		то	STA . 163+	30.9	BK/WALK		-		1844.0		204.9	<u> </u>	10.1	STA	. 153+42.4	TO	5
STA. 154+5	4.7	TO	STA. 163+	72.2	BK/CURB	4750.0	18	34.0			731.6	1			. 153+42.4	TO	5
STA . 163+7													14.9		. 153+72.7	то	5
STA. 164+5												1	17.3		. 153+81.8	то	1
STA. 164+6		TO TO	STA . 166+		BK/WALK	0.105.0			367.4	_	40.8				. 154+20.8	TO	
STA. 164+6 STA. 166+5		TO	STA . 168+		BK/CURB BK/WALK	2425.0	/1	96.6		200.0	358.0 22.2	+			. 154+30.4	TO	
STA. 167+5		то	STA . 107+		BK/WALK		-		231.4	200.0	25.7	-			. 154+88.1	TO TO	
STA. 168+5											2011	-	8.0		. 154+97.3	то	L.
STA. 169+1													8.0		. 155+90.9	то	
STA . 169+0		TO	STA . 170+		BK/WALK				215.5		23.9				. 156+68.1	то	
STA. 169+1		то	STA . 170+0		BK/CURB	507.0	18	33.0			76.7				. 156+77.2	то	
STA. 170+5		TO	STA . 170+		BK/WALK		_		75.4		8.4				. 157+61.3	ТО	
STA. 170+6		TO	STA 170+		BK/CURB	153.5	4	7.4	050.0	_	22.3	_			. 157+70.2	то	1
STA. 171+0 STA. 171+1		TO TO	STA . 172+3 STA . 172+3		BK/WALK BK/CURB	593.1		23.2	253.8	_	28.2 90.7	+			. 158+78.4	то	
STA. 171+1 STA. 172+8		TO	STA. 172+2 STA. 174+2		BK/WALK	595.1		23.2	368.1		40.9	-			. 158+87.5	ТО	1
STA. 172+9		то	STA. 174+		BK/CURB	885.3	34	10.1	500.1		136.2	-			. 159+67.2	ТО	
STA. 175+0		TO	STA . 176+2		BK/WALK	00010	-		231.0	_	25.7	+			. 159+76.3	то	
STA. 175+1		TO	STA. 176+		BK/CURB	542.6	20	03.0			82.8			STA	. 160+16.0		
STA. 176+5		то	STA . 179+		BK/WALK				576.9		64.1			STA	. 160+74.0		
STA. 176+6		ТО	STA . 179+4	43.4	BK/CURB	1432.5	54	19.3			220.2			STA	. 160+66.2	то	1
STA. 179+3					BK/CURB	238.0					26.4			STA	. 160+76.3	то	1
STA. 179+4							_					_	18.6		. 161+71.2	ТО	5
STA . 179+5 STA . 180+1					BK/CURB	475.0	-			_	52.8	1	10.0	STA	. 161+80.3	TO	5
STA. 180+1 STA. 180+3					DR/CURD	475.0				_	52.0		28.7		. 163+50.0	TO	
0111110010	1.0						-			_		-	.0.1		. 165+35.0	TO	\$
					SUBTOTAL	12,002	4.	177	4,164	200	2.282	- ·	122		. 165+67.0	то	
						20,748	,	14,6		820	4,026	- ·	152		. 165+76.0	TO	
										-					. 166+25.4	TO	
															. 166+50.1	TO	Ľ
	Г					-					1				. 166+60.0	TO	Ľ
						POLY	MERIZED		MERIZED	POLYMERIZE	Р нот-мі	x			. 167+85.0 . 168+45.8	TO TO	Ļ
							NOUS		NG BINDER	HOT-MIX	ASPHAL	т			. 168+54.8	то	L à
			PAVING	SCI	IEDULE	MA	TERIAL		CHINE	ASPHALT	PAVEME	ΝТ			. 169+23.6	то	÷
						(TAC	K COA T)		D), IL-4.75, N50	SURFACE COUR MIX "E", N70	SE, (FULL DEPT	H), 6"			. 169+32.4	TO	
									100	MIX E, N/U					. 169+78.7	TO	
			LO	САП	ON	P	DUND		FON	TON	SQ YD				. 169+87.7	TO	
															. 170+64.5	TO	
LET FILTERS			153+35.00	то	STA. 158+5		,005		40.3	210.5					. 170+73.4	то	1
EACH	L		158+50.00	TO	STA. 163+5		,785		94.9	292.4				STA	. 171+72.6	то	1
	⊢		163+50.00	TO	STA. 168+5		,890		02.3	303.5				STA	. 172+04.6	то	1
1	-		168+50.00 173+50.00	TO TO	STA. 173+50 STA. 178+50		,678		87.4 87.8	281.1 281.7	154.3			STA	. 174+88.9	ТО	1
1			173+50.00	TO	STA. 178+50 STA. 180+64		,683 ,362		87.8 95.3	281.7 143.0				STA	. 174+97.9	ТО	
1		SIA.	110+30.00		51A. 100+04	1.00	,502	+`	55.5	143.0				STA	. 175+65.5	ТО	5
1	H				TO	TAL 14	1.403	1	.009	1.513	155				. 175+74.6	TO	5
1					10		.,		,	1,010	1 100				. 176+96.7	TO	5
1															. 177+05.5	TO	5
1															. 179+86.1	TO	Ľ
1										IX ASPHALT				STA	. 179+95.1	то	Ľ
4	- HMA		a drivewa'	DRIVEWAY SCHEDULE DRIVEWAY PAVEMENT,									1	1			

	PAVIN	S SCI	HEDULE	POLYMERIZED BITUMINOUS MATERIAL (TACK COAT)	POLYM ERIZED LEVELING BINDER (MACHINE METHOD), IL-4.75, N50	POLYMERIZED HOT-MIX ASPHALT SURFACE COURSE, MIX "E", N70	H0T-MIX ASPHALT PAVEMENT (FULL DEPTH), 6"
	LO	САТ	ION	POUND	TON	TON	SQ YD
	STA 153+35.00	TO	STA. 158+50.00	2,005	140.3	210.5	
	STA. 158+50.00	TO	STA. 163+50.00	2,785	194.9	292.4	
	STA. 163+50.00	TO	STA. 168+50.00	2,890	202.3	303.5	
	STA. 168+50.00	TO	STA. 173+50.00	2,678	187.4	281.1	154.3
	STA. 173+50.00	TO	STA. 178+50.00	2,683	187.8	281.7	
	STA. 178+50.00	то	STA. 180+64.00	1,362	95.3	143.0	
-		I	TOTAL	14,403	1,009	1,513	155

HMA DRIVE	WAY	SCHEDULE	HOT-MIX ASPHALT DRIVEWAY PAVEMENT, 6"
LO	CAT	ON	SQ YD
LEFT SIDE			
STA. 154+41.40	то	STA. 155+32.10	79.2
STA. 155+66.40	то	STA. 155+90.90	40.0
STA. 157+30.60	то	STA. 157+45.30	36.9
STA. 158+66.90	то	STA. 158+78.30	17.0
STA. 159+36.90	то	STA. 159+67.30	32.2
STA. 165+57.20	то	STA. 165+69.80	15.8
STA. 166+11.10	то	STA. 166+24.00	19.5
STA. 168+21.80	то	STA. 169+33.10	88.5
STA. 171+10.30	то	STA. 171+59.70	27.5
STA. 174+21.00	то	STA. 174+33.70	59.9
STA. 174+77.20	то	STA. 174+88.80	74.6
STA. 179+12.10	то	STA. 180+46.00	183.7
RIGHT SIDE			
STA. 172+35.70	то	STA. 172+84.30	74.0
		TOTAL	749

STA. 159+36.90	TO	STA. 159+67.30	32.2
STA. 165+57.20	TO	STA. 165+69.80	15.8
STA. 166+11.10	TO	STA. 166+24.00	19.5
STA. 168+21.80	то	STA. 169+33.10	88.5
STA. 171+10.30	то	STA. 171+59.70	27.5
STA. 174+21.00	то	STA. 174+33.70	59.9
	-	074 174 00 00	
STA. 174+77.20	то	STA. 174+88.80	74.6
STA. 179+12.10	то	OTA 180 140 00	400.7
STA. 179+12.10	110	STA. 180+46.00	183.7
RIGHT SIDE			
NGIT SIDE			
STA. 172+35.70	то	STA, 172+84,30	74.0
		TOTAL	749
			•
STATE OF	- 11		
STALE OF	- 11	LTINO12	

			I	L. RTE. 29			F.A.P. RTE.	SECTION		COUNTY	TOTAL SHEETS	SHEET NO.
			SCHEDUL	F OF OUA	NTITIES		669	16-00045-01-SW		TAZEWELL	155	20
			CONLEGE							CONTRAC	T NO. 8	89713
SCALE:	NONE	SHEET 2	OF 3	SHEETS	STA.	TO STA.		ILLINOIS	FED. A	ID PROJECT 05	2(122)	

USER NAME = IDOT	DESIGNED - KMC	REVISED -				
	DRAWN - KRS DLC	REVISED -	STATE OF ILLINOIS			
PLOT SCALE = 2.000 FT / in.	CHECKED - RDC	REVISED -	DEPARTMENT OF TRANSPORTATION			
PLOT DATE = 1/22/2019	DATE - \$DATE	REVISED -		SCALE:	NONE	SHEET 2

TOTAL 2 42

DEWA	LKLE	₹T SIDE	BK/CURB	PORTLAND CEM ENT CONCRETE SIDEWALK 4 INCH	PORTLAND CEMENT CONCRETE SIDEWALK 4 INCH, SPECIAL (AT CURB)	PORTLAND CEMENT CONCRETE SIDEWALK 4 INCH, SPECIAL (AT BK/WALK)	PORTLAND CEMENT CONCRETE SIDEWALK 6 INCH, SPECIAL	AGGREGATE BASE COURSE, TYPE B, 4"	DETECTABLE WARNINGS
LC	CATI	ON	or BK/WALK	SQ FT	SQ FT	SQ FT	SQ FT	SQ YD	SQ FT
2.4	то	STA. 153+54.2	BK/WALK			21.1		2.3	
2.4	то	STA: 153+54.2 STA: 153+45.1	BK/CURB	36.4	7.5	21.1		4.9	
2.7	то	STA: 153+96.1	BK/WALK	00.4	1.0	41.8		4.6	
31.8	ТО	STA. 153+86.9	BK/CURB	71.4	14.2			9.5	
20.8	то	STA. 154+52.6	BK/WALK			57.8		6.4	
30.4	то	STA. 154+42.7	BK/CURB	110.1	28.7			15.4	
38.1	TO	STA. 155+66.4	BK/WALK			104.4		11.6	
97.3	то	STA. 155+57.3	BK/CURB	338.8	124.0			51.4	
90.9	TO	STA. 156+52.8	BK/WALK			115.9		12.9	
0.0	то	STA. 156+43.6	BK/CURB	263.7	91.4			39.5	
68.1	TO	STA. 157+06.2	BK/WALK			72.1		8.0	
7.2	то	STA. 156+97.1	BK/CURB	144.7	43.7			20.9	
61.3	то	STA. 158+66.5	BK/WALK			200.6		22.3	
70.2	TO	STA. 158+57.2	BK/CURB	471.0	174.9			71.8	
78.4	то	STA. 159+23.0	BK/WALK			82.0		9.1	
37.5	TO	STA. 159+02.5	BK/CURB	144.7	35.6			20.0	
67.2	TO	STA. 160+22.3	BK/WALK	000.4		106.1		11.8	
76.3	то	STA. 160+13.3	BK/CURB	200.1	68.6			29.9	44.0
16.0 74.0									14.3
6.2	то	STA. 161+47.2	BK/WALK			158.0		17.6	15.8
76.3	то	STA. 161+47.2 STA. 161+38.3	BK/CURB	343.6	119.2	156.0		51.4	
71.2	то	STA. 161+38.3 STA. 163+50.0	BK/WALK	343.0	119.2	355.3		39.5	
30.3	то	STA: 165+42.9	BK/CURB	1857.8	729.3	335.5		287.5	
50.0	то	STA: 165+35.0	BK/WALK	1037.0	120.0		370.0	41.1	
35.0	то	STA, 165+51.9	BK/WALK			32.0	0.000	3.6	
37.0	то	STA. 165+98.1	BK/WALK			55.1		6.1	
76.0	то	STA. 165+78.1	BK/CURB	83.5	11.0			10.5	
25.4	то	STA. 166+60.0	BK/WALK			64.0		7.1	
50.1	то	STA. 168+12.8	BK/CURB	897.5	333.7			136.8	
60.0	то	STA. 167+85.0	BK/WALK				250.0	27.8	
35.0	то	STA. 168+21.8	BK/WALK			71.3		7.9	
15.8	то	STA. 168+88.6	BK/WALK			81.3		9.0	
54.8	то	STA. 168+79.5	BK/CURB	168.6	53.5			24.7	
23.6	то	STA. 169+43.7	BK/WALK			36.3		4.0	
32.4	TO	STA. 169+34.7	BK/CURB	56.1	8.6			7.2	
78.7	то	STA. 170+06.9	BK/WALK			52.5		5.8	
37.7	то	STA. 169+97.9	BK/CURB	96.1	24.4			13.4	
64.5	TO	STA. 171+17.4	BK/WALK			101.8		11.3	
73.4	TO	STA. 171+08.4	BK/CURB	219.7	73.9	400.0		32.6	
72.6	TO	STA. 174+21.0	BK/WALK	4400 5	421.0	492.8		54.8	
04.6	TO	STA. 174+12.0	BK/CURB	1139.5	424.0	70.4		173.7	
38.9 97.9	TO TO	STA. 175+30.5	BK/WALK BK/CURB	162.8	51.1	79.1		8.8 23.8	
97.9 35.5	ТО	STA. 175+21.5 STA. 176+61.5	BK/CURB BK/WALK	102.8	51.1	188.1		23.8	
74.6	то	STA. 176+61.5 STA. 176+52.5	BK/WALK BK/CURB	434.9	159.9	100.1		20.9	
96.7	то	STA: 176+52.5 STA: 179+51.1	BK/WALK	454.9	109.9	504.8	1	56.1	
)5.5	то	STA. 179+51.1 STA. 179+42.1	BK/CURB	1227.5	472.0	304.0		188.8	
36.1	то	STA: 179+42.1 STA: 180+46.0	BK/WALK	1221.5	412.0	117.9	<u> </u>	13.1	
95.1	то	STA. 180+46.0	BK/CURB	277.1	88.4	117.0	<u> </u>	40.6	
/0.1		51A. 100140.0	DIVOURD	211.1	00.4			40.0	
			SUB-TOTAL	8.746	3,138	3,192	620	1744	30
			/0/AL		3,100	5,102	-220		

TEM PORARY EROSION CONTRO	DL SEEDING
LOCATION	POUND
ENTIRE PROJECT	200
TOTAL	200

	IPRA	STONE DUM PED RIPRAP, CLASS B3	FILTER FABRIC	
LO	CAT	ON	TON	SQ YD
STA 163+50 LT.	TO	STA. 165+35 LT.	102.5	128.8
STA. 166+65 RT.	TO	STA. 167+36 RT.	48.5	61.2
		151	190	

SEEDING AND LA	NDSC/	APING SCHEDULE	Area	SEEDING, CLASS 1A	NITROGEN FERTILIZER NUTRIENT	PHOSPHORUS FERTILIZER NUTRIENT	POTASSIUM FERTILIZER NUTRIENT	M ULCH, M ETHOD 2	SEEDLINGS	TREES SPECIAL
L	OCATIO	ON	SQ YD	ACRE	POUND	POUND	POUND	ACRE	UNIT	EACH
STA 153+35.00	то	STA. 158+50.00	785	0.162	14.59	14.59	14.59	0.162		
STA. 158+50.00	то	STA. 163+50.00	919	0.190	17.09	17.09	17.09	0.190		
STA. 163+50.00	TO	STA. 168+50.00	1,105	0.228	20.55	20.55	20.55	0.228		
STA. 168+50.00	TO	STA. 173+50.00	761	0.157	14.16	14.16	14.16	0.157		
STA. 173+50.00	ТО	STA. 178+50.00	1004	0.207	18.66	18.66	18.66	0.207		5
STA. 178+50.00	то	STA. 180+64.00	318	0.066	5.91	5.91	5.91	0.066		3
DELIVER TO VIL	LAGE	OF CREVE COBUR							6.0	
			SUBTOTAL	1.011	90.96	90.96	90.96	1.011	6.0	8
			TOTAL	1.25	91	91	91	1.25	6.0	8

STORM SEWER SCHEDULE		TRENCH BACKFILL	STORM SEWERS, CLASS A, TYPE 1 12"	STORM SEWERS, CLASS A, TYPE 1 18"	STORM SEWERS, CLASS A, TYPE 1 24"	STORM SEWERS, CLASS A, TYPE 2 12"	STORM SEWERS, CLASS A, TYPE 2 24"	STORM SEWERS, CLASS A, TYPE 2 30"	STORM SEWERS, CLASS A, TYPE 2 36"	PROPOSED STORM SEWER CONNECTION TO EXISTING STORM SEWER	PLACE PIPE LINER, 12"	PLACE PIPE	PLACE PIPE		STORM SEWERS, TYPE 1, WATER MAIN QUALITY PIPE, 18"	2, WATER MAIN	
		CU YD	FOOT	EACH	FOOT	FOOT	FOOT	FOOT	FOOT	FOOT	FOOT						
	TO STA. 158+50.00	2.50	52								34	401					
STA. 158+50.00	TO STA. 163+50.00	129.9	61		156					1		127	246				
STA. 163+50.00	TO STA. 168+50.00	425.6	762	70	10		88	6		2					30		
STA. 168+50.00	TO STA. 173+50.00	242.40	554							1				48			
STA. 173+50.00	TO STA. 178+50.00	324.50	189	164		75								149		327	
STA. 178+50.00	TO STA. 180+64.00	67.20	53	159					102								35
	TOTAL	1,192	1.671	393	166	75	88	6	102	4	34	528	246	197	30	327	35

ELECTRIC STRUCTURES SCHEDULE			ELECTRIC SERVICE INSTALLATION	HANDHOLE, PORTLAND CEMENT CONCRETE	LIGHTING CONTROLLER, BASE MOUNTED, 240VOLT, 100AMP	LIGHT POLE, ALUMINUM, 45 FT. M.H., 15 FT. MAST ARM	LIGHT POLE FOUNDATION, 30" DIAMETER	LIGHT POLE Foundation, 24" diameter	Breakaway Device, Coupling With Aluminum Skirt	Luminaire, Led, Horizontal Mount, Special	Luminaire, Led, special	ORNAM ENTAL LIGHT UNIT, COM PLETE
L	DCAT	ION	EACH	EACH	EACH	EACH	FOOT	FOOT	EACH	EACH	EACH	EACH
STA 153+35.00	TO	STA. 158+50.00	0	0	0	5	32.5	45	5	5	27	9
STA. 158+50.00	TO	STA. 163+50.00	1	3	1	5	32.5	55	5	5	33	11
STA. 163+50.00	TO	STA. 168+50.00	0	0	0	5	32.5	50	5	5	30	10
STA. 168+50.00	TO	STA. 173+50.00	0	0	0	5	32.5	65	5	5	39	13
STA. 173+50.00	TO	STA. 178+50.00	1	3	1	5	32.5	55	5	5	33	11
STA. 178+50.00	то	STA. 180+64.00	0	0	0	2	13.0	15	2	2	9	3
		TOTAL	2	6	2	27	175.5	285	27	27	171	57

		JCTURE SCHEDULE	FLARED END SECTIONS 24"	MANHOLES, TYPE A, 4'-DIAMETER, TYPE 1 FRAME, CLOSED LID	TYPE 3V FRAME AND GRATE	MANHOLES, TYPE A, 5'-DIAMETER, TYPE 1 FRAME, CLOSED LID	INLETS, TYPE G-1	INLET- MANHOLE, TYPE G-1, 4' DIAMETER	INLET- MANHOLE, TYPE G-1, 5' DIAMETER
L	DCA.	TION	EACH	EACH	EACH	EACH	EACH	EACH	EACH
STA 153+35.00	TO	STA. 158+50.00		3	1		3		
STA. 158+50.00	TO	STA. 163+50.00	1	1		2	3	1	
STA. 163+50.00	TO	STA. 168+50.00	1	4		4	10	2	1
STA. 168+50.00	TO	STA. 173+50.00		2			6	3	
STA. 173+50.00	TO	STA. 178+50.00		4			8	2	
STA. 178+50.00	TO	STA. 180+64.00				2	4		1
	-	ΤΟΤΑΙ	2	14	1	8	34	8	2

PATCHIN	IG SI	CHEDULE	CLASS C PATCHES, TYPE II, 16 INCH	CLASS C PATCHES, TYPE III, 16 INCH	CLASS C PATCHES, TYPE IV, 16 INCH	SAW CUTS	TIE BARS 3/4"
LO	CAT	ION	SQ YD	SQ YD	SQ YD	FOOT	EACH
STA 153+35.00	TO	STA. 158+50.00	15.0	39.6	0.0	130	48
STA. 158+50.00	TO	STA. 163+50.00	24.7	16.0	164.6	413	296
STA. 163+50.00	TO	STA. 168+50.00	23.0	40.8	302.9	1,055	155
STA. 168+50.00	TO	STA. 173+50.00	17.7	42.3	123.0	584	125
STA. 173+50.00	TO	STA. 178+50.00	25.0	0.0	236.5	647	268
STA. 178+50.00	TO	STA. 180+64.00	5.0	0.0	293.5	546	312
		TOTAL	110	139	1,121	3,375	1,204

HANDRA	IL AI	ND WALL		PIPE HANDRAIL	SEGMENTAL CONCRETE BLOCKWALL
LO	CAT	ON		FOOT	SQ FT
STA 155+32.00	TO	STA. 155+55.00	LT		78
STA. 157+00.00	TO	STA. 157+28.50	LT		128
STA. 157+48.20	TO	STA. 158+00.00	LT		225
STA. 162+15.00	TO	STA. 163+00.00	RT		245
STA. 163+50.00	TO	STA. 165+35.00	LT	185	
STA. 166+50.00	TO	STA. 167+50.00	RT	100	
STA. 166+60.00	TO	STA. 167+85.00	LT	125	
STA. 171+60.00	TO	STA. 173+87.00	LT		1,090
		TOTAL		410	1,766

STA. 158+50.00 TO STA. 163+50.0		ABLESCHEDULE	UNDERGROUND CONDUIT, PVC, 2'' DIA.	UNDERGROUND CONDUIT, PVC, 4" DIA.		ELECTRIC CABLE IN CONDUIT, 600V (XLP-TYPE USE) 1/C NO. 8				ELECTRIC CABLE IN CONDUIT, 600V (XLP-TYPE USE) 1/C NO. 2	ELECTRIC CABLE IN CONDUIT, 600V (XLP-TYPE USE) 1/C NO. 1
		ON	FOOT	FOOT	FOOT	FOOT	FOOT	FOOT	FOOT	FOOT	FOOT
STA 153+35.00	TO	STA. 158+50.00	929	0	1326	0	0	2787	0	1,461	0
STA. 158+50.00	TO	STA. 163+50.00	1194	108	1674	0	1134	3786	0	1746	60
STA. 163+50.00	TO	STA. 168+50.00	1145	0	1650	0	3303	1653	0	0	0
STA. 168+50.00	TO	STA. 173+50.00	1170	0	1311	1806	1311	1806	0	0	0
STA. 173+50.00	TO	STA. 178+50.00	1206	108	2364	1842	624	1842	1740	0	60
STA. 178+50.00	то	STA. 180+64.00	300	0	345	555	0	555	345	0	0
	тот			216	8670	4203	6372	12429	2085	3207	120

WATER MAIN STRUCTURE SCHEDULE	WATER MAIN 6"	WATER MAIN 8"	TAPPING VALVES AND SLEEVES 6"		WATER SERVICE LINE 1"	WATER SERVICE LINE 2"	CORPORATION STOPS 1"	CORPORATION STOPS 2"	CURB STOPS 1"	CURB STOPS 2"	FIRE HYDRANT WITH AUXILIARY VALVE AND VALVE BOX	PLUG EX WATER MAIN	PLUG WATER MAIN 8"	WATER VALVES 8"	DIRECTIONAL BORING		WATER MAIN ENCASEMENT	WATER MAIN LINE STOP 8"	
LOCATION	EACH	FOOT	EACH	EACH	FOOT	FOOT	EACH	EACH	EACH	EACH	EACH	EACH	EACH	EACH	FOOT	EACH	FOOT	EACH	CU YD
STA 153+35.00 TO STA. 158+50.00	16	238		1	10		1		1		2	1		1					92
STA. 158+50.00 TO STA. 163+50.00	12	331			20		2		2					3	165			1	128
STA. 163+50.00 TO STA. 168+50.00	24	758	1		10		1		1		2	1		2	175		70		293
STA. 168+50.00 TO STA. 173+50.00	46	850			50	30	5	3	5	3	4	1		3	150		40		328
STA. 173+50.00 TO STA. 178+50.00	36	1000			70	10	2	1	2	1	3			3			433		387
STA. 178+50.00 TO STA. 180+64.00	20	396		2	10		1		1		2	3	1	3			20		154
ENTIRE PROJECT																15			
TOTAL	154	3,573	1	3	170	40	12	4	12	4	13	6	1	15	490	15	563	1	1,382


PAVEMENTM	ARKI	NG SCHEDULE	M ODIFIED URETHANE PAVEMENT MARKING - LETTERS AND SYMBOLS	GROOVING FOR RECESSED PAVEMENT MARKING, LETTERS AND SYMBOLS	MODIFIED URETHANE PAVEMENT MARKING - LINE 4"	GROOVING FOR RECESSED PAVEMENT MARKING 5"	URETHANE RECESSED URETHANE RECESSED PAVEMENT MARKING - LINE PAVEMENT 6" AAVEMENT MARKING - LINE PAVEMENT 4"		RAISED REFLECT MAF	TIVE PAVEMENT Rker		
					YELLOW		WHITE		WHITE		ONE-WAY	TWO-WAY
LO	CATI	ON	SQ FT	SQ FT	FOOT	FOOT	FOOT	FOOT	FOOT	FOOT	EACH	EACH
STA. 154+64.00	TO	STA. 158+50.00	68.76	79.8	965.0	965.0	193.0	193.0	21.0	21.0	10	19
STA. 158+50.00	TO	STA. 163+50.00	103.14	119.7	1045.0	1045.0	209.0	209.0	17.1	17.1	11	23
STA. 163+50.00	TO	STA. 168+50.00	103.14	119.7	977.5	977.5	195.5	195.5	16.3	16.3	12	22
STA. 168+50.00	TO	STA. 173+50.00	68.76	79.8	1067.5	1067.5	213.5	213.5	17.3	17.3	12	23
STA. 173+50.00	TO	STA. 178+50.00	34.38	39.9	1250.0	1250.0	250.0	250.0		0.0	12	25
STA. 178+50.00	TO	STA. 180+64.00	34.38	39.9	232.5	232.5	46.5	46.5	28.3	28.3	6	8
		SUBTOTAL	413	479	5,538	5538	1108	1108	100	100	63	120
		TOTAL	413	479	5,538	5538	1108	1108	100	100	1	B3


QUANTITIES NOT OTHERWISE SCHEDULED	ENGINEER'S FIELD OFFICE, TYPE B	MOBILIZATION	TRAFFIC CONTROL SURVELLANCE	TRAFFIC CONTROL AND PROTECTION, (SPECIAL)	CHANGEABLE MESSAGE SIGN	CONSTRUCTION LAYOUT	MATERIAL TRANSFER DEVICE
LOCATION	CALMO	L SUM	CAL DA	L SUM	CAL DA	L SUM	TON
IL-29	12	1	200	1	180	1	1513
TOTAL	12	1	200	1	180	1	1513

	USER NAME = IDOT	DESIGNED - KMC	REVISED -						IL. RTE. 29		F.A.P. RTE.	SECTION	COUNTY TOTAL SHEET SHEETS NO.
MW		DRAWN - KRS DLC	REVISED -	STATE OF ILLINOIS	NOIS SCHEDULE OF QUANTITIES				669	16-00045-01-SW	TAZEWELL 155 21		
Midwest Engineering	PLOT SCALE = 2.000 FT / in.	CHECKED - RDC	REVISED -	DEPARTMENT OF TRANSPORTATION	SCHEDULE OF QUANTITIES					CONTRACT NO. 89713			
Associates, Inc.	PLOT DATE = 1/22/2019	DATE - \$DATE	REVISED -		SCALE: NONE SHEET 3 OF 3 SHEETS STA. TO STA.					ILLINOIS FE	D. AID PROJECT 05E2(122)		

TRENCH BACKFILL	CONCRETE CI M
CU YD	
	STA 153+35.00

		ND GUTTER AND SCHEDULE		CONTROLLED LOW- STRENGTH MATERIAL	COM BINATION CONCRETE CURB AND GUTTER, TYPE B-6.12	COMBINATION CONCRETE CURB AND GUTTER, TYPE B-6.24	CONCRETE CURB TRANSITION	TRANSITIONAL COMBINATION CONCRETE CURB AND GUTTER	CONCRETE MEDIAN (SPECIAL)
	LOC			CUYD	FOOT	FOOT	FOOT	FOOT	SQ FT
STA 153+35.00	TO	STA. 158+50.00	LT	9.2		499			
STA. 158+50.00	TO	STA. 163+50.00	LT	7.7		415			
STA. 163+50.00	TO	STA. 168+50.00	LT	9.3		500			
STA. 168+50.00	TO	STA.173+50.00	LT	9.3		500		18	157
STA. 173+50.00	TO	STA. 178+50.00	LT	9.3		500		49	
STA. 178+50.00	TO	STA. 180+54.00	LT	3.8		205			
STA 153+35.00	TO	STA. 158+50.00	RT	7.7		418		12	
STA. 158+50.00	TO	STA . 163+50.00	RT	9.3		503			
STA. 163+50.00	TO	STA. 168+50.00	RT	9.0	16	487		31	
STA. 168+50.00	TO	STA. 173+50.00	RT	8.4		456	63	99	
STA. 173+50.00	TO	STA. 178+50.00	RT	9.3		501		108	
STA. 178+50.00	TO	STA . 180+64.00	RT	4.4		240		40	
			TOTAL	97	16	5,224	63	357	157

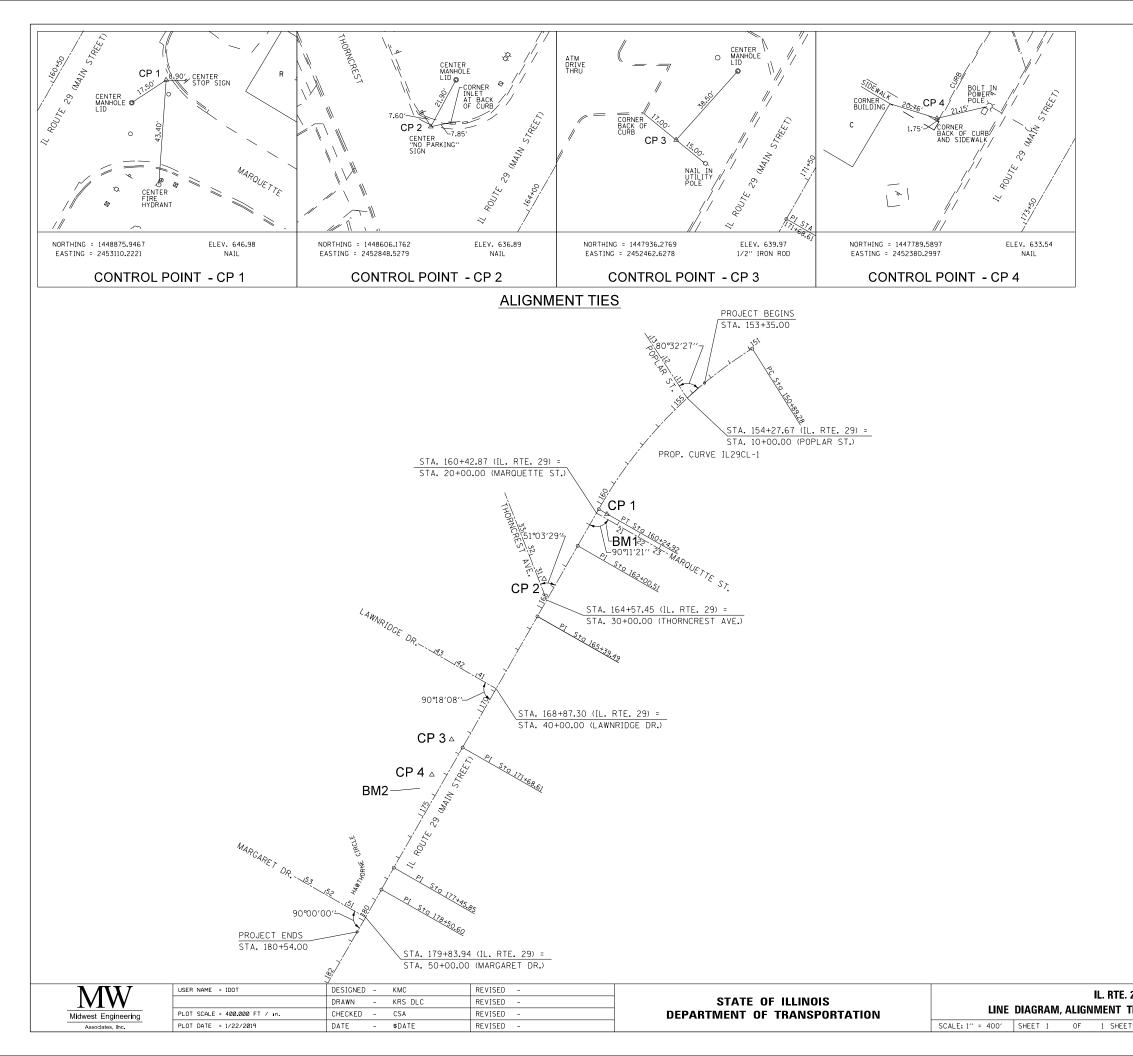

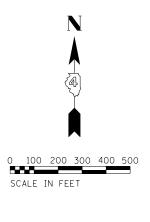


BENCHMARKS


BENCHMARK NO. 1 (BM1): CAP BOLT NEXT TO 'M'' IN MUELLER FIRE HYDRANT STA. 160+64.85, 58.75' LT. ELEVATION: 647.71


BENCHMARK NO. 2 (BM2): CAP BOLT NEXT TO "M" IN MUELLER FIRE HYDRANT STA. 174+04.73, 70.32' RT. ELEVATION: 634.39

29			F.A.P. RTE.	SEC.	CTION		COUNTY	TOTAL SHEETS	SHEET NO.
TIES AND BENCHMARKS		669	13-0004	5-01-SW		TAZEWELL	155	22	
		DENGINIARING	_				CONTRA	CT NO.	89713
ТS	STA.	TO STA.			ILLINOIS	FED.	AID PROJECT ()5E2(122)	

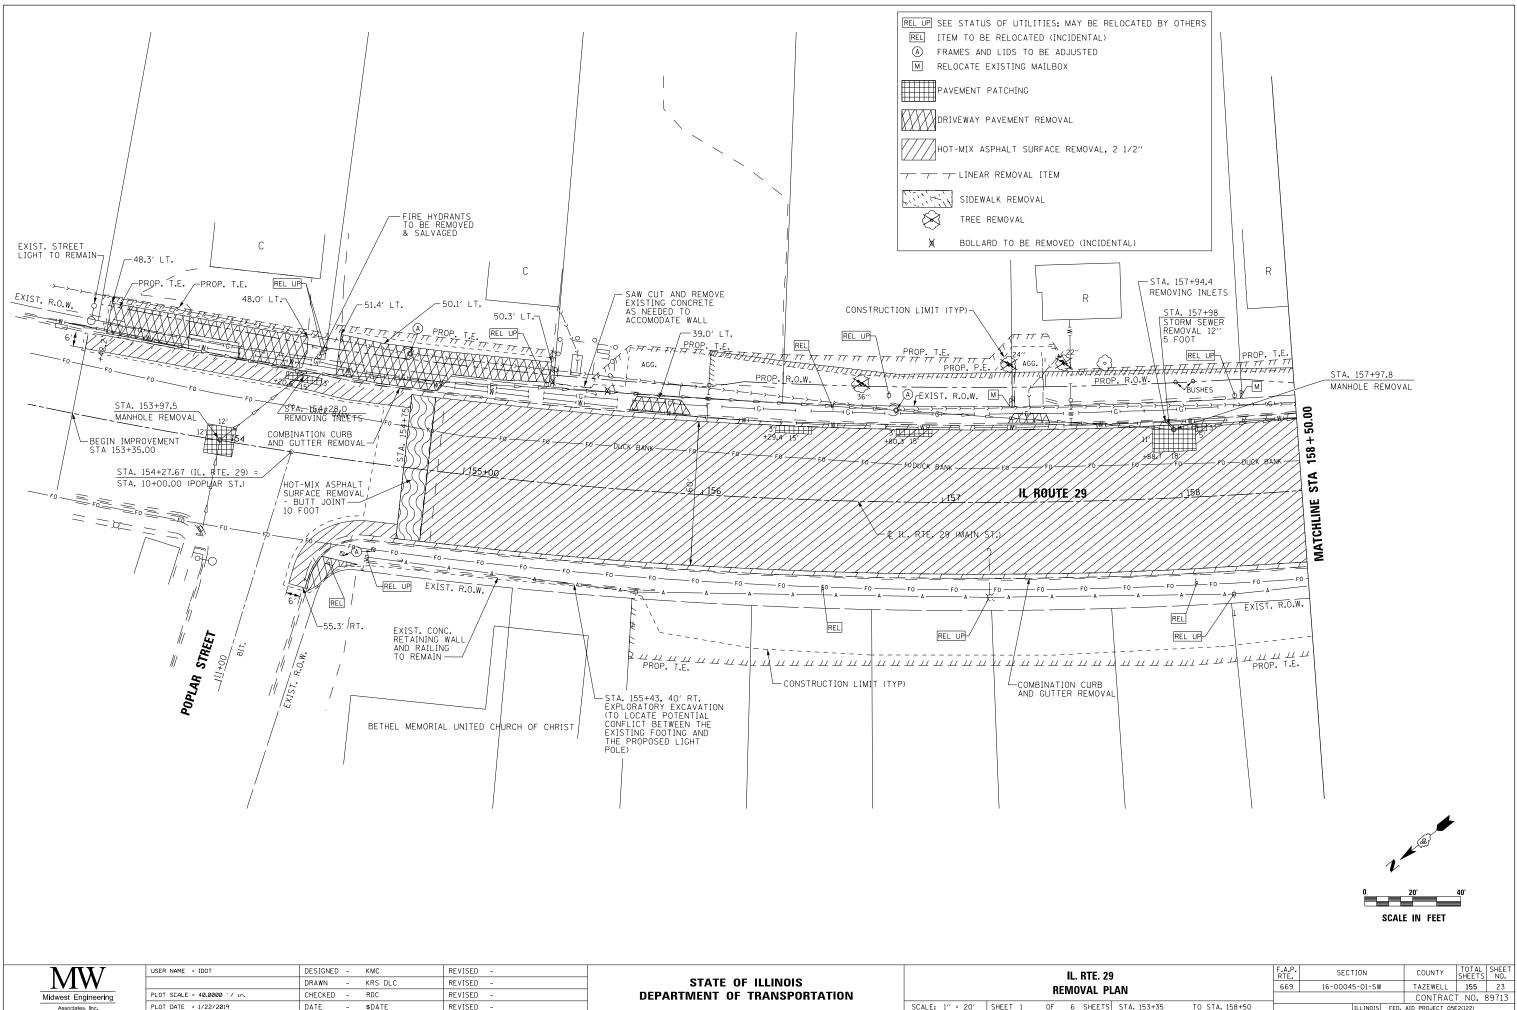


SCALE: 1" = 20' SHEET 1 OF 6 SHEETS STA. 153+35

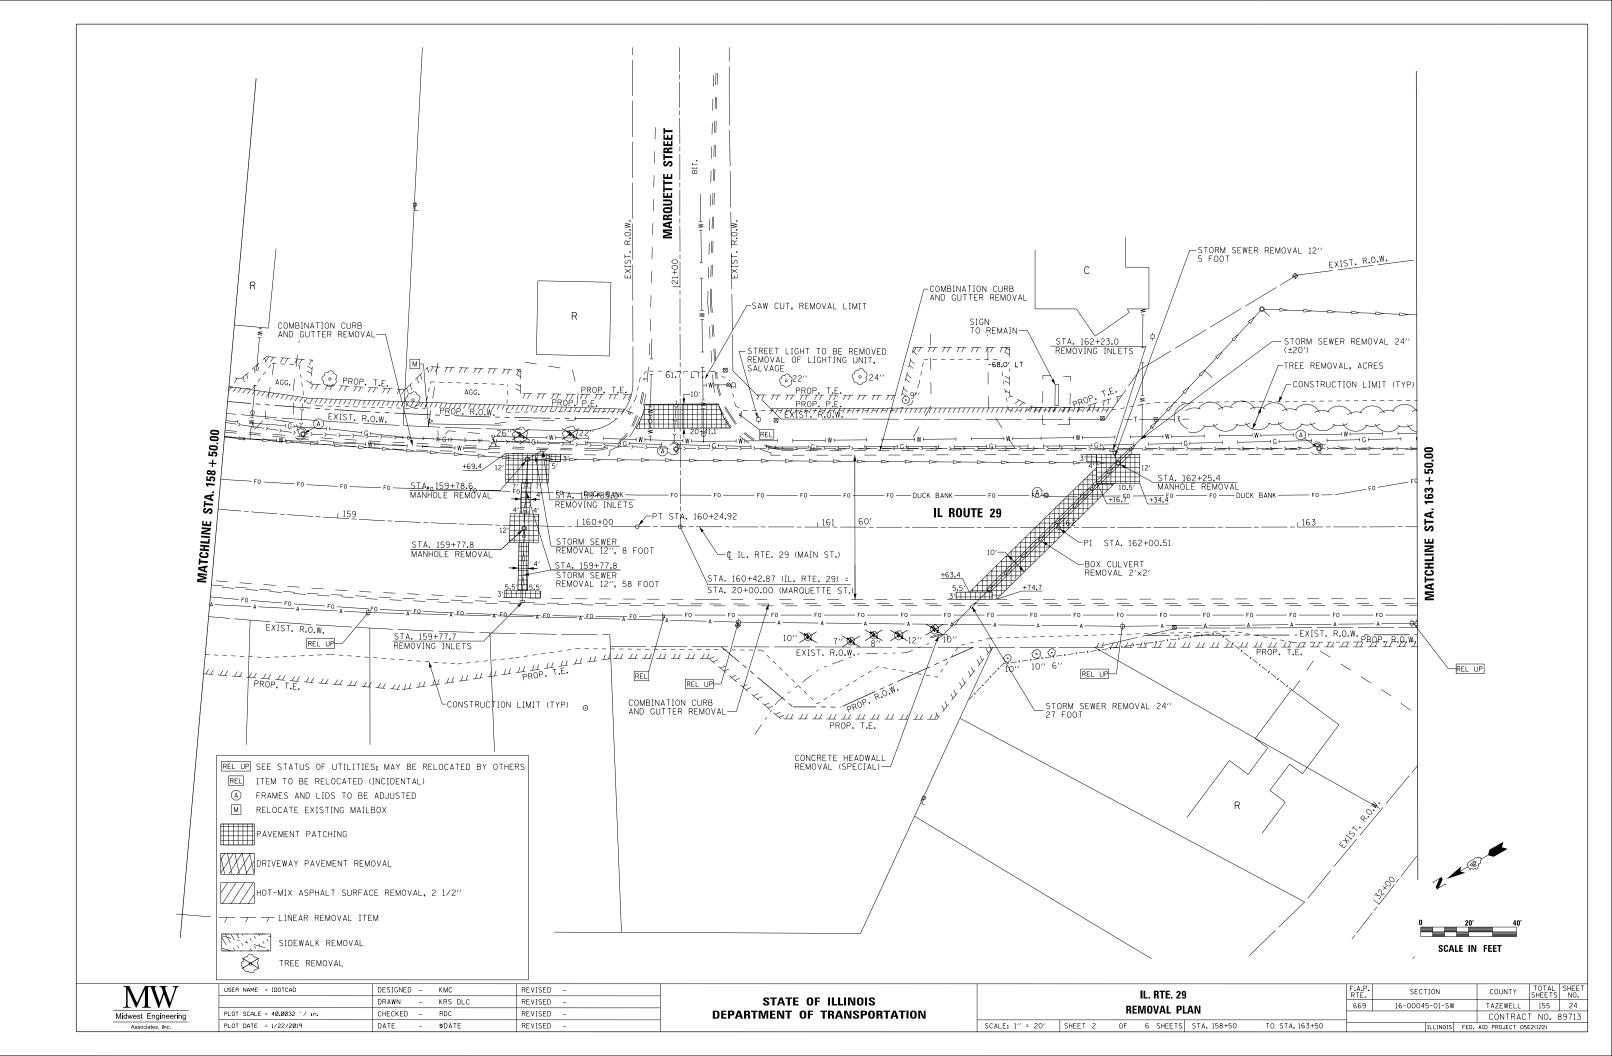

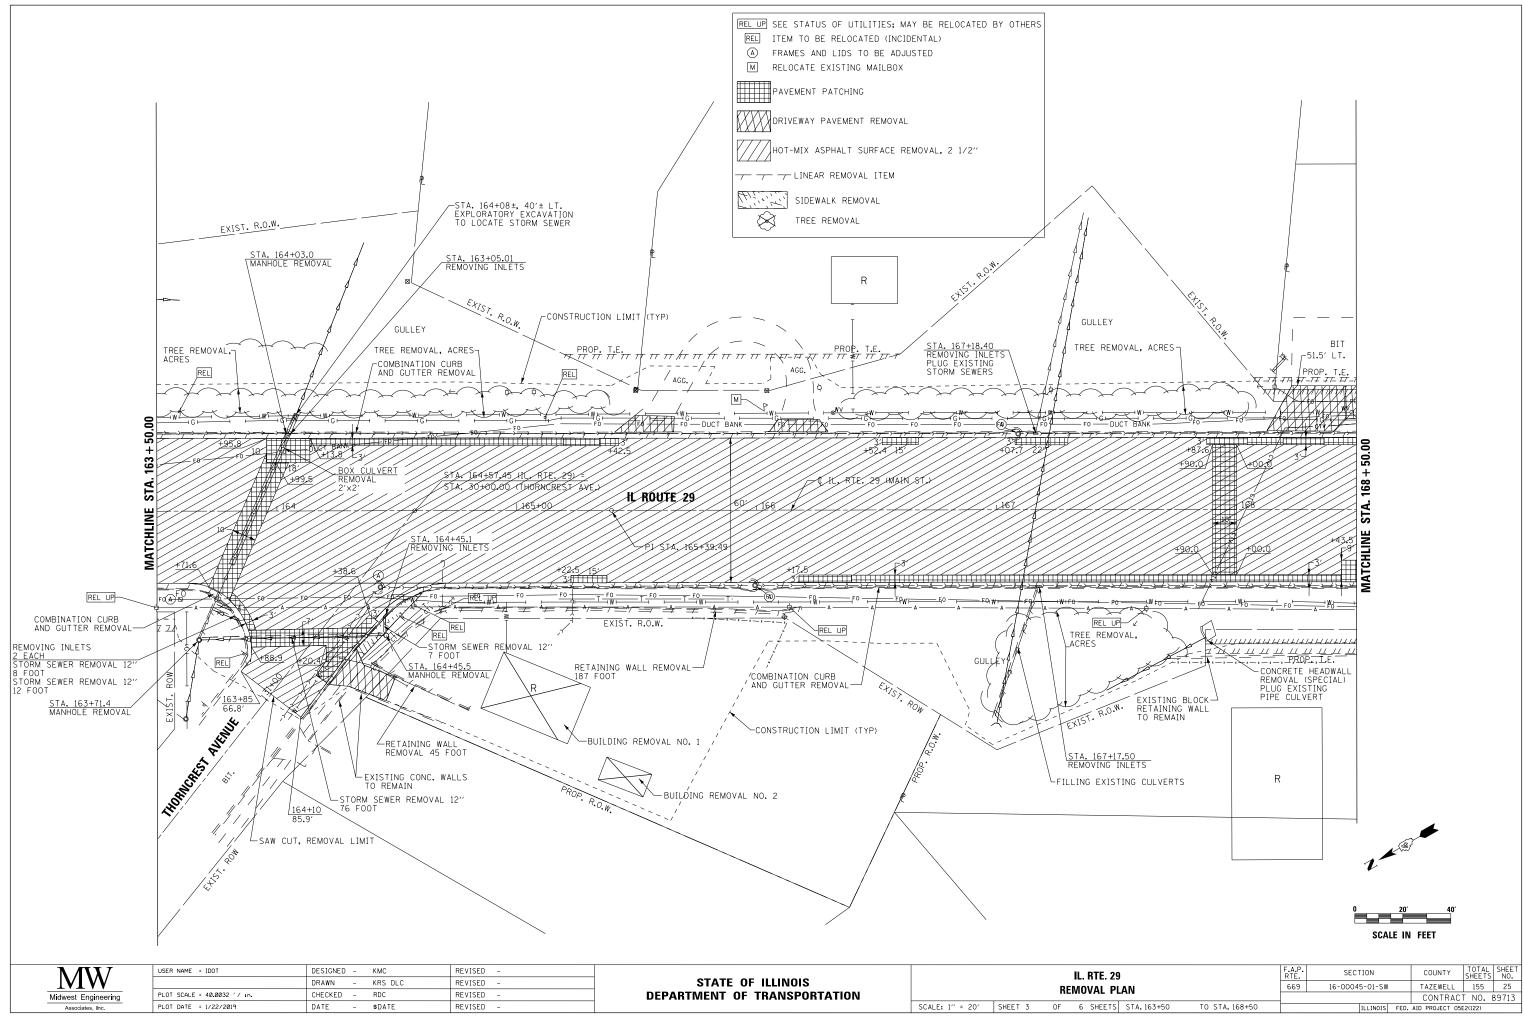

Ы	PLAN			16-00045-01-SW		TAZEWELL	155	25
						CONTRAC	F NO. H	89713
TS	STA.163+50	TO STA.168+50		ILLINOIS	FED.	AID PROJECT 058	2(122)	

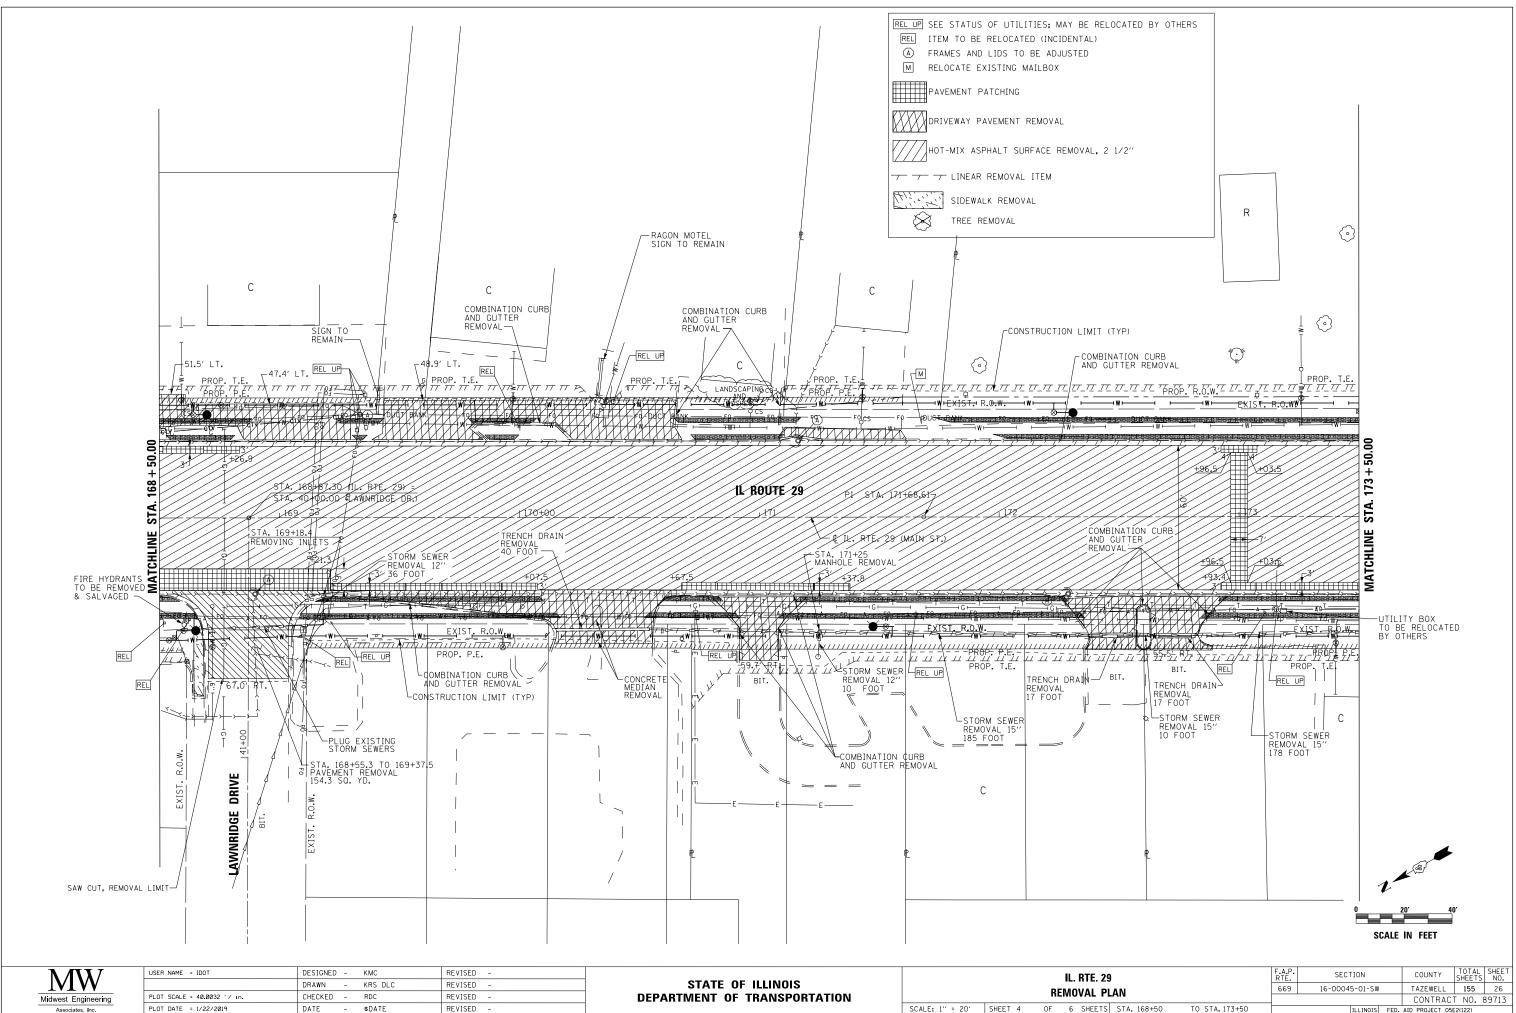


PLOT DATE = 1/22/2019

DATE

\$DATE


REVISED


ΡI	AN.		669	16-00045-01-SW		TAZEWELL	155	26
						CONTRACT	ΓNΟ.	89713
TS	STA. 168+50	TO STA.173+50		ILLINOIS	FED.	AID PROJECT 05E	2(122)	

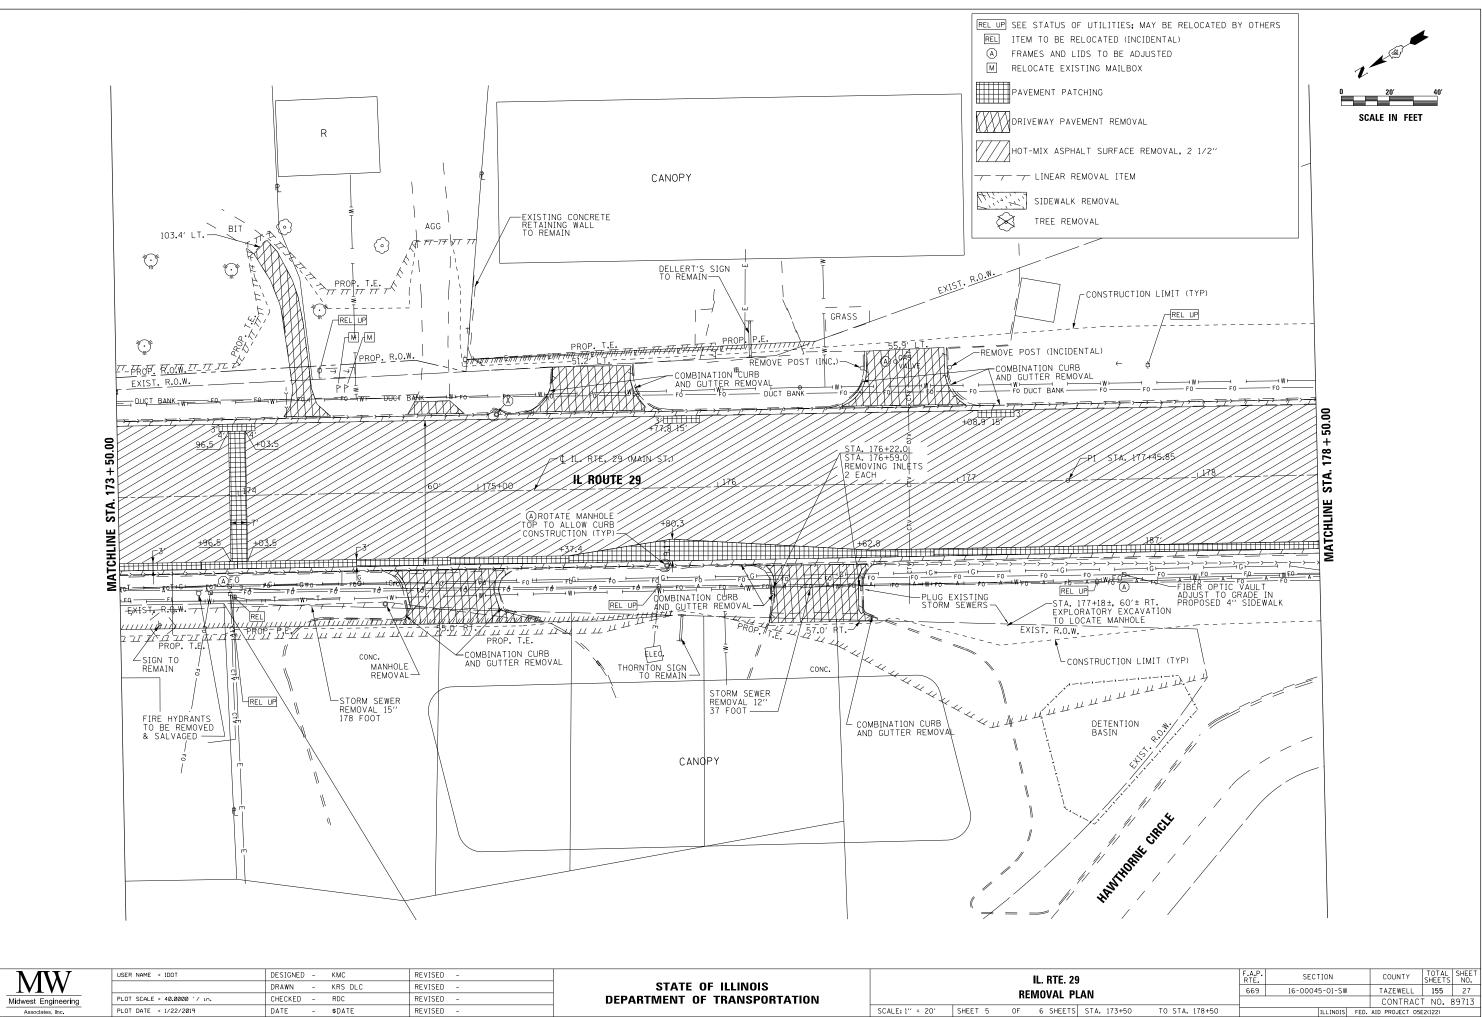



MW
Midwest Engineering
Associates Inc


USER NAME = IDOT	DESIGNED -	КМС	REVISED -					IL. RTE. 29	3
	DRAWN -	KRS DLC	REVISED -	STATE OF ILLINOIS					-
PLOT SCALE = 40.0000 ' / 10.	CHECKED -	RDC	REVISED -	DEPARTMENT OF TRANSPORTATION			KEI	MOVAL PL	-A
PLOT DATE = 1/22/2019	DATE -	\$DATE	REVISED -		SCALE: 1" = 20'	SHEET 5	OF	6 SHEETS	5

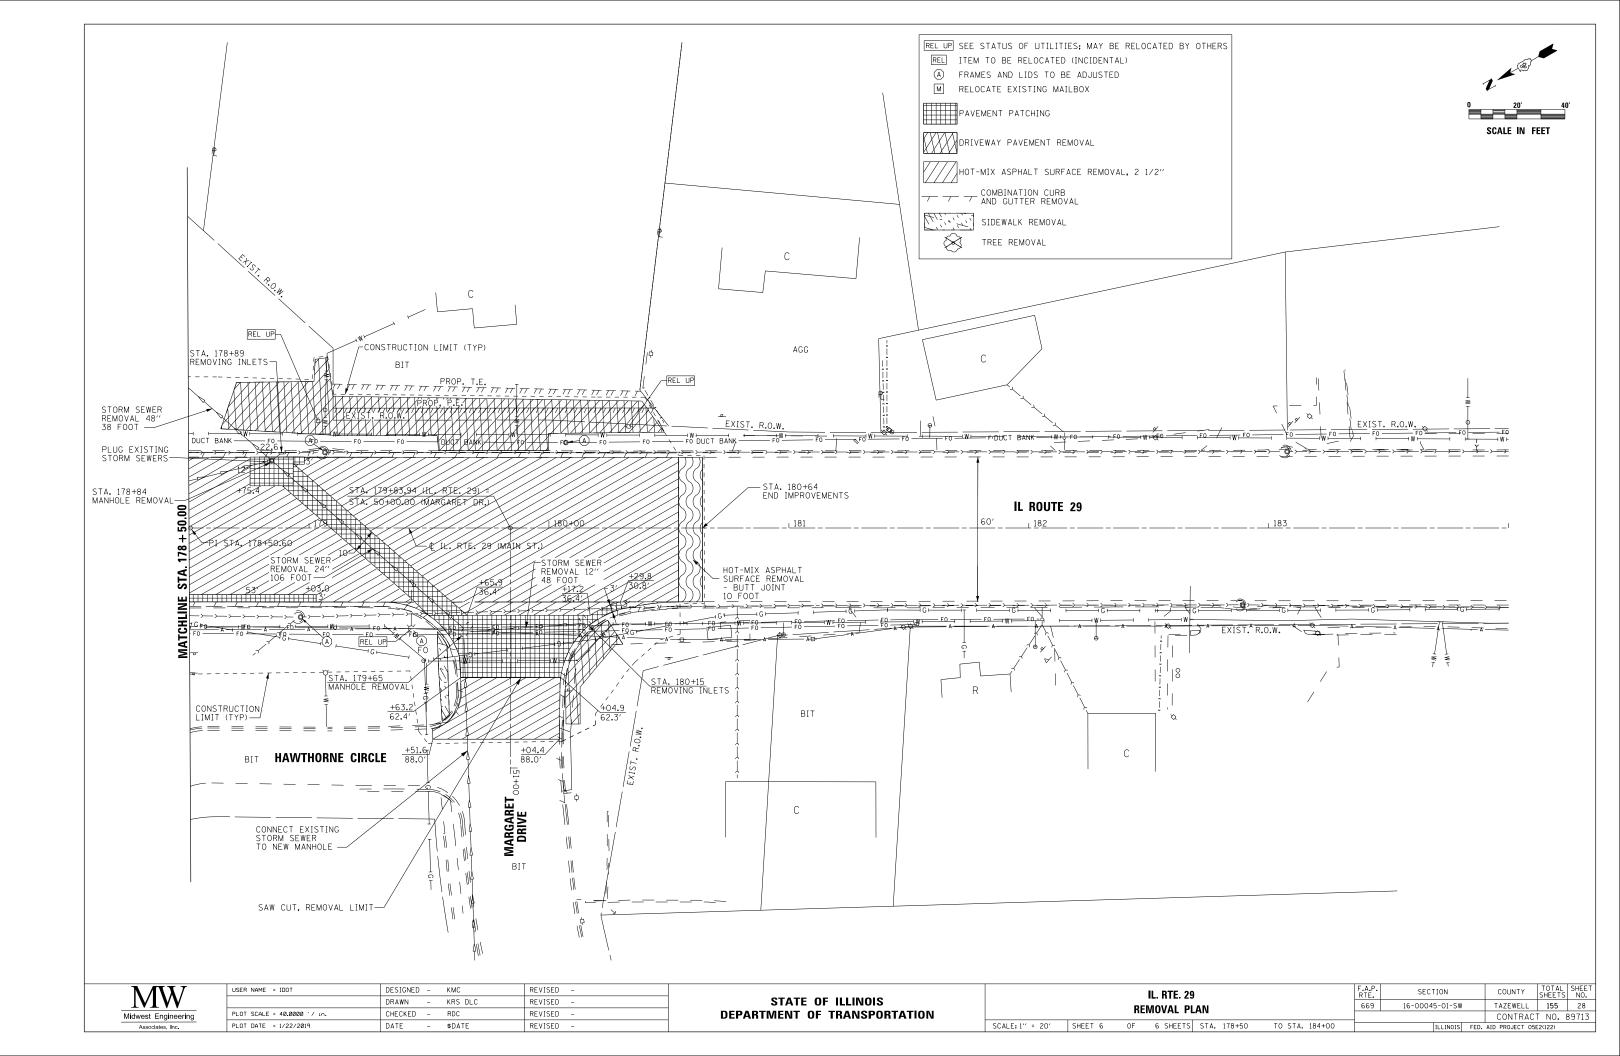


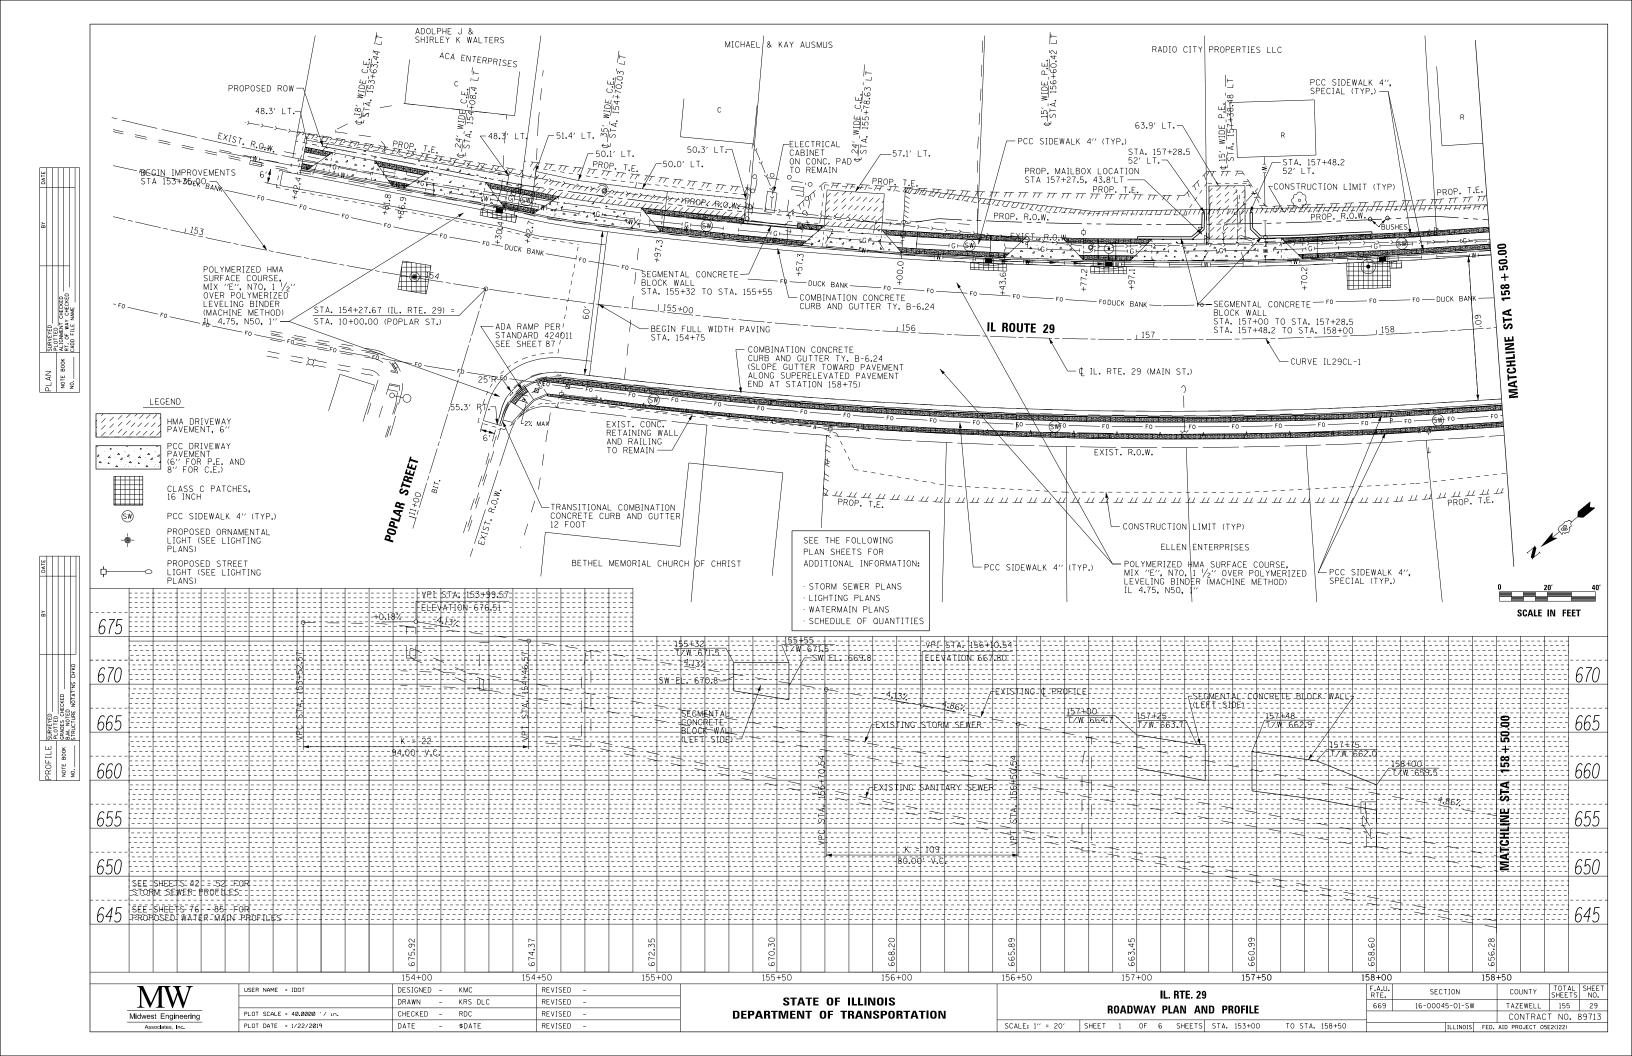


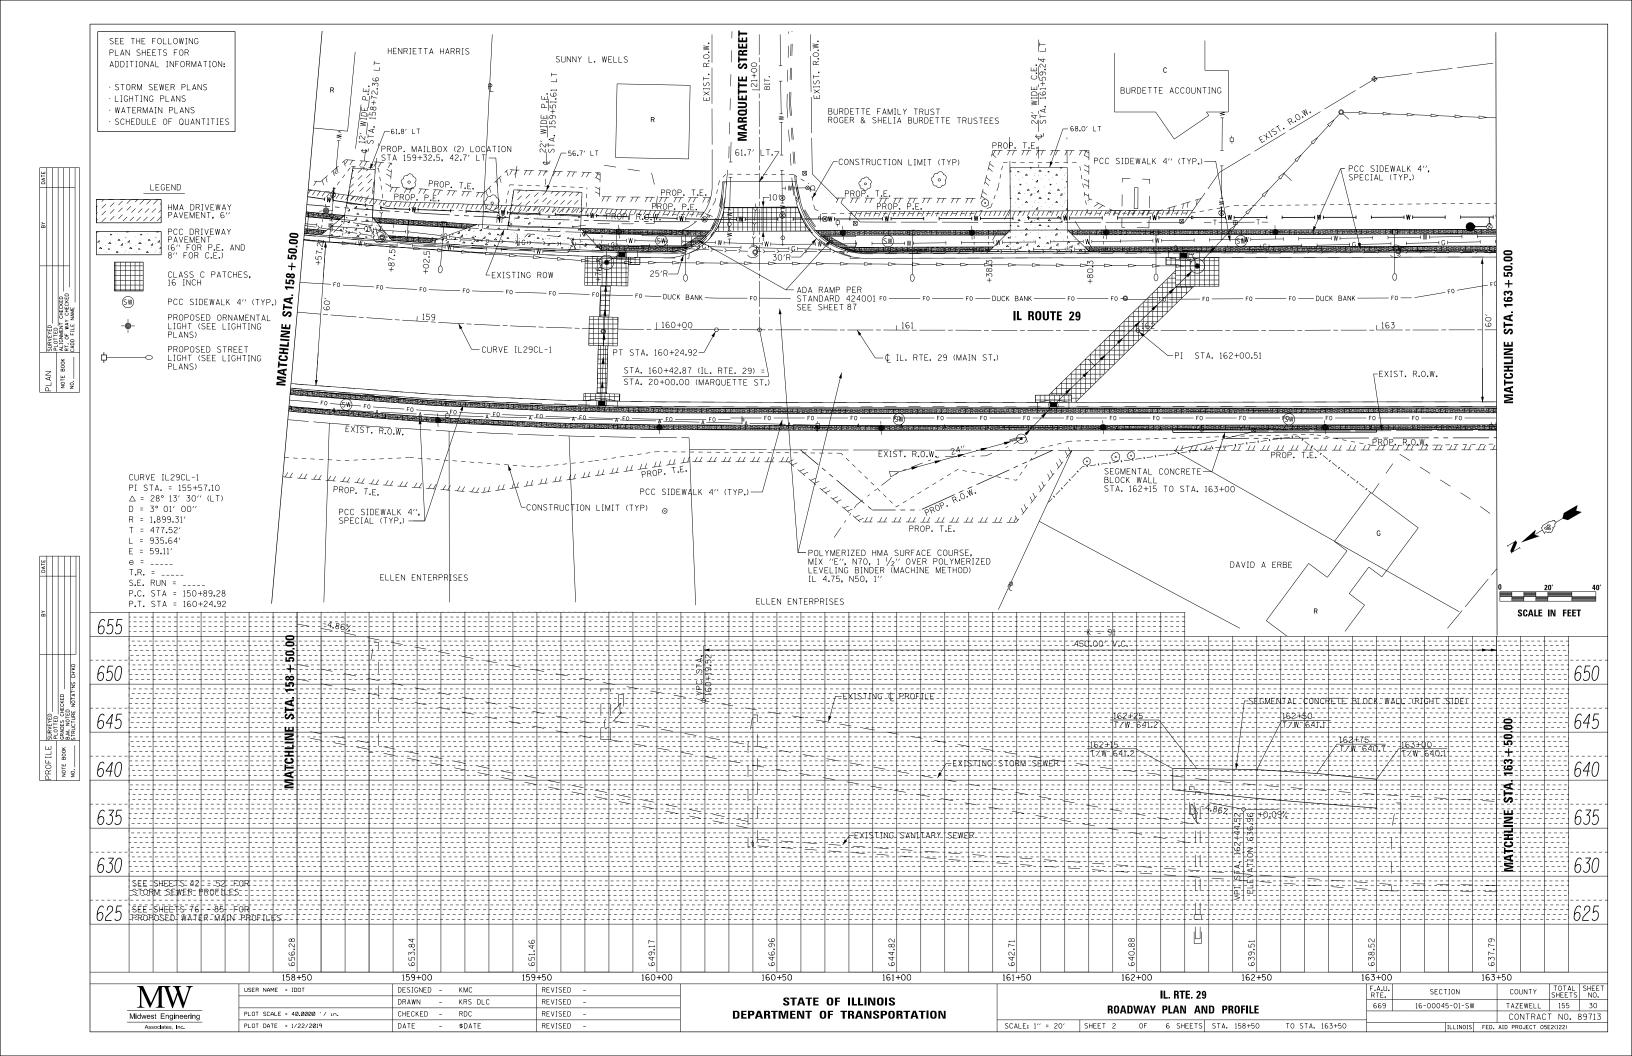

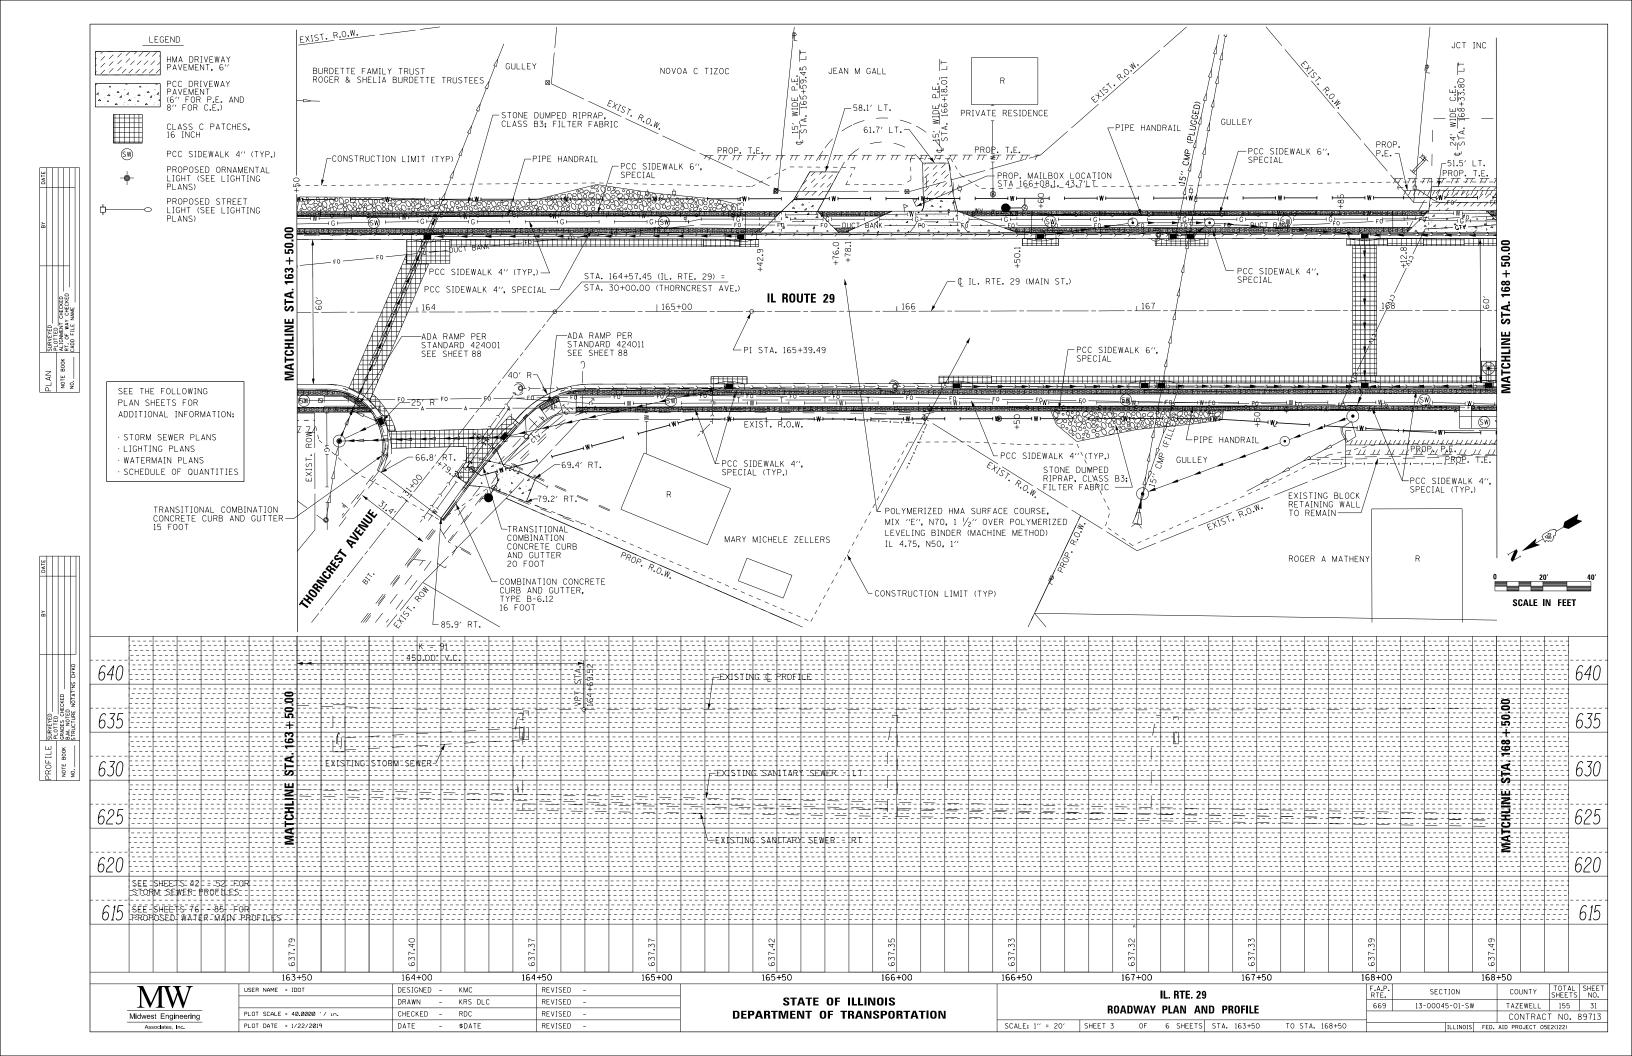


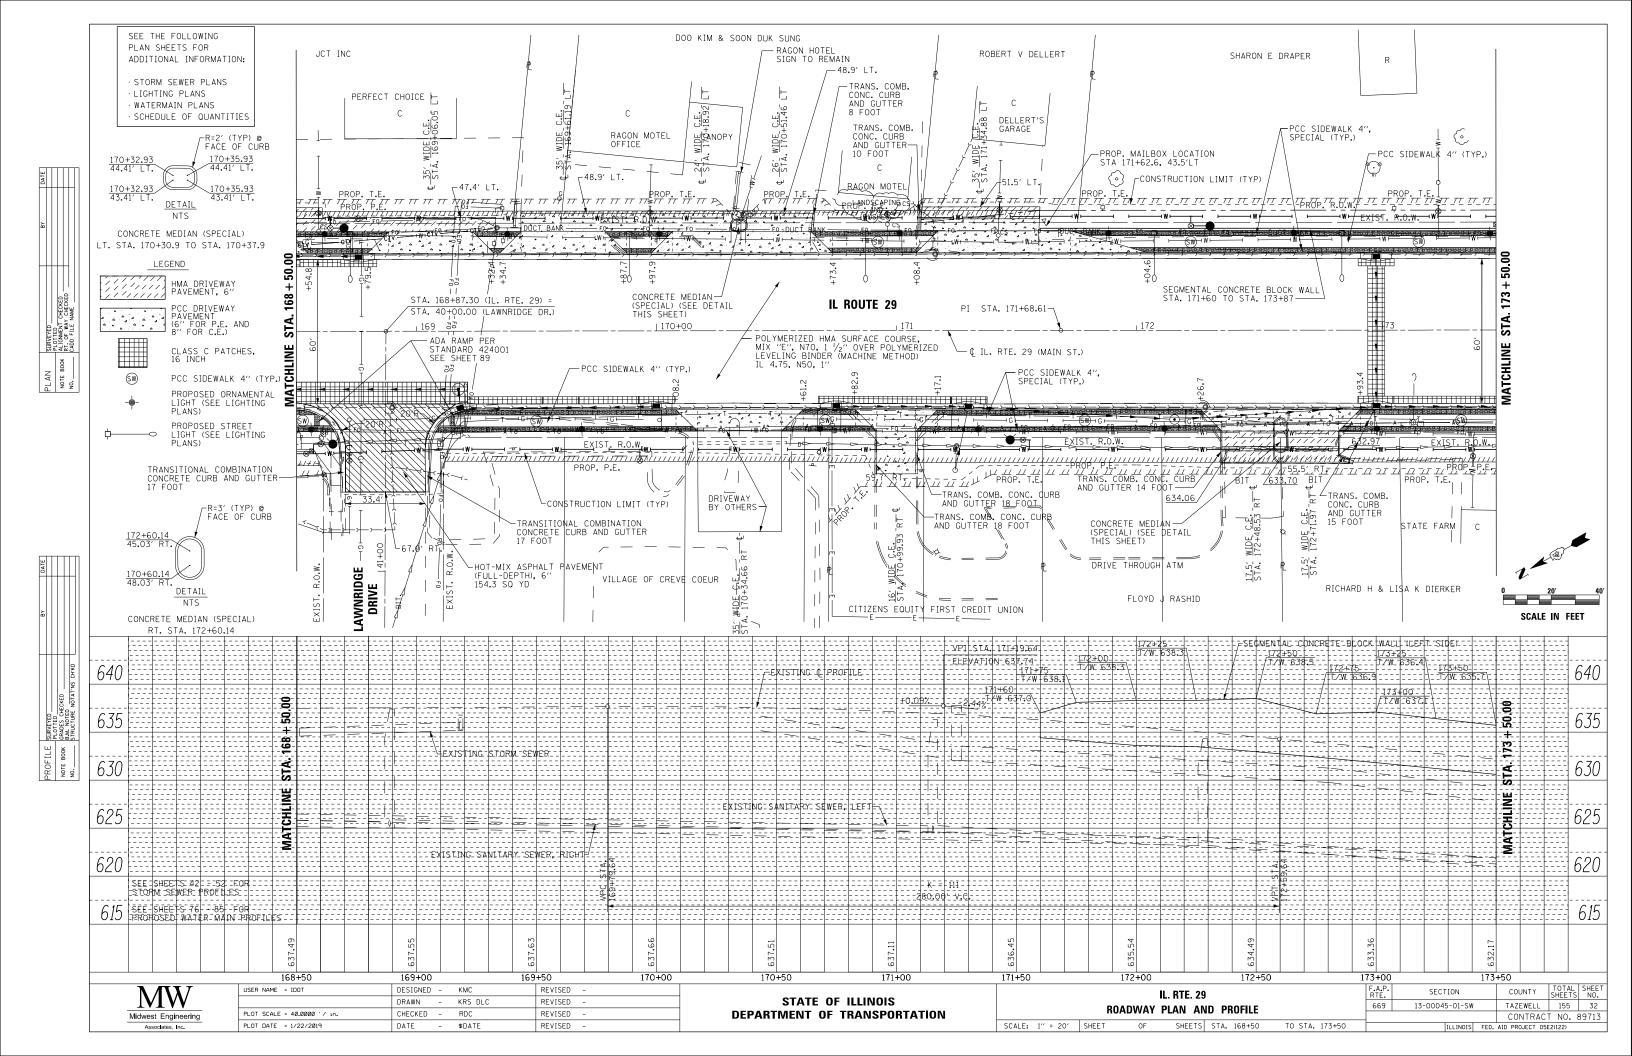

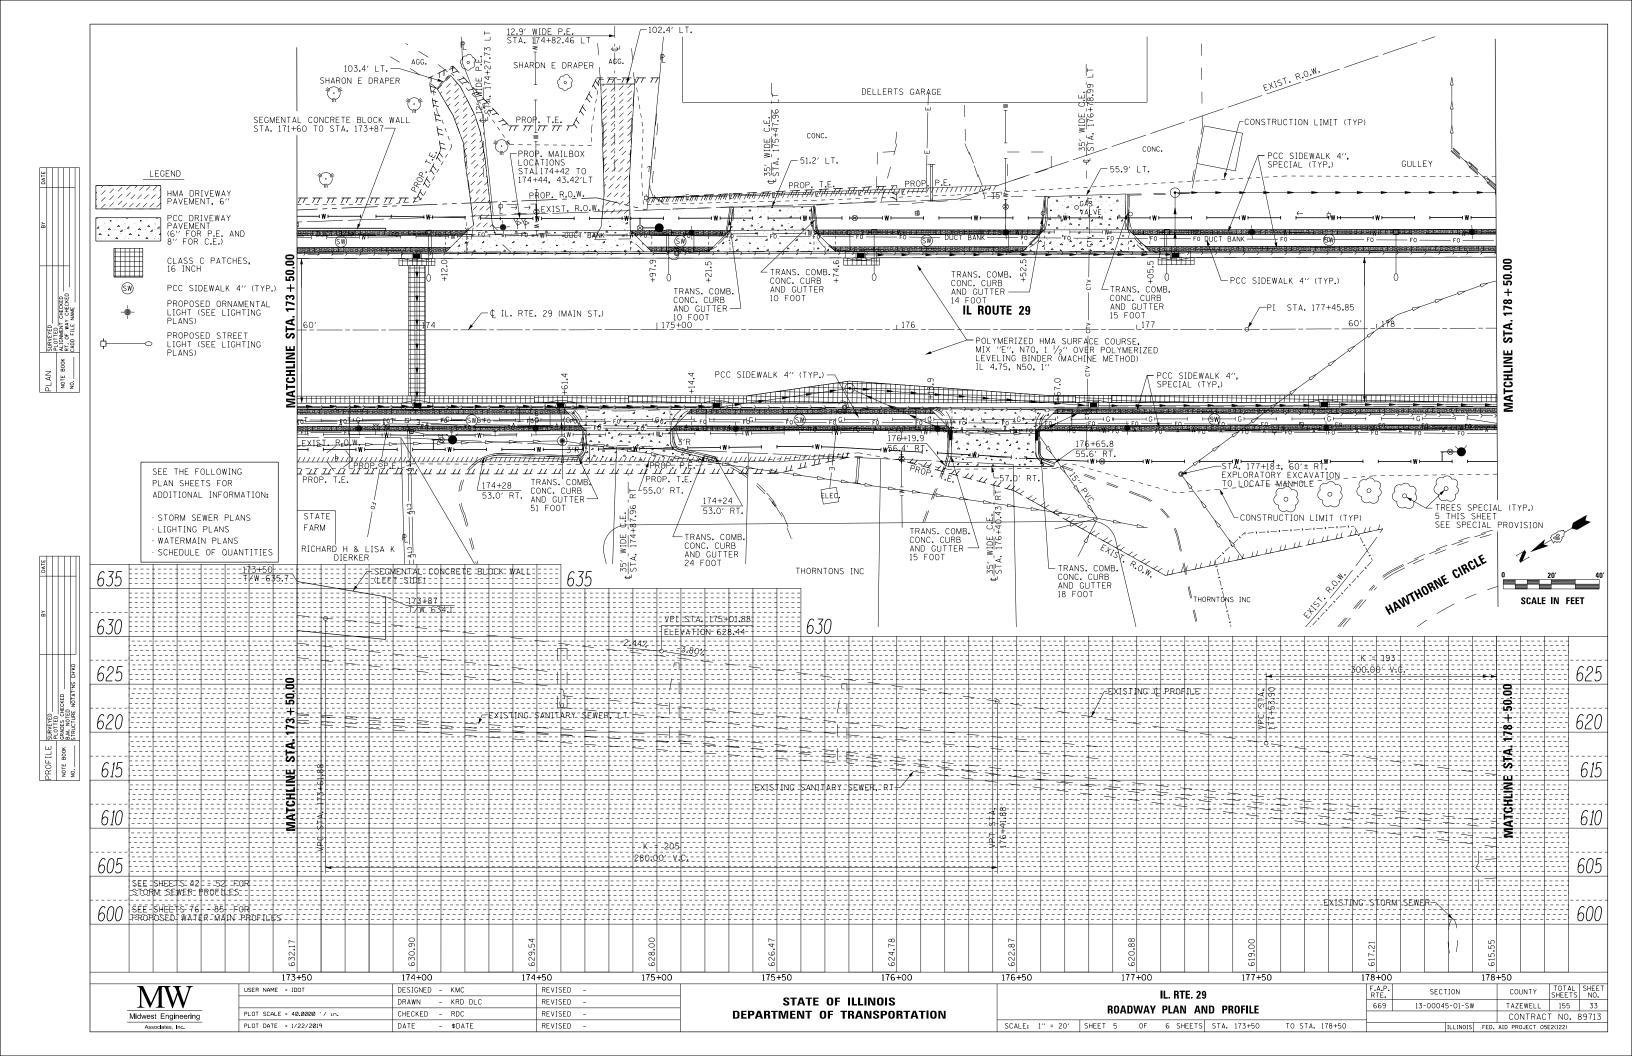

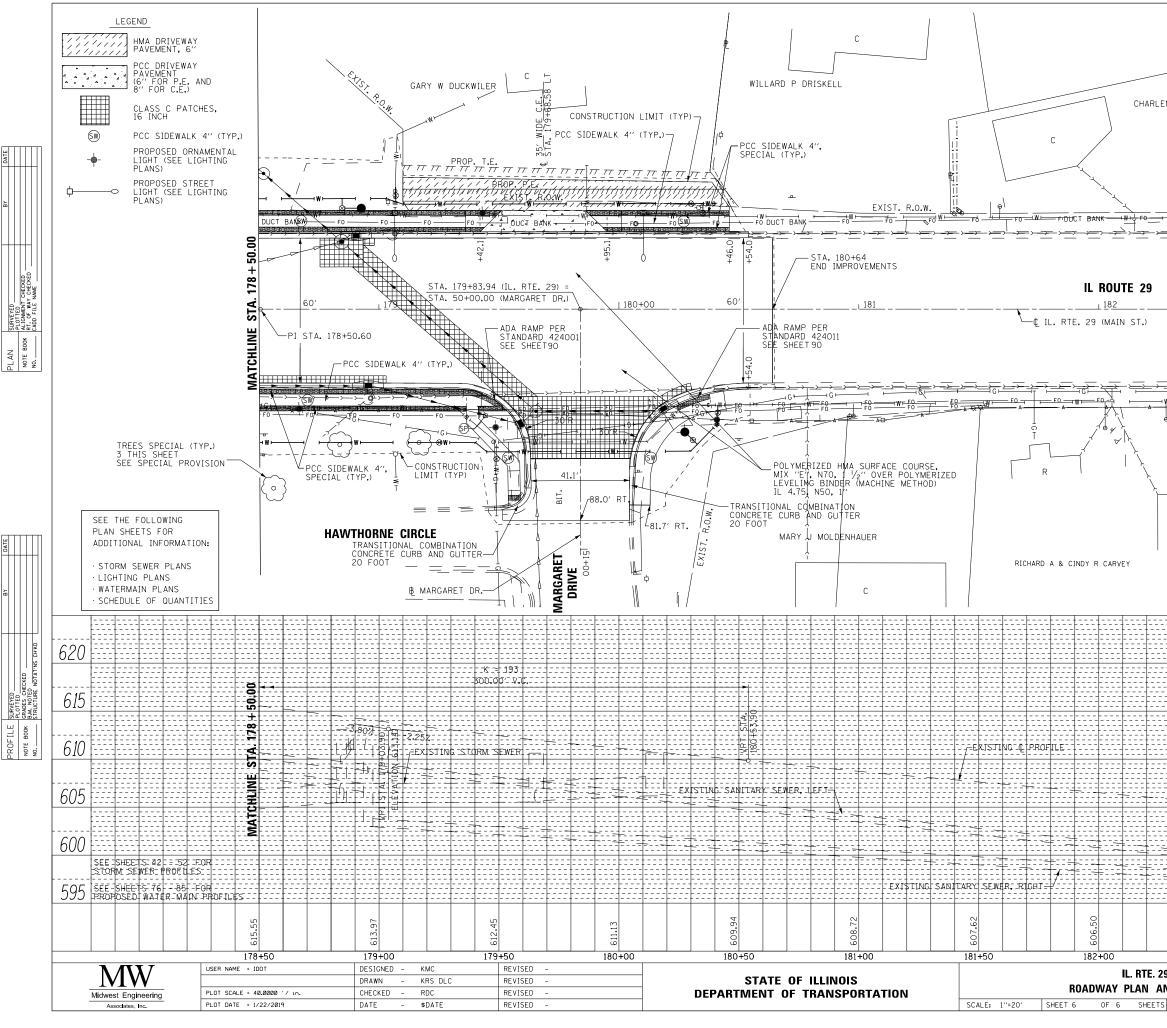

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29 AND P ts sta.	ROFILE 178+50		TO S	TA. 18	0+54		A.P. TE. 69	13-	SECT -00045			taz CO	UNTY EWELL NTRAC DJECT 05		34

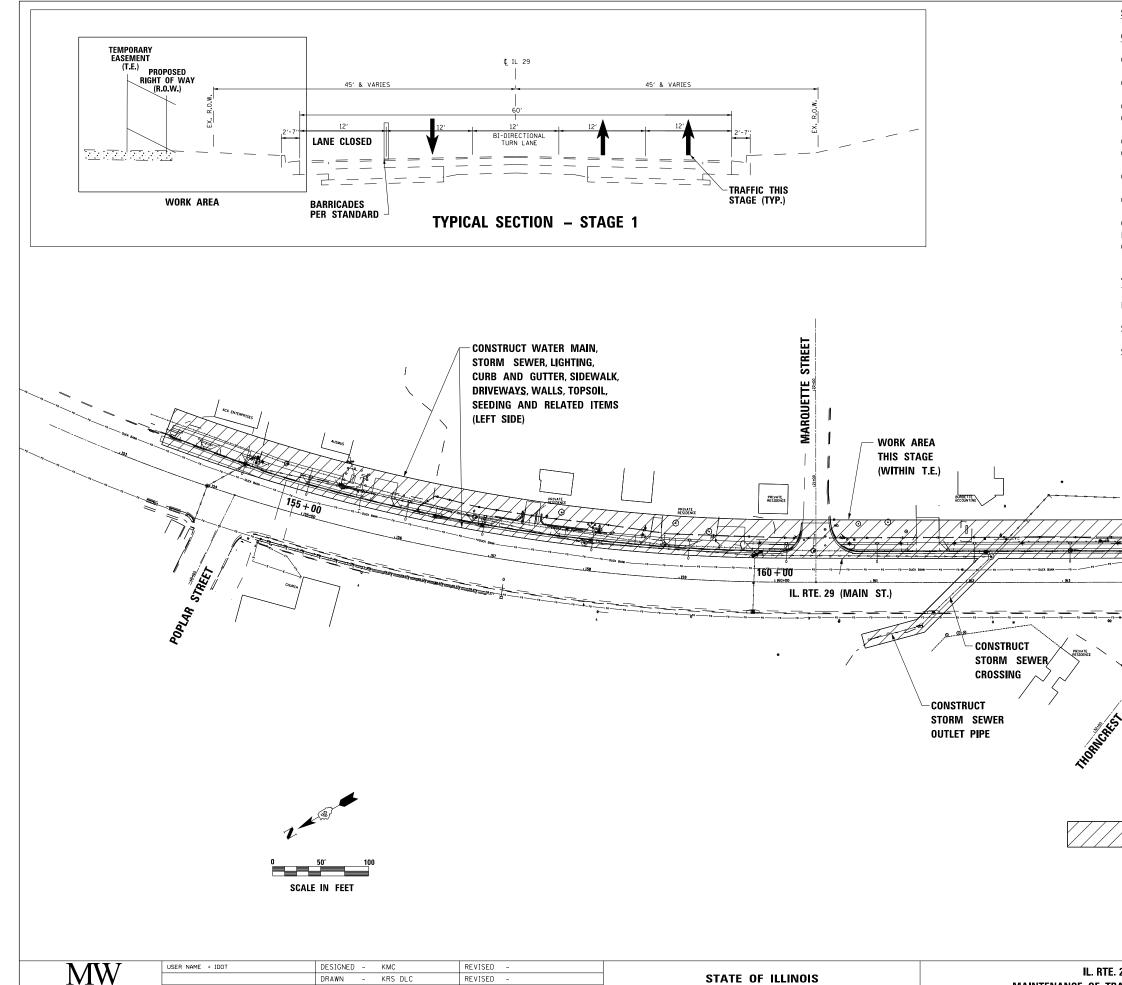

Midwes

										1
MW	USER NAME = IDOT	DESIGNED - KMC	REVISED -			II RTE 29	F.A.P.	SECTION	COUNTY TOTAL SHEET	1
		DRAWN - KRS DLC	REVISED -	STATE OF ILLINOIS			669	16-00045-01-SW	TAZEWELL 155 35	ĺ –
west Engineering	PLOT SCALE = 100.000 ' / In.	CHECKED - RDC	REVISED -	DEPARTMENT OF TRANSPORTATION		MAINTENANCE OF TRAFFIC - STAGE I			CONTRACT NO. 89713	1
Associates, Inc.	PLOT DATE = 1/22/2019	DATE – \$DATE	REVISED -		SCALE:	IL. RTE. 29 MAINTENANCE OF TRAFFIC – STAGE 1 669 16-00045-01-SW TAZEWELL 155	AID PROJECT 05E2(122)	j.		

STAGE 1

CONSTRUCTION

CONSTRUCT WATER MAIN ON LEFT SIDE (EASTERLY) OF IL ROUTE 29.

CONSTRUCT STORM SEWER ON LEFT SIDE (EASTERLY) OF IL ROUTE 29.

CONSTRUCT STORM SEWER CROSSING OF ROUTE 29 AT STATION 162+00 AND OUTLET PIPE TO STATION 161+00, 60 FEET RIGHT.

CONSTRUCT STORM SEWER CROSSING OF ROUTE 29 AT STATION 167+90 AND OUTLET PIPE TO STATION 167+00, 89 FEET RIGHT.


CONSTRUCT STORM SEWER CROSSING OF ROUTE 29 AT STATION 178+30.

CONSTRUCT LIGHTING ON LEFT SIDE (EASTERLY) OF IL ROUTE 29.

CONSTRUCT WATER MAIN, STORM SEWER, LIGHTING, CURB AND GUTTER, SIDEWALK, DRIVEWAYS, WALLS, TOPSOIL, SEEDING AND RELATED ITEMS ON LEFT SIDE (EASTERLY) OF IL ROUTE 29.


TRAFFIC

NORTHBOUND RIGHT LANE CLOSED AS NEEDED SOUTHBOUND LANES OPEN STANDARDS: 701502 AND 701602 - CONSTRUCT WATER MAIN, STORM SEWER, LIGHTING, CURB AND GUTTER, SIDEWALK, DRIVEWAYS, WALLS, TOPSOIL, SEEDING AND RELATED ITEMS (LEFT SIDE) 165 + 00 IATCH \square **INDICATES WORK AREA** THIS STAGE

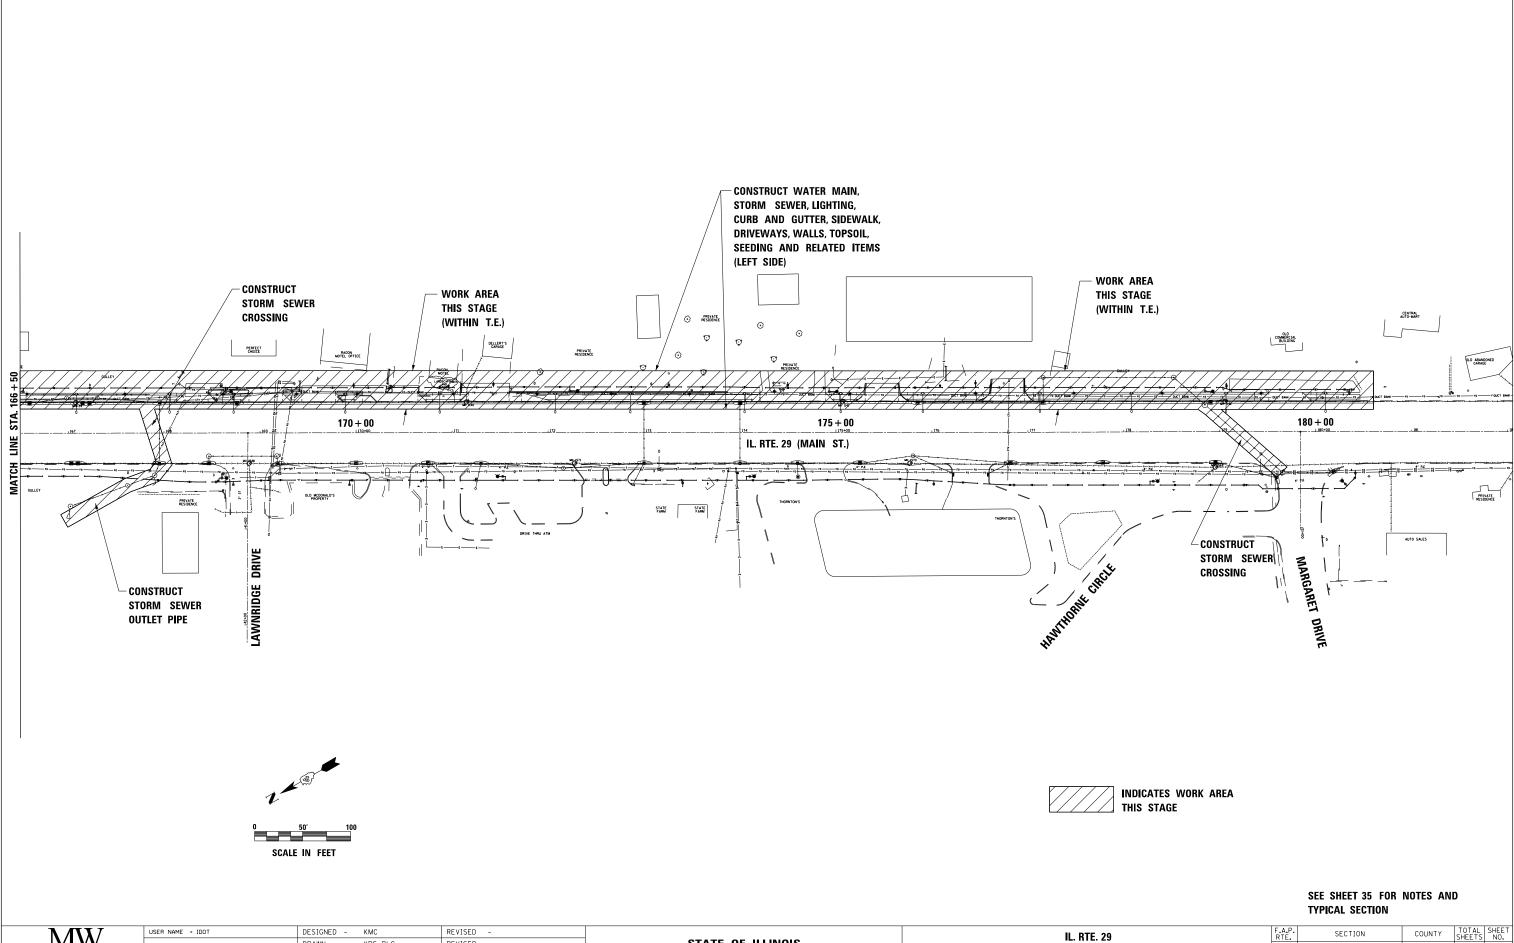

N	ЛW	USER NAME = IDOT	ME = IDOT DESIGNED - KMC REVISED - DRAWN - KRS DLC REVISED - STATE OF ILLINOIS ALE = 100.000 // In. CHECKED - RDC REVISED -	IL. RTE. 29 MAINTENANCE OF TRAI							
Midwe	est Engineering	PLOT SCALE = 100.000 ' / in.	CHECKED -	RDC	REVISED -	DEPARTMENT OF TRANSPORTATION		MAINTEN	ANUE U	DF TRAF	T I
A	ssoclates, Inc.	PLOT DATE = 1/22/2019	DATE -	\$DATE	REVISED -		SCALE:	SHEET 2	0F 2	SHEETS	5

29		F.A.P. RTE.	SECTION		COUNTY	TOTAL SHEETS	SHEET NO.	
AFFIC – STAGE 1			669	16-00045-01-SW		TAZEWELL	155	36
						CONTRAC	T NO. 8	39713
TS	STA.166+50	TO STA.180+54	ILLINOIS FED. AID PROJECT 05E2(122)					

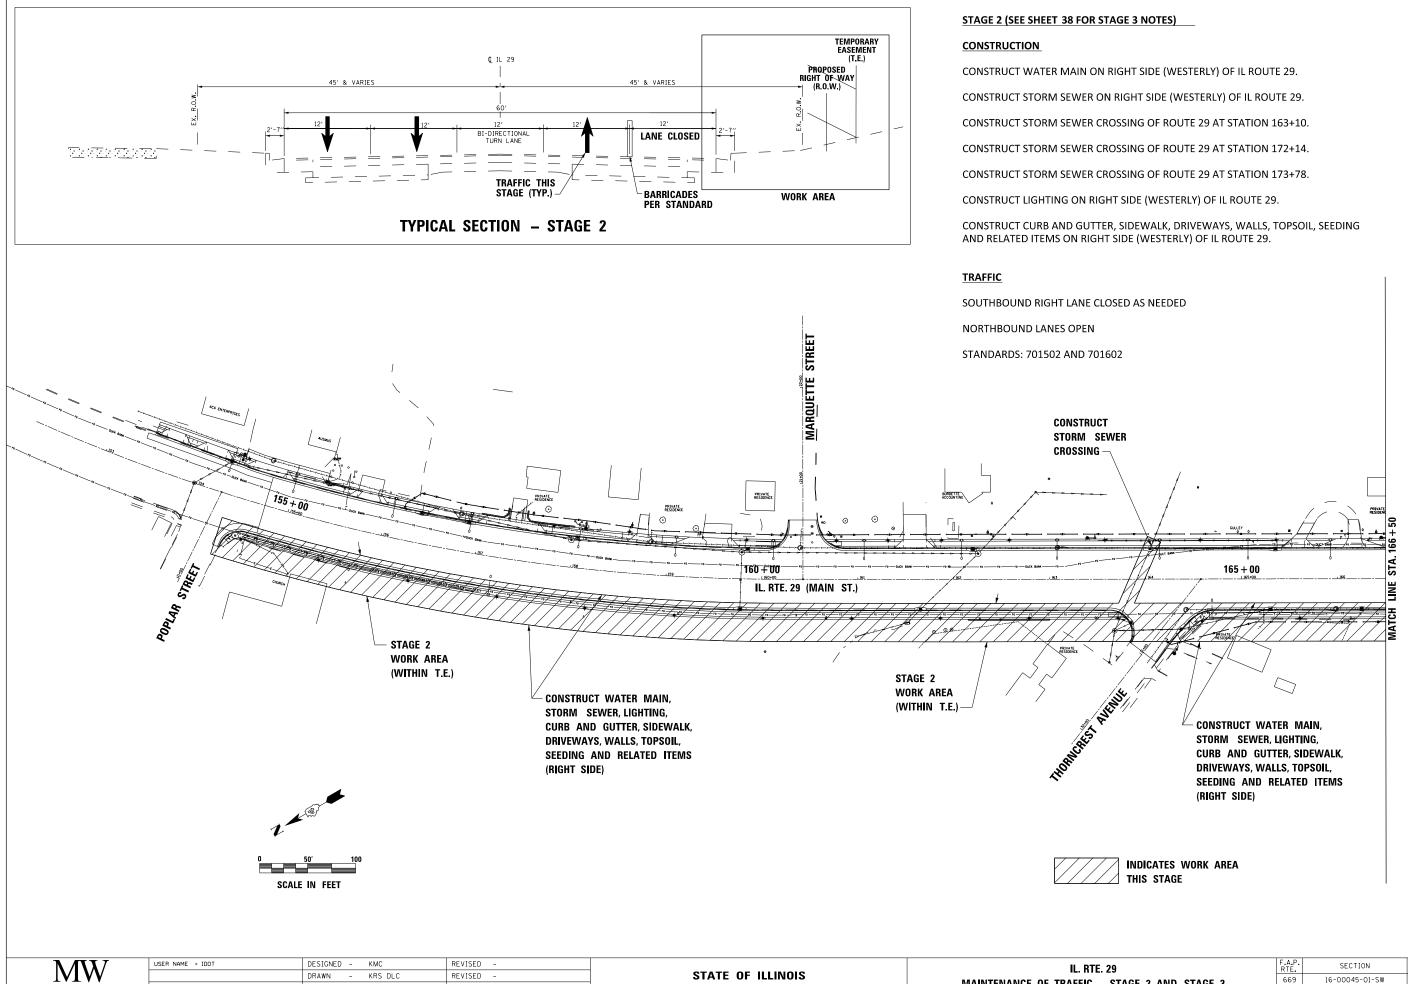

ЛW	USER NAME = IDOT	DESIGNED - KMC	REVISED -					IL. RTE.	. 29		F.A.P. RTE,	SECTION	COUNTY	TOTAL SHEET SHEETS NO.
VIVV		DRAWN - KRS DLC	REVISED -	STATE OF ILLINOIS		MAINTENANCE			- STAGE 2 AN	D STACE 2	669	16-00045-01-SW	TAZEWELL	155 37
est Engineering	PLOT SCALE = 100.000 ' / in.	CHECKED - RDC	REVISED -	DEPARTMENT OF TRANSPORTATION		WAINTENANGE	UF INA	AFFIC -	- STAGE Z AN	ID STAGE 3			CONTRAC	T NO. 89713
Associates, Inc.	PLOT DATE = 1/22/2019	DATE – \$DATE	REVISED -		SCALE:	SHEET 1	0F 2	SHEE	ETS STA. 153+35	TO STA.166+50		ILLINOIS F	ED. AID PROJECT OF	jE2(122)

Midwest


STAGE 3 (NOTES ONLY)

CONSTRUCTION

COMPLETE PAVEMENT MARKING FOR ALL FIVE LANES OF IL ROUTE 29.

TRAFFIC


INTERMITTENT LANE CLOSURES. KEEP AT LEAST ONE LANE OPEN IN EACH DIRECTION AT ALL TIMES.

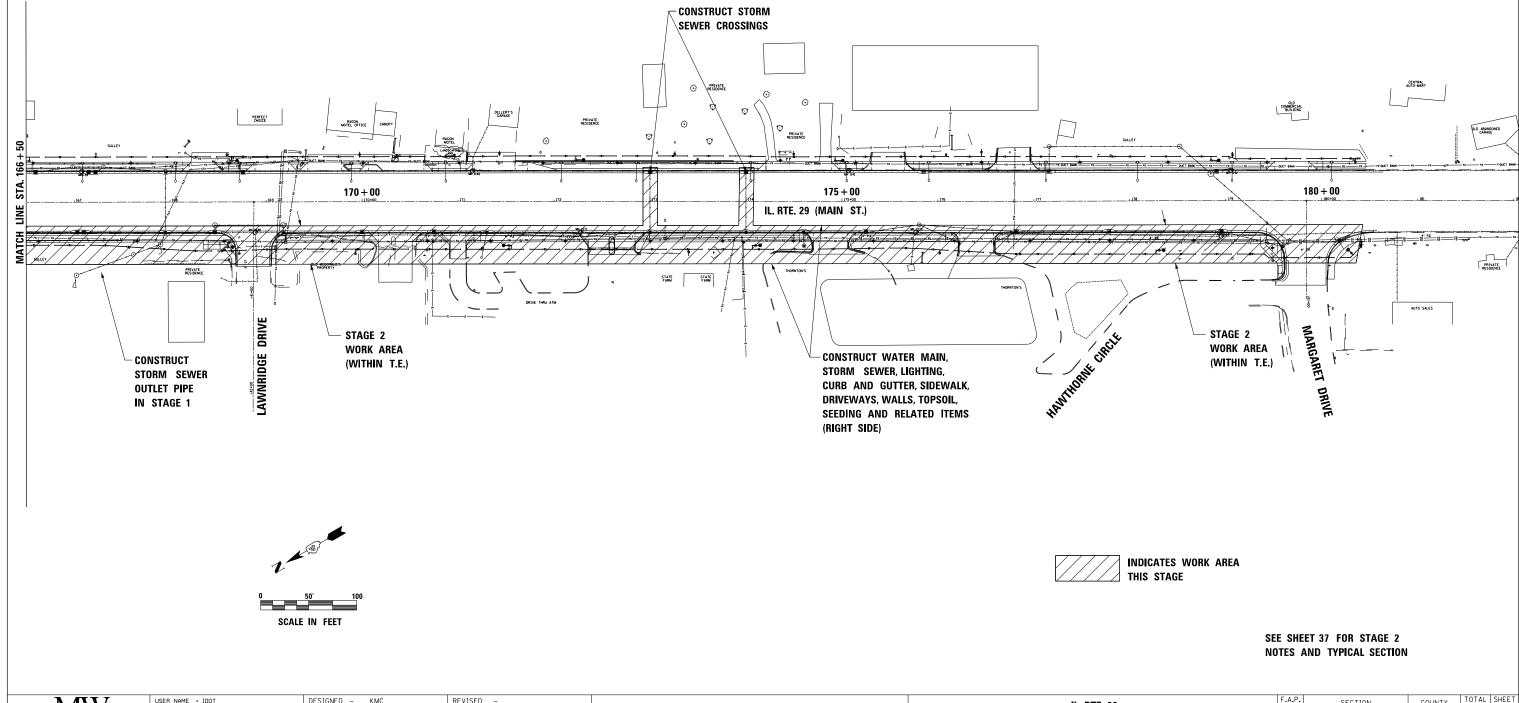


MM	USER NAME = IDOT	DESIGNED - KMC	REVISED -			IL. RTE. 29	F.A.P. RTE,	SECTION	COUNTY TOTAL SHEET SHEETS NO.
IVI VV		DRAWN - KRS DLC	REVISED -	STATE OF ILLINOIS			669	16-00045-01-SW	TAZEWELL 155 38
Midwest Engineering	PLOT SCALE = 100.000 '/ in.	CHECKED - RDC	REVISED -	DEPARTMENT OF TRANSPORTATION		MAINTENANCE OF TRAFFIC – STAGE 2 AND STAGE 3			CONTRACT NO. 89713
Associates, Inc.	PLOT DATE = 1/22/2019	DATE – \$DATE	REVISED -		SCALE:	SHEET 2 OF 2 SHEETS STA. 166+50 TO STA. 18	0+54	ILLINOIS FE	D. AID PROJECT 05E2(122)

PERFORM MILLING OPERATION AND CONSTRUCT HMA SURFACE FOR ALL FIVE LANES OF IL ROUTE 29.


STANDARDS: 701502 AND 701602

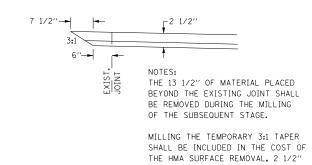



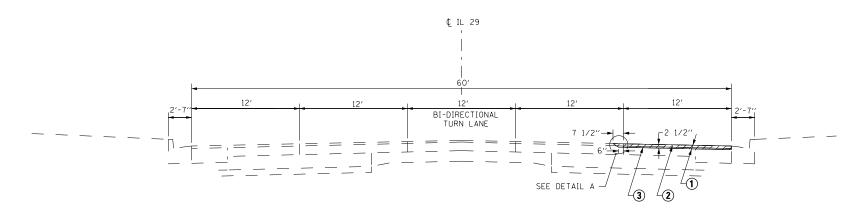


<u>STAGE 4</u> STA. 154 + 75 TO STA. 180 + 54

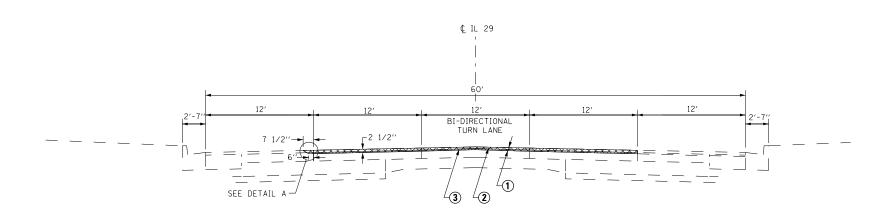

PROPOSED LEGEND:

- HOT-MIX ASPHALT SURFACE REMOVAL, 2 1/2" 1
- POLYMERIZED HOT-MIX ASPHALT SURFACE 2 COURSE, MIX "E", N70 (1 1/2")
- 3 POLYMERIZED LEVELING BINDER (MACHINE METHOD), IL4.75, N50 (1")

STAGE 5 STA. 154 + 75 TO STA. 180 + 54

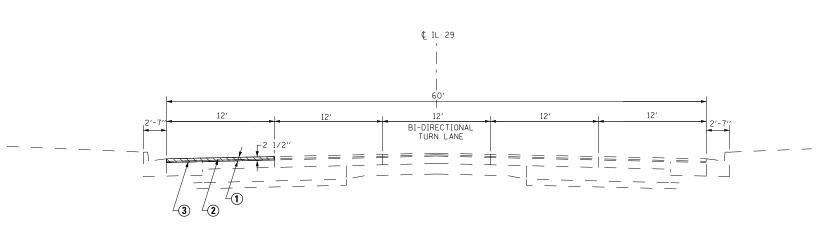


<u>STAGE 6</u> STA. 154 + 75 TO STA. 180 + 54

NOTES:
1.) NO TRAFFIC (EXCEPT TRAFFIC CROSSING
OVER TO AND FROM ENTRANCES AND RAMPS
SHALL BE ALLOWED ON THE MILLED SURFACE
OR ON THE PRIMED LEVELING BINDER.

2.) EACH STAGE SHALL BE COMPLETE TO SURFACE COURSE PROPOSED GRADE PRIOR TO PRCEEDING WITH THE NEXT STAGE.


MW	USER NAME = IDOTCAD	DESIGNED - KMC	REVISED -		IL. RTE. 29	F.A.P. SECTION	COUNTY TOTAL SHEET
		DRAWN - KRS DLC	REVISED -	STATE OF ILLINOIS	PROPOSED STAGING DETAILS FOR PAVING STAGES 4, 5 AND 6	669 16-00045-01-SV	W TAZEWELL 155 39
Midwest Engineering	PLOT SCALE = 100.000 '/ in.	CHECKED - RDC	REVISED -	DEPARTMENT OF TRANSPORTATION	PRUPUSED STAGING DETAILS FUR PAVING STAGES 4, 5 AND 0		CONTRACT NO. 89713
Associates, Inc.	PLOT DATE = 1/22/2019	DATE – \$DATE	REVISED -		SCALE: SHEET 1 OF 3 SHEETS STA. 153+35 TO STA. 180+54	ILL INOIS	FED. AID PROJECT 05E2(122)



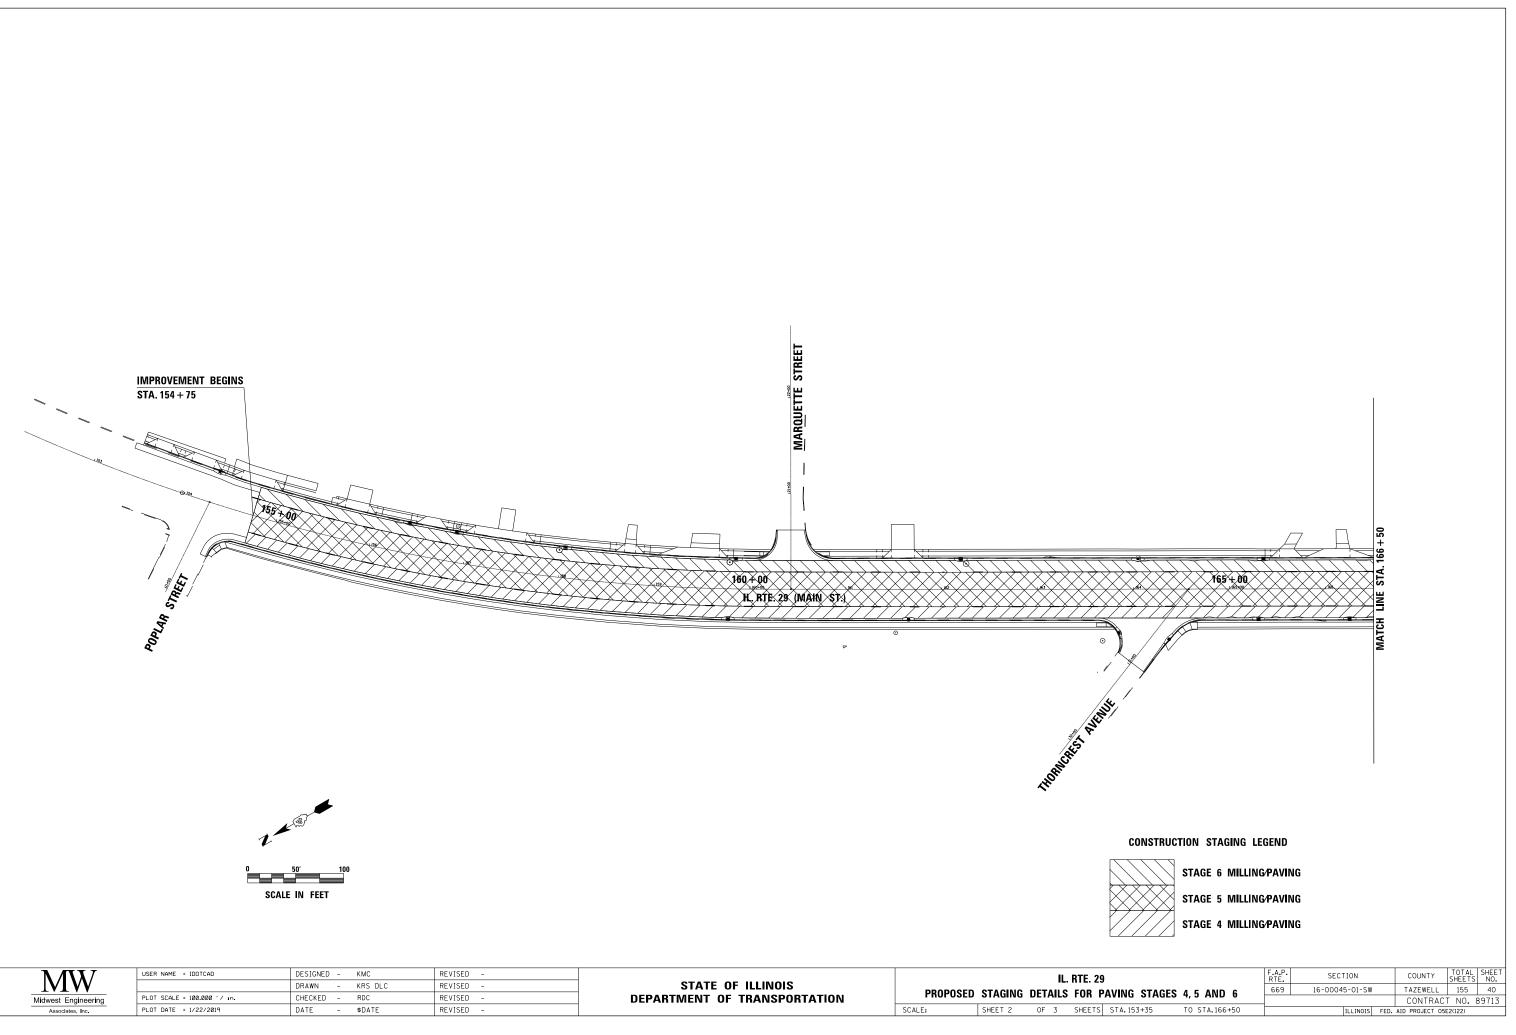



MW
Midwest Engineering
Associates Inc


USER NAME = IDOTCAD	DESIGNED -	КМС	REVISED -				п	. RTE. 29
	DRAWN -	KRS DLC	REVISED -	STATE OF ILLINOIS	DRODOOFD		_	
PLOT SCALE = 100.000 '/ in.	CHECKED -	RDC	REVISED -	DEPARTMENT OF TRANSPORTATION	PROPOSED	STAGING	DETAILS	FOR F
PLOT DATE = 1/22/2019	DATE -	\$DATE	REVISED -		SCALE:	SHEET 2	0F 3	SHEETS

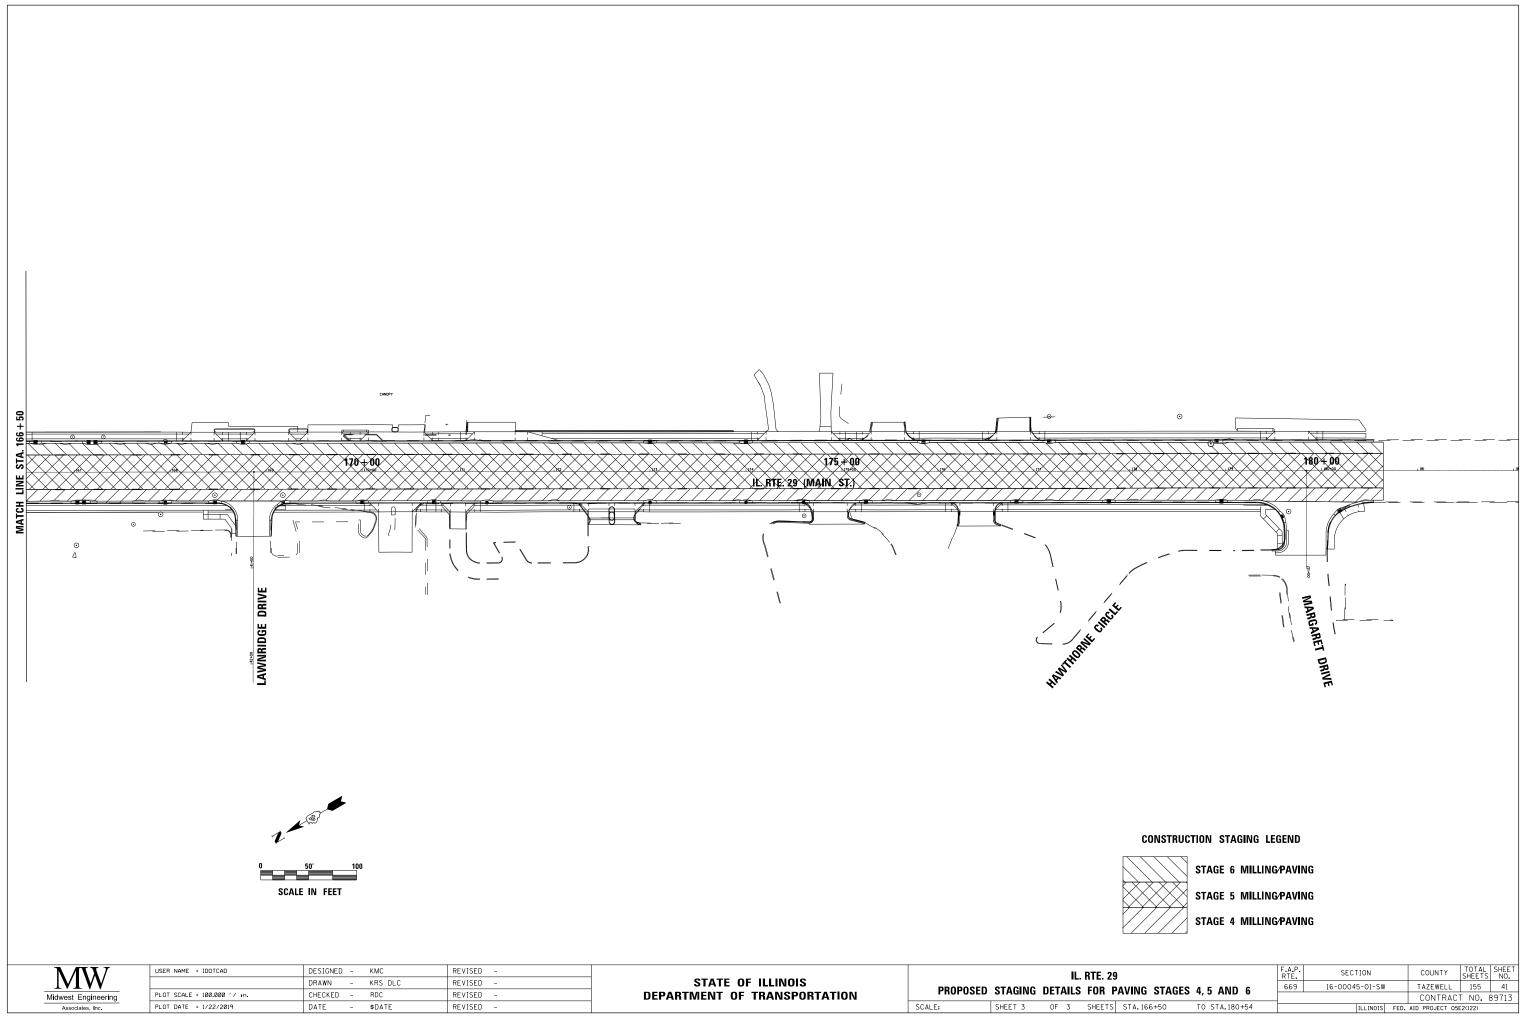


MW	USER NAME = IDUICAD	DESIGNED -	KMC	REVISED -				
		DRAWN -	KRS DLC	REVISED -	STATE OF ILLINOIS	DDODOOFD	OTAOINO	DETAIL
lwest Engineering	PLOT SCALE = 100.000 ' / in.	CHECKED -	RDC	REVISED -	DEPARTMENT OF TRANSPORTATION	PROPOSED	STAGING	DETAILS
Associates, Inc.	PLOT DATE = 1/22/2019	DATE -	\$DATE	REVISED -		SCALE:	SHEET 3	OF 3

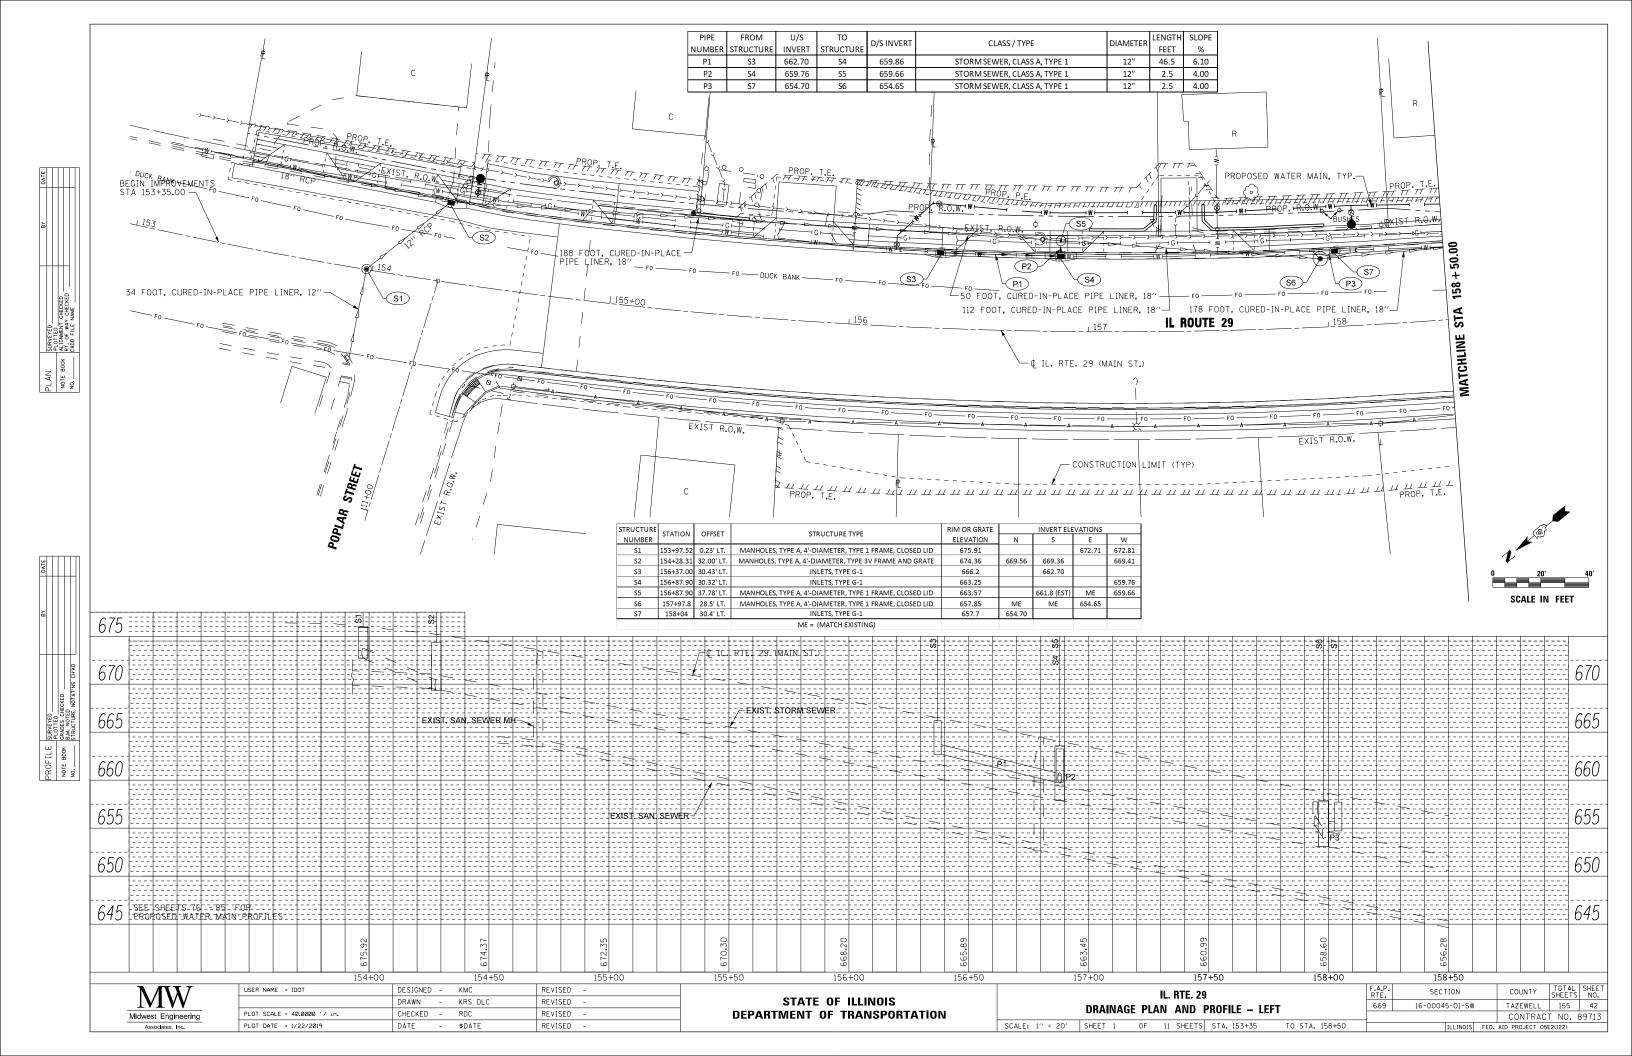


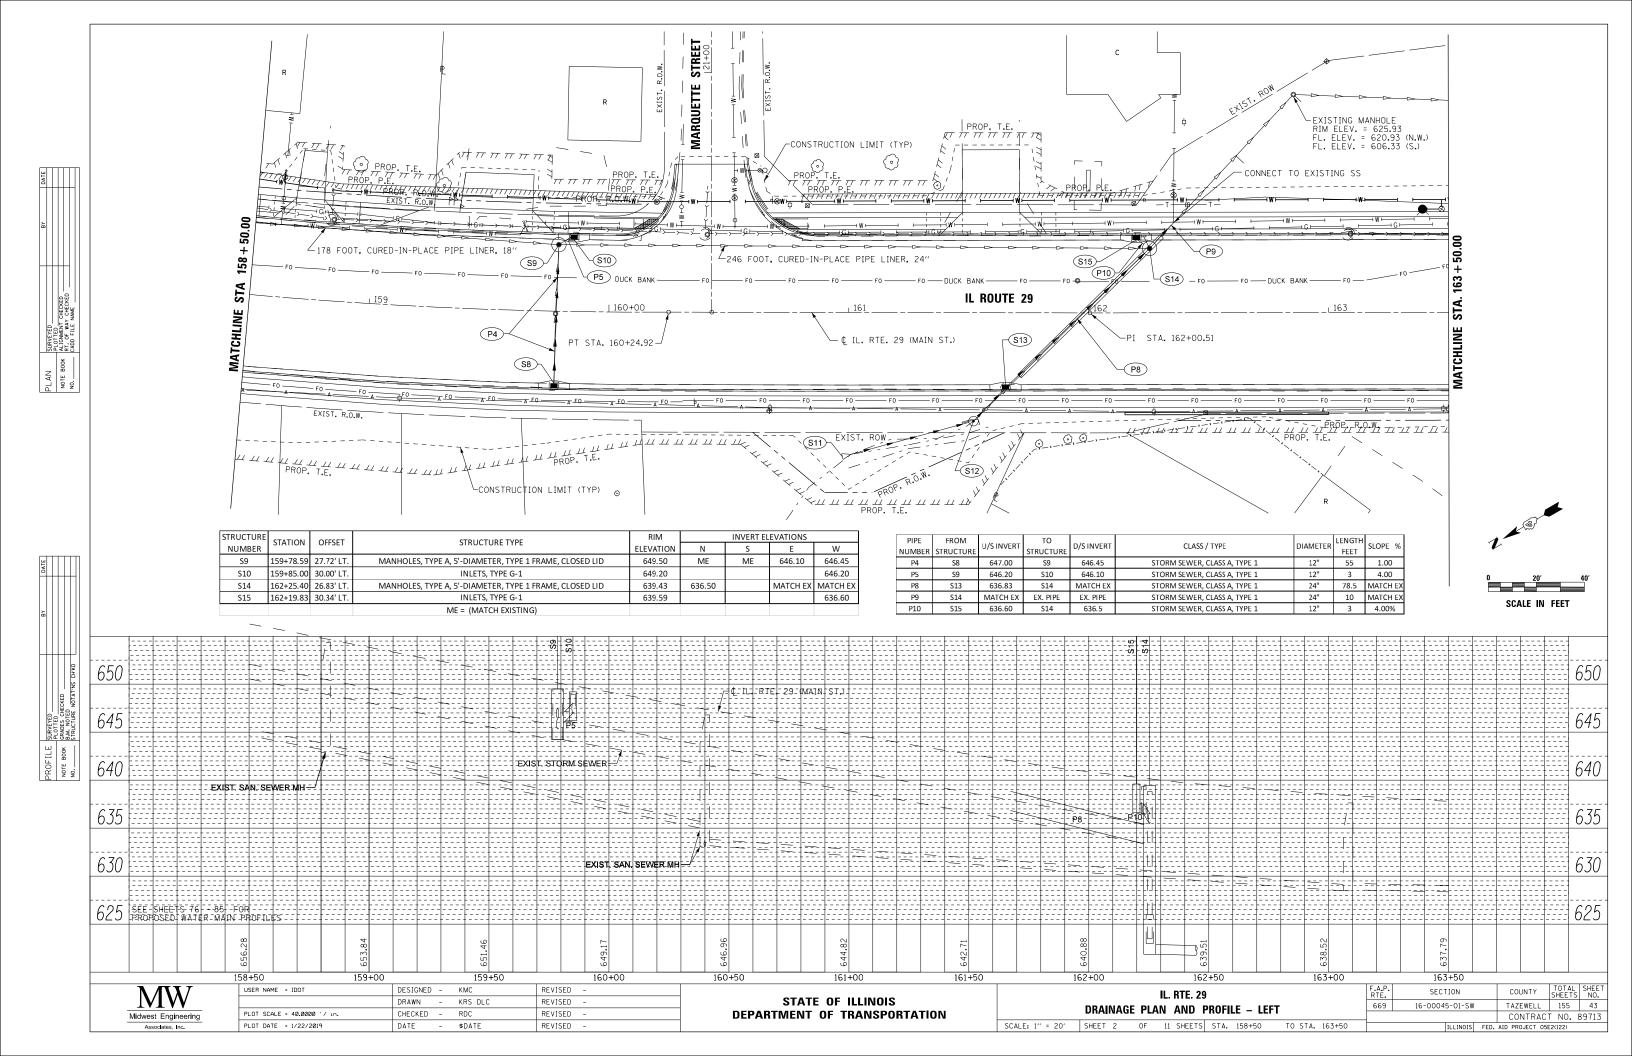


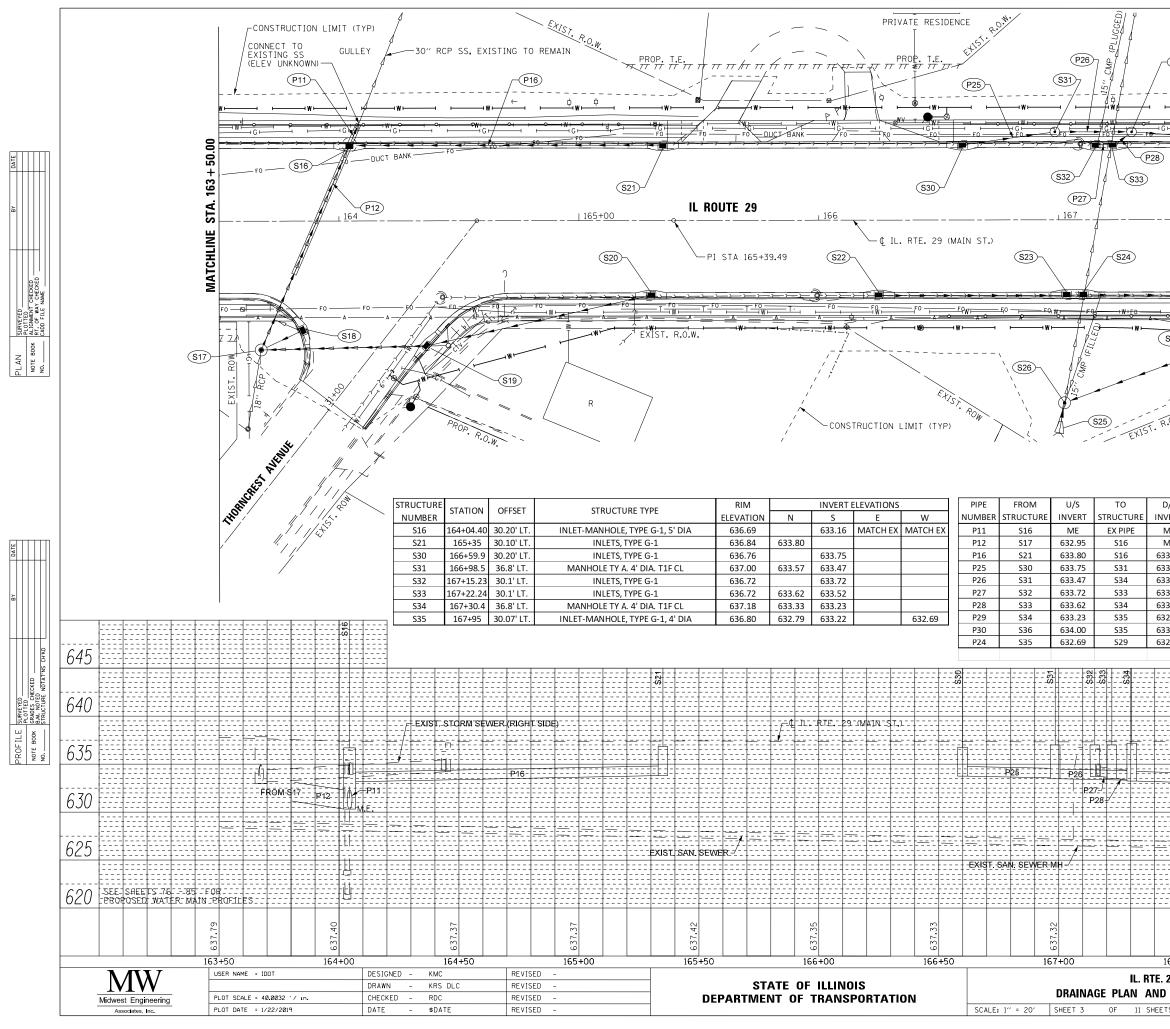



S34 G1 DUCI C1 DUC	SEE SH	(P29) (c _{f0}) (c _{f0})) (c _{f0}) (c _{f0})) (c _{f0}) (c _{f0})) (c _{f0}) (c _{f0})) (c _{f0})) (c _{f0}) (c _{f0})) (c _{f0}))			X/				MATCHLINE STA. 168 + 50.00	0	1 SCALE	20′		40'
D/S			CLA	ss / Typ	PF				DIAM	IETER	LENGT		.OPE	
		CTOP:									FEET	-	%	
ME ME				ER, CLAS ER, CLAS						D" 4"	6 88			
33.16				ER, CLAS						+ 2"	127.	5_0.	50%	
33.57		STORM	VI SEW	ER, CLAS	55 A, T	YPE 1				2"	35.5		50%	
33.33 33.62				ER, CLAS ER, CLAS						2" 2"	28 3		50% 00%	
33.62 33.33				ER, CLAS						2 2"	3 6.5	_	00% 46%	
32.79		STORM	VI SEW	ER, CLAS	65 A, T	YPE 1			1	2"	61	0.	72%	
33.22 32.40				ER, CLAS ER, CLAS						2" 2"	78 59.2		00% 50%	
22.70				ATCH EX						-	Z		5070	645
				22222										
														640
														-
														635
F	29	<u></u>	<u>+</u> A			- P 30-			FROM	1 \$36				
														670
														630
				1										
			E	<u> </u>										625
				=====										
														620
637.33			23 30					49						
637			227	ico				637.49						
167+5	0		16	8+00			1	168		1		1	1	
29						A.P. TE.		SECT				JNTY	TOT. SHEE	
)FILE –					569	16-	-00045	-01-SV	V	-	EWELL NTRA	155 CT NO	
TS ST	A. 163+5	50 TO	STA.	168+50]	LLINOIS	FED.	AID PRO			

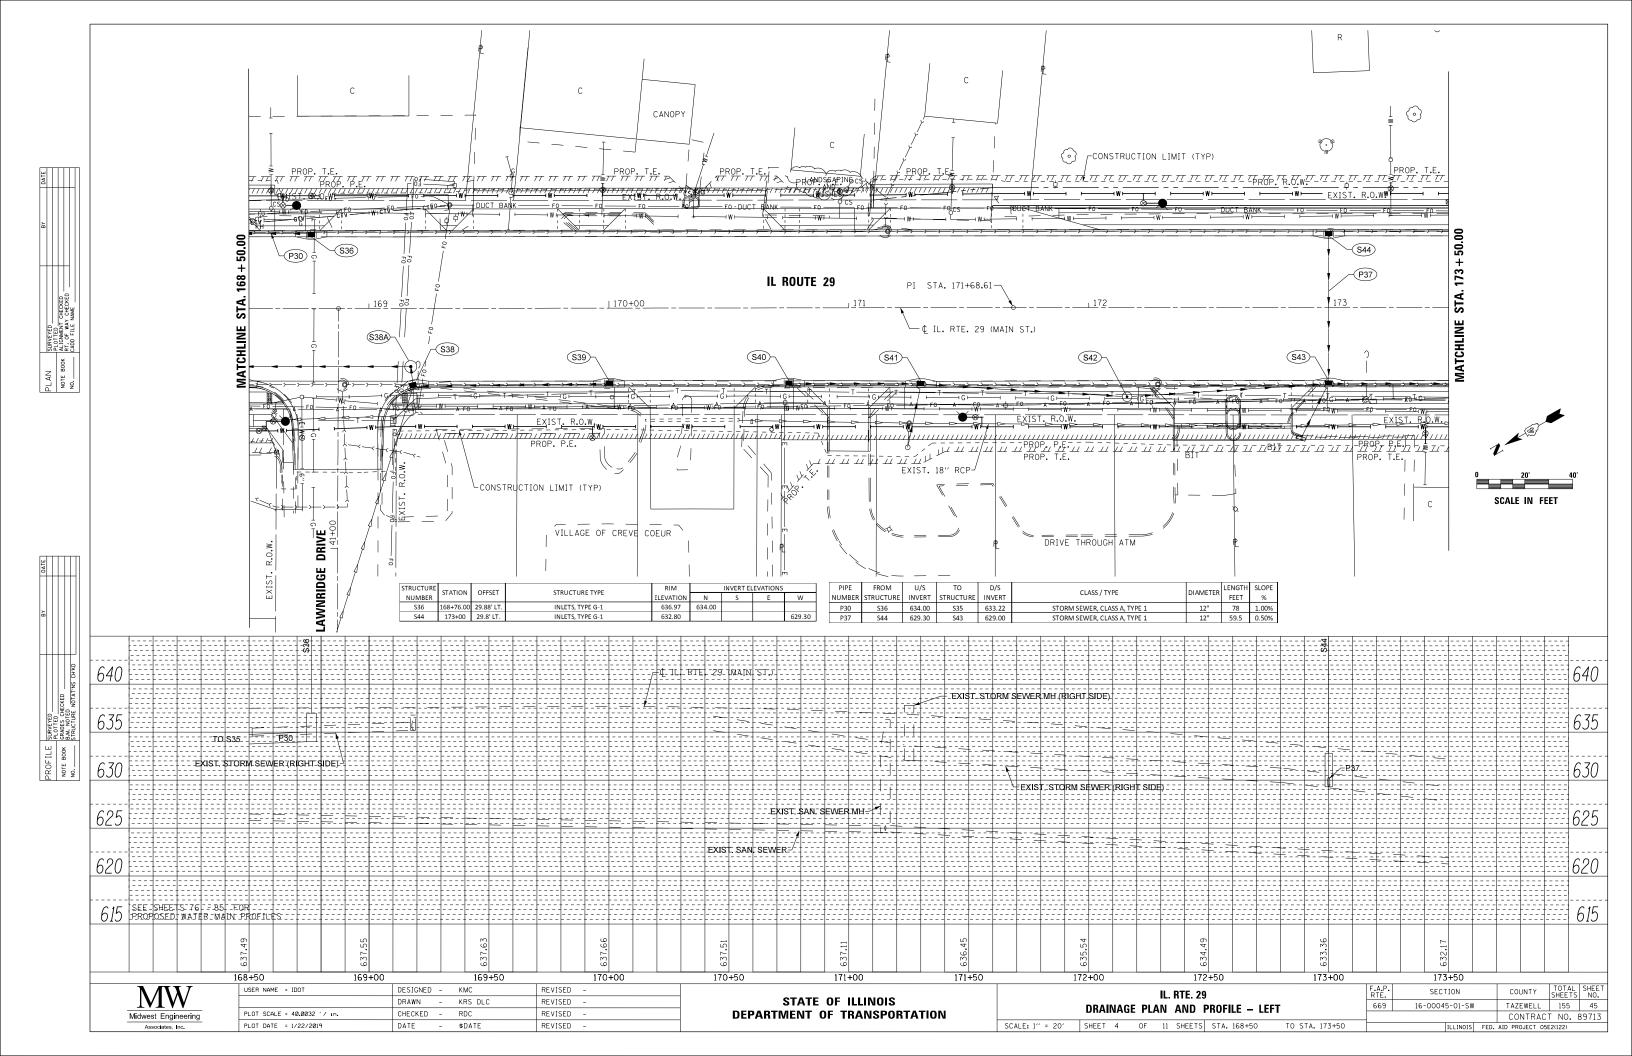

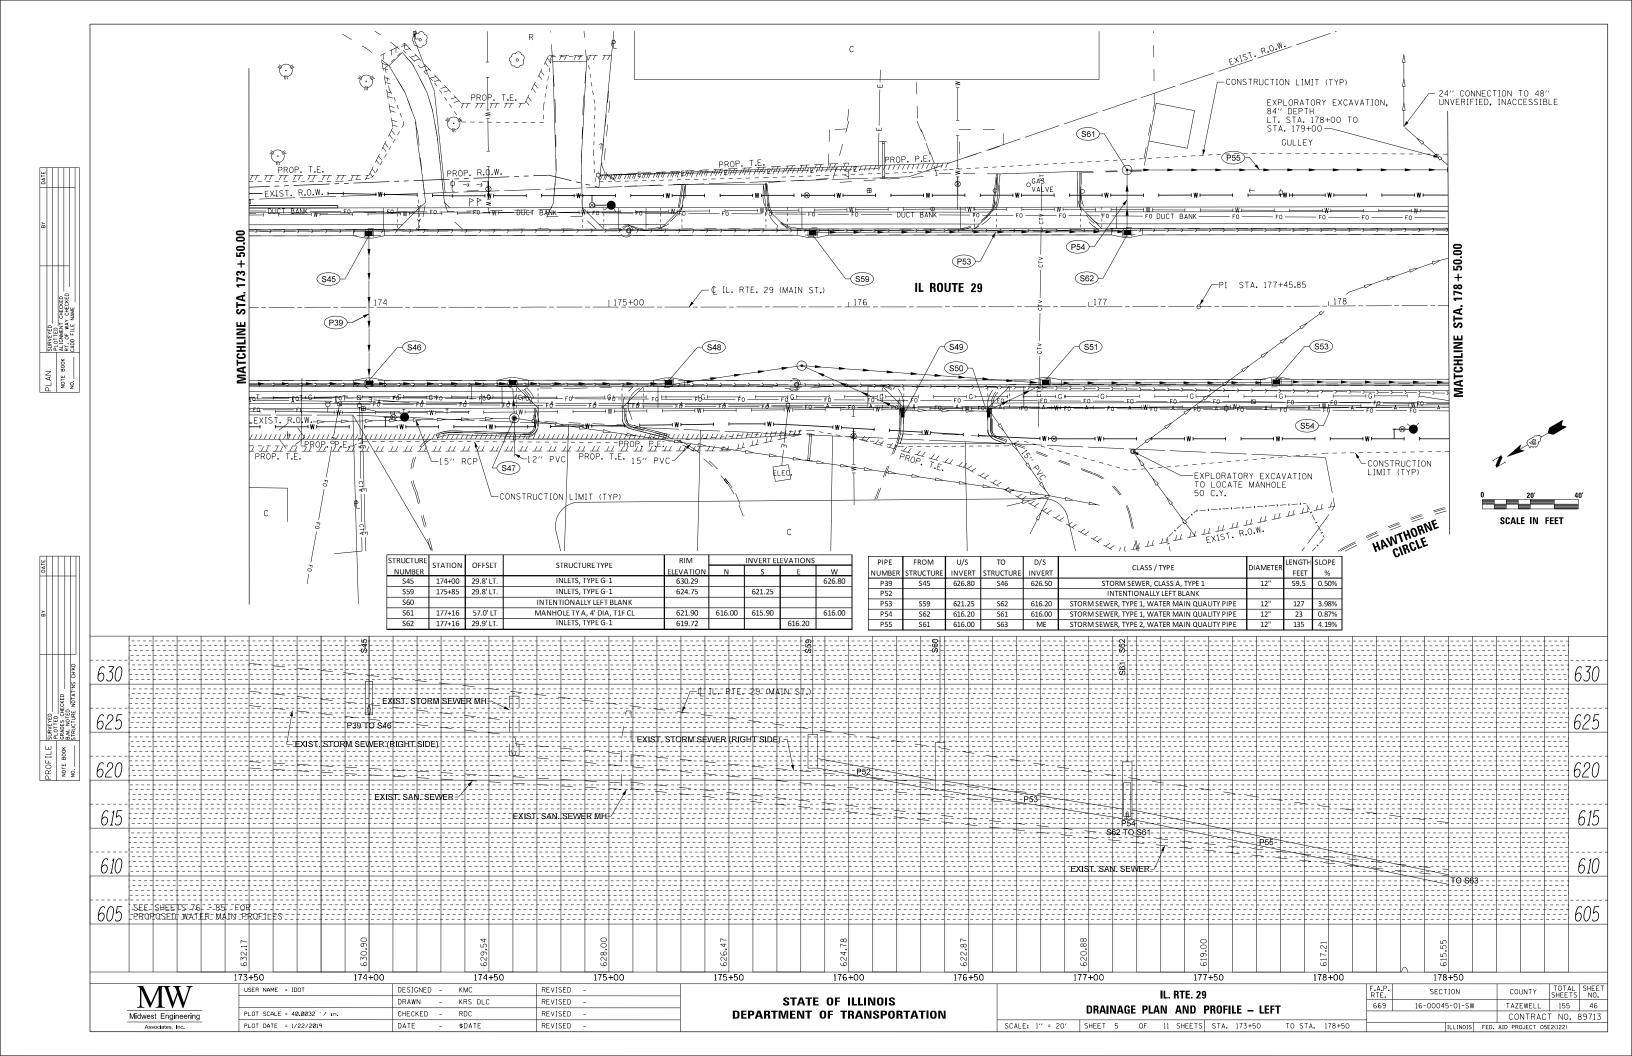


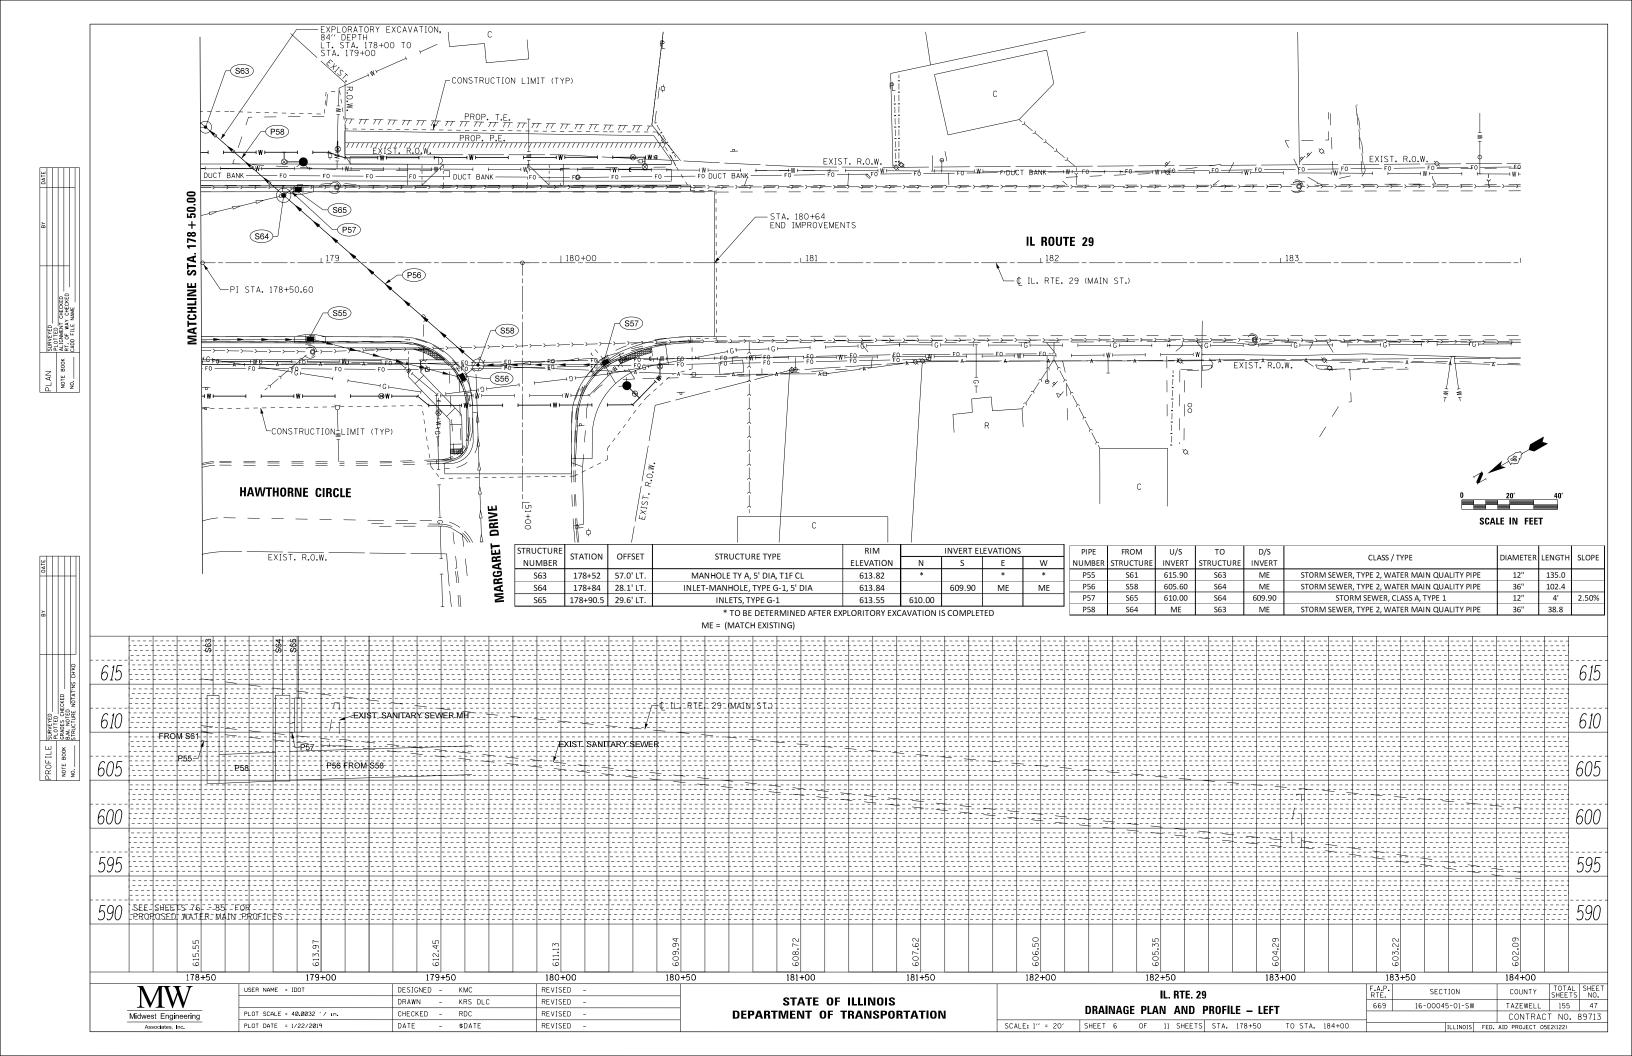

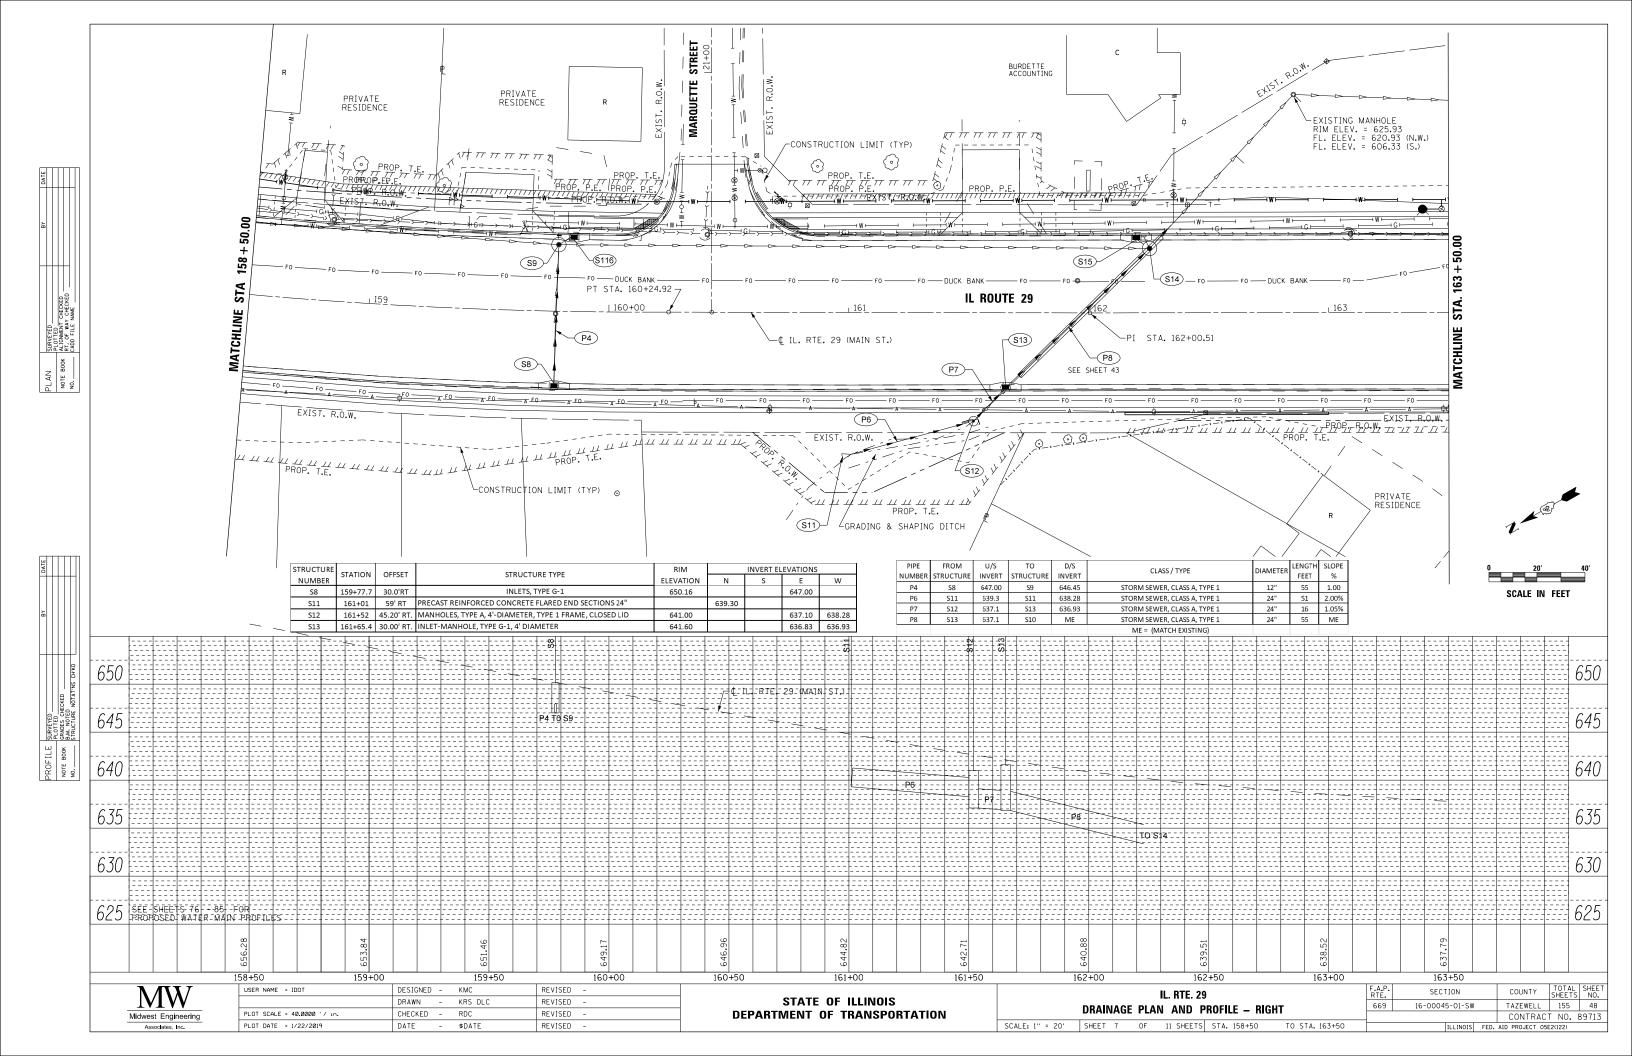


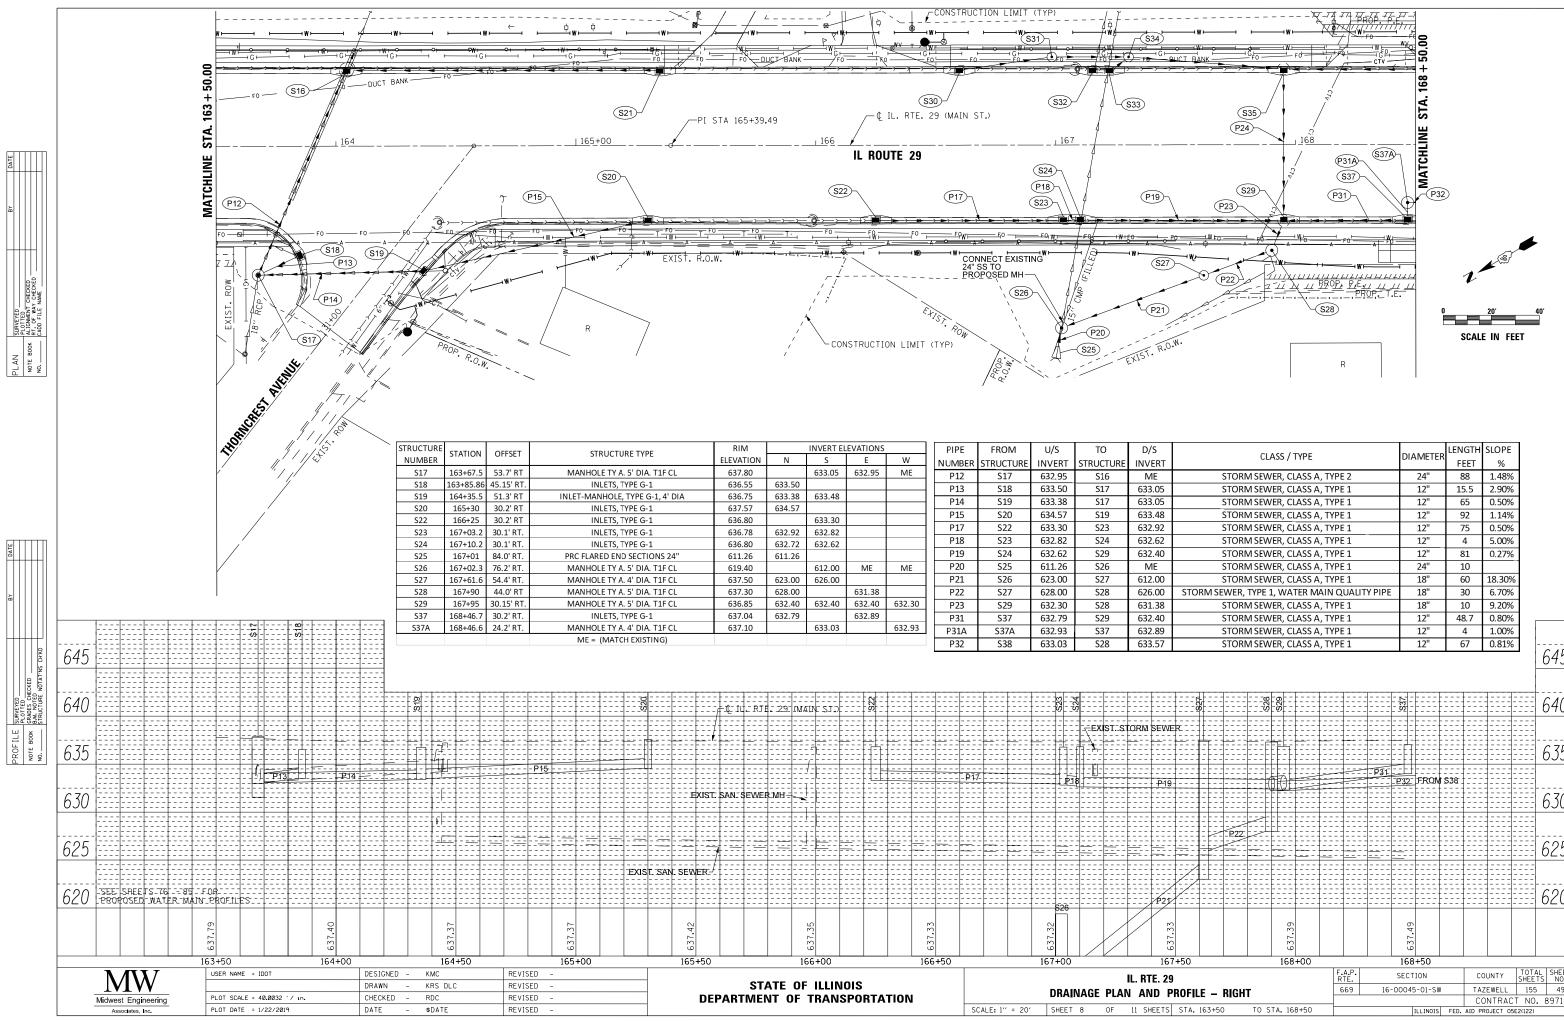


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					CL	AS:	s /	TYF	E								DIA	METE	R	IGTH					
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			STOR													+		24" 12"	_	88 .5.5		18% 90%	_		
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, }			STOR				·			·						+		12"	_	92		14%	_		
, ,			STOR					_		·						+		12"	_	92 75		14 <i>%</i> 50%	_		
-			STOR							·			_			+		12"	-	4		0%	_		
-)			STOR							·						+		12"	+	81		27%	_		
			STOR				· ·			·								24"	_	10	0.1	_,,,	-		
)			STOR				<i>.</i>									+		18"	_	60	18.	30%	6		
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,十			STOR				_				_					1		12"	4	8.7	0.8	30%	5		
,			STOR	M	SEV	VER	ι <i>,</i> Ο	LAS	S A	, ΤY	'PE	1						12"		4	1.0)0%	5		
1			STOR	M	SEW	VER	ι <i>,</i> C	LAS	S A	, TY	PΕ	1						12"		67	0.8	31%	, ,		
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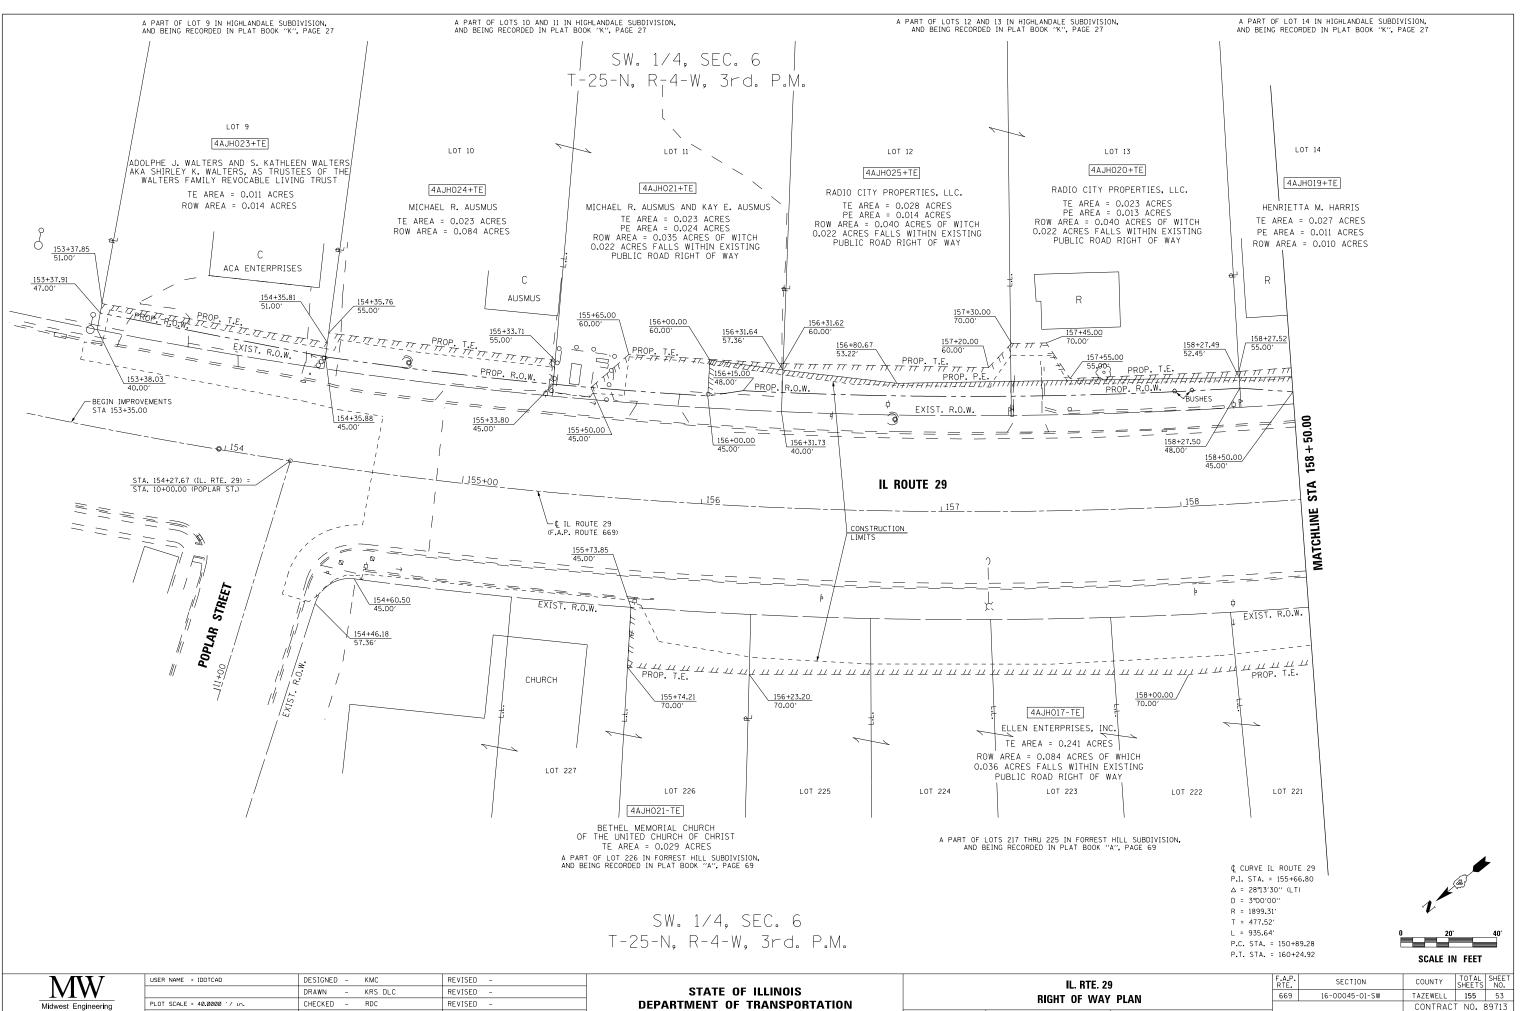

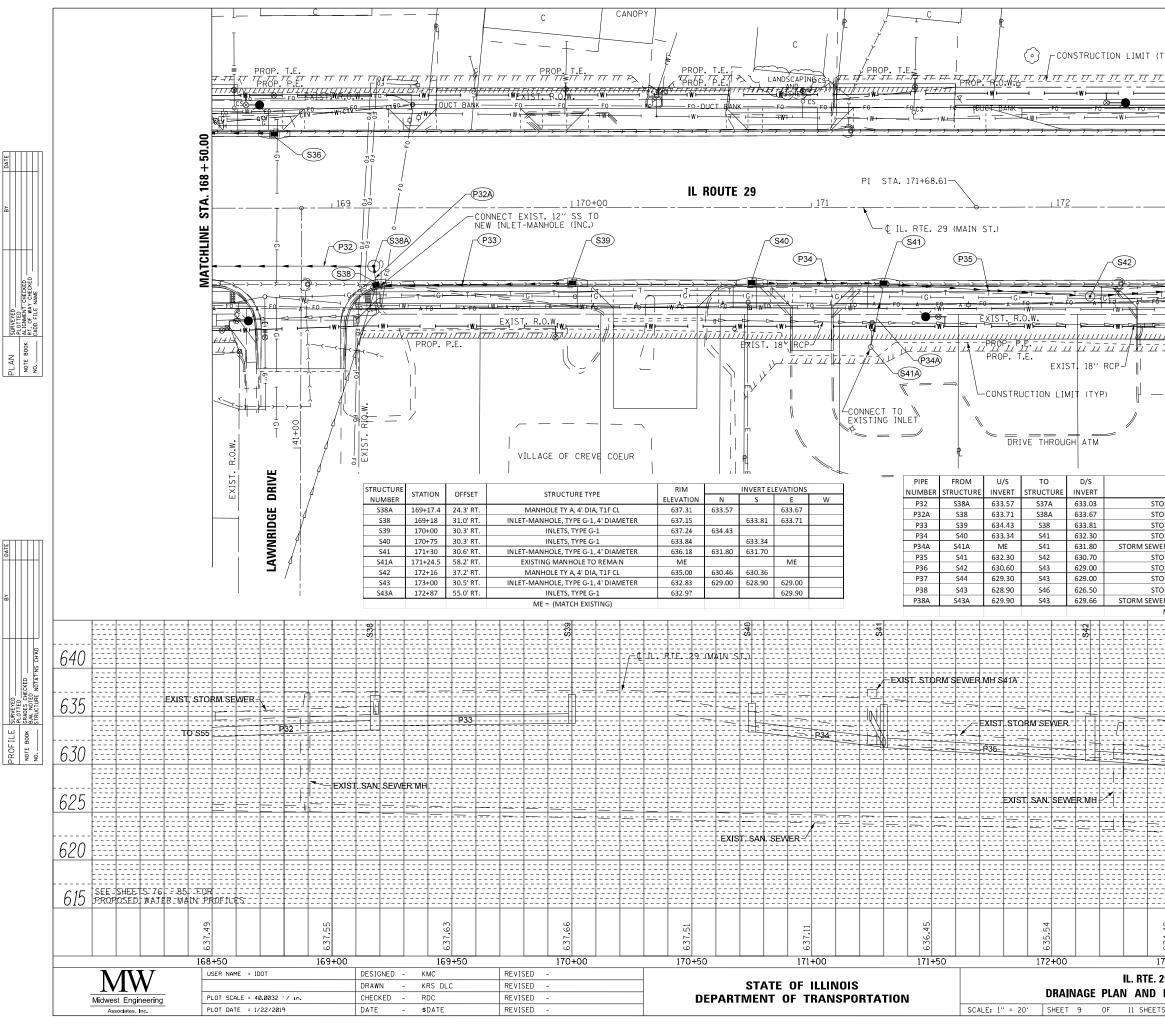
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CLASS / TYPE	DIAMETER	LENGTH	SLOPE					
ORM SEWER, CLASS A, TYPE 1	12" 12"	FEET 67 4	% 0.80% 1.00%					
ORM SEWER, CLASS A, TYPE 1 ORM SEWER, CLASS A, TYPE 1 ORM SEWER, CLASS A, TYPE 1	12" 12"	77.5	0.80%					
VER, TYPE 1, WATER MAIN QUALITY PIPE ORM SEWER, CLASS A, TYPE 1	12" 12"	24 82.5	TBD 1.94%					
FORM SEWER, CLASS A, TYPE 1 FORM SEWER, CLASS A, TYPE 1	12" 12"	80.7 59.5	1.99% 0.50%					
TORM SEWER, CLASS A, TYPE 1 /ER, TYPE 1, WATER MAIN QUALITY PIPE	12" 12"	97 23.7	2.47% 1.00%					
ME = (MATCH EXISTING)								
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634.49			632.17					615
172+50 173+	E.	A.P.	LI-22 22 173 SECT		со		TOT	
	F. R	A.P. TE. 669	173	ION	TAZ	EWELL	TOT, SHEE 155	AL SHEET TS NO.



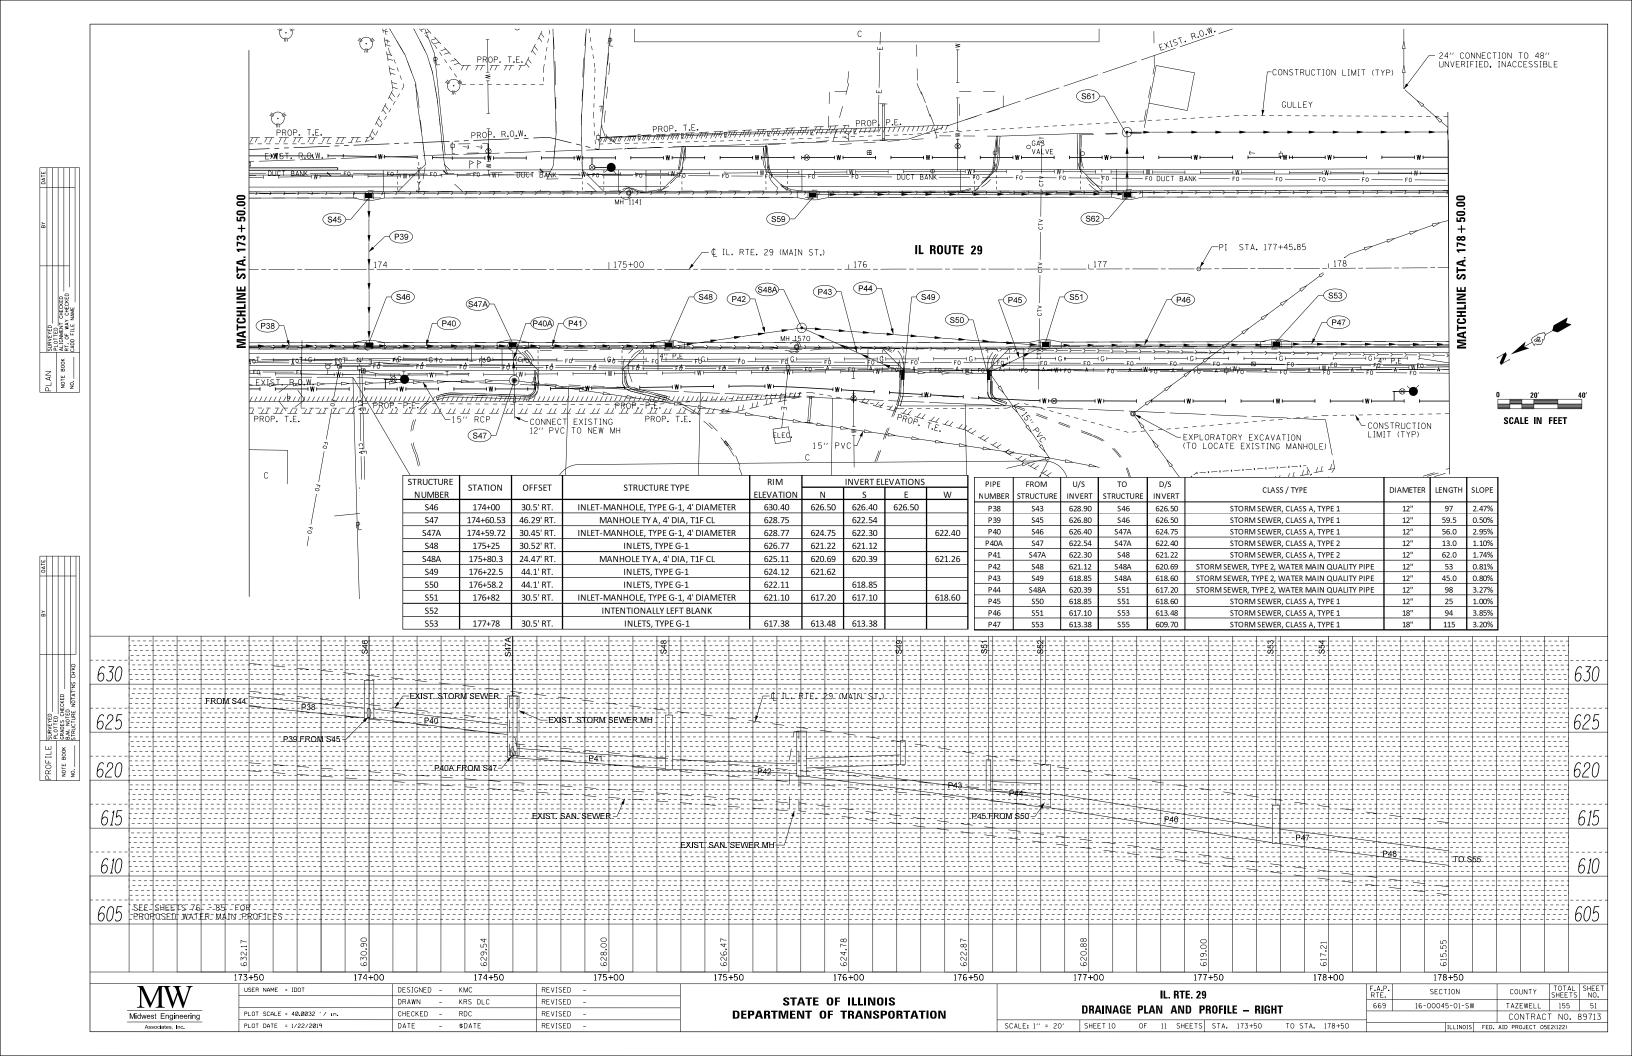
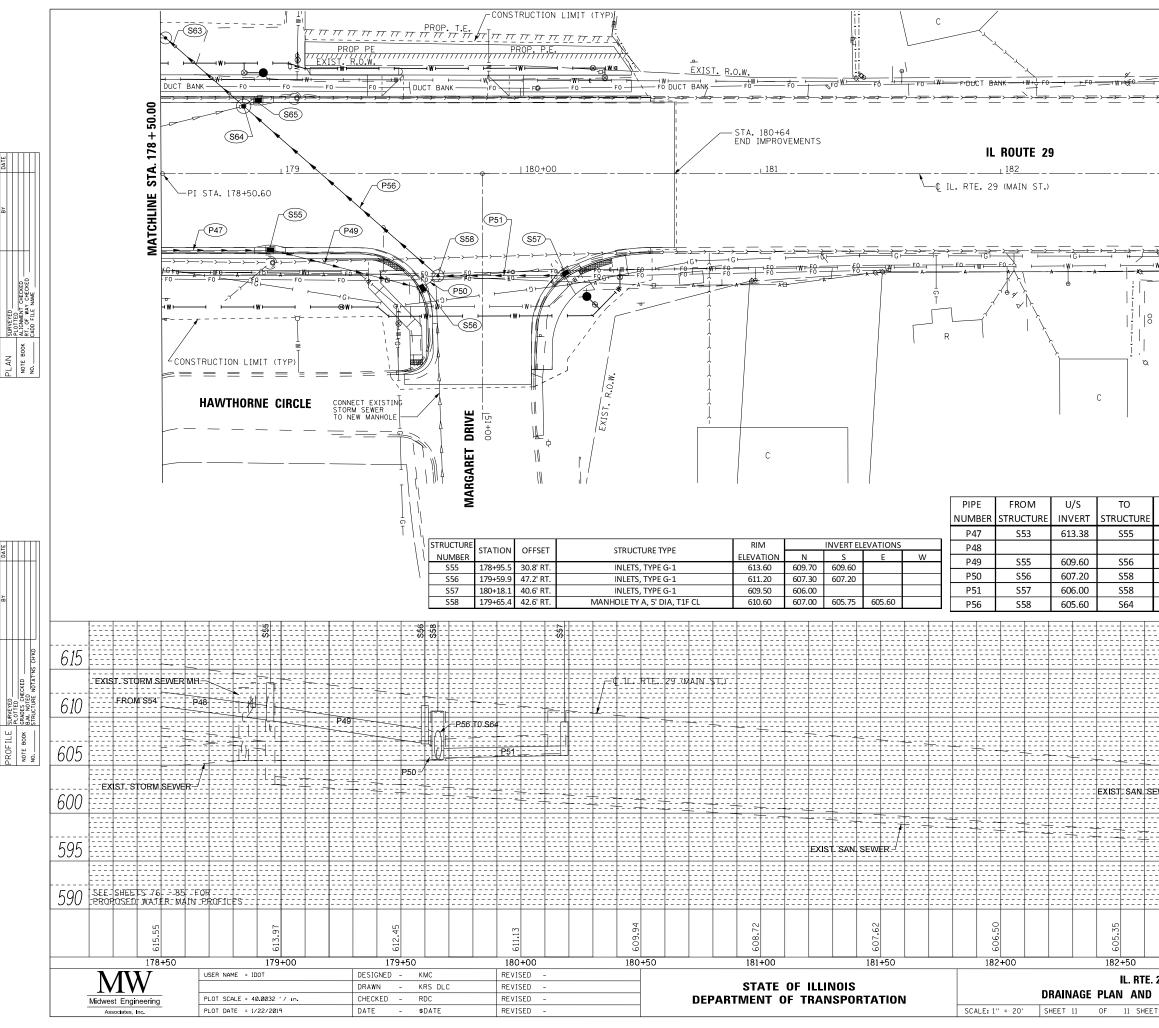
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	D/S VERT					CLAS	S / TY	ΈE				DIAI	METER	21	GTH EET	SLOPE %
	09.70	_						SS A, ⁻ EFT BL		1			18"	-	15	3.20%
	07.30			STO	ORM S	EWEF	R, CLA	SS A,	TYPE 1				18"	62		3.70%
6	07.00 05.75	+		STO	ORM S	EWEF	, CLA	SS A, ⁻ SS A, ⁻	TYPE 1	1		:	18" 12"	49		5.00% 0.51%
	ME	1		STO	ORM S	EWEF	R, CLA	SS A, '	TYPE 2	2		1 3	36"	10	2.4	
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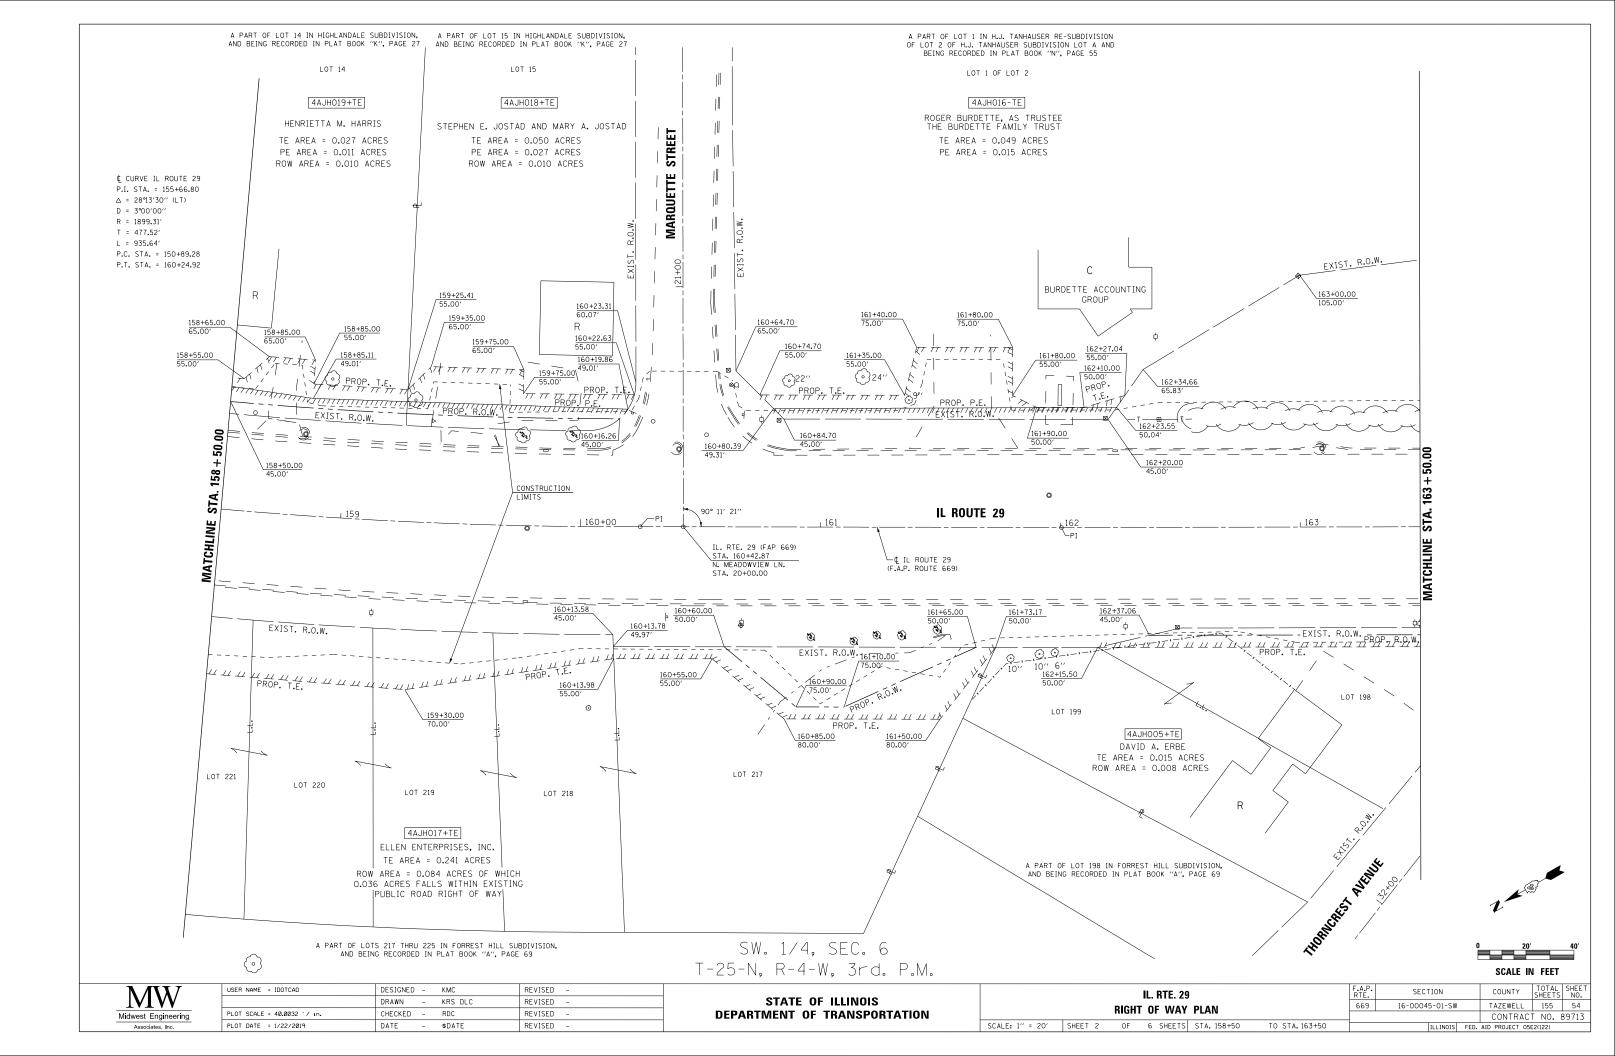
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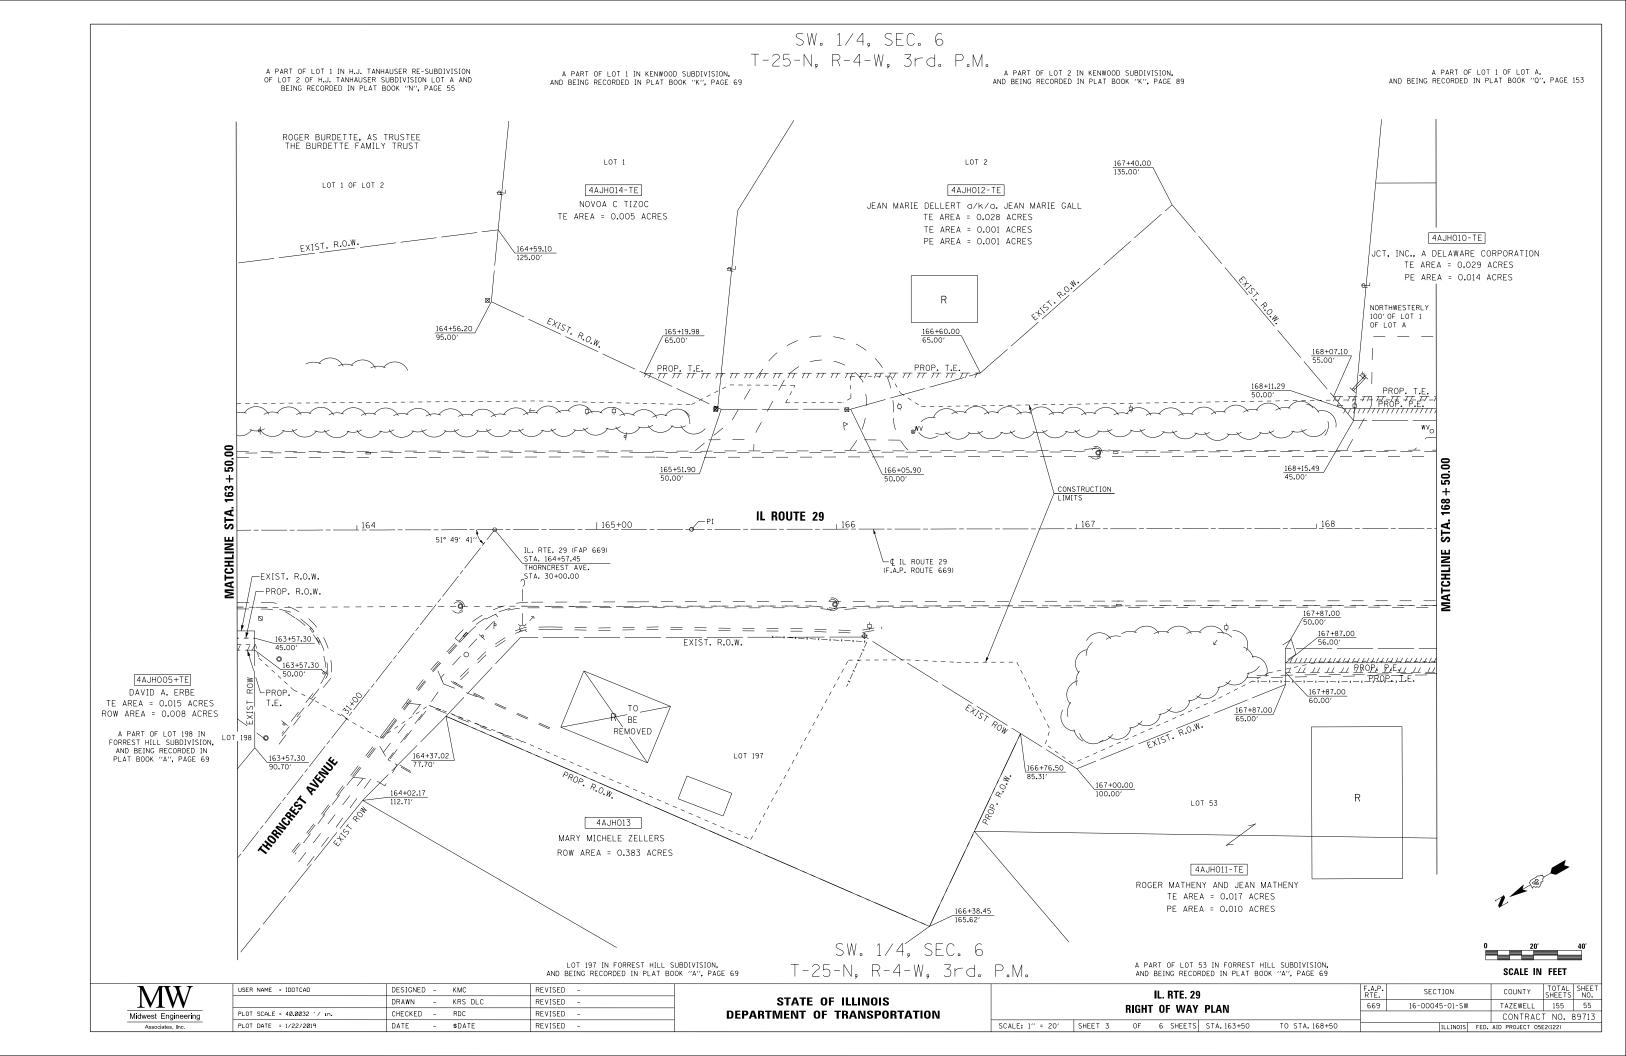
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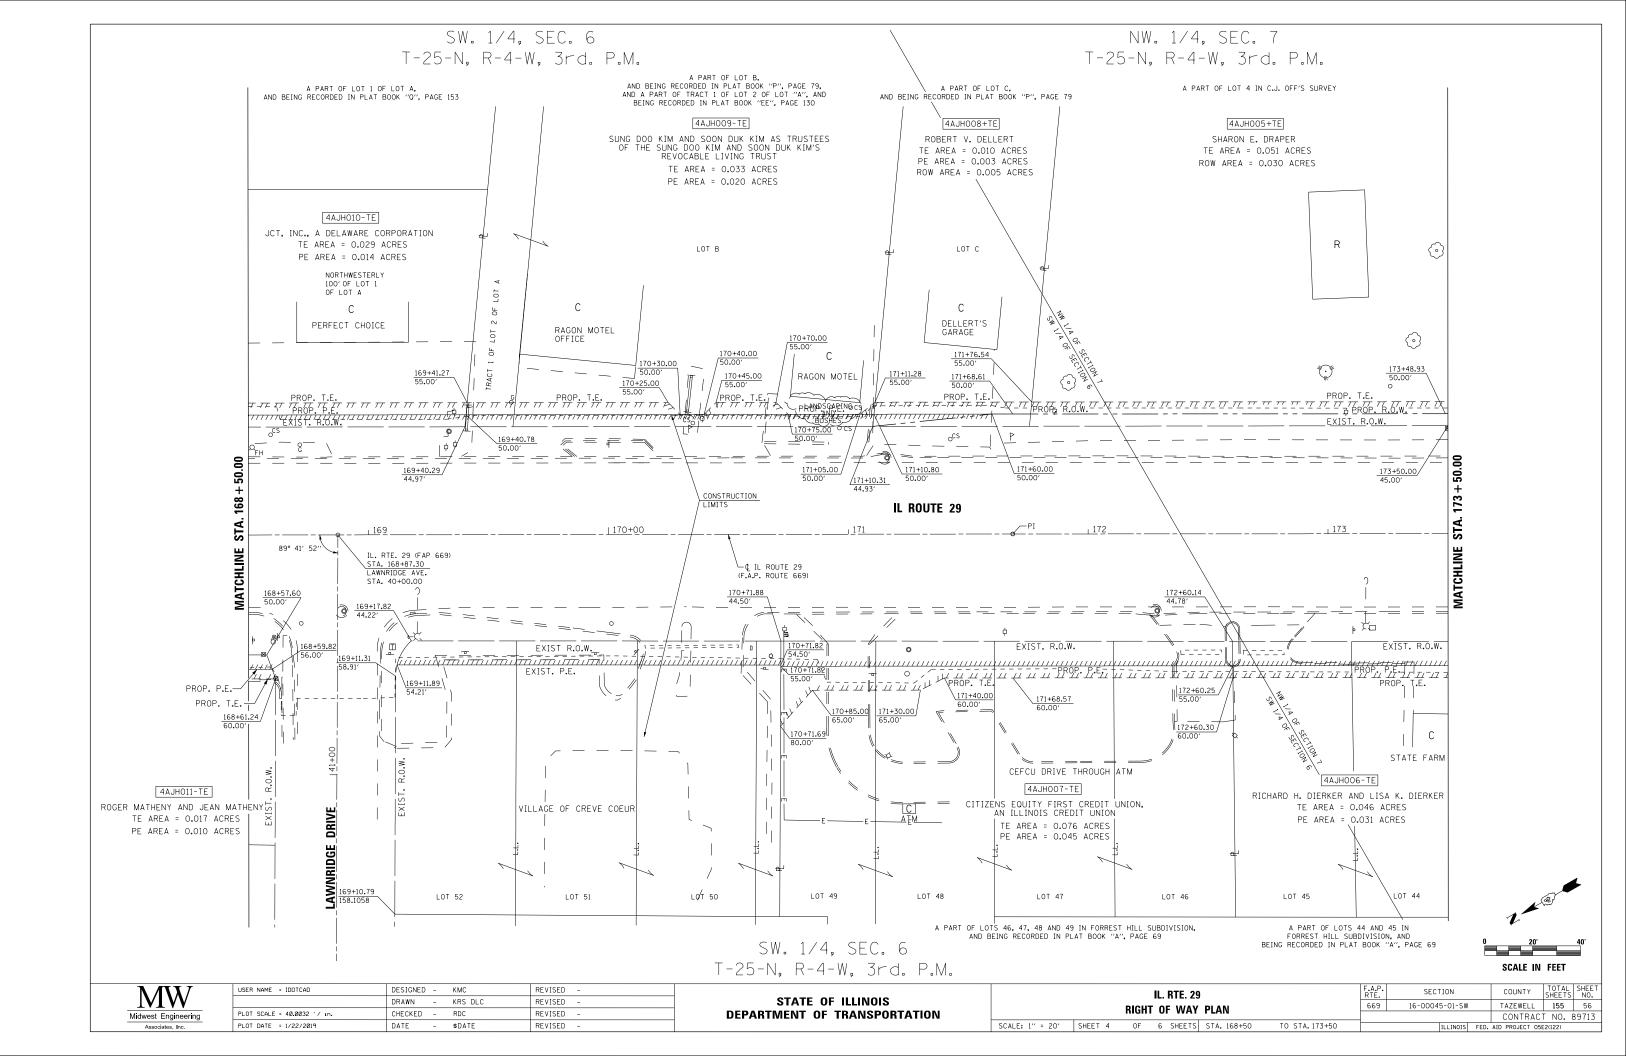
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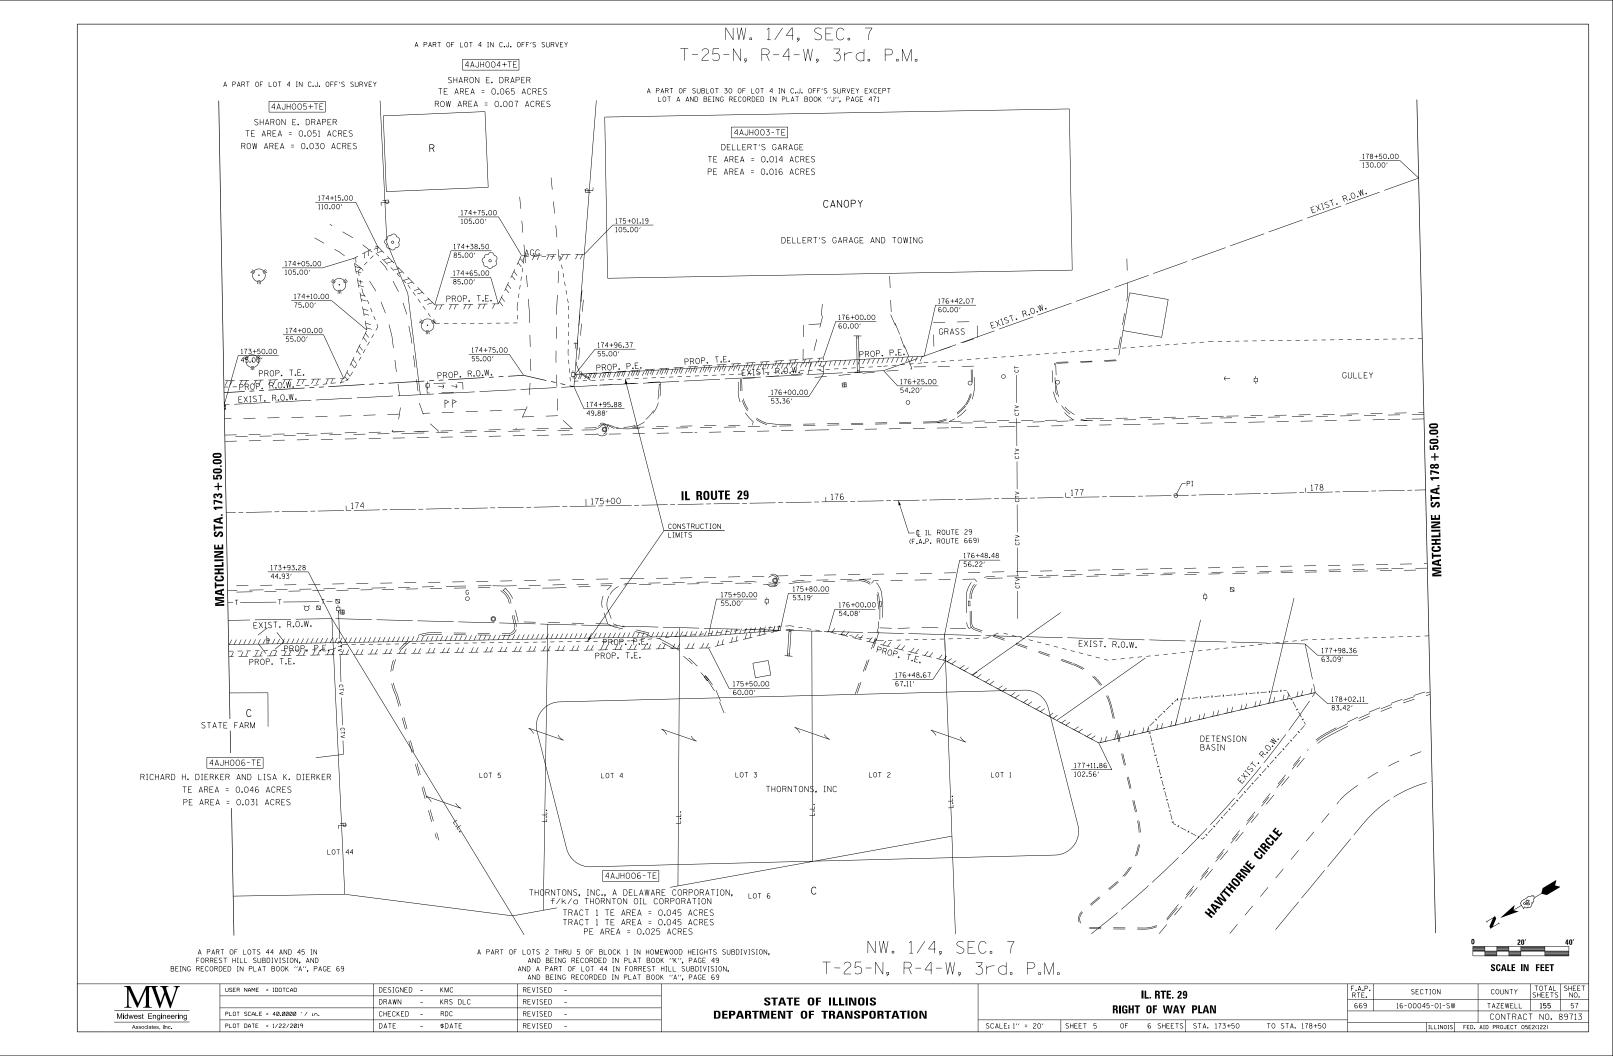
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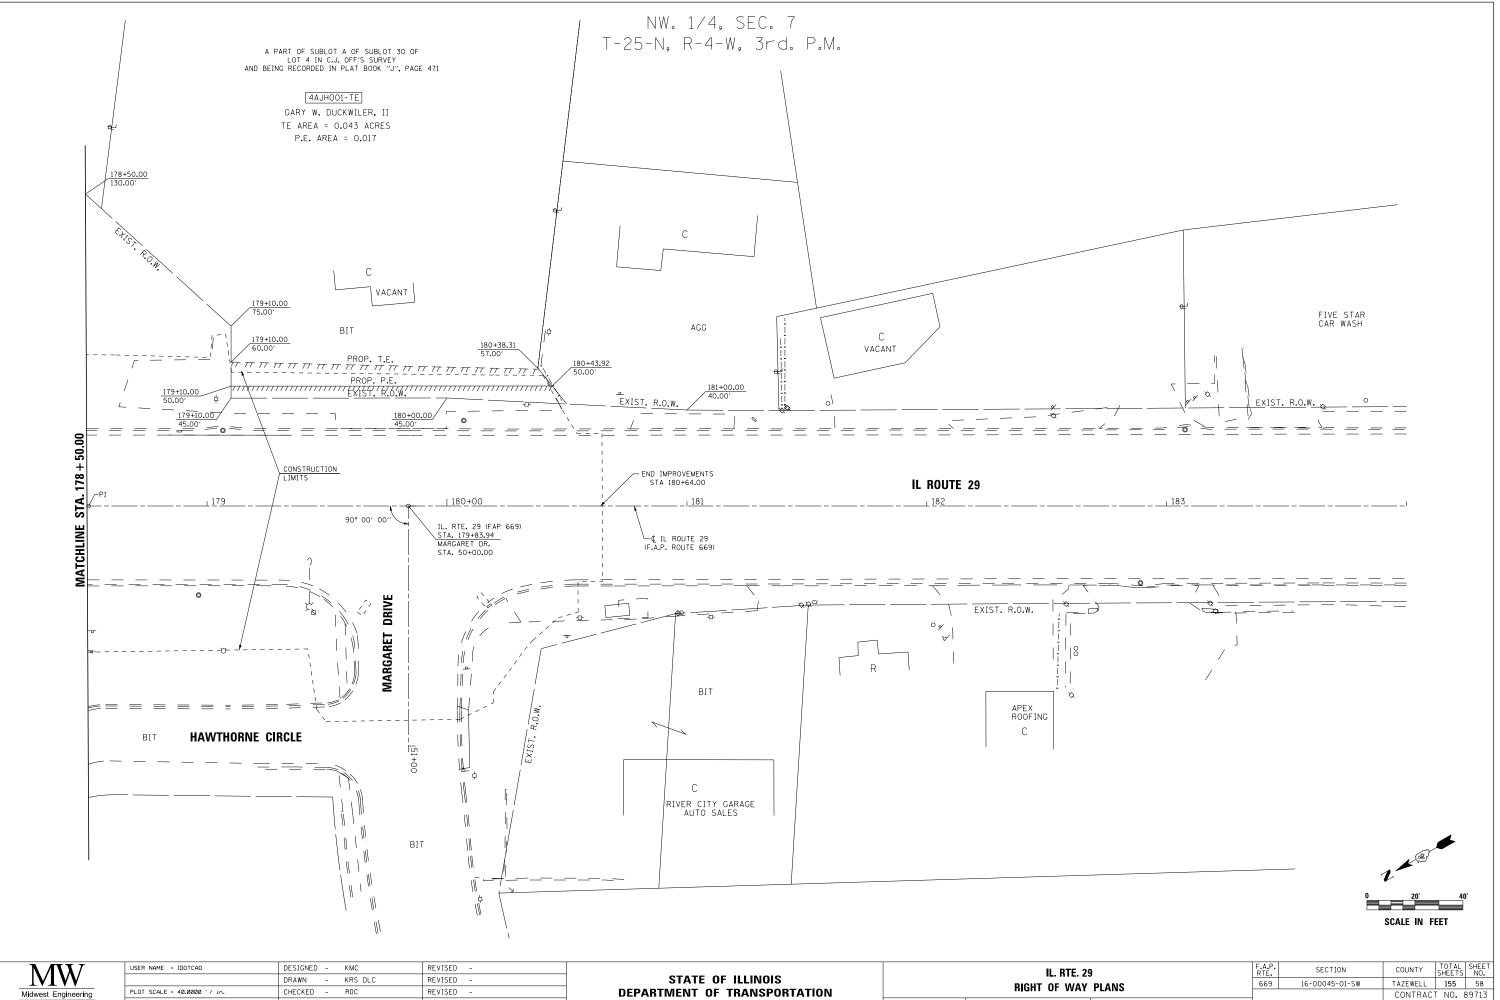
CONTRACT NO. 89713 SCALE: 1" = 20' SHEET 1 OF 6 SHEETS STA. 153+35 TO STA. 158+50 FED AID PROJECT 05E2(122












KRS DLC	REVISED -	STATE OF ILLINOIS
RDC	REVISED -	DEPARTMENT OF TRANSPORTATION
\$DATE	REVISED -	

Associator Inc

DATE

SCALE: 1" = 20' SHEET 6 OF 6 SHEETS

v	PLANS		669	16-00045-01-SV	V	TAZEWELL	155	58	
•	LANO					CONTRACT	Γ NO.	89713	1
TS	STA. 178+50	TO STA. 184+00		ILLINOIS	FED.	AID PROJECT 05E	2(122)		1

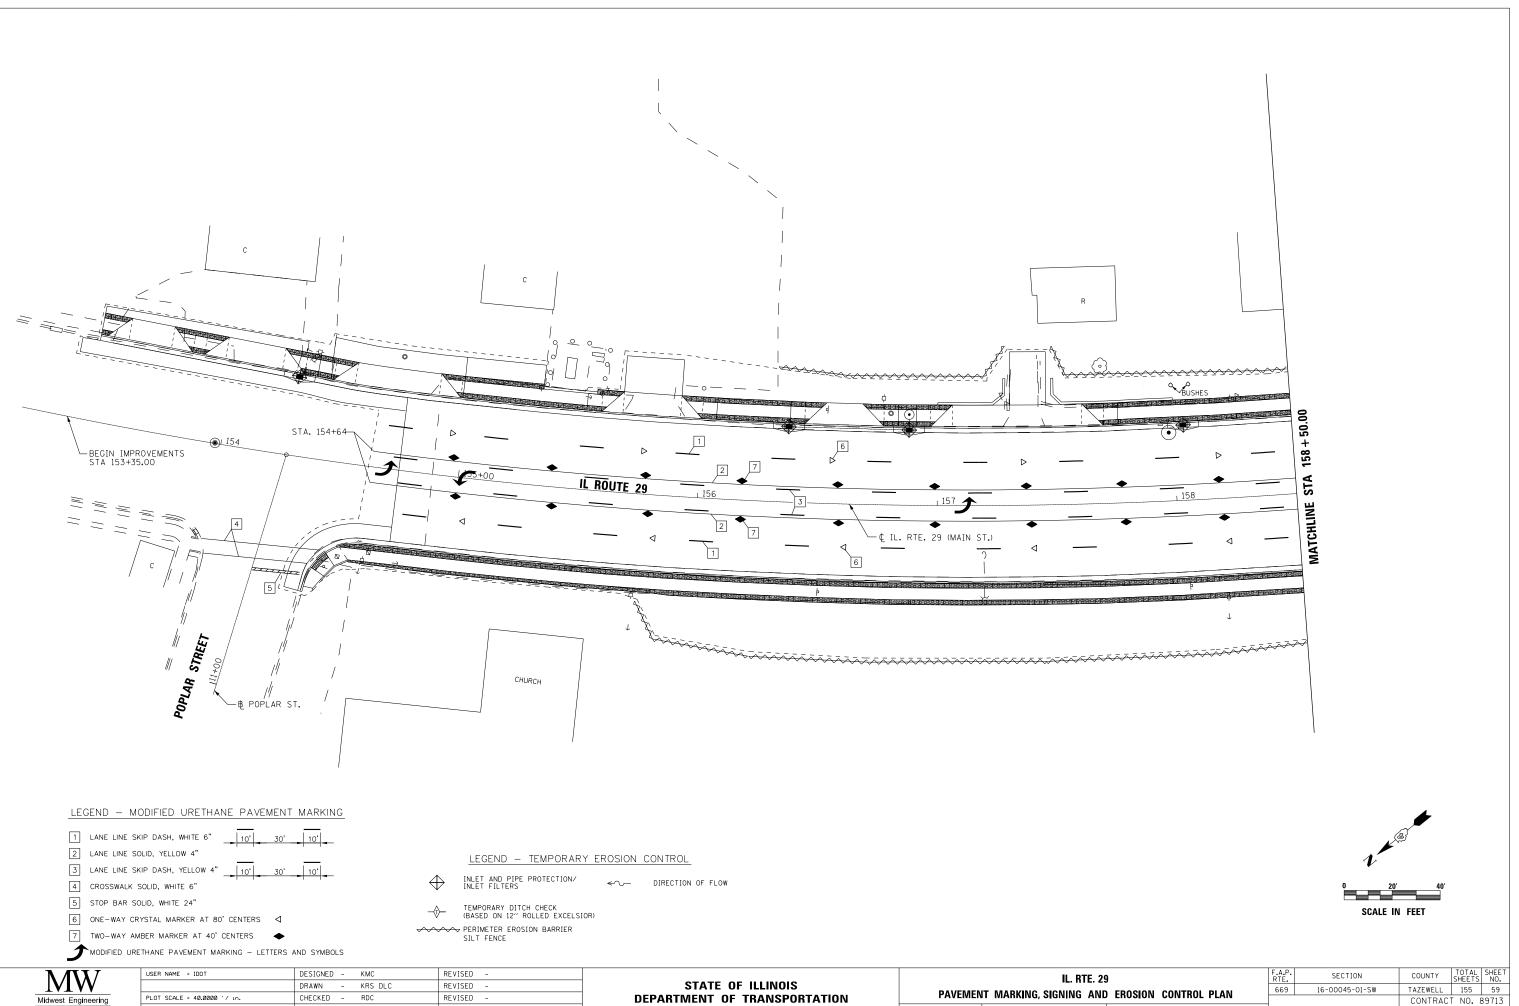

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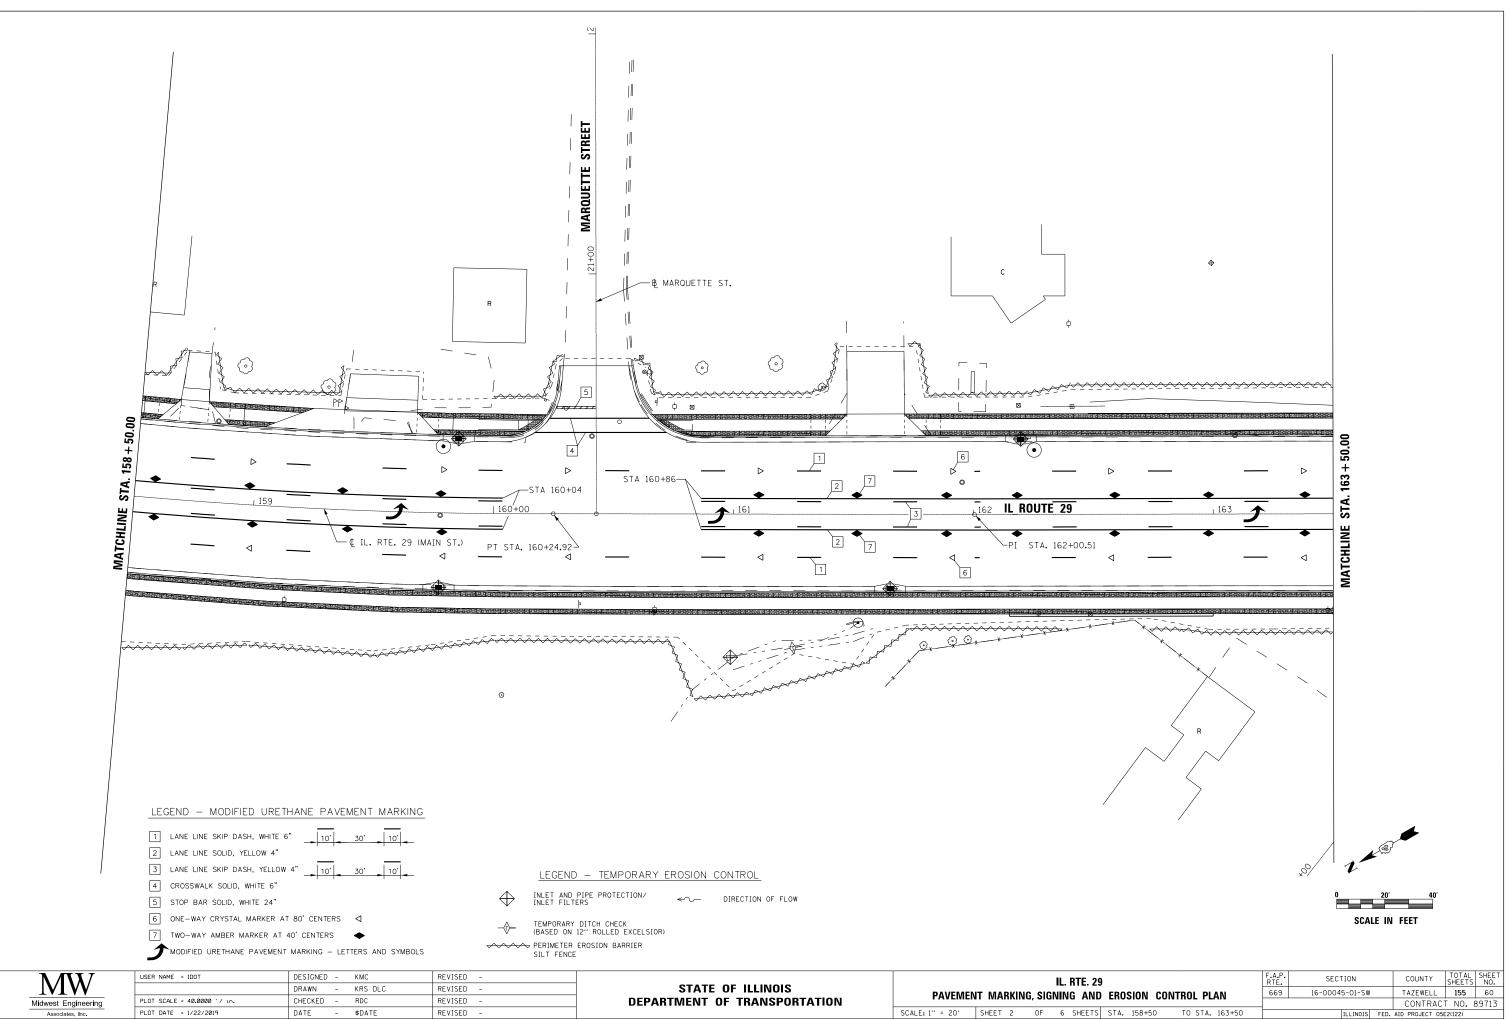
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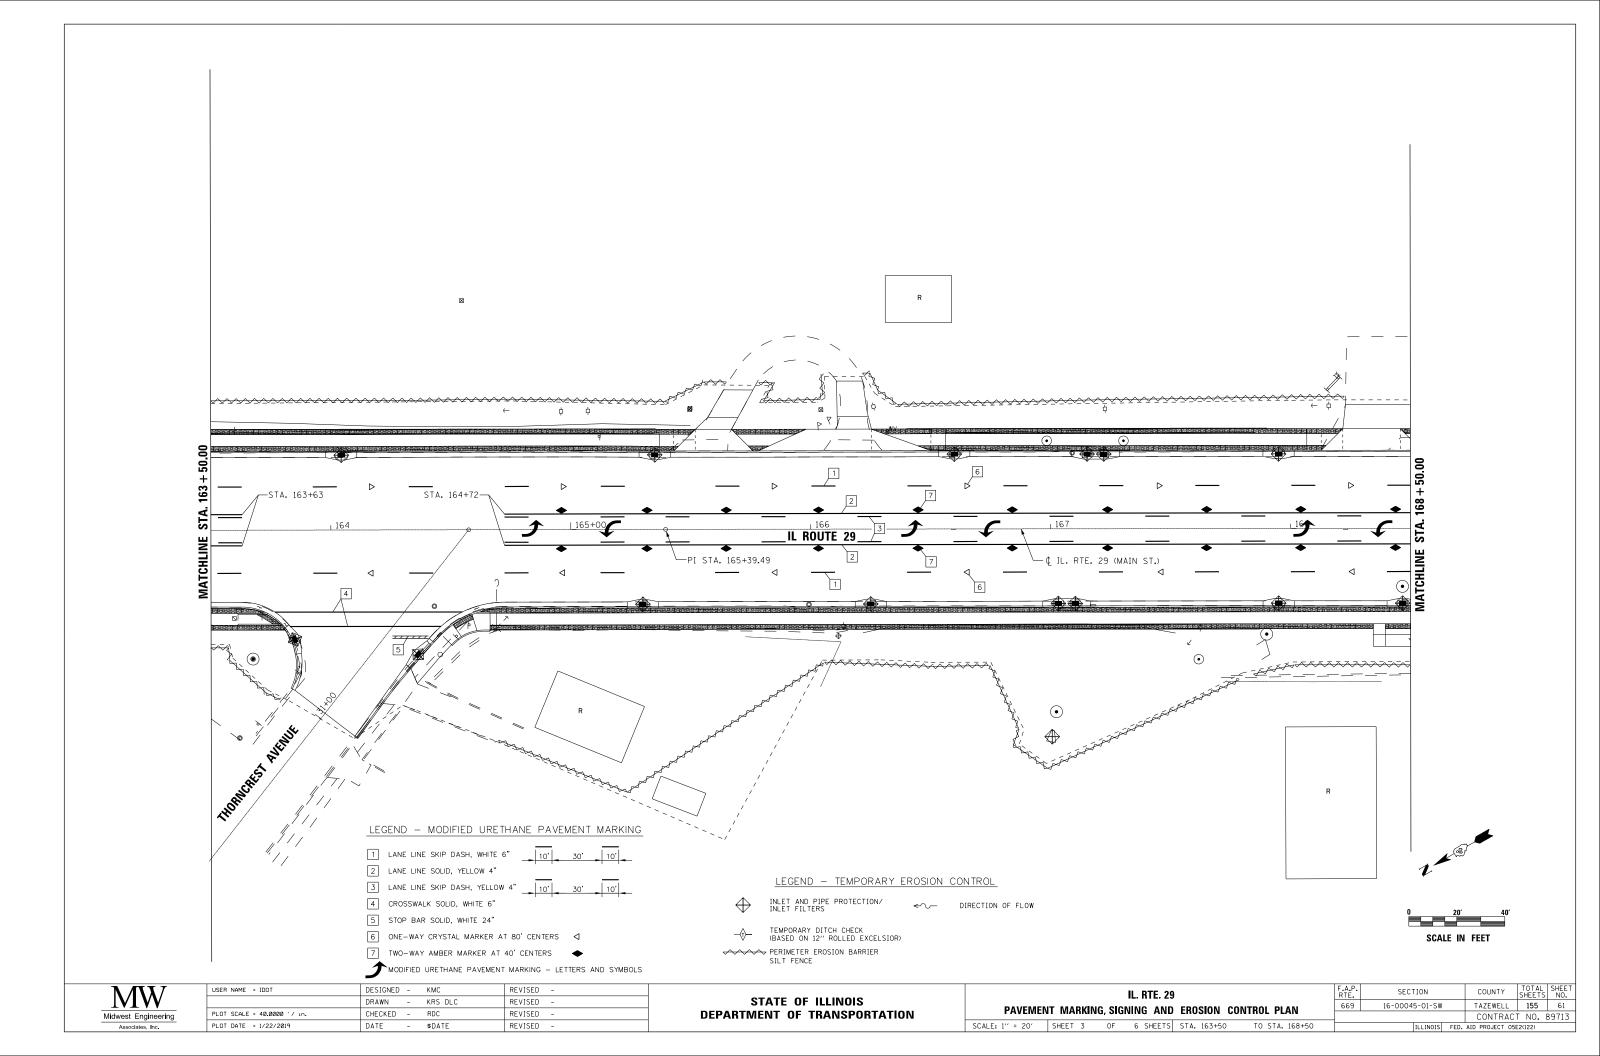
RTMENT	OF	TRANSPORTATION	PAVEMEN		G, SIGN
			SCALE: 1" = 20'	SHEET 1	OF


IL. RTE. 29	1	RTE.	SECTION		COUNTY	SHEETS	NO.
	EROSION CONTROL PLAN	669	16-00045-01-SW	1	TAZEWELL	155	59
	ENUSION CONTINUE FEAR				CONTRAC	T NO. 8	39713
6 SHEETS	STA. 153+00 TO STA. 158	8+50	ILLINOIS	FED.	AID PROJECT 058	2(122)	




		DRAWN -	KRS DLC	REVISED -	STATE OF ILLINOIS	PAVEMEN	IT MARKIN		NING AND
ng	PLOT SCALE = 40.0000 ' / in.	CHECKED -	RDC	REVISED -	DEPARTMENT OF TRANSPORTATION	FAVEINEN		u, siu	MING ANL
	PLOT DATE = 1/22/2019	DATE -	\$DATE	REVISED -		SCALE: 1" = 20'	SHEET 2	OF	6 SHEETS


5 STA. 158+50 TO STA. 163+50




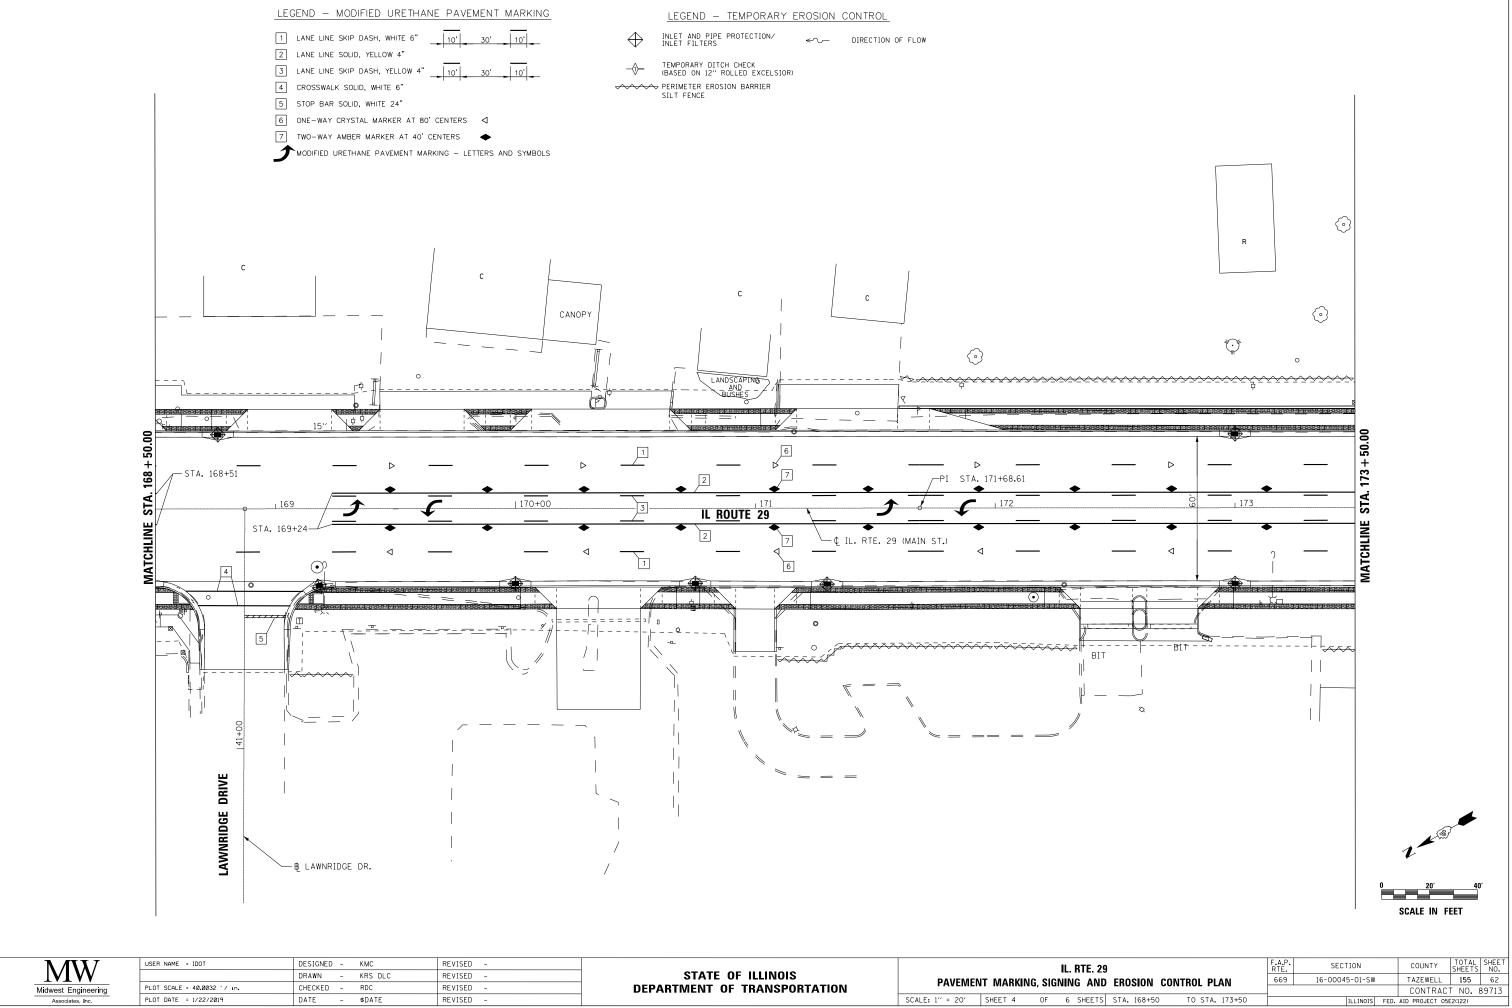

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st Engineering	PLOT SCALE = 40.0032 '/ 10.	CHECKED -	RDC	REVISED -	DEPARTMENT OF TRANSPORTATION	PAVEMEN	IT MARKING	G, SIG
ssociates, Inc.	PLOT DATE = 1/22/2019	DATE -	\$DATE	REVISED -		SCALE: 1" = 20'	SHEET 4	OF

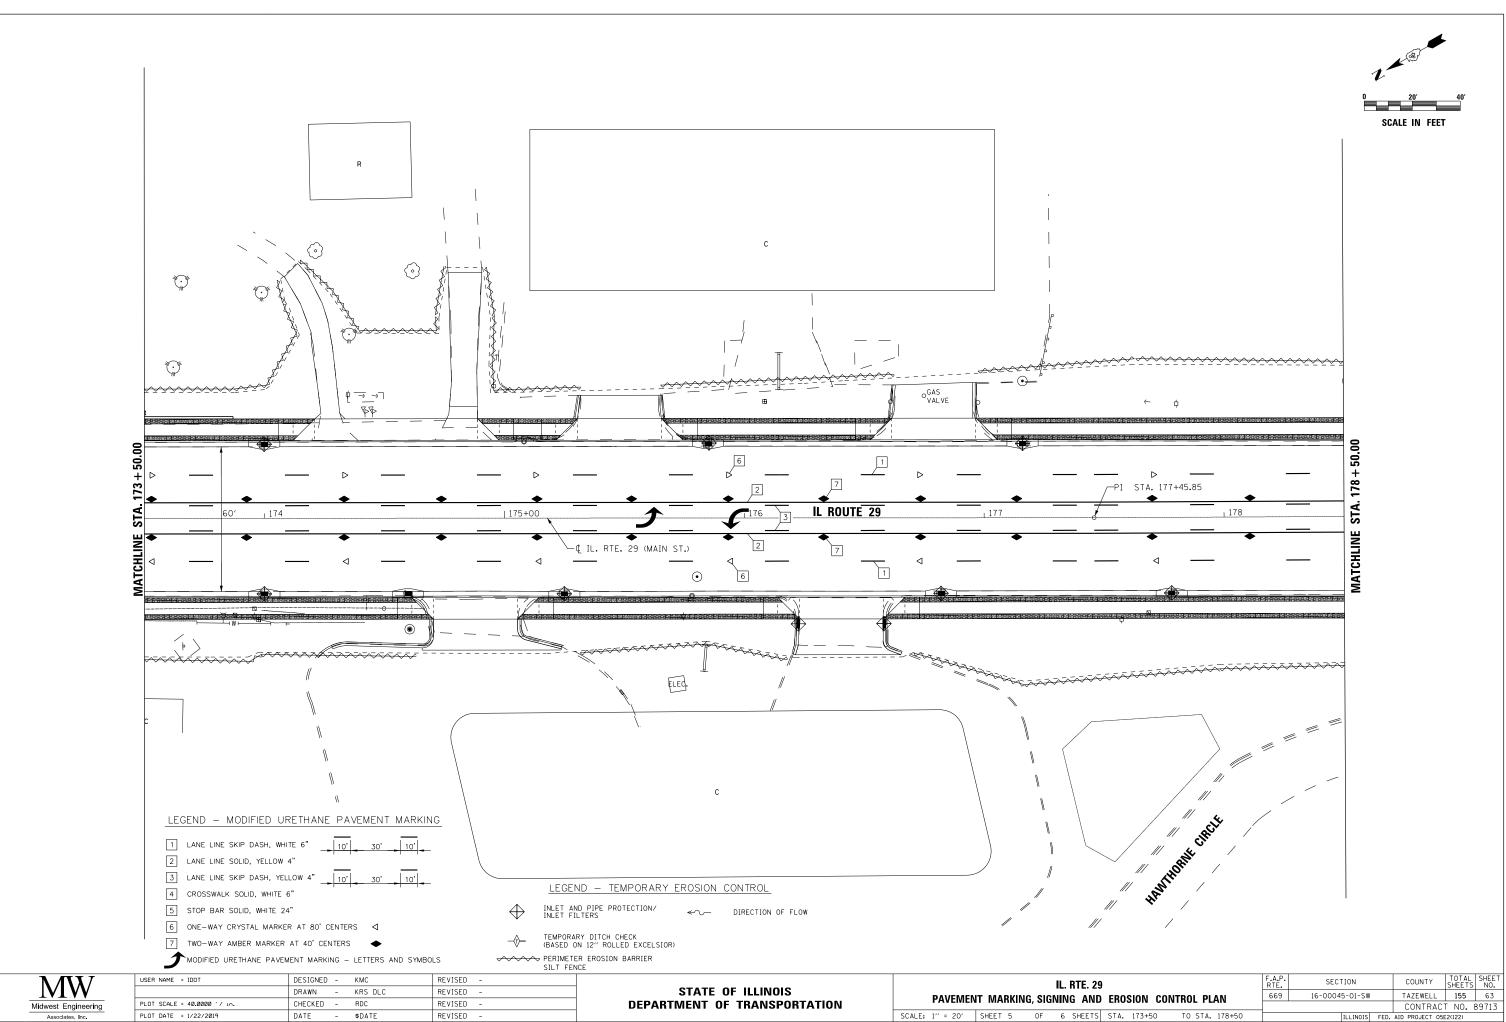


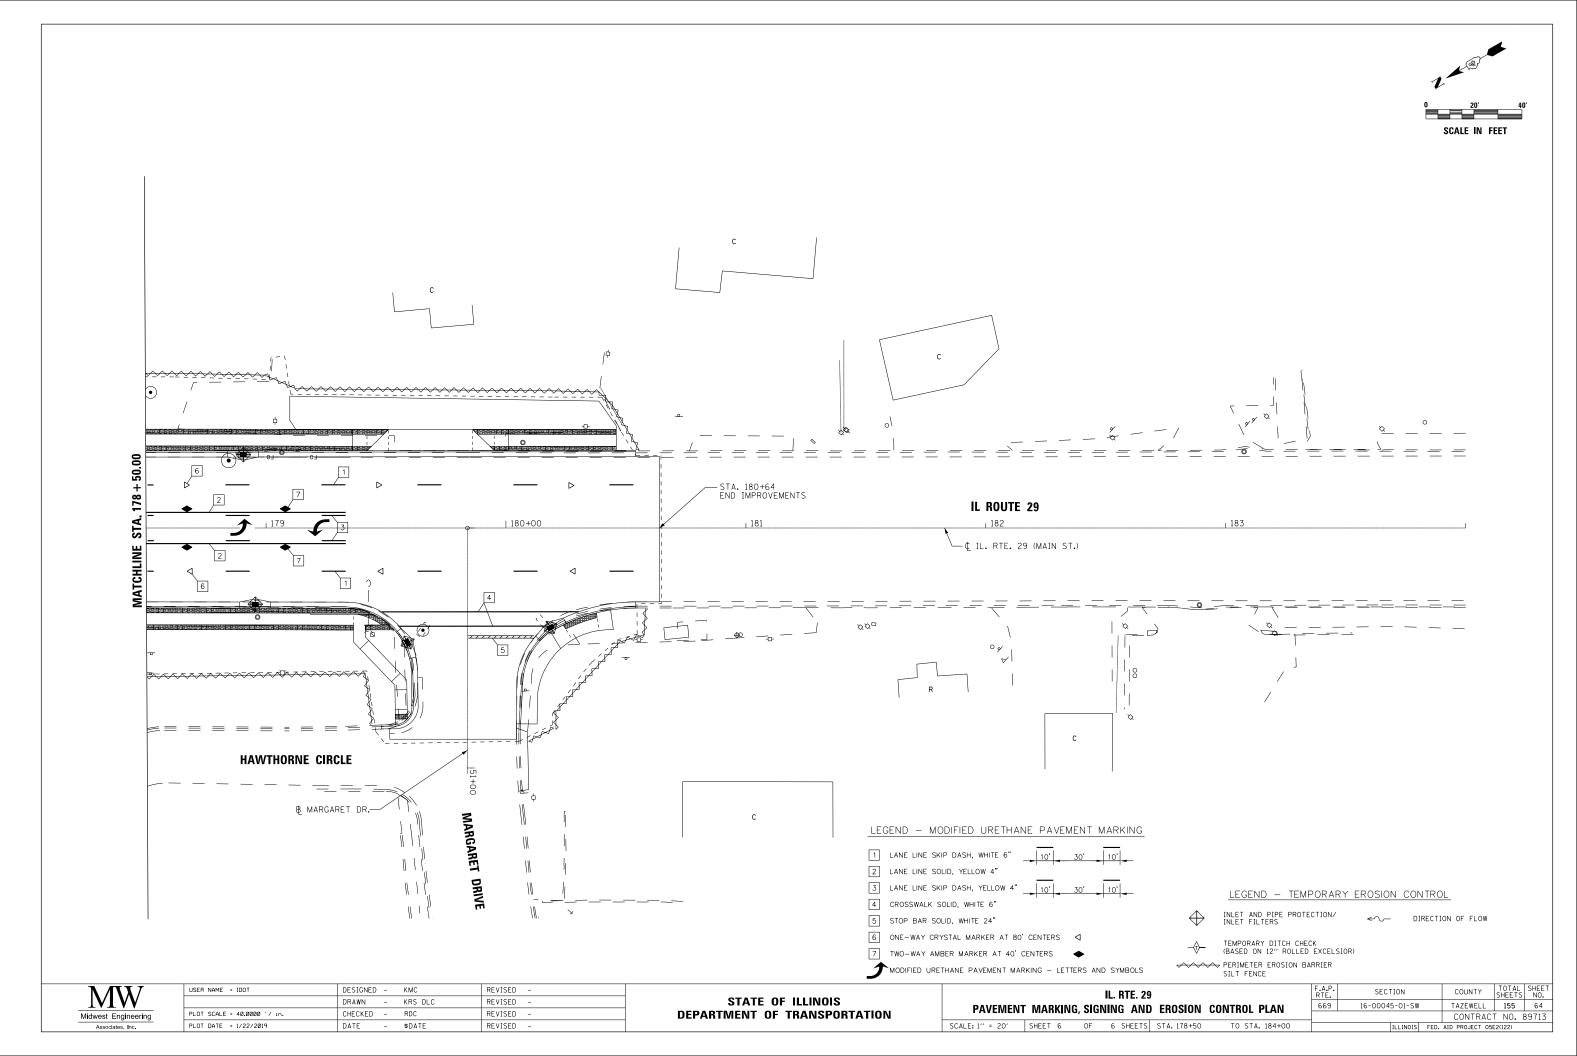


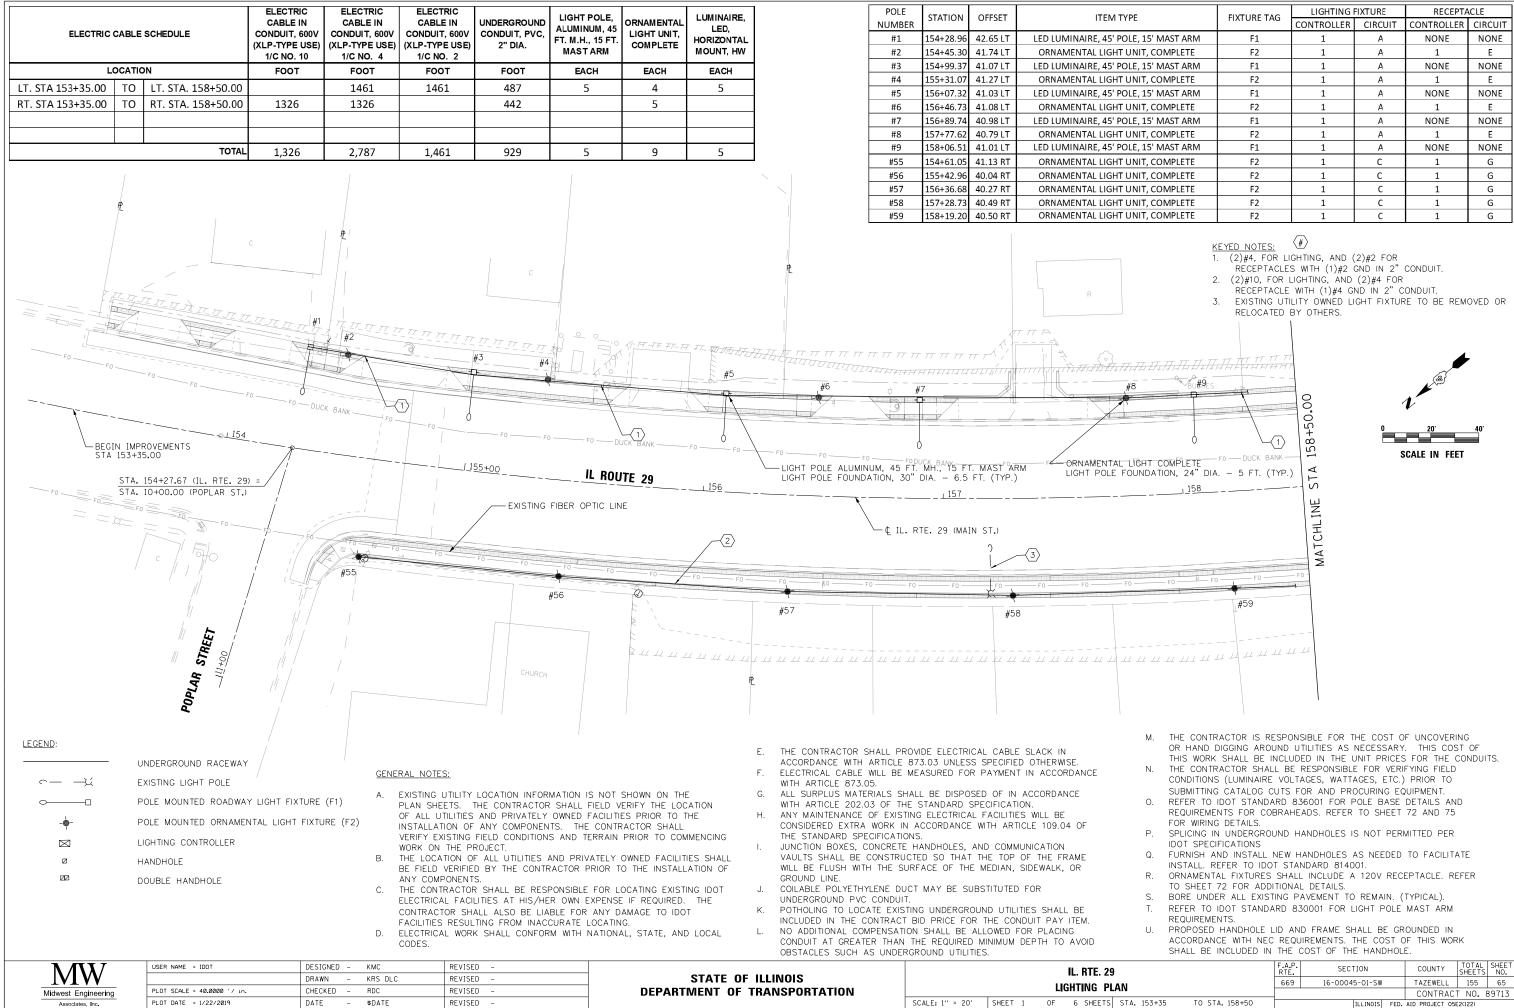


EM TYPE	FIXTURE TAG	LIGHTING I	FIXTURE	RECEPTA	CLE
	FIXTURE TAG	CONTROLLER	CIRCUIT	CONTROLLER	CIRCUIT
45' POLE, 15' MAST ARM	F1	1	А	NONE	NONE
IGHT UNIT, COMPLETE	F2	1	А	1	Е
45' POLE, 15' MAST ARM	F1	1	А	NONE	NONE
IGHT UNIT, COMPLETE	F2	1	А	1	E
45' POLE, 15' MAST ARM	F1	1	А	NONE	NONE
IGHT UNIT, COMPLETE	F2	1	А	1	Е
45' POLE, 15' MAST ARM	F1	1	А	NONE	NONE
IGHT UNIT, COMPLETE	F2	1	А	1	E
45' POLE, 15' MAST ARM	F1	1	А	NONE	NONE
IGHT UNIT, COMPLETE	F2	1	С	1	G
IGHT UNIT, COMPLETE	F2	1	С	1	G
IGHT UNIT, COMPLETE	F2	1	С	1	G
IGHT UNIT, COMPLETE	F2	1	С	1	G
IGHT UNIT, COMPLETE	F2	1	С	1	G

29	F.A.P. RTE.	SECTION		COUNTY	TOTAL SHEETS	SHEET NO.
PLAN	669	16-00045-01-SW		TAZEWELL	155	65
				CONTRAC	T NO. 8	39713
TS STA. 153+35 TO STA. 158+50		ILLINOIS	FED.	AID PROJECT 05	E2(122)	

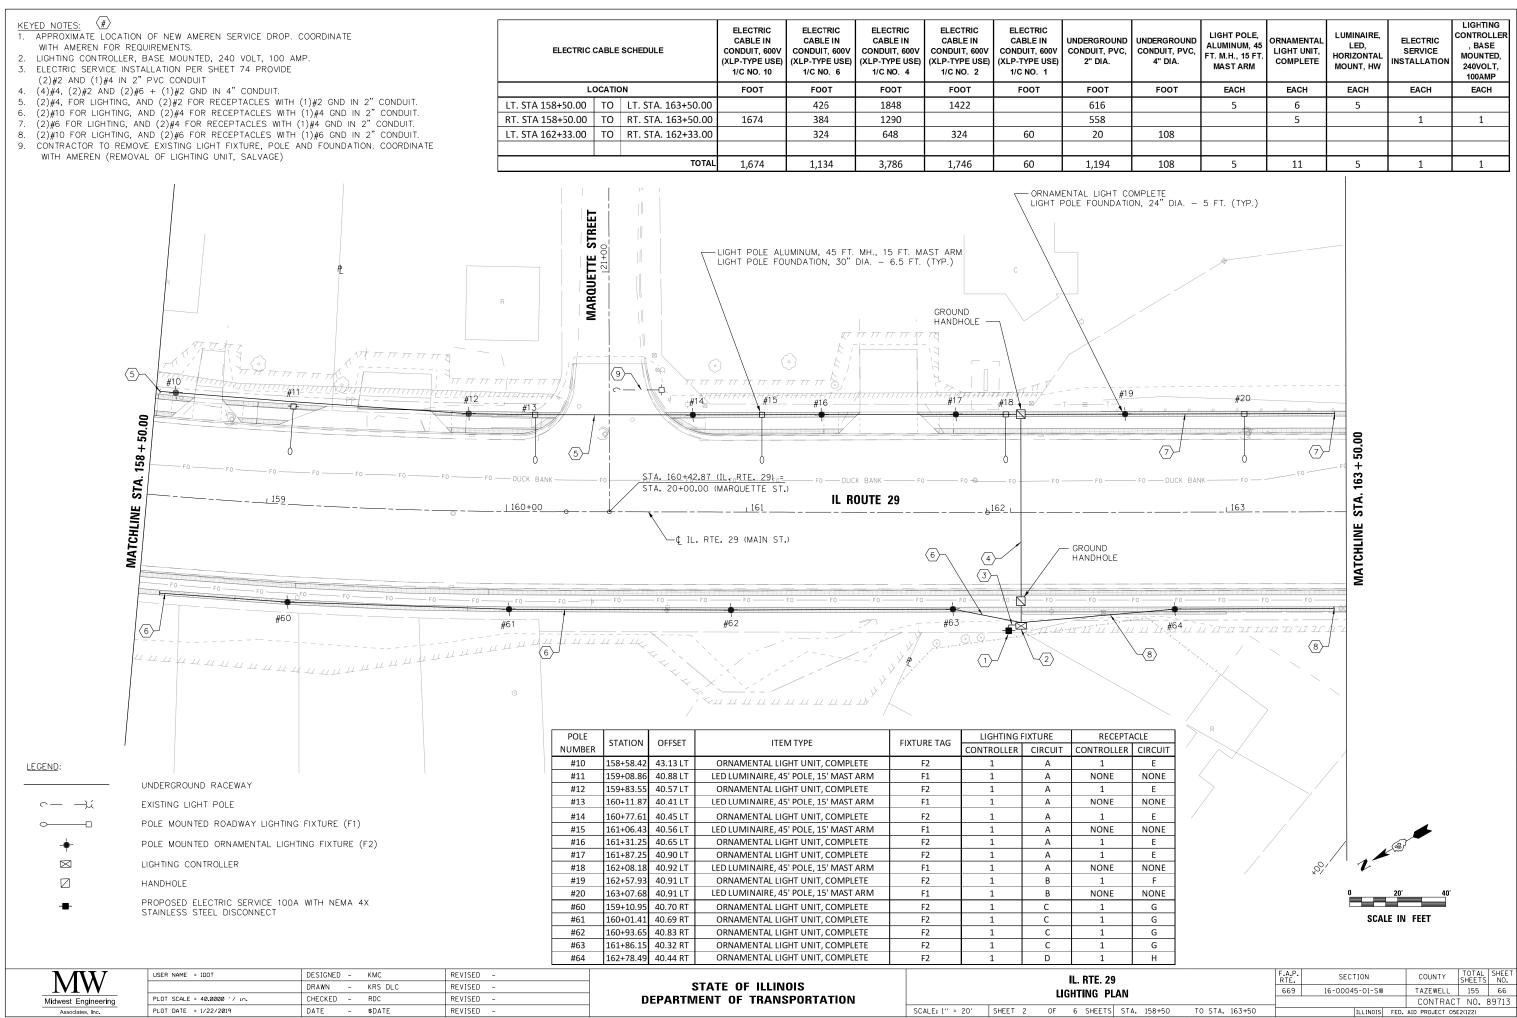

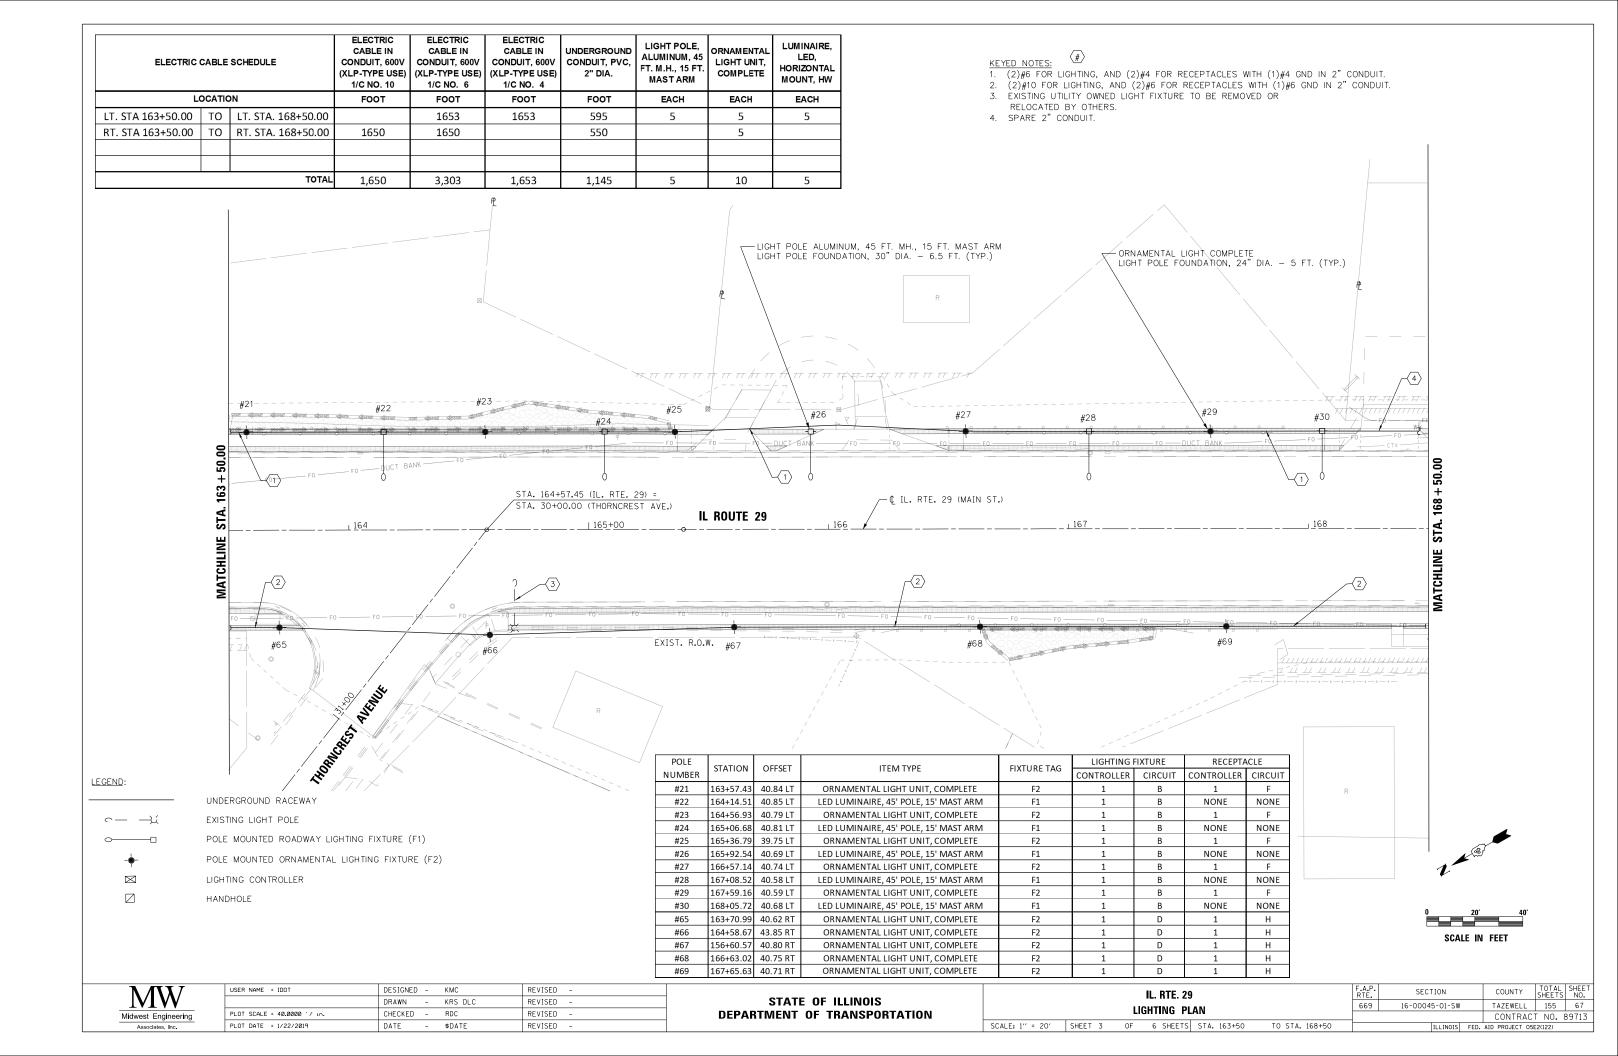

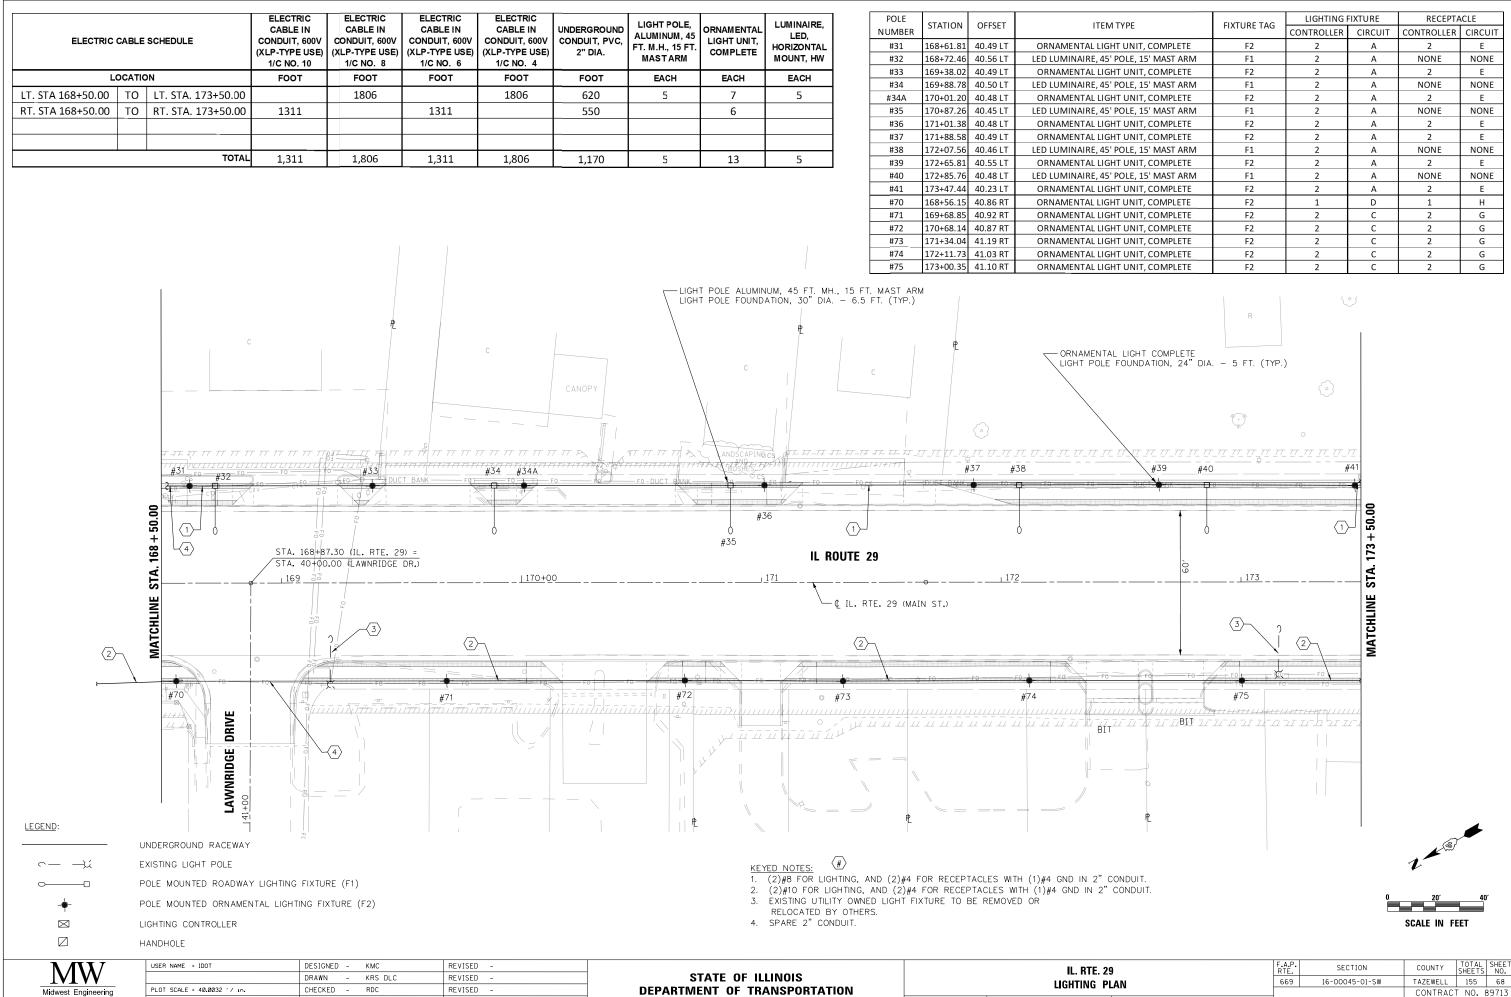

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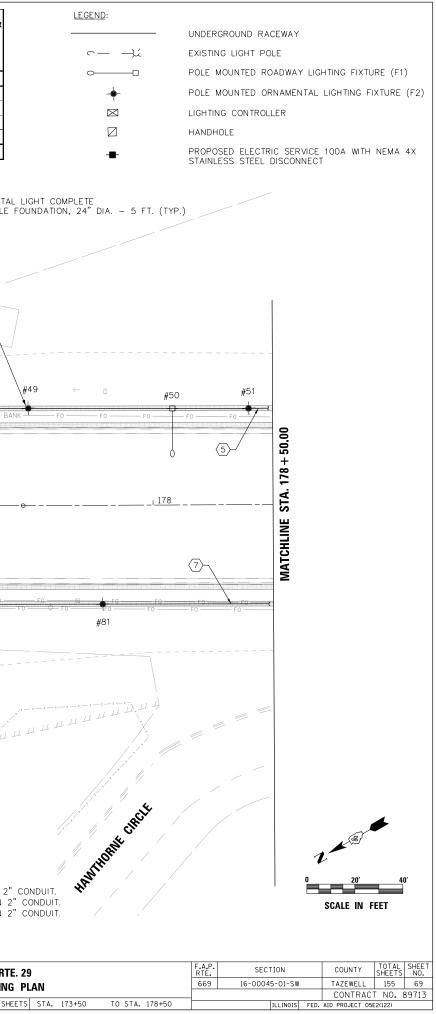
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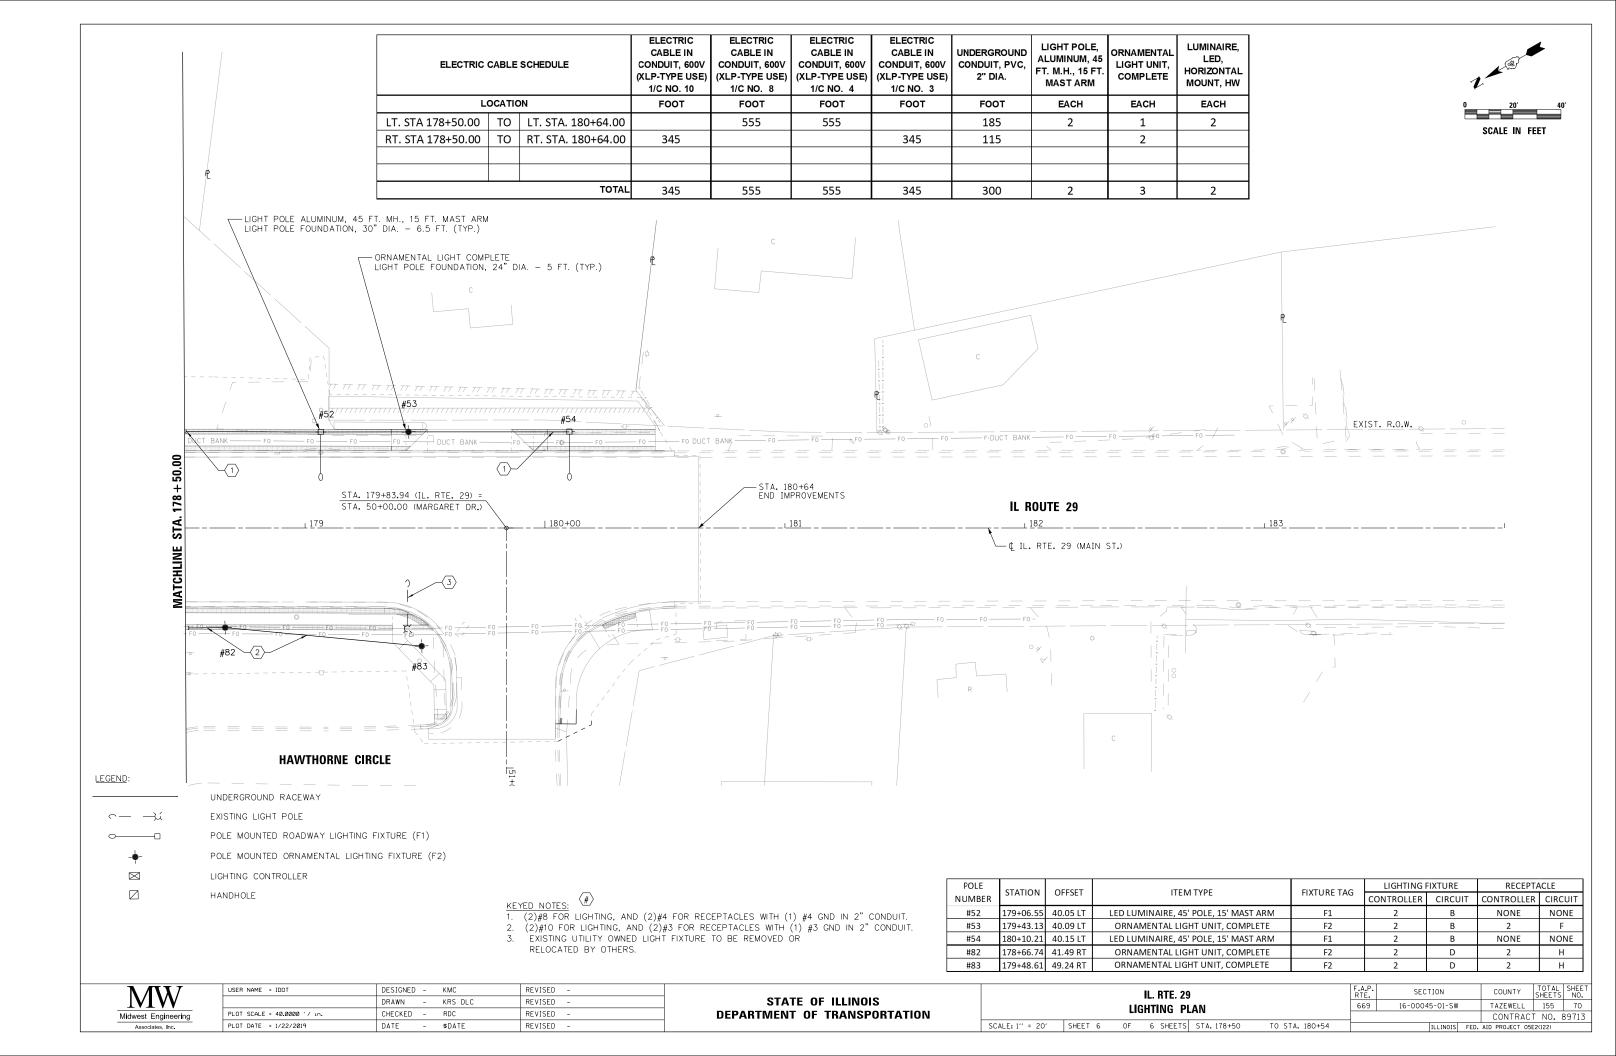
ΕΜ ΤΥΡΕ	FIXTURE TAG	LIGHTING	IXTURE	RECEPTA	CLE
	FIXTURE TAG	CONTROLLER	CIRCUIT	CONTROLLER	CIRCUIT
GHT UNIT, COMPLETE	F2	2	А	2	E
5' POLE, 15' MAST ARM	F1	2	А	NONE	NONE
GHT UNIT, COMPLETE	F2	2	А	2	E
5' POLE, 15' MAST ARM	F1	2	А	NONE	NONE
GHT UNIT, COMPLETE	F2	2	А	2	E
5' POLE, 15' MAST ARM	F1	2	А	NONE	NONE
GHT UNIT, COMPLETE	F2	2	А	2	E
GHT UNIT, COMPLETE	F2	2	А	2	E
5' POLE, 15' MAST ARM	F1	2	А	NONE	NONE
GHT UNIT, COMPLETE	F2	2	А	2	E
5' POLE, 15' MAST ARM	F1	2	А	NONE	NONE
GHT UNIT, COMPLETE	F2	2	А	2	E
GHT UNIT, COMPLETE	F2	1	D	1	Н
GHT UNIT, COMPLETE	F2	2	С	2	G
GHT UNIT, COMPLETE	F2	2	С	2	G
GHT UNIT, COMPLETE	F2	2	С	2	G
GHT UNIT, COMPLETE	F2	2	С	2	G
GHT UNIT, COMPLETE	F2	2	С	2	G

29			F.A.P. RTE.	SECTION	COUNTY	TOTAL SHEETS	SHEET NO.
Ы	AN		669	16-00045-01-SW	TAZEWELL	68	
	/				CONTRAC	T NO. 8	39713
rs	STA. 168+50	TO STA. 173+50		ILLINOIS FE	D. AID PROJECT OS	2(122)	

SCALE: 1" = 20' SHEET 4 OF 6 SHEET

ELECTRIC	CABLE SCHEI	DULE	ELECTRIC CABLE IN CONDUIT, 600V (XLP-TYPE USE) 1/C NO. 10	ELECTRIC CABLE IN CONDUIT, 600V (XLP-TYPE USE) 1/C NO. 8	ELECTRIC CABLE IN CONDUIT, 600V (XLP-TYPE USE) 1/C NO. 6	ELECTRIC CABLE IN CONDUIT, 600V (XLP-TYPE USE) 1/C NO. 4	ELECTRIC CABLE IN CONDUIT, 600V (XLP-TYPE USE) 1/C NO. 3	ELECTRIC CABLE IN CONDUIT, 600V (XLP-TYPE USE) 1/C NO. 1	CONDUIT, PVC,	UNDERGROUND CONDUIT, PVC, 4" DIA.	LIGHT POLE, ALUMINUM, 45 FT. M.H., 15 FT. MAST ARM	ORNAMENTAL LIGHT UNIT, COMPLETE	LUMINAIRE, LED, HORIZONTAL MOUNT, HW	ELECTRIC SERVICE INSTALLATION	LIGHTING CONTROLLER , BASE MOUNTED, 240VOLT, 100AMP
	OCATION		FOOT	FOOT	FOOT	FOOT	FOOT	FOOT	FOOT	FOOT	EACH	EACH	EACH	EACH	EACH
LT. STA 173+50.00 RT. STA 173+50.00		STA. 178+50.00 STA. 178+50.00	1716	1842	300	1842	1416		614 572		5	5	5	1	1
LT. STA 174+34.00		STA: 178+30.00 STA 174+34.00	648		324		324	60	20	108		0			
		TOTAL	2,364	1,842	624	1,842	1,740	60	1,206	108	5	11	5	1	1
	+ 50.00	© 7 DUCT BANK		5 (1			77 444 #45	<u>лип лип лип лип лип</u>		POLE FOUNDATI		#47 #47	OGAS VALVE	F0 -	8 Fo Duct
	*														
	MATCHLINE STA. 173+		174			-(4) (7) -(4) (7) -(7) (7) -(7) (7) (7) (7) (7) (7) (7) (7) (7) (7)		FO FO FO	RTE. 29 (MAIN	176		DUTE 29		L177	- F0 F0
	STA. 173	6 Fo 6 Fo 6 #76 #76			#77			#78		176	IL R(DUTE 29		1 <u>177</u>	<u>-FQ</u> -FQ
	STA. 173							F0 F0 #78 #78 #11 11 11 RECEPTACLE	HEIFILTER	176		DUTE 29		гориальна Fo ⁻ Ф ^{E0} Fo-	ΕΓ
UMBER STATION	MATCHLINE STA. 173	#76						#78	FD FD FD FD FD FD FD FD FD FD FD FD FD F	176		DUTE 29		гориальна Fo ⁻ Ф ^{E0} Fo-	- F0
UMBER STATION #42 174+04.90 #43 174+35.89	OFFSET 40.48 LT 42.79 LT	LED LUMINAIF ORNAMENTA	ITEM TYPE RE, 45' POLE, 15' M ALLIGHT UNIT, CO	MAST ARM DMPLETE	FIXTURE TAG F1 F2	LIGHTING FIXT			HITTITI II II II FO FO FO HITTITI II II II II ELEQ.	176		DUTE 29		гориальна Fo ⁻ Ф ^{E0} Fo-	FP
UMBER STATION #42 174+04.90 #43 174+35.89 #44 175+05.00	OFFSET 40.48 LT 42.79 LT 40.53 LT	LED LUMINAIF ORNAMENTA LED LUMINAIF	ITEM TYPE RE, 45' POLE, 15' f AL LIGHT UNIT, CO RE, 45' POLE, 15' f	MAST ARM DMPLETE MAST ARM	FIXTURE TAG F1 F2 F1 F1	(4) (7) F0 F0 F0 LIGHTING FIXT CONTROLLER (2) 2 2 2 2	TURE CINTURE CONTURE CIRCUIT CONTURE A NC		HITTITI II II II FO FO FO HITTITI II II II II ELEQ.	176		DUTE 29		гориальна Fo ⁻ Ф ^{E0} Fo-	FD
UMBER STATION #42 174+04.90 #43 174+35.89	OFFSET 40.48 LT 42.79 LT 40.53 LT 40.40 LT	LED LUMINAIF ORNAMENTA LED LUMINAIF ORNAMENTA	ITEM TYPE RE, 45' POLE, 15' M ALLIGHT UNIT, CO	MAST ARM DMPLETE MAST ARM DMPLETE MAST ARM DMPLETE	FIXTURE TAG F1 F2	LIGHTING FIXT	TURE CIRCUIT CONTI A NC B NC B		FO F	1176	#79 4 -2			гориальна Fo ⁻ Ф ^{E0} Fo-	F0 F0
UMBER STATION #42 174+04.90 #43 174+35.89 #44 175+05.00 #45 175+14.47 #46 175+90.57 #47 176+45.49	OFFSET 40.48 LT 42.79 LT 40.53 LT 40.64 LT 40.50 LT	LED LUMINAIF ORNAMENTA LED LUMINAIF ORNAMENTA LED LUMINAIF ORNAMENTA	ITEM TYPE RE, 45' POLE, 15' I' AL LIGHT UNIT, CC RE, 45' POLE, 15' I' AL LIGHT UNIT, CC RE, 45' POLE, 15' I' AL LIGHT UNIT, CC RE, 45' POLE, 15' I' AL LIGHT UNIT, CC RE, 45' POLE, 15' I' AL LIGHT UNIT, CC	MAST ARM DMPLETE MAST ARM DMPLETE MAST ARM DMPLETE MAST ARM DMPLETE	FIXTURE TAG F1 F2 F1 F2 F1 F2 F1 F2 F1 F2 F1 F2 F1 F2 F1 F2 F1 F2 F1 F2 F1 F2 F1 F2 F1 F2 F1 F2 F2	4 7 re ro re	TURE TURE TURE CONTI A NCA B NCB B NCB	F0 F0 #78 #78 RECEPTACLE ROLLER CIRCUI DNE NONE 2 E DNE NONE 2 F DNE NONE 2 F	FO FO FO		#79 #79		AMEREN SER	#80 ++++++++++++++++++++++++++++++++++++	
UMBER STATION #42 174+04.90 #43 174+35.89 #44 175+05.00 #45 175+14.47 #46 175+90.57 #47 176+45.49 #48 177+12.57	OFFSET 40.48 LT 40.53 LT 40.64 LT 40.50 LT 40.62 LT	LED LUMINAIF ORNAMENTA LED LUMINAIF ORNAMENTA LED LUMINAIF ORNAMENTA LED LUMINAIF	ITEM TYPE RE, 45' POLE, 15' I AL LIGHT UNIT, CC RE, 45' POLE, 15' I	MAST ARM DMPLETE MAST ARM DMPLETE MAST ARM DMPLETE MAST ARM DMPLETE MAST ARM DMPLETE MAST ARM	FIXTURE TAG F1 F2 F2	4 7 F0 F0 F0	TURE CONTI A NC A NC B NC B NC B NC	FO FO #78 #78 RECEPTACLE ROLLER CIRCUI DNE NONE 2 E DNE NONE 2 F DNE NONE 2 F DNE NONE 2 F	FO FO FO	<u>кечер NC</u> кечер NC 1. арряс WITH	HTES:	TON OF NEW	S.	#80 #80	
IUMBER I74+04.90 #42 174+35.89 #43 175+05.00 #45 175+14.47 #46 175+90.57 #47 176+45.49 #48 177+12.57 #49 177+48.19	OFFSET 40.48 LT 42.79 LT 40.53 LT 40.64 LT 40.50 LT	LED LUMINAIF ORNAMENTA LED LUMINAIF ORNAMENTA LED LUMINAIF ORNAMENTA LED LUMINAIF ORNAMENTA	ITEM TYPE RE, 45' POLE, 15' I' AL LIGHT UNIT, CC RE, 45' POLE, 15' I' AL LIGHT UNIT, CC RE, 45' POLE, 15' I' AL LIGHT UNIT, CC RE, 45' POLE, 15' I' AL LIGHT UNIT, CC RE, 45' POLE, 15' I' AL LIGHT UNIT, CC	MAST ARM DMPLETE MAST ARM DMPLETE MAST ARM DMPLETE MAST ARM DMPLETE MAST ARM DMPLETE MAST ARM DMPLETE	FIXTURE TAG F1 F2 F1 F2 F1 F2 F1 F2 F1 F2 F1 F2 F1 F2 F1 F2 F1 F2 F1 F2 F1 F2 F1 F2 F1 F2 F1 F2 F2	4 7 F0 F0 F0	TURE CONTI A NC A S B NC B NC B NC B NC B NC B NC B NC	F0 F0 #78 #78 RECEPTACLE ROLLER CIRCUI DNE NONE 2 E DNE NONE 2 F DNE NONE 2 F	FO FO FO	<u>ке уер мс</u> ке уер мс 1. арряс with 2. LiGHT	#79 #79 	ION OF NEW REQUIREMENT R, BASE MOU	S. JNTED, 240 V	10 € 10 #80 VICE DROP. CC OLT, 100 AMP	
UMBER STATION #42 174+04.90 #43 174+35.89 #44 175+05.00 #45 175+14.47 #46 175+90.57 #47 176+45.49 #48 177+12.57 #49 177+48.19 #50 178+08.24 #51 178+40.00	OFFSET 40.48 LT 42.79 LT 40.64 LT 40.62 LT 40.62 LT 40.23 LT 40.12 LT	LED LUMINAIF ORNAMENTA LED LUMINAIF ORNAMENTA LED LUMINAIF ORNAMENTA LED LUMINAIF ORNAMENTA LED LUMINAIF ORNAMENTA	ITEM TYPE 32 32 ITEM TYPE 32 32 ITEM TYPE 32 44 11GHT UNIT, CC 32 45 12 12 12 12 12 12 12 12 12 12	MAST ARM DMPLETE MAST ARM DMPLETE MAST ARM DMPLETE MAST ARM DMPLETE MAST ARM DMPLETE MAST ARM DMPLETE MAST ARM DMPLETE MAST ARM DMPLETE	FIXTURE TAG F1 F2 F2	4 7 F0 F0 F0	TURE TURE CONTINUES CONTIN	RECEPTACLE ROLLER CIRCUI DNE NONE 2 F DNE NONE 2 F DNE NONE 2 F DNE NONE 2 F DNE NONE 2 F DNE NONE 2 F DNE NONE 2 F	FO FO FO	<u>кЕҮЕД NC</u> <u>кЕҮЕД NC</u> <u>ке</u> <u>ке</u> #79 #79 DIES: # DIMATE LOCAT AMEREN FOR I NG CONTROLLE RIC SERVICE IN 2 AND (1)#4 IN	ION OF NEW REQUIREMENT R, BASE MOU STALLATION 2" PVC CON	S. JNTED, 240 V PER SHEET 7 NDUIT	#80 #80 VICE DROP. CC OLT, 100 AMP 4 PROVIDE	
NUMBER STATION #42 174+04.90 #43 174+35.89 #44 175+05.00 #45 175+14.47 #46 175+90.57 #47 176+45.49 #48 177+12.57 #49 177+48.19 #50 178+08.24 #51 178+40.00 #76 173+75.76	OFFSET 40.48 LT 42.79 LT 40.64 LT 40.62 LT 40.62 LT 40.23 LT 40.12 LT 41.08 RT	LED LUMINAIF ORNAMENTA LED LUMINAIF ORNAMENTA LED LUMINAIF ORNAMENTA LED LUMINAIF ORNAMENTA LED LUMINAIF ORNAMENTA LED LUMINAIF ORNAMENTA	ITEM TYPE RE, 45' POLE, 15' I AL LIGHT UNIT, CC RE, 45' POLE, 15' I RE, 45' POLE, 15'	MAST ARM OMPLETE MAST ARM OMPLETE MAST ARM OMPLETE MAST ARM OMPLETE MAST ARM OMPLETE MAST ARM OMPLETE MAST ARM OMPLETE MAST ARM OMPLETE MAST ARM	FIXTURE TAG F1 F2 F2	4 7 F0 F0 F0	TURE CIRCUIT CONTI A NCA B NCO	RECEPTACLE ROLLER CIRCUI DNE NONE 2 E DNE NONE 2 F DNE NONE 2 F	FO FO FO	<u>KEYED NC</u> <u>KEYED NC <u>KEYED NC</u> <u>KEYED NC <u>KEYED NC</u> <u>KEYED NC <u>KEYED NC</u> <u>KEYED NC</u> <u>KEYED NC</u> <u>KEYED NC</u> <u>KEYED NC</u> <u>KEYED NC</u> <u>KEYED NC</u> <u>KEYED</u></u></u></u>	TES:	TION OF NEW REQUIREMENT R, BASE MOU JSTALLATION 2" PVC CON (2)#3 WITH (S. JNTED, 240 V PER SHEET 7 NDUIT 1) #3 GND IN	VICE DROP. CC VICE DROP. CC VICIT, 100 AMP 4 PROVIDE 4" CONDUIT.	
NUMBER STATION #42 174+04.90 #43 174+35.89 #44 175+05.00 #45 175+14.47 #46 175+90.57 #47 176+45.49 #48 177+12.57 #49 177+48.19 #50 178+08.24 #51 178+40.00 #76 173+75.76 #77 174+49.46	OFFSET 40.48 LT 42.79 LT 40.48 LT 40.53 LT 40.62 LT 40.56 LT 40.23 LT 40.12 LT 41.10 RT	LED LUMINAIF ORNAMENTA LED LUMINAIF ORNAMENTA LED LUMINAIF ORNAMENTA LED LUMINAIF ORNAMENTA LED LUMINAIF ORNAMENTA ORNAMENTA ORNAMENTA	ITEM TYPE RE, 45' POLE, 15' I AL LIGHT UNIT, CC RE, 45' POLE, 15' I AL LIGHT UNIT, CC AL LIGHT UN	MAST ARM OMPLETE MAST ARM OMPLETE MAST ARM OMPLETE MAST ARM OMPLETE MAST ARM OMPLETE MAST ARM OMPLETE MAST ARM OMPLETE MAST ARM OMPLETE MAST ARM OMPLETE OMPLETE OMPLETE	FIXTURE TAG F1 F2 F2	4 7 F0 F0 F0	TURE CIRCUIT CONTI A NC B NC B NC B NC B NC B NC B NC B NC C C	RECEPTACLE ROLLER CIRCUI DNE NONE 2 E DNE NONE 2 F DNE NO	FO FO FO	<u>КЕҮЕ</u> NC <u>кеүе</u> NC <u>ке</u> NC <u></u>	TES: #79 #79 #79 #79 #79 #79 #70 #70 #70 #70 #70 #70 #70 #70	TON OF NEW REQUIREMENT REQUIREMENT R, BASE MOU ISTALLATION 2" PVC CON (2)#3 WITH (AND (2)#4 S, AND (2)#4	S. JNTED, 240 V PER SHEET 7 NDUIT (1) #3 GND IN FOR RECEPTA FOR RECEPT	VICE DROP. CC VICE DROP. CC VICIT, 100 AMP 4 PROVIDE 4" CONDUIT. CLES WITH (1) ACLES WITH (1)	#4 GND) #4 GND
UMBER STATION #42 174+04.90 #43 174+35.89 #44 175+05.00 #45 175+14.47 #46 175+90.57 #47 176+45.49 #48 177+12.57 #49 177+48.19 #50 178+08.24 #51 178+0.00 #76 173+75.76 #77 174+49.46 #78 175+32.82	OFFSET 40.48 LT 42.79 LT 40.64 LT 40.62 LT 40.62 LT 40.23 LT 40.12 LT 41.08 RT	LED LUMINAIF ORNAMENTA LED LUMINAIF ORNAMENTA LED LUMINAIF ORNAMENTA LED LUMINAIF ORNAMENTA LED LUMINAIF ORNAMENTA ORNAMENTA ORNAMENTA ORNAMENTA	ITEM TYPE RE, 45' POLE, 15' I AL LIGHT UNIT, CC RE, 45' POLE, 15' I RE, 45' POLE, 15'	MAST ARM OMPLETE MAST ARM OMPLETE MAST ARM OMPLETE MAST ARM OMPLETE MAST ARM OMPLETE MAST ARM OMPLETE MAST ARM OMPLETE MAST ARM OMPLETE OMPLETE OMPLETE OMPLETE OMPLETE	FIXTURE TAG F1 F2 F2	4 7 F0 F0 F0	TURE CONTI A NC B NC B NC B NC B NC B NC B NC B NC B	RECEPTACLE ROLLER CIRCUI DNE NONE 2 E DNE NONE 2 F DNE NONE 2 F	FO FO FO	<u>КЕҮЕ</u> NC <u>кеүе</u> NC <u>ке</u> NC <u></u>	TES: # TTES: # TTES	TON OF NEW REQUIREMENT REQUIREMENT R, BASE MOU ISTALLATION 2" PVC CON (2)#3 WITH (AND (2)#4 S, AND (2)#4	S. JNTED, 240 V PER SHEET 7 NDUIT (1) #3 GND IN FOR RECEPTA FOR RECEPT	VICE DROP. CC VICE DROP. CC VICIT, 100 AMP 4 PROVIDE 4" CONDUIT. CLES WITH (1) ACLES WITH (1)	#4 GND) #4 GND
UMBER STATION #42 174+04.90 #43 174+35.89 #44 175+05.00 #45 175+14.47 #46 175+90.57 #47 176+45.49 #48 177+12.57 #49 177+48.19 #50 178+08.24 #51 178+04.00 #76 173+75.76 #77 174+49.46 #78 175+32.82 #79 176+16.94 #80 176+96.01	OFFSET 40.48 LT 42.79 LT 40.53 LT 40.64 LT 40.53 LT 40.62 LT 40.62 LT 40.53 LT 40.53 LT 40.64 LT 40.52 LT 40.52 LT 40.52 LT 40.52 LT 40.52 LT 40.52 LT 40.72 LT 41.08 RT 41.10 RT 41.07 RT 41.07 RT	LED LUMINAIF ORNAMENTA LED LUMINAIF ORNAMENTA LED LUMINAIF ORNAMENTA LED LUMINAIF ORNAMENTA CORNAMENTA ORNAMENTA ORNAMENTA ORNAMENTA ORNAMENTA ORNAMENTA ORNAMENTA	PO-1 Clip 200 PO-1 Clip 200 ITEM TYPE RE, 45' POLE, 15' I RE, 45' POLE, 15' I Clip 200 RE	MAST ARM OMPLETE MAST ARM OMPLETE MAST ARM OMPLETE MAST ARM OMPLETE	FIXTURE TAG F1 F2 F1 F1 F2 F1 F2 F1 F2 F1 F1 F2 F1 F1 F2 F1 F1 F2 F1 F1 F2 F1 F1 F2 F1 F1 F2 F1 F1 F2 F1 F1 F2 F1 F1 F2 F1 F1 F2 F1 F1 F2 F1 F1 F2 F1 F1 F2 F1 F1 F2 F1 F1 F2 F1 F1 F2 F1 F1 F2 F1 F2 F1 F2 F1 F2 F1 F2 F1 F2 F1 F2 F1 F2 F1 F2 F1 F2 F1 F2 F1 F2 F2 F1 F2 F2 F2 F2 F2 F2 F2 F2 F2 F2	4 7 F0 F0 F0	TURE CONTI A NC B NC B NC B NC B NC B NC B NC B NC B	FO FO FO FO FO FO FO FO FO FO	FO FO FO	<u>КЕҮЕ</u> NC <u>кеүе</u> NC <u>ке</u> NC <u></u>	TES: #79 #79 #79 #79 #79 #79 #70 #70 #70 #70 #70 #70 #70 #70	TON OF NEW REQUIREMENT REQUIREMENT R, BASE MOU ISTALLATION 2" PVC CON (2)#3 WITH (AND (2)#4 S, AND (2)#4	S. JNTED, 240 V PER SHEET 7 NDUIT (1) #3 GND IN FOR RECEPTA FOR RECEPT	VICE DROP. CC VICE DROP. CC VICIT, 100 AMP 4 PROVIDE 4" CONDUIT. CLES WITH (1) ACLES WITH (1)	#4 GND) #4 GND
UMBER STATION #42 174+04.90 #43 174+35.89 #44 175+05.00 #45 175+14.47 #46 175+90.57 #47 176+45.49 #48 177+12.57 #49 177+48.19 #50 178+08.24 #51 178+0.00 #76 173+75.76 #77 174+9.46 #78 175+32.82 #79 176+16.94 #80 176+96.01	OFFSET 40.48 LT 42.79 LT 40.64 LT 40.50 LT 40.62 LT 40.62 LT 40.62 LT 40.62 LT 40.12 LT 41.10 RT 41.10 RT 41.07 RT 41.07 RT 41.20 RT 41.20 RT	LED LUMINAIF ORNAMENTA DORNAMENTA LED LUMINAIF ORNAMENTA LED LUMINAIF ORNAMENTA LED LUMINAIF ORNAMENTA ORNAMENTA ORNAMENTA ORNAMENTA ORNAMENTA ORNAMENTA ORNAMENTA	PO PO PO <	MAST ARM DMPLETE MAST ARM DMPLETE MAST ARM DMPLETE MAST ARM DMPLETE MAST ARM DMPLETE MAST ARM DMPLETE MAST ARM DMPLETE DMPLETE DMPLETE DMPLETE DMPLETE DMPLETE DMPLETE DMPLETE DMPLETE DMPLETE DMPLETE	FIXTURE TAG F1 F2 F2	4 7 F0 F0 F0	TURE CONTI A NC B NC B NC B NC B NC B NC B NC B NC B	FO FO FO FO FO FO FO FO FO FO	FO FO FO	<u>КЕҮЕ</u> NC <u>кеүе</u> NC <u>ке</u>	TES: #79 #79 #79 #79 #79 #79 #70 #70 #70 #70 #70 #70 #70 #70	TON OF NEW REQUIREMENT REQUIREMENT R, BASE MOU ISTALLATION 2" PVC CON (2)#3 WITH (AND (2)#4 S, AND (2)#4	S. JNTED, 240 V PER SHEET 7 NDUIT (1) #3 GND IN FOR RECEPTA FOR RECEPT	VICE DROP. CC VICE DROP. CC VICIT, 100 AMP 4 PROVIDE 4" CONDUIT. CLES WITH (1) ACLES WITH (1)	#4 GND) #4 GND
UMBER STATION #42 174+04.90 #43 174+35.89 #44 175+05.00 #45 175+14.47 #46 175+90.57 #47 176+45.49 #48 177+12.57 #49 177+48.19 #50 178+08.24 #51 178+04.00 #76 173+75.76 #77 174+49.46 #78 175+32.82 #79 176+16.94 #80 176+96.01	OFFSET 40.48 LT 42.79 LT 40.64 LT 40.50 LT 40.62 LT 40.62 LT 40.62 LT 40.62 LT 40.12 LT 41.10 RT 41.10 RT 41.07 RT 41.07 RT 41.20 RT 41.20 RT	LED LUMINAIF ORNAMENTA LED LUMINAIF ORNAMENTA LED LUMINAIF ORNAMENTA LED LUMINAIF ORNAMENTA CORNAMENTA ORNAMENTA ORNAMENTA ORNAMENTA ORNAMENTA ORNAMENTA ORNAMENTA	PO-1 Clip 200 PO-1 Clip 200 ITEM TYPE RE, 45' POLE, 15' I RE, 45' POLE, 15' I Clip 200 RE	MAST ARM OMPLETE MAST ARM OMPLETE MAST ARM OMPLETE MAST ARM OMPLETE MAST ARM OMPLETE MAST ARM OMPLETE MAST ARM OMPLETE	FIXTURE TAG F1 F2 F1 F2 F1 F2 F1 F2 F1 F2 F1 F2 F1 F2 F1 F2 F1 F2 F1 F2 F1 F2 F1 MC K	4 7 F0 F0 F0 F0	TURE CONTI A NC B NC B NC B NC B NC B NC B NC B NC B	FO FO FO FO FO FO FO FO FO FO		KEYED NC 1. APPR WITH 2. LIGHT 3. ELECT (2)#2 4. (4)#11 5. (2)#8 6. (2)#10	TES: #79 #79 #79 #79 #77 #77 #77 #77	TON OF NEW REQUIREMENT REQUIREMENT R, BASE MOU ISTALLATION 2" PVC CON (2)#3 WITH (AND (2)#4 S, AND (2)#4	S. JNTED, 240 V PER SHEET 7 NDUIT (1) #3 GND IN FOR RECEPTA FOR RECEPT	VICE DROP. CC VICE DROP. CC VICIT, 100 AMP 4 PROVIDE 4" CONDUIT. CLES WITH (1) ACLES WITH (1)) #4 GND II) #3 GND) #3 GND
UMBER STATION #42 174+04.90 #43 174+35.89 #44 175+05.00 #45 175+14.47 #46 175+90.57 #47 176+45.49 #48 177+12.57 #49 177+48.19 #50 178+08.24 #51 178+04.00 #76 173+75.76 #77 174+49.46 #78 175+32.82 #79 176+16.94 #80 176+96.01	OFFSET 40.48 LT 42.79 LT 40.53 LT 40.64 LT 40.53 LT 40.64 LT 40.52 LT 40.52 LT 40.53 LT 40.52 LT 40.52 LT 40.52 LT 40.52 LT 40.52 LT 40.52 LT 40.72 LT 41.10 RT 41.10 RT 41.07 RT 41.07 RT 41.20 RT	LED LUMINAIF ORNAMENTA DORNAMENTA LED LUMINAIF ORNAMENTA LED LUMINAIF ORNAMENTA LED LUMINAIF ORNAMENTA ORNAMENTA ORNAMENTA ORNAMENTA ORNAMENTA ORNAMENTA ORNAMENTA	ITEM TYPE RE, 45' POLE, 15' I AL LIGHT UNIT, CC RE, 45' POLE, 15' I AL LIGHT UNIT, CC RE, 45' POLE, 15' I AL LIGHT UNIT, CC RE, 45' POLE, 15' I AL LIGHT UNIT, CC RE, 45' POLE, 15' I AL LIGHT UNIT, CC	MAST ARM OMPLETE MAST ARM OMPLETE MAST ARM OMPLETE MAST ARM OMPLETE MAST ARM OMPLETE MAST ARM OMPLETE MAST ARM OMPLETE OMPLE	FIXTURE TAG F1 F2 F2	4 7 F0 F0 F0	TURE CONTI A NC B NC B NC B NC B NC B NC B NC B NC B	FO FO FO FO FO FO FO FO FO FO		KEYED NC ro	TES: #79 #79 #79 #79 #79 #79 #70 #70 #70 #70 #70 #70 #70 #70	TON OF NEW REQUIREMENT R, BASE MOU USTALLATION 2" PVC CON (2)#3 WITH (AND (2)#4 G, AND (2)#3	S. JNTED, 240 V PER SHEET 7 NDUIT (1) #3 GND IN FOR RECEPTA FOR RECEPT	VICE DROP. CC VICE DROP. CC VICIT, 100 AMP 4 PROVIDE 4" CONDUIT. CLES WITH (1) ACLES WITH (1)) #4 GND II) #4 GND) #3 GND






MOUNTING	DESCRIPTION WAY LIGHTING FIXTURE ASSEMBLY CONSISTING OF A TAPERED ALUMINUM POLE, & 15' LONG CURVED TRUSS ARM WITH AN OVERALL	DISTRIBUTION	APPROXIMATE LUMENS	APPROX. WATTAGE	TYPE	COLOR TEMP	VOLTAGE	REMARKS
MOUNTING					K. WATTAGE TYPE			
ASSEMBL	ING HEIGHT OF 45' WITH A ROADWAY TYPE LIGHTING LUMINAIRE WITH A CAST ALUMINUM POWER-PAD HOUSING, FULL CUT-OFF , AND IES TYPE III DISTRIBUTION. ENTIRE FIXTURE ASSEMBLY SHALL COMPLY WITH IDOT PERFORMANCE SPECIFICATIONS. BLY SHALL BE AS DETAILED ON DRAWINGS.	ROADWAY TYPE III	41,857	388	LED	4,000K	240	
2 TO 24" OVE ALUMINUM	CHTING FIXTURE ASSEMBLY CONSISTING OF A 14' CAST ALUMINUM ORNAMENTAL POLE WITH CAST RAISED FLUTED BASE WITH A 16" DVERALL HEIGHT, TAPERED 6 1/2" TO 4" FLUTED POLE WITH (1) POST TOP MOUNTED ACORN STYLE LUMINAIRE WITH CAST IUM HOUSING, AND PRESSED PRISMATIC GLASS REFLECTOR. LUMINAIRE SHALL HAVE IES TYPE III LUNAR OPTIC LIGHTING BUTION AS REQUIRED. ASSEMBLY SHALL BE AS DETAILED ON THE DRAWINGS.	TYPE III LUNAR OPTIC	1,340	26	LED	4,000K	240	GFCI RECEPTACLE MOUNTED IN POLE, (2) BANNER ARM ON POLES, FUSED ON EACH PHASE, AND ON RECEPTACLE, & FIXED FLAG HOLDER.

CONTRACTOR SHALL PROVIDE PHOTOMETRIC CALCULATIONS FROM THE MANUFACTURER USING A LIGHT LOSS FACTOR OF 0.684 TO THE ENGINEER DURING THE SUBMITTAL PROCESS. ALL PHOTOMETRIC REQUIREMENTS LISTED IN PERFORMANCE REQUIREMENTS ON THE LUMINAIRE PERFORMANCE TABLE SHALL BE MET.



7	USER NAME = IDOTCAD	DESIGNED - BJR	REVISED -					II B	TE. 29	1		F.A.P.	SECTION	COUNTY	TOTAL SHEET SHEETS NO.
		DRAWN - KRS DLC	REVISED -	STATE OF ILLINOIS			110	GHTING				669	16-00045-01-SW	TAZEWELL	155 71
ring	PLOT SCALE = 40.0032 ' / in.	CHECKED - RDC	REVISED -	DEPARTMENT OF TRANSPORTATION			LIG		SUNE	DOLES				CONTRAC	CT NO. 89713
	PLOT DATE = 1/22/2019	DATE – \$DATE	REVISED -		SCALE: 1" = 20'	SHEET 1	OF	F 1 S	SHEETS	STA.	TO STA.		ILLINOIS FED.	AID PROJECT OF	5E2(122)

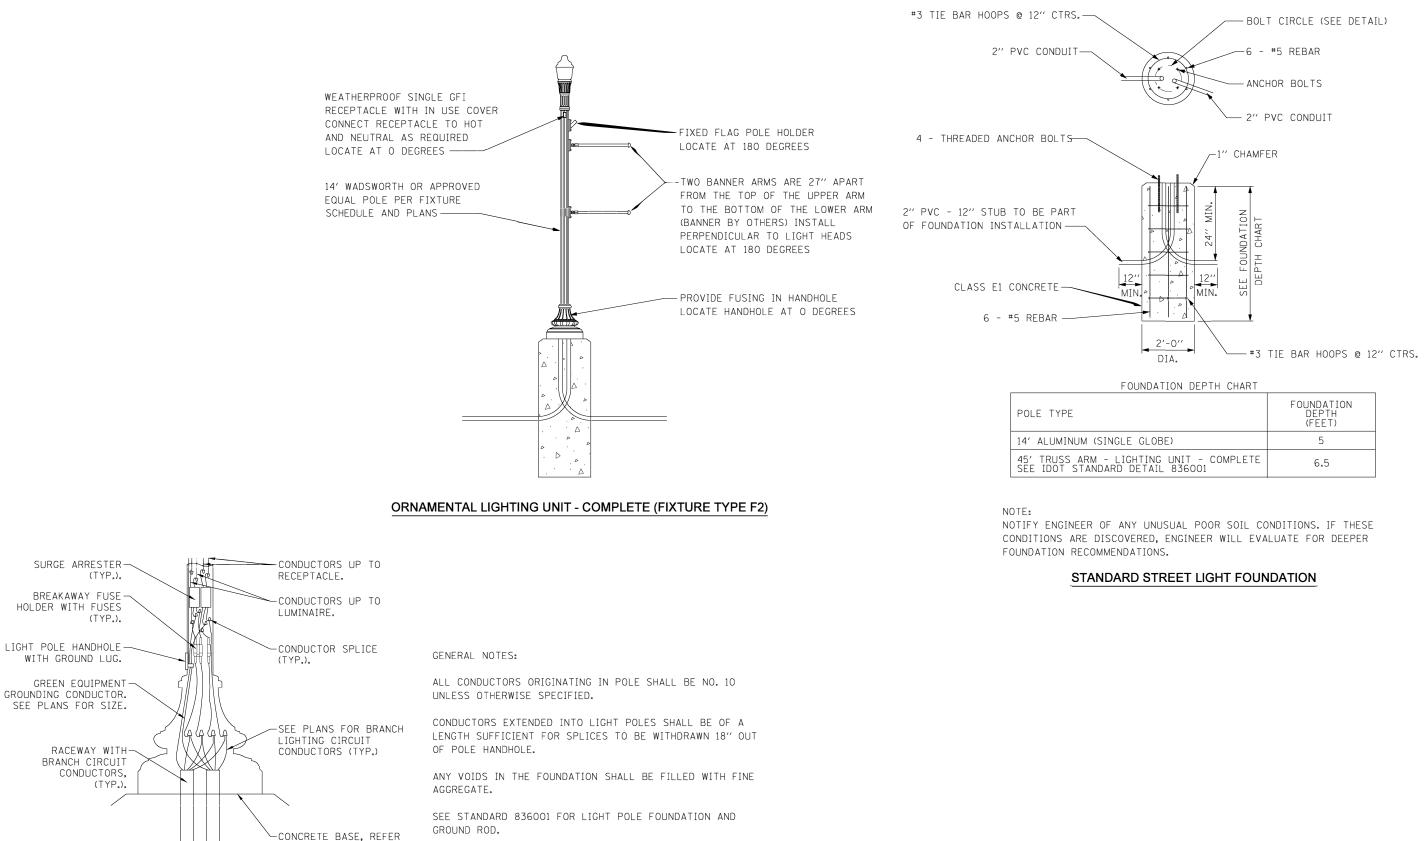

ORNAMENTAL LIGHTING UNIT - COMPLETE (LUMINAIRE WIRING IN POLE)


TO GENERAL NOTES.

DESIGNED -REVISED USER NAME = IDOTCAD КМС MW IL. RTE. 2 STATE OF ILLINOIS DRAWN KRS DLC REVISED LIGHTING DE LOT SCALE = 100.0000 ′⁄ ın. CHECKED RDC REVISED **DEPARTMENT OF TRANSPORTATION** Midwest Engineering NOT TO SCALE DATE PLOT DATE = 1/22/2019 REVISED \$DATF

ALL DIMENSIONS ARE IN INCHES UNLESS OTHERWISE SHOWN.


ILE TYPE	DEPTH (FEET)
ALUMINUM (SINGLE GLOBE)	5
′ TRUSS ARM - LIGHTING UNIT - COMPLETE E IDOT STANDARD DETAIL 836001	6.5


9	F.A.F	P. SECTION			COUNTY		SHEE		HEET		
TAILS	665	9	16-00045-01-SW				TAZEWELL		155		72
							CON	FRAC	T NO.	897	/13
	FED.	ROAD	DIST.	NO.	ILLINOIS	FED.	AID PRO	JECT (D5E2(122)		

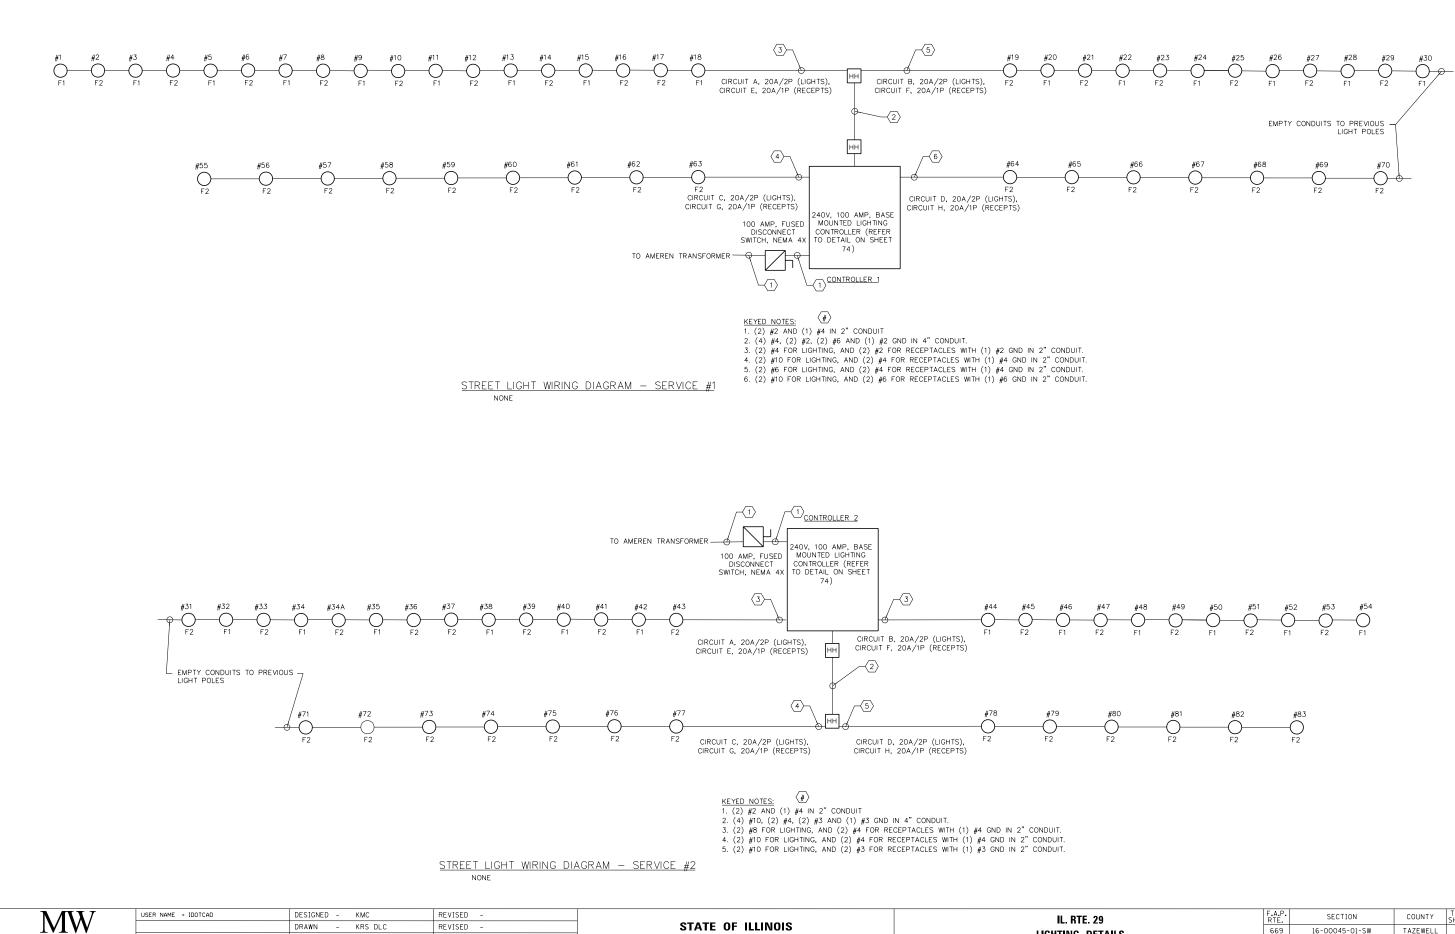

STATE OF ILLINOIS DRAWN - KRS DLC REVISED LIGHTING DE PLOT SCALE = 40.0032 '/ in. CHECKED -RDC REVISED **DEPARTMENT OF TRANSPORTATION** Midwest Engineering PLOT DATE = 1/22/2019 DATE SCALE: 1" = 20' SHEET 1 OF 1 SHEET \$DATE REVISED -

29 ETAILS		F.A.P. RTE.	SECTION	COUNTY	TOTAL SHEETS	SHEET NO.	
		669	16-00045-01-SW	TAZEWELL	155	73	
ETAILS					CONTRAC	T NO. 8	39713
TS	STA.	TO STA.		ILLINOIS FED.	AID PROJECT 058	2(122)	

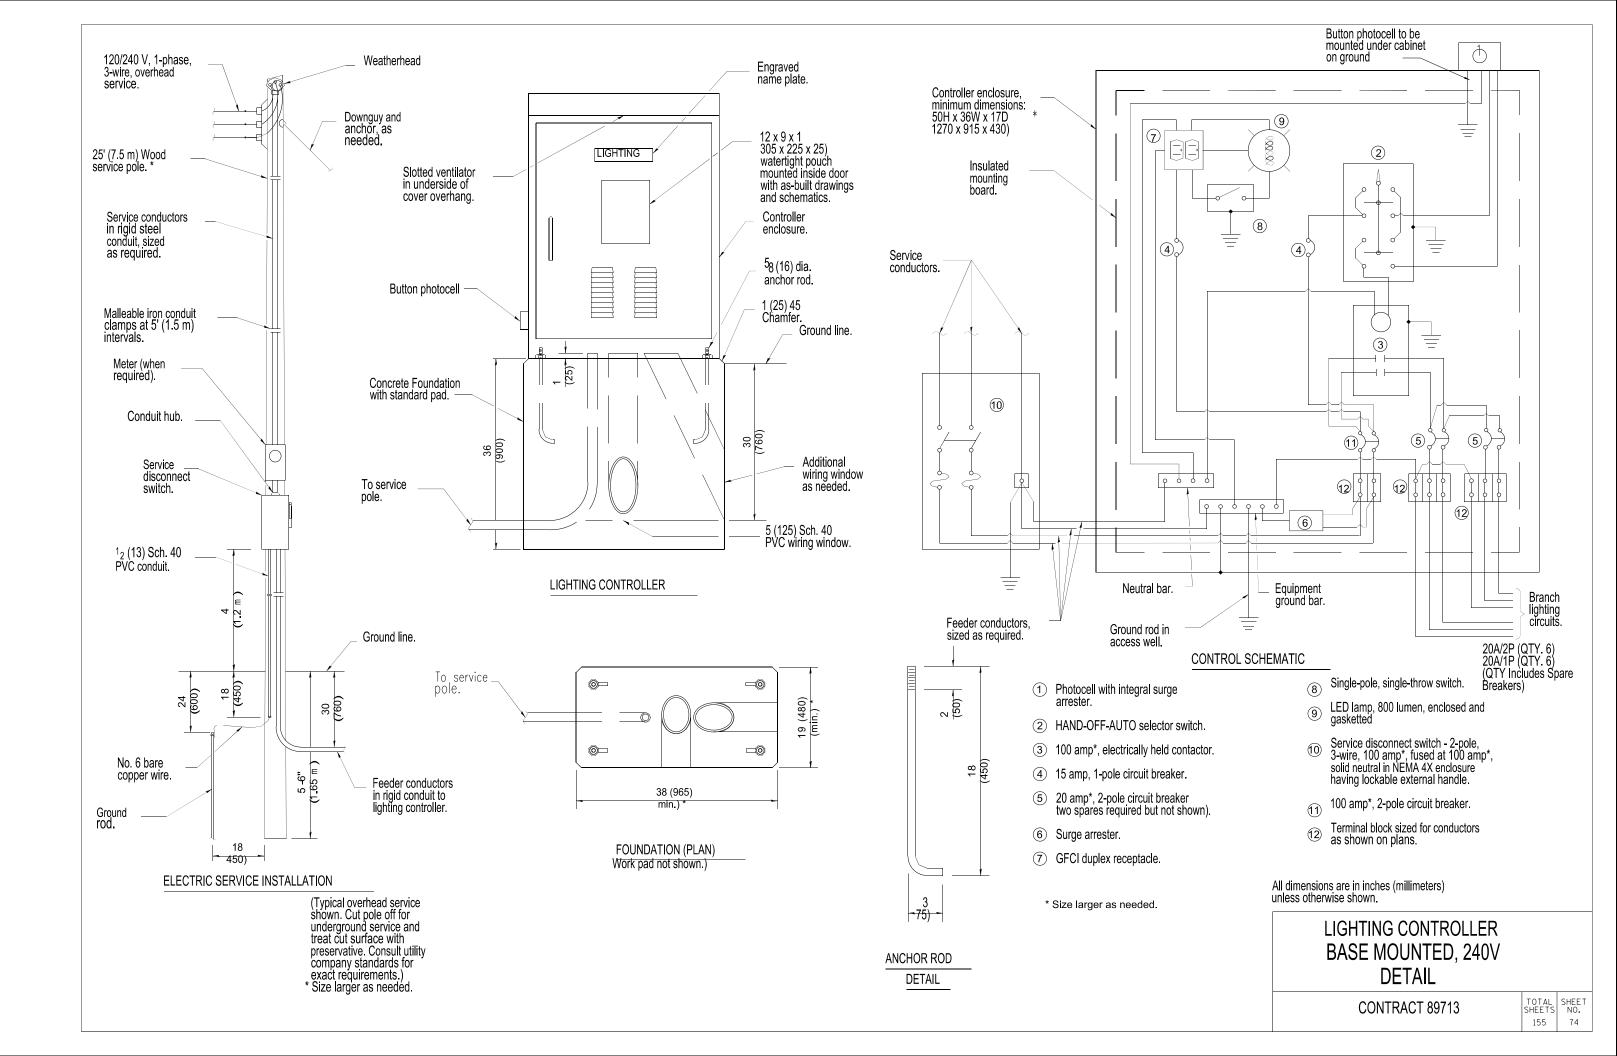

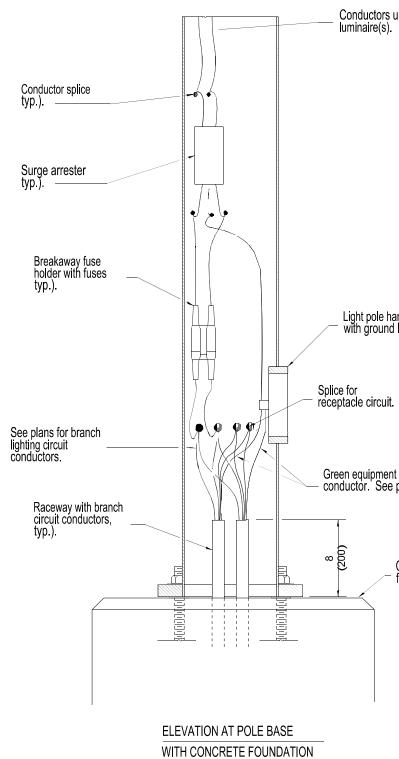



Conductors up to luminaire(s).


Light pole handhole with ground lug.

Green equipment grounding - conductor. See plans for size.


Concrete foundation.				
	GENERAL NOTES			
	All conductors originating in pole shall be No. 10 unless noted otherwise.			
	Conductors extended into light poles shall be of a length sufficient for splices to be withdrawn 18 (450) out of pole handole.			
	Any voids in the foundation shall be filled with fine aggregate.			
	See Standard 836001 for Light Pole Foundation and ground rod.			
	All dimensions are in inches (millimeters) unless otherwise shown.			
	LUMINAIRE WIRING IN POLE			
	DETAIL			
	Contract # 89713	 TOTAL SHEETS 155	SHEET NO. 75	

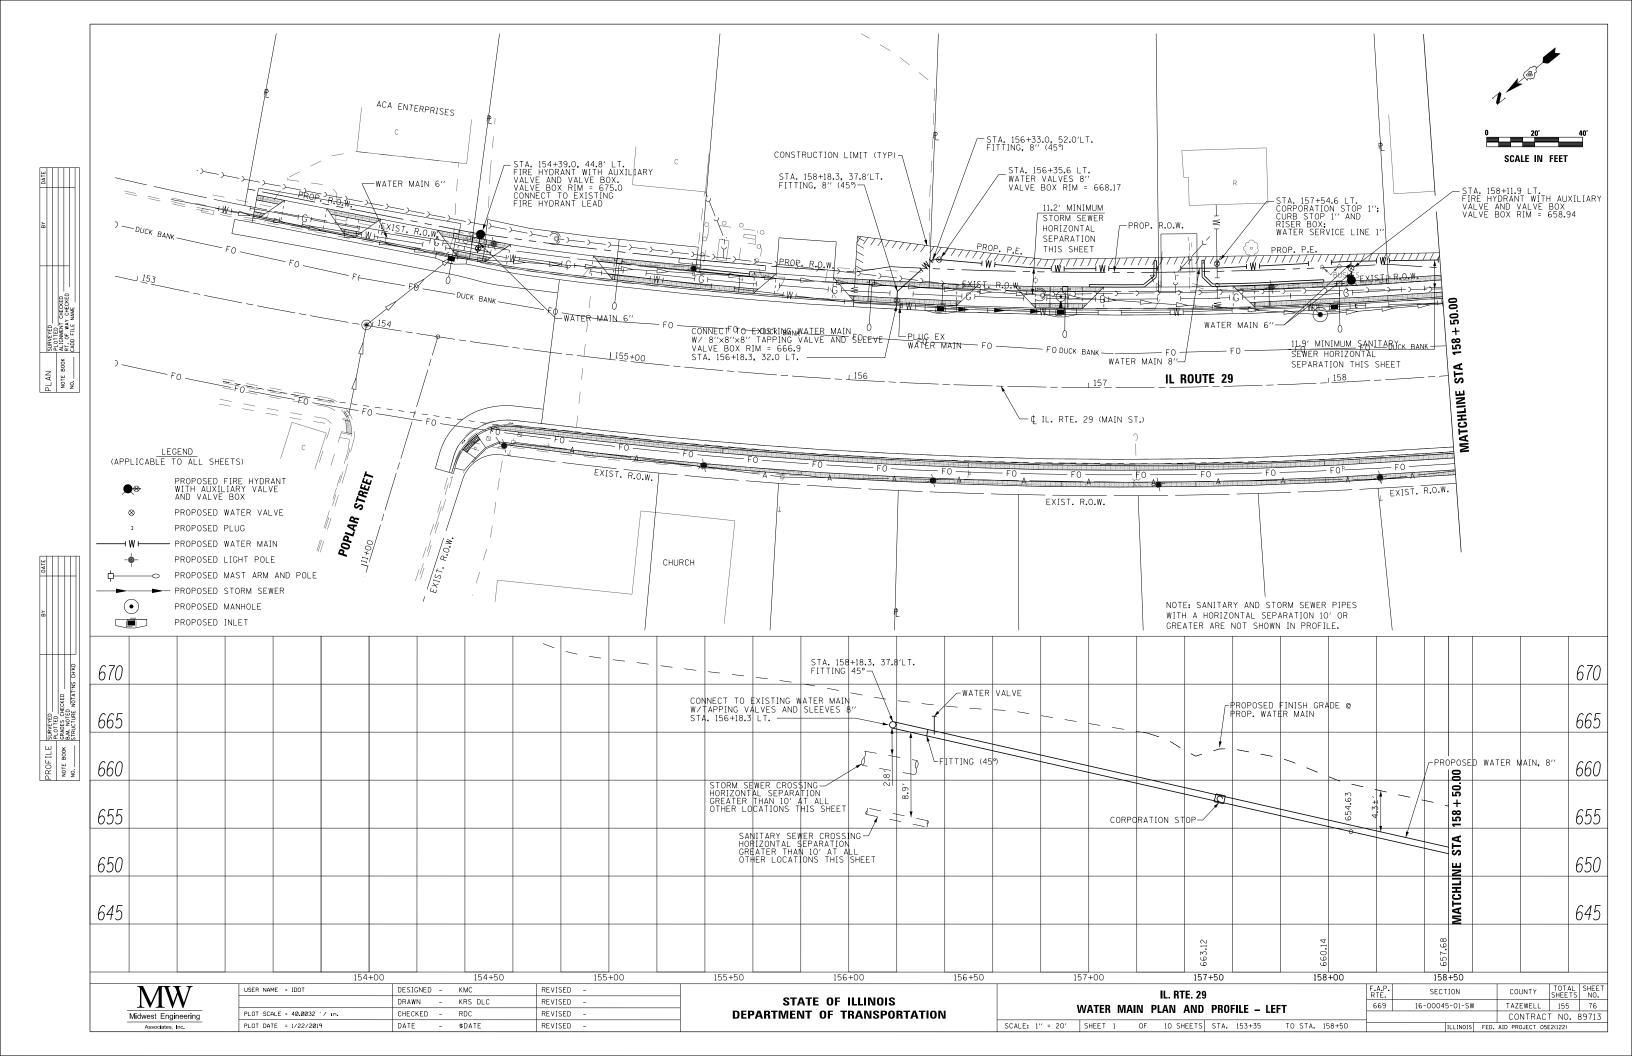


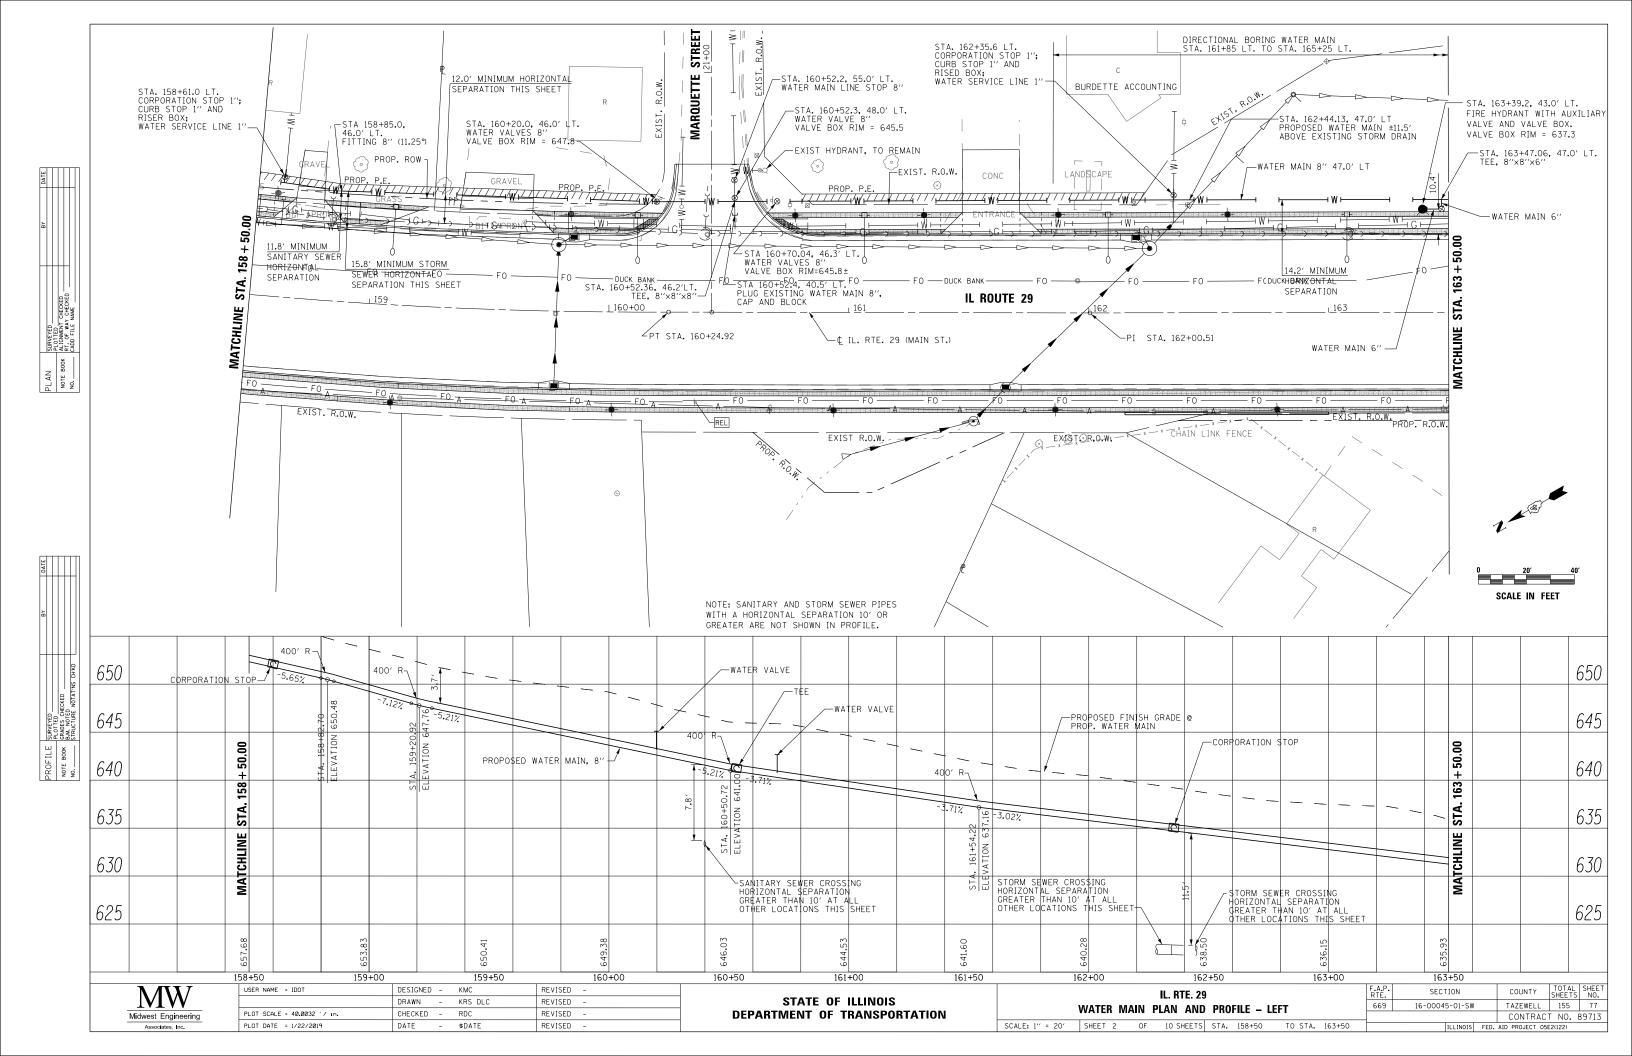


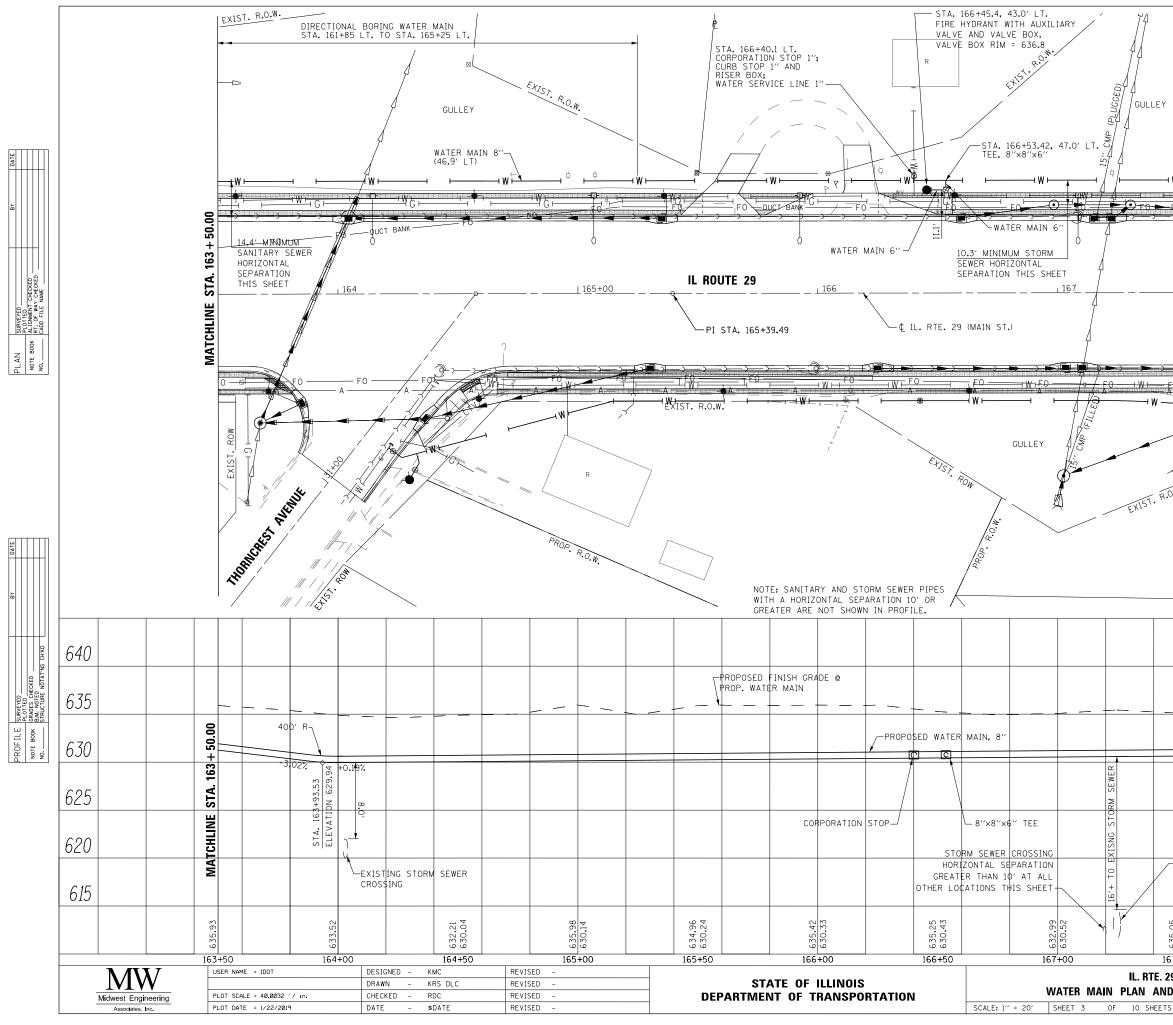


		XXXIIIA	•	20' SCALE IN FEET	40'
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					640
400' R					640 635
	+3.05%	4 1,	3.05 ³⁷		
	+3.05%	4 1,	168+49.38 ATION 632.96 STA. 168 +		635
	+3.05%	4 1,	168+, ATION STA .		635 630
+0.19% 88:72+29 88:72+29 930:29 930 930:29 930 930 930 930 930 930 930 930 930 93	OSSING MRATION	4 1,	168+, ATION STA .		635 630 625
STORM SEWER CR HORIZONTAL SEPA GREATER THAN 10 OTHER LOCATION	OSSING MRATION Y AT ALL S THIS SHEET	4 1,	STA, 168+-		635 630 625 620
+0.19% 80.72 80.72 40.19% 80.72 80.7	OSSING ARATION D' AT ALL	4 1,	168+, ATION STA .	COUNTY TOT SHEE	635 630 625 620 615

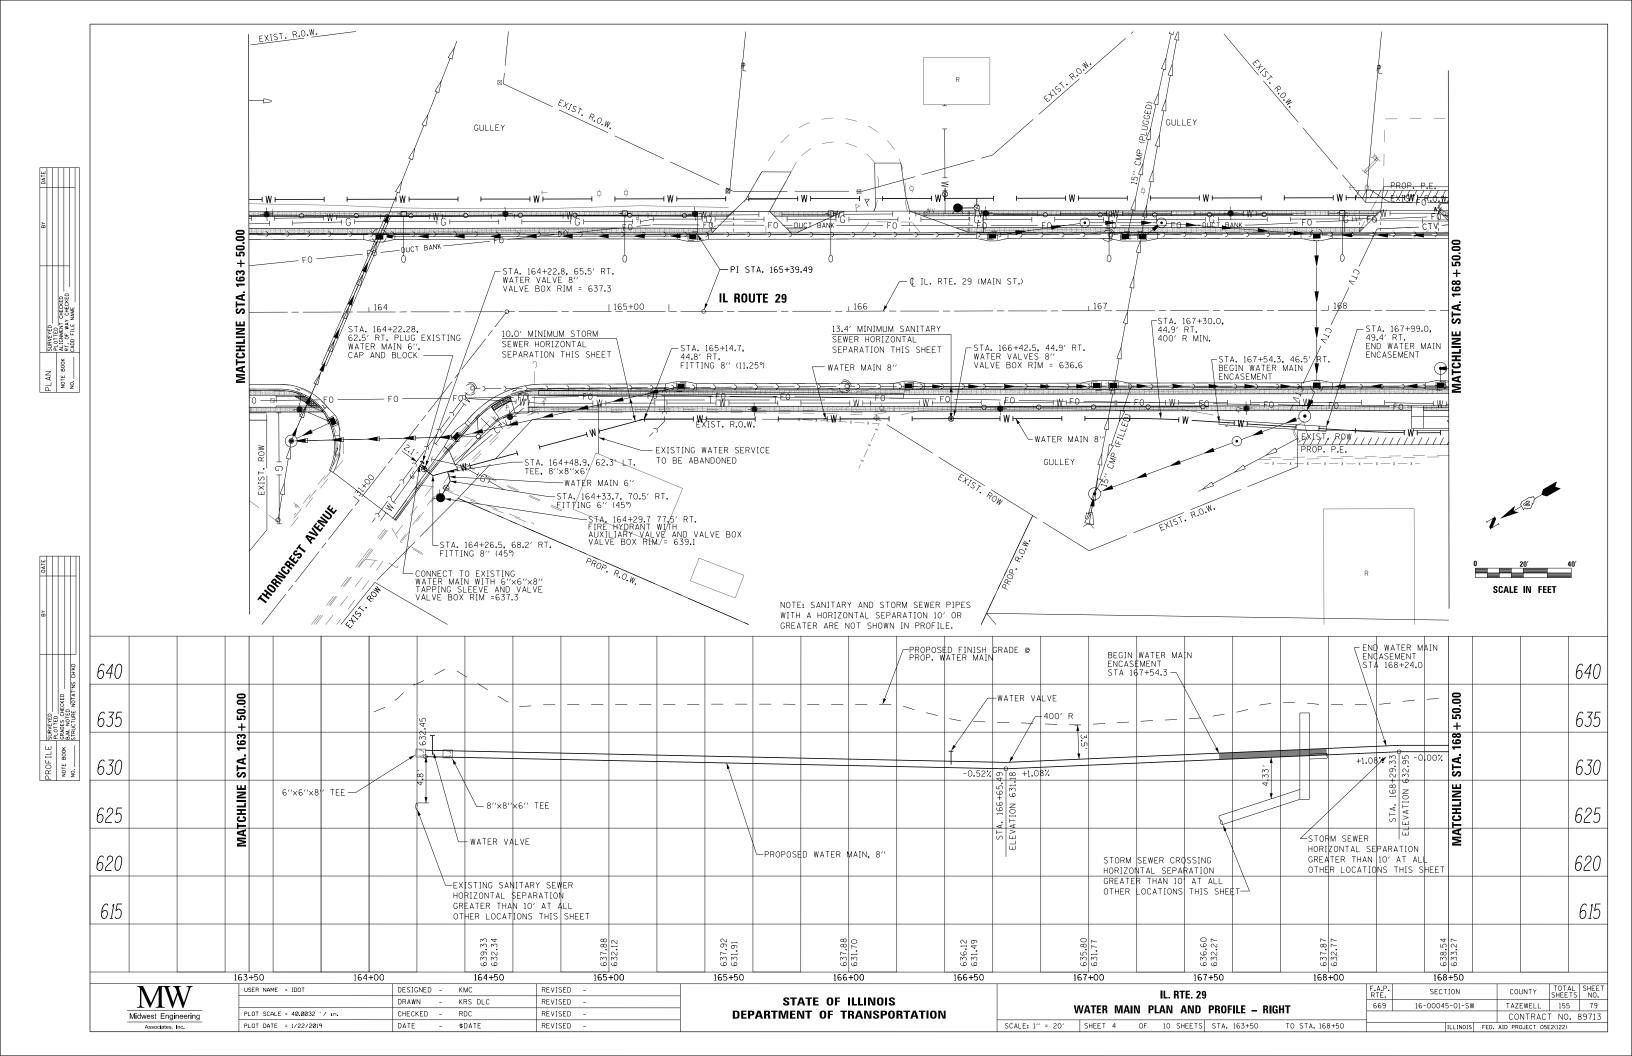


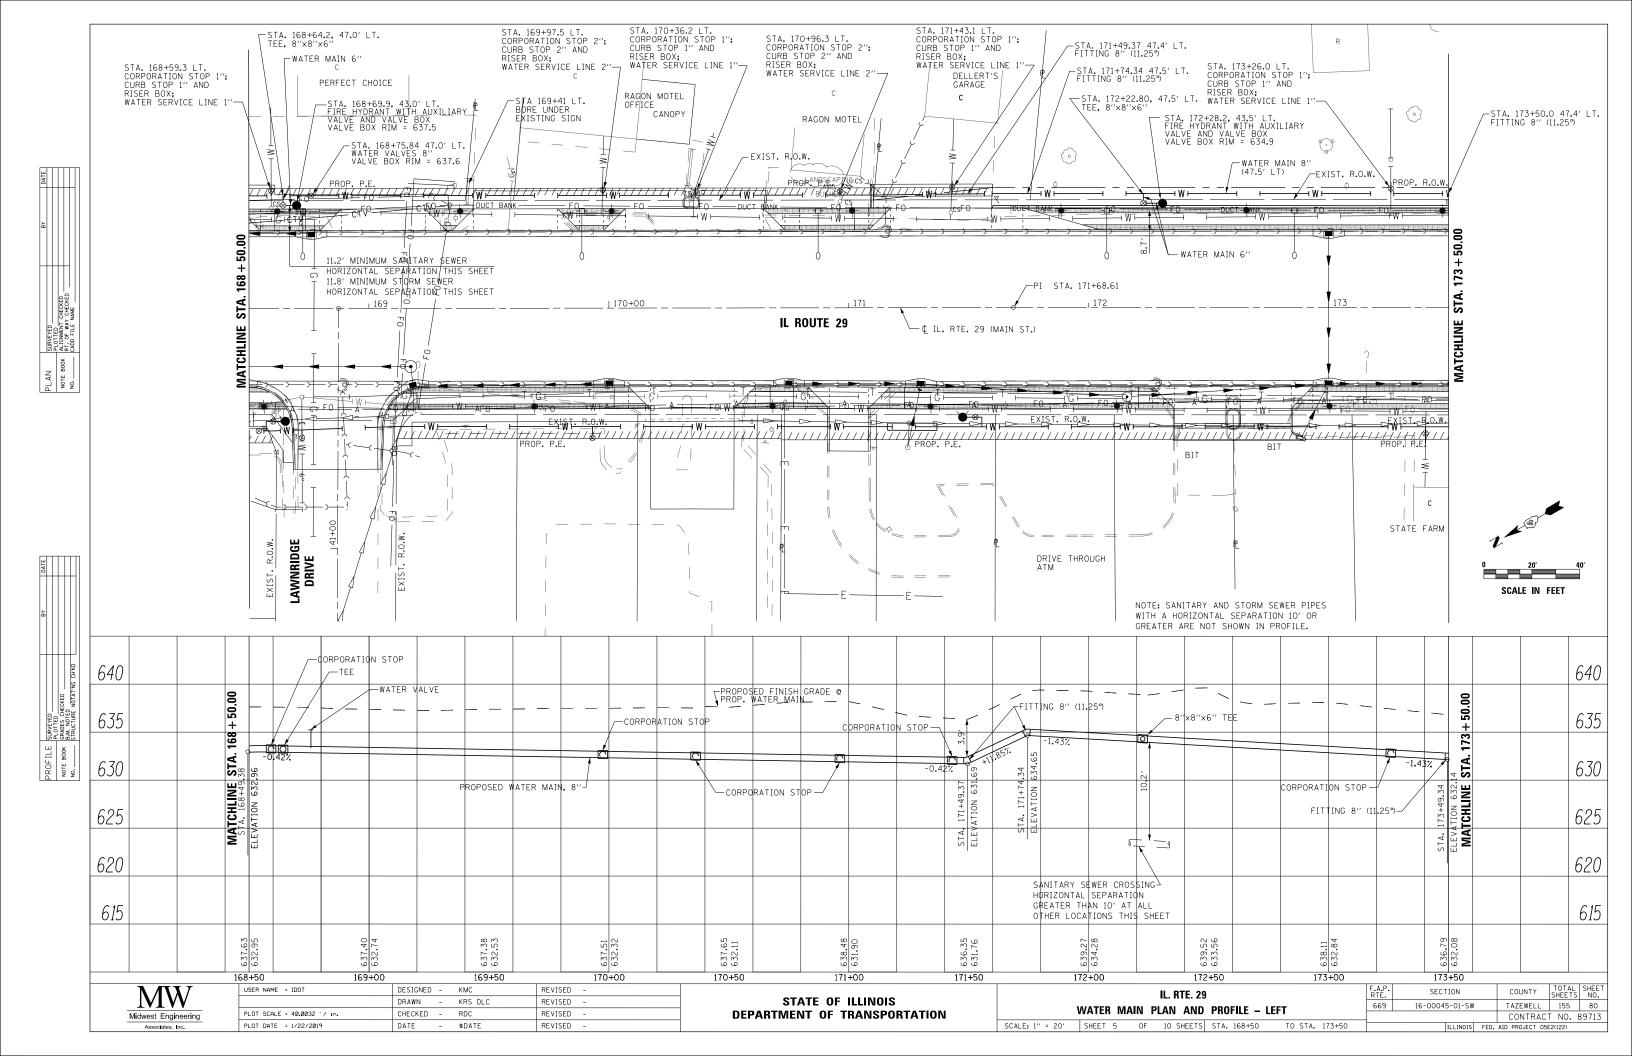


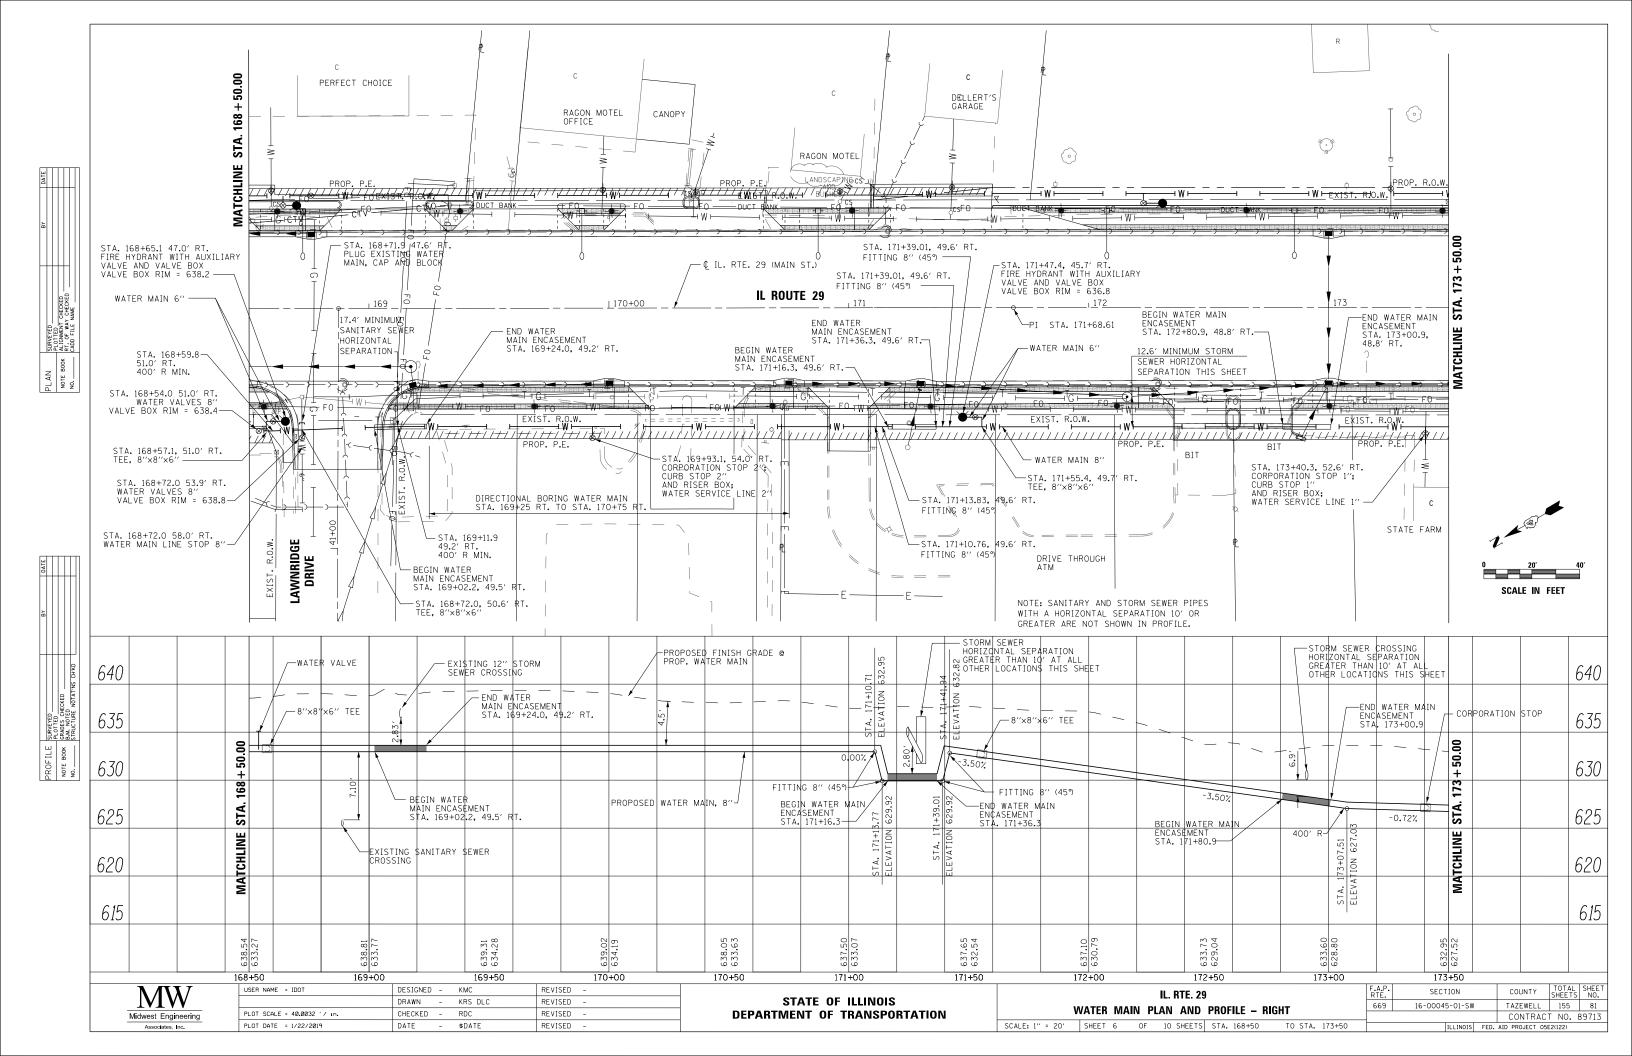

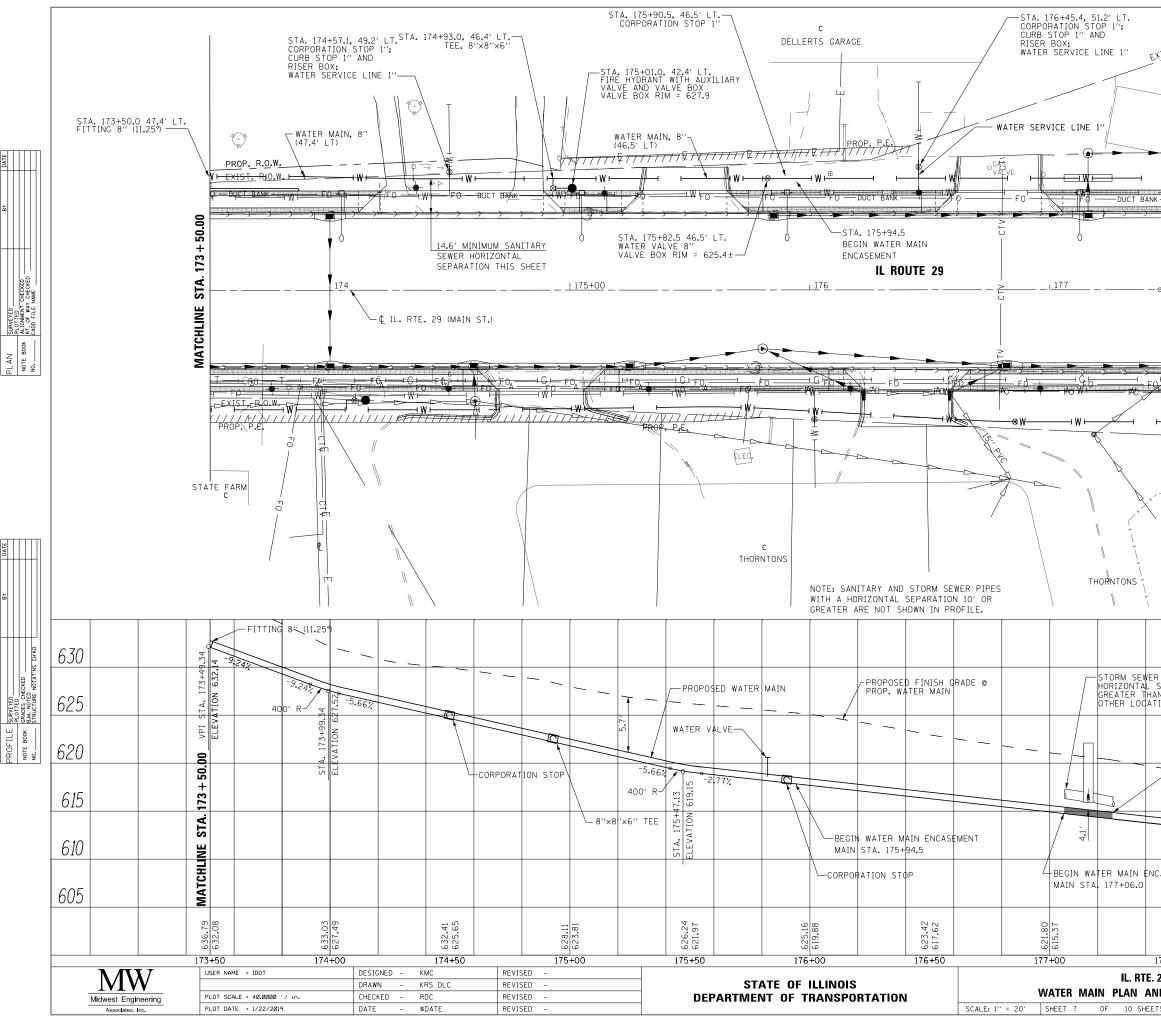



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d		17 <u>8</u>			MATCHLINE STA 178 + 50.00		
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	~~···		ORNE	IRCLE	0	20'	40'
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							630
R SEPARAT N 10' A IONS TH	ION T ALL IS SHEET						625
		TER MAIN EN TA. 177+26.0	CASEMENT		STA. 178 + 50.00		620
/ _							615
		-2.77% 010	-3.14%		MATCHLINE		610
CASEMEN	т	STA. 178+04.53			MA		605
619.33 614.54		616.23 612.22 612.2EEV		614.54	510.58		
177+50		178+00	F.A.P. RTE.	178- SECTI	+50	COUNTY	TOTAL SHEET SHEETS NO.
	FILE – LEFT		RTE. 669	16-00045		TAZEWELL	SHEETS NO. 155 82 T NO. 89713
TS STA.	173+50 TO	STA. 178+50		I	LLINOIS FI	ED. AID PROJECT O	

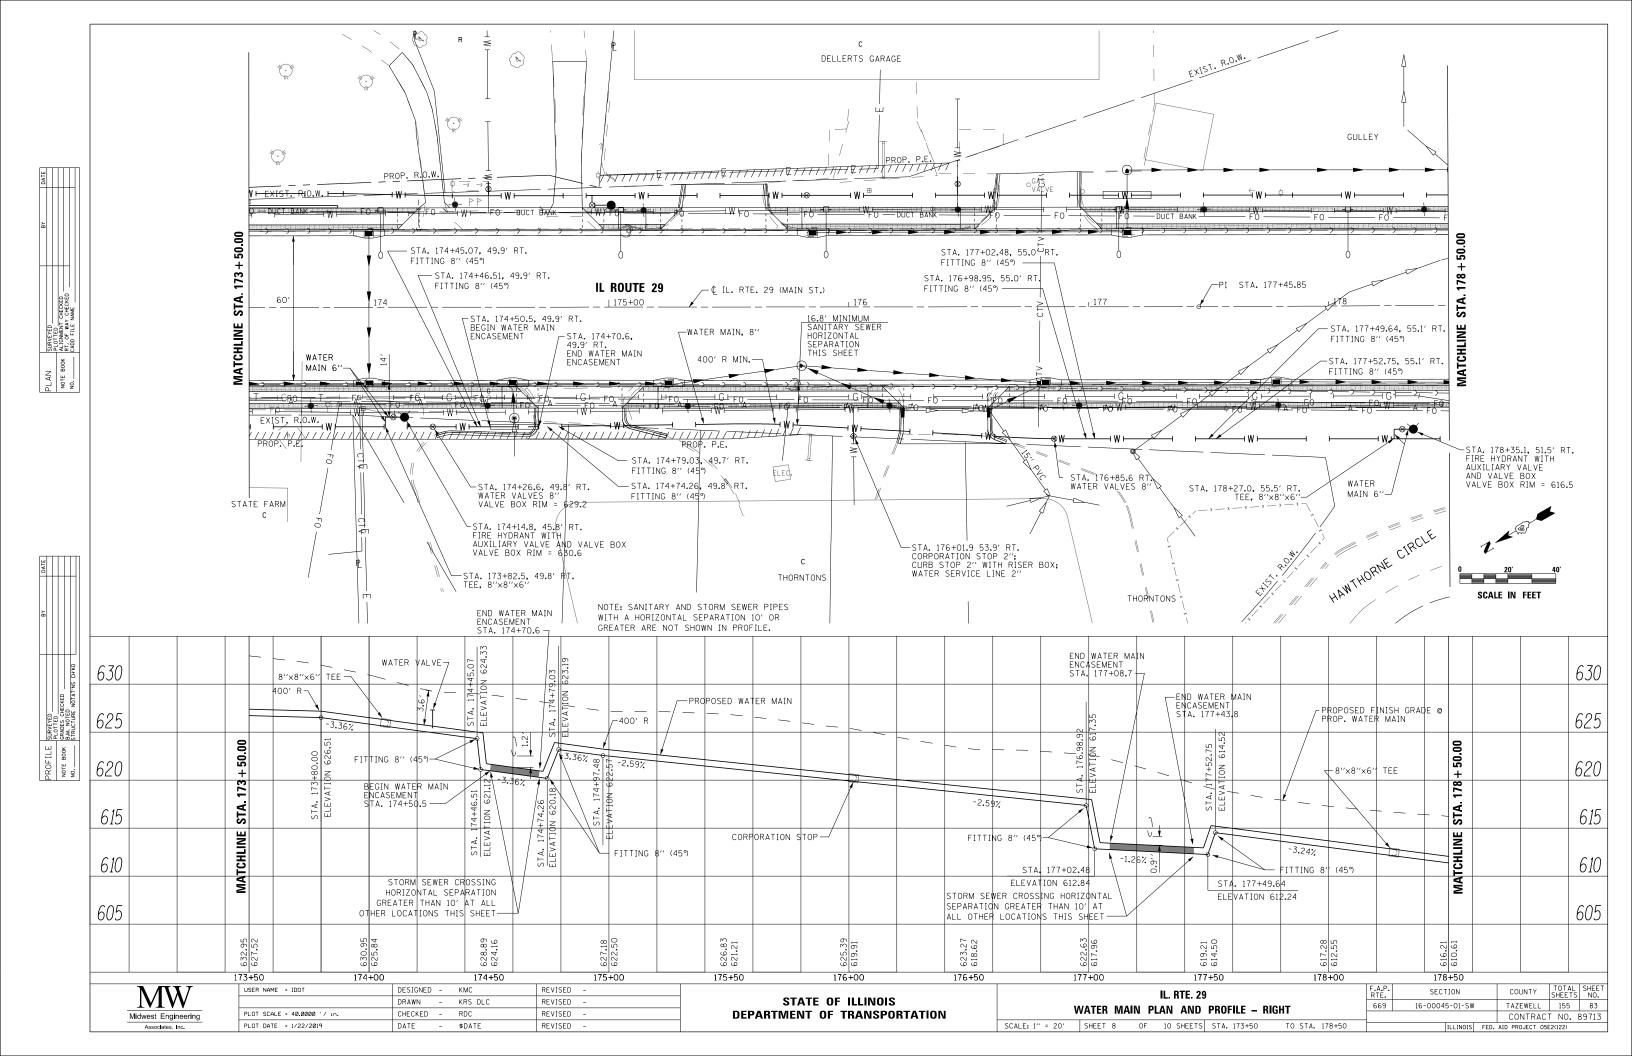


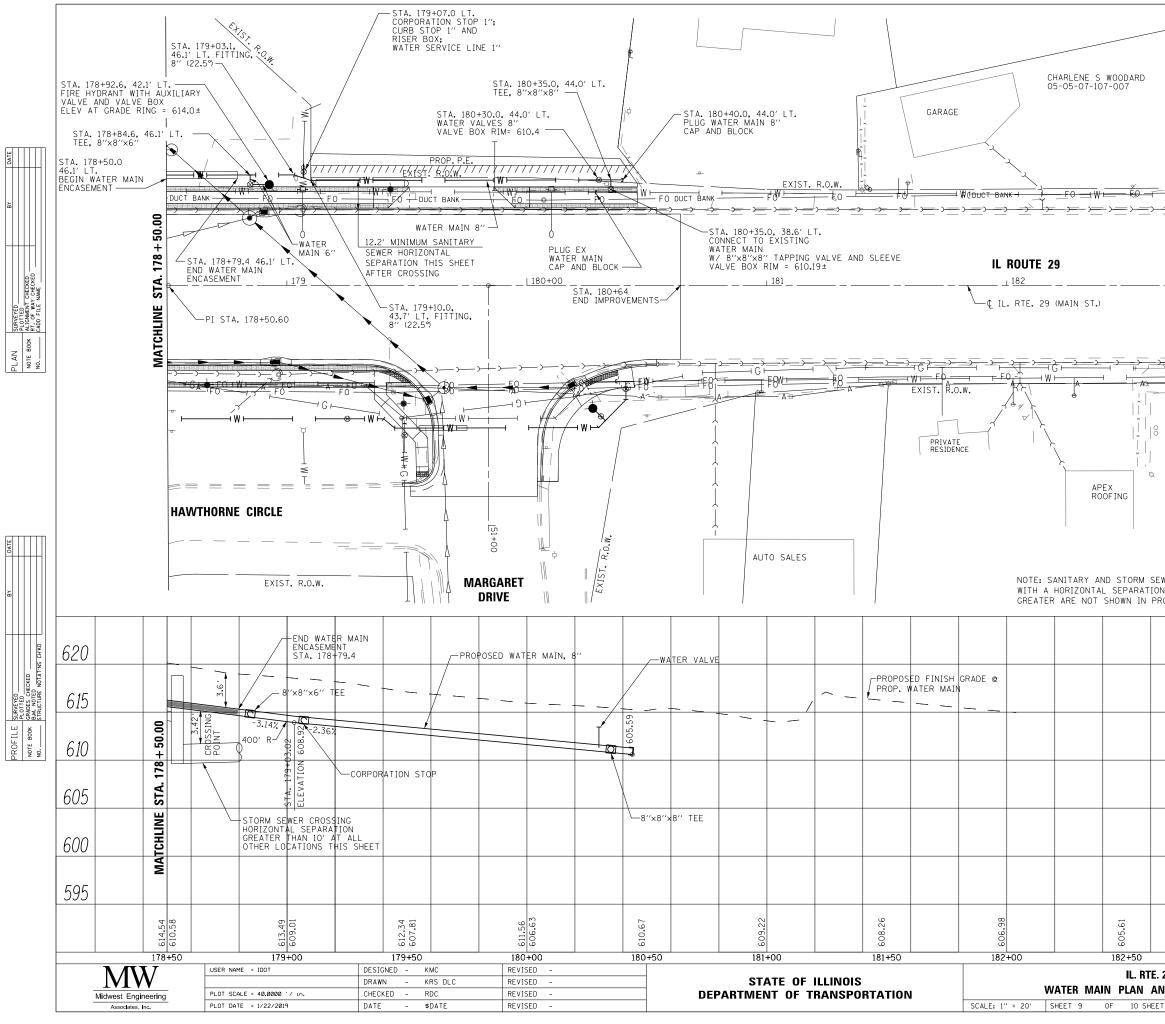


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EXIST. R.O.W.	A	A		A		
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EWER PIPES IN 10' OR ROFILE.				ooner		
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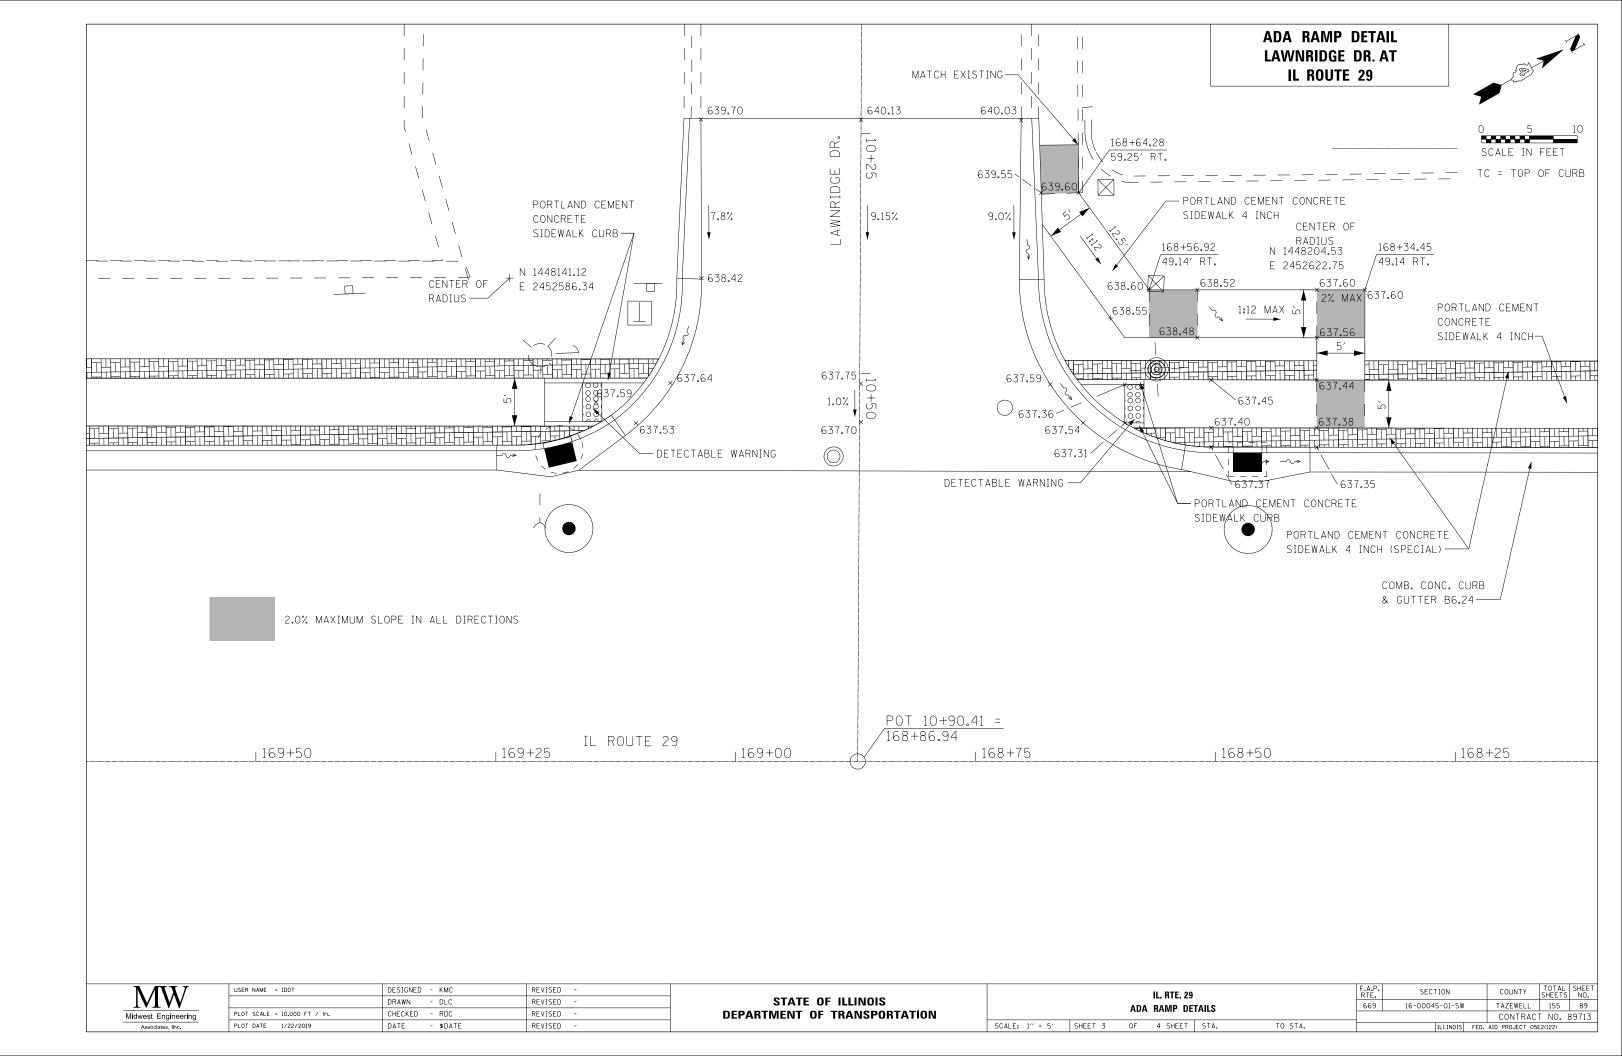


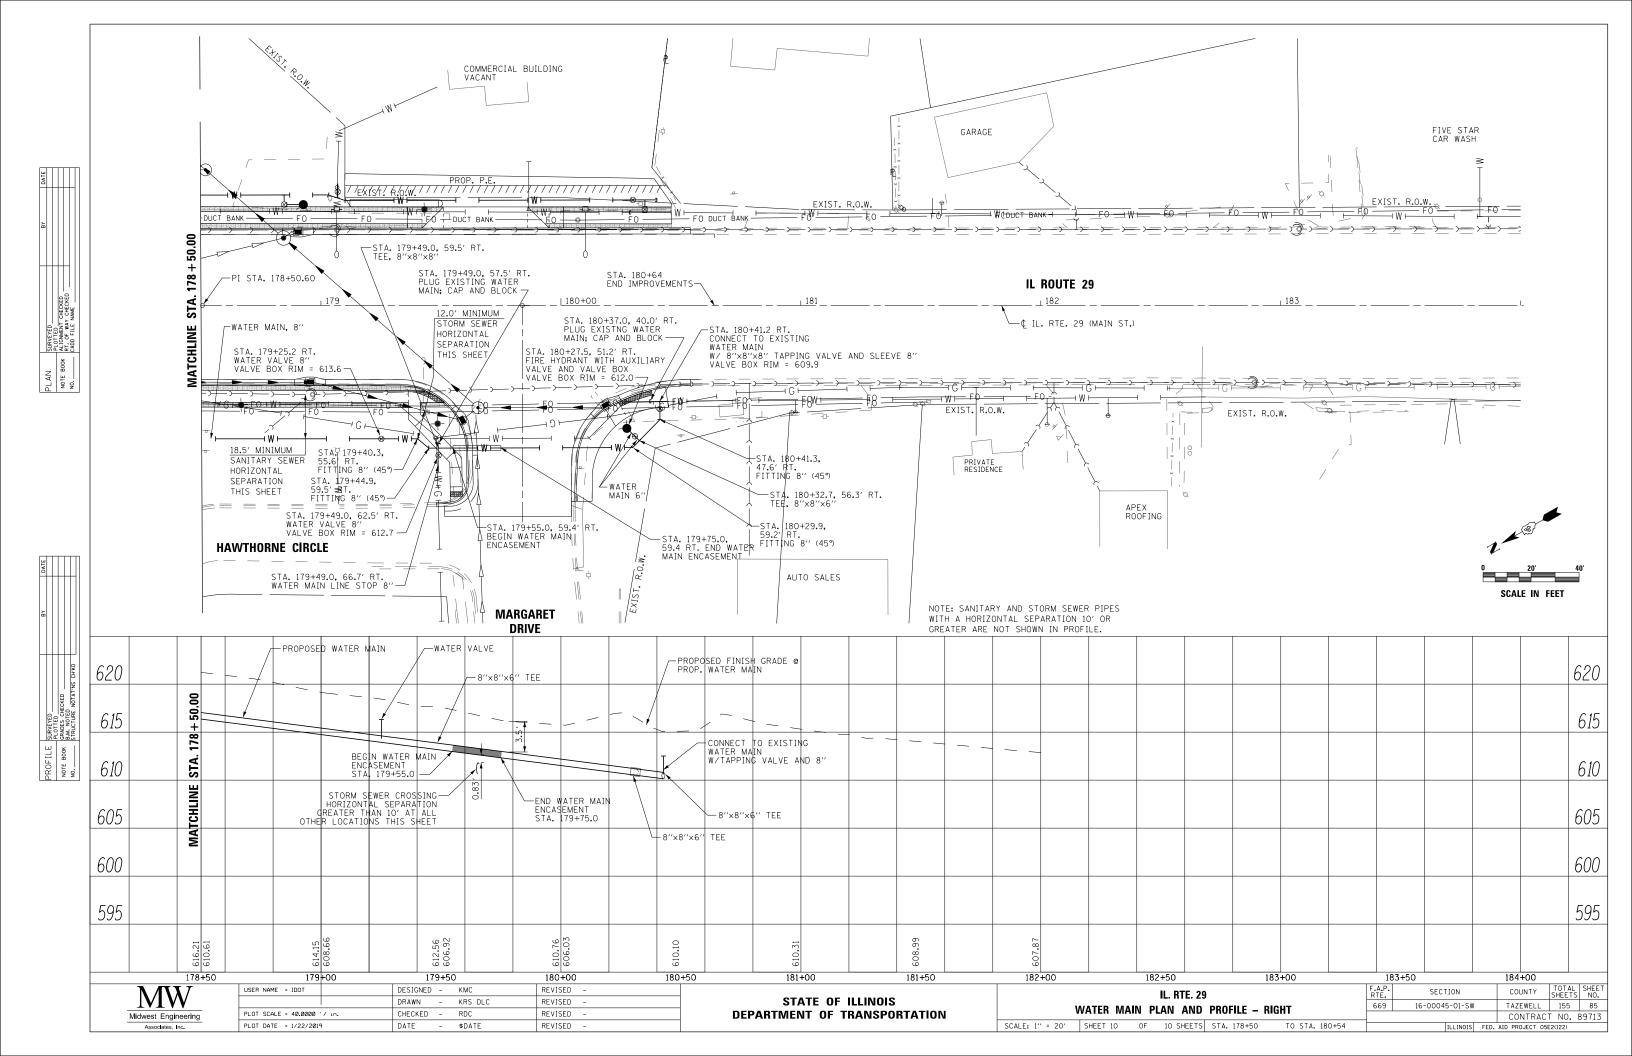


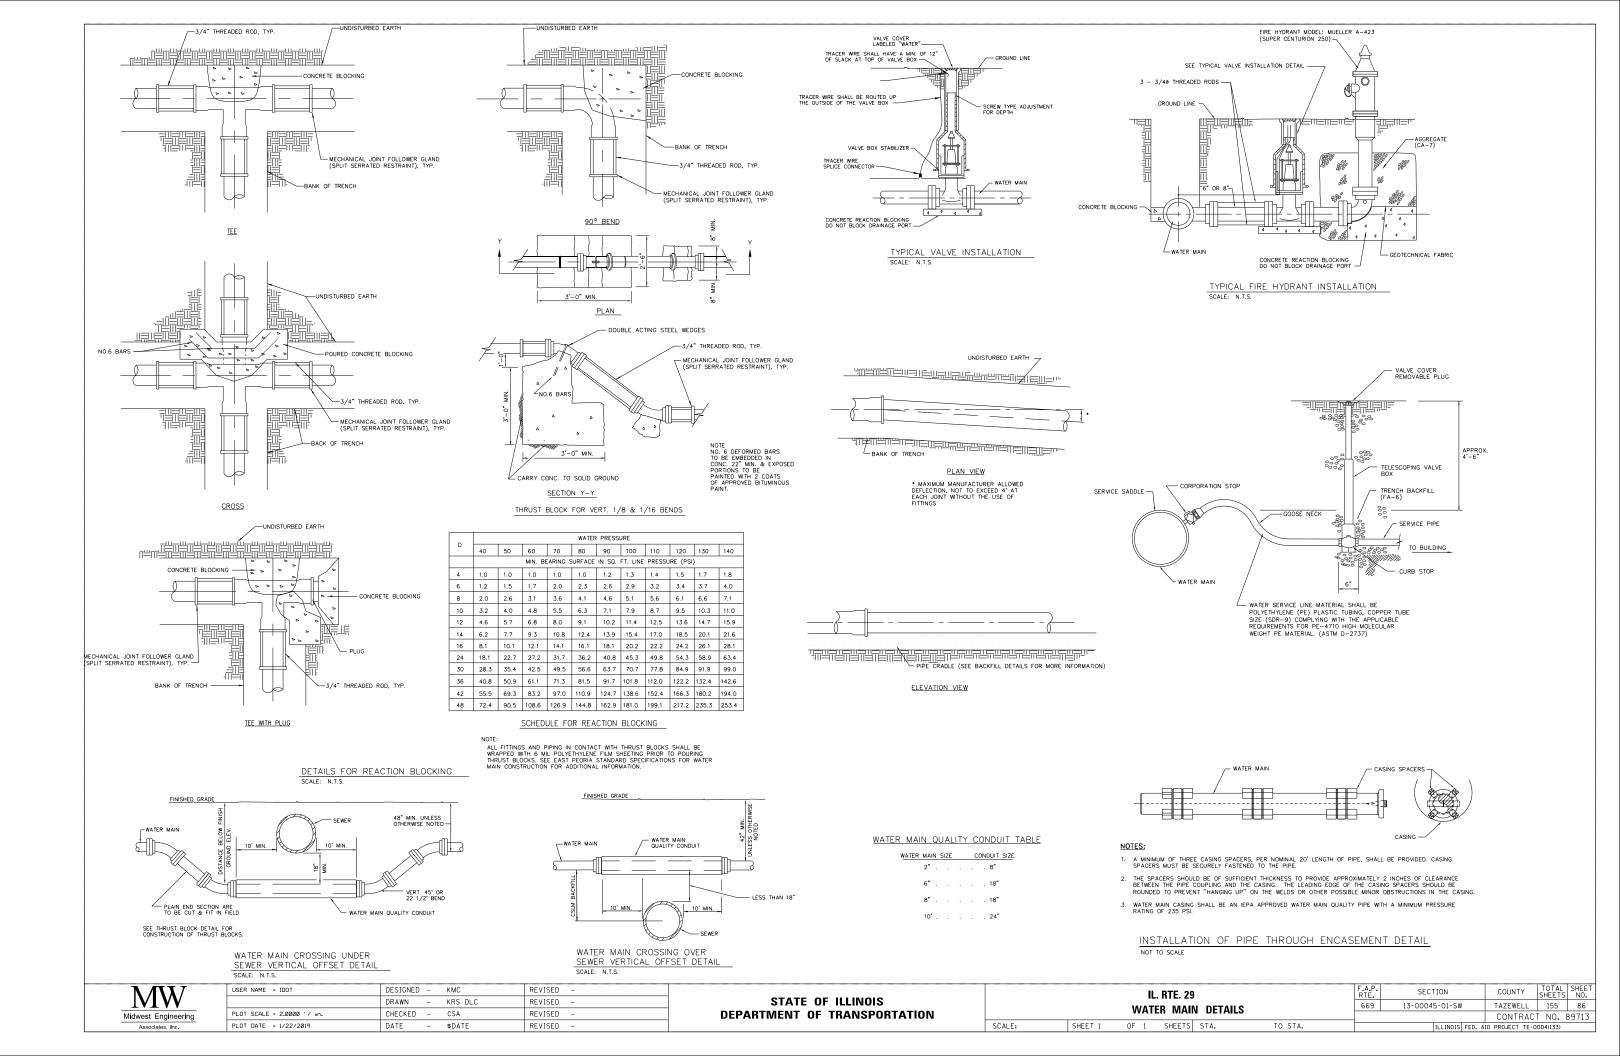


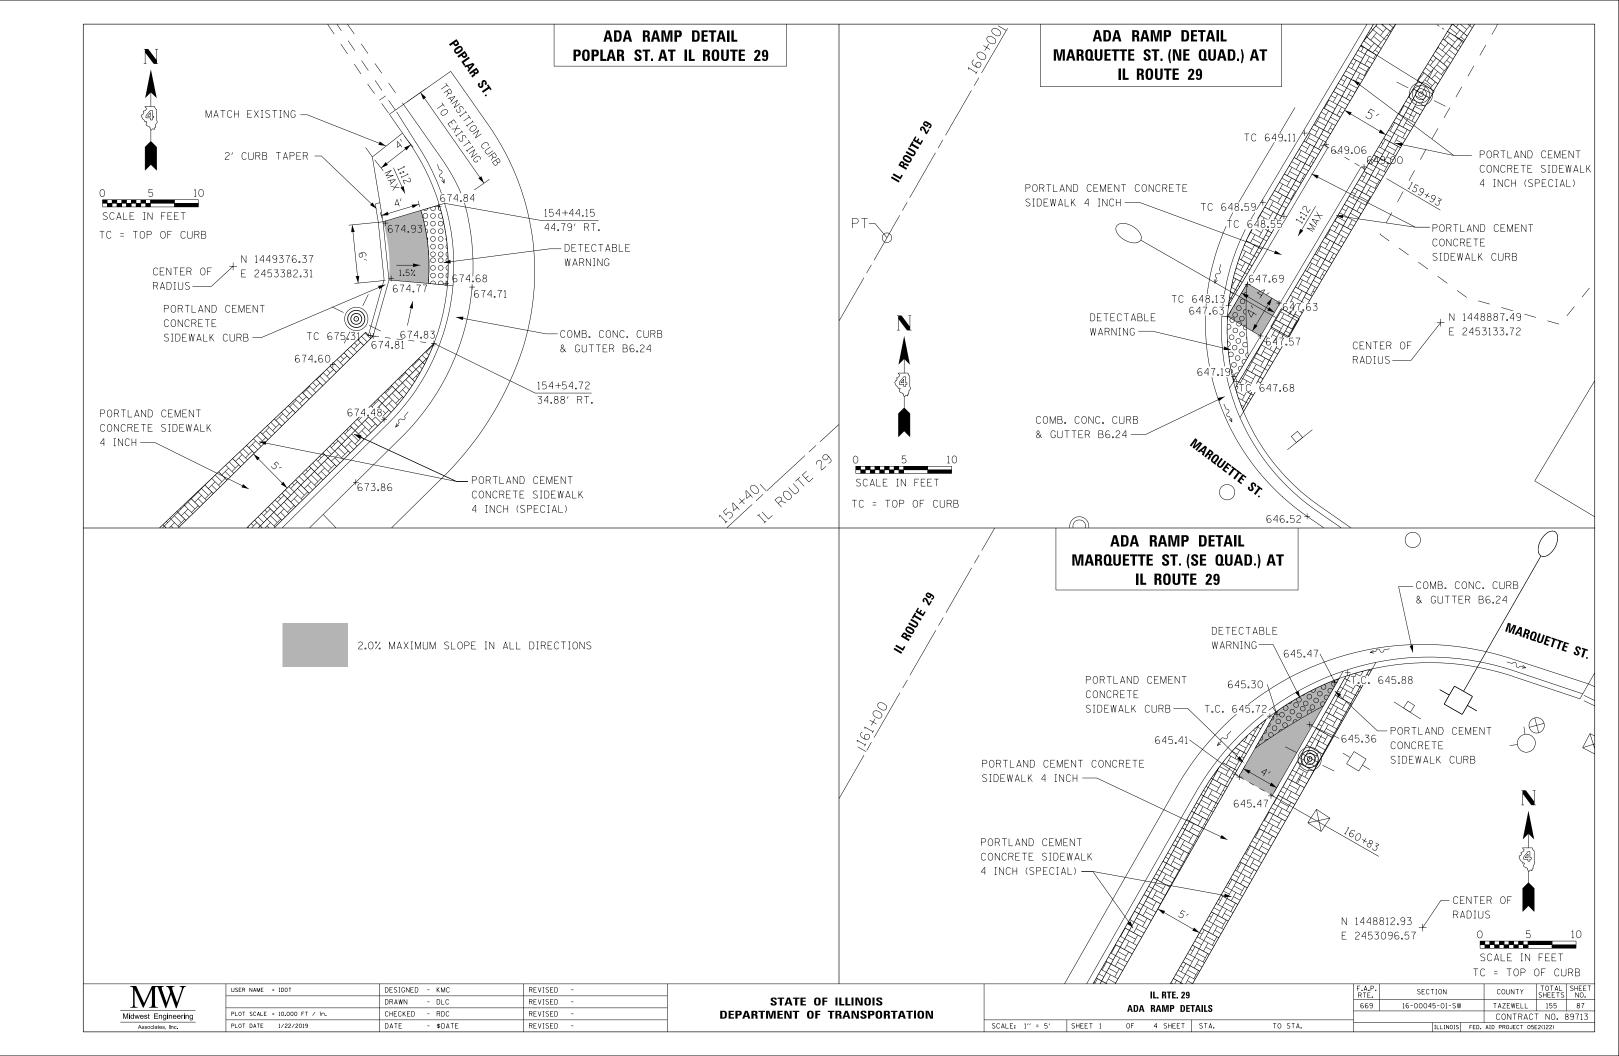

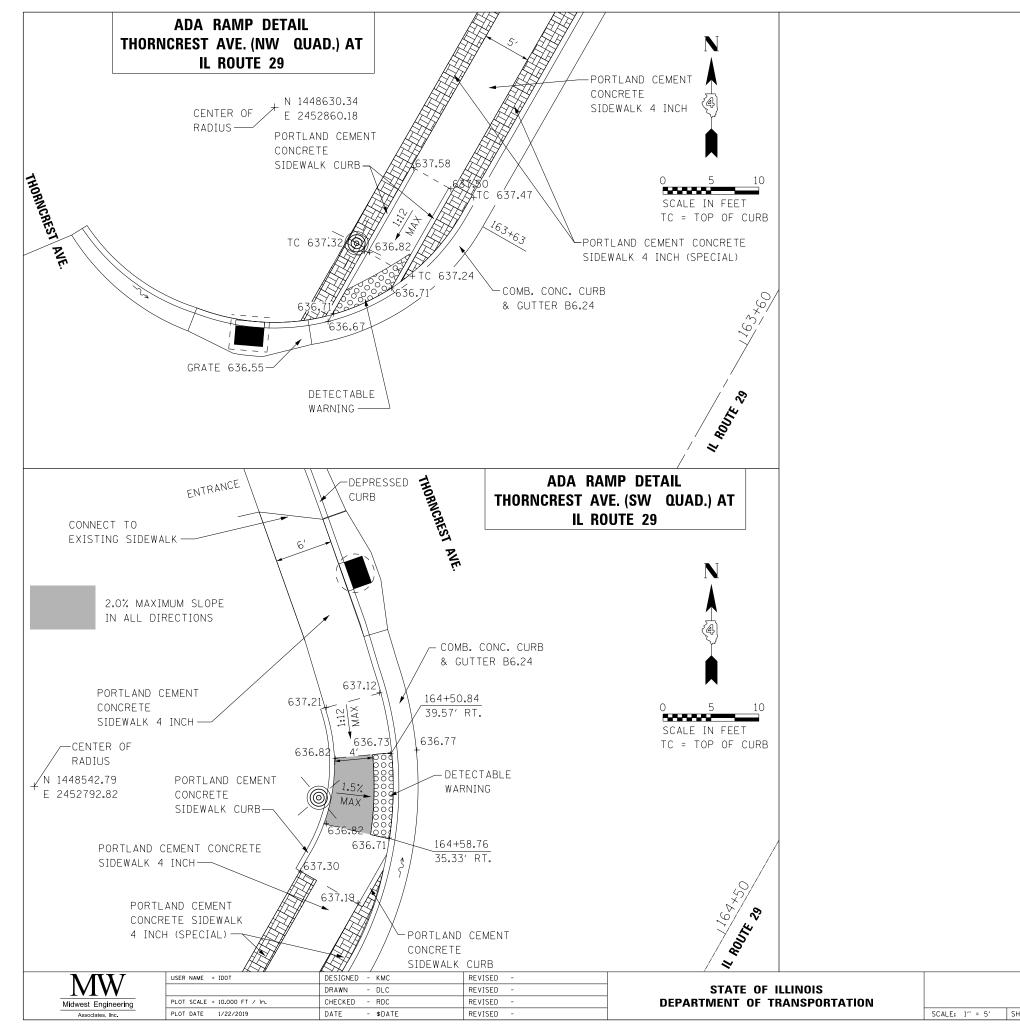IL. RTE. 29			F.A.P. RTE.	SECTION	COUNTY	TOTAL SHEETS	SHEET NO.
A RAMP DETAILS		669	16-00045-01-SW	TAZEWELL	155	88	
					CONTRAC	T NO. 8	39713
4 SHEET	STA.	TO STA.		ILLINOIS FEI	. AID PROJECT 05	2(122)	



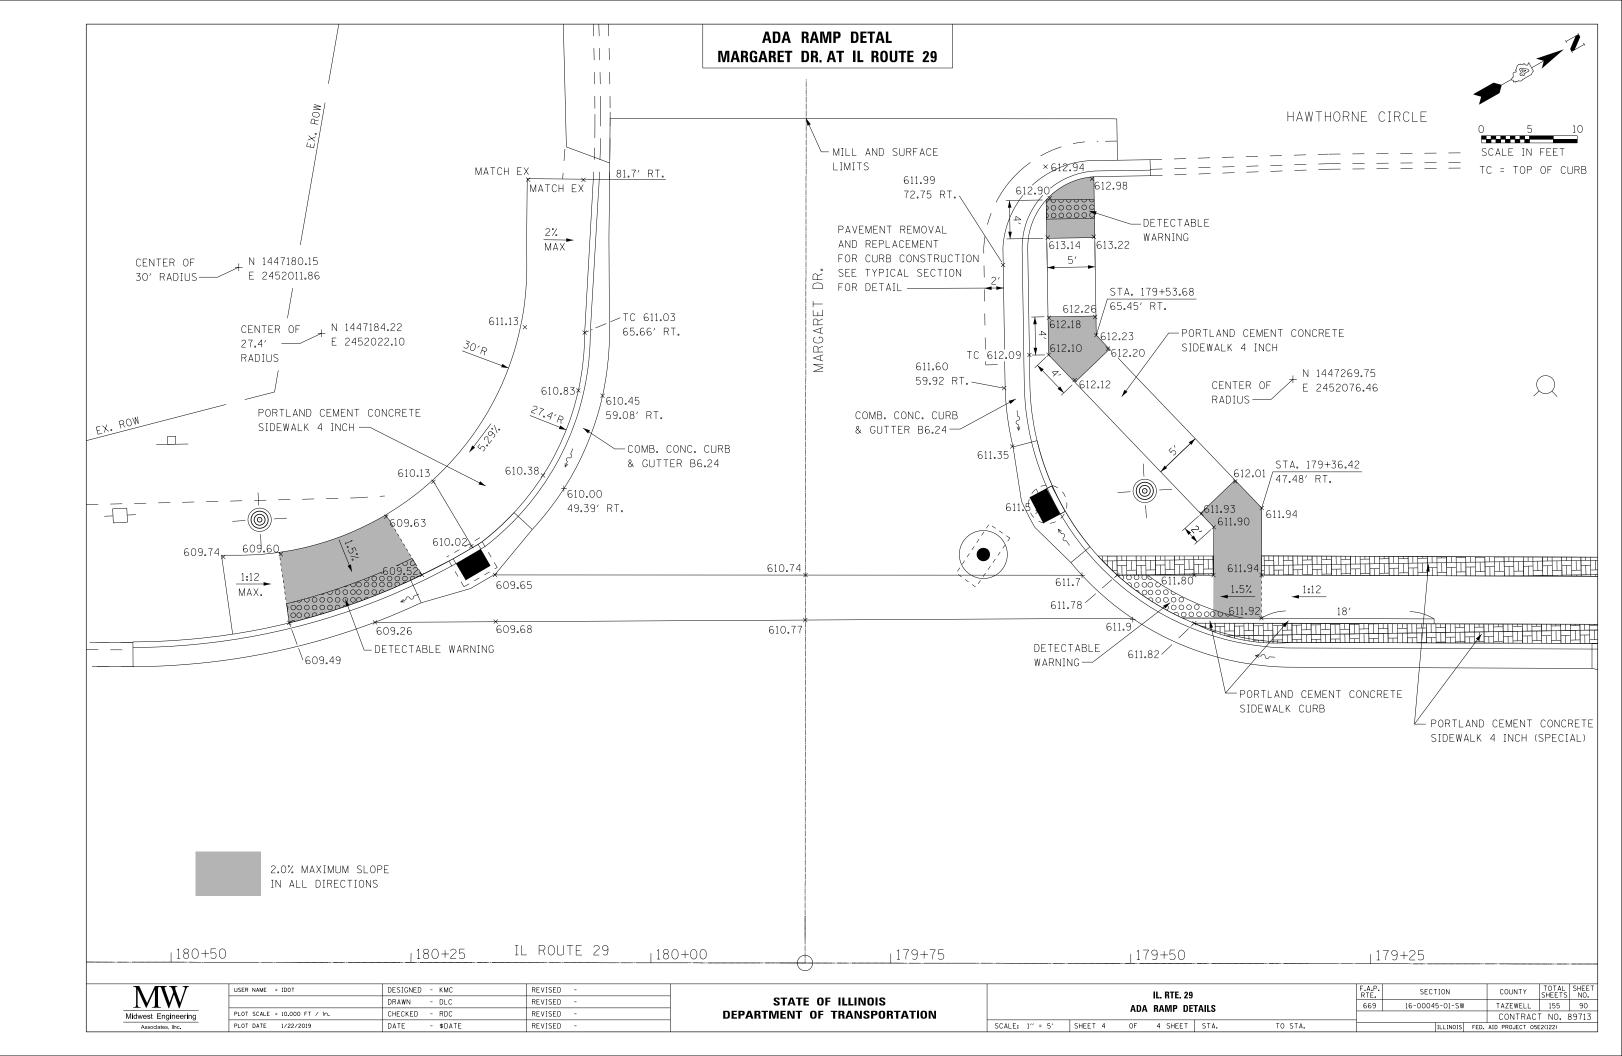

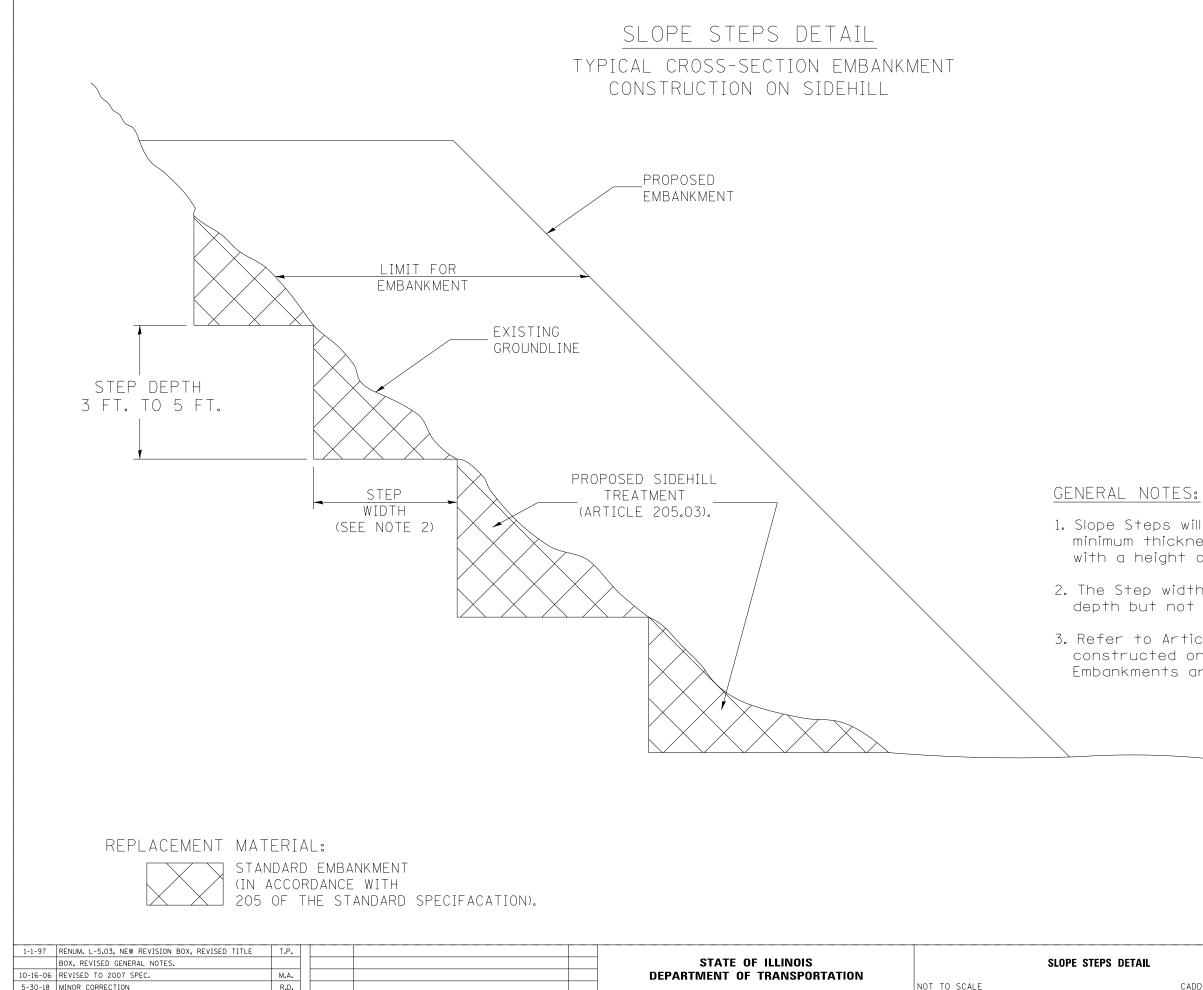


1. Slope Steps will be required for all 12(300) minimum thickness "sliver fills" and on all fills with a height of 10 feet or greater.

2. The Step width shall be twice the Step depth but not less than 6 feet.

3. Refer to Article 205.03 for Embankment to be constructed on Hillside or Slopes, or if existing Embankments are to be widened.

						(millimeters)
unl	ess	otherw	ise	not	ed.	


			F.A.P. RTE.	SEC	TION	COUNTY	TOTAL SHEETS	SHEET NO.	
DETAIL		669	16-0004	15-01-SW	TAZEWELL	155	91		
				CONTRACT NO. 5			NO. 8	9713	
	CADD	STD.	205001-D4	FED. RO	AD DIST. NO.	ILLINOIS FED. /	ID PROJECT	0	//10

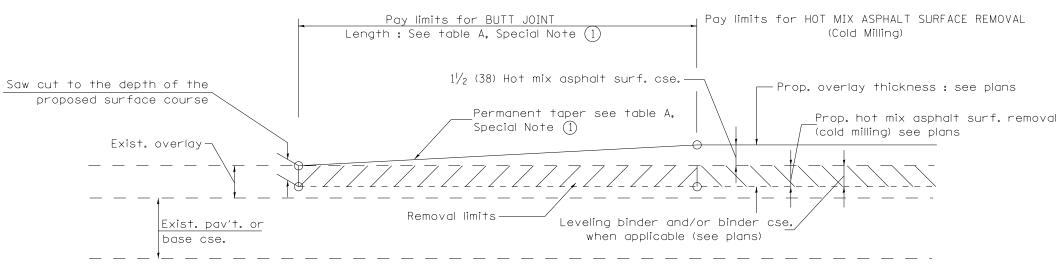

CASE 1 : WITH HOT MIX ASPHALT SURFACE REMOVAL (COLD MILLING)

	I	APER RAIES		
SPECIAL NOTE	ELEMENT	MAINLINE INTERSTATES &	ALL	1
NUMBER		4-LANE EXPRESSWAYS	OTHERS	
	BUTT JOINT	1:480	1:240	2
	TAPER RATE			
2	TEMPORARY RAMP	1:80	1:40	
	TAPER RATE			3.

TABLE A

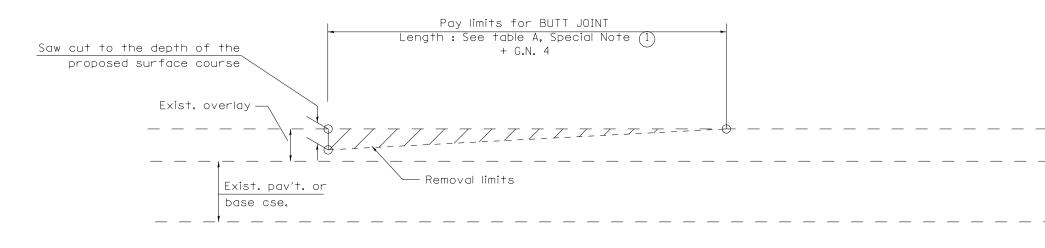

CASE 2 : NO HOT MIX ASPHALT SURFACE REMOVAL (COLD MILLING)

01-01-97 RENUM. C-23.01, NEW REVISION BOX	T.P.	08-21-13 MAJOR MODIFICATIONS	R.D.				F.A.P.	SECTION	COUNTY	TOTAL	SHEET
04-01-97 CORRECTION TO DEPTH	J.A.	02-29-16 MINOR CORRECTIONS	R.D.	STATE OF ILLINOIS	BUTT JOINTS		669	16-00045-01-SW	TAZEWELL	155	92
09-15-05 REVISED DESIGNER NOTE	M.M.A.	04-12-16 MINOR CORRECTIONS	R.D.	DEPARTMENT OF TRANSPORTATION		SHT. 1 OF 3	5		CONTRACT		
10-16-06 REVISED TO 2007 SPEC.	M.A.	02-14-17 ADDED NOTE 5	R.D.		NOT TO SCALE	CADD STD. 406101-D4	FED. ROA	D DIST. NO. ILLINOIS FED.	AID PROJECT		

GENERAL NOTES


1. The work shall be done in accordance with Article 406.08 and the Special Provision for Butt Joints.

2. The pavement surface to be removed may be either bituminous or P.C. concrete. The work shall be performed in accordance with Article 440.04 and the Special Provisions for Butt Joints.


3. The saw cut joints shall be primed just prior to the placing of bituminous material. The work will be in accordance with the applicable portions of Article 406.05.

4. The length of butt joint is based on the taper rate times change in cold miling depth within the butt joint pay limits, unless otherwise indicated.


5. Temporary ramps are paid for separately and not included in the cost of the butt joints.

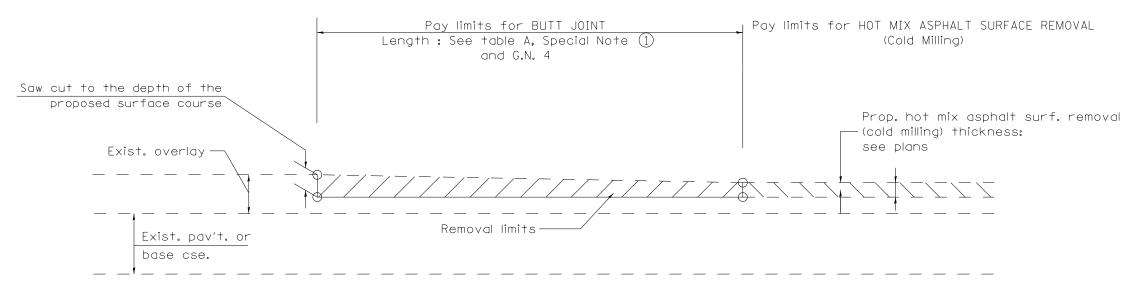

CASE 3 : HOT MIX ASPHALT SURFACE REMOVAL (COLD MILLING) TIE-IN TO EXISTING BITUMINOUS TAPER

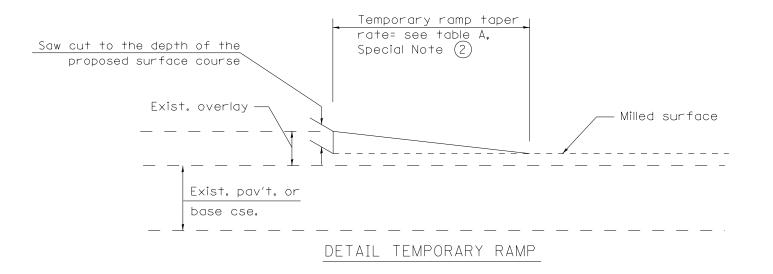

		RTE, SECTION	COUNTY SHEETS NO.
STATE OF ILLINOIS	BUTT JOINTS	669 16-00045-01-SW	TAZEWELL 155 93
DEPARTMENT OF TRANSPORTATION	NOT TO SCALE	SHT. 2 OF 3 CADD STD. 406101-D4 FED. ROAD DIST. NO. III. INDISTED. A	CONTRACT NO. 89713

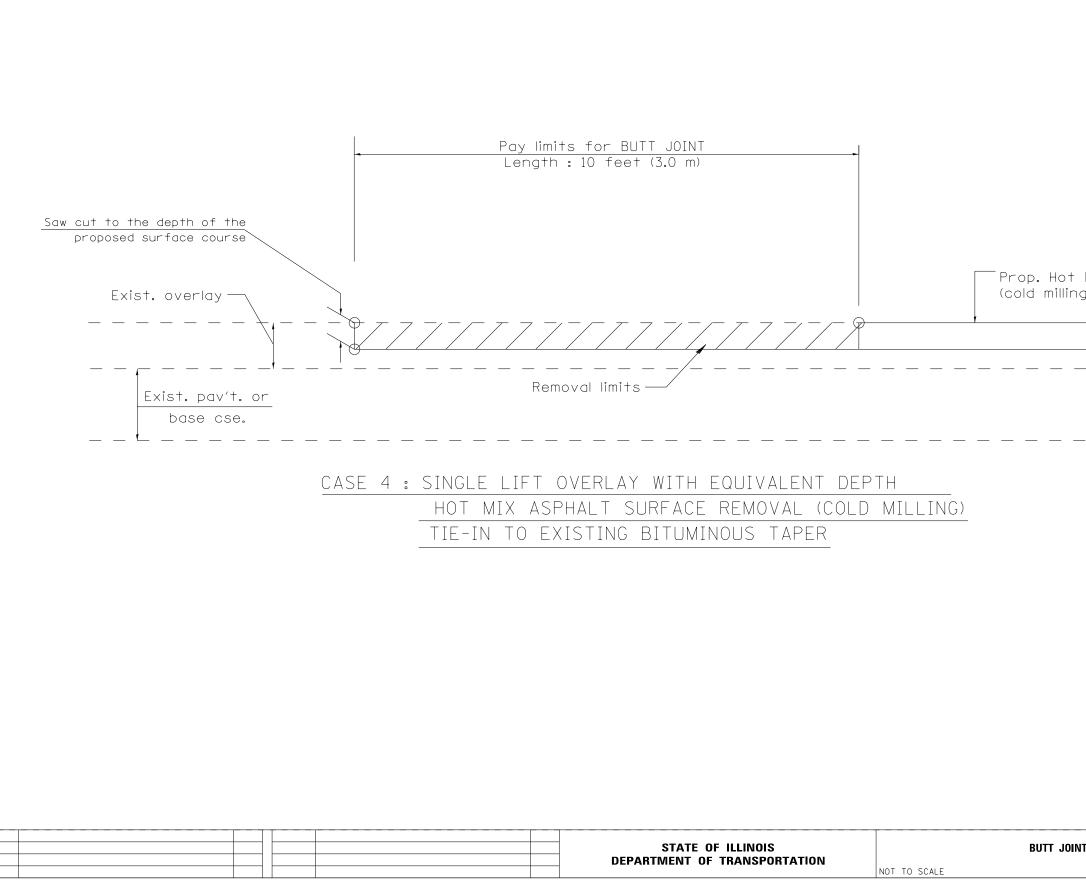


Prop. Hot Mix Asphalt surf. removal (cold milling) per plans.

_ _ _ _

		F.A.P. RTE.	SECTION	COUNTY	TOTAL SHEETS	SHEET NO.
INTS		669	16-99945-01-SW	TAZEWELL	155	94
	SHT. 3 OF 3			CONTRACT	NO. 8	9713
	CADD STD. 406101-D4	FED. RC	AD DIST. NO. ILLINOIS FED. A	ID PROJECT		

TABLE 1									
URBAN ENTRANCE DESIGN CONTROLS									
		COMMERCIAL							
ELEMENI	ELEMENT NON-COMMERCIAL		2-WAY OPERATION						
WIDTH (W)	12' (3.6 m) MIN. 24' (7.2 m) MAX.	14′ (4.3 m) MIN. 24′ (7.2 m) MAX.	24′ (7.2 m) MIN. 35′ (10.7 m) MAX						
RADIUS EQUIVALENT 1:1 FLARE (F)	5′ (1.5 m) MIN. 25′ (7.6 m) MAX.	15' (4.6 m) MIN. 40' (12.0 m) MAX.	15' (4.6 m) MIN. 40' (12.0 m) MAX.						
MAX. GRADE (G)	8%	6	°/_						

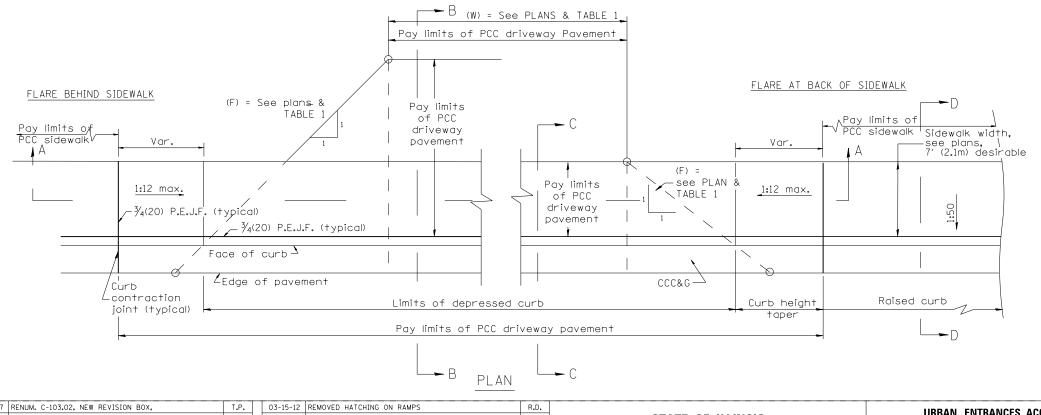

01-01-97	RENUM. C-103.02, NEW REVISION BOX,	T.P.	03-15-12 REMOVED HATCHIN	ING ON RAMPS R.D.		UBBAN ENTRANCES ACCESSIBLE TO THE	DISABLED.	F.A.P.	SECTION	COUNTY TOTAL SHEET
	REVISED GENERAL NOTES				STATE OF ILLINOIS	FOR CURBLINE SIDEWALKS	DIGADLED,	669	16-00045-01-SW	TAZEWELL 155 95
09-15-05	REVISED DESIGNER NOTE	M.M.A.			DEPARTMENT OF TRANSPORTATION		SHT. 1 OF 2			CONTRACT NO. 89713
10-16-06	REVISED TO 2007 SPEC.	M.A.				NUT TO SCALE	CADD STD. 425IOI-D4	FED. ROAD D	DIST. NO. ILLINDIS FED.	AID PROJECT

2% max.

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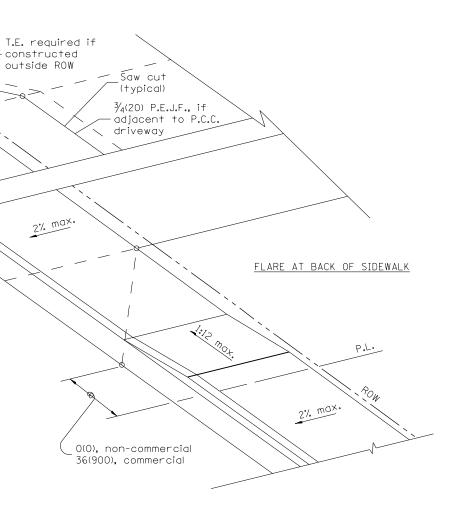
PERSPECTIVE

FLARE BEHIND SIDEWALK

2% max.


STATE TO DRIVEWAYS

HIGHWAYS''




GENERAL NOTES

- 1. The sidewalk area located within the pay limits of P.C.C. Driveway Pavement will be of the same thickness and construction as the P.C.C. Driveway Pavement.
- 2. Combination Concrete Curb & Gutter shall be depressed in accordance with Standard 606001.
- 3. Exceptions to the radius flare/property line relationship are as shown in the plans for common entrances, with jointly executed access permits.
- 4. Refer to State Standard 424026 for detectable warnings at busy commercial entrances.

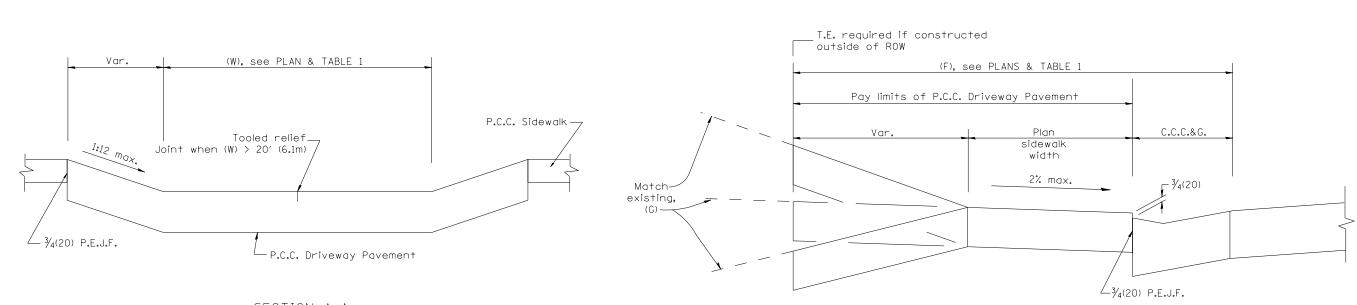

<u>Section A-A</u>

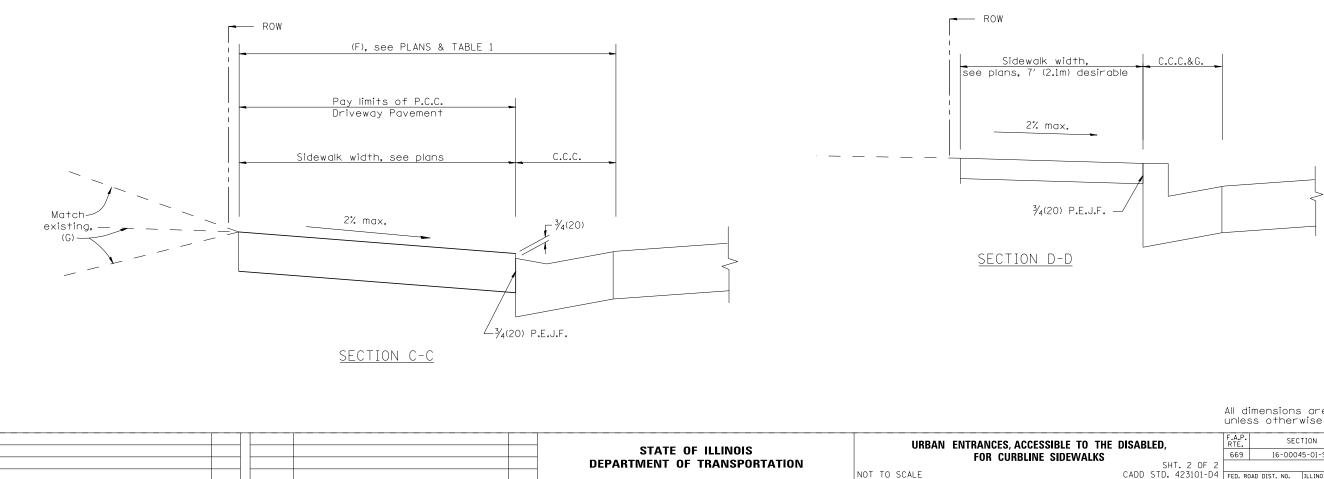




BLE TO THE DISABLED.		SECTION	COUNTY	TOTAL SHEETS	SHEET NO.
SIDEWALKS	669	16-00045-01-SW	TAZEWELL	155	96
SHT. 2 OF 2			CONTRACT	NO. 89	9713
CADD STD. 423101-D4	FED. RC	AD DIST. NO. ILLINOIS FED. AI	D PROJECT		

DESIGNER NOTES:	
1. DESIGNER SHOULD REVIEW "HANDBOOK FOR THE POLICY ON PERMITS FOR ACCESS DRIVEWAYS TO STATE HIGHWAYS"	
1:1 FLARES ARE RECOMMENDED FOR SIDEWALKS WITH NARROW SEPARATIONS.	
2. DESIGNER SHOULD REVIEW BDE CHAPTER 58.	
3. STATE STANDARD 606001 AND APPLICABLE SIDEWALK STANDARDS SHOULD BE INCLUDED IN THE PLANS TO SUPPLEMENT THIS DRAWING.	RAWING.

	TAB	LE 1						
	URBAN ENTRAN	CE DESIGN CONTROLS						
		COMMERCIAL						
ELEMENT	NON-COMMERCIAL	1-WAY OPERATION	2-WAY OPERATION					
WIDTH (W)	12' (3.6 m) MIN. 24' (7.2 m) MAX.	14' (4.3 m) MIN. 24' (7.2 m) MAX.	24′ (7.2 m) MIN. 35′ (10.7 m) MAX					
RADIUS EQUIVALENT 1:1 FLARE (F)	5' (1.5 m) MIN. 25' (7.6 m) MAX.	15' (4.6 m) MIN. 40' (12.0 m) MAX.	15' (4.6 m) MIN. 40' (12.0 m) MAX					
MAX. GRADE (G)	8%	6						

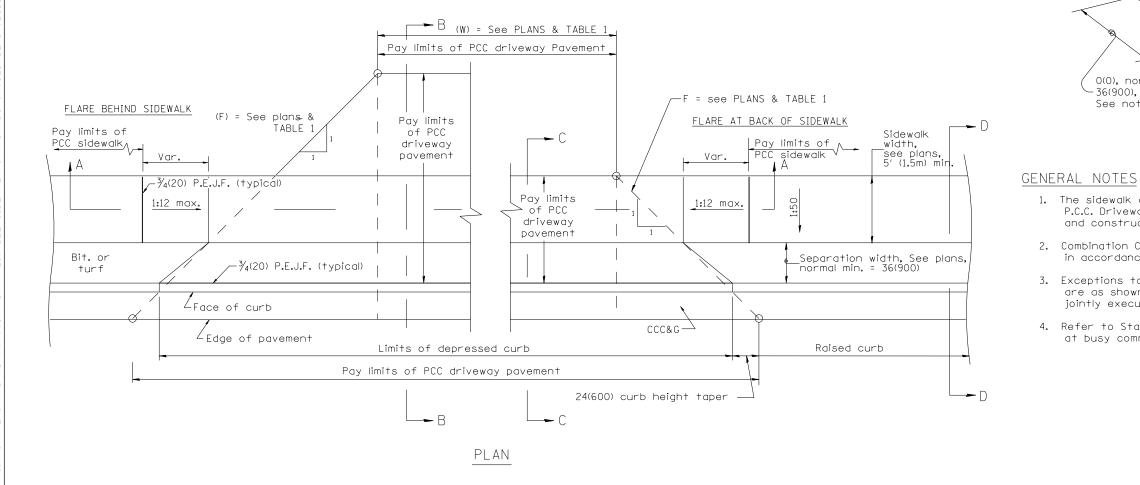

01-01-97 RENUM. C-103.01, NEW REVISION BOX	T.P.	03-15-12	REMOVED HATCHING ON RAMPS	R.D.		URBAN ENTRANCES, ACCESSIBLE TO THE	F.A.P. RTE.	SECTION	COUNTY	TOTAL	SHEET NO.
01-17-03 REMOVE CURB CONTRACTION	JATR				STATE OF ILLINOIS	FOR SEPARATED SIDEWALKS	669	16-00045-01-SW	TAZEWELL	155	97
09-15-05 JOINT	M.M.A.				DEPARTMENT OF TRANSPORTATION		SHT. 1 OF 2		CONTRACT	NO. 8	9713
10-16-06 REVISED TO 2007 SPEC.	M.A.					NOT TO SCALE	CADD SID. 423106-D4 FED. RO	AD DIST. NO. ILLINOIS FED.	AID PROJECT		

2% max.


~~> *"*℃+ FLARE BEHIND SIDEWALK

2% max.

min (G)

min (G)

PERSPECTIVE

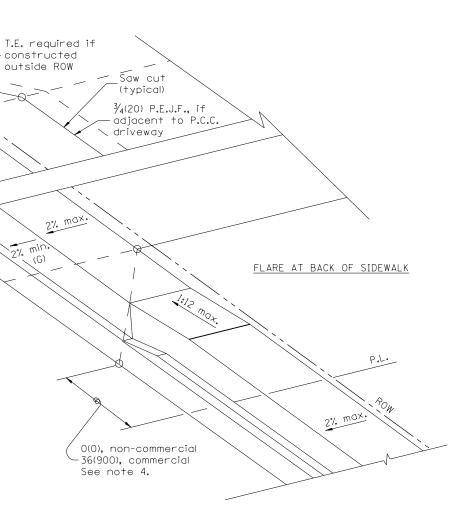


1. The sidewalk area located within the pay limits of P.C.C. Driveway Pavement will be of the same thickness and construction as the P.C.C. Driveway Pavement.


2. Combination Concrete Curb & Gutter shall be depressed in accordance with Standard 606001.

3. Exceptions to the radius flare/property line relationship are as shown in the plans for common entrances, with jointly executed access permits.

4. Refer to State Standard 424026 for detectable warnings at busy commercial entrances.

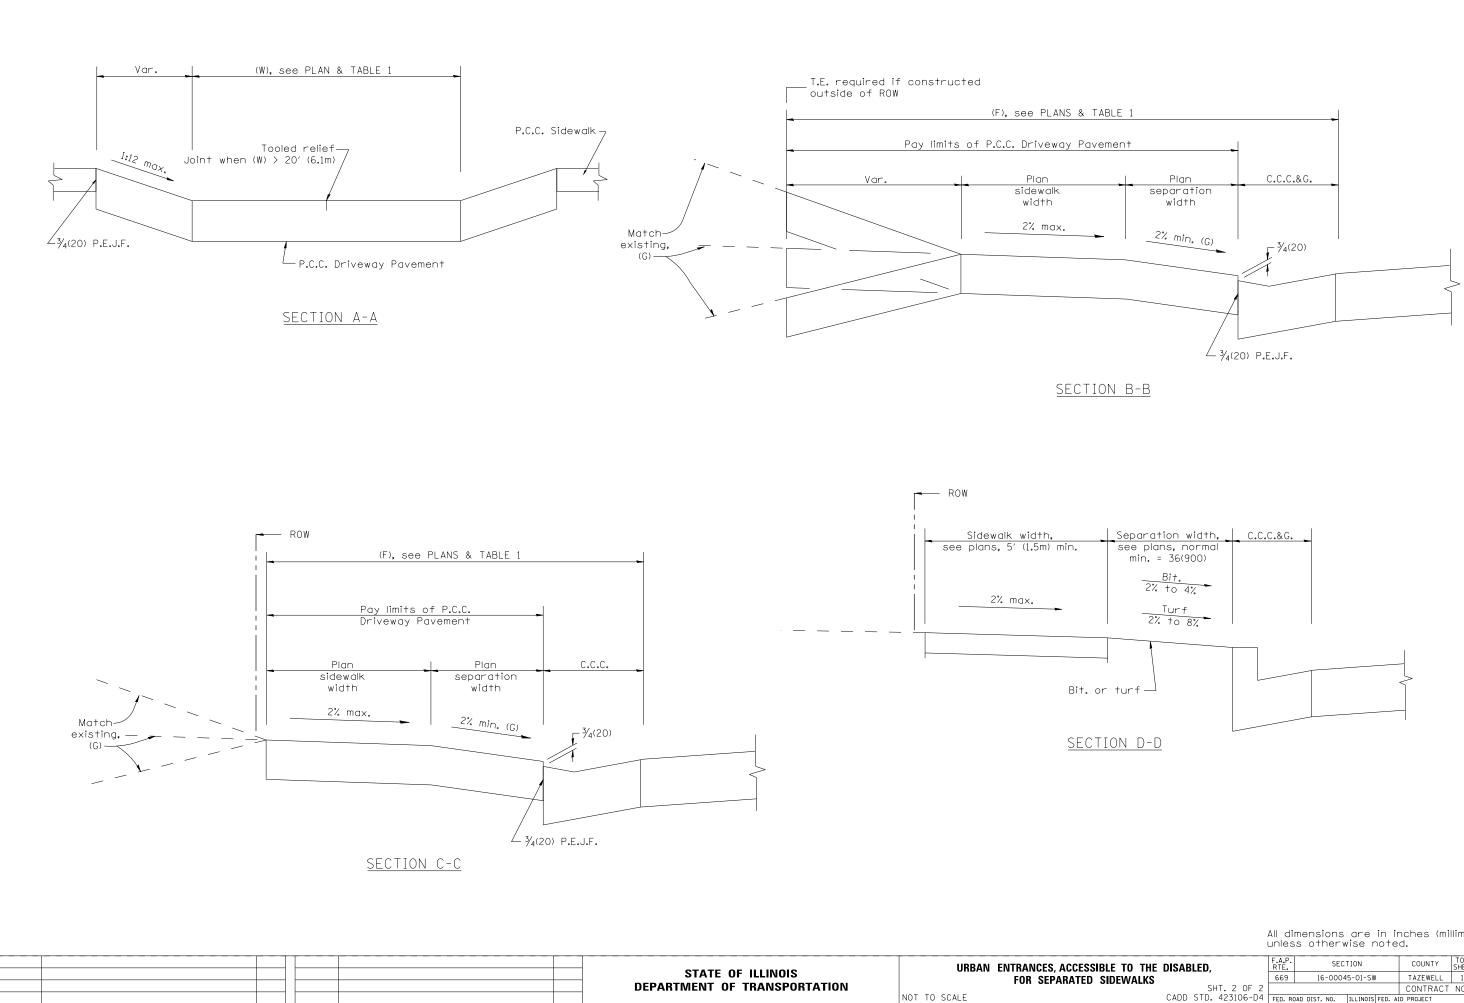

BLE TO THE DISABLED.		SECTION	COUNTY	TOTAL SHEETS	SHEET NO.
SIDEWALKS		16-00045-01-SW	TAZEWELL	155	98
SHT. 2 OF 2	CONTRACT NO.				
CADD STD. 423106-D4	FED. RC	AD DIST. NO. ILLINOIS FED. AI	D PROJECT		

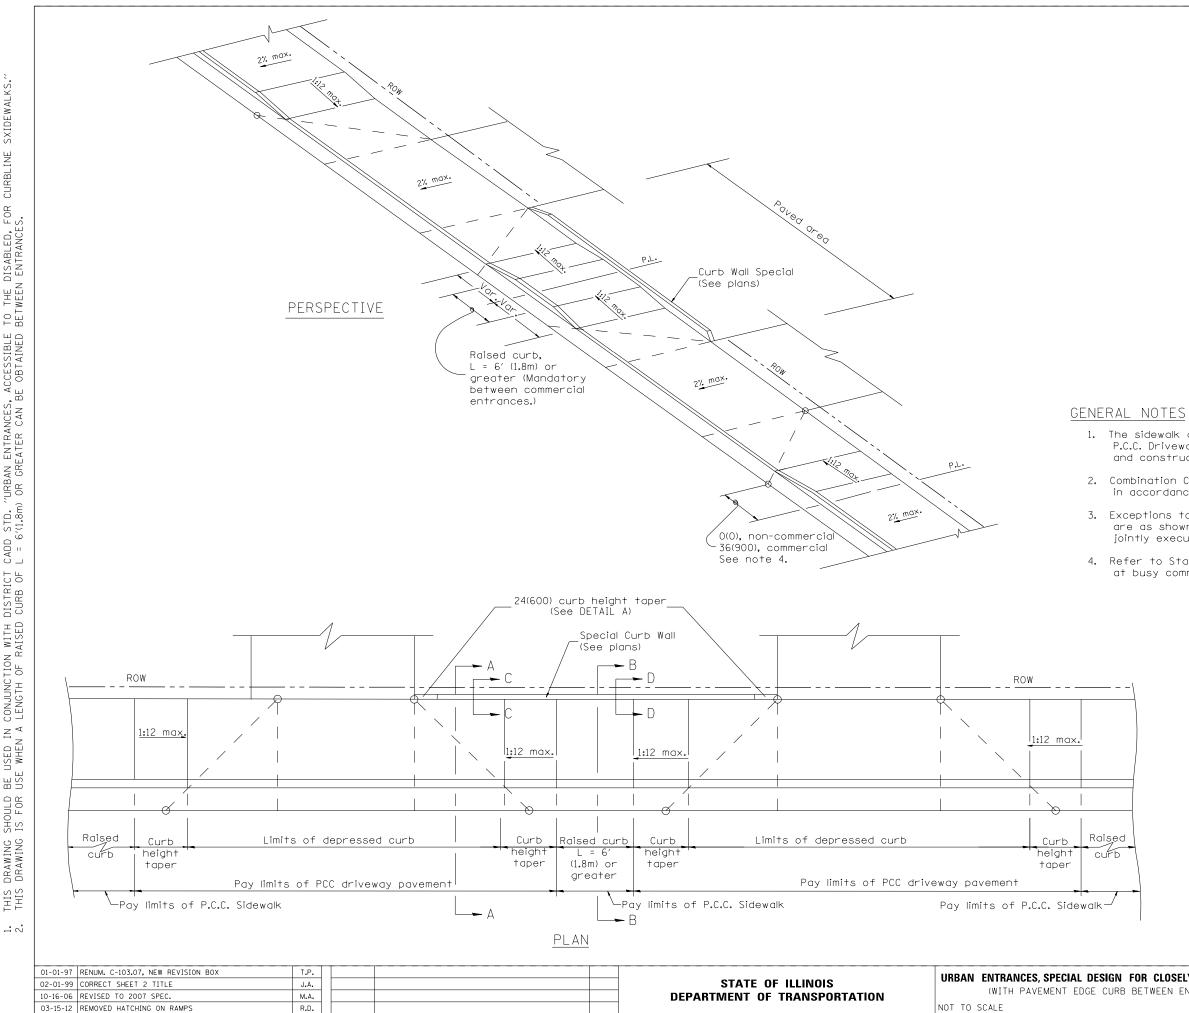

CURBLINE CADD STD. "URBAN ENTRANCES, ACCESSIBLE TO THE DISABLED, FOR L = 6'(1.8m) OR GREATER CAN BE OBTAINED BETWEEN ENTRANCES. BE USED IN CONJUNCTION WITH DISTRICT USE WHEN A LENGTH OF RAISED CURB OF DESIGNER NOTES: 1. THIS DRAWING SHOULD 2. THIS DRAWING IS FOR


1. The sidewalk area located within the pay limits of P.C.C. Driveway Pavement will be of the same thickness and construction as the P.C.C. Driveway Pavement.

2. Combination Concrete Curb & Gutter shall be depressed in accordance with Standard 606001.

3. Exceptions to the radius flare/property line relationship are as shown in the plans for common entrances, with jointly executed access permits.

4. Refer to State Standard 424026 for detectable warnings at busy commercial entrances.

OR CLOSELY SPACED ENTRANCES	F.A.P. RTE.	SECTION	COUNTY	TOTAL SHEETS	SHEET NO.
BETWEEN ENTRANCES)	669	16-00045-01-SW	TAZEWELL	155	99
SHT. 1 OF 2			CONTRACT	NO. 8	9713
CADD STD. 423116-D4	FED. R	DAD DIST. NO. ILLINOIS FED. AI	D PROJECT		

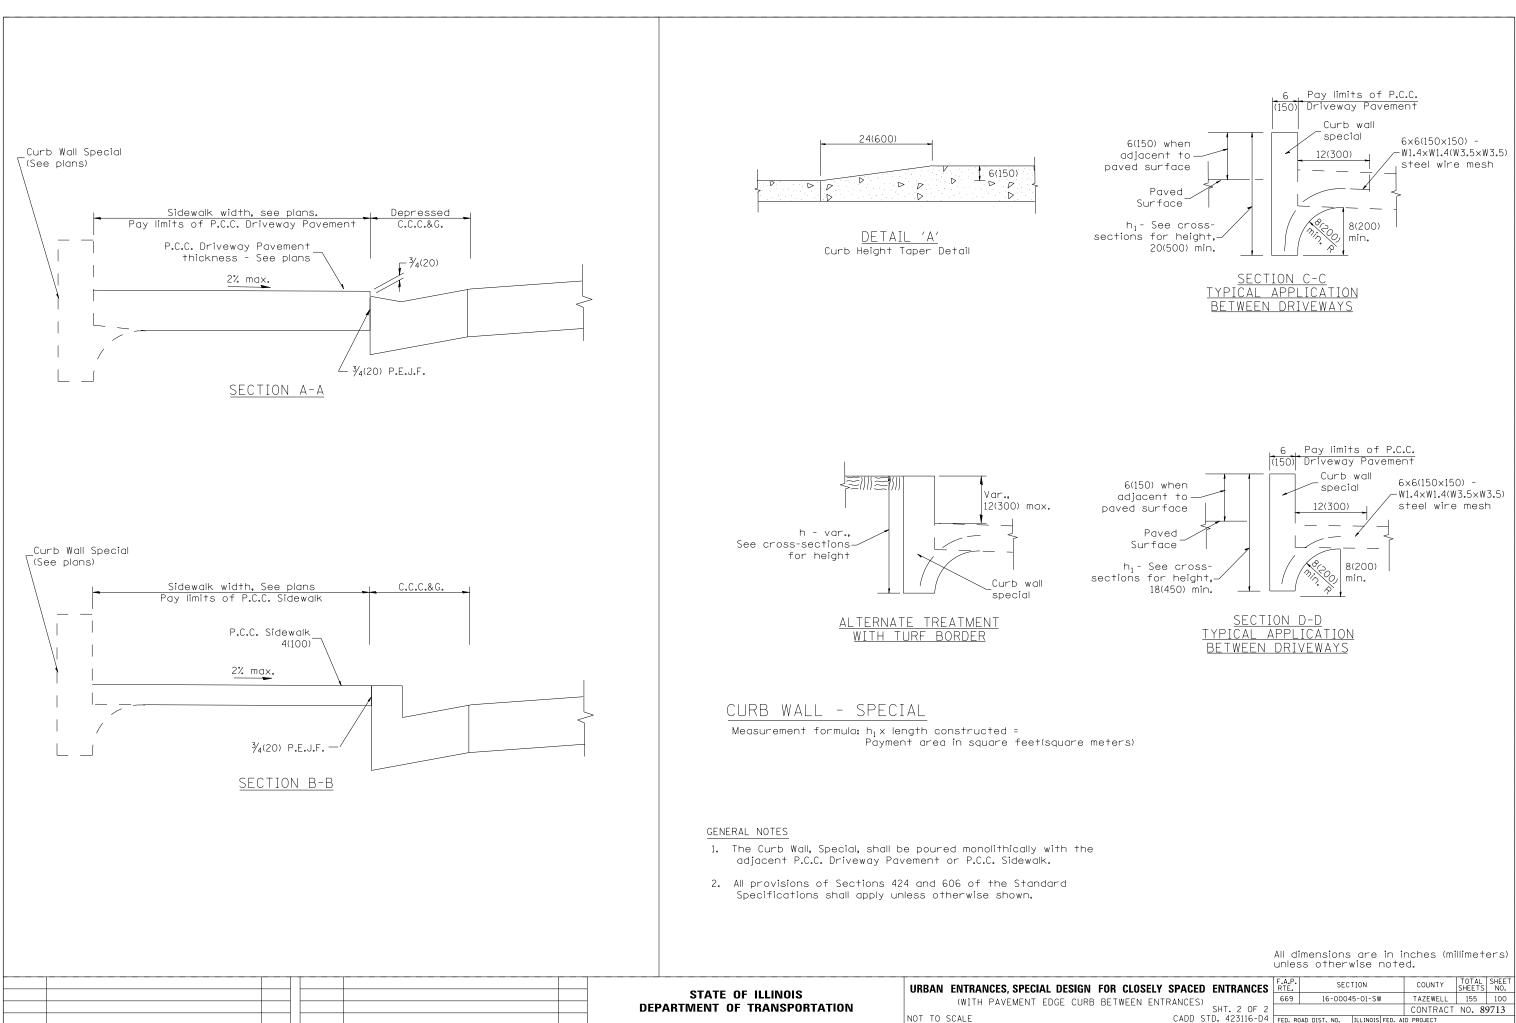

DR CLOSELY SPACED ENTRANCES	RTE.		SEC	FION		COUNTY	SHEETS	NO.
ETWEEN ENTRANCES)	669	16	-0004	5-01-SW		TAZEWELL	155	100
SHT. 2 OF 2						CONTRACT	NO. 8	9713
CADD STD. 423116-D4	FED. RO	OAD DIST.	NO.	ILLINOIS	FED. A	ID PROJECT		