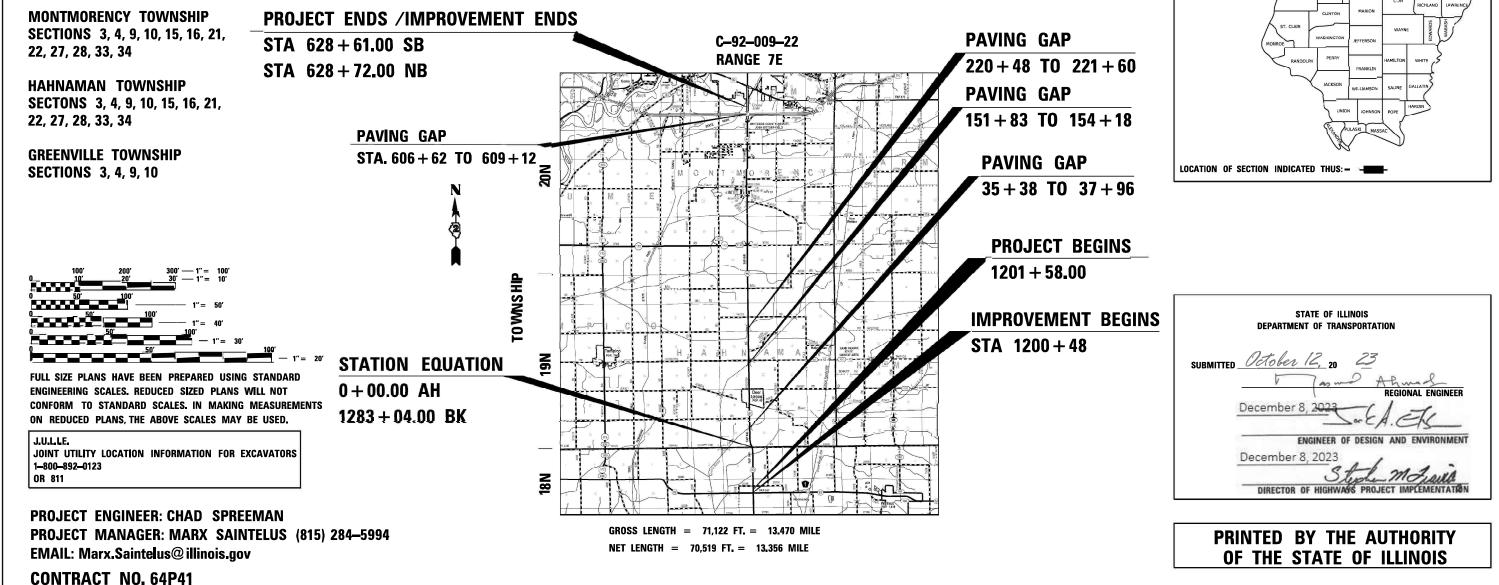
STATE OF ILLINOIS DEPARTMENT OF TRANSPORTATION

FOR INDEX OF SHEETS, SEE SHEET NO. 2

HIGHWAY_CLASSIFICATION F.A.P. ROUTE 646 (IL40) CLASSIFICATION: MINOR ARTERIAL ADT: 6,500 (2019) PV: 5,625 DESIGN SPEED: 40–55 MPH MU: 550 POSTED SPEED: 40–55 MPH SU: 325

PROPOSED HIGHWAY PLANS


FAP ROUTE 646 (IL 40) SECTION (101, 102, 135)RS PROJECT STP-NHPP-2LFN(872) HMA RESURFACING WHITESIDE COUNTY /BUREAU COUNTY



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USER NAME = Cristian.Rosas	DESIGNED -	REVISED -								F A P BTE	SECTION	COUNTY	TOTAL SHEET
	DRAWN -	REVISED -	STATE OF ILLINOIS		INDEX /	'HIGHWA	Y ST	ANDARDS		646	(101, 102, 135)RS	WHITESIDE	179 2
PLOT SCALE = 100.0000 / in	CHECKED -	REVISED -	DEPARTMENT OF TRANSPORTATION									CONTRAC	T NO. 64P41
PLOT DATE = Oct-10-2023 10:08:50 AM	DATE -	REVISED -		SCALE:	SHEET OF	= SH	IEETS	STA.	TO STA.		ILLINOIS FED.	AID PROJECT	

TERNS

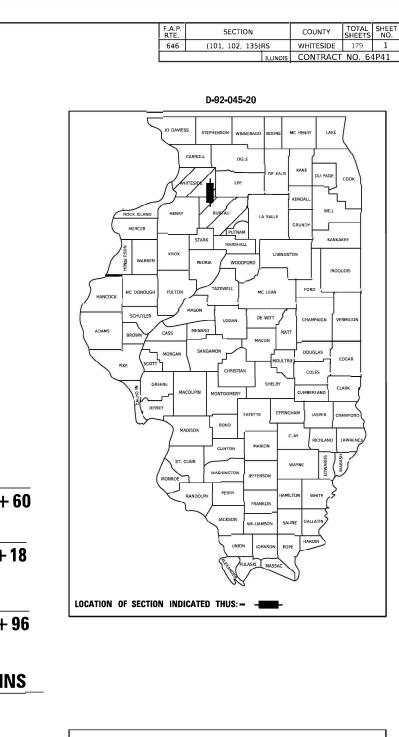" (375mm) THRU 84" (2100mm) DIAMETER :RTS 15" (37mm) THRU 60" (1500mm) DIA

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RT M GUARDRAIL JARDRAIL TERMINALS

(4.5m) AWAY PAVEMENT EDGE LY O 24" (600mm) FROM PAVEMENT EDGE 5 >= 45 MPH INS TIONS DAY ONLY, FOR SPEEDS >= 45 MPH DAY ONLY

ONLY, FOR SPEEDS >= 45 MPH TO 55 MPH MOVING OPERATION, FOR SPEEDS >= 45 MPH ESSWAY

WITH NONTRAVERSABLE MEDIAN ION

TORS

FOR SIGNS & MARKERS)

VEMENT MARKERS OUNTING DETAILS

480V

GENERAL NOTES

The contractor shall notify Traffic Operations a minimum of 5 working days prior to placing permanent pavement marking or signing.

The Contractor shall seed all disturbed areas within the project limits. Seeding Class 4 or 2A shall be used, except in front of properties where the grass will be mowed, then use Seeding, Class 1A. Class 2A shall be used on front slopes and ditch bottoms. Class 4 shall be used behind Type A gutter, on all backslopes and areas behind the backslope, and beyond the toe of front slope on fill sections without ditches.

Fertilizer Nutrients shall be applied at the rate specified in Sections 250 and 252 of the Standard Specifications. This shall be included in the cost of the SEEDING or SODDING.

Placement and compaction of the backfill for the proposed across road culverts and existing across road culverts that are removed, shall conform to Article 502.10 of the standard specifications, except that the material, either production aggregate or excavated material, shall conform to Article 208.02 of the standard specifications, and shall be compacted to a minimum of 95% of the standard laboratory density. The top one foot of trench backfill shall be gradation CA06 or CA10, beneath the proposed pavement/patch.

The entire excavation, within 2 feet outside of each shoulder, shall be backfilled with trench backfill material to the bottom of the proposed pavement/patch. Impervious material shall be used on the outer 3 feet at each end of the culvert.

The trench backfill material will be measured for payment in accordance with Article 502.12, not to exceed 2 feet outside the structure.

When laying out for patching, the minimum distance between new patches (saw cut to saw cut) shall be 15 feet. When patch spacing is less than 15 feet, the pavement between patches shall also be removed and replaced.

The existing hot-mix asphalt on private and commercial entrances shall be bladed off or milled and disposed of outside the project limits. This could be the entire entrance or tapered at the end depending on if the mainline is resurfaced or milled and resurfaced. The cost of the blading, milling, rolling, and disposal is included in the contract unit price for INCIDENTAL HOT-MIX ASPHALT SURFACING.

The drop off that occurs at entrance edges as a result of resurfacing of the entrance shall be corrected using aggregate shoulder material. This work shall be paid for by the TON for Aggregate Shoulders of the type specified in the plans.

The following Mixture Requirements are applicable for this project:

	Mainline	Shoulders	Patching
Location and Mixture Use(s):	Surface	Surface	Binder
PG:	PG 58-28	PG 58-28	PG 64-20
Design Air Voids:	4.0 @ N50	4.0 @ N50	4.0 @ N50
Mixture Composition:	IL 9.5	IL 9.5	IL 19.0
Friction Aggregate:	D	С	N/A
Mixture Weight:	112 lbs/sy/in	112 lbs/sy/in	N/A
Quality Management Program:	QCP	QC/QA	QC/QA
Sublot Size:	1000	N/A	N/A
Material Transfer Device	Yes	No	No

The Contractor will be required to furnish 5 1/2" high brass stencils as approved by the Engineer and install stationing at 250' intervals. Stationing shall be placed on both lanes of 2-lane highways and on the outside lanes in both directions on 4-lane highways. The stations shall be placed 6" inside the pavement marking edge so they can be read from the shoulder. This work will be included in the cost of the final pavement surface.

The area to be tacked or primed shall be limited to that which can be covered with HMA on the next day's production, but no more than five days in advance of the placement of the HMA, unless approved by the Engineer.

Connecting bands for corrugated metal pipes shall be metal and shall be coated with the same material as the pipe sections. The connecting bands shall be a minimum of 18" wide.

The Contractor shall supply the Resident Engineer with the manufacturer's installation requirements for the type of Steel Plate Beam Guardrail Terminal Type 1 Special (Tangent) or Steel Plate Beam Guardrail Terminal Type I Special (Flared).

Delineators shall be installed as shown in Standard 635001, except that the post shall be rotated 180° and only metalbacked delineators shall be permitted. Delineators shall be placed at the ends of approach guardrail terminal sections, and at each headwall or end section of AR Culverts. This work will be paid for at the contract unit price each for DELINEATORS.

The Contractor shall be responsible for collecting and maintaining an electronic log of all stakeout survey that is performed on the job, either by him/her or any sub-contractor performing the stakeout. Upon request, all logs shall be submitted to the Department. No additional compensation will be allowed for this work, but shall be considered included in the cost for CONSTRUCTION LAYOUT.

Pavement Marking shall be done according to Standard 780001, except as follows:

- All words, such as ONLY, shall be 8 feet high. 1.
- All non-freeway arrows shall be the large size. 2. 3.
- Typical Lane and Edge Lines.
- 4. roadway shall be according to District Standard 41.1.

PERMANENT SURVEY MARKERS, TYPE II, shall be set at intervals of 1 mile or as directed by the Engineer. Bridge or culvert projects shall have one survey marker placed near the structure. Estimated: 3 Each.

Permanent Survey Markers, Type II shall be cast-in-place as shown on District Standard 66.2, or another option would be to install a vaulted style, monumented as described by NGS as a 3D monument (Top Security Sleeve Rod Monument), with installation instructions provided by the District Chief of Surveys. If poured in place, the bottom of the marker shall be 5'-0" below the ground surface.

The Permanent Survey Markers, if possible, shall be installed at the beginning of the job and protected throughout.

The Contractor shall submit to the Engineer a description of location, elevation, and coordinates for each permanent survey marker. The horizontal coordinates must be derived by GPS and the elevation derived using an electronic level. The meta data, such as the Geoid used, (NGS adjustment ie: 97 HARN, 03, 07), and the base point(s) name or number shall be submitted along with a complete collection log. If collected using RTK method, it will require either 3 collections (averaged) from 2 different bases, or a minimum of 3 collections (averaged), at least 2 hours apart, from the same base. If using a CORS type network, the collection procedure shall include localizing with check shots on at least 2 different HARN monuments both before and after collection. The level circuit shall be run from furnished mark to furnished mark and then adjusted. The error of closure shall be submitted with the electronic level notes in a recognized format approved by the Engineer and/or the Chief of Surveys. The Engineer shall submit this information to the District Chief of Surveys.

Work on this project will be in progress at the same time as work on the I-88 bridge on IL 40. Work on these projects shall be scheduled to keep interference between all the projects to a minimum. The contractors shall inform each other of progress of the projects and give fair warning to the other contractors when a problem might be encountered.

	USER NAME =	DESIGNED - Engineering Systems	REVISED -					ROUTE	SECTION	COUNTY	TOTAL SHEET SHEETS NO.
FILE NAME = 64P41.GN (003).DOCX		DRAWN -	REVISED -	STATE OF ILLINOIS		GENERAL N	OTES	FAP 646	(101, 102, 135)RS	Whiteside & Bureau	179 3
FILE NAME = 64P41.GN (003).DOCX	PLOT SCALE =	CHECKED -	REVISED -	DEPARTMENT OF TRANSPORTATION		•				CONTRACT NO. 64P4	1
	PLOT DATE = 8/24/2023 1:49 PM	DATE - 8/21/2023 1:42 PM	REVISED -		SCALE:	SHEET NO. OF SHEETS	STA. TO STA.		ILLI	FED. AID PROJECT	

The distance between yellow no-passing lines shall be 8 inches, not 7 inches, as shown in the detail of

Centerline Skip Dash Pavement Marking on multi-lane divided, multi-lane undivided, and one-way

GENERAL NOTES

The following listed utilities located within the project limits or immediately adjacent to the project construction limits are members of JULIE:

Oneok North System, L.L.C. AT&T Communications, Inc. Mediacom AT&T	(815) 942-2230 (630) 552-4677 (309) 743-4750 (309) 757-5762
Nicor Gas Co.	(630) 388-3019
City of Rock Falls	(815) 622-1120
Comcast Cable	(224) 229-5432
iFiber	(815) 753-5798
Alliance Pipeline Company	(952) 983-1016
Kinder Morgan Cochin LLC	(641) 228-3021
Adesta/G4S Technology, LLC	(331) 264-1971
Frontier Legacy	(309) 853-6293
Commonwealth Edison Company	(309) 883-4400
Level 3 (Century Link)	(636) 887-4747
Midwest Fiber Networks LLC	(414) 672-5612

IDOT is not a member of JULIE. If you are near any overhead lighting, intersection lighting or traffic signals, contact the IDOT Traffic Office at 815/284-5469 for D2 or 815/434-6131 for D3 or you can email Yogesh Patel (<u>Yogesh.Patel@illinois.gov</u>), Dan Devine (<u>Daniel.Devine@illinois.gov</u>) and Angel Rodriguez (<u>Angel.Rodriguez2@illimnois.gov</u>). D2 has services at IL 40 & IL 172 and at IL 40 & I-88. D3 has flashers and 2 streetlights at IL 40 & IL 92. Please contact IDOT at least 48 hours prior to work.

Work on this project will be in progress at the same time as contract 64S39. The IL 40 Bridge will be the detour route for the US 30 connector bridge over I-88.

Contract 64P41 will have a restriction that no work north of Duden Road, along IL 40 will be allowed until Tuesday, September 3, 2024, unless approved by Justin Rusfeldt at cell phone number 815-213-2529 or office number 815-284-5339.

Custom General Notes for 64P41:

- The contractor shall notify District 2 Operations for a final signing review prior to ordering.
- All work shall be done within existing ROW.
- Once guardrail is removed, it must be replaced within 48 hours and not to be removed over a weekend.
- The cost of non-standard milling depth will be included in the cost of HMA surface removal 1 1/4".

	USER NAME =	DESIGNED - Engineering Systems	REVISED -			-			
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FILE NAME = 64P41.GN (003).DOCX	PLOT SCALE =	CHECKED -	REVISED -	DEPARTMENT OF TRANSPORTATION		•			0.20
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ROUTE	SECTION	COUNTY	TOTAL SHEETS	SHEE NO.
ROUTE FAP 646	SECTION (101, 102, 135)RS	COUNTY Whiteside & Bureau	total Sheets 179	shee NO. 4
				NO.

					C	CONSTRUCTION CODE	
				STP · 80% FED	STP - 80% FED	STP 5000-50,000 - 80% FED	NHPP - 80% FE
				20% STATE	20% STATE	20% STATE	20% STATE
				ROADWAY		ROADWAY	
				0005		0005	
CODE			TOTAL	BUREAU		WHITESIDE	
NO.	ITEM	UNIT	QUANTITY	RURAL	RURAL	URBAN	URBAN
20100210	TREE REMOVAL (OVER 15 UNITS DIAMETER)	UNIT	1091	254	459	378	0
20200100	EARTH EXCAVATION	CU YD	536	14	433	36	53
,			221		221		0
20800150	TRENCH BACKFILL	CU YD	231	0	231	0	0
21101615	TOPSOIL FURNISH AND PLACE, 4"	SQ YD	4663	136	3990	273	264
25000110	SEEDING, CLASS 1A	ACRE	0.25	0	0	0.25	0
25000210	SEEDING, CLASS 2A	ACRE	1.25	0.042	0.818	0.174	0.071
23000210			1.25	5.042	0.818	0.174	0.071
25000310	SEEDING, CLASS 4	ACRE	0.25	0	0.151	(0.10	0
25100630	EROSION CONTROL BLANKET	SQ YD	6141	205	4699	893	344
28000250	TEMPORARY EROSION CONTROL SEEDING	POUND	381	12	292	55	22
28000305	TEMPORARY DITCH CHECKS	FOOT	295	0	267	28	0
28000400		FOOT	1427	162	544	199	522
28000500	INLET AND PIPE PROTECTION	EACH	7	0	F		0
20000000			/	0	5	2	0
40600290	BITUMINOUS MATERIALS (TACK COAT)	POUND	129347	14088	79990	21345	13924
40600370	LONGITUDINAL JOINT SEALANT	FOOT	85272	8588	47627	15448	13609

USER NAME = Cristian.Rosas	DESIGNED -	REVISED -								F.A.P. BTE	SECTION	COUNTY	TOTAL S	HEET
	DRAWN -	REVISED -	STATE OF ILLINOIS		S	UMMARY	' OF QU	ANTITIES		646	(101, 102, 135)RS	WHITESIDE	179	5
PLOT SCALE = 100.0000 / in	CHECKED -	REVISED -	DEPARTMENT OF TRANSPORTATION								(, , , , , , , , , , , , , , , , , , ,	CONTRACT	NO. 64P	41
PLOT DATE = 12/7/2023	DATE -	REVISED -		SCALE:	SHEET	OF	SHEETS	STA.	TO STA.		ILLINOIS FED. A	ID PROJECT		

					(CONSTRUCTION CODE	
				STP - 80% FED	STP - 80% FED	STP 5000-50,000 - 80% FED	NHPP - 80% FEI
				20% STATE	20% STATE	20% STATE	20% STATE
				ROADWAY		ROADWAY	
00055			TOTAL	0005		0005	
CODE NO .	ITEM		TOTAL QUANTITY	BUREAU RURAL	RURAL	WHITESIDE URBAN	URBAN
NO .		UNIT	QUANTITI	KUKAL	KURAL		UKBAN
40601005	HOT-MIX ASPHALT REPLACEMENT OVER PATCHES	TON	7671	937	4811	961	962
40604050	HOT-MIX ASPHALT SURFACE COURSE, IL-9.5, MIX "C", N50	TON	9166	946	5904	1363	953
40604060	HOT-MIX ASPHALT SURFACE CCURSE, IL-9.5, MIX "D", N50	TON	24262	2802	14849	3549	3062
40800050	INCIDENTAL HOT-MIX ASPHALT SURFACING	TON	2071	221	1117	733	0
44000154	HOT-MIX ASPHALT SURFACE REMOVAL, 1 1/4"	SQ YD	251948	30760	173385	45891	1912
44000157	HOT-MIX ASPHALT SURFACE REMOVAL, 2"	SQ YD	28423	0	0	0	28423
44002232	HOT-MIX ASPHALT REMOVAL OVER PATCHES, 8"	SQ YD	17122	2091	10739	2146	2146
44201421	CLASS C PATCHES, TYPE IV, 15 INCH	SQ YD	89	0	89	0	0
48102100	AGGREGATE WEDGE SHOULDER, TYPE B	TON	4289	556	2841	774	118
50105220	PIPE CULVERT REMOVAL	FOOT	119	0	80	39	0
542A0223	PIPE CULVERTS, CLASS A, TYPE 1 18"	FOOT	40	0	40	0	0
542D0220	PIPE CULVERTS, CLASS D, TYPE 1 15"	FOOT	79	0	42	37	0
54260515	SLOPED METAL END SECTION, STANDARD 542411, 15", 1:6	EACH	4	0	2	2	0
54261418	CONCRETE END SECTION, STANDARD 542001, 18", 1:4	EACH	2	0	2	0	0

USER NAME = Cristian.Rosas	DESIGNED -	REVISED -								F.A.P. BTE	SECTION	COUNTY 5	OTAL SHEET
	DRAWN -	REVISED -	STATE OF ILLINOIS					ANTITIES		646	(101, 102, 135)RS	WHITESIDE	179 6
PLOT SCALE = 100.0000 / in	CHECKED -	REVISED -	DEPARTMENT OF TRANSPORTATION									CONTRACT N	NO. 64P41
PLOT DATE = 12/7/2023	DATE -	REVISED -		SCALE:	SHEET	OF	SHEETS	STA.	TO STA.		ILLINOIS FED. A	ID PROJECT	

					C	CONSTRUCTION CODE	
				STP - 80% FED	STP - 80% FED	STP 5000-50,000 - 80% FED	NHPP - 80% FED
				20% STATE	20% STATE	20% STATE	20% STATE
				ROADWAY		ROADWAY	1
				0005		0005	
CODE			TOTAL	BUREAU		WHITESIDE	
	I TEM						
NO.	ITEM		QUANTITY	RURAL	RURAL	URBAN	URBAN
60905305	BOX CULVERTS TO BE CLEANED	FOOT	43	0	43	0	0
60920015	PIPE CULVERTS TO BE CLEANED 15"	FOOT	50	0	50	0	0
60920042	PIPE CULVERTS TO BE CLEANED 42"	FOOT	58	58	0	0	0
63000001	STEEL PLATE BEAM GUARDRAIL, TYPE A, 6 FOOT POS⊺S	FOOT	1812.5	37.5	1012.5	462.5	300
63000030	STRONG POST GUARDRAIL ATTACHED TO CULVERT	FOOT	46.88	46.88	0	0	0
63000050	WEAK POST GUARDRAIL ATTACHED TO CULVERT CASE I	FOOT	75	0	75	0	0
63000350	LONG-SPAN GUARDRAIL OVER CULVERT, 12 FT 6 IN SPAN	FOOT	75	0	75	0	0
63000360	LONG-SPAN GUARDRAIL OVER CULVERT, 18 FT 9 IN SPAN	FOOT	88	0	0		0
63100085	TRAFFIC BARRIER TERMINAL, TYPE 6	EACH	6	0	4	0	2
63100087	TRAFFIC BARRIER TERMINAL, TYPE 6A	EACH	4	0	4	0	0
63100167	TRAFFIC BARRIER TERMINAL, TYPE 1 (SPECIAL) TANGENT	EACH	20	2	14	2	2
63100169	TRAFFIC BARRIER TERMINAL, TYPE 1 (SPECIAL) FLARED	EACH	2	0	0	2	0
63200310	GUARDRAIL REMOVAL	FOOT	3062	210	1639	746	467
63301210	REMOVE AND REERECT STEEL PLATE BEAM GUARDRAIL, TYPE A	FOOT	425	0	425	0	0
63301210		F001	425	0	425	0	0

	USER NAME = Cristian.Rosas	DESIGNED -	REVISED -								F.A.P. BTE	SECTION	COUNTY	TOTAL SHEET
		DRAWN -	REVISED -	STATE OF ILLINOIS		S	SUMMAR	Y OF QU	ANTITIES		646	(101, 102, 135)RS	WHITESIDE	179 7
	PLOT SCALE = 100.0000 / in.	CHECKED -	REVISED -	DEPARTMENT OF TRANSPORTATION									CONTRACT	NO. 64P41
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						CONSTRUCTION CODE	
					STP - 80% FED		NHPP - 80% FE
				20% STATE	20% STATE	20% STATE	20% STATE
				ROADWAY		ROADWAY	
				0005		0005	
CODE			TOTAL	BUREAU		WHITESIDE	
NO.	ITEM	UNIT	QUANTITY	RURAL	RURAL	URBAN	URBAN
63301990	REMOVE AND REERECT TRAFFIC BARRIER TERMINALS, TYPE 1	EACH	3	0	3	0	0
63302700	REMOVE AND REERECT TRAFFIC BARRIER TERMINALS, TYPE 6	EACH	3	0	3	0	0
63500105	DELINEATORS	EACH	28	6	16	4	2
64200108	SHOULDER RUMBLE STRIPS, 8 INCH	FOOT	113950	15173	76681	20901	1195
64200116	SHOULDER RUMBLE STRIPS, 16 INCH	FOOT	8725	278	3775	822	3850
66700305	PERMANENT SURVEY MARKERS, TYPE II	EACH	3	0	1	2	0
66900200	NON-SPECIAL WASTE DISPOSAL	CU YD	38	0	0	38	0
66900530	SOIL DISPOSAL ANALYSIS	EACH	2	0	0	2	0
			2			Z	
66901001	REGULATED SUBSTANCES PRE-CONSTRUCTION PLAN	L SUM	1	0	0	1	0
66901003	REGULATED SUBSTANCES FINAL CONSTRUCTION REPORT	L SUM	1	0	0	1	0
66901006	REGULATED SUBSTANCES MONITORING	CAL DA	4	0	0	4	0
67000400	ENGINEER'S FIELD OFFICE, TYPE A	CAL MO	7	2	3	1.5	0.5
67100100	MOBILIZATION	L SUM	1	0.5	0	0.35	0.15
70100310	TRAFFIC CONTROL AND PROTECTION, STANDARD 701421	L SUM	1	0	0.5	0.5	0
*= SPECIAI							

USER NAME = Cristian.Rosas	DESIGNED -	REVISED -								F.A.P. BTF	SECTION	COUNTY	SHEETS	HEET NO.
	DRAWN -	REVISED -	STATE OF ILLINOIS		S	SUMMARY	' OF QU	ANTITIES		646	(101, 102, 135)RS	WHITESIDE	179	8
PLOT SCALE = 100.0000 / in	CHECKED -	REVISED -	DEPARTMENT OF TRANSPORTATION								(),,	CONTRAC	T NO. 64F	241
PLOT DATE = 12/7/2023	DATE -	REVISED -		SCALE:	SHEET	OF	SHEETS	STA.	TO STA.		ILLINOIS FE	AID PROJECT		

					r	CONSTRUCTION CODE	-
				STP · 80% FED	STP - 80% FED	STP 5000-50,000 - 80% FED	NHPP - 80% FE
				20% STATE	20% STATE	20% STATE	20% STATE
				ROADWAY		ROADWAY	
				0005		0005	
CODE			TOTAL	BUREAU		WHITESIDE	
NO.	ITEM	UNIT	QUANTITY		RURAL	URBAN	URBAN
NO.			QUANTITI	KORAL	KUKAL		UNDAN
70100450	TRAFFIC CONTROL AND PROTECTION, STANDARD 701201	L SUM	1	0	1	0	0
70100460	TRAFFIC CONTROL AND PROTECTION, STANDARD 701306	L SUM	1	0.5	0	0.5	0
70100825	TRAFFIC CONTROL AND PROTECTION, STANDARD 701456	L SUM	1	0	0	0	1
						0	
70102620	TRAFFIC CONTROL AND PROTECTION, STANDARD 701501	L SUM	1	0	0	1	0
70102630	TRAFFIC CONTROL AND PROTECTION, STANDARD 701601	L SUM	1	0.5	0	0	0.5
70102635	TRAFFIC CONTROL AND PROTECTION, STANDARD 701701	L SUM	1	0.5	0	0	0.5
70103815	TRAFFIC CONTROL SURVEILLANCE	CAL DA	6	3	0	1	2
70107025	CHANGEABLE MESSAGE SIGN	CAL DA	56	5	11	0	40
70300100	SHORT TERM PAVEMENT MARKING	FOOT	15647	1946	10024	2558	1119
70300150	SHORT TERM PAVEMENT MARKING REMOVAL	SQ FT	2608	324	1671	613	0
72000100	SIGN PANEL - TYPE 1	SQ FT	753	118	252	278	105
72000200	SIGN PANEL - TYPE 2	SQ FT	191	46	110	35	0
72400310	REMOVE SIGN PANEL - TYPE 1	SQ FT	734	83	227	314	110
72400320	REMOVE SIGN PANEL - TYPE 2	SQ FT	171	25	126	0	0
12400320			171	35	136	0	0

USER NAME = Cristian.Rosas	DESIGNED -	REVISED -								F A P RTE	SECTION	COUNTY	TOTAL SHEETS	SHEET NO.
	DRAWN -	REVISED -	STATE OF ILLINOIS DEPARTMENT OF TRANSPORTATION			SUMMARY		ANTITIES		646	(101, 102, 135)RS	WHITESIDE	179	9
PLOT SCALE = 100.0000 / in	CHECKED -	REVISED -										CONTRACT	F NO. 64	P41
PLOT DATE = 12/7/2023	DATE -	REVISED -		SCALE:	SHEET	OF	SHEETS	STA.	TO STA.		ILLINOIS FED. A	ID PROJECT		

					(CONSTRUCTION CODE	
				STP - 80% FED	STP - 80% FED	STP 5000-50,000 - 80% FED	NHPP - 80% FE
				20% STATE	20% STATE	20% STATE	20% STATE
				ROADWAY		ROADWAY	
				0005		0005	
CODE			TOTAL	BUREAU		WHITESIDE	
NO.	LTEM				RURAL	URBAN	URBAN
NO.	ITEM		QUANTITY	KUKAL	RURAL	URBAN	URBAN
72400710	RELOCATE SIGN PANEL - TYPE 1	SQ FT	41	0	32	9	0
72400720	RELOCATE SIGN PANEL - TYPE 2	SQ FT	64	0	48	16	0
72501000	TERMINAL MARKER - DIRECT APPLIED	EACH	22	2	14	4	2
72800100	TELESCOPING STEEL SIGN SUPPORT	FOOT	463	98	246	42	77
73000100	WOOD SIGN SUPPORT	FOOT	785	161	262	262	100
78000100	THERMOPLASTIC PAVEMENT MARKING - LETTERS AND SYMBOLS	SQ FT	313	0	63	78	172
78000200	THERMOPLASTIC PAVEMENT MARKING - LINE 4"	FOOT	167818	23082	104045	27593	13098
78000500	THERMOPLASTIC PAVEMENT MARKING - LINE 8"	FOOT	2437	268	571	0	1598
78000600	THERMOPLASTIC PAVEMENT MARKING - LINE 12"	FOOT	4807	1016	540	799	2452
78000650	THERMOPLASTIC PAVEMENT MARKING - LINE 24"	FOOT	173	55	35	0	83
78009004	MODIFIED URETHANE PAVEMENT MARKING - LINE 4"	FOOT	2329	0	1704	0	625
78011000	GROOVING FOR RECESSED PAVEMENT MARKING, LETTERS AND SYMBOLS	SQ FT	348	0	70	0	278
78011025	GROOVING FOR RECESSED PAVEMENT MARKING 5"	FOOT	167818	23082	104045	27593	13098
78011045	GROOVING FOR RECESSED PAVEMENT MARKING 9"	FOOT	2437	268	571	0	1598

USER NAME = Cristian.Rosas	DESIGNED -	REVISED -								F A P BTE	SECTION	COUNTY TOTA	AL SHEET
	DRAWN -	REVISED -	STATE OF ILLINOIS		SUMMARY OF QUANTITIES				646	(101, 102, 135)RS	WHITESIDE 179	3 10	
PLOT SCALE = 100.0000 / in	CHECKED -	REVISED -	DEPARTMENT OF TRANSPORTATION							CONTRACT NO.	64P41		
 PLOT DATE = 12/7/2023	DATE -	REVISED -		SCALE:	SHEET	OF	SHEETS	STA.	TO STA.		ILLINOIS FED. A	AID PROJECT	


						CONSTRUCTION CODE	
						STP 5000-50,000 - 80% FED	NHPP - 80% FE
				20% STATE	20% STATE	20% STATE	20% STATE
	1			ROADWAY		ROADWAY	
CODE			TOTAL	0005			
CODE NO .	ITEM	UNIT	QUANTITY	BUREAU RURAL	RURAL	WHITESIDE URBAN	URBAN
NO.			QUANTITY	RURAL	RURAL		URBAN
78011065	GROOVING FOR RECESSED PAVEMENT MARKING 13"	FOOT	4807	1016	540	799	2452
78011125	GROOVING FOR RECESSED PAVEMENT MARKING 25"	FOOT	173	55	35	0	83
78100100	RAISED REFLECTIVE PAVEMENT MARKER	EACH	302	24	32	119	127
78300200	RAISED REFLECTIVE PAVEMENT MARKER REMOVAL	EACH	863	690	118	55	0
80400100	ELECTRIC SERVICE INSTALLATION	EACH	1	0	0	0	1
81028750	UNDERGRCUND CONDUIT, COILABLE NONMETALLIC CONDUIT, 2" DIA.	- FOOT	160	0	0	0	160
81603040	UNIT DUCT, 600V, 2-1C NO.6, 1/C NO.8 GROUND, (XLP-TYPE USE), 1" DIA. POLYETHYLENE	FOOT	505	0	0	0	505
82110007	LUMINAIRE, LED, ROADWAY, OUTPUT DESIGNATION G	EACH	3	0	0	0	3
82110008	LUMINAIRE, LED, ROADWAY, OUTPUT DESIGNATION H	EACH	12	0	0	0	12
82500340	LIGHTING CONTROLLER, PEDESTAL MOUNTED, 480VOLT, 60AMP	EACH	1	0	0	0	1
84500110	REMOVAL OF LIGHTING CONTROLLER	EACH	1	0	0	0	1
84500120	REMOVAL OF ELECTRIC SERVICE INSTALLATION	EACH	1	0	0	0	1
X0326697	CENTER LINE - RUMBLE STRIP - 8"	FOOT	5901	1676	3592	633	0
X0326899	SOLAR-POWERED FLASHING BEACON ASSEMBLY (COMPLETE)	EACH	4	0	0	4	0

USER NAME = Cristian.Rosas	DESIGNED -	REVISED -								F.A.P. BTE	SECTION	COUNTY	TOTAL	SHEET
	DRAWN -	REVISED -	STATE OF ILLINOIS	SUMMARY OF QUANTITIES						646	(101, 102, 135)RS	WHITESIDE	179	11
PLOT SCALE = 100.0000 / in.	CHECKED -	REVISED -	DEPARTMENT OF TRANSPORTATION								CONTRAC	T NO. 6	4P41	
PLOT DATE = 12/7/2023	DATE -	REVISED -		SCALE:	SHEET	OF	SHEET	S STA.	TO STA.		ILLINOIS FED. A	D PROJECT		

						(CONSTRUCTION CODE	
					20% STATE	STP - 80% FED 20% STATE	STP 5000-50,000 - 80% FED 20% STATE	NHPP - 80% FE 20% STATE
Г				T	ROADWAY 0005		ROADWAY 0005	
	CODE			TOTAL	BUREAU		WHITESIDE	
	NO.	ITEM	UNIT	QUANTITY		RURAL	URBAN	URBAN
ſ								
>	X1400267	REMOVAL OF LIGHTING LUMINAIRE, NO SALVAGE	EACH	15	0	0	15	0
>	X4401196	HOT-MIX ASPHALT SURFACE REMOVAL- LONGITUDINAL JOINT	SQ YD	7797	915	5123	1267	492
>	x6300130	STEEL PLATE BEAM GUARDRAIL, TYPE A (SPECIAL)	FOOT	150	100	50	0	0
	X6300210	GUARDRAIL BLOCKS	EACH	26	26	0		
ŕ	~6500210					0	0	0
>	 X6310176	TRAFFIC BARRIER TERMINAL, TYPE 2 (SPECIAL)	EACH	6	4	2	0	0
>	X6330725	STEEL PLATE BEAM GUARDRAIL (SHORT RADIUS)	FOOT	75	50	25	0	0
>	X7820007	GUARDRAIL REFLECTORS, TYPE C (SPECIAL)	EACH	69	8	42	11	8
2	Z0005216	HOT-MIX ASPHALT STABILIZATION 6" AT STEEL PLATE BEAM GUARD RAIL	SQ YD	1208	0	857	128	223
Z	Z0013798		L SUM	1	0.5	0	0.35	0.15
2	Z0020900	ESTABLISHING AND REFERENCING LAND SECTION MARKERS	EACH	30	4	18	8	0
┢			TON	24262	2802	14849	3786	2825
⊢		TRAINEES	HOUR	2,000	2,000			
⊢				70	0	70	0	0
F		TRAINEES - TRAINING PROGRAM GRADUATE	HOUR SQ YD	2,000 367	2,000 367	0	0	0

Ø 0042 *SPECIALTY ITEMS


USER NAME = Cristian.Rosas	DESIGNED -	REVISED -							F A P BTF	SECTION	COUNTY	TOTAL SHEET
	DRAWN -	REVISED -	STATE OF ILLINOIS				646	(101, 102, 135)RS	WHITESIDE	179 12		
PLOT SCALE = 100.0000 / in	CHECKED -	REVISED -	DEPARTMENT OF TRANSPORTATION				I		_		CONTRACT	NO. 64P41
PLOT DATE = 12/7/2023	DATE -	REVISED -		SCALE:	SHEET	OF	SHEETS STA.	TO STA.		ILLINOIS FED. A	D PROJECT	

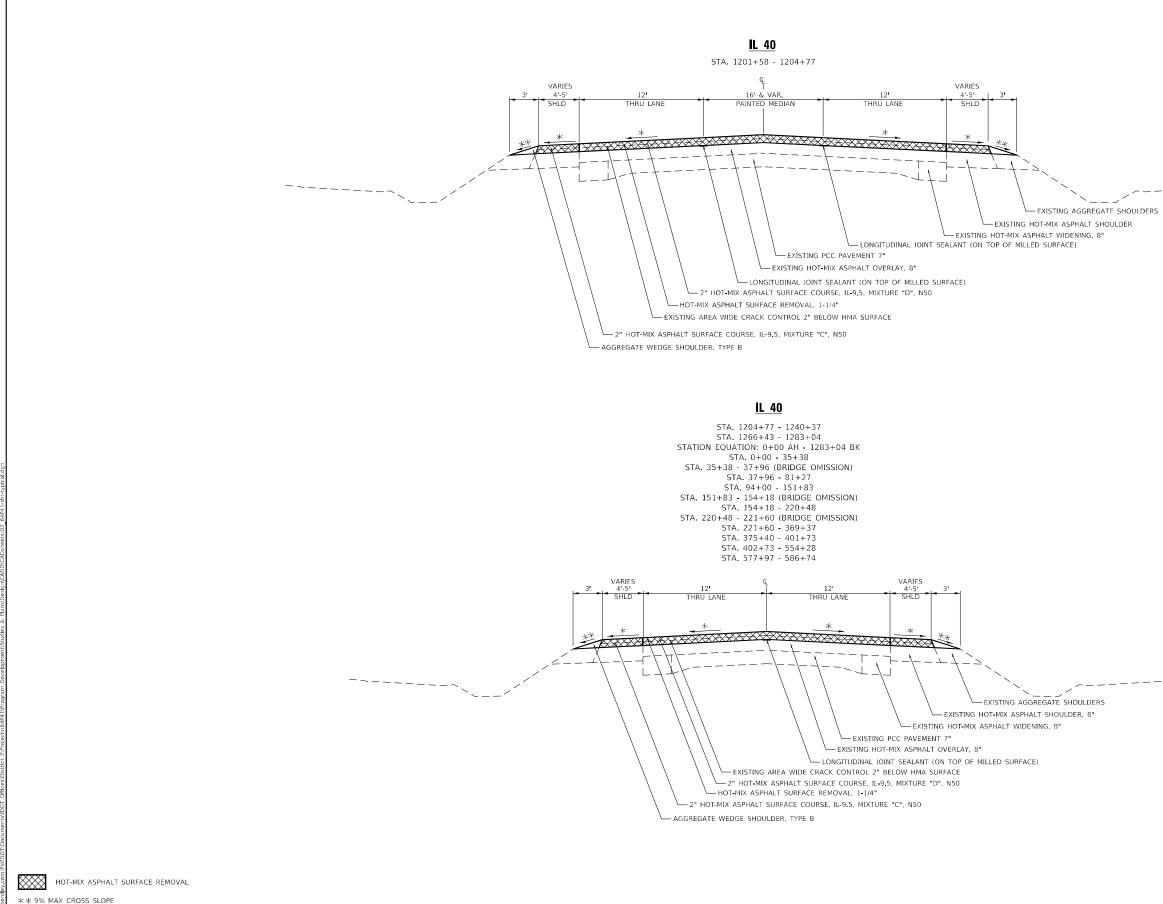

* MATCH EXISTING CROSS SLOPE RATE OF APPLICATION: 112 LB/SQ YD/IN

USER NAME = Cristian.Rosas	DESIGNED -	REVISED -							F.A.P. RTE	SECTION	COUNTY	TOTAL SHEET SHEETS NO.
	DRAWN -	REVISED -	STATE OF ILLINOIS			TYPI	CAL SECTION		646	(101, 102, 135) RS	WHITESID	E 179 13
PLOT SCALE = 120.0000 / in	CHECKED -	REVISED -	DEPARTMENT OF TRANSPORTATION								CONTRA	CT NO. 64P41
PLOT DATE = 8/24/2023	DATE -	REVISED -		SCALE:	SHEET	OF	SHEETS STA.	TO STA.		ILLINOIS FED	AID PROJECT	


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USER NAME = Cristian.Rosas	DESIGNED -	REVISED -	
	DRAWN -	REVISED -	STATE OF ILLINOIS
PLOT SCALE = 120.0000 / in.	CHECKED -	REVISED -	DEPARTMENT OF TRANSPORTATION
PLOT DATE = 8/24/2023	DATE -	REVISED -	

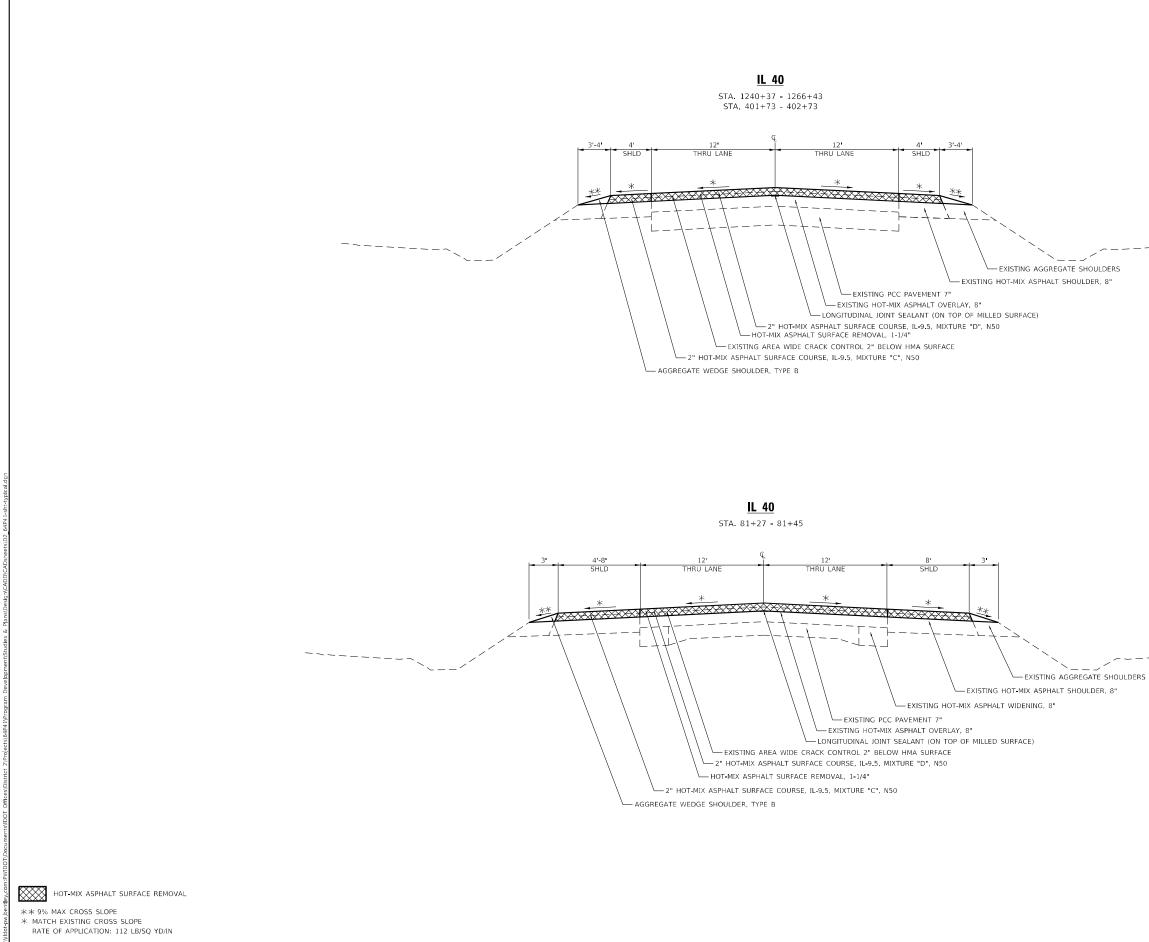
SCALE: SHEET OF SHEET

				F.A.P. RTE	F.A.P. SECTION			COUNTY	TOTAL SHEETS	SHEET NO.
TYPICAL SECTION				646	(101, 102	, 135) R	S	WHITESIDE	179	14
								CONTRACT	NO. 64	4P41
OF	SHEETS	STA.	TO STA.			ILLINOIS	FED. AI	D PROJECT		




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USER NAME = Cristian.Rosas	DESIGNED -	REVISED -							F.A.P. BTE	SECTION	COUNTY TOTAL SHEETS	EET	
	DRAWN -	REVISED -	STATE OF ILLINOIS	TYPICAL SECTION					646	(101, 102, 135) RS	WHITESIDE 179	5	
PLOT SCALE = 120.0000 / in.	CHECKED -	REVISED -	DEPARTMENT OF TRANSPORTATION						, . , . , .	CONTRACT NO. 64P	1		
PLOT DATE = 8/24/2023	DATE -	REVISED -		SCALE:	SHEET	OF	SHEETS STA.	.	TO STA.		ILLINOIS FED.	AID PROJECT	_

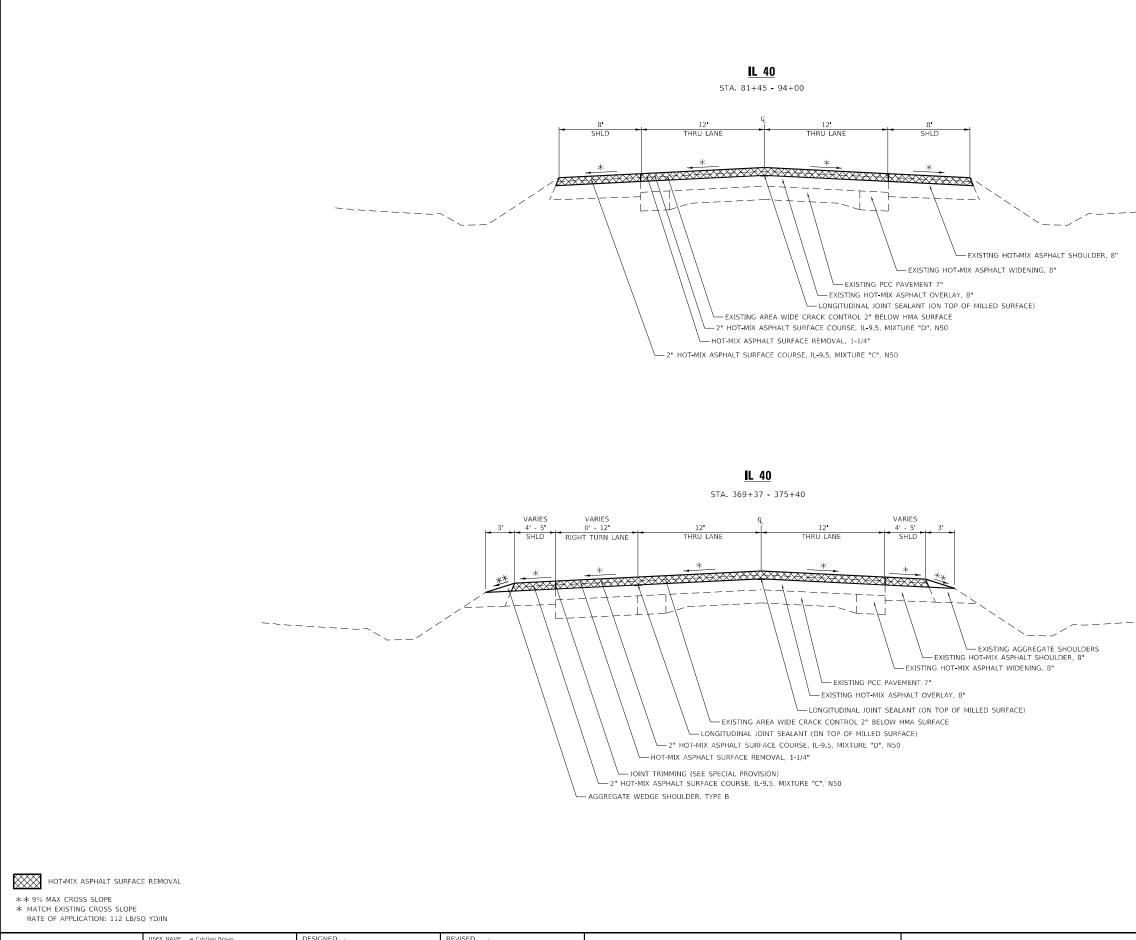

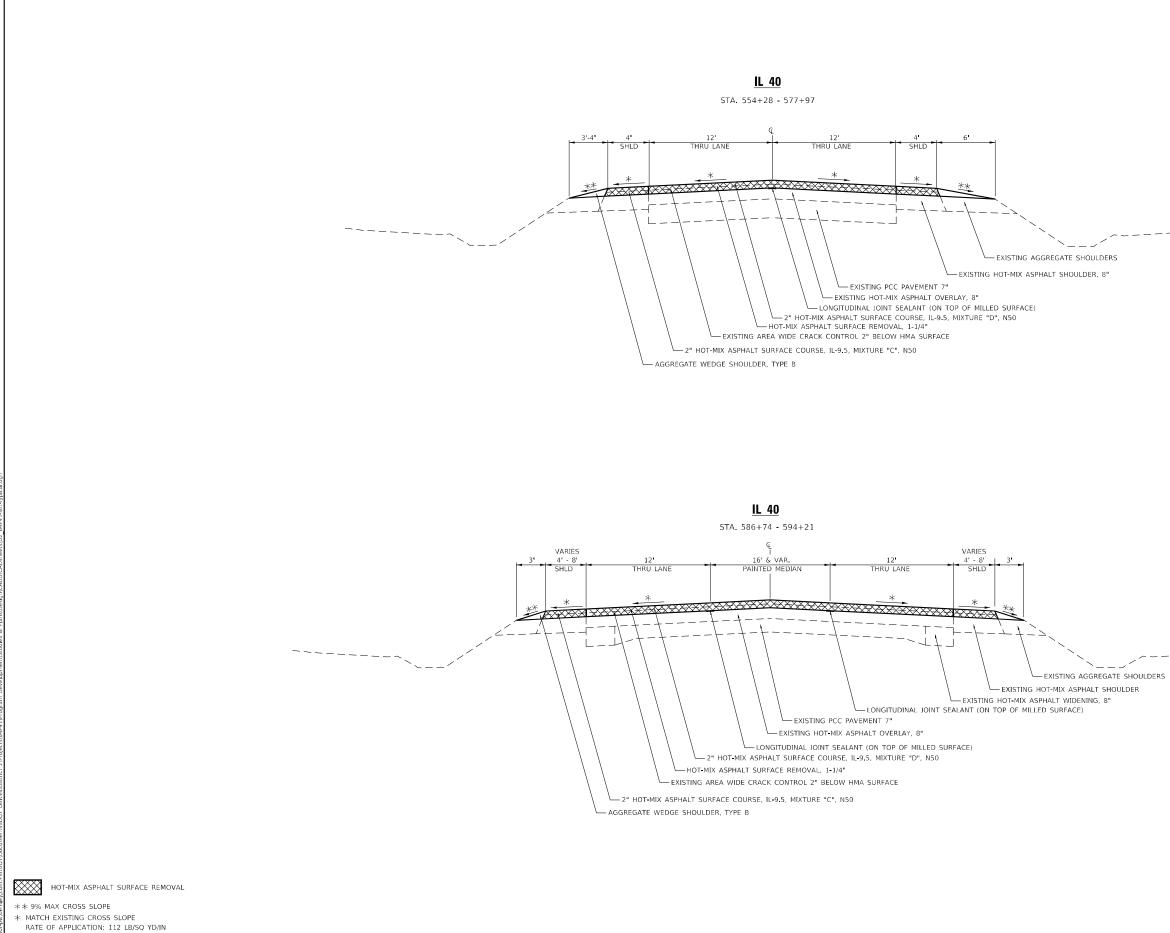USER NAME = Cristian.Rosas	DESIGNED -	REVISED -		F. B				F A P BTF	SECTION	COUNTY	TOTAL SHEET SHEETS NO.		
	DRAWN -	REVISED -	STATE OF ILLINOIS	TYPICAL SECTION			646	(101, 102, 135) RS	WHITESIDE	179 16			
PLOT SCALE = 120.0000 / in	CHECKED -	REVISED -	DEPARTMENT OF TRANSPORTATION									CONTRACT	F NO. 64P41
PLOT DATE = 8/24/2023	DATE -	REVISED -		SCALE:	SHEET	OF	SHEETS	STA.	TO STA.		ILLINOIS FED. AI	ID PROJECT	

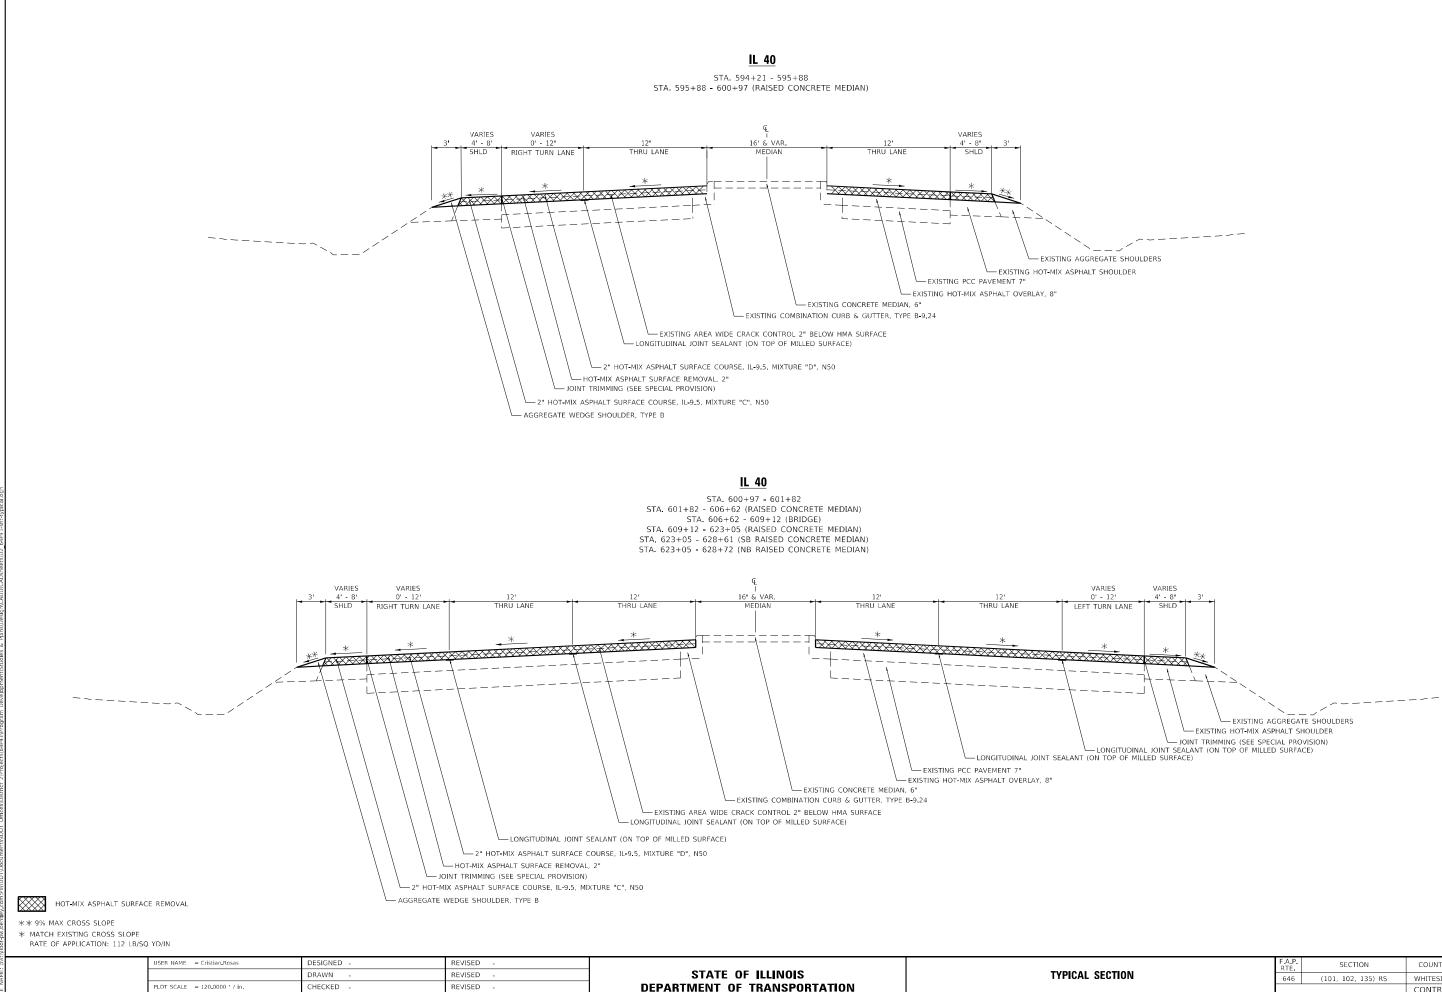


PLOT DATE = 8/24/2023
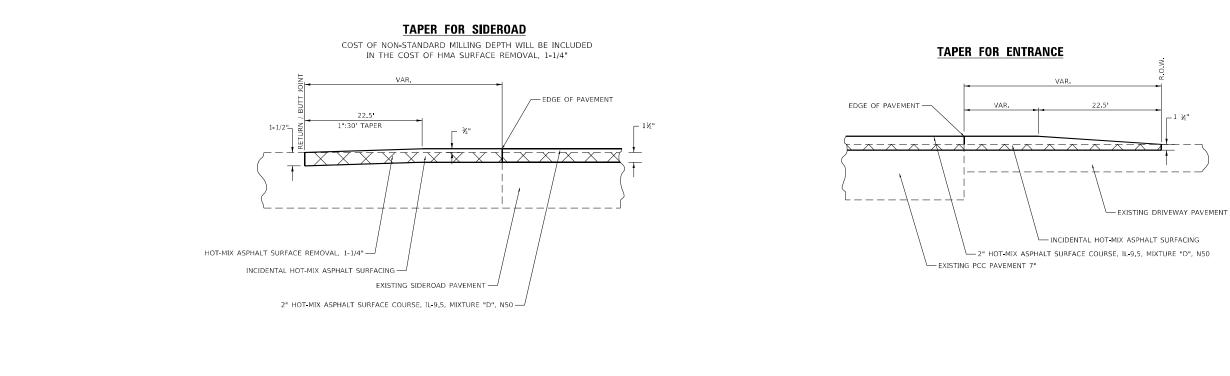
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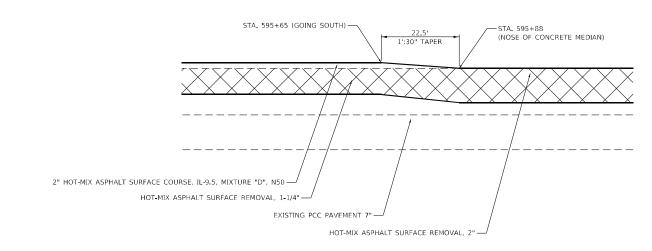
SCALE: SHEET OF SHEET

			F.A.P. RTE	SEC	COUNTY	TOTAL SHEETS	SHEET NO.		
ECI	CTION		646	(101, 102, 135) RS			WHITESIDE	179	17
			_				CONTRACT	NO. 64	4P41
TS	STA.	TO STA.			ILLINOIS	FED. A	D PROJECT		

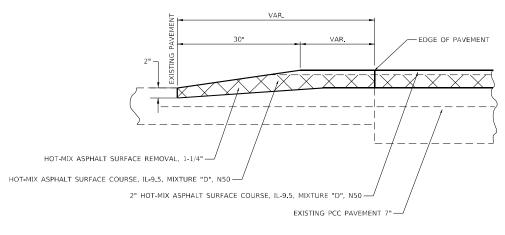


MAINLINE TAPER

COST OF NON-STANDARD MILLING DEPTH WILL BE INCLUDED IN THE COST OF HMA SURFACE REMOVAL, 2"



TAPER FOR MAINLINE IL40 COST OF NON-STANDARD MILLING DEPTH WILL BE INCLUDED IN THE COST OF HMA SURFACE REMOVAL, 1-1/4"



$\boxtimes\!$	HOT-MIX	ASPHALT	SURFACE	REMOVAL
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RATE OF APPLICATION: 112 LB/SQ YD/IN

USER NAME = Cristian Rosas	DESIGNED -	REVISED -										COUNTY	TOTAL SHEET
	DRAWN -	REVISED -	STATE OF ILLINOIS	TYPICAL SECTION			646	(101, 102, 135) RS	WHITESIDE	179 18			
PLOT SCALE = 120.0000 / in	CHECKED -	REVISED -	DEPARTMENT OF TRANSPORTATION								, . , . ,	CONTRACT	T NO. 64P41
PLOT DATE = 8/24/2023	DATE -	REVISED -		SCALE:	SHEET	OF	SHEETS	STA.	TO STA.		ILLINOIS FED.	AID PROJECT	

26.6 35.0	383+72 -	24' LT 23' LT			
37.3 <u>42.7</u> 458.5		23' LT 27' LT COUNTY (RURAL)		5010 <u>FO</u>	5220 <u>PIPE CULVERT REMOVAL</u> <u>OT LOCATION</u> OFFSET
+50.5	WHITESIDE COUNTY (3	
42.3 50.0	508+92 - 3 526+93 -	28' LT .7' RT		4	
55.1	527+18 - 3	26' LT		3	WHITESIDE COUNTY (URBAN) 9 580+10 LT
42.0 54.6		26' LT 22' RT		3	
41.0 41.3		25' RT 26' LI		11	9 TOTAL
52.0	569+20 SUBTOTAL WHITESIDE	25' LT COUNTY (URBAN)			
1090.3	TOTAL			542A <u>FO</u>	0223 PIPE CULVERTS, CLASS A, TYPE 1 18" OT <u>LOCATION</u> OFFSET
1050.5	IOTAL			4	WHITESIDE COUNTY (RURAL) 0 289+44 RT
	TRENCH BACKFILL			4	0
<u>CU YD</u>	<u>LOCATION</u> WHITESIDE COUNTY (RURAL)			
231	289+44			542D <u>FO</u>	
	_			4	WHITESIDE COUNTY (URBAN) 2 580+10 LT
	HOT-MIX ASPHALT REP	LACEMENT OVER PA		4	2
TON	<u>LOCATION</u> BUREAU (RURAL		<u>REMARKS</u>	د	WHITESIDE COUNTY (RURAL) 7 287+17 LT
	TO BE DETERMINED B SUBTOTAL BUREAU COU		REPLACEMENT OF 8" PARTIAL DEPTH PATCHES	3	
	WHITESIDE (RUR.	AL)		7	9 TOTAL
	TO BE DETERMINED B	RE/TE	REPLACEMENT OF 8" PARTIAL DEPTH PATCHES		
	WHITESIDE (URB. TO BE DETERMINED B	RE/TE	REPLACEMENT OF 8" PARTIAL DEPTH PATCHES		
1922.8	SUBTOTAL WHITESIDE	COUNTY (URBAN)			
7670.4	TOTAL				
USER	NAME = Cristian Rosas	DESIGNED - DRAWN -	REVISED - REVISED -	STATE OF ILLINOIS	F.A.P. RTE. SECTION COUNTY TOTAL SHEETS SHE SCHEDULE OF QUANTITIES 646 (101, 102, 135)RS WHITESIDE 179 19
			REVISED -		

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REMARKS CMIT DRIVEWAYS, BRIDGES, AND ENTRANCES

OMIT DEER GROVE AREA

OMIT PLAUTZ ROAD TO AIRPORT ROAD

	HANTITIES			SECT	COUNTY	TOTAL SHEETS	SHEET NO.		
DUANTITIES		646 (101, 102, 135)RS				WHITESIDE	179	20	
							CONTRACT	NO. 64	4P41
TS	STA.	TO STA.			ILLINOIS	FED. AI	D PROJECT		

64200108	SHOULDER RUMBLE	STRIPS, 8 INCH CONT	INUED	64200116	SHOULDER RUMBLE STRIPS, 16 INCH
FOOT	LOCATIO	DN	<u>REMARKS</u>	FOOT	LOCATION
	WHITESIDE COUNT	TY (RURAL)			NORTHBOUND
1960	+62	- 20+22			WHITESIDE COUNTY (RURAL)
806	23+15	- 31+21		195	33+52 - 35+47
195	31+67	- 33+62		228	38+05 40+33
1202	40+44	- 52+46		250	149+43 - 151+93
1936	53+72	- 73+08		203	218+52 - 220+55
254	73+45	- 75+99		158	221+67 - 223+25
492	76+73	81+65		326	320+75 324+01
1762	93+45	- 111+07	OMIT DEER GROVE AREA	445	401+49 405+94
737	111+70	- 119+07		1,805	SUBTOTAL WHITESIDE COUNTY (RURAL)
631	119+43	- 125+74			
486	126+05	130+91			WHITESIDE COUNTY (URBAN)
800	131+76	139+76		538	577+97 - 583+35
924	140+58	- 149+82		280	603+82 606+62
130	156+94	158+24		542	609+12 - 614+54
1248	159+14	171+62		702	616+12 - 623+14
123	172+54	- 173+77		511	623+61 - 628+72
1000	174+62	- 184+62		2,573	SUBTOTAL WHITESIDE COUNTY (URBAN)
788	185+04	- 192+92			
895	193+84	- 202+79			SOUTHBOUND
1587	203+21	219+08			BUREAU COUNTY (RURAL)
78	223+55	- 224+33		113	1232+01 - 1233+14
1267	224+72	- 237+39		165	1233+29 1234+94
1734	238+10	- 255+44		278	SUBTOTAL BUREAU COUNTY (RURAL)
2038	256+68	- 277+06			
262	277+62	280+24			WHITESIDE COUNTY (RURAL)
93	281+10	- 282+03		293	20+22 - 23+15
149	282+71	- 284+20		167	33+52 - 35+29
188	284+84	- 286+72		258	37+36 - 40+44
246	287+61	290+07		190	149+82 - 151+72
965	290+83	- 300+48		219	154+08 156+27
2118	300+89	322+07		133	219+08 - 220+41
669	324+02	- 330+71		202	221+53 223+55
2408	331+14	- 355+22		108	322+39 323+47
892	355+58	- 364+50		158	402+46 404+04
187	365+14	- 367+01		242	404+29 - 406+71
179		377+19		1,970	— SUBTOTAL WHITESIDE COUNTY (RURAL)
1748	377+55	- 395+03			
97	395+37	396+34			WHITESIDE COUNTY (URBAN)
595	396+51	402+46		92	580+12 - 581+04
136	406+71	408+07		192	581+38 583+30
851		416:82		546	601+16 - 606+62
981		427+36		523	609+12 - 614+35
145		428+95		250	620+35 - 622+85
257		431+98		496	623+65 628+61
382		436+22		2099	
878	436+94	445+72	OMIT PLAUTZ ROAD TO AIRPORT ROAD		
37,499	- SUBTOTAL WHITESI	DE COUNTY (RURAL)		278	SUBTOTAL BUREAU COUNTY (RURAL)
				3,775	SUBTOTAL WHITESIDE COUNTY (RURAL)
	WHITESIDE COUNT	TY (URBAN)		4,672	SUBTOTAL WHITESIDE COUNTY (URBAN)
480	574+41	579+21		8,725	TOTAL
18255	580+12	- 762+67			
49		- 584+17			
831		- 593+49			
465		598+74			
20,080	_	DE COUNTY (URBAN)			
15,173	SUBTOTAL BUREAU	COUNTY (RURAL)			
76,681		DE COUNTY (RURAL)			
22,096	1	DE COUNTY (URBAN)			
113,950		- · ·			

64200108	SHOULDER RUMBLE	51	FRIPS,	8	INCH	CONTI
FOOT	LOCAT	ON				
	WHITESIDE COUN	ITY	(RURAL)		
1960	+62	-	20+	22		
806	23+15		31+	21		

15,173	SUBTOTAL	BUREAU	cou	INTY
76,681	SUBTOTAL	WHITESI	DE	COUN
22,096	SUBTOTAL	WHITESI	DE	COUN
113,950	тоти	۹L		

USER NAME = Cristian.Rosas	DESIGNED -	REVISED -		F			F.A.P. BTE	SECTION	COUNTY	TOTAL SHEFTS	HEET			
	DRAWN -	REVISED -	STATE OF ILLINOIS					ANTITIES		646	(101, 102, 135)RS	WHITESIDE	179	21
PLOT SCALE = 100.0000 / in	CHECKED -	REVISED -	DEPARTMENT OF TRANSPORTATION								, . , , .	CONTRAC	T NO. 64	41
PLOT DATE = 8/24/2023	DATE -	REVISED -		SCALE: SHEET OF SHEETS STA. TO STA.				TO STA.		ILLINOIS FED. /	AID PROJECT			

2 SUBTOTAL WHITESIDE COUNTY (URBAN) 3 TOTAL 70300100 SHORT TERM PAVEMENT MARKING FOOT LENGTH FOOT LOCATION LENGTH 86 1200+48 - 1204+77 85 1204+77 - 1209+00 1271 1209+00 - 1272+55 210 1272+55 - 1283+04 1651 SUBTOTAL NB BUREAU COUNTY (RURAL) YELLOV WHITESIDE COUNTY (RURAL) YELLOV 80 1+00 - 5+37 143 37+96 - 45+11 1234 45+11 - 151+82 1326 154+18 - 220+48 508 221+60 - 247+00 194 247+00 - 256+68 123 256+68 - 262+83 4215 262+83 - 473+56 9,330 SUBTOTAL NB WHITESIDE COUNTY (RURAL) YELLOW 2212 473+56 584+17 123 266+68 - 262+83 4215 262+83 - 473+56 9,330 SUBTOTAL NB WHITESIDE COUNTY (RURAL) YELLOW 2212 473+56 <	SEE DIST STD 66.2 IL 40 at Bell Road SEE DIST STD 66.2 IL 40 at Grennan Road (NE Quad) south Knief Road(Sta 537+35:27 RT)	WHITESIDE COUNTY (RURAL) 89 1+00 - 5+46 147 28+00 - 35+37 20 34+37 - 35+37 143 37+96 - 45+11 169 247+00 - 255+44 125 255+44 - 261+70 694 SUBTOTAL SB WHITESIDE COUNTY (RURAL) WHITESIDE COUNTY (RURAL) WHITESIDE COUNTY (URBAN) 127 584+17 - 590+50 101 595+90 - 606+62 93 609+12 - 613+75 169 614+62 - 623+63 100 623+63 - 628+61 605 SUBTOTAL SD WHITESIDE COUNTY (URBAN) (X 2 10,024 SUBTOTAL BUREAU COUNTY (RURAL) (X 2 SUBTOTAL WHITESIDE COUNTY (URBAN) (X 2 10,024 SUBTOTAL WHITESIDE COUNTY (URBAN) (X 2 SUBTOTAL WHITESIDE COUNTY (URBAN) (X 2 15,647 TOTAL SUBTOTAL WHITESIDE COUNTY (URBAN)	
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2992 SUBTOTAL NB WHITESIDE COUNTY (URBAN) YELLOW			
SOUTHBOUND			
BUREAU COUNTY (RURAL)			
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169 1272+55 - 1281+00			
41 1281+00 - 1283+04			
294 SUBTOTAL SB BUREAU COUNTY (RURAL) YELLOW			

USER NAME = Cristian.Rosas	DESIGNED -	REVISED -								F.A.P. BTE	SECTION	COUNTY 5	TOTAL SHEET
	DRAWN -	REVISED -	STATE OF ILLINOIS	SCHEDULE OF QUANTITIES				646	(101, 102, 135)RS	WHITESIDE	179 22		
PLOT SCALE = 100.0000 / in.	CHECKED -	REVISED -	DEPARTMENT OF TRANSPORTATION								(, , , , , , , , , , , , , , , , , , ,	CONTRACT N	NO. 64P41
PLOT DATE = 8/24/2023	DATE -	REVISED -		SCALE:	SHEET	OF	SHEETS	STA.	TO STA.		ILLINOIS FED. AI	D PROJECT	

<u>REMARKS</u>

YELLOW BROKEN CENTERLINE ID CENTERLINE/ CONCRETE MEDIAN ID CENTERLINE/ CONCRETE MEDIAN ID CENTERLINE/ CONCRETE MEDIAN ID CENTERLINE/ CONCRETE MEDIAN

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<u>REMARKS</u>

SURFACE APPLICATION ONLY

SURFACE APPLICATION ONLY

SURFACE APPLICATION ONLY

MITTERE STATE MITTERE	<u>SQ_FT</u>	LOCAT	ION	OFFSET REMARKS	FOOT	LOCATION	OFFS
4.0.6 6.1201 6.374 LT TURN ARRAY (3 MEDDAY 10, 18 WITDOW FAMM 6.379 4.4-20 5.489 1.5.6 6.4490 ARR FT TURN ARRAY (11 MARCAY) 3.47 5.327 5.349 1.5.6 6.4490 ARR FT TURN ARRAY (11 MARCAY) 3.48 5.53 5.53 4.6.9 SUBJAK SUBJAK (2001Y) (URBAN) MARCAY (11 MARCAY) 3.48 5.54 5.549 5.1.0 SUBJAK (2001Y) (URBAN) MARCAY (11 MARCAY) 1.47 6.71 1.76 5.000 5.1.0 SUBJAK (2001Y) (URBAN) MARCAY (11 MARCAY) (12 MARCAY (12 MARCAY (12 MARCAY) (12 MARCAY) (12 MARCAY (12 MARCAY) (12 MA					<u></u>		<u>011</u> .
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4-3.8 99-100 K03-60 LARE APPORT 3 APPORT 3.8 603-93 - RAPP-1, TURK MARGYLL ANGUN, TURKAL 1, 16 2004.43 10.47 13.4 603-93 - RAPP-1, TURK MARGYLL ANGUN, TURLAL 05 SUDBEOUND 1,716 2004.47 10.99-00 4.8.3 603-93 - RAPP-1, TURK MARGYLL ANGUN, TURLAL 05 SUDBEOUND 1,616 2004.47 10.99-00 4.8.3 613-95 R.TTURK MARGYLL ANGUN, TURLAL 05 SUDBEOUND 1,619 2129-55 1223-55 50.8 TOTAL, WHITESTBE COUNTY (URBAL) - - 1,640 5000FTAL (URBAL) 50.0 SUBTORAL, WHITESTBE COUNTY (URBAL) - - - 1223-55 50.0 THERROPLASTIC FAVENERT MARK INC - LINE 4C - 164 22-00 34-37 50.0 THERROPLASTIC FAVENERT MARK INC - LINE 4C - 164 22-00 34-37 70.0 THERROPLASTIC FAVENERT MARK INC - LINE 4C - 164 22-00 34-37 70.0 THERROPLASTIC FAVENERT MARK INC - LINE 4C - 1636 15418 - 22-04 70.0 THERROPLASTIC FAVENERT MARK INC - LINE 4C - 1636 15418 - 22-04 70.0 THERROPLASTIC FAVENERT MARK INC - LINE 4C						-	
13.6 0.001-50 RRMP - LT TURU ARROW, LARGON, TO LL 40 KONTHENDONO 1,718 1,204-1 <t< td=""><td></td><td></td><td></td><td></td><td>12,766</td><td>SUBTOTAL WHITESIDE COUNT</td><td>Y (URBAN</td></t<>					12,766	SUBTOTAL WHITESIDE COUNT	Y (URBAN
19.6 660-73 - RAP - 8T TURL APROVID LAPSONT TO LL-0 SQUITEOUND 1.1.16 1204-03 -							
46.3 602-01 - 603-80 1.1 TURN ARROW(3 ARROW) TO 1L-88 FASTEONID RAMP 1,00 1,00 1,00							
46.6 6.15-91 6.15-90 RT TURN ARROWS) ARROWS TO 1L-08 WESTBOUND RAMP 1.593 1.208-00 - 1272-55 172.0 SUBTOTAL WHITESIDE COUNTY (URBAN) 4.00 SUBTOTAL WHITESIDE COUNTY (URBAN) 1.203-00 5.203-00 313.0 TOTAL SUBTOTAL WHITESIDE COUNTY (URBAN) HITESIDE COUNTY (URBAN) HITE							
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John 500 2000 1000 2000 184 224-00 - 35-37 184 224-00 - 35-37 1800 DEGETION 0EFSET REMARKS 10.671 45+11 - 151+62 NORTHOOLNO 0.1524 5.000 - 220+48 - 220+48 1.777 1200+00 - 132+77 EDGE LINE 2.47400 - 256+68 6.897 1213+61 - 1282+58 EDGE LINE 2.1073 266+83 - 262+83 1.174 SUBTOTAL BUREAU COUNTY RURAL 2.1073 266+83 - 262+83 1.174 3747 5.2-65 EDGE LINE 38.212 SUBTOTAL WHITESIDE COUNTY (URBAN) 1.478 3747 5.2-65 EDGE LINE 181 596+00 6 287-72 1.478 3747 5.92+65 EDGE LINE 182 584+17 594+17 1.478 3747 5.92+65 EDGE LINE 1.58		OTAL WHIT	ESIDE COUNTY	(URBAN)		WHITESIDE COUNTY (RURAL)	
14 28-00 - 35-37 15 12-00 37-46 - 45-11 16 10.671 45-14 - 45-142 10.67 10.671 45-14 - 200-40 10.77 1200-40 1212+7 EDGE LINE 2,540 - 200-40 1.277 1200-40 1212+7 EDGE LINE 242 247+00 - 262+83 6,697 1213-61 1202+50 EDGE LINE 242 247+00 - 262+83 6,197 1213-61 1202+50 EDGE LINE 242 247+00 - 262+83 1,473 SUBTCAL BUREAU COUNTY RUBAL EDGE LINE 242 247+00 - 262+83 1,474 37497 52+65 EDGE LINE 31,412 21,012 - 262+72 1,474 37497 52+65 EDGE LINE 111 - 22,765 34+17 - 590-50 1,474 37497 52+65 EDGE LINE 116 - 594-90 - 594-91 1,474 37497 524-55 EDGE LINE	313.0 TOTAL				400	1+00 - 5+00	
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1.277 120400 1212+77 EDGE LINE 1242 247+00 256+68 6.897 1213+61 1282+58 EDGE LINE 154 256+68 262+83 263+93					184 715	28+00 - 35+37 37+96 - 45+11	
6.897 1213*61 1282*58 EDGE LINE 154 256*68 262*83 473*56 8.174 SUBTOL BUREAU COUNTY RUAL 38.212 SUBTOL WHITESIDE COUNTY (RURAL) 38.212 SUBTOL WHITESIDE COUNTY (RURAL) 3.468 +61 35*29 EDGE LINE WHITESIDE COUNTY (RURAN) 88.212 SUBTOL WHITESIDE COUNTY (RURAN) 3.468 +61 35*29 EDGE LINE WHITESIDE COUNTY (RURAN) 88.212 98.212 99.212 99.212 99.212 99.212 99.212 99.212 99.212 99.214 99.292 99.214 99.292 99.214 99.292 99.214 99.292 99.214 99.292 99.214 99.292 99.214 99.292 99.214 99.292 99.294.21 99.292.214 99.292.214		LOCAT	ION		184 715 10,671	28+00 - 35+37 37+96 - 45+11 45+11 - 151+82	
8.174 SUBTOR L BUREAU VUY RURAL 21.073 26243 473+56 38.174 SUBTOR L BUREAU VUI Y RURAL 38.212 SUBTOR L WITTES DE COUNTY (RURAL) 3.468 -61 35-29 EDGE LINE 818 596+00 628+72 1.478 37487 52465 EDGE LINE 818 596+00 628+72 2.793 534-72 81465 EDGE LINE 818 596+00 584+17 584+17 140 82467 81467 6154+24 EDGE LINE 27.65 584+17 590+50 416 154+08 151+72 EDGE LINE 158 584+17 590+50 590	<u>FOOT</u>	LOCAT I	L <u>ON</u> DUND	OFFSET REMARKS	184 715 10,671 1,658	28+00 - 35+37 37+96 - 45+11 45+11 - 151+82 154+18 - 220+48	
WHITESIDE COUNTY (RURAL 38,212 SUBTORAL WHITESIDE COUNTY (RURAL 3.468 +61 - 35-29 EDGE LINE HITESIDE COUNTY (URRAN) 1.478 37+87 - 52+65 EDGE LINE B18 596+00 - 62-87-2 1.478 37+87 - 81+65 EDGE LINE B18 596+00 - 62-87-2 1.40 82+67 - 84+07 EDGE LINE 2,765 473+56 - 584+17 - 590+50 140 82+67 - 84+07 EDGE LINE 2,765 473+56 - 593+50 1416 154+08 - 158+24 EDGE LINE 295 590+50 - 593+50 1472 158+44 - 158+63 RADIUS RETURN - HAHNAMAN RD 42 594+21 - 600+62 1,586 367+01 - 20+07 EDGE LINE 1,892 609+12 - 60+62 1,586 367+01 - 3070 601+82<	FOOT	LOCATI NORTHBO REAU COUNT	<u>lon</u> Dund Y (RURAL)	OFFSET REMARKS WHITE	184 715 10,671 1,658 2,540	28+00 - 35+37 37+96 - 45+11 45+11 - 151+82 154+18 - 220+48 221+60 - 247+00	
WHITESIDE COUNTY (RURAL) 3.468 +61 35+29 EDGE LINE WHITESIDE COUNTY (RURAN) 1.478 37+87 52+65 EDGE LINE 8 2.793 35+72 81465 EDGE LINE 8 140 82+67 84+07 EDGE LINE 2,765 473+56 58+17 300 84+81 151+72 EDGE LINE 158 584+17 590+50 416 158+24 158+63 RDIUS RETURN + HAHNAMAN RD 2,765 473+56 593+45 60 158+24 158+14 RDIUS RETURN + HAHNAMAN RD 507 595+90 600+97 61,127 159+14 220+41 EDGE LINE 1,652 609+122 606+62 1,586 221+53 237+39 EDGE LINE 1,018 623+63 628+67 5,197 238+10 20+07 EDGE LINE 1,018 623+63 628+67 5,197 238+10 367+01 EDGE LINE 1,018 623+63 628+67 5,197 238+10 366+54 367+01 600+12 600+12 601+62 <td>FOOT BUR 1,277 120</td> <td>LOCATI NORTHBO REAU COUNT 00+00</td> <td>LON DUND Y (RURAL) - 1212+77</td> <td>OFFSET REMARKS WHITE EDGE LINE</td> <td>184 715 10,671 1,658 2,540 242</td> <td>28+00 - 35+37 37+96 - 45+11 45+11 - 151+82 154+18 - 220+48 221+60 - 247+00 247+00 - 256+68</td> <td></td>	FOOT BUR 1,277 120	LOCATI NORTHBO REAU COUNT 00+00	LON DUND Y (RURAL) - 1212+77	OFFSET REMARKS WHITE EDGE LINE	184 715 10,671 1,658 2,540 242	28+00 - 35+37 37+96 - 45+11 45+11 - 151+82 154+18 - 220+48 221+60 - 247+00 247+00 - 256+68	
3.468 +61 - 35+29 EDGE LINE WHITESIDE COUNT (URBA) 1.478 37487 - 52+65 EDGE LINE 818 596+00 - 628+72 2.793 53+72 - 84+05 EDGE LINE - 52+65 628+72 140 82+67 - 84+07 - 628+72 - 52+65 500+50 - 52+65 300 84+81 - 151+72 EDGE LINE - 505 500+50 - 509+50 - 599+45 - 5014+5 - 5	FOOT BUR 1,277 120 6,897 12	LOCAT NORTHBO REAU COUNT 00+00 13+61	LON DUND Y (RURAL) - 1212+77 - 1282+58	OFFSET REMARKS WHITE EDGE LINE EDGE LINE	184 715 10,671 1,658 2,540 242 154	28+00 - 35+37 37+96 - 45+11 45+11 - 151+82 154+18 - 220+48 221+60 - 247+00 247+00 - 256+68 256+68 - 262+83	
1.478 37+87 - 52+65 EDGE LINE 818 596+00 - 628+72 2.793 53+72 - 81+65 EDGE LINE - 500 - 584+72 - 584+72 - 584+72 - 584+72 - 584+17 - 584+17 - 584+17 - 584+17 - 584+17 - 584+17 - 590+50 - 593+72 - 591+17 EDGE LINE - 518 584+17 - 590+50 - 593+70 - 593+70 - 593+70 - 593+70 - 593+70 - 593+70 - 593+70 - 593+90 - 593+90 - 593+90 - 593+90 - 593+90 - 600+97 - 507 595+90 - 600+62 - 517 5197 23810 - 628+72 - 628+72 - 628+72 - 628+72 - 628+72 - 628+72 - 628+72 - 600+97 - 613+75 5197	FOOT BUR 1,277 120 6,897 12	LOCAT NORTHBO REAU COUNT 00+00 13+61	LON DUND Y (RURAL) - 1212+77 - 1282+58	OFFSET REMARKS WHITE EDGE LINE EDGE LINE	184 715 10,671 1,658 2,540 242 154 21,073	28+00 - 35+37 37+96 - 45+11 45+11 - 151+82 154+18 - 220+48 221+60 - 247+00 247+00 - 256+68 256+68 - 262+83 262+83 - 473+56	(RURAL)
2.793 53+72 81+65 EDGE LINE 140 82+67 84+07 EDGE LINE 2,765 473+56 584+17 590+50 300 84+81 151+72 EDGE LINE 158 584+17 590+50 593+45 416 154+08 158+24 158+24 EDGE LINE 295 590+50 595+90 472 158+24 159+14 RADIUS RETURN - HAHNAMAN RD 507 595+00 600+97 60 158+85 159+14 220+41 EDGE LINE 1,852 609+12 606+62 1,586 221+53 237+39 EDGE LINE 1,852 609+12 613+75 5,197 238+10 290+07 EDGE LINE 1,018 623+63 628+72 7,618 290+83 367+01 EDGE LINE 1,018 523+63 628+72 156 367+01 368+57 EDGE LINE 10,948 SUBTOTIL WHITESING COUNTY (NURAL 89 368+94 369+83 EDGE LINE 10,948 SUBTOTIL WHITESING COUNTY (NURAL 1,344 400+12 459+20 EDGE LINE <td>FOOT BUR 1,277 120 6,897 123 8,174 SUBTOTA</td> <td>LOCATI NORTHEC REAU COUNT 00+00 13+61 AL BUREAU</td> <td>LON DUND - 1212+77 - 1282+58 COUNTY RURA</td> <td>OFFSET REMARKS WHITE EDGE LINE EDGE LINE</td> <td>184 715 10,671 1,658 2,540 242 154 21,073</td> <td>28+00 - 35+37 37+96 - 45+11 45+11 - 151+82 154+18 - 220+48 221+60 - 247+00 247+00 - 256+68 256+68 - 262+83 262+83 - 473+56</td> <td>(RURAL)</td>	FOOT BUR 1,277 120 6,897 123 8,174 SUBTOTA	LOCATI NORTHEC REAU COUNT 00+00 13+61 AL BUREAU	LON DUND - 1212+77 - 1282+58 COUNTY RURA	OFFSET REMARKS WHITE EDGE LINE EDGE LINE	184 715 10,671 1,658 2,540 242 154 21,073	28+00 - 35+37 37+96 - 45+11 45+11 - 151+82 154+18 - 220+48 221+60 - 247+00 247+00 - 256+68 256+68 - 262+83 262+83 - 473+56	(RURAL)
140 82+67 - 84+07 - 584+17 - 584+17 - 590+50 - 500+50 - 500+50 - 500+50 - 500+50 - 500+50 - 500+50 - 500+50 - 500+50 - 500+50 - 500+50 - 500+50 - 500+50 - 500+50 <td>FOOT BUR 1,277 120 6,897 123 8,174 SUBTOTA WHITT</td> <td>LOCATI NORTHBC REAU COUNT 00+00 13+61 AL BUREAU ESIDE COUN</td> <td>LON DEND Y (RURAL) - 1212+77 - 1282+58 COUNTY RURA NTY (RURAL)</td> <td>OFFSET REMARKS WHITE EDGE LINE EDGE LINE</td> <td>184 715 10,671 1,658 2,540 242 154 21,073</td> <td>28+00 - 35+37 37+96 - 45+11 45+11 - 151+82 154+18 - 220+88 221+60 - 247+00 247+00 - 256+68 256+68 - 262+83 262+83 - 473+56 SUBTOTAL WHITESIDE COUNTY</td> <td>(RURAL)</td>	FOOT BUR 1,277 120 6,897 123 8,174 SUBTOTA WHITT	LOCATI NORTHBC REAU COUNT 00+00 13+61 AL BUREAU ESIDE COUN	LON DEND Y (RURAL) - 1212+77 - 1282+58 COUNTY RURA NTY (RURAL)	OFFSET REMARKS WHITE EDGE LINE EDGE LINE	184 715 10,671 1,658 2,540 242 154 21,073	28+00 - 35+37 37+96 - 45+11 45+11 - 151+82 154+18 - 220+88 221+60 - 247+00 247+00 - 256+68 256+68 - 262+83 262+83 - 473+56 SUBTOTAL WHITESIDE COUNTY	(RURAL)
300 84+81 - 151+72 EDGE LINE 158 584+17 - 590+50 416 154+08 - 158+24 EDGE LINE 295 590+50 - 593+45 472 158+24 - 158+63 RADIUS RETURN - HAHNAMA RD 42 594+21 - 595+90 - 595+90 - 600+97 60 158+85 - 159+14 - 20441 EDGE LINE 120 601+82 - 606+62 - - 604+62 - 604+72 - 6	FOOT BUR 1,277 120 6,897 123 8,174 SUBTOTA WHITI 3,468 -	LOCATJ NORTHBC REAU COUNT 00+00 13+61 AL BUREAU ESIDE COUN +61	LON DEND Y (RURAL) - 1212+77 - 1282+58 COUNTY RURA NTY (RURAL) - 35+29	OFFSET REMARKS WHITE EDGE LINE EDGE LINE EDGE LINE	184 715 10,671 1,658 2,540 242 154 21,073 38,212	28+00 - 35+37 37+96 - 45+11 45+11 - 151+82 154+18 - 220+48 221+60 - 247+00 247+00 - 256+68 256+68 - 262+83 262+83 - 473+56 SUBTOTAL WHITESIDE COUNTY WHITESIDE COUNTY URBAN	(RURAL)
416 154+08 - 158+24 - 158+24 - 593+45 472 158+24 - 158+63 RADIUS RETURN - HAHNAMAN RD 42 594+21 - 595+90 60 158+85 - 159+14 - 220+41 RADIUS RETURN - HAHNAMAN RD 507 595+90 - 600+97 6,127 159+14 - 220+41 EDGE LINE 120 601+82 - 606+62 1,586 221+53 - 237+39 EDGE LINE 1,852 609+12 - 613+75 5,197 238+10 - 290+07 EDGE LINE 3,372 614+62 - 623+05 7,618 290+83 - 369+83 - 369+83 - 628+72 156 367+01 - 369+83 - 369+83 - 628+72 89 368+94 - 369+83 - 459+20 EDGE LINE - SOUTHEUTTEUT (NURAL) 1,344 460+12 - 473+56 EDGE LINE EDGE LINE - SUTHEUTURUL) <td>FOOT BUR 1,277 120 6,897 123 8,174 SUBTOTA WHITH 3,468 - 1,478 3</td> <td>LOCATI NORTHBC REAU COUNT 00+00 13+61 AL BUREAU ESIDE COUN +61 7+87</td> <td>LON DEND Y (RURAL) - 1212+77 - 1282+58 COUNTY RURA NTY (RURAL) - 35+29 - 52+65</td> <td>OFFSET REMARKS WHITE EDGE LINE EDGE LINE EDGE LINE EDGE LINE</td> <td>184 715 10,671 1,658 2,540 242 154 21,073 38,212</td> <td>28+00 - 35+37 37+96 - 45+11 45+11 - 151+82 154+18 - 220+48 221+60 - 247+00 247+00 - 256+68 256+68 - 262+83 262+83 - 473+56 SUBTOTAL WHITESIDE COUNTY WHITESIDE COUNTY URBAN</td> <td>(RURAL)</td>	FOOT BUR 1,277 120 6,897 123 8,174 SUBTOTA WHITH 3,468 - 1,478 3	LOCATI NORTHBC REAU COUNT 00+00 13+61 AL BUREAU ESIDE COUN +61 7+87	LON DEND Y (RURAL) - 1212+77 - 1282+58 COUNTY RURA NTY (RURAL) - 35+29 - 52+65	OFFSET REMARKS WHITE EDGE LINE EDGE LINE EDGE LINE EDGE LINE	184 715 10,671 1,658 2,540 242 154 21,073 38,212	28+00 - 35+37 37+96 - 45+11 45+11 - 151+82 154+18 - 220+48 221+60 - 247+00 247+00 - 256+68 256+68 - 262+83 262+83 - 473+56 SUBTOTAL WHITESIDE COUNTY WHITESIDE COUNTY URBAN	(RURAL)
472 158+24 - 158+63 RADIUS RETURN - HAHNAMAN RD 60 158+85 - 159+14 - 159+14 - 600+97 6,127 159+14 - 220+41 EDGE LINE 120 601+82 - 606+62 1,586 221+53 - 237+39 EDGE LINE 1,852 609+12 - 613+75 5,197 238+10 - 367+01 - 367+01 - 623+05	FOOT BUR 1,277 120 6,897 123 8,174 SUBTOTA WHITH 3,468 - 1,478 33 2,793 53	LOCAT NORTHBC REAU COUNT 00+00 13+61 AL BUREAU ESIDE COUN +61 7+87 3+72	LON DEND Y (RURAL) - 1212+77 - 1282+58 COUNTY RURA NTY (RURAL) - 35+29 - 52+65 - 81+65	OFFSET REMARKS WHITE EDGE LINE EDGE LINE EDGE LINE EDGE LINE EDGE LINE EDGE LINE	184 715 10,671 1,658 2,540 242 154 21,073 38,212 818	28+00 - 35+37 37+96 - 45+11 45+11 - 151+82 154+18 - 220+48 221+60 - 247+00 247+00 - 256+68 256+68 - 262+83 262+83 - 473+56 SUBTOTAL WHITESIDE COUNTY WHITESIDE COUNTY (URBAN) 596+00 - 628+72	(RURAL)
60 158+85 - 159+14 - 159+14 - 507 595+90 - 600+97 6,127 159+14 - 220+41 EDGE LINE 120 601+82 - 606+62 1,586 221+53 - 237+39 EDGE LINE 1,852 609+12 - 613+75 5,197 238+10 - 290+07 EDGE LINE 3,372 614+62 - 623+05 7,618 290+83 - 368+57 EDGE LINE 1,018 623+63 - 628+72 - 156 367+01 - 368+57 EDGE LINE 10,948 SUBTOTAL WHITES L COUNTY (URBA 89 368+94 - 369+83 - 639+32 - 628+72 -	FOOT BUR 1,277 120 6,897 123 8,174 SUBTOTA WHITH 3,468 - 1,478 33 2,793 53 140 85	LOCAT NORTHBC REAU COUNT 00+00 13+61 AL BUREAU ESIDE COUN +61 7+87 3+72 2+67	LON DEND Y (RURAL) - 1212+77 - 1282+58 COUNTY RURAL NTY (RURAL) - 35+29 - 52+65 - 81+65 - 84+07	OFFSET REMARKS VHITE EDGE EDGE LINE	184 715 10,671 1,658 2,540 242 154 21,073 38,212 818 2,765	28+00 - 35+37 37+96 - 45+11 45+11 - 151+82 154+18 - 220+48 221+60 - 247+00 247+00 - 256+68 256+68 - 262+83 262+83 - 473+56 SUBTOTAL WHITESIDE COUNTY WHITESIDE COUNTY 628+72 473+56 - 584+17	(RURAL)
60 158+85 - 159+14 - 159+14 - 507 595+90 - 600+97 6,127 159+14 - 20+41 EDGE LINE 120 601+82 - 606+62 1,586 221+53 - 237+39 EDGE LINE 1,852 609+12 - 623+05 5,197 238+10 - 367+01 - 367+01 - 623+05 <td< td=""><td>FOOT BUR 1,277 120 6,897 123 8,174 SUBTOTA WHITH 3,468 - 1,478 33 2,793 53 140 82 300 84</td><td>LOCATI NORTHBC REAU COUNT 00+00 13+61 AL BUREAU E51DE COUN +61 7+87 3+72 2+67 4+81</td><td>LON DEND Y (RURAL) - 1212+77 - 1282+58 COUNTY RURA NTY (RURAL) - 35+29 - 52+65 - 81+65 - 84+07 - 151+72</td><td>OFFSET REMARKS VH ITE EDGE EDGE LINE EDGE LINE</td><td>184 715 10,671 1,658 2,540 242 154 21,073 38,212 818 2,765 158</td><td>28+00 - 35+37 37+96 - 45+11 45+11 - 151+82 154+18 - 220+48 221+60 - 247+00 247+00 - 256+68 256+68 - 262+83 262+83 - 473+56 SUBTOTAL WHITESIDE COUNTY WHITESIDE COUNTY 628+72 473+56 - 584+17 584+17 - 590+50</td><td>(RURAL)</td></td<>	FOOT BUR 1,277 120 6,897 123 8,174 SUBTOTA WHITH 3,468 - 1,478 33 2,793 53 140 82 300 84	LOCATI NORTHBC REAU COUNT 00+00 13+61 AL BUREAU E51DE COUN +61 7+87 3+72 2+67 4+81	LON DEND Y (RURAL) - 1212+77 - 1282+58 COUNTY RURA NTY (RURAL) - 35+29 - 52+65 - 81+65 - 84+07 - 151+72	OFFSET REMARKS VH ITE EDGE EDGE LINE	184 715 10,671 1,658 2,540 242 154 21,073 38,212 818 2,765 158	28+00 - 35+37 37+96 - 45+11 45+11 - 151+82 154+18 - 220+48 221+60 - 247+00 247+00 - 256+68 256+68 - 262+83 262+83 - 473+56 SUBTOTAL WHITESIDE COUNTY WHITESIDE COUNTY 628+72 473+56 - 584+17 584+17 - 590+50	(RURAL)
6,127 159+14 - 20+41 EDE LINE 120 601+82 - 606+62 1,586 221+53 - 237+39 EDE LINE 1,852 609+12 - 613+75 5,197 238+10 - 290+07 EDE LINE 3,372 614+62 - 623+05 7,618 290+83 - 367+01 EDE LINE 1,018 623+63 - 628+72 156 367+01 - 368+57 EDE LINE 10,948 SUBTOTAL WITTET COUNTY (URAL 89 368+94 - 369+83 - 369+83 - 50JHBULTET COUNTY (URAL 1,344 460+12 - 459+20 EDE LINE EDE LINE EDEE LINE EDE	FOOT BUR 1,277 120 6,897 123 8,174 SUBTOTA WHITH 3,468 - 1,478 33 2,793 53 140 83 300 84 416 15	LOCATI NORTHBC REAU COUNT 00+00 13+61 AL BUREAU E51DE COUN +61 7+87 3+72 2+67 4+81 4+08	LON DEND Y (RURAL) - 1212+77 - 1282+58 COUNTY RURA NTY (RURAL) - 35+29 - 52+65 - 81+65 - 84+07 - 151+72 - 158+24	OFFSET REMARKS WHITE EDGE EDGE LINE	184 715 10,671 1,658 2,540 242 154 21,073 38,212 818 2,765 158 295	28+00 - 35+37 37+96 - 45+11 45+11 - 151+82 154+18 - 220+48 221+60 - 247+00 247+00 - 256+68 256+68 - 262+83 262+83 - 473+56 SUBTOTAL WHITESIDE COUNTY 473+56 - 584+17 584+17 - 590+50 590+50 - 593+45	(RURAL)
1,586 221+53 - 237+39 EDEC LINE 1,852 609+12 - 613+75 5,197 238+10 - 290+07 EDEC LINE 3,372 614+62 - 623+05 7,618 290+83 - 367+01 - 367+01 - 628+72	FOOT BUR 1,277 120 6,897 123 8,174 SUBTOTA WHITI 3,468 - 1,478 33 2,793 53 140 83 300 84 416 15 472 15	LOCATI NORTHBC REAU COUNT 00+00 13+61 AL BUREAU ESIDE COUN +61 7+87 3+72 2+67 4+81 4+08 (8+24	LON DUND Y (RURAL) - 1212+77 - 1282+58 COUNTY RURA NTY (RURAL) - 35+29 - 52+65 - 81+65 - 84+07 - 151+72 - 158+24 - 158+63	OFFSET REMARKS WHITE EDGE EDGE LINE	184 715 10,671 1,658 2,540 242 154 21,073 38,212 818 2,765 158 295 42	28+00 - 35+37 37+96 - 45+11 45+11 - 151+82 154+18 - 220+48 221+60 - 247+00 247+00 - 262+83 262+83 - 473+56 SUBTOTAL WHITESIDE COUNTY VHITESIDE COUNTY 628+72 473+56 - 584+17 584+17 - 590+50 590+50 - 593+45 594+21 - 595+90	(RURAL)
5,197 238+10 290+07 EDE LINE 3,372 614+62 623+05 7,618 290+83 367+01 367+01 EDE LINE 1,018 623+63 628+72 156 367+01 368+94 368+94 369+83 EDE LINE 10,948 SUBTOTAL WHITES DE COUNTY (URAL) 893 368+94 369+83 659+83 EDE LINE EDE LINE SUBTOTAL WHITES DE COUNTY (URAL) 1,344 460+12 459+20 EDE LINE EDE LINE EURE LINE SUBTOTAL WHITES DE COUNTY (URAL) 40,182 SUBTOTAL WHITES DE COUNTY (RURAL) EDE LINE EDE LINE EURE LINE SUBTOTAL WHITES DE COUNTY (RURAL)	FOOT BUR 1,277 120 6,897 123 8,174 SUBTOTA WHITT 3,468 - 1,478 33 2,793 53 140 83 300 84 416 15 472 15 60 15	LOCATI NORTHBC REAU COUNT 00+00 13+61 AL BUREAU ESIDE COUN +61 7+87 3+72 2+67 4+81 4+08 (8+24 (8+85)	LON DUND Y (RURAL) - 1212+77 - 1282+58 COUNTY RURA NTY (RURAL) - 35+29 - 52+65 - 81+65 - 81+65 - 84+07 - 151+72 - 158+24 - 158+63 - 159+14	OFFSET REMARKS VHITE EDGE EDGE LINE EDG	184 715 10,671 1,658 2,540 242 154 21,073 38,212 818 2,765 158 295 42 507	28+00 - 35+37 37+96 - 45+11 45+11 - 151+82 154+18 - 220+48 221+60 - 247+00 247+00 - 256+68 256+68 - 262+83 262+83 - 473+56 SUBTOTAL WHITESIDE COUNTY VWHITESIDE COUNTY 628+72 473+56 - 584+17 584+17 - 590+50 590+50 - 593+45 594+21 - 595+90	(RURAL)
7,618 290+83 - 367+01 EDEC LINE 1,018 623+63 - 628+72 156 367+01 - 368+57 EDEC LINE 10,948 SUBTOTAL WHITESIDE COUNTY (URAL 89 368+94 - 369+83 629+83 EDEC LINE - SUBTOTAL WHITESIDE COUNTY (URAL) 1,344 460+12 - 473+56 EDEC LINE - SUBTOTAL WHITESIDE COUNTY (URAL) 40,182 SUBTOTAL WHITESIDE COUNTY (RURAL) EDEC LINE - - -	FOOT BUR 1,277 120 6,897 123 8,174 SUBTOTA WHIT 3,468 - 1,478 33 2,793 53 140 83 300 84 416 15 472 15 6,127 15	LOCATI NORTHBC REAU COUNT 00+00 13+61 AL BUREAU ESIDE COUN +61 7+87 3+72 2+67 4+81 4+08 (8+24 (8+85 9+14	LON DUND Y (RURAL) - 1212+77 - 1282+58 COUNTY RURAL) - 35+29 - 52+65 - 81+65 - 81+65 - 84+07 - 151+72 - 158+24 - 158+63 - 159+14 - 220+41	OFFSET REMARKS VHITE EDGE EDGE LINE	184 715 10,671 1,658 2,540 242 154 21,073 38,212 818 2,765 158 295 42 507 120	28+00 - 35+37 37+96 - 45+11 45+11 - 151+82 154+18 - 220+48 221+60 - 247+00 247+00 - 262+83 262+83 - 473+56 SUBTOTAL WHITESIDE COUNTY 473+56 - 584+17 584+17 - 593+50 590+50 - 593+50 594+21 - 595+90 595+90 - 600+97 601+82 - 606+62	(RURAL)
156 367+01 368+57 EDGE LINE 10,948 SUBTOTAL WHITESIDE COUNTY (URBA SUBTOTAL WHITESIDE COUNTY (URBA EDGE LINE 8,937 369+83 459+20 EDGE LINE SOUTHBOLND 1,344 460+12 473+56 EDGE LINE BUREAU COUNTY (RUBAL) 40,182 SUBTOTAL WHITESIDE COUNTY (RURAL) 1,119 1201+58 1212+77	FOOT BUR 1,277 120 6,897 123 8,174 SUBTOTA WHIT 3,468 - 1,478 33 2,793 53 140 83 300 84 416 15 472 15 6,127 15 1,586 22	LOCATI NORTHBC REAU COUNT 00+00 13+61 AL BUREAU ESIDE COUN +61 7+87 3+72 2+67 4+81 4+08 8+24 8+85 9+14 1+53	LON DUND Y (RURAL) - 1212+77 - 1282+58 COUNTY RURAL) - 35+29 - 52+65 - 81+65 - 81+65 - 84+07 - 151+72 - 158+24 - 158+63 - 159+14 - 220+41 - 237+39	OFFSET REMARKS VH ITE EDGE EDGE LINE	184 715 10,671 1,658 2,540 242 154 21,073 38,212 818 2,765 158 295 42 507 120 1,852	28+00 - 35+37 37+96 - 45+11 45+11 - 151+82 154+18 - 220+48 221+60 - 247+00 247+00 - 262+83 262+83 - 473+56 SUBTOTAL WHITESIDE COUNTY VH1TESIDE COUNTY 628+72 473+56 - 584+17 590+50 - 593+45 594+21 - 595+90 595+90 - 600+97 601+82 - 606+62 609+12 - 613+75	(RURAL)
89 368+94 369+83 260E LINE 8,937 369+83 459+20 EDGE LINE 1,344 460+12 473+56 EDGE LINE 40,182 SUBTOTAL WHITESIDE COUNTY (RURAL)	FOOT BUR 1,277 120 6,897 120 8,174 SUBTOTA WHITI 3,468 - 1,478 30 300 84 416 15 472 15 6,127 15 1,586 22 5,197 23	LOCATI NORTHEC REAU COUNT 00+00 13+61 AL BUREAU ESIDE COUN +61 7+87 3+72 2+67 4+81 -4+08 -8+24 -8+85 -9+14 -1+53 -8+10	LON DUND Y (RURAL) - 1212+77 - 1282+58 COUNTY RURAL) - 35+29 - 52+65 - 81+65 - 84+07 - 151+72 - 158+24 - 158+63 - 159+14 - 220+41 - 237+39 - 290+07	OFFSET REMARKS VHITE EDGE EDGE LINE	184 715 10,671 1,658 2,540 242 154 21,073 38,212 818 2,765 158 295 42 507 120 1,852 3,372	28+00 - 35+37 37+96 - 45+11 45+11 - 151+82 154+18 - 220+48 221+60 - 247+00 247+00 - 256+68 262+83 - 473+56 SUBTOTAL WHITESIDE COUNTY VH1TESIDE COUNTY 628+72 473+56 - 584+17 590+50 - 593+45 594+21 - 595+90 595+90 - 600+77 601+82 - 604+62 609+12 - 613+75	(RURAL)
8,937 369+83 459+20 EDGE LINE SOUTHBOLND 1,344 460+12 473+56 EDGE LINE BUREAU COUNTY (RURAL) 40,182 SUBTOTAL WHITESIDE COUNTY (RURAL) 1,119 1201+58 1212+77	FOOT BUR 1,277 120 6,897 120 8,174 SUBTOTA WHITT 3,468 - 1,478 30 300 84 416 15 472 15 6,127 15 1,586 22 5,197 23 7,618 29	LOCATI NORTHEC REAU COUNT 00+00 13+61 AL BUREAU ESIDE COUN +61 7+87 3+72 2+67 4+81 -4+08 -8+24 -8+85 -9+14 -1+53 -8+10 -00+83	LON DUND Y (RURAL) - 1212+77 - 1282+58 COUNTY RURAL) - 35+29 - 52+65 - 81+65 - 84+07 - 151+72 - 158+24 - 158+63 - 159+14 - 220+41 - 237+39 - 290+07 - 367+01	OFFSET OFFSE OFFSET OFFSET	184 715 10,671 1,658 2,540 242 154 21,073 38,212 818 2,765 158 295 42 507 120 1,852 3,372 1,018	28+00 - 35+37 37+96 - 45+11 45+11 - 151+82 154+18 - 220+48 221+60 - 247+00 247+00 - 262+83 262+83 - 473+56 SUBTOTAL WHITESIDE COUNTY WHITESIDE COUNTY (URBAN) 596+00 - 628+72 473+56 - S84+17 590+50 - 593+42 594+21 - 595+90 595+90 - 600+07 601+82 - 601+75 614+62 - 623+03 623+63 - 623+63	
1,344 460+12 - 473+56 EDGE LINE BUREAU COUNTY (RURAL) 40,182 SUBTOTAL WHITESIDE COUNTY (RURAL) 1,119 1201+58 - 1212+77	FOOT BUR 1,277 123 6,897 123 8,174 SUBTOTA WHITT 3,468 - 1,478 33 2,793 53 140 83 300 84 416 15 6,127 15 1,586 22 5,197 23 7,618 29 156 36	LOCATI NORTHEC REAU COUNT 00+00 13+61 AL BUREAU ESIDE COUN +61 7+87 3+72 2+67 4+81 4+08 -8+24 -8+85 -9+14 -1+53 -8+10 -0+83 -7+01	LON DUND Y (RURAL) - 1212+77 - 1282+58 COUNTY RURAL) - 35+29 - 52+65 - 81+65 - 84+07 - 151+72 - 158+24 - 158+63 - 159+14 - 220+41 - 237+39 - 290+07 - 367+01 - 368+57	OFFSET	184 715 10,671 1,658 2,540 242 154 21,073 38,212 818 2,765 158 295 42 507 120 1,852 3,372 1,018	28+00 - 35+37 37+96 - 45+11 45+11 - 151+82 154+18 - 220+48 221+60 - 247+00 247+00 - 262+83 262+83 - 473+56 SUBTOTAL WHITESIDE COUNTY WHITESIDE COUNTY (URBAN) 596+00 - 628+72 473+56 - S84+17 590+50 - 593+42 594+21 - 595+90 595+90 - 600+07 601+82 - 601+75 614+62 - 623+03 623+63 - 623+63	
40,182 SUBTOTAL WHITESIDE COUNTY (RURAL) 1,119 1201+58 - 1212+77	FOOT BUR 1,277 123 6,897 123 8,174 SUBTOTA WHITT 3,468 - 1,478 33 2,793 53 140 83 300 84 416 15 472 15 6,127 15 1,586 22 5,197 23 7,618 29 156 36 89 36	LOCATI NORTHEC REAU COUNT 00+00 13+61 AL BUREAU ESIDE COUN +61 7+87 3+72 2+67 4+81 4+08 -8+24 -8+85 -9+14 -1+53 -8+10 -0+83 -7+01 -8+94	LON DUND Y (RURAL) - 1212+77 - 1282+58 COUNTY RURA NTY (RURAL) - 35+29 - 52+65 - 81+65 - 84+07 - 151+72 - 158+24 - 158+63 - 159+14 - 220+41 - 237+39 - 290+07 - 367+01 - 368+57 - 369+83	OFFSET BEMARKS UHITE EDGE LINE	184 715 10,671 1,658 2,540 242 154 21,073 38,212 818 2,765 158 295 42 507 120 1,852 3,372 1,018	28+00 - 35+37 37+96 - 45+11 45+11 - 151+82 154+18 - 220+48 221+60 - 247+00 247+00 - 256+68 256+68 - 262+83 262+83 - 473+56 SUBTOTAL WHITESIDE COUNTY WHITESIDE COUNTY (URBAN) 596+00 - 628+72 473+56 - 584+17 590+50 - 593+45 590+50 - 593+45 594+21 - 595+90 595+90 - 600+97 601+82 - 604+62 609+12 - 613+75 614+62 - 623+03 623+63 - 628+72 SUBTOTAL WHITESIDE COUNTY	
	FOOT BUR 1,277 123 6,897 123 8,174 SUBTOTA WHITT 3,468 - 1,478 33 2,793 53 140 83 300 84 416 15 472 15 6,127 15 1,586 22 5,197 23 7,618 29 156 36 89 36 8,937 36	LOCATI NORTHEC REAU COUNT 00+00 13+61 AL BUREAU ESIDE COUN +61 7+87 3+72 2+67 4+81 4+08 -8+24 -8+85 -9+14 -1+53 -8+10 -0+83 -7+01 -8+94 -9+83	LON DUND Y (RURAL) - 1212+77 - 1282+58 COUNTY RURA NTY (RURAL) - 35+29 - 52+65 - 81+65 - 84+07 - 151+72 - 158+24 - 158+63 - 159+14 - 220+41 - 237+39 - 290+07 - 367+01 - 368+57 - 369+83 - 459+20	OFFSET REMARKS_ VHITE EDGE EDGE LINE ED	184 715 10,671 1,658 2,540 242 154 21,073 38,212 818 2,765 158 295 42 507 120 1,852 3,372 1,018	28+00 - 35+37 37+96 - 45+11 45+11 - 151+82 154+18 - 220+48 221+60 - 247+00 247+00 - 256+68 256+68 - 262+83 262+83 - 473+56 SUBTOTAL WHITESIDE COUNTY WHITESIDE COUNTY (URBAN) 596+00 - 628+72 473+56 - 584+17 590+50 - 593+45 590+50 - 593+90 593+21 - 595+90 593+21 - 600+97 601+82 - 604+62 609+12 - 613+75 614+62 - 623+03 623+63 - 628+72 SUBTOTAL WHITESIDE COUNTY	
	FOOT BUR 1,277 123 6,897 123 8,174 SUBTOTA WHITI 3,468 1,478 33 2,793 53 140 83 300 84 416 15 472 15 6,127 15 1,586 22 5,197 23 7,618 29 156 36 8,937 36 1,344 46	LOCATI NORTHEC REAU COUNT 00+00 13+61 AL BUREAU ESIDE COUN +61 7+87 3+72 2+67 4+81 4+08 -8+24 -8+85 -9+14 -1+53 -8+10 -0+83 -7+01 -8+94 -9+83 -0+12	LON DUND Y (RURAL) - 1212+77 - 1282+58 COUNTY RURA NTY (RURAL) - 35+29 - 52+65 - 81+65 - 84+07 - 151+72 - 158+24 - 158+24 - 158+63 - 159+14 - 220+41 - 237+39 - 290+07 - 367+01 - 368+57 - 369+83 - 459+20 - 473+56	OFFSET PUPENT PUPENT	184 715 10,671 1,658 2,540 242 154 21,073 38,212 818 2,765 158 295 42 507 120 1,852 3,372 1,018 10,948	28+00 - 35+37 37+96 - 45+11 45+11 - 151+82 154+18 - 220+48 221+60 - 247+00 247+00 - 256+68 256+68 - 262+83 262+83 - 473+56 SUBTOTAL WHITESIDE COUNTY WHITESIDE COUNTY (URBAN) 596+00 - 628+72 473+56 - 584+17 596+50 - 593+45 590+50 - 593+45 594+21 - 595+90 595+90 - 600+97 601+82 - 604+62 609+12 - 613+75 614+62 - 623+03 SUBTOTAL WHITESIDE COUNTY SUBTOTAL WHITESIDE COUNTY	Y (URBAN

USER NAME = Cristian.Rosas	DESIGNED -	REVISED -					F.A.P. RTE	SECTION	COUNTY	TOTAL SHEET SHEETS NO.		
	DRAWN -	REVISED -	STATE OF ILLINOIS				E OF QUANTITIES		646	(101, 102, 135)RS	WHITESIDE	179 23
PLOT SCALE = 100.0000 / in	CHECKED -	REVISED -	DEPARTMENT OF TRANSPORTATION								CONTRACT	NO. 64P41
PLOT DATE = 8/24/2023	DATE -	REVISED -]	SCALE: SHEET OF SHEETS STA. TO STA.				TO STA.		ILLINOIS FED. A	ID PROJECT	

REMARKS WHITE EDGE LINE EDGE LINE EDGE LINE EDGE LINE RADIUS RETURN - RAMP EDGE LINE RADIUS RETURN - RAMP EDGE LINE

YELLOW PAINTED MEDIAN SKIP DASH SKIP DASH SOLID CENTERLINE (NO PASSING ZONE)

YELLOW SKIP DASH SKIP DASH SOLID CENTERLINE (NO PASSING ZONC) SKIP DASH SKIP DASH SKIP DASH SOLID CENTERLINE (NO PASSING ZONC) SKIP DASH SKIP DASH

WHITE SKIP-DASH YELLOW SKIP DASH SOLID CENTERLINE (NO PASSING ZONE) PAINTED MEDIAN PAINTED MEDIAN SOLID CENTERLINE / CONCRETE MEDIAN

> WHITE EDGE LINE EDGE LINE

FOOT	LOCATION	OFFSET REMARKS	FOOT LOCATION OFFSET REMARKS	
	WHITESIDE COUNTY (RURAL)		BUREAU COUNTY (RURAL) WHITE	
3,468	+61 - 35+29	EDGE LINE	134 1200+35 - 1200+75 NE QUADRANT OF IL 40/IL 92	
			134 120035 - 120075 NW QUADRANT OF IL 40/IL 92	
374	37+87 - 52+65	EDGE LINE	<u> </u>	
70	53+72 - 81+65	EDGE LINE	268 SUBTOTAL BUREAU COUNTY (RURAL)	
140	82+67 - 84+07	EDGE LINE		
300	84+81 - 151+72	EDGE LINE	WHITESIDE COUNTY (RURAL)	
416	154+08 - 158+24	EDGE LINE	325 369+36 - 372+61 RT TURN LANE TO STAR ROAD/IL 172	
128	158+24 - 158+63	RADIUS RETURN - HAHNAMAN RCAD	145 368+12 - 368+59 ISLAND - SW QUADRANT OF STAR ROAD/IL 172	
29	158+85 - 159+14	RADIUS RETURN - HAHNAMAN RCAD	101 369+02 - 369+36 ISLAND NW QUADRANT OF STAR ROAD/ IL 172	
487	159+14 - 220+41	EDGE LINE	571 SUBTOTAL WHITESIDE COUNTY (RURAL)	
1,586	221+53 - 237+39	EDGE LINE		
5,197	238+10 - 290+07	EDGE LINE	WHITESIDE COUNTY (URBAN)	
·			233 600+11 - 600+97 ISLAND - I-88 EASTBOUND RAMP	
341	290+83 - 367+01	EDGE LINE	170 600+34 600+86 ISLAND-1-88 EASTBOUND RAMP TO IL 40 SOUTHBOUND	
156	367+01 - 368+57	RADIUS RETURN - STAR ROAD/ IL 173		
89	368+94 - 369+83	RADIUS RETURN - STAR ROAD/ IL 173		
8,937	369+83 - 459+20	EDGE LINE	221 611+76 - 613+97 LT TURN LANE TO I-88 WESTBOUND RAMP	
1,344	460+12 - 473+56	EDGE LINE	212 614+78 - 615+35 ISLAND-I-88 WESTBOUND RAMP TO IL 40 NORTHBOUND	
23,062	SUBTOTAL WHITESIDE COUNTY (R	JRAL)	384 614+74 - 615+52 ISLAND I 88 WESTBOUND RAMP	
			173 615+52 - 618+35 RT TURN LANE TO I-88 WESTBOUND RAMP	
	WHITESIDE COUNTY (URBAN)	WHITE	1,598 SUBTOTAL WHITESIDE COUNTY (URBAN)	
6,599	474+52 - 540+51	EDGE LINE		
			268 SUBTOTAL BUREAU COUNTY (RURAL)	
297	541+42 - 544+39	EDGE LINE	571 SUBTOTAL WHITESIDE COUNTY (RURAL)	
755	545+26 - 552+81	EDGE LINE	1,598 SUBTOTAL WHITESIDE COUNTY (URBAN)	
3,973	553+76 - 593+49	EDGE LINE	2,437 TOTAL	
343	594+09 - 599+25	EDGE LINE		
159	599+25 - 600+84	RADIUS RETURN - RAMP		
546	601+16 - 606+62	EDGE LINE		
394	609+12 - 614+35	EDGE LINE	78000600 THERMOPLASTIC PAVEMENT MARKING - LINE 12"	
156	614+56 - 616+12	RADIUS RETURN - RAMP	FOOT LOCATION OFFSET REMARKS	
1,249	616+12 628+61	EDGE LINE	BUREAU COUNTY (RURAL) WHITE	
	SUBTOTAL WHITESIDE COUNTY (U		229 1200+35 - 1200+75 DIAGONALS FOR NE ISLAND @ IL 92	
14,471	SUBTOTAL WITTESTDE COUNTY (C	(DAN)	2741200+35 - 1200+75 DIAGONALS FOR NW ISLAND @ IL 92	
			503 SUBTOTAL BUREAU COUNTY (RURAL)	
	BUREAU COUNTY (RURAL)		YELLOW	
500	1204+77 - 1209+77	SOLID CENTERLINE (NO PASSING ZONE)	512 1200+48 - 1204+77 DIAGONA_S FOR MEDIAN @ IL 92	
1,798	1209+77 - 1281+70	SK1P DASH	512 SUBTOTAL BUREAU COUNTY (RURAL)	
134	1281+70 - 1283+04	SOLID CENTERLINE (NO PASSING ZONE)	STZ JSBIOTAL BOREAG COUNT (KORE)	
2,432	SUBTOTAL BUREAU COUNTY (RURA			
			WHITESIDE COUNTY (URBAN)	
	WHITESIDE COUNTY (RURAL)		IL 172/ STAR ROAD	
112	1+00 - 5+46	SOLID CENTERLINE (NO PASSING ZONE	83 630+35 - 632+58 DIAGONALS FOR MEDIAN @ IL 172	
			264 632+43 - 632+81 DIAGONALS FOR SW ISLAND @ IL 172	
737	28+00 35+37	SKIP DASH	276632+57632+82 DIAGONALS FOR NW ISLAND @ IL 172	
25	34+37 - 35+37	SOLID CENTERLINE (NO PASSING ZONE)	623 SUBTOTAL WHITESIDE COUNTY (URBAN)	
715	37+96 - 45+11	SOLID CENTERLINE (NO PASSING ZONE)		
844	247:00 - 255+44	SKIP DASH	WHITESIDE COUNTY (RURAL) WHITE	
157	255+44 - 261+70	SOLID CENTERLINE (NO PASSING ZONE)	264 368+12 - 368+59 DIAGONALS FOR NW ISLAND @ STAR ROAD/ IL 172	
2,589	SUBTOTAL WHITESIDE COUNTY (R	JRAL)	276 369+02 - 369+36 DIAGONALS FOR SW ISLAND @ STAR ROAD/IL 172	
	WHITESIDE COUNTY (URBAN)	WHITE	540 SUBTOTAL WHITESIDE COUNTY (RURAL)	
015				
815	596+00 - 628+61	SK I P - DASH	WHITESIDE COUNTY (URBAN) YELLOW	
		YELLOW	176 590+50 - 593+45 DIAGONALS FOR MEDIAN @ DUDEN ROAD	
633	584+17 - 590+50	SKIP DASH	271 594+21 - 596+66 DIAGONALS FOR MEDIAN @ DUDEN ROAD	
127	595+90 - 600+97	SOLID CENTERLINE/ CONCRETE MEDIAN	447 SUBTOTAL WHITESIDE COUNTY (URBAN)	
480	601+82 - 606+62	SOLID CENTERLINE/ CONCRETE MEDIAN		
116	609+12 - 613+75	SOLID CENTERLINE/ CONCRETE MEDIAN	WHITESIDE COUNTY (URBAN) WHITE	
211	614+62 - 623+05	SOLID CENTERLINE/ CONCRETE MEDIAN	827 600+11 - 600+97 DIAGONALS FOR ISLAND @ I-88 EASTBOUND RAMP	
125	623+63 - 628+61	SOLID CENTERLINE/ CONCRETE MEDIAN	403 600+34 - 600+86 DIAGONALS FOR ISLAND @ IL 40 SOUTHBOUND RAMP	
2,506	SUBTOTAL WHITESIDE COUNTY (U	TOAN J		
			666 614+74 - 615+52 DIAGONALS FOR ISLAND @ I-88 WESTBOUND RAMP	
23,082	SUBTOTAL BUREAU COUNTY (RURA		2,181 SUBTOTAL WHITESIDE COUNTY (URBAN)	
104,045	SUBTOTAL WHITESIDE COUNTY	(RURAL)		
40,691	SUBTOTAL WHITESIDE COUNTY	(URBAN)	1,016 SUBTOTAL BUREAU COUNTY (RURAL)	
167,818	TOTAL		540 SUBTOTAL WHITESIDE COUNTY (RURAL)	
	_		3,251 SUBTOTAL WHITESIDE COUNTY (URBAN)	
			4,807 TOTAL	
LISER MAME	= Cristian.Rosas DESIGNED -	REVISED -		COUNTY
OSER NAME	DRAWN -	REVISED -		COUNTY
			040 (101, 102, 133)(3	WHITESIDE
PLOT SCALE	= 100.0000 / in CHECKED -	REVISED -	DEPARTMENT OF TRANSPORTATION	CONTRACT

FOOT	LOCATION OF F	SET REMARKS	SQ FT <u>LOCATION</u> <u>OFFSET</u>
	BUREAU COUNTY (RURAL)	WHITE	WHITESIDE COUNTY (URBAN)
13.0	1200+55 -	STOR BAR @ IL 92	51.9 612+01 - 613+74 LT T
21.0	1200+64 -	STOR BAR @ IL 92	17.3 614+80 - RAMP-
21.0	1200+72 -	STOR BAR @ IL 92	17.3614+88RAMP -
55	SUBTOTAL BUREAU COUNTY (RURAL)		87.0 SUBTOTAL WHITESIDE COUNTY (URBAN)
	WHITESIDE COUNTY (RURAL)		SOUTHBOLND
21.0	368+33 -	STOR BAR @ STAR ROAD/IL 172	WHITESIDE COUNTY RURAL
13.7	368+66 -	STOR BAR @ STAR ROAD/IL 172	<u> 69.2</u> 369+55 372+52
35	SUBTOTAL WHITESIDE COUNTY (RURAL)		70.0 SUBTOTAL WHITESIDE COUNTY (RURAL)
	WHITESIDE COUNTY (URBAN)		WHITESIDE COUNTY (URBAN)
19.5	600+47 -	STOR BAR @ I-88 EB RAMP TO IL 40 SE	51.9 595+00 - 600+00
21.7	600+97 -	STOR BAR @ 1-88 EB RAMP TO IL 40 SE	17.3 600+95 - RAMP-L
21.6	614+70 -	STOR BAR @ I-88 WB RAMP TO IL 40 SE	17.3 600+75 - RAMP
20.0	615+24	STOR BAR @ I-88 WB RAMP TO IL 40 NE	51.9 602+01 - 603+58 LT TU
83	SUBTOTAL WHITESIDE COUNTY (URBAN)		<u>51.9</u> 615+81 - 618+09 RT TU
173	TOTAL		191.0 SUBTOTAL WHITESIDE COUNTY (URBAN)
			70.0 SUBTOTAL WHITESIDE COUNTY (RURAL)
			278.0 SUBTOTAL WHITESIDE COUNTY (URBAN)
78009004	MODIFIED URETHANE PAVEMENT MARKI	<u>NG - LINE 4"</u>	348.0 TOTAL
<u>FOOT</u>	LOCATION	<u>REMARKS</u>	
	BUREAU COUNTY (RURAL)		
0			78100100 RAISED REFLECTIVE PAVEMENT MARKER
0	SUBTOTAL BUREAU COUNTY (RURAL)		EACH LOCATION OFFSET
			BUREAU COUNTY (RURAL)
	WHITESIDE COUNTY (RURAL)	WHITE	TWO-WAY AMBER
258	35+47 - 38+05	FDGF INF - NB (BRIDGE #1)	24 1200+56 - 1204+77
258	35+29 - 37+87	EDGE LINE - SB (BRIDGE #1)	24 SUBTOTAL BUREAU COUNTY (RURAL)
235	151+93 - 154+28	EDGE LINE - NB (BRIDGE # 2)	
236	151+72 - 154+08	EDGE LINE - SB (BRIDGE # 2)	WHITESIDE COUNTY (RURAL)
112	220+55 - 221+67	EDGE LINE - NB (BRIDGE # 3)	<u>13</u> 630+35 - 632+58
1,099	SUBTOTAL WHITESIDE COUNTY (RURAL)	EDGE LINE - SB (BRIDGE # 3)	13 SUBTOTAL WHITESIDE COUNTY (RURAL)
	WHITESIDE COUNTY (RURAL)	YELLOW	WHITESIDE COUNTY (RURAL)
518	35+37 - 37+96	SOLID CENTERLINE - NB & SB (BRIDGE # 1)	ONE-WAY CRISTAL
59	151+82 - 154+18	SKIP DASH - NB & SB (BRIDGE # 2)	<u> 19 </u> 369+02 - 372+61
28	220+48 - 221+60	SKIP DASH - NB & SB (BRIDGE # 3)	19 SUBTOTAL WHITESIDE COUNTY (RURAL)
605	SUBTOTAL WHITESIDE COUNTY (RURAL)		TWO-WAY AMBER
	WHITESIDE COUNTY (URBAN)	WHITE	WHITESIDE COUNTY (URBAN)
63	606+62 - 609+12	SKIP DASH - NB (BRIDGE # 4)	102 550+00 - 590+49
63	606+62 - 609+12	SKIP DASH - SB (BRIDGE # 4)	17 590+49 - 593+46
125			15 594+20 - 597+51
			11 601+78 - 603+83 20
	WHITESIDE COUNTY (URBAN)	YELLOW	7 21 598+22 - 606+62
500	606+62 - 609+12	SOLID EDGE LINE - NB & SB (BRIDGE # 4)	12 611+76 - 613+97 20
			19 614+74 - 618+35 20
500			
500			49 609+12 628+72

24	SUBTOTAL	BUREAU COL	JNTY (RU	JRAL)
32	SUBTOTAL	WHITESIDE	COUNTY	(RURAL)
246	SUBTOTAL	WHITESIDE	COUNTY	(URBAN)
302	τοτ	A L		

USER NAME = Cristian.Rosas	DESIGNED -	REVISED -							F.A.P. BTE	SECTION	COUNTY	TOTAL	SHEET NO.
	DRAWN -	REVISED -	STATE OF ILLINOIS			SCHEDUL	E OF QUANTITIES		646	(101, 102, 135)RS	WHITESIDE	179	25
PLOT SCALE = 100.0000 / in	CHECKED -	REVISED -	DEPARTMENT OF TRANSPORTATION								CONTRACT	T NO. 64	P41
PLOT DATE = 8/24/2023	DATE -	REVISED -		SCALE:	SHEET	OF	SHEETS STA.	TO STA.		ILLINOIS FED.	AID PROJECT		

KING, LETTERS AND SYMBOLS <u>REMARKS</u> <u>ET</u>

LT TURN ARROW (3 ARROWS) TO I-88 WESTBOUND RAMP RAMP-LT TURN ARROW (1 ARROW) TO IL 40 SOUTHBOUND RAMP-RT TURN ARROW (1 ARROW) TO IL 40 NORTHBOUND

WHITE

RT TURN ARROW (4 ARROWS) TO STAR RD / IL 172

LANE REDUCTION 3 ARROWS RAMP-LT TURN ARROW (1 ARROW) TO IL 40 NORTHTHBOUND AMP RT TURN ARROW (1 ARROW) TO IL 40 SOUTHBOUND LT TURN ARROW (3 ARROWS) TO IL-88 EASTBOUND RAMP RT TURN ARROW (3 ARROWS) TO IL-88 WESTBOUND RAMP

REMARKS

MEDIAN 40'o.c.

MEDIAN 40' o.c.STAR ROAD/IL 172

20' o.c. RT LANE @ STAR ROAD/IL 172

CENTERLINE 80' o.c. MEDIAN 40'o.c. MEDIAN 40'o.c. 20' o.c. LT LANE FROM IL 40 SB TO I-88 EB RAMP NORTHBOUND CENTERLINE @ 80' o.c 20' o.c. LT LANE FROM IL 40 NB TO I-88 WB RAMP 20' o.c. RT LANE FROM IL 40 SB TO I-88 WB RAMP NORTHBOUND CENTERLINE @ 80' o.c

78300200	RAISED REFLECTIVE PAVEMENT MARKER	REMOVAL	X0326899	SOLAR-POWERED FLASHING BEACON ASSEMBLY (COM
<u>EACH</u>	LOCATION OFFS	ET <u>REMARKS</u>	EACH	LOCATION
	BUREAU COUNTY RURAL	AS DIRECTED BY THE RESIDENT ENGINEER		WHITESIDE COUNTY (URBAN)
690	_	(ESTIMATED 50% MISSING)	4	THOME ROAD CONTRACTOR TO PROVIDE
690	SUBTOTAL BUREAU COUNTY (RURAL)		4	SUBTOTAL WHITESIDE COUNTY (URBAN)
	WHITESIDE COUNTY (RURAL)		4	TOTAL
118	_			
118	SUBTOTAL WHITESIDE COUNTY (RURAL)			
				ESTABLISHING AND REFERENCING LAND SECTION M
	WHITESIDE COUNTY (URBAN)		EACH	LOCATION
55	-			BUREAU COUNTY (RURAL) DISTR
55	SUBTOTAL WHITESIDE COUNTY (URBAN)		4	
863	TOTAL		4	SUBTOTAL BUREAU COUNTY (RURAL)
				WHITESIDE COUNTY (RURAL)
			18	_
X0326697	CENTER LINE - RUMBLE STRIP - 8"		18	SUBTOTAL WHITESIDE COUNTY (RURAL)
FOOT	LOCATION NORIHBOLND			WHITESIDE COUNTY (URBAN)
	BUREAU COUNTY (RURAL)		8	WHITESTEE COONTY (ORBAN)
1,049	1272+55 - 1283+04	SOLID CENTERLINE (NO PASSING ZONE)	8	– SUBTOTAL BUREAU COUNTY (URBAN)
1,049	SUBTOTAL BUREAU COUNTY (RURAL)			
			30	TOTAL
	WHITESIDE COUNTY (RURAL)			
737	28+00 - 35+37	SOLID CENTERLINE (NO PASSING ZONE)		
968	247+00 - 256+68	SOLID CENTERLINE (NO PASSING ZONE)		ROCK FILL
1,705	SUBTOTAL WHITESIDE COUNTY (RURAL)		TON	LOCATION
				WHITESIDE COUNTY (RURAL)
633	WHITESIDE COUNTY (URBAN)		70	289+44
633	584+17 590+50 SUBTOTAL WHITESIDE COUNTY (URBAN)	SOLID CENTERLINE (NO PASSING ZONE)	70	
	SOUTHBOUND		Z0055100	RUMBLE RESURFACING
	BUREAU COUNTY (RURAL)		<u>SQ_YD</u>	LOCATION
423	1204+77 - 1209+00	SOLID CENTERLINE (NO PASSING ZONE)		BJREAU COUNTY (RURAL)
204	1281+00 - 1283+04	SOLID CENTERLINE (NO PASSING ZONE)	367	RUMBLE
627	SUBTOTAL BUREAU COUNTY (RURAL)		367	SUBTOTAL BUREAU COUNTY (RURAL)
	WHITESIDE COUNTY (RURAL)		367	TOTAL
446	1+00 - 5+46	SOLID CENTERIINE (NO PASSING ZONE)		
100	34+37 - 35+37	SOLID CENTERLINE (NO PASSING ZONE)		
715	37+96 - 45+11	SOLID CENTERLINE (NO PASSING ZONE)		
626	255+44 - 261+70	SOLID CENTERLINE (NO PASSING ZONE)		
1,887	SUBTOTAL WHITESIDE COUNTY (RURAL)			
1,676	SUBTOTAL BUREAU COUNTY (RURAL)			
3,592	SUBTOTAL WHITESIDE COUNTY (RURAL)			
633	SUBTOTAL WHITESIDE COUNTY (URBAN)			

									BTE	SECTION	COUNTY SHEETS NO
	DRAWN -	REVISED -	STATE OF ILLINOIS				E OF QUANTITIES		646	(101, 102, 135)RS	WHITESIDE 179 26
PLOT SCALE = 100.0000 / in	CHECKED -	REVISED -	DEPARTMENT OF TRANSPORTATION								CONTRACT NO. 64P41
PLOT DATE = 8/24/2023	DATE -	REVISED -		SCALE:	SHEET	OF	SHEETS STA.	TO STA.		ILLINOIS FED.	AID PROJECT

5,901

TOTAL

MPLETE)

(NORTHBOUND & SOUTHBOUND) DE 1 REPLACEMENT PER POST TO D2

MARKERS

LOCATIONS TO BE DETERMINED BY RICT 2 CHIEF OF PLATS AND PLANS

RESURAFING AT IL40/IL 92 INTERSECTION REFER TO DISTRICT STANDARD 91.4

Image: Note of the state of the st	40604060	40604050	40600370	40600290															
Location: 0.4 Mile South of I-88 to IL97 Remarks Length Mainline Right Right Left South South Trimming Carta Coath Sealant IL-9.5. Mix "C" N50 IL Z" (Shoulder) Z" (Shoulder) <thz" (shoulder)<="" th=""> Z" (Shoulder) Z" (Sho</thz">	Hot-Mix Asphal	Hot-Mix Asphalt	Longitudinal	Bituminous															
Image: Normal BUREAU Image: No	Surface Course	Surface Course	Joint	Materials															
Normal Matrix Normal Matrix Number Matrix<	L-9.5, Mix "D" N	IL-9.5, Mix "C" N50	Sealant	(Tack Coat)					Left	_	Right		Mainline	Length	Remarks	8 to IL92	th of I-8	4 Mile Sou	Location: 0.
Station to Station Station to Station FT FT FT SQ YD FT SQ YD FT FT SQ YD FT FT SQ YD FT FT SQ YD FT SQ YD FT SQ YD<	2"	2" (Shoulder)				Trimming	Joint		Shldr		Shldr		Average						
40 Rural BUREAU a					Area	Width	Length	Area	Width	Area	Width	Area	Width						
Lt& Rt Sta 1201 + 58 - 1206 + 0 Mainline 442 34.5 1694.3 - - - - 762.5 884.0 - - 49.5 Lt& Rt Sta 1201 + 58 - 1203 + 4 Mainline 7704 24 20544.0 - - - - 9244.8 7704.0 49.5 Lt& Rt Sta 1206 + 0 - 1212 + 89 Rt. & Lt. Shoulder 684 0 4 306.2 4 306.2 1378 0.5 766.7 276.6 770.0 Lt & Rt Sta 1213 + 57 - 1212 + 98 Rt. & Lt. Shoulder 5834 - 4 306.2 4 306.2 1378 0.5 766.7 276.6 277.0 77.2 77.2 77.2 1231 + 95 1231 + 95 1235 + 17 126.8 3384 - 4 306.2 4 306.2 1388 0.5 102.1 106.8 326.7 Lt Sta1231+ 95- 1235 <th< td=""><td>TON</td><td>TON</td><td>FOOT</td><td>POUND</td><td>SQ YD</td><td>FT</td><td>FT</td><td>SQ YD</td><td>FT</td><td>SQ YD</td><td>FT</td><td>SQ YD</td><td>FT</td><td>FT</td><td></td><td>n</td><td>o Statio</td><td>Station t</td><td></td></th<>	TON	TON	FOOT	POUND	SQ YD	FT	FT	SQ YD	FT	SQ YD	FT	SQ YD	FT	FT		n	o Statio	Station t	
Lt& Rt Sta 1201 + 58 - 1206 + 0 Mainline 442 34.5 1694.3																			40 Rural BURF
Lt & Rt Sta 1206 + 0 - 1283 + 4 Mainline 7704 24 20544.0 - 1206 - 9244.8 7704.0 - 1206 + 0 - 1212 + 89 Rt. & Lt. Shoulder 689 - 4 306.2 4 306.2 1378 0.5 76.6 275.6 7704.0 7704.0 Rt Sta 1213 + 57 - 1231 + 91 Rt. Shoulder 5834 - 4 306.2 4 306.2 1378 0.5 76.6 275.6 7704.0 772.0 Rt Sta 1213 + 57 - 1231 + 91 Rt. Shoulder 5834 - 4 316.9 1838 0.5 102.1 367.6 102.9 102.9 102.9 102.9 102.9 102.9 102.9 102.9 102.9 102.9 102.9 102.9 102.9 102.9 102.9 102.9 102.9 102.9 102.9 102.4 203.7 102.9 102.4	213.5		884.0	762.5								1694.3	34.5	442	Mainline	1206 + 0	- 58 -		
Lt & Rt Sta 1206 + 0 - 1212 + 89 Rt. & Lt. Shoulder 689 4 306.2 4 306.2 1378 0.5 76.6 275.6 77.2 Rt Sta 1213 + 57 - 1271 + 91 Rt. Shoulder 5834 4 2592.9 5834 0.5 76.6 275.6 77.2 326.7 Lt Sta 1213 + 57 - 1231 + 95 Lt. Shoulder 1838 4 306.2 4 306.9 1838 0.5 324.1 1166.8 326.7 Lt Sta 1231 + 95 - 1235 + 17 Lt. G.R. Shoulder 322 0 var 227.6 322 0.5 17.9 102.4 28.7 Lt Sta 1235 + 7 2 2.6 3657 0.5 3657 0.5 203.2 731.4 204.8 Lt Sta 1271 + 74 - 1272 86 Rt. Shoulder & G.R. 86 0		49.5		176.8	49.1	0.5	884	196.4	4	196.4	4			442	Rt. & Lt. Shoulder	1206 + 0	- 58 -	1201 -	Lt & Rt Sta
Rt Sta 1213 + 57 - 1271 + 91 Rt. Shoulder 5834 0 4 2592.9 102.1 5834 0.5 324.1 1166.8 326.7 Lt Sta 1231 + 57 - 1231 + 95 Lt. Shoulder 1838 0.5 4 0.5 324.1 1166.8 326.7 Lt Sta 1231 + 95 - 1235 + 17 Lt. G.R. Shoulder 322 0.5 4 0.5 324.1 1166.8 326.7 Lt Sta 1231 + 95 - 1235 + 17 Lt. G.R. Shoulder 322 0.5 4 0.5 324.1 1166.8 326.7 Lt Sta 1235 + 17 Lt. G.R. Shoulder 322 0.5 162.3 3657 0.5 203.2 731.4 204.8 204.8 Rt Sta 1271 + 74 Lt. Shoulder & G.R. 3657 4 4 42.2 6 0.5 5.3 19.0 5.3 102.4	2588.5		7704.0	9244.8								20544.0	24	7704	Mainline	1283 + 4	- 0 -	1206 -	Lt & Rt Sta
Lt Sta 1213 + 57 - 1231 + 95 Lt. Shoulder 1838 0 1838 0.5 102.1 367.6 102.9 Lt Sta 1231 + 95 - 1235 + 17 Lt. G.R. Shoulder 322 0 0 4 816.9 1838 0.5 102.1 367.6 102.9 Lt Sta 1235 + 17 Lt. G.R. Shoulder 322 0 0 4 816.9 1838 0.5 102.1 367.6 102.9 28.7 Lt Sta 1235 + 17 Lt. G.R. Shoulder 3657 0 4 1625.3 3657 0.5 203.2 731.4 204.8 Rt Sta 1271 + 94 - 1272 + 86 Rt. Shoulder & G.R. 95 4 4 42.2 - 95 0.5 5.3 19.0 5.3 5.3 Lt Sta 1271 + 74 Lt. G.R. Shoulder & G.R. 86 6 6 4 38.2 86 0.5 <td></td> <td>77.2</td> <td></td> <td>275.6</td> <td>76.6</td> <td>0.5</td> <td>1378</td> <td>306.2</td> <td>4</td> <td>306.2</td> <td>4</td> <td></td> <td></td> <td>689</td> <td>Rt. & Lt. Shoulder</td> <td>1212 + 89</td> <td>- 0 -</td> <td>1206 -</td> <td>Lt & Rt Sta</td>		77.2		275.6	76.6	0.5	1378	306.2	4	306.2	4			689	Rt. & Lt. Shoulder	1212 + 89	- 0 -	1206 -	Lt & Rt Sta
Lt Sta 1231 + 95 - 1235 + 17 Lt.G.R. Shoulder 322 0.5 17.9 102.4 28.7 Lt Sta 1235 + 17 Lt.G.R. Shoulder 3657 0.5 4 0.5 203.2 731.4 204.8 Rt Sta 1271 + 91 - 1272 + 86 Rt. Shoulder & G.R. 95 4 4 42.2 95 0.5 5.3 19.0 5.3 Lt Sta 1271 + 74 - 1272 + 86 Rt. Shoulder & G.R. 95 4 42.2 95 0.5 5.3 19.0 5.3 Lt Sta 1271 + 74 - 1272 + 86 Rt. Shoulder & G.R. 86 6 4 42.2 95 0.5 5.3 19.0 5.3 Lt Sta 1271 + 74 - 1272 + 60 Lt. G.R. Shoulder 322 6 27.6 322 0.5 17.9 102.4 28.7 L				1166.8	324.1	0.5	5834			2592.9	4			5834	Rt. Shoulder		- 57 -	1213 -	Rt Sta
Lt Sta 1235 + 17 - 1271 + 74 Lt. Shoulder 3657 0.5 203.2 731.4 204.8 Rt Sta 1271 + 91 - 1272 + 86 Rt. Shoulder & G.R. 95 4 42.2 95 0.5 203.2 731.4 204.8 Lt Sta 1271 + 91 - 1272 + 86 Rt. Shoulder & G.R. 95 4 42.2 95 0.5 5.3 19.0 5.3 Lt Sta 1271 + 74 - 1272 + 80 Rt. Shoulder & G.R. 86 6 6 4 42.2 95 0.5 5.3 19.0 5.3 Lt Sta 1271 + 74 - 1272 + 80 11. Shoulder & G.R. 86 6 6 4 42.2 86 0.5 4.8 17.2 4.8 Lt Sta 1231 + 74 Lt. G.R. Shoulder 322 70 708 227.6 322 0.5 17.9 <td></td> <td></td> <td></td> <td>367.6</td> <td>102.1</td> <td>0.5</td> <td>1838</td> <td>816.9</td> <td>4</td> <td></td> <td></td> <td></td> <td></td> <td>1838</td> <td>Lt. Shoulder</td> <td></td> <td>- 57 -</td> <td>1213 -</td> <td>Lt Sta</td>				367.6	102.1	0.5	1838	816.9	4					1838	Lt. Shoulder		- 57 -	1213 -	Lt Sta
Rt Sta 1271 + 91 - 1272 + 86 Rt. Shoulder & G.R. 95 4 95 0.5 5.3 19.0 5.3 Lt Sta 1271 + 74 - 1272 + 60 Lt. Shoulder & G.R. 86 60 </td <td></td> <td></td> <td></td> <td>102.4</td> <td>17.9</td> <td>0.5</td> <td></td> <td>227.6</td> <td>var</td> <td></td> <td></td> <td></td> <td></td> <td></td> <td>Lt. G.R. Shoulder</td> <td></td> <td>- 95 -</td> <td>1231 -</td> <td>Lt Sta</td>				102.4	17.9	0.5		227.6	var						Lt. G.R. Shoulder		- 95 -	1231 -	Lt Sta
Lt Sta 1271 + 74 - 1272 + 60 Lt. Shoulder & G.R. 86 60 4 38.2 86 0.5 4.8 17.2 4.8 Lt Sta 1231 + 95 - 1235 + 17 Lt. G.R. Shoulder 322 0 var 227.6 322 0.5 17.9 102.4 28.7 Rt Sta 1272 + 86 1018 4 452.4 1018 0.5 56.6 203.6 57.0		204.8		731.4	203.2	0.5	3657	1625.3	4					3657	Lt. Shoulder	1271 + 74	- 17 -	1235 -	Lt Sta
Lt Sta 1231 + 95 - 1235 + 17 Lt. G.R. Shoulder 322 0.5 17.9 102.4 28.7 Rt Sta 1272 + 86 1283 + 4 Rt. Shoulder 1018 4 452.4 1018 0.5 56.6 203.6 57.0		5.3		19.0	5.3	0.5	95			42.2	4			95	Rt. Shoulder & G.R.	1272 + 86			Rt Sta
Rt Sta 1272 + 86 1283 + 4 Rt. Shoulder 1018 4 452.4 1018 1018 20.5 56.6 203.6 57.0		4.8		17.2	4.8	0.5	86	38.2	4					86	Lt. Shoulder & G.R.	1272 + 60	- 74 -	1271 -	Lt Sta
					17.9	0.5	322	227.6	var						Lt. G.R. Shoulder			1231 -	Lt Sta
Lt Sta 1272 + 60 1283 + 4 Lt, Shoulder 1044										452.4	4								
		58.5		208.8	58.0	0.5	1044	464.0	4					1044	Lt. Shoulder	1283 + 4	60	1272 -	Lt Sta

USER NAME = Cristian.Rosas	DESIGNED -	REVISED -							F A P BTE	SECTION	COUNTY TO	OTAL SHEET HEETS NO.
	DRAWN -	REVISED -	STATE OF ILLINOIS			HMA	A SCHEDULE		646	(101, 102, 135)RS	WHITESIDE	179 27
PLOT SCALE = 100.0000 / in	CHECKED -	REVISED -	DEPARTMENT OF TRANSPORTATION								CONTRACT N	JO. 64P41
PLOT DATE = 8/24/2023	DATE -	REVISED -		SCALE:	SHEET	OF	SHEETS STA.	TO STA.		ILLINOIS FED.	AID PROJECT	

																44000154	44000157	X4401196	48102100	Z0034105
																Hot-Mix Asphalt	Hot-Mix Asphalt	Hot-Mix Asphalt	Agg Wedge	Material
																Surface	Surface	Surface	Shoulder	Transfer
Location: 0.4	Mile So	uth of I	-88 to II	_92	Remarks	Length	Mainline		Right		Left					Removal	Removal	Removal	Туре В	Device
							Average		Shldr		Shldr		Joint	Trimming		1-1/4"	2"	Longitudinal Joint		
							Width	Area	Width	Area	Width	Area	Length	Width	Area					
	Station	to Stat	ion			FT	FT	SQ YD	FT	SQ YD	FT	SQ YD	FT	FT	SQ YD	Sq Yd	Sq Yd	Sq Yd	TON	TON
40 Rural BURE	AU																			
Lt & Rt Sta	1201	+ 58	- 1206	5 + 0	Mainline	442	34.5	1694.3								1694.3				213.5
Lt & Rt Sta	1201	+ 58	- 1206	3 + 0	Rt. & Lt. Shoulder	442			4	196.4	4	196.4	884	0.5	49.1	392.9		49.1	27.4	
Lt & Rt Sta	1206	+ 0	- 1283	3 + 4	Mainline	7704	24	20544.0								20544.0				2588.5
Lt & Rt Sta	1206		- 1212	2 + 89	Rt. & Lt. Shoulder	689			4	306.2	4	306.2	1378	0.5	76.6	612.4		76.6	42.7	
Rt Sta	1213	+ 57	- 127 ⁻	1 + 91	Rt. Shoulder	5834			4	2592.9			5834	0.5	324.1	2592.9		324.1	180.9	
Lt Sta	1213	+ 57	- 123 ⁻	1 + 95	Lt. Shoulder	1838					4	816.9	1838	0.5	102.1	816.9		102.1	57.0	
Lt Sta	1231	+ 95	- 123	5 + 17	Lt. G.R. Shoulder	322					var	227.6	322	0.5	17.9	227.6		17.9	10.0	
Lt Sta	1235	+ 17	- <u>127</u>	1 + 74	Lt. Shoulder	3657					4	1625.3	3657	0.5	203.2	1625.3		203.2	113.4	
Rt Sta	1271	+ 91	- 1272	2 + 86	Rt. Shoulder & G.R.	95			4	42.2			95	0.5	5.3	42.2		5.3	2.9	
Lt Sta	1271	+ 74	- 1272	2 + 60	Lt. Shoulder & G.R.	86					4	38.2	86	0.5	4.8	38.2		4.8	2.7	
Lt Sta	1231	+ 95	- 123	5 + 17	Lt. G.R. Shoulder	322					var	227.6	322	0.5	17.9	227.6		17.9	10.0	
Rt Sta	1272	+ 86	1283	3 + 4	Rt. Shoulder	1018			4	452.4			1018	0.5	56.6	452.4		56.6	31.6	
Lt Sta	1272	+ 60	1283	3 + 4	Lt. Shoulder	1044					4	464.0	1044	0.5	58.0	464.0		58.0	32.4	

USER NAME = Cristian.Rosas	DESIGNED -	REVISED -							F A P RTE	SECTION	COUNTY	TOTAL SHEET SHEETS NO.
	DRAWN -	REVISED -	STATE OF ILLINOIS			HMA	A SCHEDULE		646	(101, 102, 135)RS	WHITESIDE	179 28
PLOT SCALE = 100.0000 / in	CHECKED -	REVISED -	DEPARTMENT OF TRANSPORTATION				1				CONTRACT	T NO. 64P41
PLOT DATE = 10/12/2023	DATE -	REVISED -		SCALE:	SHEET	OF	SHEETS STA.	TO STA.		ILLINOIS FED.	AID PROJECT	

													40600290	40600370	40604050	40604060
													Bituminous	Longitudinal	Hot-Mix Asphalt	Hot-Mix Aspha
													Materials	Joint	Surface Course	Surface Cours
Location: 0.4	Vile South of I-88 to IL92	Remarks	Length	Mainline		Right		Left					(Tack Coat)	Sealant	IL-9.5, Mix "C" N50	
				Average		Shldr		Shldr	-	Joint	Trimming	-			2" (Shoulder)	2"
				Width	Area	Width	Area	Width	Area	Length	Width	Area	DOUND	FOOT	TON	
0 Rural WHITES	Station to Station		FT	FT	SQ YD	FT	SQ YD	FT	SQ YD	FT	FT	SQ YD	POUND	FOOT	TON	TON
Lt & Rt Sta	0 + 0 - 35 + 45	Mainline	3545	24	9453.3								4254.0	3545.0		1191.1
Rt Sta	0 + 23 - 19 + 98	Rt. Shoulder	1975	27	0400.0	4	877.8			1975	0.5	109.7	395.0	0040.0	110.6	
Lt Sta	0 + 51 - 19 + 98	Lt. Shoulder	1947					4	865.3	1947	0.5	108.2	389.4		109.0	
Rt Sta	19 + 98 - 22 + 90	Rt. Shoulder & G.R.	292			VAR	212.9			292	0.5	16.2	95.8		26.8	
Lt Sta	19 + 98 23 + 39	Lt. Shoulder & G.R.	341					VAR	181.4	341	0.5	18.9	81.6		22.9	
Rt Sta	22 + 90 - 33 + 51	Rt. Shoulder	1061			VAR	268.2			1061	0.5	58.9	120.7		33.8	
Lt Sta	23 + 39 - 33 + 62	Lt. Shoulder	1023			1/40	004.4	VAR	224.3	1023	0.5	56.8	100.9		28.3	
Rt Sta Lt Sta	33 + 51 - 35 + 47 33 + 62 - 35 + 29	Rt. Shoulder & G.R. Lt. Shoulder & G.R.	196 167			VAR	264.1	VAR	222.0	196 167	0.5	10.9 9.3	118.9 99.9		33.3 28.0	
Lt & Rt Sta	35 + 45 - 37 + 89	OMISSION	244					VAR	222.0	107	0.5	9.3	99.9		20.0	
Lt & Rt Sta	37 + 89 - 151 + 92	Mainline	11403	24	30408.0								13683.6	11403.0		3831.4
Rt Sta	38 + 10 - 40 + 34	Rt. Shoulder & G.R.	224			VAR	293.9			224	0.5	12.4	132.2		37.0	
Lt Sta	37 + 72 - 40 + 44	Lt. Shoulder & C.R.	272					VAR	337.0	272	0.5	15.1	151.7		42.5	
Rt Sta	40 + 34 - 80 + 92	Rt. Shoulder	4058			4	1803.6			4058	0.5	225.4	811.6		227.2	
Lt Sta	40 + 44 52 + 77	Lt. Shoulder	_1233					4	548.0	_1233	0.5	68.5	246.6		69.0	
Lt Sta	53 + 57 - 81 + 79	Lt. Shoulder	2822					4	1254.2	2822	0.5	156.8	564.4		158.0	
Rt Sta	81 + 28 - 94 + 10	Rt. Shoulder	1282			8	1139.6		4555	1282	0.5	71.2	512.8		143.6	
Lt Sta	82 + 46 - 84 + 17	Lt. Shoulder	171					8	152.0	171	0.5	9.5	68.4		19.2	
Lt Sta Rt Sta	84 + 76 - 93 + 45 94 + 10 - 148 + 72	Lt. Shoulder Rt. Shoulder	869 5462			4	2427.6	8	772.4	869 5462	0.5	48.3 303.4	347.6 1092.4		97.3 305.9	<u> </u>
Lt Sta	93 + 45 - 148 + 72	Lt. Shoulder	5462			4	2427.0	4	2456.4	5527	0.5	303.4	1092.4		305.9	<u> </u>
Rt Sta	148 + 72 - 151 + 99	Rt. Shoulder & G.R.	327			VAR	330.8		2430.4	327	0.5	18.2	148.9		41.7	
Lt Sta	148 + 72 - 151 + 73	Lt. Shoulder & G.R.	301			•//	000.0	VAR	301.2	301	0.5	16.7	135.5		37.9	
Lt & Rt Sta	151 92 154 18	OMISSION	226													
Lt & Rt Sta	154 + 18 - 220 + 48	Mainline	6630	24	17680.0					_			7956.0	6630.0		2227.7
Rt Sta	154 + 36 - 156 + 93	Rt. Shoulder & G.R.	257			VAR	330.8			257	0.5	14.3	148.9		41.7	
Lt Sta	154 + 3 - 156 + 38	Lt. Shoulder & G.R.	235					VAR	176.6	235	0.5	13.1	79.5		22.2	
Rt Sta	156 + 93 - 158 + 45	Rt. Shoulder	152			4	67.6			152	0.5	8.4	30.4		8.5	
Lt Sta	156 + 38 - 158 + 37	Lt. Shoulder	199					4	88.4	199	0.5	11.1	39.8		11.1	
Rt Sta	159 + 18 - 176 + 61	Rt. Shoulder	1743			4	774.7		0050.0	1743	0.5	96.8	348.6		97.6	
Lt Sta Rt Sta	<u>159</u> + 8 - <u>218</u> + 84 177 + 68 - 218 + 29	Lt. Shoulder Rt. Shoulder	_5976 4061			4	1804.9	4	2656.0	5976 4061	0.5	332.0 225.6	1195.2 812.2		<u> </u>	
Rt Sta	218 + 29 - 220 + 59	Rt. Shoulder & G.R.	230			VAR	177.1			230	0.5	12.8	79.7		22.3	
Lt Sta	218 + 84 - 220 + 37	Lt. Shoulder & G.R.	153			V/ III	177.1	VAR	106.9	153	0.5	8.5	48.1		13.5	
Lt & Rt Sta	220 + 48 - 221 + 60	OMISSION	112													
Lt & Rt Sta	221 + 60 - 366 + 51	Mainline	14491	24	38642.7								17389.2	14491.0		4328.0
Rt Sta	221 + 68 - 223 + 29	Rt. Shoulder & G.R.	161			VAR	134.0			161	0.5	8.9	60.3		16.9	
Lt Sta	221 + 50 - 223 + 79	Lt. Shoulder & G.R.	229					VAR	175.8	_ 229	0.5	12.7	79.1		22.2	
Rt Sta	223 + 29 - 237 + 38	Rt. Shoulder	1409			4	626.2			1409	0.5	78.3	281.8		78.9	
Lt Sta	223 + 79 - 237 + 48	Lt. Shoulder	1369			4	0010.0	4	608.4	1369	0.5	76.1	273.8		76.7	
Rt Sta Lt Sta	237 + 98 - 290 + 11 238 + 5 - 290 + 16	Rt. Shoulder Lt. Shoulder	<u>5213</u> 			4	2316.9	4	2316.0	<u>5213</u> 5211	0.5	289.6 289.5	1042.6 1042.2		291.9 291.8	<u> </u>
Rt Sta	290 + 75 - 290 + 16	Rt. Shoulder	2980			4	1324.4	4	2310.0	2980	0.5	165.6	596.0		166.9	
Lt Sta	290 + 76 - 322 + 33	Lt. Shoulder	3157			<u> </u>	1024.4	4	1403.1	3157	0.5	175.4	631.4		176.8	<u> </u>
Rt Sta	320 + 55 - 323 + 88	Rt. Shoulder & G.R.	333			VAR	227.0			333	0.5	18.5	102.1		28.6	
Lt Sta	322 + 33 - 323 + 58	Lt. Shoulder & G.R.	125					VAR	65.8	125	0.5	6.9	29.6		8.3	
Rt Sta	323 + 88 - 368 + 38	Rt. Shoulder	4450			4	1977.8			4450	0.5	247.2	890.0		249.2	
Lt Sta	323 + 47 - 367 + 1	Lt. Shoulder	_4354					4	1935.1	4354	0.5	241.9	870.8		243.8	
Lt Sta	367 + 1 - 367 + 80	Lt. Shoulder	79					4	35.1	79	0.5	4.4	15.8		4.4	
Lt & Rt Sta	366 + 51 - 369 + 44	Mainline	293	24	781.3		-			-			351.6	293.0		87.5
Lt Sta.	367 + 0 - 375 + 40	turnlane	840	VAR	916.1								412.2	840.0		400.0
Lt & Rt Sta	369 + 44 - 372 + 62	Mainline Rt. Shoulder	318 3222	24	848.0	4	1432.0			3222	0.5	179.0	381.6 644.4	318.0	180.4	106.8
Rt Sta Lt Sta	<u>369</u> + 6 - <u>401</u> + 28 <u>369</u> + 81 - <u>374</u> + 59	Lt. Shoulder	478			4	1432.0	4	212.4	478	0.5	26.6	95.6		26.8	<u> </u>
Lt Sta	374 + 59 - 375 + 40	Lt. Shoulder	81					4 VAR	50.0	81	0.5	4.5	22.5		6.3	
Lt Sta	375 + 40 - 402 + 22	Lt. Shoulder	2682					4	1192.0	2682	0.5	149.0	536.4		150.2	
Lt & Rt Sta	372 + 62 - 375 + 86	Mainline	324	24	1224.0	-							550.8	324.0		154.2
Rt Sta	401 + 28 - 406 + 13	Rt. Shoulder & G.R.	485			VAR	373.4			485	0.5	26.9	168.0		47.0	
Lt Sta	402 + 22 - 406 + 95	Lt. Shoulder & G.R.	473					VAR	363.7	473	0.5	26.3	163.6		45.8	
Rt Sta	406 + 13 - 447 + 37	Rt. Shoulder	4124			4	1832.9			4124	0.5	229.1	824.8		230.9	
Lt Sta	406 + 95 - 459 + 33	Lt. Shoulder	5238					4	2328.0	5238	0.5	291.0	1047.6		293.3	
Rt Sta	448 + 13 - 464 + 39	Rt. Shoulder	1626			4	722.7			1626	0.5	90.3	325.2		91.1	
Lt Sta	459 + 96 - 473 + 69	Lt. Shoulder	1373				040.7	4	610.2	1373	0.5	76.3	274.6		76.9	<u> </u>
Rt Sta	465 + 7 - 472 + 6	Rt. Shoulder	699			4	310.7			699	0.5	38.8	139.8		39.1	
Rt Sta Lt & Rt Sta	472 + 69 - 473 + 69 375 + 86 - 473 + 69	Rt. Shoulder Mainline	100 9783	24	26088.0	4	44.4			100	0.5	5.6	20.0 11739.6	9783.0	5.6	2921.9
																/9/19

USER NAME = Cristian.Rosas	DESIGNED -	REVISED -							F A P BTF	SECTION	COUNTY TOTAL SHE
	DRAWN -	REVISED -	STATE OF ILLINOIS				SCHEDULE		646	(101, 102, 135)RS	WHITESIDE 179 29
PLOT SCALE = 100.0000 / in	CHECKED -	REVISED -	DEPARTMENT OF TRANSPORTATION								CONTRACT NO. 64P41
PLOT DATE = 8/24/2023	DATE -	REVISED -		SCALE:	SHEET	OF	SHEETS STA.	TO STA.		ILLINOIS FED.	AID PROJECT

											SCHEE				44000154 Hot-Mix Asphalt Surface	44000157 Hot-Mix Asphalt Surface	X4401196 Hot-Mix Asphalt Surface	48102100 Agg Wedge Shoulder	Z00341 Materia Transfe
Location: 0.4	Mile So	uth of I	-88 to II 92	Remarks	Length	Mainline		Right		Left					Removal	Removal	Removal	Type B	Devic
Elocation: 0.1	ville oo		00 10 1202	rtemano	Longin	Average		Shldr		Shldr		Joint	Trimming		1-1/4"	2"	Longitudinal Joint	турсы	Devic
						Width	Area	Width	Area	Width	Area	Length	Width	Area					
	Station	to Stat	ion		FT	FT	SQ YD	FT	SQ YD	FT	SQ YD	FT	FT	SQ YD	Sq Yd	Sq Yd	Sq Yd	TON	TON
Rural WHITES	SIDE																		
& Rt Sta	0	+ 0	- 35 + 45	Mainline	3545	24	9453.3								9453.3				1191
Rt Sta		+ 23	- 19 + 98	Rt. Shoulder	1975			4	877.8			1975	0.5	109.7	877.8		109.7	61.2	
Lt Sta		+ 51	- 19 + 98	Lt. Shoulder	1947					4	865.3	1947	0.5	108.2	865.3		108.2	60.4	
Rt Sta		+ 98	- 22 + 90	Rt. Shoulder & G.R.	292			VAR	212.9			292	0.5	16.2	212.9		16.2	9.1	
Lt Sta		+ 98	- 23 + 39	Lt. Shoulder & G.R.	341					VAR	181.4	341	0.5	18.9	181.4		18.9	10.6	
Rt Sta		+ 90	- 33 + 51	Rt. Shoulder	1061			VAR	268.2			1061	0.5	58.9	268.2		58.9	32.9	
It Sta		+ 39	- 33 + 62	Lt. Shoulder	1023				004.4	VAR	224.3	1023	0.5	56.8	224.3		56.8	31.7	
Rt Sta Lt Sta		+ 51 + 62	- 35 + 47 - 35 + 29	Rt. Shoulder & G.R.	196			VAR	264.1	VAR	222.0	196	0.5	10.9	264.1 222.0		10.9		
& Rt Sta		+ 62	- 35 + 29 - 37 + 89	Lt. Shoulder & G.R. OMISSION	167 244					VAR	222.0	167	0.5	9.3	222.0		9.3		
& Rt Sta		+ 89	- 151 + 92	Mainline	11403	24	30408.0		-						30408.0				3831
Rt Sta		+ 10	- 40 + 34	Rt. Shoulder & G.R.	224	24	30-00.0	VAR	293.9			224	0.5	12.4	293.9		12.4		5031
Lt Sta		+ 72	- 40 + 34	Lt. Shoulder & G.R.	272				200.0	VAR	337.0	272	0.5	12.4	337.0		15.1		
Rt Sta		+ 34	- 80 + 92	Rt. Shoulder	4058			4	1803.6			4058	0.5	225.4	1803.6		225.4	125.8	
Lt Sta	40	+ 44	- 52 + 77	Lt. Shoulder	1233					4	548.0	1233	0.5	68.5	548.0		68.5	38.2	
Lt Sta		+ 57	- 81 + 79	Lt. Shoulder	2822					4	1254.2	2822	0.5	156.8	1254.2		156.8	87.5	
Rt Sta		+ 28	- 94 + 10	Rt. Shoulder	1282			8	1139.6			1282	0.5	71.2	1139.6		71.2	39.7	
Lt Sta		+ 46	- 84 + 17	Lt. Shoulder	171					8	152.0	171	0.5	9.5	152.0		9.5	5.3	
Lt Sta	84	+ 76	- 93 + 45	Lt. Shoulder	869					8	772.4	869	0.5	48.3	772.4		48.3	26.9	
Rt Sta		+ 10	- 148 + 72	Rt. Shoulder	5462			4	2427.6			5462	0.5	303.4	2427.6		303.4	169.3	
Lt Sta	93	+ 45	- 148 + 72	Lt. Shoulder	5527				0000	4	2456.4	5527	0.5	307.1	2456.4		307.1	171.3	
Rt Sta		+ 72	- 151 + 99	Rt. Shoulder & G.R.	327	<u> </u>		VAR	330.8		001.0	327	0.5	18.2	330.8		18.2		
Lt Sta	148	+ 72	- 151 + 73	Lt. Shoulder & G.R.	301 226					VAR	301.2	301	0.5	16.7	301.2		16.7		
& Rt Sta & Rt Sta	151 154	92 + 18	- <u>154</u> 18 - 220 + 48	OMISSION Mainline	6630	24	17680.0	<u> </u>					<u> </u>		17680.0				2227
Rt Sta	154	+ 18	- 220 + 48 - 156 + 93	Rt. Shoulder & G.R.	257	24	17000.0	VAR	330.8			257	0.5	14.3	330.8		14.3		2221
Lt Sta	154	+ 3	- 156 + 38	Lt. Shoulder & G.R.	235				000.0	VAR	176.6	237	0.5	14.3	176.6	<u> </u>	13.1		
Rt Sta	154	+ 93	- 158 + 45	Rt. Shoulder	152			4	67.6	V/ 41 X		152	0.5	8.4	67.6		8.4	4.7	
Lt Sta	156	+ 38	- 158 + 37	Lt. Shoulder	199					4	88.4	199	0.5	11.1	88.4		11.1	6.2	
Rt Sta	159	+ 18	- 176 + 61	Rt. Shoulder	1743			4	774.7	~		1743	0.5	96.8	774.7	· · · · · · · · · · · · · · · · · · ·	96.8	54.0	
Lt Sta	159	+ 8	- 218 + 84	Lt. Shoulder	5976					4	2656.0	5976	0.5	332.0	2656.0		332.0	185.3	
Rt Sta	177	+ 68	- 218 + 29	Rt. Shoulder	4061			4	1804.9			4061	0.5	225.6	1804.9		225.6	125.9	
Rt Sta	218	+ 29	- 220 + 59	Rt. Shoulder & G.R.	230			VAR	177.1			230	0.5	12.8	177.1		12.8		
Lt Sta	218	+ 84	- 220 + 37	Lt. Shoulder & G.R.	153					VAR	106.9	153	0.5	8.5	106.9		8.5		
& Rt Sta	220	+ 48	- 221 + 60	OMISSION	112		0001								00010 -				
& Rt Sta	221	+ 60	- 366 + 51	Mainline	14491	24	38642.7		124.0			164	0.5	0.0	38642.7		0.0		4328
Rt Sta Lt Sta	221 221	+ 68 + 50	- 223 + 29 - 223 + 79	Rt. Shoulder & G.R.	161 229			VAR	134.0	VAR	175.8	161 229	0.5	8.9 12.7	134.0 175.8		8.9 12.7		
Rt Sta		+ 29	- 223 + 79 - 237 + 38	Lt. Shoulder & G.R. Rt. Shoulder	1409			4	626.2	VAR	0.C1I	1409	0.5	78.3	626.2		78.3	43.7	
Lt Sta		+ 79	- 237 + 38	Lt. Shoulder	1369				020.2	4	608.4	1369	0.5	76.1	608.4	<u> </u>	76.1	43.7	
Rt Sta		+ 98	- 290 + 11	Rt. Shoulder	5213			4	2316.9			5213	0.5	289.6	2316.9		289.6	161.6	
Lt Sta	238		- 290 + 16	Lt. Shoulder	5211					4	2316.0	5211	0.5	289.5	2316.0		289.5	161.5	
Rt Sta		+ 75	- 320 + 55	Rt. Shoulder	2980			4	1324.4			2980	0.5	165.6	1324.4		165.6	92.4	
Lt Sta	290	+ 76	- 322 + 33	Lt. Shoulder	3157					4	1403.1	3157	0.5	175.4	1403.1		175.4	97.9	
Rt Sta		+ 55	- 323 + 88	Rt. Shoulder & G.R.	333			VAR	227.0			333	0.5	18.5	227.0		18.5		
Lt Sta		+ 33	- 323 + 58	Lt. Shoulder & G.R.	125					VAR	65.8	125	0.5	6.9	65.8		6.9		
Rt Sta		+ 88	- 368 + 38	Rt. Shoulder	4450			4	1977.8		4005	4450	0.5	247.2	1977.8		247.2	138.0	
Lt Sta		+ 47	- <u>367</u> + 1 - 367 + 80	Lt. Shoulder	4354	<u> </u>				4	1935.1	4354	0.5	241.9	1935.1		241.9	135.0	
Lt Sta	367	+ 1 + 51	- 367 + 80 - 369 + 44	Lt. Shoulder Mainline	79 293	24	781.3			4	35.1	79	0.5	4.4	35.1 781.3		4.4	2.4	87.
Lt Sta	365		- 369 + 44 - 375 + 40	turnlane	<u> </u>	VAR	781.3 916.1	<u> </u>					<u> </u>		781.3 916.1				01.
& Rt Sta		+ 44	- 372 + 62	Mainline	318	24	848.0						<u> </u>		848.0				106
Rt Sta		+ 6	- 401 + 28	Rt. Shoulder	3222	<u> </u>	0.0	4	1432.0			3222	0.5	179.0	1432.0		179.0	99.9	100
Lt Sta		+ 81	- 374 + 59	Lt. Shoulder	478					4	212.4	478	0.5	26.6	212.4		26.6	14.8	
Lt Sta		+ 59	- 375 + 40	Lt. Shoulder	81					VAR	50.0	81	0.5	4.5	50.0		4.5	2.5	
Lt Sta	375	+ 40	- 402 + 22	Lt. Shoulder	2682					4	1192.0	2682	0.5	149.0	1192.0		149.0	83.1	
& Rt Sta		+ 62	- 375 + 86	Mainline	324	_24	1224.0								1224.0				154
Rt Sta		+ 28	- 406 + 13	Rt. Shoulder & G.R.	485			VAR	373.4			485	0.5	26.9	373.4		26.9		
Lt Sta		+ 22	- 406 + 95	Lt. Shoulder & G.R.	473					VAR	363.7	473	0.5	26.3	363.7		26.3		
Rt Sta		+ 13	- 447 + 37	Rt. Shoulder	4124			4	1832.9		00000	4124	0.5	229.1	1832.9		229.1	127.8	
Lt Sta		+ 95	- 459 + 33	Lt. Shoulder	5238				700 -	4	2328.0	5238	0.5	291.0	2328.0		291.0	162.4	
Rt Sta		+ 13	- 464 + 39	Rt. Shoulder	1626			4	722.7	A	610.0	1626	0.5	90.3	722.7		90.3	50.4	
Lt Sta Rt Sta	459 465	+ 96	- 473 + 69 - 472 + 6	Lt. Shoulder Rt. Shoulder	1373 699	<u> </u>			310.7	4	610.2	1373 699	0.5	76.3 38.8	610.2 310.7		76.3 38.8	42.6	
Rt Sta Rt Sta		+ 7	- 472 + 6 - 473 + 69	Rt. Shoulder Rt. Shoulder	100			4	310.7 44.4			100	0.5	38.8 5.6	<u>310.7</u> 44.4		5.6	21.7 3.1	
& Rt Sta		+ 86	- 473 + 69 - 473 + 69	Mainline	9783	24	26088.0	4	+4.4			- 100	0.0	0.0	26088.0		0.0	3.1	2921
			101100		0,00		20000.0		1		1	1	1	1	20000.0				2321

JSER NAME = Cristian.Rosas DESIGNED -REVISED STATE OF ILLINOIS HMA SCHEE DRAWN REVISED PLOT SCALE = 100.0000 / in. CHECKED -REVISED DEPARTMENT OF TRANSPORTATION OF SHEETS PLOT DATE = 10/12/2023 DATE REVISED SCALE: SHEET

			F.A.P. RTE	SECTION	COUNTY	TOTAL SHEETS	SHEET NO.
ED	ULE		646	(101, 102, 135)RS	WHITESIDE	179	30
_					CONTRACT	NO. 64	P41
TS	STA.	TO STA.		ILLINOIS FED. A	ID PROJECT		

																		40600290	40600370	40604050	40604060
																		Bituminous	Longitudinal	Hot-Mix Asphalt	Hot-Mix Asph
				-														Materials	Joint	Surface Course	Surface Cour
Location: 0.4	Mile So	uth of	1-88	3 to IL	92		Remarks	Length	Mainline		Right		Left					(Tack Coat)	Sealant	IL-9.5, Mix "C" N50	IL-9.5, Mix "D"
									Average		Shldr		Shldr		Joint	Trimming				2" (Shoulder)	2"
									Width	Area	Width	Area	Width	Area	Length	Width	Area				
	Station	to St	atior	า				FT	FT	SQ YD	FT	SQ YD	FT	SQ YD	FT	FT	SQ YD	POUND	FOOT	TON	TON
40 Urban WHITE	SIDE																				
Lt & Rt Sta	473	+ 69	-	545	+ 2	6	Mainline	7157	24	19085.3								8588.4	7157.0		2137.6
Rt Sta	473	+ 69	-	486	+ 6	3	Rt. Shoulder	1294			4	575.1			1294	0.5	71.9	258.8		72.5	
Lt Sta	474	+ 37	-	540	+ 6	0	Lt. Shoulder	6623					4	2943.6	6623	0.5	367.9	1324.6		370.9	
Rt Sta	487	+ 27		528			Rt. Shoulder	4156			4	1847.1			4156	0.5	230.9	831.2		232.7	
Rt Sta	529	+ 40		540	_		Rt. Shoulder	1126			4	500.4			1126	0.5	62.6	225.2		63.1	
Rt Sta	541			552			Rt. Shoulder	1162			4	516.4			1162	0.5	64.6	232.4		65.1	
Lt Sta	541		-	544			Lt. Shoulder	334					4	148.4	334	0.5	18.6	66.8		18.7	
Lt Sta	545		-	552			Lt. Shoulder	792					4	352.0	792	0.5	44.0	158.4		44.4	
Lt & Rt Sta	545			552			Mainline	755	24	2013.3								906.0	755.0		225.5
Lt & Rt Sta	552		_		+ 4		Mainline	3423	24	9128.0		000.0			4.400	0.5	70.0	4107.6	6846.0		1022.3
Rt Sta	553			568			Rt. Shoulder	1439			4	639.6		1170.0	1439	0.5	79.9	287.8		80.6	
Lt Sta	553	+ 68		580			Lt. Shoulder	2640				004.0	4	1173.3	2640	0.5	146.7	528.0		147.8	
Rt Sta	568	+ 56		573			Rt. Shoulder	527			4	234.2			527	0.5	29.3	105.4		29.5	
Rt Sta	574	-		577			Rt. Shoulder	360				160.0			360	0.5	20.0	72.0		20.2	
Rt Sta	577		-	583			Rt. Shoulder & G.R. Lt. Shoulder & G.R.	538			VAR	349.4		211.0	538	0.5	29.9	157.2		44.0 39.2	
Lt Sta	580 583			583 588			Rt. Shoulder & G.R.	337 517			4	229.8	VAR	311.0	337 517	0.5	18.7 28.7	140.0 103.4		39.2 29.0	
Rt Sta	583	+ 36		588	_		Lt. Shoulder	517			4	229.0	4	225.8	517	0.5	28.7	103.4	<u> </u>	29.0	
Lt & Rt Sta	583		-	588 588			Mainline	149	24	397.3		<u> </u>	4	223.ð	508	0.0	20.2	101.6	298.0	20.4	50.1
Lt & Rt Sta	587			588			Mainline	149	(24-26)	544.4								245.0	392.0		68.6
Rt Sta	588			590			Rt. Shoulder	463	(24-20)	544.4	5	257.2			463	0.5	25.7	245.0	392.0	32.4	0.00
Lt Sta	588			593 598			Lt. Shoulder	1018				201.2	5	565.6	1018	0.5	25.7 56.6	254.5		71.3	
Rt Sta	588			598	_		Rt. Shoulder	444			5	246.7		000.0	444	0.5	24.7	111.0		31.1	
Rt Sta	594	+ 71		599			Rt. Shoulder	51			11	62.3			51	0.5	24.7	28.1		7.9	-
Lt Sta	598	+ 71		599	_		Lt. Shoulder	54				02.0	11	66.0	54	0.5	3.0	29.7		8.3	
Rt Sta & Ramp	599			600	_		Rt. Shoulder	156			VAR	190.7		00.0	156	0.5	8.7	85.8		24.0	
Lt Sta & Ramp	599			600			Lt. Shoulder	159				100.1	VAR	159.8	159	0.5	8.8	71.9		20.1	
Lt & Rt Sta	590			594			Mainline	359	(26-39)	1296.4								583.4	718.0		163.3
Lt & Rt Sta	594		-	595			Mainline	180	(39-56)	950.0								427.5	360.0		119.7
Lt Sta	594		-	601			Lt. Shoulder	710	(00.00)		4	315.6			710	0.5	39.4	142.0		39.8	
Rt Sta	594		-	601			Rt. Shoulder	687			4	305.3			687	0.5	38.2	137.4		38.5	
Rt Sta	595	+ 88		597			Mainline	163	(30-26)	507.1								228.2	163.0		63.9
Lt Sta	595	+ 88		597	+ 2	4	Mainline	136	(22-26)	362.7								163.2	136.0		45.7
Rt Sta	597			600	+ 4	2	Mainline	291	26	840.7								378.3	291.0		105.9
Lt Sta	597	+ 24	-	600	+ 4	2	Mainline	318	(26-27)	936.3								421.4	318.0		118.0
Rt Sta	600	+ 42	-	601	+ 8	2	Mainline	140	24.2	376.4								169.4	560.0		47.4
Lt Sta	600	+ 42	-	602	+ 9	9	Mainline	257	24.2	691.0								311.0	1028.0		87.1
Area between me		57		601	+ 8	2	Mainline	125	Varies	234.6								105.5	500.0		29.6
Rt Sta	601	+ 14	-	603	+ 8	6	Rt. Shoulder	272			10	302.2			272	0.5	15.1	136.0		38.1	
Rt Sta	603			606	+ 5	0	Rt. Shoulder/G.R,	264			Var	381.4			264	0.5	14.7	171.6		48.1	
Lt Sta	601	+ 14		606			Lt. Shoulder	536			10	595.6			536	0.5	29.8	268.0		75.0	
Rt Sta	601	+ 82		602			Mainline	117	(31-24)	357.5								160.9	234.0		45.0
LT Sta.	601				+ 9		Lt T.L. onto I-88	117	12	156.0								70.2	234.0		19.7
LT Sta.	602				+ 8		Lt T.L. onto I-88	83	14	129.1								58.1	166.0		16.3
LT Sta.	603				+ 2		Lt T.L. onto I-88	239	Varies	241.8								108.8	478.0		30.5
Rt Sta	602				+ 6		Mainline	363	26.6	1072.9				L				482.8	726.0		135.2
Lt Sta	602				+ 6		Mainline	363	26.4	1064.8								479.2	726.0		134.2
Lt & Rt Sta	606				+ 1		OMISSION	250	100.0												
Rt Sta	609				+ 5		Mainline	40	(26.6-27.2)									6.0	80.0		15.1
Lt Sta	609				+ 7		Mainline	360	(26.6-27.8)	1088.0		500.0			500	0.5	00.1	54.4	720.0	74.0	137.1
Rt Sta	609				+ 5		Rt. Shoulder	530			10	588.9			530	0.5	29.4	265.0		74.2	
Lt Sta	609				+ 8		Lt. Shoulder/G.R,	263			10	344.2			263	0.5	14.6	154.9		43.4	
Lt Sta	611				+ 3		Lt. Shoulder	247	(26.6.20.4)	905.0	10	274.4			247	0.5	13.7	123.5	449.0	34.6	101 1
Rt Sta Rt Sta	609	_	_		+ 7		Mainline & R.T.L M.L. & Lt T.L. onto I-88	224	(26.6-38.1) 38.1	805.2 406.4	<u> </u>	<u> </u>			<u> </u>	<u> </u>		362.3 182.9	448.0 192.0		<u> </u>
Rt Sta	611 612				+ 7		Lt T.L. onto I-88	96 103	36.3	406.4		<u> </u>			<u> </u>	<u> </u>		182.9	206.0		51.2
Lt Sta	612				+ 7		Mainline	103	24.3	278.1		<u> </u>			<u> </u>	<u> </u>		125.1	206.0		35.0
Area between me					+ 4		Mainline	129	Varies	133.8				L				60.2	258.0		16.9
Rt Sta	613				+ 4		Mainline	129	24.7	354.0						<u> </u>		159.3	258.0		44.6
Lt Sta	613		-		+ 4		Mainline	129	24.2	346.9				L				156.1	258.0		43.7
Rt Sta	615		-		+ 1		Mainline	108	27.2	326.4								146.9	216.0		41.1
Lt Sta	615		-		+ 1		Mainline	108	26.4	316.8				L				142.6	216.0		39.9
Rt Sta	616				+ 7		Mainline	663	26.2	1930.1								868.5	663.0		243.2
Rt Sta	616				+ 3		Mainline & Rt. T.L.	223	36.9	914.3		1000						411.4	446.0		115.2
Rt Sta	616				+ 7		Rt. Shoulder	1260			10.9	1526.0			1260	0.5	70.0	686.7		192.3	
Lt Sta	616				+ 6		Lt. Shoulder	1249	(00.0.00.1	700 0	10.8	1498.8			1249	0.5	69.4	674.5	(20.0	188.8	
LT Sta.	618				+ 3		Mainline & Rt. T.L.	200	(36.9-26.4)			<u> </u>			<u> </u>	<u> </u>		316.5	400.0		88.6
LT Sta.	620				+ 7		Mainline	240	26.4	704.0								316.8	240.0		88.7
Rt Sta	622				+ 9		Mainline	123	26.4	360.8		<u> </u>					-	162.4	123.0		45.5
LT Sta.	622				+ 9		Mainline	123	26.4	360.8		<u> </u>						162.4	123.0		45.5
Rt Sta	623				+ 7		Mainline	474	24	1264.0								568.8	474.0		159.3
LT Sta. Rt. & Lt. Turn area	623				+ 6		Mainline	463	24	1234.7		<u> </u>						555.6	463.0 246.0		155.6
	622	+1/5	1 -	023	+9	0	Meadian	123	Varies	214.9	1	1	1	1		1	1	96.7	1 /46()		27.1

USER NAME = Cristian.Rosas	DESIGNED -	REVISED -								F.A.P. BTE	SECTION	COUNTY TO	OTAL SHEET
	DRAWN -	REVISED -	STATE OF ILLINOIS			HMA	A SCHED	ULE		646	(101, 102, 135)RS		179 31
PLOT SCALE = 100.0000 / in.	CHECKED -	REVISED -	DEPARTMENT OF TRANSPORTATION								(,,,	CONTRACT N	IO. 64P41
PLOT DATE = 8/24/2023	DATE -	REVISED -		SCALE:	SHEET	OF	SHEETS	STA.	TO STA.		ILLINOIS FED.		

					IVIAI		5100	LDEK		SCHE	JULE			44000154	44000157	X4401196	48102100	Z003410
				-										Hot-Mix Asphalt		Hot-Mix Asphalt	Agg Wedge	Materia
														Surface	Surface	Surface	Shoulder	Transfe
Location: 0.4	Mile South of I-88	B to IL92	Remarks	Length	Mainline		Right		Left					Removal	Removal	Removal	Туре В	Device
					Average		Shldr		Shldr		Joint	Trimming		1-1/4"	2"	Longitudinal Joint		
	Otation to Otation				Width	Area	Width	Area	Width	Area	Length	Width	Area	C a V d	Ct Vd	C a V d	TON	TON
40 Urban WHITE	Station to Station	1		FT	FT	SQ YD	FT	SQ YD	FT	SQ YD	FT	FT	SQ YD	Sq Yd	Sq Yd	Sq Yd	TON	TON
Lt & Rt Sta	473 + 69 -	545 + 26	Mainline	7157	24	19085.3								19085.3				2137.6
Rt Sta	473 + 69 -	486 + 63	Rt. Shoulder	1294			4	575.1			1294	0.5	71.9	575.1		71.9	40.1	
Lt Sta	474 + 37 -	540 + 60	Lt. Shoulder	6623					4	2943.6	6623	0.5	367.9	2943.6		367.9	205.3	
Rt Sta	487 + 27 -	528 + 83	Rt. Shoulder	4156_			4	1847.1			4156	0.5	230.9	1847.1		230.9	128.8	
Rt Sta	529 + 40 -	540 + 66	Rt. Shoulder	1126			4	500.4			1126	0.5	62.6	500.4		62.6	34.9	
Rt Sta	541 + 33 -	552 + 95	Rt. Shoulder	1162			4	516.4	4	140.4	1162	0.5	64.6	516.4		64.6	36.0	
Lt Sta	541 + 17 - 545 + 2 -	544 + 51 552 + 94	Lt. Shoulder Lt. Shoulder	334 792					4	148.4 352.0	334 792	0.5	18.6 44.0	148.4 352.0		18.6 44.0	10.4 24.6	
Lt & Rt Sta	545 + 26 -	552 + 81	Mainline	755	24	2013.3			4	332.0	132		44.0	2013.3		44.0	24.0	225.5
Lt & Rt Sta	552 + 81 -	587 + 4	Mainline	3423	24	9128.0		-				-		9128.0	-			1022.
Rt Sta	553 + 68 -	568 + 7	Rt. Shoulder	1439			4	639.6			1439	0.5	79.9	639.6	-	79.9	44.6	
Lt Sta	553 + 68 -	580 + 8	Lt. Shoulder	2640					4	1173.3	2640	0.5	146.7	1173.3		146.7	81.8	
Rt Sta	568 + 56 -	573 + 83	Rt. Shoulder	527			4	234.2			527	0.5	29.3	234.2		29.3	16.3	
Rt Sta	574 + 38 -	577 + 98	Rt. Shoulder	360			4	160.0			360	0.5	20.0	160.0		20.0	11.2	
Rt Sta	577 + 98 -	583 + 36	Rt. Shoulder & G.R.	538			VAR	349.4	1/45	011.0	538	0.5	29.9	349.4		29.9	16.7	
Lt Sta Rt Sta	580 + 8 - 583 + 36 -	583 + 45 588 + 53	Lt. Shoulder & G.R. Rt. Shoulder	337 517			4	229.8	VAR	311.0	337 517	0.5 0.5	18.7 28.7	311.0 229.8		18.7 28.7	16.0	
Lt Sta	583 + 36 -	588 + 53	Lt. Shoulder	517			4	229.0	4	225.8	517	0.5	28.7	229.8		28.7	16.0	
Lt & Rt Sta	587 + 4 -	588 + 53	Mainline	149	24	397.3		<u> </u>		223.0	500	0.0	20.2	397.3		20.2	15.7	50.1
Lt & Rt Sta	588 + 53 -	590 + 49	Mainline	196	(24-26)	544.4		<u> </u>				<u> </u>		544.4				68.6
Rt Sta	588 + 53 -	593 + 16	Rt. Shoulder	463			5	257.2			463	0.5	25.7	257.2		25.7	14.4	
Lt Sta	588 + 53 -	598 + 71	Lt. Shoulder	1018					5	565.6	1018	0.5	56.6	565.6		56.6	31.6	
Rt Sta	594 + 27 -	598 + 71	Rt. Shoulder	444			5	246.7			444	0.5	24.7	246.7		24.7	13.8	
Rt Sta	598 + 71 -	599 + 22	Rt. Shoulder	51			11	62.3		-	51	0.5	2.8	62.3		2.8		
Lt Sta	598 + 71 -	599 + 25	Lt. Shoulder	54 156			1/4 D	100.7	11	66.0	54	0.5	3.0	66.0		3.0		
Rt Sta & Ramp Lt Sta & Ramp	599 + 22 - 599 + 25 -	600 + 78 600 + 84	Rt. Shoulder Lt. Shoulder	156			VAR	190.7	VAR	159.8	156 159	0.5	8.7 8.8	190.7 159.8		8.7 8.8		
Lt & Rt Sta	590 + 49 -	594 + 8	Mainline	359	(26-39)	1296.4				155.0	155	0.5	0.0	1296.4		0.0		163.3
Lt & Rt Sta	594 + 8 -	595 + 88	Mainline	180	(39-56)	950.0								950.0				119.7
Lt Sta	594 + 4 -	601 + 14	Lt. Shoulder	710	(00 00)	000.0	4	315.6			710	0.5	39.4	315.6		39.4	22.0	110.7
Rt Sta	594 + 27 -	601 + 14	Rt. Shoulder	687			4	305.3			687	0.5	38.2	305.3		38.2	21.3	
Rt Sta	595 + 88 -	597 + 51	Mainline	163	(30-26)	507.1									507.1			63.9
Lt Sta	595 + 88 -	597 + 24	Mainline	136	(22-26)	362.7									362.7			45.7
Rt Sta	597 + 51 -	600 + 42	Mainline	291	26	840.7									840.7			105.9
Lt Sta	597 + 24 -	600 + 42	Mainline	318	(26-27)	936.3									936.3			118.0
Rt Sta	600 + 42 - 600 + 42 -	601 + 82 602 + 99	Mainline Mainline	140 257	24.2 24.2	376.4 691.0									376.4 691.0			47.4
Area between me		601 + 82	Mainline	125	Varies	234.6									234.6			29.6
Rt Sta	601 + 14 -	603 + 86	Rt. Shoulder	272	Valles	234.0	10	302.2			272	0.5	15.1		302.2	15.1		23.0
Rt Sta	603 + 86 -	606 + 50	Rt. Shoulder/G.R.	264			Var	381.4			264	0.5	14.7		381.4	14.7		
Lt Sta	601 + 14 -	606 + 50	Lt. Shoulder	536			10	595.6			536	0.5	29.8		595.6	29.8		
Rt Sta	601 + 82 -	602 + 99	Mainline	117	(31-24)	357.5									357.5			45.0
LT Sta.	601 82 -	602 99	Lt T.L. onto I-88	117	12	156.0									156.0			19.7
LT Sta.	602 + 99 -		Lt T.L. onto I-88	83	14	129.1									129.1			16.3
LT Sta.	603 + 82 -		Lt T.L. onto I-88	239	Varies	241.8									241.8			30.5
Rt Sta	602 + 99 - 602 + 99 -	606 + 62 606 + 62	Mainline Mainline	<u>363</u> 363	26.6 26.4	1072.9 1064.8		<u> </u>							1072.9 1064.8			135.2 134.2
Lt & Rt Sta	606 + 62 -	609 + 12	OMISSION	250	20.4	1004.0									1004.0			134.2
Rt Sta	609 + 12 -	609 + 52	Mainline	40	(26.6-27.2)	119.6				1				L	119.6			15.1
Lt Sta	609 + 12 -	612 + 72	Mainline	360	(26.6-27.8)										1088.0			137.1
Rt Sta	609 + 24 -	614 + 54	Rt. Shoulder	530			10	588.9			530	0.5	29.4		588.9	29.4		
Lt Sta	609 + 24 -	611 + 87	Lt. Shoulder/G.R,	263			10	344.2			263	0.5	14.6		344.2	14.6		
Lt Sta	611 + 87 -	614 + 34	Lt. Shoulder	247			10	274.4			247	0.5	13.7		274.4	13.7		
Rt Sta	609 + 52 -	611 + 76	Mainline & R.T.L	224	(26.6-38.1)			<u> </u>							805.2			101.4
Rt Sta	611 + 76 -	612 + 72	M.L. & Lt T.L. onto I-88		38.1	406.4									406.4			51.2
Rt Sta	612 + 72 - 612 + 72 -	613 + 75 613 + 75	Lt T.L. onto I-88 Mainline	103 103	36.3 24.3	415.4 278.1									415.4 278.1	+		52.3 35.0
										+								
Area between me		615 + 4	Mainline	129	Varies	133.8									133.8			16.9
Rt Sta	613 + 75 -	615 + 4	Mainline	129	24.7	354.0		<u> </u>							354.0			44.6
Lt Sta Rt Sta	613 + 75 - 615 + 4 -	615 + 4 616 + 12	Mainline Mainline	129 108	24.2 27.2	346.9 326.4		-		-					346.9 326.4			43.7
Lt Sta	615 + 4 -	616 + 12	Mainline	108	26.4	316.8	1								316.8			39.9
Rt Sta	616 + 12 -	622 + 75	Mainline	663	26.2	1930.1				1					1930.1			243.2
Rt Sta	616 + 12 -		Mainline & Rt. T.L.	223	36.9	914.3		<u> </u>		1					914.3			115.2
Rt Sta	616 + 12 -	628 + 72	Rt. Shoulder	1260			10.9	1526.0			1260	0.5	70.0		1526.0	70.0		
Lt Sta	616 + 12 -	628 + 61	Lt. Shoulder	1249			10.8	1498.8			1249	0.5	69.4		1498.8	69.4		
LT Sta.	618 + 35 -	620 + 35	Mainline & Rt. T.L.	200	(36.9-26.4)										703.3			88.6
LT Sta.	620 + 35 -	622 + 75	Mainline	240	26.4	704.0									704.0			88.7
Rt Sta	622 + 75 -	623 + 98	Mainline	123	26.4	360.8									360.8			45.5
LT Sta.	622 + 75 -	623 + 98	Mainline	123	26.4	360.8		<u> </u>							360.8			45.5
Rt Sta	623 + 98 -		Mainline	474	24	1264.0									1264.0			159.3 155.6
LT Sta. Rt. & Lt. Turn area	623 + 98 -		Mainline Meadian	463 123	24 Varies	1234.7 214.9		<u> </u>							12 <u>3</u> 4.7 214.9	+		27.1
	022 10 -	023 90	MCauidii	120	Valies	214.3	l	L	I	1	Total W/bit	eside Urba	n - Mainline	45790.1	24759.8	1706.4	785.5	6212.

USER NAME = Cristian.Rosas	DESIGNED -	REVISED -							F A P. BTF	SECTION	COUNTY	TOTAL	SHEET
	DRAWN -	REVISED -	STATE OF ILLINOIS				SCHEDULE		646	(101, 102, 135)RS	WHITESIDE	179	32
PLOT SCALE = 100.0000 / in	CHECKED -	REVISED -	DEPARTMENT OF TRANSPORTATION								CONTRACT	NO. 64	4P41
PLOT DATE = 10/12/2023	DATE -	REVISED -		SCALE:	SHEET	OF	SHEETS STA.	TO STA.		ILLINOIS FED.	AID PROJECT		

										DER H						40600290	40600370	40604050	40604060
																Bituminous Materials	Longitudinal Joint	Hot-Mix Asphalt Surface Course	Hot-Mix Asphal Surface Course
Location: 0.		uth of		02	Remarks	Length	Mainline		Right		Left					(Tack Coat)	Sealant		IL-9.5, Mix "D" N
Location. 0.		unoi	1-00 IU IL	.92	Remarks	Lengin			Shldr		Shldr		Joint	Trimming		(Tack Coal)	Sealani		<u>1L-9.5, MIX D N</u> 2"
							Average	Aree	Width	A.r.o.o.	Width	A.r.a.a		<u>_</u>				2" (Shoulder)	Ζ
	Station	to Cto	tion			FT	Width FT	Area SQ YD		Area		Area SQ YD	Length FT	Width	Area	POUND	FOOT	TON	TON
BAN WHITESI							ГІ	JUID	FT	SQ YD	FT	SUID		FT	SQ YD	PUUND	FUUT	TON	TON
Rt Sta			60/	+ 25	Domp Aroc	204	Varioo	979.0								440.5	204.0		123.4
		+ 21			Ramp Area		Varies	979.0			Vor	55	400	0.5	7.4		204.0	0.0	123.4
Rt Sta	601			+ 26	Ramp Area L.t. SH	23	Veries	000.0			Var	55	133	0.5	7.4	24.6	105.0	6.9	70.0
Lt Sta	599	+ 21		+ 16	Ramp Area	195	Varies	628.8	Man	44.0			101	0.5	0.7	282.9	195.0	5.0	79.2
Lt Sta	601	+ 2	- 601		Ramp Area R.t. SH	14) / -i	500.7	Var	41.0			121	0.5	6.7	18.5	450.0	5.2	75.4
Rt Sta		+ 53	- 616		Ramp Area	159	Varies	598.7			<u> </u>	- 4 - 7	400		0.1	269.4	159.0		75.4
Rt Sta		+ 50		+ 53	Ramp Area L.t. SH	3					Var	54.57	109	0.5	6.1	24.6		6.9	
Rt Sta	614		- 616		Ramp Area R.t. SH	161	<u> </u>		Var	111.2			196	0.5	10.9	50.0		14.0	
Lt Sta	614	+ 35		3 + 12	Ramp Area	177	Varies	961.2								432.5	177.0		121.1
Lt Sta	614			+ 39	Ramp Area L.t. SH	4					Var	75	163	0.5	9.1	33.6		9.4	
Lt Sta	614	+ 56	- 616	3 + 12	Ramp Area R.t. SH	156			Var	159.2			232	0.5	12.9	71.6		20.1	
																4040			
												10	tal vynites	ide Urban ·	- Ramps	1648.3	735.0	62.4	399.1
													Total Bur	eau Coun	tv Rural	13,379	8,588	944	2,802
														side Coun	-	76,399	47,627	5,510	14,849
									. <u> </u>					ide Count		32,913	29,057	2,316	6,611
												10			nd Total	122,690	23,037 85,272	8,771	24,262

USER NAME = Cristian.Rosas	DESIGNED -	REVISED -					
	DRAWN -	REVISED -	STATE OF ILLINOIS			HMA	SCHEDU
PLOT SCALE = 100.0000 / in.	CHECKED -	REVISED -	DEPARTMENT OF TRANSPORTATION				
PLOT DATE = 8/24/2023	DATE -	REVISED -		SCALE:	SHEET	OF	SHEETS

			F.A.P. RTE	SECT	ION		COUNTY	TOTAL SHEETS	SHEET NO.
ED	ULE		646	(101, 102	, 135)R	6	WHITESIDE	179	33
			_				CONTRACT	NO. 64	4P41
TS	STA.	TO STA.			ILLINOIS	FED. AI	D PROJECT		

					NLINE												
													44000154	44000157	X4401196	48102100	Z00341
														Hot-Mix Asphalt	· · · · · · · · · · · · · · · · · · ·	Agg Wedge	Materi
													Surface	Surface	Surface	Shoulder	Transf
Location: 0	.4 Mile South of I-88 to IL92	Remarks	Length	Mainline		Right		Left					Removal	Removal	Removal	Туре В	Devic
				Average	•	Shldr		Shldr		Joint	Trimming		1-1/4"	2"	Longitudinal Joint		l
				Width	Area	Width	Area	Width	Area	Length	Width	Area					
	Station to Station		FT	FT	SQ YD	FT	SQ YD	FT	SQ YD	FT	FT	SQ YD	Sq Yd	Sq Yd	Sq Yd	TON	TOT
Rt Sta	599 + 21 - 601 + 25	Ramp Area	204	Varies	979.0									979.0			123.
Rt Sta	601 + 3 - 601 + 26	Ramp Area L.t. SH	23					Var	55	133	0.5	7.4		54.6	7.4	4.1	
Lt Sta	<u> </u>	Ramp Area	195	Varies	628.8									628.8			79.:
<u>Lt Sta</u>	601 + 2 - 601 + 16	Ramp Area R.t. SH	14			Var	41.0			121	0.5	6.7		41.0	6.7	3.8	I
R <u>t Sta</u>	<u>614 + 53 - 616 + 12</u>	Ramp Area	159	Varies	598.7									598.7			75.4
Rt Sta	614 + 50 - 614 + 53	Ramp Area L.t. SH	3					Var	54.57	109	0.5	6.1		54.6	6.1	3.4	1
Rt Sta	614 + 51 - 616 + 12	Ramp Area R.t. SH	161			Var	111.2			196	0.5	10.9		111.2	10.9	6.1	I
Lt Sta	614 + 35 - 616 + 12	Ramp Area	177	Varies	961.2									961.2			121.
Lt Sta	614 + 35 - 614 + 39	Ramp Area L.t. SH	4					Var	75	163	0.5	9.1		74.6	9.1	5.1	
Lt Sta	614 + 56 - 616 + 12	Ramp Area R.t. SH	156			Var	159.2			232	0.5	12.9		159.2	12.9	7.2	
										Tota Wh	liteside Urba	an - Ramps	0.0	3662.8	53.0	29.6	399.
											Bureau Co			0	915	511	2,80
											iteside Co			0	5,123	2,729	14,84
										Total Whi	teside Cou	nty Urban	45,790	28,423	1,759	815	6,61

USER NAME = Cristian.Rosas	DESIGNED -	REVISED -		Í			
	DRAWN -	REVISED -	STATE OF ILLINOIS	ĺ		HMA	SCHE
PLOT SCALE = 100.0000 / in.	CHECKED -	REVISED -	DEPARTMENT OF TRANSPORTATION	ĺ			
PLOT DATE = 10/12/2023	DATE -	REVISED -		SCALE:	SHEET	OF	SHEET

			F.A.P. RTE	SEC	NON		COUNTY	TOTAL SHEETS	
ED	ULE		646	(101, 102	, 135)R	5	WHITESIDE	179	34
_							CONTRACT	NO. 64	4P41
TS	STA.	TO STA.			ILLINOIS	FED. A	ID PROJECT		

					1		E	NTRA	NCE SO		JLE						
L	_OCAT I ON		CL TO ROW	WIDTH AT SHDLR	SHDLR TO THROAT	THROAT WIDTH	THROAT TO TERMINI	TERMINI WIDTH	MB Turnout or Additional Area	MB Turnout AREA (SQYD)	AREA	Total Area	Surface Area	Surface Area	40600290 BIT MAT (TACK COAT)	40800050 INCIDENTAL HMA SURFACE	48102100 AGG Wedge SHLI Type B
STA	RT/LT	REMARKS	FOOT	FOOT	FOOT	FOOT	FOOT	FOOT			SQ YD	SQ YD	SQ FT	SQ YD	POUND	TON	TON
					-			в	JREAU COUNTY (F	RURAL)							
1240+91	RT	CE	40.0	59.1	21.6	22.0	2.4	21.6		-	103.2	103.2	756	84.0	37.8	11.8	1.8
1250+70	RT	PE MB	48.1	62.5	25.1	14.0	7.0	11.0	281.3	31.3	116.2	147.4	925	102.7	46.2	14.4	1.9
1252+33	RT	PE	44.8	32.5	17.8	14.0	11.0	12.0		-	61.8	61.8	507	56.3	25.3	7.9	1.0
1258+41	LT	PE MB	42.0	66.2	17.8	20.0	8.0	18.0	362.5	40.3	102.0	142.3	890	98.9	44.5	13.9	2.1
1278+05	LT	CE	60.2	55.8	12.8	31.0	31.5	29.1		-	166.4	166.4	1,495	166.1	74.7	23.3	1.7
1280+14	LT	CE	40.0	59.6	12.4	26.8	11.6	27.1	l	-	94.4	94.4	849	94.4	42.5	13.2	1.8
								[TESIDE COUNTY				T				
31+35	RT	CE	60.0	57.4	12.0	33.1	4.9	23.8		-	75.8	75.8	696	77.3	34.8	10.8	1.8
31+43	LT	<u>C</u> E	68.8	45.6	16.7	23.5	36.4	22.3		-	156.9	156.9	1,417	157.4	70.8	22.0	1.4
53+06	RT	PE MB	40.4	40.9	16.8	17.5	7.6	13.6	237.3	26.4	67.8	94.1	581	64.6	29.1	9.0	1.3
73+23	LT	PE	39.8	36.7	15.5	11.1	8.4	11.0		-	51.4	51.4	462	51.4	23.1	7.2	1.1
74+19	RT	PE	40.2	36.8	14.4	15.0	9.8	15.0		-	57.7	57.7	517	57.4	25.8	8.0	<u> </u>
76+39	LT	CE	39.2 40.1	72.9 27.3	15.2 7.3	29.3 17.3	8.7 10.8	29.3 14.6		-	114.2 37.3	114.2 37.3	888 324	98.6 36.0	44.4 16.2	13.8	0.8
82+77	RT	CE	40.1	44.8	14.6	17.5	3.5	14.0		-	58.8	58.8	446	49.5	22.3	6.9	1.4
84+34	RT	CE	40.1	25.9	3.7	19.8	14.3	19.8			41.0	41.0	369	41.0	18.4	5.7	0.8
	RT	CF	39.9	60.1	13.1	30.7	10.9	30.6	<u> </u>		102.9	102.9	923	102.6	46.2	14.4	1.9
86+92		CE	40.0	72.9	15.4	49.6	8.5	57.4		_	155.7	155.7	1,322	146.9	66.1	20.6	2.3
87+53	LT	<u>CE</u>	39.9	50.2	13.0	30.2	10.9	37.2			98.7	98.7	851	94.6	42.6	13.2	1.6
88+04	RT	<u>PE</u> PE	40.0	38.5	18.0	19.2	5.5	19.1		_	69.4	69.4	463	51.5	23.2	7.2	1.2
88+13	LT	PE	40.0	42.9	15.4	19.2	8.6	19.0		_	71.4	71.4	643	71.4	32.1	10.0	1.3
89+33	RT	<u>PE</u>	40.0	27.6	8.8	11.3	8.8	10.7	<u> </u>		29.6	29.6	257	28.5	12.8	4.0	0.9
89+39	LT	CE	40.0	82.7	17.9	45.1	6.1	45.6		_	157.7	157.7	1,380	153.4	69.0	21.5	2.6
90+88	LT	<u>P</u> E	40.0	30.1	8.1	19.2	15.8	19.2	<u> </u>	-	56.1	56.1	486	54.0	24.3	7.6	0.9
91+18	RT	PE	40.0	24.4	11.5	12.7	5.5	13.8		-	31.8	31.8	262	29.1	13.1	4.1	0.8
92+73	RT	PE	40.7	27.5	12.4	17.5	5.3	17.3		-	41.2	41.2	339	37.7	17.0	5.3	0.9
93+22	LT	CE	40.0	38.8	13.3	17.3	7.7	12.6		-	54.0	54.0	592	65.8	29.6	9.2	1.2
93+91	RT	PE	39.8	24.7	10.6	12.1	7.5	11.1		-	31.5	31.5	267	29.7	13.3	4.2	0.8
111+51	LT	PE MB	40.0	29.6	13.3	15.0	7.0	15.2	104.6	11.6	44.5	56.1	481	53.4	24.0	7.5	0.9
131+57	LT	PE MB	40.0	21.0	5.4	16.9	14.4	12.0	3685.3	409.5	34.5	444.0	407	45.2	20.3	6.3	0.7
143+10	RT	PE	58.3	32.2	7.8	12.8	29.8	12.8		-	62.0	62.0	708	78.6	35.4	11.0	1.0
172+35	LT	PE MB	39.6	25.0	6.0	11.0	17.3	11.0	138.5	15.4	33.1	48.5	307	34.1	15.4	4.8	0.8
174+31	LT	PE MB	40.0	48.8	23.0	21.5	11.0	19.5	335.9	37.3	114.9	152.2	776	86.2	38.8	12.1	1.5
193+16	LT	PE MB	45.3	35.0	16.0	35.0	13.0	10.5	250.1	27.8	95.1	122.9	457	50.7	22.8	7.1	1.1
195+57	RT	PE	39.5	50.4	18.8	12.2	4.9	12.1		-	72.0	72.0	651.8	72.4	32.6	10.1	1.6
195+61	LT	MB							399.8	44.4	-	44.4	400	44.4	20.0	6.2	-

USER NAME = Cristian.Rosas	DESIGNED -	REVISED -								F A P RTE	SECTION	COUNTY TOTAL SHEETS	SHEET NO.
	DRAWN -	REVISED -	STATE OF ILLINOIS				NCE SCH			646	(101, 102, 135)RS	WHITESIDE 179	35
PLOT SCALE = 100.0000 / in	CHECKED -	REVISED -	DEPARTMENT OF TRANSPORTATION		1							CONTRACT NO. 64	4P41
PLOT DATE = 10/12/2023	DATE -	REVISED -		SCALE:	SHEET	OF	SHEETS	STA.	TO STA.		ILLINOIS FED. A	D PROJECT	

							E	NTRA	NCE SO	CHEDU	JLE						
I	LOCATION		CL TO ROW	WIDTH AT SHDLR	SHDLR TO THROAT	THROAT WIDTH	THROAT TO TERMINI	TERMINI WIDTH	MB Turnout or Additional Area	MB Turnout AREA (SQYD)	AREA	Total Area	Surface Area	Surface Area	40600290 BIT MAT (TACK COAT)	40800050 INCIDENTAL HMA SURFACE	48102100 AGG Wedge SHL Type B
STA	RT/LT	REMARKS	FOOT	FOOT	FOOT	FOOT	FOOT	FOOT			SQ YD	SQ YD	SQ FT	SQ YD	POUND	TON	TON
			1		1			WHI	TESIDE COUNTY	(RURAL)		1		1			
197+91	LT	MB							447.6	49.7	-	49.7	448	49.7	22.4	7.0	-
198+14	RT	PE	39.5	42.1	14.9	13.4	8.8	13.4		-	59.1	59.1	532	59.1	26.6	8.3	1.3
256+21	LT	PE MB	46.0	70.0	14.0	35.3	13.0	20.7	332.2	36.9	122.3	159.2	1,130	125.6	56.5	17.6	2.2
277+31	LT	CE	40.2	56.0	12.9	23.3	11.2	19.6	164.2	-	83.7	83.7	670	74.4	33.5	10.4	1.7
280+84 282+52	LT	PE MB	40.1	42.8	14.0 12.7	18.8 12.7	10.1	18.9 11.0	164.3 104.4	18.3 11.6	69.2 47.5	87.5 59.1	577	64.1 46.5	28.8	9.0	1.3
282+52		PE MB	40.1	33.3	12.7	12.7	11.4	10.7	146.3	16.3	39.6	55.8	369	40.5	18.4	5.7	0.8
287+38		PE MB	40.1	37.9	11.6	16.7	12.5	16.7	177.1	19.7	58.4	78.1	518	57.6	25.9	8.1	1.2
300+58	RT	<u>PE MB</u> MB	10.1	57.5	11.0	10.7	12.5	10.7	454.2	50.5	-	50.5	454	50.5	22.7	7.1	-
300+70	LT	PE	40.1	40.7	11.3	19.4	12.7	11.0		-	59.3	59.3	526	58.5	26.3	8.2	1.3
307+17	RT	PE MB	40.0	34.3	14.8	11.0	9.2	11.0	176.4	19.6	48.4	68.0	443	49.3	27.7	6.9	1.1
323+69	LT	PE	40.0	54.7	11.5	20.8	12.6	15.3		-	73.6	73.6	605	67.2	30.2	9.4	1.7
323+98	RT	МВ							509.1	56.6	-	56.6	509	56.6	25.5	7.9	-
340+86	RT	PE MB	40.0	40.9	14.7	16.3	9.3	14.0	279.0	31.0	62.3	93.3	580	64.4	29.0	9.0	1.3
359+05	RT	PE MB	39.9	29.8	12.7	12.8	11.2	12.8	212.4	23.6	46.1	69.7	432.9	48.1	21.6	6.7	0.9
364+73	RT	MB		<u> </u>					141.6	15.7	-	15.7	142	15.7	7.1	2.2	-
364+84	LT	CE	40.0	64.6	16.5	34.1	8.1	32.3		-	120.2	120.2	1,025	113.9	51.3	16.0	2.0
377+25	RT	MB							384.3	42.7	-	42.7	384	42.7	19.2	6.0	-
377+35	LT	PE	40.0	35.0	12.4	14.3	11.4	14.3		-	52.1	52.1	407	45.2	20.3	6.3	1.1
395+11	RT	MB	40.0	22.2	12.1	12 1	10.0	12.1	420.8	46.8		46.8	421	46.8	21.0	6.5	-
395+19 396+42	LT		40.0 40.0	33.2	13.1	12.1	10.8	12.1			<u>47.3</u> 67.0	47.3 100.7	425 623	47.3 69.2	21.3	<u> 6 . 6 </u>	1.0
417+18	RT	PE MB	40.0	42.0	15.2 23.2	17.4	9.0 0.7	16.3 18.6	303.3		118.3	118.3	984	109.3	49.2	15.3	2.2
417+22		MB	+0.0	72.1	23.2	10.0	0.7	10.0	289.7	32.2		32.2	290	32.2	14.5	4.5	-
429+14	RT LT	PE	40.0	45.5	8.8	23.9	15.1	21.0		-	71.6	71.6	631	70.1	31.5	9.8	1.4
429+53	RT	MB							291.7	32.4	-	32.4	292	32.4	14.6	4.5	-
432+17	LT	PF	40.0	41.6	10.5	22.1	13.4	21.4		-	69.7	69.7	627	69.6	31.3	9.7	1.3
436+54	LT	CE	40.0	72.5				22.3		-	-	-	1,134	126.0	56.7	17.6	2.2
445+93	RT	PE	40.0	31.5	12.5	11.7	11.5	11.2		-	44.7	44.7	403	44.8	20.1	6.3	1.0
452+40	RT	PE	40.0	36.5	13.7	13.6	10.4	13.6	366.4	40.7	53.6	94.4	473	52.5	23.6	7.4	1.1
465+79	RT	МВ							446.6	49.6	-	49.6	447	49.6	22.3	6.9	-
466+17	LT	PE	30.2	38.0	11.0	16.4	3.2	14.2	315.1	35.0	38.6	73.7	663	73.7	33.1	10.3	1.2
468+91	LT	PE	40.0	34.0	10.2	11.3	13.8	11.3		-	43.0	43.0	387	43.0	19.4	6.0	1.1
469+10	RT	CE MB	40.0	55.2	13.9	32.6	10.1	31.9	257.3	28.6	104.0	132.6	896	99.6	44.8	13.9	1.7
471+33	LT	PE	40.0	40.1	16.3	12.7	7.7	12.7		-	58.6	58.6	417	46.3	20.8	6.5	1.2
471+43	RT	MB							340.0	37.8	-	37.8	417	46.3	20.8	6.5	-

USER NAME = Cristian.Rosas	DESIGNED -	REVISED -								F.A.P. BTE	SECTION	COUNTY	TOTAL SHEET SHEETS NO
	DRAWN -	REVISED -	STATE OF ILLINOIS			ENTRAN	ICE SCHI			646	(101, 102, 135)RS	WHITESIDE	179 36
PLOT SCALE = 100.0000 / in.	CHECKED -	REVISED -	DEPARTMENT OF TRANSPORTATION									CONTRACT	NO. 64P41
PLOT DATE = 10/12/2023	DATE -	REVISED -		SCALE:	SHEET	OF	SHEETS	STA.	TO STA.		ILLINOIS FED.	AID PROJECT	

							E	NTRA	NCE SO	CHEDL	JLE						
L	ΟCATION	I	CL TO ROW	WIDTH AT SHDLR	SHDLR TO THROAT	THROAT WIDTH	THROAT TO TERMINI	TERMINI WIDTH	MB Turnout or Additional Area	MB Turnout AREA (SQYD)	AREA	Total Area	Surface Area	Surface Area	40600290 BIT MAT (TACK COAT)	40800050 INCIDENTAL HMA SURFACE	48102100 AGG Wedge SHL Type B
STA	RT/LT	REMARKS	FOOT	FOOT	FOOT	FOOT	FOOT	FOOT			SQ YD	SQ YD	SQ FT	SQ YD	POUND	TON	TON
								WHI	TESIDE COUNTY	(URBAN)		•		•			
483+01	LT	Bump Out								-	-	-	496.2	55.1	24.8	7.7	-
484+14	LT	PE MB	40.0	33.6	11.7	11.1	12.3	10.9	77.3	8.6	44.0	52.6	389	43.3	19.5	6.1	1.0
486+20	LT	PE MB	40.0	36.1	12.0	15.2	12.0	15.2	166.7	18.5	54.4	72.9	492	54.7	24.6	7.7	1.1
489+35	RT	PE	40.0	34.7	15.7	9.6	8.3	9.6		-	47.4	47.4	430	47.8	21.5	6.7	1.1
489+79	LT	PE MB	40.0	24.1	10.5	9.3	13.5	9.3	130.5	14.5	33.4	47.9	313	34.8	15.7	4.9	0.7
490+62	LT	PE	40.0	29.7	13.2	11.9	10.8	11.9		-	44.7	44.7	402	44.7	20.1	6.3	0.9
495+27	LT	CE	40.0	63.3	13.8	29.7	10.2	21.6		-	100.2	100.2	847	94.1	42.3	13.2	2.0
496+21	RT	PE MB	40.0	36.3	17.7	10.7	6.3	10.7	457.6	50.8	53.7	104.6	452	50.2	22.6	7.0	1.1
497+08	LT	CE MB	40.0	59.1	15.6	26.9	8.4	26.9	146.2	16.2	99.7	115.9	851	94.6	42.6	13.2	1.8
497+40	RT	PE	40.0	41.8	16.9	13.8	7.1	13.3		-	62.9	62.9	566	62.9	28.3	8.8	1.3
499+42	RT	PE MB	40.0	45.7	17.9	18.7	6.1	17.3	214.9	23.9	76.2	100.1	666	74.0	33.3	10.4	1.4
504+93	LT	PE MB	40.0	45.8	14.5	16.3	9.5	15.6	197.9	22.0	67.0	89.0	564	62.7	28.2	8.8	1.4
506+77	LT	CE	40.0	54.3	15.2	23.7	8.8	23.7		-	89.0	89.0	734	81.6	36.7	11.4	1.7
512+09	RT	PE MB	40.0	40.2	16.8	14.7	7.2	14.7	263.4	29.3	62.9	92.2	529	58.8	26.5	8.2	1.2
516+23	LT	CE	40.0	76.1	18.3	32.9	5.7	27.4		-	129.9	129.9	1,213	134.8	60.7	18.9	2.4
518+23	LT	PE	40.0	45.6	17.6	16.3	6.4	13.6	249.5	27.7	71.1	98.8	620	68.9	31.0	9.7	1.4
523+92	RT	PE	40.0	45.8	15.7	15.1	8.3	15.1		-	67.0	67.0	553	61.4	27.6	8.6	1.4
524+41	LT	МВ							651.6	72.4	-	72.4	652	72.4	32.6	10.1	-
537+08	RT	CE	40.0	59.8	14.8	30.0	9.2	30.0		-	104.6	104.6	871	96.8	43.6	13.6	1.9
542+20	RT	PE	40.0	39.7	17.7	11.8	6.3	11.8		-	58.9	58.9	504	56.0	25.2	7.8	1.2
543+08	LT	МВ							371.9	41.3	-	41.3	372	41.3	18.6	5.8	-
544+94	RT	PE	40.0	42.2	11.0	13.0	13.0	13.0		-	52.4	52.4	471	52.3	23.6	7.3	1.3
546+11	RT	PE	40.0	37.8	11.3	16.2	12.7	16.1	<u> </u>		56.7	56.7	509	56.5	25.4	7.9	1.2
547+14	RT	PE	40.0	50.7	12.9	24.5	11.1	24.3		-	84.0	84.0	733	81.5	36.7	11.4	1.6
547+81	LT	PE MB	40.0	46.1	12.7	21.6	11.3	21.3	276.2	30.7	74.7	105.4	681	75.6	34.0	10.6	1.4
548+91	RT	PE	39.6	38.6	13.5	13.0	10.5	13.2		-	54.1	54.1	438	48.7	21.9	6.8	1.2
549+24	LT	MB							392.5	43.6	-	43.6	393	43.6	19.6	6.1	-
550+36	LT	MB							532.0	59.1	-	59.1	532	59.1	26.6	8.3	-
550+44	RT	PE	40.0	48.8	16.6	14.1	7.4	14.1		-	69.7	69.7	556	61.7	27.8	8.6	1.5

USER NAME = Cristian.Rosas	DESIGNED -	REVISED -							F.A.P. RTE	SECTION	COUNTY	TOTAL SHEET SHEETS NO.
	DRAWN -	REVISED -	STATE OF ILLINOIS				NCE SCHEDULE		646	(101, 102, 135)RS	WHITESIDE	179 37
PLOT SCALE = 100.0000 / in.	CHECKED -	REVISED -	DEPARTMENT OF TRANSPORTATION								CONTRACT	NO 64P41
PLOT DATE = 10/12/2023	DATE -	REVISED -		SCALE:	SHEET	OF	SHEETS STA.	TO STA.		ILLINOIS FED.	AID PROJECT	

							E	NTRA	NCE SO	CHEDU	JLE						
				WIDTH	SHDLR		THROAT		MB Turnout	MB			Surface	Surface	40600290 BIT	40800050 INCIDENTAL	48102100 AGG
L	ΟΟΑΤΙΟ	ON	CL TO ROW	AT	то	THROAT WIDTH	то	TERMINI WIDTH	or Additional	Turnout AREA	AREA	Total Area	Area	Area	МАТ	НМА	Wedge SHLD
			NOW	SHDLR	THROAT	WIDTH	TERMINI	WIDTH	Area	(SQYD)		Area			(TACK COAT)	SURFACE	Туре В
STA	RT/L	T REMARKS	FOOT	FOOT	FOOT	FOOT	FOOT	FOOT			SQ YD	SQ YD	SQ FT	SQ YD	POUND	TON	TON
								WHI	TESIDE COUNTY	(URBAN)							
551+83	LT	CE	40.0	42.4	15.1	15.4	8.9	14.2		-	63.2	63.2	531	59.0	26.6	8.3	1.3
554+52	LT	PE	40.0	36.0	17.0	12.4	7.0	10.0		-	54.4	54.4	466	51.8	23.3	7.2	1.1
555+28	LT	PE MB	40.0	31.3	17.0	11.0	7.0	10.1	339.0	37.7	48.2	85.8	413	45.8	20.6	6.4	1.0
556+54	LT	PE MB	40.0	42.2	18.1	15.3	5.9	13.7	290.9	32.3	67.4	99.7	568	63.1	28.4	8.8	1.3
557+74	LT	PE MB	40.0	38.8	14.1	19.5	9.9	17.9	416.0	46.2	66.2	112.4	609	67.6	30.4	9.5	1.2
559+03	LT	PE MB	49.5	46.4	14.9	20.2	18.6	20.2	231.3	25.7	97.0	122.7	844	93.8	42.2	13.1	1.4
562+18	LT	PE MB	49.5	43.9	11.4	20.9	22.1	20.9	231.1	25.7	92.6	118.3	857	95.2	42.8	13.3	1.4
562+86	LT	PE MB	49.5	45.5	13.7	22.3	19.8	22.3	17.9	2.0	100.7	102.7	866	96.2	43.3	13.5	1.4
565+68	LT	PE MB	49.5	36.7	19.1	15.2	14.4	15.2	127.7	14.2	79.5	93.7	664	73.8	33.2	10.3	1.1
566+55	RT	PE	40.0	45.8	12.9	23.7	11.1	16.3		-	74.6	74.6	649	72.1	32.5	10.1	1.4
567+44	LT	MB							717.7	79.7	-	79.7	718	79.7	35.9	11.2	-
570+51	RT	PE	40.0	42.4	13.1	16.7	10.8	14.5		-	61.8	61.8	511	56.7	25.5	7.9	1.3
570+86	LT	PE MB	40.0	40.4	17.5	14.6	6.5	11.9	401.9	44.7	63.0	107.7	530	58.9	26.5	8.2	1.3
579+96	LT	PE MB	40.0	36.8	12.8	18.4	11.0	14.7	161.3	17.9	59.3	77.2	533	59.3	26.7	8.3	1.1
583+53	LT	PE MB	39.9	37.3	14.4	17.6	9.6	12.7	473.1	52.6	59.9	112.4	541	60.1	27.1	8.4	1.2
584+33	LT	PE MB	60.0	31.8	14.1	21.1	10.1	14.8	481.4	53.5	61.5	115.0	595	66.1	29.7	9.3	1.0
														TOTAL	3,475.8	1,081.4	133.6
											COUNTY (RU				271.1	84.3	10.4
											E COUNTY (1,868.4	581.3	71.3
										WHITESID	E COUNTY (URBAN)			1,336.2	415.7	51.9

USER NAME = Cristian.Rosas	DESIGNED -	REVISED -								F.A.P. RTE	SECTION	COUNTY TOTAL SHEETS	SHEET NO.
	DRAWN -	REVISED -	STATE OF ILLINOIS			ENTRA	NCE SCH			646	(101, 102, 135)RS	WHITESIDE 179	38
PLOT SCALE = 100.0000 / in	CHECKED -	REVISED -	DEPARTMENT OF TRANSPORTATION									CONTRACT NO. 64	4P41
PLOT DATE = 10/12/2023	DATE -	REVISED -		SCALE:	SHEET	OF	SHEETS	STA.	TO STA.		ILLINOIS FE	D. AID PROJECT	

) SCH		• •			40600290	40800050	48102100
	LOCATI	ON	CENTERL INE TO	WIDTH AT	SHOULDER	THROAT	THROAT TO		AREA	Total	Surface Area	Surface Area	BIT	INCIDENTAL HMA	AGG Wedge SHL
			ROW	SHOULDER	TO THROAT	WIDTH	TERMINI	WIDTH		Area			(TACK COAT)	SURFACE	Туре В
STA	RT/LT	REMARKS	FOOT	FOOT	FOOT	FOOT	FOOT	FOOT	SQ YD	SQ YD	SQ FT	SQ YD	POUND	TON	TON
				•	·		BUREAU C	OUNTY (RURA				•	·	•	·
213+24	RT	2875 N Ave.	59.2	69.1	20.7	32.6	22.5	21.5	184.6	184.6	1,860	206.6	93.0	28.9	2.1
213+26	LT	2875 N Ave.	61.7	76.2	29.2	29.8	16.6	27.1	224.0	224.0	2,146	238.4	107.3	33.4	2.4
283+04	LT	3000 N Ave.	61.1	106.9	30.6	30.0	17.8	22.0	284.3	284.3	2,272	252.5	113.6	35.3	3.3
282+80	RT	Osage Rd.	72.8	107.8	39.6	24.8	17.2	21.4	335.9	335.9	2,481	275.6	124.0	38.6	3.3
			- F		1		WHITESIDE	COUNTY (RU	RAL)	1	1	1	1	1	. <u></u>
53+17	LT	Hurd Rd.	70.9	80.3	35.5	22.2	19.4	20.0	247.6	247.6	2,248	249.8	112.4	35.0	2.5
81+12	RT	Deer Rd.	40.2	37.5	16.7	20.8	4.0	19.9	63.4	63.4	852	94.7	42.6	13.3	1.2
82+05	LT	Arrow Rd.	39.9	66.8	9.0	44.7	14.9	31.0	118.3	118.3	1,338	148.7	66.9	20.8	2.1
34+52	LT	llub St.	39.9	63.6	11.1	48.7	12.8	49.8	139.5	139.5	1,494	166.0	74.7	23.2	2.0
58+73	LT	Hahnaman Rd.	66.4	73.6	27.7	24.9	22.6	22.4	210.9	210.9	1,984	220.5	99.2	30.9	2.3
58+74	RT	Hahnaman Rd.	44.4	87.1	16.4	39.8	11.7	24.2	157.2	157.2	1,713	190.4	85.7	26.7	2.7
77+17	RT	∩eer Valley Dr.	86.8	106.8	53.4	21.8	17.6	20.6	422.7	422.7	3,347	371.9	167.4	52.1	3.3
237+71	LT	Yates Rd.	48.8	56.7	25.9	18.9	6.9	30.7	127.6	127.6	1,216	135.1	60.8	18.9	1.8
237+72	RT	Yates Rd.	44.6	59.9	22.6	22.1	6.1	29.2	120.4	120.4	1,213	134.8	60.7	18.9	1.9
90+43	LT	Bell Rd.	56.0	61.2	21.3	24.9	18.7	18.0	146.5	146.5	1,502	166.8	75.1	23.4	1.9
290+45	RT	Bell Rd.	53.5	63.4	25.6	22.3	11.9	18.7	148.8	148.8	1,474	163.8	73.7	22.9	2.0
868+75	LT	IL 172	114.5	202.9	69.9	45.3	28.4	36.4	1,092.1	1,092.1	8,920	991.1	446.0	138.7	6.3
868+70	RT	Star Rd.	39.9	49.4	11.2	29.7	7.4	22.6	70.9	70.9	944	104.9	47.2	14.7	1.5
147+74	RT	Plautz Rd.	49.8	78.9	23.2	37.0	10.7	30.0	188.9	188.9	1,938	215.3	96.9	30.1	2.4
459+61	LT	Knob Hill Ct.	40.0	64.1	12.9	37.6	11.1	29.7	114.4	114.4	1,286	142.9	64.3	20.0	2.0
464+74	RT	Blue Heron Dr.	47.4	69.6	23.9	26.8	7.6	22.0	148.2	148.2	1,527	169.7	76.4	23.8	2.2
1/2+43	RT	Mechling Ln.	49.8	27.1	27.1	23.3	6.6	21.1	92.4	92.4	1,458	162.0	/2.9	22.7	0.8
		_				1	WHITESIDE	COUNTY (UR	BAN)	.					
474+03	LT	Gaulrapp Rd.	46.3	67.8	19.5	32.3	10.8	27.2	144.0	144.0	1,519	168.8	76.0	23.6	2.1
486+95	RT	Grennan Rd.	43.0	64.3	17.9	32.2	9.1	25.2	125.1	125.1	1,357	150.8	67.9	21.1	2.0
529+13	RT	Buena Vista Dr.	34.6	58.3	15.5	32.4	3.1	31.0	89.2	89.2	1,026	114.0	51.3	16.0	1.8
40+85	LT	Knief Rd.	60.6	70.6	35.3	21.0	10.3	18.1	201.9	201.9	1,841	204.5	92.0	28.6	2.2
540+94	RT	Knief Rd.	49.8	67.8	26.5	27.7	7.3	26.5	162.5	162.5	1,637	181.9	81.8	25.5	2.1
544+74	LT	Bertha Rd.	60.1	60.5	26.3	21.2	17.8	17.8	157.8	157.8	1,525	169.4	76.2	23.7	1.9
533+26	LT	W.Thome Rd.	51.8	74.4	21.0	34.2	14.8	25.0	175.5	175.5	1,814	201.5	90.7	28.2	2.3
533+31	RT	E.Thome Rd.	57.6	73.2	27.8	27.0	13.8	24.7	194.3	194.3	1,921	213.5	96.1	29.9	2.3
568.33	RT	Summerdale Rd.	38.3	49.1	21.4	26.2	0.9	26.2	92.1	92.1	970	107.8	48.5	15.1	1.5
574+07	RT	Airport Rd.	58.7	59.1	27.2	27.8	15.6	22.0	174.5	174.5	1,692	188.0	84.6	26.3	1.8
593+77	LT	Duden Rd.	79.3	50.2	15.1	20.0	35.7	20.0	138.1	138.1	1,513	168.2	75.7	23.5	1.6
593+97	RT	Duden Rd.	80.2	112.5	33.8	36.4	23.5	24.1	358.2	358.2	3,579	397.7	179.0	55.7	3.5
												TOTAL	3,180.5	989.5	74.9
										U COUNTY (437.9	136.2	11.2
										IDE COUNTY			1,722.7	536.0	38.7
		_						_	WHITES	IDE COUNTY	(URBAN)		1,019.8	317.3	25.0
USER NAM	4E = Cristian.Rosas	DESIGNED -		REVISED -	I									F A P RTE	SECTION
		DBAWN -		REVISED -						1				RTF. I	3201.014

DRAWN -

CHECKED -

DATE -

PLOT SCALE = 100.0000 / in.

PLOT DATE = Oct-12-2023 02:49:56 PM

REVISED -								F.A.P. BTE	SECTION	COUNTY	TOTAL	SHEET
REVISED -	STATE OF ILLINOIS			SIDERO	AD SCH	EDULE		646	(101, 102, 135)RS	WHITESIDE	179	39
REVISED -	DEPARTMENT OF TRANSPORTATION									CONTRAC	T NO. 64	4P41
REVISED -		SCALE:	SHEET	OF	SHEETS	STA.	TO STA.		ILLINOIS FED. A	ID PROJECT		

										SIGN	SCHEDU	LE					
Mile	County	Side	Commoin Name	e of Sign	Sign Code	Sizc Hor (in)	Size Ver (in)	72000100 SIGN PANEL TYPE 1 (SQ FT)	72000200 SIGN PANEL TYPE 2 (SQ FT)	72400710 RELOCATE SIGN PANEL TYPE I (SQ FT)	72400720 RELOCATE SIGN PANEL TYPE 2 (SQ FT)	72400310 REMOVE SIGN PANEL Type 1 (SQ FT)	72400320 REMOVE SIGN PANEL TYPE 2 (SQ FT)	72800100 TELESCOPING STEEL SIGN SUPPORT (FOOT) (2 in)	72800100 TELESCOPING STEEL SIGN SUPPORT (FOOT) (2 1/4 in)	73000100 WOOD SIGN SUPPORT (FOOT)	Notes
22.76	Bureau	R	Nort		M3 - 1	24	12	2.00				2.00					
-			IL 4 No Parking		M1 - 1100 R8 - 3	24 24	24 24	4.00				4.00					
22.79	Bureau	L	< WA MOLINE		D1 - 2	60	30						12.50				
22.80	Bureau	L	< WA MOLINE		D1 - 2	60	30		12.50							26.0	375 feet north of IL 92 CL
22.80	Bureau	R	Speed Lir		R2-1 (55)	30	36	7.50								14.0	375 feet north of IL 92 CL
22.82	Bureau	R	ROCK FALL STERLING		D2 - 2	60	30						12.50				
22.84	Bureau	R	ROCK FALL STERLING		D2 - 2	60	30		12.50							26.0	600 feet north of 1L 92 CL
22.84	Bureau		JCT		M2 - 1		15	2.20								15.0	600 feet north of IL 92 CL
	Juicau		Illinoi		M1 - 1100	21	24	4.00									
22.86	Bureau	L	JCT		M2 - 1 M1 - 1100	30 36	21 36					4.40					
22.89	Bureau	R	 Cross Road Inte			36	36	9.00						_			820 feet north of 1L 92 CL
			2875 STOP A	ōΝ	<u>W17-1100</u> W3-1	30 36	9 36	1.90									
22.89	Bureau	L	STOP A		W3-1	36	36	9.00								16.0	820 feet north of IL 92 CL
22.90	Bureau	L	STOP A		W3-1	36	36					9.00					
22.90	Bureau				R1-1	36	36	9.00				6.25		9.0	5.0		At 2875 N
22.98	Bureau	R			R1-1	36	36	9.00				6.25		9.0	5.0		AL 2875 N
23.00	Bureau	R	Speed Lie		R2-1 (55)	30	36	5.00				7.50		9.0	5.0		AC 4973 h
	Juredu	. н		rker 23	N1 - 1200 N1 - 1200	18	18	2.30				2.30		3.0			
23.07	Bureau		Cross Road Inte		W2 - 1	36	36	9.00				2.30				16.0	500 feet north of 2875 N
	Juiedu		2875		<u>W17-1100</u>	30	9	1.90						_			
24.00	Bureau	R	LEFT REVER		W1 - 4L N1 - 1200	36 18	36 18	2.30				9.00		9.0	5.0		
			Mile Mar		M1 - 1200	18	18	2.30				2.30		3.0	5.0		
24.05	Bureau	R	LEFT REVER	SE CURVE	W1-4L	36	36	9.00								16.0	500 feet south cf Weave
24.09	Bureau	L	NO PASSIN	NG ZONE	W14-3	64	48		10.70							16.0	
24.30	Bureau	L	STO	ιP	R 1 - 1	36	36	9.00				6.25		9.0	5.0		3000N
24.30	Bureau	R	STO	ıP	R1-1	36	36	9.00				6.25					3000N
24.31	Bureau	L	Bureau C	County	11-1104	48	30		10.00				10.00	18.0	10.0		
0.00	Whiteside	R	Whiteside	County	11-1104	48	30		10.00				10.00				
0.01	Whiteside	R	NO PASSIN	NG ZONE	W14-3	64	48		10.70				10.70			15.0	
0.39	Whiteside	1	IFFT REVER	SE CURVE	w1-41	36	36	9.00								16.0	500 feet north of Weave
0.41	Whiteside	L	LEFT REVER	SE CURVE	W1-4L	36	36					9.00					
0.54	Whiteside	R	NO PASSIN	NG ZONE	W14-3	64	48		10.70				10.70			15.0	
0.86	Whiteside	R	NO PASSIN	NG ZONE		64	48		10.67				10.67			15.0	
1.00	Whiteside	R	Mile Mar		N1 - 1200	18	18	2.30				2.30					
			Mile Mar	'ker l	N1-I200	18	18	2.30			1	2.30					
		USER NAME = Cris	itian.Rosas	DESIGNED - DRAWN -		REVISED REVISED	-			STATE O	F ILLINOIS			SIGN S	CHEDULE		F.A.P. RTE. SECTION COUNTY 646 (101, 102, 135)RS WHITESIDE
	E E	PLOT SCALE = 100	0.0000 / in.	CHECKED -		REVISED			DED	ARTMENT OF							646 (101, 102, 135)RS WHITESIDE CONTRACT

									SCHEDU						
lile County	Side	Common Name of Sign	Sign Code	Size Hor (in)	Size Ver (in)	72000100 SIGN PANEL TYPE 1 (SQ FT)	72000200 SIGN PANEL TYPE 2 (SQ FT)	72400710 RELOCATE SIGN PANEL TYPE I (SQ FT)	72400720 RELOCATE SIGN PANEL TYPE 2 (SQ FT)	72400310 REMOVE SIGN PANEL Type 1 (SQ FT)	72400320 REMOVE SIGN PANEL TYPE 2 (SQ FT)	72800100 TELESCOPING STEEL SIGN SUPPORT (FOOT) (2 in)	72800100 TELESCOPING STEEL SIGN SUPPORT (FOOT) (2 1/4 in)	73000100 WOOD SIGN SUPPORT (FOOT)	Notes
.20 Whiteside	L	IL 92 3 PEORIA 67	D2 - 2	48	30						10.00				
.32 Whiteside	L	Speed Limit 55	R2-1(55)	30	36						7.50				40/55 split moves 1070' north
1.42 Whiteside	R	Speed Zone Ahead 40		36	36			9.00						16.0	Relocate 1100 foot north from 1.2
		IL 92 3													
1.42 Whiteside	L	PEORIA 67	D2 - 2	48	30		10.00					19.0	10.0		
1.52 Whiteside	L	Speed Limit 55	R2-1(55)	30	36			7.50						14.0	
1.52 Whiteside	R	Deer Grove 50 Speed Limit 40	11-1100 R2-1	48	30 36			7.50	10.00					17.0	Relocate 1070' north, by Adopt a Hu
1.54 Whiteside	R		- R1-1	36	36	<u> </u>		_		6.25		_		_	Deer Rd
1.63 Whiteside	R	Speed Limit 40	R2-1(40)	30	36					7.50					150 feet north of Hub St
1.64 Whiteside	L	Speed Limit 40	R2-1(40)	30	36					7.50					
		NU_IRUCK PARKING HERE TO CORNER	кърс	24	30	5.00				5.00					
1.82 Whiteside	R	Speed Limit 55	R2-1(55)	30	36	7.50								14.0	41.61109, -89.68933
1.82 Whiteside	R	Deer Grove 50	11-1100	48	30			7.50	10.00					17.0	41.61109, -89.68954
		Speed Limit 40	R2-1	30	36			7.50							Move 40/55 split 400 feet south
1.92 Whiteside	R	ROCK FALLS 12 STERLING 13	D2 - 2	60	30		12.50					22.0	10.0		
1.92 Whiteside	L	Speed Zone Ahead 40	₩3-5(40)	36	36	9.00								16.0	
2.00 Whiteside	R	ROCK FALLS 12 STERLING 13	D2 - 2	60	30						12.50	9.0	5.0		
2.00 Wintestue		Mile Marker 2 Mile Marker 2	M1 - 1200 M1 - 1200	18	18	2.30				2.30	12.30	3.9	5.0		
2.02	L	Speed Zone Ahead 40	W3-5(40)	36	36					9.00					
2.03 Whiteside						9.00									
2.95 Whiteside	L	South IL 40	M3 - 3 (WH) M1 - 1100	24 24	12 24					2.00					
3.00 Whiteside	L	South	M3-3(WH)	24	12	2.00								14.0	Move 100 feet south of Int.
		IL 40	M1 - I 100	24	24	4.00									
3.00 Whiteside	R	Mile Marker 3 Mile Marker 3	M1 - 1200 M1 - 1200	18 18	18	2.30 2.30				2.30					
3.01 Whiteside	R	STOP	R1-1	36	36	9.00				9.00					Hahnaman Rd - east leg
3.04 Whiteside	R	North	N3-1 (WII)	24	12	2.00				2.00					
		11 40	M1 - 1100	24	24	4.00				4.00					
3.07 Whiteside	L	Tampico 5>	D1 - 1A	60	18	7.50					18.00	10.0			300 feet north of the intersection
3.10 Whiteside	1	Tampico 5>	D1 - 1A	60	18					7.50					
3.12 Whiteside	L	Cross Road Intersection	W2 - 1	36	36	9.00								17.0	600 feet north of the intersection
		Hannaman Rd	W17-1100	36	9	2.30								_	
3.17 Whiteside	L	Cross Road Intersection Hannaman Road	W2-1 W17-1100	36 36	36 15					9.003.80					
4.00 Whiteside	R	Mile Marker 4	M1 - 1200	18	18	2.30				2.30					
		Mile Marker 4	M1 - 1200	18	18	2.30				2.30					
4.52 Whiteside	L	STOP	R1-1	36	36	9.00				6.25					 Yates Rd - West leg
5.00 Whiteside	R	Mile Marker 5	M1-1200	18	18	2.30				2.30					

		SIGN	SCHE
SCALE:	SHEET	OF	SHEETS

	F A P RTE	SECT	rion		COUNTY	TOTAL SHEETS	SHEET NO.
JLE	646	(101, 102	, 135)R	5	WHITESIDE	179	41
	_				CONTRACT	NO. 64	4P41
STA. TO STA.			ILLINOIS	FED. A	ID PROJECT		

Mile	County	Side	Common Name of Sign	Sign Code	Size Hor (in)	Size Ver (in)	72000100 SIGN PANEL TYPE 1 (SQ FT)	72000200 SIGN PANEL TYPE 2 (SQ FT)	72400710 RELOCATE SIGN PANEL TYPE I (SQ FT)	72400720 RELOCATE SIGN PANEL TYPE 2 (SQ FT)	72400310 REMOVE SIGN PANEL Type 1 (SQ FT)	72400320 REMOVE SIGN PANEL TYPE 2 (SQ FT)	72800100 TELESCOPING STEEL SIGN SUPPORT (FOOT) (2 in)	. TE (F
	Whiteside	R	Mile Marker 6 Mile Marker 6	M1 - I 200 M1 - I 200	18 18	18	2.30				2.30			
_					10	10	2.30				2.50			
6.83	Whiteside	R	JCT IL 172	M3-3 (WII) M1-1100	21 30	15 24					2.20			+
						24					5.00			
6.84	Whiteside	L	Deer Grove 5 Peoria 73	D1 - 2	60	30				12.50			19.0	-
6.87	Whiteside	R	JCT	M3-3 (WH) M1-1100	21 30	15 24	2.20							+
6.89	Whiteside	L	Speed Limit 55 < TAMPICO	<u>R2_1(55)</u>	30	36	7.50							
6.91	Whiteside	R	<prophetstown< td=""><td>D1 - 2</td><td>72</td><td>30</td><td></td><td></td><td></td><td>15.00</td><td></td><td></td><td>19.0</td><td></td></prophetstown<>	D1 - 2	72	30				15.00			19.0	
6.96	Whiteside	R	1L 172 1L 40	M1-1100 M1-1100	30 24	24	5.00				5.00			–
			Left Arrow	M1-1100 M6-11 (WH)	24	15	2.19				2_19			-
			Straight up arrow	M5-3(WH)	21	15	2.19				2.19			
6.97	Whiteside	L	STOP	R - 1	36	36	9.00				9.00			
6.98	Whiteside	L	IL 172	N1 - I 100	30	2.4	5.00				5.00			+
6.90	whiteside	L.	1L 40	M1-1100	24	24	4.00				4.00			
				M6-1R (WH) M5-3(WH)	21	15 15	2.19				2.19			-
				(M) - J ((((1)))	21	15	2.15				2.15			
7.02	Whiteside	L	TAMPICO> PROPHETSTOWN>	D1 - 2	72	30						15.00		-
7.02	Whiteside	R	ROCK FALLS 6 STERLING 7	D2 - 2	60	30						12.50		\vdash
7.04	Whiteside	L	TAMPICO> PROPHETSTOWN>	D1 - 2	72	30		15.00					19.0	
7.05	Whiteside	R	Speed Limit 55	R2-1(55)	30	36	7.50							1
7.06	Whiteside	L	Birthplace of President> Ronald Reagn	DSPC (BR)	72	36						18.00		
7.07	Whiteside	L	Birthplace of President> Ronald Reagn	DEPC (BR)	72	36		18.00					21.0	Ē
7.11	Whiteside	L	JCT	M3-3 (WH)	21	15	2.20				2.20			
			IL 172	M1-1100	30	24	5.00				5.00			
7.11	Whiteside	R	ROCK FALLS 6 STERLING 7	D2 - 2	60	30		12.50					19.0	
8.00	Whiteside	R	Mile Marker 8 Mile Marker 8	<u>M1 - I 200</u> M1 - I 200	18	18	2.30				2.30		9.0	
														_
8.23	Whiteside	L	Adopt A Highway K of C Council 11874	11-1107A 11-1107B	30	36	7.50				7.50			
8.35	Whiteside	R	Right side Road Intersection	W2 - 2R	36	36					9.00			-
			Plautz Rd	<u>W</u> 17-1100	36	9					2.30			-
8.39	Whiteside	R	Right side Road Intersection	W2 - 2R	36	36	9.00							-
			Plautz Rd	W17-1100	36	9	2.30							+
8.59	Whiteside	L	Left side Road Intersection	W2 - 2L	36	36	9.00							-
			Plautz Rd	w17-1100	36	9	2.30							+
8.63	Whiteside	L	Left side Road Intersection	W2-2L	36	36					9.00			_
			Plautz Rd	<u>w</u> 17-1100	36	9	<u> </u>		<u> </u>		2.30			+
8.72	Whiteside	L		R1-1	36	36	9.00				6.30			

USER NAME = Cristian.Rosas	DESIGNED -	REVISED -					
	DRAWN -	REVISED -	STATE OF ILLINOIS	1		SIGN	SCHED
PLOT SCALE = 100.0000 / in.	CHECKED -	REVISED -	DEPARTMENT OF TRANSPORTATION	1			
PLOT DATE = 8/24/2023	DATE -	REVISED -		SCALE:	SHEET	OF	SHEETS

00	73000100	72800100
IGN RT Notes	WOOD SIGN SUPPORT (FOOT)	SCOPING STEEL GN SUPPORT Γ) (2 1/4 in)
	(FOOT)	(2 1/4 111)
Relocate to 700' south of inte		10.0
Move to 500' south of inters	14.0	
400' south of the intersec	14.0	
Relocate to 300' south of inte		10.0
At IL 172 - west leg isla		
350' feet north of intersed		10.0
425' north of the intersec	14.0	
		10.0
550' north of intersecti		10.0
725' north of intersecti		10.0
		5.0
500 feet south of the inters	17.0	
500 feet North of the inters	17.0	
Knob Hill Ct		

			F A P RTE	SEC	ΓΙΟΝ		COUNTY	TOTAL SHEETS	SHEET NO.
ED	ULE		646	(101, 102	2, 135)R	5	WHITESIDE	179	42
							CONTRACT	NO. 64	4P41
TS	STA.	TO STA.			ILLINOIS	FED. A	D PROJECT		

										SCHEDU				
Mile	County	Side	Conmon Name of Sign	Sign Code	Size Hor (in)	Sizc Ver (in)	72C00100 SIGN PANEL TYPE 1 (SQ FT)	72000200 SIGN PANEL TYPE 2 (SQ FT)	72400710 RELOCATE SIGN PANEL TYPE I (SQ FT)	72400720 RELOCATE SIGN PANEL TYPE 2 (SQ FT)	72400310 REMOVE SIGN PANEL Type 1 (SQ FT)	72400320 REMOVE SIGN PANEL TYPE 2 (SQ FT)	72800100 TELESCOPING STEE SIGN SUPPORT (FOOT) (2 in)	EL TE
8.81	Whiteside	R	STOP	R1-1	36	36	9.00				6.30			—
8.93	Whiteside	L	STOP		36	36	9.00				6.30			
8.97	Whiteside	R	45 mph Speed Zone Ahead	WSPC	36	36					9.00			
			School Entrance	WSPC	36	18					4.50			
9.00	Whiteside	R	Mile Marker 9	M1 - 1200	18	18	2.30				2.30		9.0	
			Mile Marker 9	M1 - I 200	18	18	2.30				2.30			_
9.12	Whiteside	L	Speed Limit 55	R2-1	30	36					7.50			-
9.12	Whiteside	R	School Entrance Speed Limit 45	WSPC R 2 - 1	30 30	18 36					3.75			_
_			When Flashing	WSPC	24	18					3.00			
9.17	Whiteside	R	School Speed Zone 45 Ahead	S4 - 5 (45)	36	36	9.00							<u> </u>
9.21	Whiteside	R	STOP	R1-1	36	36	9.00				6.30			
9.28	Whiteside	R	School Entrance	WSPC	30	18					3.75			_
9.20	WIIItestue	K	Speed Limit 45	R2-1	30	36					7.50			
			When Flashing	WSPC	24	18					3.00			
			School Speed Limit 45	S4-3P R2-1(45)	36 36	12 48	3.00	12.00						_
			When Flashing		36	18	4.50	12.00						_
9.28	Whiteside	L	Speed Limit 55 End School Zone	R2 - 1 (55)	30 24	36 30	7.50							
9.32	Whiteside	R	School Symbol sign	S1-1	36	36	9.00				9.00			
9.50	Whiteside	L	School Symbol sign	S1-1	36	36	9.00				9.00			_
9.53	Whiteside	L	School Entrance	WSPC	30	18					3.75			_
			Speed Limit 45	R 2 - 1	30	36					7.50			_
_			When Flashing School		24 36	18	3.00				3.00			-
			Speed Limit 45	R2-1(45)	36	48		12.00						
			When Flashing	S4-4P	36	18	4.50							
9.53	Whiteside	R	Speed Limit 55	R2-1(55)	30	36	7.50							
			End School Zone	55-2	24	30	5.00							
9.64	Whiteside	L	School Speed Zone 45 Ahead	<u> </u>	36	36	9.00							
9.75	Whiteside	L	School Entrance	WSPC	30	18					3.75			
9.75	whiteside	L	Speed Limit 45	R2-1	30	36					7.50			
_			When Flashing	WSPC	24	18					3.00			
														_
9.87	Whiteside	L	45 mph Speed Zone Ahead School Entrance	WSPC WSPC	36 36	36					9.00 4.50			+
10.00	Whiteside	R	STOP	R1-1	36	36	9.00				6.30			
10.00	Whiteside	R	Mile Marker 10	M1 - 1200	18	18	2.30				2.30			
	wint cestrac		Mile Marker 10	M1 - 1200	18	18	2.30				2.30			_
10.21	Whiteside	L	Leaving	D13-1102	30	9					1.90			
			Water Supply Protection Area	D13-1100	30	30	6.30				6.30			—
10 21	Whiteside	R	Water Supply Protection Area	D13-1100	30	30	6.30				1.90			+
10.21	whiteside	ĸ	Report Spills	D13-1100	30	9	1.90				6.30			
10.33	Whitestals	P			26	26	0.00				6.20			
10.22		R	STOP	R1-1	36	36	9.00				6.30			+
10_30	Whiteside	1	STOP	R 1 - 1	36	36	9.00				6 30			\pm
10.36	Whiteside	R	Cross Road Intersection	W2 - 1	36	36	9.00				9.00			+
			Thome Rd	W17-1100	36	9	2.30				2.30			

USER NAME = Cristian.Rosas	DESIGNED -	REVISED -					
	DRAWN -	REVISED -	STATE OF ILLINOIS			SIGN	SCHED
PLOT SCALE = 100.0000 / in	CHECKED -	REVISED -	DEPARTMENT OF TRANSPORTATION				
PLOT DATE = 8/24/2023	DATE -	REVISED -		SCALE:	SHEET	OF	SHEETS

72800100	73000100	
ESCOPING STEEL SIGN SUPPORT OT) (2 1/4 in)	WOOD SIGN SUPPORT (FOOT)	Notes
		Blue Heron Dr
		Mechling Lane
		Remove signs and post
5.0		
		Remove sign and post
		Remove signs and post
	16.0	
		Grennan Rd
	18.0	
	16.0	
	18.0	
	17.0	
	16.0	
		Remove signs and post
		Remove signs and post
		Buena Vista Dr
		Knief Rd
		Rertha Rd
	18.0	1' above sign to accommodate flasher

		COUNTY	SHEETS	NO.
DULE 646 (101, 102, 135)RS	WHITESIDE	179	43
		CONTRACT	NO. 64	4P41
S STA. TO STA. ILLINO	IS FED. A	AID PROJECT		

			DRAW	VN -	REVISED	-			STATE 0	F ILLINOIS		1	SIGN S	CHE
	U	SER NAME = Cr	istian.Rosas DESIG	GNED -	REVISED	-		1		-	4.00			<u> </u>
11.30	Whiteside	L	South IL 40	M3 - 3 (WH) M1 - 1 100	24	12	<u> </u>				2.00			+
	wirtestue	L	<pre>cross Road Intersec < Duden Rd</pre>	w17-1100	36	9	2.30							+
11.30 11.30	Whiteside	L	Merge Right Cross Road Intersec		36	36	9.00				9.00			+
11.26	Whiteside Whiteside	L	Two-Way Traffic (Syr	wbol)	36	36	9.00				9.00			+
11 26	Whiteside						0.00							+
			Straight up arro Advance right turn a		21 21	15 15					2.20			+
			I - 88 I - 88	M1 - 1 M1 - 1	24 24	24					4.00			+
			East	M3 - 2	24	12					2.00			+
11.26	Whiteside	R	West	M3 - 4	24	12					2.00			\pm
			Advance right turn a		21	15	2.20							—
			I-88 Straight up arro	M1-1 pw	24 21	24	4.00							\pm
			1 - 88	M1 - 1	24	24	4.00							—
11.25	Whiteside	R	West East	M3 - 4 M3 - 2	24 24	12	2.00							+
														+
11.22	Whiteside	L	STOP	R1-1	36	36	9.00				6.30			+-
			CKC	M4 - 1100 M11 - 100	24 24	12 24	2.00 4.00							\pm
			Jet	M2-1 (WH)	21	15	2.19							+
11.19	Whiteside	R	Jct 	<u>M</u> 2 - 1 (BL) M1 - 1	21 24	15 24	2.19 4.00							
														\mp
1.00	Whiteside	L	Speed Limit 55	R2-1	30	36	7.50							+
			СКС L 110	M4 - 1100 M11 - 100	24 24	12 24					2.00			+
1.16	Whiteside	R	Jct	M2-1 (WH)	21	15					2.19			+
			1 - 88	M1 - 1	24	24					4.00			+
11.16	Whiteside	R	Jct	M2 - 1 (BL)	21	15					2.19			+
4			Duden Rd>	<u>W17-1100</u>	36	9	2.30				2.30			+
11.12	Whiteside	R	 Cross Road Intersec	ction W2-1	36	36	9.00				9.00			+
11.08	Whiteside	R	Right side Road	W2 - 2R W17 - 1100	36 36	36					9.00			+
											0.00			+
11.05	Whiteside	R	Divided Highway	y W6-1	36	36	9.00							+
11.03	Whiteside	L	No Passing Zone	e	64	48		10.70						-
11.00	Whiteside	L	Speed Limit 55	R2 - 1	30	36					7.50			+
			Mile Marker 11	M1 - I 200	18	18	2.30				2.30			+
*.00	Whiteside	к	Mile Marker 11	M1 - 1200	18	18	2.30				2.30		9.0	+
11.00	Wb i + ' '	R	Right Reverse Cur		36	36					9.00			+
10.88	Whiteside	L	Water Supply Protection Report Spills		30 30	30 9	6.30 1.90				1.90 6.30			+
			Water Supply Protectio	on Area D13-1100	30	30	6.30				6.30			\pm
10.88	Whiteside	R	Leaving	D13-1102	30	9	1.90				1.90			+
10.80	Whiteside	R	Airport (Symbol)) 1 - 5	24	24					4.00			+
			Thome Rd	<u></u> 17 - 1100	36	9	2.30				2.30			+
10.56	Whiteside	L	Cross Road Intersec		36	36	9.00				9.00			+
10.46	Whiteside	R	STOP	R 1 - 1	36	36			9.00				9.0	\vdash
			IL 40	<u>M</u> 1 - I 100	24	24					4.00			+
0.44	Whiteside	1	South	M3-3(WH)	24	12		(3011)		(3011)	2.00	(30 11)		+
	County	Side	Common Name of S	Sign Sign Code	Hor (in)	Ver (in)	(SQ FT)	(SQ FT)	TYPE I (SQ FT)	TYPE 2 (SQ FT)	Type 1 (SQ FT)	TYPE 2 (SQ FT)	SIGN SUPPORT (FOOT) (2 in)	()
Mile					Size	Size	TYPE 1	SIGN PANEL TYPE 2	RELOCATE SIGN PANEL	RELOCATE SIGN PANEL	REMOVE SIGN PANEL	REMOVE SIGN PANEL	TELESCOPING STEEL	L TE
Mile							72000100 SIGN PANEL	72000200	72400710	72400720	72400310	72400320	72800100	+-

72800100 ELESCOPING STEEL SIGN SUPPORT FOOT) (2 1/4 in)	SUPPORT	Notes
5.0	18.0	Thome Rd 1' above sign to accommodate flash
5.0		
	16.0 	875 feet south of intersection
	17.0	move to 525' south of intersection
	14.0	225 feet south of Duden Rd
	14.0	move to 175' south <u>of intersection</u>
	15.0	At Dead End
	16.0	
	17.0	390 feet north of Duden Rd
DULE		F.A.P. RTE. SECTION COUNT 646 (101, 102, 135)RS WHITESI CONTR
S STA.	TO STA.	ILLINOIS FED. AID PROJECT

CountySideWhitesideLWhitesideLWhitesideLWhitesideMWhitesideMWhitesideRWhitesideRWhitesideLWhitesideLWhitesideLWhitesideRWhitesideLWhitesideLWhitesideLWhitesideRWhitesideLWhitesideLWhitesideLWhitesideLWhitesideLWhitesideLWhitesideRWhitesideRWhitesideRWhitesideRWhitesideRWhitesideRWhitesideRWhitesideLWhitesideRWhitesideLWhitesideM <tr< th=""><th>Merge Right Left side Road Intersection Duden Rd South Left side Road Intersection Left side Road Intersection Left side Road Intersection Duden Rd Left Lane Ends Left Lane Ends Kest Left Lane Ends Kest Left Lane Ift turn arrow East Left Lane Ift turn arrow South Left Lane Ift turn arrow Left Lane Ift turn arrow South Left Lane Ift Lane Ift turn arrow Left Lane Ift tur</th><th>Sign Code </th><th>Size Hor (in) 36 36 24 24 24 36 36 36 36 24 24 24 24 24 24 24 24 24 24 24 24 24</th><th>Size Ver (in) 36 9 12 24 36 9 12 24 36 36 12 24 12 24 15</th><th>SIGN PANEL TYPE 1 (SQ FT) 9.00 2.00 4.00 2.00 4.00 9.00</th><th>SIGN PANEL TYPE 2 (SQ FT)</th><th>RELOCATE SIGN PANEL TYPE I (SQ FT)</th><th>RELOCATE SIGN PANEL TYPE 2 (SQ FT)</th><th>REMOVE SIGN PANEL Type 1 (SQ FT) 9.00 2.30</th><th>REMOVE SIGN PANEL TYPE 2 (SQ FT)</th><th>TELESCOPING STEEL SIGN SUPPORT (FOOT) (2 in)</th><th>TELESCOPING STEEL SIGN SUPPORT (FOOT) (2 1/4 in)</th><th>WOOD SIGN SUPPORT (FOOT) 17.0</th><th>Notes 200 feet south of I-88 EB ramps</th></tr<>	Merge Right Left side Road Intersection Duden Rd South Left side Road Intersection Left side Road Intersection Left side Road Intersection Duden Rd Left Lane Ends Left Lane Ends Kest Left Lane Ends Kest Left Lane Ift turn arrow East Left Lane Ift turn arrow South Left Lane Ift turn arrow Left Lane Ift turn arrow South Left Lane Ift Lane Ift turn arrow Left Lane Ift tur	Sign Code 	Size Hor (in) 36 36 24 24 24 36 36 36 36 24 24 24 24 24 24 24 24 24 24 24 24 24	Size Ver (in) 36 9 12 24 36 9 12 24 36 36 12 24 12 24 15	SIGN PANEL TYPE 1 (SQ FT) 9.00 2.00 4.00 2.00 4.00 9.00	SIGN PANEL TYPE 2 (SQ FT)	RELOCATE SIGN PANEL TYPE I (SQ FT)	RELOCATE SIGN PANEL TYPE 2 (SQ FT)	REMOVE SIGN PANEL Type 1 (SQ FT) 9.00 2.30	REMOVE SIGN PANEL TYPE 2 (SQ FT)	TELESCOPING STEEL SIGN SUPPORT (FOOT) (2 in)	TELESCOPING STEEL SIGN SUPPORT (FOOT) (2 1/4 in)	WOOD SIGN SUPPORT (FOOT) 17.0	Notes 200 feet south of I-88 EB ramps
WhitesideLWhitesideLWhitesideMWhitesideMWhitesideRWhitesideL <tr< th=""><th>Left side Road Intersection Duden Rd South Left side Road Intersection Left side Road Intersection Duden Rd Left Lane Rd Left Lane Ends Left Lane Ends Left Lane Ends Left Lane Ends Left Lane Intersection Le</th><th>w2 - 2L w17 - 1100 M3 - 3 (WH) M1 - 1100 w2 - 2L w17 - 1100 </th><th>36 36 24 24 36 36 24 24 24 24 24 24 24 24 21 24</th><th>36 9 12 24 36 9 12 24 12 24 36 36 12 24</th><th>9.00 2.00 4.00 2.00 4.00</th><th></th><th></th><th></th><th>9.00</th><th></th><th></th><th></th><th>17.0</th><th>200 feet south of I-88 EB ramps</th></tr<>	Left side Road Intersection Duden Rd South Left side Road Intersection Left side Road Intersection Duden Rd Left Lane Rd Left Lane Ends Left Lane Ends Left Lane Ends Left Lane Ends Left Lane Intersection Le	w2 - 2L w17 - 1100 M3 - 3 (WH) M1 - 1100 w2 - 2L w17 - 1100	36 36 24 24 36 36 24 24 24 24 24 24 24 24 21 24	36 9 12 24 36 9 12 24 12 24 36 36 12 24	9.00 2.00 4.00 2.00 4.00				9.00				17.0	200 feet south of I-88 EB ramps
Image: state s	Duden Rd South IL 40 Left side Road Intersection Duden Rd Left Lane Ends Left Lane Ends Left Lane Ends Left Lane Intersection Left Lane Ends Left Lane Intersection Left Lane Ends Left La	W17 - 1100 M3 - 3 (WH) M1 - 1100 W2 - 2L W17 - 1100	36 24 24 36 36 24 24 24 24 24 24 24 24 21 24	9 12 24 36 9 12 24 36 	4.00 2.00 4.00				2.30				<u>├</u> ───┼	
Whiteside R Whiteside R Whiteside L Whiteside R Whiteside L Whiteside R Whiteside R Whiteside R Whiteside L Whiteside L Whiteside R Whiteside R Whiteside L Whiteside M	South IL 40 IL 40 ILeft side Road Intersection Duden Rd IL 40 ILeft Lane Ends ILeft Lane Ends ILeft Lane Ends ILeft Lane Ends ILeft Lane Intersect ILeft Lan	M3-3(WH) M1-1100 W2-2L W17-1100 M3-1(WH) M1-1100 M3-4(BL) M1-1 M3-4(BL) M1-1 M3-4(BL) M1-1 M3-4(BL) M3-3(WH)	24 24 36 36 24 24 24 24 24 24 24 24 21 21 24	12 24 9 12 24 36 36 12 12 24	4.00 2.00 4.00						·	l .	t	Banded to light pole
Whiteside R Whiteside R Whiteside L Whiteside R Whiteside L Whiteside R Whiteside R Whiteside R Whiteside L Whiteside L Whiteside R Whiteside R Whiteside L Whiteside M	Left side Road Intersection Duden Rd North Left Lane Ends Left Lane Ends Kest Loss Advance left turn arrow Loss Advance left turn arrow South LL 40 Left Lane Ends Loss Loss Loss Loss Loss Loss Loss Lo	w2 - 2L w17 - 1100	36 36 24 24 24 36 24 24 24 24 21 21 24	24 36 9 12 24 36 12 12 24	2.00						1		<u> </u>	Banded to light pole
Whiteside R Whiteside R Whiteside L Whiteside R Whiteside L Whiteside R Whiteside R Whiteside R Whiteside L Whiteside L Whiteside R Whiteside R Whiteside L Whiteside M	Duden Rd North IL 40 Left Lane Ends West I-88 Advance left turn arrow East I-88 Advance left turn arrow South IL 40 Keep Right (symbol)	W17-1100 M3-1(WH) M1-1100 W9-1L M3-4(BL) M1-1 M3-4(BL) M3-4(BL) M1-1 M3-4(BL) M1-1 M3-1L M5-1L M3-3(WH)	36 24 24 36 24 24 24 24 21 24	9 12 24 36 12 24	4.00								\square	
Whiteside L Whiteside R Whiteside R Whiteside L Whiteside R Whiteside R Whiteside R Whiteside L Whiteside R Whiteside L Whiteside R Whiteside L Whiteside L Whiteside L Whiteside L Whiteside L Whiteside L Whiteside M	North IL 40 Left Lane Ends West Advance left turn arrow East I-88 Advance left turn arrow East I-88 Advance left turn arrow Keep Right (symbol)	M3-1(WH) M1-1100 W9-1L M3-4(BL) M1-1 M5-1L M3-4(BL) M1-1 M5-1L M5-1L M3-3(WH)	24 24 36 24 24 24 24 21 21 24	12 24 36 12 24	4.00				9.00				<u> </u>	
Whiteside L Whiteside R Whiteside R Whiteside L Whiteside R Whiteside R Whiteside R Whiteside L Whiteside R Whiteside L Whiteside R Whiteside L Whiteside L Whiteside L Whiteside L Whiteside L Whiteside L Whiteside M	IL 40 Left Lane Ends West I-88 Advance left turn arrow East I-88 Advance left turn arrow South IL 40 Keep Right (symbol)	M1-1100 W9-1L M3-4(BL) M1-1 M5-1L M1-1 M5-1L M3-3(WH)	24 36 24 24 21 24 24	24 36 12 24	4.00				2.30		-			
Whiteside L Whiteside R Whiteside R Whiteside L Whiteside R Whiteside R Whiteside R Whiteside L Whiteside R Whiteside L Whiteside R Whiteside L Whiteside L Whiteside L Whiteside L Whiteside L Whiteside L Whiteside M	Left Lane Ends West I-88 Advance left turn arrow East I-88 Advance left turn arrow South IL 40 Keep Right (symbol)	M1-1100 W9-1L M3-4(BL) M1-1 M5-1L M1-1 M5-1L M3-3(WH)	24 36 24 24 21 24 24	24 36 12 24	4.00								<u>├──</u>	Banded to light pole
Whiteside R Whiteside L Whiteside L Whiteside L Whiteside M Whiteside M Whiteside M Whiteside R Whiteside R Whiteside R Whiteside R Whiteside R Whiteside I Whiteside M Wh	West 1-88 Advance left turn arrow East 1-88 Advance left turn arrow South IL 40 Keep Right (symbol)	M3 - 4 (BL) M1 - 1 M5 - 1L M3 - 4 (BL) M3 - 4 (BL) M3 - 1L M5 - 1L M3 - 3 (WH)	24 24 21 24 24	12 24	9.00		_							
Whiteside L Whiteside L Whiteside L Whiteside L Whiteside L Whiteside M Whiteside M Whiteside R Whiteside R Whiteside R Whiteside I Whiteside M Whiteside M Whiteside M Whiteside M Whiteside M Whiteside L Wh	I-88 Advance left turn arrow East I-88 Advance left turn arrow South IL 40 Keep Right (symbol)	M1 - 1 M5 - 1L M3 - 4 (BL) M1 - 1 M5 - 1L M3 - 3 (WH)	24 21 24	24					9.00				17.0	
Whiteside L Whiteside L Whiteside L Whiteside L Whiteside L Whiteside M Whiteside M Whiteside R Whiteside R Whiteside R Whiteside I Whiteside M Whiteside M Whiteside M Whiteside M Whiteside M Whiteside L Wh	I-88 Advance left turn arrow East I-88 Advance left turn arrow South IL 40 Keep Right (symbol)	M1 - 1 M5 - 1L M3 - 4 (BL) M1 - 1 M5 - 1L M3 - 3 (WH)	24 21 24	24				2.00						Move 1 light pole to the north
Whiteside I Whiteside M Whiteside M Whiteside M Whiteside R Whiteside R Whiteside L Whiteside L Whiteside L Whiteside R Whiteside L Whiteside L Whiteside I Whiteside L Whiteside L Whiteside L Whiteside I Whiteside I Whiteside I Whiteside M Whiteside M Whiteside M Whiteside M Whiteside M Whiteside L Whiteside M Whiteside M Whiteside L	East I-88 Advance left turn arrow South IL 40 Keep Right (symbol)	M3 - 4 (BL) M1 - 1 M5 - 1L M3 - 3 (WH)	24	15				4.00						
Whiteside I Whiteside M Whiteside M Whiteside M Whiteside R Whiteside R Whiteside L Whiteside L Whiteside L Whiteside R Whiteside L Whiteside L Whiteside I Whiteside L Whiteside L Whiteside L Whiteside I Whiteside I Whiteside I Whiteside M Whiteside M Whiteside M Whiteside M Whiteside M Whiteside L Whiteside M Whiteside M Whiteside L	I-88 Advance left turn arrow South IL 40 Keep Right (symbol)	M1 - 1 M5 - 1 L M3 - 3 (WH)						2.20				!	<u>├</u> ──── <u>├</u>	
Whiteside M Whiteside R Whiteside R Whiteside L Whiteside M Whiteside M Whiteside M Whiteside M Whiteside L Wh	Advance left turn arrow South IL 40 Keep Right (symbol)	M5 - 1L M3 - 3 (WH)	24	12			<u>.</u>	2.00						Move to next light pole south
Whiteside M Whiteside R Whiteside R Whiteside L Whiteside M Whiteside M Whiteside M Whiteside M Whiteside L Wh	IL 40 Keep Right (symbol)		21	24 15				4.00 2.20						
Whiteside M Whiteside R Whiteside R Whiteside L Whiteside M Whiteside M Whiteside M Whiteside M Whiteside L Wh	IL 40 Keep Right (symbol)		24	12	2.00						10.0	5.0	<u>├</u> ──── <u>├</u>	100 feet south of I-88 WB ramps
Whiteside R Whiteside R Whiteside L Whiteside M Whiteside M Whiteside M Whiteside M Whiteside M Whiteside M Whiteside L Whiteside M Whiteside M Whiteside M Whiteside L Wh			24	24	4.00						* • • •			
Whiteside R Whiteside L Whiteside L Whiteside L Whiteside I Whiteside I Whiteside I Whiteside I Whiteside M Whiteside M Whiteside M Whiteside L Whiteside L Whiteside L Whiteside L Image: State S		R4 - 7	24	30	5.00				5.00					North Median at WB ramps
Whiteside R Whiteside L Whiteside L Whiteside L Whiteside I Whiteside I Whiteside I Whiteside I Whiteside M Whiteside M Whiteside M Whiteside L Whiteside L Whiteside L Whiteside L Image: State S		R 3 - 2	30	30	6.25				6.25					
Whiteside L Whiteside L Whiteside L Whiteside L Whiteside M Whiteside M Whiteside M Whiteside M Whiteside L Whiteside L Whiteside L Whiteside L	North	M3-1(WH)	24	12	2.00				2.00		12.0	5.0		
Whiteside L Whiteside L Whiteside L Whiteside L Whiteside M Whiteside M Whiteside M Whiteside M Whiteside L Whiteside L Whiteside L Whiteside L	IL 10	M1 - I 100	21	21	1.00				1.00					
Whiteside M Whiteside M Whiteside M Whiteside M Whiteside L	"H"	D9 - 2	24	24	4.00				2.00		12.0	5.0		
Whiteside M Whiteside M Whiteside M Whiteside M Whiteside L	Straight up arrow	M6-3 (BL)	21	15	2.20				2.20					
Whiteside M Whiteside M Whiteside L Whiteside L	East	M3-2 (BL)	24	12					2.00					
Whiteside M Whiteside M Whiteside L Whiteside L		M3-4 (BL) M1-1	24	12 24					2.00			/	<u>├</u> ───┼	
Whiteside M Whiteside M Whiteside L Whiteside L	I - 88	M1 - 1	24	24	-				4.00					
Whiteside M Whiteside M Whiteside L Whiteside L	Straight up arrow Advance Right turn Arrow	M6-3 (BL) M5-1R (BL)	21	15 15					2.20					
Whiteside M Whiteside M Whiteside L Whiteside L			21	15					2.20					
Whiteside M Whiteside L Uniteside L	East West	M3-2 (BL) M3-4 (BL)	24	12 12	2 <u>00</u> 2.00							<u>/</u>	16.0	Move 120 feet north
Whiteside M Whiteside L Uniteside L	I - 88	M1 - 1	24	24	4.00									
Whiteside M Whiteside L Uniteside L	I-88	M1-1 M6-3 (BL)	24	24	4.00									
Whiteside M Whiteside L Uniteside L	Straight up arrow Advance Right turn Arrow	M5 1R (BL)	21	15	2.19									
Whiteside M Whiteside L Uniteside L	Haza ⁻ d MarKer (slope down to Right)		12	36	3.00				3.00		11.0	3.0	<u>├</u> ──────────	
Whiteside L Whiteside L Whiteside L														
	Haza'd MarKer (slope down to Right)	OM3 - L	12	36	3.00				3.00		11.0	3.0	<u>├</u> ─────────	
Whiteside L	Jct	M2 1(BL)	21	15					2.20				<u> </u>	
Whiteside L	I-88 Jct	M1-1 M2-1 (WH)	24	24 15					4.00 2.20				<u> </u>	
Whiteside L	СКС	M4 - I 100	24	12					2.00					
Whiteside L	IL 110	M1I-100	24	24					4.00				<u>├</u> ───┼	
	Jct	M2 - 1 (BL)	21	15	2.20								16.0	Move 65 feet north
	I - 88 J c t	M1-1 M2-1 (WH)	24 21	24 15	4.00 2.20							1		combine and put on one post side by side
	СКС	M4 - I 100	24	12	2.00									
	IL 110	M1I-100	24	24	4.00								<u>├</u> ──────────	
Whiteside R	· · · · · · · · · · · · · · · · · · ·	W3-5	36	36	9.00				9.00				17.0	Domaina El as
	Red Flag	-	12	12					1.00					Remove flag
Whiteside M		W3-5	36	36 12	9.00				9.00			<u> </u>	17.0	Remove flag
	Speed Zone Ahead 45 Red Flag				762.75	100.4-				170 5-				
		BUREAU	Total COUNTY (RUF	IRAL)	752.75	190.47 45.70	40.50 0.00	63.90 0.00	733.99 83.10	170.57 35.00	<u>312.0</u> 63.0	151.00 35.00	785.0 161.0	
		WHITESIDE	E COUNTY (R	RURAL)	251.75	110.07	31.50	47.50	226.96	135.57	166.0	80.00	262.0	
USER NAME = C		WHITESIDE	E COUNTY (U REVISED -	URBAN)	383.30	34.70	9.00	16.40	423.93	0.00	83.0	36.00	362.0	F.A.P. SECTION COUNTY

						BUR	AU/WHITE:	SIDE COUNT	Y GUARDRA	AIL						
				<u> </u>	40604050	48102100	63000001	63000030	63000050	63000350	63000360	63100085	63100087	63100167	63100169	63200310
MAP LOCATION	BEGIN STATION	END STATION	STRUCTURE NUMBER	LEFT OR RIGHT	HOT-MIX ASPHALT SURFACE COURSE, IL-9.5, MIX "C", N50	AGGREGATE WEDGE SHOULDER, TYPE B	STEEL PLATE BEAM GUARDRAIL, TYPE A, 6 FOOT POSTS	STRONG POST GUARDRAIL ATTACHED TO CULVERT	WEAK POST GUARDRAIL ATTACHED TO CULVERT CASE I	GUARDRAIL OVER	LONG-SPAN GUARDRAIL OVER CULVERT, 18 FT 9 IN SPAN	TRAFFIC BARRIER TERMINAL, TYPE 6	TRAFFIC BARRIER TERMINAL, TYPE 6A	TRAFFIC BARRIER TERMINAL, TYPE 1 (SPECIAL) TANGENT	TRAFFIC BARRIER TERMINAL, TYPE 1 (SPECIAL) FLARED	GUARDRAIL REMOVAL
					TON	TON	FOOT	FOOT	FOOT	FOOT	FOOT	EACH	EACH	EACH	EACH	FOOT
L			I	_	1	1 -	BUREA		RAL)	- <u>1</u>			I	<u></u>	1	
1	1232+06	1234+59	SN 006-2519	LEFT				ļ						2		75
2	1272+03	1273+75	SN 006-2518	RIGHT		16	12.5	25								63
3	1271+75	1272+53	SN 006-2518	LEFT		12	25	21.875								72
			Γ		I	1		DE COUNTY (RU	JRAL)	T					1	
4	20+25	22+25	SN 098-1052	RIGHT	10	<u> </u>	62.5			37.5				2		103
5	20+62	22+75	SN 098-1052	LEFT	11		75			37.5				2		103
10	149+79	152+29	SN 098-0109	RIGHT	23	_										_
12	153+80	156+18	SN 098-0109	LEFT	18											_
13	150+11	151+99	SN 098-0109	LEFT	15	_				_						_
14	218+86	220 <u>+</u> 86	SN 098-0104	RIGHT	14		112.5					1		1		180
15	221+40	222+90	SN 098-0104	RIGHT	11		62.5					1		1		130
16	221+20	223+20	SN 098-0104	LEFT	14		112.5					1		1		181
17	219+42	220+67	SN 098-0104	LEFT	8		37.5					1		1		130
18	320+94	323+57	SN 098-1005	RIGHT	13		125		37.5					2		99
19	322+24	323+59	SN 098-1005	LEFT	5	2	62.5		37.5	<u> </u>				L		74
20	401+99	405+80	SN 098-1010	RIGHT	9		187.5						2	2		332
21	402+42	406+12	SN 098-1010	LEFT	5		175						2	2		307
			1				WHITESI	DE COUNTY (UI	RBAN)	- 1			1			
22	578+56	582+88	SN 098-2018	RIGHT	27	_	287.5				43.75	_		1	1	425
23	580+11	583+29	SN 098-2018	LEFT	18		175				43.75			1	1	321
24	604+20	606+57	SN 098-0086	RIGHT	13		150					1		1		233
25	609+15	611+53	SN 098-0086	LEFT	13		150					1		1		234
					I			I				-	1	-	1	
		тот	ALS		227	30	1813	46.88	75	75	87.5	6	4	20	2	3062
	BU	UREAU COU	INTY (RURAL)		0	28	37.5	46.88	0	0	0	0	0	2	0	210
	WH	IITESIDE CO	UNTY (RURAL)		156	2	1012.5	0.00	75	75	0	4	4	14	0	1639
	WH	IITESIDE CO	UNTY (URBAN)		71	0	762.5	0.00	0	0	87.5	2	0	4	2	1213

USER NAME = Cristian.Rosas	DESIGNED -	REVISED -								F A P BTF	SECTION	COUNTY TO	TAL SHEET
	DRAWN -	REVISED -	STATE OF ILLINOIS			GUARD	RAIL SCI	IEDULE		646	(101, 102, 135)RS	WHITESIDE 1	79 46
PLOT SCALE = 100.0000 / in	CHECKED -	REVISED -	DEPARTMENT OF TRANSPORTATION									CONTRACT NO	D. 64P41
PLOT DATE = Oct-12-2023 02:27:00 PM	DATE -	REVISED -		SCALE:	SHEET	OF	SHEETS	STA.	TO STA.		ILLINOIS FED. /	AID PROJECT	

							BUREA	U/WHITESIC	E COUNTY	GUARDRAIL						
					63301210	63301990	63302700	63500105	72501000	X6300130	X6300210	X6310176	X6330725	X7820007	Z0005216	
MAP LOCATION	BEGIN STATION	END STATION	STRUCTURE NUMBER	LEFT OR RIGHT	REMOVE AND REERECT STEEL PLATE BEAM GUARDRAIL, TYPE A	REMOVE AND REERECT TRAFFIC BARRIER TERMINALS, TYPE 1	REMOVE AND REERECT TRAFFIC BARRIER TERMINALS, TYPE 6	DELINEATORS	TERMINAL MARKER - DIRECT APPLIED	STEEL PLATE BEAM GUARDRAIL, TYPE A (SPECIAL)	GUARDRAIL BLOCKS	TRAFFIC BARRIER TERMINAL, TYPE 2 (SPECIAL)	STEEL PLATE BEAM GUARDRAIL (SHORT RADIUS)	GUARDRAIL REFLECTORS, TYPE C (SPECIAL)	HMA STABILIZATION 6" AT STEEL PLATE BEAM GUARD RAIL	NOTES
					FOOT	EACH	EACH	EACH	EACH	FOOT	EACH	EACH	FOOT	EACH	SQ YD	
								BUREAU C	OUNTY (RURA	L)						
1	1232+06	1234+59	SN 006-2519	LEFT				2	2		26			4		
2	1272+03	1273+75	SN 006-2518	RIGHT				2		25		2	25	2		
3	1271+75	1272+53	SN 006-2518	LEFT				2		75		2	25	2		
	1						1	WHITESIDE	COUNTY (RUR	AL)	1	·				
4	20+25	22+25	SN 098-1052	RIGHT				2	2	25				3	93	
5	20+62	22+75	SN 098-1052	LEFT				2	2	25				3	99	
10	149+79	152+29	SN 098-0109	RIGHT	162.5	1	1							4	57	REMOVE AND REERECT
12	153+80	156+18	SN 098-0109	LEFT_	162.5	1	1							3	41	REMOVE AND REERECT
13	150+11	151+99	SN 098-0109	LEFT	100	1	1							3	31	REMOVE AND REERECT
14	218+86	220+86	SN 098-0104	RIGHT				1	1					3	72	
15	221+40	222+90	SN 098-0104	RIGH⊺				1	1					2	93	
16	221+20	223+20	SN 098-0104	LEFT				1	1					3	51	
17	219+42	220+67	SN 098-0104	LEFT				1	1					2	35	
18	320+94	323+57	SN 098-1005	RIGH⊺				2	2					4	117	
19	322+24	323 + 59	SN 098-1005	LEFT				2				2	25	2	42	
20	401+99	405+80	SN 098-1010	RIGHT				2	2					5	79	
21	402+42	406+12	SN 098-1010	LEFT				2	2					5	47	
								WHITESIDE C	COUNTY (URB	AN)						
22	578+56	582+88	SN 098-2018	RIGHT				2	2					6	105	
23	580+11	583+29	SN 098-2018	LEFT				2	2					5	23	
24	604+20	606+57	SN 098-0086	RIGHT				1	1					4	109	
25	609+15	611+53	SN 098-0086	LEFT				1	1					4	114	
					· · · · · ·		1			1	1				1	
			ALS		425	3	3	28	22	150	26	6	75	69	1208	
	B	JREAU COU	INTY (RURAL)		0	0	0	6	2	100	26	4	50	8	0	
			UNTY (RURAL)		425	3	3	16	14	50	0	2	25	42	857	
	WF	ITESIDE CO	UNTY (URBAN)		0	0	0	6	6	0	0	0	0	19	351	

USER NAME = Cristian.Rosas	DESIGNED -	REVISED -								F A P RTE	SECTION	COUNTY TOTAL SHEETS	SHEET 5 NO.
	DRAWN -	REVISED -	STATE OF ILLINOIS				RAIL SCI			646	(101, 102, 135)RS	WHITESIDE 179	47
PLOT SCALE = 100.0000 / in	CHECKED -	REVISED -	DEPARTMENT OF TRANSPORTATION									CONTRACT NO. 64	4P41
PLOT DATE = Oct-11-2023 07:34:50 AM	DATE -	REVISED -		SCALE:	SHEET	OF	SHEETS	STA.	TO STA.		ILLINOIS FED. A	ID PROJECT	

					SEEDING	G / TEMPOR	ARY EROSIO	N CONTROL SEED	DING / MUL	CH			
GUARDRAIL	BEGIN	END	STRUCTURE	LEFT OR	25000110	25000210	25000310	25100630	(NOTE 1) 28000250	28000305 TEMPORARY	28000400 PERIMETER	28000500 INLET AND	
LOCATION	STATION	STATION	NUMBER	RIGHT	SEEDING	SEEDING	SEEDING	EROSION CONTROL	TEMP EROS	DITCH	EROSION	PIPE	NOTES
		o minori	ROMBER		CL 1A	CL 2A	CL <u>4</u>	BLANKET	CONTR SEED	CHECKS	BARRIER	PROTECTION	4
					ACRE	ACRE	ACRE	SQ YD	POUND	FOOT	FOOT	EACH	
							BUREAU COU	NTY (RURAL)				1	
1	1232+00	1235+00	SN 006-2519										
2	1272+00	1273+75	SN 006-2518	RT		0.014		68	4		85		
3	1271+70	1273+60	SN 006-2518	LT		0.017		83	5		77		
NA	VAR	VAR	NA	LT/RT		0.011		54	3				TREE REMOVALS, VAR LOC
							WHITESIDE CO	· · ·				1	1
4	20+55	22+35	SN 098-1052	RT		0.095	0.011	514	32	20	112		
5	20+55	<u>2</u> 2+85	SN 098-1052			0.075		364	23		274	1	
10	149+80	151+35	SN 098-0109	RT		0.039		189	12				
12	153+75	156+30	SN 098-0109	T		0.028		136	8		_		
13	150+15	152+05	SN 098-0109			0.027		131	8				
14	218+85	220+90	SN 098-0104	RT		0.027		131	8				
15	221+40	222+95	SN 098-0104	RT		0.044	0.009	257	16	44			
16	221+20	223+25	SN 098-0104	LT		0.038		184	11				
17	219+40	220+70	SN 098-0104	LT		0.024		117	7		158		
NA	287+00	290+00	NA	<u> </u>		0.121	0.071	930	58	54		2	SNOW STORAGE DITCH
18	321+10	3223+65	SN 098-1005	RT		0.022		107	7				
19	321+60	323+40	SN 098-1005			0.009	0.001	49	3			1	
NA	350+50	355+00	NA	RT		0.068	0.037	509	32	69			DITCH RESHAPING
20	401+85	405+60	SN 098-1010	RT		0.093	0.004	470	29				
21	402+80	406+40	SN 098-1010	Т		0.088	0.018	514	32	80		1	
NA	VAR	VAR	NA	LT/RT		0.020		97	6				TREE REMOVALS, VAR LOC
				<u> </u>		<u> </u>	WHITESIDE COU	JNTY (URBAN)					<u>+</u>
22	578+50	582+95	SN 098-2018	RT		0.134	0.003	664	41	28			
23	580+10	583+25	SN 098-2018	LT	0.006	0.024	0.001	151	9		199	2	
24	604+20	606+60	SN 098-0086	RT		0.039		189	12		261		
25	_609+15	611+55	SN 098-0086	LT		0.032		155	10		261		
NA	VAR	VAR	NA	LT/RT		0.016		78	5				TREE REMOVALS, VAR LOC
		TOTALS			0.25	1,25	0.25	6141	381	295	1427	7	
	BURI	AU COUNTY	(RURAL)		0.000	0.042	0.000	205	12	0	162	0	
	WHITE	SIDE COUN	TY (RURAL)		0.000	0.818	0.151	4699	292	267	544	5	
	WHITE	SIDE COUNT	TY (URBAN)		0.006	0.245	0.004	1237	77	28	721	2	

ROUNDING UP TOTAL SEEDING QUANTITIES

USER NAME = Cristian.Rosas	DESIGNED -	REVISED -								F A P RTE	SECTION	COUNTY	TOTAL SHEET SHEETS NO.
	DRAWN -	REVISED -	STATE OF ILLINOIS				NG SCH	DULE		646	(101, 102, 135)RS	WHITESIDE	179 48
PLOT SCALE = 100.0000 / in.	CHECKED -	REVISED -	DEPARTMENT OF TRANSPORTATION								(CONTRACT	T NO. 64P41
PLOT DATE = Oct-12-2023 02:15:52 PM	DATE -	REVISED -		SCALE:	SHEET	OF	SHEETS	STA.	TO STA.		ILLINOIS FED.	AID PROJECT	


					EARTHWORK	SCHEDULE AN	D TOPSOIL		
	<u>r</u>			20200100				21101615	
MAP LOCATION	BEGIN STATION	END STATION	STRUCTURE NUMBER	EARTH EXCAVATION	EARTH EXCAVATION SDJUSTED FOR SHRINKAGE	EMBANKMENT **	EARTHWORK BALANCE * WASTE (+) SHORAGE (-)	TOPSOIL FURNISH AND PLACE, 4"	
				CU YD	CU YD	CU YD	CU YD	SQ YD	
			a		BUREA	U COUNTY (RURU	AL)		
1	1232+06	1234+60	SN 006-2519	0	0	0	0	0	81 2
2&3	1271+75	1272+75	SN 006-2518	14	11	58	-47	136	
			i v		WHITES	IDE COUNTY (RUI	RAL)		
4&5	20+25	22+75	SN 098-1052	71	53	181	-128	755	
10 TO 14	149+79	156+18	SN 098-0109	13	10	17	-7	318	
14 TO 17	218+87	223+21	SN 098-0104	82	62	15	47	527	
NA	287+00	290+00	NA	56	42	0	42	509	DITCH RESHAPING
18 & 19	320+95	323+59	SN 098-1005	60	45	5	40	136	
NA	351+00	355+00	NA	102	77	0	77	927	SNOW STORAGE D
20 & 21	401+99	406+12	SN 098-1010	49	37	53	-16	818	
					WHITES	IDE COUNTY (URB	AN)	-	27
22 & 23	578+57	583+30	SN 098-2018	36	27	12	15	273	
24	604+20	606+57	SN 098-0086	31	23	1	22	155	
25	609+15	611+53	SN 098-0086	22	17	2	15	109	
					15.		0		27
		TOTALS		540	404	344	60	4663	
	BUREA	U COUNTY	(RURAL)	14	11	58	-47	136	
	WHITESI	DE COUNTY	(RURAL)	433	326	271	55	3990	
	WHITESI	DE COUNTY	(URBAN)	89	67	15	52	537	

* ADJUSTED FOR SHRINKAGE FACTOR OF 25%

** DOES NOT INCLUDE TOPSOIL QUANTITY

USER NAME = Cristian.Rosas	DESIGNED	REVISED -									F.A.P.	SECTION	COUNTY TOTAL SHEET
	DRAWN -	REVISED _	STATE OF ILLINOIS		EARTH	WORK S	SCHEDL	ULE (GUARI	DRAIL)		646	(101, 102, 135)RS	WHITESIDE 179 49
PLOT SCALE = 100.0000 * / in.	CHECKED	REVISED -	DEPARTMENT OF TRANSPORTATION										CONTRACT NO. 64P41
PLOT DATE = Oct-12-2023 09:40:41 AM	DATE	REVISED +	r I	SCALE:	SHEET	OF	SHEE	ETS STA.	T	TO STA.		ILLINOIS FED.	AID PROJECT

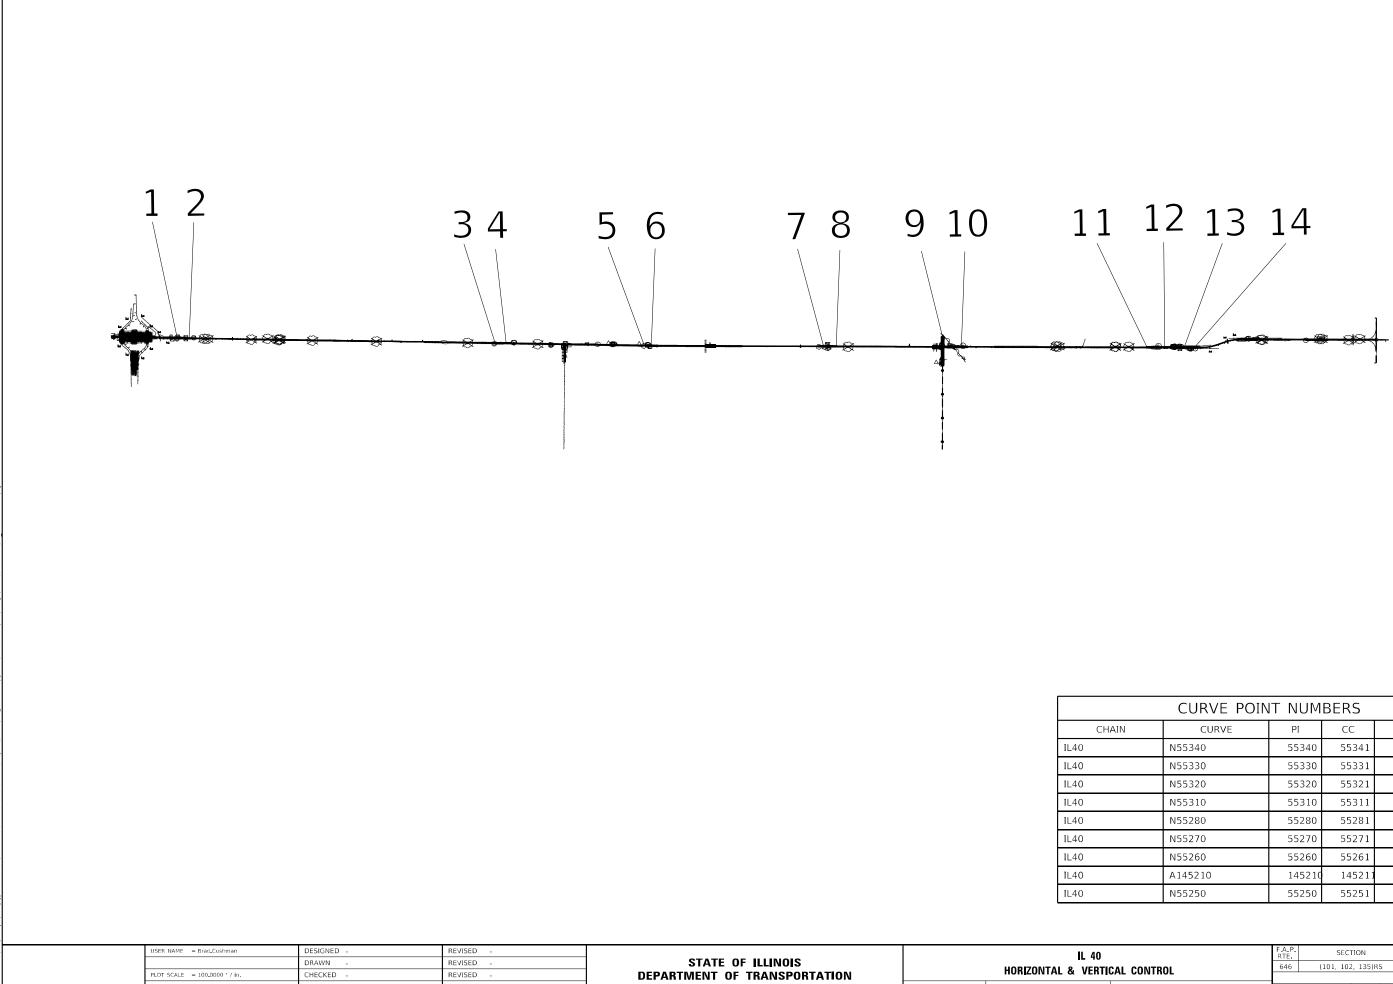NOTES
G
DITCH



REVISED

PLOT DATE = Aug-24-2023 11:08:03 AM

DATE

SCALE: SHEET OF SHEETS

	CURVE POIN	IT NUM	BERS		
HAIN	CURVE	PI	CC	PC	PT
	N55340	55340	55341	55342	55343
	N55330	55330	55331	55332	55333
	N55320	55320	55321	55322	55323
	N55310	55310	55311	55312	55313
	N55280	55280	55281	55282	55283
	N55270	55270	55271	55272	55273
	N55260	55260	55261	55262	55263
	A145210	145210	145211	145212	145213
	N55250	55250	55251	55252	55253

RTE. SECTION COUNTY	SHEETS	NO.
FICAL CONTROL 646 (101, 102, 135)RS WHITESIDE	179	50
CONTRACT	NO. 64	1P41
TS STA. TO STA. ILLINOIS FED AID PROJECT		

0 D102 A1451051 Beginning chain IL40 description ------Curve Data Curve N55340 P.I. Station 0+97.33 N 1,791,666.2558 E 2,427,547.2611 $Delta = 3^{\circ} 53' 29.3546'' (LT)$ Degree = 1° 59' 59 9645" Tangent = 97.3251'Length = 194.5753'Radius = 2,864.8031 External = 1.6527Long Chord = 194.5379'Mid. Ord. = 1.6518'P.C. Station 0+00.00 N 1,791,573.0970 E 2,427,575.4321 P.T. Station 1+94.58 N 1.791.757.2880 E 2.427.512.8327 C.C. N 1,790,743.8726 E 2,424,833.2644 Course from PT N55340 to PC N55330 339° 17' 00.0000" Dist 348.8740' Curve Data Curve N55330 P.I. Station 10+45.47 N 1,792,553.1634 E 2,427,211.8318 Delta = 19° 52' 40.2915" (RT) Degree = 1° 59' 59.6058" Tangent = 502.0192'Length = 993.9474'Radius = 2,864.9458 External = 43.6514Long Chord = 988.9701' Mid. Ord. = 42,9963 P.C. Station 5+43.45 N 1,792,083.6041 E 2,427,389.4196 P.T. Station 15+37.40 N 1,793,055.1288 E 2,427,204.4826 C.C. N 1,793,097,0700 E 2,430,069,1214 Course from PT N55330 to A0051068 359° 09' 40.2915" Dist 7,561.1761' Point A0051068 N 1,800,615.4946 E 2,427,093.7912 Sta 90+98.57 Course from A0051068 to A0051069 359° 12' 33.6943" Dist 22,666.9467' Point A0051069 N 1,823,280.2832 E 2,426,781.0136 Sta 317+65.52 Course from A0051069 to A0051070 359° 58' 58.5844" Dist 15,316.2195' Point A0051070 N 1,838,596.5020 E 2,426,776.4532 Sta 470+81.74 Course from A0051070 to A0051064 359° 52' 55.1114" Dist 7.019.7879' Point A0051064 N 1,845,616.2750 E 2,426,761.9930 Sta 541+01.53 Course from A0051064 to A0051066 359° 56' 34,5168" Dist 3,868,6609' Point A0051066 N 1,849,484,9340 E 2,426,758,1390 Sta 579+70.19 Course from A0051066 to PC N55320 359° 56' 34,5168" Dist 804,0434'

CUR N55340 CUR N55330 A0051068 A0051069 A0051070 A0051064 A0051066 CUR N55320 -

CUR N55310 N55300 N55290 CUR N55280 CUR N55270 CUR N55260 CUR A145210 CUR N5525-

Chain II 40 contains:

Curve N55320 P.I. Station 589+63.75 N 1,850,478.4966 E 2,426,757.1492 Delta = 2° 46' 29.0484" (RT) Degree = 0° 43 55.8740" Tangent = 189.5197'Length = 378.9653Radius = 7,825.2907' External = 2.2946Long Chord = 378.9283Mid. Ord. = 2.2940'P.C. Station 587+74.23 N 1,850,288.9770 E 2,426,757.3380 P.T. Station 591+53.20 N 1.850.667.8031 E 2.426.766.1351 C.C. N 1,850,296.7726 E 2,434,582.6249 Course from PT N55320 to PC N55310 2° 43' 03.5652" Dist 42.3644' Curve Data Curve N55310 P.I. Station 594+35.56 N 1,850,949.8500 E 2,426,779.5232 Delta = 2° 46' 26 6235" (LT) Degree = 0° 34' 40.9531" Tangent = 240.0000'Length = 479.9062Radius = 9,912.0354 External = 2.9051Long Chord = 479.8594'Mid. Ord. = 2.9043P.C. Station 591+95.56 N 1,850,710.1199 E 2,426,768.1438 P.T. Station 596+75.47 N 1,851,189.8499 E 2,426,779.2870 C.C. N 1,851,180.0919 E 2,416,867.2564 Course from PT N55310 to N55300 359° 56' 36.9417" Dist 2,875.1415' Point N55300 N 1,854,064.9900 E 2,426,776.4565 Sta 625+50.61 Course from N55300 to N55290 0° 32' 20.4513" Dist 1,391.5492' Point N55290 N 1,855,456.4776 E 2,426,789.5474 Sta 639+42.16 Course from N55290 to PC N55280 359° 54' 11.4453" Dist 4,199.6606' Curve Data Curve N55280 P.I. Station 686+31.30 N 1,860,145.6142 E 2,426,781.6235 $Delta = 1^{\circ} 31' 35.7853'' (LT)$ Degree = 0° 09' 21 4203" Tangent = 489.4827'Length = 978.9075'Radius = 36,739,8213 External = 3,2605Long Chord = 978.8786Mid. Ord. = 3.2602 P.C. Station 681+41.82 N 1,859,656.1322 E 2,426,782.4507 P.T. Station 691+20.73 N 1.860.634.9004 E 2.426.767.7563 C.C. N 1,859,594.0477 E 2,390,042.6818 Course from PT N55280 to PC N55270 358° 22' 35.6599" Dist 450.6783' Curve Data Curve N55270

Curve Data

P.I. Station 697+89.53 N 1,861,303.4323 E 2,426,748.8090 Delta = 1° 34' 10.9839" (RT) Degree = 0° 21' 35.4536" Tangent = 218.1220' Length = 436.2166' Radius = 15.922.2074' External = 1.4940' Long Chord = 436.2030' Mid. Ord. = 1.4938' P.C. Station 695+71.40 N 1,861,085.3979 E 2,426,754.9884 P.T. Station 700+07.62 N 1,861,521.5541 E 2,426,748.6045 C.C. N 1,861,536.4799 E 2,442,670.8049

Course from PT N55270 to PC N55260 359 $^\circ$ 56 46.6438 " Dist 767.3341 '

	USER NAME = Brad.Cushman	DESIGNED -	REVISED -					II 40			F.A.P. BTE	SECTION	COUNTY	TOTAL SHEET
		DRAWN -	REVISED -	STATE OF ILLINOIS	HORIZONTAL & VERTICAL CONTROL		646	(101, 102, 135)RS	WHITESIDE	179 51				
	PLOT SCALE = 100.0000 / in.	CHECKED -	REVISED -	DEPARTMENT OF TRANSPORTATION	HORIZONTAL & VERTICAL CONTROL					CONTRACT	NO. 64P41			
1	PLOT DATE = Aug-24-2023 11:08:35 AM	DATE -	REVISED -		SCALE:	SHEET	OF	SHEETS	STA.	TO STA.		ILLINOIS FE	D. AID PROJECT	

Curve Data Curve N55260 P.I. Station 710+74.21 N 1,862,588.1451 E 2,426,747.6046 $Delta = 34^{\circ} 33' 14.8181'' (LT)$ Degree = 5° 57' 17.6548" Tangent = 299.2573'Length = 580.2632'Radius = 962.1612 External = 45.4643'Long Chord = 571.5094'Mid. Ord. = 43.4129P.C. Station 707+74.95 N 1,862,288.8879 E 2,426,747.8852 P.T. Station 713+55.22 N 1,862,834.4514 E 2,426,577.6396 C.C. N 1,862,287.9860 E 2,425,785.7243 Course from PT N55260 to PC A145210 325° 23' 31.8257" Dist 896.7265' Curve Data Curve A145210 P.I. Station 723+41.51 N 1,863,646.2258 E 2,426,017.4703 Delta = 32° 15' 30.0000" (RT) Degree = 18° 29' 59,9820" Tangent = 89.5631' Length = 174.3694'Radius = 309.7070' External = 12.6902'Long Chord = 172.0755Mid. Ord. = 12.1907 P.C. Station 722+51.94 N 1,863,572.5100 E 2,426,068.3383 P.T. Station 724+26.31 N 1,863,735.7136 E 2,426,013.7987 C.C. N 1.863,748,4100 E 2,426,323,2454 Course from PT A145210 to PC N55250 357° 39' 01.8257" Dist 58.5657' Curve Data *_____* Curve N55250 P.I. Station 725+33.01 N 1,863,842.3186 E 2,426,009.4248 $Delta = 17^{\circ} 38' 59.9983'' (LT)$ Degree = 18° 28' 57.0343" Tangent = 48.1290' Length = 95.4957'Radius = 310,0000External = 3.7139' Long Chord = 95.1185'Mid. Ord. = 3.6699 P.C. Station 724+84.88 N 1,863,794.2301 E 2,426,011.3978 P.T. Station 725+80.38 N 1,863,887,5453 E 2,425,992,9641 C.C. N 1,863,781.5216 E 2,425,701.6584 Course from PT N55250 to D102 340° 00' 01.8274" Dist 1,671.2792' Point D102 N 1,865,458.0391 E 2,425,421.3668 Sta 742+51.65 Course from D102 to A1451051 340° 15' 01.8257" Dist 674.7866' Point A1451051 N 1.866.093.1341 E 2.425.193.3508 Sta 749+26.44 Ending chain IL40 description

Chain HAHNAMANE contains: A0051073 A0051095

Beginning chain HAHNAMANE description

Point A0051073 N 1,807,390.4148 E 2,427,000.2963 Sta 562+82.78

Course from A0051073 to A0051095 89° 24' 24.7113" Dist 545.8100'

Point A0051095 N 1,807,396.0650 E 2,427,546.0770 Sta 568+28.59

Ending chain HAHNAMANE description

Chain HAHNAMANW contains: A0051099 A0051098 A0057902 A0057897 A0057892 A005260 A0051072 A0051071 A0051073

Beginning chain HAHNAMANW description

Point A0051099 N 1,807,086.8810 E 2,400,719.5580 Sta 300+00.00 Course from A0051099 to A0051098 89° 19' 35.6987" Dist 4,922.9794' Point A0051098 N 1,807,144.7411 E 2,405,642.1974 Sta 349+22.98 Course from A0051098 to A0057902 89° 43' 53.8031" Dist 2,882.1893' Point A0057902 N 1,807,158.2420 E 2,408,524.3550 Sta 378+05.17 Course from A0057902 to A0057897 89° 36' 40.8166" Dist 1,319.1063' Point A0057897 N 1,807,167.1900 E 2,409,843.4310 Sta 391+24.27 Course from A0057897 to A0057892 88° 54' 55.2094" Dist 1,316.4409' Point A0057892 N 1,807,192.1100 E 2,411,159.6360 Sta 404+40.72 Course from A0057892 to A005260 88° 43' 47,5874" Dist 1,315,9783' Point A005260 N 1,807,221.2798 E 2,412,475.2910 Sta 417+56.69 Course from A005260 to A0051072 89° 17' 32.2320" Dist 4,071.2462' Point A0051072 N 1,807,271.5663 E 2,416,546.2267 Sta 458+27.94 Course from A0051072 to A0051071 89° 35' 51.7477" Dist 5,215.1796' Point A0051071 N 1,807,308.1834 E 2,421,761.2777 Sta 510+43.12 Course from A0051071 to A0051073 89° 06' 02.7446" Dist 5,239.6638' Point A0051073 N 1.807.390.4148 E 2.427.000.2963 Sta 562+82.78 _____

Ending chain HAHNAMANW description

Chain RT172_WHITESIDE contains: WHA20 WHA12 WHA13 CUR L99220 CUR L99230 CUR L99240 WHA14 CUR L99250 WHA15

Beginning chain RT172_WHITESIDE description

Point WHA20 N 1,791,258,6832 E 2,400,858,0285 Sta 0+00.00

Course from WHA20 to WHA12 359° 16' 29,2062" Dist 15,764,9664'

Point WHA12 N 1,807,022,3868 E 2,400,658,4890 Sta 157+64.97

Course from WHA12 to WHA13 359° 23' 07.6802" Dist 3,458.5231'

Point WHA13 N 1,810,480.7110 E 2,400,621.3949 Sta 192+23.49

Course from WHA13 to PC L99220 359° 31' 38.5525" Dist 7,787.2958'

Curve Data

Curve L99220 Feature: 111 P.I. Station 275+80.71 N 1,818,837.6425 E 2,400,552.4582 Delta = 0° 36' 56.5525" (LT) Degree = 0° 03' 14.4636" Tangent = 569.9200' Length = 1,139.8290' Radius = 106,068.5951' External = 1.5311' Long Chord = 1,139.8235' Mid. Ord. = 1.5311' P.C. Station 270+10.79 N 1,818,267.7419 E 2,400,557.1594 P.T. Station 281+50.61 N 1,819,407.4597 E 2,400,541.6333 C.C. N 1,817,392.8078 E 2,294,492.1729

Course from PT L99220 to PC L99230 358° 54' 42.0000" Dist 2,949.4676'

Curve Data


Curve L99230 Feature: 111 P.I. Station 317+04.71 N 1,822,960.9161 E 2,400,474.1272 Delta = 0° 46' 50.5054" (LT) Degree = 0° 03' 52.4189" Tangent = 604.6300' Length = 1,209.2413' Radius = 88,746.9992' External = 2.0596' Long Chord = 1,209.2319' Mid. Ord. = 2.0596' P.C. Station 311+00.08 N 1,822,356.3952 E 2,400,485.6115 P.T. Station 323+09.32 N 1,823,565.2245 E 2,400,454.4073 C.C. N 1,820,670.7473 E 2,311,754.6222

Course from PT L99230 to PC L99240 358° 07' 51.4946" Dist 1,370.5985'


USER NAME = Brad Cushman	DESIGNED -	REVISED -					II 40			F.A.P. BTE	SECTION	COUNTY	TOTAL	SHEET
	DRAWN -	REVISED -	STATE OF ILLINOIS				IL 40 9 VEDTI			646	(101, 102, 135)RS	WHITESIDE	179	52
PLOT SCALE = 100.0000 / in.	CHECKED -	REVISED -	DEPARTMENT OF TRANSPORTATION		HUKIZ	ONTAL &	& VEKI	CAL CONTR	(UL		(),,	CONTRACT	NO. 64	P41
PLOT DATE = Aug-24-2023 11:08:55 AM	DATE -	REVISED -		SCALE:	SHEET	OF	SHEETS	STA.	TO STA.		ILLINOIS FED.	AID PROJECT		

Curve Data Curve L99240 Feature: 111 P.I. Station 341+77.07 N 1,825,431,9793 E 2,400,393,4908 $Delta = 2^{\circ} 21' 19.5962'' (RT)$ Degree = 0° 14' 12.9408" Tangent = 497.1500'Length = 994.1600'Radius = 24,182.7803External = 5.1097'Long Chord = 994.0900'Mid. Ord. = 5,1086P.C. Station 336+79.92 N 1,824,935.0937 E 2,400,409.7053 P.T. Station 346+74.08 N 1,825,929.1113 E 2,400,397.7113 C.C. N 1,825,723.8134 E 2,424,579.6202 Course from PT L99240 to WHA14 0° 29' 11.0908" Dist 2,256.6028' Point WHA14 N 1,828,185.6328 E 2,400,416.8686 Sta 369+30.68 Course from WHA14 to PC L99250 90° 12' 31.0000" Dist 1,764.5757' Curve Data Curve L99250 Feature: 111 P.I. Station 392+95.74 N 1,828,177.0218 E 2,402,781.9085 Delta = 0° 42' 26.0000" (LT) Degree = 0° 03' 31.9998' Tangent = 600.4800'Length = 1,200.9448'Radius = 97,294.8299' External = 1.8530'Long Chord = 1,200.9371'Mid. Ord. = 1,8530 P.C. Station 386+95.26 N 1,828,179.2081 E 2,402,181.4325 P.T. Station 398+96,20 N 1,828,182,2473 E 2,403,382,3658 C.C. N 1,925,473.3931 E 2,402,535.6774 Course from PT L99250 to WHA15 89° 30' 05.0000" Dist 23,399.1438' Point WHA15 N 1.828.385.8736 E 2.426.780.6236 Sta 632+95.35

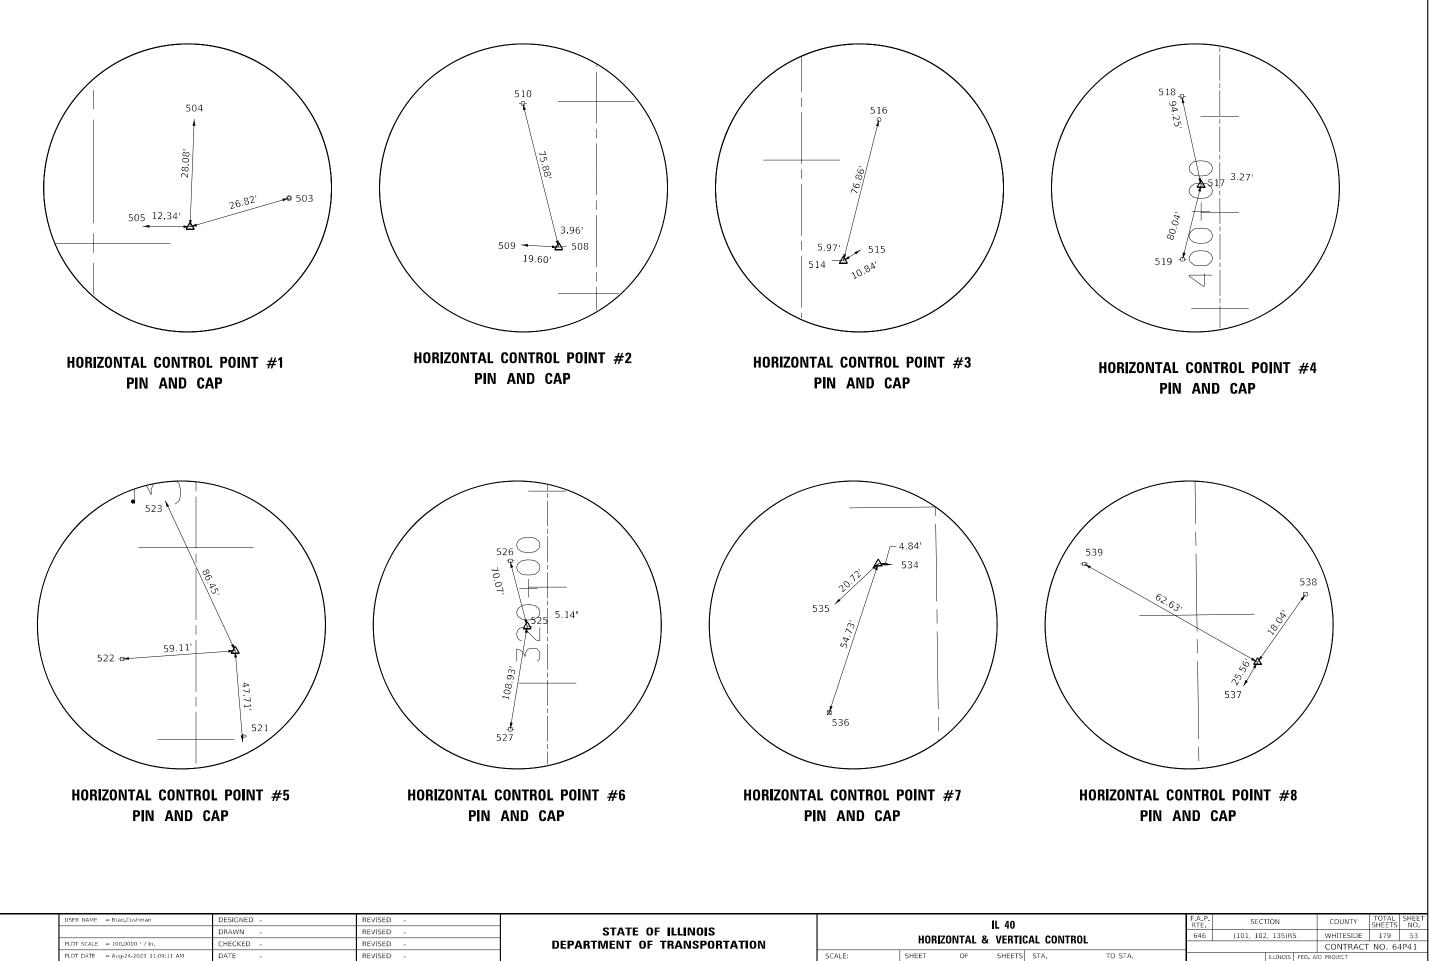
Ending chain RT172_WHITESIDE description



USER NAME = Brad Cushman	DESIGNED - DRAWN -	REVISED - REVISED -	STATE OF ILLINOIS				
PLOT SCALE = 100.0000 / in.	CHECKED -	REVISED -	DEPARTMENT OF TRANSPORTATION	ĺ	HORIZO	NIAL &	ı Vt
PLOT DATE = Aug-24-2023 11:09:11 AM	DATE -	REVISED -		SCALE:	SHEET	OF	SF

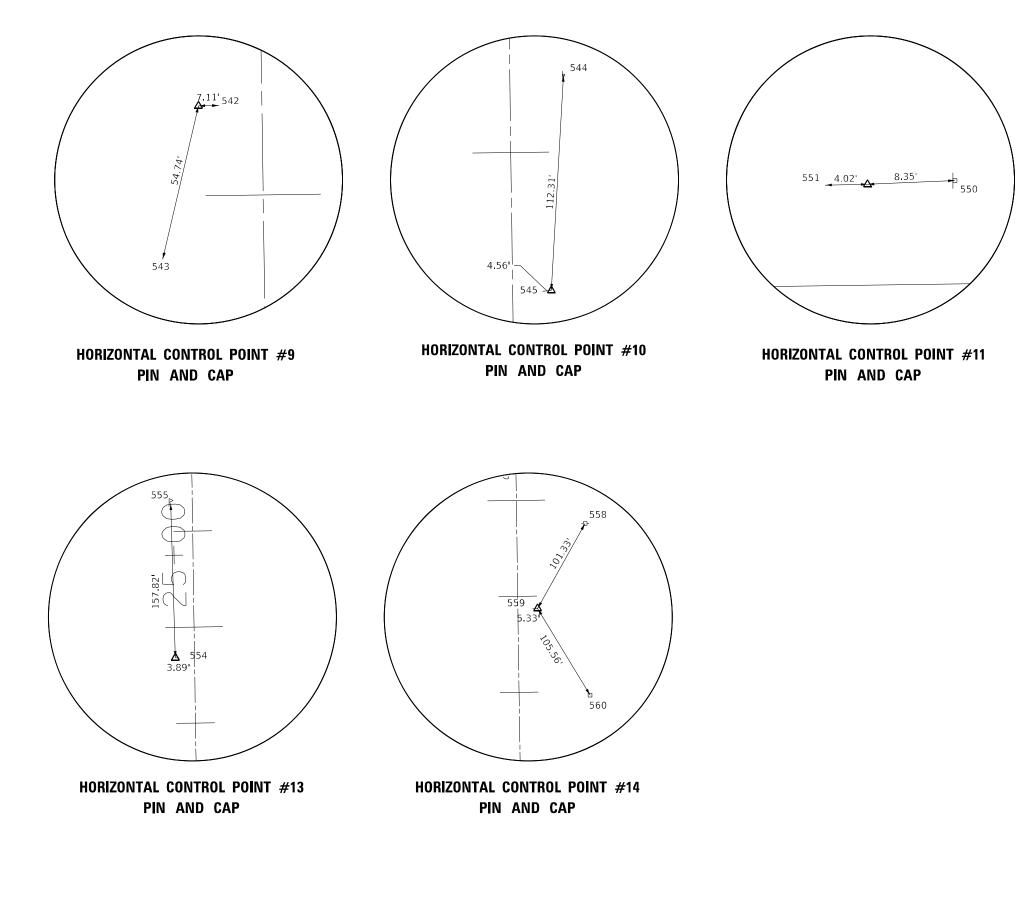

USER NAME = Brad.Cushman	DESIGNED -	REVISED -		ĺ			L 40
	DRAWN -	REVISED -	STATE OF ILLINOIS	1			
PLOT SCALE = 100.0000 / in.	CHECKED -	REVISED -	DEPARTMENT OF TRANSPORTATION	1	HORIZO	NIAL &	VERTIC
PLOT DATE = Aug-24-2023 11:09:26 AM	DATE -	REVISED -		SCALE:	SHEET	OF	SHEETS

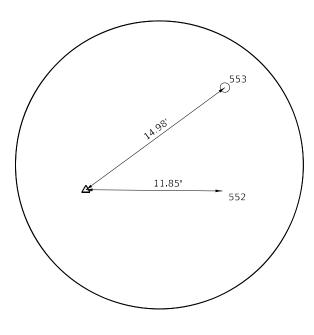



IL 40			F.A.P. RTE	SECTION	COUNTY	TOTAL SHEETS	SHEET NO.
. VERTIC	AL CONTR	01	646	(101, 102, 135)RS	WHITESIDE	179	54
-					CONTRACT	NO. 64	4P41
SHEETS	STA.	TO STA.		ILLINOIS FED. A	ID PROJECT		

				HORIZONTAL	CONTROL	POINTS	
POINT	NORTH	EAST	ELEVATION	CHAIN	STATION	OFFSET	DESCRIPTION
1	1849919.0910	2426782.8650	643.8950	IL40	584+04.32	25.1585' RT	TOPO SURVEY POINT, PIN
2	1849238.9530	2426738.7260	644.2524	IL40	577+24.23	19.658' LT	TOPO SURVEY POINT, PIN
3	1832262.3150	2426800.0360	644.8118	IL40	407+47.55	21.6968' RT	TOPO SURVEY POINT, PIN
4	1831643,2850	2426758,9230	645.9132	IL40	401+28.53	19.6005 LT	TOPO SURVEY POINT, PIN
5	1823960.9810	2426801.2330	647.7322	IL40	324+46.21	20.4221' RT	TOPO SURVEY POINT, PIN
6	1823573.9920	2426759.8080	647.4163	IL40	320+59.23	21.1181' LT	TOPO SURVEY POINT, PIN
7	1813995.9390	2426888.9950	647.0619	IL40	224+80.57	20.1421' LT	TOPO SURVEY POINT, PIN
8	1813290,9720	2426939,5900	646.9637	IL40	217+74.97	20.7204 RT	X-SECTION SURVEY POINT, PIN
9	1807247.2190	2426980.2300	646.0209	IL40	157+31.23	22.0403' LT	TOPO SURVEY POINT, PIN
10	1806344.4230	2427034.8560	645.6718	IL40	148+27.77	20.123' RT	TOPO SURVEY POINT, PIN
11	1796027.2520	2427180.6030	640.8764	IL40	45+09.55	19.6332' RT	TOPO SURVEY POINT, PIN
12	1795049.8880	2427143.6940	646.4870	IL40	35+32.83	31.5799' LT	TOPO SURVEY POINT, PIN
13	1793985,5890	2427170,9380	640.6769	IL40	24+68.25	19.9196' LT	TOPO SURVEY POINT, PIN
14	1793405.1100	2427219.9000	640.5825	IL40	18+87.11	20.5393 RT	TOPO SURVEY POINT, PIN
15	1790846,8610	2427673,9490	639.7564	IL40	OUT OF CHAIN		TOPO SURVEY POINT, PIN
16	1790283.1220	2427726.0120	640.1204	IL40	OUT OF CHAIN		TOPO SURVEY POINT, PIN
17	1787004,9480	2427730.8600	638,1175	IL40	OUT OF CHAIN		TOPO SURVEY POINT, PIN
18	1786259.2370	2427782.3390	637.2386	IL40	OUT OF CHAIN		TOPO SURVEY POINT, PIN
WHI10	1794633,8830	2427151,3780	640.3413	IL40	31+16.76	29,9868' LT	DISK, TOPO SURVEY POINT
WHI40	1828353.5780	2426828.9590	649.0291	IL40	368+38.80	49.456' RT	DISK, TOPO SURVEY POINT

				SURVEY	WORK POI	NTS	
POINT	NORTH	EAST	ELEVATION	CHAIN	STATION	OFFSET	DESCRIPTION
MF1133	1847710.7100	2428164.7700	644.0300	IL40	561+94.56	1404.8628' RT	NGS MONUMENT, PERM. SURVEY MARKER
WES100	1806856.7210	2426976.7760	645.0690	IL40	153+40.82	30.8824 LT	TOPO SURVEY POINT, NAIL
WES101	1806921.1440	2427053.0380	647.1820	IL40	154+04.18	46.2613' RT	TOPO SURVEY POINT, NAIL
WES110	1795323.4340	2427243.3880	647.4010	IL40	38+04.89	72.108' RT	TRAVERSE SURVEY POINT, NAIL
WES111	1790522.4250	2427633.0920	637.9610	IL40	OUT OF CHAIN		TRAVERSE SURVEY POINT, NAIL
WES112	1790560,5060	2427758,4420	637.7380	IL40	OUT OF CHAIN		TRAVERSE SURVEY POINT, NAIL

USER NAME = Brad-Cushman	DESIGNED -	REVISED -					IL 4	0			F A P RTE	SECTION	COUNTY	TOTAL SHEET SHEETS NO.
	DRAWN -	REVISED -	STATE OF ILLINOIS		HORIZO	NTAL A		ERTICAL	CONTRO	1	646	(101, 102, 135)RS	WHITESIDE	179 55
PLOT SCALE = 100.0000 / in.	CHECKED -	REVISED -	DEPARTMENT OF TRANSPORTATION		nonizo			LITICAL	CONTRO				CONTRAC	T NO. 64P41
PLOT DATE = Aug-24-2023 11:09:43 AM	DATE -	REVISED -		SCALE:	SHEET	OF	SHE	ETS STA.		TO STA.		ILLINOIS FEE	AID PROJECT	

				BEN	ICH MARKS		
POINT	NORTH	EAST	ELEVATION	CHAIN	STATION	OFFSET	DESCRIPTION
400	1852171.2130	2426824.2310	669.4630	IL40	606+56.79	45.9101' RT	VERTICAL CONTROL STATION, VERTICAL CONTROL STATION
401	1849628,1080	2426729.0900	639,3419	IL40	581+13.39	28,9064' LT	VERTICAL CONTROL STATION, HEADWALL
405	1824038.7510	2426747.9870	646.3820	IL40	325+24.00	32.8008' LT	VERTICAL CONTROL STATION, HEADWALL
407	1813632.2980	2426897.1770	650.7466	IL40	221+16.85	16.9787' LT	VERTICAL CONTROL STATION, BRIDGE HEADWALL
409	1806893.7920	2426988.0600	651.4957	IL40	153+77.73	19.0879' LT	VERTICAL CONTROL STATION, BRIDGE HEADWALL
411	1795261.7610	2427152,7250	649.6956	IL40	37+44.55	19.4482' LT	VERTICAL CONTROL STATION, BRIDGE HEADWALL
413	1793669.6260	2427219.2980	638.7346	IL40	21+51.61	23.8097' RT	VERTICAL CONTROL STATION, HEADWALL
415	1790519.9500	2427726.7560	638.2024	IL40	OUT OF CHAIN		VERTICAL CONTROL STATION, HEADWALL
417	1786798.2610	2427720.4150	635.0339	IL40	OUT OF CHAIN		VERTICAL CONTROL STATION, HEADWALL
450	1846872.3850	2426719.9620	648.1927	IL40	553+57.68	40.7796' LT	VERTICAL CONTROL STATION, R.O.W. MARKER
451	1843891.5280	2426804.2320	650.8790	IL40	523+76.70	38.6861'RT	VERTICAL CONTROL STATION, POWER POLE
452	1841556.3730	2426809.8400	652.3246	IL40	500+41.53	39.4838' RT	VERTICAL CONTROL STATION, R.O.W. MARKER
453	1820534,5140	2426780.0460	649.8963	IL40	290+20.03	38.8559' LT	VERTICAL CONTROL STATION, POWER POLE
454	1817243.9040	2426826.1530	654.8572	IL40	257+29.09	38.1599' LT	VERTICAL CONTROL STATION, POWER POLE
455	1810031.4890	2426924.6940	647.9084	IL40	185+16.00	39.1513' LT	VERTICAL CONTROL STATION, POWER POLE
456	1802543.1580	2427027.8740	648.4383	IL40	110+26.96	39.3114' LT	VERTICAL CONTROL STATION, POWER POLE
457	1799285,5020	2427088,7690	642,5336	IL40	77+68.80	24,492' LT	VERTICAL CONTROL STATION, HEADWALL
458	1783218.9320	2427861.5880	643.1505	IL40	OUT OF CHAIN		VERTICAL CONTROL STATION, BOLT
461	1831935.7090	2426757.4430	646.6010	IL40	404+20.95	20.9934' LT	VERTICAL CONTROL STATION, HEADWALL
462	1835074.0770	2426823.9520	643.6410	IL40	435+59.30	46.45' RT	VERTICAL CONTROL STATION, HEADWALL
463	1838885.0860	2426735.0580	658.5467	IL40	473+70.41	40.8006' LT	VERTICAL CONTROL STATION, R.O.W. MARKER

				APPARENT P	ROPERTY C	ORNERS	
POINT	NORTH	EAST	ELEVATION	CHAIN	STATION	OFFSET	DESCRIPTION
WES700	1794201.7670	2427257.2530	637.7840	IL40	26+83.14	69.5509'RT	PROPERTY CORNER, PIN


USER NAME = Brad.Cushman	DESIGNED -	REVISED -					IL 40		F A P RTE	SECTION	COUNTY	TOTAL SHEETS	HEET NO.
	DRAWN -	REVISED -	STATE OF ILLINOIS			-	VERTICAL CONT	BOI	646	(101, 102, 135)RS	WHITESIDE	179	56
PLOT SCALE = 100.0000 / in	CHECKED -	REVISED -	DEPARTMENT OF TRANSPORTATION		Πυκιζι	JNIAL 0	VENIIGAL GUNI	RUL			CONTRAC	T NO. 64	241
PLOT DATE = Aug-24-2023 11:10:01 AM	DATE -	REVISED -		SCALE:	SHEET	OF	SHEETS STA.	TO STA.		ILLINOIS FE	D. AID PROJECT		


501 1 502 1 503 1 504 1 505 1 506 1 507 1 508 1 509 1 510 1 511 1 512 1 513 1 514 1 515 1 516 1 517 1 518 1 519 1 520 1	NORTH 1852168.5390 1852161.6450 1852170.2830 1849926.5400 1849947.1510 1849947.1510 1849628.2010 1849628.2010 1849239.2180 1849239.2180 1849240.1300 1849313.8550 1841554.9710 1841554.9710 1841598.8740 1832262.6260 1832268.0980 1832335.8860 1831642.9320	EAST 2426816.9090 2426830.5890 2426813.4700 2426783.9320 2426783.9320 2426770.5170 2426738.6200 2426718.1680 2426719.1630 2426742.6780 2426742.6780 2426795.510 2426797.5810 2426797.5810 2426794.0770 2426809.2130 2426818.6290	CHAIN IL40	STATION 606+54.12 606+54.12 606+55.87 584+11.74 584+32.38 584+04.47 581+13.47 581+91.01 577+24.49 577+25.42 577+99.15 500+40.18 499+44.13 500+84.20	TIES 38.5855' RT 32.2587' RT 35.1482' RT 35.1482' RT 26.2535' RT 12.8106' RT 19.3763' LT 39.751' LT 15.7058' LT 39.2199' LT 38.2544' LT 15.959' RT 27.0242' RT	DESCRIPTION DROP INLET LIGHT POLE EDGE OF LANES - RT. MANHOLE ENTRANCE - FIELD EDGE OF LANES - RT. PAVEMENT EDGE RIGHT POWER POLE PAVEMENT EDGE RIGHT FENCE POWER POLE PAVEMENT EDGE RIGHT				
500 1 501 1 502 1 503 1 504 1 505 1 506 1 506 1 507 1 508 1 509 1 510 1 511 1 512 1 513 1 514 1 515 1 516 1 517 1 518 1 519 1 520 1	1852168.5390 1852161.6450 1852170.2830 1849926.5400 1849947.1510 1849947.1510 1849919.2320 1849628.2010 1849705.7140 1849239.2180 1849240.1300 1849313.8550 1841554.9710 1841598.8740 1832262.6260 1832335.8860 1831642.9320	2426816.9090 2426830.5890 2426813.4700 2426808.6290 2426783.9320 2426770.5170 2426738.6200 2426718.1680 2426719.1630 2426719.1630 2426790.0550 2426797.5810 2426797.5810 2426797.5810 2426791.4900 2426794.0770 2426809.2130	CHAIN IL40	STATION 606+54.12 606+47.21 606+55.87 584+11.74 584+32.38 584+04.47 581+13.47 581+91.01 577+24.49 577+25.42 577+99.15 500+40.18 499+44.13 500+84.20	OFFSET 38.5855' RT 52.2587' RT 35.1482' RT 50.9299' RT 26.2535' RT 12.8106' RT 19.3763' LT 39.751' LT 15.7058' LT 39.2199' LT 38.2544' LT	DROP INLET LIGHT POLE EDGE OF LANES - RT. MANHOLE ENTRANCE - FIELD EDGE OF LANES - RT. PAVEMENT EDGE RIGHT POWER POLE PAVEMENT EDGE RIGHT FENCE POWER POLE PAVEMENT EDGE RIGHT				
500 1 501 1 502 1 503 1 504 1 505 1 506 1 507 1 508 1 509 1 510 1 511 1 512 1 513 1 514 1 515 1 516 1 517 1 518 1 519 1 520 1	1852168.5390 1852161.6450 1852170.2830 1849926.5400 1849947.1510 1849947.1510 1849919.2320 1849628.2010 1849705.7140 1849239.2180 1849240.1300 1849313.8550 1841554.9710 1841598.8740 1832262.6260 1832335.8860 1831642.9320	2426816.9090 2426830.5890 2426813.4700 2426808.6290 2426783.9320 2426770.5170 2426738.6200 2426718.1680 2426719.1630 2426719.1630 2426790.0550 2426797.5810 2426797.5810 2426797.5810 2426791.4900 2426794.0770 2426809.2130	CHAIN IL40	STATION 606+54.12 606+47.21 606+55.87 584+11.74 584+32.38 584+04.47 581+13.47 581+91.01 577+24.49 577+25.42 577+99.15 500+40.18 499+44.13 500+84.20	OFFSET 38.5855' RT 52.2587' RT 35.1482' RT 50.9299' RT 26.2535' RT 12.8106' RT 19.3763' LT 39.751' LT 15.7058' LT 39.2199' LT 38.2544' LT	DROP INLET LIGHT POLE EDGE OF LANES - RT. MANHOLE ENTRANCE - FIELD EDGE OF LANES - RT. PAVEMENT EDGE RIGHT POWER POLE PAVEMENT EDGE RIGHT FENCE POWER POLE PAVEMENT EDGE RIGHT				
500 1 501 1 502 1 503 1 504 1 505 1 506 1 507 1 508 1 509 1 510 1 511 1 512 1 513 1 514 1 515 1 516 1 517 1 518 1 519 1 520 1	1852168.5390 1852161.6450 1852170.2830 1849926.5400 1849947.1510 1849947.1510 1849919.2320 1849628.2010 1849705.7140 1849239.2180 1849240.1300 1849313.8550 1841554.9710 1841598.8740 1832262.6260 1832335.8860 1831642.9320	2426816.9090 2426830.5890 2426813.4700 2426808.6290 2426783.9320 2426770.5170 2426738.6200 2426718.1680 2426719.1630 2426719.1630 2426790.0550 2426797.5810 2426797.5810 2426797.5810 2426791.070 2426809.2130 2426818.6290	CHAIN IL40	STATION 606+54.12 606+47.21 606+55.87 584+11.74 584+32.38 584+04.47 581+13.47 581+91.01 577+24.49 577+25.42 577+99.15 500+40.18 499+44.13 500+84.20	OFFSET 38.5855' RT 52.2587' RT 35.1482' RT 50.9299' RT 26.2535' RT 12.8106' RT 19.3763' LT 39.751' LT 15.7058' LT 39.2199' LT 38.2544' LT	DROP INLET LIGHT POLE EDGE OF LANES - RT. MANHOLE ENTRANCE - FIELD EDGE OF LANES - RT. PAVEMENT EDGE RIGHT POWER POLE PAVEMENT EDGE RIGHT FENCE POWER POLE PAVEMENT EDGE RIGHT				
500 1 501 1 502 1 503 1 504 1 505 1 506 1 507 1 508 1 509 1 510 1 511 1 512 1 513 1 514 1 515 1 516 1 517 1 518 1 519 1 520 1	1852168.5390 1852161.6450 1852170.2830 1849926.5400 1849947.1510 1849947.1510 1849919.2320 1849628.2010 1849705.7140 1849239.2180 1849240.1300 1849313.8550 1841554.9710 1841598.8740 1832262.6260 1832335.8860 1831642.9320	2426816.9090 2426830.5890 2426813.4700 2426808.6290 2426783.9320 2426770.5170 2426738.6200 2426718.1680 2426719.1630 2426719.1630 2426790.0550 2426797.5810 2426797.5810 2426797.5810 2426791.070 2426809.2130 2426818.6290	IL40	606+54.12 606+47.21 606+55.87 584+11.74 584+32.38 584+04.47 581+13.47 581+91.01 577+24.49 577+25.42 577+99.15 500+40.18 499+44.13 500+84.20	38.5855' RT 52.2587' RT 35.1482' RT 50.9299' RT 26.2535' RT 12.8106' RT 19.3763' LT 39.751' LT 15.7058' LT 39.2199' LT 38.2544' LT	DROP INLET LIGHT POLE EDGE OF LANES - RT. MANHOLE ENTRANCE - FIELD EDGE OF LANES - RT. PAVEMENT EDGE RIGHT POWER POLE PAVEMENT EDGE RIGHT FENCE POWER POLE PAVEMENT EDGE RIGHT				
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502 1 503 1 504 1 505 1 506 1 507 1 508 1 509 1 510 1 511 1 512 1 513 1 514 1 515 1 516 1 517 1 518 1 519 1 520 1	1852170.2830 1849926.5400 1849947.1510 1849919.2320 1849628.2010 1849705.7140 1849239.2180 1849240.1300 1849313.8550 1841554.9710 1841598.8740 1832262.6260 1832335.8860 1831642.9320	2426813.4700 2426808.6290 2426783.9320 2426770.5170 2426738.6200 2426718.1680 2426718.1680 2426719.1630 2426720.0550 2426720.0550 2426786.3180 2426797.5810 2426791.4900 2426791.4900 2426809.2130 2426818.6290	IL40	606+55.87 584+11.74 584+32.38 584+04.47 581+13.47 581+91.01 577+24.49 577+25.42 577+99.15 500+40.18 499+44.13 500+84.20	35.1482' RT 50.9299' RT 26.2535' RT 12.8106' RT 19.3763' LT 39.751' LT 15.7058' LT 39.2199' LT 38.2544' LT 15.959' RT	EDGE OF LANES - RT. MANHOLE ENTRANCE - FIELD EDGE OF LANES - RT. PAVEMENT EDGE RIGHT POWER POLE PAVEMENT EDGE RIGHT FENCE POWER POLE PAVEMENT EDGE RIGHT				
503 1 504 1 505 1 506 1 507 1 508 1 509 1 510 1 511 1 512 1 513 1 514 1 515 1 516 1 517 1 518 1 519 1 520 1	1849926.5400 1849947.1510 1849919.2320 1849628.2010 1849705.7140 1849239.2180 1849240.1300 1849313.8550 1841554.9710 1841598.8740 1832262.6260 1832335.8860 1831642.9320	2426808.6290 2426783.9320 2426770.5170 2426738.6200 2426738.6200 2426742.6780 2426742.6780 2426719.1630 2426720.0550 2426786.3180 2426797.5810 2426797.5810 2426791.0770 2426809.2130 2426818.6290	IL40	584+11.74 584+32.38 584+04.47 581+13.47 581+91.01 577+24.49 577+25.42 577+99.15 500+40.18 499+44.13 500+84.20	50.9299' RT 26.2535' RT 12.8106' RT 19.3763' LT 39.751' LT 15.7058' LT 39.2199' LT 38.2544' LT 15.959' RT	MANHOLE ENTRANCE - FIELD EDGE OF LANES - RT. PAVEMENT EDGE RIGHT POWER POLE PAVEMENT EDGE RIGHT FENCE POWER POLE PAVEMENT EDGE RIGHT				
504 1 505 1 506 1 507 1 508 1 509 1 510 1 511 1 512 1 513 1 514 1 515 1 516 1 517 1 518 1 519 1 520 1 521 1	1849947.1510 1849919.2320 1849628.2010 1849705.7140 1849239.2180 1849240.1300 1849313.8550 1841554.9710 1841598.8740 1832262.6260 1832335.8860 1831642.9320	2426783.9320 2426770.5170 2426738.6200 2426718.1680 2426712.6780 2426719.1630 2426720.0550 2426786.3180 2426797.5810 2426797.5810 2426791.4900 2426794.0770 2426809.2130 2426818.6290	IL40	584+32.38 584+04.47 581+13.47 581+91.01 577+24.49 577+25.42 577+99.15 500+40.18 499+44.13 500+84.20	26.2535' RT 12.8106' RT 19.3763' LT 39.751' LT 15.7058' LT 39.2199' LT 38.2544' LT 15.959' RT	ENTRANCE - FIELD EDGE OF LANES - RT. PAVEMENT EDGE RIGHT POWER POLE PAVEMENT EDGE RIGHT FENCE POWER POLE PAVEMENT EDGE RIGHT				
505 1 506 1 507 1 508 1 509 1 510 1 511 1 512 1 513 1 514 1 515 1 516 1 518 1 519 1 520 1 521 1	1849919.2320 1849628.2010 1849705.7140 1849239.2180 1849240.1300 1849313.8550 1841554.9710 1841558.9410 1832262.6260 1832335.8860 1831642.9320	2426770.5170 2426738.6200 2426718.1680 2426742.6780 2426719.1630 2426720.0550 2426786.3180 2426797.5810 2426731.4900 2426731.4900 2426809.2130 2426818.6290	IL40	584+04.47 581+13.47 581+91.01 577+24.49 577+25.42 577+99.15 500+40.18 499+44.13 500+84.20	12.8106' RT 19.3763' LT 39.751' LT 15.7058' LT 39.2199' LT 38.2544' LT 15.959' RT	EDGE OF LANES - RT. PAVEMENT EDGE RIGHT POWER POLE PAVEMENT EDGE RIGHT FENCE POWER POLE PAVEMENT EDGE RIGHT				
506 1 507 1 508 1 509 1 510 1 511 1 512 1 513 1 514 1 515 1 516 1 517 1 518 1 520 1 521 1	1849628.2010 1849705.7140 1849239.2180 1849240.1300 1849313.8550 1841554.9710 1841458.9410 1832262.6260 1832268.0980 1832335.8860 1831642.9320	2426738.6200 2426718.1680 2426742.6780 2426719.1630 2426720.0550 2426786.3180 2426797.5810 2426797.5810 2426791.4900 2426794.0770 2426809.2130 2426818.6290	IL40	581+13.47 581+91.01 577+24.49 577+25.42 577+99.15 500+40.18 499+44.13 500+84.20	19.3763' LT 39.751' LT 15.7058' LT 39.2199' LT 38.2544' LT 15.959' RT	PAVEMENT EDGE RIGHT POWER POLE PAVEMENT EDGE RIGHT FENCE POWER POLE PAVEMENT EDGE RIGHT				
507 1 508 1 509 1 510 1 511 1 512 1 513 1 514 1 515 1 516 1 517 1 518 1 520 1 521 1	1849705.7140 1849239.2180 1849240.1300 1849313.8550 1841554.9710 1841458.9410 1842262.6260 1832268.0980 183235.8860 1831642.9320	2426718.1680 2426742.6780 2426719.1630 2426720.0550 2426786.3180 2426797.5810 2426791.4900 2426794.0770 2426809.2130 2426818.6290	IL40	581+91.01 577+24.49 577+25.42 577+99.15 500+40.18 499+44.13 500+84.20	39.751' LT 15.7058' LT 39.2199' LT 38.2544' LT 15.959' RT	POWER POLE PAVEMENT EDGE RIGHT FENCE POWER POLE PAVEMENT EDGE RIGHT	-			
508 1 509 1 510 1 511 1 512 1 513 1 514 1 515 1 516 1 517 1 518 1 519 1 520 1	1849239.2180 1849240.1300 1849313.8550 1841554.9710 1841458.9410 1841598.8740 1832262.6260 1832335.8860 1831642.9320	2426742.6780 2426719.1630 2426720.0550 2426786.3180 2426797.5810 2426731.4900 2426731.4900 2426809.2130 2426818.6290	IL40 IL40 IL40 IL40 IL40 IL40 IL40 IL40	577+24.49 577+25.42 577+99.15 500+40.18 499+44.13 500+84.20	15.7058' LT 39.2199' LT 38.2544' LT 15.959' RT	PAVEMENT EDGE RIGHT FENCE POWER POLE PAVEMENT EDGE RIGHT				
509 1 510 1 511 1 512 1 513 1 514 1 515 1 516 1 517 1 518 1 519 1 520 1 521 1	1849240.1300 1849313.8550 1841554.9710 1841458.9410 1841598.8740 1832262.6260 1832268.0980 1832335.8860 1831642.9320	2426719.1630 2426720.0550 2426786.3180 2426797.5810 2426731.4900 2426794.0770 2426809.2130 2426818.6290	IL40 IL40 IL40 IL40 IL40 IL40 IL40	577+25.42 577+99.15 500+40.18 499+44.13 500+84.20	39.2199' LT 38.2544' LT 15.959' RT	FENCE POWER POLE PAVEMENT EDGE RIGHT	-			
510 1 511 1 512 1 513 1 514 1 515 1 516 1 517 1 518 1 519 1 520 1 521 1	1849313.8550 1841554.9710 1841458.9410 1841598.8740 1832262.6260 1832268.0980 1832335.8860 1831642.9320	2426720.0550 2426786.3180 2426797.5810 2426731.4900 2426794.0770 2426809.2130 2426818.6290	IL40 IL40 IL40 IL40 IL40	577+99.15 500+40.18 499+44.13 500+84.20	38.2544' LT 15.959' RT	POWER POLE PAVEMENT EDGE RIGHT	-			
511 1 512 1 513 1 514 1 515 1 516 1 517 1 518 1 519 1 520 1 521 1	1841554.9710 1841458.9410 1841598.8740 1832262.6260 1832268.0980 1832335.8860 1831642.9320	2426786.3180 2426797.5810 2426731.4900 2426794.0770 2426809.2130 2426818.6290	IL40 IL40 IL40 IL40	500+40.18 499+44.13 500+84.20	15.959' RT	PAVEMENT EDGE RIGHT	4			
512 1 513 1 514 1 515 1 516 1 517 1 518 1 519 1 520 1 521 1	1841458.9410 1841598.8740 1832262.6260 1832268.0980 1832335.8860 1831642.9320	2426797.5810 2426731.4900 2426794.0770 2426809.2130 2426818.6290	IL40 IL40 IL40	499+44.13 500+84.20			4			
513 1 514 1 515 1 516 1 517 1 518 1 519 1 520 1 521 1	1841598.8740 1832262.6260 1832268.0980 1832335.8860 1831642.9320	2426731.4900 2426794.0770 2426809.2130 2426818.6290	IL40 IL40	500+84.20	27.0242'RT	I				
514 1 515 1 516 1 517 1 518 1 519 1 520 1 521 1	1832262.6260 1832268.0980 1832335.8860 1831642.9320	2426794.0770 2426809.2130 2426818.6290	IL40	+	1	ENTRANCE - CENTERLINE	4			
515 1 516 1 517 1 518 1 519 1 520 1 521 1	1832268.0980 1832335.8860 1831642.9320	2426809.2130 2426818.6290			38.7784' LT	POWER POLE	4			
516 1 517 1 518 1 519 1 520 1 521 1	1832335.8860 1831642.9320	2426818.6290	IL40	407+47.86	15.7379' RT	PAVEMENT EDGE RIGHT	4			
i17 1 i18 1 i19 1 i20 1 i21 1	1831642,9320			407+53.33	30.8755' RT	PIPE CULVERT	4			
518 1 519 1 520 1 521 1		2426762 1770	IL40	408+21.11	40.3117' RT	FENCE POST	4			
19 1 20 1 21 1	1001705 4000		IL40	401+28.17	16.3466 LT	PAVEMENT EDGE RIGHT	4			
520 1 521 1	1831735.4900	2426738.8360	IL40	402+20.74	39.6601' LT	POWER POLE	4			
521 1	1831565.7330	2426739.5450	IL40	400+50.98	39.0016' LT	POWER POLE	4			
	1823960.9220	2426796.6060	IL40	324+46.15	15.7951' RT	PAVEMENT EDGE RIGHT	4			
522 1	1823913.4310	2426805.0950	IL40	323+98.66	24.2699' RT	MAILBOX	4			
	1823956.7360	2426742.3570	IL40	324+41.98	38.4552 LT	POWER POLE	4			
	1824039.3370	2426764.7200	IL40	325+24.58	16.0676' LT	PAVEMENT EDGE RIGHT	4			
	1824120.4360	2426741.7340	IL40	326+05.68	39.0294' LT	POWER POLE	4			
	1823573.5980	2426764.9320	IL40	320+58.84	15.9943' LT	PAVEMENT EDGE RIGHT	4			
	1823641,9650	2426742.2400	IL40	321+27.21	38.6659' LT	POWER POLE	4			
	1823466.5950	2426742.1650	IL40	319+51.84	38.7931 LT	POWER POLE	4			
	1820534.2530	2426803.8430	IL40	290+19.44	15.0648' LT	PAVEMENT EDGE RIGHT	4			
	1820544.7620	2426774.8470	IL40	290+30.34	43.913' LT	SIGN	4			
	1820560.1510	2426779.6460	IL40	290+45.67	38.9021 LT	ROAD - CENTERLINE	4			
	1817243.4410	2426848.6870	IL40	257+28.32	15.6345 LT	PAVEMENT EDGE RIGHT	4			
	1817108.9760	2426836.6350	IL40	255+94.03	29.5408' LT	MAILBOX	4			
	1817111.4850	2426827.1770	IL40	255+96.67	38.9633' LT	POWER POLE PAVEMENT EDGE RIGHT	4			
	1813995.5170	2426893.8130	IL40	224+80.08	15.3304' LT		4			
	1813981.7870	2426873.8720 2426871.9750	IL40 IL40	224+66.63	35.4589' LT		4			
	1813944.1760			224+29.05	37.8747' LT	R.O.W. MARKER	4			
	1813290.8890 1813322.9110	2426934.6410 2426956.2390	IL40 IL40	217+74.96 218+06.68	15.7707' RT 37.8085' RT	PAVEMENT EDGE RIGHT ABOVE GROUND SPLICE BOX	4			
	1813322.9110	2426956.2390	IL40 IL40	218+06.68	37.8085 RT 38.8375 LT	POWER POLE	4			
		L		1	1		_			
T _	BEVICED	1						FAD		
	REVISED - REVISED -		STAT	E OF ILLINOIS				F.A.P. RTE. 646 (10	SECTION 01, 102, 135)RS	COUNTY TOTAL SHEETS WHITESIDE 179
F			DEPARTMENT	OF TRANSPOR	TATION	HORIZONTAL & VERTICAL CONTROL SCALE: SHEET OF SHEETS STA.	TO STA.	(10	ILLINOIS FED.	CONTRACT NO. 64


USER NAME = Brad.Cushman	DESIGNED -	REVISED -					IL 40
PLOT SCALE = 100.0000 / in.	DRAWN - CHECKED -	REVISED - REVISED -	STATE OF ILLINOIS DEPARTMENT OF TRANSPORTATION		HORIZO	ONTAL & \	VERTIC/
PLOT DATE = Aug-24-2023 11:10:21 AM	DATE -	REVISED -		SCALE:	SHEET	OF	SHEETS

				REFERENCE	E TIES	
POINT	NORTH	EAST	CHAIN	STATION	OFFSET	DESCRIPTION
540	1810033.0520	2426948.1720	IL40	185+17.24	15.654' LT	PAVEMENT EDGE RIGHT
541	1810026.7230	2426933.3020	IL40	185+11.12	30.6099' LT	PIPE CULVERT
542	1807247.3590	2426987.3380	IL40	157+31.27	14.931' LT	PAVEMENT EDGE RIGHT
543	1807193.9010	2426967.8230	IL40	156+78.09	35.1818' LT	PIPE CULVERT
544	1806456.6870	2427041.2340	IL40	149+39.93	28.0495' RT	SIGN
545	1806344.0350	2427030.3160	IL40	148+27.44	15.5781' RT	PAVEMENT EDGE RIGHT
546	1802545.0360	2427051,2480	IL40	110+28.52	15,9137' LT	PAVEMENT EDGE RIGHT
547	1802640.9510	2427042.6720	IL40	111+24.54	23.1654' LT	MAILBOX
548	1799286.0680	2427097.0860	IL40	77+69.24	16.1676'LT	PAVEMENT EDGE RIGHT
549	1799341.1560	2427067.4290	IL40	78+24.76	45.015' LT	POWER POLE
550	1796027.6130	2427188.8770	IL40	45+09.79	27.9116' RT	SIGN
551	1796027.1740	2427176.5830	IL40	45+09.53	15.6125' RT	PAVEMENT EDGE RIGHT
552	1795049.7890	2427155,5440	IL40	35+32.56	19.7326' LT	BACK OF CURB
553	1795058.7620	2427155.7650	IL40	35+41.53	19.3803' LT	CATCH BASIN GRATE
554	1793985.4130	2427174.8330	IL40	24+68.02	16.0275' LT	PAVEMENT EDGE RIGHT
555	1794143.2730	2427164.4590	IL40	26+26.01	24.0895' LT	MAILBOX
556	1793669.1510	2427211.0320	IL40	21+51.26	15.5377' RT	PAVEMENT EDGE RIGHT
557	1793673.4900	2427264.0730	IL40	21+54.82	68.6365' RT	POWER POLE
558	1793493.6430	2427269.5160	IL40	19+74.91	71.4461 RT	POWER POLE
559	1793404.7530	2427214.5870	IL40	18+86.84	15.2217' RT	PAVEMENT EDGE RIGHT
560	1793314.8300	2427274.5490	IL40	17+96.04	73.8608' RT	ABOVE GROUND SPLICE BOX
561	1790847.3040	2427680.2930	3P_IL40_BUREAU	1275+66.77	15.8963' LT	PAVEMENT EDGE RIGHT
562	1790804.8620	2427611.8700	3P_IL40_BUREAU	1275+25.61	85.5282' LT	POWER POLE
563	1790519.7710	2427717.4180	3P_IL40_BUREAU	1272+38.39	15,9124' RT	PAVEMENT EDGE RIGHT
564	1790562.5680	2427727.0600	3P_IL40_BUREAU	1272+81.05	26.1519' RT	ENTRANCE - FIELD
565	1790283.1260	2427720.4870	3P_IL40_BUREAU	1270+01.72	15.6718' RT	PAVEMENT EDGE RIGHT
566	1790237.2720	2427637.2150	3P_IL40_BUREAU	1269+57.04	68.2332' LT	POWER POLE
567	1790057,2400	2427734,9690	3P_IL40_BUREAU	1267+75.66	26,9937' RT	SIGN
568	1787004.6400	2427736.0050	3P_IL40_BUREAU	1237+23.34	14.6576' LT	PAVEMENT EDGE RIGHT
569	1786954.5600	2427714.5800	3P_IL40_BUREAU	1236+73.57	36.7808' LT	PIPE CULVERT
570	1786947.3570	2427700.7670	3P_IL40_BUREAU	1236+66.56	50.6932' LT	ABOVE GROUND SPLICE BOX
571	1786795.4510	2427709.7250	3P_IL40_BUREAU	1235+14.54	43.8603' LT	WARNING SIGN
572	1786798.8280	2427738.3000	3P_IL40_BUREAU	1235+17.52	15.2408' LT	PAVEMENT EDGE RIGHT
573	1786258.9820	2427776.7640	3P_IL40_BUREAU	1229+77.19	15.6703' RT	PAVEMENT EDGE RIGHT
574	1786220.6340	2427800.5200	3P_IL40_BUREAU	1229+38.51	38.8877' RT	POWER POLE
575	1783227.6410	2427848.4800	3P_IL40_BUREAU	1199+45.14	44.9894' RT	PAVEMENT EDGE RIGHT
576	1783261.7800	2427835.8740	3P_IL40_BUREAU	1199+79.45	32.862' RT	STREET - SIGN
577	1783233.2170	2427869.0390	3P_IL40_BUREAU	1199+50.43	65.6244' RT	HANDHOLE


USER NAME = Brad.Cushman	DESIGNED -	REVISED -					L 40			F.A.P. BTE	SECTION	COUNTY TO	OTAL SHEET
	DRAWN -	REVISED -	STATE OF ILLINOIS							646	(101, 102, 135)RS	WHITESIDE	179 58
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PLOT DATE = Aug-24-2023 11:10:47 AM	DATE -	REVISED -		SCALE:	SHEET	OF	SHEETS	STA.	TO STA.		ILLINOIS FED.	AID PROJECT	

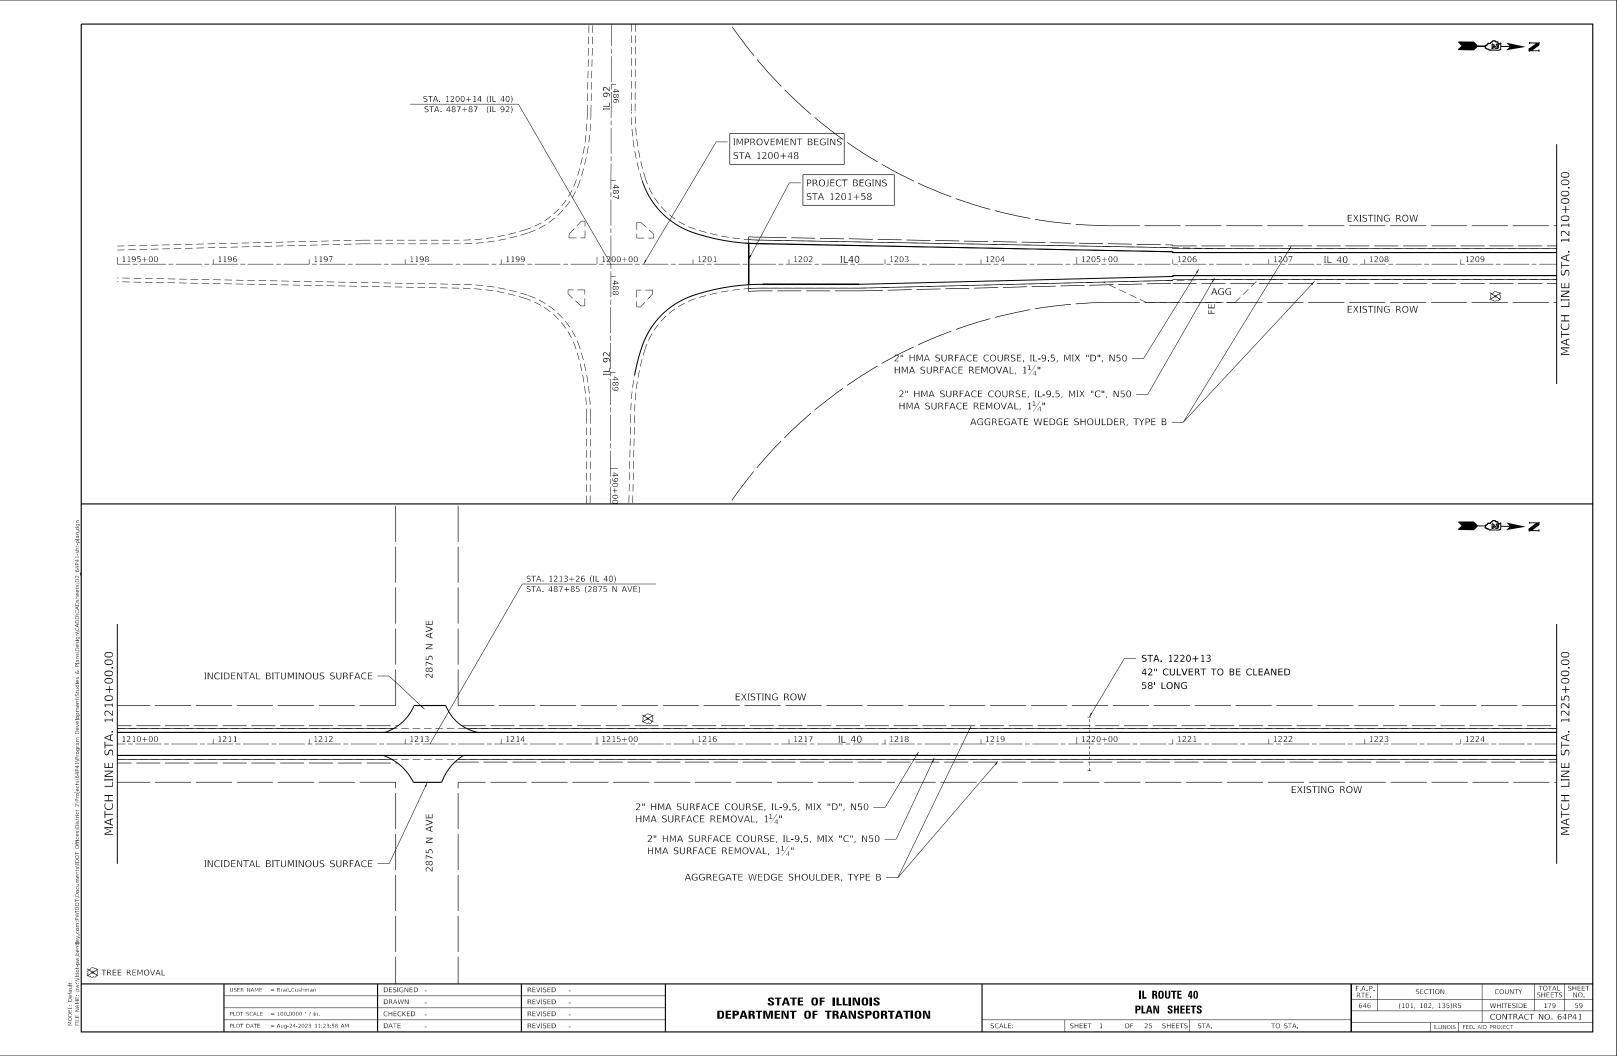


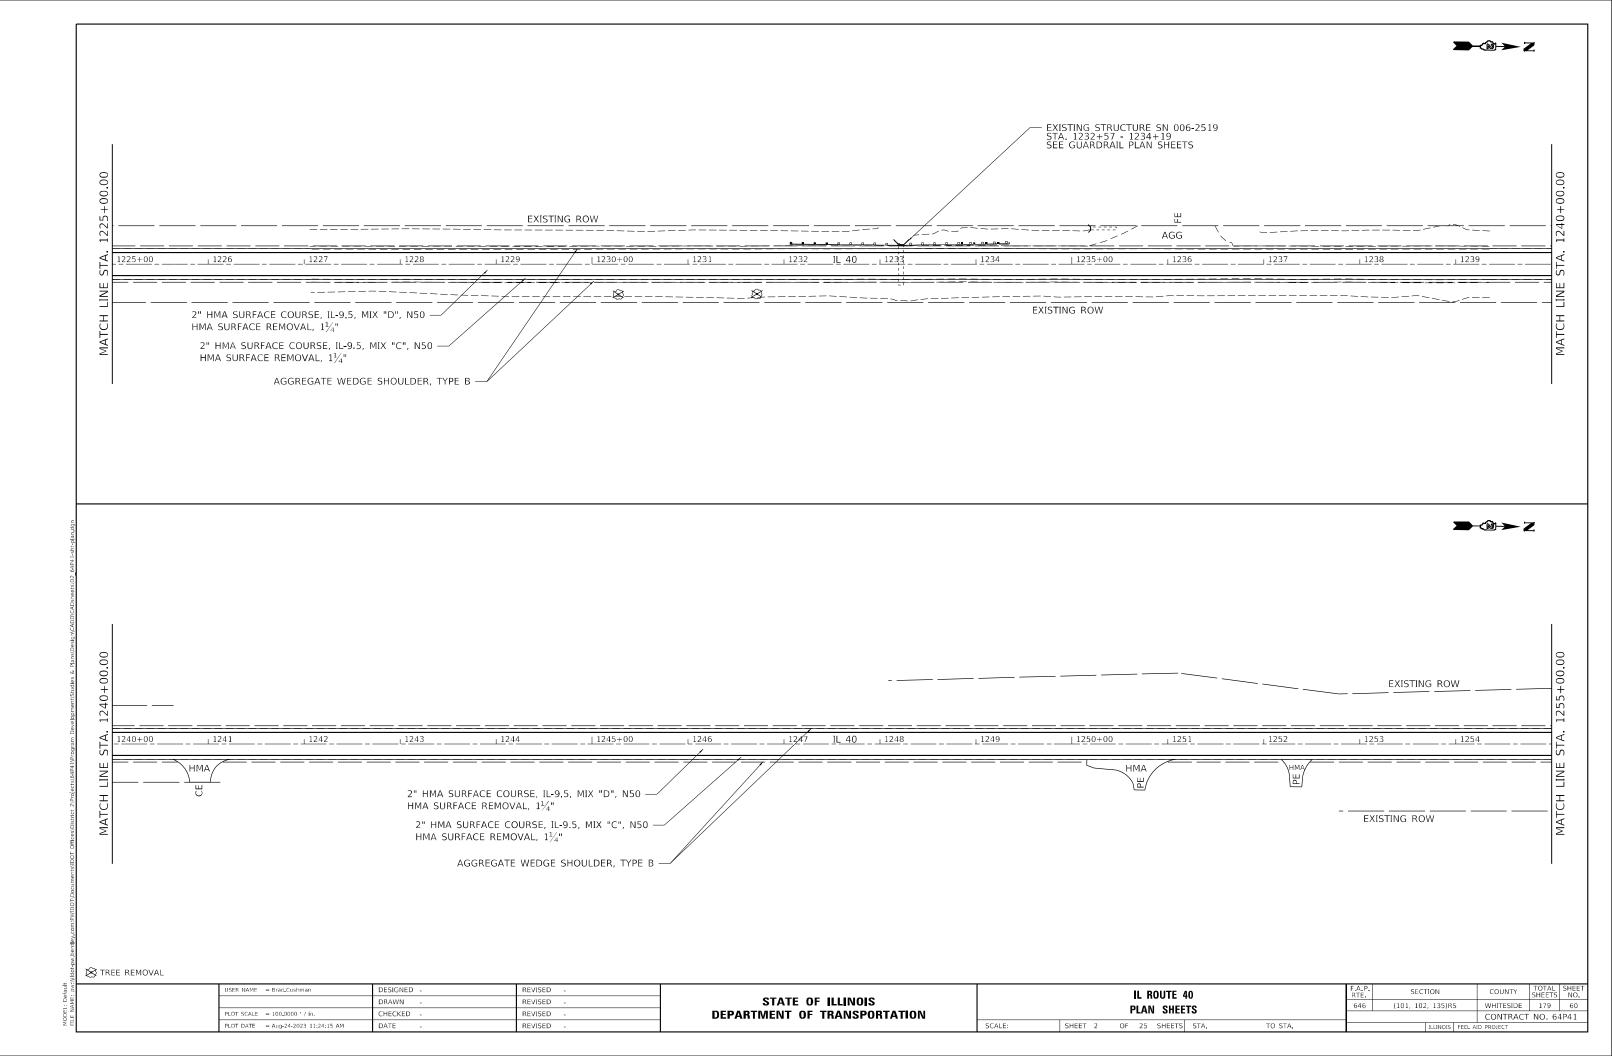


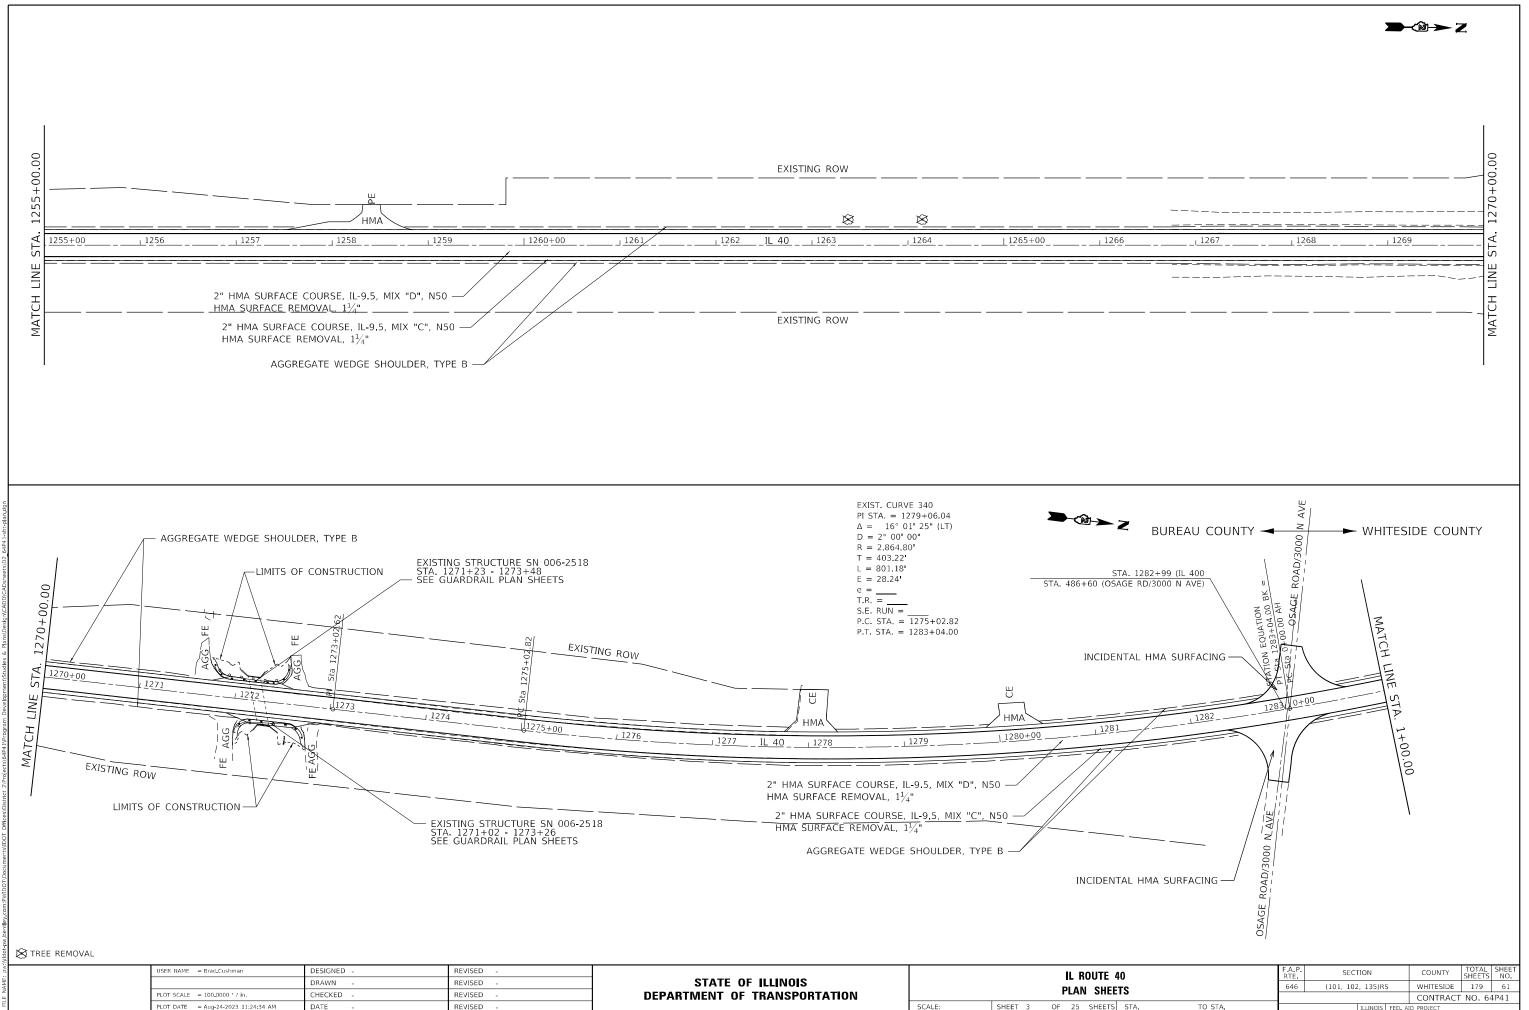



IL ROUTE 40		REVISED -	DESIGNED -	USER NAME = Brad.Cushman	
	STATE OF ILLINOIS	REVISED -	DRAWN -		
PLAN SHEET	DEPARTMENT OF TRANSPORTATION	REVISED -	CHECKED -	PLOT SCALE = 100.0000 / in.	
25 SHEETS	SCALE: SHEET 3 OF	REVISED -	DATE -	PLOT DATE = Aug-24-2023 11:24:34 AM	
	DEPARTMENT OF TRANSPORTATION	REVISED -	CHECKED -		

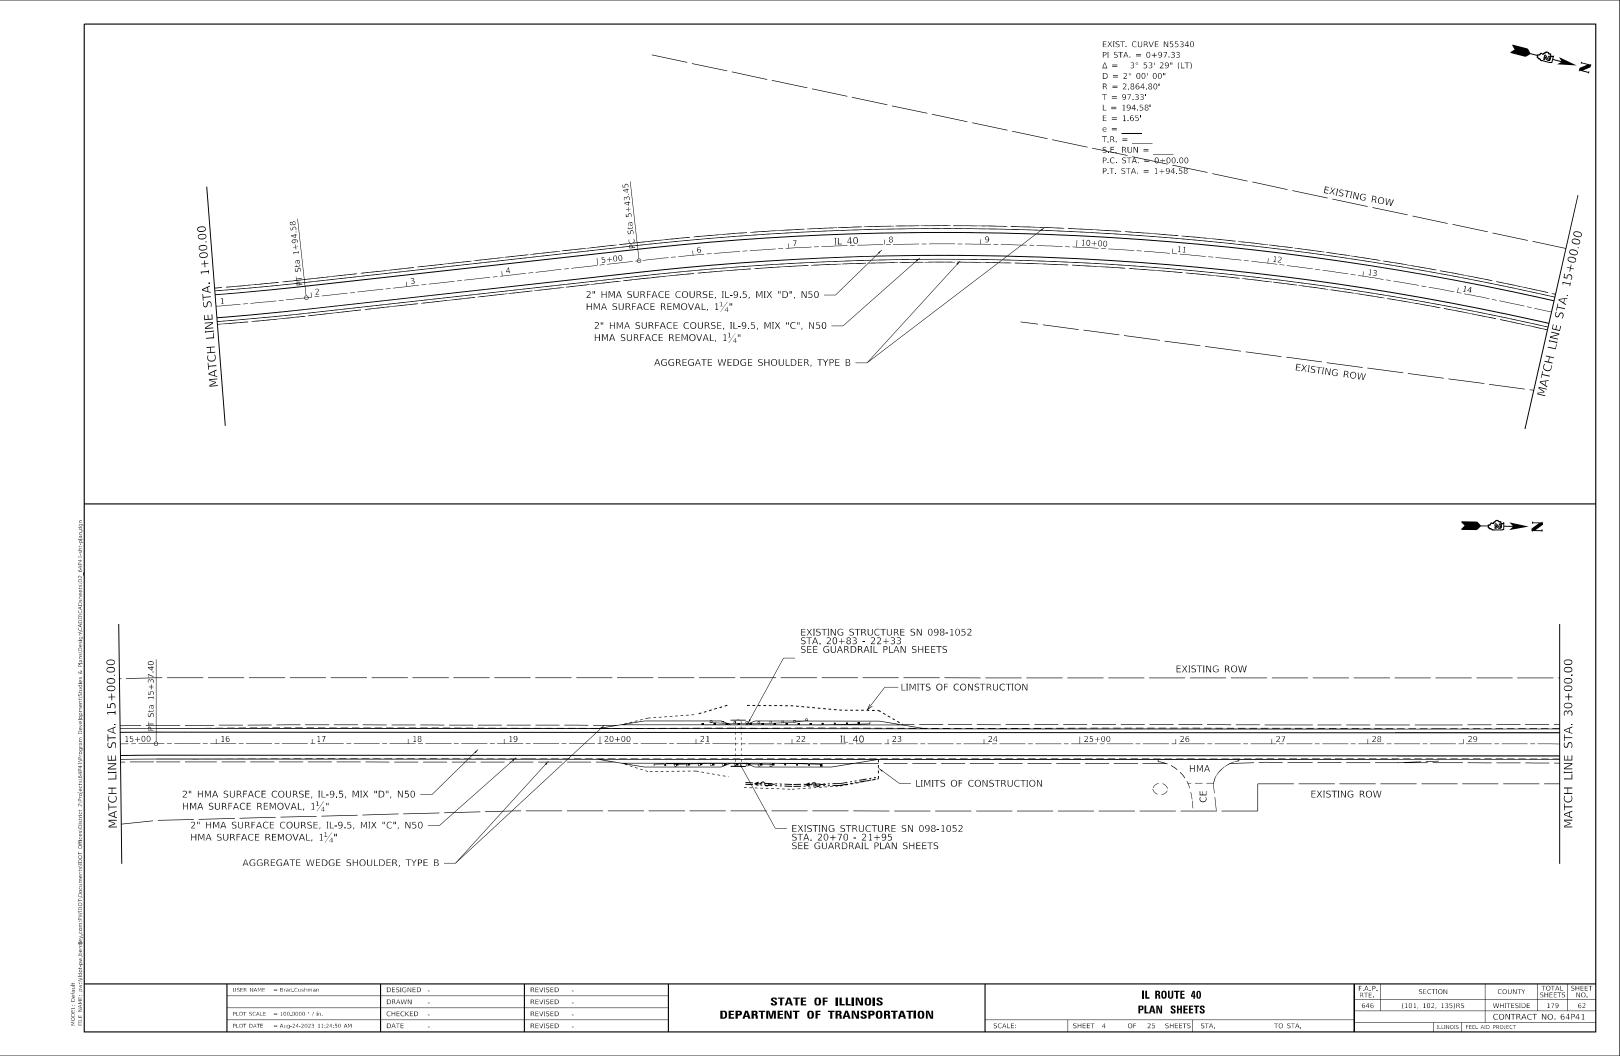


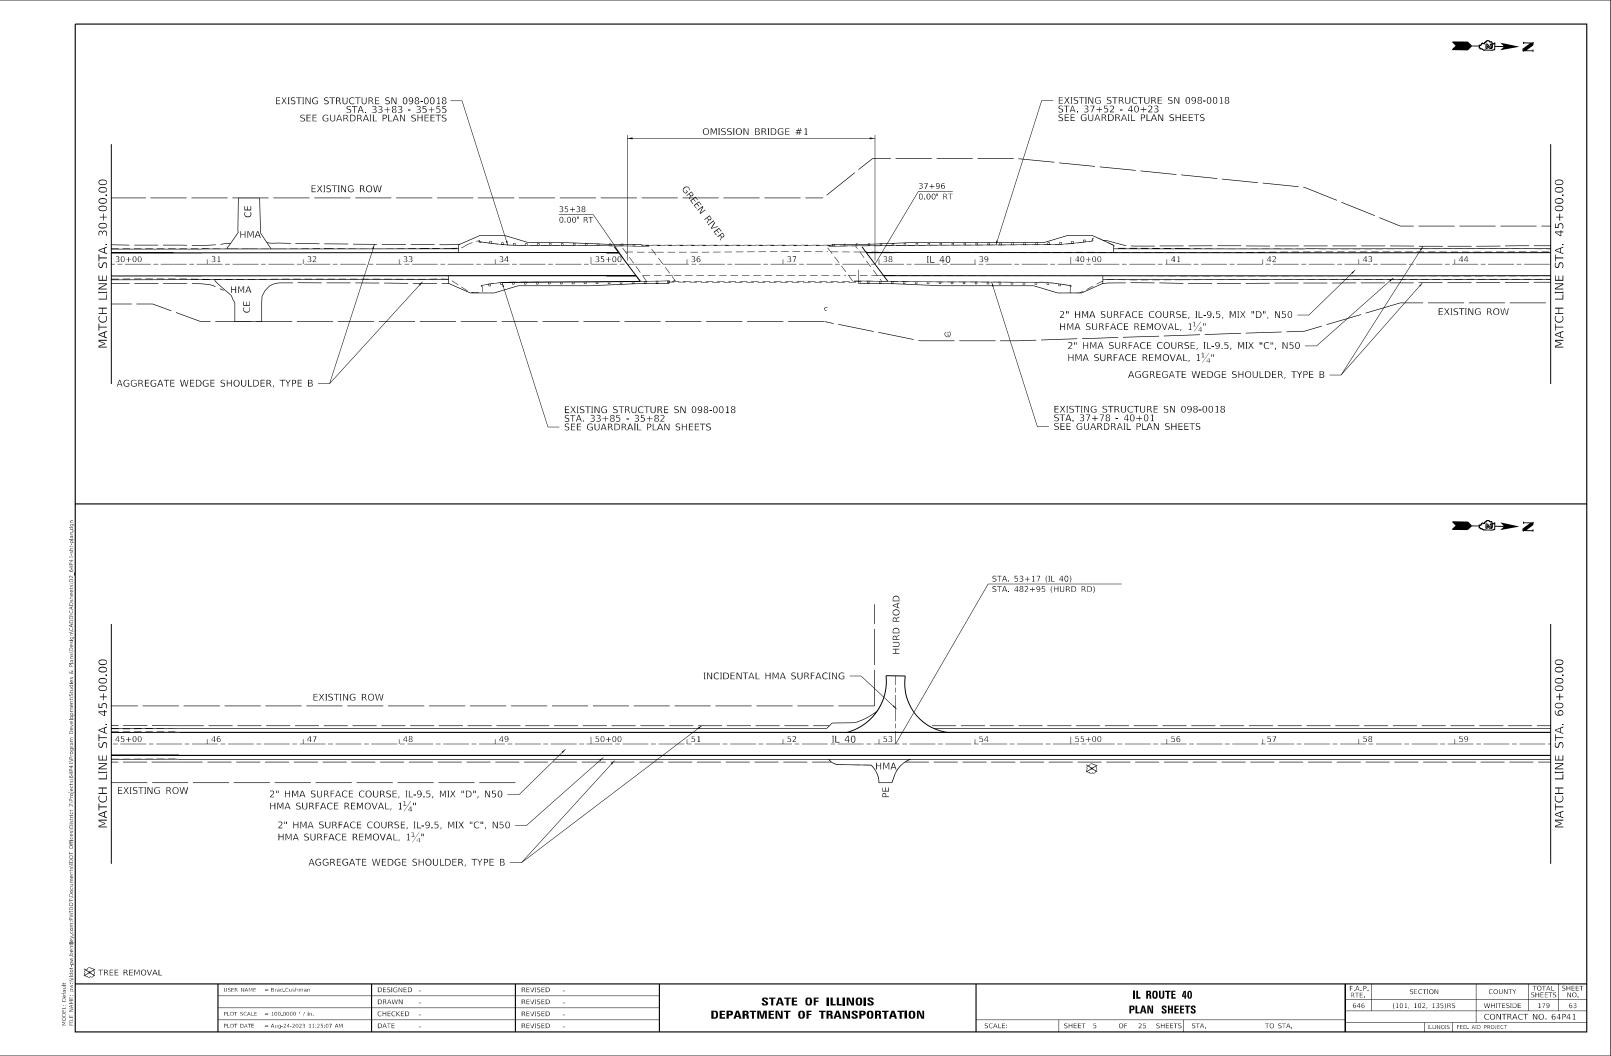


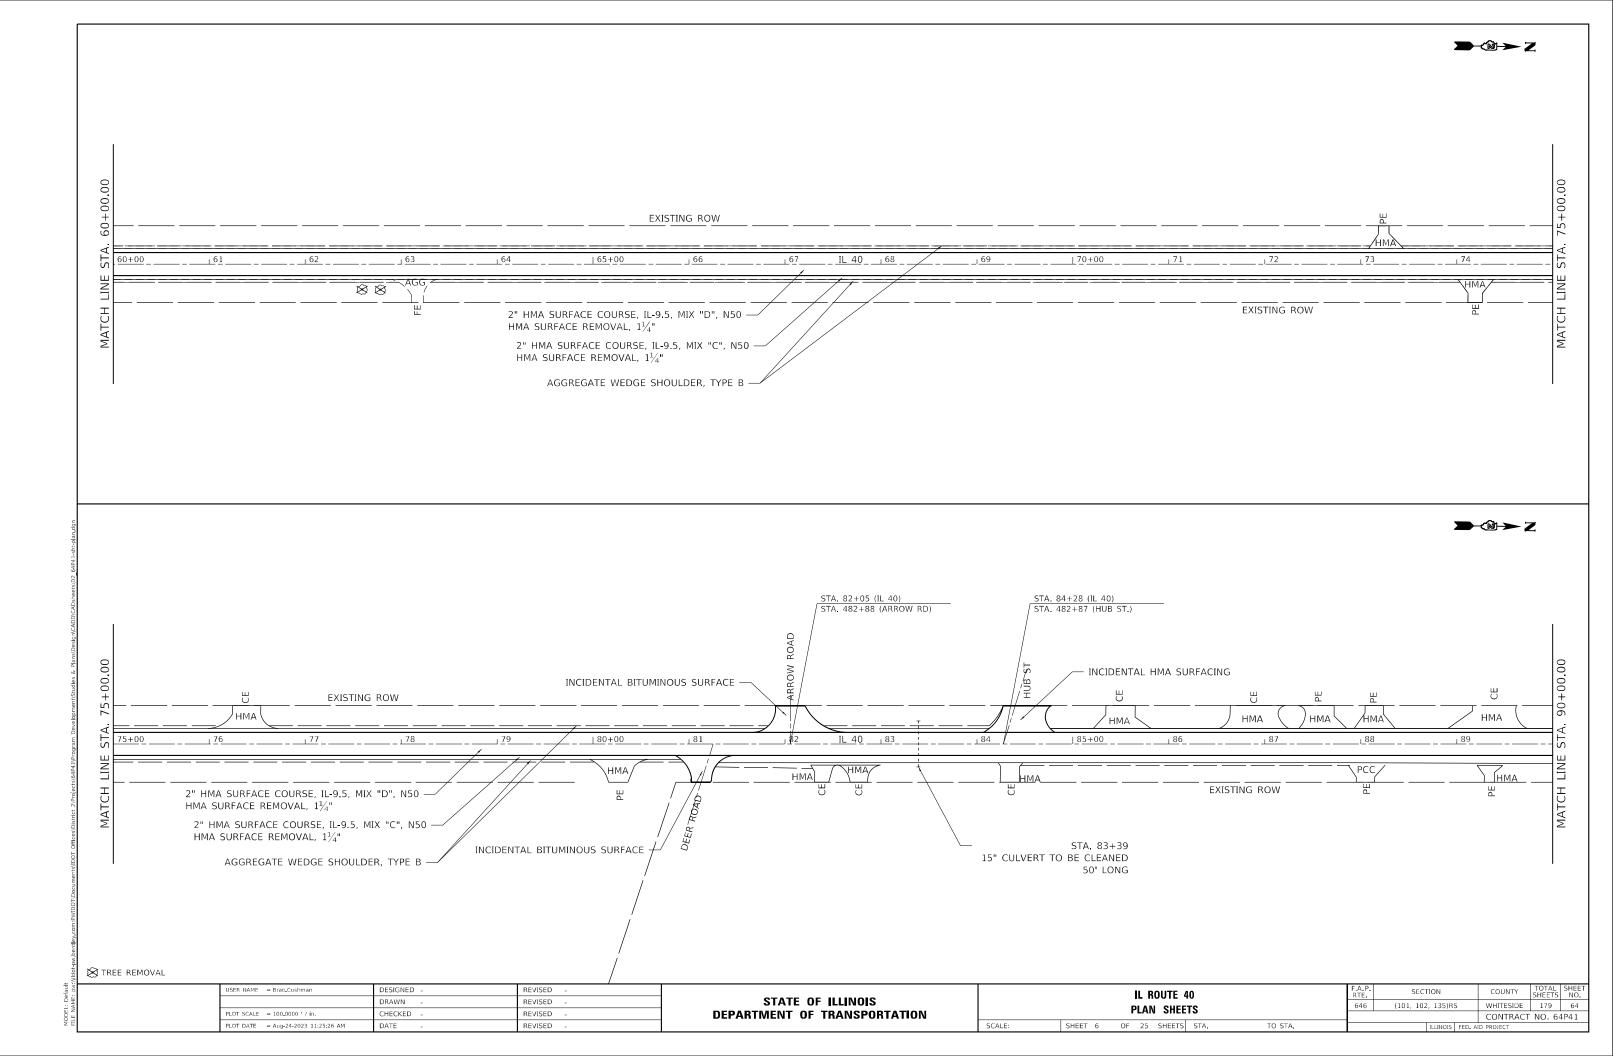


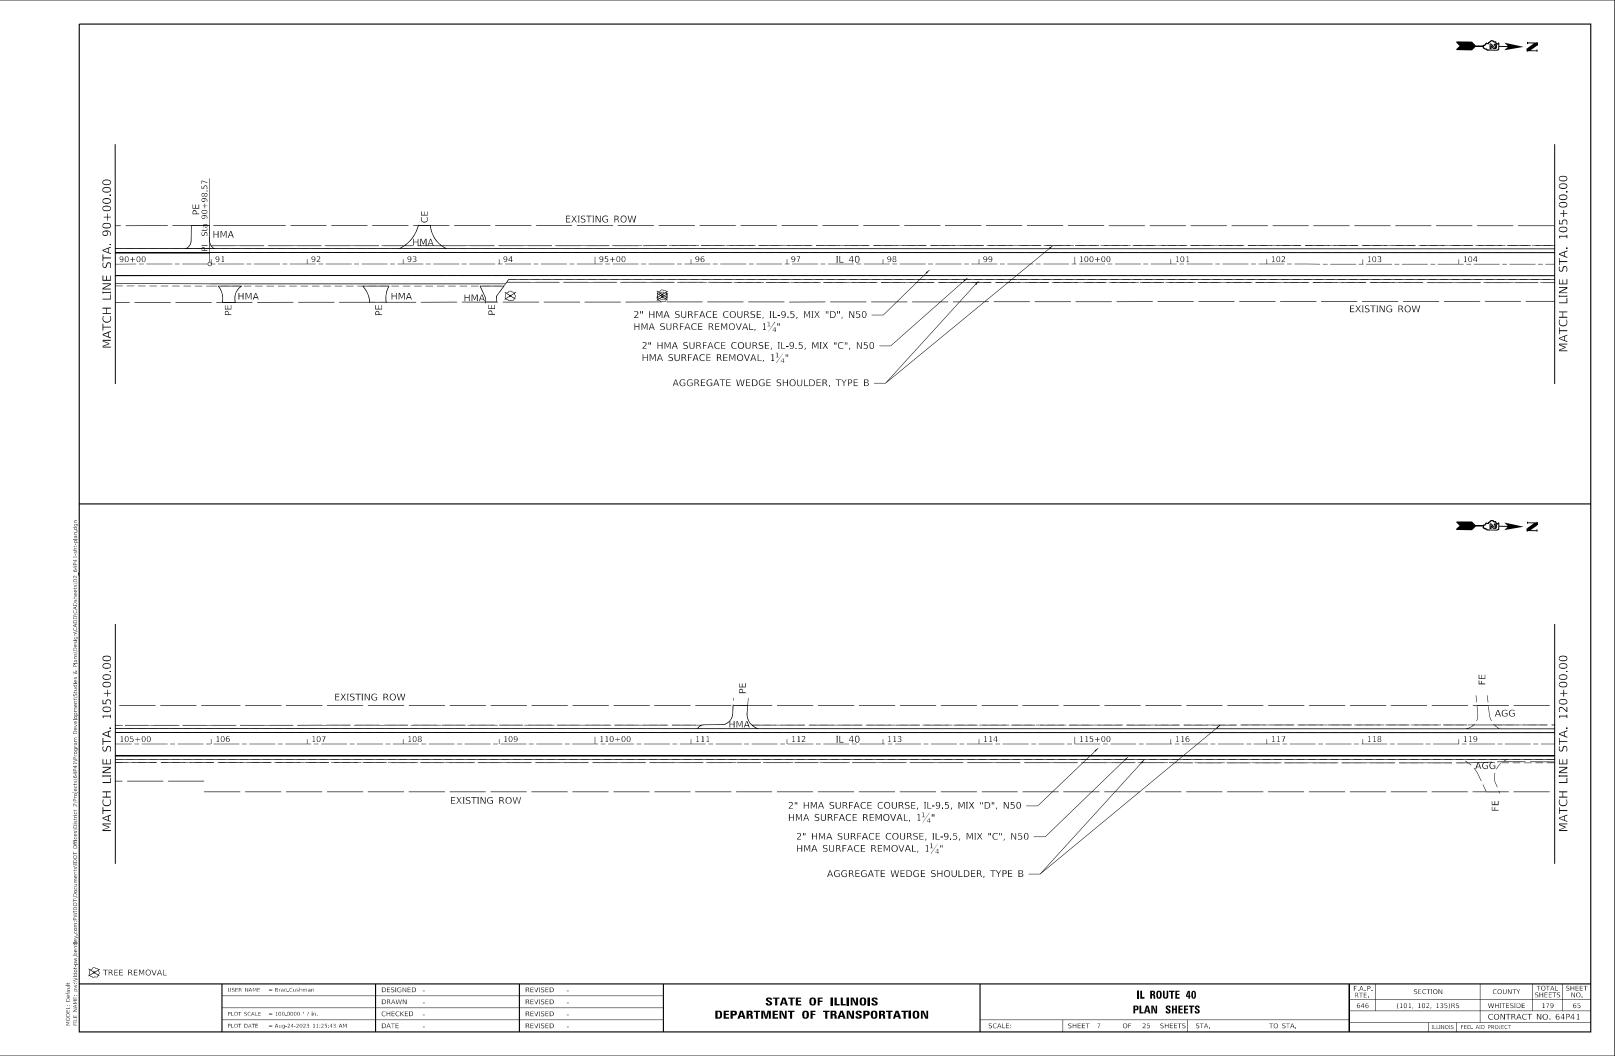


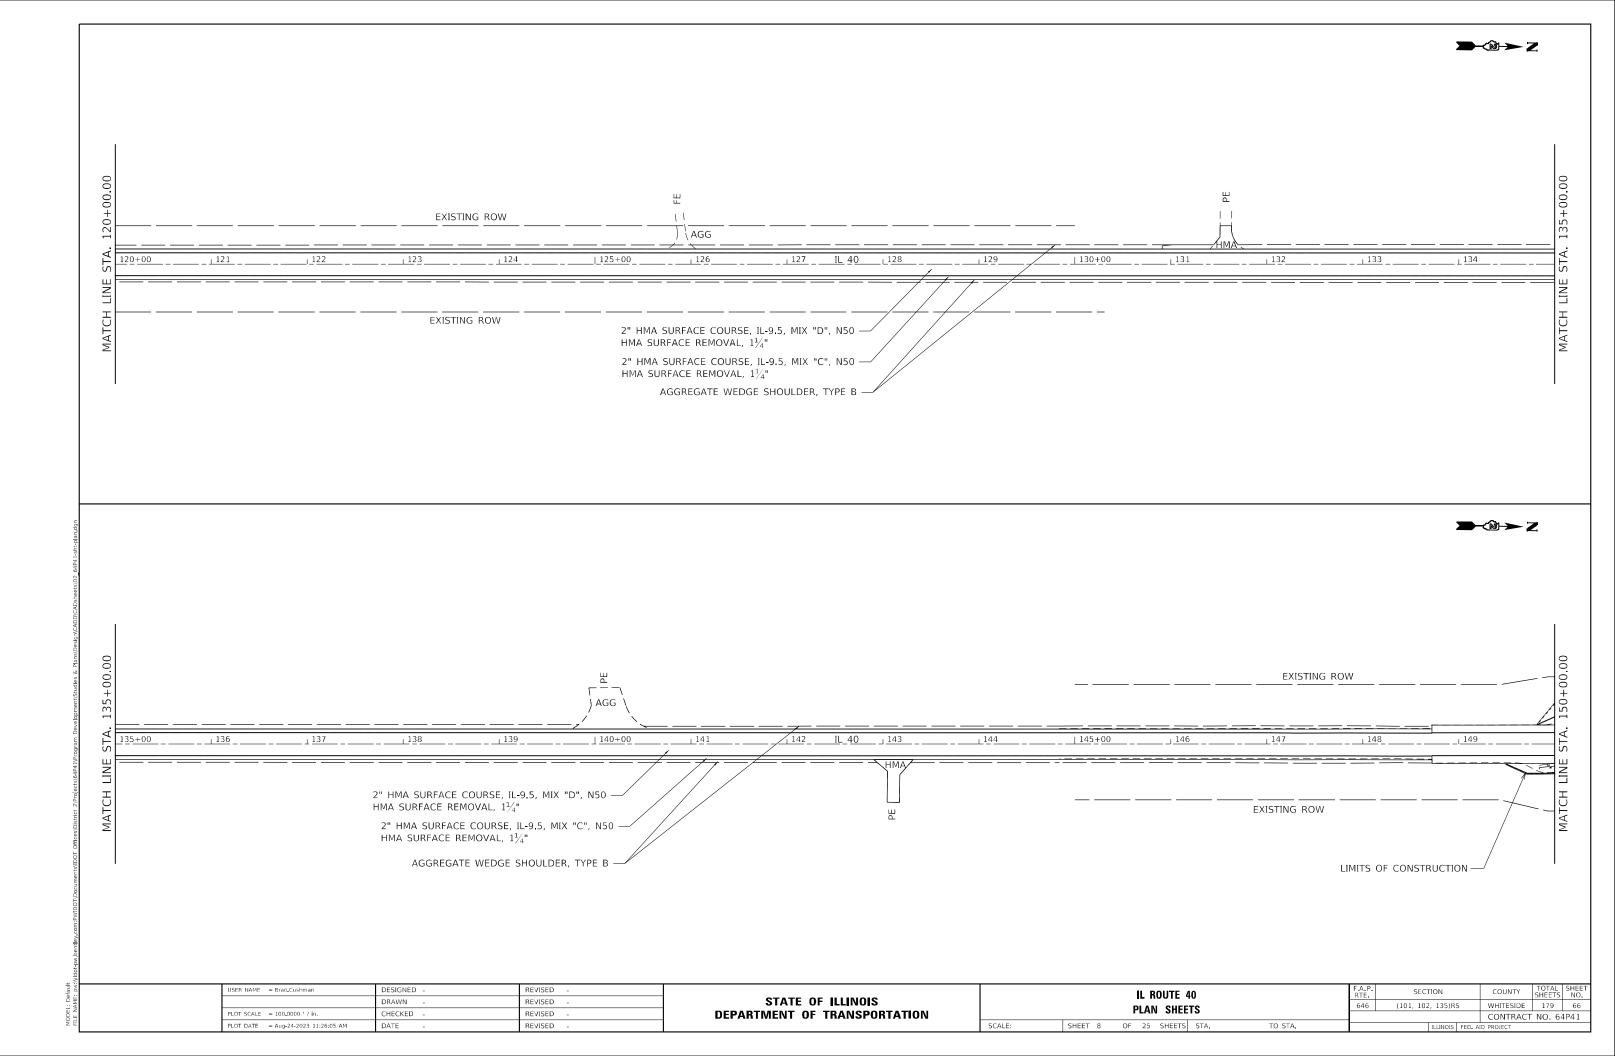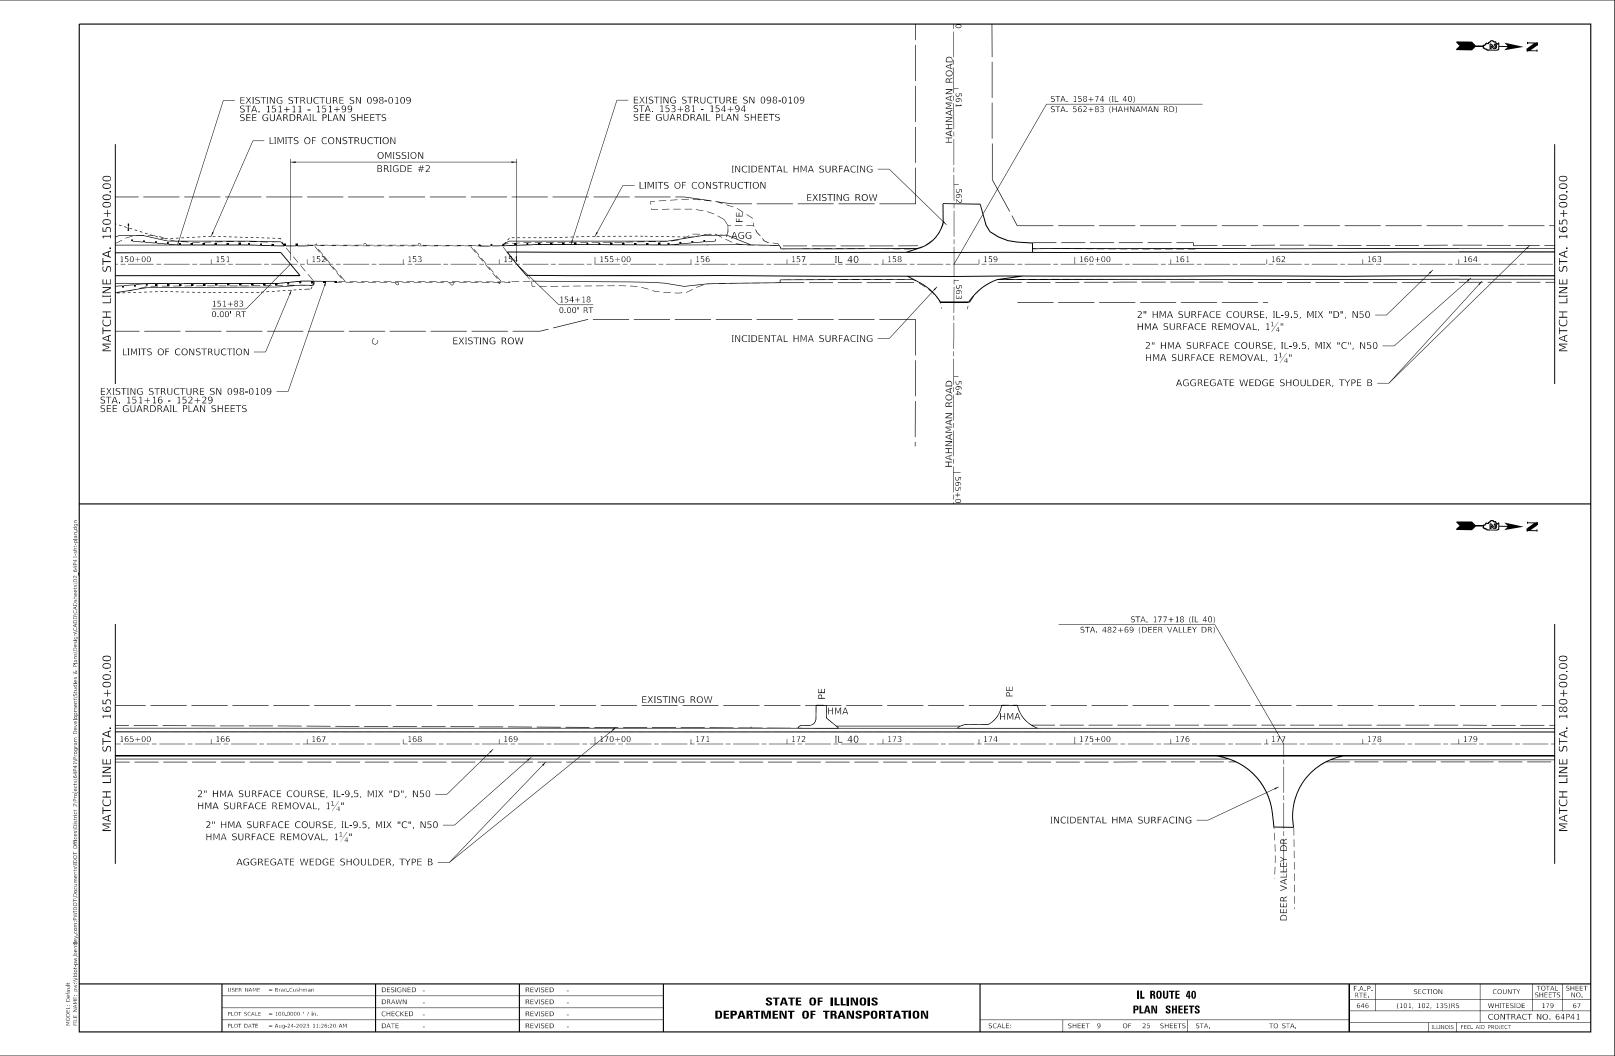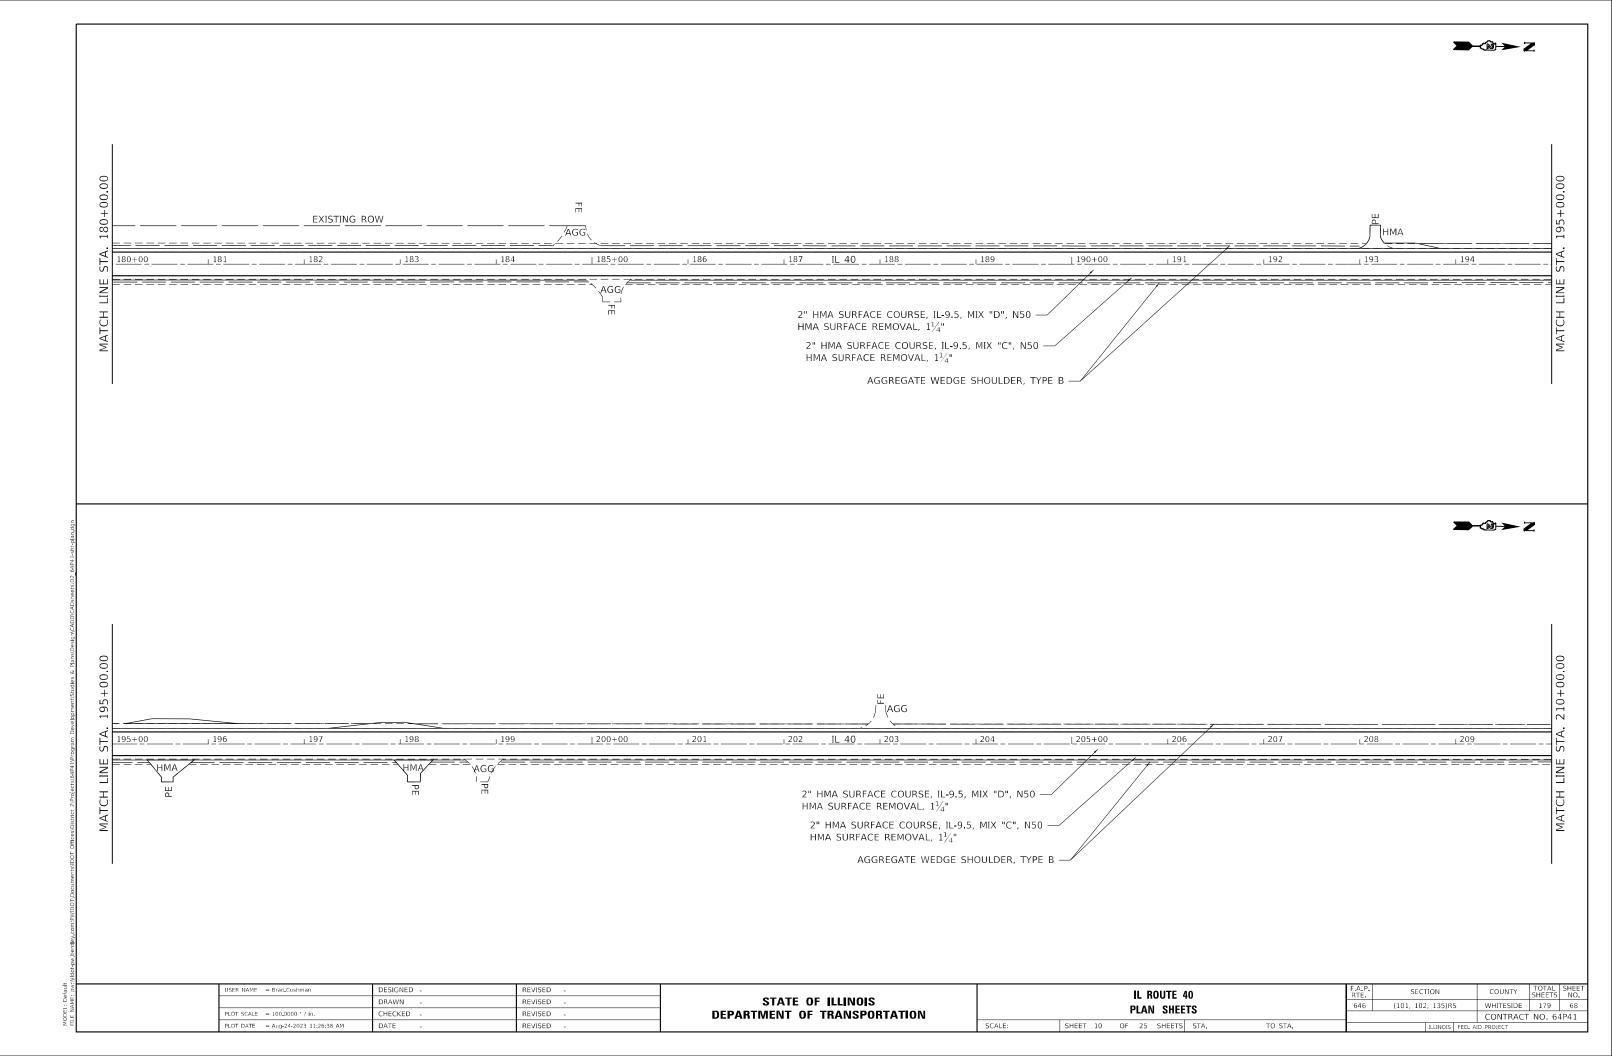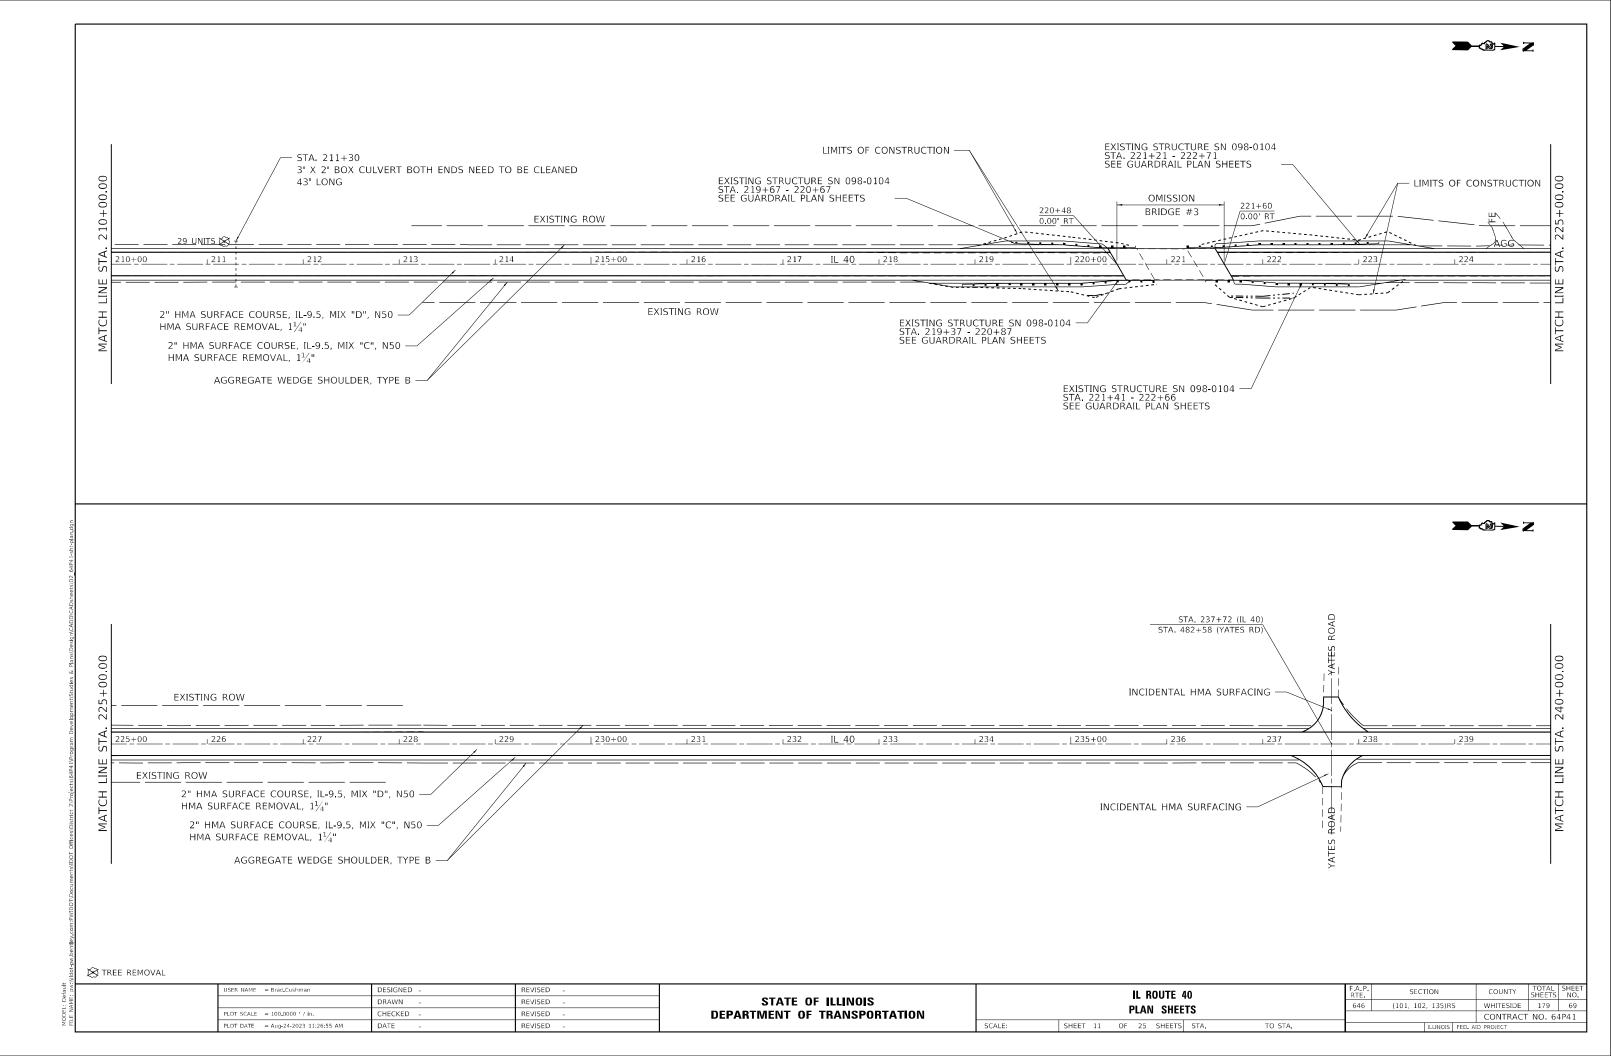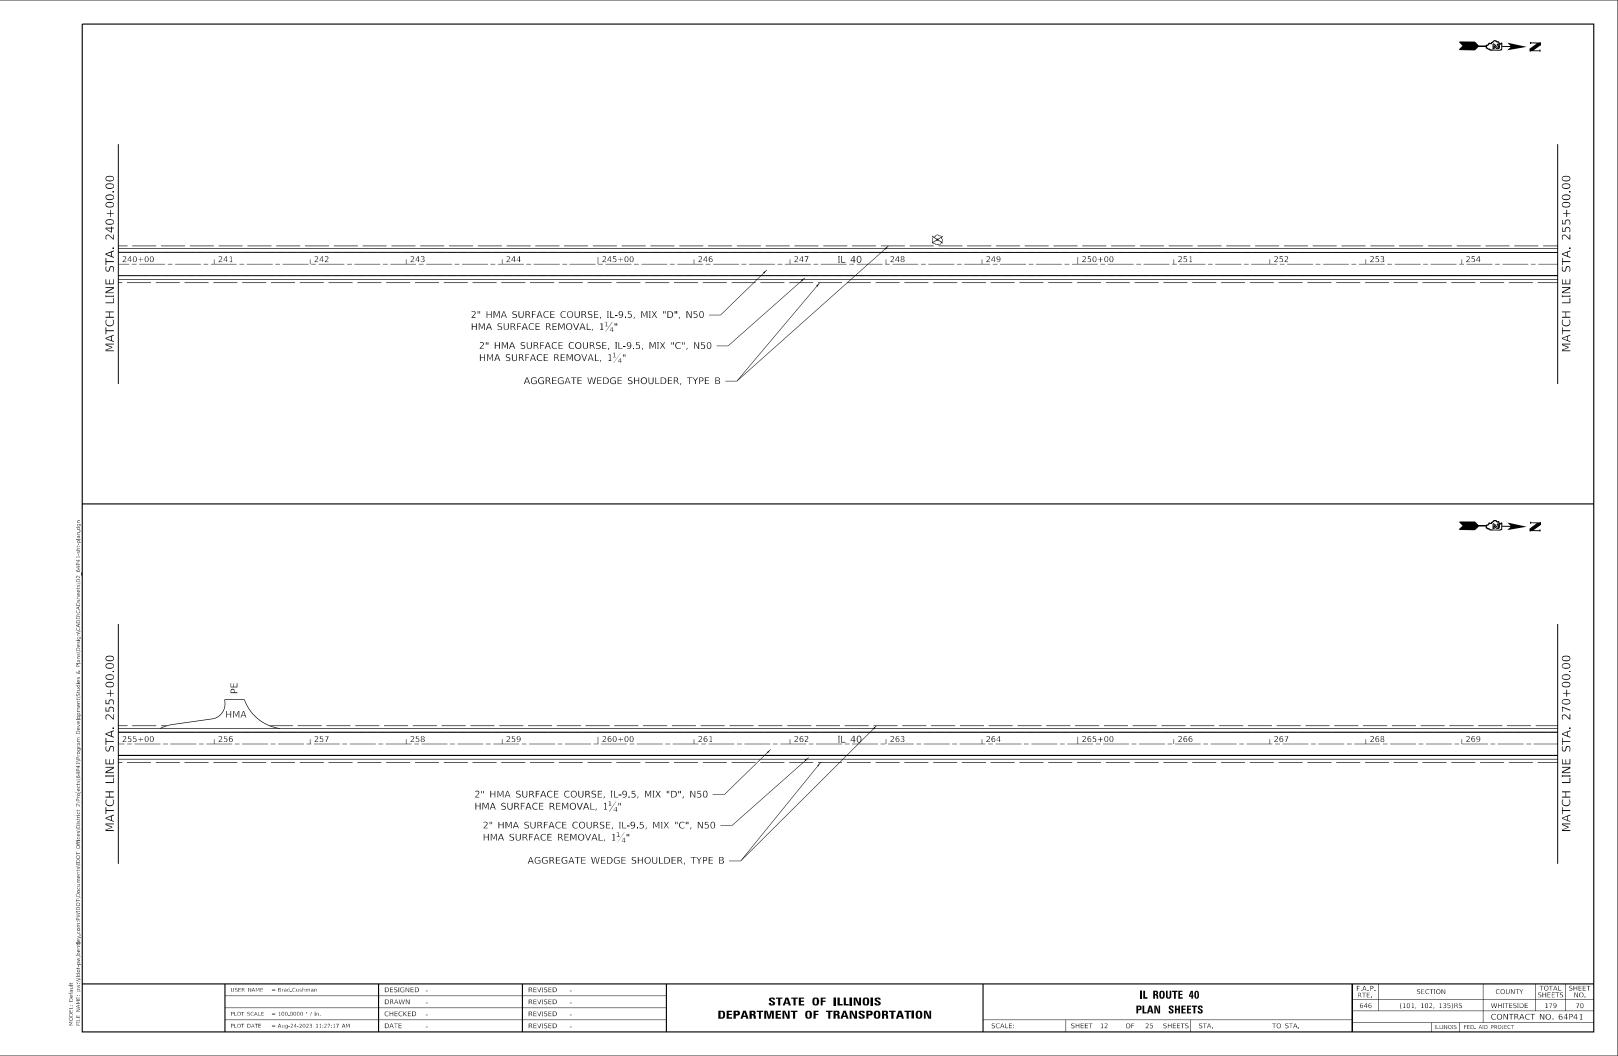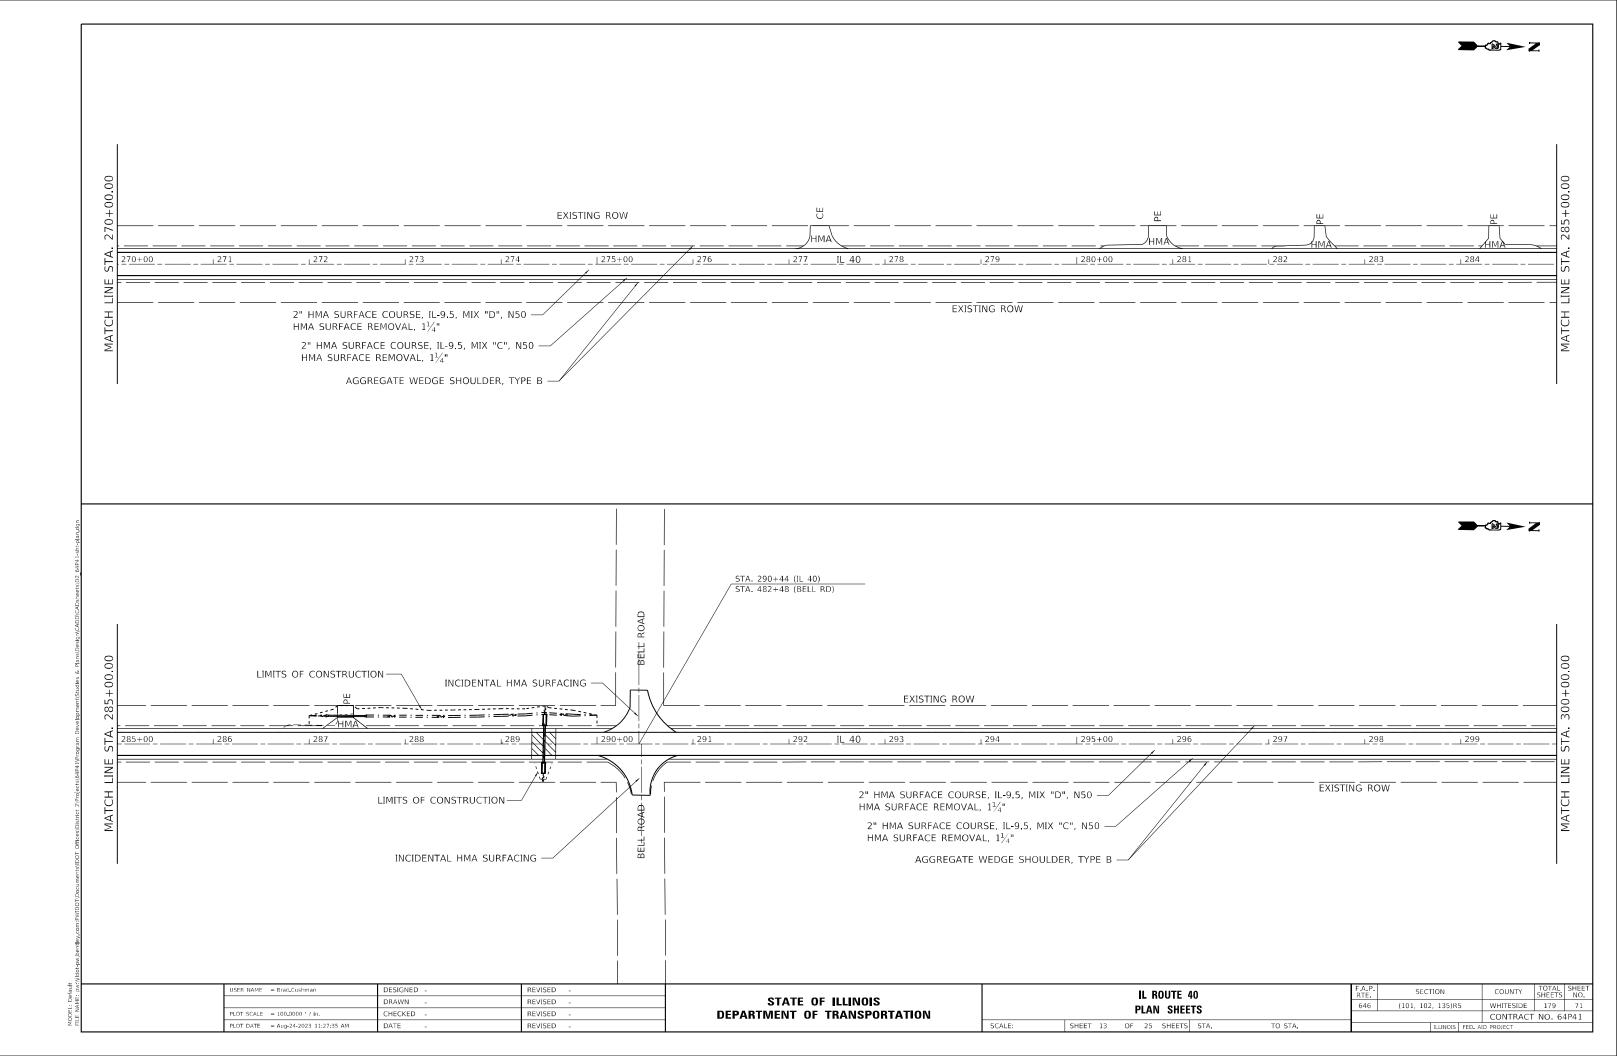


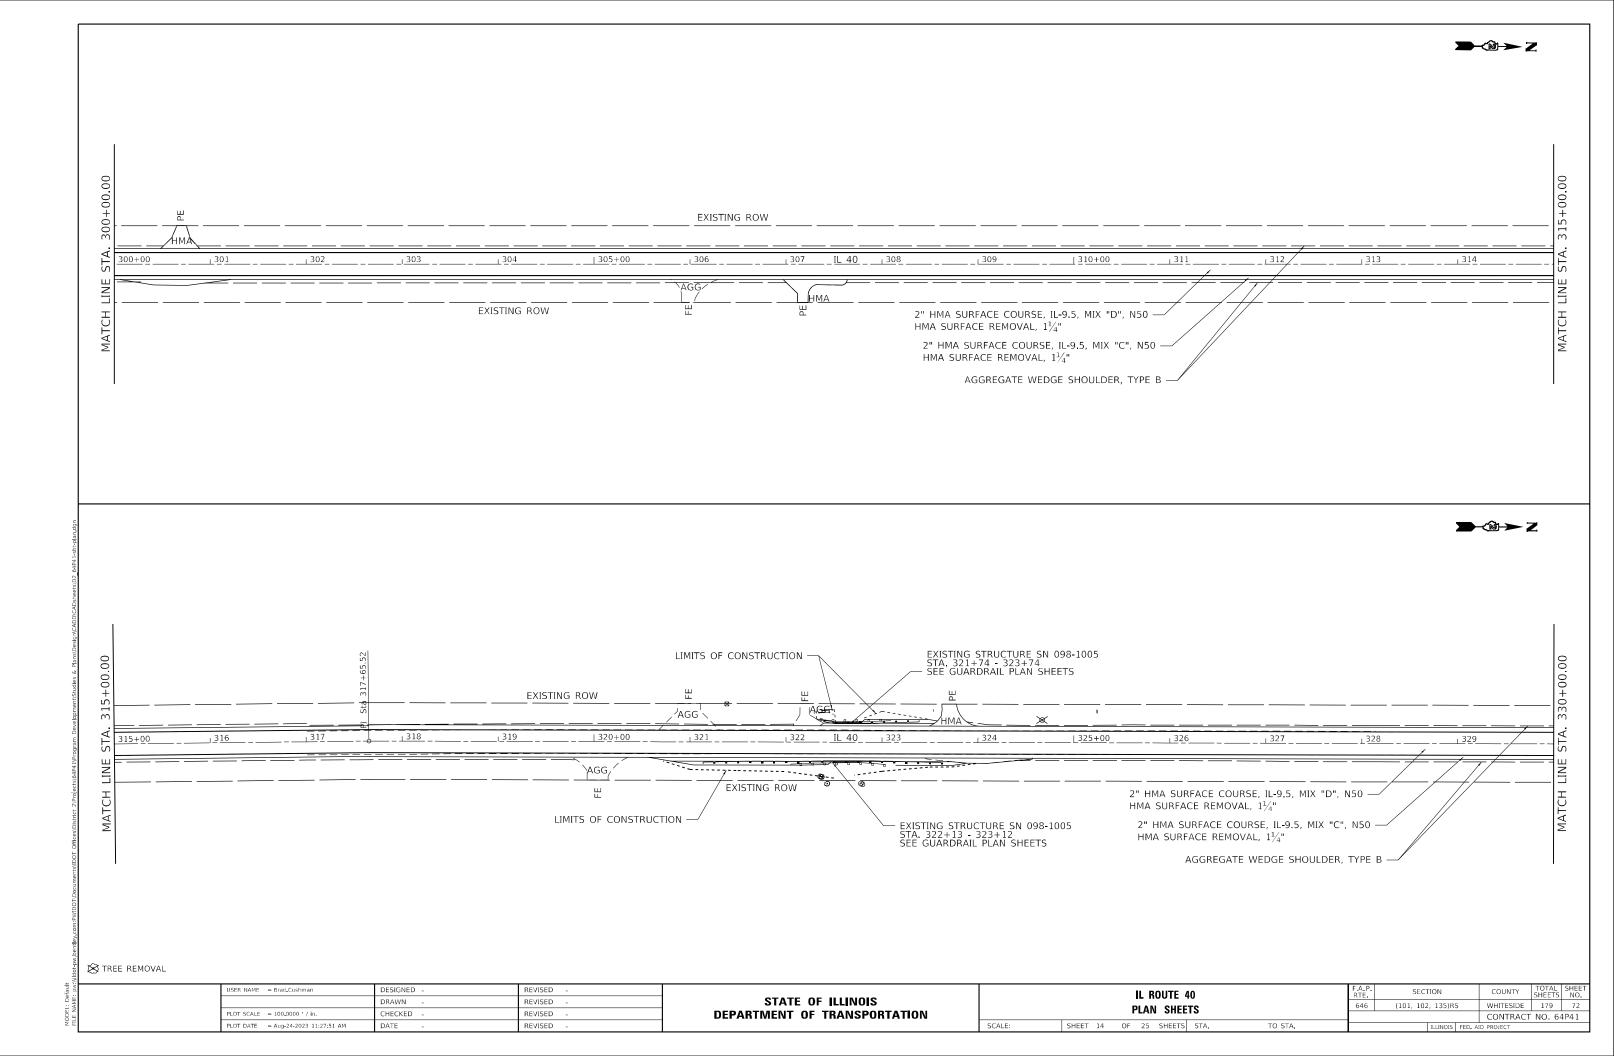


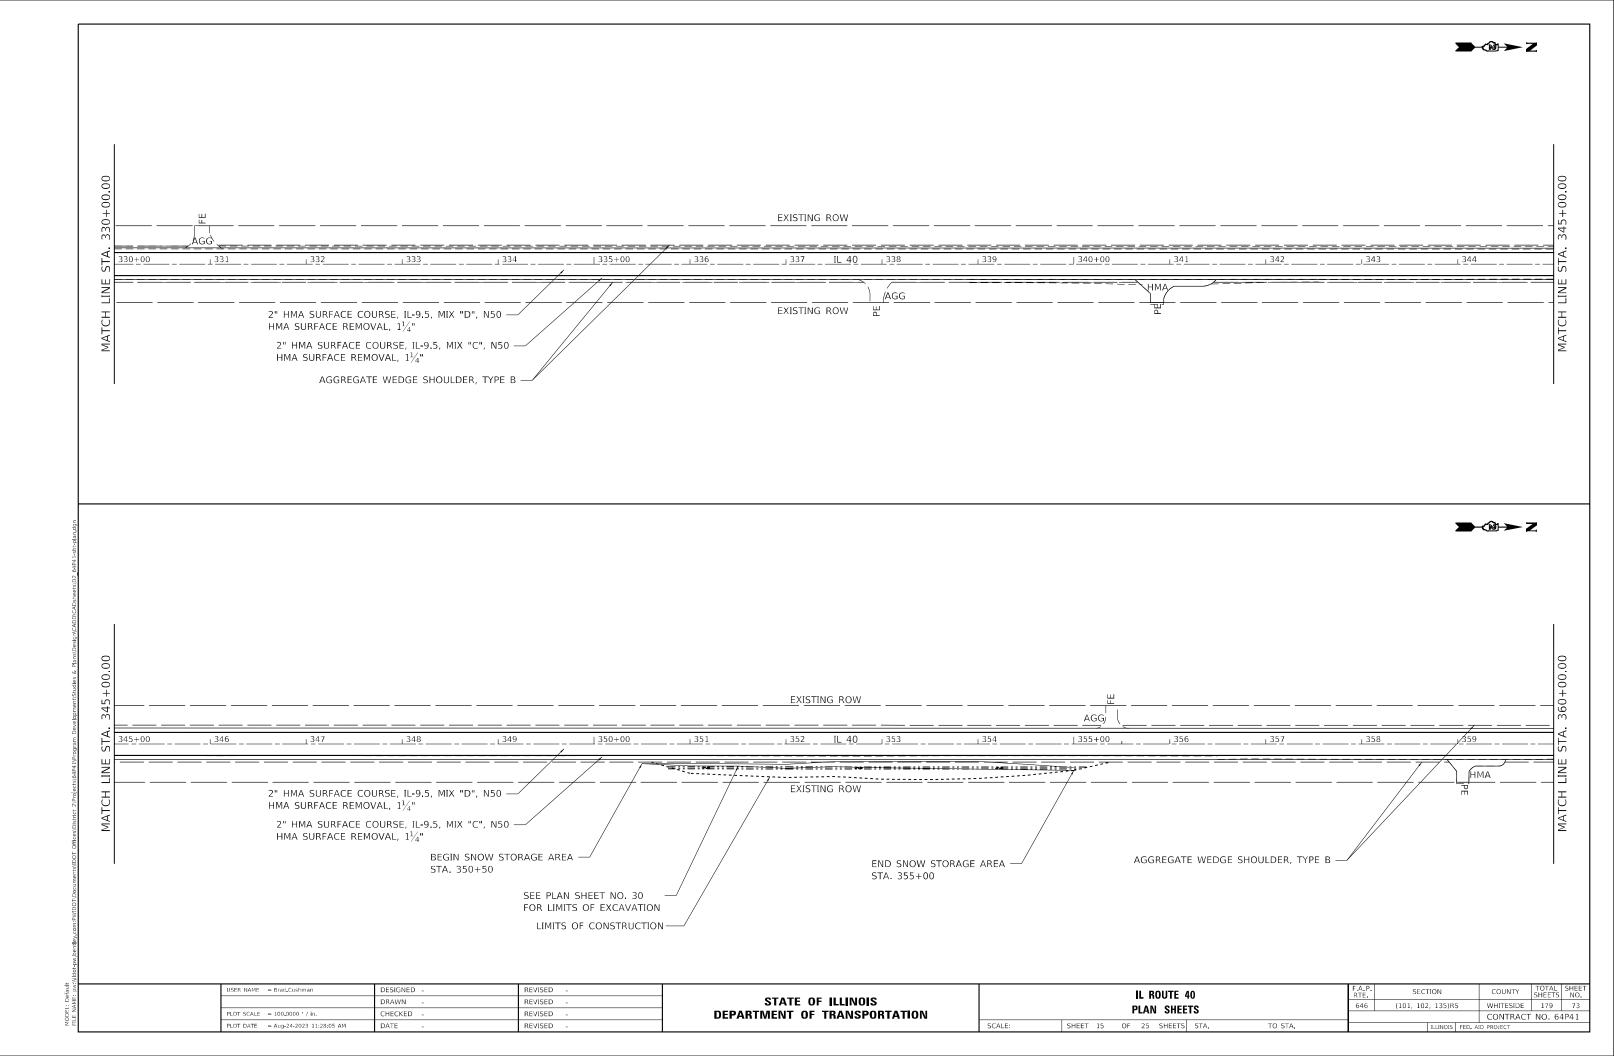


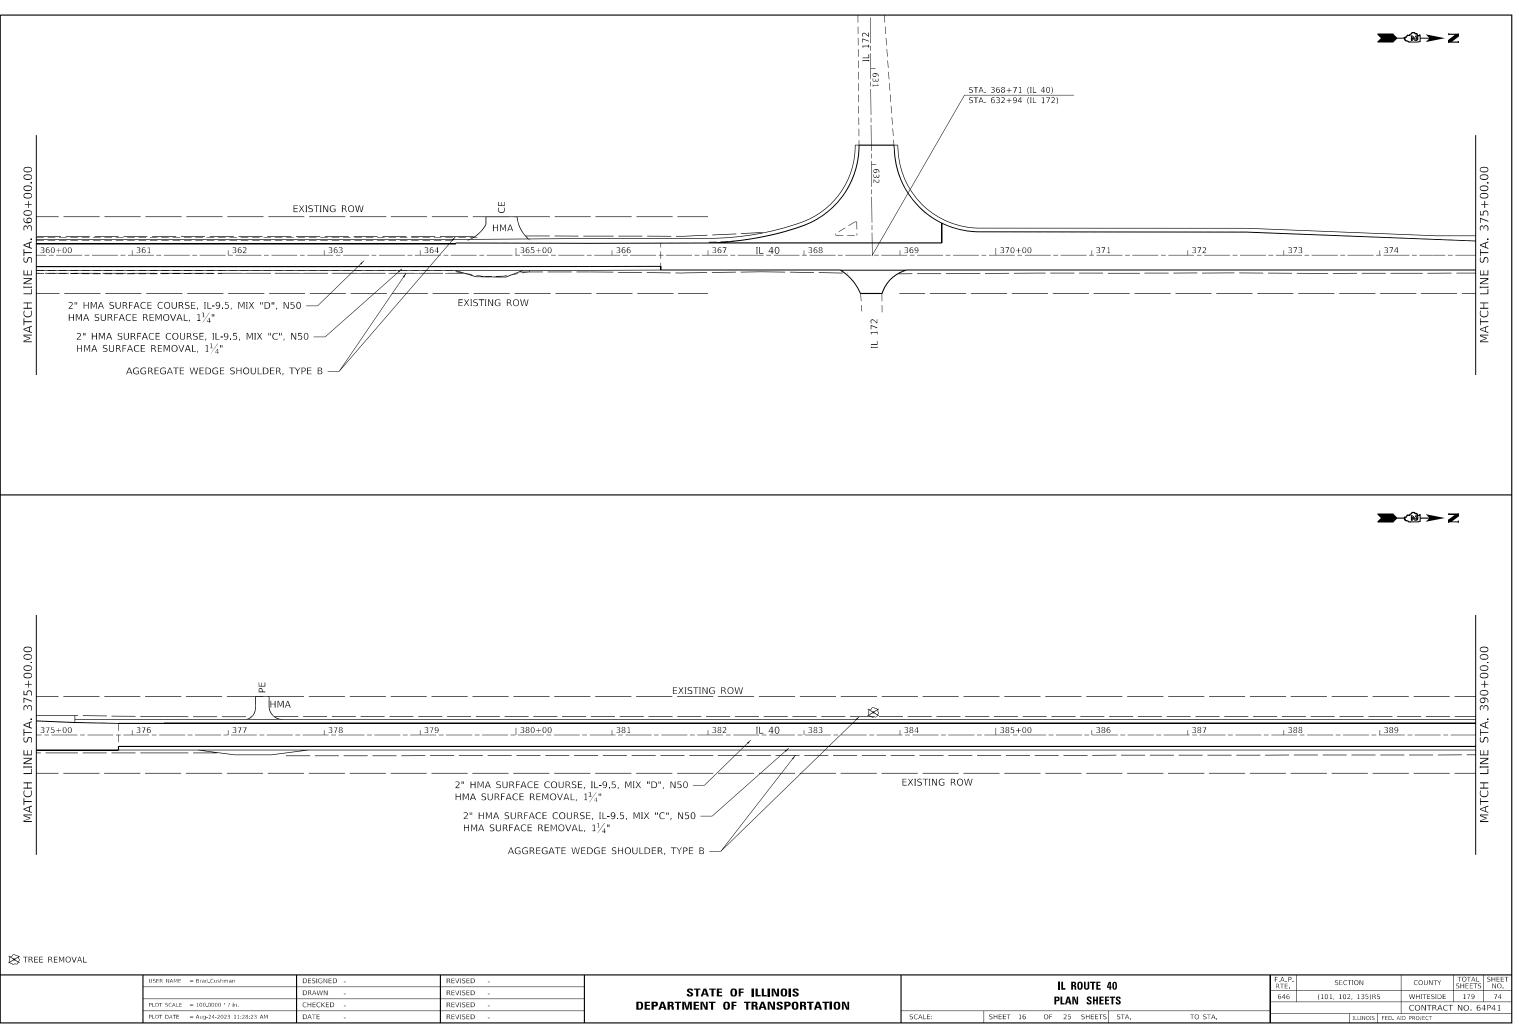




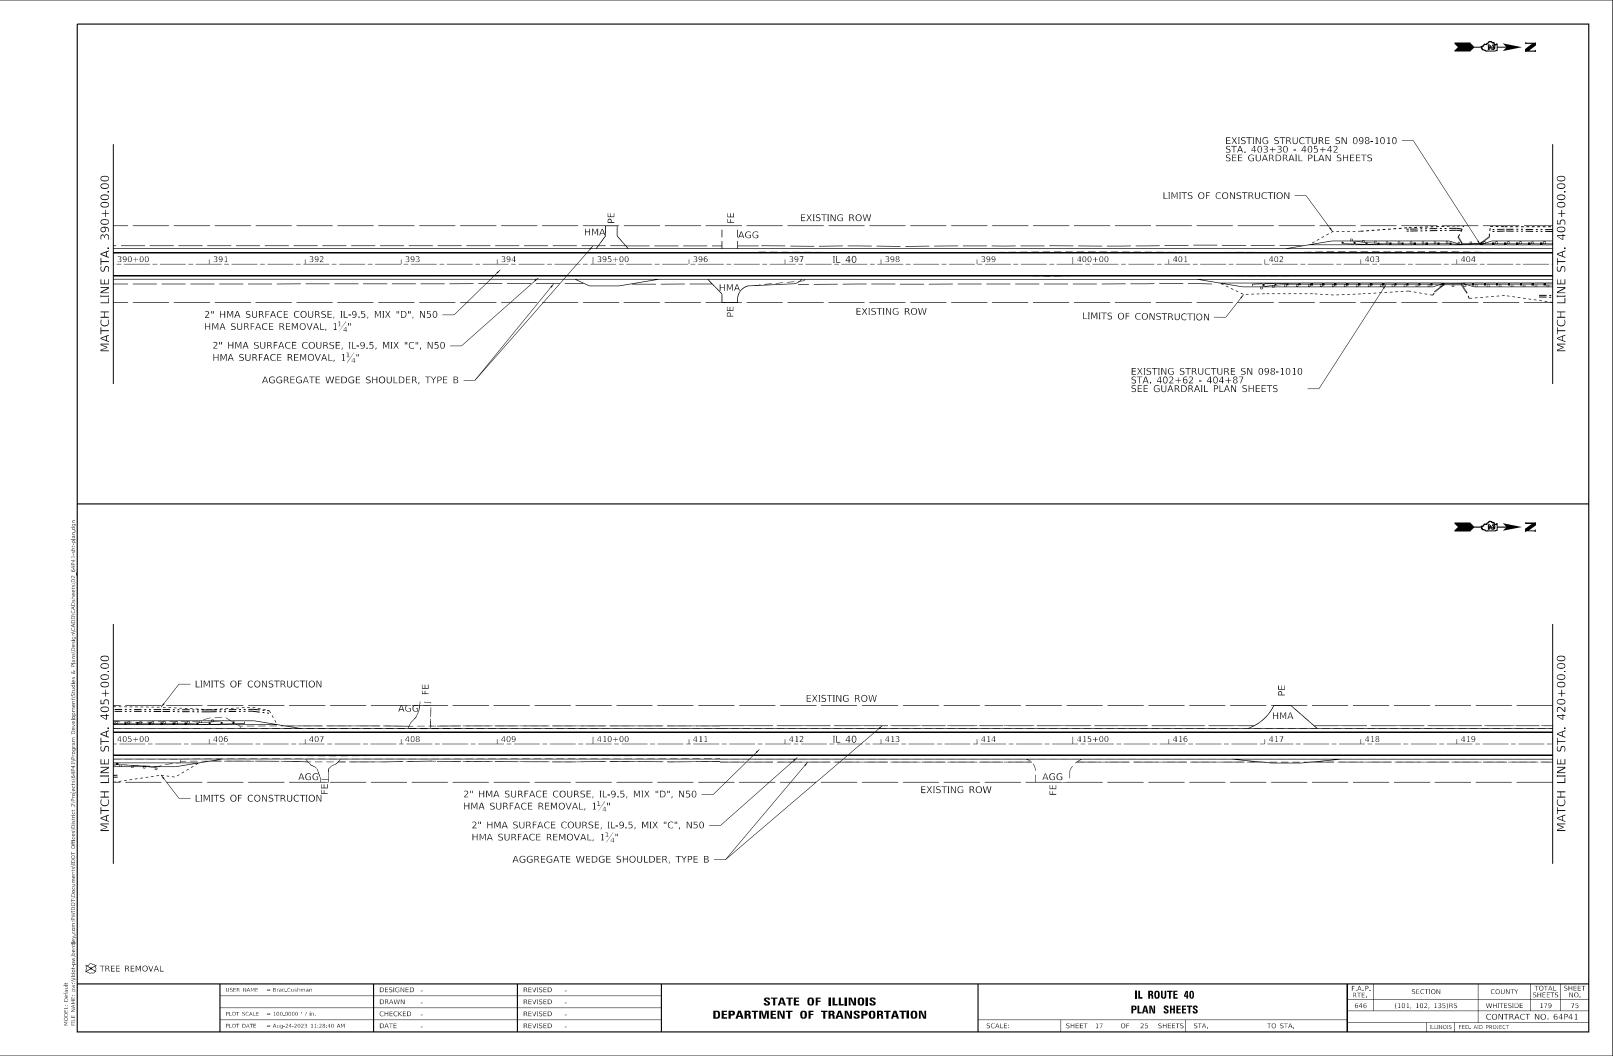


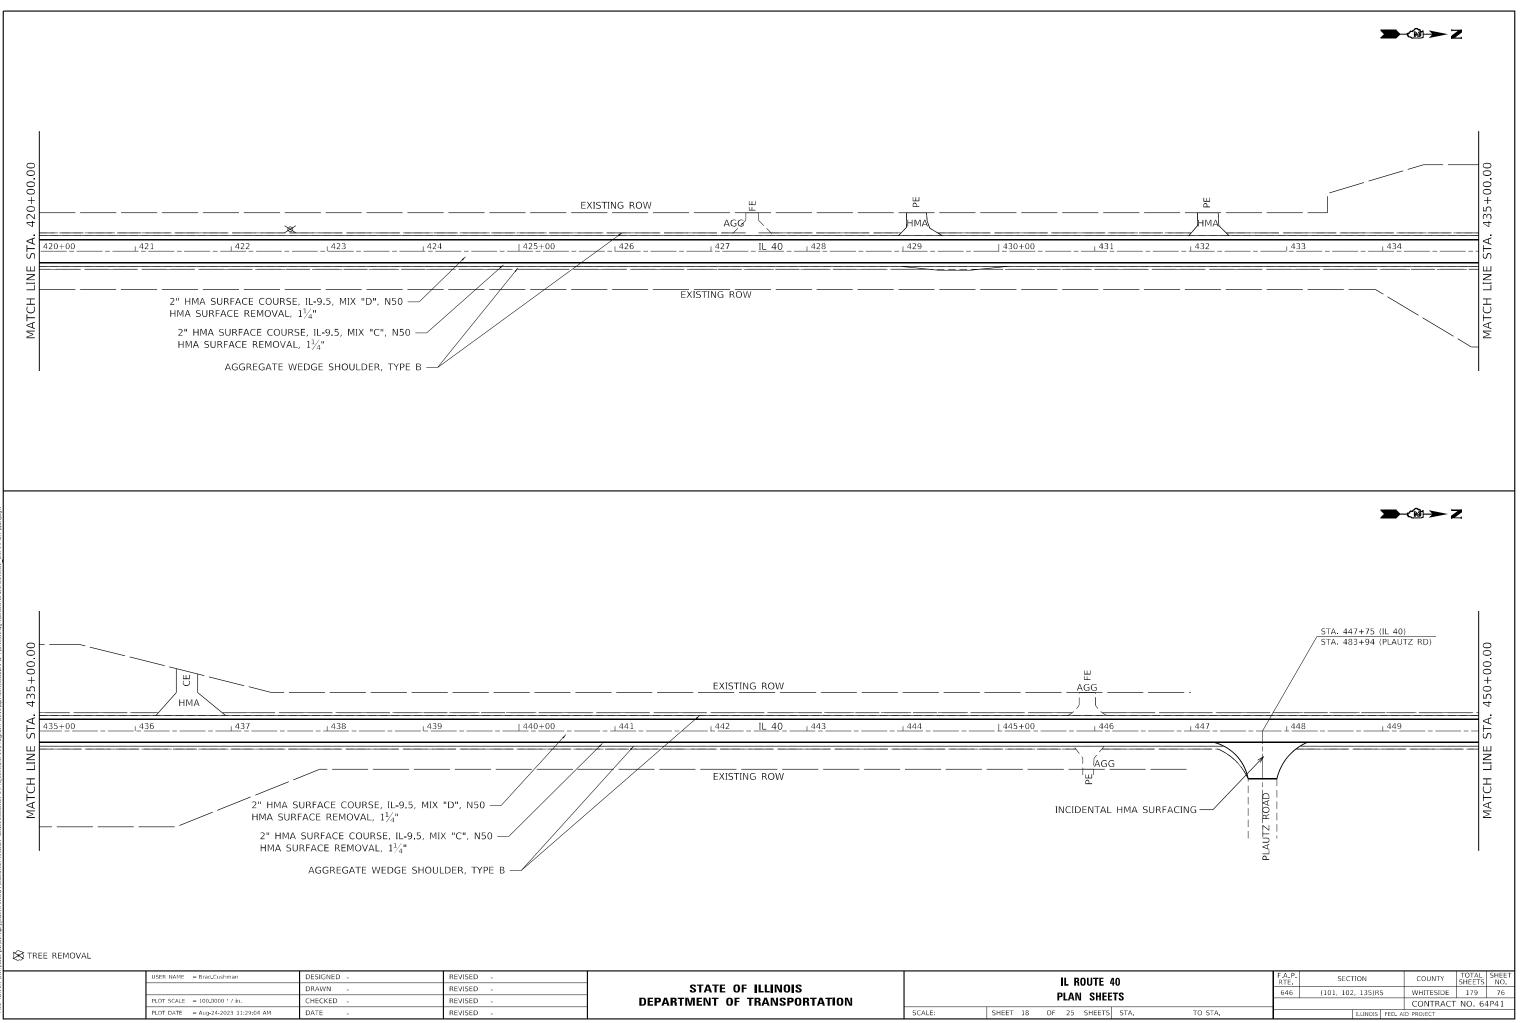


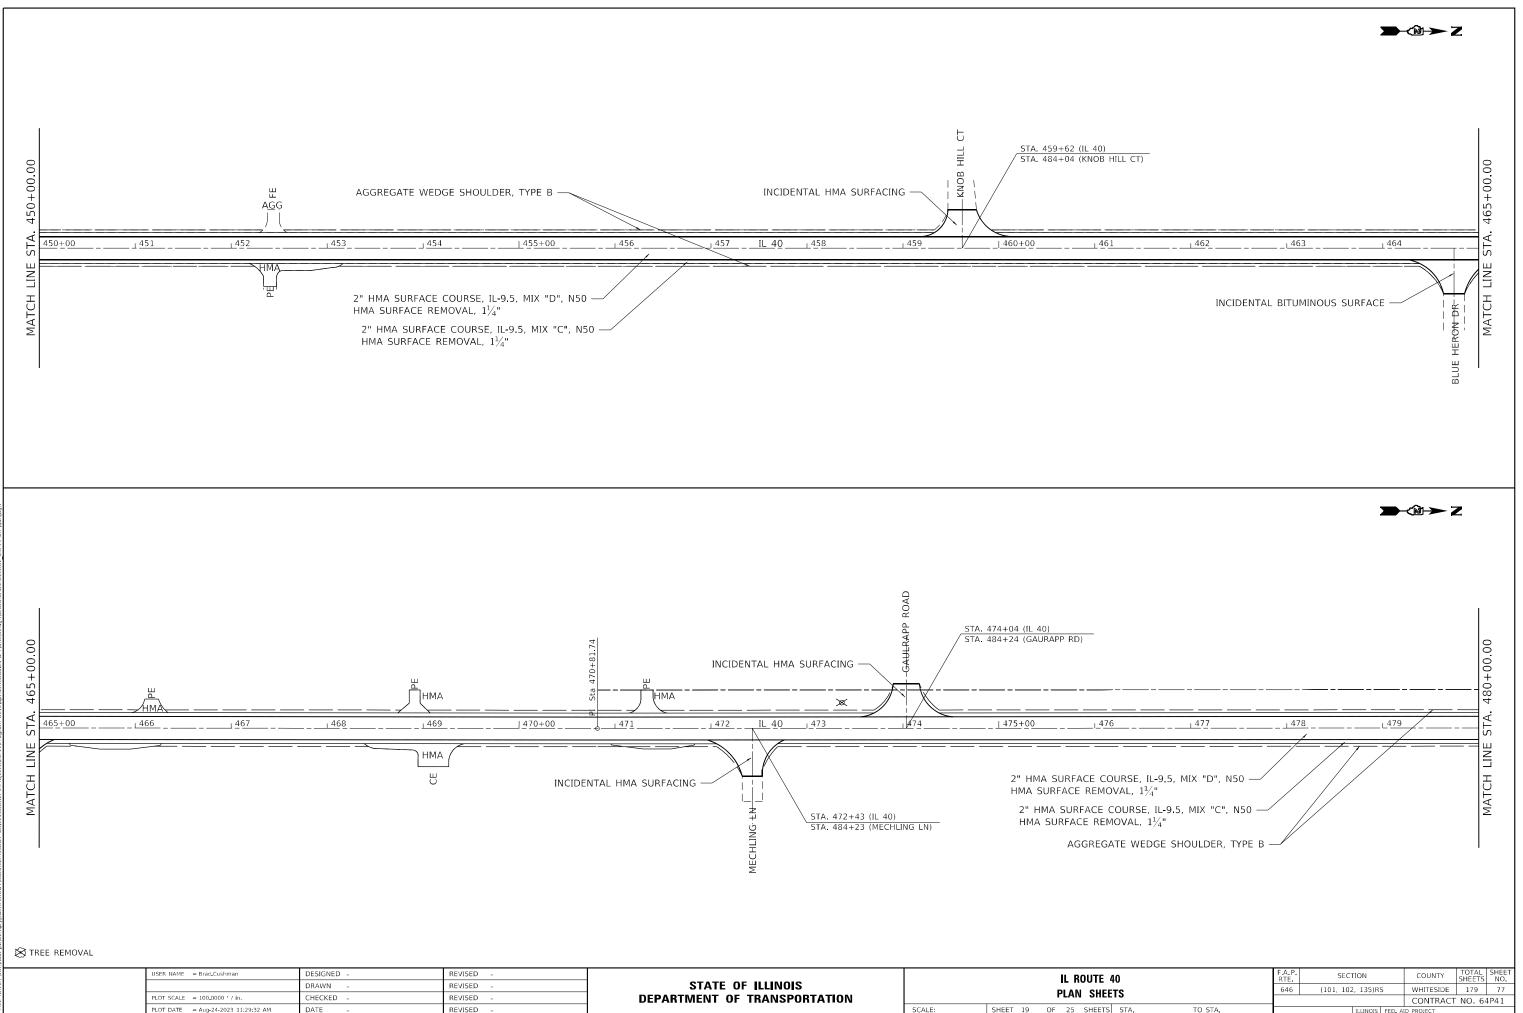




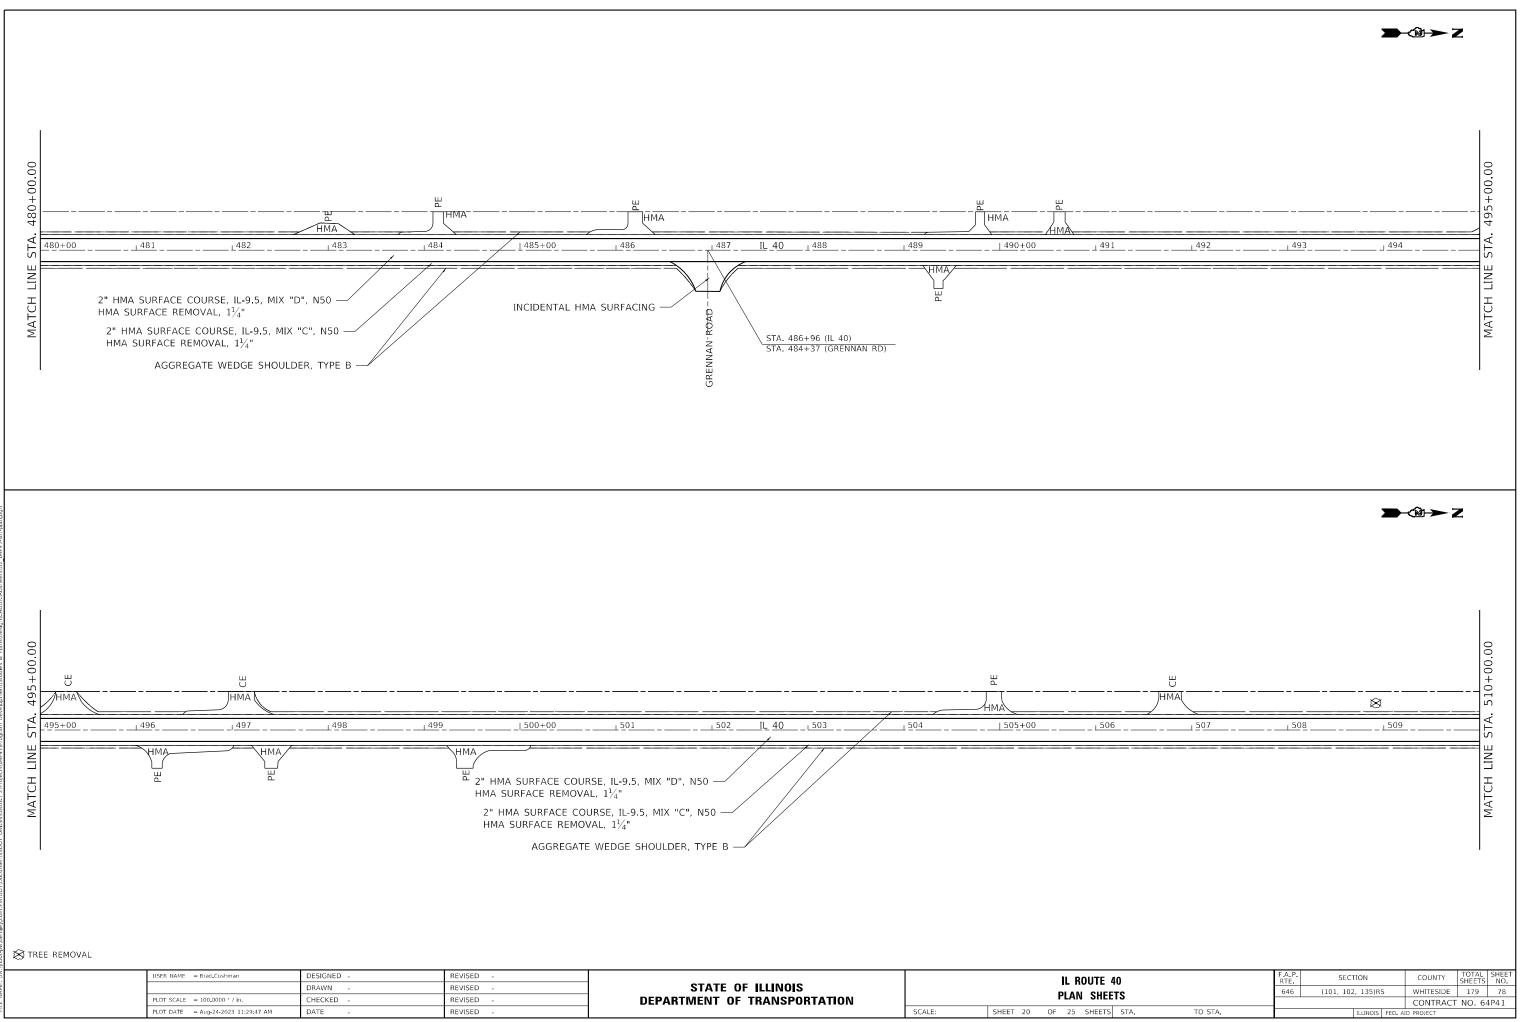
USER NAME = Brad Cushman	DESIGNED - DRAWN -	REVISED - REVISED -	STATE OF ILLINOIS			IL ROUTE 40
PLOT SCALE = 100.0000 / in.	CHECKED -	REVISED -	DEPARTMENT OF TRANSPORTATION	L	I	PLAN SHEETS
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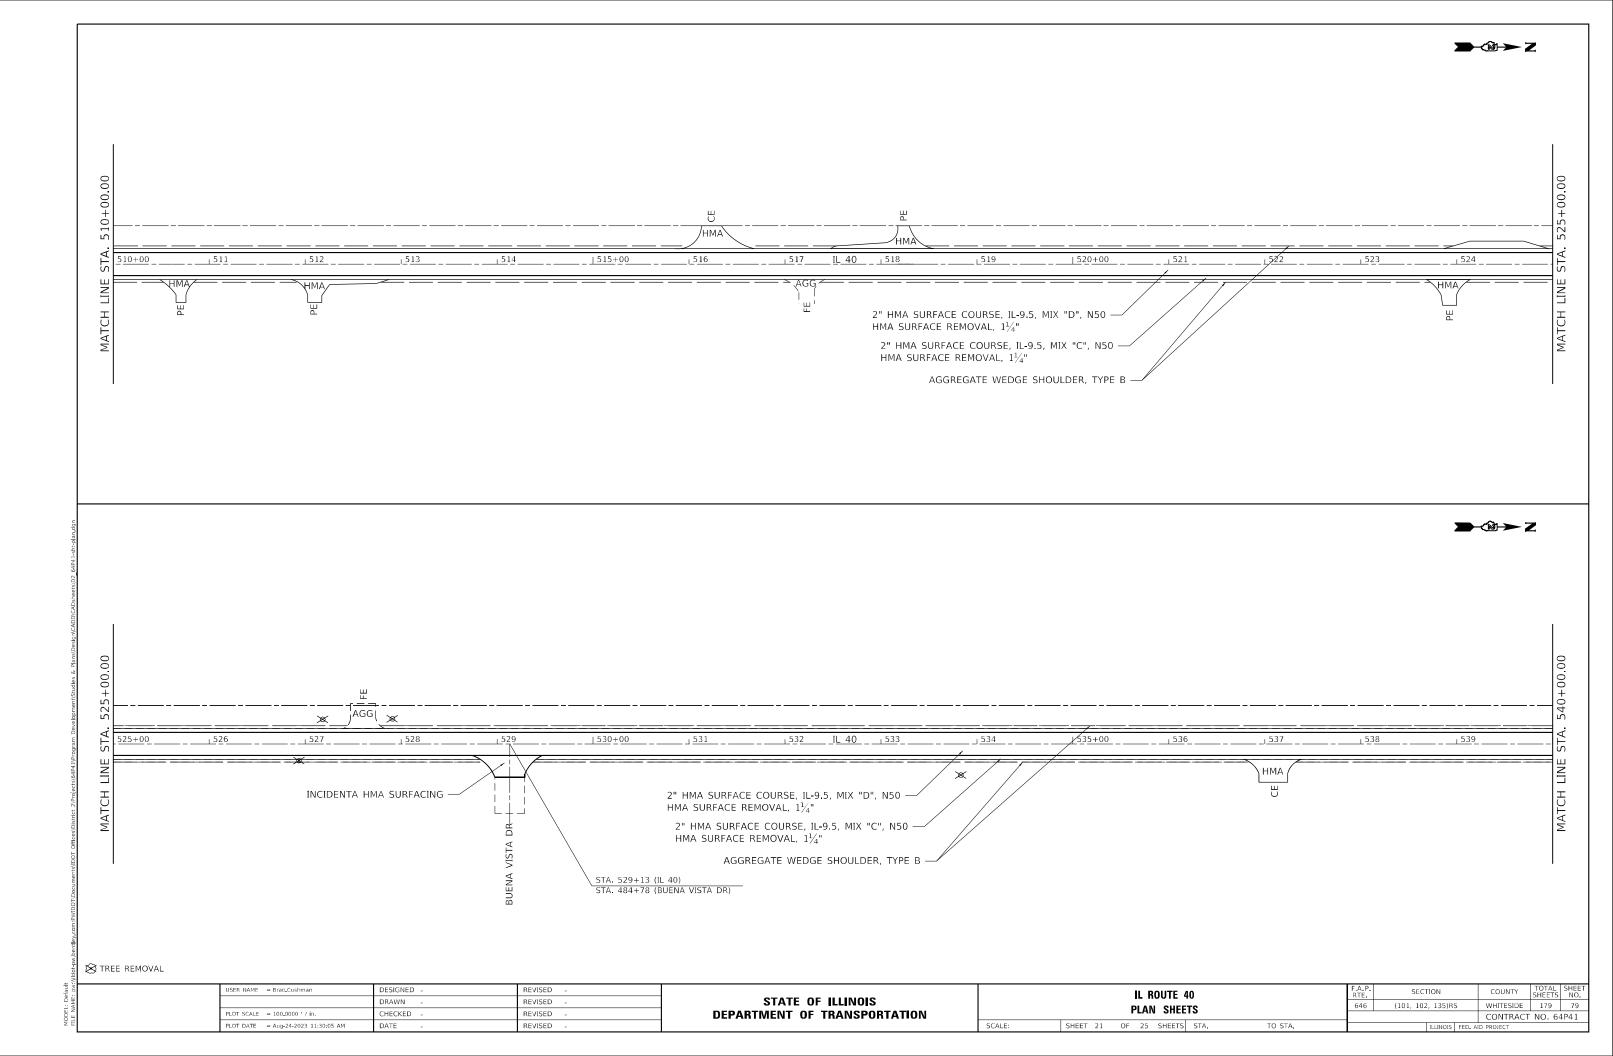









SCALE: SHEET 19 OF 25 SHEETS STA.






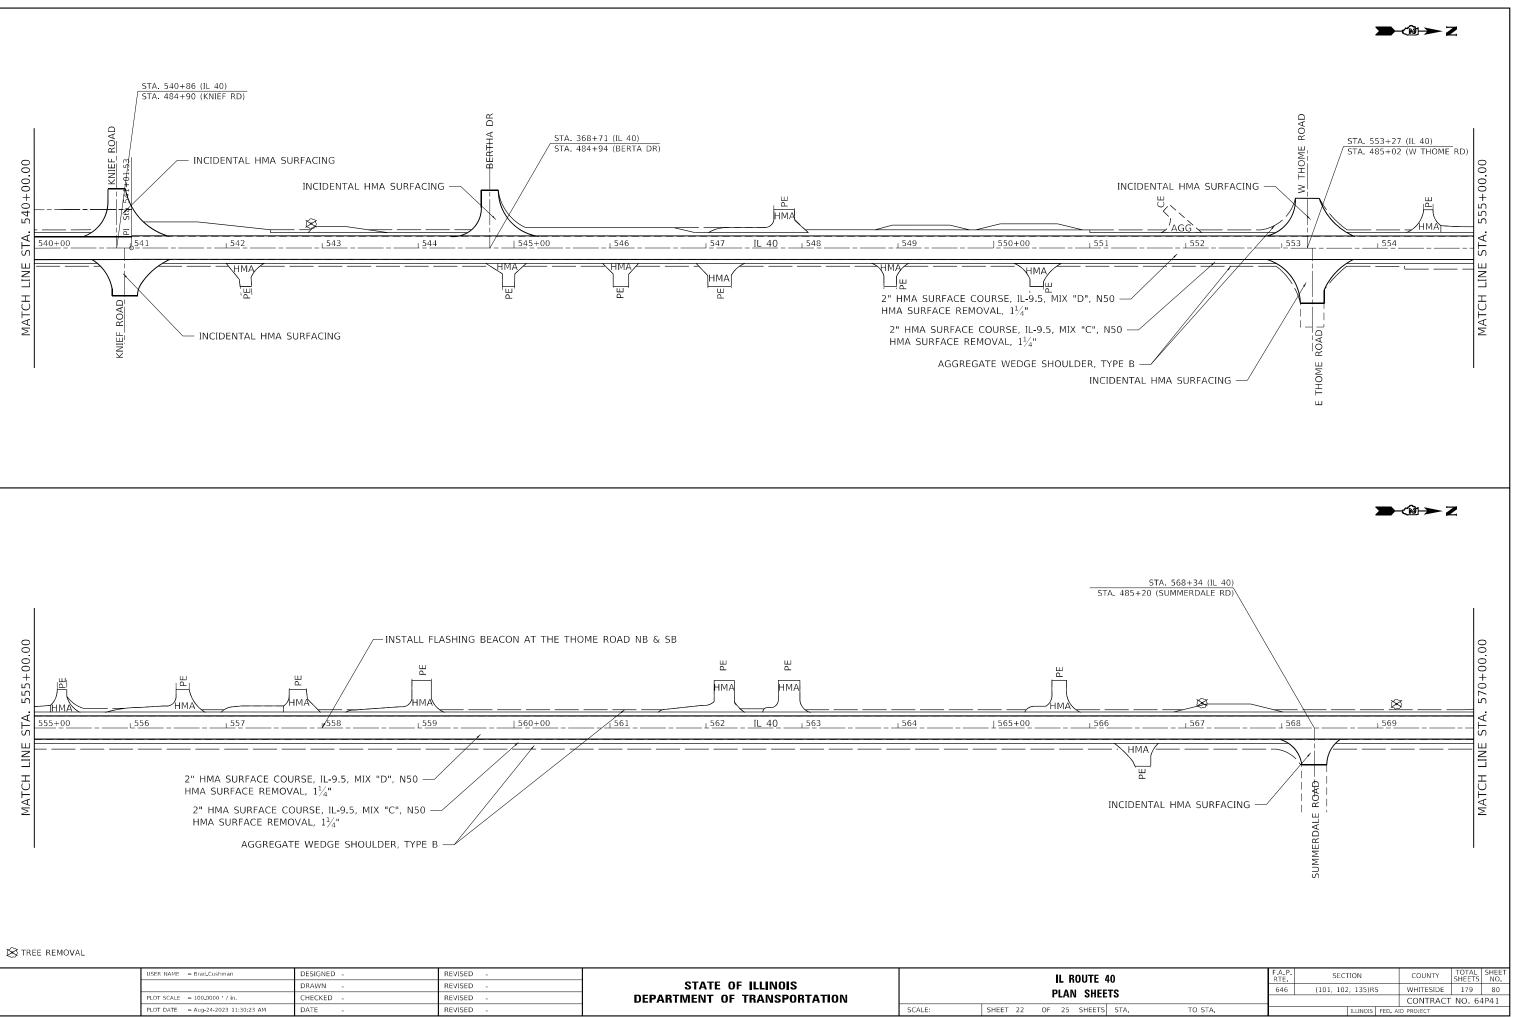


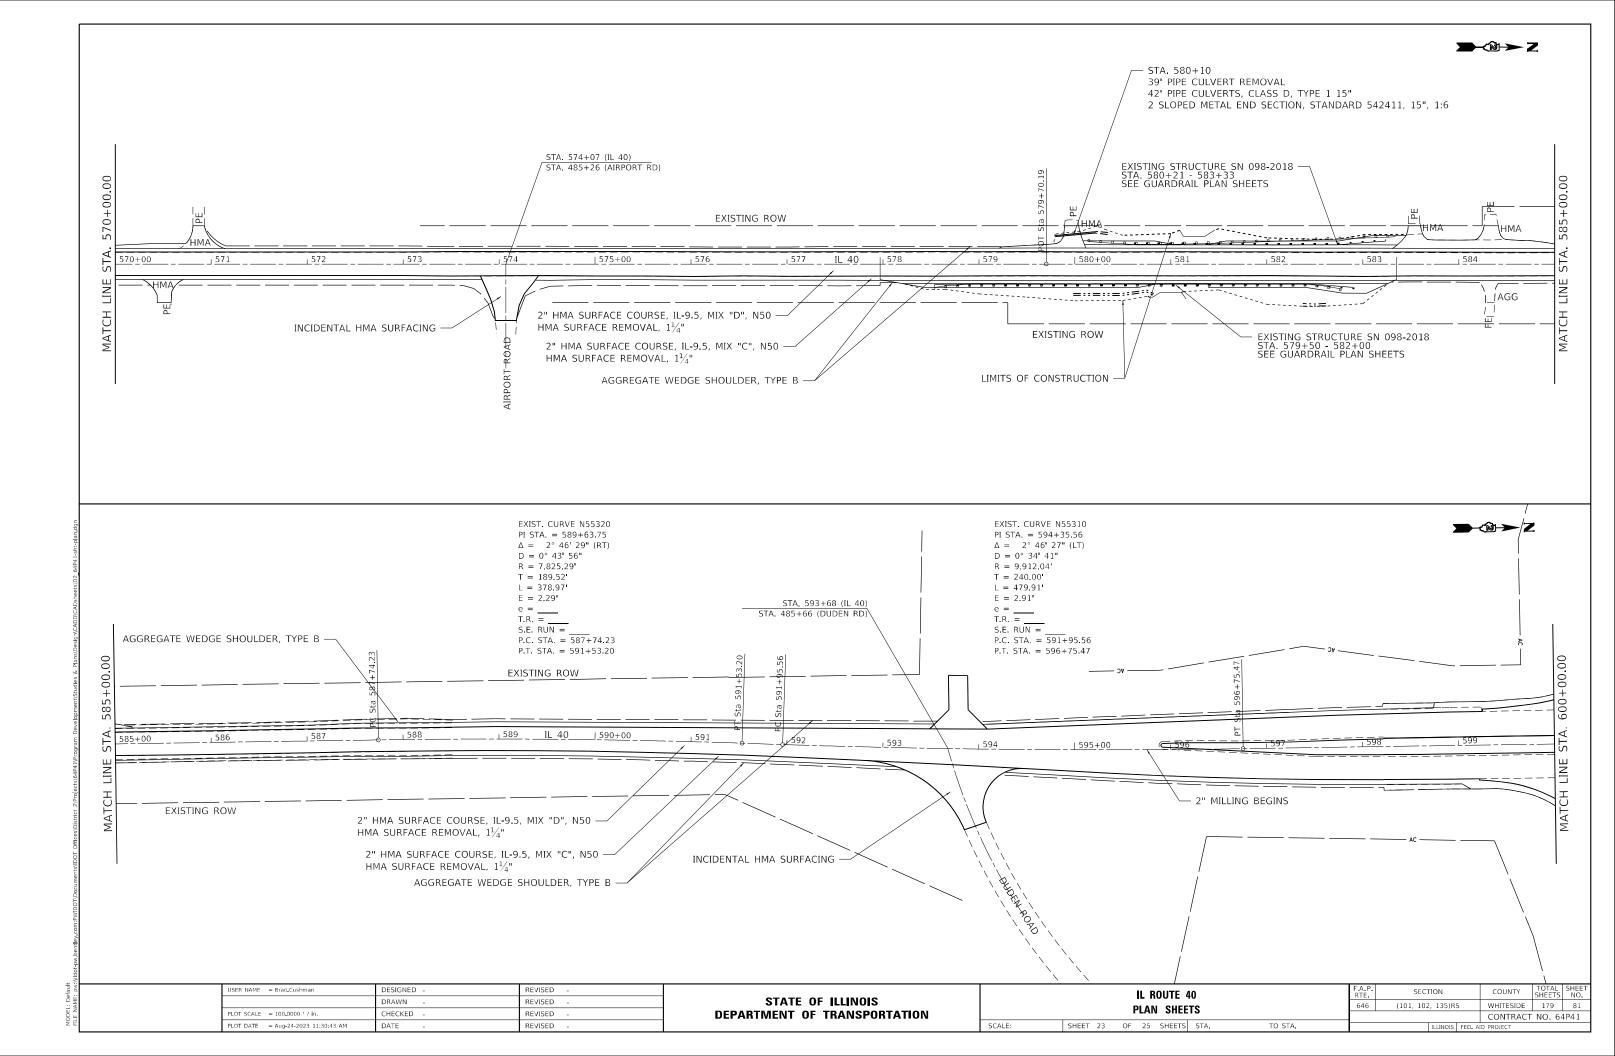

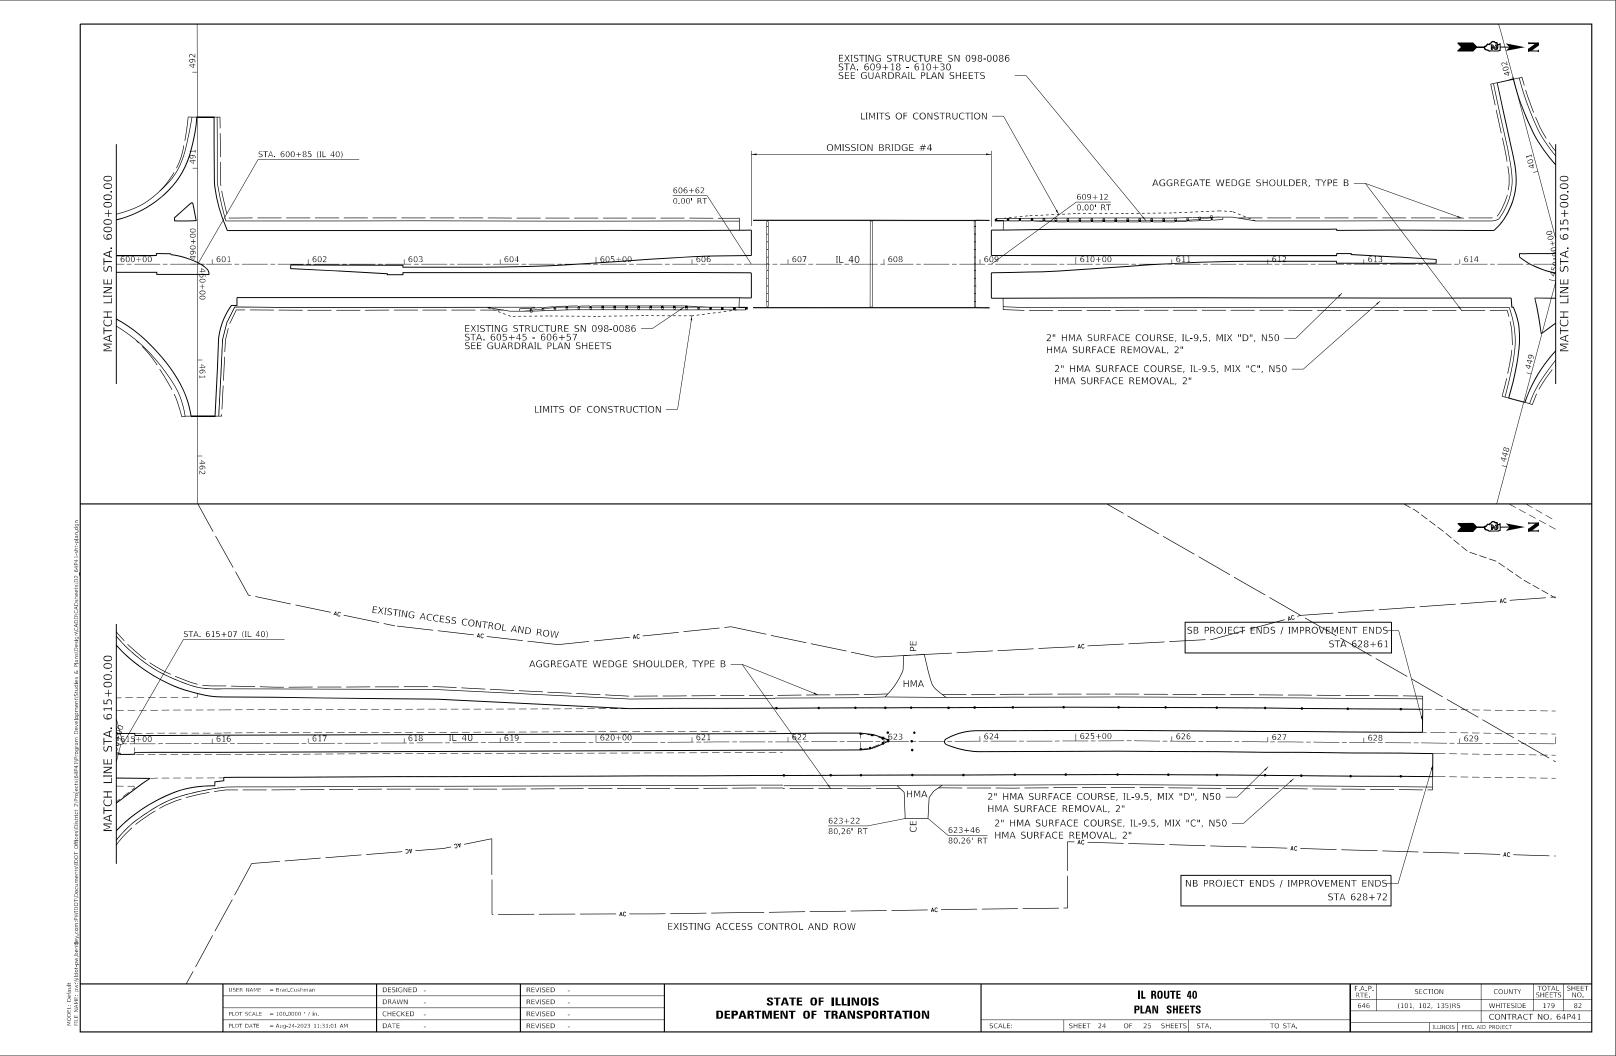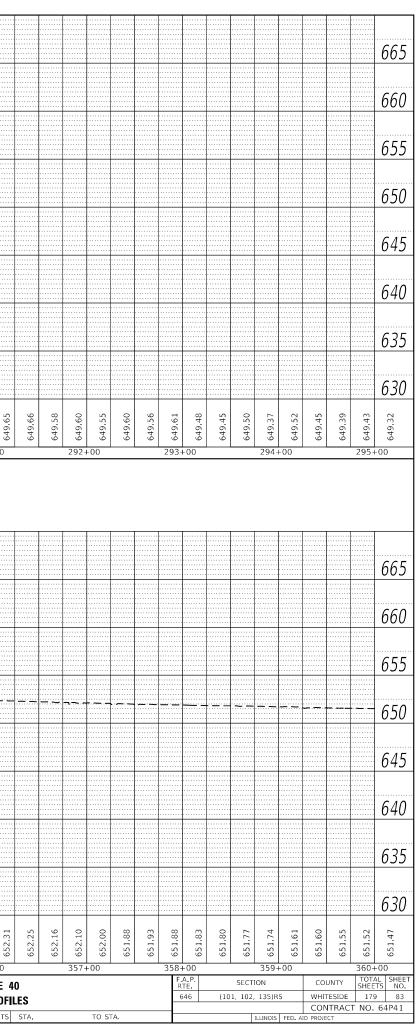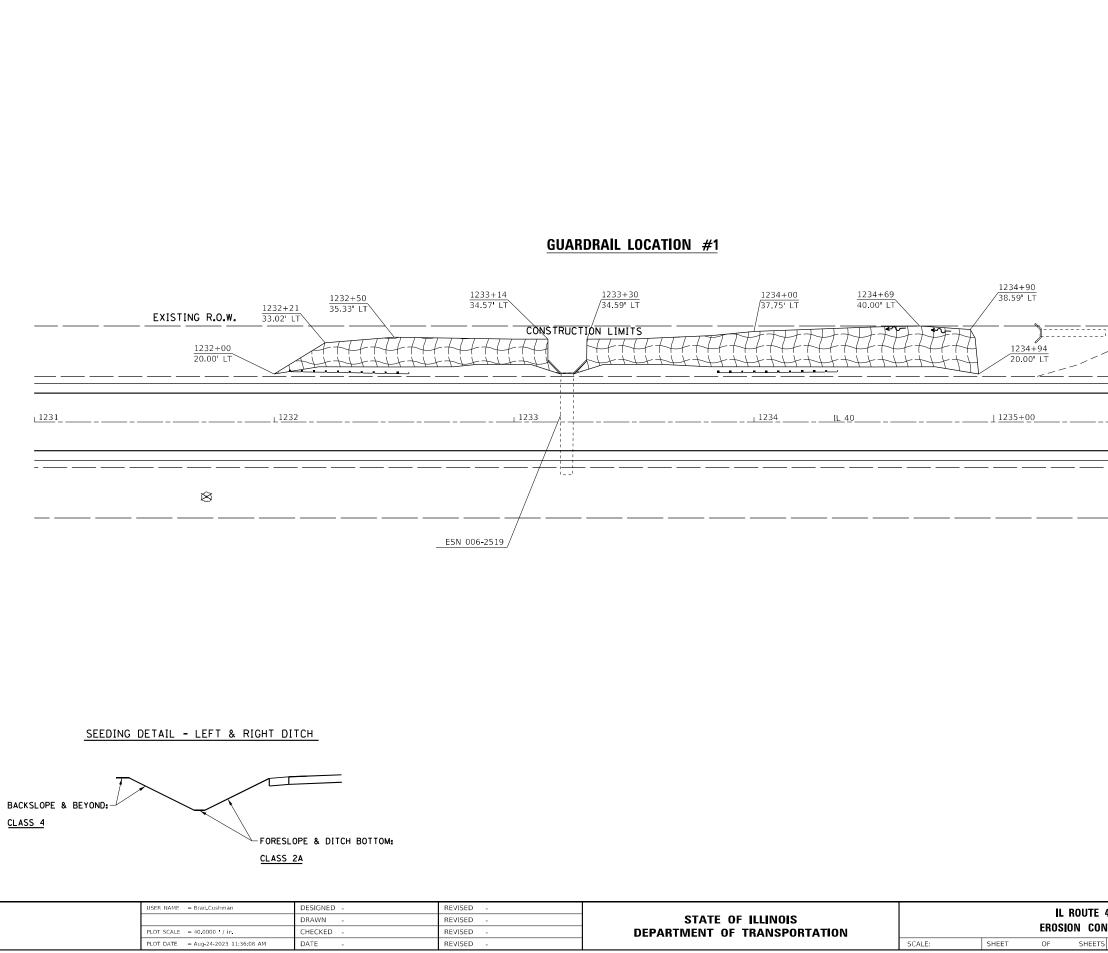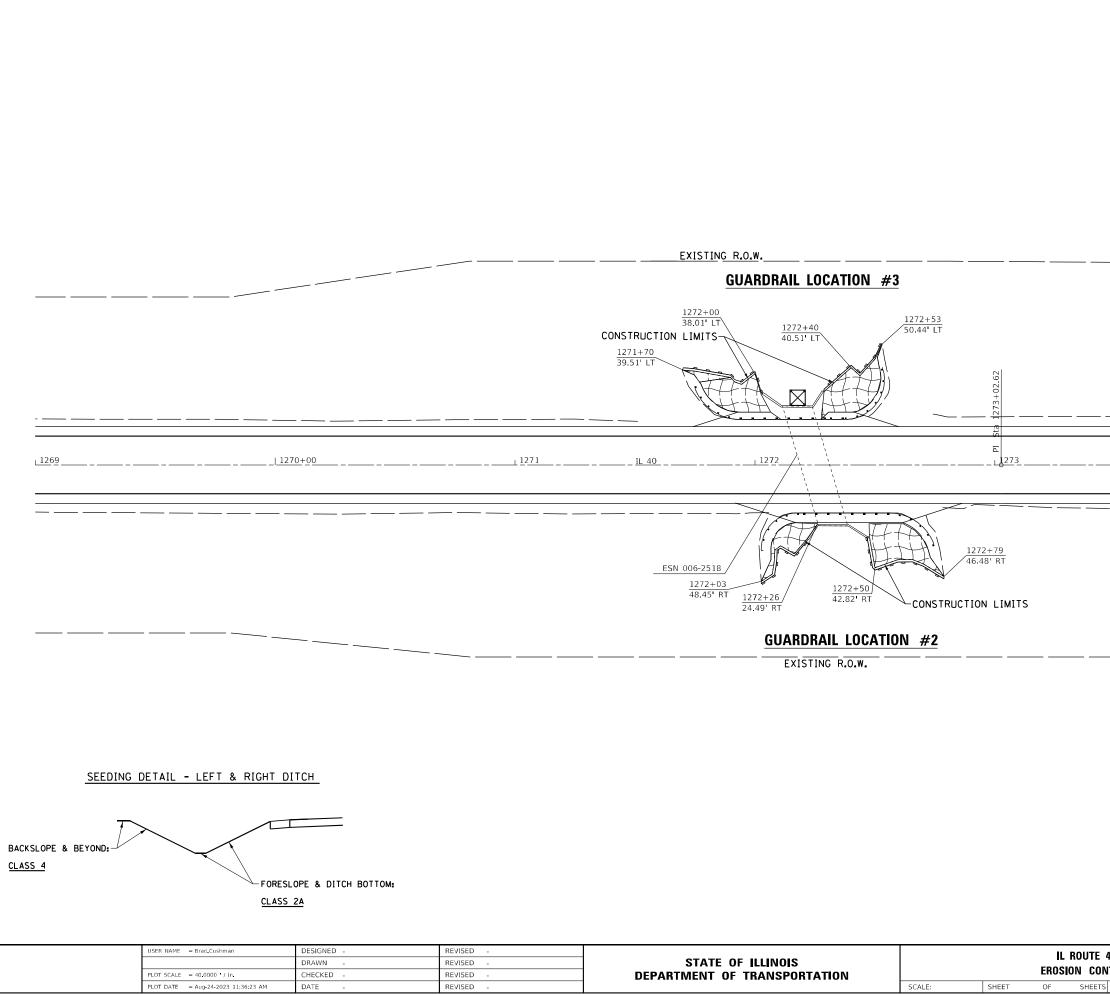


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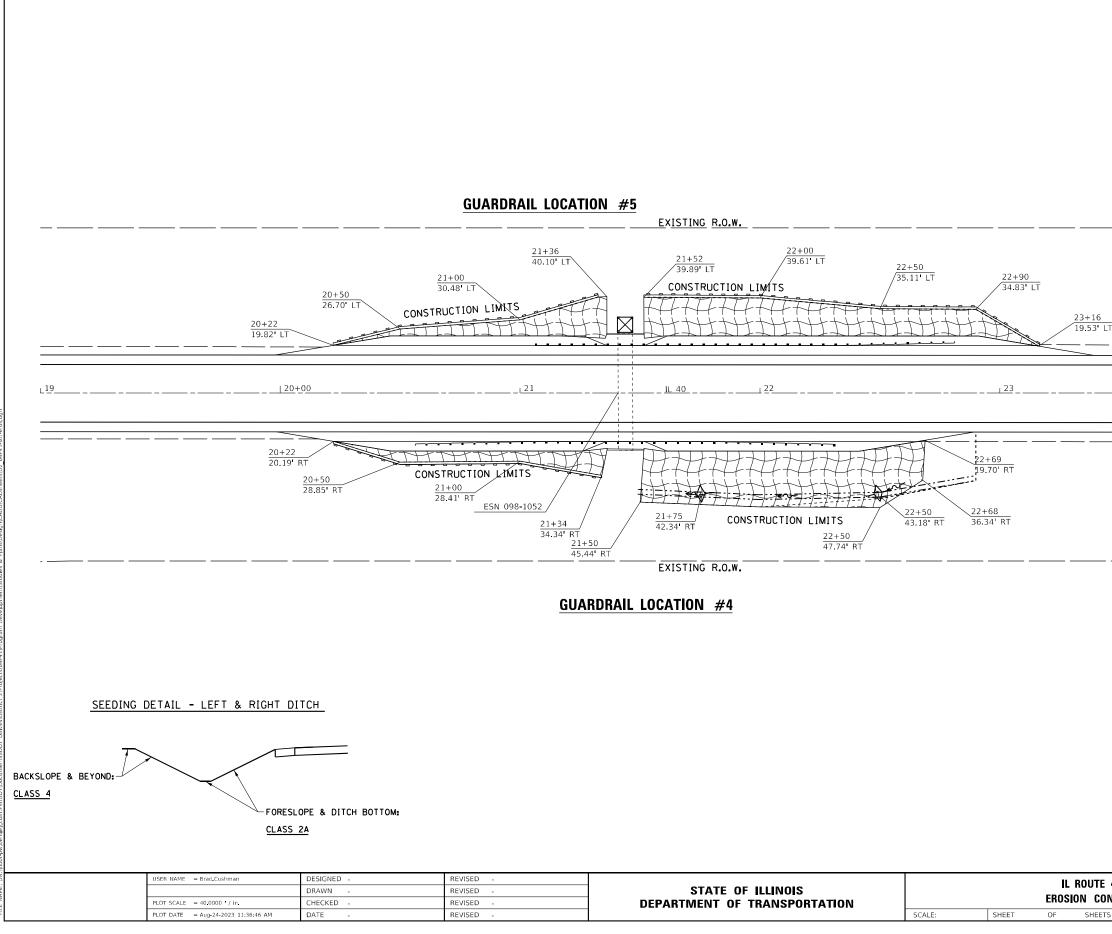


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EXISTING R.O.W.	
	LEGEND
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	= EROSION CONTROL BLANKET
L	* BUREAU/WHITESIDE
E 40	F.A.P. RTE. SECTION COUNTY TOTAL SHEETS SHEETS NO. *646 (101, 102, 135)RS * 179 84
DNTROL TS STA. TO STA.	*646 (101, 102, 133)KS 179 64 CONTRACT NO. 64P41 ILLINOIS FED. AID PROJECT



		> < <u>№</u> > Z
	<u>1274</u>	
		<u>LEGEND</u> = EROSION CONTROL BLANKET = PERIMETER EROSION BARRIER
40 NTROL		= PERIMETER ERUSION BARRIER = INLET AND PIPE PROTECTION * BUREAU/WHITESIDE FA.P. SECTION COUNTY TOTAL SHEET *646 (101, 102, 135)RS * 179 85

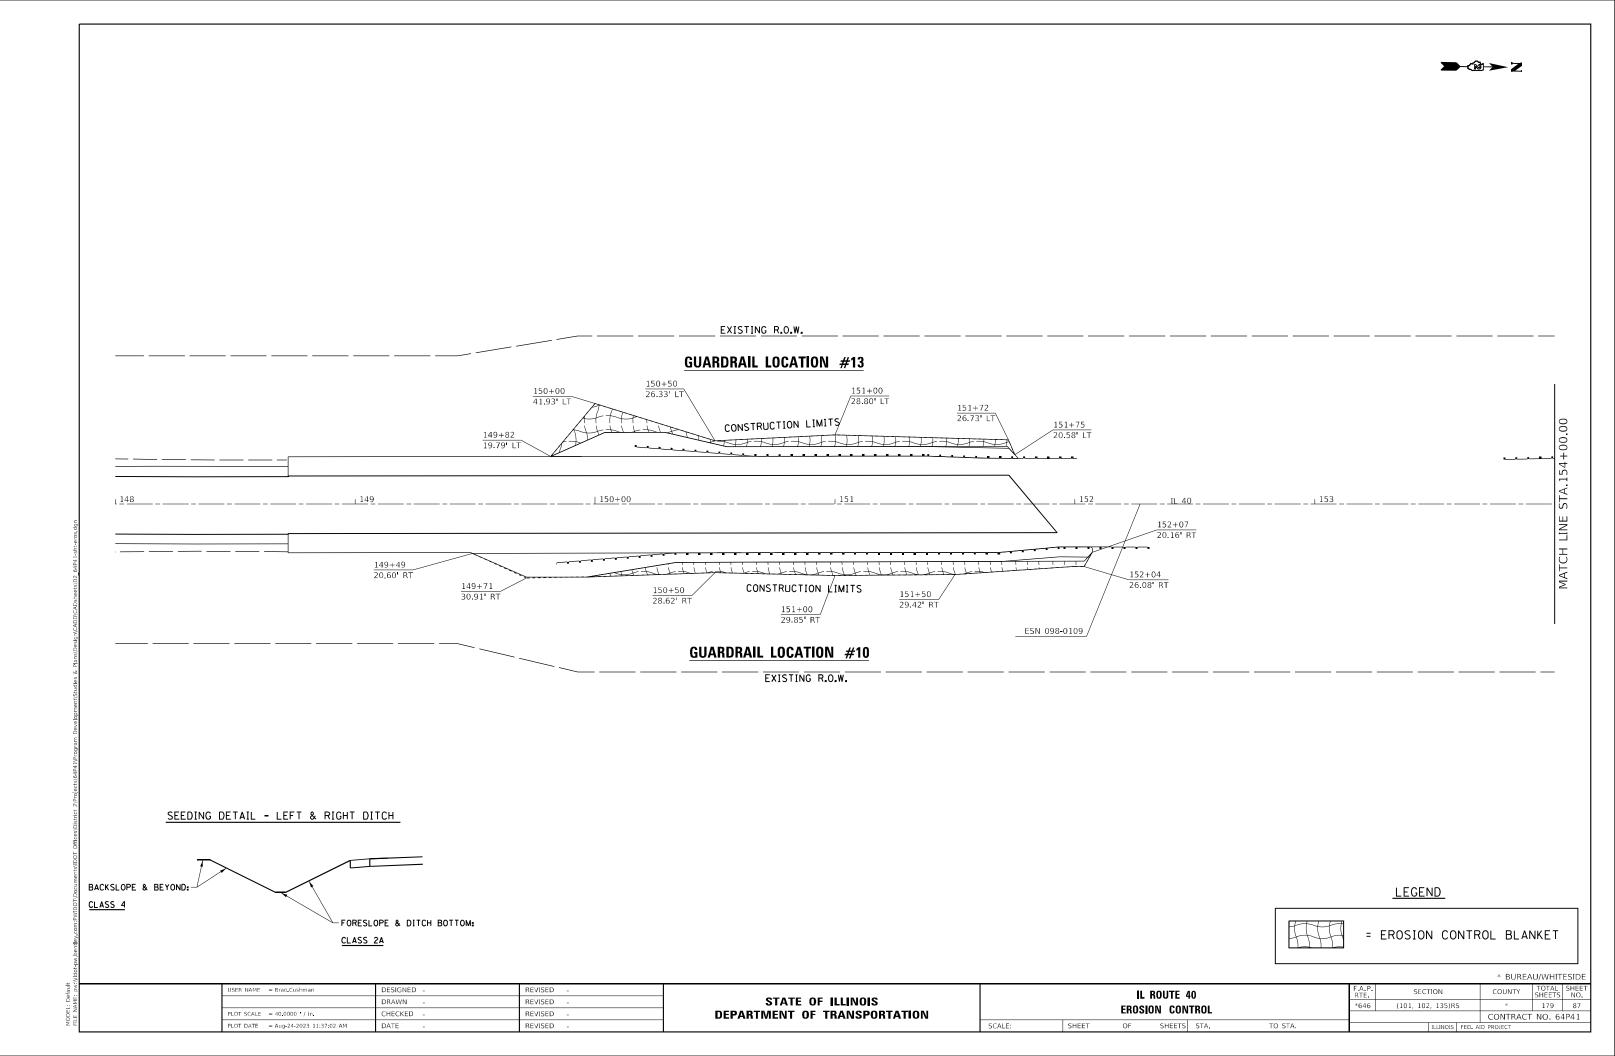
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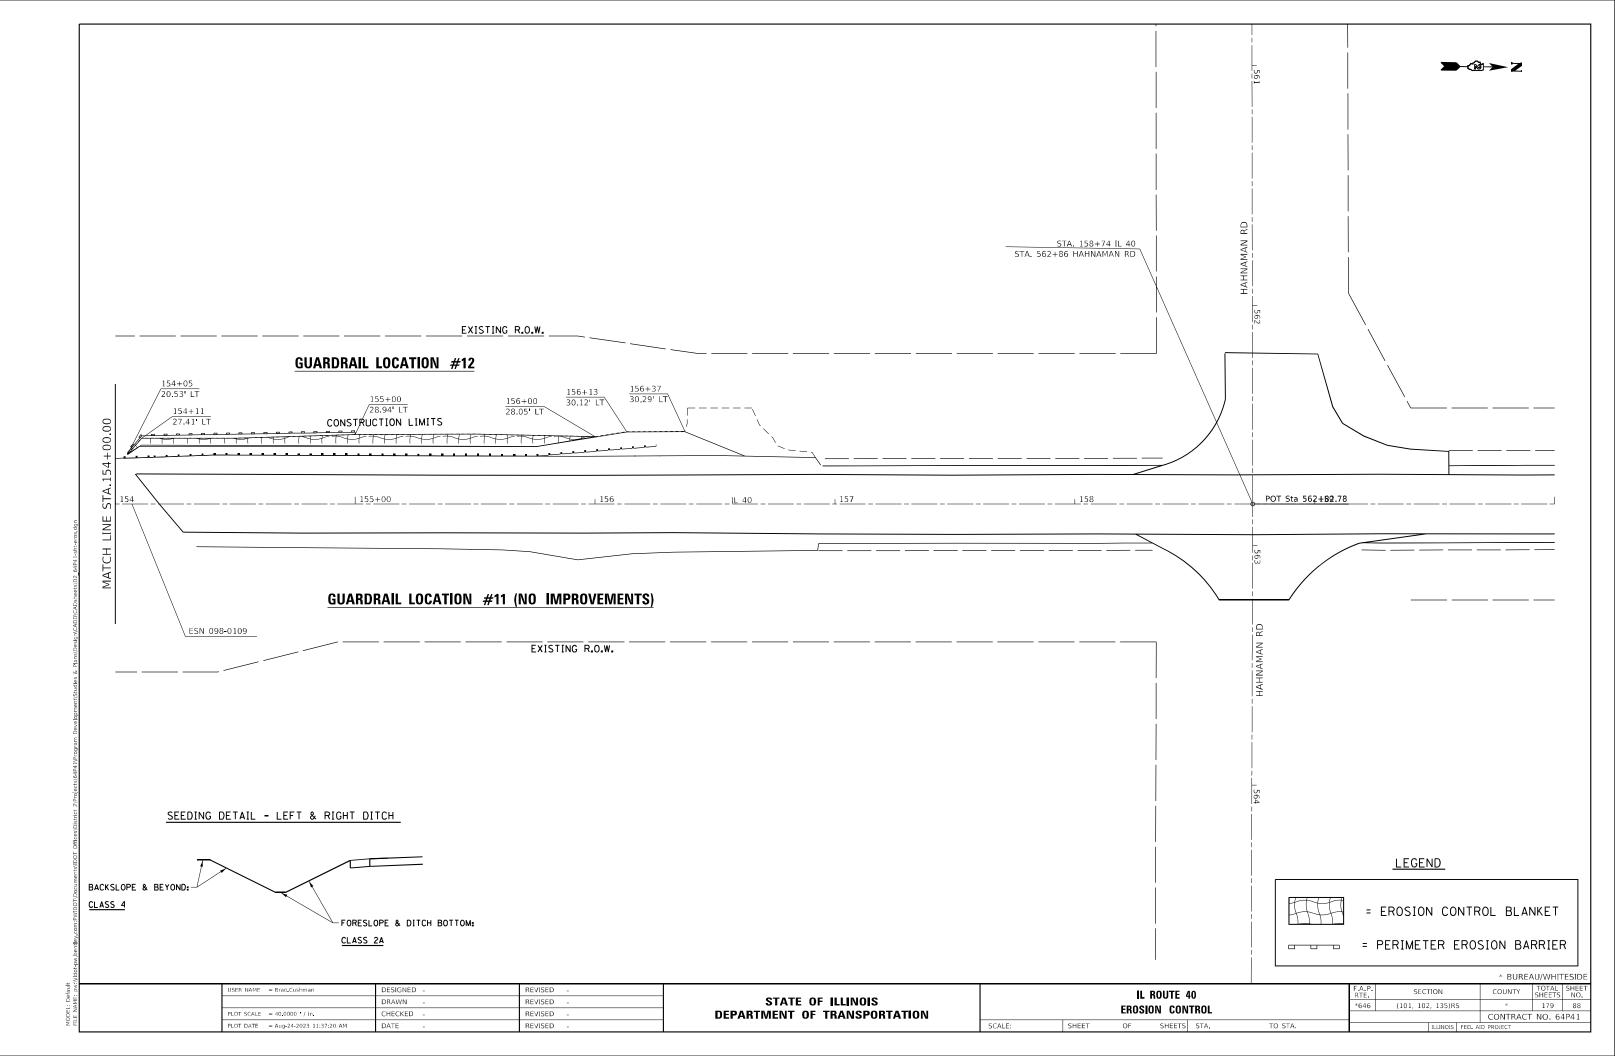


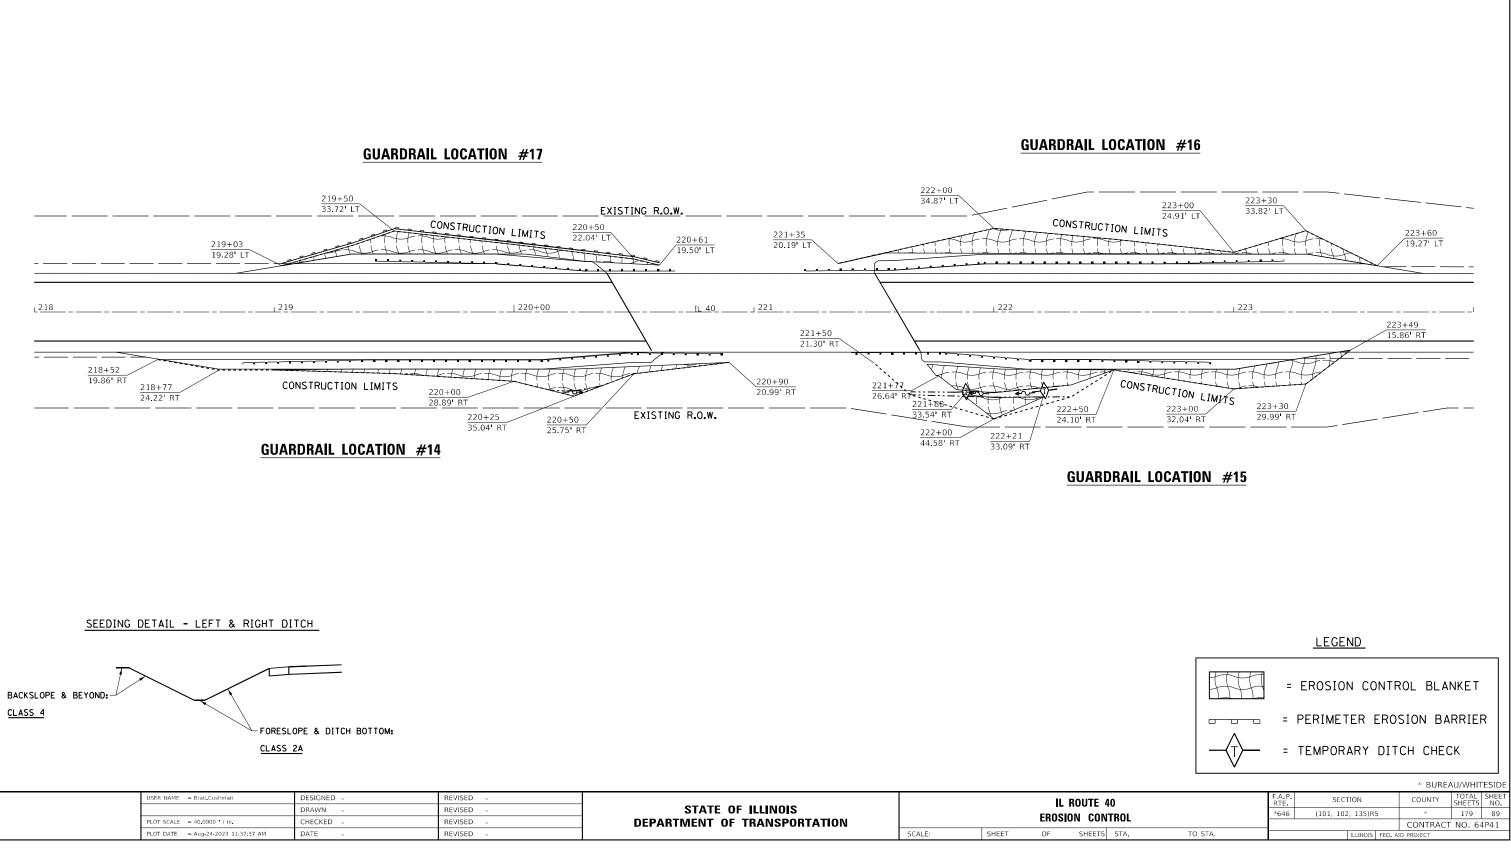
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LEGEND
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					* BUREA	U/WHIT	ESIDE
40			F.A.P. RTE	SECTION	COUNTY	TOTAL SHEETS	SHEET NO.
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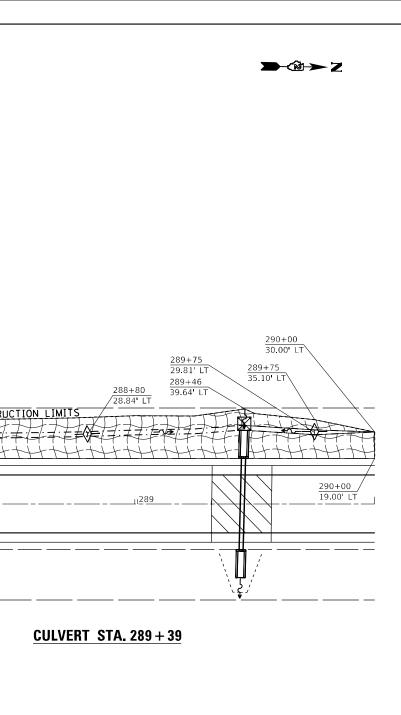




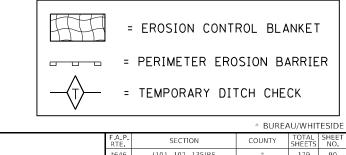


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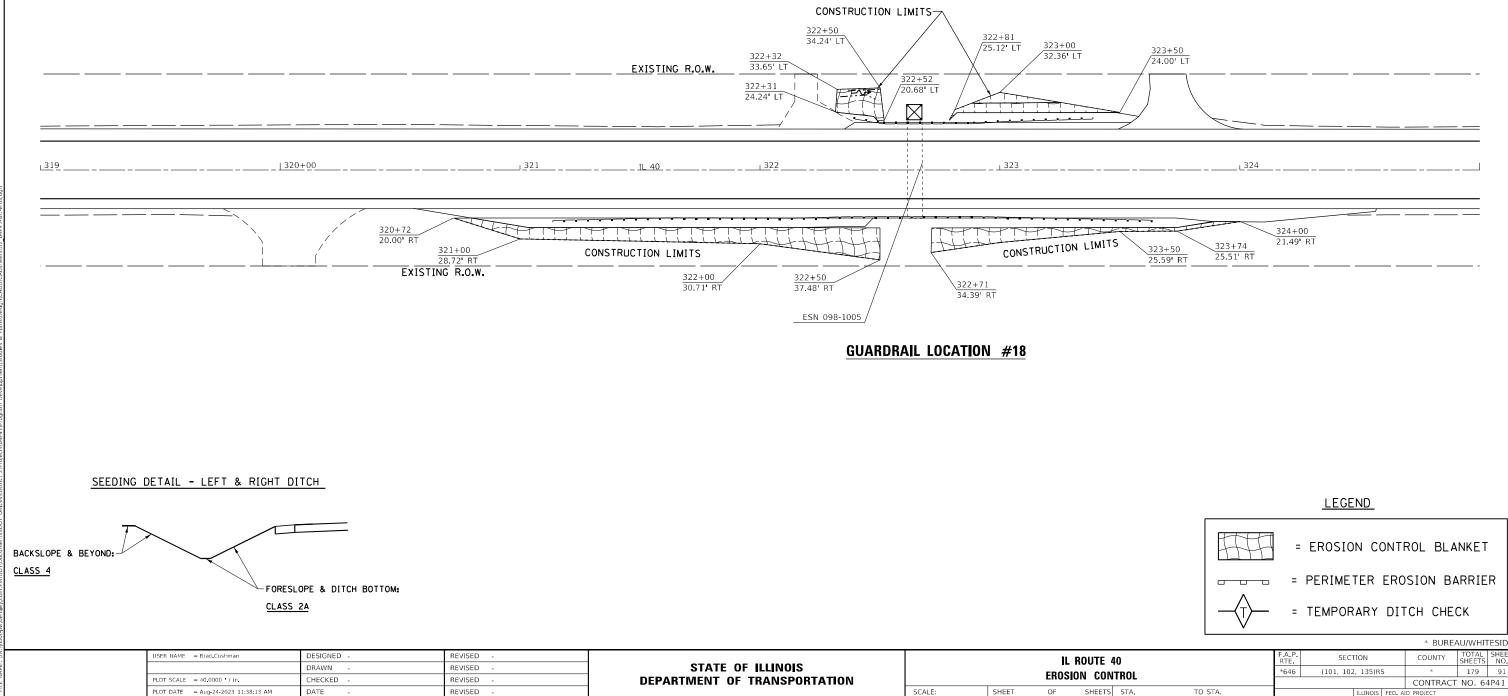






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าก	TROL		*646	(101, 102	, 135)R	S	*	179	90	
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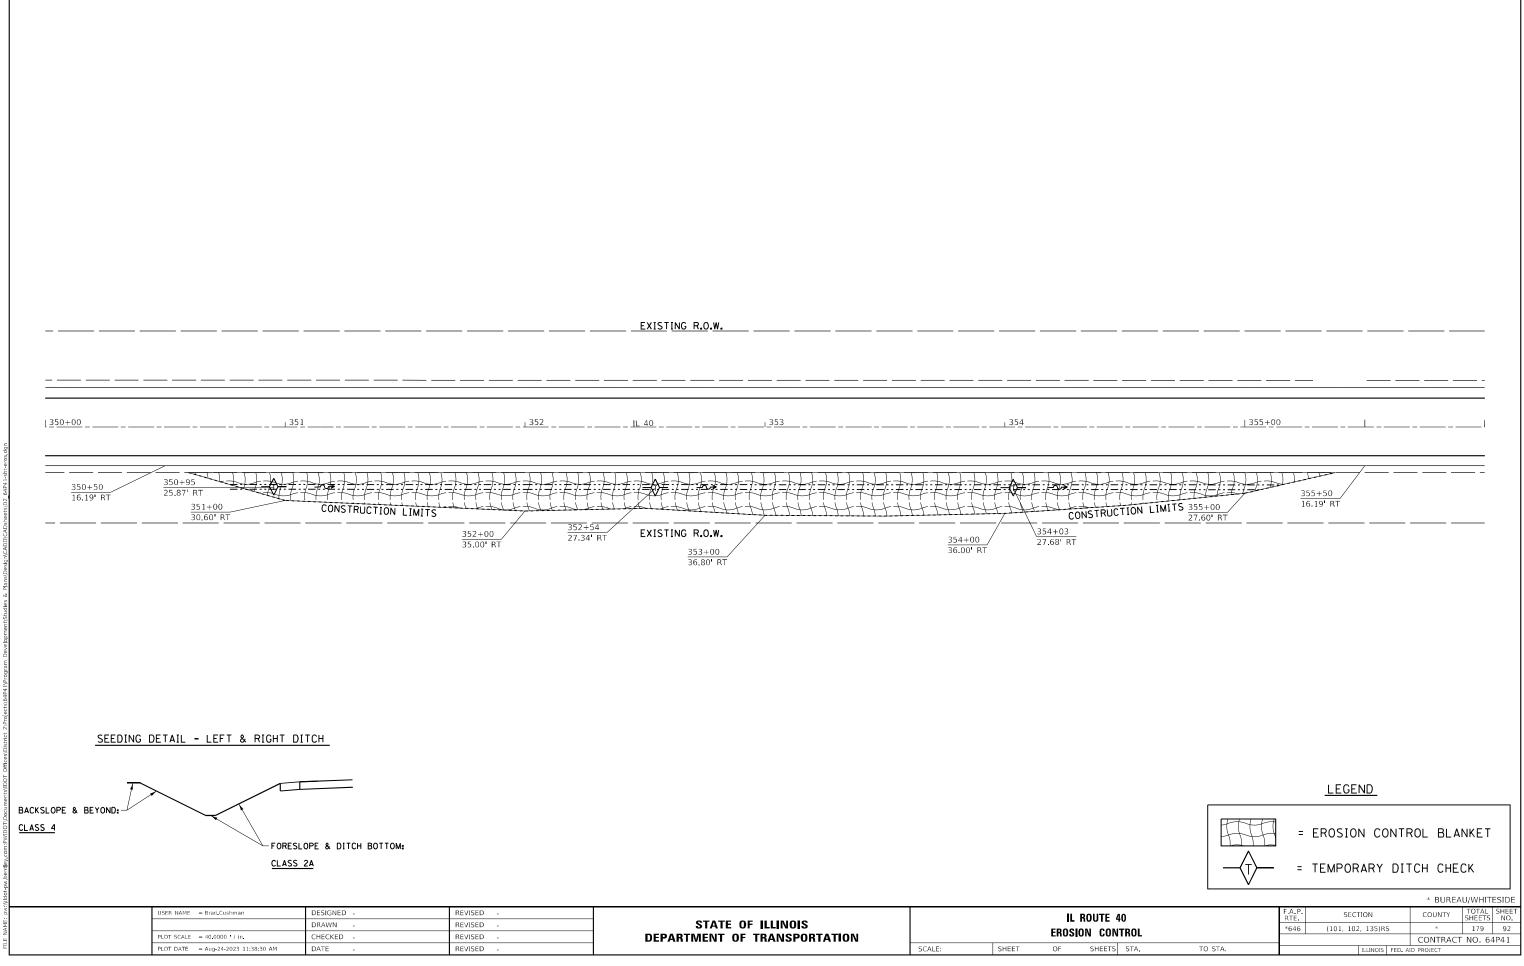
GUARDRAIL LOCATION #19

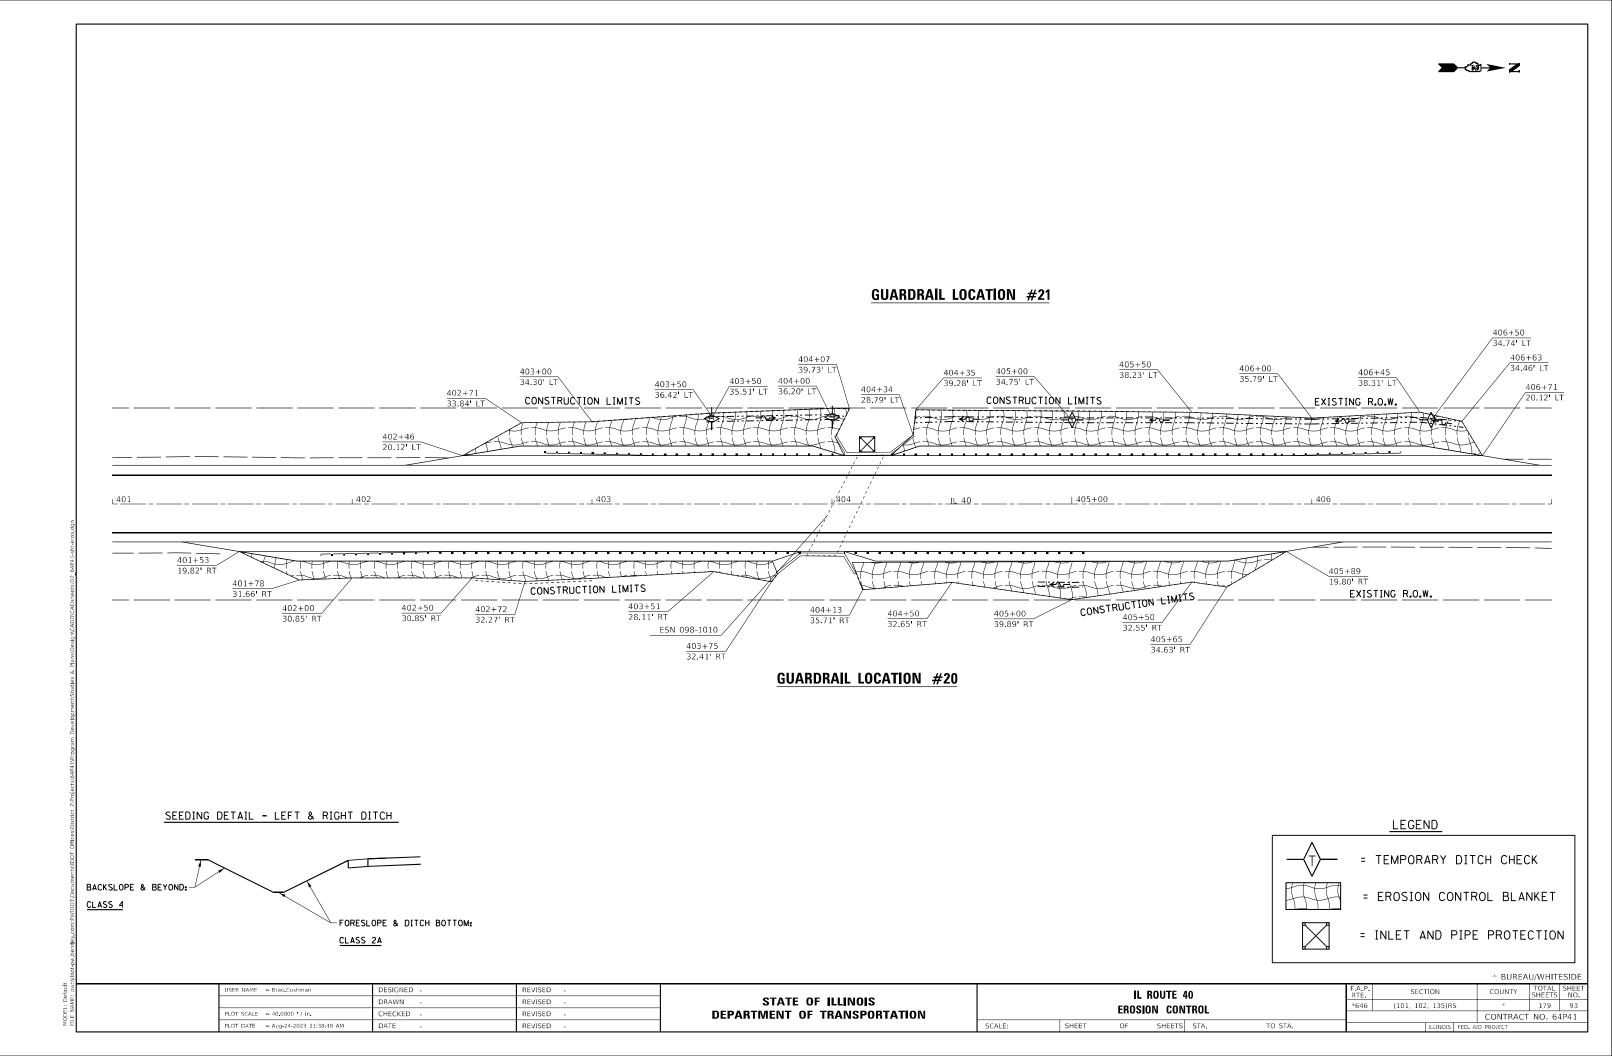


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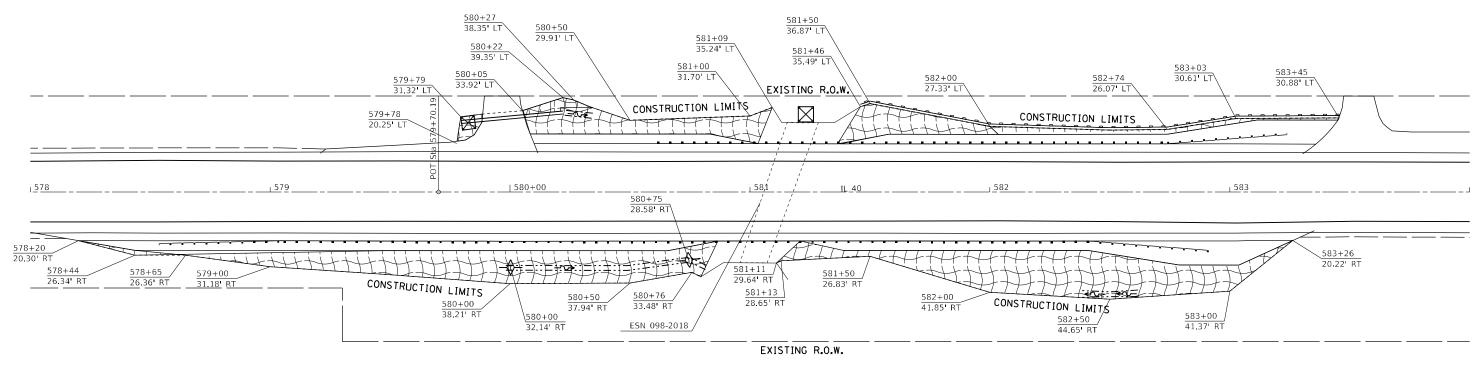
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	F.A.P. RTE	SECTION	COUNTY	TOTAL SHEETS	SHEET NO.
	*646	(101, 102, 135)RS	*	179	91
			CONTRACT	NO 6	10/1

SHEETS STA. TO STA.

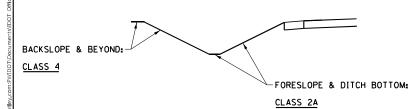








SEEDING DETAIL - LEFT & RIGHT DITCH

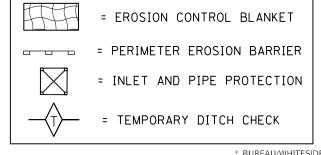


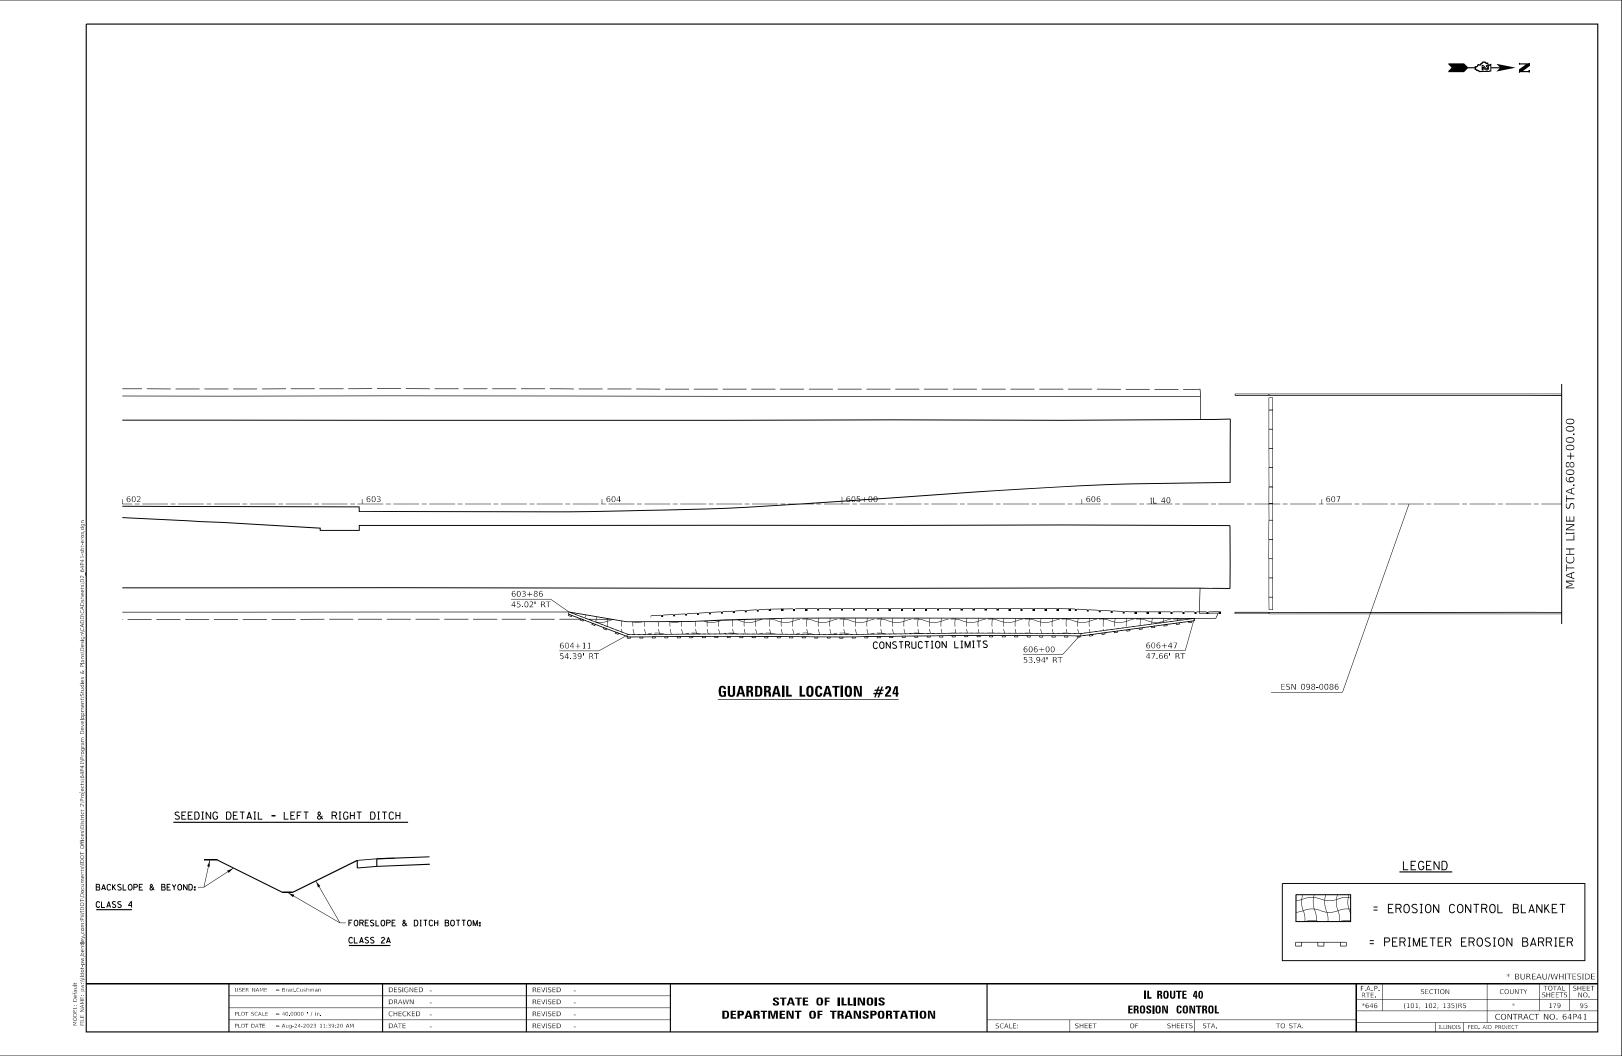
												* BORE	AU/WHITESIDE
USER NAME = Brad.Cushman	DESIGNED -	REVISED -				п	ROUTE 4	IN		F.A.P.	SECTION	COUNTY	TOTAL SHEET
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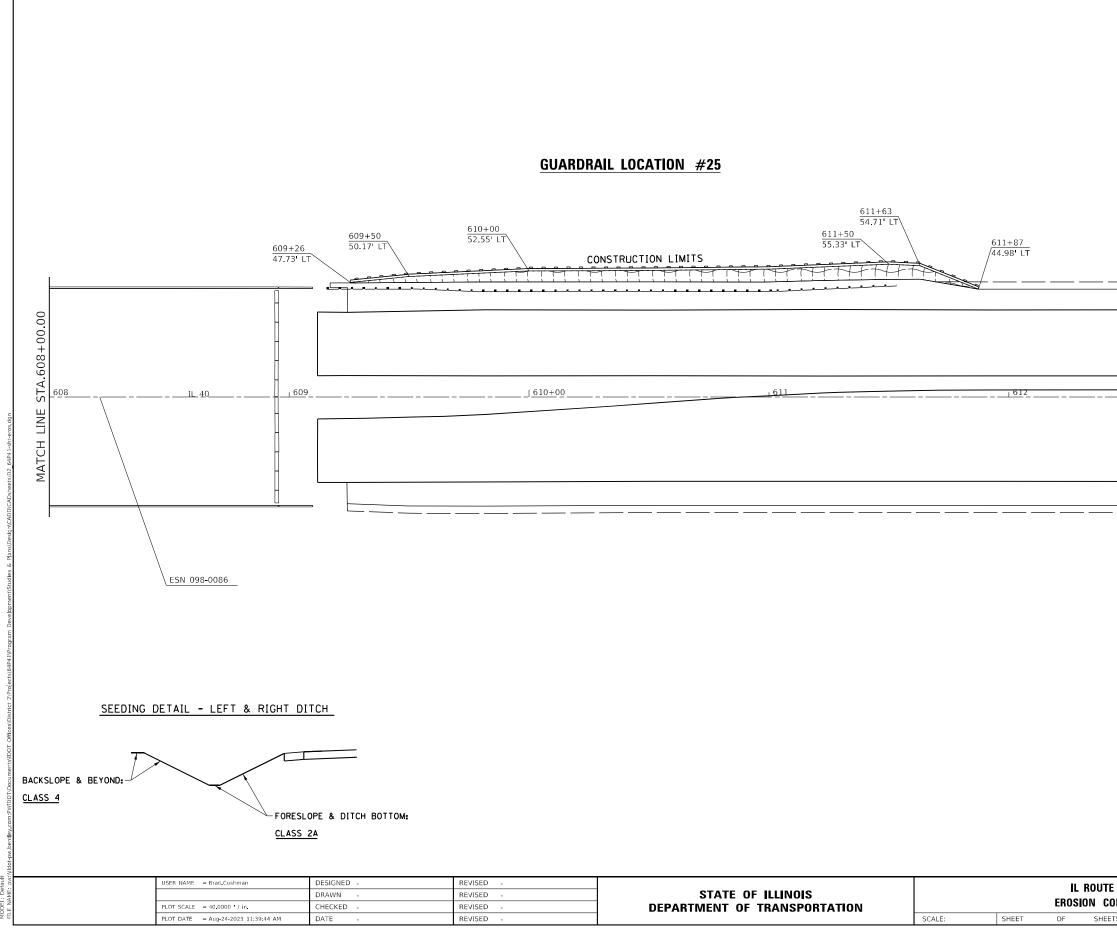


GUARDRAIL LOCATION #22

<u>LEGEND</u>

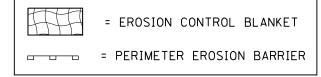




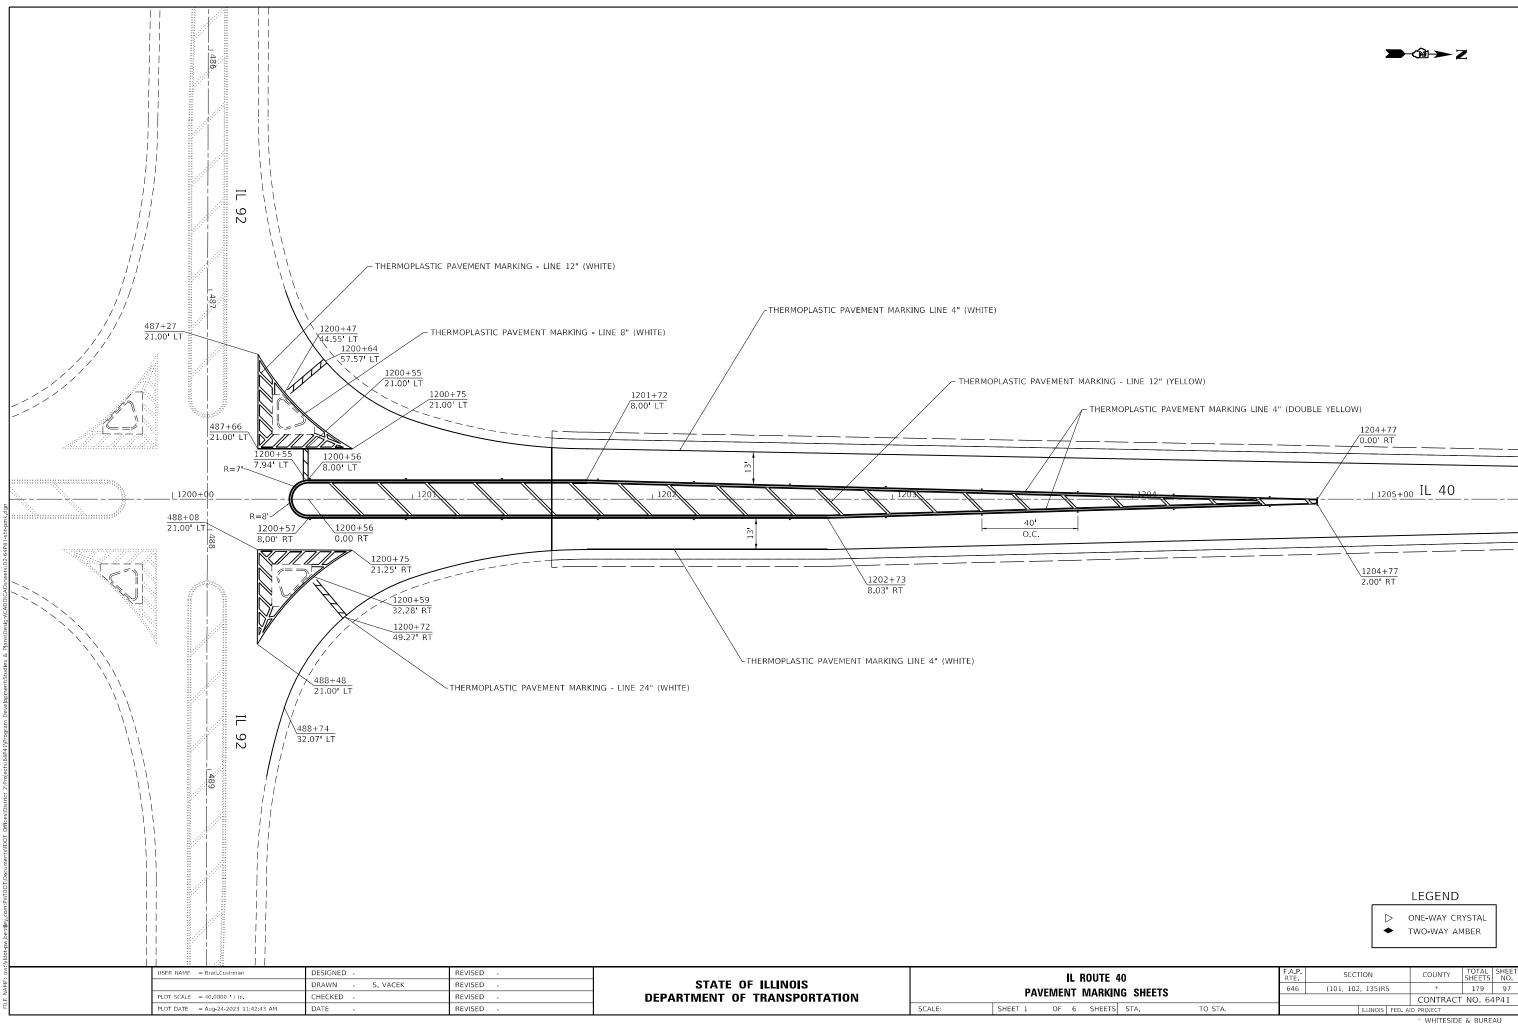




<u>LEGEND</u>

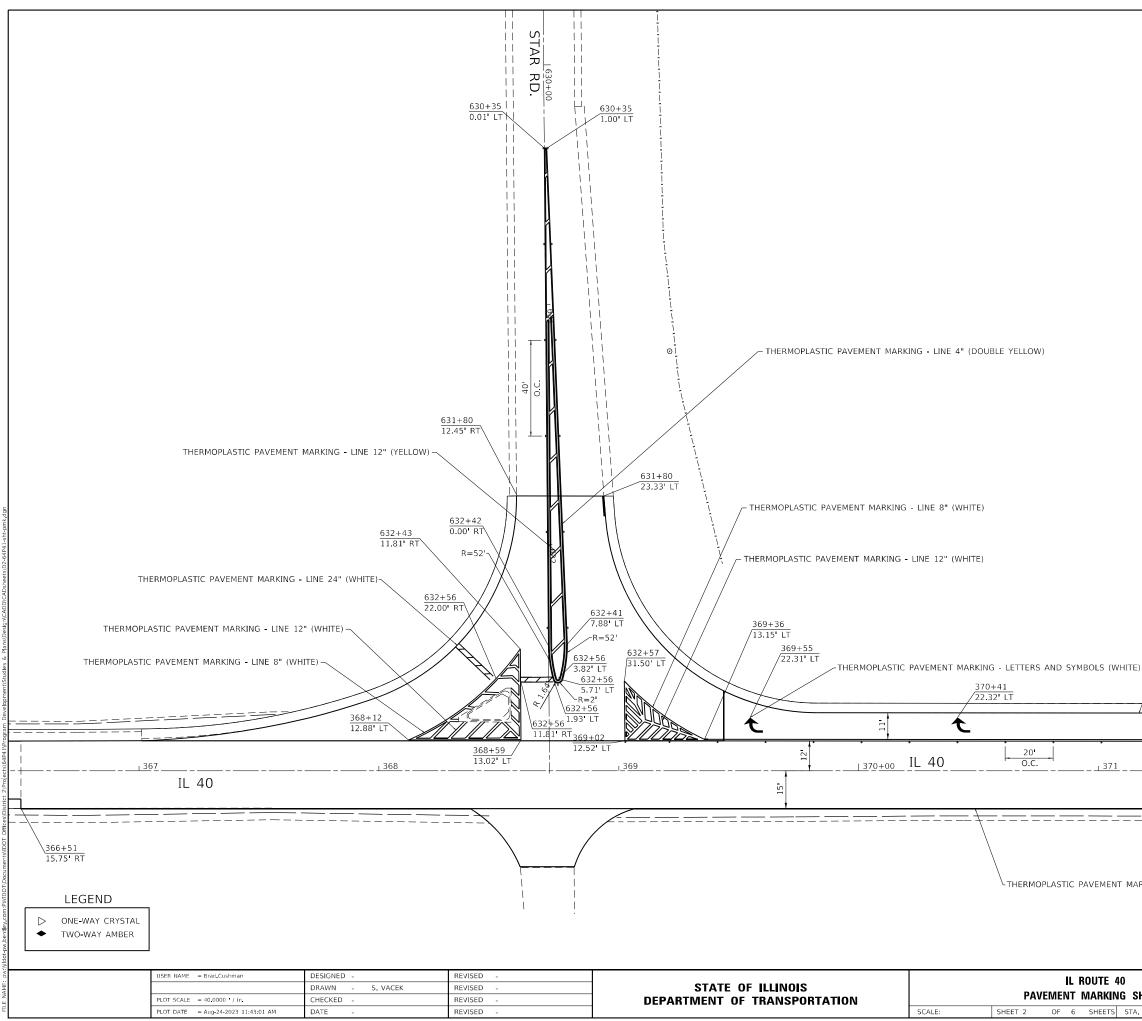


					* BURE	4U/WHI1	FESIDE
Εź	40		F.A.P. RTE	SECTION	COUNTY	TOTAL SHEETS	SHEET NO.
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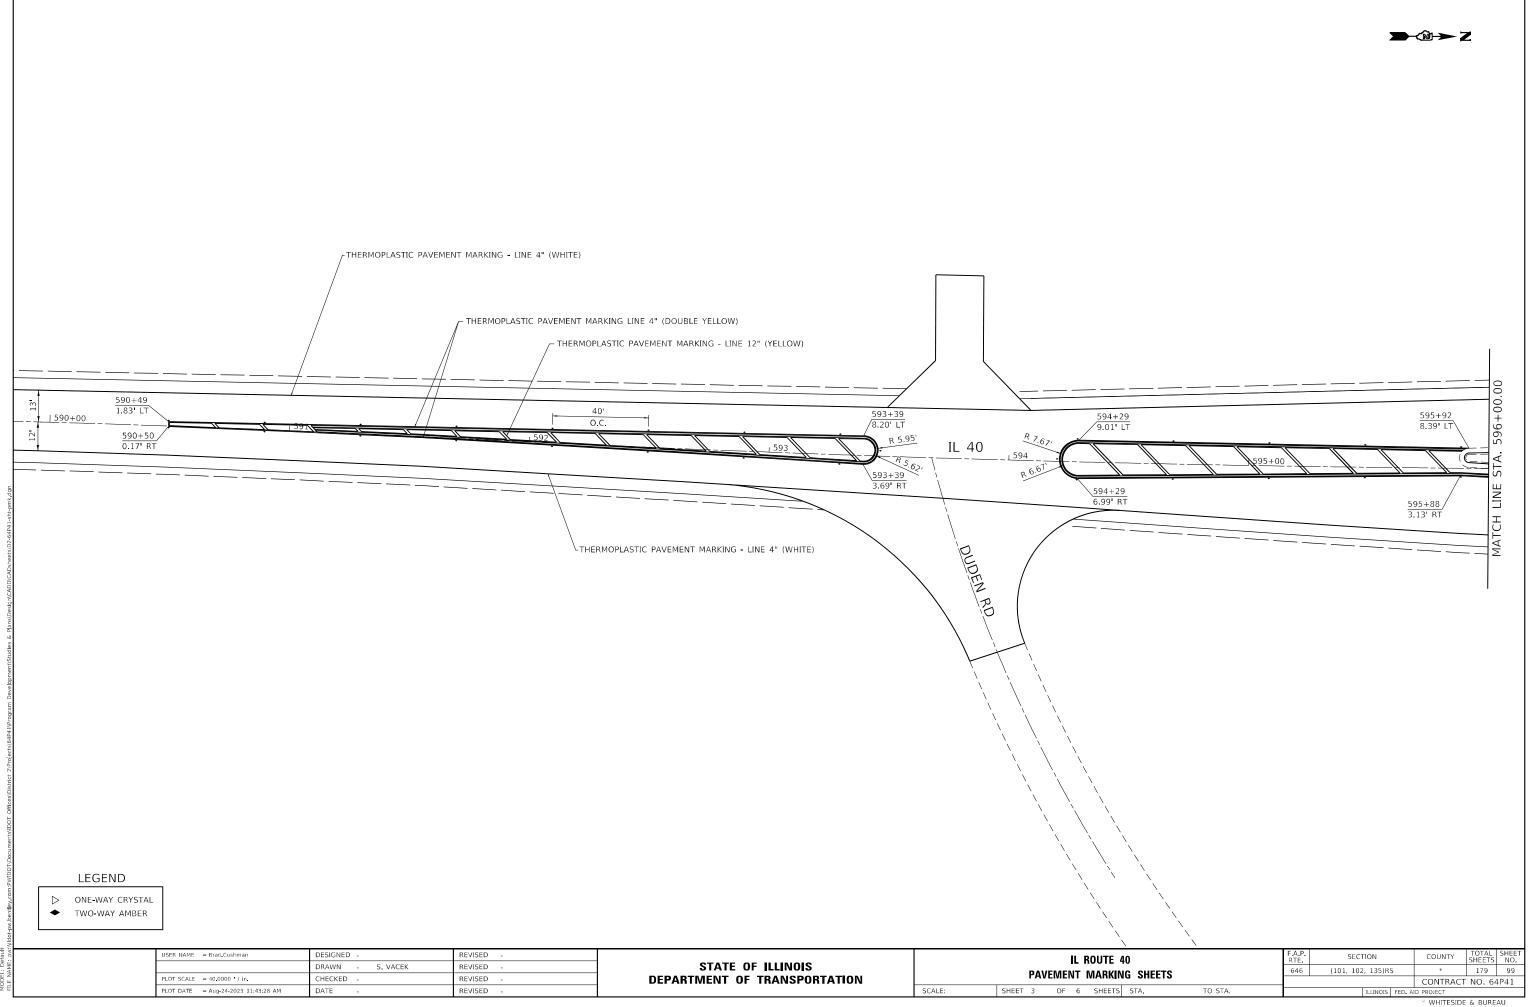
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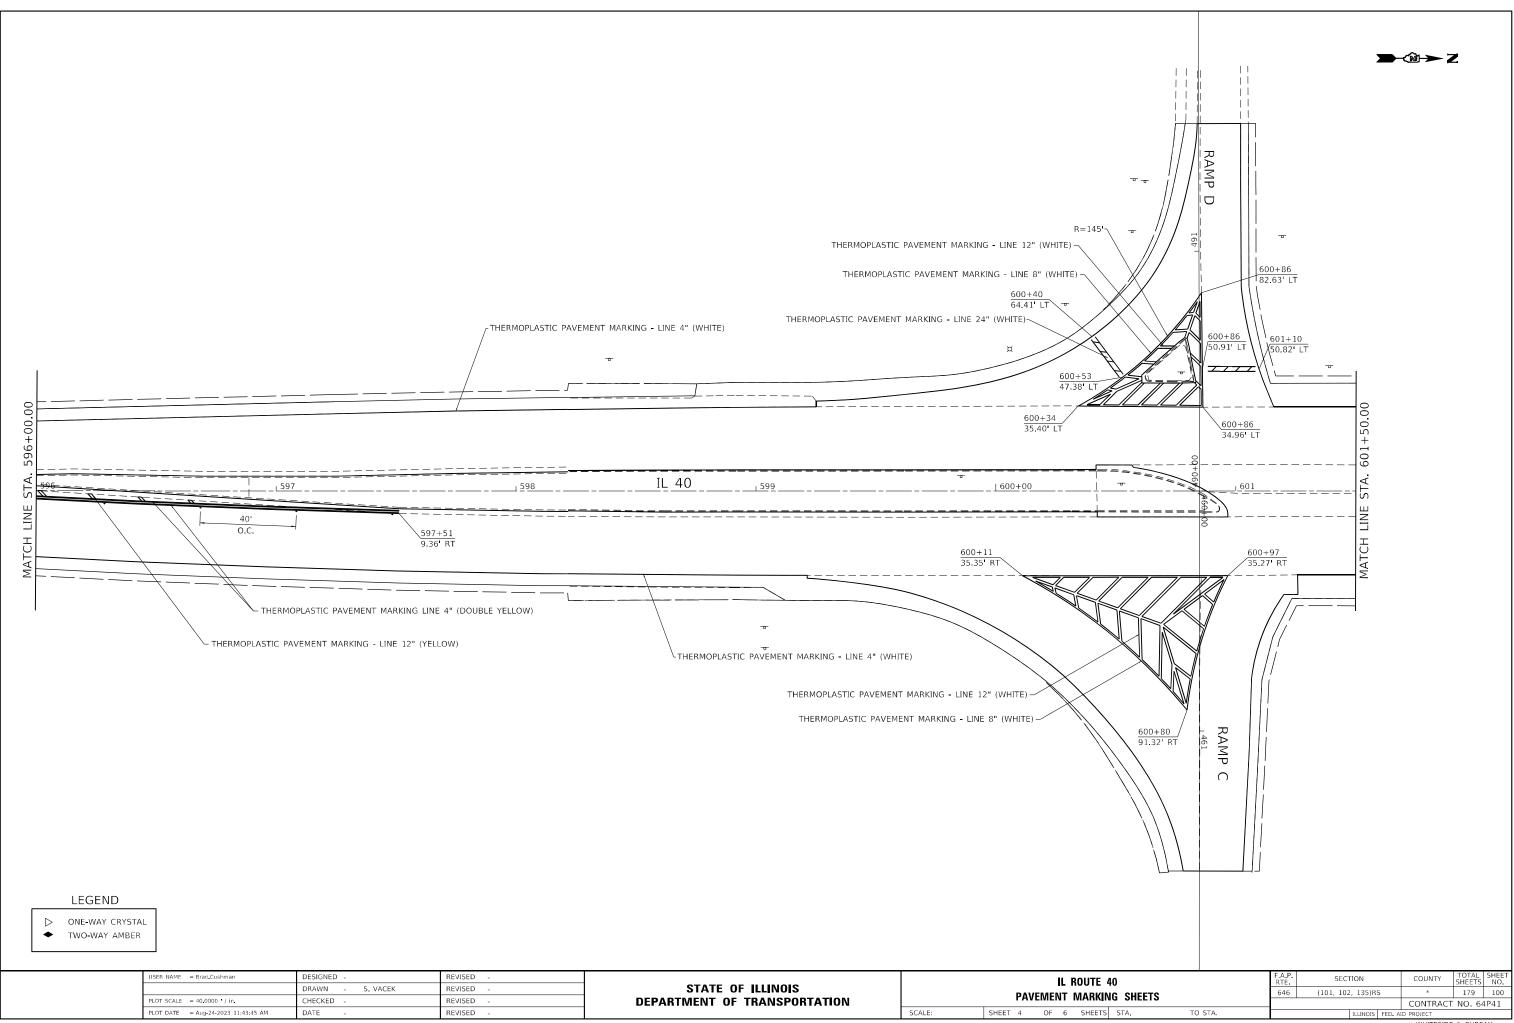
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E 40	F.A.P. RTE	SECTION	COUNTY		SHEET NO.
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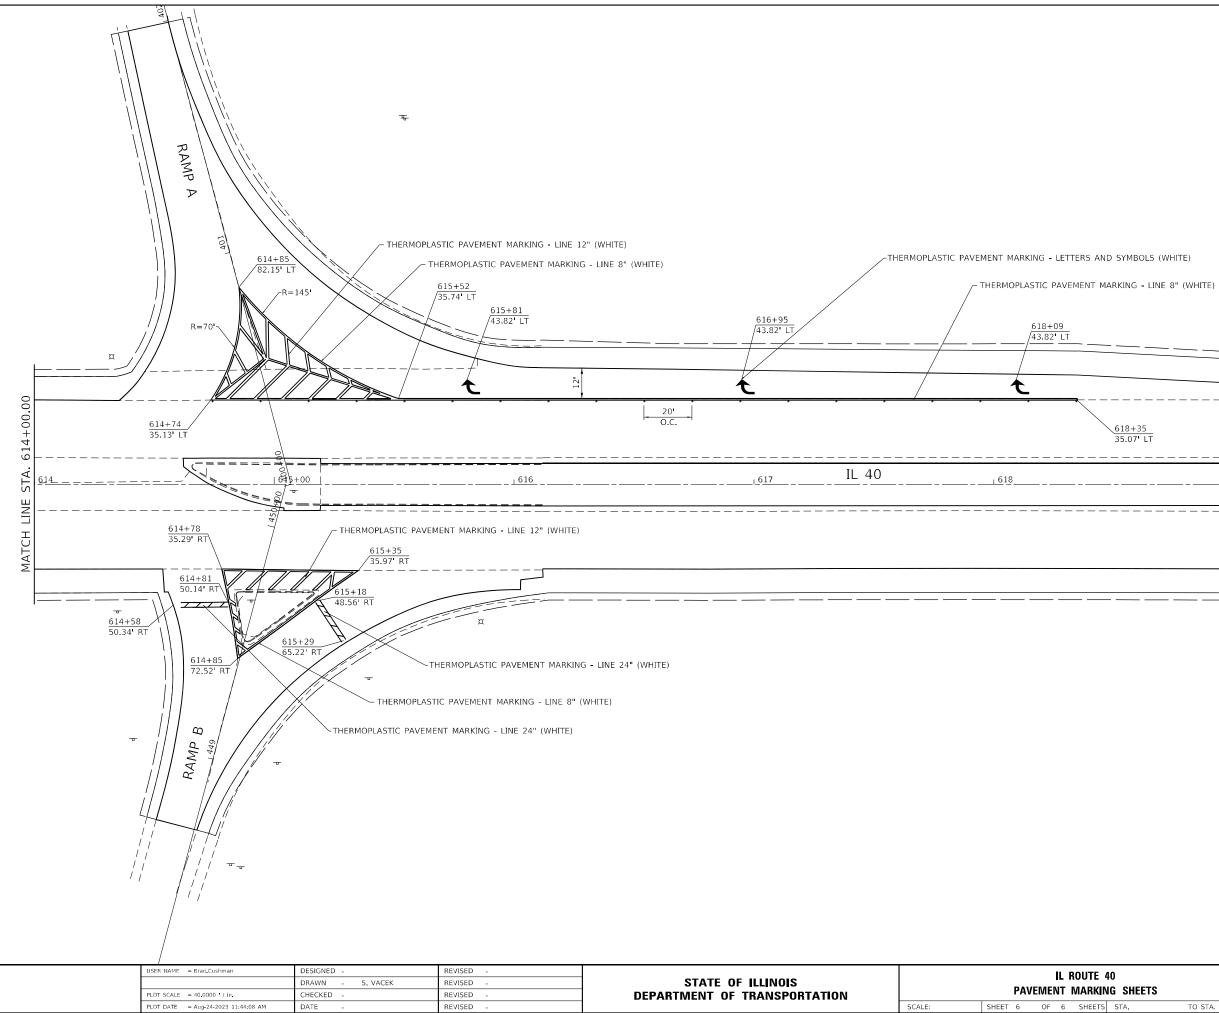
ILLINOIS FED. AID PROJECT × WHITESIDE & BUREAU





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DATE -	REVISED -	

WHITESIDE & BUREAU




618+35 35.07' LT

LEGEND


620+0

ONE-WAY CRYSTAL TWO-WAY AMBER

40 ING SHEETS		SECT	SECTION			TOTAL SHEETS	SHEET NO.	
		(101, 102, 135)RS			*	179	101	
					CONTRACT NO. 64P41			
TS STA. TO STA.			ILLINOIS	FED. A	D PROJECT			
					× WHITESIDE	& BURE	AU	

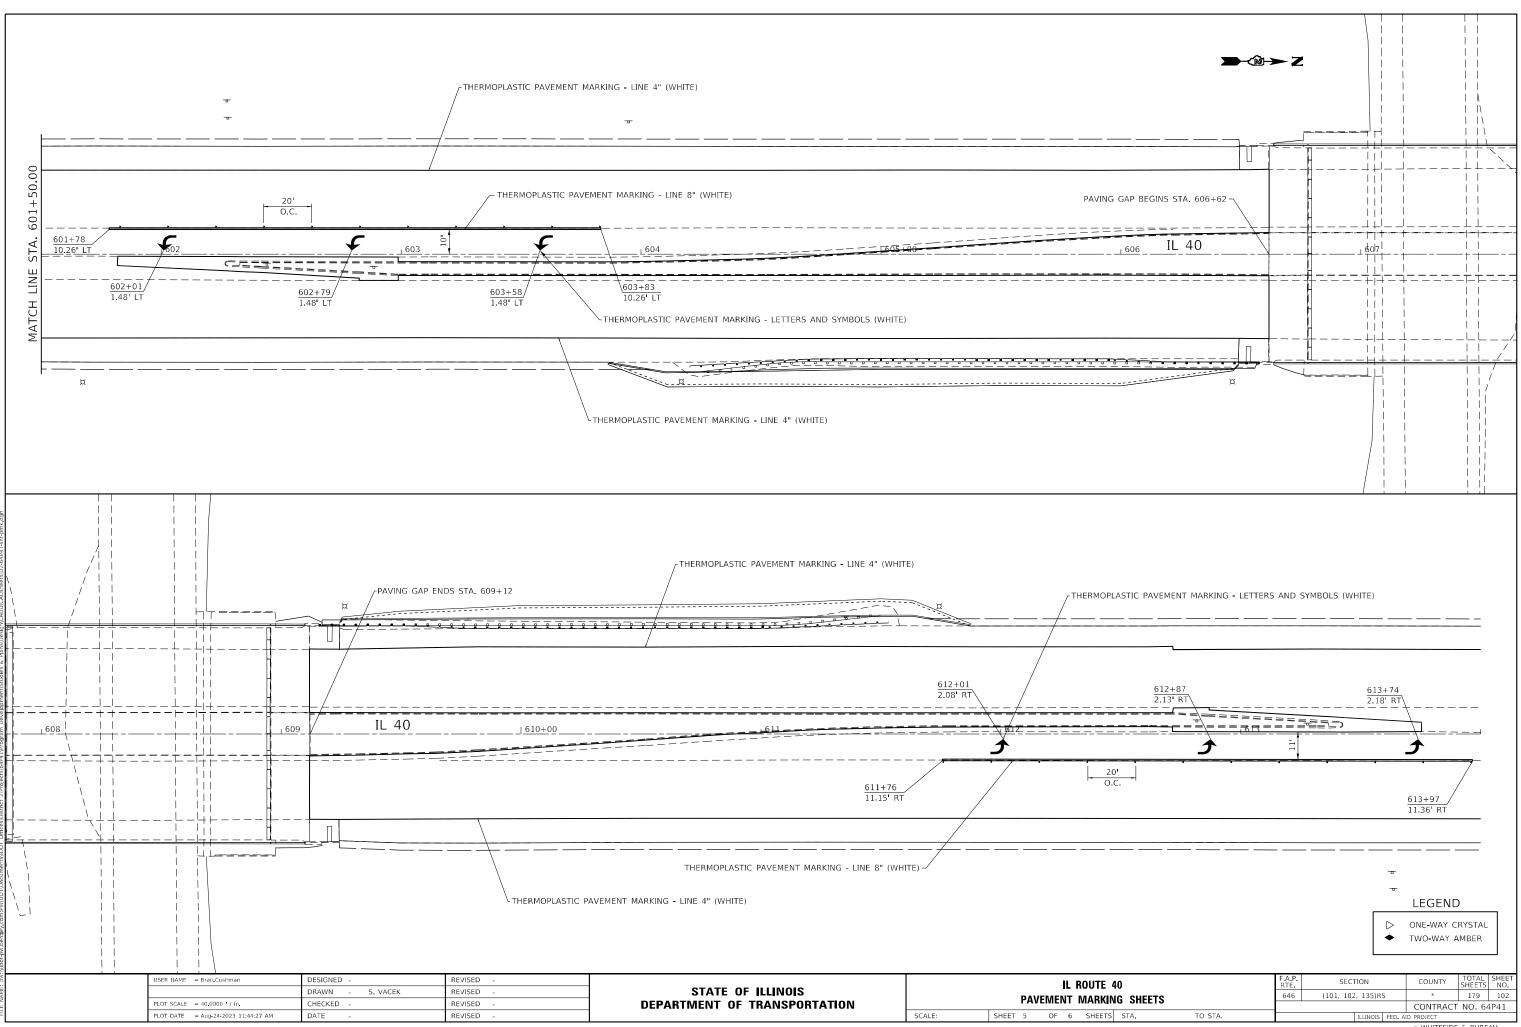

WHITESIDE & BUREAU

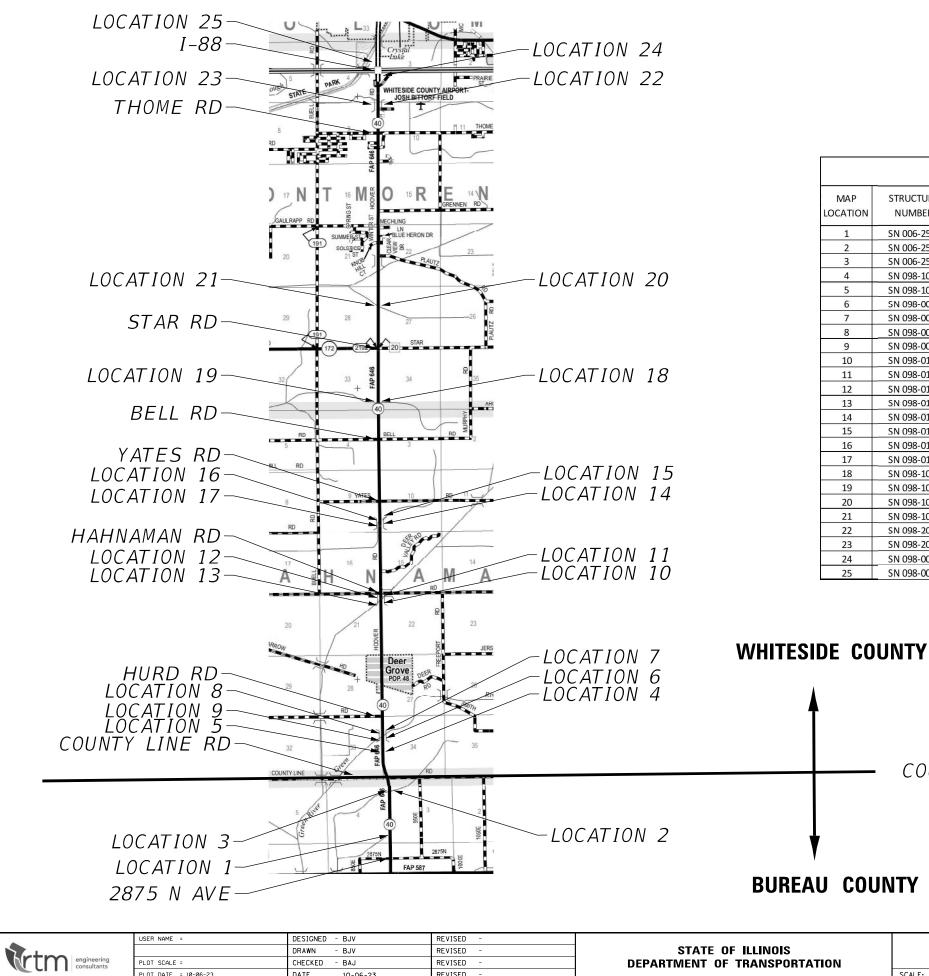

			EXISTIN
MAP LOCATION	STRUCTURE NUMBER	BEGIN STATION	END STATI
1	SN 006-2519	1232+00	1235+00
2	SN 006-2518	1272+00	1273+75
3	SN 006-2518	1271+70	1273+60
4	SN 098-1052	20+55	22+35
5	SN 098-1052	20+55	22+85
6	SN 098-0018	33+80	35+85
7	SN 098-0018	37+75	40+05
8	SN 098-0018	37+50	40+25
9	SN 098-0018	33+80	35+55
10	SN 098-0109	149+80	151+35
11	SN 098-0109	154+00	155+95
12	SN 098-0109	153+75	156+30
13	SN 098-0109	150+15	152+05
14	SN 098-0104	218+85	220+90
15	SN 098-0104	221+40	222+95
16	SN 098-0104	221+20	223+25
17	SN 098-0104	219+40	220+70
18	SN 098-1005	321+10	323+65
19	SN 098-1005	321+60	323+40
20	SN 098-1010	401+85	405+60
21	SN 098-1010	402+80	406+40
22	SN 098-2018	578+50	582+95
23	SN 098-2018	580+10	583+25
24	SN 098-0086	604+20	606+60
25	SN 098-0086	609+15	611+55

COUNTY LINE

SCALE:

ORIGINAL SURVEY SURVEY PLOTTED NOTE BOOK TEMPLATE AREAS NO.

PLOT DATE = 10-06-23

DATE

10-06-23

REVISED


FINAL SURVEY SURVEY NOTE BOOK REAS AREAS AREAS AREAS AREAS AREAS AREAS

BUREAU/WHITESID GUARDRAIL KE SHEET NO.



NG STRUCTURES ION SIZE NOTES TYPE CULVERT 3.5' W X 5' T 12' W x 8' T CULVERT CULVERT 12' W x 8' T CULVERT 6'W x 3' T CULVERT 6'W x 3' T BRIDGE NO IMPROVEMENTS BRIDGE NO IMPROVEMENTS NO IMPROVEMENTS BRIDGE BRIDGE NO IMPROVEMENTS BRIDGE NO IMPROVEMENTS BRIDGE BRIDGE BRIDGE BRIDGE BRIDGE BRIDGE BRIDGE CULVERT 8'W x 7'H 8'W x 7'H CULVERT 8' W x 6' H CULVERT 8' W x 6' H CULVERT 10' W x 6' H CULVERT CULVERT 10' W x 6' H BRIDGE BRIDGE

DE COUNTY		SECTION	COUNTY	TOTAL SHEETS	SHEET NO.
εγ ΜΑΡ	646	(101, 102, 135) RS	WHITESIDE	179	103
			CONTRAC	T NO. 6	54P41
STA TO STA		ILLINOIS			

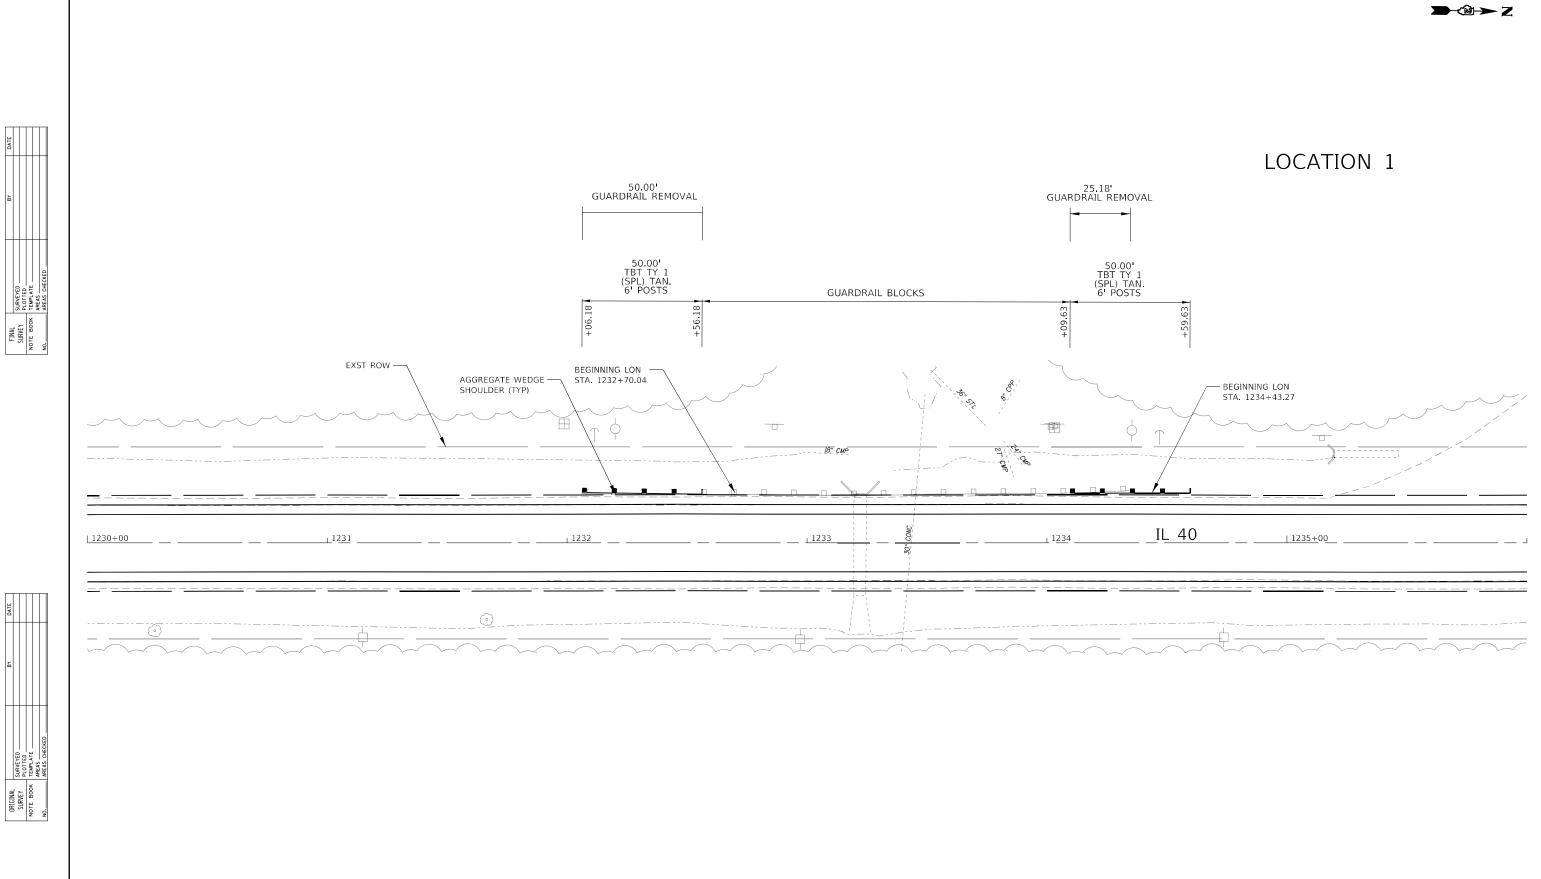


DATE

DATE

	USER NAME =	DESIGNED - BJV	REVISED -			IL 40 GUARI	DRAII	F.A. SECTION	COUNTY TOTAL SHEET
		DRAWN - BJV	REVISED -	STATE OF ILLINOIS		GUARDRAIL PLAT		646 (101, 102, 135)	RS WHITESIDE 179 104
consultants	PLOT SCALE = 1'=20'	CHECKED - BAJ	REVISED -	DEPARTMENT OF TRANSPORTATION	SCALE. 11 - 201				CONTRACT NO. 64P41
	PLOT DATE = 10-06-23	DATE - 10-06-23	REVISED -		SCALE: 1" = 20'	SHEET NO.	STA TO STA	ILLINO	s



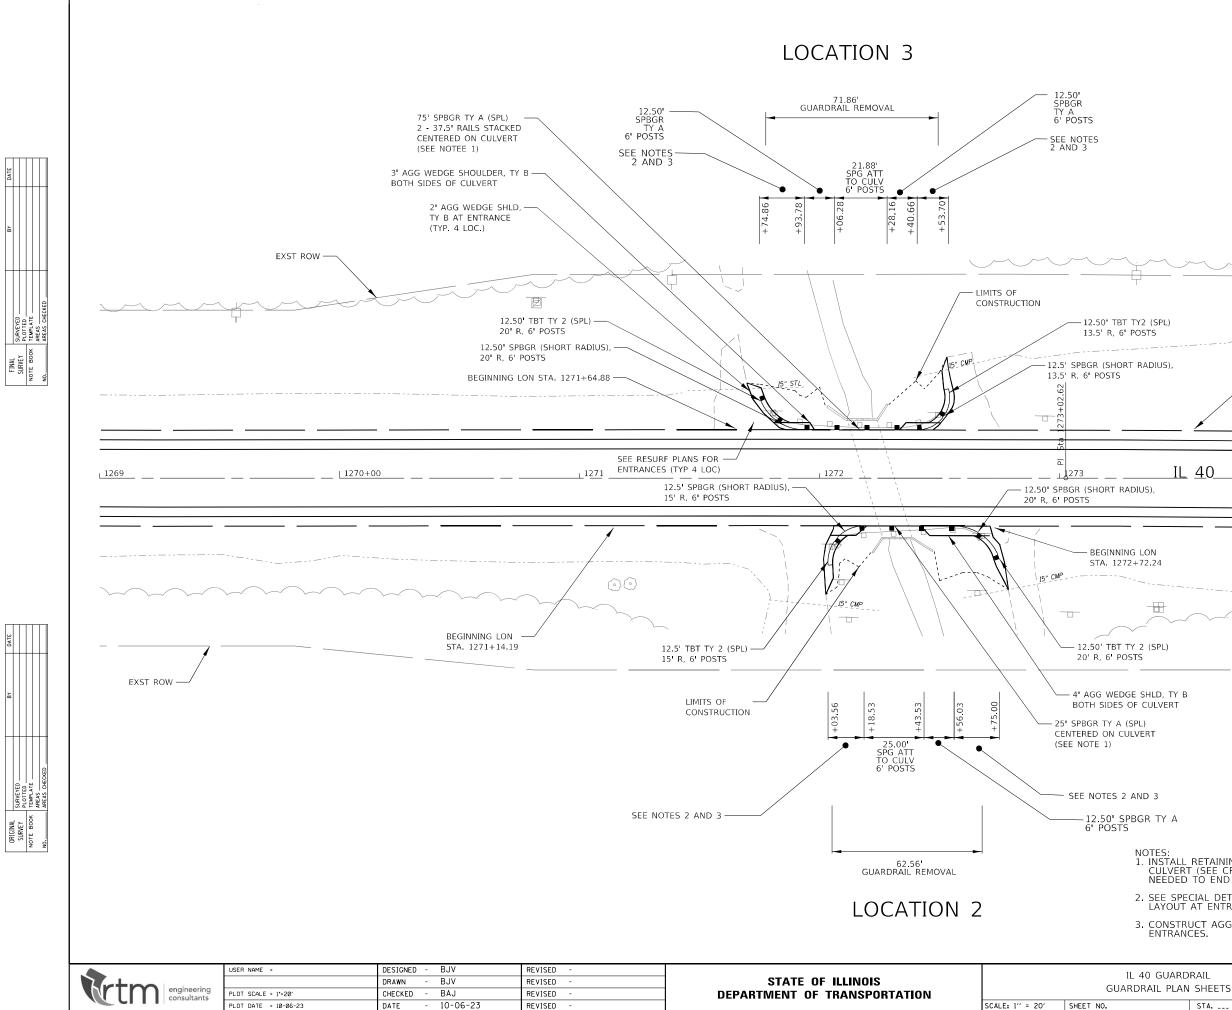

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DETAINING DAIL TO DELVENT	EDOS				
RETAINING RAIL TO PREVENT T (SEE CROSS SECTIONS AND I TO END SPANS AT POSTS.	DETAI	LS). OVERLAP SPLICES	AS0		
ECIAL DETAILS FOR TERMINAL A AT ENTRANCES, USE 6' POSTS					
UCT AGGREGATE WEDGE SHOU ICES.	JLDER	AT RADIUS GUARDR	AIL ALONG		
DRAIL	F.A. RTE.	SECTION	COUNTY	TOTAL SHEETS	SHEET NO.
N SHEETS	646	(101, 102, 135) RS	WHITESIDE CONTRAC	179	105

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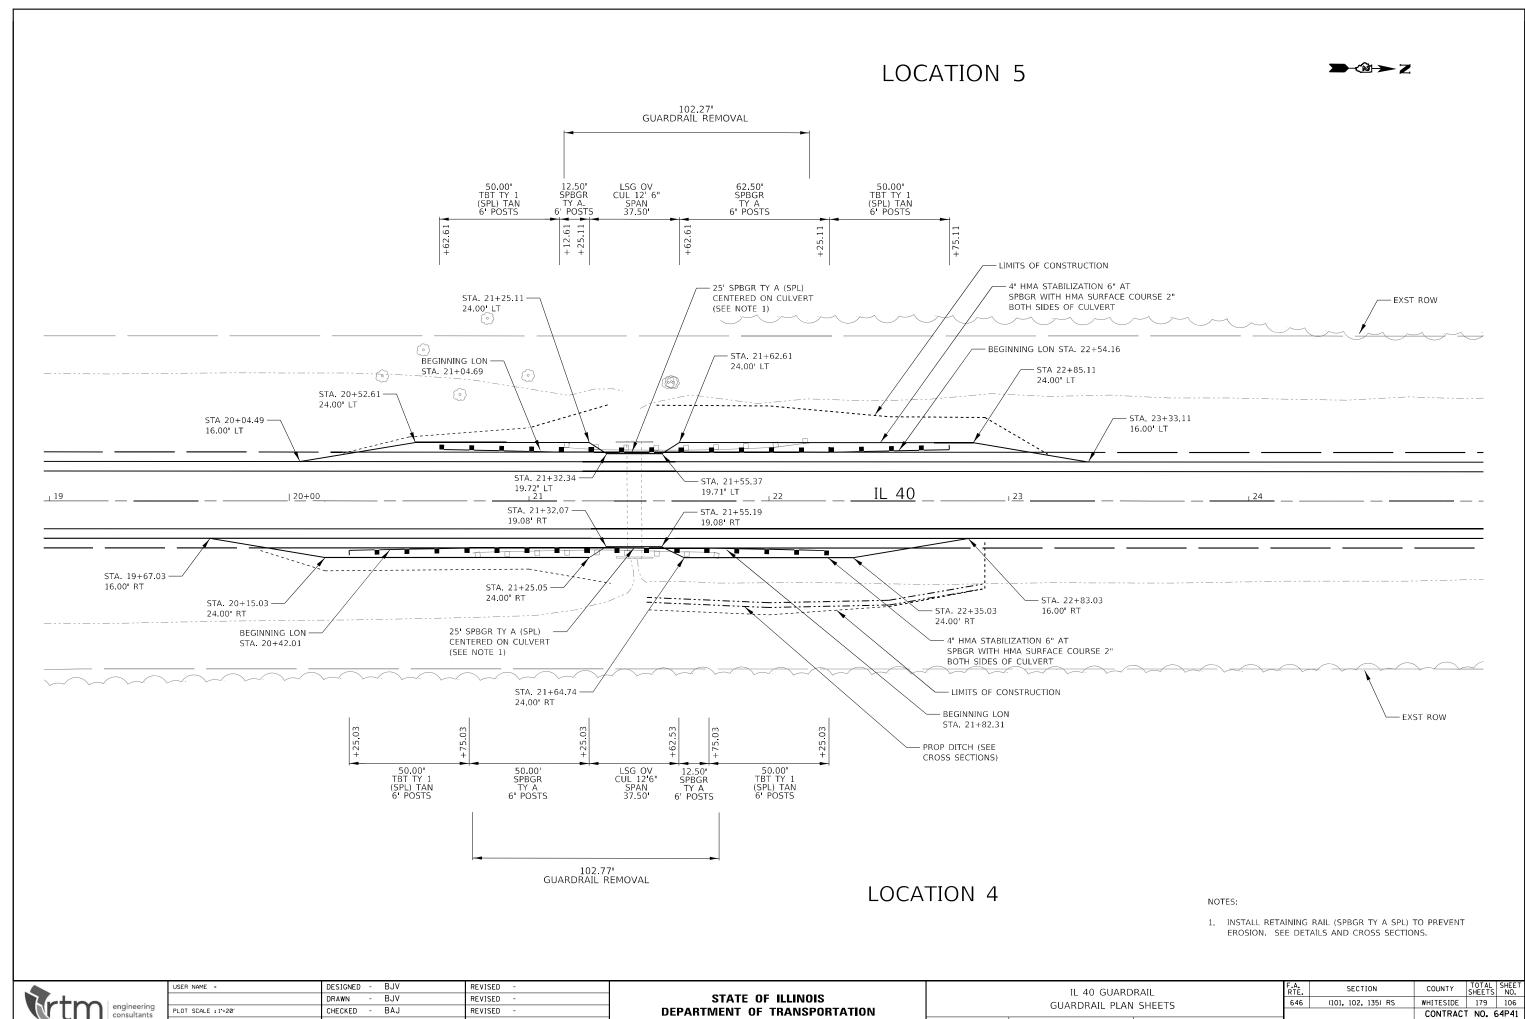
STA. ___ TO STA.



SCALE: 1" = 20' SHEET NO.

STA. ___ TO STA.

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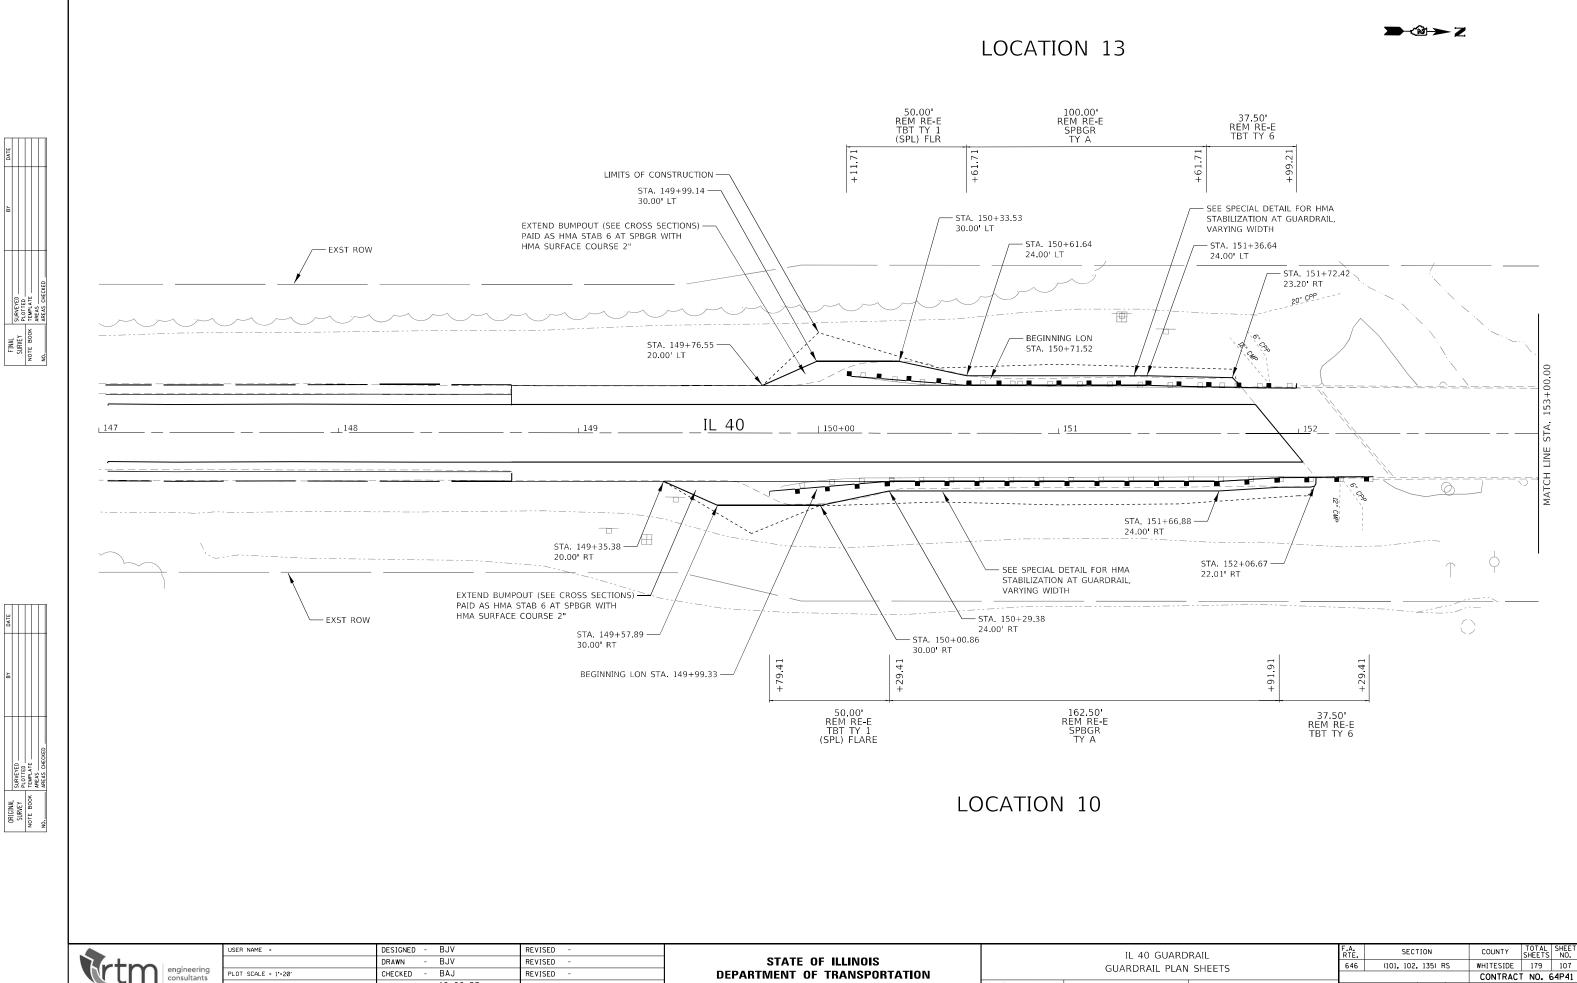
PLOT DATE = 10-06-23

DATE

10-06-23

REVISED


FINAL SURVEY SURVEY NOTE BOOK REAS NO. AREAS AREAS AREAS AREAS AREAS



	engineering consultants	USER NAME =	DESIGNED - BJV	REVISED -				
			DRAWN - BJV	REVISED -	STATE OF ILLINOIS	GUARDRAIL PLA		
		PLOT SCALE = 1'=20'	CHECKED - BAJ	REVISED -	DEPARTMENT OF TRANSPORTATION			
		PLOT DATE = 10-06-23	DATE - 10-06-23	REVISED -		SCALE: 1" = 20'	SHEET NO.	

ORIGINAL SURVEY BLOTEE NOTE BOOK REAS NO. AREAS CHEC

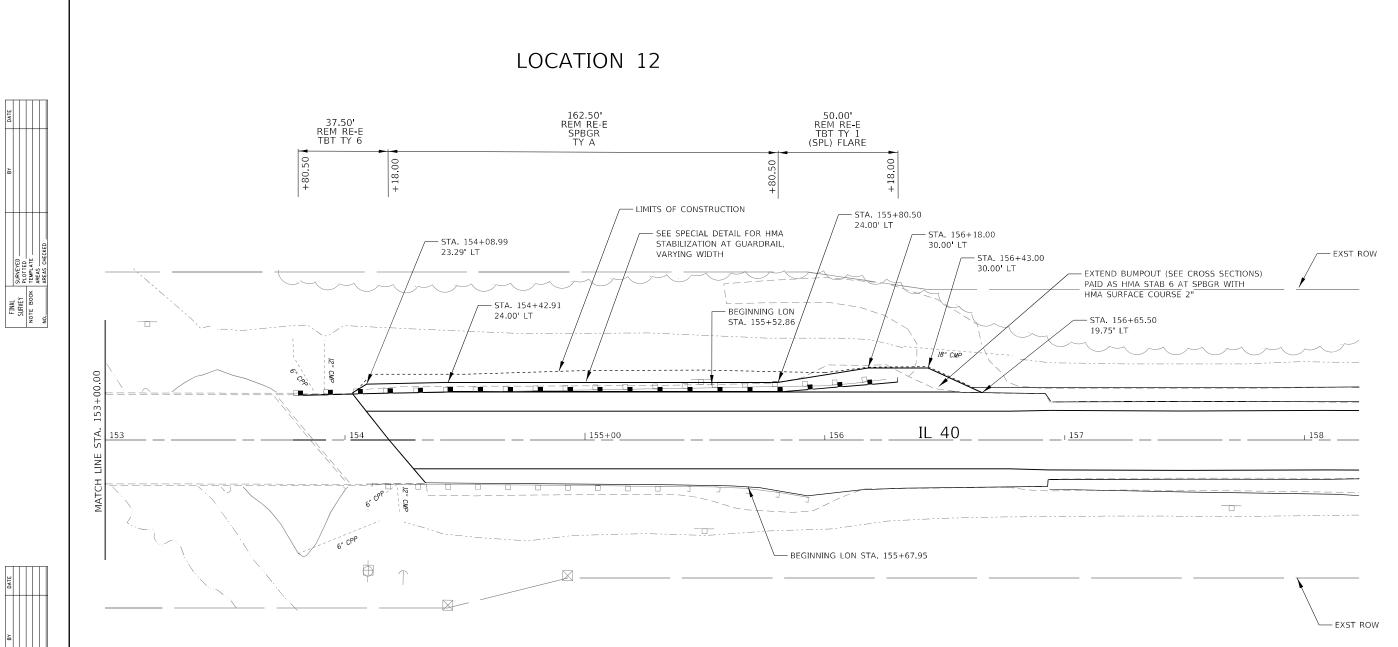STA. ___ TO STA. . ILLINOIS



LOCATION 11 (NO GUARDRAIL IMPROVEMENTS)

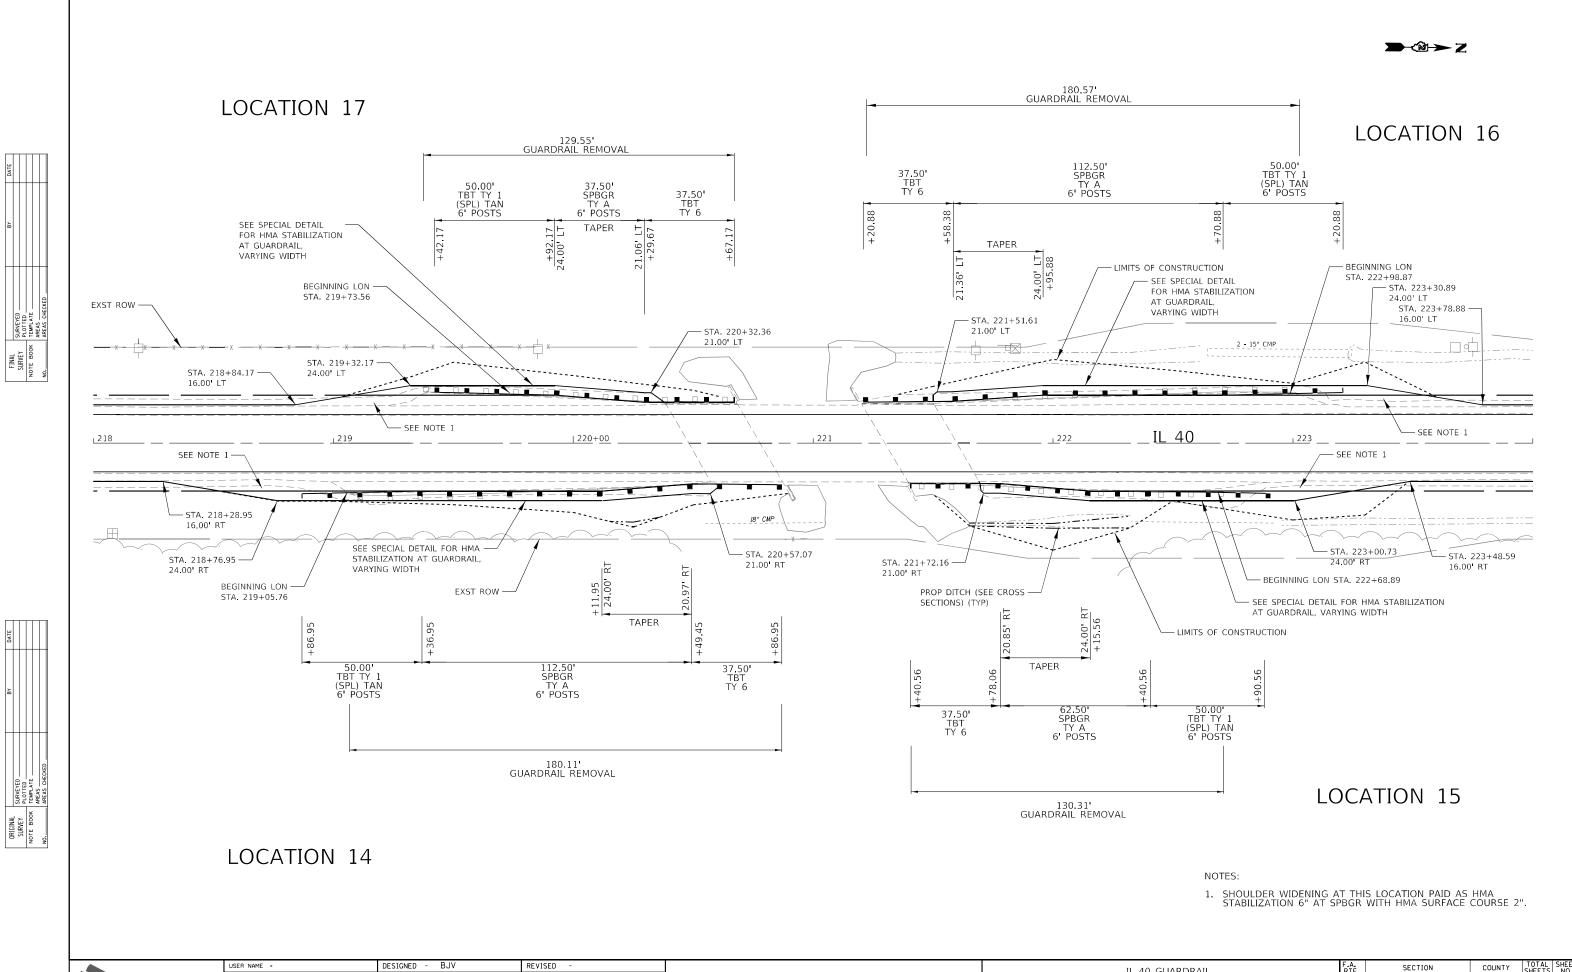
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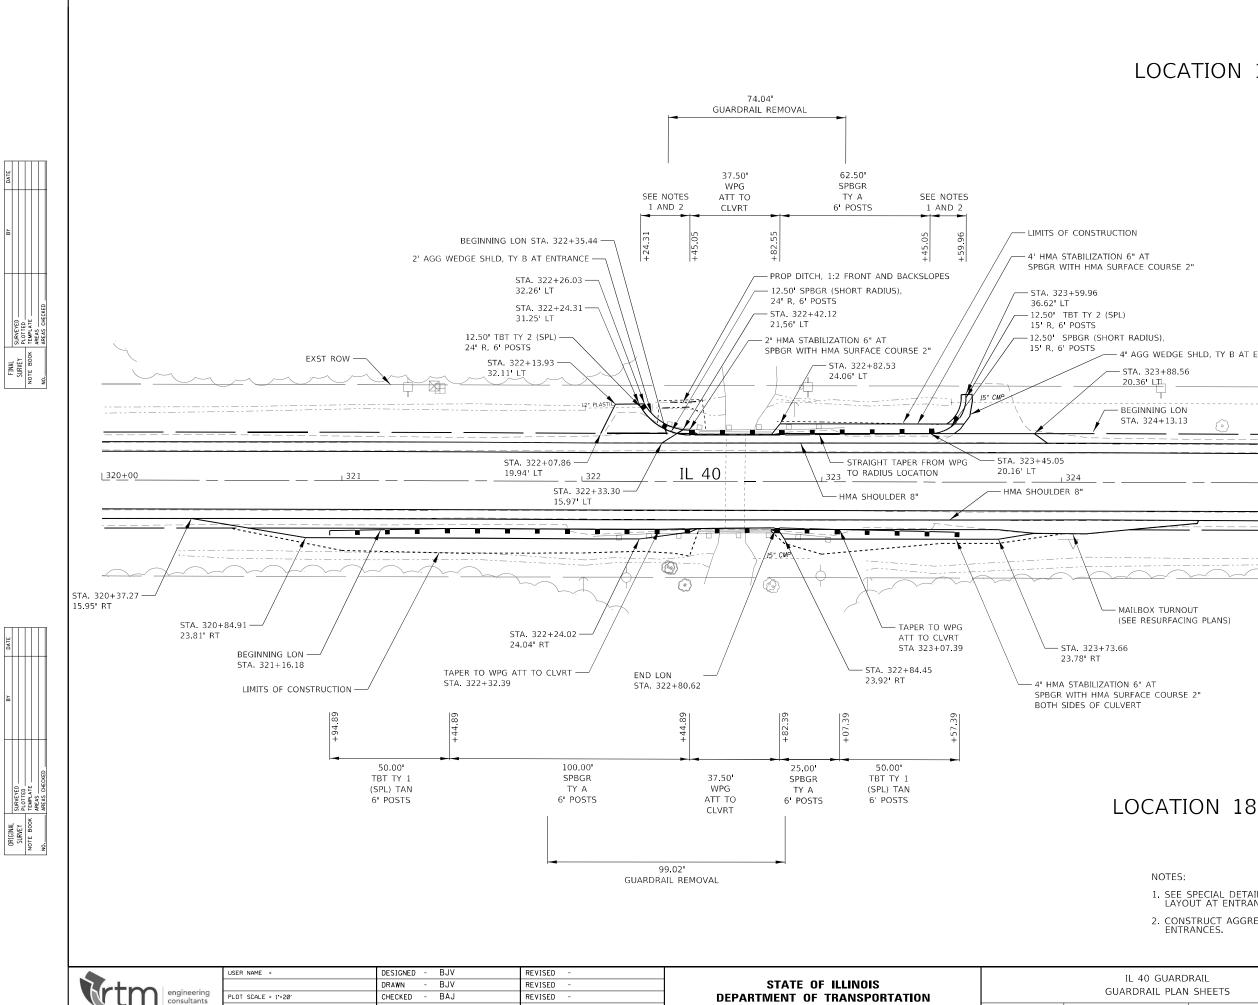
	USER NAME =	DESIGNED - BJV	REVISED -	STATE OF ILLINOIS DEPARTMENT OF TRANSPORTATION	IL 40 GUARDRAIL GUARDRAIL PLAN SHEETS		F.A.	SECTION	COUNTY TOTAL SHEET
		DRAWN - BJV	REVISED -				646	(101, 102, 135) RS	WHITESIDE 179 108
engineering consultants	PLOT SCALE = 1'=20'	CHECKED - BAJ	REVISED -						CONTRACT NO. 64P41
CITI	PLOT DATE = 10-06-23	DATE - 10-06-23	REVISED -		SCALE: 1" = 20' SHEET NO.	STA TO STA		ILLINOIS	1

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engineering	USER NAME = PLOT SCALE = 1*=20'	DESIGNED - BJV DRAWN - BJV CHECKED - BAJ	REVISED - REVISED - REVISED -	STATE OF ILLINOIS DEPARTMENT OF TRANSPORTATION		IL 40 GUAR GUARDRAIL PLA	DRA N Sł
Consultants	PLOT DATE = 10-06-23	DATE - 10-06-23	REVISED -	DEFAILINENT OF THANSFORTATION	SCALE: 1" = 20'	SHEET NO.	S

DRAIL F.A. SECTION COUNTY TOTAL SHEET NO. 646 (101, 102, 135) RS WHITESIDE 179 109 CONTRACT NO. 64P41 STA. ... TO STA. ...



PLOT DATE = 10-06-23

DATE

10-06-23

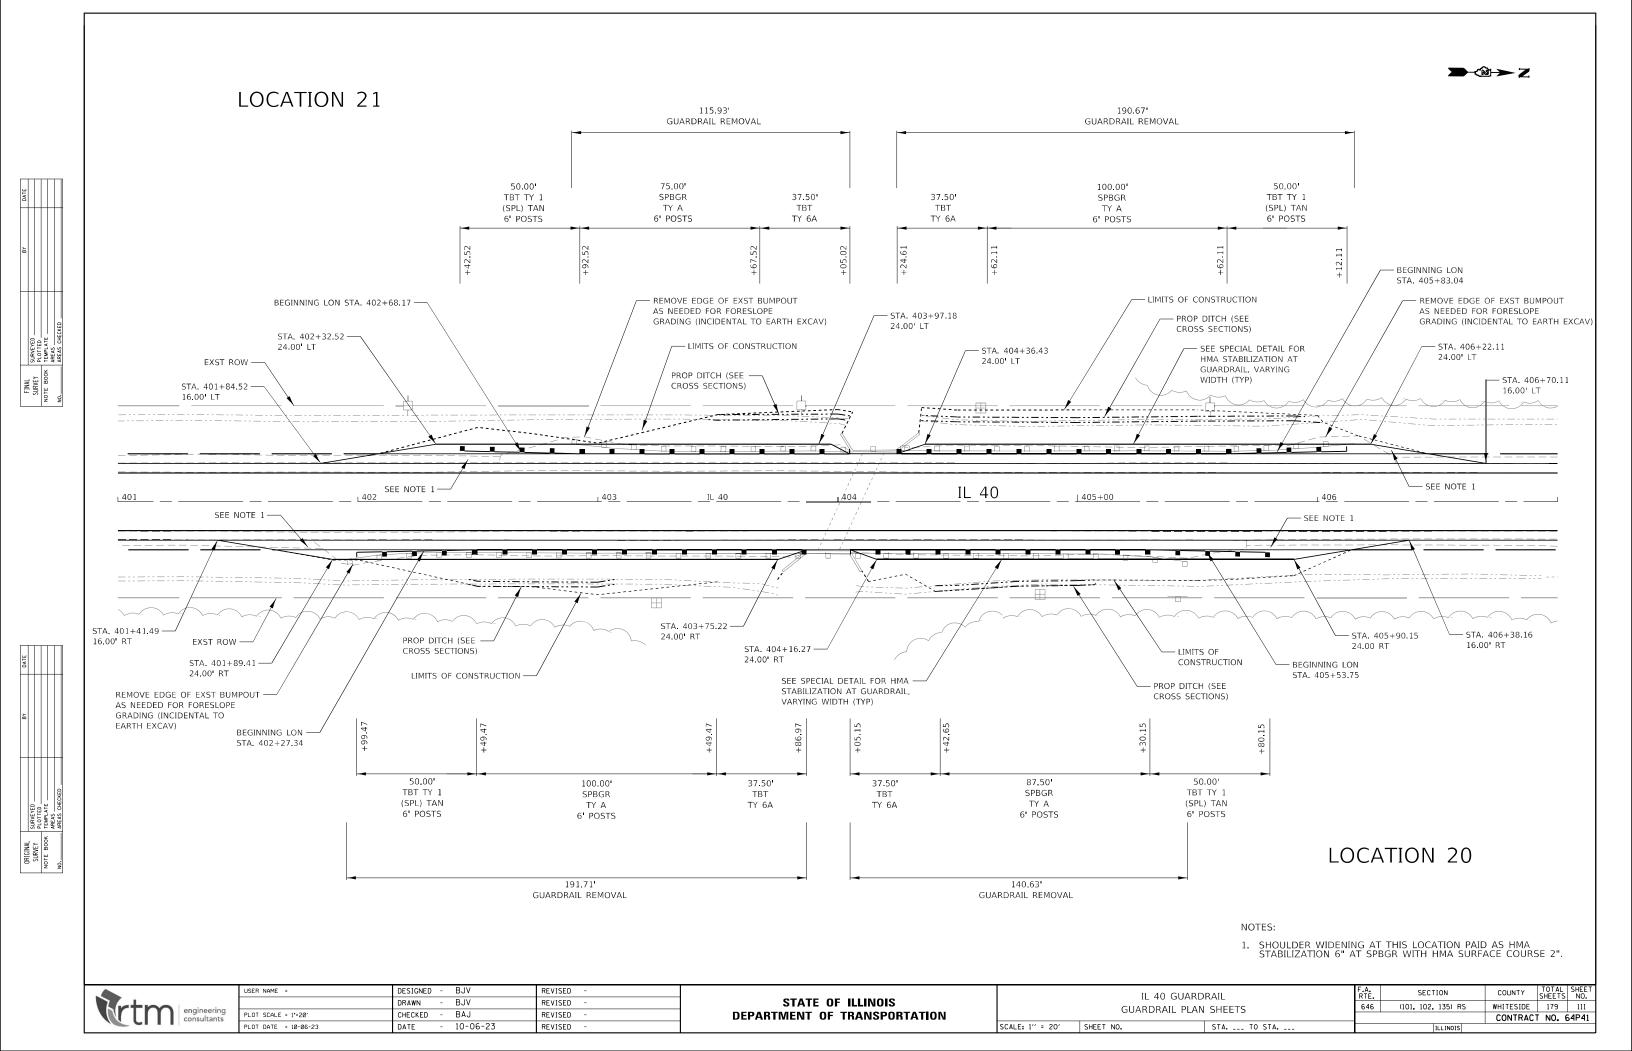
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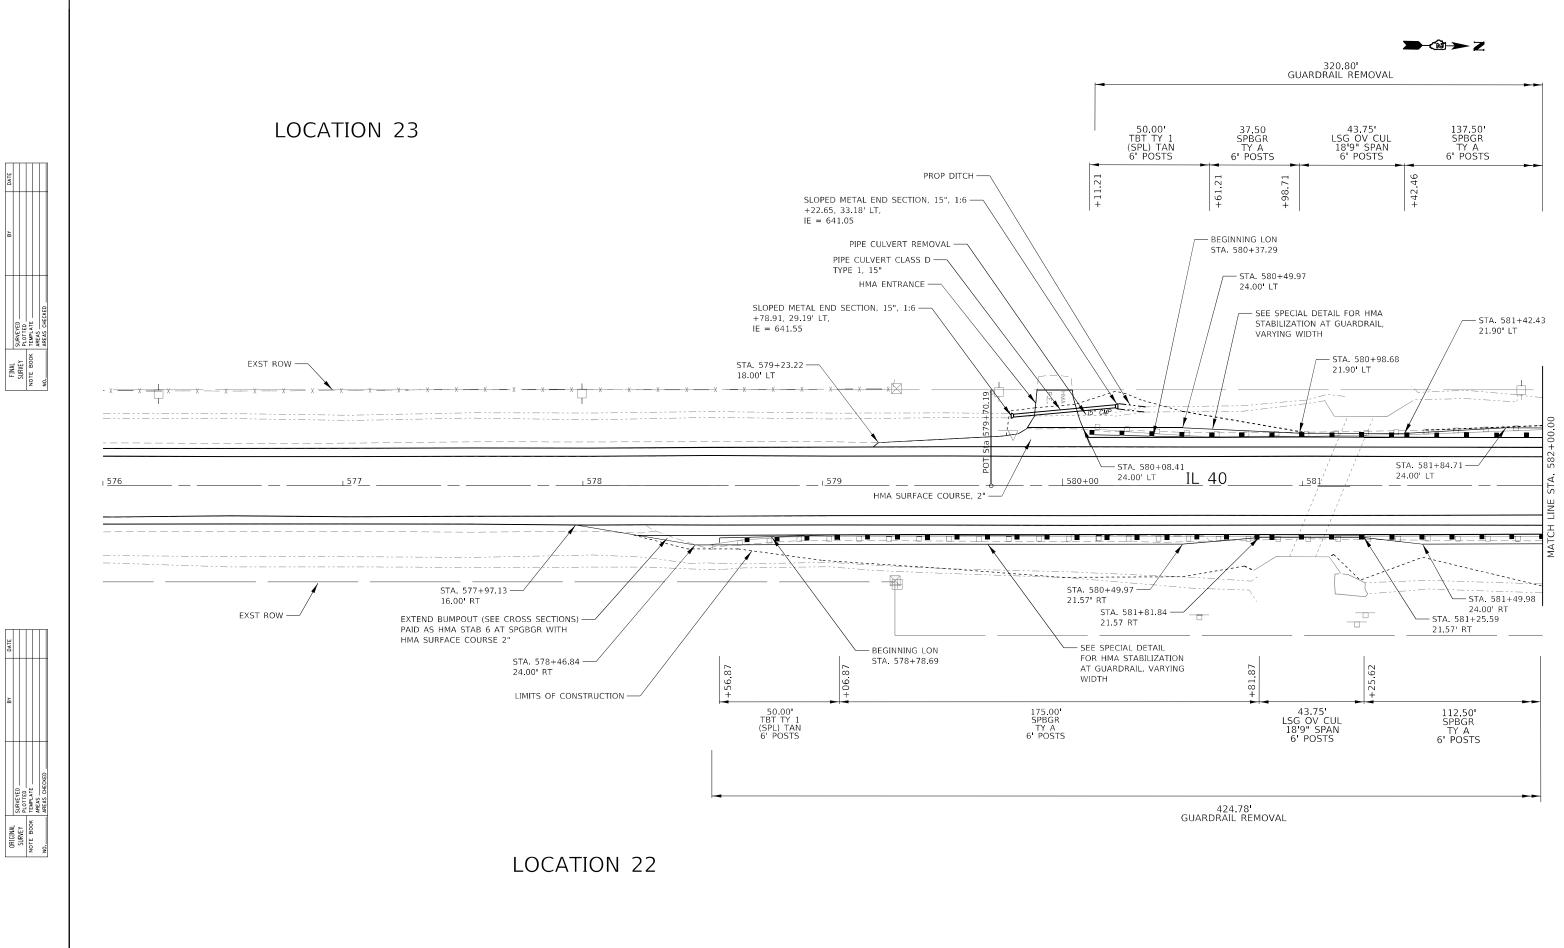
SCALE: 1" = 20' SHEET NO.

STA. ___ TO STA.

D - ŵ -> Z LOCATION 19 4' AGG WEDGE SHLD, TY B AT ENTRANCE | 325+00 - EXST ROW SEE SPECIAL DETAILS FOR TERMINAL AND SHORT RADIUS GUARDRAIL LAYOUT AT ENTRANCES. USE 6' POSTS. 2. CONSTRUCT AGGREGATE WEDGE SHOULDER AT RADIUS GUARDRAIL ALONG ENTRANCES. COUNTY TOTAL SHEET SHEETS NO. WHITESIDE 179 110 SECTION F.A. RTE. 646 (101, 102, 135) RS CONTRACT NO. 64P41


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	USER NAME =	DESIGNED -	BJV	REVISED -			IL 40 GUARE	BAIL	F.A.	SECTION	COUNTY	TOTAL SHEET
		DRAWN -	BJV	REVISED -	STATE OF ILLINOIS				646	(101, 102, 135) RS	WHITESIDE	179 112
engineering	PLOT SCALE = 1'=20'	CHECKED -	BAJ	REVISED -	DEPARTMENT OF TRANSPORTATION		GUARDRAIL PLAN	0.0		CONTRAC	T NO. 64P41	
CITI	PLOT DATE = 10-06-23	DATE -	10-06-23	REVISED -		SCALE: 1" = 20'	SHEET NO.		ILLINOIS			

ORIGINAL SURVEY NOTE BOOK REAL AREAS NO. AREAS CHECI




LOCATION 23

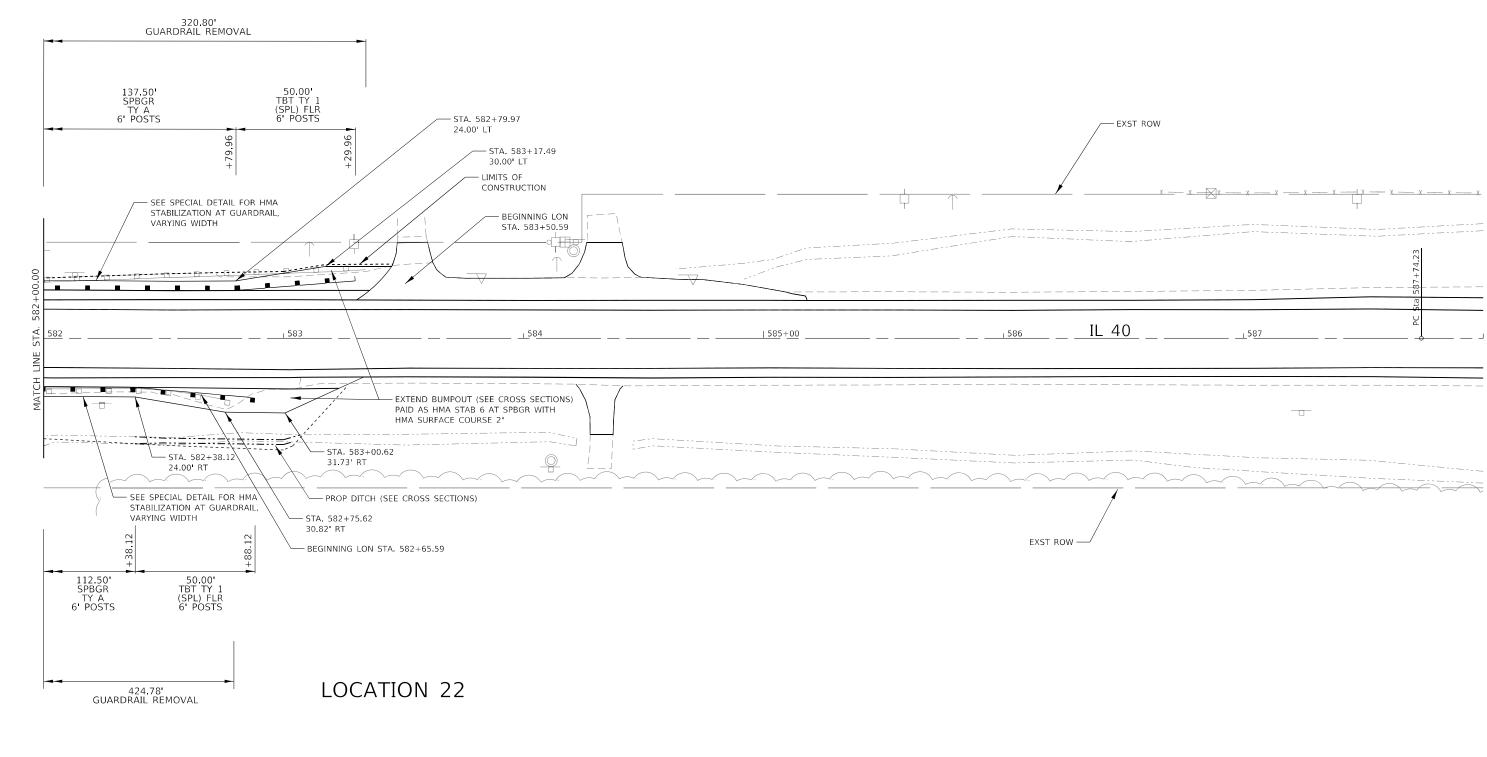FINAL SURVEY SURVEY NOTE BOOK TEMPLATE NO._____AREAS AREAS AREAS AREAS AREAS AREAS


ORIGINAL SURVEY NOTE BOOK REAS AREAS OR. AREAS CHECKED

	USER NAME =	DESIGNED -	BJV	REVISED -			Ц	40 GUARDRAIL	F.A.	SECTION	COUNTY TOTAL SHEET
Viction 1		DRAWN -	BJV	REVISED -	STATE OF ILLINOIS				646	(101, 102, 135) RS	WHITESIDE 179 113
engineering consultants	PLOT SCALE = 1"=20'	CHECKED -	BAJ	REVISED -	DEPARTMENT OF TRANSPORTATION	GUARDRAIL PLAN SHEETS					CONTRACT NO. 64P41
	PLOT DATE = 10-06-23	DATE -	10-06-23	REVISED -		SCALE: 1" = 20'	SHEET NO.	STA TO STA		ILL INOIS	1 1 1 1 1 1 1 1 1 1 1 1 1 1 1 1 1 1 1 1

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Ret engineering	USER NAME = PLOT SCALE = 1*=20'	DESIGNED - BJV DRAWN - BJV CHECKED - BAJ	REVISED - REVISED - REVISED -	STATE OF ILLINOIS DEPARTMENT OF TRANSPORTATION				
CITI consultants	PLOT DATE = 10-06-23	DATE - 10-06-23	REVISED -		SCALE: 1" = 20'	SHEET NO.	Τ	

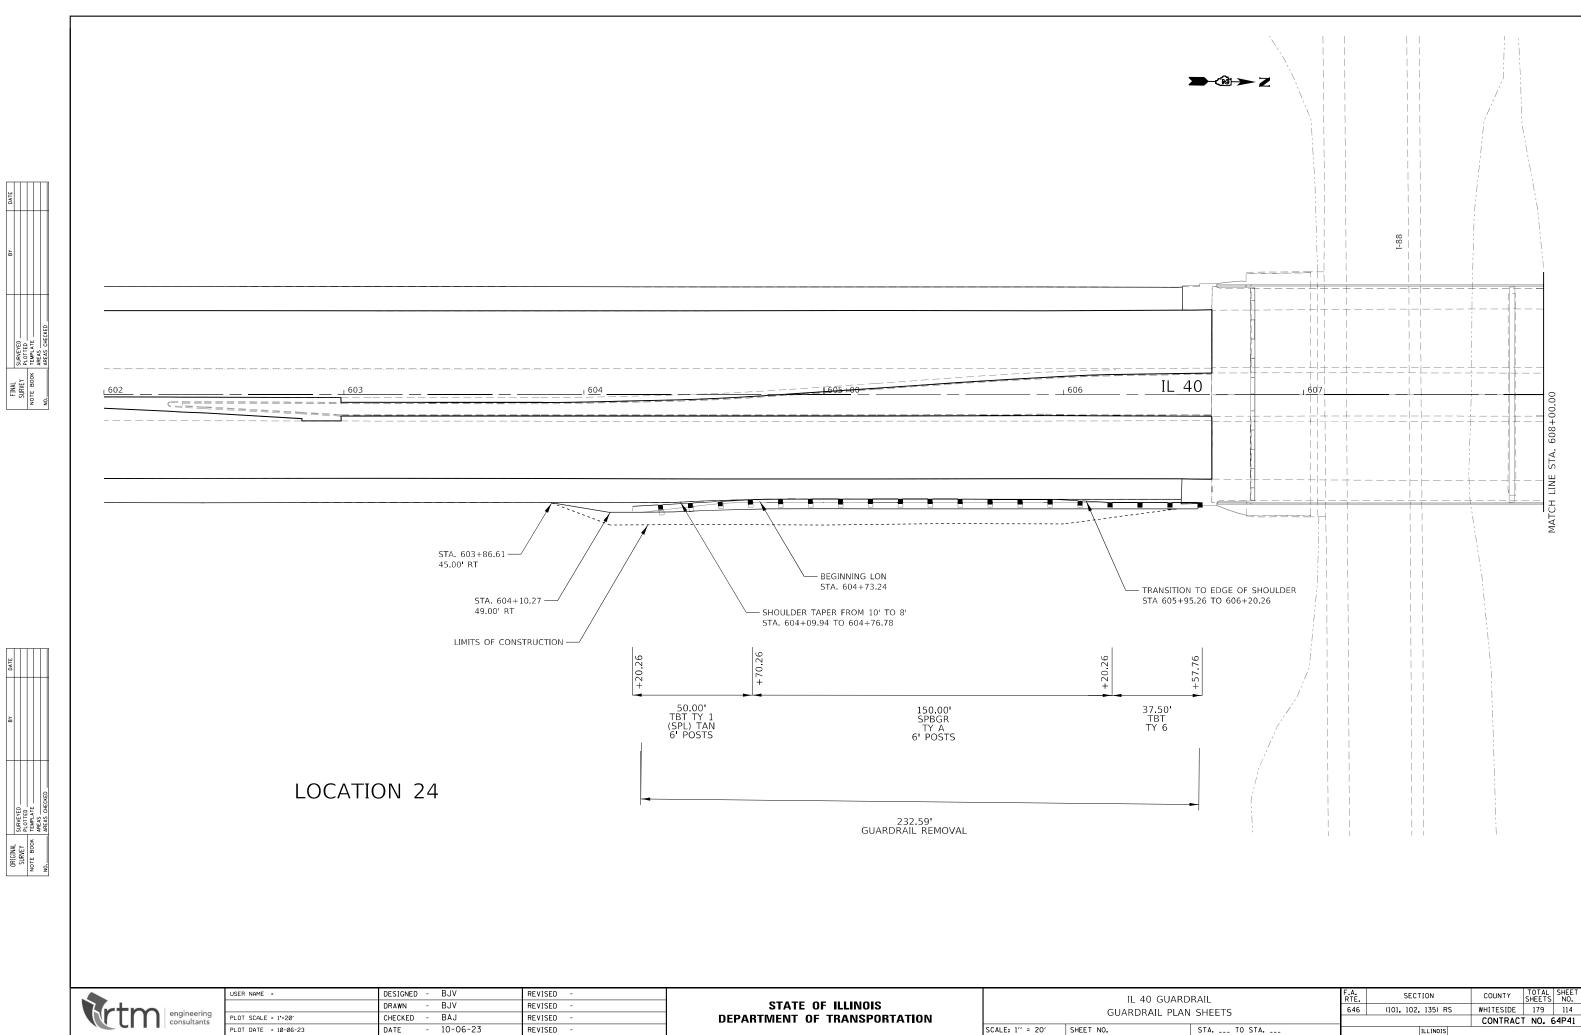


SCALE: 1" = 20' SHEET NO.
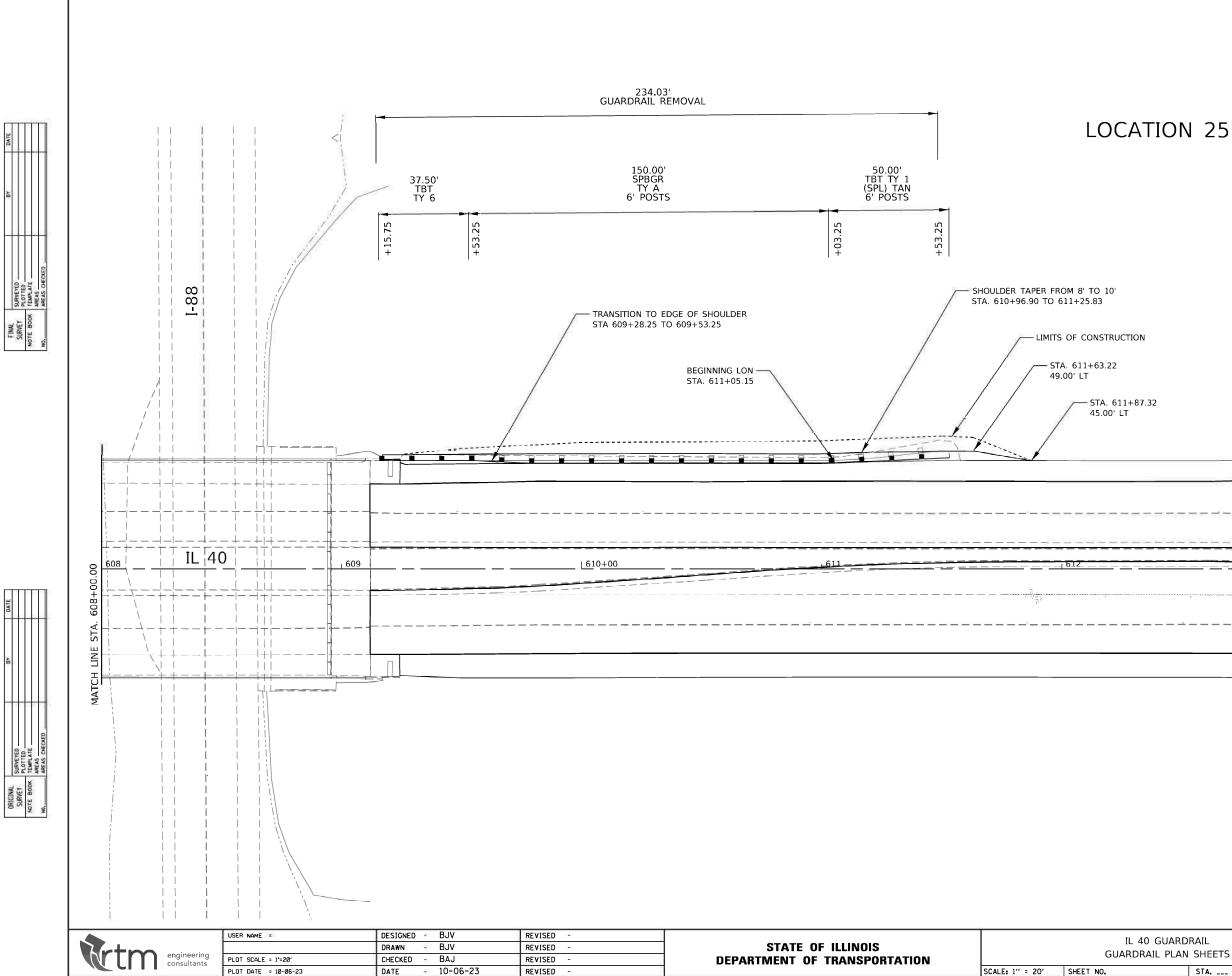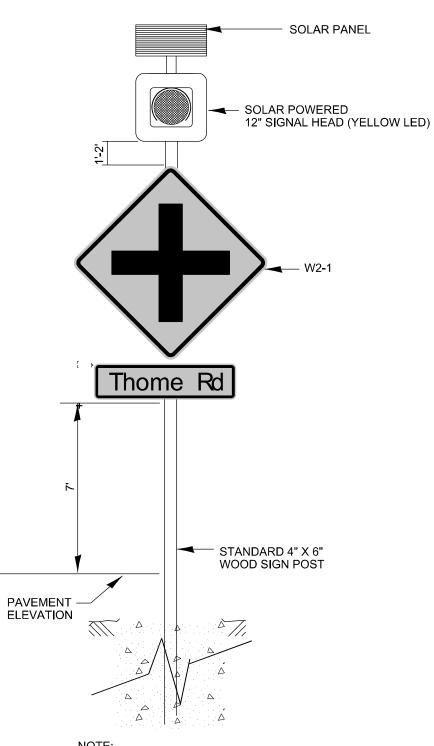
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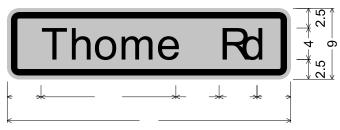
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	RAIL	F.A. RTE.	SECTION	COUNTY	TOTAL SHEETS	SHEET NO.
	SHEETS	646	(101, 102, 135) RS	WHITESIDE CONTRACT	179	115
	STA TO STA		ILLINOIS	SUMMAG		

SOLAR POWER FLASHER DETAIL





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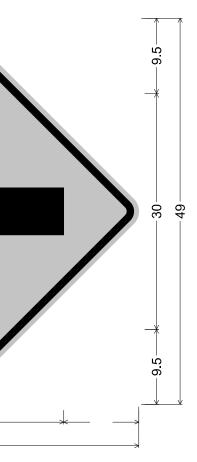


Т	h	0	m	е	R	d

NOTE: THE CONTRACTOR SHALL SUPPLY ALL NECESSARY HARDWARE TO MOUNT THE SIGNS TO THE POST. THIS MOUNTING HARDWARE SHALL BE SIMILAR TO THE SIGN FIX BRAND MATERIAL.

USER NAME = Brad.Cushman	DESIGNED -	REVISED -			F						COUNTY	TOTAL SHEET SHEETS NO.
	DRAWN -	REVISED -	STATE OF ILLINOIS	FLASHER DETAILS					646	(101, 102, 135)RS	WHITESIDE	179 116
PLOT SCALE = 40.000 / in	CHECKED -	REVISED -	DEPARTMENT OF TRANSPORTATION							, . , . , . , .	CONTRAC	T NO. 64P41
PLOT DATE = Aug-24-2023 01:04:09 PM	DATE -	REVISED -		SCALE:	SHEET	OF	SHEETS STA.	TO STA.		ILLINOIS FED. A	AID PROJECT	

ault pwr/Wdat-pw.beniley.com/PWIDDT.DocumentsIDDT. OfficesIDistrict. 2/ProjectsI64P41VProgram Development/Studies & PlansiDesign/CADDI/CADSheetsID2_64P41 flasher detail.



NOTES:

- EXISTING LIGHT POLE, 50' M.H. WITH 6' M.A. TO REMAIN ----NEW LUMINAIRE, LED, ROADWAY, OUTPUT DESIGNATION H TO BE INSTALLED EXISTING LUMINAIRE TO BE REMOVED
- EXISTING LIGHT POLE, 20' M.H. WITH 10' M.A. TO REMAIN ⊷ NEW LUMINAIRE, LED, ROADWAY, OUTPUT DESIGNATION G TO BE INSTALLED EXISTING LUMINAIRE TO BE REMOVED
- LIGHTING CONTROLLER, PEDESTAL MOUNTED, 480VOLT, 60AMP, SINGLE PHASE, 3-WIRE
- --ELECTRIC SERVICE INSTALLATION, 480VOLT, 60AMP
- UNDERGROUND CONDUIT, COILABLE NONMETALLIC CONDUIT, 2" DIA.
- UNIT DUCT, 600V, 2-1C NO.6, 1/C NO.8 GROUND, (XLP-TYPE USE), 1" DIA. POLYETHYLENE ___
- EXISTING LIGHTING CONTROLLER TO BE REMOVED \bowtie
- -----EXISTING ELECTRIC SERVICE TO BE REMOVED

LIGHTING SUMMARY OF QUANTITIES

PAY ITEM	DESCRIPTION	UNIT	QUAN [®]
80400100	ELECTRIC SERVICE INSTALLATION	EACH	1
81028750	UNDERGROUND CONDUIT, COILABLE NONMETALLIC CONDUIT, 2" DIA.	FOOT	160
81603040	UNIT DUCT, 600V, 2-1C NO.6, 1/C NO.8 GROUND, (XLP-TYPE USE), 1" DIA. POLYETHYLENE	FOOT	50.
82110007	LUMINAIRE, LED, ROADWAY, OUTPUT DESIGNATION G	EACH	3
82110008	LUMINAIRE, LED, ROADWAY, OUTPUT DESIGNATION H	EACH	12
82500340	LIGHTING CONTROLLER, PEDESTAL MOUNTED, 480VOLT, 60AMP	EACH	1
84500110	REMOVAL OF LIGHTING CONTROLLER	EACH	1
84500120	REMOVAL OF ELECTRIC SERVICE INSTALLATION	EACH	1
X1400267	REMOVAL OF LIGHTING LUMINAIRE, NO SALVAGE	EACH	15

HIGHWAY STANDARDS:

821101-02 LUMINAIRE WIRING IN POLE


825016-01 LIGHTING CONTROLLER, PEDESTAL MOUNTED, 480V

USER NAME = Brad.Cushman	DESIGNED -	REVISED -			F F							SECTION	COUNTY	TOTAL SHEET SHEETS NO.
	DRAWN -	REVISED -	STATE OF ILLINOIS	LIGHTING SUMMARY OF QUANTITIES						(101, 102, 135)RS	WHITESIDE	179 117		
PLOT SCALE = 100.0000 / in	CHECKED -	REVISED -	DEPARTMENT OF TRANSPORTATION									CONTRACT	T NO. 64P41	
PLOT DATE = Aug-24-2023 01:06:17 PM	DATE -	REVISED -		SCALE:	SHEET	OF	SHEETS	STA.	TO STA.			ILLINOIS FEI	AID PROJECT	

1 LIGHTING LEGEND & SUMMARY OF QUANTITIES

4 WIRING DIAGRAMS & LUMINAIRE PERFORMANCE TABLES

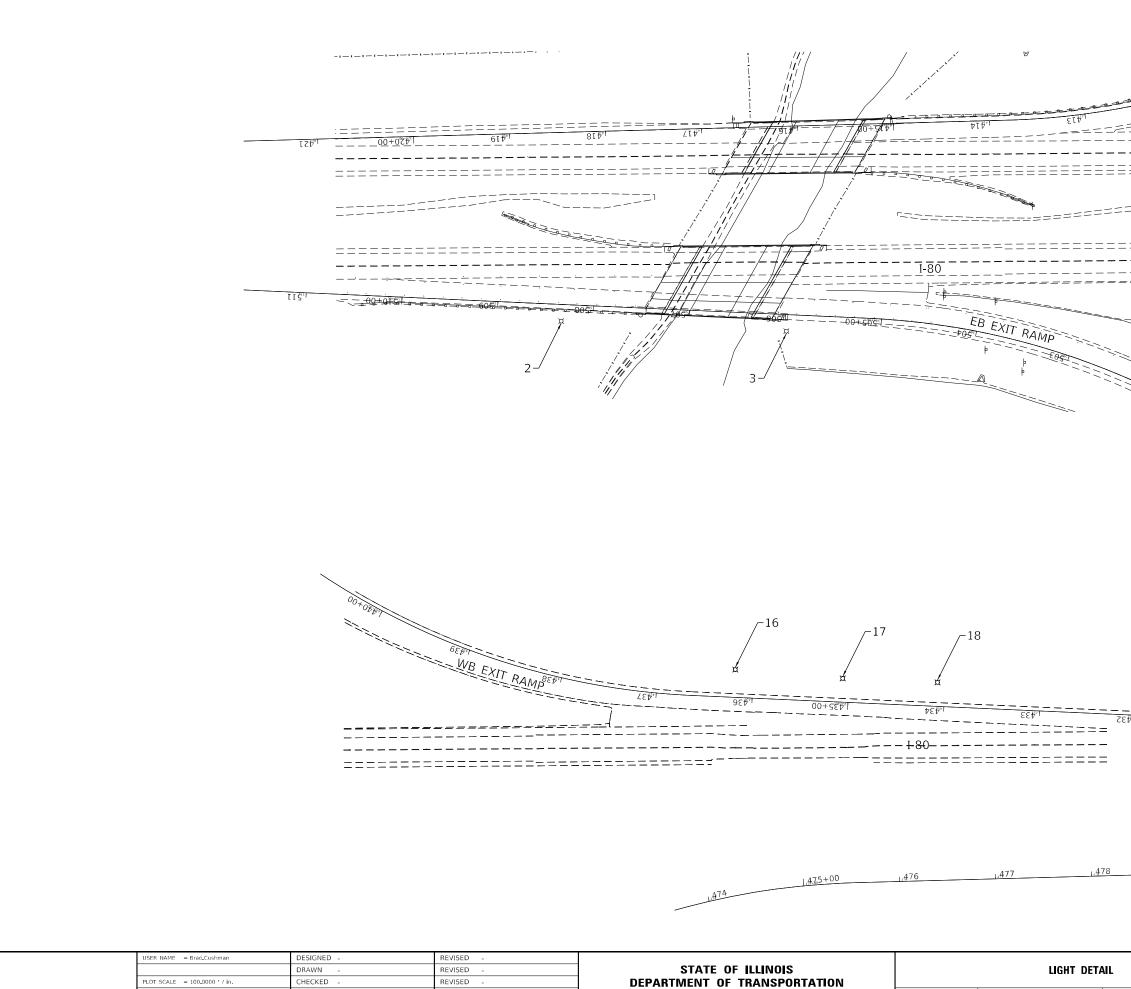- 2 TO 3 LIGHTING PLANS
- INDEX OF SHEETS



REVISED

PLOT DATE = Aug-24-2023 01:10:27 PM

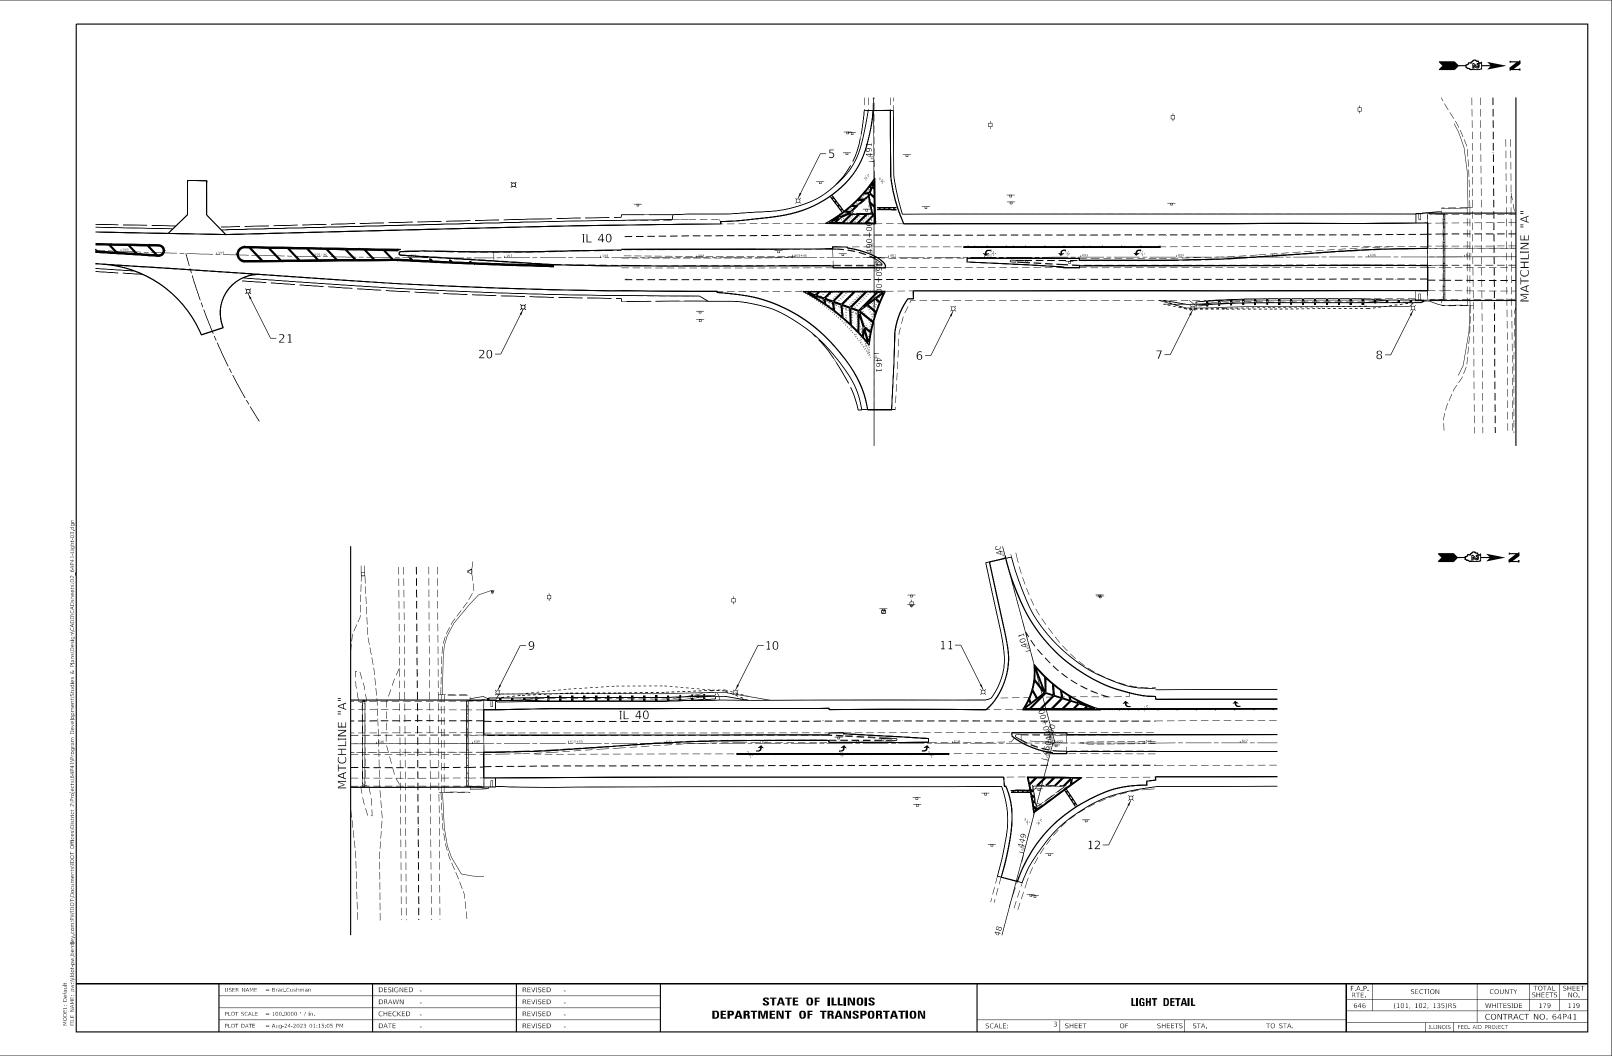
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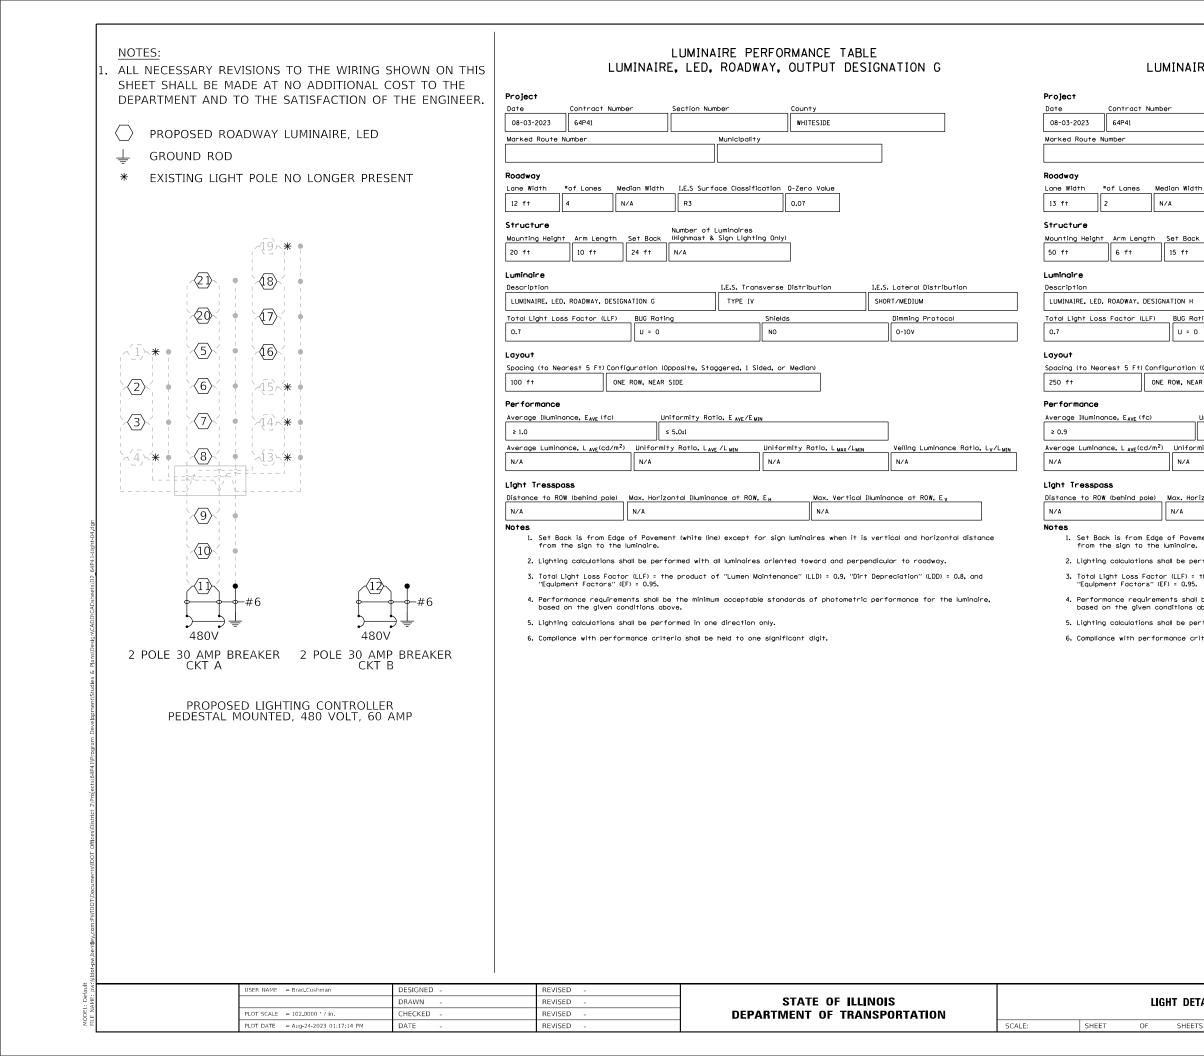
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	F.A.P. RTE	SECT	rion		COUNTY	TOTAL SHEETS	SHEET NO.
TAIL		(101, 102	, 135)R	5	WHITESIDE	179	118
					CONTRACT	NO. 64	4P41
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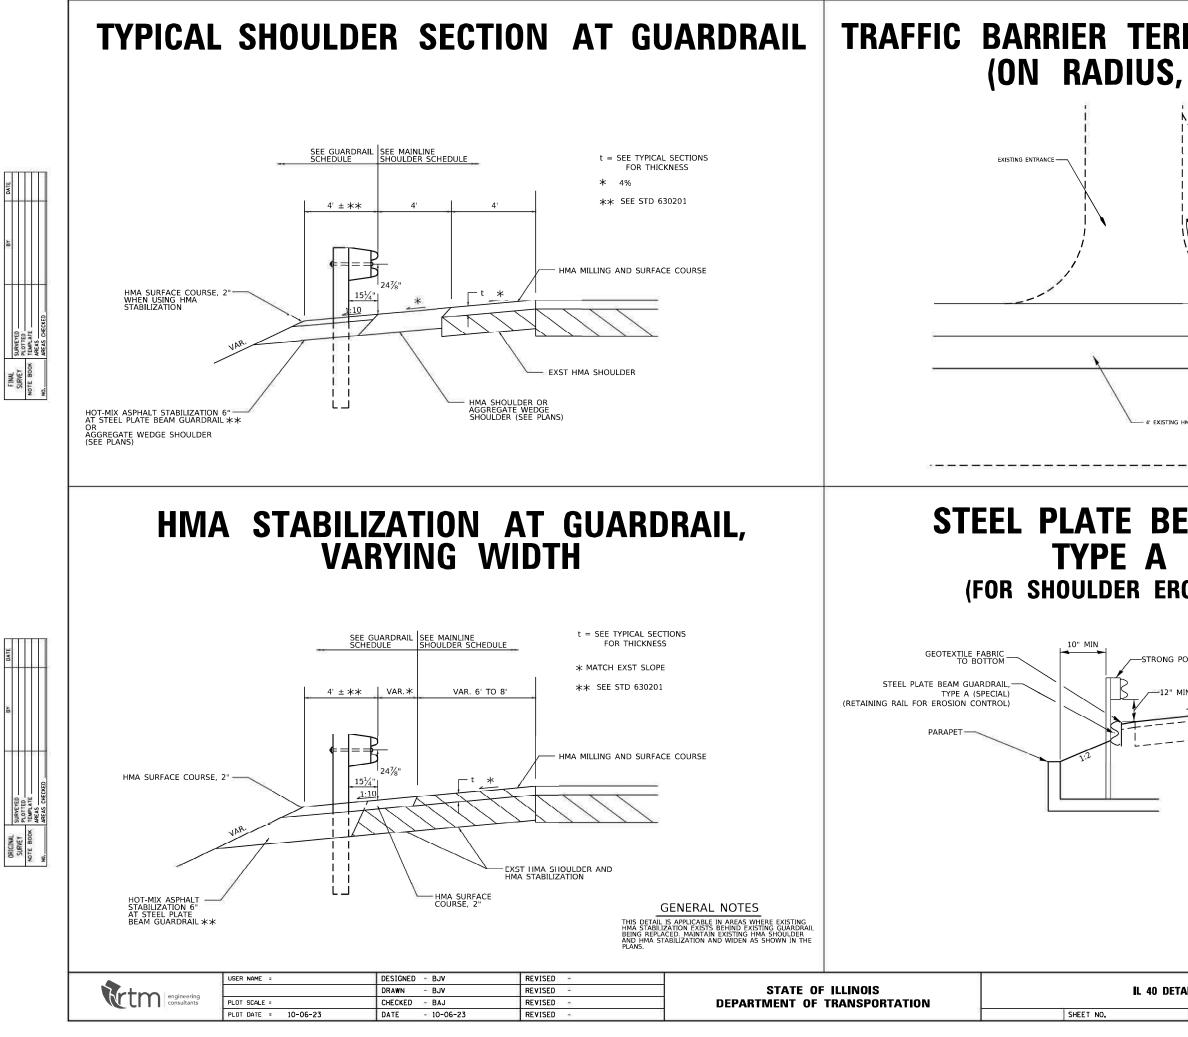


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LUMINAIRE PERFORMANCE TABLE LUMINAIRE, LED, ROADWAY, OUTPUT DESIGNATION H


ect								
	Contract N	lumber	Section Num	nber		ounty		
03-2023	64P41					WHITESIDE		
ed Route	Number			Municipality				
lway								
Width	*of Lanes	Median Width	I.E.S Surf	ace Classific	ation Q-	Zero Value		
ft	2	N/A	R3		C	.07		
i cture ting Heigh	nt Arm Lengt	h Set Bock	Number of ((Highmast &	Luminaires Sign Lightin	a Only)			
ft	6 ft	15 ft	N/A					
noire								
ription INAIRE, LE	D. ROADWAY, DE	SIGNATION H		I.E.S. Trans	sverse Di	STRIBUTION		Lateral Distribution
	ss Factor (LL				Shields			Dimming Protocol
		U = 0			NO			0-10V
r ut ing (to Ne ft	earest 5 Ft) C	onfiguration (C ONE ROW, NEAR		ggered, 1 Sic	led, or N	edian)		
ormance								
age Illumir .9	nance, E _{AVE} (fo		niformity Rat ≤ 5.0:1	io, E AVE / E MIN	1			
age Lumin	iance, L _{AVE} (cd)		ty Ratio, L _{AVE}		N/A	ty Ratio, L _{MAX} /L _{MIN}		Veiling Luminance Ratio, L _V /L _{MIN}
t Tressp ince to R	0055 OW (behind pol	e) Max. Horiz	ontal Illumina	nce at ROW,	E _H	Max. Vertical I N/A	lluminc	ance of ROW, Ey
s]		
	ack is from E the sign to t		nt (white line	e) except fo	er sign lu	minaires when it is	verti	ical and horizontal distance
2. Lighti	ng calculation	s shall be perf	ormed with c	ul luminaires	oriented	toward and perpe	ndicul	ar to roadway.
	Light Loss Fo ment Factors		ne product o	f "Lumen Ma	intenanc	e" (LLD) = 0.9, "Dirt	Depro	eciation" (LDD) = 0.8, and
		rements shall b n conditions ab		m acceptable	e standa	rds of photometric	perfo	ormance for the luminaire,
5. Lighti	ng calculation	s shall be perf	'ormed in one	direction o	only.			
6. Compli	ance with per	formance crit	eria shall be	held to one	signific	nt digit.		


				F A P. RTE	SECTION		COUNTY	TOTAL SHEETS	SHEET NO.
LIC	GHT DETA	IL		646	(101, 102, 135)R	S	WHITESIDE	179	120
							CONTRACT	NO. 64	4P41
OF	SHEETS	STA.	TO STA.		ILLINOIS	FED. A	ID PROJECT		




	L TYPE 2 (SPECIAL) Entrance)
	PROPOSED AGGREGATE WEDGE SHOULDER
	EXISTING HEADWALL
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NAT A	SPBGR TY A OR B
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	\backslash
HMA SHOULDER	4' PROPOSED HMA SHOULDER
	PROFUSED TIMA STOULDER
	GUARDRAIL, CIAL) AT CULVERT)
	EDGE OF
OST GUARDRAIL	
IN TO TOP OF RETA	
	GENERAL NOTES
	STEEL PLATE BEAM GUARDRAIL SHALL BE ACCORDING TO THE REQUIREMENTS OF AASHTO M 180, TYPE 1, CLASS A.
	STELL PLATE BEAM GUARDRAIL AND STELL POSTS SHALL BE IN ACCORDANCE WITH ARTICLES 1006.23 AND 1006.25 OF THE STANDARD SPECIFICATIONS.
	ALL SECTIONS OF GUARDRAIL SHALL BE BOLTED TOGETHER. RAIL ELEMENTS SHALL BE BOLTED TO POST.
	BOTTOM OF RAIL SHALL BE EMBEDDED INTO THE FORESLOPE UNTIL NO GAP EXISTS BETWEEN THE BOTTOM OF THE RAIL AND THE EXISTING GROUND.
	GEOTEXTILE FABRIC SHALL BE PLACED BEHIND THE RAIL ELEMENT AND ON THE GROUND BEHIND THE EXISTING GUARDRAIL BEFORE PLACING THE AGGREGATE WEDGE SHOULDERS. THE INSTALLATION AND MATERIAL FOR GEOTEXTILE FABRIC SHALL BE ACCORDING TO SECTION 210 OF THE STANDARD SPECIFICATIONS
	SHALL BE ACCORDING TO SECTION 210 OF THE STANDARD SPECIFICATIONS. AT LOCATIONS WHERE THERE ARE GAPS UNDER THE RAIL, ANOTHER RAIL ELEMENT SHALL BE PLACED BELOW THE FIRST RAIL AND BOLTED TO IT. THE ADDITIONAL RAIL ELEMENTS WILL BE PAID AT THE CONTRACT UNIT PRICE PER FOOT FOR STEEL PLATE BEAM GUARDRAIL, TYPE A (SPECIAL).
	STEEL PLATE BEAM GUARDRAIL (BOTTOM RAIL) AND GEOTEXTILE FABRIC SHALL BE PAID FOR AT THE CONTRACT UNIT PRICE PER FOOT FOR STEEL PLATE BEAM GUARDRAIL, TYPE A (SPECIAL). STRONG POST GUARDRAIL WILL BE PAID FOR SEPARATELY.

	F.A. RTE.	SECTION	COUNTY	TOTAL SHEETS	SHEET NO.
AILS	646	(101, 102, 135) RS	WHITESIDE	179	121
r i i i i i i i i i i i i i i i i i i i	SCALES		CONTRAC	T NO. 6	54P41
STA TO STA		ILLINOIS			

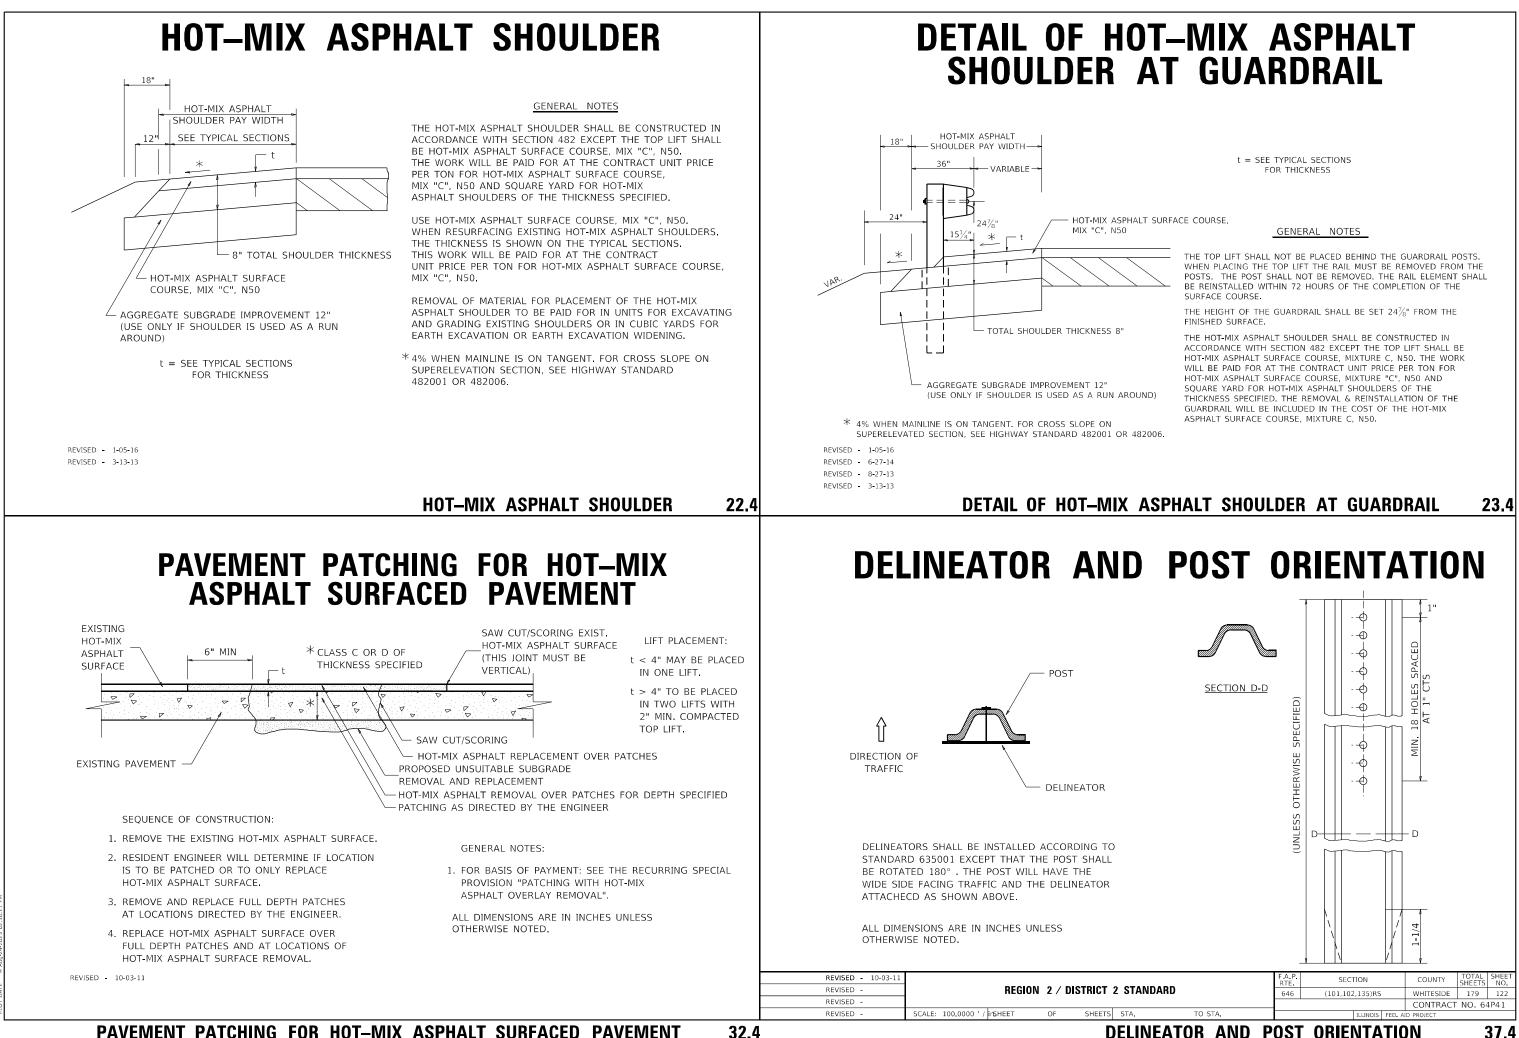

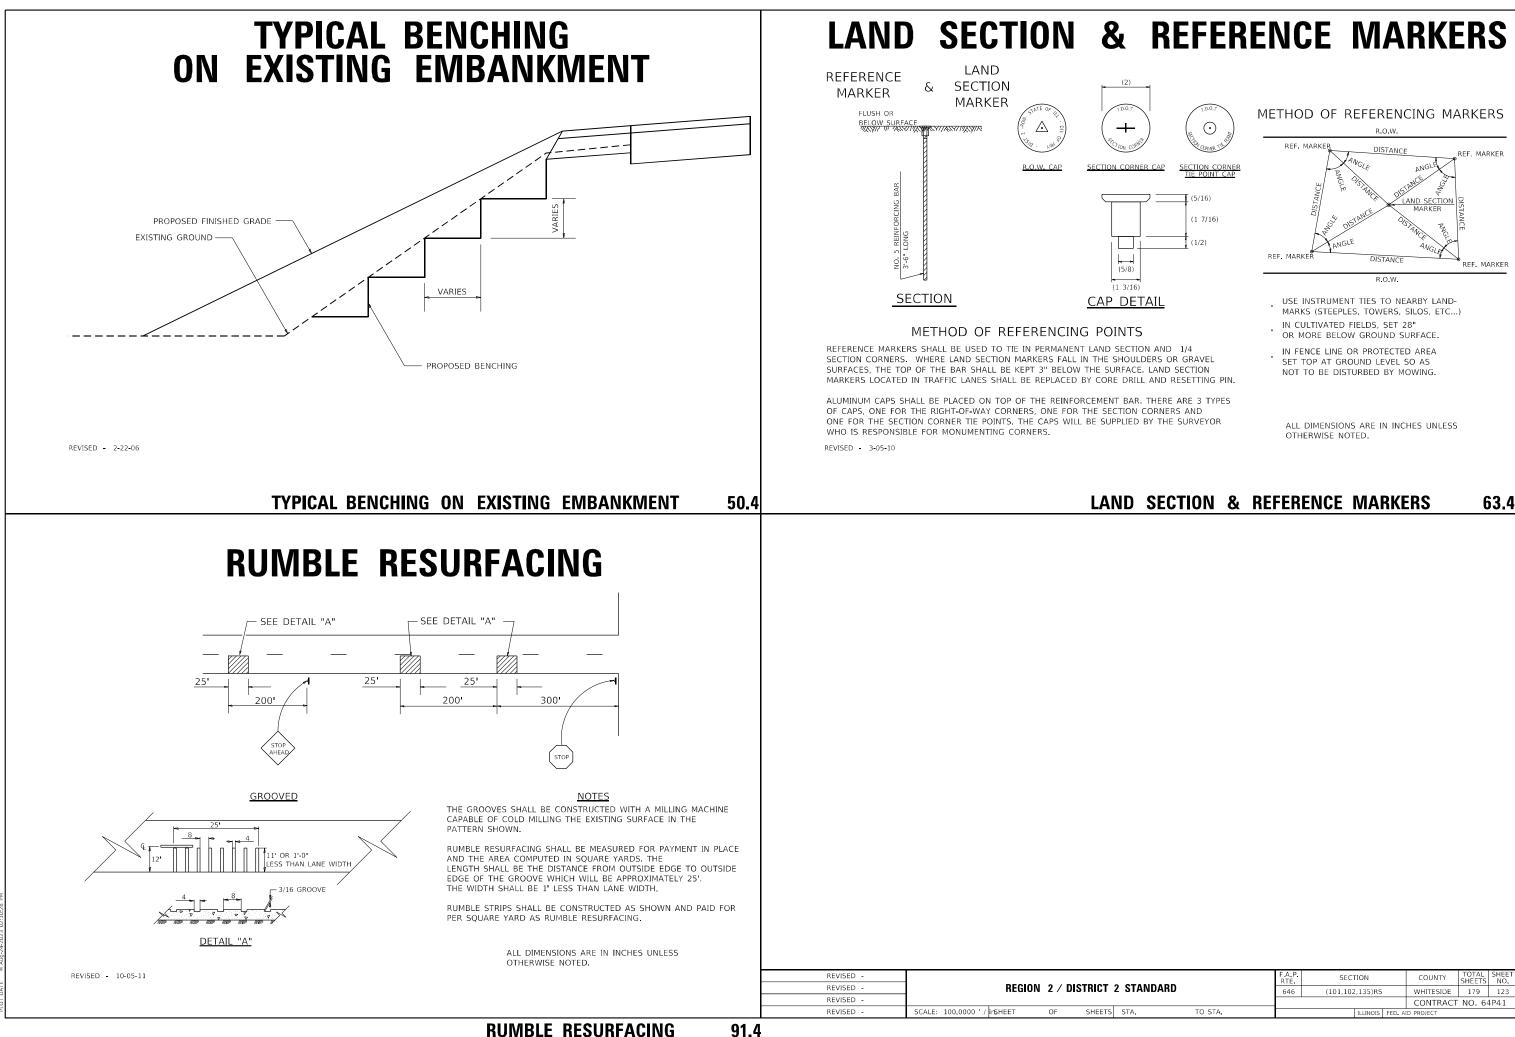

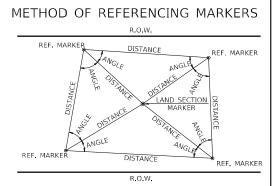


- USE INSTRUMENT TIES TO NEARBY LAND-MARKS (STEEPLES, TOWERS, SILOS, ETC ...)
- IN CULTIVATED FIELDS, SET 28" OR MORE BELOW GROUND SURFACE.
- IN FENCE LINE OR PROTECTED AREA SET TOP AT GROUND LEVEL SO AS NOT TO BE DISTURBED BY MOWING.

ALL DIMENSIONS ARE IN INCHES UNLESS OTHERWISE NOTED.

LAND SECTION & REFERENCE MARKERS 63.4


T 2 STANDARD				SECT	COUNTY	TOTAL SHEETS	SHEET NO.		
T 2 STANDARD			646	(101,102	,135)RS		WHITESIDE	179	123
							CONTRACT	NO. 64	1P41
TS	STA.	TO STA.			ILLINOIS	FED. AI	D PROJECT		

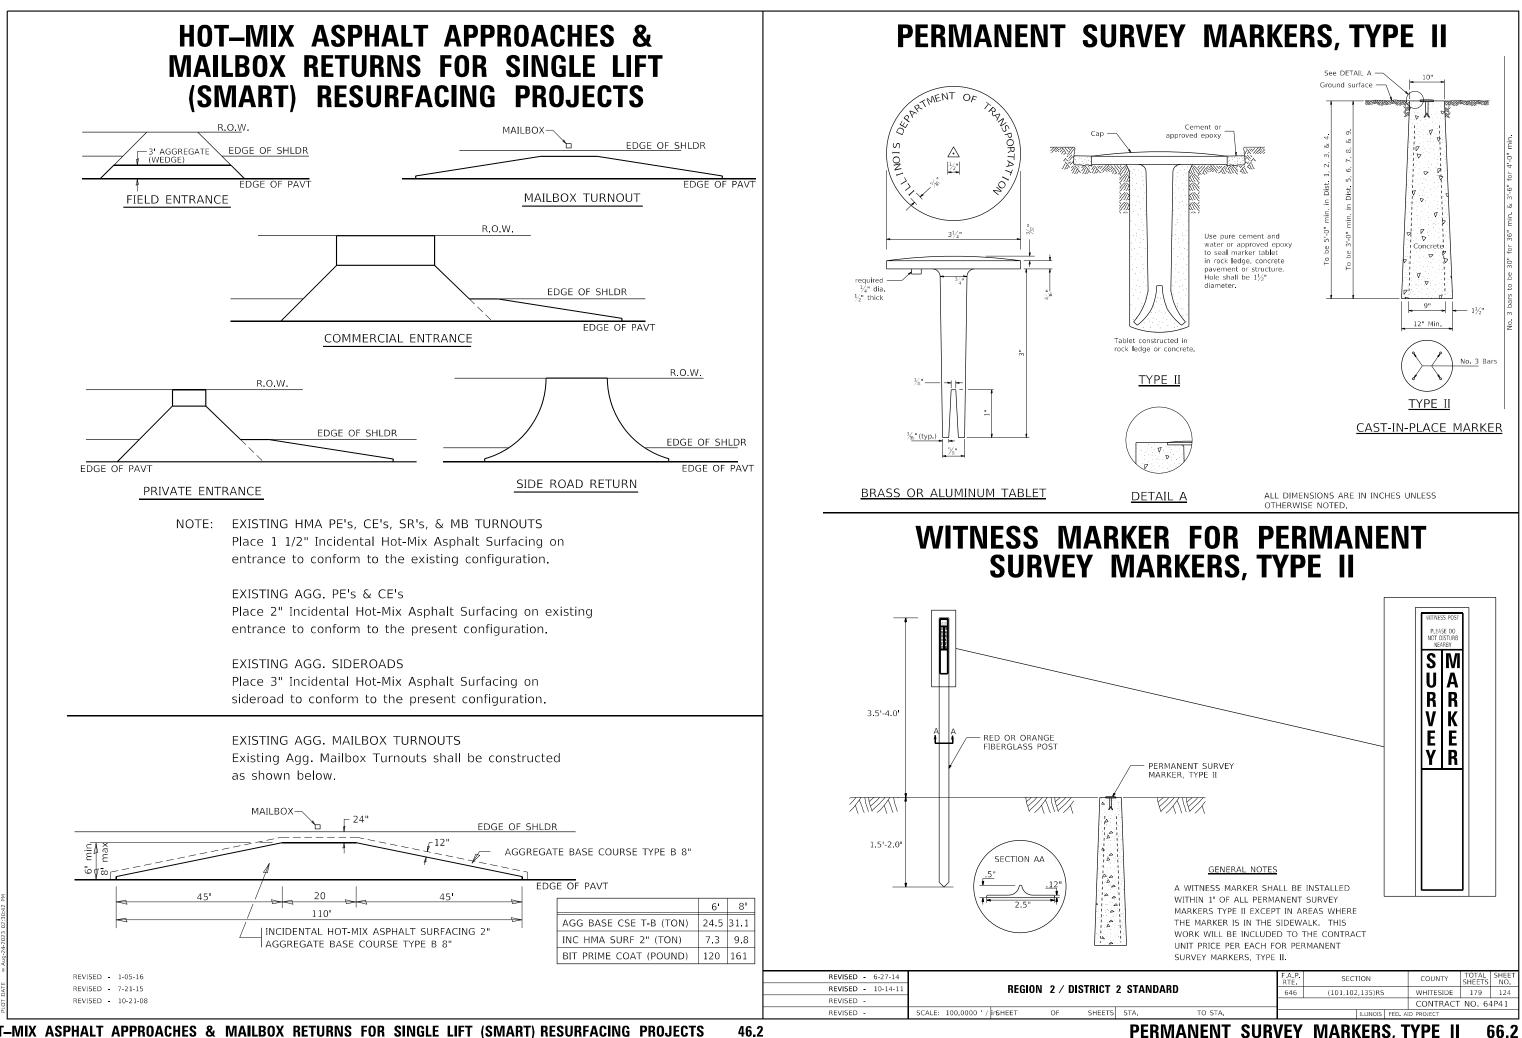

HOT-MIX ASPHALT APPROACHES & MAILBOX RETURNS FOR SINGLE LIFT (SMART) RESURFACING PROJECTS

46.2

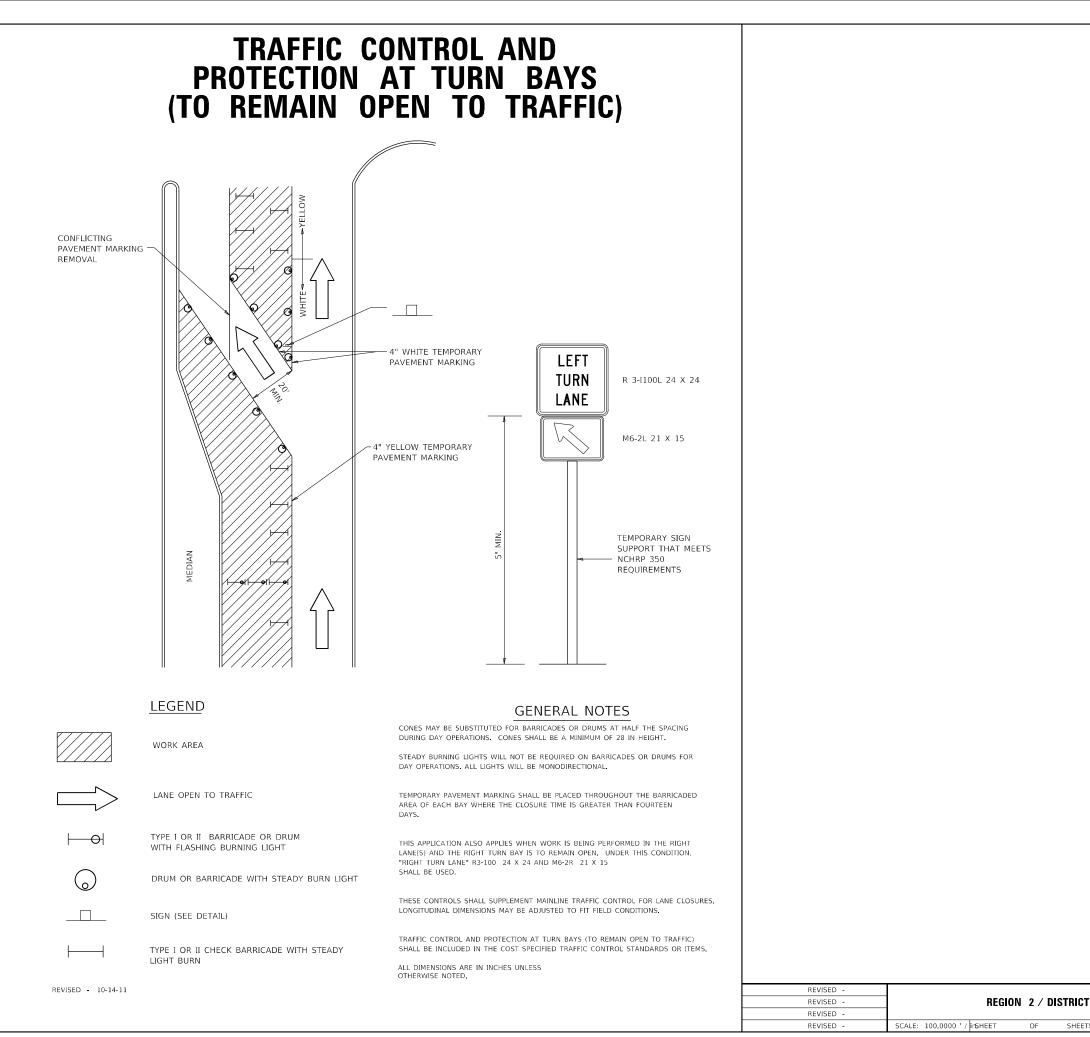66.2





Traffic Control and Protection at Turn Bays (To Remain Open to Traffic) 94.2

					F.A.P. RTE	SECTION	COUNTY	TOTAL SHEETS	SHEET NO.
REGION	2 / L	DISTRICT	2 STANDARD		646	(101,102,135)RS	WHITESIDE	179	125
					_		CONTRACT	NO. 64	1P41
HEET	OF	SHEETS	STA.	TO STA.		ILLINOIS FED. /	ID PROJECT		

WORK ZONE SIGN DETAILS

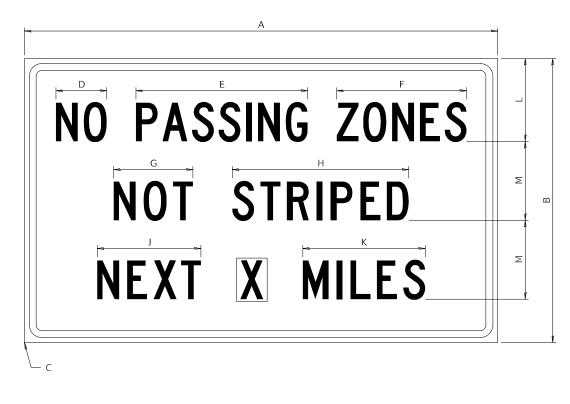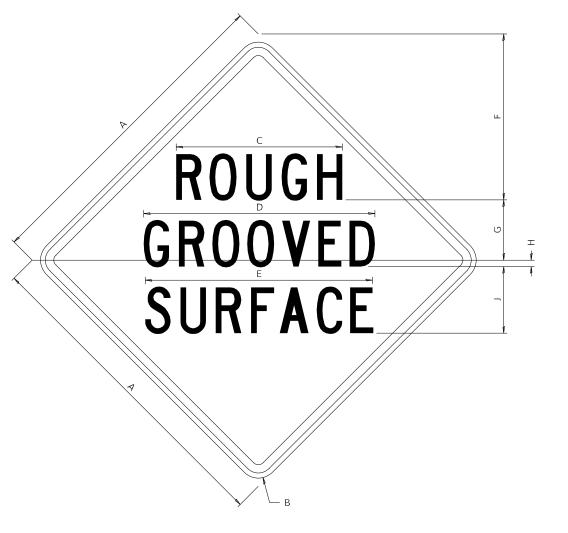ILLINOIS STANDARD G20–1100





LEGEND AND BORDER COLOR BACKGROUND

NON-REFLECTORIZED ORANGE REFLECTORIZED

		DIMENSIONS										
SIGN SIZE	А	В	С	D	E	F	G	Н	J	К	L	М
60 x 36	60.00	36.00	2,25	6.4	21.80	16.40	10.00	22.40	13.20	15.50	10.50	10.00

BLACK

SIGN SIZE	SER	ies by	LINE	MARGIN	BORDER	
SIGN SIZE	1	2	3	MARGIN	BUKDER	
60 x 36	5C	5C	5C	0.625	0.875	

Sign not to scale

GENERAL NOTES

All work to furnish and install these signs shall be included in the cost of the specified traffic control standards and shall not be paid separately.

All Illinois Standard signs shall conform to the latest edition of the "Illinois Standard Highway Signs Book" in effect on the date of invitation for bids.

Signs shall meet the applicable portions of Sections 701 and 720 of the Standard Specifications.

All dimensions are in inches unless otherwise noted.

ער ד	

COLOR

SIGN SIZE				DII		2112			
	А	В	С	D	Е	F	G	Н	J
48 x 48	48.00	3.00	25.00	34.80	34.20	24.94	9.00	1.00	10.00

SIGN SIZE	SER	ies by	LINE	MARGIN	BORDER	
SIGN SIZE	1	2	3	MARGIN	BURDER	
48 x 48	7C	7C	7C	1.250	0.750	

	USER NAME = Brad.Cushman	DESIGNED -	REVISED - 3-02-16				F A P BTF	SECTION	COUNTY	TOTAL SHEET
FILE NAME: pw:\\ildot-pw.bentley.com:PWIDOT\Do	uments\IDOT Offices\District 2\Projects\64P41\Program	De [24R04W/@h t\Studies & Plans\Design\CADD\CADshe	ats \RE_\G∯BD -sht-details.dgn	STATE OF ILLINOIS		REGION 2 / DISTRICT 2 STANDARD	646	(101,102,135)RS	WHITESIDE	179 126
	PLOT SCALE = 100.0000 / in. CHECKED -	CHECKED -	REVISED -	DEPARTMENT OF TRANSPORTATION	TATION				CONTRACT	NO. 64P41
	PLOT DATE = Aug-24-2023 02:31:12 PM	DATE -	REVISED -		SCALE:	SHEET 1 OF 4 SHEETS STA. TO STA.		ILLINOIS FED. A	ND PROJECT	
						WORK ZONE SIGN DETA	ILS	SHEET 1	OF 4	34.1

ILLINOIS STANDARD W8–1107

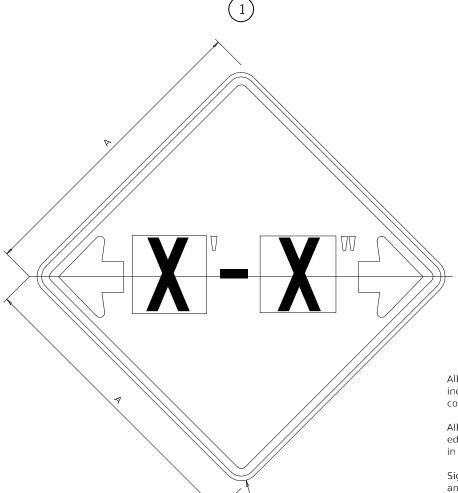
LEGEND AND BORDER BACKGROUND

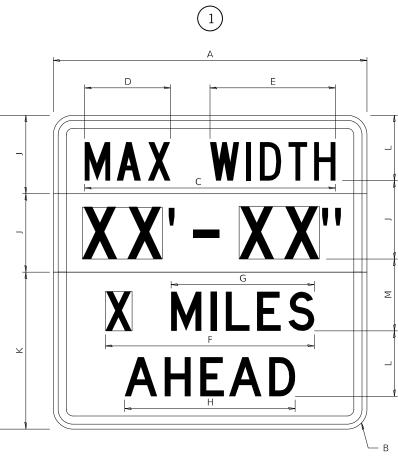
BLACK ORANGE NON-REFLECTORIZED REFLECTORIZED

Sign not to scale

WORK ZONE SIGN DETAILS







GENERAL NOTES

All work to furnish and install these signs shall be included in the cost of the specified traffic control standards and shall not be paid separately.

All Illinois Standard signs shall conform to the latest edition of the "Illinois Standard Highway Signs Book" in effect on the date of invitation for bids.

Signs shall meet the applicable portions of Sections 701 and 720 of the Standard Specifications.

All dimensions are in inches unless otherwise noted.

COLOR	LEGEND AND BORDER
COLOR	BACKGROUND

NON-REFLECTORIZED REFLECTORIZED

SIGN SIZE	DIMEN	ISIONS
SIGN SIZE	А	1ENSIONS B 0 3.00
48 x 48	48.00	3.00

Illinois Standard signs W12-I102 and W12-I103 shall be $\begin{pmatrix} 1 \end{pmatrix}$ used as described in the special provisions.

SIGN SIZE	SERIES BY LINE	MARGIN	BORDER
SIGN SIZE	1	MARGIN	DURDER
48 x 48	12C	0,750	1,250

Sign not to scale

l		USER NAME = Brad.Cushman	DESIGNED -	REVISED - 3-02-16				
	FILE NAME: pw:\\ildot-pw.bentley.com:PWIDOT\Doc	uments\IDOT Offices\District 2\Projects\64P41\Program	De DHRAWVAN It\Studies & Plans\Design\CADD\CADshee	ts 收在_/纠纷段D -sht-details.dgn	STATE OF ILLINOIS	REGION 2 / DI		
		PLOT SCALE = 100.0000 / in.	CHECKED -	REVISED -	DEPARTMENT OF TRANSPORTATION			
		PLOT DATE = Aug-24-2023 02:31:30 PM	DATE -	REVISED -		SCALE:	SHEET 2	OF 4 SH

1

6C

BACKGROUND

А

48.00

SIGN SIZE

48 x 48

Sign not to scale

В

3.00

COLOR

SIGN SIZE

48 x 48

BLACK FL ORANGE

LEGEND AND BORDER NON-REFLECTORIZED BLACK WHITE REFLECTORIZED BACKGROUND (WIDTH) FL ORANGE REFLECTORIZED DIMENSIONS D С Е G Н М F Κ 38.40 13.20 19.20 22.00 10.00 11.00 32.00 26.20 12.00 24.00 SERIES BY LINE BORDER MARGIN 4 2 3 8D 6D 6D 0.750 1.250 XX'-XX" WIDTH AND X MILES ARE VARIABLE TOP AND BOTTOM OF BACKGROUND WHITE SECTION COUNTY TRICT 2 STANDARD 646 (101,102,135)RS WHITESIDE 179 127 CONTRACT NO. 64P41 SHEETS STA. TO STA. WORK ZONE SIGN DETAILS SHEET 2 OF 4 34.1

ILLINOIS STANDARD W12–I103

WORK ZONE SIGN DETAILS

STOP LINE SIGN FOR TEMPORARY SIGNALS

ROAD CLOSED TO OVERSIZED LOADS 11.7 43.8 11.7 11.3 3.5 NO OVERSIZE 28.9 2.6 —---2.6 º OVERWEIGHT LOADS 00 XX MILES AHEAD 5 96 LEGEND AND BORDER BLACK NON-REFLECTORIZED COLOR BACKGROUND ORANGE REFLECTORIZED Permit Loads - Loads Over 13 Feet; 3.0" Radius, 1.3" Border; [NO OVERSIZE -] D; [OVERWEIGHT LOADS] D 85% spacing; [XX MILES AHEAD] D; Table of letter and object lefts. 0 Ν Ο V Е R S Ζ Е 48.4 60.7 69.5 11.7 18.1 30.0 36.2 42.8 54.4 63.5 80.8 Е W Е S Ο V R G Н Т L Ο А D 33.4 2.6 8.6 15.0 20.4 26.2 38.8 41.3 47.4 53.2 64.5 69.9 75.9 82.9 88.7 Е D Μ S Х Х А Н Е А 7.6 13.6 25.3 32.3 35.1 40.6 46.2 57.9 65.1 71.4 76.6 83.7

Sign not to scale

~	
	AC
	SI

LEGEND AND BORDER COLOR BACKGROUND

SIGN SIZE 24 x 24

GENERAL NOTES

All work to furnish and install these signs shall be included in the cost of the specified traffic control standards and shall not be paid separately.

All Illinois Standard signs shall conform to the latest edition of the "Illinois Standard Highway Signs Book" in effect on the date of invitation for bids.

Signs shall meet the applicable portions of Sections 701 and 720 of the Standard Specifications.

All dimensions are in inches unless otherwise noted.

	FILE NAME: pw:\\ildot-pw.bentley.com:PWIDOT\Doc	USER NAME = Brad Cushman uments\IDOT Offices\District 2\Projects\64P41\Program PLOT SCALE = 100.0000 / in	DESIGNED - Pe D#AwWeh t\Studies & Plans\Design\CADD\CADshee CHECKED -	REVISED - 3-02-16 ts/REV/ISED-sht-details.dgn REVISED -	STATE OF ILLINOIS DEPARTMENT OF TRANSPORTATION		REGION 2 / DISTRICT	2
		PLOT DATE = Aug-24-2023 02:31:52 PM	DATE -	REVISED -		SCALE:	SHEET 3 OF 4 SHEETS	٤
-		•	•	•	•	·		-



BLACK WHITE

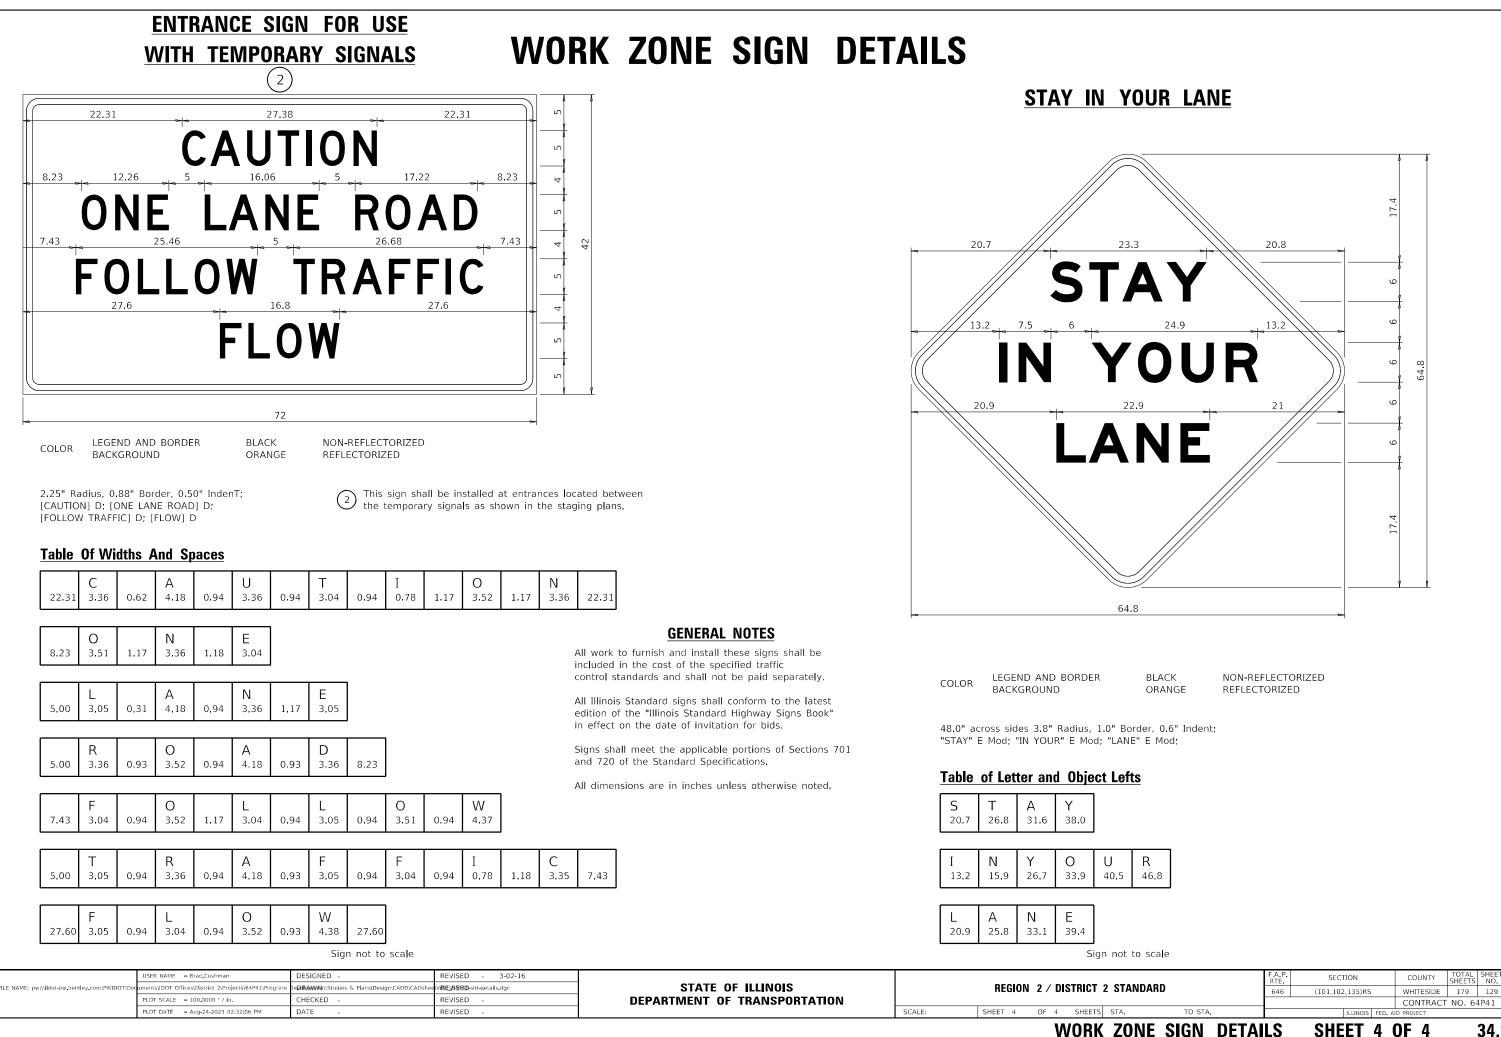
SERIES BY LINE 1 2 3 4C 4C 4C

Sign not to scale


SECTION COUNTY 2 STANDARD 646 (101,102,135)RS WHITESIDE 179 128 CONTRACT NO. 64P41 STA. TO STA. ILLINOIS FED. WORK ZONE SIGN DETAILS SHEET 3 OF 4 34.1

NON-REFLECTORIZED

REFLECTORIZED




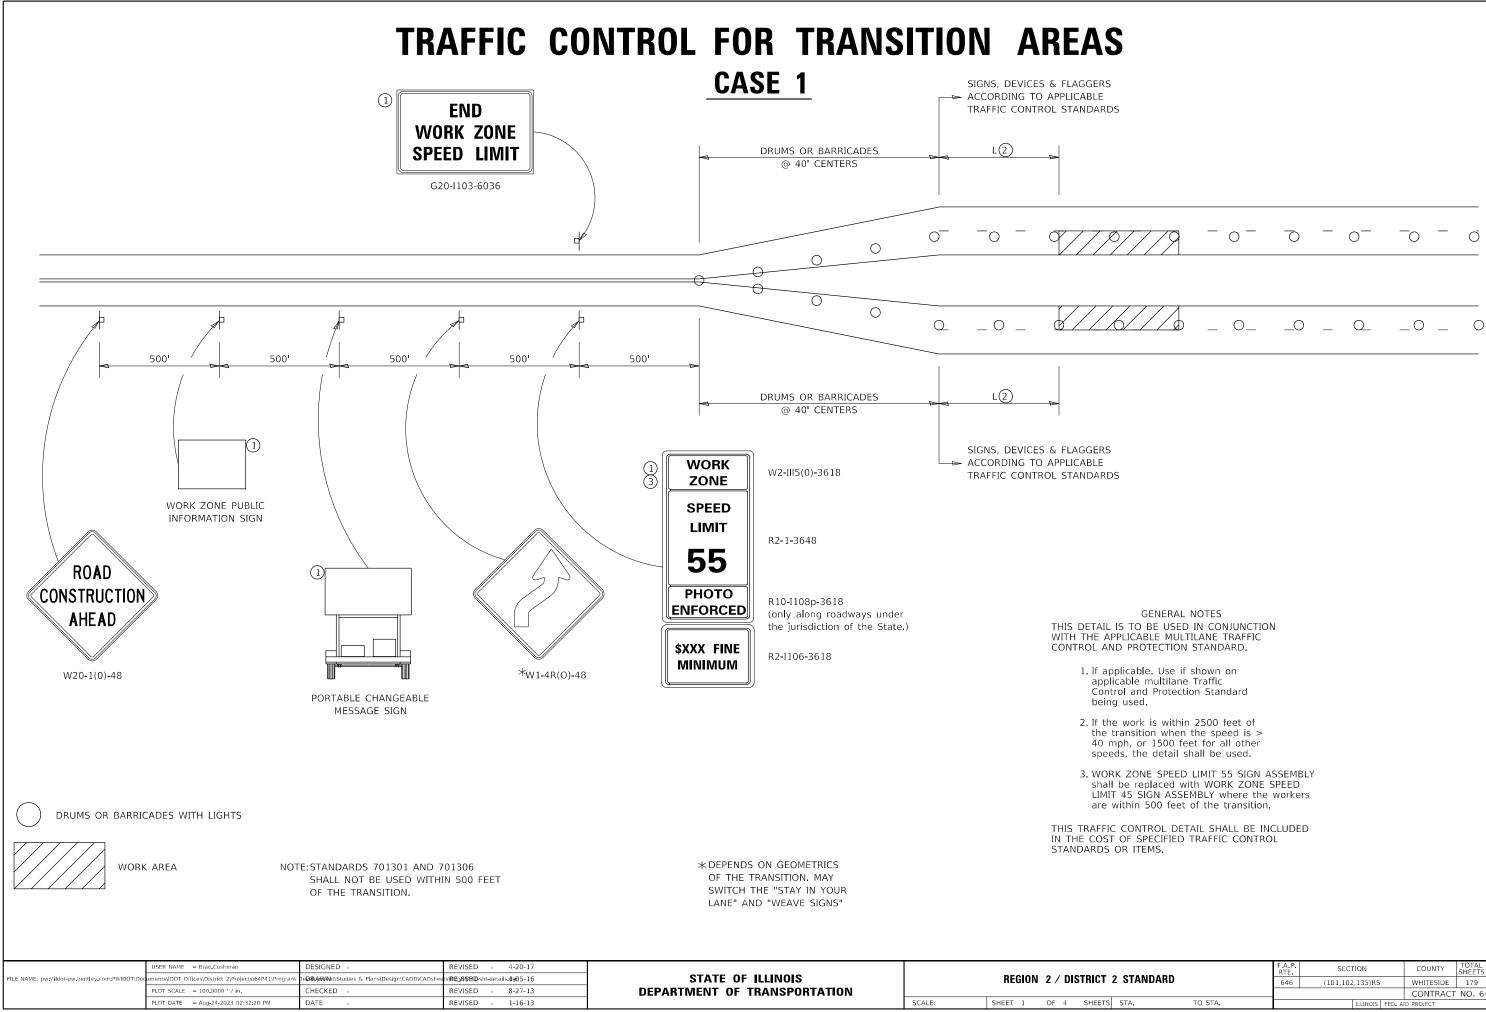34.1



TRAFFIC CONTROL FOR TRANSITION AREAS

R	TRANSITION	AREA	S	SHE	ET	1 (DF 4		38.1
S	STA. TO STA.				ILLINOIS	FED. AI	D PROJECT		
_	1						CONTRACT	NO. 64	1P41
	2 STANDARD		646	(101,102	,135)RS		WHITESIDE	179	130
			F.A.P. RTE	SECT	ION		COUNTY	TOTAL SHEETS	SHEET NO.

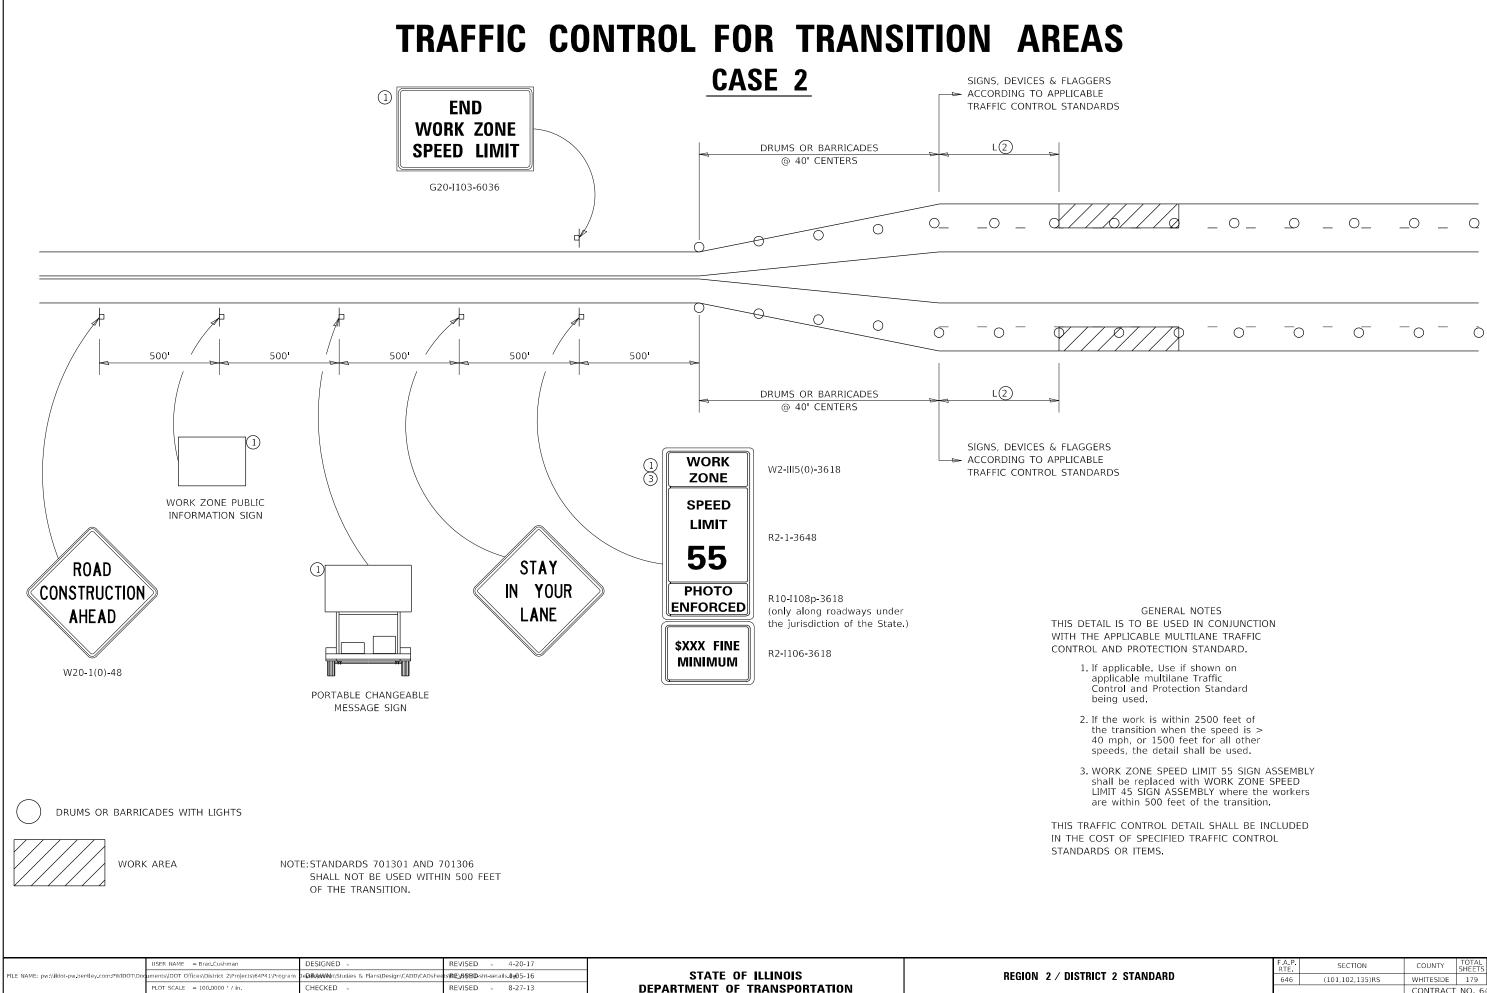


-	REVISED - 8-27-13 REVISED - 1-16-13	DEPARIMENT OF TRANSPORTATION	SCALE:	SHEET 2	OF 4	SHEETS	STA.
			TRAFFIC	CONT	ROL	FOR	TRAN

PLOT DATE = Aug-24-2023 02:32:35 PM

DATE

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a section county sheets no. 646 (101,102,135)RS WHITESIDE 179 131 CONTRACT NO. 64P41 CONTRACT NO. 64P41			AREAS	s	SHE	ET				38.1
RTE SECTION COUNTY SHEETS NO.									NO. 64	↓P41
BTE SECTION COUNTY SHEETS NO.	2 STANDARD			646	(101,102,135)RS			WHITESIDE	179	131
		2 СТАМЛАЛЛ			SECT	ION		COUNTY	TOTAL SHEETS	SHEET NO.

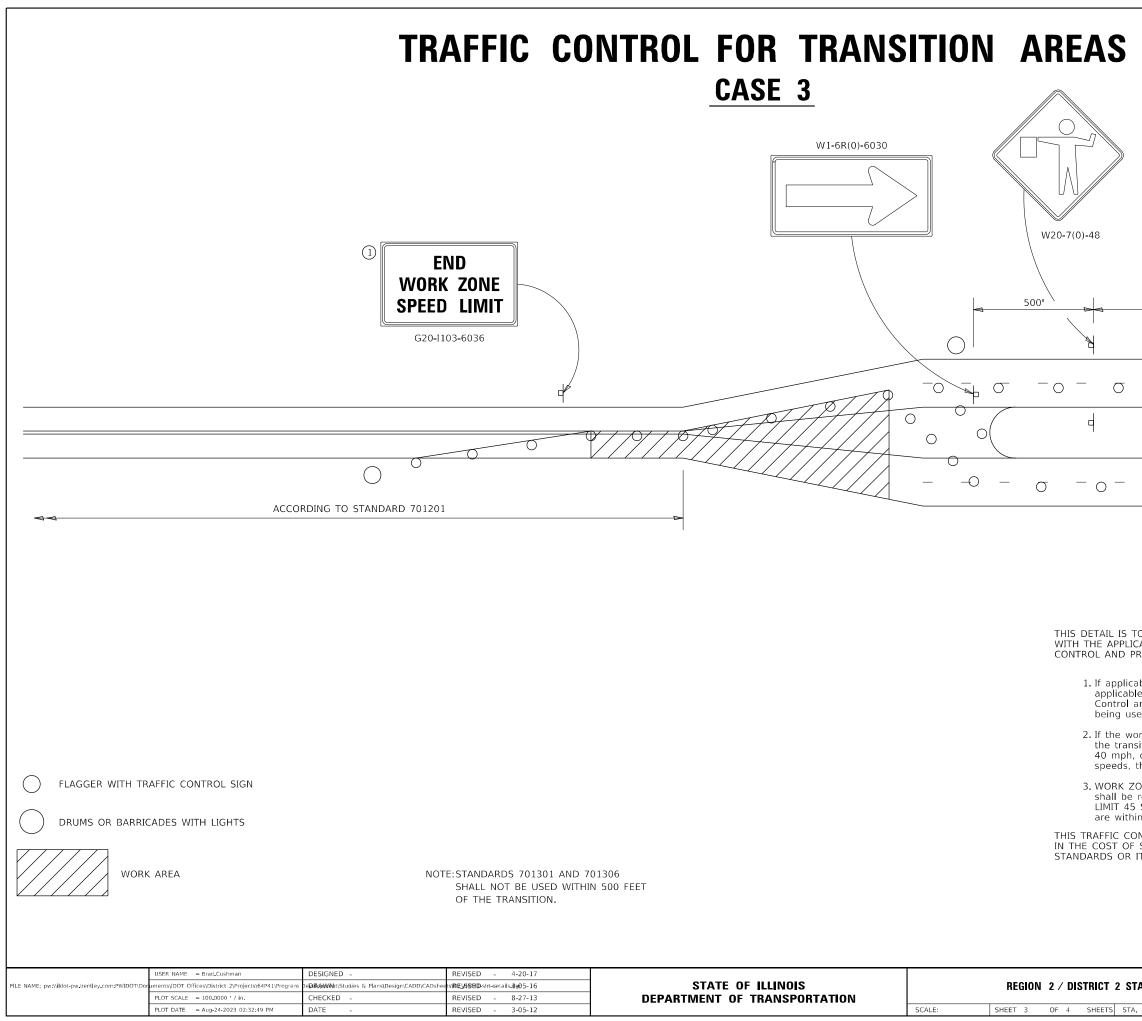


S ONE LANE ROAD AHEAD W20-4(0)-48	۵,	E PREF TO	STOF	///	ARD 701406, 701422	
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GENERAL NOTES L IS TO BE USED IN CONJUNCTION APPLICABLE MULTILANE TRAFFIC ND PROTECTION STANDARD. applicable. Use if shown on olicable multilane Traffic ntrol and Protection Standard ng used. the work is within 2500 feet of a transition when the speed is > mph, or 1500 feet for all other seeds, the detail shall be used. ORK ZONE SPEED LIMIT 55 SIGN A: all be replaced with WORK ZONE S IIT 45 SIGN ASSEMBLY where the e within 500 feet of the transition. CC CONTROL DETAIL SHALL BE ING ST OF SPECIFIED TRAFFIC CONTRO S OR ITEMS.	SSEMBL PEED workers CLUDED	i				
	F.A.P. RTE.	SECTION		COUNT	Y TOTA SHEE	IL SHEET
2 STANDARD	646	(101,102,135			_	132
S STA. TO STA.		11 L IN	IOIS FED. AI			

I	RA	NS	ITI	0	N	AREAS
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SHEET 3 OF 4

ILLINOIS FED. AID PROJEC

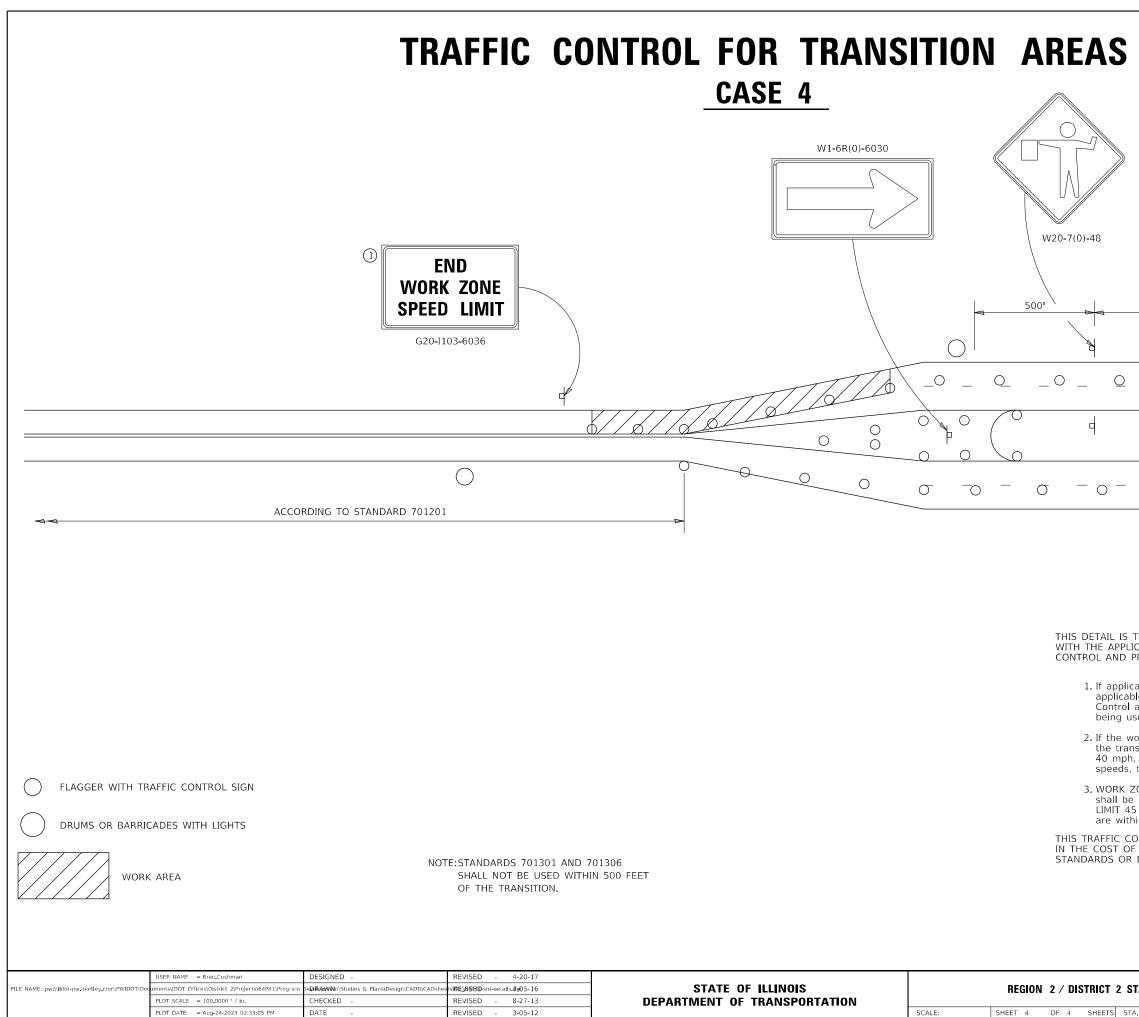38.1




DATE

S ONE LANE ROAD AHEAD W20-4(0)-48	0'	BE PREP/ TO S	AREI STOF	///	ARD 01406, 701422	
						A
QOO	_ O_	0	_	0_		
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GENERAL NOTES L IS TO BE USED IN CONJUNCTION APPLICABLE MULTILANE TRAFFIC ND PROTECTION STANDARD. applicable. Use if shown on olicable multilane Traffic ntrol and Protection Standard ng used. he work is within 2500 feet of e transition when the speed is > mph, or 1500 feet for all other eeds, the detail shall be used. DRK ZONE SPEED LIMIT 55 SIGN A: all be replaced with WORK ZONE S IIT 45 SIGN ASSEMBLY where the e within 500 feet of the transition. IC CONTROL DETAIL SHALL BE INC ST OF SPECIFIED TRAFFIC CONTRO S OR ITEMS.	SSEMBLY SPEED workers CLUDED					
2 STANDARD	F.A. P RTE 646 (SECTION 101,102,135)R	s	COUNTY WHITESID	SHEETS	SHEET NO. 133
				CONTRA	INO. 04	· + 1


TA.	TO STA.		
RANS	ITION	AREA	S


ILLINOIS FED. AID PROJ SHEET 4 OF 4

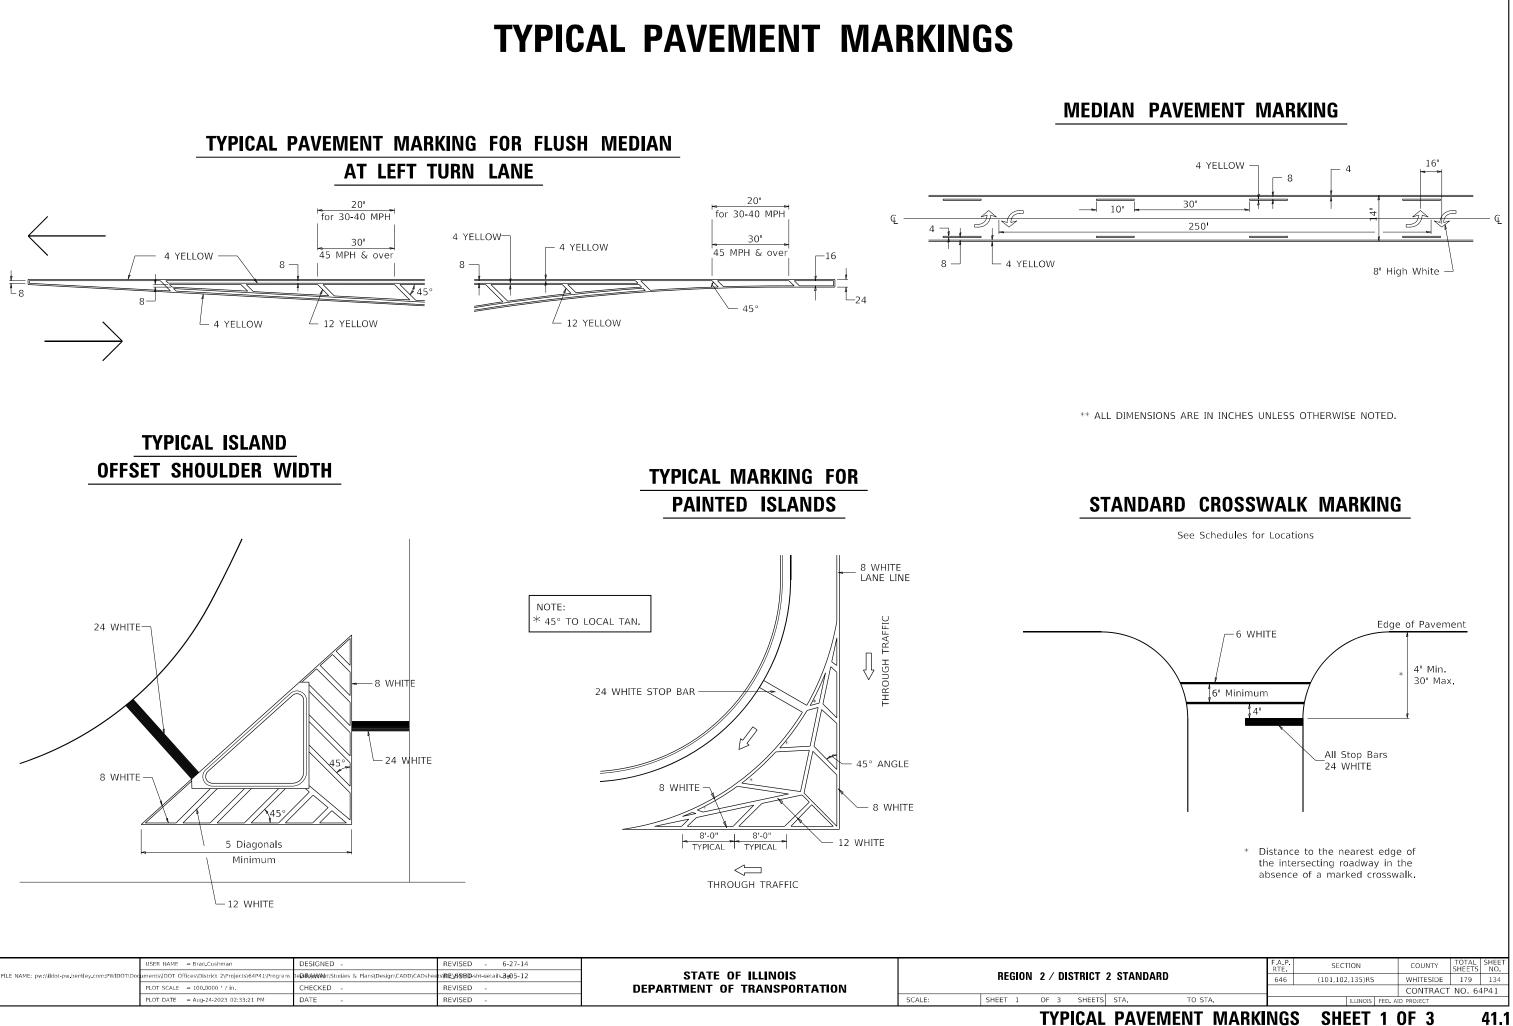
38.1



	PLOT SCALE = 100.0000 / in. PLOT DATE = Aug-24-2023 02:33:21 PM	CHECKED - DATE -	REVISED - REVISED -	DEPARTMENT OF TRANSPORTATION	SCALE:	SHEET 1	OF 3 SI	HEETS
FILE NAME: pw:\\ildot-pw.bentley.com:PWIDOT\Doc		DeD#RdyWV4ht\Studies & Plans\Design\CADD\CADshee		STATE OF ILLINOIS DEPARTMENT OF TRANSPORTATION		REGION	2 / DISTR	ICT 2
	USER NAME = Brad Cushman	DESIGNED -	REVISED - 6-27-14		1			

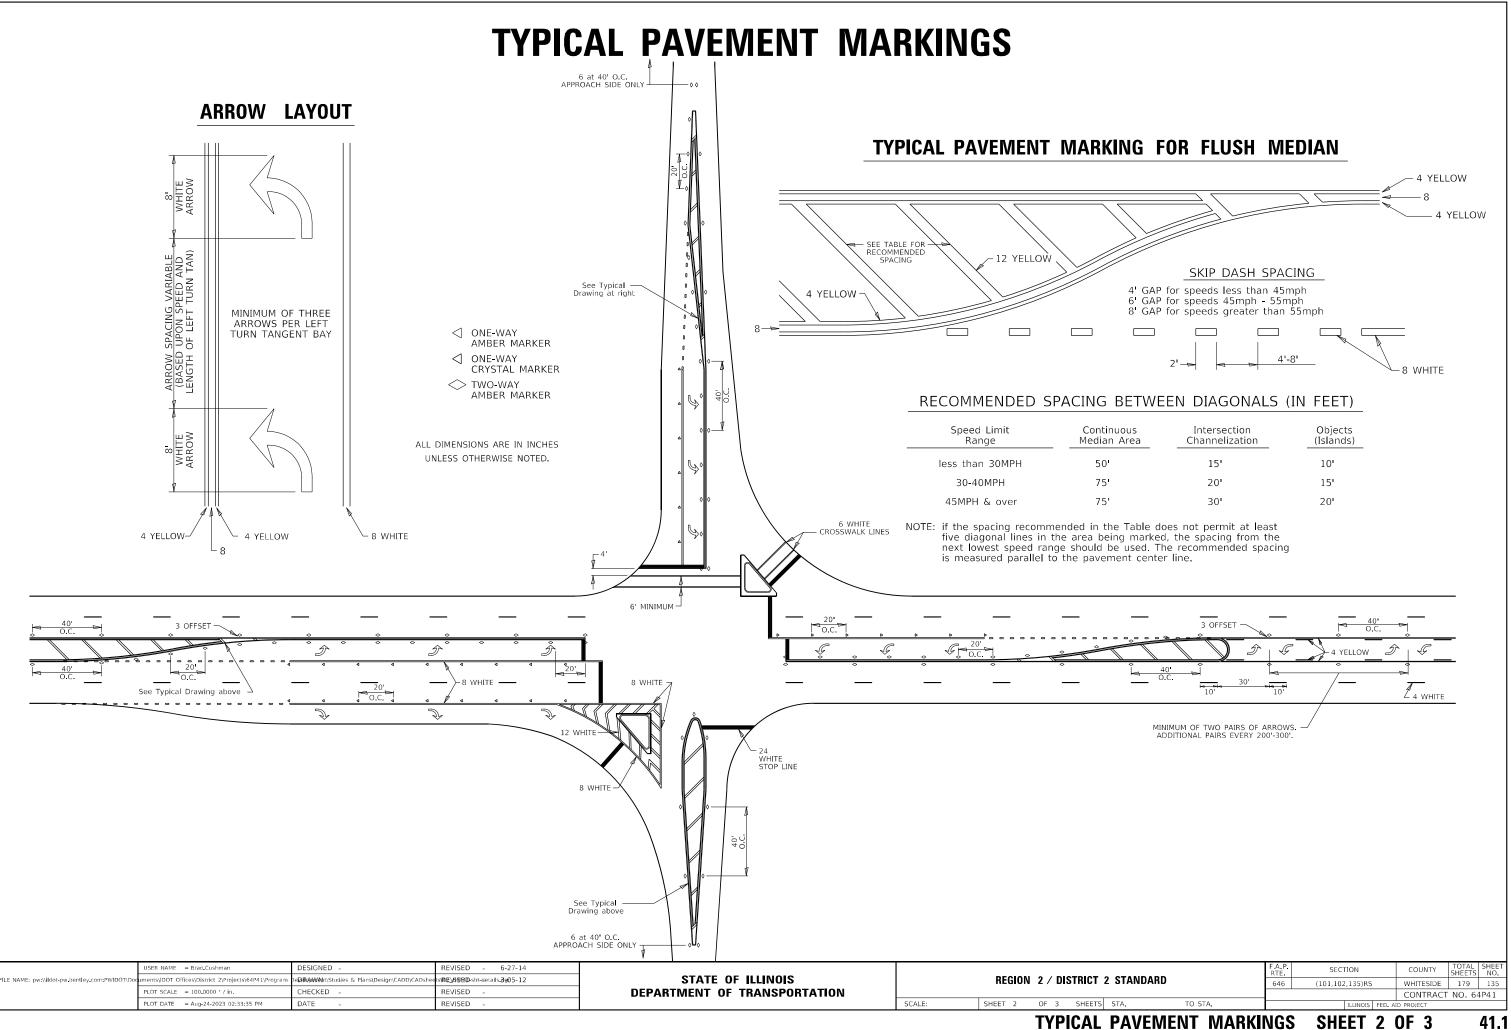

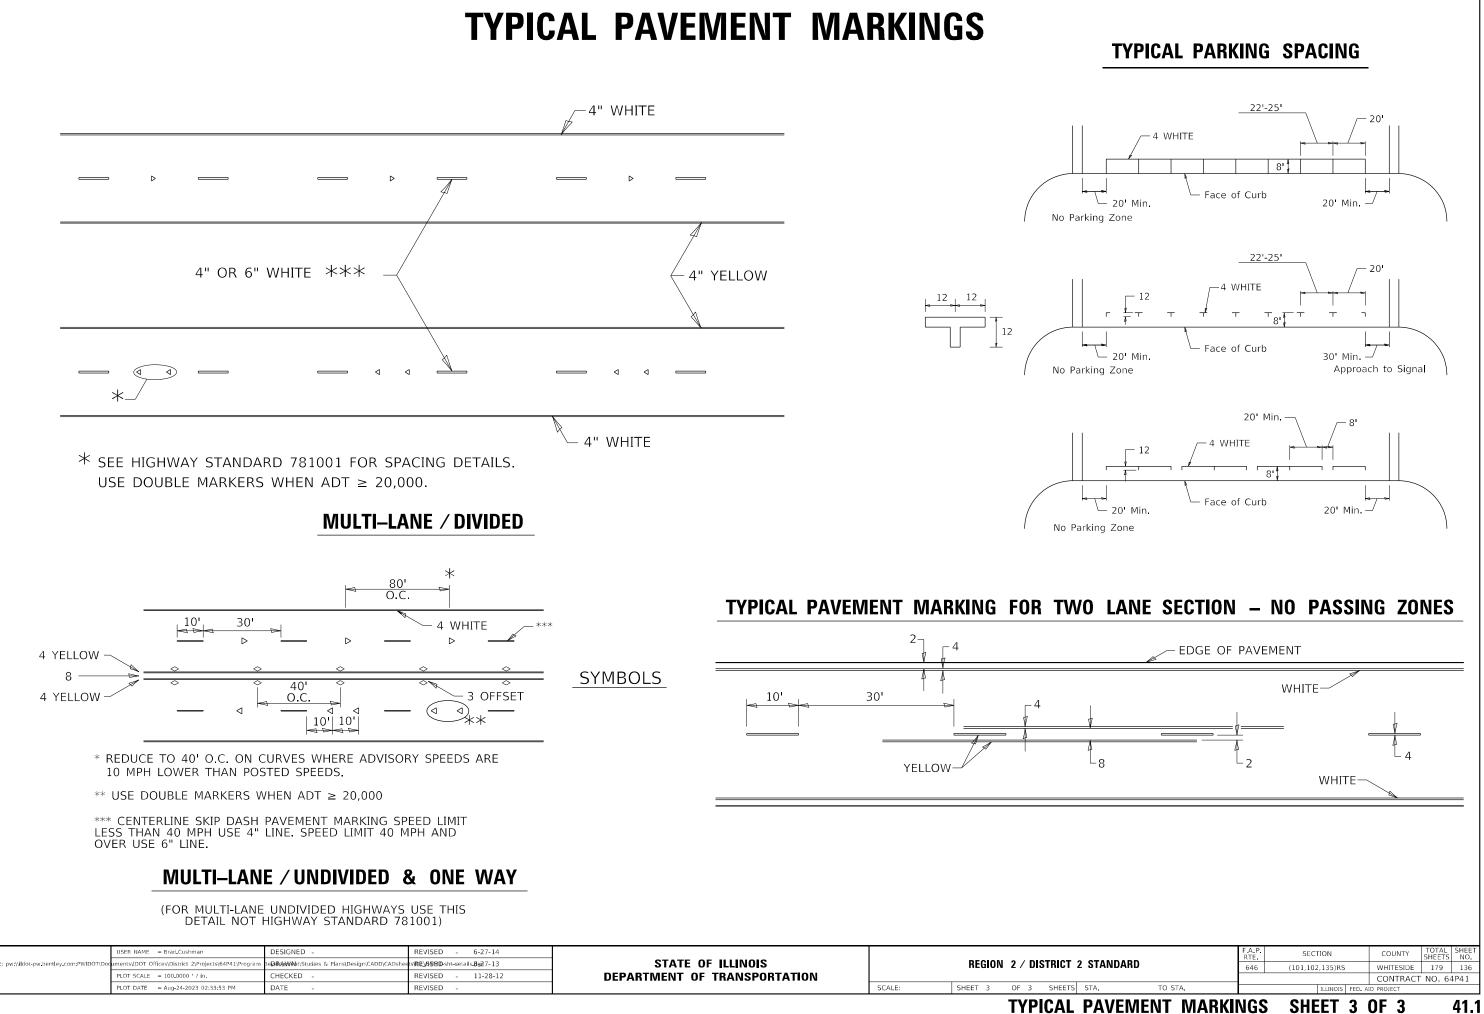

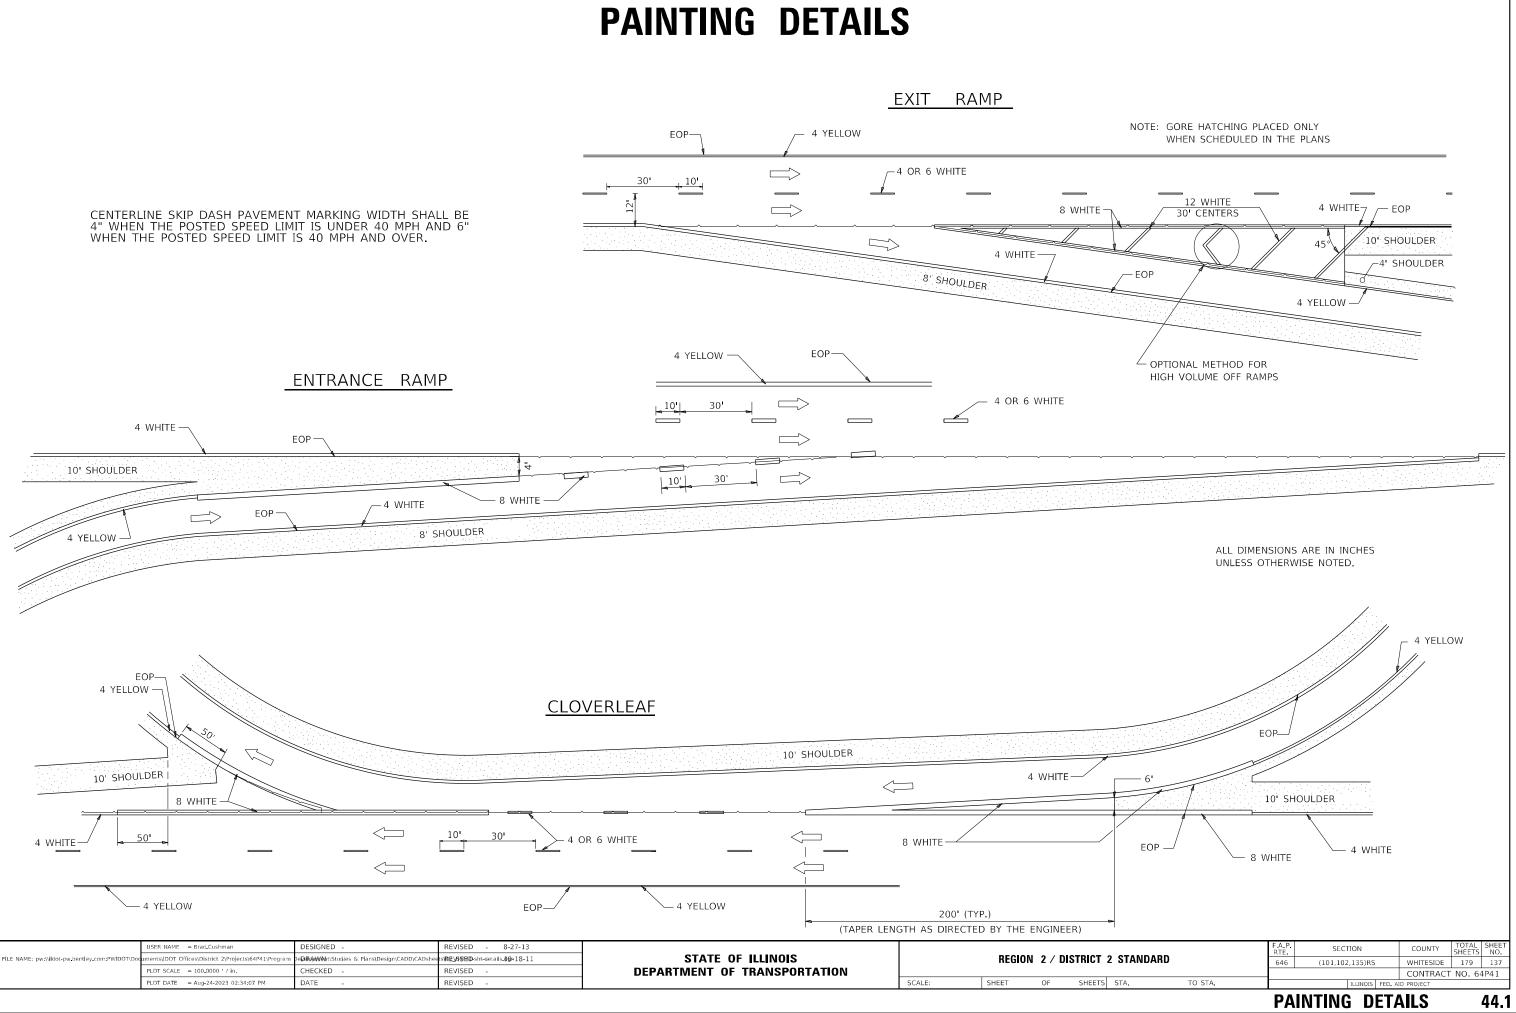


12

tee

2 min.


Hinge point

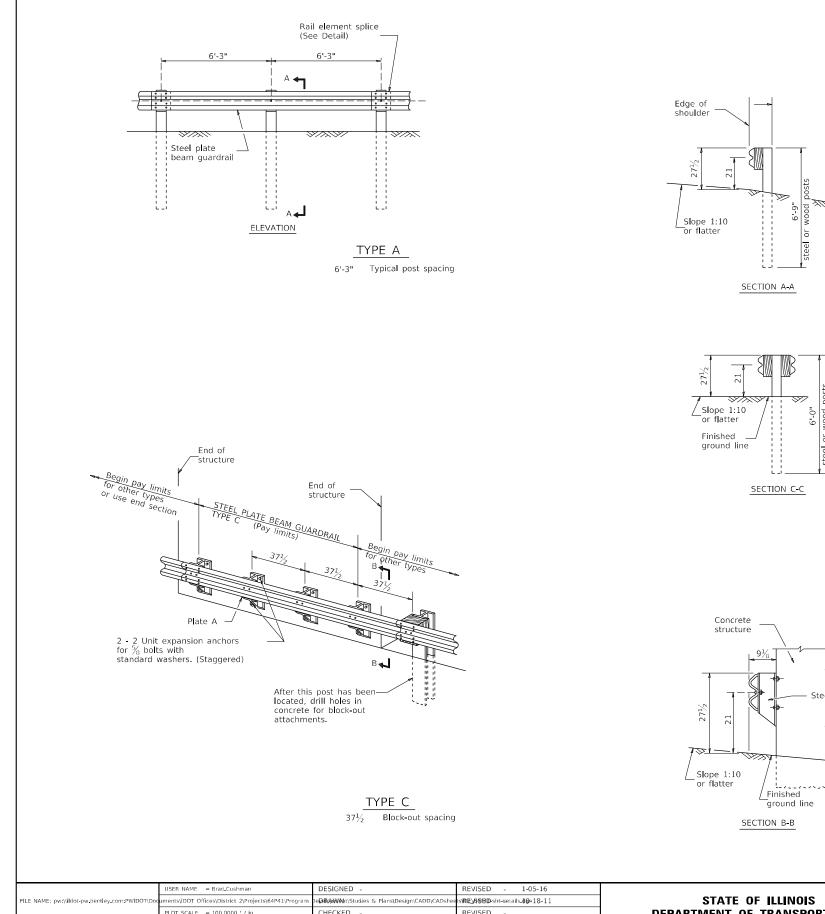Steel block-outs only



	USER NAME = Brad.Cushman	DESIGNED -	REVISED - 1-05-16		ĺ	
m:PWIDOT\Doc	uments\IDOT Offices\District 2\Projects\64P41\Program	De D#RAWWeh t\Studies & Plans\Design\CADD\CADshee	ts \RE_\6\\$18D -sht-details 0 0+18-11	STATE OF ILLINOIS	l I	REGION 2 / DISTRICT 2 STANI
	PLOT SCALE = 100.0000 / in	CHECKED -	REVISED -	DEPARTMENT OF TRANSPORTATION	l I	
	PLOT DATE = Aug-24-2023 02:34:23 PM	DATE -	REVISED -		SCALE:	SHEET 1 OF 4 SHEETS STA.
						FERENT ATELL DIAT




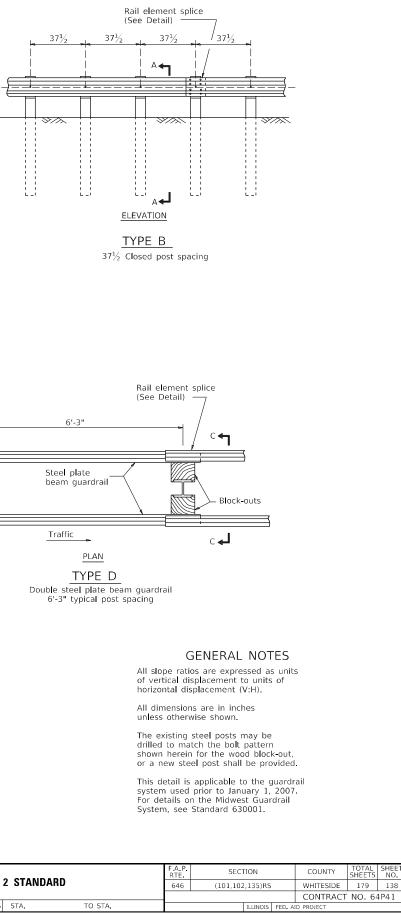



53.1


SHEE NO

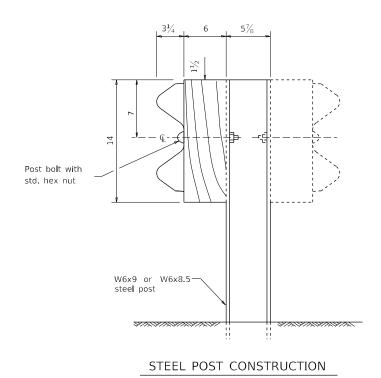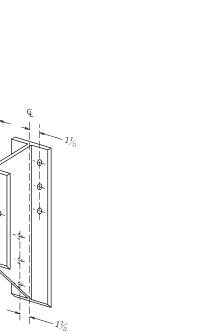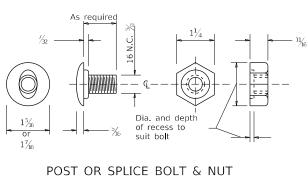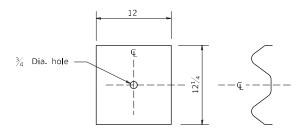SHEETS










NOTE

Plate A shall be placed between rail element and block-out at non-splice mounting points only when steel block-outs are used.

PLATE A

	USER NAME = Brad Cushman	DESIGNED -	REVISED - 1-05-16							F.A.P. RTE	SECTION	COUNTY	TOTAL SHEET SHEETS NO.
FILE NAME: pw:\\ildot-pw.bentley.com:PWIDOT\Doc	uments\IDOT Offices\District 2\Projects\64P41\Program PLOT SCALE = 100.0000 ' / in.	DeDARAWWANT\Studies & Plans\Design\CADD\CADshe CHECKED -	eetswog_vs/s9200-sht-details.of@r+18-11 REVISED -	STATE OF ILLINOIS DEPARTMENT OF TRANSPORTATION		REGION 2/	DISTRICT	2 STANDARD		646	(101,102,135)RS	WHITESIDE	179 139 T NO. 64P41
	PLOT DATE = Aug-24-2023 02:34:38 PM	DATE -	REVISED -		SCALE:	SHEET 2 OF 4	4 SHEETS	STA.	TO STA.		ILLINOIS FED.	AID PROJECT	
				REMOV	E AND	REERECT S	TEEL P	PLATE BI	EAM GU	JARDRAI	L SHEET 2	2 of 4	53.1

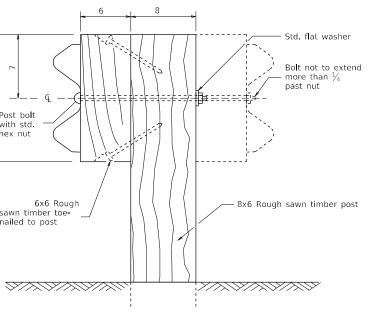STEEL BLOCK-OUT DETAIL



WOOD POST CONSTRUCTION

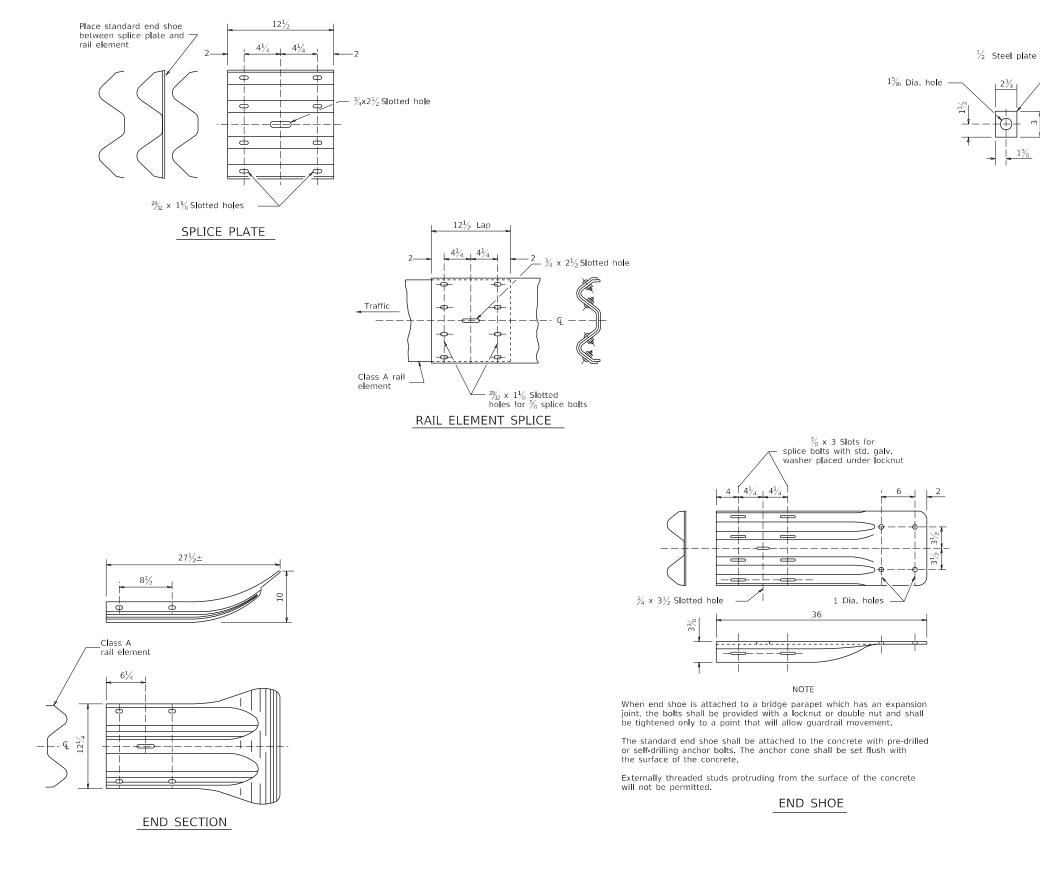
 \sim

Post bolt with std. hex nut


6x6 Rough

sawn timber toe-nailed to post

4




[USER NAME = Brad Cushman	DESIGNED -	REVISED - 1-05-16				
	FILE NAME: pw:\\ildot-pw.bentley.com:PWIDOT\Doc	uments\IDOT Offices\District 2\Projects\64P41\Program	De D#RAWVeh t\Studies & Plans\Design\CADD\CADshee	ts%RE_V#\$FBD-sht-details.100÷18-11	STATE OF ILLINOIS		REGION 2 / DISTRI	CT 2
		PLOT SCALE = 100.0000 / in.	CHECKED -	REVISED -	DEPARTMENT OF TRANSPORTATION			
		PLOT DATE = Aug-24-2023 02:34:56 PM	DATE -	REVISED -		SCALE:	SHEET 3 OF 4 SHE	EETS

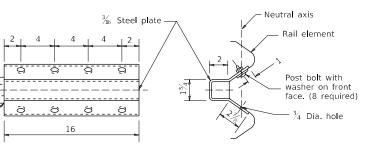

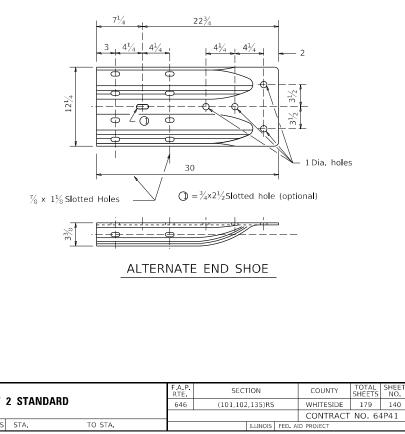
NOTE Anchor plate T shall be used to attach cable assembly to guardrail when required on traffic barrier terminals






53.1

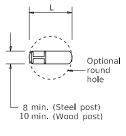REMOVE AND REERECT STEEL PLATE BEAM GUARDRAIL SHEET 3 of 4




PLAN

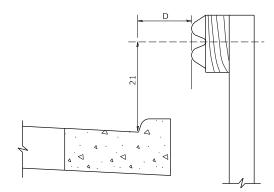

Note: If it is necessary for D to be more than12 and less than 10°-0" type M-2 curb and gutter (Std. 606001) shall be used in front of and in advance of the guardrail.

GUARDRAIL PLACED BEHIND CURB

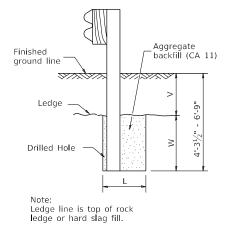(D = O desirable to 12 maximum)




ELEVATION

FOOTING FOR POST WHEN IMPERVIOUS MATERIAL IS ENCOUNTERED

V	w	L					
v v		Steel Post	Wood Post				
0 - 18	24	21	23				
>18 - 41.5	12	8	10				
>41.5 - 53.5	12 - 0	8	10				

1" double nuts or locknuts and washer


	USER NAME = Brad Cushman	DESIGNED -	REVISED - 1-05-16			
FILE NAME: pw:\\ildot-pw.bentley.com:PWIDOT\Do	uments\IDOT Offices\District 2\Projects\64P41\Program	De D#RAWWAN t\Studies & Plans\Design\CADD\CADshee	tswRE_VA&BBD-sht-details.alga+18-11	STATE OF ILLINOIS		REGION 2 / DISTRICT 2 S
	PLOT SCALE = 100.0000 / in.	CHECKED -	REVISED -	DEPARTMENT OF TRANSPORTATION		
	PLOT DATE = Aug-24-2023 02:35:16 PM	DATE -	REVISED -]	SCALE:	SHEET 4 OF 4 SHEETS STA

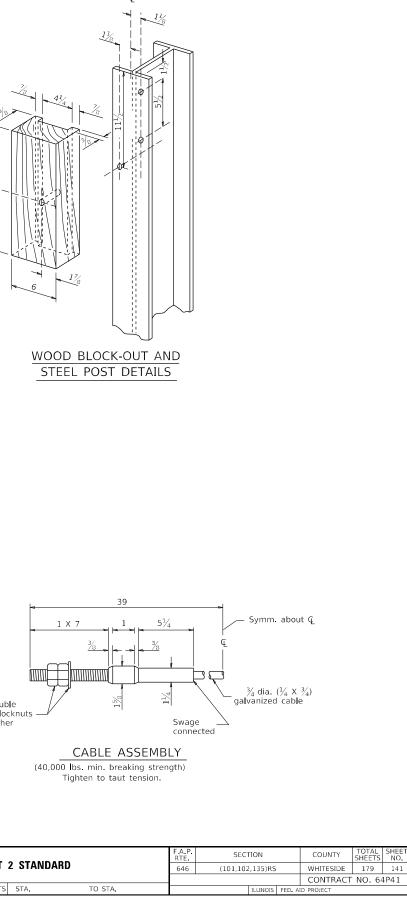

REMOVE AND REERECT STEEL PLATE BEAM GUARDRAIL SHEET 4 of 4

53.1

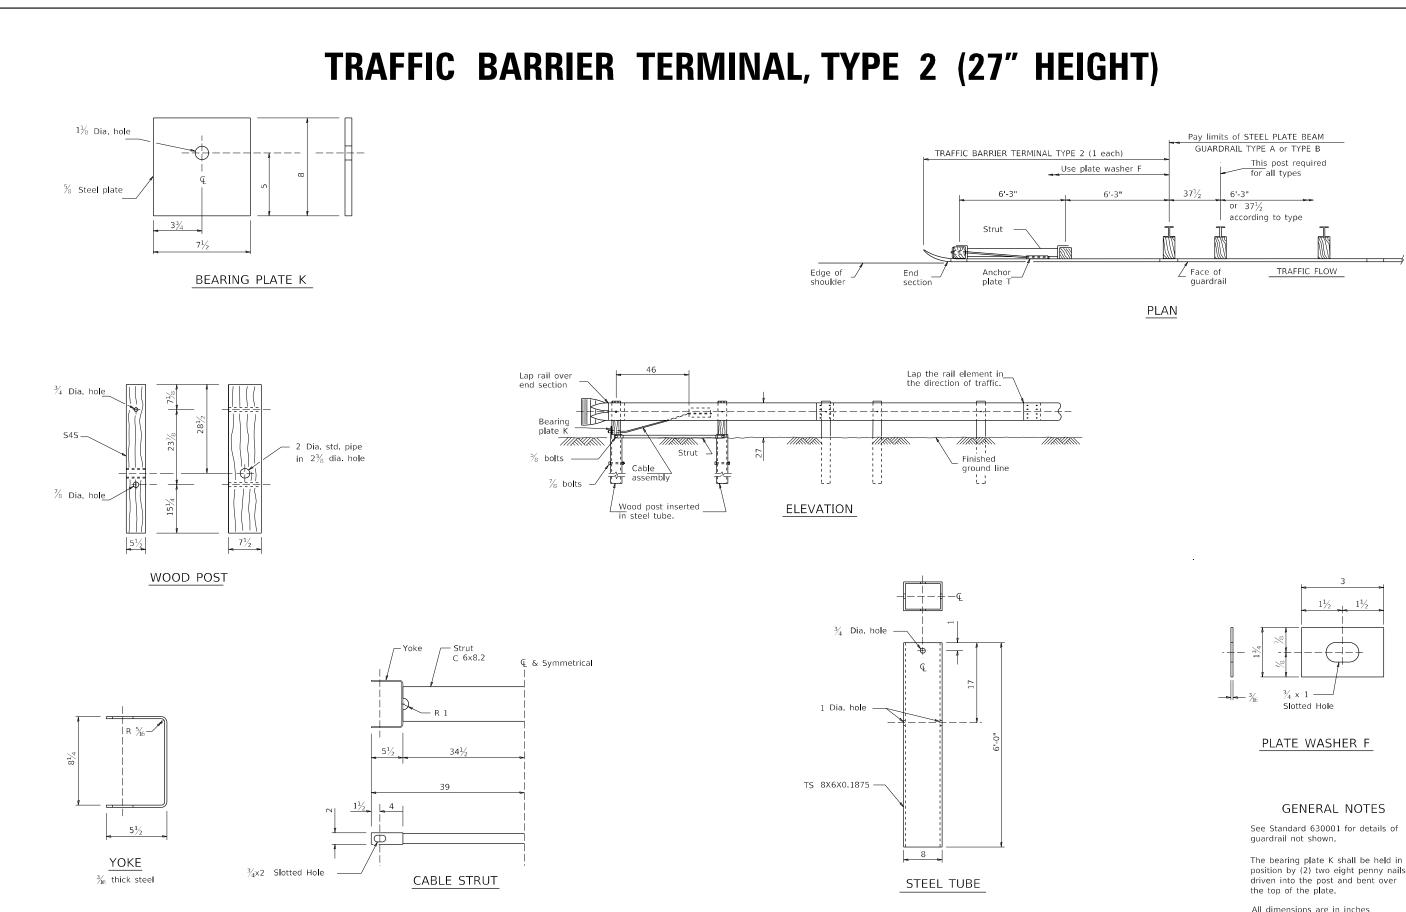
NO.



	USER NAME = Brad.Cushman	DESIGNED -	REVISED - 10-18-11								F A P RTE	SECTION	COUNTY	TOTAL SHEET SHEETS NO.
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	PLOT DATE = Aug-24-2023 02:35:30 PM	DATE -	REVISED -		SCALE:	SHEET	OF	SHEETS	STA.	TO STA.		ILLINOIS FED.	AID PROJECT	
							TR/	AFFIC	BARRIER	TERMINA	L, TYF	PE 2 (27"	HEIGHT) 54.1

position by (2) two eight penny nails

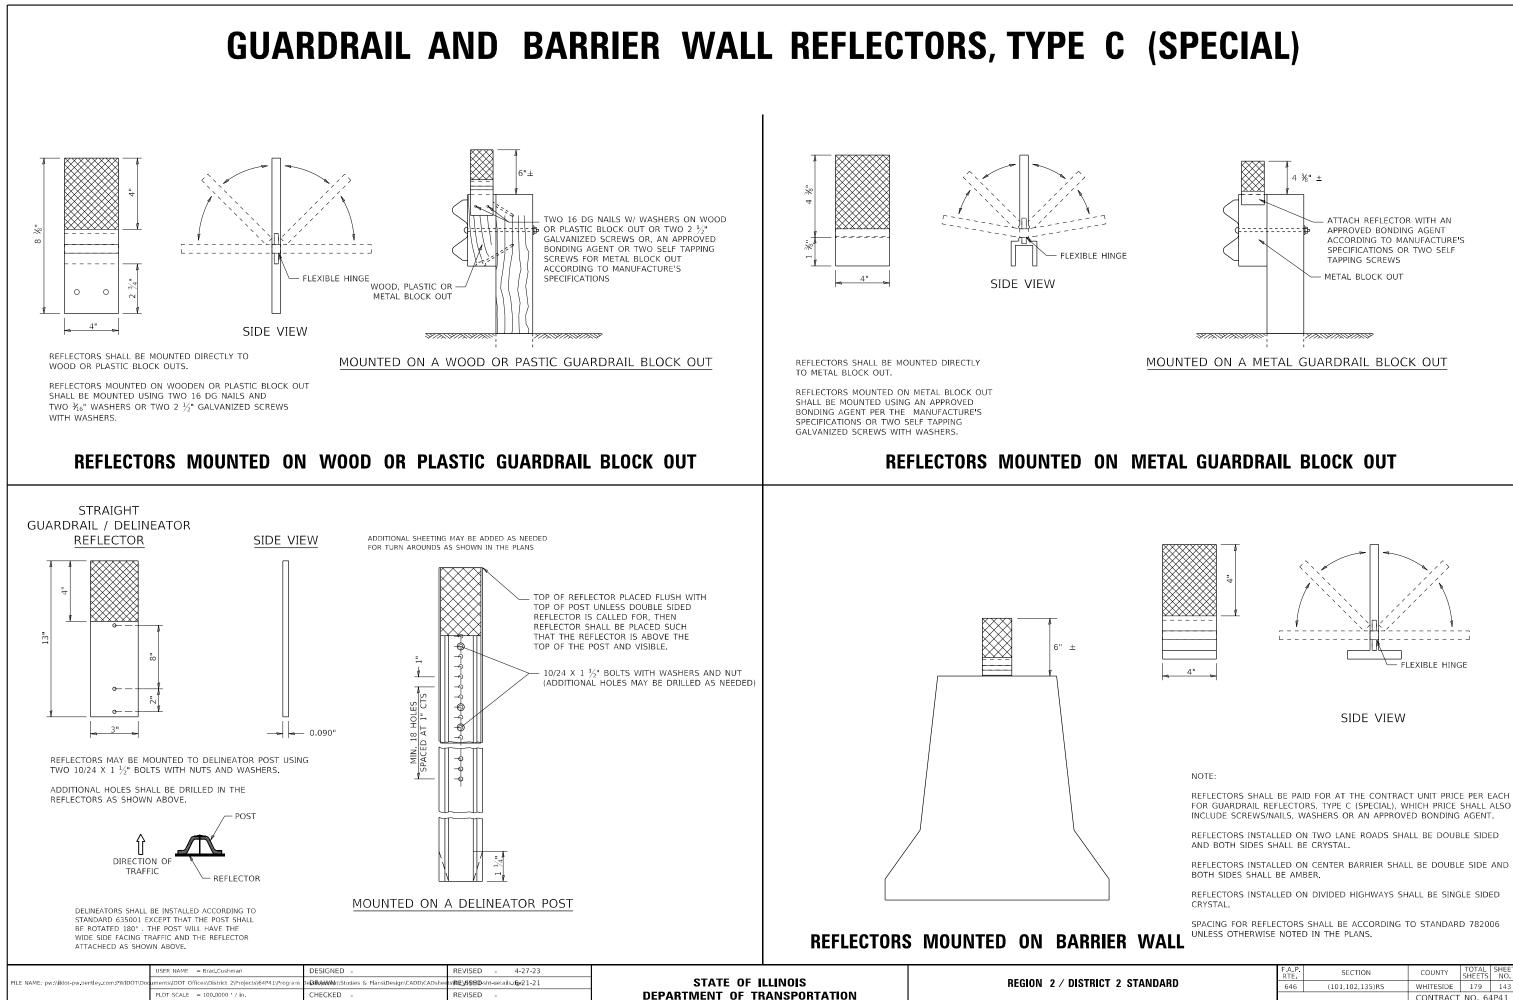All dimensions are in inches unless otherwise shown.



PLOT DATE = Aug-24-2023 02:35:44 PM

DATE


REVISED


SHEET


SCALE


OF SHEET GUARDRAIL AND BARRIER WALL REFLECTORS, TYPE C (SPECIAL)


2	IER	WALL REFLECT	ORS	, TYPE	C	(SP	PECIAL)		55.1
S	STA.	TO STA.			ILLINOIS	FED. A	ID PROJECT		
			_				CONTRACT	NO. 64	4P41
-	2 STANDARD			(101,102	2,135)RS		WHITESIDE	179	143
			F.A.P. RTE	SEC	TION		COUNTY	TOTAL SHEETS	SHEET NO.

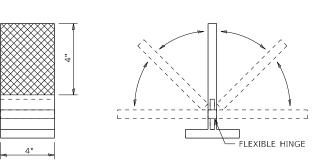


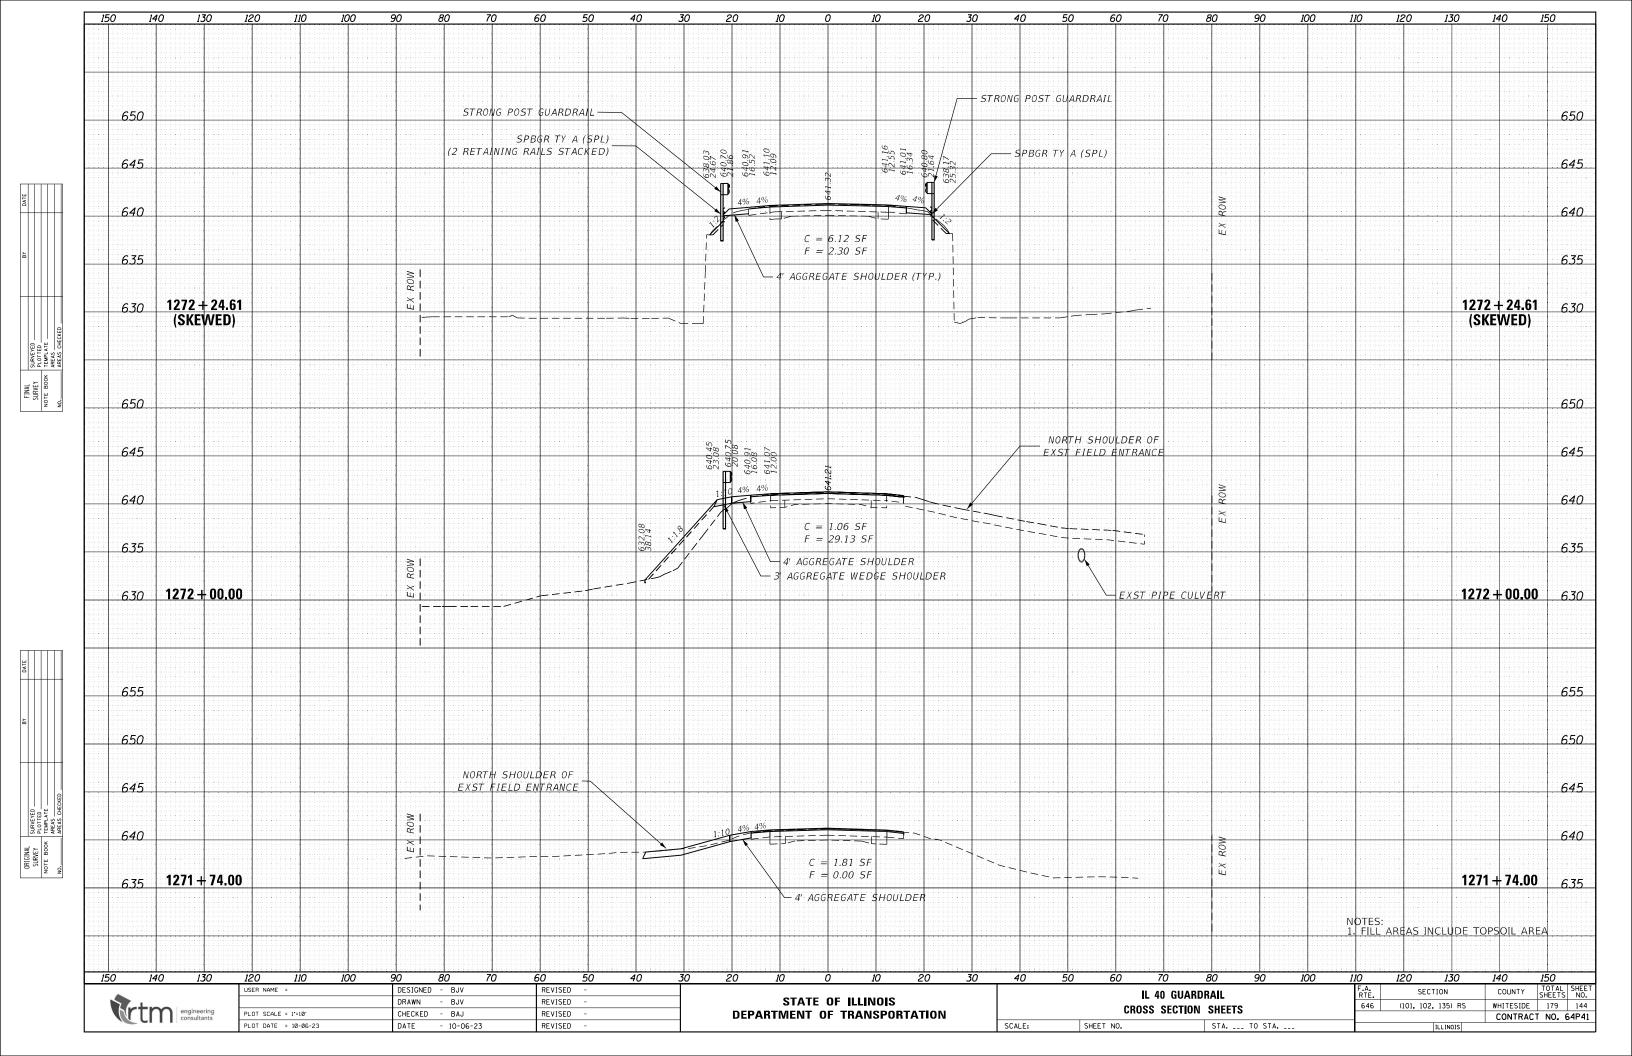


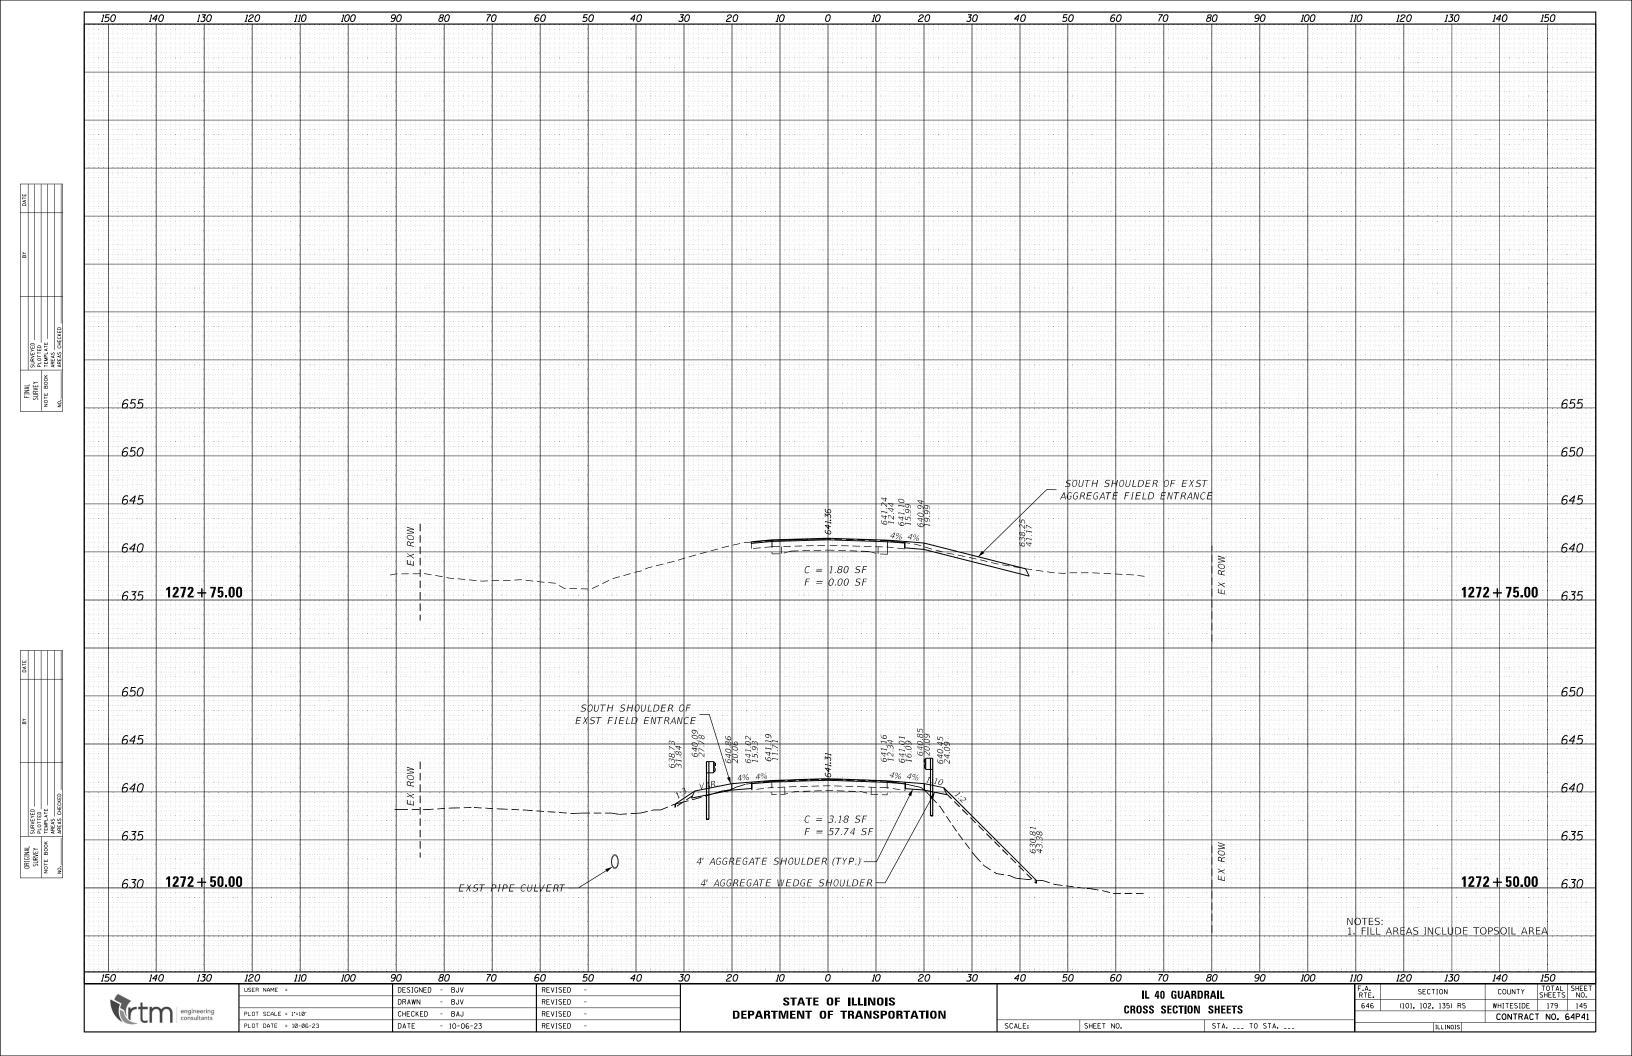

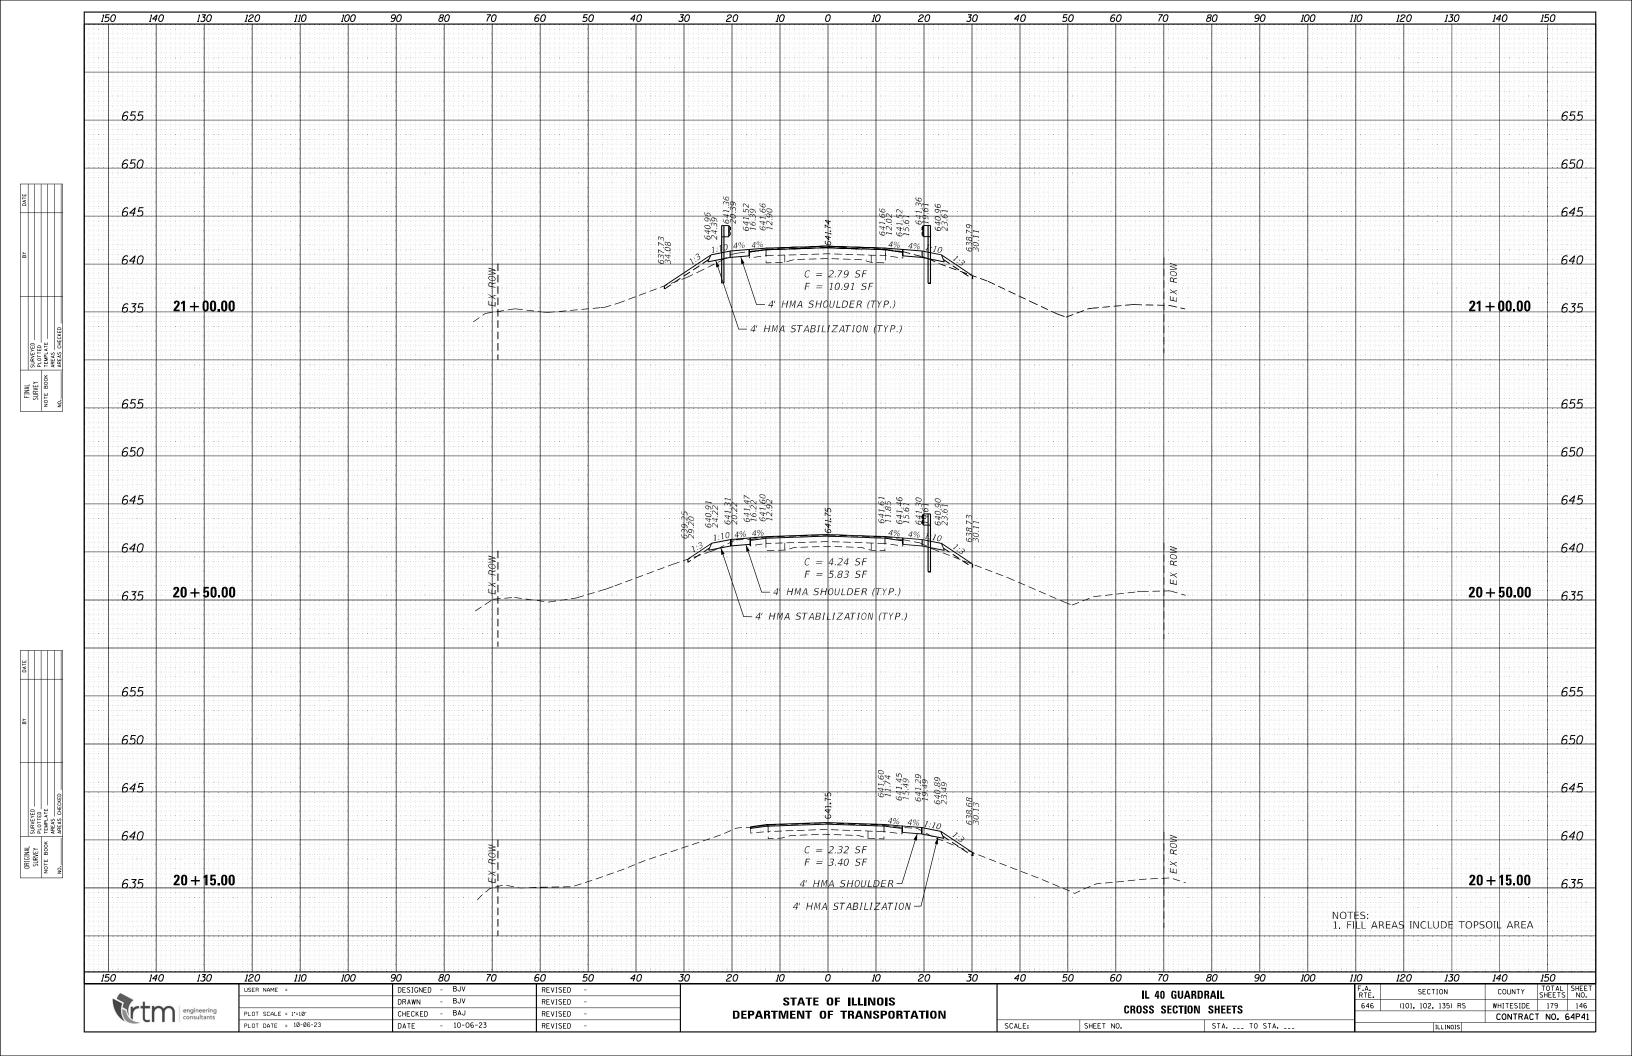


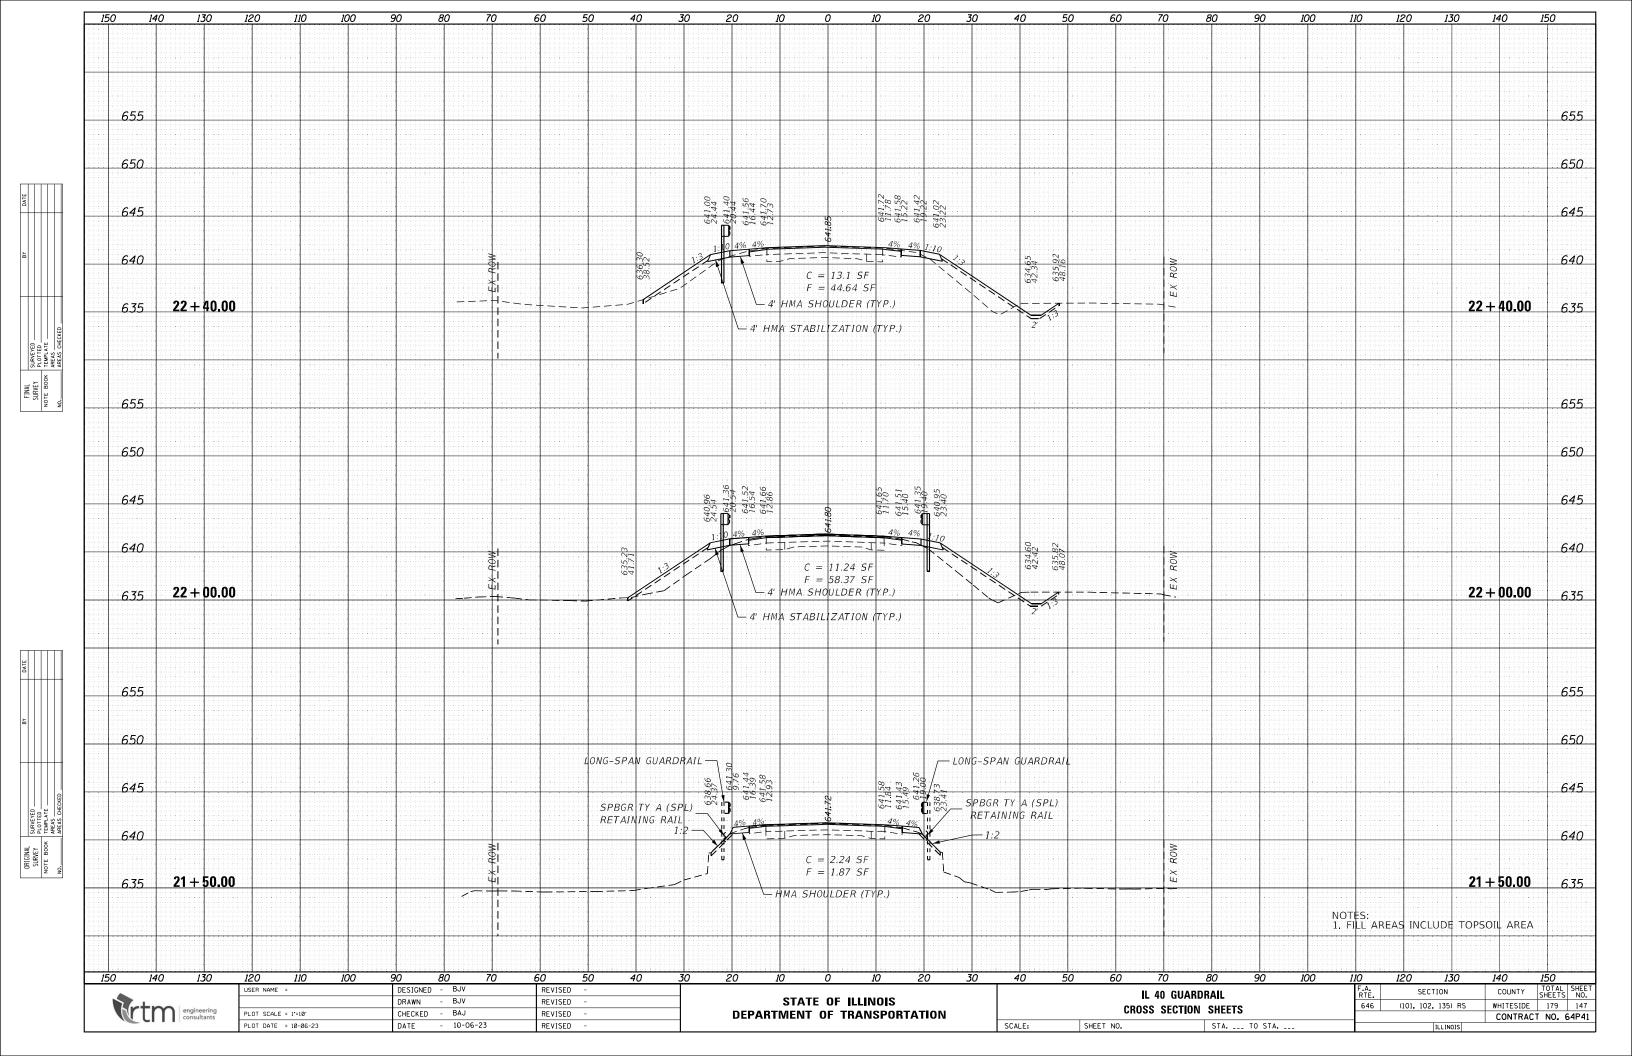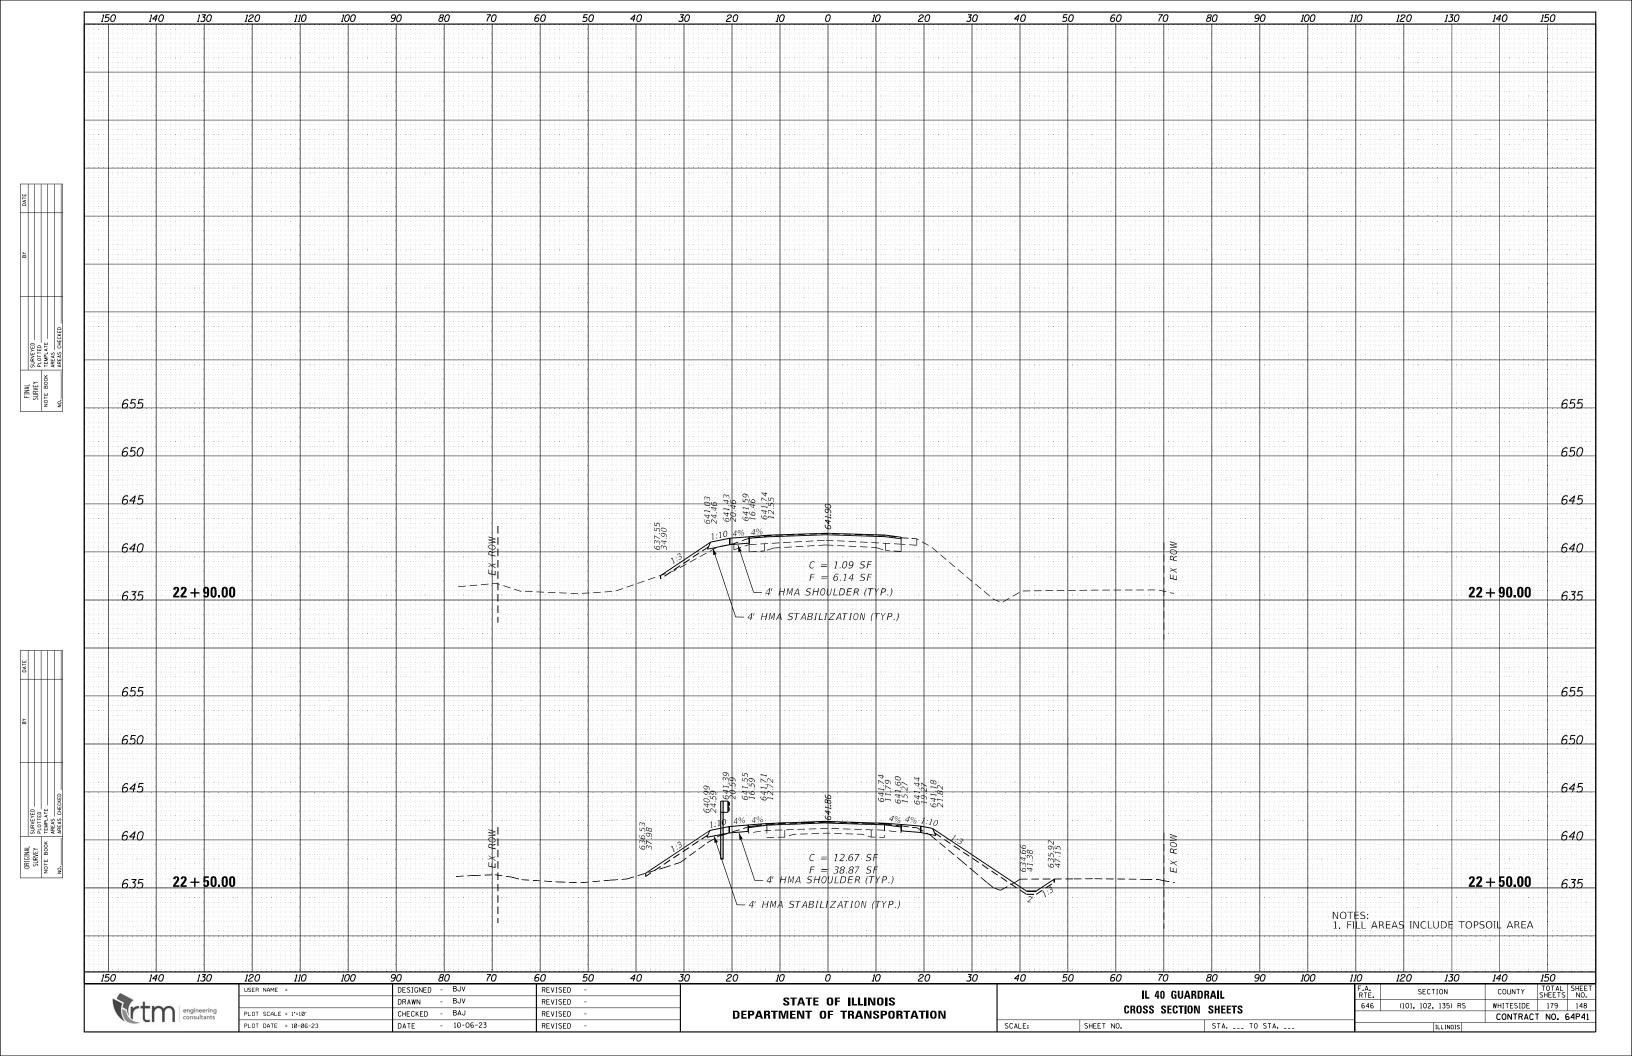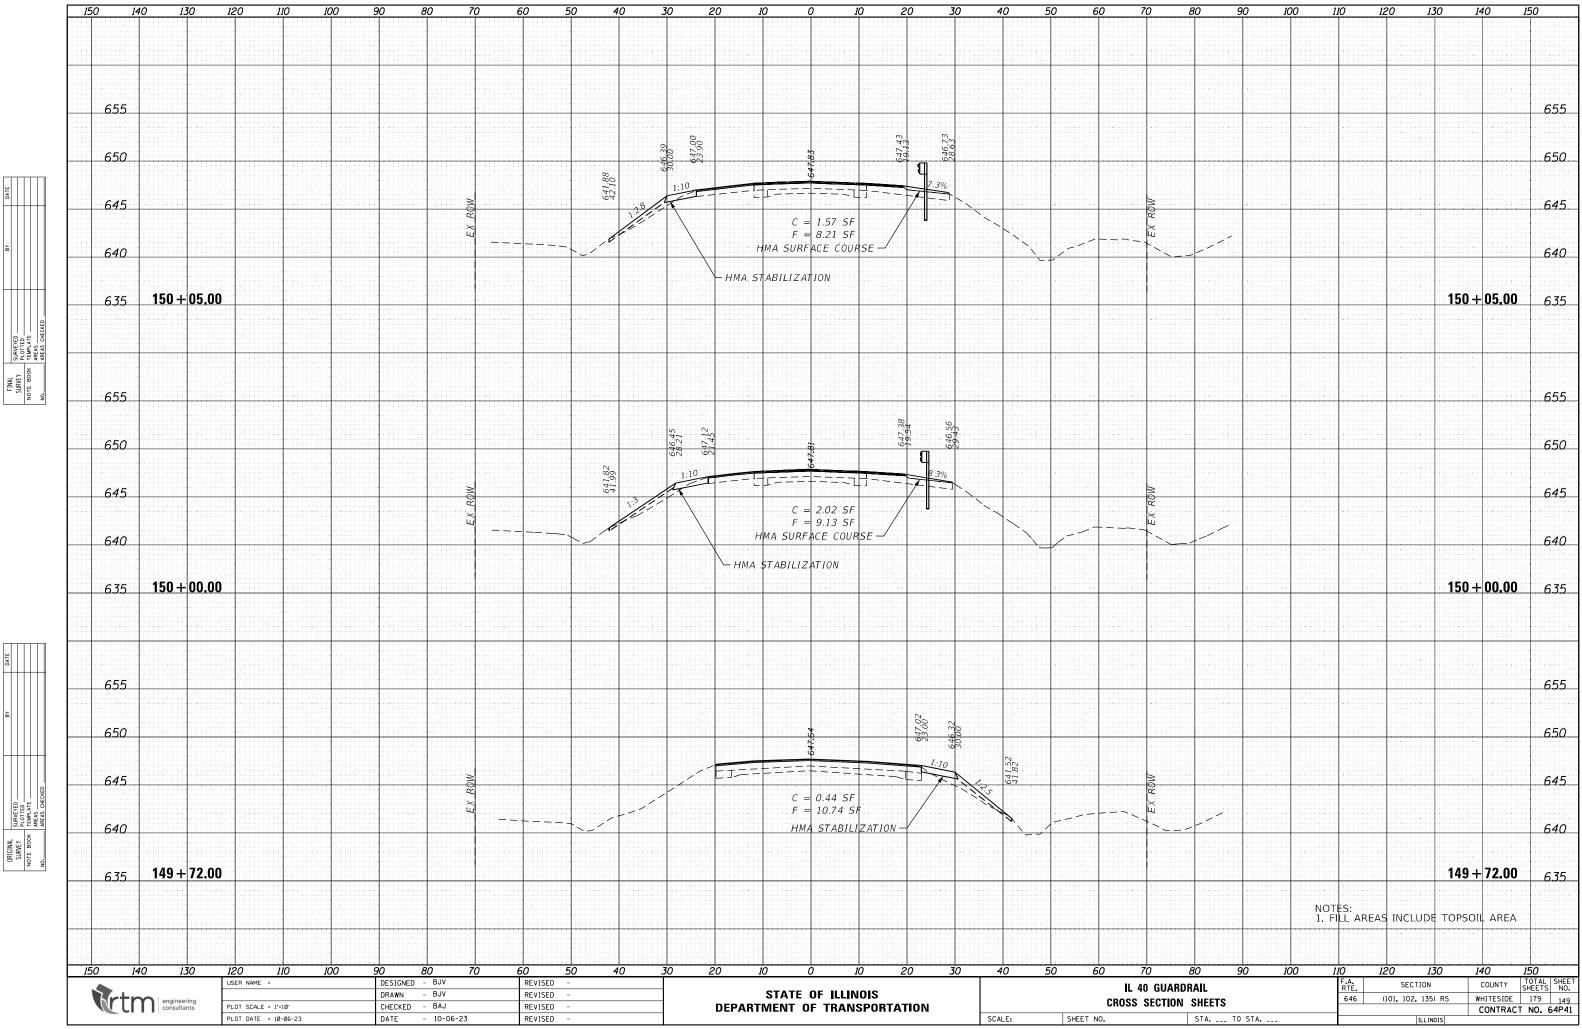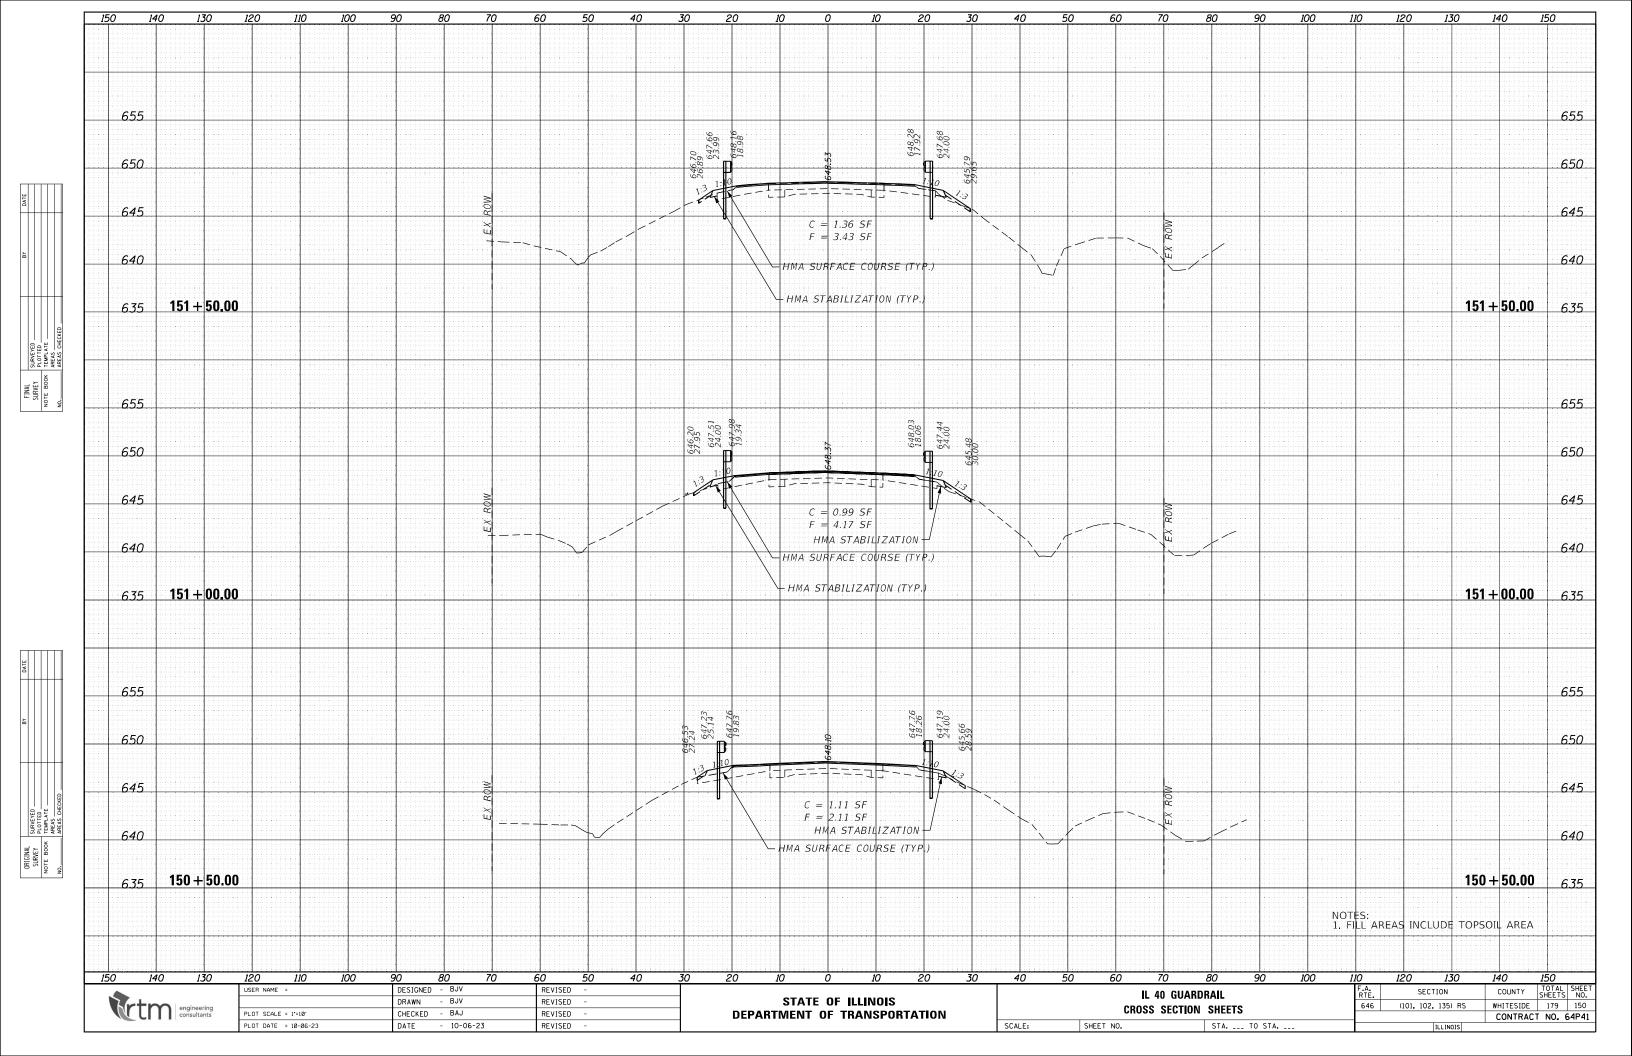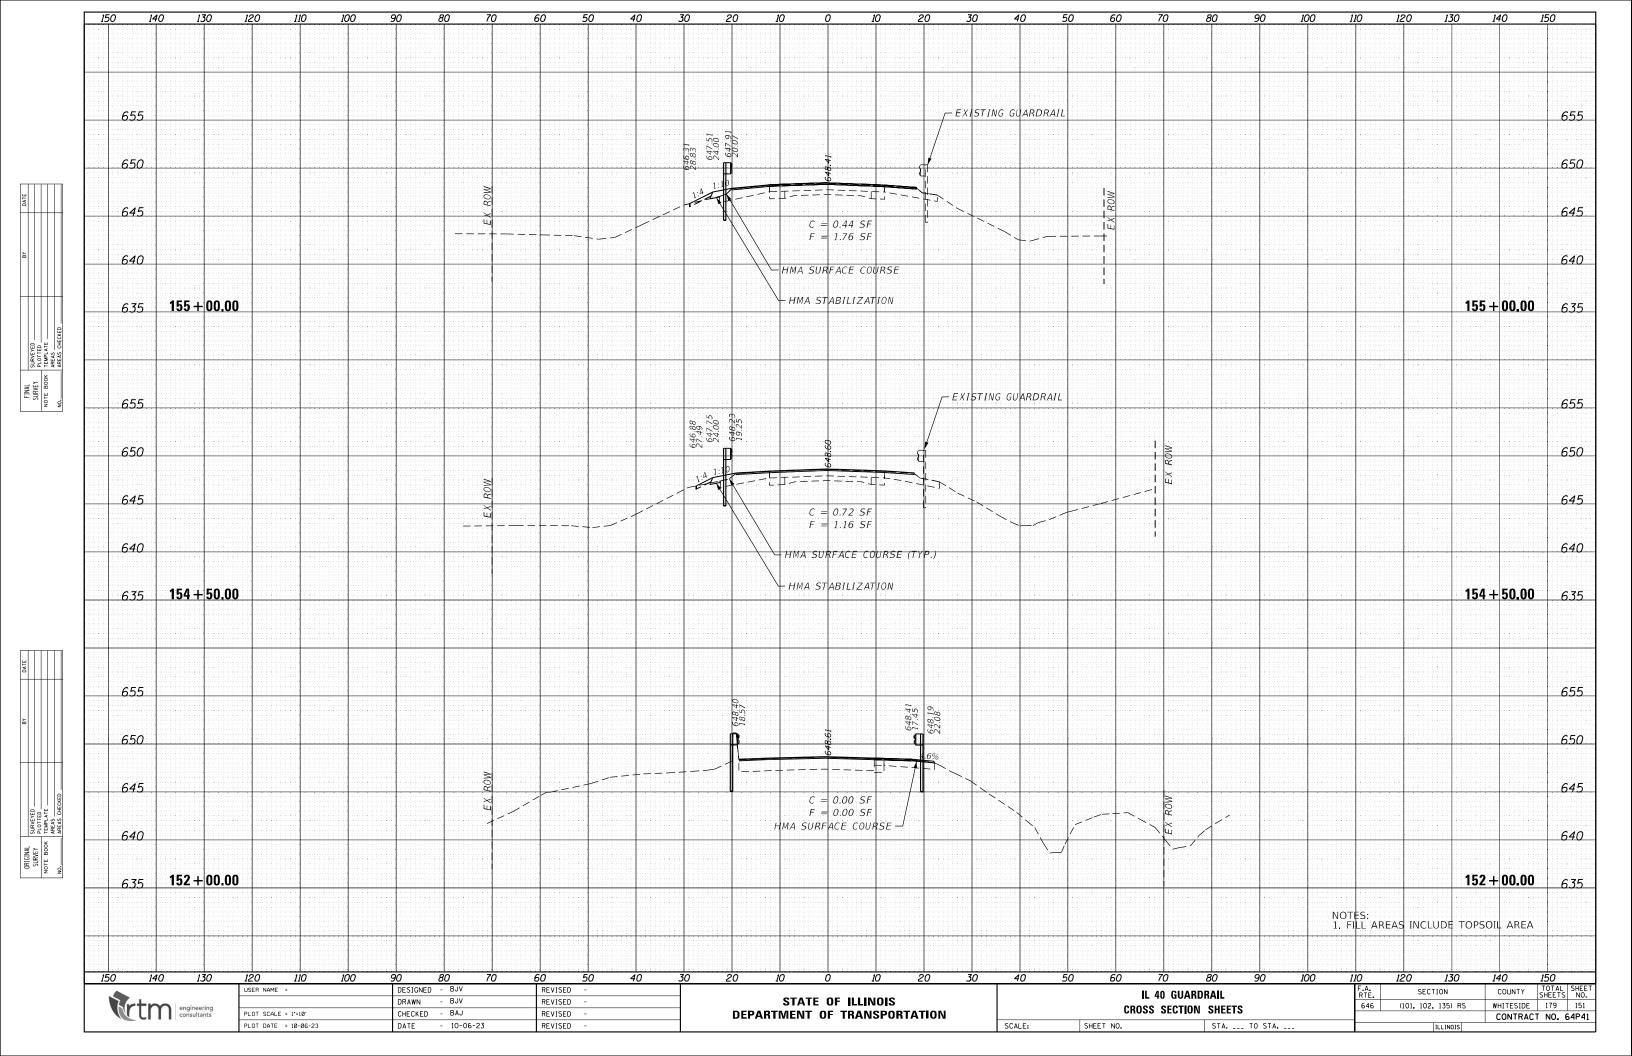




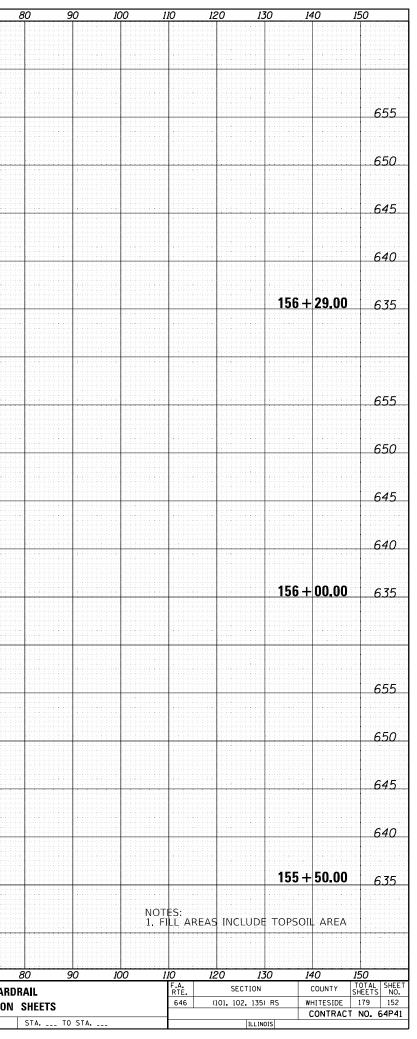


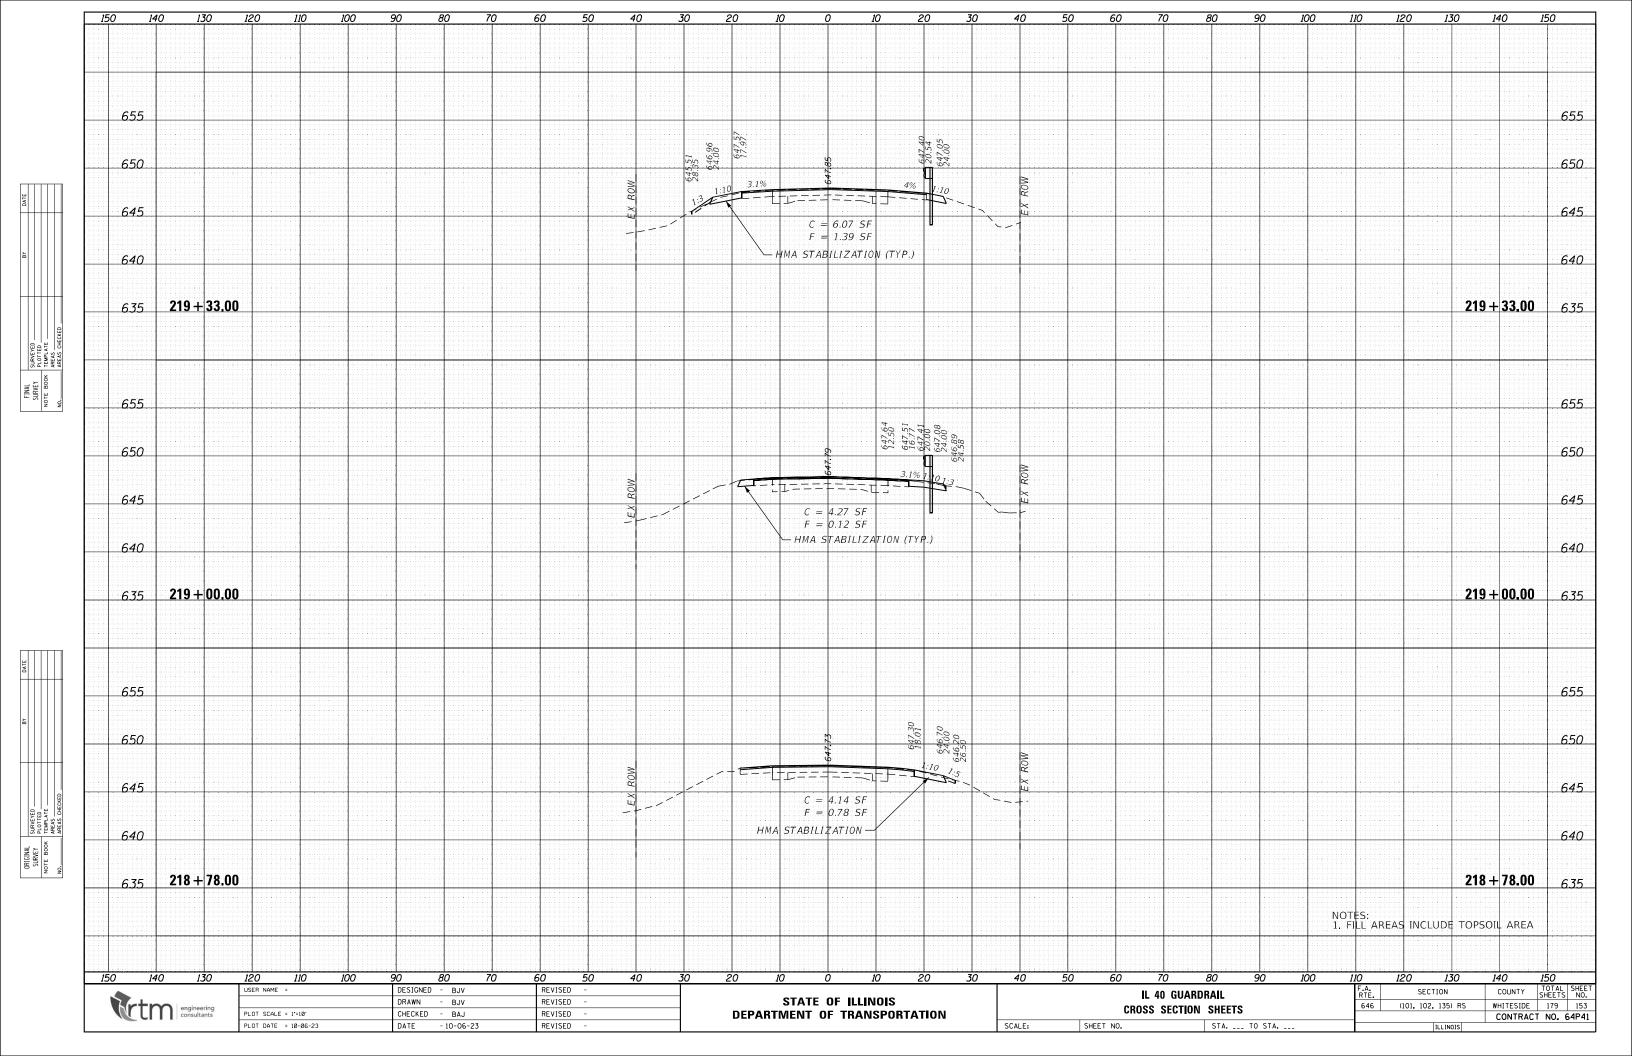
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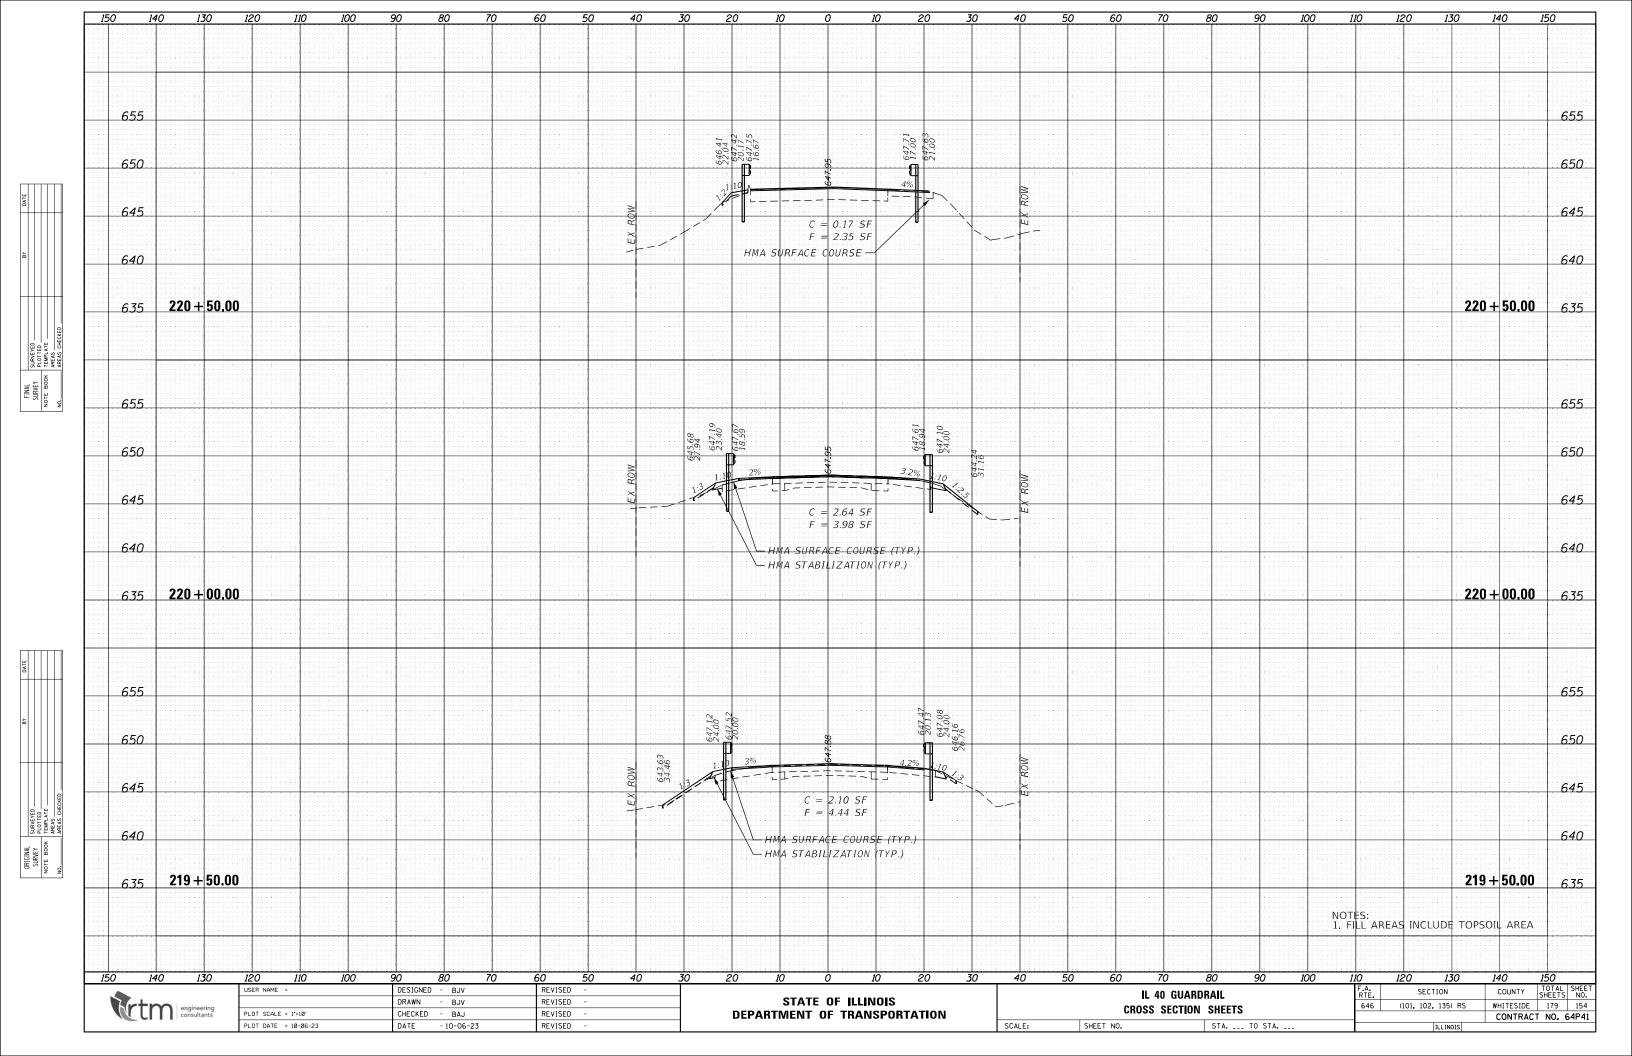


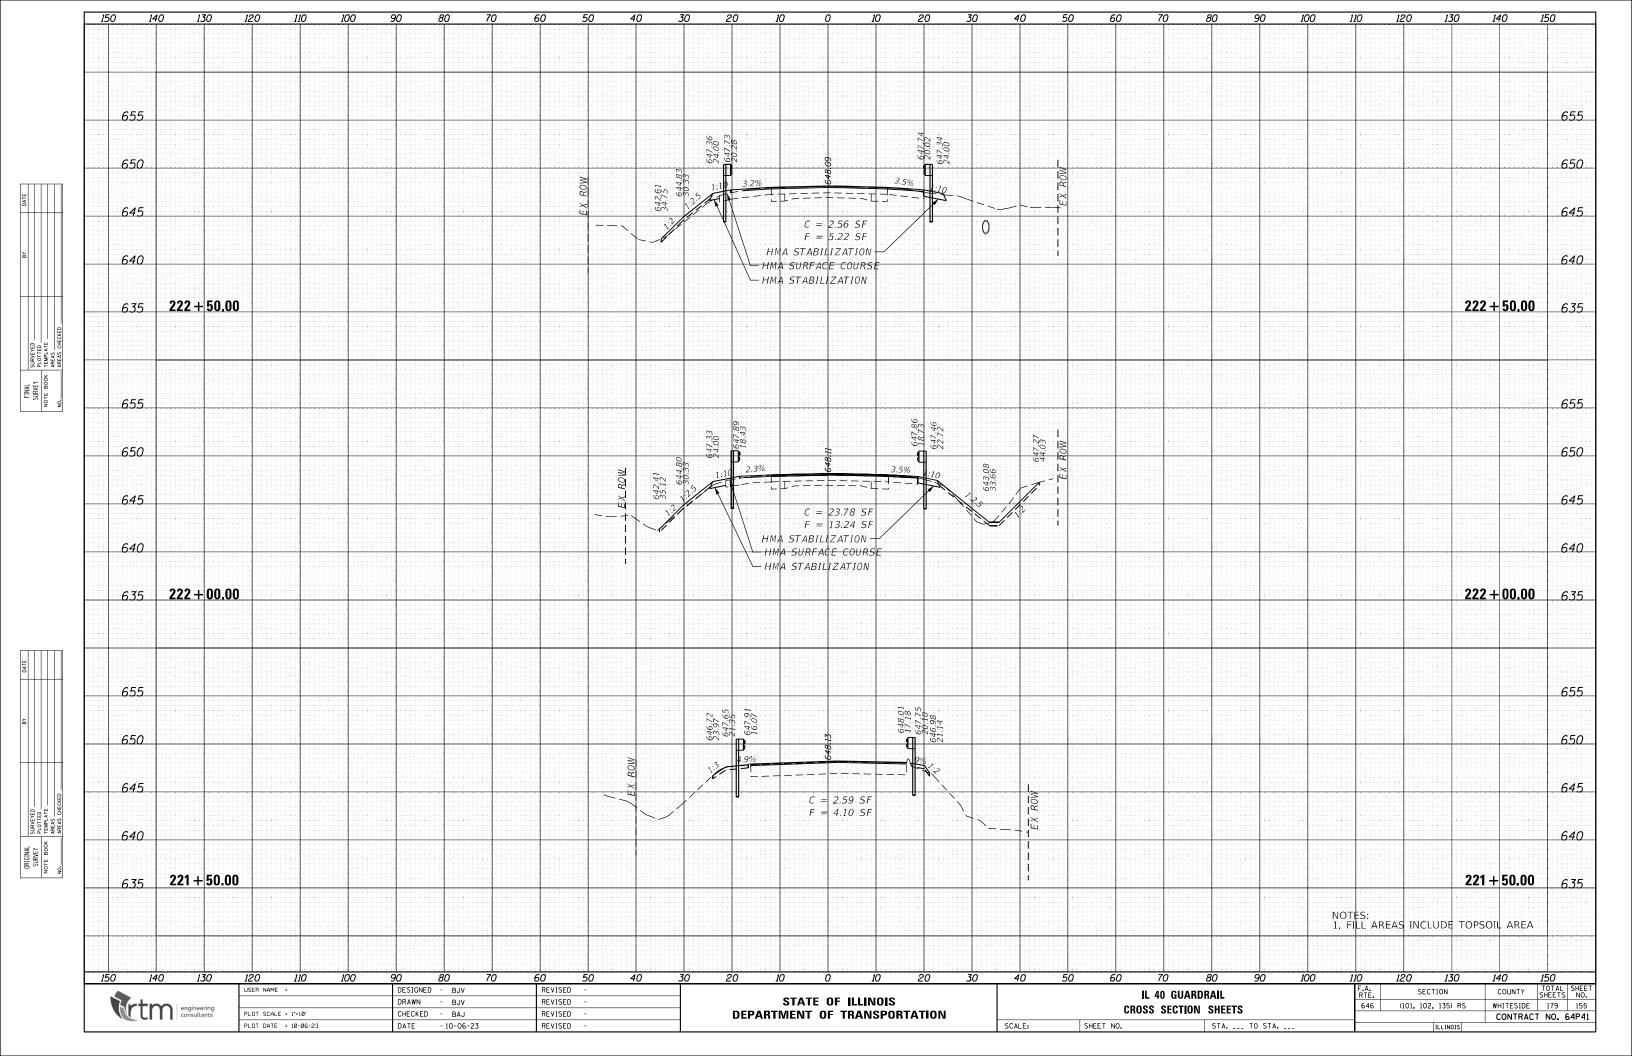


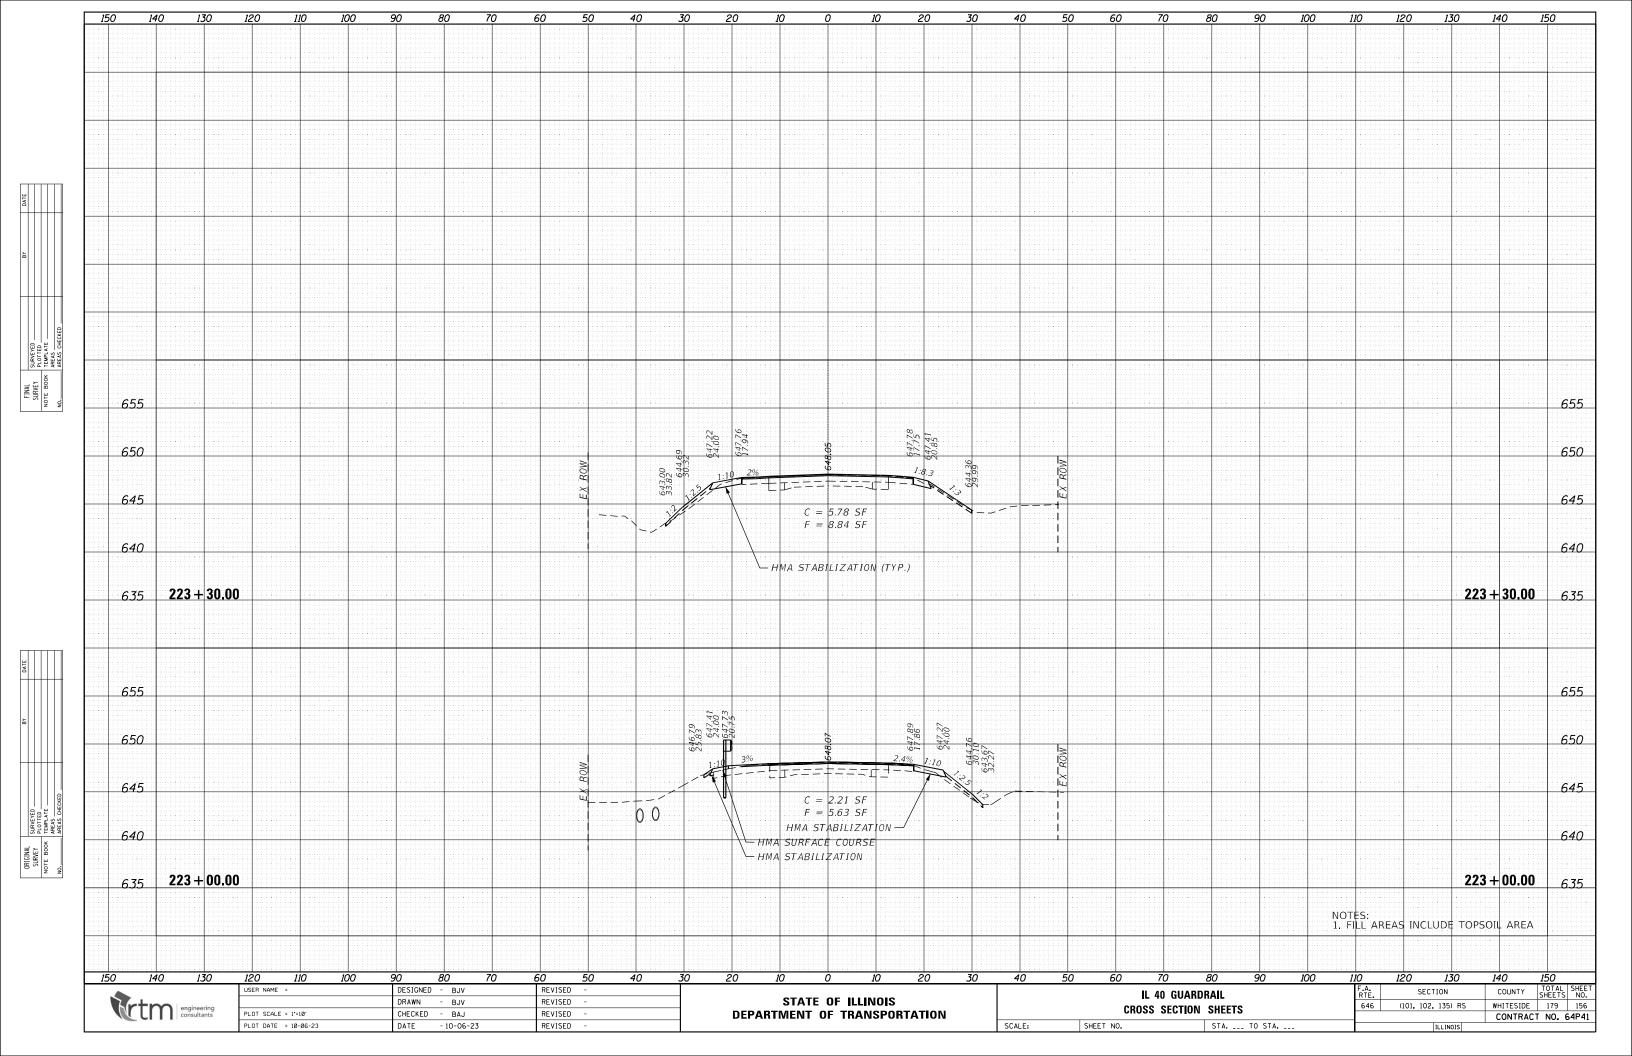
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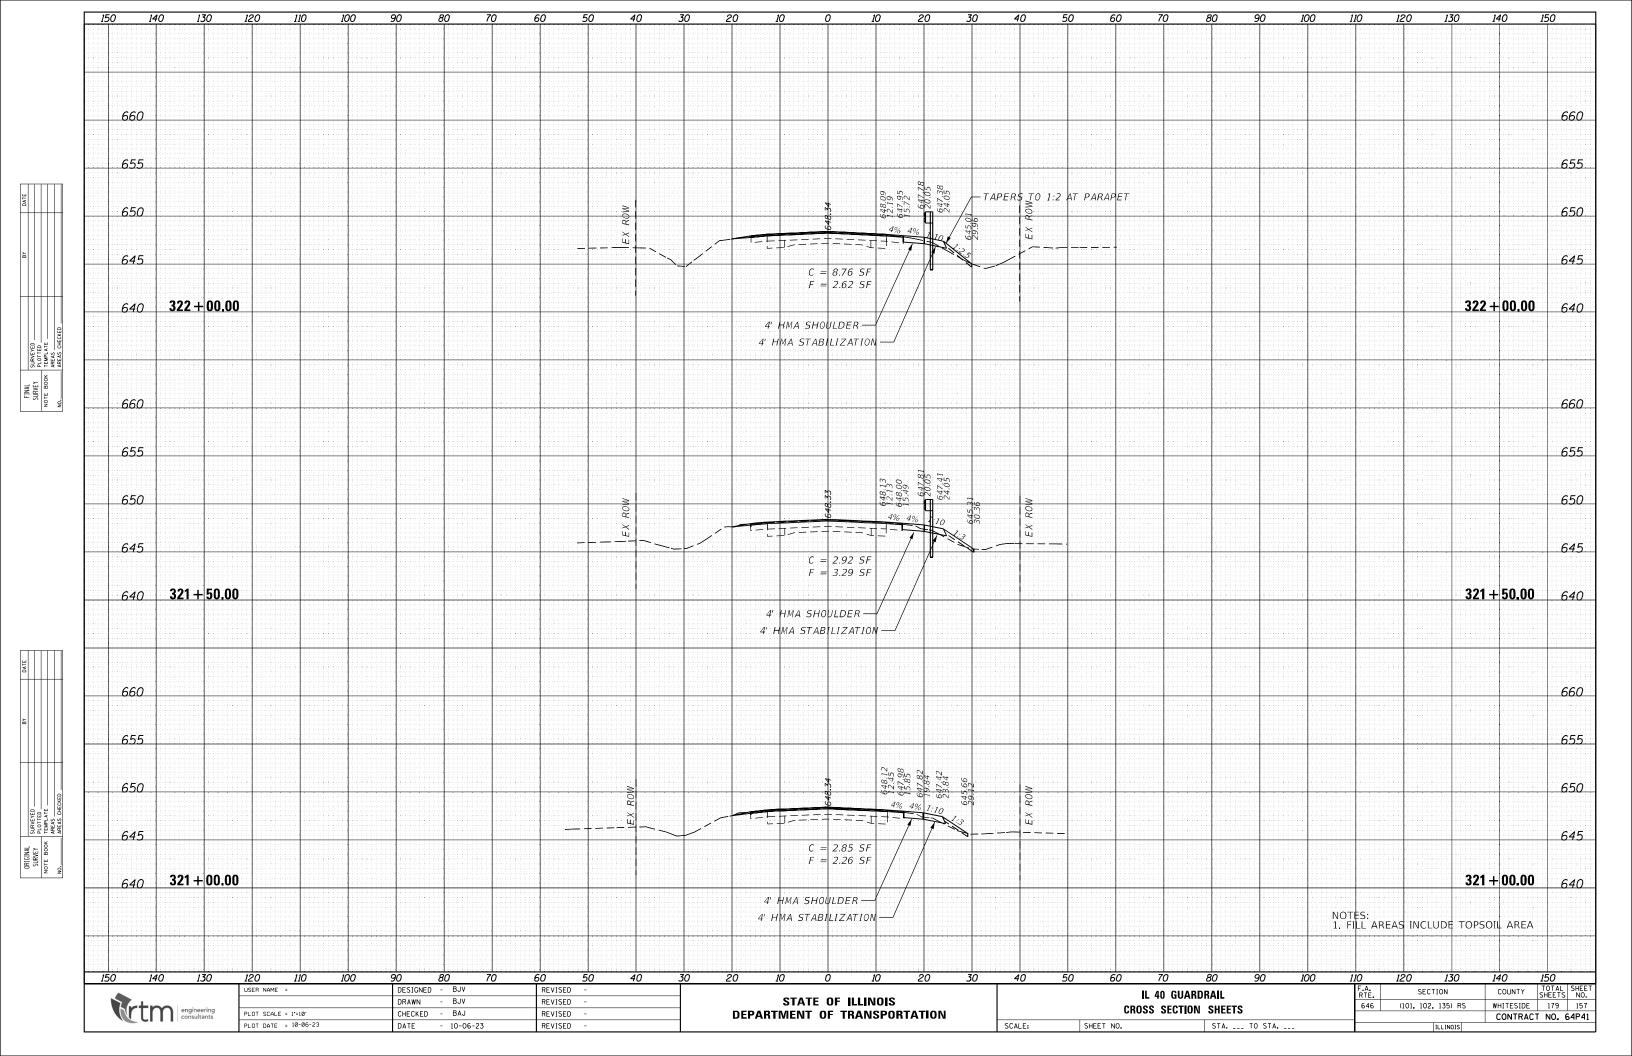


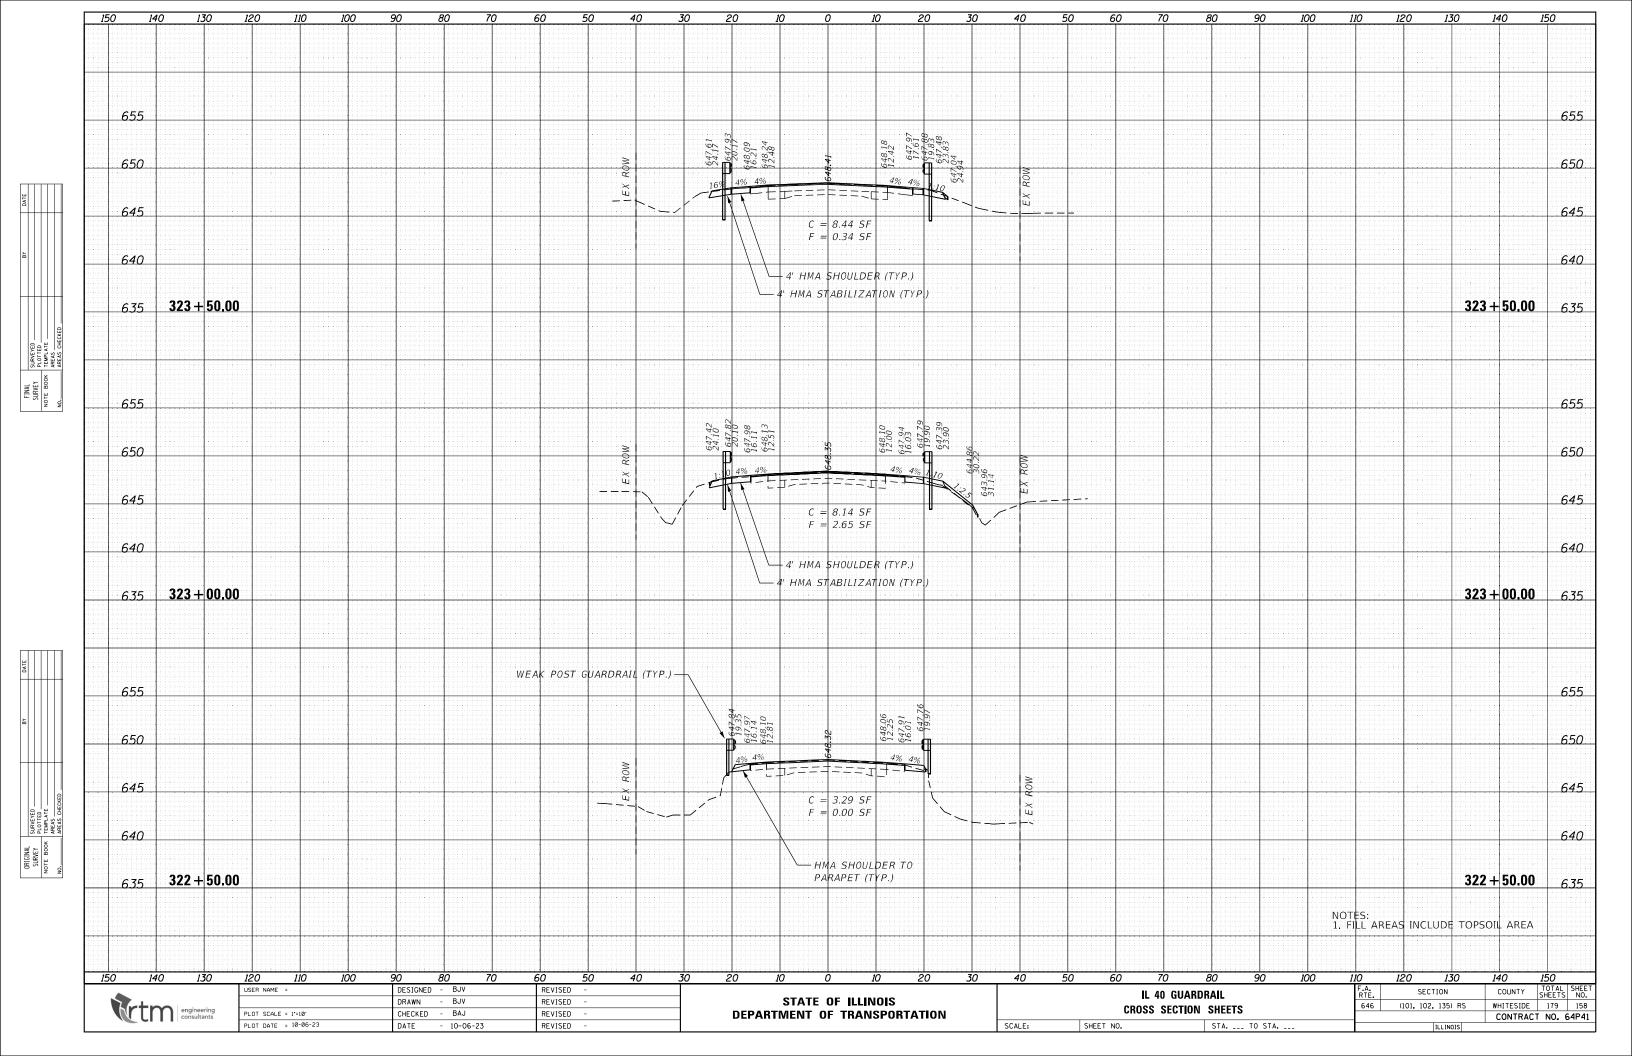






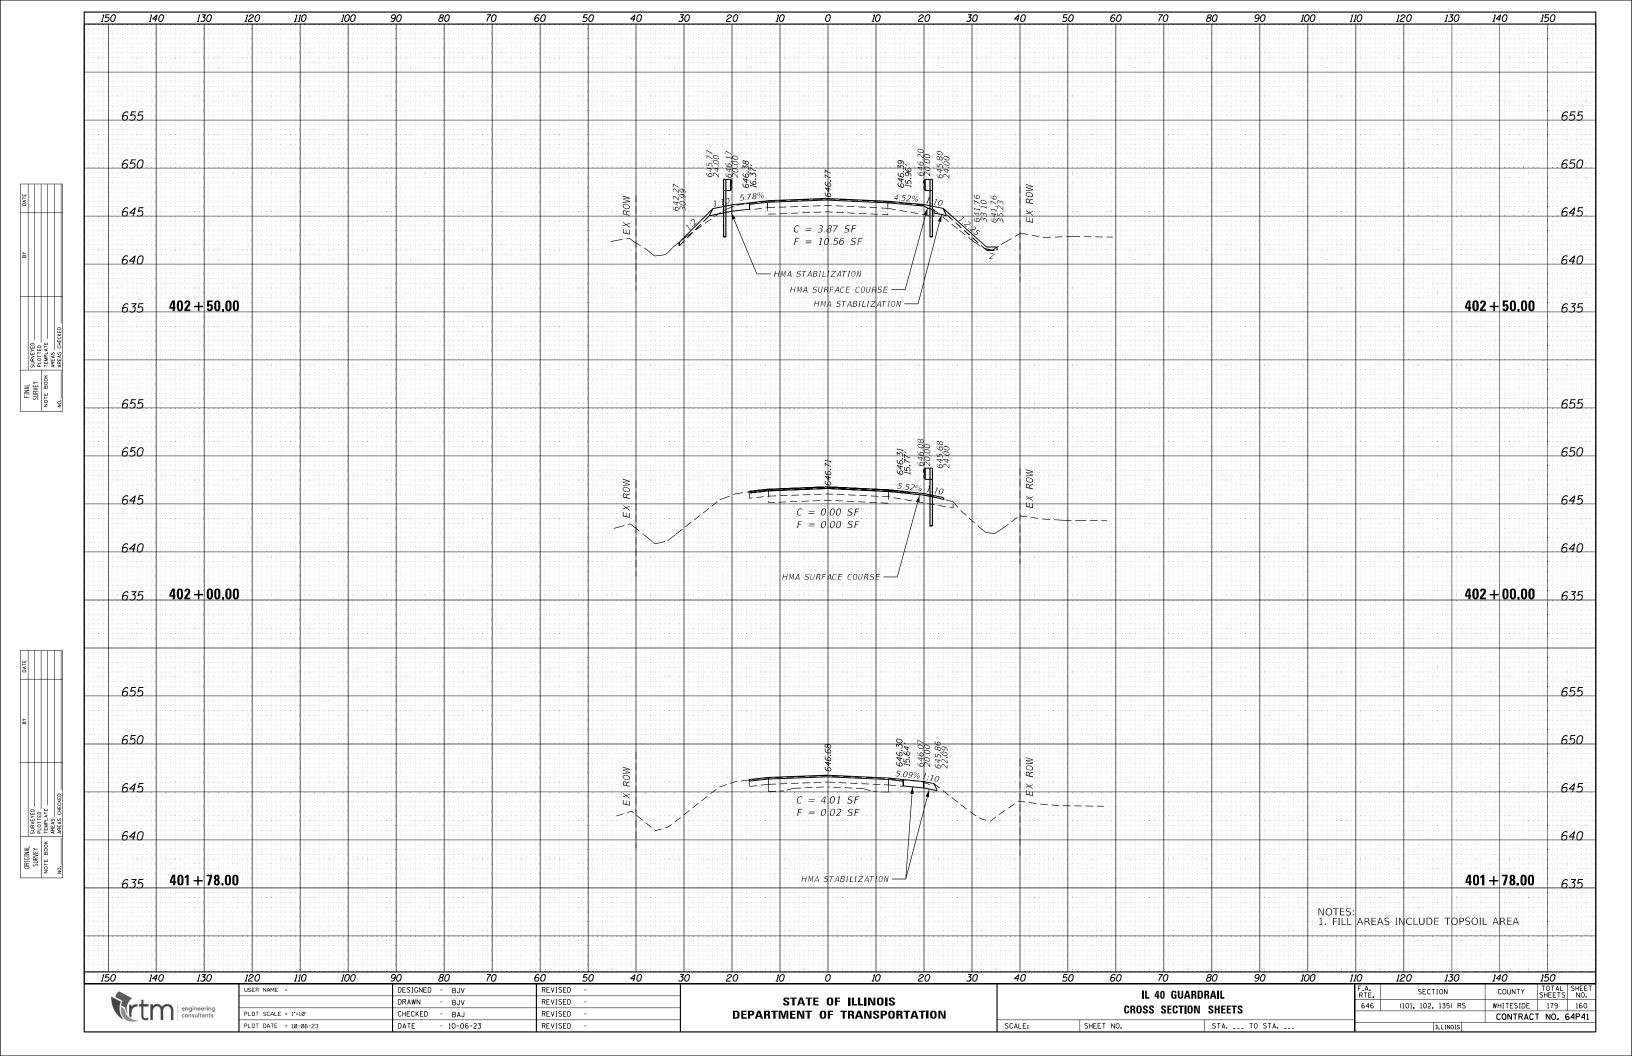


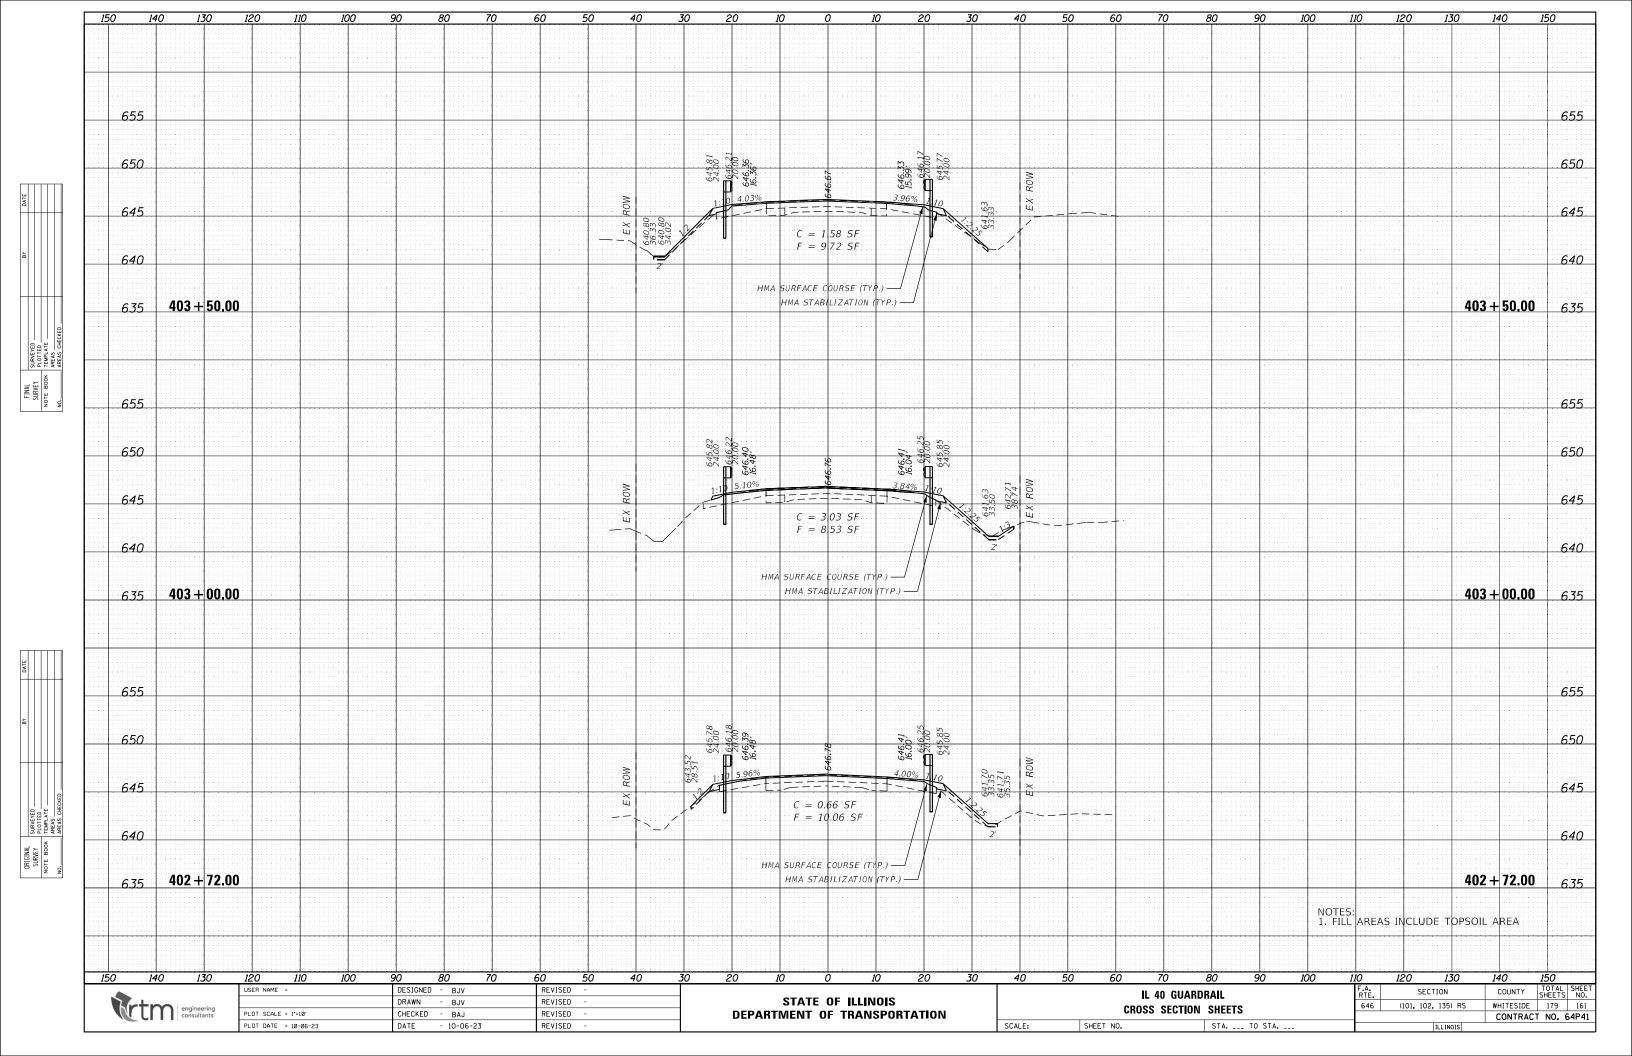


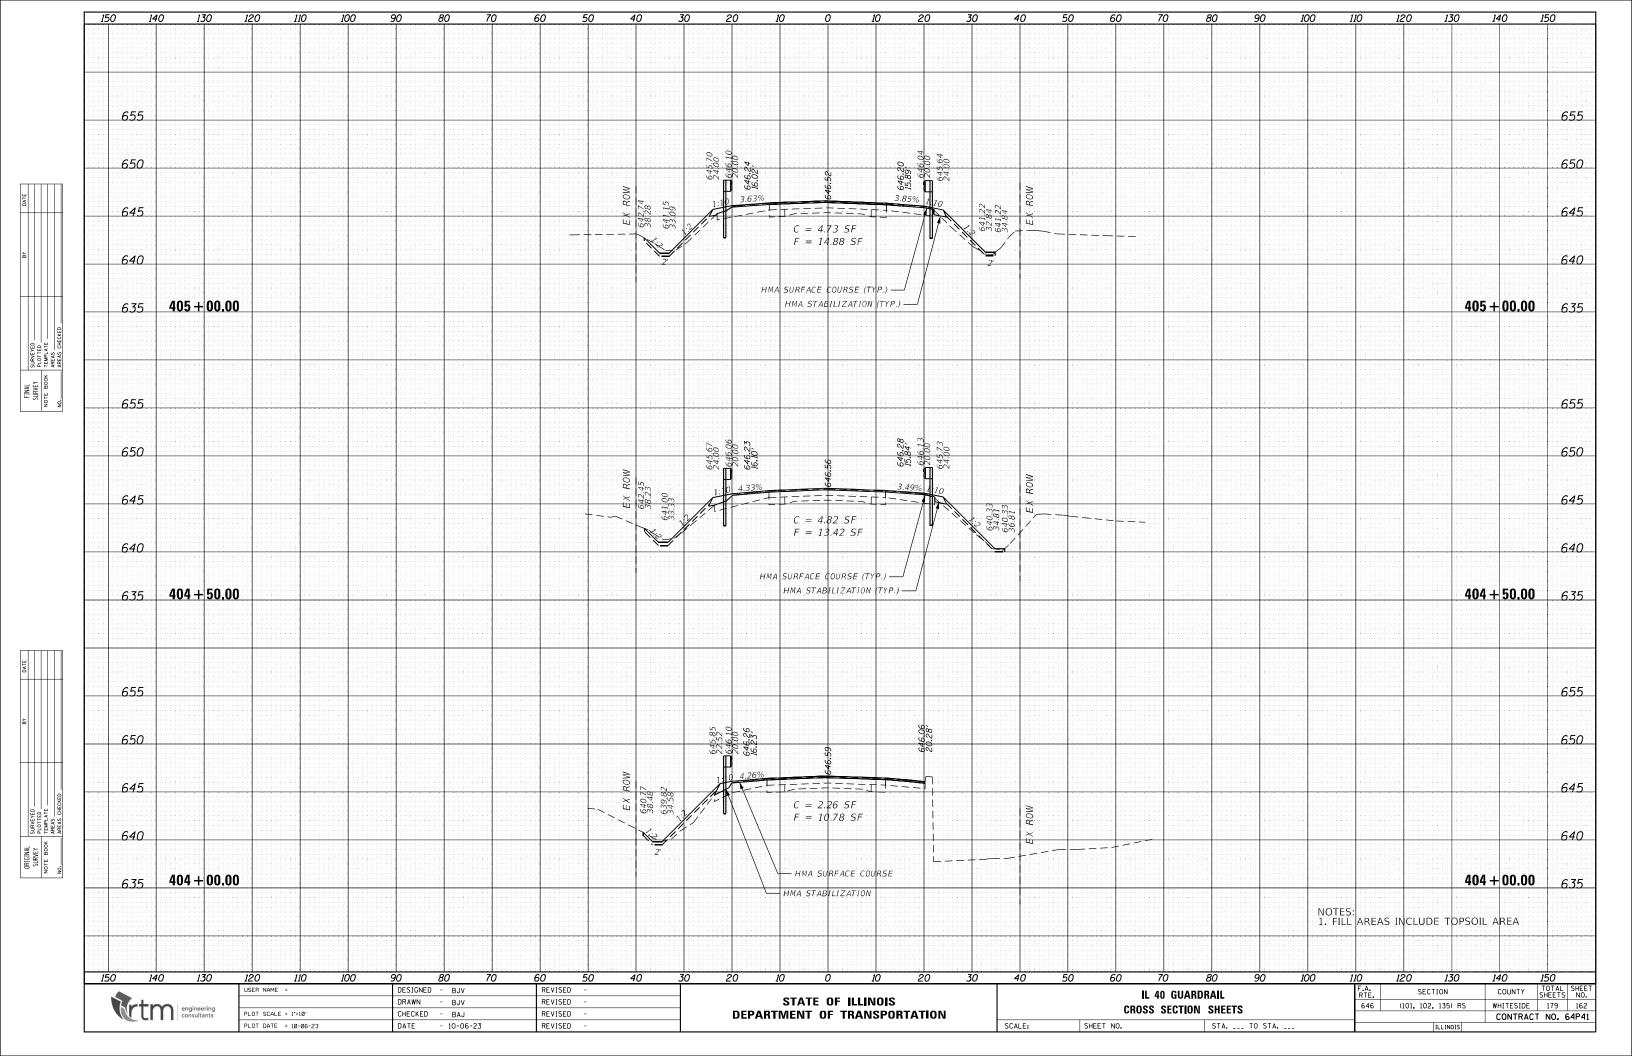


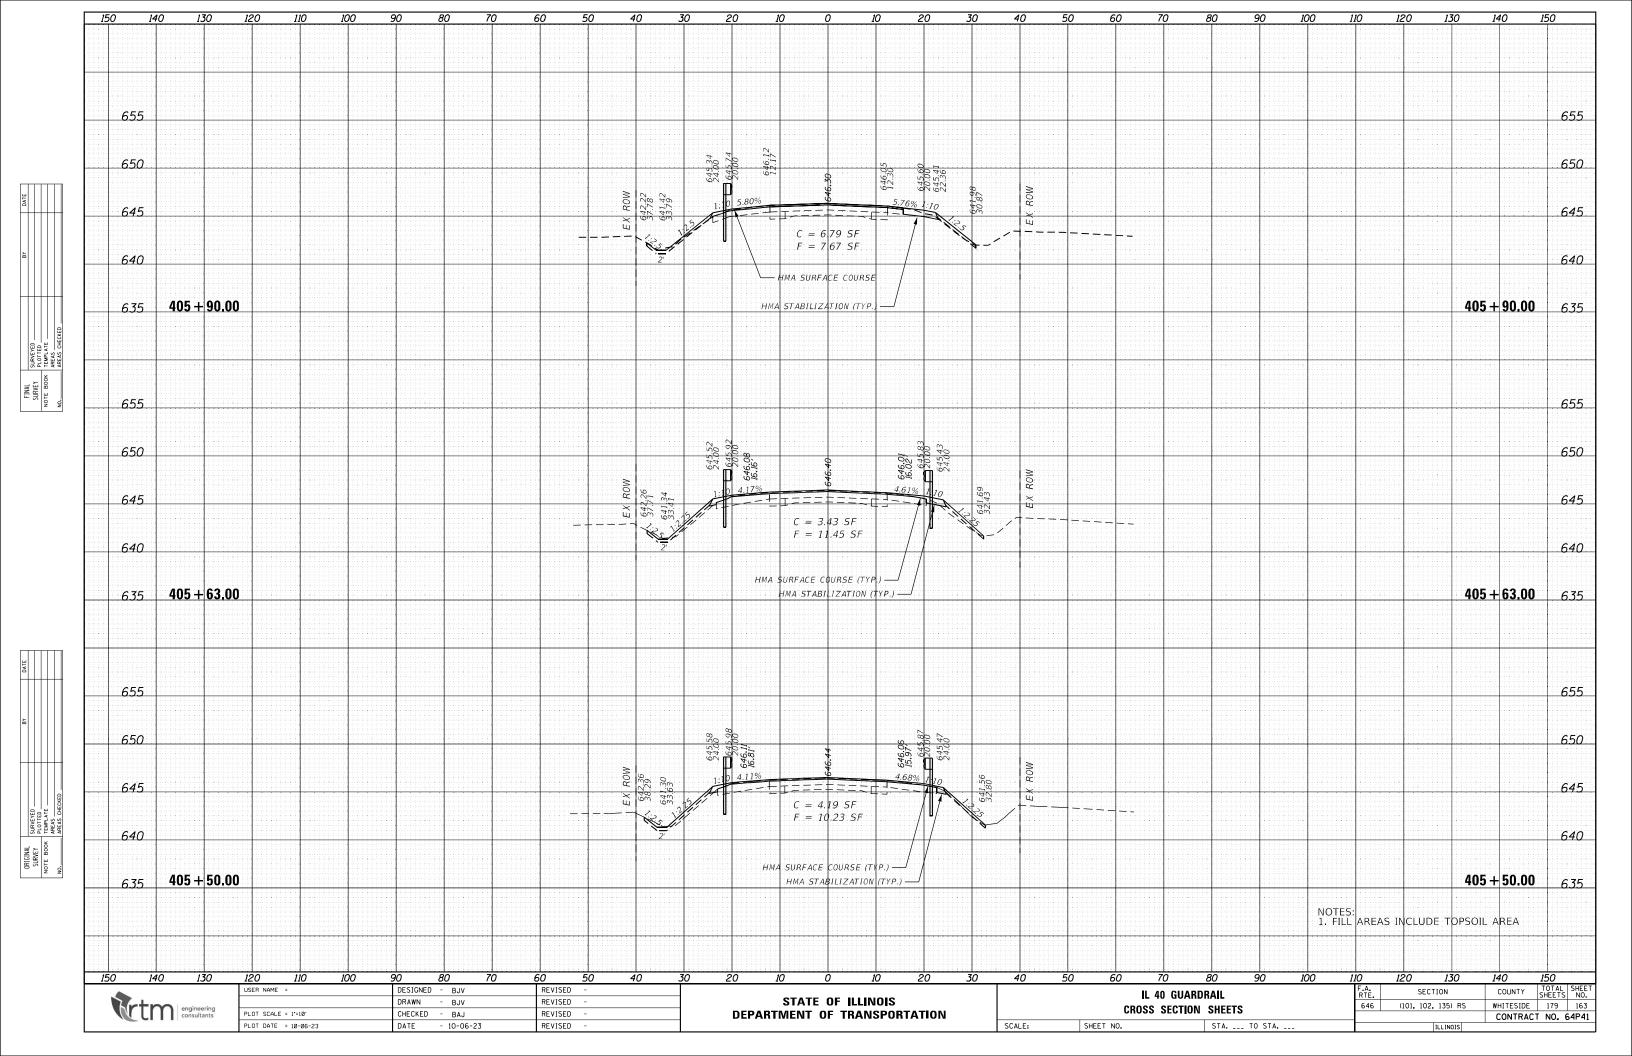
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