


F.A.P. RTE.	SECTION	COUNTY	TOTAL SHEETS	SHEET NO.
343	*	COOK	283	131
STA. * TO STA.		ILLINOIS FED. AID PROJECT		
FED. ROAD DIST. NO. 1		* 70D-Y-R & 70HB-R-1		62897

KEY PLAN


- NOTE
- CONNECT EXISTING CIRCUITS TO NEW CONDUCTORS AT BASE OF POLE.
 - ALL PROPOSED UNIT DUCTS ARE 30MM DIA. POLYETHYLENE WITH (3) 1/C #4 & (1) 1/C #6 GND (EPR-TYPE RHW).
 - ALL PROPOSED PUSHED CONDUITS ARE 75MM DIA. RGS.
 - REFER TO IDOT DISTRICT 1 STANDARD DETAIL BE-902 FOR UPRR UNDERPASS LUMINAIRE INSTALLATION DETAILS. STANDARD DETAIL SHALL BE MODIFIED TO HAVE 3" (75MM) DIA. PVC RGCC PASS THROUGH A PENETRATION IN THE MSE WALL TO THE JUNCTION BOX EMBEDDED IN THE PARAPET WALL, INSTEAD OF DROPPING DOWN IN FRONT OF THE MSE WALL.
 - FOUNDATION REQUIRES THREE (3) CONDUITS FOR UNIT DUCTS.

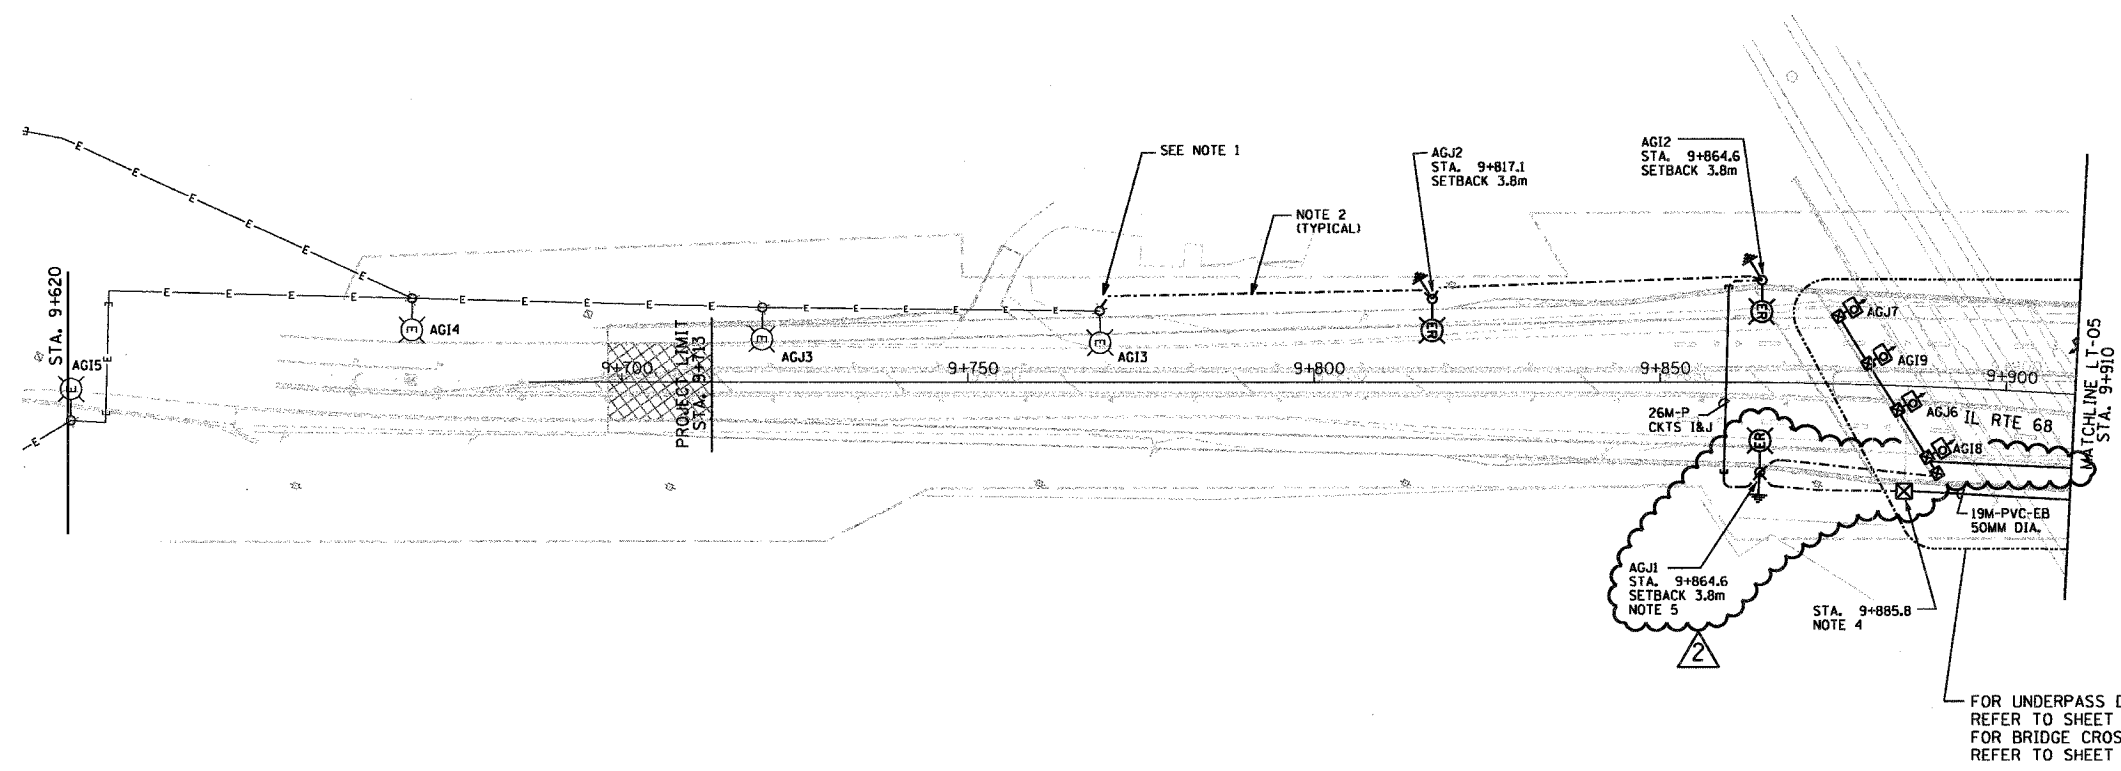

FOR UNDERPASS DETAILS REFER TO SHEET LT-18
FOR BRIDGE CROSSING DETAILS REFER TO SHEET LT-17



1 PROPOSED ROADWAY LIGHTING PLAN
SCALE: 1 : 500
5 0 5 10 15 20 25
SCALE IN METERS

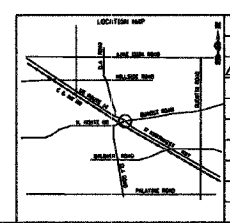

REVISIONS	
NAME	DATE
ADDENDUM 2	02/15/07

ILLINOIS DEPARTMENT OF TRANSPORTATION
ILLINOIS ROUTE 68 AT U.S. ROUTE 14
ROADWAY LIGHTING PROPOSED PLAN
IL 68 STA. 9+620 TO STA. 9+910

SCALE 1:500
DATE NOVEMBER 2006

DRAWN BY R.P.J.
DESIGNED BY I.B.
CHECKED BY A.D.O.

Rick Johns
 IDOT - District 01
 IL 68 over US 14
 P:\0513\000 - IL 68 over US 14\Working Files\Drawing Files\Lighting\LT-06 - Proposed Plan.dgn
 2/13/2007 3:17:05 PM 500.0000 M / M.