


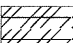

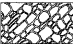





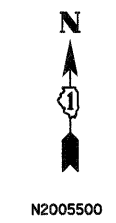
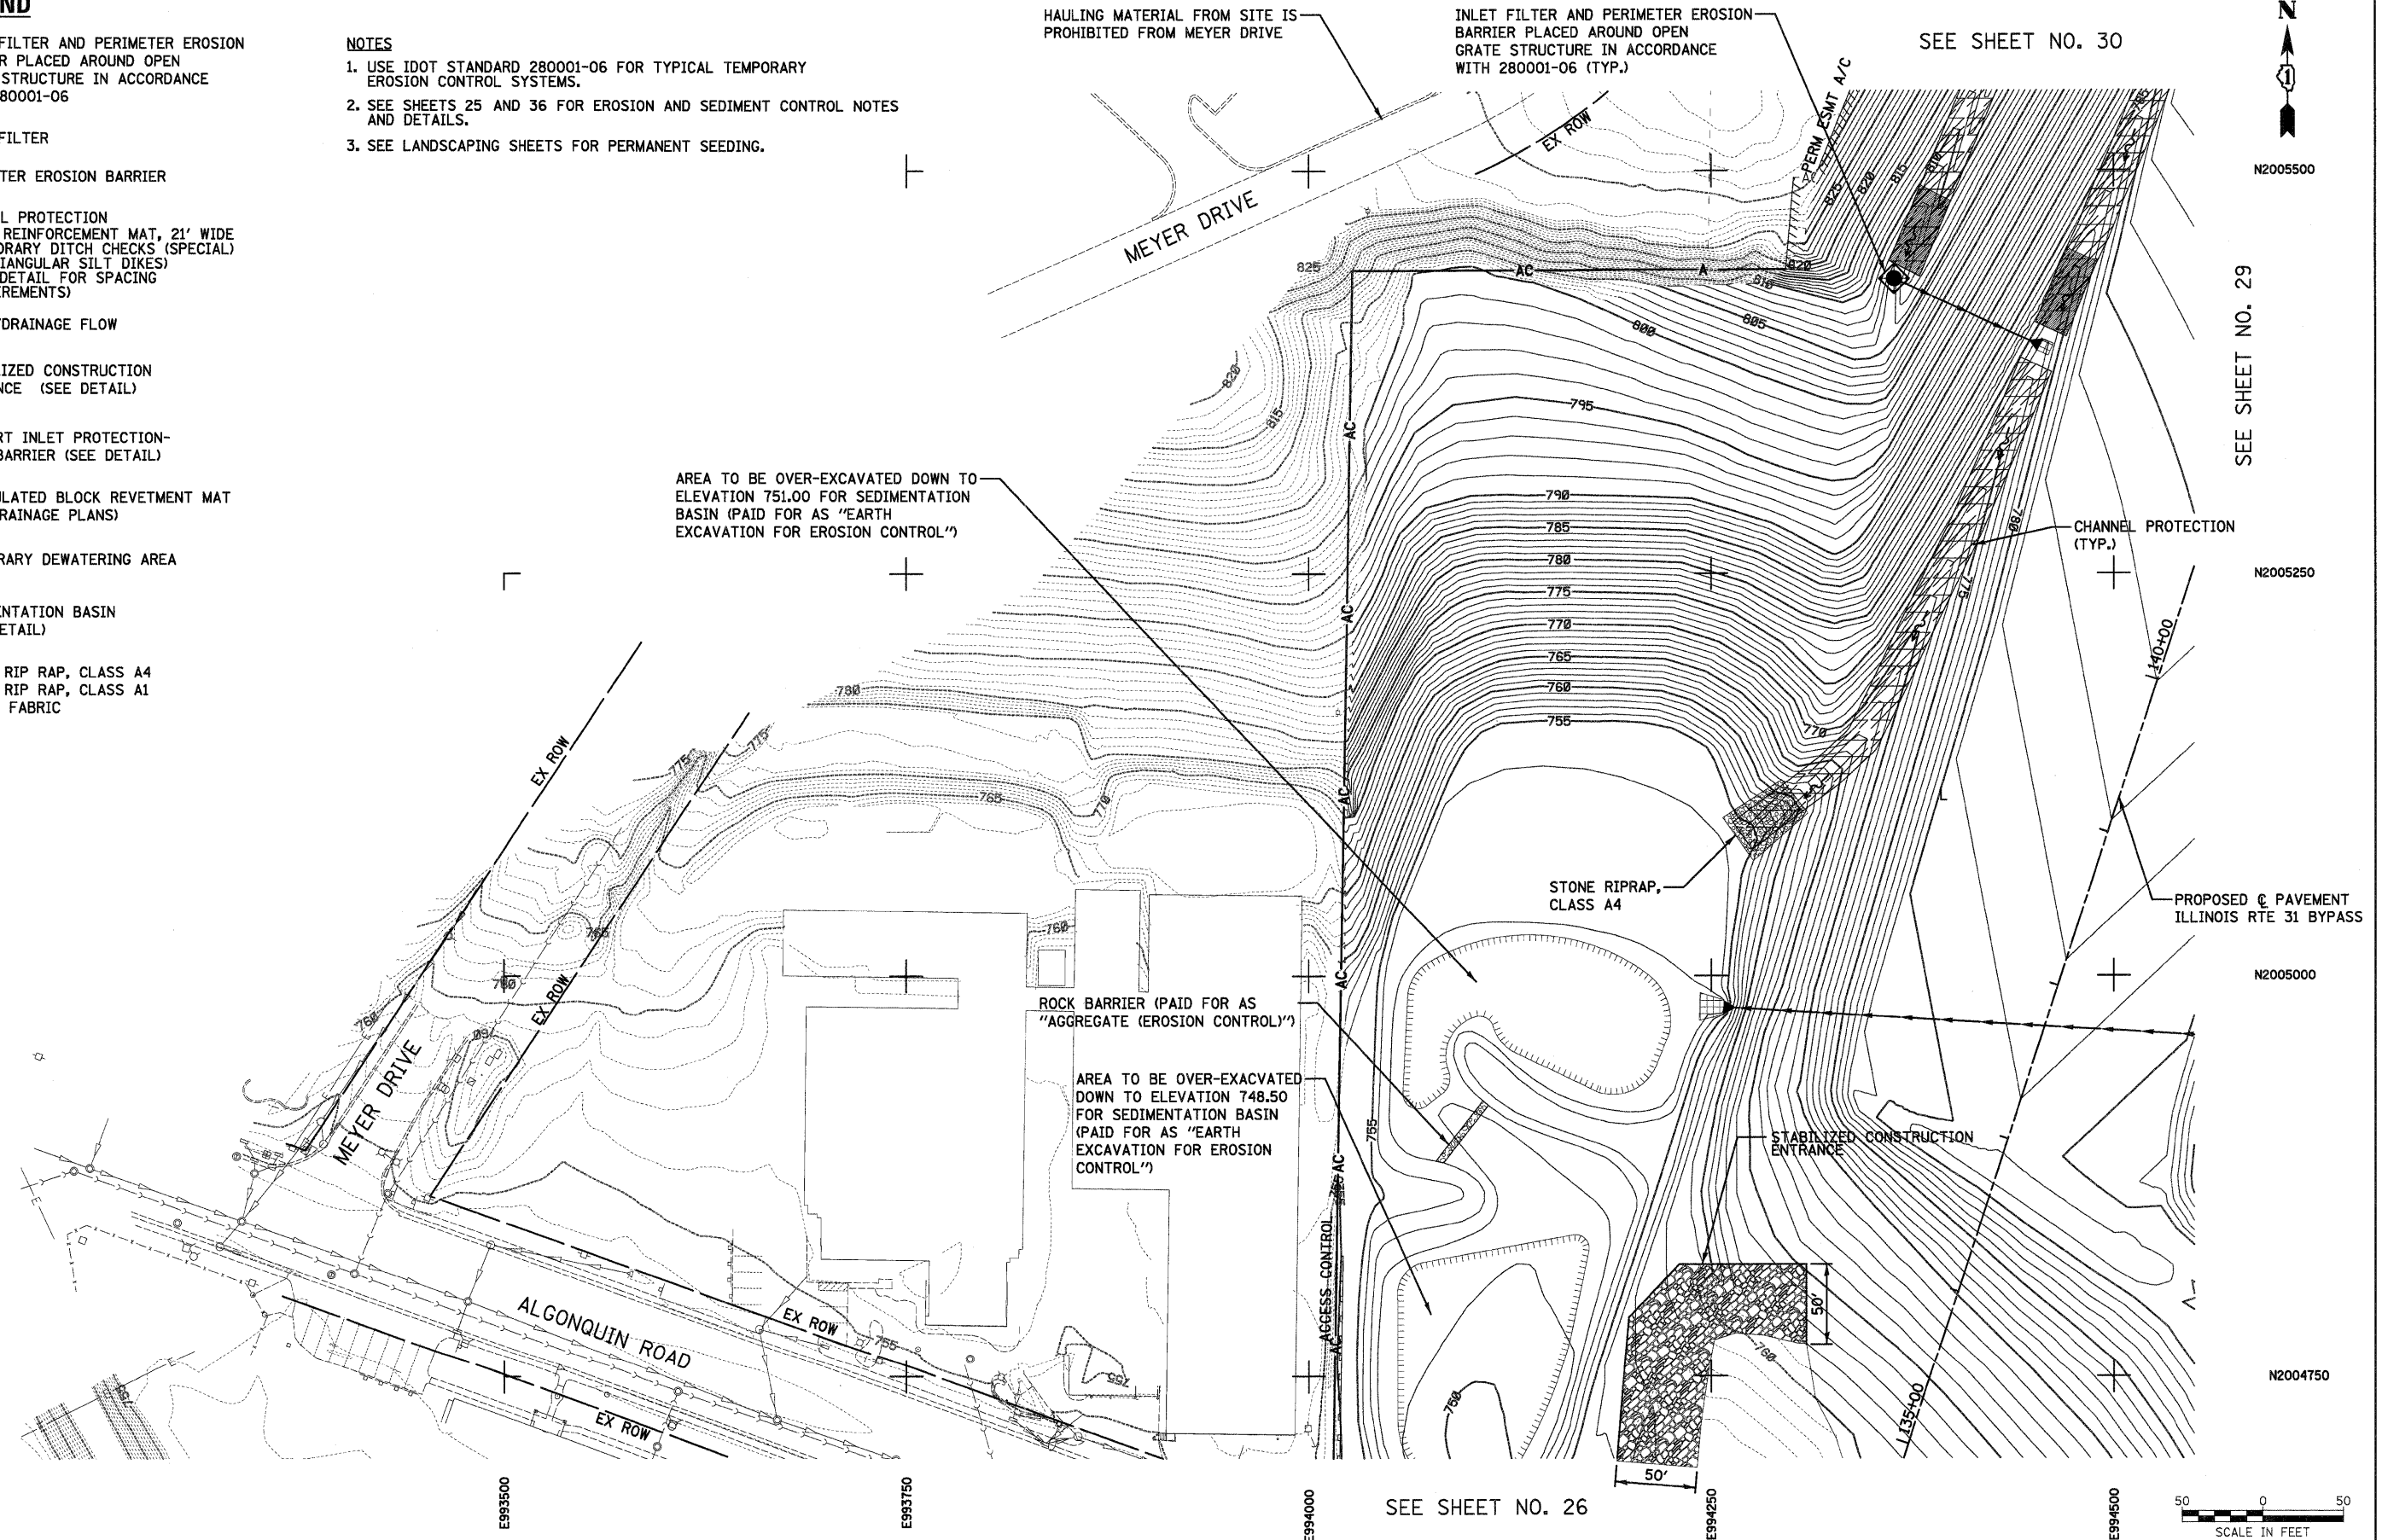


**LEGEND**

-  INLET FILTER AND PERIMETER EROSION BARRIER PLACED AROUND OPEN GRATE STRUCTURE IN ACCORDANCE WITH 280001-06
-  INLET FILTER
-  PERIMETER EROSION BARRIER
-  CHANNEL PROTECTION - TURF REINFORCEMENT MAT, 21' WIDE - TEMPORARY DITCH CHECKS (SPECIAL) (2 TRIANGULAR SILT DIKES) (SEE DETAIL FOR SPACING REQUIREMENTS)
-  DITCH/DRAINAGE FLOW
-  STABILIZED CONSTRUCTION ENTRANCE (SEE DETAIL)
-  CULVERT INLET PROTECTION - ROCK BARRIER (SEE DETAIL)
-  ARTICULATED BLOCK REVETMENT MAT (SEE DRAINAGE PLANS)
-  TEMPORARY DEWATERING AREA
-  SEDIMENTATION BASIN (SEE DETAIL)
-  STONE RIP RAP, CLASS A4  
STONE RIP RAP, CLASS A1  
FILTER FABRIC

**NOTES**

1. USE IDOT STANDARD 280001-06 FOR TYPICAL TEMPORARY EROSION CONTROL SYSTEMS.
2. SEE SHEETS 25 AND 36 FOR EROSION AND SEDIMENT CONTROL NOTES AND DETAILS.
3. SEE LANDSCAPING SHEETS FOR PERMANENT SEEDING.



N2005500


SEE SHEET NO. 29

N2005250

N2005000

N2004750

SEE SHEET NO. 26

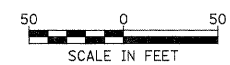

FILE NAME = ...\\D160F78-ah-eros-03.dgn	USER NAME = gtb	DESIGNED - DTE	REVISED -	<b>STATE OF ILLINOIS DEPARTMENT OF TRANSPORTATION</b>	<b>EROSION AND SEDIMENT CONTROL PLANS</b>	F.A. RTE.	SECTION	COUNTY	TOTAL SHEETS	SHEET NO.
	PLOT SCALE = 600.0000' / ft.	DRAWN - DTE	REVISED -		SCALE: 1" = 50'	18A-1	McHENRY	115	28	
	PLOT DATE = 1/18/2012	CHECKED - GAB	REVISED -		SHEET NO. 4 OF 12 SHEETS					
		DATE - 1/20/2012	REVISED -		STA. TO STA.	CONTRACT NO. 60F78 ILLINOIS FED. AID PROJECT				