
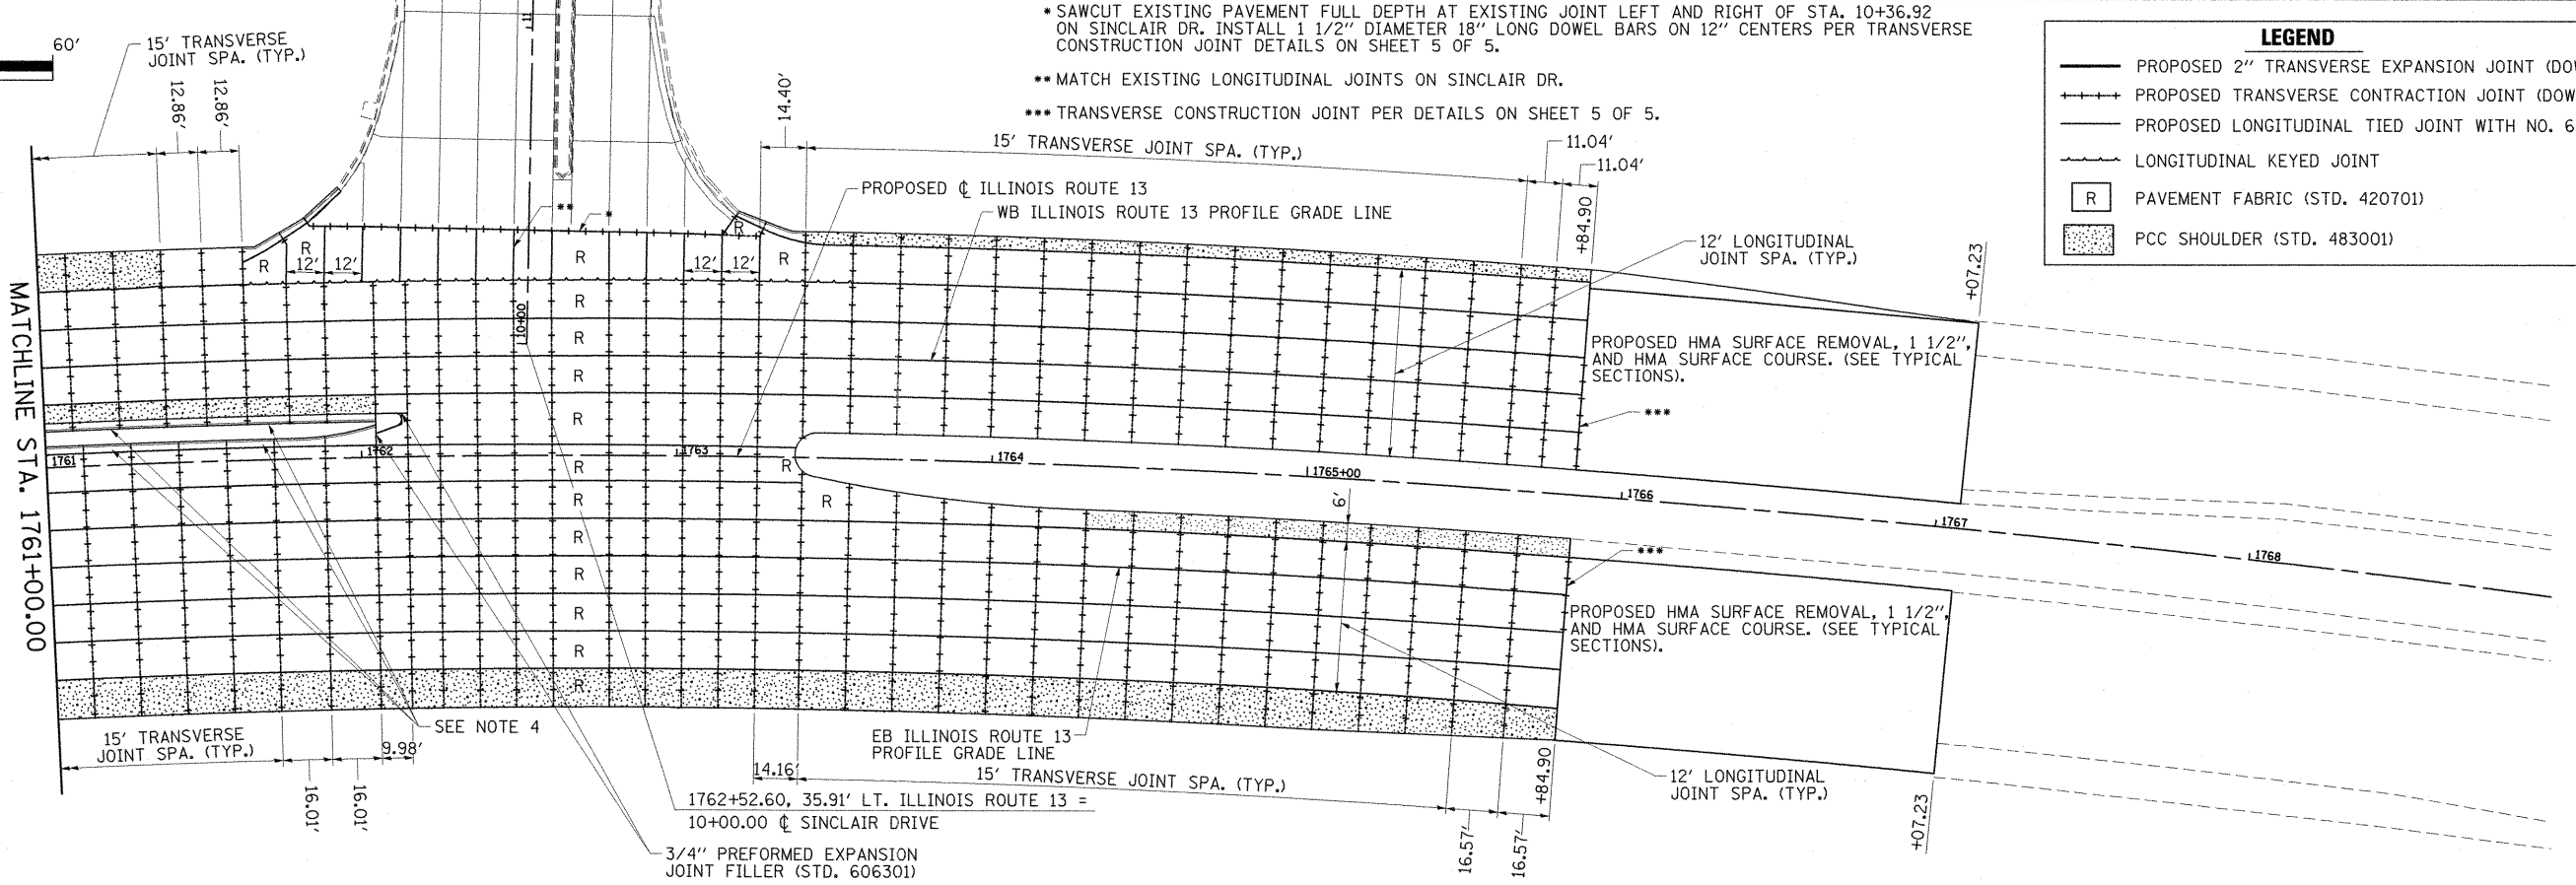


EASTBOUND AND WESTBOUND ILLINOIS ROUTE 13 TRANSVERSE CONTRACTION JOINT SPACING ALONG RESPECTIVE ILLINOIS ROUTE 13 PROFILE GRADE LINE

- NOTES:
1. SEE STANDARDS 420001, 420101, 420106, 483001, 606001, 606301 AND MSE WALL STRUCTURE PLANS FOR ADDITIONAL DETAILS.
  2. SEE STANDARDS 420401 FOR JOINTING AND REINFORCEMENT DETAILS FOR THE BRIDGE APPROACH PAVEMENT CONNECTORS.
  3. SEE MSE WALL STRUCTURE PLANS FOR JOINTING AND REINFORCEMENT DETAILS IN AND ADJACENT TO THE MSE WALL MOMENT SLAB AND PARAPET
  4. SEE DRAINAGE STRUCTURE JOINT DETAIL ON SHEET 5 OF 5.

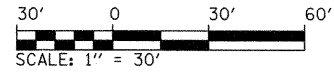

LEGEND	
	PROPOSED 2" TRANSVERSE EXPANSION JOINT (DOWELED)
	PROPOSED TRANSVERSE CONTRACTION JOINT (DOWELED)
	PROPOSED LONGITUDINAL TIED JOINT WITH NO. 6 BARS
	LONGITUDINAL KEYED JOINT
	PAVEMENT FABRIC (STD. 420701)
	PCC SHOULDER (STD. 483001)

FILE NAME =	USER NAME = OpenH&B Springfield	DESIGNED - KPF	REVISED -
1:\dot\0906603\draw\cadd\sheet\099885	shlt-jointing003.dgn	DRAWN - TAP	REVISED -
	PLOT SCALE = 30.0000' / IN.	CHECKED - SPH	REVISED -
	PLOT DATE = 12/14/2011	DATE - 12/9/11	REVISED -

STATE OF ILLINOIS  
DEPARTMENT OF TRANSPORTATION

JOINTING PLAN  
ILLINOIS ROUTE 13

SCALE: 1" = 30' SHEET NO. 3 OF 5 SHEETS STA. 1754+00.00 TO STA. END

F.A. RTE.	SECTION	COUNTY	TOTAL SHEETS	SHEET NO.
331	(IX-1) VB-1, B-1, N-4, R-3	WILLIAMSON	367	133
				CONTRACT NO. 98859
ILLINOIS FED. AID PROJECT				