		IDO	SIDEWALK REMOVAL T JURISDICTIONAL LIMITS	
			VILLAGE OF ROMEOVILLE CORPORATE LIMITS	VILLAGE OF BOLINGBROOK CORPORATE LIMITS
FROM STATION	TO STATION	LT/RT	SIDEWALK REMOVAL	SIDEWALK REMOVAL
			SQ FT	SQ FT
97+14	99+02	LT	990	
103+57	103+84	RT	119	
106+13	106+38	RT	237	
106+85	108+20	RT	1352	
298+20	299+12	RT		136
304+55	305+30	LT	380	
790+96	791+08	LT	211	
823+94	831+68	LT		3747
832+50	836+44	LT		2219
842+05	842+07	LT		10
	TOTA	LS	3289	6112

		WILL CO	SIDEWALK REMOVAL DUNTY JURISDICTIONAL LIMIT	·s
			VILLAGE OF ROMEOVILLE CORPORATE LIMITS	VILLAGE OF BOLINGBROOK CORPORATE LIMITS
FROM STATION	TO STATION	LT/RT	SIDEWALK REMOVAL	SIDEWALK REMOVAL
			SQ FT	SQ FT
CARLOW DF	₹			
398+18	399+20	RT		445
RODEO DR	•			
497+17	499+12	LT		940
497+22	499+28	RT		911
WEBER RD	•			
842+07	847+50	LT		2668
848+19	856+89	LT		4608
857+93	859+87	LT		1050
860+34	877+41	LT		8466
	TOTA	LS LS	0	19088

NOTES:

1. THE LOCATION OF THE IDOT / WILL COUNTY JURISDICTIONAL INTERFACE IS STA 842+07.

KNIGHT

Engineers & Architects

USER NAME = mmaestra	DESIGNED	PAW	REVISED -
	DRAWN	PAW	REVISED -
PLOT SCALE = 1:20	CHECKED	PJ0	REVISED -
PLOT DATE = 5/13/2017	DATE	05/12/17	REVISED -

		SCHEDULE OF QU	F.A.I/P RTE. SECTION		COUNTY	TOTAL SHEETS	SHEET NO.		
1		REMOVAL IT			*	(99-1HB-1) R-1	WILL	1508	101
-							CONTRACT	NO. 6	0X10
	SCALE: NONE	SHEET NO. 5 OF 5 SHEETS	STA.	TO STA.	* FAI 55,	FAP 856 ILLINOIS FED. A	ID PROJECT		

						L AND PROTECTION DICTION LIMITS	N		
TREE NUMBER	STA	OFFSET	LT/RT	STREET	SIZE	TREE REMOVAL (6 TO 15 UNITS DIAMETER)	TREE REMOVAL (OVER 15 UNITS DIAMETER)	*TREE REMOVAL (UNDER 6 UNITS DIAMETER)	TEMPORARY FENCE
					INCH	UNIT	UNIT	UNIT	FOOT
1014	101+52	50	RT	NORMANTOWN	4	-	-	4	
1015	101+90	51	RT	NORMANTOWN	4	-	-	4	
1701	103+60	14	RT	NORMANTOWN	3	-	-	3	
1702	103+85	13	RT	NORMANTOWN	3	-	-	3	
1704	104+14	10	RT	NORMANTOWN	3	-	-	3	
1703	104+29	44	RT	NORMANTOWN	3	-	-	3	
1706	104+36	9	RT	NORMANTOWN	3	-	-	3	
1705	104+44	48	RT	NORMANTOWN	3	-	-	3	
1707	104+97	47	RT	NORMANTOWN	3	-	-	3	
1708	105+23	47	RT	NORMANTOWN	8	8	-	-	
1709	105+25	62	RT	NORMANTOWN	8	8	-	-	
1710	105+38	64	RT	NORMANTOWN	8	8	-	-	
1711	105+44	48	RT	NORMANTOWN	6	6	-	-	
1712	105+80	67	RT	NORMANTOWN	8	8	-	-	
1713	105+89	53	RT	NORMANTOWN	8	8	-	-	
1735	106+00	45	LT	NORMANTOWN	3	-	-	3	
1714	106+10	0	RT	NORMANTOWN	3	-	-	3	
1736 1715	106+30 106+39	44	LT LT	NORMANTOWN	3	-	-	3	
		1		NORMANTOWN		-	-	3	
1737	106+56	43	LT	NORMANTOWN	3	-	-	3	
1716 1738	106+70 106+92	46	LT LT	NORMANTOWN	3	-	-	3	
1717	106+92	3	LT	NORMANTOWN NORMANTOWN	3	-	-	3	
1717	100+99	50	RT	NORMANTOWN	8	8	-	-	
1718	107+24	43	LT	NORMANTOWN	3	0	-	3	
1739	107+28	2	LT	NORMANTOWN	3	_	_	3	
1719	107+48	70	RT	NORMANTOWN	8	8	-	-	
1713	107+63	70	RT	NORMANTOWN	8	8	-	-	
1721	107+68	64	RT	NORMANTOWN	8	8	-	-	
1723	107+81	62	RT	NORMANTOWN	8	8	_	-	
1724	107+88	67	RT	NORMANTOWN	12	12	_	_	
1725	108+13	50	RT	NORMANTOWN	5	-	_	5	
1726	108+13	50	RT	NORMANTOWN	5	-	-	5	
1727	108+30	53	RT	NORMANTOWN	3	-	-	3	
1728	108+61	50	RT	NORMANTOWN	6	6	-	-	
1729	108+92	61	RT	NORMANTOWN	6	6	-	-	
1730	109+09	63	RT	NORMANTOWN	10	10	-	-	
1731	109+09	48	RT	NORMANTOWN	5	-	-	5	
1732	109+17	54	RT	NORMANTOWN	8	8	-	-	
1733	109+23	56	RT	NORMANTOWN	10	10	-	-	
1734	109+29	52	RT	NORMANTOWN	6	6	-	-	
1809	293+21	6	RT	REMINGTON	6	-	-	-	20
1808	293+52	6	RT	REMINGTON	6	-	-	-	20
1807	293+82	7	RT	REMINGTON	6	-	-	-	20
1806	294+08	6	RT	REMINGTON	6	-	-	-	20
1805	294+42	7	RT	REMINGTON	6	-	-	-	20
1804	294+67	4	RT	REMINGTON	6	6	-	-	
1803	294+89	1	RT	REMINGTON	6	6	-	-	
1802	295+13	2	LT	REMINGTON	6	6	-	-	
1801	295+38	5	LT	REMINGTON	6	6	-	-	
1332	296+36	41	LT	REMINGTON	3	-	-	-	20
1337	296+38	41	RT	REMINGTON	3	-	-	-	20

TREE	0.74	055055	I T/DT	OTREET	0175	TREE REMOVAL	TREE REMOVAL	*TREE REMOVAL	TEMPORARY
NUMBER	STA	OFFSET	LT/RT	STREET	SIZE	(6 TO 15 UNITS DIAMETER)	(OVER 15 UNITS DIAMETER)	(UNDER 6 UNITS DIAMETER)	FENCE
					INCH	UNIT	UNIT	UNIT	FOOT
1325	296+39	6	LT	REMINGTON	4	-	-	-	20
1338	296+68	42	RT	REMINGTON	3	-	-	-	20
1333	296+70	41	LT	REMINGTON	3	-	-	-	20
1326	296+89	6	LT	REMINGTON	4	-	-	-	20
1334	297+05	41	LT	REMINGTON	3	-	-	-	20
1339	297+11	41	RT	REMINGTON	3	-	-	-	20
1327	297+14	7	LT	REMINGTON	4	-	-	-	20
1328	297+38	6	LT	REMINGTON	4	-	-	-	20
1335	297+39	42	LT	REMINGTON	3	-	-	-	20
1340	297+49	41	RT	REMINGTON	2	-	-	-	20
1329	297+64	7	LT	REMINGTON	4	-	-	4	
1336	297+76	42	LT	REMINGTON	3	-	-	-	20
1341	297+79	41	RT	REMINGTON	2	-	-	-	20
1330	297+88	6	LT	REMINGTON	3	-	-	3	
1331	298+14	6	LT	REMINGTON	4	-	-	4	
1345	301+52	68	RT	WINDHAM	12	-	-	-	20
1347	301+56	50	RT	WINDHAM	15	15	-	-	
1349	301+56	49	LT	WINDHAM	20	-	20	-	
1344	301+62	78	RT	WINDHAM	15	-	-	-	20
1346	301+72	58	RT	WINDHAM	15	-	-	-	20
1348	301+72	53	LT	WINDHAM	12	12	-	-	
1343	301+73	76	RT	WINDHAM	15	-	-	-	20
1342	301+88	75	RT	WINDHAM	15	-	_	-	20
1901	302+00	57	RT	WINDHAM	20	-	-	-	20
1914	302+05	56	LT	WINDHAM	12	12	-	-	
1902	302+64	64	RT	WINDHAM	12	-	-	-	20
1903	302+74	50	RT	WINDHAM	10	-	-	-	20
1915	303+65	46	LT	WINDHAM	12	12	-	-	
1904	304+14	58	RT	WINDHAM	6	-	-	-	20
1916	304+81	41	LT	WINDHAM	4	-	-	4	
1905	305+06	49	RT	WINDHAM	4	-	-	-	20
1906	305+61	47	RT	WINDHAM	8	-	-	-	20
1907	305+79	48	RT	WINDHAM	8	-	-	-	20
1917	305+85	37	LT	WINDHAM	32	-	-	-	20
1908	305+95	49	RT	WINDHAM	7	-	-	-	20
1918	306+00	37	LT	WINDHAM	36	-	-	-	20
1909	306+17	45	RT	WINDHAM	6	-	-	-	20
1910	306+53	49	RT	WINDHAM	4	-	-	-	20
1911	306+53	45	RT	WINDHAM	8	-	-	-	20
1912	306+73	45	RT	WINDHAM	6	-	-	-	20
1913	307+21	40	RT	WINDHAM	7	-	-	-	20
1001	795+01	63	RT	WEBER RD	12	12	-	-	
1002	795+38	68	RT	WEBER RD	8	8	-	-	
1003	795+55	82	RT	WEBER RD	17	-	17	-	
1004	795+76	73	RT	WEBER RD	7	7	-	-	
1005	796+63	85	RT	WEBER RD	14	14	-	-	
1006	796+72	89	RT	WEBER RD	30	-	30	-	
1007	796+90	81	RT	WEBER RD	10	10	-	-	
1007	797+69	84	RT	WEBER RD	7	7	<u>-</u>	-	
1008	802+35	89	LT	WEBER RD	8	8	-	-	
1010	802+33	90	LT	WEBER RD	10	10	-	-	
1010	803+06	97	LT	WEBER RD	10	10	-	-	

TREE REMOVAL AND PROTECTION

NOTES:

- 1. THE LOCATION OF THE IDOT / WILL COUNTY JURISDICTIONAL INTERFACE IS STA 842+07.
- 2. ALL TREE REMOVAL TO BE DONE ON AN ADVANCED CONTRACT.

_EGEND:

- NOT INCLUDED IN CONTRACT 60X10

- T=TRANSPLANTED TREE (COORDINATE WITH REMOVAL AND LANDSCAPING PLANS)
- * IN ACCORDANCE WITH SECTION 201 OF STANDARD SPECIFICATIONS,
 THE COST OF THIS WORK SHALL BE INCLUDED IN THE CONTRACT
 UNIT PRICE FOR EARTHWORK.



USER NAME = dbarnes	DESIGNED	DGB	REVISED	-
	DRAWN	DGB	REVISED	-
PLOT SCALE = 1:20	CHECKED	PJ0	REVISED	-
PLOT DATE = 8/18/2017	DATE	08/25/17	REVISED	-

STATE OF ILLINOIS DEPARTMENT OF TRANSPORTATION

				S	СН			OF QU SCHED	ANTITIES ULE
	SCALE:	NONE	SHEET	NO.	1	OF	4	SHEETS	STA.
-									

TO STA.

F.A.I/P RTE.	SECTION	COUNTY	TOTAL SHEETS	SHEI NO
*	(99-1HB-1) R-1	WILL	1508	102
		CONTRACT	NO. 6	0X10
¥ FAT 55	EAP 856 THINOIS FED A	ID PROJECT		

ILE NAME = D160X10-sht-schedule16-Tree Sched

						L AND PROTECTION	N		
TREE NUMBER	STA	OFFSET	LT/RT	STREET	SIZE	TREE REMOVAL (6 TO 15 UNITS DIAMETER)	TREE REMOVAL (OVER 15 UNITS DIAMETER)	*TREE REMOVAL (UNDER 6 UNITS DIAMETER)	TEMPORARY FENCE
					INCH	UNIT	UNIT	UNIT	FOOT
1012	803+40	98	LT	WEBER RD	10	10	-	-	
1013	803+54	92	LT	WEBER RD	10	10	-	-	
1101	804+53	94	LT	WEBER RD	7	7	-	-	
1102	804+73	92	LT	WEBER RD	7	7	-	-	
1103	804+86	104	LT	WEBER RD	8	8	-	-	
1104	804+95	93	LT	WEBER RD	9	9	-	-	
1105	805+09	106	LT	WEBER RD	9	9	-	-	
1106	805+22	104	LT	WEBER RD	9	9	-	-	
1107	807+26	70	LT	WEBER RD	7	7	-	-	
1108	807+35	60	LT	WEBER RD	7	7	-	-	
1109	807+40	117	LT	WEBER RD	7	7	-	-	
1110	807+62	62	LT	WEBER RD	7	7	-	-	
1111	807+68	112	LT	WEBER RD	7	7	-	-	
1112	808+18	69	LT	WEBER RD	8	8	-	-	
1113	808+49	71	RT	WEBER RD	7	7	-	-	
1114	808+65	71	LT	WEBER RD	9	9	-	-	
1115	808+91	62	RT	WEBER RD	8	8	-	-	
1116	809+15	71	LT	WEBER RD	9	9	-	-	
1117	809+21	74	RT	WEBER RD	12	12	-	-	
1118	809+58	62	RT	WEBER RD	11	11	-	-	
1119	809+58	74	LT	WEBER RD	10	10	-	-	
1133	813+43	94	LT	WEBER RD	6	6	-	-	
1135	813+55	105	LT	WEBER RD	6	6	-	-	
1120	813+58	42	RT	WEBER RD	12	12	-	-	
1134	813+61	86	LT	WEBER RD	8	8	-	-	
1136	813+63	106	LT	WEBER RD	6	6	-	-	
1137	813+74 813+84	101 78	LT LT	WEBER RD	6 10	10	-	-	
1138				WEBER RD			-	-	
1121 1122	813+96	89 81	RT RT	WEBER RD	12 12	12 12	-	-	
	814+14	78		WEBER RD	10	12	-	-	
1139 1140	814+24	74	LT LT	WEBER RD WEBER RD	10	10	-	-	
1141	814+43 814+53	86	LT	WEBER RD	10	10	-	-	
1123	814+56	74	RT	WEBER RD	12	12	-	-	
1142	814+66	93	LT	WEBER RD	6	6	-	-	
1142	814+82	97	LT	WEBER RD	6	6	-	_	
1143	814+92	93	LT	WEBER RD	6	6	-	-	
1145	815+00	74	LT	WEBER RD	6	6	-	-	
1146	815+08	103	LT	WEBER RD	6	6	-	-	
1147	815+17	85	LT	WEBER RD	8	8	-	-	
1124	815+38	57	RT	WEBER RD	12	12	-	-	
1148	815+38	79	LT	WEBER RD	8	8	-	-	
1125	815+53	70	RT	WEBER RD	12	12	-	-	
1149	815+69	79	LT	WEBER RD	5	-	-	5	
1126	815+72	70	RT	WEBER RD	12	12	-	-	
1127	816+01	93	RT	WEBER RD	12	12	-	-	
1128	816+23	71	RT	WEBER RD	12	12	-	-	
1130	816+63	96	RT	WEBER RD	12	12	-	-	
1129	816+67	82	RT	WEBER RD	12	12	-	-	
1131	816+84	98	RT	WEBER RD	12	12	-	-	
1201	831+96	75	RT	WEBER RD	5	-	-	5	
1203	832+22	102	RT	WEBER RD	5	-	-	-	20
	1	1	I	ı	-	1	1	1	1

	IDOT JURISDICTION LIMITS											
TREE NUMBER	STA	OFFSET	LT/RT	STREET	SIZE	TREE REMOVAL (6 TO 15 UNITS DIAMETER)	TREE REMOVAL (OVER 15 UNITS DIAMETER)	*TREE REMOVAL (UNDER 6 UNITS DIAMETER)	TEMPORARY FENCE			
					INCH	UNIT	UNIT	UNIT	FOOT			
1202	833+00	87	RT	WEBER RD	3	-	-	3				
1301	833+20	86	RT	WEBER RD	3	-	-	3				
1303	833+37	97	RT	WEBER RD	7	-	-	-	20			
1304	833+55	104	RT	WEBER RD	6	-	-	-	20			
1302	833+56	82	RT	WEBER RD	11	11	-	-				
1305	833+73	89	RT	WEBER RD	12	12	-	-				
1306	834+11	90	RT	WEBER RD	12	12	-	-				
1307	834+28	98	RT	WEBER RD	9	-	-	-	20			
1308	834+43	88	RT	WEBER RD	9	9	-	-				
1309	834+64	78	RT	WEBER RD	3	-	-	3				
1310	834+64	96	RT	WEBER RD	2	-	-	-	20			
1311	834+81	78	RT	WEBER RD	3	-	-	3				
1312	834+96	92	RT	WEBER RD	3	-	-	3				
1313	835+16	89	RT	WEBER RD	3	-	-	3				
1314	835+27	92	RT	WEBER RD	3	-	-	3				
1315	835+33	99	RT	WEBER RD	3	-	-	3				
1316 1317	835+45 835+49	92	RT	WEBER RD WEBER RD	3 10	-	-	3 -				
1317	835+60	93	RT RT	WEBER RD	10	10 10	-	-				
1319	835+62	103	RT	WEBER RD	10	10	-	-				
2201	4984+27	82	RT	RAMP A	3	-	_	3				
2202	4984+27	82	RT	RAMP A	3	<u>-</u>	<u>-</u>	3				
2203	4984+43	87.70	RT	RAMP A	3	-	_	3				
2204	4984+59	81	RT	RAMP A	3	_	_	3				
2205	4984+75	85	RT	RAMP A	2	-	-	2				
2206	4984+92	79	RT	RAMP A	2	-	-	2				
2207	4985+10	84	RT	RAMP A	3	-	-	3				
2208	4985+25	79	RT	RAMP A	3	-	-	3				
2209	4985+40	82	RT	RAMP A	3	-	-	3				
2210	4985+59	79	RT	RAMP A	3	-	-	3				
2211	4987+91	65	RT	RAMP A	8	-	-	-	20			
2212	4988+11	64	RT	RAMP A	7	-	-	-	20			
2213	4989+48	59	RT	RAMP A	7	7	-	-				
2214	4989+48	59	RT	RAMP A	6	6	-	-				
2215	4989+48	59	RT	RAMP A	6	6	-	-				
2217	4990+55	58	RT	RAMP A	8	8	-	-				
2216	4990+55	58	RT	RAMP A	7	7	-	-				
2218	4990+77	55	RT	RAMP A	8	8	-	-				
2219	4990+77	55	RT	RAMP A	11	11	-	-				
2220	4991+64	60	RT	RAMP A	6	6	-	-				
2221	4991+69	60	RT	RAMP A	15	15	-	-				
2222	4991+73	68	RT	RAMP A	8	8	-	-				
2223	4991+92	32	RT	RAMP A	11	11	-	-				
2224	4992+37	69	RT	RAMP A	22	-	22	-				
2225	4993+74	99	RT	RAMP A	11	11	-	-	20			
2226	4995+36	112	RT	RAMP A	11 8	-	-	-	20			
2227 2228	4995+63 4995+81	112 104	RT RT	RAMP A RAMP A	9	-	-	-	20			
2228	4995+81	1	RT	RAMP A	10	-	-	-	20			
2229	4996+66	111 40	LT	RAMP A	12	<u>-</u> Т	-	-	20			
2233	4997+52	85	LT	RAMP A	4	-	-	<u>-</u> Т				
2234	4997+66	93	LT	RAMP A	4	-	-	T	1			
22J 4	T331 T00	1 30		I VAIVIE A				<u>'</u>	1			

TREE REMOVAL AND PROTECTION

NOTES:

1. THE LOCATION OF THE IDOT / WILL COUNTY JURISDICTIONAL INTERFACE IS STA 842+07.

2. ALL TREE REMOVAL TO BE DONE ON AN ADVANCED CONTRACT.

LEGEND:

- NOT INCLUDED IN CONTRACT 60X10

T=TRANSPLANTED TREE (COORDINATE WITH REMOVAL AND LANDSCAPING PLANS)

* IN ACCORDANCE WITH SECTION 201 OF STANDARD SPECIFICATIONS,
THE COST OF THIS WORK SHALL BE INCLUDED IN THE CONTRACT
UNIT PRICE FOR EARTHWORK.



USER NAME = dbarnes	DESIGNED	DGB	REVISED	-
	DRAWN	DGB	REVISED	-
PLOT SCALE = 1:20	CHECKED	PJ0	REVISED	-
PLOT DATE = 8/18/2017	DATE	08/25/17	REVISED	-

		SCHEDULE	OF OU	ANTITIES		F.A.I.			S
			SCHED			*			(99-
ı	SCALE: NONE	SHEET NO. 2 OF 4	SHEETS	STA.	TO STA.	* FAI	55,	FAP	856

F.A.I/P RTE.	SECTION		COUNTY	TOTAL SHEETS	SHEI NO
*	(99-1HB-1) R	-1	WILL	1508	103
			CONTRACT	NO. 6	0X10
* FAI 55,	FAP 856 ILLINOIS	FED. AID	PROJECT		

TREE REMOVAL AND PROTECTION IDOT JURISDICTION LIMITS TREE REMOVAL TR												
TREE STA OFFSET				STREET	SIZE	TREE REMOVAL (6 TO 15 UNITS DIAMETER)	TREE REMOVAL (OVER 15 UNITS DIAMETER)	*TREE REMOVAL (UNDER 6 UNITS DIAMETER)	TEMPORARY FENCE			
		007+91 47 LT DAMD A				UNIT	UNIT	UNIT	FOOT			
2231	4997+81	47	LT	RAMP A	12	12	-	-				
2235	4997+95	102	LT	RAMP A	4	-	-	Т				
2232	4998+01	60	LT	RAMP A	12	12	-	-				
1132	4998+51	39	LT	RAMP A	12	Т	-	-				
1154	6000+37	160	RT	RAMP B	5	-	-	5				
2301 6003+69 149			RT	RAMP B	6	-	-	-	20			
2302	6003+95	148	RT	RAMP B	5	-	-	-	20			
2303	6006+47	129	RT	RAMP B	14	14	-	-				
2304	6006+47	129	RT	RAMP B	16	-	16	-				
2305	6006+51	130	RT	RAMP B	12	12	-	-				
2306	6006+51	130	RT	RAMP B	16	-	16	-				
2313	6006+67	278	LT	RAMP B	3	-	-	<u> </u>				
2314	6006+78	250	LT	RAMP B	3	-	-	T				
2315	6007+07	257	LT	RAMP B	3	-	-	Ţ				
2316	6007+18	228	LT	RAMP B	4	-	-	T				
2317 2307	6007+48 6007+54	235 107	LT	RAMP B	4	-	20	Т				
2307	6007+54	207	RT LT	RAMP B RAMP B	20	-		<u>-</u> Т				
2319	6007+39	213	LT	RAMP B	4	-	-	T T				
2308	6008+28	90	RT	RAMP B	12	12	-	-				
2309	6008+28	90	RT	RAMP B	14	14	-	-				
2310	6008+47	87	RT	RAMP B	19	-	19	-				
2311	6008+98	75	RT	RAMP B	17	-	17	-				
2312	6010+92	64	RT	RAMP B	8	8	-	-				
2501	7984+91	75	RT	RAMP C	5	-	-	-	20			
2502	7985+23	66	RT	RAMP C	5	-	-	-	20			
2503	7985+56	70	RT	RAMP C	4	-	-	-	20			
2504	7985+87	65	RT	RAMP C	4	-	-	-	20			
2505	7986+38	63	RT	RAMP C	3	-	-	-	20			
2506	7986+68	59	RT	RAMP C	5	-	-	-	20			
2507	7987+92	59	RT	RAMP C	8	-	-	-	20			
2508	7990+04	47	RT	RAMP C	15	15	-	-				
2509	7991+76	58	RT	RAMP C	12	12	-	-				
2510	7991+96	61	RT	RAMP C	12	12	-	-				
2511	7994+44	3	LT	RAMP C	6	6	-	-				
2512	7994+72	19	LT	RAMP C	5	-	-	5				
2513	7994+89	26	LT	RAMP C	5	-	-	5				
2514	7995+12	48	LT	RAMP C	3	-	-	3				
2515	7995+35	20	LT	RAMP C	3	-	-	3				
2516	7996+43 9001+52	43 48	LT LT	RAMP C RAMP D	5	-	-	5				
1151 1152	9001+52	34	LT	RAMP D	8	8	-	-				
1150	9001+58	68	LT	RAMP D				-				
1153	9001+39	24	LT	RAMP D	6	6	-	-				
2601	9004+09			-	-							
2602	9004+58	117	RT	RAMP D	8	8	-	-				
2603	9004+73	115	RT	RAMP D	8	8	-	-				
2604	9005+00	135	RT	RAMP D	12	-	-	-	20			
2605	9005+34	118	RT	RAMP D	14	14	-	-				
2606	9006+42	115	RT	RAMP D	13	-	-	-	20			
2607	9005+62	110	RT	RAMP D	18	-	-	-	20			
2608 9006+07 115 RT RAMP D			13	13	-	-						

						LAND PROTECTION DICTION LIMITS			
TREE NUMBER	STA	OFFSET	LT/RT	STREET	SIZE	TREE REMOVAL (6 TO 15 UNITS DIAMETER)	TREE REMOVAL (OVER 15 UNITS DIAMETER)	*TREE REMOVAL (UNDER 6 UNITS DIAMETER)	TEMPORARY FENCE
					INCH	UNIT	UNIT	UNIT	FOOT
2625	9006+18	40	LT	RAMP D 8		8	-	-	
2624	9006+24	75	LT	RAMP D	6	6	-	-	
2626	9006+42	24	LT	RAMP D	8	8	-	-	
2627	9006+72	50	LT	RAMP D	8	8	-	-	
2636	9006+79	259	LT	RAMP D	5	-	-	Т	
2628	9006+88	42	LT	RAMP D	6	6	-	-	
2628 9006+ 2629 9006+				RAMP D	8	8	-	-	
2637	9007+08	258	LT	RAMP D	5	-	-	Т	
2638	9007+22	232	LT	RAMP D	5	-	-	Т	
2630	9007+20	007+20 64 LT RAMP D 3		3	-	-	3		
2639	9007+36	199	LT	RAMP D	5	-	-	Т	
2640	9007+51	231	LT	RAMP D	5	-	-	Т	
2609	9007+53	84	RT	RAMP D	20	=	20	-	
2641	9007+64	205	LT	RAMP D	5			Т	
2643	9007+74	175	LT RAMP D 5		-	Т			
2610	9007+77	81	RT	RAMP D	11	11 -		-	
2611	9007+77	81	RT	RAMP D	10	10	-	-	
2642	9007+85	210	LT	RAMP D	5	-	-	Т	
2631	9008+04	65	LT	RAMP D	4	-	-	T	
2644	9008+10	194	LT	RAMP D	5	-	-	Т	
2632	9008+09	79	LT	RAMP D	3	-	-	Т	
2645	9008+42	195	LT	RAMP D	10	10	-	-	
2646	9008+51	172	LT	RAMP D	10	10	-	-	
2647	9008+83	169	LT	RAMP D	10	10	-	-	
2612	9008+79	70	RT	RAMP D	8	8	-	-	
2613	9008+98	66	RT	RAMP D	9	9	-	-	
2614	9009+24	59	RT	RAMP D	8	8	-	-	
2615	9010+96	39	RT	RAMP D	11	11	-	-	
2633	9010+97	59	RT	RAMP D	9	9	-	-	
2616	9011+02	40	RT	RAMP D	6	6	-	-	
2617	9011+02	40	RT	RAMP D	8	8	-	-	
2618	9011+13	42	RT	RAMP D	6	6	-	-	
2619	9011+13	42	RT	RAMP D	6	6	-	-	
2634	9011+84	54	RT	RAMP D	6	6	-	-	
2635	9012+06	55	RT	RAMP D	10	10	-	-	
2620	9013+39	44	RT	RAMP D	5	-	-	5	
2621	9013+39	44	RT	RAMP D	5	-	-	5	
2622	9013+39	44	RT	RAMP D	5	-	-	5	
2623	9013+39	44	RT	RAMP D	5	-	-	5	

TOTALS

1313

TREE REMOVAL AND PROTECTION

- T=TRANSPLANTED TREE (COORDINATE WITH REMOVAL AND LANDSCAPING PLANS)
- * IN ACCORDANCE WITH SECTION 201 OF STANDARD SPECIFICATIONS;
 THE COST OF THIS WORK SHALL BE INCLUDED IN THE CONTRACT
 UNIT PRICE FOR EARTHWORK.

1240

1. THE LOCATION OF THE IDOT / WILL COUNTY JURISDICTIONAL INTERFACE IS STA 842+07.

- NOT INCLUDED IN CONTRACT 60X10

LEGEND:

2. ALL TREE REMOVAL TO BE DONE ON AN ADVANCED CONTRACT.

KNI	GHT		
	Engineers	&	Architects

USER NAME = dbarnes	DESIGNED DGB	REVISED -
	DRAWN DGB	REVISED -
PLOT SCALE = 1:20	CHECKED PJO	REVISED -
PLOT DATE = 8/18/2017	DATE 08/25/17	REVISED -

STATE OF ILLINOIS DEPARTMENT OF TRANSPORTATION

	SCHEDULE OF QU	F.A.I/P RTE.	SECTION	COUNTY	TOTAL SHEETS	SHEET NO.
	TREE SCHED	*	(99-1HB-1) R-1	WILL	1508	104
				CONTRACT	NO. 60	0X10
SCALE: NONE	SHEET NO. 3 OF 4 SHEETS	* FAI 55,	FAP 856 ILLINOIS FED. AI	ID PROJECT		

TREE NUMBER STA OFFSET LTIRT STREET SIZE (if 0.15 INITS DIAMETER) DIA	TREE REMOVAL AND PROTECTION WILL COUNTY JURISDICTION LIMITS											
1424 398+95 26.8 RT	I SIA IOFES			LT/RT	STREET	SIZE	(6 TO 15 UNITS	(OVER 15 UNITS	(UNDER 6 UNITS	TEMPORARY FENCE		
1423 398+61 26.3 RT CARLOW 3 -						INCH	UNIT	UNIT	UNIT	FOOT		
1422 399+81 26.3 RT CARLOW 3 -	1424	398+25	26.8	RT	CARLOW	3	-	-	3			
2001	1423		26.3			3	-	-	3			
2004 489+55 0.4 RT RODEO 4 -	1422	398+81	26.3	RT	CARLOW	3	-	-	3			
2002	2001	495+45	37.6	LT	RODEO	6	-	-	-	20		
2005	2004	495+55	0.4	RT	RODEO	4	-	-	4			
2003	2002	495+67	41.4	LT	RODEO	7	-	-	-	20		
2006	2005	495+77	0.4	LT	RODEO	4	-	-	4			
1434	2003	495+80	45.5	RT	RODEO	6	-	-	-	20		
1439 496+31 36.4	2006	495+97	1.9	LT RODEO		2	-	-	2			
1440	1434	496+05	43.3	RT	RODEO	1	-	-	-	20		
1441	1439	496+11					-	-	-			
1435	1440	496+34	39.0	LT	RODEO	7	-	-	-	20		
1436					RODEO	7	-	-	-	20		
1442						1	-	-	-			
1437							-	-	-			
1443			1			1	-	-	-			
1438							-	-		20		
1444							-	-				
1445							-	-		20		
1421 501+37 43.7 LT REMINGTON 12 12 12 - -												
2106 501+62 40.8								-	3			
2107 501+65 40.8								-	-			
2108 502+20 44.5 LT REMINGTON 6 6 6 - - -								-	-			
2109 502+83 42.3 LT REMINGTON 8 8 - - 5 2101 503+43 39.6 RT REMINGTON 5 - - 5 2110 503+87 38.6 RT REMINGTON 8 8 - - 2102 503+87 38.6 RT REMINGTON 5 - - 5 2103 504+27 37.0 RT REMINGTON 8 8 - - 2104 504+69 35.9 RT REMINGTON 6 6 - - 2111 505+02 23.5 LT REMINGTON 6 6 - - 2112 505+16 34.8 RT REMINGTON 6 6 - - 1320 845+31 90.0 RT WEBER RD 4 - - 4 1321 845+66 91.9 RT WEBER RD 4								-	-			
2101 503+43 39.6 RT REMINGTON 5 - - 5 2110 503+53 35.9 LT REMINGTON 8 8 - - 2102 503+87 38.6 RT REMINGTON 5 - - 5 2103 504+27 37.0 RT REMINGTON 8 8 - - 2104 504+69 35.9 RT REMINGTON 8 8 - - 2111 505+02 23.5 LT REMINGTON 6 6 - - 2112 505+33 24.0 LT REMINGTON 6 6 - - 1320 845+31 90.0 RT WEBER RD 4 - - 4 1321 845+66 91.9 RT WEBER RD 4 - - 4 1323 846+33 90.7 RT WEBER RD 4 -<									-			
2110 503+53 35.9 LT REMINGTON 8 8 - - 5 2102 503+87 38.6 RT REMINGTON 5 - - 5 2103 504+27 37.0 RT REMINGTON 8 8 - - 2104 504+69 35.9 RT REMINGTON 8 8 - - 2111 505+02 23.5 LT REMINGTON 6 6 - - 2105 505+16 34.8 RT REMINGTON 6 6 - - 2112 505+33 24.0 LT REMINGTON 6 6 - - 1320 845+31 90.0 RT WEBER RD 4 - - 4 1321 845+66 91.9 RT WEBER RD 4 - - 4 1323 846+33 90.7 RT WEBER RD 4<							8	-	-			
2102 503+87 38.6 RT REMINGTON 5 - - 5 2103 504+27 37.0 RT REMINGTON 8 8 - - 2104 504+69 35.9 RT REMINGTON 8 8 - - 2111 505+02 23.5 LT REMINGTON 6 6 - - 2105 505+16 34.8 RT REMINGTON 6 6 - - 2112 505+33 24.0 LT REMINGTON 6 6 - - 2112 505+33 24.0 LT REMINGTON 6 6 - - 1320 845+31 90.0 RT WEBER RD 4 - - 4 1321 845+66 91.9 RT WEBER RD 4 - - 4 1323 846+33 90.7 RT WEBER RD 4 -<							-	-	5			
2103 504+27 37.0 RT REMINGTON 8 8 -							0	-	-			
2104 504+69 35.9 RT REMINGTON 8 8 - - - 2111 505+02 23.5 LT REMINGTON 6 6 -							Ω	-				
2111 505+02 23.5 LT REMINGTON 6 6 - - - 2105 505+16 34.8 RT REMINGTON 6 6 -								_	_			
2105 505+16 34.8 RT REMINGTON 6 6 - - - 2112 505+33 24.0 LT REMINGTON 6 6 -								_	_			
2112 505+33 24.0 LT REMINGTON 6 6 - - - 1320 845+31 90.0 RT WEBER RD 4 - - 4 1321 845+66 91.9 RT WEBER RD 4 - - - 4 1322 845+97 91.3 RT WEBER RD 4 - - - 4 1323 846+33 90.7 RT WEBER RD 4 - - - 4 1324 846+71 88.9 RT WEBER RD 4 - - - 4 1401 847+10 89.1 RT WEBER RD 4 - - - 4 1402 847+51 88.4 RT WEBER RD 4 - - - 4 1403 847+90 87.2 RT WEBER RD 4 - - - 4 1405 849+10 83.9 RT WEBER RD 4 - - - <td></td>												
1320 845+31 90.0 RT WEBER RD 4 - - 4 1321 845+66 91.9 RT WEBER RD 4 - - 4 1322 845+97 91.3 RT WEBER RD 4 - - 4 1323 846+33 90.7 RT WEBER RD 4 - - 4 1324 846+71 88.9 RT WEBER RD 4 - - 4 1401 847+10 89.1 RT WEBER RD 4 - - 4 1402 847+51 88.4 RT WEBER RD 4 - - 4 1403 847+90 87.2 RT WEBER RD 4 - - 4 1404 848+69 83.2 RT WEBER RD 4 - - 4 1405 849+10 83.9 RT WEBER RD 4 - - 4 1406 849+50 84.6 RT WEBER RD 4									_			
1321 845+66 91.9 RT WEBER RD 4 - - 4 1322 845+97 91.3 RT WEBER RD 4 - - 4 1323 846+33 90.7 RT WEBER RD 4 - - 4 1324 846+71 88.9 RT WEBER RD 4 - - 4 1401 847+10 89.1 RT WEBER RD 4 - - 4 1402 847+51 88.4 RT WEBER RD 4 - - 4 1403 847+90 87.2 RT WEBER RD 4 - - 4 1404 848+69 83.2 RT WEBER RD 4 - - 4 1405 849+10 83.9 RT WEBER RD 4 - - 4 1406 849+50 84.6 RT WEBER RD 4 - - 4 1408 850+32 87.2 RT WEBER RD 5							-	-				
1322 845+97 91.3 RT WEBER RD 4 - - 4 1323 846+33 90.7 RT WEBER RD 4 - - 4 1324 846+71 88.9 RT WEBER RD 4 - - 4 1401 847+10 89.1 RT WEBER RD 4 - - 4 1402 847+51 88.4 RT WEBER RD 4 - - 4 1403 847+90 87.2 RT WEBER RD 4 - - 4 1404 848+69 83.2 RT WEBER RD 4 - - 4 1405 849+10 83.9 RT WEBER RD 4 - - 4 1406 849+50 84.6 RT WEBER RD 4 - - 4 1408 850+32 87.2 RT WEBER RD 5 - - 5							-	-	4			
1323 846+33 90.7 RT WEBER RD 4 - - 4 1324 846+71 88.9 RT WEBER RD 4 - - 4 1401 847+10 89.1 RT WEBER RD 4 - - 4 1402 847+51 88.4 RT WEBER RD 4 - - 4 1403 847+90 87.2 RT WEBER RD 4 - - 4 1404 848+69 83.2 RT WEBER RD 4 - - 4 1405 849+10 83.9 RT WEBER RD 4 - - 4 1406 849+50 84.6 RT WEBER RD 4 - - 4 1407 849+91 85.6 RT WEBER RD 4 - - 4 1408 850+32 87.2 RT WEBER RD 5 - - 5						4	-	-	4			
1401 847+10 89.1 RT WEBER RD 4 - - 4 1402 847+51 88.4 RT WEBER RD 4 - - 4 1403 847+90 87.2 RT WEBER RD 4 - - 4 1404 848+69 83.2 RT WEBER RD 4 - - 4 1405 849+10 83.9 RT WEBER RD 4 - - 4 1406 849+50 84.6 RT WEBER RD 4 - - 4 1407 849+91 85.6 RT WEBER RD 4 - - 4 1408 850+32 87.2 RT WEBER RD 5 - - 5		846+33	90.7	RT		4	-	-	4			
1401 847+10 89.1 RT WEBER RD 4 - - 4 1402 847+51 88.4 RT WEBER RD 4 - - 4 1403 847+90 87.2 RT WEBER RD 4 - - 4 1404 848+69 83.2 RT WEBER RD 4 - - 4 1405 849+10 83.9 RT WEBER RD 4 - - 4 1406 849+50 84.6 RT WEBER RD 4 - - 4 1407 849+91 85.6 RT WEBER RD 4 - - 4 1408 850+32 87.2 RT WEBER RD 5 - - 5	1324	846+71	88.9	RT	WEBER RD	4	-	-	4			
1403 847+90 87.2 RT WEBER RD 4 - - 4 1404 848+69 83.2 RT WEBER RD 4 - - 4 1405 849+10 83.9 RT WEBER RD 4 - - 4 1406 849+50 84.6 RT WEBER RD 4 - - 4 1407 849+91 85.6 RT WEBER RD 4 - - 4 1408 850+32 87.2 RT WEBER RD 5 - - 5		847+10	89.1		WEBER RD	4	-	-	4			
1404 848+69 83.2 RT WEBER RD 4 - - 4 1405 849+10 83.9 RT WEBER RD 4 - - 4 1406 849+50 84.6 RT WEBER RD 4 - - 4 1407 849+91 85.6 RT WEBER RD 4 - - 4 1408 850+32 87.2 RT WEBER RD 5 - - 5	1402	847+51	88.4	RT	WEBER RD	4	-	-	4			
1405 849+10 83.9 RT WEBER RD 4 - - 4 1406 849+50 84.6 RT WEBER RD 4 - - 4 1407 849+91 85.6 RT WEBER RD 4 - - 4 1408 850+32 87.2 RT WEBER RD 5 - - 5	1403	847+90	87.2	RT	WEBER RD	4	-	-	4			
1406 849+50 84.6 RT WEBER RD 4 - - 4 1407 849+91 85.6 RT WEBER RD 4 - - 4 1408 850+32 87.2 RT WEBER RD 5 - - 5	1404	848+69	83.2	RT	WEBER RD	4	-	-	4			
1407 849+91 85.6 RT WEBER RD 4 - - 4 1408 850+32 87.2 RT WEBER RD 5 - - 5	1405	849+10	83.9	RT	WEBER RD	4	-	-	4			
1408 850+32 87.2 RT WEBER RD 5 5	1406	849+50	84.6	RT	WEBER RD	4	-	-	4			
	1407	849+91		RT	WEBER RD	4	-	-	4			
1409 850+71 88.6 RT WEBER RD 5 - - 5		850+32				5	-	-	5			
							-	-				
1410 851+15 89.2 RT WEBER RD 5 5							-	-				
1411 851+55 89.9 RT WEBER RD 5 5								-	5			
1412 851+94 91.7 RT WEBER RD 6 6								-	-			
1413 852+37 86.9 RT WEBER RD 6 6							6	-				
1414 852+83 91.6 RT WEBER RD 4 - 4	1414	852+83	91.6	RT	WEBER RD	4	-	-	4			

TREE NUMBER	STA	OFFSET	LT/RT	STREET	SIZE	TREE REMOVAL (6 TO 15 UNITS DIAMETER)	TREE REMOVAL (OVER 15 UNITS DIAMETER)	*TREE REMOVAL (UNDER 6 UNITS DIAMETER)	TEMPORARY FENCE
					INCH	UNIT UNIT		UNIT	FOOT
1415	853+17	' 89.5 RT		WEBER RD	4	-	-	4	
1416	853+96	90.6	RT	WEBER RD	4	-	-	4	
1417	854+35	88.4	RT	WEBER RD	4	-	-	4	
1418	854+77	87.2	RT			-	-	4	
1419	855+18	87.9	RT	WEBER RD	R RD 4		-	4	
1420	855+57	91.8	RT	WEBER RD	4	4		4	
1425	858+47	70.1	LT	WEBER RD	10	10		-	
1426	859+07	70.2	LT	WEBER RD	10			-	
1427	859+38	69.6	LT	WEBER RD	10			-	
1428	859+66	69.2	LT	WEBER RD	8	8	-	-	
1429	859+84	70.7	LT	WEBER RD	8	8	-	-	
1430	859+91	86.1	LT	WEBER RD	6	6	-	-	
1431	860+35	72.0	LT	WEBER RD			-	-	
1432	860+61	69.2	LT	WEBER RD	8	8	-	-	
1433	860+92	67.9	LT WEBER RD 8		8	8	-	-	
1501	862+56	53.4	LT	WEBER RD	WEBER RD 18 - 18		18	-	
					TOTALS	171	18	134	240

TREE REMOVAL AND PROTECTION WILL COUNTY JURISDICTION LIMITS

* IN ACCORDANCE WITH SECTION 201 OF STANDARD SPECIFICATIONS;
THE COST OF THIS WORK SHALL BE INCLUDED IN THE CONTRACT
UNIT PRICE FOR EARTHWORK.

1. THE LOCATION OF THE IDOT / WILL COUNTY JURISDICTIONAL INTERFACE IS STA 842+07.

2. ALL TREE REMOVAL TO BE DONE ON AN ADVANCED CONTRACT.

	USER NAME = dbarnes	DESIGNED DGB
CUT		DRAWN DGB

	USER NAME = dbarnes	DESIGNED	DGB	REVISED	-
		DRAWN	DGB	REVISED	-
-	PLOT SCALE = 1:20	CHECKED	PJ0	REVISED	-
5	PLOT DATE = 8/18/2017	DATE	08/25/17	REVISED	-

LEGEND:

STATE OF ILLINOIS DEPARTMENT OF TRANSPORTATION

- NOT INCLUDED IN CONTRACT 60X10

	SCHEDULE OF QU	ANTITIES		F.A.I/P RTE.	SI	ECTION		COUNTY	TOTAL	SHEE
	*	(99-	IHB-1) R-1	1	WILL	1508	105			
					CONTRACT	NO. 6	0X10			
SCALE: NONE	SHEET NO. 4 OF 4 SHEETS	STA.	TO STA.	* FAI 55,	FAP 856	ILLINOIS F	ED. AII	PROJECT		

Engineers & Architects

				PAVEMENT -	RECONSTRUC	TION			
FROM STATION	TO STATION	PORTLAND CEMENT CONCRETE PAVEMENT 10 1/4" (JOINTED)	PORTLAND CEMENT CONCRETE SHOULDERS 10 1/4"	BRIDGE APPROACH PAVEMENT CONNECTOR (PCC)	HOT-MIX ASPHALT PAVEMENT (FULL- DEPTH), 8"	HOT-MIX ASPHALT PAVEMENT (FULL- DEPTH), 12 1/4"	HOT-MIX ASPHALT PAVEMENT (FULL- DEPTH), 11"	HOT-MIX ASPHALT SHOULDERS, 12 1/4"	AGGREGATE SUBGRADE IMPROVEMENT 12"
		SQ YD	SQ YD	SQ YD	SQ YD	SQ YD	SQ YD	SQ YD	SQ YD
WEBER ROA	AD		1 7						
790+20	809+63	29225	363						33691
809+63	813+78			640					640
813+78	866+27	58649	228						67115
NORMANTO	WN ROAD	1	ı		l	1		1	
90+79	98+17						4851		5427
104+00	109+39						4199		4908
LAKEVIEW	DRIVE							I	
201+33	202+28				486				539
WINDHAM F	PARKWAY							•	
302+25	307+59						3081		3541
CARLOW D	RIVE							•	•
398+18	398+62				174				210
RAMP A		l						•	
4986+03	4998+00	750				5146		2022	8199
RAMP B	•	•						•	
6003+23	6029+83					6695		4045	11129
3146+48	3153+95					604		832	1519
RAMP C		•	•			•		•	•
3085+43	7997+50	735				3845		1844	6778
RAMP D		•	•					•	•
9003+50	9026+50					3978		2199	6533
1-55			•					•	•
3104+50	3107+99							1145	1149
	TOTAL	89358	591	640	660	20268	12130	12087	151377

·	QUANTITY
	SQ YD
FROM PAVEMENT	
RECONSTRUCTION	151,377
SCHEDULE	
FROM PAVEMENT	
RESURFACING AND	1,984
WIDENING SCHEDULE	
FROM CONCRETE BARRIER	
WALL (SPECIAL) SCHEDULE	447
,	
FROM CONCRETE BARRIER,	
DOUBLE FACE, 42 INCH	36
HEIGHT SCHEDULE	
EDOM CONODETE DADDIED	
FROM CONCRETE BARRIER	34
TRANSITION SCHEDULE	
TOTAL	153,878

Ξ	Fngineers &	Architec
ILE NAME	KNIGHT	
11		
0160		

USER NAME = mmaestra	DESIGNED	PAW	REVISED -	
	DRAWN	PAW	REVISED -	
PLOT SCALE = 1:20	CHECKED	PJ0	REVISED -	
PLOT DATE = 5/13/2017	DATE	05/12/17	REVISED -	

	S	СН	EDI	JLE	OF OU	ANTITIES		F.A.I/P RTE.	SECTION	COUNTY	TOTAL SHEETS	SHEET NO.
	_				WAY IT			*	(99-1HB-1) R-1	WILL	1508	106
										CONTRACT	NO. 6	0X10
SHEET	NO.	1	OF	9	SHEETS	STA.	TO STA.	* FAI 55,	FAP 856 ILLINOIS FED. A	ID PROJECT		

STREET	FROM STATION	OFFSET	TO STATION	OFFSET	QUANT
	STATION		STATION		FOO
WEBER / NORMANTOWN	790+20	41.0 LT	90+72	21.4 RT	17
WEBER / NORMANTOWN	790+20	40.5 RT	107+11	42.9 RT	15
WEBER	792+27	4.0 LT	799+15	13.0 LT	7
WEBER	792+27	4.0 RT	799+15	1.0 RT	7
NORMANTOWN / WEBER / RAMP C	90+69	20.2 LT	7997+85	29.4 RT	15
NORMANTOWN / WEBER / RAMP B	109+36	36.3 LT	6001+46	26.6 RT	15
WEBER	802+98	10.9 RT	804+45	9.1 LT	1
WEBER	802+98	14.7 RT	804+46	32.9 RT	1
RAMP C / WEBER	7997+93	27.3 LT	809+77	103.0 LT	3
RAMP B / WEBER	6003+12	16.1 LT	810+55	35.8 RT	4
WEBER / RAMP D	812+88	103.0 LT	9003+19	30.9 LT	3
WEBER / RAMP A	813+57	36.2 RT	4998+26	28.0 LT	4
RAMP D / WEBER / REM (WEST)	9002+24	6.0 RT	298+20	38.0 RT	21
RAMP A / WEBER / LAKEVIEW	4998+22	28.0 RT	201+35	27.0 RT	6
WEBER	821+27	13.0 LT	836+10	12.0 LT	14
WEBER	821+27	13.0 RT	836+10	1.0 RT	14
LAKEVIEW / WEBER / WINDHAM	201+36	21.0 LT	302+98	36.7 RT	15
REMINGTON (WEST) / WEBER	298+21	38.0 LT	842+07	53.0 LT	5
WINDHAM / WEBER	301+26	37.0 LT	842+07	53.0 RT	5
WEBER	837+48	1.0 LT	842+07	13.0 LT	4
WEBER	837+48	13.0 RT	842+07	13.0 RT	4
NORMANTOWN	96+30	35.7 LT	96+56	55.0 LT	
NORMANTOWN	97+14	55.1 LT	97+38	38.0 LT	
NORMANTOWN	102+94	44.0 RT	103+12	62.6 RT	
NORMANTOWN	103+56	62.6 RT	103+74	44.0 RT	
NORMANTOWN	102+96	38.0 LT	103+19	59.7 LT	
NORMANTOWN	103+58	59.7 LT	103+81	38.0 LT	
WEBER	831+27	53.6 LT	831+83	98.2 LT	
WEBER	832+29	98.6 LT	832+95	53.6 LT	
WEBER	841+33	53.0 RT	841+71	84.9 RT	
WEBER	842+12	53.0 RT	842+45	53.0 RT	
WEBER	839+18	65.1 LT	839+45	92.5 LT	
WEBER	839+99	92.5 LT	840+52	58.1 LT	
WEBER / CARLOW	842+07	53.0 LT	398+18	20.0 RT	6
WEBER / REMINGTON (EAST)	842+07	53.0 RT	503+06	21.0 RT	17
WEBER	842+07	13.0 LT	851+94	13.0 LT	9
WEBER	842+07	13.0 RT	851+94	5.0 LT	9
CARLOW / WEBER / RODEO	395+90	19.4 LT	496+76	34.0 RT	14
RODEO / WEBER	497+75	34.0 LT	872+90	33.6 LT	16
REMINGTON (EAST) / WEBER	503+58	24.5 LT	870+10	41.4 RT	15
WEBER	858+22	3.0 RT	871+35	2.5 LT	13
WEBER	858+22	13.0 RT	871+35	5.5 RT	13
WEBER	872+32	68.6 RT	872+35	74.8 RT	10
WEBER	859+70	65.0 LT	859+95	94.0 LT	+
WEBER	860+25	94.0 LT	860+47	61.2 LT	
	+	J U L /	+		

COMBINA	TION CONCE	RETE CURB 8	& GUTTER T	YPE B-6.12
FROM STATION	OFFSET	TO STATION	OFFSET	QUANTITY
				FOOT
WEBER ROA		707 : 70	400 0 DT	0.4
796+89	98.8 RT	797+70	100.9 RT	81
NORMANTO		104.16	CE C L T	35
104+02	38.6 LT	104+16	65.6 LT	
104+46	65.6 LT	104+65	38.6 LT	38
105+08	38.6 LT	105+26	67.6 LT	40
105+55	67.6 LT	105+74	38.6 LT	40
106+14	44.6 RT	106+42	68.4 RT	41
106+83	68.6 RT	107+11	43.5 RT	42
107+49	38.6 LT	108+21	71.9 LT	79
108+85	71.6 LT	109+36	36.3 LT	64
107+11	42.9 RT	109+39	36.2 RT	237
109+36	36.3 LT	109+39	36.4 LT	3
107+08	4.9 RT	108+34	2.8 LT	258
108+94	4.0 LT	110+79	3.1 LT	373
LAKEVIEW	DRIVE			•
201+35	27.0 RT	202+28	27.0 RT	93
201+36	21.0 LT	204+46	19.3 LT	310
201+26	28.0 RT	201+40	45.7 RT	26
201+78	45.8 RT	201+91	27.0 RT	27
202+89	26.8 RT	202+94	39.4 RT	15
203+29	39.2 RT	203+34	24.7 RT	16
204+17	22.3 RT	204+35	38.6 RT	25
204+17	37.9 RT	204+75	21.2 RT	21
205+68	21.4 RT	204+73	28.4 RT	17
205+66	21.4 K1	205+64	20.4 KT	17
DEMINISTO	N POLII EVA	RD / WINDHA	M DADKW	\ <u>\</u>
302+98	36.7 RT	308+59	18.9 RT	556
	37.0 LT	307+59		639
301+26			19.0 LT	
302+86	38.4 RT	303+15	68.6 RT	48
303+43	66.9 RT	303+66	35.7 RT	45
304+21	32.3 LT	304+30	50.7 LT	23
304+55	49.5 LT	304+67	29.2 LT	25
307+55	19.1 RT	307+89	44.6 RT	45
308+24	45.1 RT	308+58	18.8 RT	48
CARLOW D	RIVE			
397+55	19.9 LT	397+78	42.6 LT	36
398+06	42.6 LT	398+28	19.8 LT	36
RODEO DRI	VE / REMING	GTON BOUL	EVARD	
501+58	24.5 RT	502+13	68.5 RT	79
502+21	28.6 RT	502+45	28.6 RT	76
502+55	68.6 RT	503+17	21.6 RT	84
503+06	21.0 RT	505+72	19.0 RT	264
503+58	24.5 LT	505+72	19.0 LT	215
503+42	27.3 LT	503+91	55.9 LT	60
503+94	30.4 LT	504+24	29.6 LT	92
504+29	55.7 LT	504+76	21.6 LT	62
551.20	33.7 L1	531:70	_1.0 _1	<u> </u>
	<u> </u>	l	TOTAL	4316
			· UIAL	1 -1010

COMBINA	TION CONCE	RETE CURB 8	& GUTTER T	YPE B-6.18
FROM STATION	OFFSET	TO STATION	OFFSET	QUANTITY
				FOOT
REMINGTO	BOULEVA	RD / WINDHA	M PARKWA	Y
294+63	CTR	295+46	3.8 LT	172.5
297+63	1.5 LT	298+60	1.5 LT	97.0
297+63	10.6 LT	298+60	10.5 LT	97.0
301+09	10.5 RT	303+77	10.5 RT	266.5
301+09	1.5 RT	303+77	4.1 RT	267.0
			TOTAL	900.0

COMBINA	TION CONCE	RETE CURB 8	& GUTTER T	YPE B-9.24
FROM	OFFSET	то	OFFSET	QUANTITY
STATION	OFFSET	STATION	OFFSET	QUANTITI
				FOOT
WEBER RO	AD			
804+45	9.1 LT	805+75	3.8 LT	274
806+60	161.4 LT	806+67	161.7 LT	426
805+41	62.8 RT	808+80	63.7 RT	355
805+43	69.8 RT	808+81	68.6 RT	396
807+36	23.9 LT	809+87	57.0 LT	256
807+41	11.3 LT	810+23	25.0 LT	287
813+42	57.0 LT	815+99	37.8 LT	259
813+25	25.0 LT	816+03	23.6 LT	282
815+21	108.2 LT	817+72	91.4 LT	337
815+21	101.5 LT	817+72	84.2 LT	263
817+23	132.9 RT	817+30	132.9 RT	504
817+67	30.0 LT	821+27	13.0 LT	736
			TOTAL	4374



USER NAME = mmaestra	DESIGNED	PAW	REVISED -
	DRAWN	PAW	REVISED -
PLOT SCALE = 1:20	CHECKED	PJ0	REVISED -
PLOT DATE = 5/13/2017	DATE	05/12/17	REVISED -

SCHEDULE	OF OU	ANTITIES		F.A.I/P RTE.	SECTION	COUNTY	TOTAL SHEETS	SHEET NO.
	WAY IT			*	(99-1HB-1) R-1	WILL	1508	107
						CONTRACT	NO. 6	0X10
SCALE: NONE SHEET NO. 2 OF 9	SHEETS	STA.	TO STA.	* FAI 55,	FAP 856 ILLINOIS FED. AI	D PROJECT		

SLEEPER SLAB						
LOCATION	QUANTITY					
	FOOT					
WEBER / NORMANTOWN (WEST)	150					
WEBER / NORMANTOWN (EAST)	170					
WEBER / RAMP C (SOUTH)	74					
WEBER / RAMP C (NORTH)	60					
WEBER (STA 806+00)	75					
WEBER (STA 807+00)	71					
WEBER / RAMP B (SOUTH)	22					
WEBER / RAMP B (NORTH)	16					
WEBER / RAMP D (SOUTH)	16					
WEBER / RAMP D (NORTH)	18					
WEBER (816+50)	79					
WEBER (817+25)	93					
WEBER / RAMP A (SOUTH)	56					
WEBER / RAMP A (NORTH)	64					
WEBER / LAKEVIEW	125					
WEBER / REMINGTON (WEST)	173					
WEBER / WINDHAM	176					
WEBER / CARLOW	140					
WEBER / RODEO	170					
WEBER / REMINGTON (EAST)	144					
TOTAL	1892					

PROTECTIVE COAT	
LOCATION	QUANTITY
	SQ YD
PORTLAND CEMENT CONCRETE PAVEMENT 10 1/4" (JOINTED)	89,358
BRIDGE APPROACH PAVEMENT CONNECTOR (PCC)	640
COMBINATION CONCRETE CURB AND GUTTER, TYPE B-6.24	10,647
COMBINATION CONCRETE CURB AND GUTTER, TYPE B-6.12	997
COMBINATION CONCRETE CURB AND GUTTER, TYPE B-6.18	258
COMBINATION CONCRETE CURB AND GUTTER, TYPE B-9.24	1,619
CONCRETE BARRIER WALL (SPECIAL)	771
CONCRETE BARRIER, DOUBLE FACE, 42 INCH HEIGHT	54
CONCRETE BARRIER TRANSITION	121
CONCRETE MEDIAN SURFACE, 4 INCH	68
CONCRETE MEDIAN SURFACE, 6 INCH	284
CONCRETE MEDIAN, TYPE SB-6.12	157
CONCRETE MEDIAN, TYPE SB-6.18	89
CONCRETE MEDIAN, TYPE SB-6.24	349
CONCRETE MEDIAN, TYPE SB-9.24	165
CONCRETE MEDIAN, TYPE SM-4.24	107
CONCRETE MEDIAN, TYPE SB (SPECIAL)	1,003
PORTLAND CEMENT CONCRETE SIDEWALK, 5 INCH	9,057
PORTLAND CEMENT CONCRETE SIDEWALK, 8 INCH	523
PORTLAND CEMENT CONCRETE SHOULDERS 10 1/4"	591
TOTAL	116,858

USER NAME = mmaestra	DESIGNED	PAW	REVISED	-
	DRAWN	PAW	REVISED	-
PLOT SCALE = 1:20	CHECKED	PJ0	REVISED	-
PLOT DATE = 5/13/2017	DATE	05/12/17	REVISED	-

		SCHEDULE OF QU	ANTITIE	:s	F.A.I/P RTE.	SECTION	COUNTY	TOTAL SHEETS	SHEET NO.
l		ROADWAY IT			*	(99-1HB-1) R-1	WILL	1508	108
ļ							CONTRACT	NO. 6	0X10
	SCALE: NONE	SHEET NO. 3 OF 9 SHEETS	STA.	TO STA.	* FAI 55,	FAP 856 ILLINOIS FED, AI	D PROJECT		

		PAVEMENT	- RESURFAC	CING AND WIDEN	IING	
FROM STATION	TO STATION	HOT-MIX ASPHALT BASE COURSE, 8 3/4"	HOT-MIX ASPHALT BASE COURSE WIDENING, 8 3/4"	POLYMERIZED LEVELING BINDER (MACHINE METHOD), IL-4.75, N50	HOT-MIX ASPHALT SURFACE COURSE, MIX D, N70	AGGREGATE SUBGRADE IMPROVEMENT 12"
		SQ YD	SQ YD	TON	TON	SQ YD
WEBER						
866+27	871+78			137	274	883
NORMANTO	WN ROAD					
90+79	91+61	11	23	16	30	69
108+22	108+83			10	20	69
109+39	112+71	44	149	98	195	362
LAKEVIEW	DRIVE					
202+28	202+32			1	2	
REMINGTO	N BOULEVA	RD / WINDHAM	PARKWAY			
296+06	298+20			60	120	
307+59	307+63				2	
CARLOW D	RIVE					
398+13	398+18			1	2	
RODEO DRI	VE					
495+39	497+75	318	44	64	129	503
REMINGTO	N BOULEVAR	L RD				
501+71	505+72		96	82	165	166
	TOTAL	373	312	469	937	2,053

	BITUMINOUS MATERIALS (TA	ACK COAT)
PAY CODE		QUANTITY
(USEAGE)		POUND
40700100	FROM PAVEMENT	
(F-D PAVEMENT)	RECONSTRUCTION	30324
. ,	SCHEDULE	
40600290	FROM PAVEMENT	
(RESURFACING &	RESURFACING AND	7779
WIDENING)	WIDENING SCHEDULE	
400000	FROM DRIVEWAY	507
4080029 (INCIDENTAL	SCHEDULE	507
•	FROM SHARED-USE PATH	
'	SCHEDULE	911

KNIGHT
Engineers & Archite

USER NAME = mmaestra	DESIGNED	PAW	REVISED -
	DRAWN	PAW	REVISED -
PLOT SCALE = 1:20	CHECKED	PJ0	REVISED -
PLOT DATE = 5/13/2017	DATE	05/12/17	REVISED -

	SCHEDULE OF QU	ANTITIE	s	F.A.I/P RTE.	SECTION	COUNTY	TOTAL SHEETS	SHEET NO.
	ROADWAY IT			*	(99-1HB-1) R-1	WILL	1508	109
						CONTRACT	NO. 6	0X10
SCALE: NONE	SHEET NO. 4 OF 9 SHEETS	STA.	TO STA.	* FAI 55,	FAP 856 ILLINOIS FED, AI	ID PROJECT		

	SIDEWALK								
			WILL	COUNTY JURI	SDICATIONAL	LIMITS			
	VILLAGE OF ROMEOVILLE CORPORATE LIMITS (20% ROMEOVILLE, 80% STP URBAN)					СО	BROOK IITS ITY)		
ROADWAY	FROM STATION ST	TO STATION	LT/RT	PORTLAND CEMENT CONCRETE SIDEWALK 5 INCH	PORTLAND CEMENT CONCRETE SIDEWALK 8 INCH	DETECTABLE WARNINGS	PORTLAND CEMENT CONCRETE SIDEWALK 5 INCH	PORTLAND CEMENT CONCRETE SIDEWALK 8 INCH	DETECTABLE WARNINGS
				SQ FT	SQ FT	SQ FT	SQ FT	SQ FT	SQ FT
Carlow Drive	398+18	399+18	RT				513		
Carlow Drive	396+82	397+77	LT				483		10.0
Carlow Drive	397+77	398+06	LT					132	
Carlow Drive	398+06	399+16	LT				598		10.0
Rodeo Drive	497+22	499+01	RT				891		
Rodeo Drive	497+17	498+98	LT				914		
Remington Blvd (East)	500+81	501+99	RT	645		11.4			
Remington Blvd (East)	501+99	502+25	RT		129				
Remington Blvd (East)	502+25	502+42	RT	88		20.0			
Remington Blvd (East)	502+42	502+74	RT		159				
Remington Blvd (East)	502+74	503+25	RT	253		11.8			
Remington Blvd (East)	500+81	503+25	LT				1269		
Weber Road	842+07	847+42	LT				2675		10.6
Weber Road	842+24	856+82	RT	7292		23.7			
Weber Road	848+20	856+92	LT				4424		22.3
Weber Road	857+82	872+34	RT				7331		33.1
Weber Road	858+17	858+22	MEDIAN				53		20.0
Weber Road	857+84	859+89	LT				1143		31.0
Weber Road	859+89	860+29	LT					186	
Weber Road	860+29	877+41	LT				8604		10.5
	TOTAL			8278	288	66.9	28898	318	147.5
ROUND	ED SCHEDUI	E TOTAL		8278	288	67	28898	318	148

NOTES:

1. THE LOCATION OF THE IDOT / WILL COUNTY JURISDICTIONAL INTERFACE IS STA 842+07.

KNIGHT		
Engineers	&	Architects

USER NAME = mmaestra	DESIGNED	PAW	REVISED -
	DRAWN	PAW	REVISED -
PLOT SCALE = 1:20	CHECKED	PJ0	REVISED -
PLOT DATE = 5/13/2017	DATE	05/12/17	REVISED -

SCALE:

SCHEDULE OF QUANTITIES SIDEWALK RTE. SECTION SHEETS * (99-1HB-1) R-1 WILL 1508	
CONTRACT NO. CO	110
	0X10
NONE SHEET NO. 5 OF 9 SHEETS STA. TO STA. # FAI 55, FAP 856 ILLINOIS FED. AID PROJECT	

SHARED USE PATH												
			I		I IDOI JU	JRISDICATION	AL LIMITS	OLIA DED	UOE DATU			
								OF ROMEOVIL	USE PATH .LE CORPORAT ROMEOVILLE)			
ROADWAY	FROM STATION	TO STATION	LT/RT	AREA (SQ YD)	HOT-MIX ASPHALT SURFACE COURSE, MIX "D", N50 TON	HOT-MIX ASPHALT BINDER COURSE, IL- 19.0, N50 TON	SUBBASE GRANULAR MATERIAL, TYPE B 6"	BITUMINOUS MATERIALS (PRIME COAT)	BITUMINOUS MATERIALS (TACK COAT) 40800029 POUND	PORTLAND CEMENT CONCRETE SIDEWALK 5 INCH SQ FT	PORTLAND CEMENT CONCRETE SIDEWALK 8 INCH SQ FT	DETECTABLE WARNINGS SQ FT
Normantown Rd	100+80	103+11	RT	219			219			1945		43
Normantown Rd	103+11	103+57	RT	37							331	
Normantown Rd	103+57	103+84	RT	14	1.2	2.0	14	32.3	3.2			16
Normantown Rd	106+13	106+23	RT	8	0.6	1.1	8	17.0	1.7			
Normantown Rd	106+23	106+41	RT	21			21			189		18
Normantown Rd	106+41	106+85	RT	50							446	
Normantown Rd	106+85	107+01	RT	18			18			163		20
Normantown Rd	107+01	108+20	RT	141	11.8	19.7	141	317.3	31.7			
Lakeview Dr	200+99	201+26	RT	26	2.1	3.6	26	57.5	5.8			
Lakeview Dr	201+26	201+40	RT	17			17			153		16
Lakeview Dr	201+40	201+78	RT	34			1,			100	302	10
Lakeview Dr	201+78	201+94	RT	14			14			129	552	16
Lakeview Dr	201+94	202+80	RT	76	6.4	10.7	76	172.0	17.2	129		10
Lakeview Dr	201+94	202+80	RT	13	0.4	10.7	13	172.0	17.2	120		16
Lakeview Dr	202+60	202+94	RT	30			14			120	272	10
Lakeview Dr	202+94	203+30		13			14			121	212	16
			RT			0.0	0.4	100.0	40.0	121		10
Lakeview Dr	203+44	204+12	RT	61	5.2	8.6	61	138.3	13.8			
Lakeview Dr	204+12	204+32	RT	15			15			134		20
Lakeview Dr	204+32	204+68	RT	32							290	
Lakeview Dr	204+68	204+86	RT	19			20			173		16
Lakeview Dr	204+86	205+59	RT	65	5.5	9.1	65	146.0	14.6			
Lakeview Dr	205+59	205+86	RT	19			19			168		18
Windham Pkwy	301+16	304+20	LT	271	22.7	37.9	302	608.8	60.9			
Windham Pkwy	304+20	304+30	LT	7			7			66		12
Windham Pkwy	304+30	304+56	LT	17							157	
Windham Pkwy	304+56	304+66	LT	8			8			71		12
Windham Pkwy	304+66	305+30	LT	41	3.4	5.7	41	91.5	9.2			
Weber Rd	790+20	799+16	LT	1,054	88.5	147.5	1054	2370.8	237.1			
Weber Rd	799+16	799+27	CT	15			15			138		40
Weber Rd	799+16	799+47	LT	42			42			377		43
Weber Rd	800+55	801+01	LT	52			52			465		27
Weber Rd	801+01	805+37	LT	485	40.8	68.0	485	1092.3	109.2			
Weber Rd	805+37	805+50	LT	13			13			116		22
Weber Rd	805+83	806+88	LT	118			118			1064		52
Weber Rd	807+37	810+08	LT	315			315			2835		43
Weber Rd	813+12	816+02	LT	331			332			2950		49
Weber Rd	816+57	818+07	RT	177			177			1597		55
Weber Rd	818+40	818+65	RT	23			24			211		23
Weber Rd	818+65	822+99	RT	486	40.8	68.1	486	1093.8	109.4			
Weber Rd	822+99	823+31	RT	43	13.5	55.1	42	1.550.0	155.4	375		28
Weber Rd	824+03	824+30	RT	26			25			233		25
Weber Rd	824+30	836+07	RT	1,321	111.0	184.9	1321	2972.3	297.2	200		25
Weber Rd			RT	24	111.0	104.8	24	2912.3	291.2	217		20
Weber Rd	836+07 837+27	836+31 837+50	RT	31			24			270		20 20
vvener ra	031721	037+30	Ki	31						210		20
		6114	DED HET T	ATH TOTAL O	240.4	ECC 0	ECAA	0100 5	011.0	14200	4700	686
		эпа		PATH TOTALS NDED TOTALS		566.8 567	5644 5644	9109.5 9110	911.0 911	14280 14280	1798 1798	686


NO SHARED-USE PATH WITHIN WILL COUNTY JURISDICTION

NOTES:

1. THE LOCATION OF THE IDOT / WILL COUNTY JURISDICTIONAL INTERFACE IS STA 842+07.



USER NAME = mmaestra	DESIGNED	PAW	REVISED -
	DRAWN	PAW	REVISED -
PLOT SCALE = 1:20	CHECKED	PJ0	REVISED -
PLOT DATE = 5/13/2017	DATE	05/12/17	REVISED -

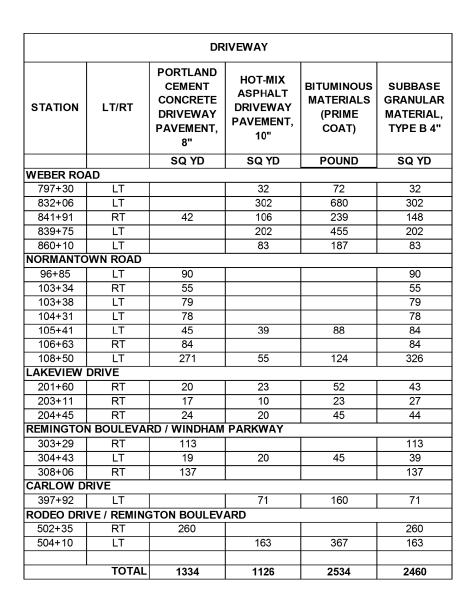

	CHAIN LINK FENCE											
FROM STATION	OFFSET	TO STATION	OFFSET	CHAIN LINK FENCE, 4'	CHAIN LINK FENCE, 6' (SPECIAL)							
				FOOT	FOOT							
WEBER R	OAD											
810+08	45 LT	810+17	37 LT		12							
813+18	45 LT	813+18	37 LT		9							
RAMP B												
6016+09	80 RT	3130+38	90 RT	1153								
RAMP C												
7993+42	88 RT	7994+09	95 RT	116								
RAMP D		•										
9014+70	37 RT	9020+30	38 RT	560								
			TOTAL	1829	21							

	CONCRETE GUTTER, TYPE B									
FROM STATION	OFFSET	TO STATION	OFFSET	QUANTITY						
				FOOT						
WEBER R	WEBER ROAD (SB)									
1803+35	71.0 LT	1805+17	114.0 LT	231						
I-55										
3105+79	67.8 RT	3106+90	69.5 RT	111						
3106+54	67.7 LT	3107+52	67.7 LT	100						
			TOTAL	442						

KNIGHT

Engineers & Architects

USER NAME = mmaestra	DESIGNED	PAW	REVISED -
	DRAWN	PAW	REVISED -
PLOT SCALE = 1:20	CHECKED	PJ0	REVISED -
PLOT DATE = 5/13/2017	DATE	05/12/17	REVISED -

	SCHEDULE OF QUANTITIES						S	F.A.I/P RTE.	SECTION	COUNTY	TOTAL SHEETS	SHEET NO.	
	ROADWAY ITEMS						*	(99-1HB-1) R-1	WILL	1508	112		
HOADWAT TIEMO									•	CONTRACT NO. 60X10			
SHEET	NO.	7	OF	9	SHEETS	STA.	TO STA.	* FAI 55,	FAP 856 ILLINOIS FED. A	AID PROJECT			

	GUARDRAIL SCHEDULE												
FROM STA	TO STA	OFFSET LT/RT	LENGTH OF BARRIER (WITH TERMINALS)	ROADWAY	JURISDICTION	BEAM GUARDRAIL, TYPE A, 6	STEEL PLATE BEAM GUARDRAIL, TYPE A, 9 FOOT POSTS	TRAFFIC BARRIER TERMINAL, TYPE 1 (SPECIAL) TANGENT	TRAFFIC BARRIER TERMINAL, TYPE 1 (SPECIAL) FLARED	TRAFFIC BARRIER TERMINAL, TYPE 2	TRAFFIC BARRIER TERMINAL, TYPE 6	TERMINAL MARKER - DIRECT APPLIED	GUARDRAIL REFLECTORS, TYPE A
						FOOT	FOOT	EACH	EACH	EACH	EACH	EACH	EACH
1813+75.0	1815+43.0	RT	168.0	WEBER RD (SB)	IDOT	-	75.0	1	-	-	1	-	4
2808+61.0	2810+04.0	LT	143.0	WEBER RD (NB)	IDOT		50.0	-	1	-	1	1	4
6015+70.0	6029+83.0	RT	1413.0	RAMP B / I-55 (NB)	IDOT	1362.5	-	1	-	(Meet Existing)	-	1	18
4982+75.5	4985+13.0	RT	237.5	RAMP A / I-55 (SB)	IDOT	175.0	-	1	-	1	-	1	4
3103+32.0	3106+82.0	RT	350.0	I-55 (NB)	IDOT	287.5	-	1	-	1	-	1	4
3106+41.0	3110+66.0	LT	425.0	I-55 (SB)	IDOT	362.5	-	1	-	1	-	1	5
3146+35.5	3151+73.0	RT	537.5	I-55 (NB)	IDOT	525.0	-	(Meet Existing)	=	1	-	1	7
			PROJECT TO	OTAL		2712.5	125.0	5	1	4	2	6	46

	IMPACT ATTENUATORS										
STA	STA OFFSET ROA		JURISDICTION	IMPACT ATTENUATORS (FULLY REDIRECTIVE, NARROW), TEST LEVEL 2	IMPACT ATTENUATORS (SEVERE USE, WIDE), TEST LEVEL 2						
				EACH	EACH						
803+69	LT	WEBER RD (NB)	IDOT	-	1						
808+66	MED	WEBER RD (NB)	IDOT	1	-						
813+49	MED	WEBER RD (NB)	IDOT	1	-						
	PF	ROJECT TOTAL	2	1							

SEGMENTAL CONCRETE BLOCK WALL										
NO.	FROM STATION	OFFSET	TO STATION	OFFSET	QUANTITY					
					SQ FT					
	WEBER R	OAD								
WALL NO. 1	799+06	90.0' RT	799+31	118.3' RT	206					
WALL NO. 2	830+90	69.6' LT	831+60	69.6' LT	280					
WALL NO. 3	833+10	69.6' LT	834+25	69.6' LT	345					
	•	•		TOTAL	831					

KNIGHT	
Engineers &	Architects

USER NAME = mmaestra	DESIGNED	MJM	REVISED	-
	DRAWN	MJM	REVISED	-
PLOT SCALE = 1:20	CHECKED	PJ0	REVISED	-
PLOT DATE = 5/13/2017	DATE	05/12/17	REVISED	-

SCHEDULE OF QUANTITIE		F.A.I/P RTE.	SECTION	COUNTY	TOTAL SHEETS	SHEET NO.
ROADWAY ITEMS		*	(99-1HB-1) R-1	WILL	1508	113
				CONTRACT	NO. 6	0X10
SHEET NO. 8 OF 9 SHEETS STA.	TO STA.	* FAI 55,	FAP 856 ILLINOIS FED. AI	D PROJECT		

CONCRETE BARRIER WALL (SPECIAL)										
FROM STATION	OFFSET	TO STATION	OFFSET	CONCRETE BARRIER WALL (SPECIAL)	AGGREGATE SUBGRADE IMPROVEMENT 12"	PARAPET RAILING				
				FOOT	SQ YD	FOOT				
WEBER R	OAD									
803+31	86.9 LT	805+54	109.4 LT	226	115	226				
808+66	41.6 LT	810+02	57.0 LT	137	67	137				
813+11	57.0 LT	815+05	38.0 LT	195	91	158				
WEBER R	OAD / RO	DEO DRIV	E							
853+75	74.1 LT	498+53	65.3 RT	347	174	347				
			TOTAL	905	447	868				

CONCRETE BARRIER, DOUBLE FACE, 42 INCH HEIGHT											
	CONCRETE AGGREGATE										
FROM STATION	OFFSET	TO STATION	OFFSET	BARRIER	SUBGRADE						
			OFFSLI	WALL	IMPROVEMENT						
				(SPECIAL)	12"						
				FOOT	SQ YD						
WEBER R	OAD										
803+81	20.7 RT	804+29	20.7 RT	49	36						
			TOTAL	49	36						

	CONCRETE BARRIER TRANSITION										
FROM STATION	OFFSET TO STATION		OFFSET	CONCRETE BARRIER WALL (SPECIAL)	AGGREGATE SUBGRADE IMPROVEMENT 12"						
				FOOT	SQ YD						
I-55											
3105+21	0.0	3105+51	0.0	30	12						
3106+04	0.0	3106+28	0.0	24	10						
3106+96	0.0	3107+26	0.0	30	12						
		•	TOTAL	84	34						

AGGR	EGATE SHOU	ILDERS, TYPI	E B 10"
FROM TO STATION		LT/RT/CT	QUANTITY
			SQ YD
WEBER ROA	D	•	•
808+06	809+77	LT	74
813+57	815+78	RT	77
RAMP A			
4980+12	4998+22	RT	431
4989+77	4998+26	LT	191
RAMP B			
6003+12	6013+88	LT	239
6001+46	6029+83	RT	755
RAMP C			
7981+30	7997+85	RT	398
7987+90	7997+93	LT	225
RAMP D			
9003+19	9013+41	LT	225
9002+24	9026+08	RT	530
I-55			
3102+98	3107+06	RT	351
3105+46	3111+01	LT	380
3146+31	3153+95	RT	215
		TOTAL	4091

SUBBASE GRANULAR MATERIAL, TYPE B 6"									
FROM STATION	TO STATION	LT/RT/CT	QUANTITY						
			SQ YD						
WEBER RO	WEBER ROAD - CONCRETE MEDIAN SURFACE, 6"								
802+98	804+46	RT	284						
RODEO DRI	VE / REMINO	STON BOULE	EVARD - UNDER PORK CHOP ISLANDS -						
CONCRETE	MEDIAN SU	RFACE, 4"							
502+21	502+45	RT	12						
502+28	502+39	RT	8						
503+94	504+24	LT	48						
FROM SHAI	RED-USE PA	TH SCHEDU	LE						
			5644						
		TOTAL	5996						

KNIGHT		
Engineers	&	Architects

USER NAME = mmaestra	DESIGNED	PAW	REVISED -
	DRAWN	PAW	REVISED -
PLOT SCALE = 1:20	CHECKED	PJ0	REVISED -
PLOT DATE = 5/13/2017	DATE	05/12/17	REVISED -

	SCHEDULE OF QU	F.A.I/P RTE.	SECTION	COUNTY	TOTAL SHEETS	SHEET NO.		
	ROADWAY IT	*	(99-1HB-1) R-1	WILL	1508	114		
						CONTRACT	NO. 6	0X10
SCALE: NONE	SHEET NO. 9 OF 9 SHEETS	STA.	TO STA.	* FAI 55,	FAP 856 ILLINOIS FED, AI	D PROJECT		

KNIGHT

	USER NAME = mmaestra	DESIGNED DGB	REVISED -	
IGHT		DRAWN DGB	REVISED -	
	PLOT SCALE = 1:20	CHECKED PJO	REVISED -	
Engineers & Architects	PLOT DATE = 5/13/2017	DATE 05/12/17	REVISED -	

STATE OF ILLINOIS DEPARTMENT OF TRANSPORTATION

SCHEDULE OF QUANTITIES EROSION CONTROL (TEMPORARY DRAINAGE) ITEMS											
	SCALE:	NONE		SHEET	NO.	1	OF	4	SHEETS	STA.	TO STA.

F.A.I/P RTE.	SECTION			COUNTY	TOTAL SHEETS	SHEE NO.
*	(99-1HB-1) R-1			WILL	1508	115
				CONTRACT	NO. 6	50X10
* FAI 55,	FAP 856 IL	LINOIS FED.	AID	PROJECT		

			TEMPORARY INLETS			TEMPORARY CATCH BASINS		TEMPORARY MANHOLES		
STATION	OFFSET (FEET)	LT/RT	FRAME & GRATE	QUANTITY (EACH)	DIAMETER (FEET)	FRAME & LID	QUANTITY (EACH)	DIAMETER (FEET)	FRAME & GRATE	QUANTITY (EACH)
EBER RD								4	TYPE 1 FRAME OPEN LID	1
791+50	34	RT						4	TYPE I FRAME OPEN LID	1
792+00	58	RT	TYPE 1 FRAME OPEN LID	1						
793+85	55	RT			4	TYPE 1 FRAME OPEN LID	1			
794+00 794+62	70 55	RT RT			4 4	TYPE 8 GRATE TYPE 1 FRAME OPEN LID	1 1			
797+29	80	RT	TYPE 1 FRAME OPEN LID	1			·			
800+70	69	RT			4	TYPE 1 FRAME OPEN LID	1			
803+50 806+62	95 63	RT RT	TYPE 1 FRAME OPEN LID	1	4	TYPE 8 GRATE	1			
808+64	48	RT	THE THOUSE OF ENERS	'	4	TYPE 1 FRAME OPEN LID	1			
817+22	46	RT	TYPE 1 FRAME OPEN LID	1						
820+12 822+72	51 52	RT RT	TYPE 1 FRAME OPEN LID	1	4	TYPE 1 FRAME OPEN LID	1			
325+87	52	RT	TYPE 1 FRAME OPEN LID	1	7	THE THOME OF ENGLIS	1			
27+87	52	RT	TYPE 1 FRAME OPEN LID	1						
30+56	61	RT	TYPE 1 FRAME OPEN LID	1						
332+73 335+05	65 80	RT RT	TYPE 1 FRAME OPEN LID TYPE 1 FRAME OPEN LID	1 1						
37+57	79	RT	TYPE 1 FRAME OPEN LID	1						
342+90	61	RT						4	TYPE 1 FRAME CLOSED LID	1
343+00	57 52	RT	TYPE 1 FRAME OPEN LID	1		TVDE 4 EDAME OPENING				
345+59 346+79	52 39	RT RT			4	TYPE 1 FRAME OPEN LID	1	7	TYPE 1 FRAME CLOSED LID	1
347+00	39	RT						7	TYPE 1 FRAME CLOSED LID TYPE 1 FRAME CLOSED LID	1
348+29	53	RT	TYPE 1 FRAME OPEN LID	1						
353+49	75	RT	TYPE 1 FRAME OPEN LID	1						
55+98	80	RT			4	TYPE 1 FRAME OPEN LID	1			
56+62	97	RT	TYPE 1 FRAME OPEN LID	1						
57+86	78	RT	TYPE 1 FRAME OPEN LID	1						
60+54	69	RT	TYPE 1 FRAME OPEN LID	1						
363+00 365+75	64 57	RT RT	TYPE 1 FRAME OPEN LID TYPE 1 FRAME OPEN LID	1 1						
RMANTOWN		1	777 E 777 O WIL OF EIT EID	·						
93+77	33	RT	TYPE 1 FRAME OPEN LID	1						
95+40 98+80	38 38	RT RT	TYPE 1 FRAME OPEN LID TYPE 1 FRAME OPEN LID	1 1						
EVIEW DR		KI	TI FE I FRAINE OFEN LID	1						
203+76	23	LT	TYPE 1 FRAME OPEN LID	1						
	LVD / WINDH									
305+88	27 EMINGTON B	RT	TYPE 1 FRAME OPEN LID	1						
498+03	36	RT			4	TYPE 1 FRAME OPEN LID	1			
499+03	36	RT	TYPE 1 FRAME OPEN LID	1						
506+18	23	RT	TYPE 1 FRAME OPEN LID	1						
1P D 017+50	26	RT			4	TYPE 8 GRATE	1			
					7	2 5 010112	·			
GE-1										
BER RD 304+54	1	RT						4	TYPE 1 FRAME CLOSED LID	1
306+37	3	LT						4	TYPE 1 FRAME CLOSED LID	1
307+67	25	LT						4	TYPE 1 FRAME CLOSED LID	1
315+04		_ T						4	TYPE 1 FRAME CLOSED LID	1
317+00 317+22	24 15	LT LT						4 4	TYPE 1 FRAME CLOSED LID TYPE 1 FRAME CLOSED LID	1 1
317+22	44	LT						4	TYPE 1 FRAME CLOSED LID	1
318+95	22	LT			4	TYPE 1 FRAME OPEN LID	1			
45+82	6	LT						4 7	TYPE 1 FRAME CLOSED LID	1
46+79 46+85	6 10	LT LT		 				4	TYPE 1 FRAME CLOSED LID TYPE 1 FRAME CLOSED LID	1 1
47+00	7	LT						7	TYPE 1 FRAME CLOSED LID	1
56+00	9	LT						4	TYPE 1 FRAME CLOSED LID	1
60+48	4	RT						5	TYPE 1 FRAME CLOSED LID	1
62+68 63+00	2 2	RT RT						4 4	TYPE 1 FRAME CLOSED LID TYPE 1 FRAME CLOSED LID	1 1
65+04	4	RT						4	TYPE 1 FRAME CLOSED LID	1
365+73	2	RT						4	TYPE 1 FRAME CLOSED LID	1
MP B 0006+74	40	RT						4	TYPE 1 FRAME CLOSED LID	1
0006+74 MP D	40	KI						4	TIFE I FRAINE GLUSED LID	1
000+54	62	RT						4	TYPE 1 FRAME CLOSED LID	1
000+75	103	RT						4	TYPE 1 FRAME CLOSED LID	1
001+08	67	RT						4	TYPE 1 FRAME CLOSED LID	1

FRAME AND GRATE ADJUSTMENTS FOR M.O.T.										
ALIGNMENT	STATION	OFFSET LT / RT	INLETS TO BE ADJUSTED	INLETS TO BE ADJUSTED WITH NEW TYPE 1 FRAME, CLOSED LID EACH	CATCH BASINS TO BE ADJUSTED	TO BE ADJUSTED WITH NEW	CATCH BASINS TO BE ADJUSTED WITH NEW TYPE 1 FRAME, CLOSED LID EACH	MANHOLES TO BE ADJUSTED	MANHOLES TO BE ADJUSTED WITH NEW TYPE 1 FRAME, OPEN LID	SANITARY MANHOLES TO BE ADJUSTED
PRESTAGE-1			D.O.I.	Dion		2.011	D.O.I.	EAGII	D-torr	<u> </u>
WEBER RD	789+00	25 RT	1							
WEBER RD	789+42	53 RT								1
WEBER RD	792+00	25 RT		1						
WEBER RD	793+10	58 RT								1
WEBER RD	793+55	61 RT								1
WEBER RD	794+69	26 RT		1						
WEBER RD	797+30	43 RT		1						
WEBER RD	799+24	80 RT								1
WEBER RD	801+18	32 RT		1						
WEBER RD	802+79	88 RT						1		
WEBER RD	803+42	81 RT							1	
WEBER RD	803+55	44 RT		1						
WEBER RD	804+34	2 RT					1			
WEBER RD	806+41	33 RT		1						
WEBER RD WEBER RD	808+64 814+64	33 RT 33 RT	1	1						
WEBER RD	814+64	33 RT	1		-	1				
WEBER RD	817+22	33 RT		1		'				
WEBER RD	820+17	55 RT		· · · · · · · · · · · · · · · · · · ·		1				
WEBER RD	820+49	38 RT		1						
WEBER RD	820+64	3 LT			1					
WEBER RD	821+15	63 RT				1				
WEBER RD	822+02	63 RT				1				
WEBER RD	822+72	45 RT		1						
WEBER RD	822+78	50 RT						1		
WEBER RD	824+11	74 RT						1		
WEBER RD	825+86	33 RT		1						
WEBER RD	825+92	36 RT						1		
WEBER RD	827+86	33 RT		1				4		
WEBER RD WEBER RD	828+03 830+52	39 RT 39 RT		1				1		
WEBER RD	830+91	66 RT		1					1	
WEBER RD	832+63	43 RT		1					'	
WEBER RD	835+05	51 RT		1						
WEBER RD	835+05	55 RT		1						
WEBER RD	835+05	65 RT						1		
WEBER RD	835+65	66 RT						1		
WEBER RD	836+35	71 RT		1						
WEBER RD	836+88	63 RT				1				
WEBER RD	839+16	66 RT						1		
WEBER RD	843+00	36 RT					1			
WEBER RD	855+98	58 RT					1			
WEBER RD	856+71	75 RT					1			
WEBER RD	856+78	45 RT		1						
WEBER RD WEBER RD	857+54 857+58	57 RT 43 RT		1						
WEBER RD WEBER RD	857+58	43 RT 87 RT		- 1	-		1			
WEBER RD	857+79	73 RT		1			-			
WEBER RD	860+54	44 RT		1						
WEBER RD	863+00	38 RT		1						
WEBER RD	863+59	78 RT								1
WEBER RD	865+73	35 RT		1						
NORMANTOWN RD	91+71	20 RT					1			
NORMANTOWN RD	93+02	25 RT					1			
NORMANTOWN RD	93+19	25 RT					1			
NORMANTOWN RD	93+76	28 RT					1			
NORMANTOWN RD	95+30	35 RT					1			
NORMANTOWN RD	98+80	33 RT		1						
NORMANTOWN RD	98+80	0			1			4		
NORMANTOWN RD	99+25 105+14	0 4 RT						1	 	
LAKEVIEW DR	203+81	19 LT				1		1		
		1961	1		i .	1 1	i .		i	i

						CATCH BASINS	CATCH BASINS			
ALIGNMENT	STATION	OFFSET LT / RT	INLETS TO BE ADJUSTED	INLETS TO BE ADJUSTED WITH NEW TYPE 1 FRAME, CLOSED LID	CATCH BASINS TO BE ADJUSTED	TO BE ADJUSTED WITH NEW	TO BE ADJUSTED WITH NEW	MANHOLES TO BE ADJUSTED	MANHOLES TO BE ADJUSTED WITH NEW TYPE 1 FRAME, OPEN LID	SANITARY MANHOLES TO BE ADJUSTED
			EACH	EACH	EACH	EACH	EACH	EACH	EACH	EACH
PRESTAGE-1										
WINDHAM PKWY	305+98	19 RT					1			
REMINGTON BLVD (E)	506+10	19 RT					1			
STAGE-1										
WEBER RD	793+12	73 LT								1
WEBER RD	795+50	52 LT					1			
WEBER RD	795+65	87 LT								1
WEBER RD	796+90	52 LT		1						
WEBER RD	798+50	51 RT					1			
WEBER RD	799+24	91 LT								1
WEBER RD	800+62	86 LT								1
WEBER RD	806+05	59 LT		1						
WEBER RD	806+42	80 LT					1			
WEBER RD	806+53	101 LT						1		
WEBER RD	806+63	39 LT		1						
WEBER RD	806+72	68 RT					1			
WEBER RD	808+60	101 LT					1			
WEBER RD	808+60	109 LT						1		
WEBER RD	809+74	102 LT					1			
WEBER RD	813+59	101 LT					1			
WEBER RD	813+93	102 LT		1						
WEBER RD	814+63	38 LT		1						
WEBER RD	815+04	101 LT					1			
WEBER RD	816+65	122 LT						1		
WEBER RD	816+79	101 LT					1			
WEBER RD	816+84	54 LT					1			
WEBER RD	817+24	78 LT		1						
WEBER RD	835+06	6 LT					1			
WEBER RD	835+20	6 LT						1		
WEBER RD	854+41	9 LT					1	•		
WEBER RD	855+10	9 LT					1			
NORMANTOWN RD	95+92	50 LT								1
STAGE-2	00.02	55 2.								
WEBER RD	793+10	58 RT								1
WEBER RD	793+55	60 RT								1
WEBER RD	801+00	9 RT		1						'
WEBER RD	801+38	38 RT		'			1			
WEBER RD	804+60	10 RT					1			
WEBER RD	805+80	46 RT					1			
WEBER RD										
	806+55	19 RT					1			
WEBER RD	807+09 807+48	39 RT		1						
WEBER RD		8 LT		1			4			
WEBER RD	807+66	2 LT					1			
WEBER RD	807+83	7 LT					1			
WEBER RD	808+60	7 RT					1			
WEBER RD	809+36	6 LT					1			
WEBER RD	810+20	22 LT		1						
WEBER RD	813+29	24 LT		1						
WEBER RD	814+41	7 LT					1		-	
WEBER RD	815+04	4 LT					1			
WEBER RD	815+04	22 LT					1			
WEBER RD	815+47	21 LT					1		ļ	
WEBER RD	815+95	20 LT		1					ļ	
WEBER RD	817+13	1 RT					1			
WEBER RD	817+29	48 RT					1			
WEBER RD	817+34	34 RT					1			
WEBER RD	817+77	24 RT					1			
WEBER RD	828+04	66 RT						1		
WEBER RD	830+91	66 RT						1		
WEBER RD	835+05	66 RT						1		
WEBER RD	837+28	63 RT						1		
WEBER RD	839+16	65 RT						1		
WEBER RD	863+50	76 RT				1				1



USER NAME = mmaestra	DESIGNED DGB	REVISED -
	DRAWN DGB	REVISED -
PLOT SCALE = 1:20	CHECKED PJO	REVISED -
PLOT DATE = 5/13/2017	DATE 05/12/17	REVISED -

STATE OF ILLINOIS DEPARTMENT OF TRANSPORTATION

	ERO:	SION						ANTITIES RY DRAIN	IAGE) ITEMS
SCALE:	NONE	SHEET	NO.	2	OF	4	SHEETS	STA.	TO STA.

863+59 76 RT

TOTAL

WEBER RD

.A.I/P RTE.	SECTION	COUNTY	TOTAL SHEETS	SHEET NO.
*	(99-1HB-1) R-1	WILL	1508	116
		CONTRACT	NO. 6	0X10
FAI 55,	FAP 856 ILLINOIS FED	. AID PROJECT		

19

PIPE CULVERTS, CLASS C, TYPE 1 12" (TEMPORARY)						
FROM STATION	OFFSET LT / RT	TO STATION	OFFSET LT / RT	PIPE CULVERTS, CLASS C, TYPE 1 12" (TEMPORARY)	TRENCH BACKFILL	
				(FOOT)	(CU YD)	
PRESTAGE-1					•	
WEBER RD						
792+00	58 RT	7+92	22 RT	22	0.0	
794+62	55 RT	794+68	60 RT	2	0.5	
797+29	67 RT	797+29	80 RT	12	2.8	
800+70	76 RT	800+70	83 RT	3	0.7	
803+42	81 RT	803+50	95 RT	13	3.1	
804+54	1 RT	806+10	3 RT	156	36.8	
806+41	33 RT	806+62	63 RT	35	8.3	
808+64	33 RT	808+64	48 RT	13	3.1	
817+22	33 RT	817+22	46 RT	10	2.4	
820+11	51 RT	820+17	55 RT	4	0.9	
822+00	63 RT	822+72	52 RT	66	15.6	
822+72	52 RT	722+78	50 RT	3	0.7	
825+87	52 RT	725+92	36 RT	14	3.3	
827+87	52 RT	828+04	65 RT	19	4.5	
832+65	65 RT	832+73	69 RT	6	1.4	
835+05	66 RT	835+05	80 RT	11	2.6	
837+43	55 RT	837+57	79 RT	25	5.9	
842+45	63 RT	842+90	61 RT	43	10.2	
842+90	61 RT	843+00	63 RT	24	5.7	
842+90	61 RT	843+00	57 RT	8	1.9	
845+59	52 RT	845+59	71 RT	16	3.8	
848+29	52 RT	848+29	74 RT	2	0.5	
853+49	74 RT	853+49	89 RT	13	3.1	
856+45	94 RT	856+62	97 RT	16	3.8	
857+79	73 RT	857+86	78 RT	6	1.4	
860+54	44 RT	860+54	69 RT	24	5.7	
863+00	38 RT	863+00	64 RT	25	5.7	
	35 RT	865+73	57 RT		5.9	
865+73 NORMANTOW		000+73	37 KT	21	5.0	
		00.77	22 DT		0.7	
93+77	28 RT	93+77	33 RT	3	0.7	
95+30	65 RT	95+40	38 RT	8	1.9	
98+80	34 RT	98+80	38 RT	2	0.5	
LAKEVIEW DF		000:04	40.57			
203+76	23 RT	203+81	19 RT	2	0.5	
REMINGTON E			10 ==			
305+88	27 RT	305+98	19 RT	10	2.4	
RAMP D						
9014+50	32 RT	9017+50	28 RT	300	70.8	
RODEO DR / F						
498+97	30 RT	499+03	36 RT	6	1.4	
506+10	19 RT	506+18	23 RT	6	1.4	

PIPE C	PIPE CULVERTS, CLASS C, TYPE 1 12" (TEMPORARY)							
FROM STATION	OFFSET LT / RT	TO STATION	OFFSET LT / RT	PIPE CULVERTS, CLASS C, TYPE 1 12" (TEMPORARY)	TRENCH BACKFILL			
				(FOOT)	(CU YD)			
STAGE-1								
WEBER RD								
806+10	3 LT	806+37	3 LT	27	6.4			
807+67	3 LT	808+58	41 LT	89	21.0			
817+22	15 LT	817+52	24 LT	30	7.1			
817+78	116 LT	818+15	44 LT	77	18.2			
818+15	44 LT	818+95	22 LT	79	18.7			
862+68	2 RT	863+00	2 RT	32	7.6			
865+04	4 RT	865+73	2 RT	69	16.3			
STAGE-1B								
WEBER RD								
817+52	16 LT	818+14	44 LT	61	61.0			
	PROJEC	1413	376					

PIPE CULVERTS, CLASS C, TYPE 1 15" (TEMPORARY)						
FROM OFFSET TO OFFSET STATION LT/RT				PIPE CULVERTS, CLASS C, TYPE 1 15" (TEMPORARY)	TRENCH BACKFILL	
				(FOOT)	(CU YD)	
PRESTAGE-1						
WEBER RD						
842+90	61 RT	842+90	71 RT	8	1.9	
STAGE-1						
WEBER RD						
817+01	22 LT	817+22	15 LT	18	4.3	
STAGE-1B						
RAMP D						
9000+54	62 RT	9001+08	67 RT	67	15.9	
	PROJEC	93	22			

PIPE CULVERTS, CLASS C, TYPE 1 24" (TEMPORARY)						
FROM STATION	OFFSET LT / RT	TO STATION	OFFSET LT / RT	PIPE CULVERTS, CLASS C, TYPE 1 24" (TEMPORARY)	TRENCH BACKFILL	
				(FOOT)	(CU YD)	
PRESTAGE-1						
WEBER RD						
791+50	34 RT	791+50	80 RT	46	9.4	
791+50	34 RT	793+85	55 RT	236	48.5	
793+85	55 RT	794+35	54 RT	51	10.5	
846+79	73 RT	846+79	39 RT	31	6.4	
846+79	73 RT	846+79	39 RT	31	6.4	
855+98	58 RT	855+98	80 RT	18	3.7	
855+98	80 RT	855+98	89 RT	5	1.0	
RAMP D						
9000+75	103 RT	9001+08	67 RT	41	8.4	
9004+00	48 RT	9004+06	122 RT	74	15.2	
STAGE-1						
WEBER RD						
845+82	6 LT	846+79	7 LT	92	18.9	
845+85	10 LT	847+00	9 LT	10	2.1	
STAGE-1B						
WEBER RD						
856+00	9 LT	856+10	4 LT	10	2.1	
RAMP B						
6000+74	40 RT	6006+86	40 RT	10	2.1	
	PROJEC	655	135			

	PIPE CULVERTS, CLASS C, TYPE 1 30" (TEMPORARY)								
FROM STATION	OFFSET LT / RT	TO STATION	OFFSET LT / RT	PIPE CULVERTS, CLASS C, TYPE 1 30" (TEMPORARY)	BACKFILL				
				(FOOT)	(CU YD)				
PRESTAGE-1									
RAMP A									
4994+00	47 RT	4994+00	75 RT	28	5.6				
	PROJEC	28	6						

USER NAME = mmaestra	DESIGNED DGB	REVISED -
	DRAWN DGB	REVISED -
PLOT SCALE = 1:20	CHECKED PJO	REVISED -
PLOT DATE = 5/13/2017	DATE 05/12/17	REVISED -

		s	СН	EDI	ULE	OF OU	ANTITIES		F.A.I/P RTE.	SECTION	COUNTY	TOTAL SHEETS	
EROSION CONTROL (TEMPORARY DRAINAGE) ITEMS					*	(99-1HB-1) R-1	WILL	1508	117				
					٠						CONTRACT	NO. 6	0X10
	SHEET	NO.	3	0F	4	SHEETS	STA.	TO STA.	* FAT 55.	FAP 856 ILLINOIS FED. AL	D PROJECT		

ALIGNMENT	PIPE NUMBER	FROM STATION	LT / RT	TO STATION	LT / RT	CLASS D PATCHES, TYPE III, 12 INCH (SPECIAL)
						SQ YD
RESTAGE-1						
RAMP A	*	4994+00	RT	4994+00	RT	15
RAMP D	*	9000+83	RT	9001+05	RT	32
RAMP D	*	9004+02	RT	9004+04	RT	18
TAGE-1						
WEBER RD	37	801+00	LT	801+00	LT	3
WEBER RD	26	804+54	LT	804+54	LT	12
WEBER RD	*	806+10	LT	806+37	LT	12
WEBER RD	128	815+00	LT	815+00	LT	12
WEBER RD	120	817+00	LT	817+00	LT	11
WEBER RD	*	817+00	LT	817+22	LT	10
WEBER RD	*	817+22	LT	817+60	LT	13
TAGE-2						
WEBER RD	58	792+00	LT	792+00	RT	9
WEBER RD	45	798+50	RT	798+50	RT	4
WEBER RD	26	804+54	RT	804+57	RT	3
WEBER RD	*	817+52	LT	818+14	LT	27
WEBER RD	105	822+00	RT	822+00	RT	3
WEBER RD	234	825+76	RT	825+76	RT	3
WEBER RD	227	828+44	RT	828+44	RT	3
WEBER RD	219	831+12	CTR	831+12	RT	6
WEBER RD	212	833+50	CTR	833+50	RT	5
WEBER RD	204	835+20	CTR	835+20	RT	5
WEBER RD	662A	837+85	RT	837+85	RT	2
WEBER RD	304	843+28	CTR	843+28	RT	5
WEBER RD	325	845+82	CTR	845+82	RT	3
WEBER RD	336	846+85	CTR	846+85	RT	3
WEBER RD	363	856+10	CTR	856+10	RT	8
WEBER RD	394	858+40	RT	858+40	RT	6
WEBER RD	381	860+46	RT	860+46	RT	4
WEBER RD	377	864+50	RT	864+50	RT	4
WEBER RD	373	862+68	RT	862+68	RT	4
WEBER RD	370	863+86	RT	863+86	RT	3
WEBER RD	367	865+04	RT	865+04	RT	4
***************************************		CT TOTAL	'\	000.04	131	253

RIPRAP FOR TEMPORARY EROSION CONTROL							
ALIGNMENT	STATION	OFFSET LT / RT	STONE RIPRAP, CLASS A4	FILTER FABRIC			
			SQ YD	SQ YD			
WEBER RD	791+39	139 LT	27	50			
RAMP A	4998+71	324 LT	27	50			
RAMP B	6003+25	326 LT	27	50			
RAMP C	7994+47	94 LT	24	44			
RAMP D	9010+73	64 LT	24	44			
TOTA	TOTAL						

TEMPORARY FENCE FOR WETLAND PROTECTION								
ALIGNMENT	FROM STATION	OFFSET LT / RT	TO STATION	OFFSET LT / RT	TEMPORARY FENCE			
					FOOT			
WEBER RD	790+20	45 RT	791+95	73 RT	351			
WEBER RD	790+20	57 LT	792+19	297 LT	199			
WEBER RD	803+84	128 RT	804+50	134 RT	67			
WEBER RD	804+50	128 RT	804+90	140 RT	40			
RAMP C	7993+05	84 RT	7994+25	100 RT	124			
NORMANTOWN RD	91+58	75 LT	92+59	74 LT	205			
NORMANTOWN RD	91+15	114 RT	91+42	114 RT	26			
	TOTAL							

KNIGHT		
Engineers	&	Architec

USER NAME = mmaestra	DESIGNED DGB	REVISED -
	DRAWN DGB	REVISED -
PLOT SCALE = 1:20	CHECKED PJO	REVISED -
PLOT DATE = 5/13/2017	DATE 05/12/17	REVISED -

SCH	EDULE OF QU	ANTITIES	F.A.I/P RTE.	SECTION	COUNTY	TOTAL SHEETS	SHEET NO.	
	OL (TEMPORA	*	(99-1HB-1) R-1	WILL	1508	118		
	(CONTRACT	NO. 6	0X10
NE SHEET NO. 4	OF 4 SHEETS	STA.	TO STA.	* FAI 55,	FAP 856 ILLINOIS FED. A	D PROJECT		

					TEMPORARY	RELOCATE	PINNING	BARRIER WALI
					CONCRETE BARRIER	TEMPORARY CONCRETE	TEMPORARY CONCRETE	MARKERS, TYPE C
	FROM	FROM	ТО	ТО	70400100	70400200	BARRIER X7040125	78200530
	STA	OFF	STA	OFF	FOOT	FOOT	EACH	EACH
CHAIN STAGE 1								
WEBER	790+20	9 R	797+55	7 R	737.5		171	60
WEBER	806+56	62 R	810+86	36 R	437.5		99	36
WEBER	806+44	5 L	810+47	36 R	412.5		93	34
WEBER	813+26	36 R	817+31	46 R	412.5		93	34
WEBER	812+88	36 L	816+80	24 L	400.0		90	32
I-55 N.B.	3090+89	61 R	3120+99	46 R	3,012.5		717	242
I-55 N.B.	3101+47	9 R	3107+80	17 R	637.5			52
I-55 S.B.	3123+99	54 L	3094+42	47 L	2,962.5		705	238
I-55 S.B.	3110+01	9 L	3102+41	17 L	762.5			62
I-55 RAMP A	4984+49	1 RT	4999+30	27 R	1,487.5		351	120
I-55 RAMP A	4993+42	57 R	4994+10	59 R	75.0		12	6
I-55 RAMP B	6000+88	77 R	6013+98	1 RT	1,362.5		321	110
I-55 RAMP C	7985+93	6 L	7999+51	36 R	1,362.5		321	110
I-55 RAMP D	9001+31	65 R	9015+74	2 R	1,450.0		342	116
I-55 RAMP D	9008+19	30 R	9019+47	4 R	1,137.5		267	92
NORMANTOWN	91+11	30 R	92+88	37 R	187.5		39	16
				STAGE TOTAL	16,837.5		3,621	1,360
STAGE 1A I-55 N.B.	3088+73	48 R	3127+70	42 R	625.0	3,275.0	465	50
I-55 S.B.	3123+98	55 L	3091+15	42 L		3,287.5	414	
I-55 RAMP C	7983+76	9 L	7987+29	11 R		362.5	81	
I-55 RAMP D	9014+28	6 R	9023+02	3 L		875.0	204	
I-55 RAMP D	9014+23	26 R	9019+03	3 R	62.5	425.0	111	6
NORMANTOWN	90+91	9 R	93+32	13 R	250.0	0.0	54	20
NORMANTOWN	92+89	31 L	90+99	24 L		200.0	42	
			1	STAGE TOTAL	937.5	8,425.0	1,371	76
STAGE 1B					937.5			76
WEBER	815+67	30 L	815+29	29 L	937.5	50.0	6	76
WEBER I-55 N.B.	3084+41	50 R	3089+77	29 L 42 R	937.5	50.0 537.5	6 123	76
WEBER 1-55 N.B. 1-55 N.B.	3084+41 3096+46	50 R 46 R	3089+77 3097+22	29 L 42 R 42 R	937.5	50.0 537.5 87.5	6 123 15	76
WEBER I-55 N.B. I-55 N.B. I-55 RAMP B	3084+41 3096+46 6007+09	50 R 46 R 14 R	3089+77 3097+22 6030+13	29 L 42 R 42 R 2 L	937.5	50.0 537.5 87.5 2,312.5	6 123 15 549	76
WEBER I-55 N.B. I-55 N.B. I-55 RAMP B I-55 S.B.	3084+41 3096+46 6007+09 3145+77	50 R 46 R 14 R 77 R	3089+77 3097+22 6030+13 3154+00	29 L 42 R 42 R 2 L 42 R	937.5	50.0 537.5 87.5 2,312.5 825.0	6 123 15 549 192	76
WEBER I-55 N.B. I-55 N.B. I-55 RAMP B I-55 S.B. I-55 RAMP C	3084+41 3096+46 6007+09 3145+77 7984+80	50 R 46 R 14 R 77 R 24 L	3089+77 3097+22 6030+13 3154+00 7994+39	29 L 42 R 42 R 2 L 42 R	937.5	50.0 537.5 87.5 2,312.5 825.0 962.5	6 123 15 549 192 69	76
WEBER I-55 N.B. I-55 N.R. I-55 RAMP B I-55 S.B. I-55 RAMP C	3084+41 3096+46 6007+09 3145+77 7984+80 9006+21	50 R 46 R 14 R 77 R 24 L 2 L	3089+77 3097+22 6030+13 3154+00 7994+39 9017+52	29 L 42 R 42 R 2 L 42 R 2 L 18 R	937.5	50.0 537.5 87.5 2,312.5 825.0 962.5 1,137.5	6 123 15 549 192 69 267	76
WEBER I-55 N.B. I-55 N.B. I-55 RAMP B I-55 S.B. I-55 RAMP C I-55 RAMP D	3084+41 3096+46 6007+09 3145+77 7984+80 9006+21 3083+57	50 R 46 R 14 R 77 R 24 L 2 L 43 L	3089+77 3097+22 6030+13 3154+00 7994+39 9017+52 3092+64	29 L 42 R 42 R 2 L 42 R 2 L 48 R 2 L 48 R 44 L	937.5	50.0 537.5 87.5 2,312.5 825.0 962.5 1,137.5 912.5	6 123 15 549 192 69 267 213	76
WEBER I-55 N.B. I-55 N.B. I-55 RAMP B I-55 S.B. I-55 RAMP C I-55 RAMP D	3084+41 3096+46 6007+09 3145+77 7984+80 9006+21	50 R 46 R 14 R 77 R 24 L 2 L	3089+77 3097+22 6030+13 3154+00 7994+39 9017+52	29 L 42 R 42 R 2 L 42 R 2 L 18 R 44 L 1 R	937.5	50.0 537.5 87.5 2,312.5 825.0 962.5 1,137.5 912.5 212.5	6 123 15 549 192 69 267 213	76
WEBER I-55 N.B. I-55 N.B. I-55 RAMP B	3084+41 3096+46 6007+09 3145+77 7984+80 9006+21 3083+57	50 R 46 R 14 R 77 R 24 L 2 L 43 L	3089+77 3097+22 6030+13 3154+00 7994+39 9017+52 3092+64	29 L 42 R 42 R 2 L 42 R 2 L 48 R 2 L 48 R 44 L	937.5	50.0 537.5 87.5 2,312.5 825.0 962.5 1,137.5 912.5	6 123 15 549 192 69 267 213	76
WEBER I-55 N.B. I-55 N.R. I-55 RAMP B I-55 S.B. I-55 RAMP C I-55 RAMP D I-55 S.B. NORMANTOWN	3084+41 3096+46 6007+09 3145+77 7984+80 9006+21 3083+57	50 R 46 R 14 R 77 R 24 L 2 L 43 L	3089+77 3097+22 6030+13 3154+00 7994+39 9017+52 3092+64	29 L 42 R 42 R 2 L 42 R 2 L 18 R 44 L 1 R	937.5	50.0 537.5 87.5 2,312.5 825.0 962.5 1,137.5 912.5 212.5	6 123 15 549 192 69 267 213	76

		TEMP	ORARY CC	NCRETE	BARRIER SC	HEDULE		
					TEMPORARY CONCRETE BARRIER	RELOCATE TEMPORARY CONCRETE BARRIER	PINNING TEMPORARY CONCRETE BARRIER	BARRIER WA MARKERS, TYPE C
	FROM	FROM	то	ТО	70400100	70400200	X7040125	78200530
CHAIN	S⊤A	OFF	STA	OFF	FOOT	FOOT	EACH	EACH
STAGE 2								
WEBER	790+20	2 L	794+88	2 L		475.0	108	
WEBER	807+13	33 L	816+11	45 L		900.0	210	
WEBER	806+83	93 L	809+74	105 L		300.0	66	
WEBER	812+87	105 L	815+69	110 L		287.5	63	
I-55 N.B.	3102+60	51 R	3107+66	48 R		512.5		
I-55 S.B.	3105+42	49 L	3111+39	52 L		600.0		
I-55 RAMP A	4979+22	23 R	4992+27	2 R		1,312.5		
				STAGE TOTAL		4,387.5	447	
STAGE 2A WEBER	808+39	42 L	808+77	46 L		50.0	6	
··· LDLIN	000.55	12.2	000177	STAGE TOTAL		50.0	6	
STAGE 2B						30.0	J	
STAGE 2C				STAGE TOTAL				
				STAGE TOTAL				
STAGE 3 WEBER	809+52	67 L	813+70	64 L		425.0		
				STAGE TOTAL		425.0		
STAGE 3A								
STAGE 3B				STAGF TOTAL				
STAGE 3C				STAGE TOTAL				
				STAGE TOTAL				
STAGE 4 WEBER	805+74	10 L	807+51	7 L		187.5		
WEBER	816+06	38 L	817+70	24 L		175.0		
	013100	301	01/1/0	STAGE TOTAL		362.5		
STAGE 4A						32.3		
STAGE 4B				STAGE TOTAL				
				STAGE TOTAL				
			CONTIN	NGENCY (20%)				287
			PI	ROJECT TOTAL	17,775.0	22,100.0	7,146	1,723

		TEMPORARY	CURB AND G	UTTER	
STREET NAME	FROM STATION	TO STATION	LT/RT	LENGTH AT FACE OF CURB	COMBINATION CONCRETE CURB AND GUTTER, TYPE B-6.12 (SPECIAL)
					FOOT
PRESTAGE 1					
WEBER	792+00	799+53	RT	785	785
WEBER	800+35	805+79	RT	553	553
WEBER	806+31	810+84	RT	456	456
WEBER	809+98	810+47	LT	50	50
WEBER	812+89	813+54	LT	65	65
WEBER	813+26	817+31	RT	406	406
WEBER	4998+90	823+18	RT	564	564
WEBER	824+04	836+37	RT	1290	1290
WEBER	837+32	841+63	RT	448	448
WEBER	842+13	856+78	RT	1489	1489
WEBER	857+70	870+10	RT	1264	1264
RAMP B	6000+42	6001+14	RT	75	75
NORMANTOWN	93+67	99+20	RT	554	554
NORMANTOWN	101+38	102+98	RT	161	161
LAKEVIEW	201+12	204+46	LT	335	335
WINDHAM	301+23	302+26	RT	104	104
WINDHAM	304+44	307+90	RT	358	358
WINDHAM	307+74	308+43	RT	71	71
CARLOW	395+90	397+77	LT	195	195
CARLOW	398+06	399+36	LT	140	140
RODEO	496+76	499+28	RT	253	253
REMINGTON	501+12	502+23	LT	112	112
REMINGTON	501+20	501+94	RT	77	77
REMINGTON	502+80	503+29	RT	52	52
				STAGE TOTAL	9857
STAGE 1					
WEBER	792+00	798+70	LT	671	671
WEBER	807+72	809+76	LT	204	204
WEBER	812+85	813+50	LT	64	64
WINDHAM	301+07	302+84	LT	180	180
				STAGE TOTAL	1119
STAGE 1B					
WEBER	798+70	799+28	LT	59	59
				STAGE TOTAL	59
STAGE 2					
WINDHAM	300+69	301+06	LT	41	41
REMINGTON	500+81	502+13	RT	155	155
REMINGTON	502+54	503+26	RT	94	94
	552.5.	555 : 25		STAGE TOTAL	290
STAGE 2C					
REMINGTON	500+90	502+45	LT	157	157
				STAGE TOTAL	157
			-	ROJECT TOTAL	11,482

KNIGHT	
Engineers &	Architects

USER NAME = mmaestra	DESIGNED	WVN	REVISED	-
	DRAWN	WVN	REVISED	-
PLOT SCALE = 1:20	CHECKED	PJ0	REVISED	-
PLOT DATE = 5/13/2017	DATE	05/12/17	REVISED	-

STAT	E 01	F ILLINOIS
DEPARTMENT	OF	TRANSPORTATION

	SCHEDULE OF QUANTITIES MAINTENANCE OF TRAFFIC ITEMS				F.A.I/P RTE.	SECTION	COUNTY	TOTAL SHEETS	SHEET NO.
					*	(99-1HB-1) R-1	WILL	1508	119
	III/IIII/IIII II IIII III IIII						CONTRACT	NO. 6	0X10
	SCALE: NONE	SHEET NO. 1 OF 2 SHEETS	STA.	TO STA.	* FAI 55, FAP 856 ILLINOIS FED. AID PROJECT				

	TEMPORARY ATTENUATOR SCHEDULE (CONTINUED)								
			IMPACT ATTENUATORS, TEMPORARY (FULLY REDIRECTIVE, NARROW), TEST LEVEL 3	IMPACT ATTENUATORS, TEMPORARY (FULLY REDIRECTIVE, WIDE), TEST LEVEL 3	IMPACT ATTENUATORS, RELOCATE (FULLY REDIRECTIVE, NARROW), TEST LEVEL 3	IMPACT ATTENUATORS, RELOCATE (FULLY REDIRECTIVE, WIDE), TEST LEVEL 3	IMPACT ATTENUATORS, TEMPORARY (NON-REDIRECTIVE), TEST LEVEL 3	IMPACT ATTENUATORS, RELOCATE (NON- REDIRECTIVE), TEST LEVEL 3	
CHAIN	STATION	OFFSET	70600260 EACH	70600270 EACH	70600332 EACH	EACH	70600250 EACH	70600350 EACH	
CHAIN STAGE 1	STATION	OFFSET	EACH	EACH	EACH	EACH	EACH	EACH	
WEBER	797+55	5 R	1						
WEBER	806+56	62 R	1						
WEBER	818+61	64 R					1		
WEBER	816+80	24 L	1						
NORMANTOWN	91+11	30 R	1						
NORMANTOWN	92+88	37 R	1						
I-55 N.B.	3090+89	61 R		1					
I-55 N.B.	3101+47	9 R	1						
I-55 S.B.	3123+98	54 L		1					
I-55 S.B.	3110+01	9 L	1						
I-55 RAMP A	4993+42	57 R	1						
I-55 RAMP B	6000+88	77 R	1						
I-55 RAMP D	9001+31	65 R	1						
I-55 RAMP D	9008+19	30 R	1						
STAGE TOTAL			11	2			1		
STAGE 1A I-55 N.B.	3088+73	48 R				1			
NORMANTOWN	90+91	9 R			1	_			
NORMANTOWN	93+32	13 R			1				
NORMANTOWN	90+99	24 L			1				
NORMANTOWN	92+89	31 L			1				
STAGE TOTAL					4	1			
STAGE 1B									
WEBER	807+83	52 R			1				
WEBER	815+67	30 L			1				
I-55 N.B.	3084+41	50 R			1				
I-55 N.B.	3096+46	45 R			1				
I-55 N.B.	3145+77	45 R	1						
I-55 RAMP B	6007+09	14 R			1				
I-55 RAMP D	9006+12	2 L			1				
NORMANTOWN	94+17	1 R			1				
STAGE TOTAL			1		7				
STAGE 1C I-55 N.B.	2002:52	F3.0			4				
STAGE TOTAL	3092+53	52 R			1				
JIAGE TOTAL				1	1	<u> </u>	l .	1	


	TEMPORARY ATTENUATOR SCHEDULE (CONTINUED)							
			IMPACT ATTENUATORS, TEMPORARY (FULLY REDIRECTIVE, NARROW), TEST LEVEL 3	IMPACT ATTENUATORS, TEMPORARY (FULLY REDIRECTIVE, WIDE), TEST LEVEL 3	IMPACT ATTENUATORS, RELOCATE (FULLY REDIRECTIVE, NARROW), TEST LEVEL 3	IMPACT ATTENUATORS, RELOCATE (FULLY REDIRECTIVE, WIDE), TEST LEVEL 3	IMPACT ATTENUATORS, TEMPORARY (NON-REDIRECTIVE), TEST LEVEL 3	IMPACT ATTENUATORS, RELOCATE (NON- REDIRECTIVE), TEST LEVEL 3
			70600260	70600270	70600332		70600250	70600350
CHAIN	STATION	OFFSET	EACH	EACH	EACH	EACH	EACH	EACH
STAGE 2								
WEBER	807+13	33 L			1			
WEBER	815+69	110 L			1			
I-55 N.B.	3102+60	51 R			1			
I-55 S.B.	3111+39	52 L			1			
I-55 RAMP A	4979+22	23 R			1			
	•	STAGE TOTAL			5			
STAGE 2A								
WEBER	808+39	42 L			1			
I-55 RAMP A	4999+44	50 L						1
		STAGE TOTAL			1			1
STAGE 3								
WEBER	810+55	37 R						1
WEBER	813+70	64 L			1			
		STAGE TOTAL			1			1
FOR CON	TRACTOR WOR	K ZONE ACCESS	4		4			
	1	PROJECT TOTAL	16	2	23	1	1	2


KNIGHT		
Engineers	&	Architect

USER NAME = mmaestra	DESIGNED	WVN	REVISED -	Γ
	DRAWN	WVN	REVISED -	1
PLOT SCALE = 1:20	CHECKED	PJ0	REVISED -	1
PLOT DATE = 5/13/2017	DATE	05/12/17	REVISED -	1

SCHEDULE OF QUANTITIES					SECTION	COUNTY	TOTAL SHEETS	SHEE NO.
MAINTENANCE OF TRAFFIC ITEMS				*	(99-1HB-1) R-1	WILL	1508	120
III/IIII/III						CONTRACT	NO. 6	0X10
SCALE: NONE	SHEET NO. 2 OF 2 SHEETS	STA.	TO STA.	* FAI 55.	FAP 856 ILLINOIS FED. AI	ID PROJECT		

IGHT		
Facility O. Analysis	PLOT SCALE = 1:	:20
Engineers & Architects	PLOT DATE = 5	5/13/2017

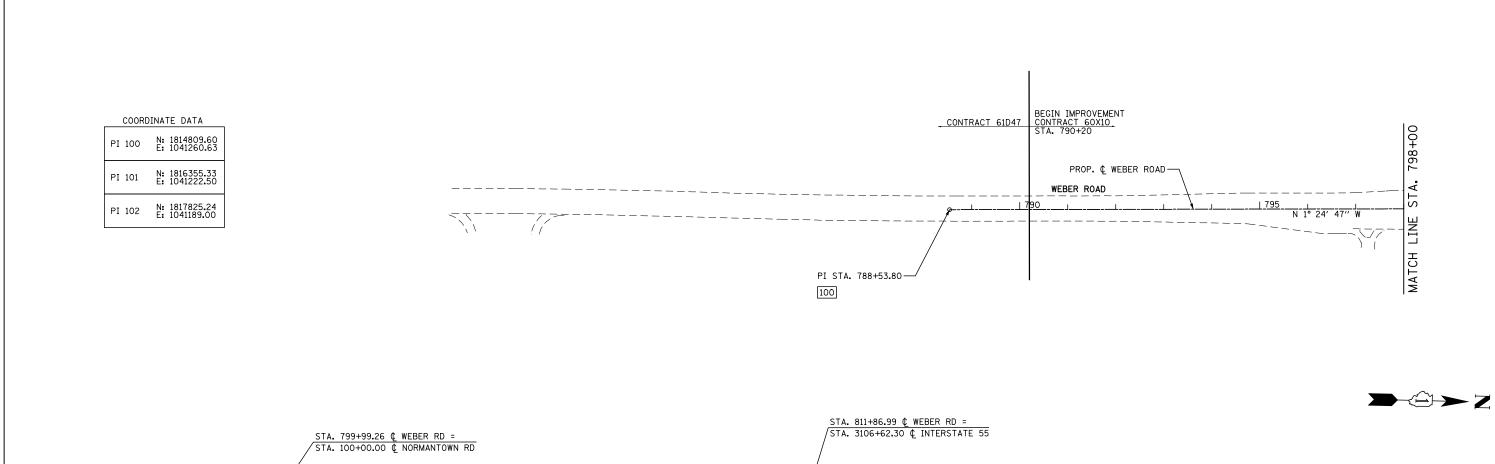

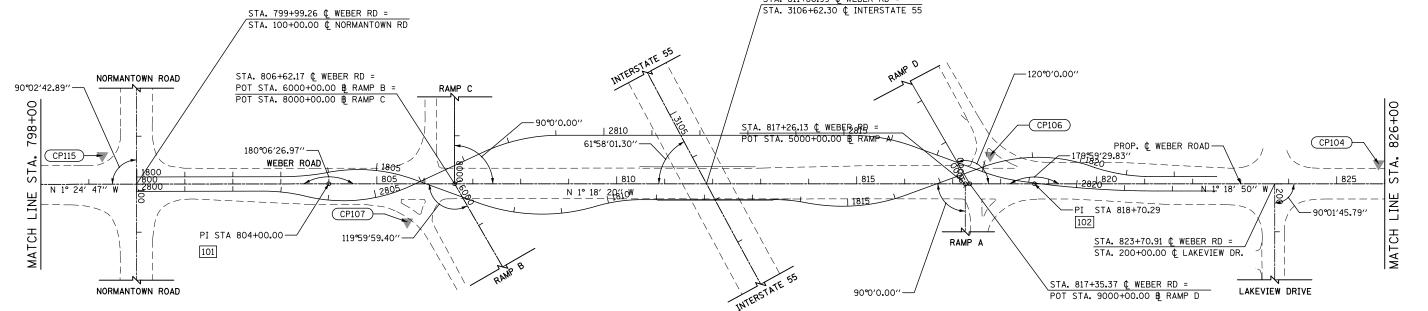


0	100′	200′	300′	400′
		SCALE IN FEE	Т	


KNIGHT		
Engineers	&	Architects


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	DRAWN	PAW	REVISED -	
PLOT SCALE = 1:200	CHECKED	PJ0	REVISED -	
PLOT DATE = 5/13/2017	DATE	05/12/17	REVISED -	
		-		_

STATE OF ILLINOIS					
DEPARTMENT OF TRANSPORTATION					

	ALIGNMENT, TIES AND	F.A.I/P RTE.	SECTION	COUNTY	TOTAL SHEETS	SHEET NO.		
	WEBER ROAD CE	*	(99-1HB-1) R-1	WILL	1508	121		
	WEBEN NOAD GE			CONTRACT	NO. 6	0X10		
SCALE: AS SHOWN SH	HEET NO. 1 OF 12 SHEETS	* FAI 55, I	FAP 856 ILLINOIS FED. AI	D PROJECT				

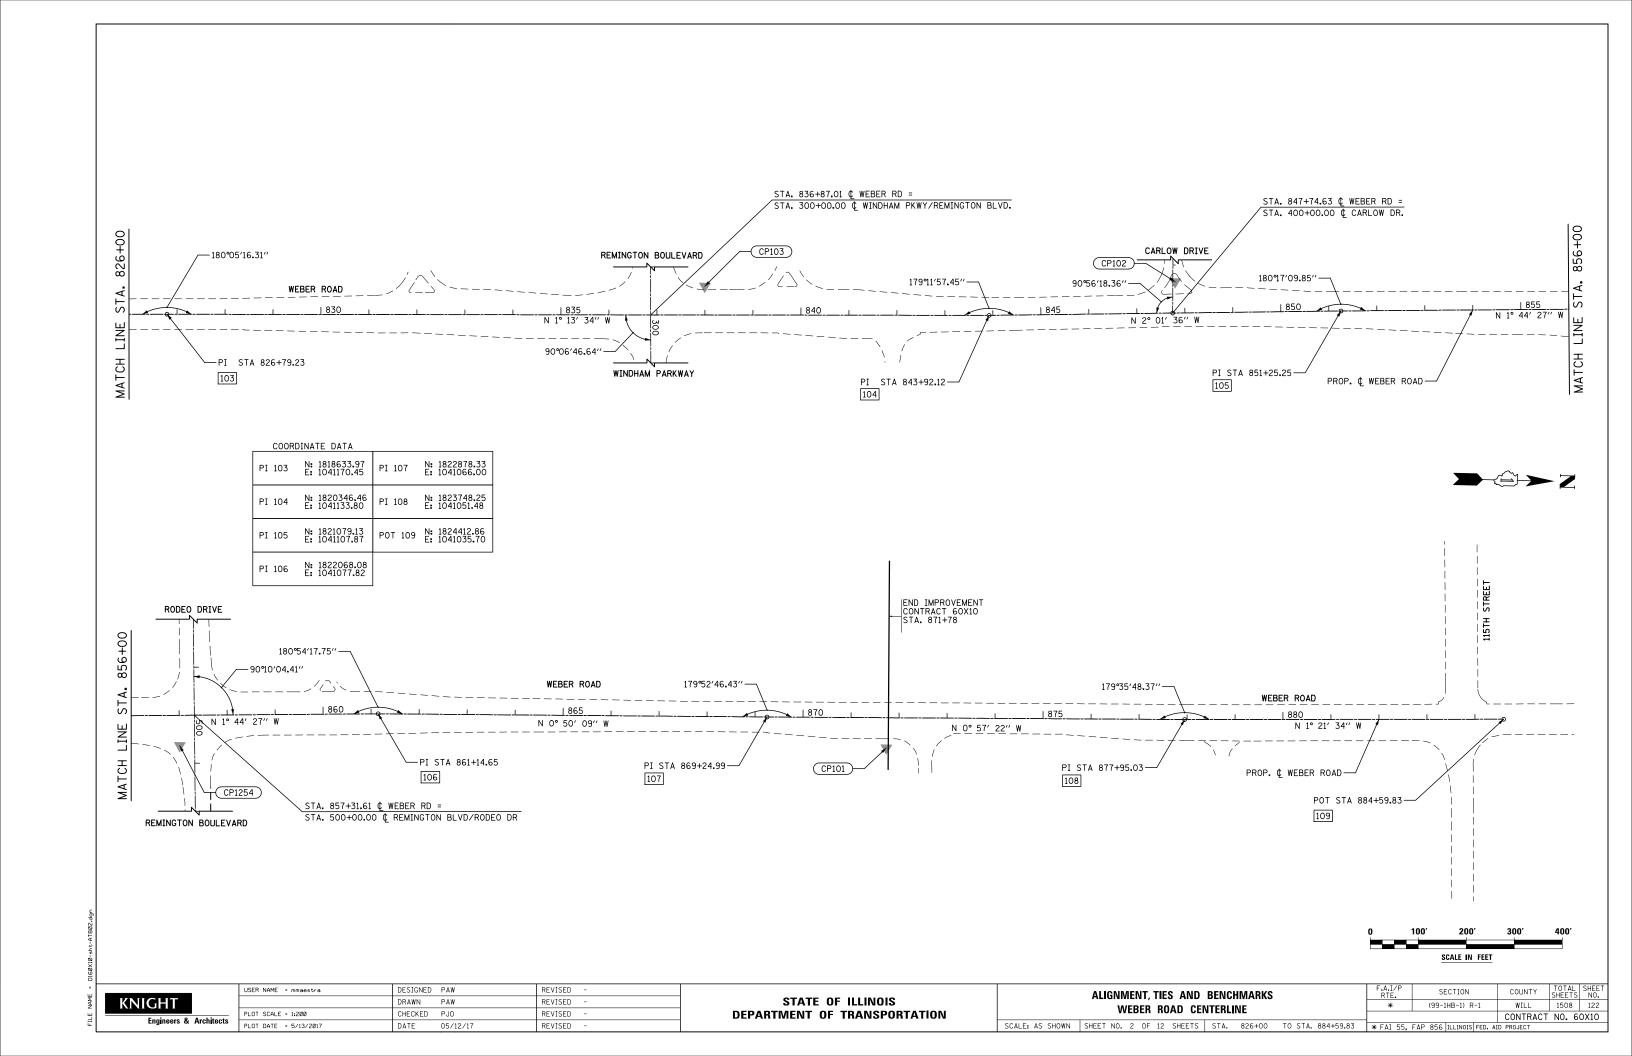

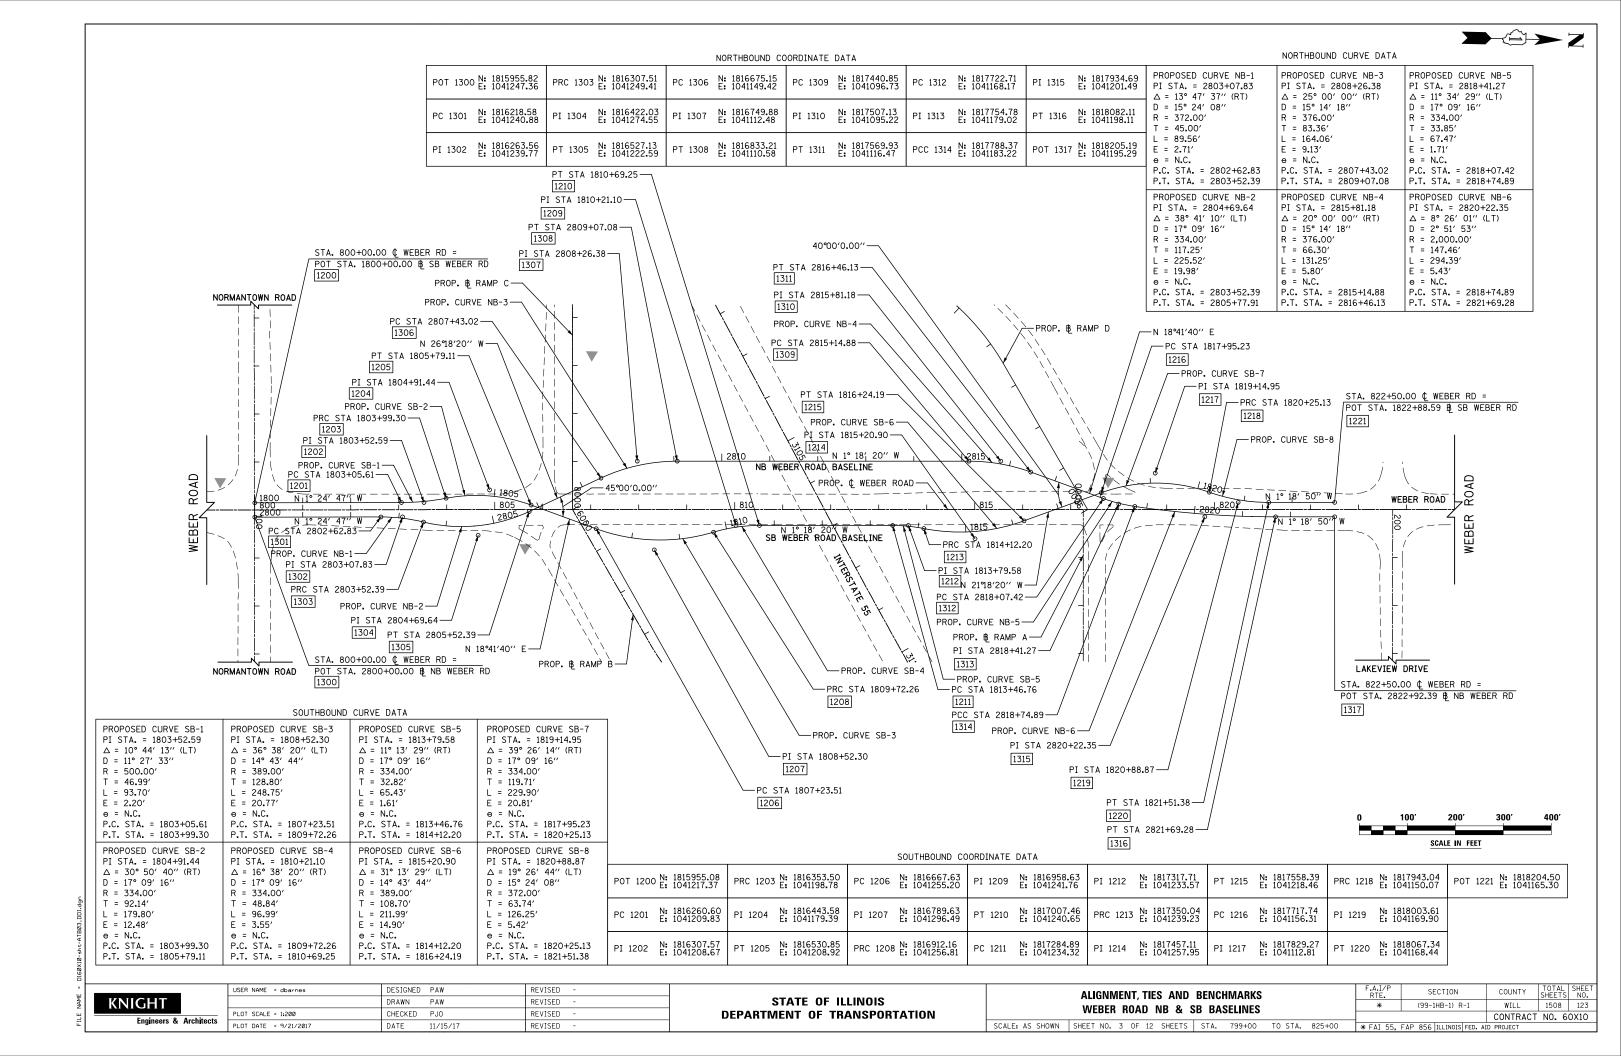

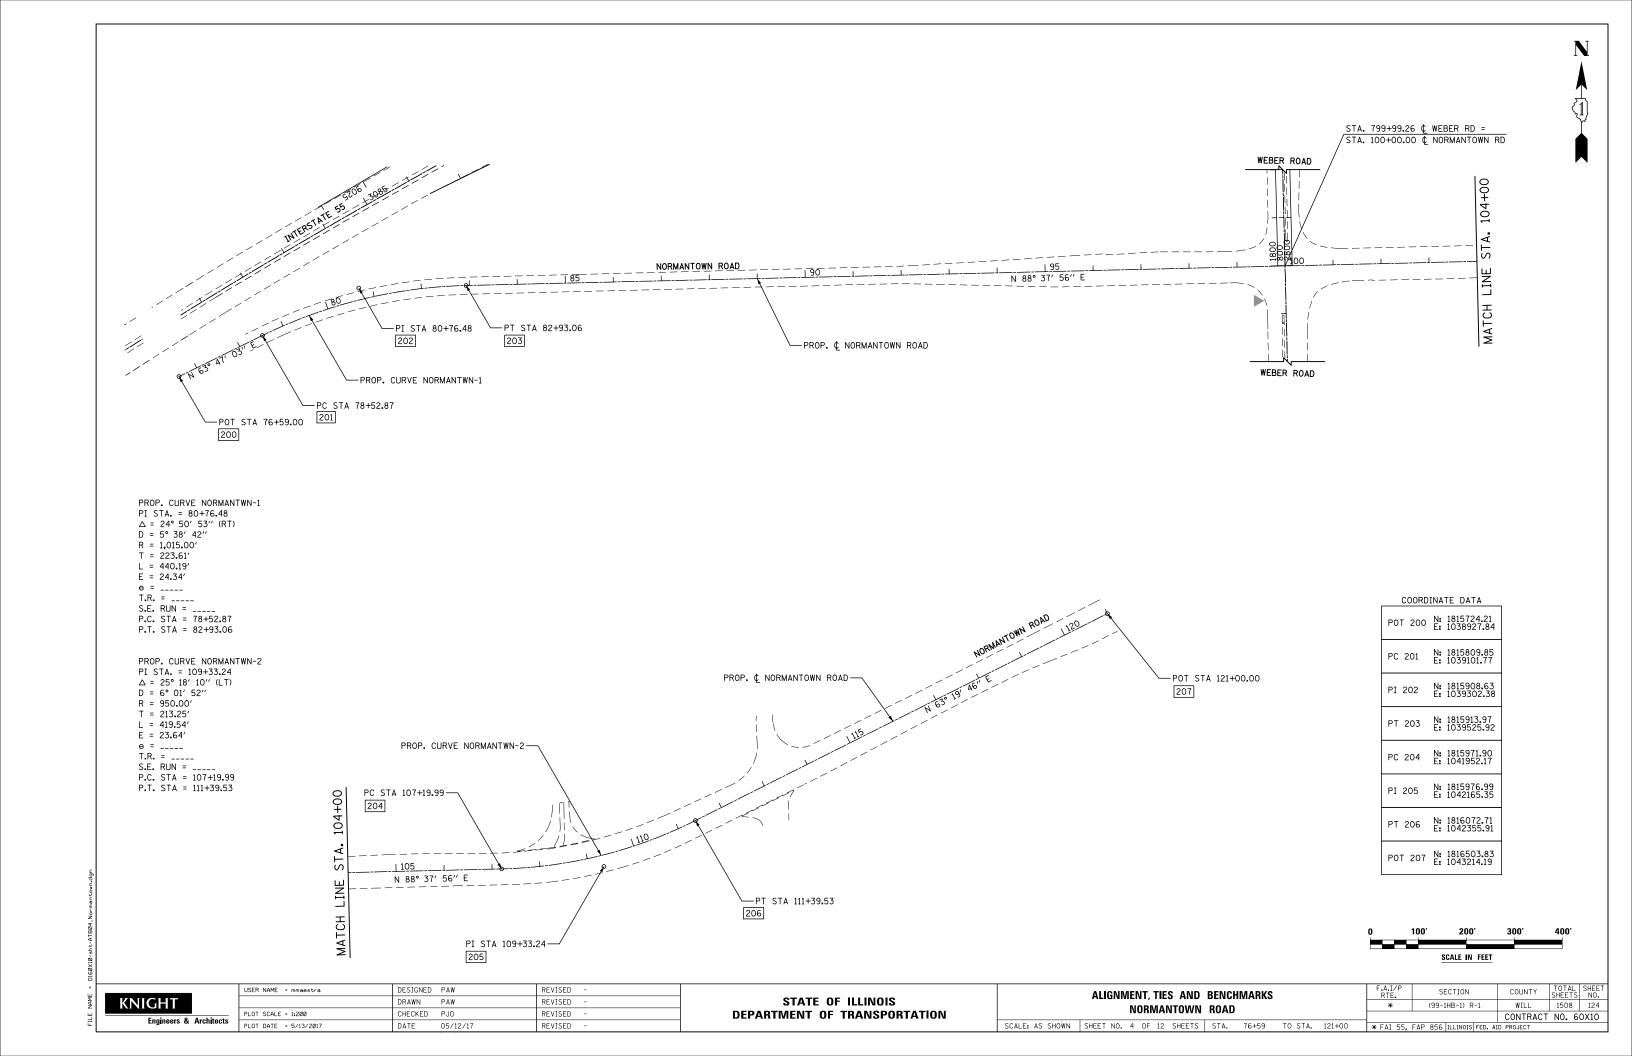

STA. 847+74.63 & WEBER RD =
POT STA. 400+00.00 & CARLOW DR.

POT Sta 390+79.28

[1000]

PROP. & CARLOW DRIVE

PROP. & CARLOW DRIVE

WEBER ROAD

WEBER ROAD

POT STA 400+00.00

[1001]

WEBER ROAD

POT 1000 N: 1820711.25 E: 1040199.71


CARLOW DR COORDINATE DATA

POT 1001 N: 1820728.74 E: 1041120.27

LAKEVIEW DR
COORDINATE DATA

POT 800 N: 1818325.73
E: 1041177.52

POT 801 N: 1818350.38 E: 1042277.24

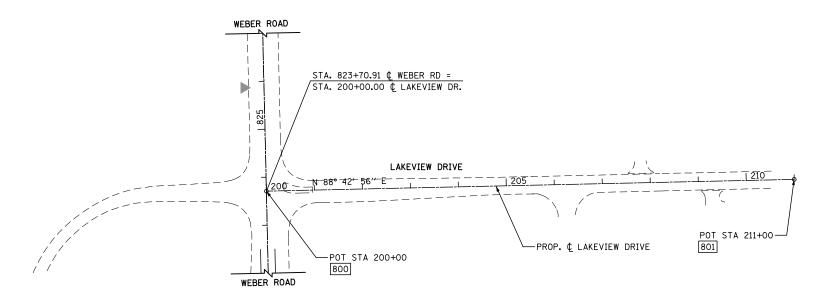

0 100' 200' 300' 400'

SCALE IN FEET

KNIGHT


Engineers & Architects

DESIGNED	PAW	REVISED -
DRAWN	PAW	REVISED -
CHECKED	PJ0	REVISED -
DATE	05/12/17	REVISED -
-	DRAWN CHECKED	DRAWN PAW CHECKED PJO

STATE	: OF	: ILLINOIS
DEPARTMENT	0F	TRANSPORTATION

		ALIGNMENT, TIES AND	F.A.I/P RTE.	SECTION	COUNTY	TOTAL SHEETS	SHEET NO.		
		LAKEVIEW AND CA	*	(99-1HB-1) R-1	WILL	1508	125		
					CONTRACT	NO. 6	0X10		
SCALE:	AS SHOWN	SHEET NO. 5 OF 12 SHEETS	STA.	TO STA.	* FAI 55.	FAP 856 ILLINOIS FED. AI	D PROJECT		



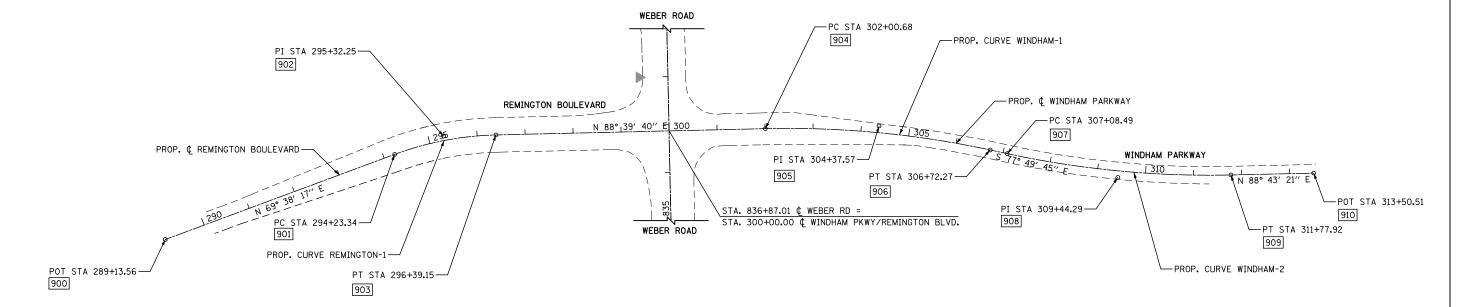

PROP. CURVE REMINGTON-1
PI STA. = 295+32.25

\$\Delta\$ = 19\text{01}' 23'' (RT)

\$D = 8\text{0} 48' 53'' R = 650.00' T = 108.91' L = 215.81' E = 9.06' Θ = ____ e = ____ T.R. = ____ S.E. RUN = ____ P.C. STA = 294+23.34 P.T. STA = 296+39.15

PROP. CURVE WINDHAM-1 PI STA. = 304+37.57 Δ = 13° 30′ 36″ (RT) D = 2° 51′ 53″ D = 2°51°53° R = 2,000.00′ T = 236.89′ L = 471.59′ E = 13.98′ e = ____ T.R. = ____ S.E. RUN = ____ P.C. STA = 302+00.68 P.T. STA = 306+72.27

PROP. CURVE WINDHAM-2 PI STA. = 309+44.29 \[\Delta = 13\circ 26' 54'' (LT) \]\[\Delta = 2\circ 51' 53'' \]\[\R = 2.000.00' \]\[\T = 235.80' \] L = 469.44' E = 13.85' e = ____ T.R. = ____ S.E. RUN = ____ P.C. STA = 307+08.49 P.T. STA = 311+77.92

COOPDINATE DATA

	COORDINA	IL DATA	
POT 900	N: 1819415.27 E: 1040099.23	PT 906	N: 1819601.80 E: 1041817.91
PC 901	N: 1819592.64 E: 1040577.16	PC 907	N: 1819594.16 E: 1041853.31
PI 902	N: 1819630.54 E: 1040679.26	PI 908	N: 1819544.45 E: 1042083.81
PT 903	N: 1819633.08 E: 1040788.13	PT 909	N: 1819549.70 E: 1042319.56
PC 904	N: 1819646.21 E: 1041349.51	POT 910	N: 1819553.55 E: 1042492.10
PI 905	N: 1819651.74 E: 1041586.34		
·			

SCALE IN FEET




USER NAME = mmaestra	DESIGNED	PAW	REVISED -	
	DRAWN	PAW	REVISED -	
PLOT SCALE = 1:200	CHECKED	PJ0	REVISED -	
PLOT DATE = 5/13/2017	DATE	05/12/17	REVISED -	
				-

STATE OF ILLINOIS **DEPARTMENT OF TRANSPORTATION**


ALIGNMENT, TIES AND BENCHMARKS	F.A.I/P RTE.	SECTION
REMINGTON BOULEVARD / WINDHAM PARKWAY	*	(99-1HB-1) R


COUNTY TOTAL SHEET NO. WILL 1508 126 CONTRACT NO. 60X10 SCALE: AS SHOWN | SHEET NO. 6 OF 12 SHEETS | STA. 289+13.56 | TO STA. 313+50.51 | * FAI 55, FAP 856 | ILLINOIS | FED. AID PROJECT

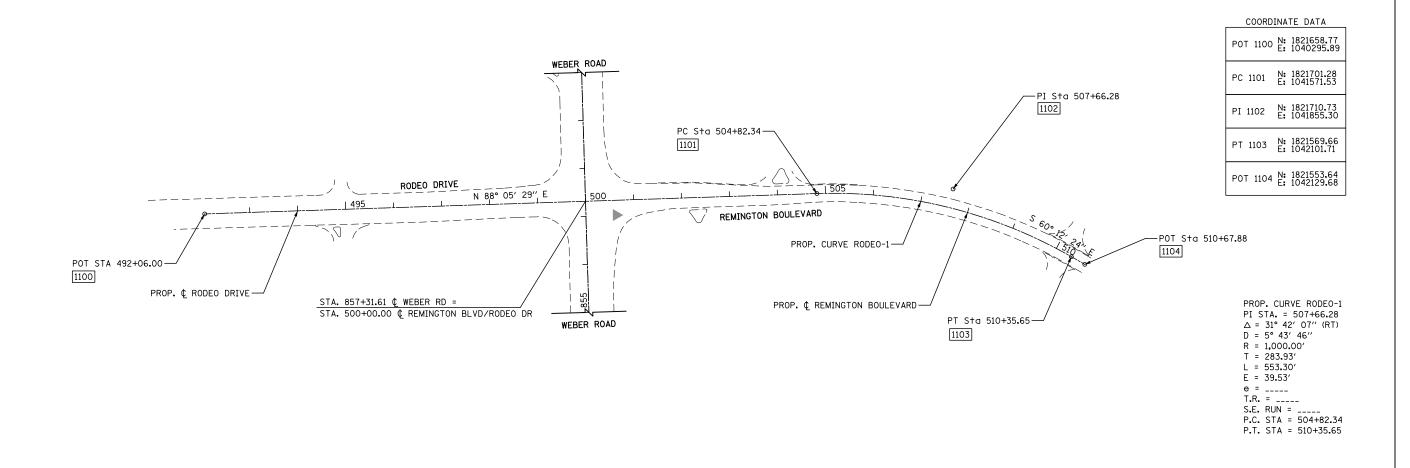



KNIGHT
Engineers & Architec


PLOT SCALE = 1:200 CHECKED PJO REVISED - STATE OF ILLINOIS PLOT SCALE = 1:200 CHECKED PJO REVISED - DEPARTMENT OF TRANSPORTATION ** (99-1HB-1) R-1 WILL 1508 1		USER NAME = mmaestra	DESIGNED	PAW	REVISED -		ALIG	IGNMENT, TIES AND	BENCHMARKS		F.A.I/P RTE.	SECTION	COUNTY	TOTAL SHI SHEETS N	EET NO.
CONTRACT NO. 60X:			DRAWN	PAW	REVISED -	STATE OF ILLINOIS		•			*	(99-1HB-1) R-1	WILL	1508 12	127
PLOT DATE = 5/13/2017 DATE 05/12/17 REVISED - SCALE: AS SHOWN SHEET NO. 7 OF 12 SHEETS STA. 492+06 TO STA. 510+67.88 **FAI 55, FAP 856 ILLINOIS FED. AID PROJECT	_	PLOT SCALE = 1:200	CHECKED	PJ0	REVISED -	DEPARTMENT OF TRANSPORTATION	NUDE	EO DRIVE / REIVINGIO	IN BUULEVAND				CONTRAC	T NO. 60X1	
	S	PLOT DATE = 5/13/2017	DATE	05/12/17	REVISED -		SCALE: AS SHOWN SHEET	NO. 7 OF 12 SHEETS	STA. 492+06 TO STA.	510+67.88	* FAI 55, F	AP 856 ILLINOIS FED. A	ID PROJECT		

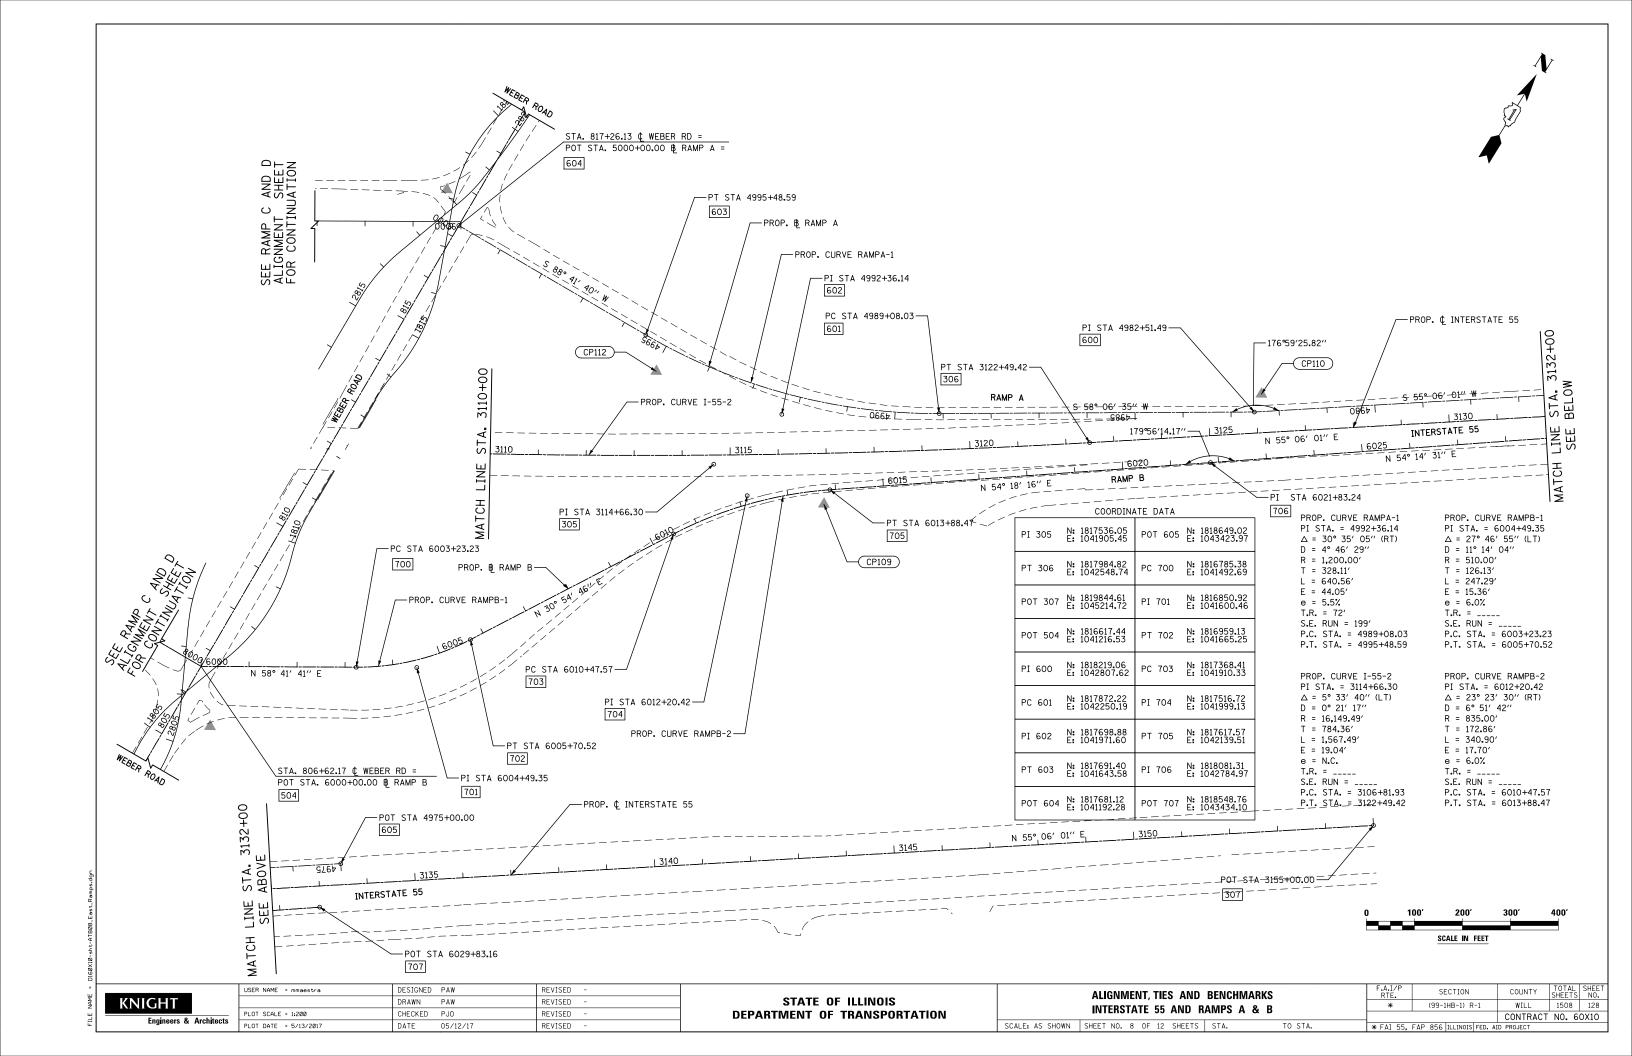

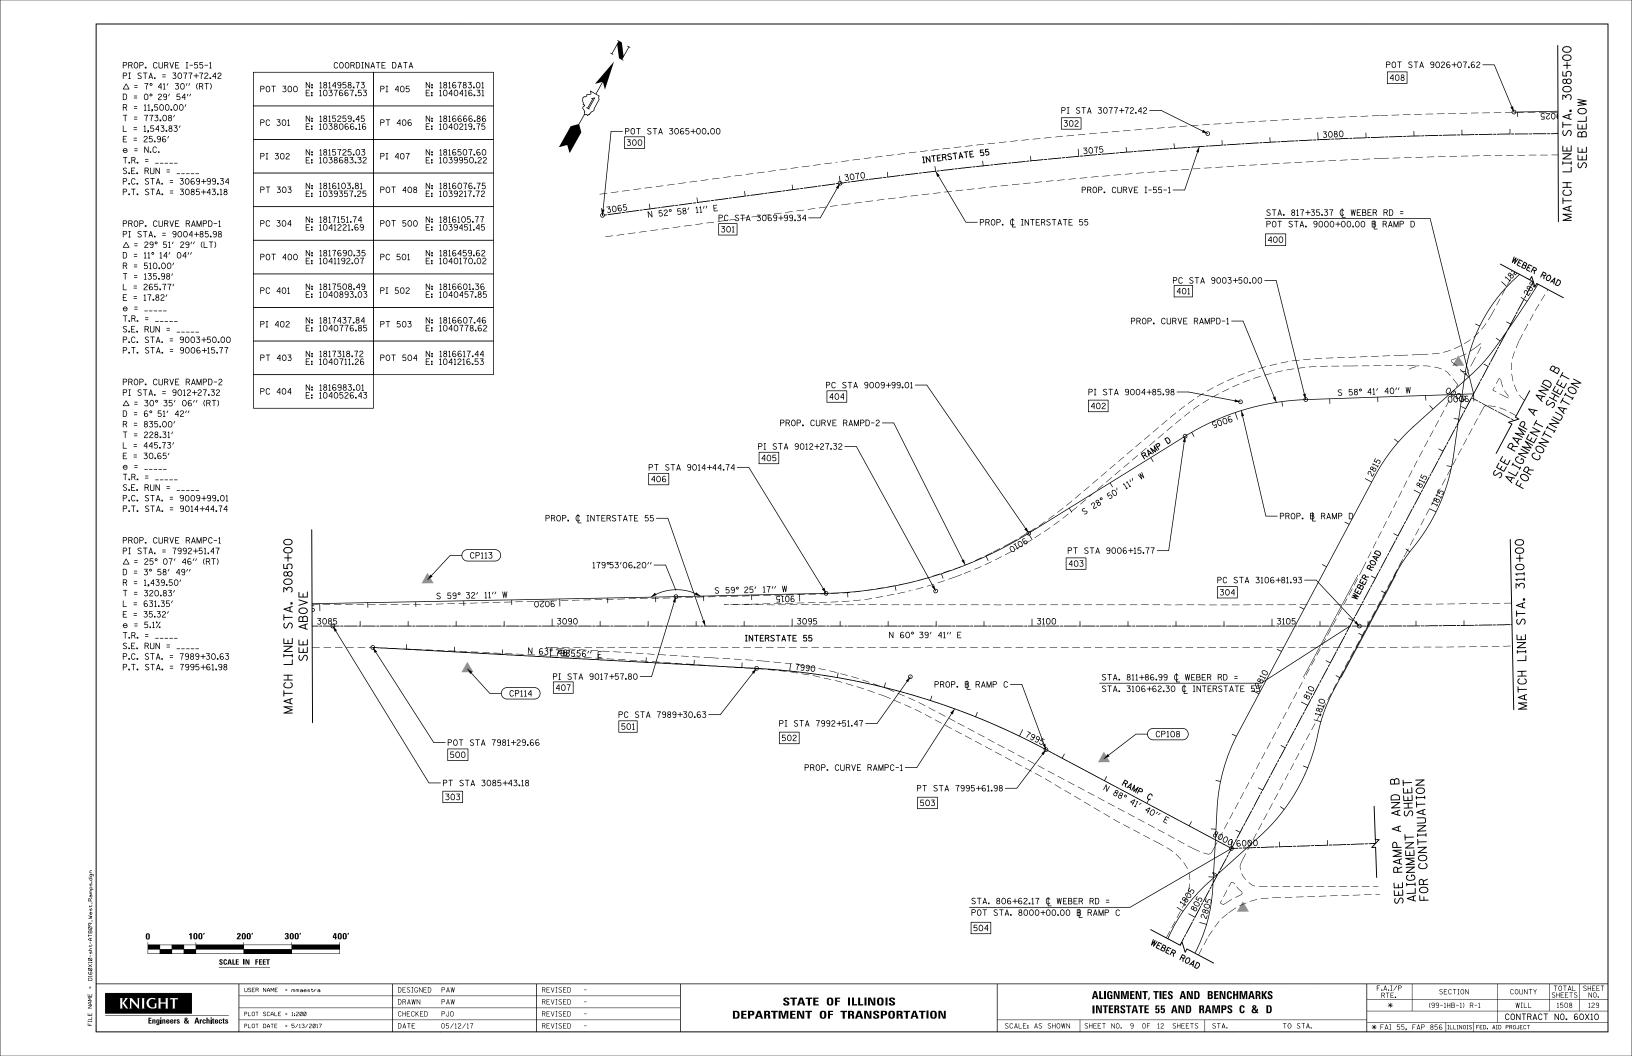

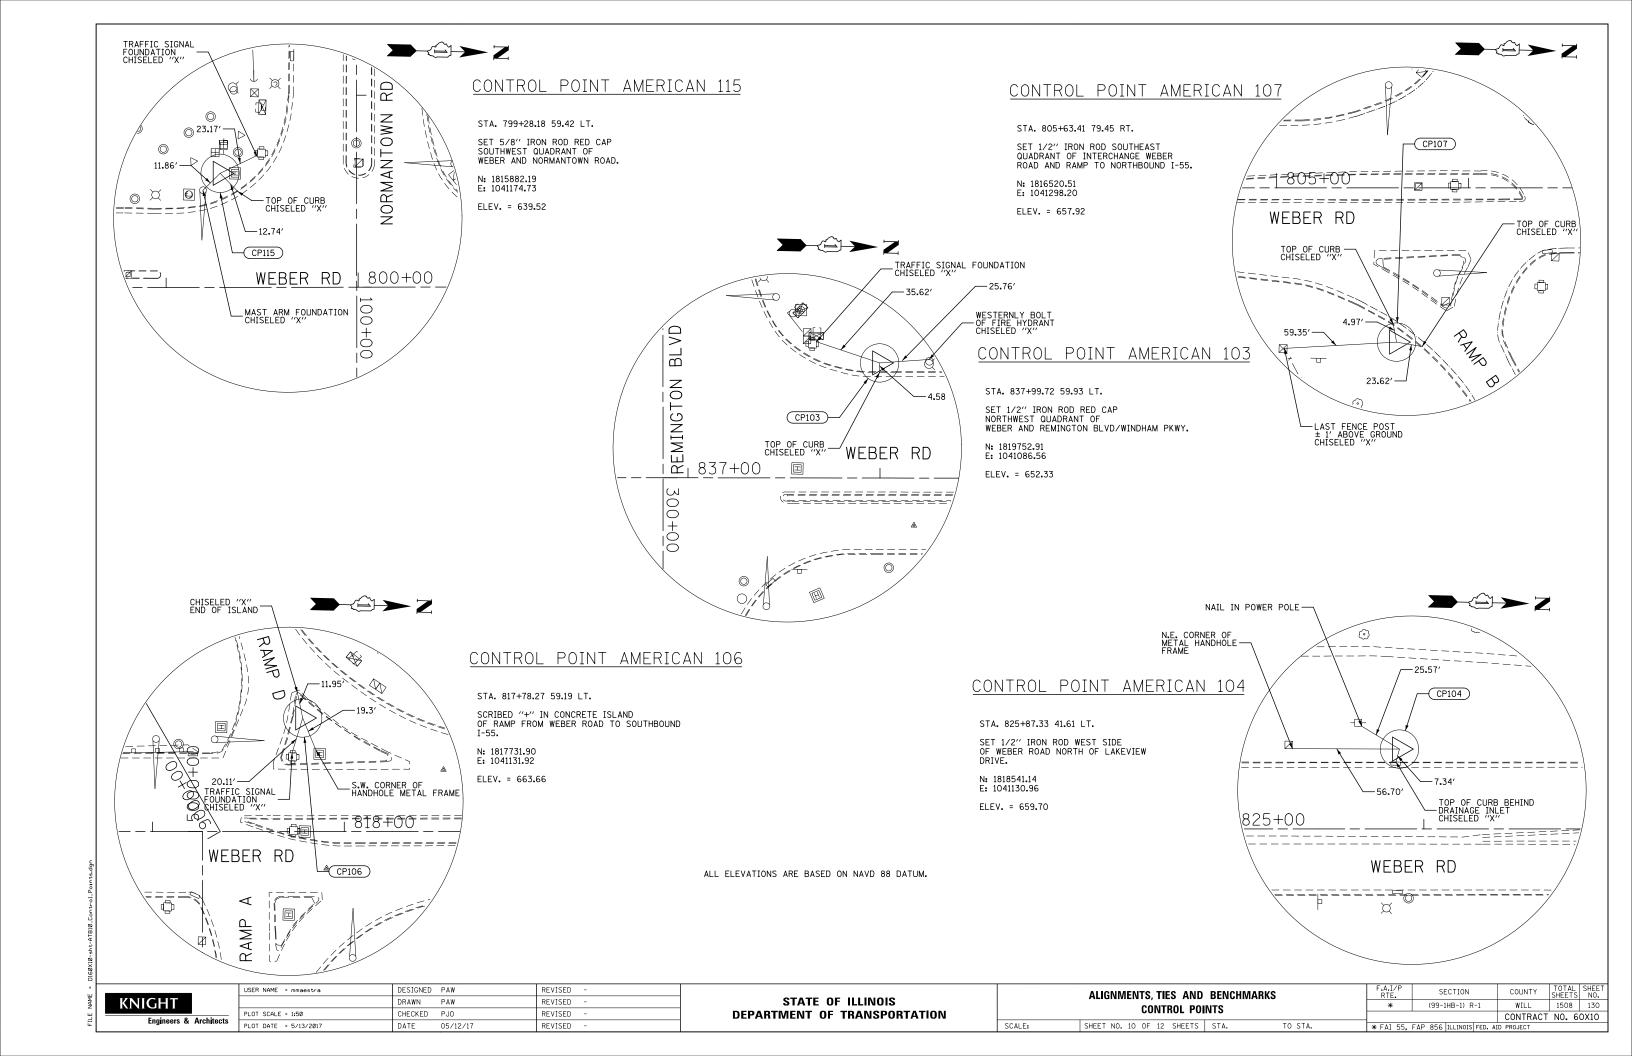

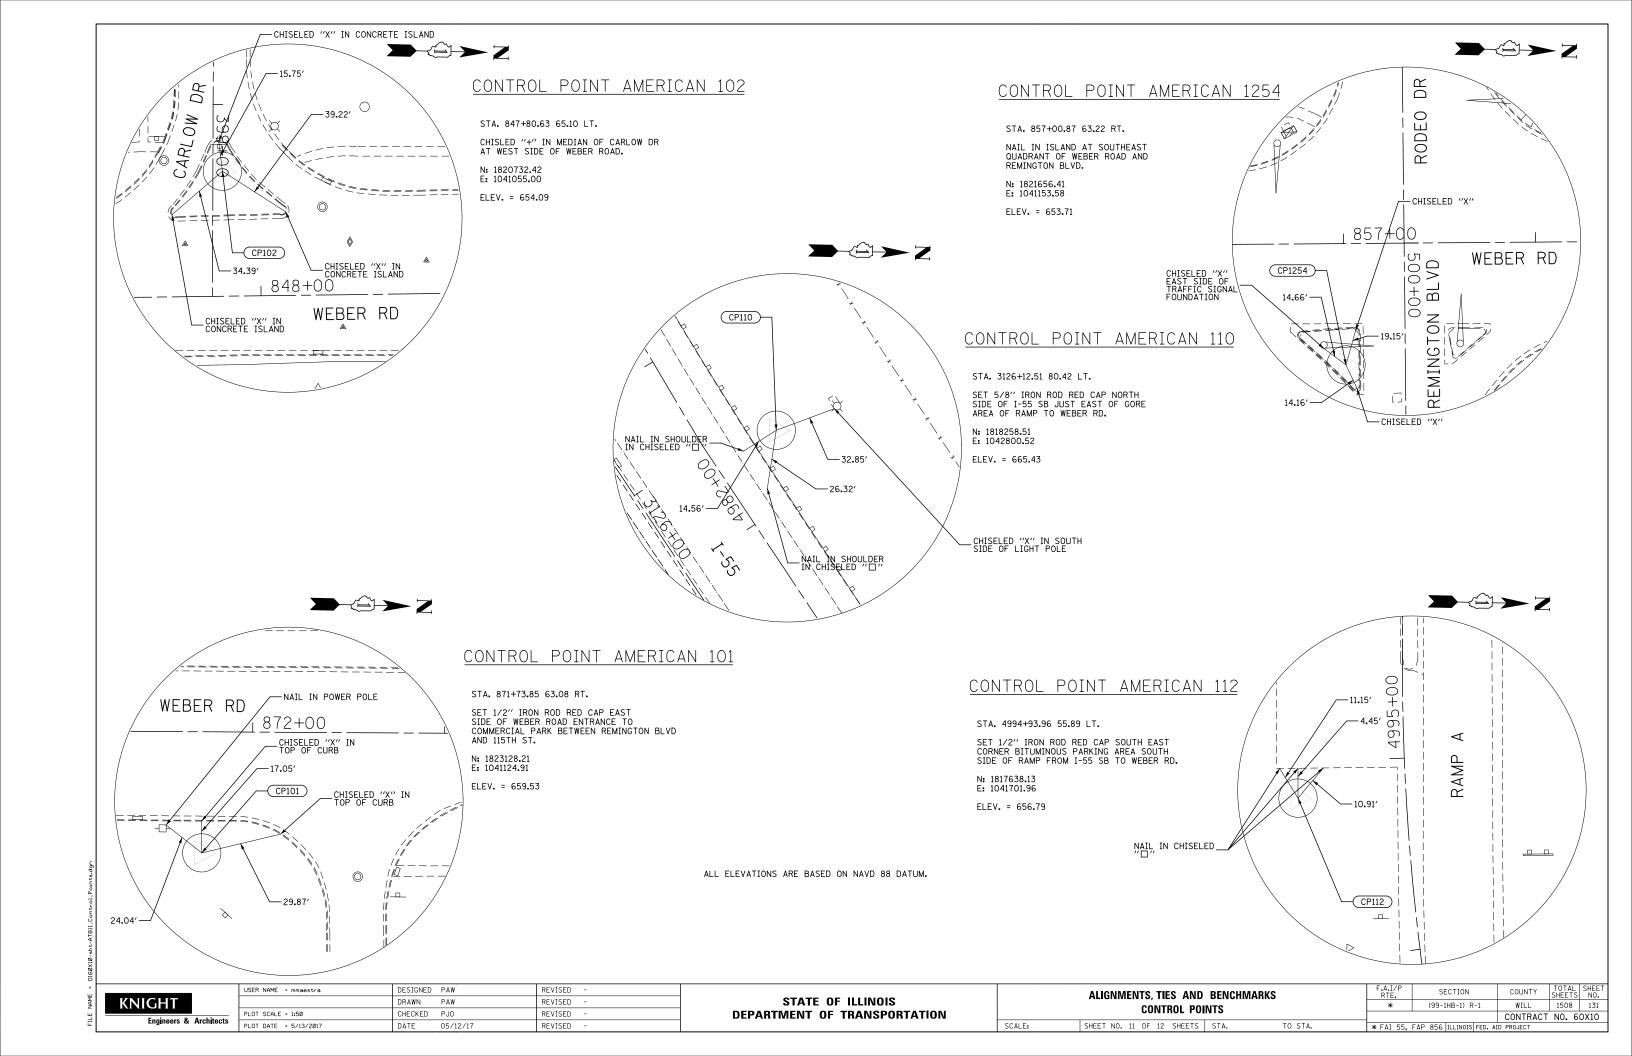

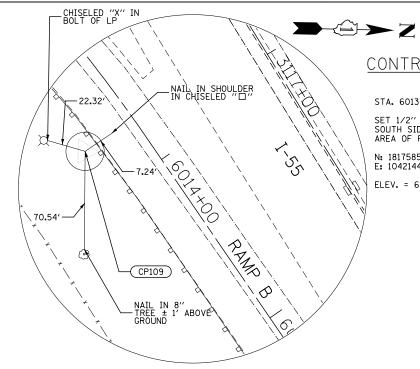

CONTROL POINT AMERICAN 109

STA. 6013+73.27 28.76 RT.

SET 1/2" IRON ROD RED CAP SOUTH SIDE OF I-55 NB AT GORE AREA OF RAMP FROM WEBER RD.

N: 1817585.55 E: 1042144.45

ELEV. = 657.90

BENCHMARK 3287

ELEV. 642.98 (NAVD 88)

FOUND CHISELED "□" IN SOUTHERLY CORNER OF CONCRETE FOUNDATION OF A TRAFFIC SIGNAL CONTROLLER BOX IN THE NORTHWEST QUADRANT OF WEBER ROAD AND NORMANTOWN ROAD.

BENCHMARK 3288


ELEV. 642.81 (NAVD 88)

FOUND CHISELED " \square " IN THE NORTHERLY SIDE OF A CONCRETE FOUNDATION TO A CANTILEVER TRAFFIC SIGNAL IN THE NORTHEAST QAUDRANT OF WEBER ROAD AND NORMANTOWN ROAD.

STA. 9022+74.44 45.23 RT.

N: 1816284.65 E: 1039481.97

ELEV. = 657.23

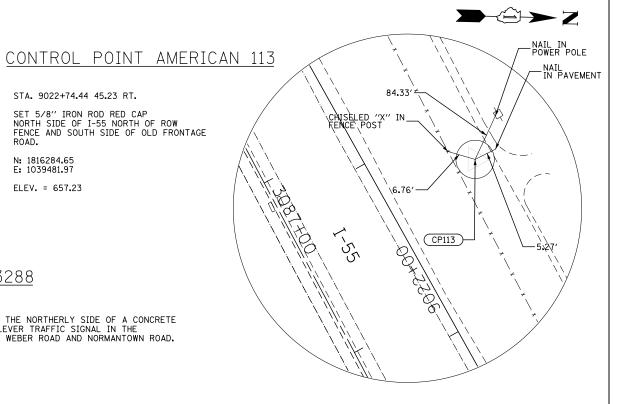

BENCHMARK LIN 17

ELEV. 654.37 (NAVD 88)

CHISELED "X" IN NORTH BOLT OF ROUND LIGHT POLE FOUNDATION BETWEEN I-55 SOUTHBOUND AND I-55 RAMP TO WEBER ROAD, MILE MARKER 263,71 SIGN.

BENCHMARK LIN 5


ELEV. 624.62 (NAVD 88)

CHISELED "□" EAST SIDE OF LIGHT POLE FOUNDATION WEST OF WEBER ROAD, 4TH POLE SOUTH OF WEBER ROAD AND NORMANTOWN ROAD, JUST NORTH OF "DISCOUNT TIRE CO."

BENCHMARK LIN 9

ELEV. 652.89 (NAVD 88)

CHISELED "" WEST SIDE OF FOUNDATION FOR MASTARM IN SOUTH EAST QUADRANT OF WEBER ROAD AND WINDHAM PARKWAY/REMINGTON BOULEVARD.

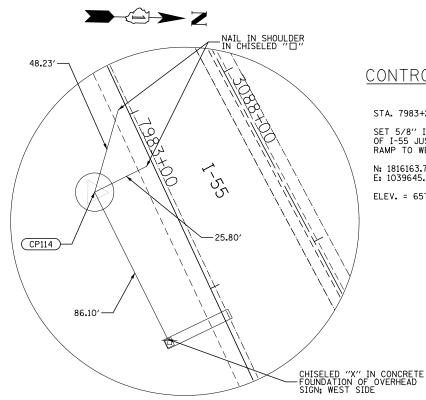

CONTROL POINT AMERICAN 114

STA. 7983+29.07 33.61 RT.

SET 5/8" IRON ROD RED CAP SOUTH SIDE OF I-55 JUST WEST OF GORE AREA OF RAMP TO WEBER RD.

N: 1816163.71 E: 1039645.19

ELEV. = 657.63

CONTROL POINT AMERICAN 108


STA. 7996+77.51 40.15 LT.

SET 1/2" IRON ROD RED CAP NORTH SIDE OF BITUMINOUS PARKING AREA NORTH SIDE OF RAMP FROM I-55 NB TO WEBER RD.

N: 1816650.23 E: 1040893.21

ELEV. = 649.71

SCALE:

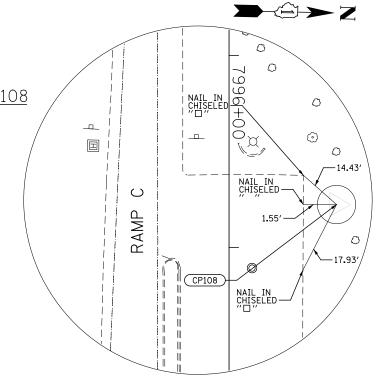

ALL ELEVATIONS ARE BASED ON NAVD 88 DATUM.

KNIGHT

USER NAME = mmaestra	DESIGNED	PAW	REVISED -
	DRAWN	PAW	REVISED -
PLOT SCALE = 1:50	CHECKED	PJ0	REVISED -
PLOT DATE = 5/13/2017	DATE	05/12/17	REVISED -

ALIG	NN	IEN			S AND ROL POI	BENCHMARI NTS	(S	
SHEET	NO.	12	0F	12	SHEETS	STA.	T0	STA.

F.A.I/F RTE.)		SE	ECTION			COUNTY	TOTAL SHEETS	SHEE
*			(99-1	IHB-1) R	-1		WILL	1508	132
							CONTRACT	NO. 6	0X10
∗FAI 5	5,	FAP	856	ILLINOIS	FED.	AID	PROJECT		

Engineers & Architects

STATE OF ILLINOIS **DEPARTMENT OF TRANSPORTATION**


TRAFFIC CONTROL DETOUR GENERAL NOTES


- 1. ALL SIGNING SHALL BE IN ACCORDANCE WITH IDOT DISTRICT 1 DETAIL TC-21 AND APPLICABLE PROVISIONS OF THE STATE OF ILLINOIS "STANDARD SPECIFICATIONS FOR ROAD AND BRIDGE CONSTRUCTION" ADOPTED JANUARY 1, 2016, THE DETAILS IN THESE PLANS, AND THE LATEST EDITION OF THE STATE OF ILLINOIS "MANUAL ON UNIFORM TRAFFIC CONTROL DEVICES". THIS INCLUDES POST-MOUNTING ALL SIGNS WHEREVER POSSIBLE IN ACCORDANCE WITH ARTICLE 701.14 AND STANDARD 701901.
- 2. THE RAMP TURNING RESTRICTIONS WILL BE LIMITED TO TWO CONSECUTIVE WEEKENDS. THE RESTRICTIONS SHALL BEGIN AT 8:00 PM FRIDAY EVENING AND SHALL BE REOPENED TO ALL TRAFFIC IN NINE CALENDAR DAYS AT 5:00 AM MONDAY. SEE SPECIAL PROVISIONS FOR MORE DETAILS.
- 3. THE ENGINEER SHALL BE NOTIFIED IN WRITING AT LEAST THREE WEEKS PRIOR TO THE DAY THE DETOUR IS TO BE IN EFFECT. THE ENGINEER WILL CONTACT THE VILLAGE OF BOLINGBROOK, VILLAGE OF ROMEOVILLE, WILL COUNTY DIVISION OF TRANSPORTATION AND ANY OTHER INTERESTED PARTIES.
- 4. THE CONTRACTOR WILL NOT BE ALLOWED TO RESTRICT RAMP TURN MOVEMENTS UNTIL ALL SIGNING IS ERECTED IN ACCORDANCE WITH THE DETOUR PLAN AND APPROVED BY THE ENGINEER.
- 5. THE CONTRACTOR SHALL MAKE ALL CHANGES IN THE SIGNING THAT ARE DEEMED NECESSARY BY THE ENGINEER. THIS WORK SHALL BE INCLUDED IN THE UNIT PRICE FOR TRAFFIC CONTROL AND PROTECTION (SPECIAL).
- 6. THE CONTRACTOR SHALL BE RESPONSIBLE FOR MAINTENANCE OF ALL BARRICADES, SIGNS, LIGHTS, AND OTHER TRAFFIC CONTROL DEVICES, INSTALLED BY HIM, THAT ARE IN PLACE AND OPERATING 24 HOURS A DAY, 7 DAYS A WEEK, FOR THE DURATION OF THIS DETOUR.
- 7. ALL EXISTING SIGNING THAT DOES NOT APPLY AND/OR CONFLICTS WITH THE DETOUR ROUTE WHILE THE DETOUR IS IN EFFECT SHALL BE COMPLETELY COVERED BY THE CONTRACTOR. THIS WORK SHALL BE INCLUDED IN THE COST FOR TRAFFIC CONTROL AND PROTECTION (SPECIAL).
- 8. ALL DETOUR SIGNING SHALL BE POST MOUNTED IN ACCORDANCE WITH ARTICLE 701.14 AND STANDARD 701901 EXCEPT AS OTHERWISE INDICATED ON THE PLANS.
- 9. THE CONTRACTOR WILL NOT BE ALLOWED TO CLOSE THE RAMPS PRIOR TO OBTAINING WRITTEN APPROVAL THAT THE TRAFFIC SIGNAL CONTROLLER AND CABINET HAS PASSED ALL TESTS AND IS FULLY OPERATIONAL AT THE VENDOR'S FACILITY. SEE SPECIAL PROVISIONS FOR ADDITIONAL DETAILS.


- 10. ALL DETOUR SIGNING DESIGNATED WITH "(0)" IN THE SIGN CODE OR WITH "(BLACK/ORANGE)" WITHIN PLAN NOTES SHALL HAVE BLACK LEGENDS ON ORANGE HIGH INTENSITY BACKGROUNDS AND STANDARD BLACK BORDERS. ALL DETOUR SIGNING SHALL BE NEW OR LIKE NEW CONDITION.
- 11. THE SIZES OF ALL SIGNS AND LETTER HEIGHTS NOT SPECIFIED IN THESE PLANS SHALL BE IN ACCORDANCE WITH THE ILLINOIS MANUAL ON UNIFORM TRAFFIC CONTROL DEVICES.
- TYPE III BARRICADES, AND THEIR APPLICATION, SHALL CONFORM TO HIGHWAY STANDARD 701901.
- 13. CONSTRUCTION EQUIPMENT SHALL NOT BE PARKED IMMEDIATELY
 BEHIND THE TYPE III BARRICADES OR WITHIN THE CLEAR ZONE AT ANY
 TIME. ARTICLE 107.14 OF THE STANDARD SPECIFICATIONS SHALL APPLY.
- 14. THE ENGINEER SHALL BE NOTIFIED AT LEAST THREE (3) DAYS PRIOR TO THE REMOVAL OF THE DETOUR. THE ENGINEER WILL CONTACT THE VILLAGE OF BOLINGBROOK, VILLAGE OF ROMEOVILLE, WILL COUNTY DIVISION OF TRANSPORTATION AND OTHER INTERESTED PARTIES.
- 15. PORTABLE CHANGEABLE MESSAGE SIGNS SHALL FLASH THE MESSAGE SHOWN IN THE SIGN LEGEND, TWO PHASES SHALL BE USED. EACH PHASE SHALL BE DISPLAYED FOR 3 SECONDS WITH A MAXIMUM CYCLE OF 6 SECONDS, LETTERS SHALL BE 18 INCHES HIGH AND ALL UPPER-CASE. CHANGEABLE MESSAGE SIGNS SHALL COMPLY WITH THE REQUIREMENTS IN SECTION 6F.60 OF THE 2009 MUTCD.
- 16. ANY TEMPORARY TRAFFIC SIGNAL TIMING ADJUSTMENTS THAT MAY BE REQUIRED BY THE CONTRACTOR DURING THE RAMP DETOURS AT EXISTING INTERSECTIONS ALONG THE DETOUR ROUTES SHALL BE PAID FOR SEPARATELY UNDER TEMPORARY TRAFFIC SIGNAL TIMING. SEE SPECIAL PROVISIONS FOR ADDITIONAL INFORMATION AND LOCATIONS. ADDITIONAL LOCATIONS REQUIRING TEMPORARY SIGNAL TIMING SHALL BE COORDINATED WITH THE ENGINEER, THE DEPARTMENT BUREAU OF TRAFFIC, WILL COUNTY DIVISION OF TRANSPORTATION AND LOCAL MUNICIPALITIES.
- 17. ALL TRAFFIC CONTROL SIGNING AND/OR DEVICES SHOWN ON THE DETOUR PLANS SHALL NOT BE PAID FOR SEPARATELY UNLESS OTHERWISE INDICATED ON THE PLANS, BUT SHALL BE INCLUDED IN THE CONTRACT UNIT PRICE FOR TRAFFIC CONTROL AND PROTECTION (SPECIAL).
- 18. RAMP A, RAMP B, RAMP C AND RAMP D DETOURS SHALL ALL BE IN EFFECT CONCURRENTLY AS INDICATED IN THE SUGGESTED SEQUENCE OF CONSTRUCTION INCLUDED IN THE MAINTENANCE OF TRAFFIC PLANS.
- 19. THE CONTRACTOR SHALL HAVE THE DETOUR IN EFFECT PRIOR TO ERECTING NEW GUIDE SIGNS AT THE INTERCHANGE.


KNIGHT	
Engineers &	Architect

USER NAME = mmaestra	DESIGNED	MJM	REVISED -
	DRAWN	PAW	REVISED -
PLOT SCALE = 1:2	CHECKED	PJ0	REVISED -
PLOT DATE = 5/13/2017	DATE	05/12/17	REVISED -

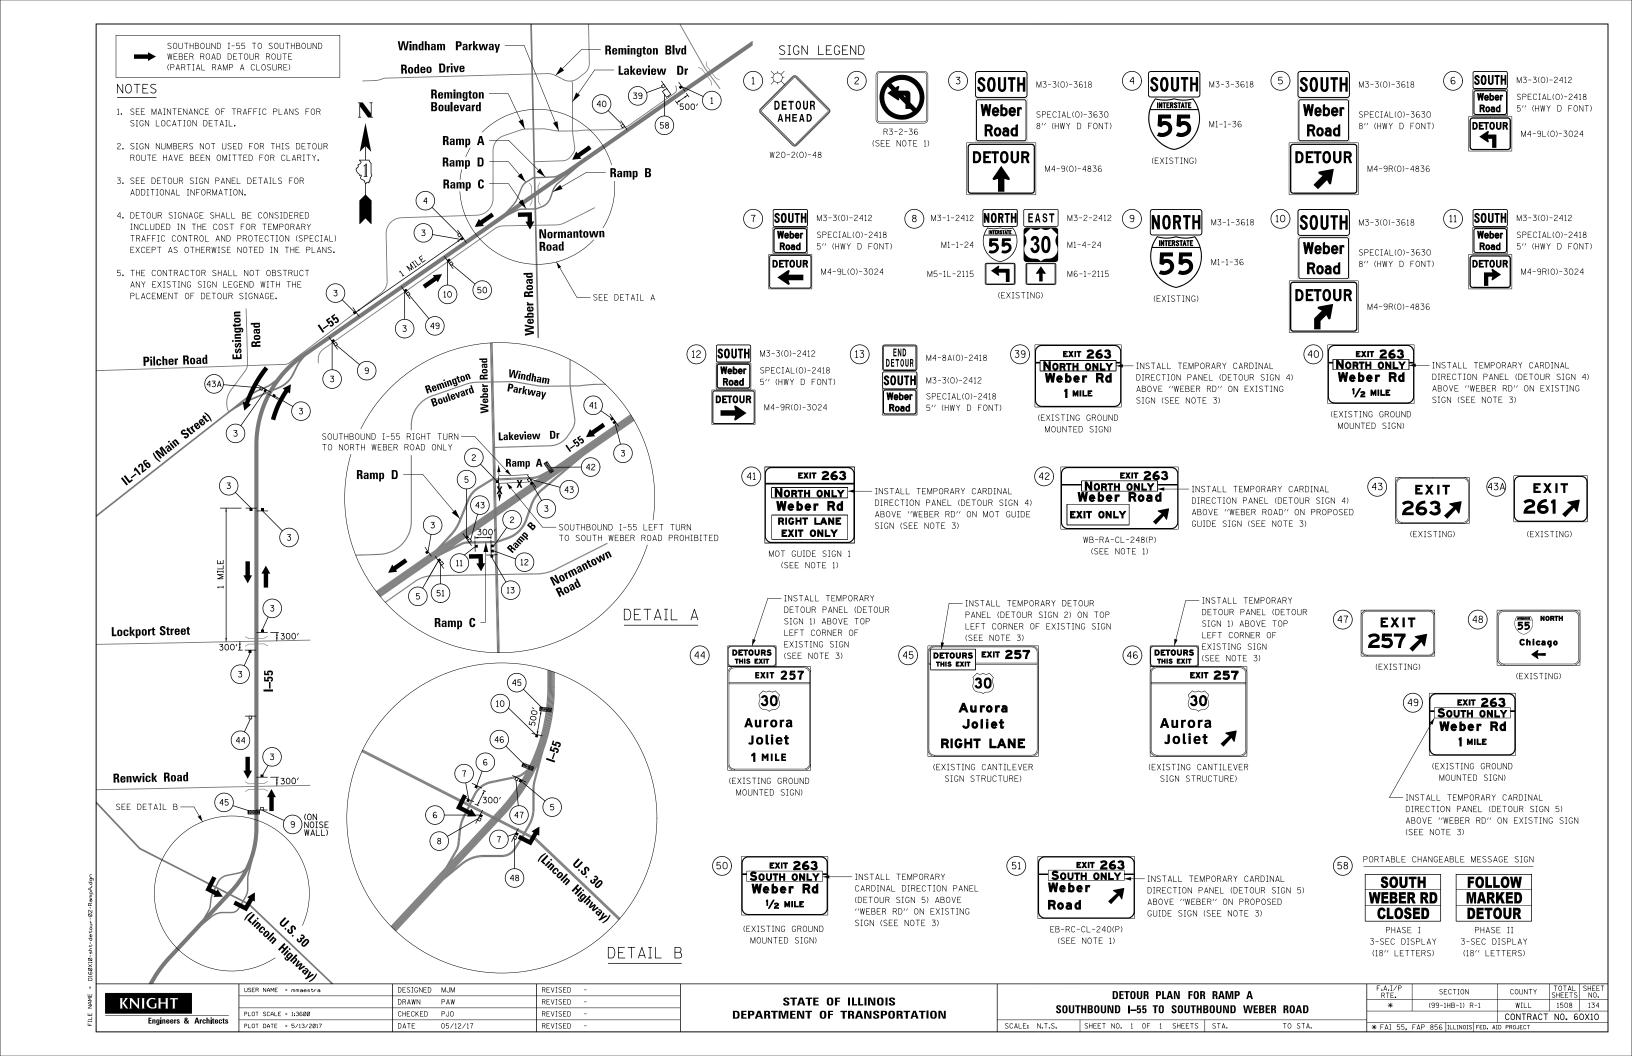

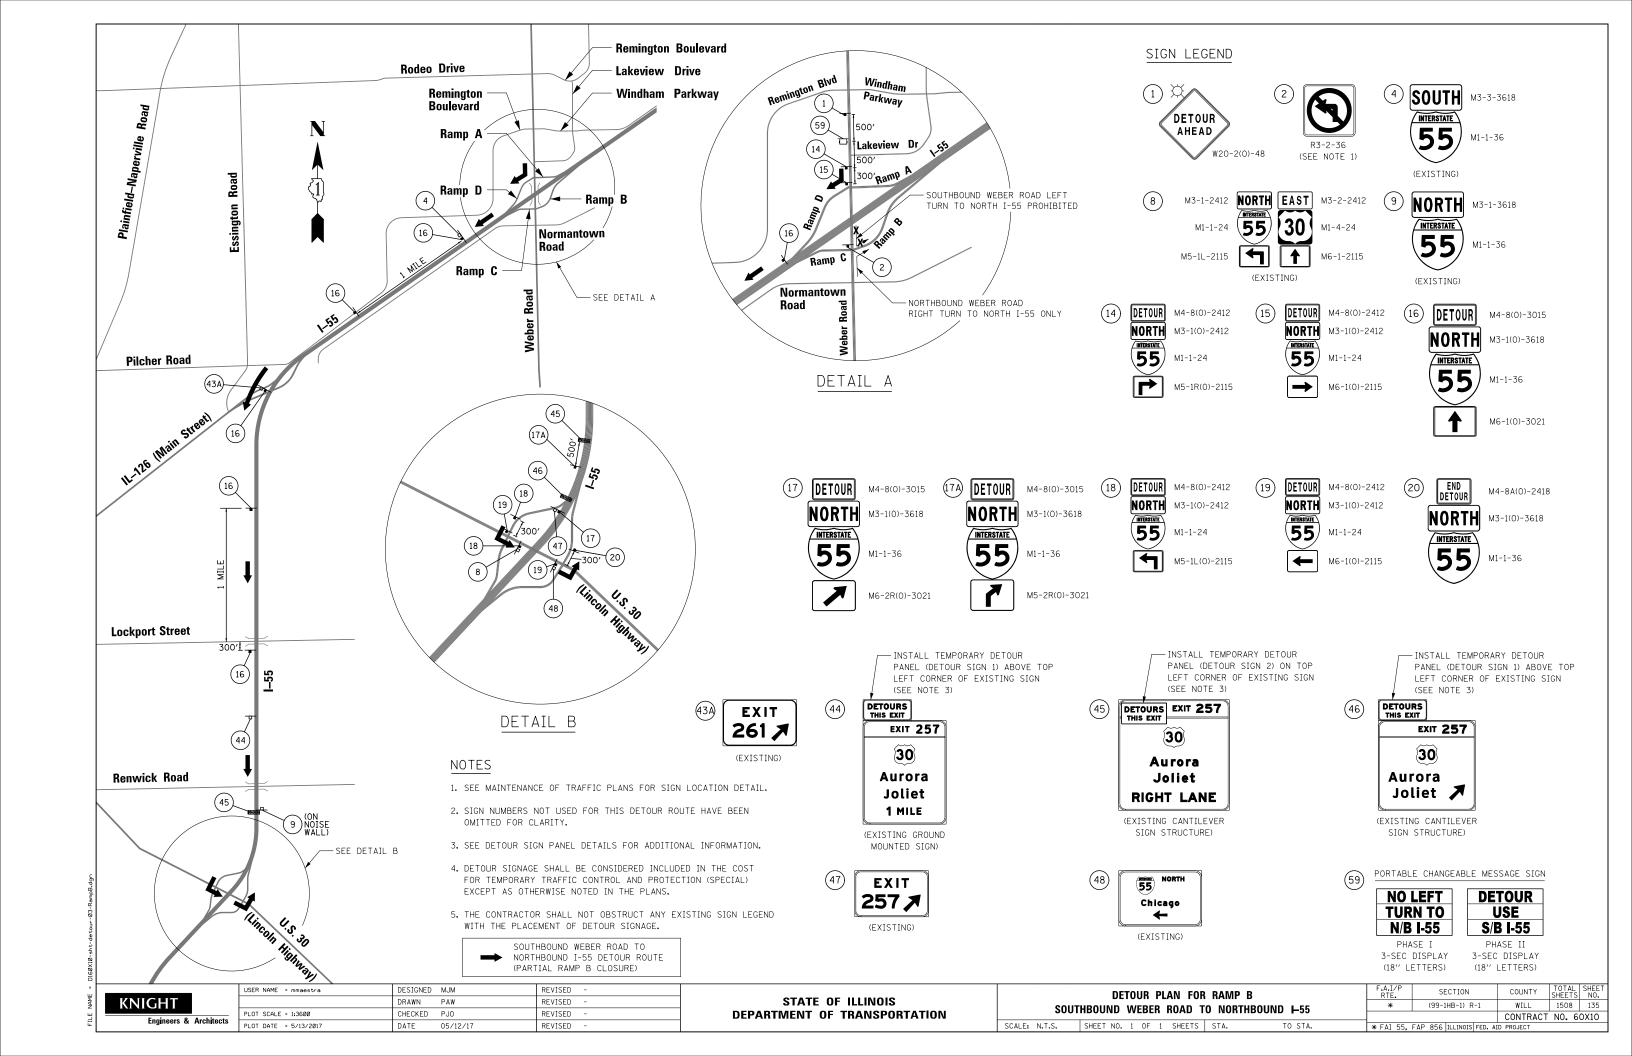

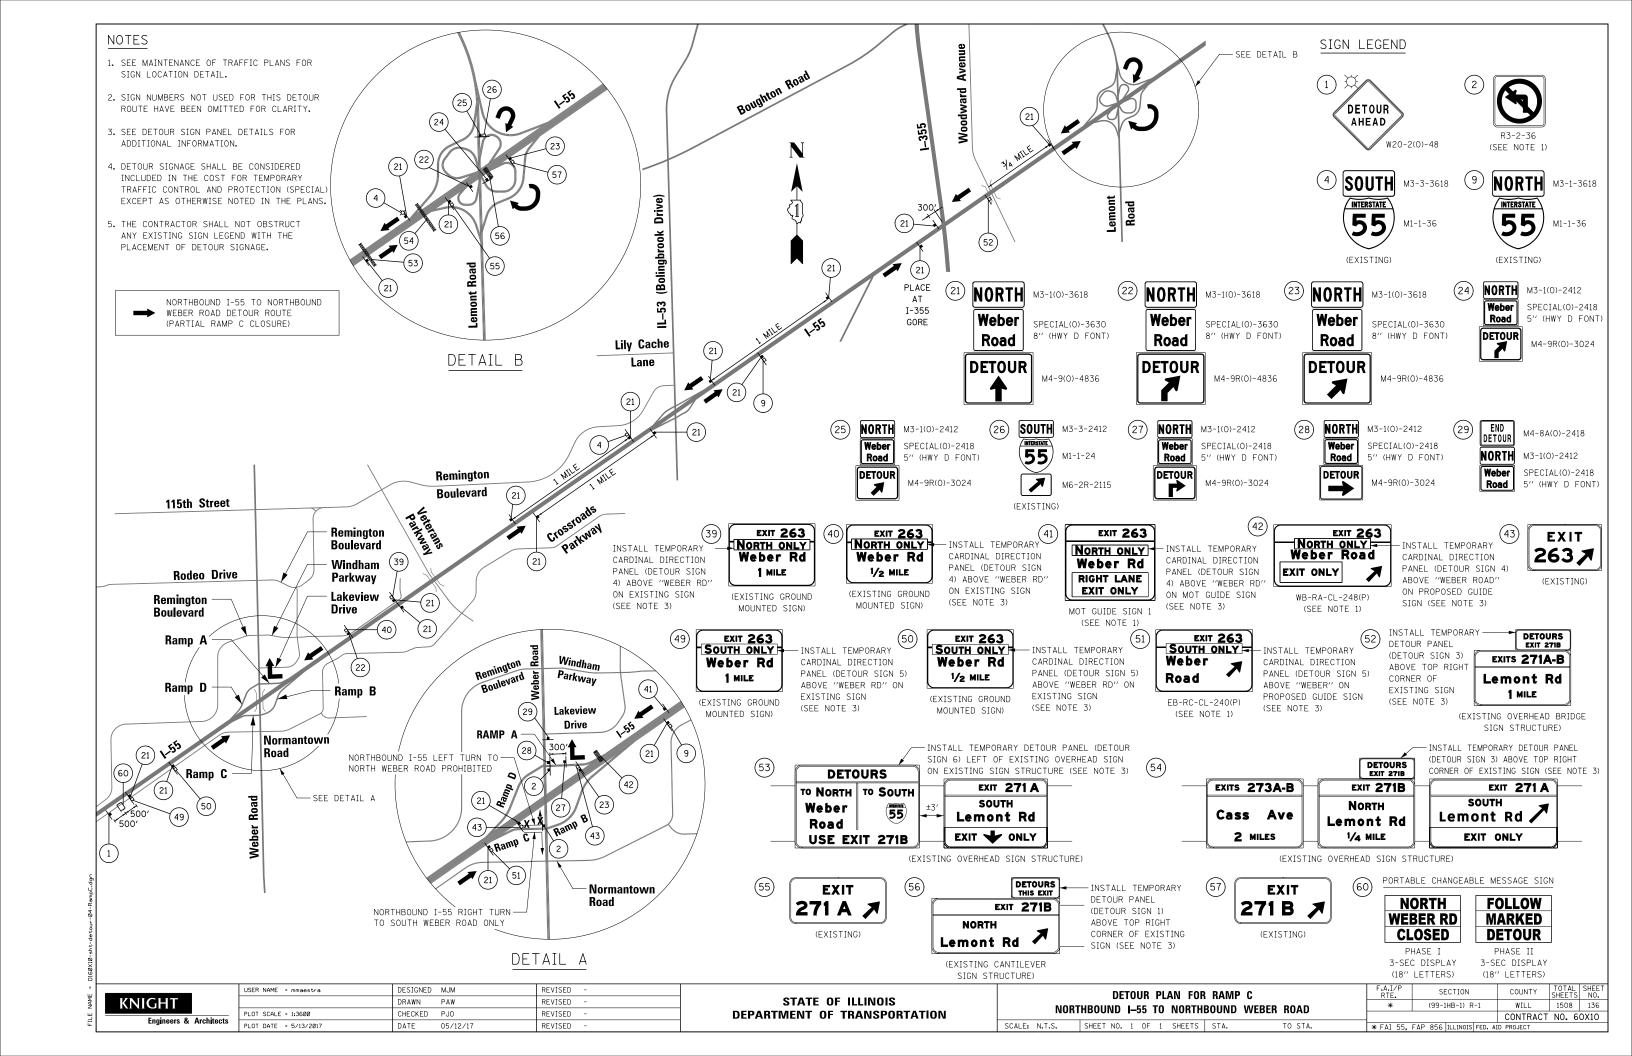

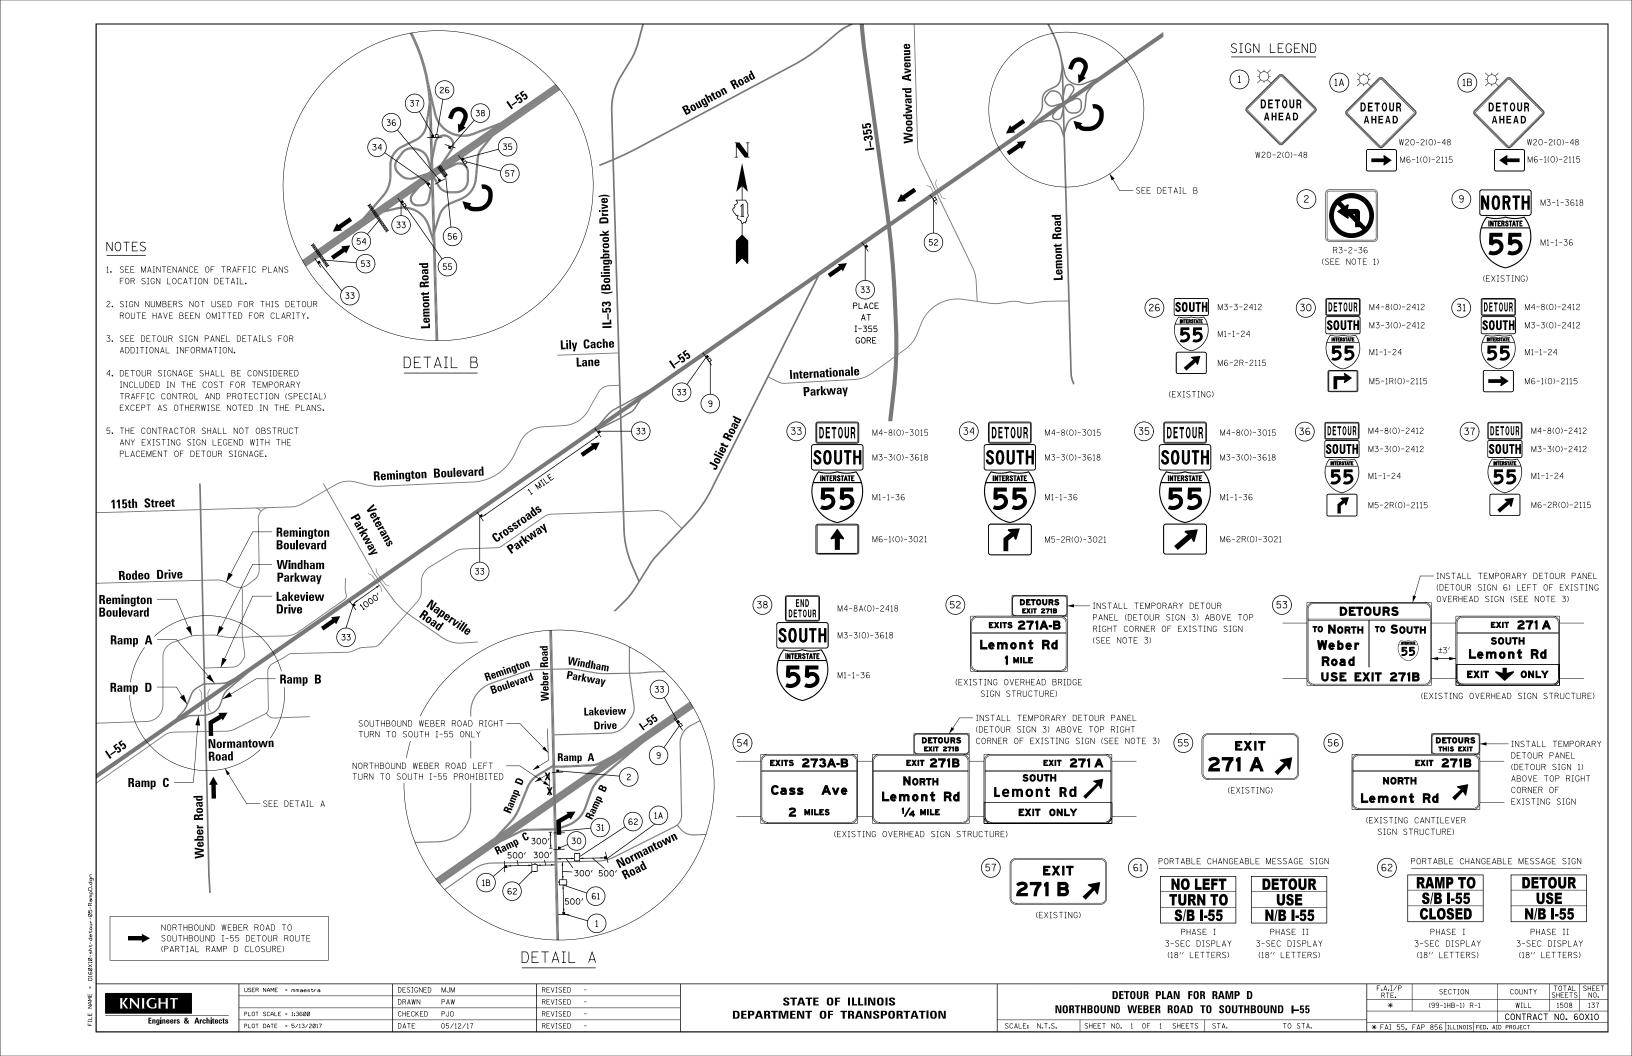

SIGN DETAIL

SPECIAL(O)-2418 DETOUR SIGNS SHALL BE CONSIDERED INCLUDED IN THE COST FOR TRAFFIC CONTROL AND PROTECTION (SPECIAL) AND WILL NOT BE MEASURED FOR PAYMENT, NO ADDITIONAL COMPENSATION WILL BE ALLOWED.

Weber Road

SIGN NUMBER	SPECIAL(O)-2418 (DETOUR)
WIDTH x HGHT.	2'-0" x 1'-6"
BORDER WIDTH	0.63"
CORNER RADIUS	1.5"
MOUNTING	Overhead
BACKGROUND	TYPE: AP SHEETING
	COLOR: Orange
LEGEND/BORDER	TYPE: AP SHEETING
	COLOR: Black/Black

SYMBOL	ROT	Х	Υ	WID	HT


Panel Style: construction_guide.ssi Dimensions are in inches.tenths

Letter locations are panel edge to lower left corner

							LET	TER	POSIT	IONS	(X)				LENGTH	H SERIES/SIZE
W	е	b	е	r												D 2000
3.1	8	11.6	15.2	18.9											17.7	5/3.8
R	0	а	d													D 2000
4.8	8.8	12.4	16												14.2	5/3.8
																1

SIGN DETAIL 1:25

SPECIAL(0)-3630 DETOUR SIGNS SHALL BE CONSIDERED INCLUDED IN THE COST FOR TRAFFIC CONTROL AND PROTECTION (SPECIAL) AND WILL NOT BE MEASURED FOR PAYMENT. NO ADDITIONAL COMPENSATION WILL BE ALLOWED.

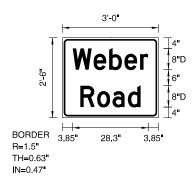

Panel Style: construction_guide.ssi Dimensions are in inches.tenths

SCALE: NONE

Letter locations are panel edge to lower left corner

SIGN NUMBER	SPECIAL(O)-3630 (DETOUR)
WIDTH x HGHT.	3'-0" x 2'-6"
BORDER WIDTH	0.63"
CORNER RADIUS	1.5"
MOUNTING	Ground
BACKGROUND	TYPE: AP SHEETING
	COLOR: Orange
LEGEND/BORDER	TYPE: AP SHEETING
	COLOR: Black/Black

SYMBOL	ROT	Х	Υ	WID	HT


TOTAL SHEET NO. 1508 138


							LET	TER	POSIT	IONS	(X)				LENGTH	SERIES/SIZE
W	е	b	е	r												D 2000
3.8	11.7	17.5	23.3	29.1											28.3	8/6
R	0	а	d													D 2000
6.7	13	18.8	24.5												22.6	8/6

KNIGHT Engineers & Architects

USER NAME = mmaestra	DESIGNED	MJM	REVISED -
	DRAWN	PAW	REVISED -
PLOT SCALE = 1:3	CHECKED	PJ0	REVISED -
PLOT DATE = 5/13/2017	DATE	05/12/17	REVISED -


				F.A.I/P RTE.	SECTION	COUNTY
DETOUR SIGN	ING PAI	NEL DETAILS		*	(99-1HB-1) R-1	WILL
						CONTRAC
SHEET NO. 1 OF 5	SHEETS	STA.	TO STA.	¥ FAT 55	EAP 856 TH INOIS FED	ATD PROJECT

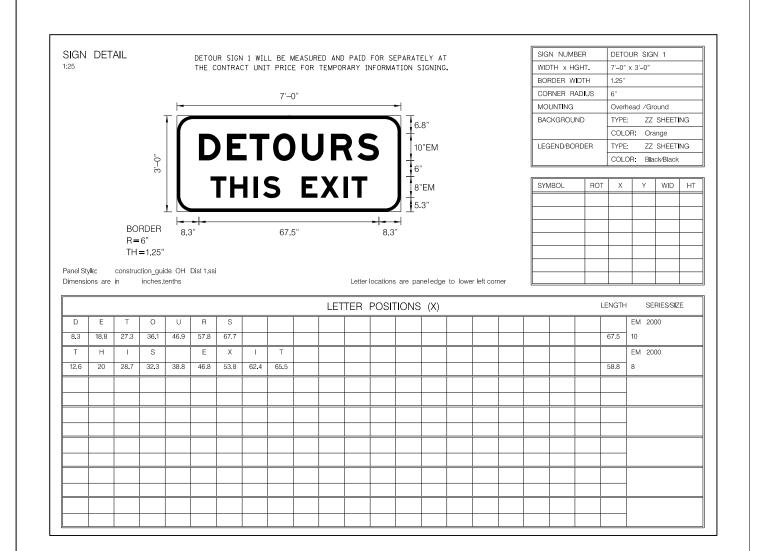

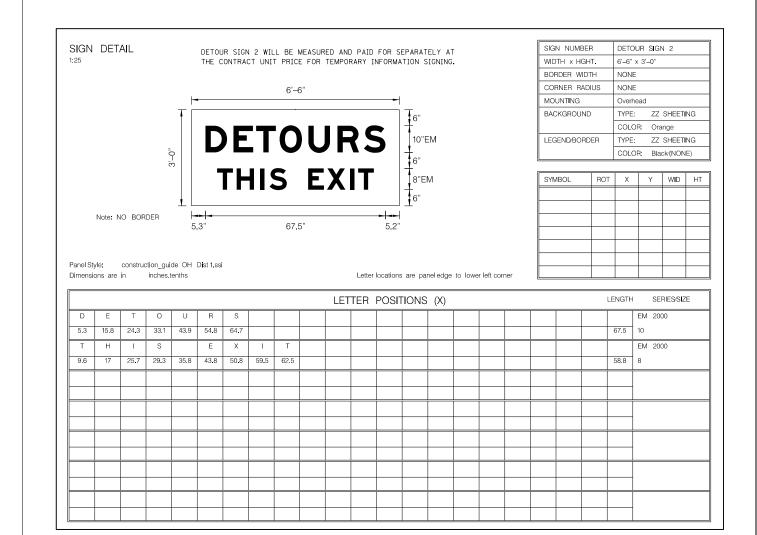



USER NAME = mmaestra	DESIGNED	MJM	REVISED -	Ξ
	DRAWN	PAW	REVISED -	
PLOT SCALE = 1:3	CHECKED	PJ0	REVISED -	
PLOT DATE = 5/13/2017	DATE	05/12/17	REVISED -	

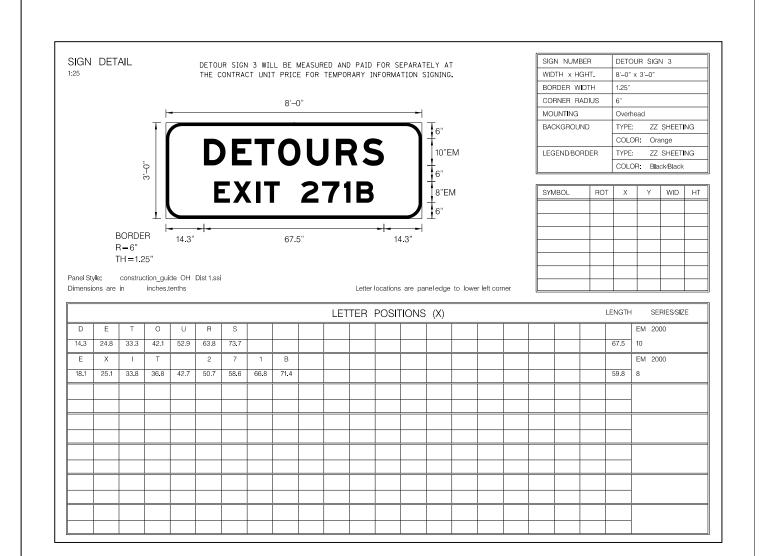


KNIGHT	
Engineers &	Architects

USER NAME = mmaestra	DESIGNED	MJM	REVISED -
	DRAWN	PAW	REVISED -
PLOT SCALE = 1:3	CHECKED	PJ0	REVISED -
PLOT DATE = 5/13/2017	DATE	05/12/17	REVISED -

STATE O	F ILLINOIS
DEPARTMENT OF	TRANSPORTATION

		F.A.I/P RTE.	SECTION	COUNTY	TOTAL SHEETS	SHEET NO.		
	DETOUR SIGNING PA	*	(99-1HB-1) R-1	WILL	1508	140		
						CONTRACT	NO. 6	0X10
SCALE: NONE	SHEET NO. 3 OF 5 SHEETS	* FAI 55, FAP 856 ILLINOIS FED. AID PROJECT						


4E = D160X10-sht-detour-08-SigningDetail.d

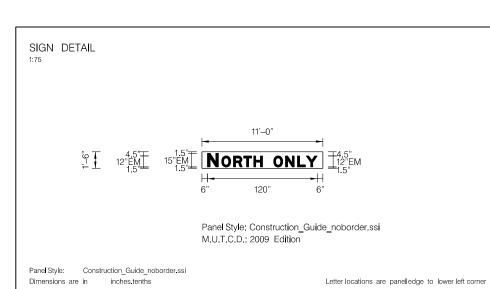

Diritorioi	0110 010							Lotto		are par	.o.oogo	10 10110	 			
							LET	TER	POSIT	IONS	(X)				LENGTH	SERIES/SIZE
N	0	R	Т	Н												EM 2000
6	21.5	34.4	45.5	56.5											60.2	15,12
0	N	L	Υ													EM 2000
78.2	91.2	104.3	113.9												47.8	12

SIGN NUMBER	DETOUR SIGN 4
WIDTH x HGHT.	11'-0" x 1'-6"
BORDER WIDTH	NONE
CORNER RADIUS	NONE
MOUNTING	Overhead
BACKGROUND	TYPE: AP SHEETING
	COLOR: Orange
LEGEND/BORDER	TYPE: AP SHEETING
	COLOR: Black/Orange

SYMBOL	ROT	Х	Υ	W I D	НТ

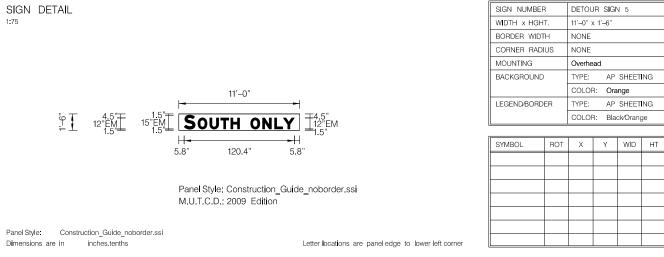


							LET	TER	POSIT	IONS	(X)				LENGTH	SERIES/SIZE
S	0	U	Т	Н												EM 2000
5.8	20.8	33.8	45.7	56.7											60.6	15,12
0	N	L	Υ													EM 2000
78.4	91.4	104.5	114,1												47.8	12

KNIGHT
Engineers & Architects

USER NAME = mmaestra	DESIGNED	MJM	REVISED -	_
	DRAWN	PAW	REVISED -	
PLOT SCALE = 1:3	CHECKED	PJ0	REVISED -	
PLOT DATE = 5/13/2017	DATE	05/12/17	REVISED -	

1					F.A.I/P RTE.	SECTION	COUNTY	TOTAL	
		DETOUR SIGNING PA	*	(99-1HB-1) R-1	WILL	1508	141		
ļ							CONTRACT	NO. 6	0X10
	SCALE: NONE	SHEET NO. 4 OF 5 SHEETS	STA.	TO STA.	* FAI 55,	FAP 856 ILLINOIS FED, A	ID PROJECT		

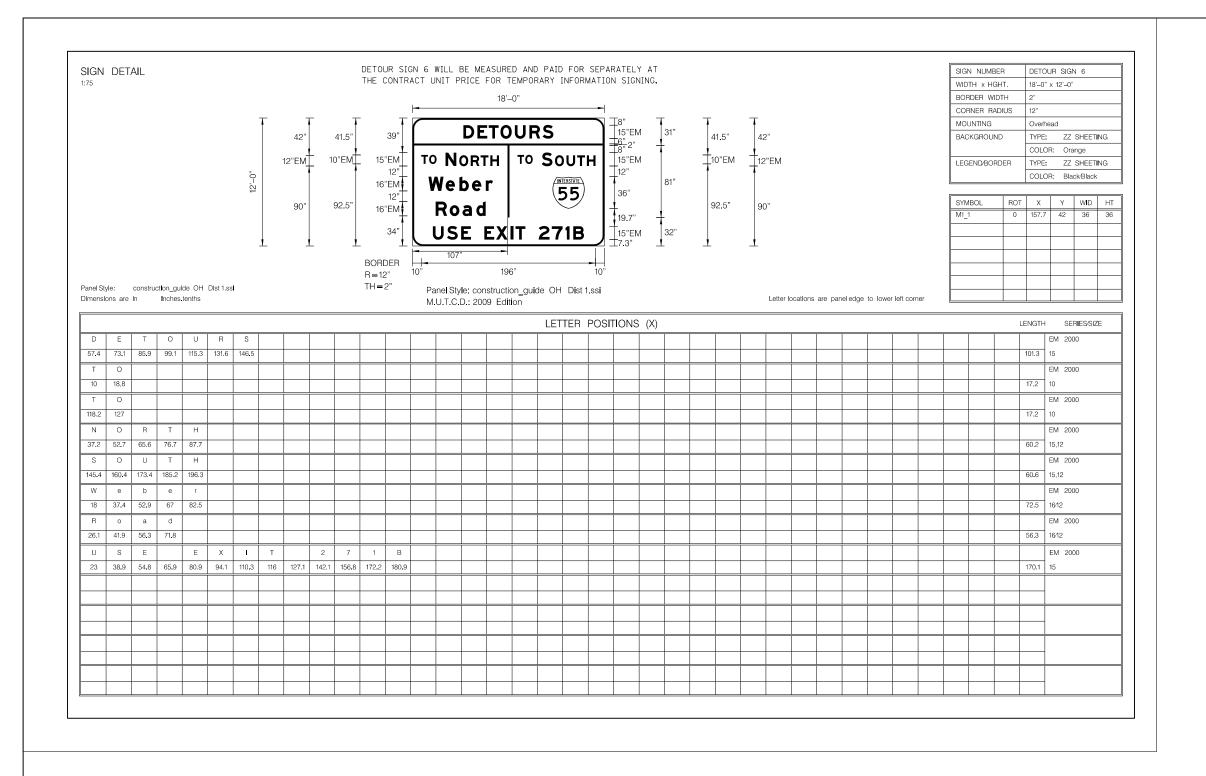

KNIGHT	
Engineers &	Architects

USER NAME = mmaestra	DESIGNED	MJM	REVISED -
	DRAWN	PAW	REVISED -
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STATE OF	: ILLINOIS
DEPARTMENT OF	TRANSPORTATION

			F.A.I/P RTE.	SECTION	COUNTY	TOTAL SHEETS	SHEET NO.
١		DETOUR SIGNING PA	*	(99-1HB-1) R-1	WILL	1508	142
ļ					CONTRACT	NO. 6	0X10
	SCALE: NONE	SHEET NO. 5 OF 5 SHEETS	* FAI 55,	FAP 856 ILLINOIS FED, AI	D PROJECT		

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MAINTENANCE OF TRAFFIC GENERAL NOTES

- 1. THE CONTRACTOR SHALL PROVIDE AND MAINTAIN A MINIMUM OF TWO 12' THROUGH TRAFFIC LANES IN EACH DIRECTION ON WEBER ROAD EXCEPT AS OTHERWISE INDICATED ON THE PLANS. OFF-PEAK PERIOD LANE CLOSURES WILL BE ALLOWED FOR CONSTRUCTION ACTIVITY ONLY AS APPROVED BY THE ENGINEER. SEE SPECIAL PROVISIONS FOR ALLOWABLE OFF-PEAK PERIOD LANE CLOSURE TIMES.
- 2. THE CONTRACTOR SHALL PROVIDE ALL SIGNS, VERTICAL PANELS, TYPE III BARRICADES, CHANNELIZATION DRUMS, TYPE II BARRICADES, ALL TEMPORARY CONCRETE BARRIERS AND PROTECTION NECESSARY FOR WORK ZONE TRAFFIC CONTROL AND PROTECTION, OR AS DIRECTED BY THE ENGINEER.
- 3. THE CONTRACTOR SHALL INSTALL AND MAINTAIN PROPOSED AND TEMPORARY DRAINAGE SYSTEMS,AND
 EROSION CONTROL MEASURES DURING STAGE CONSTRUCTION THROUGHOUT THE DURATION OF THE PROJECT.
 THIS WORK SHALL BE INCLUDED IN THE COST OF THE PAY ITEMS ASSOCIATED WITH THE APPLICABLE
 DRAINAGE SYSTEMS AND EROSION CONTROL MEASURES. SEE TEMPORARY DRAINAGE AND EROSION CONTROL PLANS.
- 4. THE CONTRACTOR SHALL CONTACT THE DISTRICT ONE TRAFFIC CONTROL SUPERVISOR AT (847)705-4155 FOR EXPRESSWAYS, (847)705-4470 FOR ARTERIALS, ROMEOVILLE PUBLIC WORKS (815)886-1870, AND WILL COUNTY DIVISION OF TRANSPORTATION (815)727-8476. FOR WORK WITHIN THE CITY LIMITS OF ROMEOVILLE, A MINIMUM OF 72 HOURS IN ADVANCE OF BEGINNING OF WORK.
- 5. THE CONTRACTOR SHALL USE TEMPORARY PAVEMENT MARKING ON SURFACES TO BE REMOVED AND IN AREAS THAT DO NOT CONFLICT WITH OTHER STAGES.
- 6. THE CONTRACTOR SHALL USE DURING ALL WINTER STAGING MONTHS (NOVEMBER 1 APRIL 1) PERMANENT PAVEMENT MARKINGS. THE PERMANENT PAVEMENT MARKING MATERIAL SHALL BE APPROVED BY THE ENGINEER. PERMANENT PAVEMENT MARKING ON NEW OR EXISTING PAVEMENT TO REMAIN SHALL BE REMOVED BY WATER BLASTING OR AS APPROVED BY THE ENGINEER. PAVEMENT MARKING TO BE REMOVED FROM TEMPORARY OR EXISTING PAVEMENT SHALL BE REMOVED BY GRIDING OR AS APPROVED BY THE ENGINEER.
- THE CONTRACTOR SHALL USE PAVEMENT MARKING TAPE, TYPE IV ON EXISTING SURFACES TO REMAIN, AREAS IN CONFLICT WITH OTHER STAGES AND PERMANENT SURFACES EXCEPT DURING WINTER MONTHS.
- 8. THE CONTRACTOR SHALL ESTABLISH AND MAINTAIN OPENINGS IN THE BARRIER WALL ALONG INTERSTATE 55 AND RAMPS A, B, C, AND D WITH THE APPROVAL OF THE ENGINEER. THE FOLLOWING QUANTITIES HAVE BEEN INCLUDED FOR CONTRACTOR ACCESS: FOUR (4) TEMPORARY ATTENTUATOR IMPACT ATTENUATORS, TEMPORARY (FULLY REDIRECTIVE, NARROW), TEST LEVEL 3 AND FOUR (4) IMPACT ATTENUATORS, RELOCATE (FULLY REDIRECTIVE, NARROW), TEST LEVEL 3. SIGNING FOR THE WORK ZONE OPENINGS SHALL FOLLOW DISTRICT ONE STANDARD TC-18.
- 9. ARTERIALS AND SIDE ROAD PAVEMENT MARKINGS SHALL FOLLOW DISTRICT ONE STANDARD TC-13.
- 10. PAVEMENT MARKINGS ALONG INTERSTATE 55 AND RAMPS A, B, C, AND D SHALL FOLLOW DISTRICT ONE STANDARD TC-12.
- 11. NOT USED
- 12. NOT USED
- 13. ALL DRUMS, VERTICAL PANELS, AND TYPE II BARRICADES (IF REQUIRED) SHALL BE EQUIPPED WITH MONO-DIRECTIONAL STEADY BURNING LIGHTS ON MULTILANE ROADWAYS, WHILE BI-DIRECTIONAL LIGHTS ARE REQUIRED ON ALL, TWO-WAY, TWO-LANE ROADWAYS.
- 14. ALL DRUMS, VERTICAL PANELS, AND TYPE II BARRICADES SHALL BE SPACED AT 50 FEET CENTER TO CENTER THROUGHOUT THE WORK ZONE, EXCEPT IN TAPER AREAS, GORE AREAS, AND ALONG CORNER RADII, WHERE THEY SHALL BE SPACED AT 20 FEET CENTER TO CENTER EXCEPT AS OTHERWISE INDICATED ON THE PLANS.
- 15. TYPE II BARRICADES SHALL BE USED IN LIEU OF DRUMS IN LOCATIONS WHERE TYPE II MUST BE PLACED IN EXCAVATED AREAS DUE TO LIMITED SPACE. THESE BARICADES SHALL HAVE LEG EXTENSIONS INSTALLED SUCH THAT THE TOP OF THE BARRICADE IS IN COMPLIANCE WITH IDOT HIGHWAY STANDARD 701901. DRUMS AND BARRICADES SHALL NOT BE PLACED TOGETHER WITHIN AN INDIVIDUAL RUN OF DEVICES.
- 16. TEMPORARY CONCRETE BARRIERS SHALL BE EQUIPPED WITH TYPE "C" REFLECTORS, IN ACCORDANCE WITH HIGHWAY STANDARD 704011 SPACED AT 25' CENTERS.
- 17. ALL CONSTRUCTION WARNING SIGNS SHALL BE BLACK LEGEND ON ORANGE BACKGROUND.
- 18. ALL CONSTRUCTION WARNING SIGN DIMENSIONS SHALL BE 48" X 48", EXCEPT AS OTHERWISE STATED ON THE PLANS.
- 19. ALL "ROAD CONSTRUCTION AHEAD" WARNING SIGNS SHALL BE EQUIPPED WITH HIGH INTENSITY MONO-DIRECTIONAL FLASHING LIGHTS.

- 20. THE CONTRACTOR SHALL INSTALL AND COVER ALL TEMPORARY SIGNING BEFORE EXISTING SIGNS ARE REMOVED. THE CONTRACTOR SHALL RELOCATE EXISTING SIGNS AS INDICATED ON THE PLANS.
- 21. THE CONTRACTOR SHALL INSTALL AND COVER ALL PERMANENT SIGNING BEFORE TEMPORARY SIGNS ARE REMOVED. THE COST OF THIS WORK SHALL BE INCLUDED IN THE COST FOR SIGN PANEL, OF THE TYPE SPECIFIED.
- 22. ALL EXISTING GUIDE SIGNS (I.e. STREET NAME SIGNS, ADVANCE STREET NAME SIGNS, ROUTE MARKERS, ETC.) SHALL BE MAINTAINED AND VISIBLE TO TRAFFIC DURING CONSTRUCTION.
- 23. EXISTING, TEMPORARY AND PROPOSED TRAFFIC/GUIDE SIGNS IN CONFLICT WITH STAGING SHALL BE COVERED AS INDICATED ON THE MAINTENANCE OF TRAFFIC PLANS AND/OR AS DIRECTED BY THE ENGINEER, THE COST OF THIS WORK SHALL BE CONSIDERED INCLUDED IN THE CONTRACT COST FOR TRAFFIC CONTROL AND PROTECTION (SPECIAL).
- 24. THE FABRICATION, INSTALLATION, MAINTENANCE AND REMOVAL OF TEMPORARY GUIDE SIGNS,
 TEMPORARY SIGN PANELS AND BLANK-OUT PANELS, AS SHOWN IN THE MAINTENANCE OF TRAFFIC
 SIGN PANEL DETAILS AND PLANS WILL BE MEASURED AND PAID FOR SEPARATELY AT THE CONTRACT UNIT
 COST FOR TEMPORARY INFORMATION SIGNING. THE RELOCATION OF THESE TEMPORARY PANELS/SIGNS FOR
 SUBSEQUENT STAGES SHALL BE CONSIDERED INCLUDED IN THE COST FOR TEMPORARY INFORMATION SIGNING.
- 25. DIRECTION INDICATOR BARRICADES SHALL BE USED AT LANE CLOSURE TAPER LOCATIONS FOR ROADWAYS WITH SPEEDS GREATER THAN OR EQUAL TO 45 MPH OR AS OTHERWISE DIRECTED BY THE ENGINEER.
- 26. THE CONTRACTOR SHALL MAINTAIN PRIVATE DRIVEWAY, COMMERCIAL DRIVEWAY, FIELD ENTRANCE, AND SIDE ROAD ACCESS AT ALL TIMES AT THE LOCATIONS SHOWN ON THE PLANS OR WHERE DIRECTED BY THE ENGINEER. THIS WORK WILL BE PAID FOR AT THE CONTRACT UNIT PRICE PER EACH FOR TEMPORARY ACCESS (PRIVATE ENTRANCE), TEMPORARY ACCESS (COMMERCIAL ENTRANCE), TEMPORARY ACCESS (ROAD). EACH DRIVEWAY, FIELD ENTRANCE, AND SIDE ROAD SHALL ONLY BE MEASURED FOR PAYMENT ONCE. DURING WINTER MONTHS, THE CONTRACTOR SHALL CONSTRUCT AND MAINTAIN TEMPORARY ACCESS COMPOSED OF A HOT-MIX ASPHALT SURFACE OVER PREVIOUSLY INSTALLED AGGREGATE TEMPORARY ACCESS. THIS WORK WILL BE PAID FOR SEPARATELY AND SHALL BE IN ACCORDANCE WITH TEMPORARY ACCESS (WINTERIZE).
- 27. AT THE END OF EACH WORK DAY, THE CONTRACTOR SHALL BACKFILL OR COVER ALL TRENCHES AND OPEN EXCAVATION HOLES FOR PROPOSED STORM SEWER, DRAINAGE STRUCTURES, AND WATER MAINS IN ORDER TO PROVIDE A SAFE CONDITION FOR MOTORISTS AND THE PUBLIC DURING NON-WORKING HOURS. THE COST OF THIS WORK SHALL BE INCLUDED IN THE COST FOR TRAFFIC CONTROL AND PROTECTION (SPECIAL).
- 28. LOCATIONS OF EXISTING SIDEWALK CLOSURES SHALL BE DETERMINED BY THE RESIDENT ENGINEER.

 UNLESS OTHERWISE SHOWN ON THE PLANS, THE CONTRACTOR SHALL CLOSE EXISTING SIDEWALKS

 WHEN THEY ENTER A WORK ZONE IN ACCORDANCE WITH IDOT STANDARD 701801. THIS WORK SHALL BE CONSIDERED

 INCLUDED IN THE CONTRACT UNIT PRICE FOR TEMPORARY TRAFFIC CONTROL AND PROTECTION (SPECIAL).
- 29. WARNING SIGNS ARE REQUIRED AT ALL DRIVEWAYS AND UNSIGNALIZED SIDE ROADS TO ALERT MOTORISTS OF THE NEW LANE CONFIGURATION FOR EACH STAGE CHANGE. THE SIGNS SHALL BE IN ACCORDANCE WITH MAINTENANCE OF TRAFFIC DETAIL TEMPORARY INFORMATION SIGNING AT DRIVEWAYS/SIDE ROADS. THESE SIGNS SHALL BE PAID FOR SEPARATELY UNDER THE TEMPORARY INFORMATION SIGNING PAY ITEM AND SHALL BE MEASURED FOR PAYMENT ONCE PER EACH LOCATION. THE RELOCATION OF THESE SIGNS FOR SUBSEQUENT STAGES SHALL BE CONSIDERED INCLUDED IN THE COST FOR TEMPORARY INFORMATION SIGNING.
- 30. TEMPORARY CONCRETE BARRIER SHALL BE CONTINUOUSLY PINNED TO THE PAVEMENT WHEREVER A 37 INCH PAVED CLEAR ZONE (FREE OF DROP-OFFS, FIXED OBJECTS, OR OTHER OBSTACLES) CANNOT BE PROVIDED FOR BEHIND THE BARRIER. THIS WORK SHALL BE PAID FOR SEPARATELY AT THE CONTRACT UNIT PRICE FOR PINNING TEMPORARY CONCRETE BARRIER.
- 31. DRUMS AND TEMPORARY PAVEMENT MARKING 4" DOUBLE YELLOW LINE SHALL BE INSTALLED TO DELINEATE THE LEFT TRAVEL EDGE OF PAVEMENT AFTER TEMPORARY PAVEMENT HAS BEEN CONSTRUCTED IN THE EXISTING RAISED MEDIAN IN PRE-STAGE.
- 32. TWO WEEKS PRIOR TO PLACEMENT OF PERMANENT PAVEMENT MARKINGS THE ENGINEER SHALL CONTACT CORY JUCIUS, ARTERIAL TRAFFIC OPERATIONS ENGINEER AT (847) 705-4411,
 PATRICE HARRIS, IDOT AREA TRAFFIC FIELD ENGINEER AT (708) 597-9800,
 THE EXPRESSWAY AREA ENGINEER AT (847) 705-4153 AND
 ROMEOVILLE PUBLIC WORKS AT (815) 886-1870 FOR WORK WITHIN THE VILLAGE LIMITS OF ROMEOVILLE.
- 33. THE CONTRACTOR SHALL PROVIDE AND MAINTAIN ACCESS TO ALL COMMERCIAL AND PRIVATE ENTRANCES.
 PAY ITEMS ARE INCLUDED IN THE PLANS FOR THIS ITEM. SEE IDOT DISTRICT 1 STANDARD TC-26 FOR
 TEMPORARY INFORMATION SIGNING REQUIREMENTS AT DRIVEWAYS.

PREAMBLE TO THE MAINTENANCE OF TRAFFIC

DIVERGING DIAMOND INTERCHANGE (DDI) AREA REFERS TO THE SECTION OF WEBER ROAD BETWEEN THE INTERSECTIONS OF RAMPS A/D AND RAMPS B/C. THIS IS THE SECTION WHERE TRAFFIC TRAVELS ON THE LEFT SIDE OF THE ROADWAY COMPARED TO A CONVENTIONAL DIAMOND INTERCHANGE. EXTRA CARE NEEDS TO BE TAKEN WHEN REFERRING TO NORTHBOUND AND SOUTHBOUND STAGING OF WEBER ROAD IN THIS AREA. THE DDI AREA DOES NOT INCLUDE THE RAMPS; THEY WILL BE REFERRED TO SEPARATELY.

FOR THE REFERENCES MADE TO WEBER ROAD, LANE 1 IS THE THROUGH LANE ALONG THE MEDIAN, LANE 2 IS THE MIDDLE LANE AND LANE 3 IS THE OUTSIDE LANE.

FOR THE RAMPS, LANE 1 IS THE INSIDE LANE CLOSEST TO I-55 AND LANE 2 IS THE OUTSIDE LANE FURTHEST FROM I-55.

OFF PEAK HOURS ARE AS DEFINED IN "KEEPING THE EXPRESSWAY OPEN TO TRAFFIC" AND "KEEPING ARTERIAL ROADWAYS OPEN TO TRAFFIC" SPECIAL PROVISIONS.

WHEN APPLICABLE, PROTECTED LEAD-LAG LEFT TURN PHASING WILL BE UTILIZED SO THAT NORTHBOUND AND SOUTHBOUND LEFT TURN PHASES DO NOT OPERATE CONCURRENTLY. SEE TEMPORARY TRAFFIC SIGNAL PLANS.

PRE-STAGE

WEBER ROAD

CONSTRUCTION TO BE COMPLETED

- FULL OR PARTIAL REMOVAL OF THE BARRIER MEDIAN AND CHANNELIZING ISLANDS. CONSTRUCT TEMPORARY PAVEMENT AS SHOWN ON THE PLANS. ADJUST MEDIAN DRAINAGE STRUCTURES.
- REMOVE EXISTING CURB AND GUTTER ON THE EAST SIDE, ADD EMBANKMENT AS NEEDED, AND INSTALL TEMPORARY PAVEMENT AND TEMPORARY CURB AND GUTTER AS PER PRE-STAGE PLANS.
- INSTALL TEMPORARY TRAFFIC SIGNALS TO BE OPERATIONAL BY STAGE 1. SEE TEMPORARY TRAFFIC SIGNAL PLANS.
- CONSTRUCT TEMPORARY STORM SEWERS AS PER PRE-STAGE EROSION CONTROL PLANS.
- CONSTRUCT PROPOSED CULVERTS UNDER WEBER ROAD EMBANKMENT NEAR INTERSTATE 55.

MAINTENANCE OF TRAFFIC

- PRE-STAGE WORK WILL BE PERFORMED DURING OFF-PEAK HOURS IN ACCORDANCE WITH STANDARDS SHOWN IN THE PLANS.
- THE MEDIAN REMOVAL AND REPLACEMENT WITH TEMPORARY PAVEMENT SHOULD OCCUR FIRST FOLLOWED BY THE EAST SIDE WIDENING.

RAMPS A, B, C & D

CONSTRUCTION TO BE COMPLETED

- CONSTRUCT TEMPORARY PAVEMENT PER PRE-STAGE PLANS
- ON RAMP D, CONSTRUCT TEMPORARY CULVERT ACROSS EXISTING PAVEMENT AS INDICATED IN THE TEMPORARY DRAINAGE AND EROSION CONTROL PLANS.
- ON RAMP B, CONSTRUCT CULVERT ACROSS EXISTING PAVEMENT AS INDICATED IN THE TEMPORARY DRAINAGE AND EROSION CONTROL PLANS
- REMOVE EXISTING CANTILEVER EXIT SIGN STRUCTURES ON RAMPS A AND C.

MAINTENANCE OF TRAFFIC

 WORK WILL BE PERFORMED DURING OFF-PEAK HOURS. TRAFFIC CONTROL SHALL BE IN ACCORDANCE WITH STANDARDS SHOWN IN THE PLANS.

INTERSTATE 55

CONSTRUCTION TO BE COMPLETED

- REMOVE SHOULDER RUMBLE STRIPS AS INDICATED ON THE PLANS.
- REMOVE EXISTING GUARDRAIL AND OVERHEAD CANTILEVER SIGN ALONG RAMP A AUXILIARY LANE.
- CONSTRUCT TEMPORARY PAVEMENT PER PRE-STAGE PLANS.

MAINTENANCE OF TRAFFIC

 WORK WILL BE PERFORMED DURING OFF-PEAK HOURS. TRAFFIC CONTROL SHALL BE IN ACCORDANCE WITH STANDARDS SHOWN IN THE PLANS.

$\frac{\text{NORMANTOWN ROAD} \; / \; \text{REMINGTON BLVD} \; / \; \text{WINDHAM PKWY} \; / \; \text{RODEO DR} \; / \; \\ \text{LAKEVIEW DRIVE}$

CONSTRUCTION TO BE COMPLETED

- FULL OR PARTIAL REMOVAL OF THE BARRIER MEDIAN AND CHANNELIZING ISLANDS. CONSTRUCT TEMPORARY PAVEMENT AS SHOWN ON THE PLANS. ADJUST MEDIAN DRAINAGE STRUCTURES.
- REMOVE EXISTING CURB AND GUTTER ON THE EAST SIDE, ADD EMBANKMENT AS NEEDED, AND INSTALL TEMPORARY PAVEMENT AND TEMPORARY CURB AND GUTTER AS PER PRE-STAGE PLANS.

MAINTENANCE OF TRAFFIC

- PRE-STAGE WORK WILL BE PERFORMED DURING OFF-PEAK HOURS IN ACCORDANCE WITH STANDARDS SHOWN IN THE PLANS.
- THE MEDIAN REMOVAL AND REPLACEMENT WITH TEMPORARY PAVEMENT SHOULD OCCUR FIRST FOLLOWED BY THE EAST SIDE WIDENING.

STAGE 1

WEBER ROAD

CONSTRUCTION TO BE COMPLETED

- OUTSIDE THE DDI AREA, CONSTRUCT SOUTHBOUND LANES 1, 2, AND 3. INSIDE
 THE DDI AREA, CONSTRUCT NORTHBOUND LANES 1, 2, AND 3. CONSTRUCT
 OUTSIDE (WEST) CURB AND GUTTER WHERE TEMPORARY PAVEMENT WILL NOT BE
 INSTALLED. CONSTRUCT SOUTHBOUND LEFT TURN LANES AT LOCATIONS SHOWN
 ON THE PLANS.
- CONSTRUCT NOISE WALL #1 ALONG THE WEST SIDE OF WEBER ROAD NORTH OF RODEO DRIVE.
- CONSTRUCT RETAINING WALL (S.N.099-0909) ON SOUTHWEST CORNER OF WEBER ROAD AND RAMP C INTERSECTION.
- CONSTRUCT BARRIER WALL AT SOUTHWEST CORNER OF WEBER ROAD AND RODEO DRIVE INTERSECTION.
- CONSTRUCT TEMPORARY PAVEMENT AND TEMPORARY CURB AND GUTTER ADJACENT TO LANE 3 SOUTH OF NORMANTOWN ROAD. OMIT CONSTRUCTION OF THE PROPOSED OUTSIDE CURB AND GUTTER IN THIS SECTION.
- INSIDE THE DDI AREA, CONSTRUCT TEMPORARY PAVEMENT WITHIN THE PROPOSED CHANNELIZATION ISLANDS AND ALONG THE PROPOSED EDGES OF PAVEMENT AS SHOWN ON THE PLANS.
- OUTSIDE THE DDI AREA, CONSTRUCT TEMPORARY PAVEMENT BETWEEN LANE 1 OF THE SOUTHBOUND LANES AND MEDIAN PRESTAGE PAVEMENT TO PROVIDE A DRIVABLE SURFACE FOR STAGE 2.
- CONSTRUCT STORM SEWER MAIN ALONG THE WEST SIDE OF WEBER ROAD. SEE STAGE 1 TEMPORARY DRAINAGE AND EROSION CONTROL PLANS.

MAINTENANCE OF TRAFFIC

- MAINTAIN TWO (2) 12' TRAVEL LANES IN EACH DIRECTION AND SHIFT TRAFFIC EAST UTILIZING THE EXISTING PAVEMENT AND TEMPORARY PAVEMENT CONSTRUCTED DURING PRE-STAGE.
- PROVIDE ONE (1) 12' LEFT TURN LANE AT SIGNALIZED INTERSECTIONS IN EACH DIRECTION.
- AT LOCATIONS WHERE INDICATED, PROVIDE 11' RIGHT TURN LANES.

RAMP A

CONSTRUCTION TO BE COMPLETED

- CONSTRUCT PROPOSED PAVEMENT AND LEFT SHOULDER.
- PARTIALLY CONSTRUCT CULVERT AS PER STAGE 1 EROSION CONTROL PLANS.
- CONSTRUCT LEFT FOUNDATION FOR OVERHEAD SIGN STRUCTURE.

MAINTENANCE OF TRAFFIC

 SHIFT TRAFFIC TO THE OUTSIDE OF THE EXISTING RAMP UTILIZING BOTH EXISTING AND TEMPORARY PAVEMENT BUILT IN PRE-STAGE. PROVIDE ONE (1) 16' EXIT ONLY AUXILIARY LANE FROM SOUTHBOUND I-55. AT WEBER ROAD, PROVIDE ONE (1) 14' LEFT TURN LANE AND ONE (1) 14' RIGHT TURN LANE.

RAMP B

CONSTRUCTION TO BE COMPLETED

- CONSTRUCT PROPOSED AND TEMPORARY PAVEMENT TO THE GORE AREA.
- PARTIALLY CONSTRUCT CULVERT UNDER PROPOSED RAMP B AS INDICATED ON THE STAGE 1 TEMPORARY DRAINAGE AND EROSION CONTROL PLANS.

MAINTENANCE OF TRAFFIC

 MAINTAIN ONE (1) 16' LANE AND SHIFT TRAFFIC TO THE OUTSIDE OF THE RAMP UTILIZING EXISTING AND TEMPORARY PAVEMENT.

RAMP C

CONSTRUCTION TO BE COMPLETED

- CONSTRUCT PROPOSED RAMP PAVEMENT AS SHOWN IN THE PLANS.
- PARTIALLY CONSTRUCT CULVERT AS INDICATED ON THE STAGE 1 TEMPORARY DRAINAGE AND EROSION CONTROL PLANS.

MAINTENANCE OF TRAFFIC

 MAINTAIN ONE (1) 16' LANE FROM NORTHBOUND I-55 AND SHIFT TRAFFIC TO THE OUTSIDE OF RAMP USING EXISTING AND TEMPORARY PAVEMENT BUILT IN PRE-STAGE. AT WEBER ROAD, MAINTAIN EXISTING LEFT AND RIGHT TURN LANES.

RAMP D

SCALE: NONE

CONSTRUCTION TO BE COMPLETED

- CONSTRUCT PROPOSED RAMP PAVEMENT ADJACENT TO WEBER ROAD.
- CONSTRUCT TRAVERSABLE CONCRETE END SECTIONS ON EXISTING BOX CULVERTS.
- PARTIALLY CONSTRUCT CULVERT AS INDICATED ON THE STAGE 1 TEMPORARY DRAINAGE AND EROSION CONTROL PLANS.
- CONSTRUCT TEMPORARY STORM SEWER OUTFALL AS INDICATED ON THE TEMPORARY DRAINAGE AND EROSION CONTROL PLANS.



USER NAME = mmaestra	DESIGNED	WVN	REVISED	-
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MAINTENANCE OF TRAFFIC SUGGESTED CONSTRUCTION SEQUENCING		F.A.I/P RTE.	SECTION	COUNTY	TOTAL SHEETS	SHEI NO
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STAGE 1 (CONTINUED)

MAINTENANCE OF TRAFFIC

 MAINTAIN ONE (1) 16' LANE AND SHIFT TRAFFIC TO THE OUTSIDE OF RAMP USING BOTH EXISTING AND TEMPORARY PAVEMENT BUILT IN PRE-STAGE.

INTERSTATE 55

CONSTRUCTION TO BE COMPLETED

 CONSTRUCT CENTER PIER OF PROPOSED WEST BRIDGE STRUCTURE (S.N. 099-0428).

MAINTENANCE OF TRAFFIC

MAINTAIN SIX (6) MAINLINE THROUGH LANES; REDUCE LANE WIDTHS TO 11'. SHIFT
TRAFFIC OUTSIDE (RIGHT) ONTO THE EXISTING SHOULDERS IN ACCORDANCE
WITH IDOT DISTRICT 1 DETAIL TC-09. WORK ZONE ENTRY AND EXIT OPENINGS
SHALL BE IN ACCORDANCE WITH IDOT DISTRICT 1 STANDARD TC-18.

NORMANTOWN ROAD / REMINGTON BLVD / WINDHAM PKWY / RODEO DR

CONSTRUCTION TO BE COMPLETED

- CONSTRUCT WESTBOUND LANES AND CURB AND GUTTER AS SHOWN IN PLANS.
- CONSTRUCT TEMPORARY PAVEMENT AS SHOWN IN PLANS.

MAINTENANCE OF TRAFFIC

- MAINTAIN ONE (1) 11' TRAVEL LANE IN EACH DIRECTION AND SHIFT TRAFFIC SOUTH UTILIZING THE EXISTING PAVEMENT AND TEMPORARY PAVEMENT CONSTRUCTED DURING PRE-STAGE.
- PROVIDE ONE (1) 11' LEFT TURN LANE AT SIGNALIZED INTERSECTIONS IN EACH DIRECTION.
- PROVIDE ONE (1) 11' RIGHT TURN LANE WHERE SHOWN IN PLANS.

LAKEVIEW DRIVE

NO CONSTRUCTION

MAINTENANCE OF TRAFFIC

 MAINTAIN ONE (1) 12' TRAVEL LANE IN EACH DIRECTION IN THE EXISTING CONFIGURATION.

STAGE 1A

WEBER ROAD

CONSTRUCTION TO BE COMPLETED

 CONSTRUCT REMAINDER OF WEST BRIDGE STRUCTURE (S.N. 099-0428) OMITTING SHARED-USE PATH SECTIONS.

MAINTENANCE OF TRAFFIC (SEE STAGE 1)

RAMP A

CONSTRUCTION TO BE COMPLETED

 COMPLETE CONSTRUCTION OF RAMP PAVEMENT IN PROXIMITY TO THE GORE ALONG INTERSTATE 55.

MAINTENANCE OF TRAFFIC

CLOSE THE SHOULDER ALONG THE RAMP A AUXILIARY LANE AND MAINTAIN ONE (1) EXIT ONLY LANE AT THE EXIT TERMINAL. SHIFT TRAFFIC TO TEMPORARY PAVEMENT AS ESTABLISHED IN STAGE 1.

RAMP B

CONSTRUCTION TO BE COMPLETED

 CONSTRUCT RAMP PAVEMENT (LANE 1) IN PROXIMITY TO THE GORE ALONG INTERSTATE 55.

MAINTENANCE OF TRAFFIC

 SHIFT TRAFFIC RIGHT ONTO EXISTING SHOULDER AND TEMPORARY PAVEMENT, MAINTAIN ONE (1) 16' LANE.

RAMP C

CONSTRUCTION TO BE COMPLETED

CONSTRUCT RAMP PAVEMENT (LANE 1) IN PROXIMITY TO THE GORE ALONG INTERSTATE 55.

MAINTENANCE OF TRAFFIC (SEE STAGE 1)

RAMP D

CONSTRUCTION TO BE COMPLETED

 CONSTRUCT RAMP PAVEMENT IN PROXIMITY TO THE GORE ALONG INTERSTATE 55.

MAINTENANCE OF TRAFFIC

 SHIFT TRAFFIC ONTO TEMPORARY PAVEMENT BUILT IN PRE-STAGE. MAINTAIN ONE (1) 16' LANE

INTERSTATE 55

CONSTRUCTION TO BE COMPLETED

 CONSTRUCT REMAINDER OF WEST BRIDGE STRUCTURE (S.N. 099-0428) OMITTING SHARED-USE PATH SECTIONS.

MAINTENANCE OF TRAFFIC

 SHIFT TRAFFIC INSIDE (LEFT) TOWARDS THE MEDIAN OF I-55 IN BOTH DIRECTIONS. MAINTAIN SIX (6) MAINLINE THROUGH LANES 11' WIDE.

NORMANTOWN ROAD / REMINGTON BLVD / WINDHAM PKWY / RODEO DR

CONSTRUCTION TO BE COMPLETED

- CONSTRUCT CENTER LANES AS SHOWN IN PLANS.
- CONSTRUCT TEMPORARY PAVEMENT IN PROPOSED MEDIAN LOCATIONS AS SHOWN IN PLANS.

MAINTENANCE OF TRAFFIC

- MAINTAIN ONE (1) 11' TRAVEL LANE IN EACH DIRECTION AND SHIFT WESTBOUND TRAFFIC NORTH UTILIZING THE PROPOSED PAVEMENT AND TEMPORARY PAVEMENT CONSTRUCTED DURING PRE-STAGE WHILE KEEPING EASTBOUND TRAFFIC IN STAGE 1 CONFIGURATION.
- PROVIDE ONE (1) 11' LEFT TURN LANE AT SIGNALIZED INTERSECTIONS IN EACH DIRECTION.

LAKEVIEW DRIVE

NO CONSTRUCTION

MAINTENANCE OF TRAFFIC (SEE STAGE 1)

STAGE 1B

WEBER ROAD

CONSTRUCTION TO BE COMPLETED

• WITHIN THE DDI AREA, CONSTRUCT REMAINDER OF SOUTHBOUND LANES 1, 2 AND 3, NORTHBOUND LANES 1, 2, AND 3 PAVEMENT AND TEMPORARY PAVEMENT.

MAINTENANCE OF TRAFFIC

TRAFFIC REMAINS IN STAGE 1 CONFIGURATION.

RAMP A

CONSTRUCTION TO BE COMPLETED (SEE STAGES 1 AND 1A)

MAINTENANCE OF TRAFFIC (SEE STAGE 1A)

RAMP B

CONSTRUCTION TO BE COMPLETED

- CONSTRUCT RAMP PAVEMENT (LANE 1) IN PROXIMITY TO THE GORE, SHOULDER, AND GUARDRAIL.
- FINISH CULVERT CONSTRUCTION AS INDICATED ON THE STAGE 1B TEMPORARY DRAINAGE AND EROSION CONTROL PLANS.

MAINTENANCE OF TRAFFIC

 SHIFT TRAFFIC ONTO NEW PAVEMENT AND TEMPORARY PAVEMENT BUILT IN STAGE 1. MAINTAIN ONE (1) 16' LANE.

RAMP C

CONSTRUCTION TO BE COMPLETED

- CONSTRUCT RAMP PAVEMENT AND OUTSIDE SHOULDER. REMOVE TEMPORARY PAVEMENT.
- CONSTRUCT THE CRASH INVESTIGATION SITE.
- FINISH CULVERT CONSTRUCTION AS INDICATED ON THE STAGE 1B TEMPORARY DRAINAGE AND EROSION CONTROL PLANS.
- CONSTRUCT OVERHEAD SIGN STRUCTURE.
- INSTALL NEW CANTILEVER EXIT SIGN STRUCTURE.

MAINTENANCE OF TRAFFIC

 PROVIDE ONE (1) 16' LANE. SHIFT TRAFFIC LEFT ONTO NEW PAVEMENT CONSTRUCTED IN STAGE 1 AND 1A. AT WEBER ROAD, PROVIDE ONE (1) 12' LEFT TURN LANE AND ONE (1) 12' RIGHT TURN LANE.

RAMP D

SCALE: NONE

CONSTRUCTION TO BE COMPLETED

- CONSTRUCT RAMP PAVEMENT ALONG I-55 AND OUTSIDE SHOULDER.
- FINISH STORM SEWER OUTFALL CONSTRUCTION AS INDICATED ON THE STAGE 1B TEMPORARY DRAINAGE AND EROSION CONTROL PLANS.

MAINTENANCE OF TRAFFIC

SHIFT TRAFFIC ONTO NEW PAVEMENT. MAINTAIN ONE (1) 16' LANE.



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STAGE 1B (CONTINUED)

INTERSTATE 55

CONSTRUCTION TO BE COMPLETED

 CONSTRUCT PROPOSED PAVEMENT, SHOULDER AND GUARDRAIL AT END OF RAMP B AUXILIARY LANE.

MAINTENANCE OF TRAFFIC

- SHIFT NORTHBOUND TRAFFIC INSIDE (LEFT) TOWARDS THE MEDIAN OF I-55. MAINTAIN SIX (6) THROUGH LANES 11' WIDE
- SOUTHBOUND TRAFFIC REMAINS IN STAGE 1A CONFIGURATION.

NORMANTOWN ROAD

CONSTRUCTION TO BE COMPLETED

CONSTRUCT EASTBOUND LANES AND CURB AND GUTTER AS SHOWN IN PLANS.

MAINTENANCE OF TRAFFIC

- MAINTAIN ONE (1) 11' TRAVEL LANE IN EACH DIRECTION AND SHIFT EASTBOUND TRAFFIC NORTH UTILIZING THE PROPOSED PAVEMENT AND TEMPORARY PAVEMENT CONSTRUCTED DURING PERVIOUS STAGES WHILE KEEPING WESTBOUND TRAFFIC IN STAGE 1A CONFIGURATION.
- PROVIDE ONE (1) 11' LEFT TURN LANE AT SIGNALIZED INTERSECTION WITH WEBER ROAD IN EACH DIRECTION.

REMINGTON BLVD / WINDHAM PKWY / RODEO DR

CONSTRUCTION TO BE COMPLETED

• CONSTRUCT CENTER LANES AS SHOWN IN PLANS.

MAINTENANCE OF TRAFFIC

- MAINTAIN ONE (1) 11' TRAVEL LANE IN EACH DIRECTION WHILE KEEPING THROUGH AND RIGHT TURNING TRAFFIC IN STAGE 1A CONFIGURATION.
- PROVIDE ONE (1) 11' LEFT TURN LANE AT SIGNALIZED INTERSECTIONS IN EACH DIRECTION. SHIFT EASTBOUND LEFT TURNING TRAFFIC NORTH.

LAKEVIEW DRIVE

NO CONSTRUCTION

MAINTENANCE OF TRAFFIC (SEE STAGE 1)

STAGE 1C

WEBER ROAD

CONSTRUCTION TO BE COMPLETED

 CONSTRUCT WEST SIDE INTERSECTION SEGMENTS ON NORMANTOWN ROAD, REMINGTON BLVD/WINDHAM PARKWAY, AND RODEO DRIVE/REMINGTON BLVD.

MAINTENANCE OF TRAFFIC (SEE STAGE 1)

RAMP A

CONSTRUCTION (SEE STAGE 1A)

MAINTENANCE OF TRAFFIC (SEE STAGE 1A)

RAMP B

CONSTRUCTION TO BE COMPLETED

 REMOVE TEMPORARY PAVEMENT AND CONSTRUCT INSIDE SHOULDER NEAR GORE.

MAINTENANCE OF TRAFFIC

• SHIFT TRAFFIC ONTO NEW PAVEMENT. MAINTAIN ONE (1) 16' LANE.

RAMP C

CONSTRUCTION (SEE STAGE 1B)

MAINTENANCE OF TRAFFIC

 PROVIDE ONE (1) 16' LANE ON NEW PAVEMENT. AT WEBER ROAD, PROVIDE ONE (1) 12' LEFT TURN LANE AND ONE (1) 12' RIGHT TURN LANE.

RAMP D

CONSTRUCTION (SEE STAGE 1B)

MAINTENANCE OF TRAFFIC (SEE STAGE 1B)

NORMANTOWN ROAD

CONSTRUCTION TO BE COMPLETED

CONSTRUCT MEDIAN AS SHOWN IN PLANS

MAINTENANCE OF TRAFFIC

- MAINTAIN ONE (1) 11' TRAVEL LANE IN EACH DIRECTION AND SHIFT TRAFFIC NORTH UTILIZING THE PROPOSED PAVEMENT AND TEMPORARY PAVEMENT CONSTRUCTED DURING PERVIOUS STAGES.
- PROVIDE ONE (1) 11' LEFT TURN LANE AT SIGNALIZED INTERSECTION WITH WEBER ROAD IN EACH DIRECTION.
- PROVIDE ONE (1) 12' RIGHT TURN LANE FOR EASTBOUND TRAFFIC AT WEBER

REMINGTON BLVD / WINDHAM PKWY / RODEO DR

CONSTRUCTION TO BE COMPLETED

CONSTRUCT EASTBOUND LANES AND CURB AND GUTTER AS SHOWN IN PLANS.

MAINTENANCE OF TRAFFIC

- MAINTAIN ONE (1) 11' TRAVEL LANE IN EACH DIRECTION AND SHIFT EASTBOUND TRAFFIC NORTH UTILIZING THE PROPOSED PAVEMENT AND TEMPORARY PAVEMENT CONSTRUCTED DURING PERVIOUS STAGES WHILE KEEPING WESTBOUND TRAFFIC IN STAGE 1A CONFIGURATION.
- PROVIDE ONE (1) 11' LEFT TURN LANE AT SIGNALIZED INTERSECTIONS IN EACH DIRECTION.

LAKEVIEW DRIVE

NO CONSTRUCTION

MAINTENANCE OF TRAFFIC (SEE STAGE 1)

STAGE 1D

WEBER ROAD

CONSTRUCTION TO BE COMPLETED

CONSTRUCT PROPOSED PAVEMENT PER STAGE 1D PLANS.

MAINTENANCE OF TRAFFIC

- MAINTAIN TWO (2) LANES IN EACH DIRECTION.
- SHIFT SOUTHBOUND TRAFFIC WEST TO THE STAGE 2 CONFIGURATION JUST NORTH OF RODEO DRIVE.
- TRAFFIC SOUTH OF RODEO DRIVE TO REMAIN IN THE STAGE 1 CONFIGURATION.

RAMPS A, B, C, AND D / INTERSTATE 55 / NORMANTOWN RD / REMINGTON BLVD / WINDHAM PKWY / RODEO DR / LAKEVIEW DR

NO CONSTRUCTION

MAINTENANCE OF TRAFFIC (SEE STAGE 1C)

STAGE 2

WEBER ROAD

CONSTRUCTION TO BE COMPLETED

- OUTSIDE OF THE DDI AREA, CONSTRUCT NORTHBOUND LANES 1, 2, AND 3
 PAVEMENT. WITHIN THE DDI AREA, CONSTRUCT SOUTHBOUND LANES 1, 2, AND 3
 PAVEMENT AND OUTSIDE (EAST) CURB AND GUTTER.
- INSIDE THE DDI AREA, CONSTRUCT TEMPORARY PAVEMENT WITHIN THE RAMP CHANNELIZATION ISLANDS.
- REMOVE EXISTING BRIDGE (S.N. 099-0281) PARAPETS AND DECK. CONSTRUCT NEW BRIDGE DECK, PARAPETS AND BRIDGE DRAINAGE SYSTEM. PERFORM SUBSTRUCTURE REPAIR AND PCC BEAM REPAIR.
- CONSTRUCT STORM SEWER AS INDICATED ON THE STAGE 2 TEMPORARY DRAINAGE AND EROSION CONTROL PLANS.

MAINTENANCE OF TRAFFIC

- SHIFT TRAFFIC WEST TO NEW PAVEMENT AND TEMPORARY PAVEMENT CONSTRUCTED IN STAGE 1 AND ONTO WEST BRIDGE. MAINTAIN TWO (2) 12' TRAVEL LANES IN EACH DIRECTION, ONE (1) 12' LEFT TURN LANE AT SIGNALIZED INTERSECTIONS IN EACH DIRECTION.
- REDUCE TRAFFIC LANES TO 11' OVER WEST BRIDGE (S.N. 099-0281).

RAMP A

SCALE: NONE

CONSTRUCTION TO BE COMPLETED

- CONSTRUCT RAMP SHOULDER AND CRASH INVESTIGATION SITE.
- FINISH CULVERT CONSTRUCTION AS INDICATED ON THE STAGE 2 TEMPORARY DRAINAGE AND EROSION CONTROL PLANS.
- COMPLETE CONSTRUCTION OF OVERHEAD SIGN STRUCTURE

MAINTENANCE OF TRAFFIC

 MAINTAIN ONE (1) 16' EXIT ONLY AUXILIARY LANE FROM SOUTHBOUND I-55 ALONG NEW PAVEMENT BUILT IN STAGE 1. AT WEBER ROAD, PROVIDE ONE (1) 12' LEFT TURN AND ONE (1) 12' RIGHT TURN LANE.



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STAGE 2 (CONTINUED)

RAMP B

NO CONSTRUCTION

MAINTENANCE OF TRAFFIC

PLACE TRAFFIC IN FINAL CONFIGURATION.

RAMP C

NO CONSTRUCTION

MAINTENANCE OF TRAFFIC

 PROVIDE ONE (1) 16' LANE IN THE FINAL RAMP CONFIGURATION. AT WEBER ROAD PROVIDE ONE (1) 12' LEFT TURN AND ONE (1) RIGHT TURN LANE ON THE RIGHT (SOUTH) SIDE OF THE RAMP.

RAMP D

NO CONSTRUCTION

MAINTENANCE OF TRAFFIC

MAINTAIN ONE (1) 16' LANE.

INTERSTATE 55

CONSTRUCTION

 AT EAST BRIDGE STRUCTURE (S.N. 099-0281) REMOVE EXISTING SLOPE WALLS AND CONSTRUCT PROPOSED RETAINING WALLS BOTH NORTH AND SOUTH OF I-55 (S.N. 099-0907 AND S.N. 099-0908).

MAINTENANCE OF TRAFFIC

REINSTATE TRAFFIC LANES TO PRE-CONSTRUCTION (EXISTING) CONFIGURATION.
CLOSE OUTSIDE SHOULDERS IN BOTH DIRECTIONS NEAR BRIDGES USING
DISTRICT ONE STANDARD TC-17.

NORMANTOWN ROAD

NO CONSTRUCTION

MAINTENANCE OF TRAFFIC

- FOR EASTBOUND TRAFFIC WEST OF WEBER, SHIFT TRAFFIC NORTH MAINTAIN ONE
 (1) 12' RIGHT TURN LANE, ONE (1) 12' THROUGH LANE, AND ONE 12' LEFT TURN
 LANE. EAST OF WEBER, OPEN TRAFFIC TO FINAL CONFIGURATION AS SHOWN IN
 PLANS.
- FOR WESTBOUND TRAFFIC EAST OF WEBER, MAINTAIN ONE (1) 12' RIGHT TURN LANE, ONE (1) 12' THROUGH LANE, AND ONE (1) 12' LEFT TURN LANE. WEST OF WEBER, OPEN TRAFFIC TO FINAL CONFIGURATION AS SHOWN IN PLANS.

REMINGTON BLVD (WEST) / WINDHAM PKWY

NO CONSTRUCTION

MAINTENANCE OF TRAFFIC

• SHIFT TRAFFIC SOUTH. MAINTAIN ONE (1) 11' OR 12' THROUGH LANE AND ONE (1) 11' LEFT TURN LANE IN EACH DIRECTION.

RODEO DRIVE / REMINGTON BLVD (EAST)

CONSTRUCTION

BUILD SOUTHERN PROPOSED CURB AND GUTTER, ROADWAY WIDENING, TEMPORARY PAVEMENT, AND TEMPORARY CURB AND GUTTER AS SHOWN IN PLANS.

MAINTENANCE OF TRAFFIC

 SHIFT TRAFFIC NORTH ALONG REMINGTON. MAINTAIN ONE(1) 11' THROUGH LANE IN EACH DIRECTION AND ONE (1) 11' LEFT TURN LANE.

LAKEVIEW DRIVE

CONSTRUCTION TO BE COMPLETED

• CONSTRUCT EASTBOUND LANES AND SOUTH CURB AND GUTTER.

MAINTENANCE OF TRAFFIC

 MAINTAIN ONE (1) 11' LANE IN EACH DIRECTION AND SHIFT TRAFFIC NORTH ON EXISTING PAVEMENT AND TEMPORARY PAVEMENT BUILT IN PRE-STAGE.

STAGE 2A

WEBER ROAD

CONSTRUCTION TO BE COMPLETED

- COMPLETE CONSTRUCTION OF PAVEMENT SECTIONS WITHIN THE DDI INTERSECTIONS.
- INSIDE THE DDI AREA, CONSTRUCT TEMPORARY PAVEMENT WITHIN THE RAMP CHANNELIZATION ISLANDS.
- OUTSIDE DDI, CONSTRUCT INTERSECTION PAVEMENT AS SHOW IN THE PLANS.

MAINTENANCE OF TRAFFIC (SEE STAGE 2)

RAMP A

NO CONSTRUCTION

MAINTENANCE OF TRAFFIC

 SPLIT TRAFFIC AT WEBER ROAD, PROVIDE ONE (1) 12' LEFT TURN LANE AND ONE (1) 16' RIGHT TURN LANE.

RAMP B / RAMP C / RAMP D

NO CONSTRUCTION

MAINTENANCE OF TRAFFIC (SEE STAGE 2)

INTERSTATE 55

NO CONSTRUCTION

MAINTENANCE OF TRAFFIC

• OPEN SHOULDER AND PLACE TRAFFIC IN FINAL CONFIGURATION.

NORMANTOWN ROAD / REMINGTON BLVD / WINDHAM PKWY / RODEO DR

NO CONSTRUCTION

MAINTENANCE OF TRAFFIC (SEE STAGE 2)

LAKEVIEW DRIVE

CONSTRUCTION TO BE COMPLETED

CONSTRUCT PAVEMENT SECTION AS SHOWN IN PLANS.

MAINTENANCE OF TRAFFIC

SHIFT EASTBOUND TRAFFIC SOUTH UTILIZING PROPOSED PAVEMENT AND WESTBOUND TRAFFIC TO REMAIN IN STAGE 2 CONFIGURATION.

STAGE 2B

WEBER ROAD

CONSTRUCTION TO BE COMPLETED

CONSTRUCT INTERSECTION PAVEMENT AS SHOWN ON THE PLANS.

MAINTENANCE OF TRAFFIC (SEE STAGE 2)

RAMP A / RAMP B / RAMP C / RAMP D / INTERSTATE 55

NO CONSTRUCTION

MAINTENANCE OF TRAFFIC (SEE STAGE 2A)

NORMANTOWN ROAD

NO CONSTRUCTION

MAINTENANCE OF TRAFFIC

SHIFT TRAFFIC SOUTH UTILIZING PROPOSED PAVEMENT AND TEMPORARY PAVEMENT BUILT IN PREVIOUS STAGES. MAINTAIN ONE (1) 11' THROUGH LANE AND ONE (1) 11' LEFT TURN LANE FOR EACH DIRECTION.

REMINGTON BLVD / WINDHAM PKWY

NO CONSTRUCTION

MAINTENANCE OF TRAFFIC

• SHIFT EASTBOUND TRAFFIC NORTH UTILIZING PROPOSED PAVEMENT. WESTBOUND TRAFFIC TO REMAIN IN STAGE 2 CONFIGURATION. MAINTAIN ONE (1) 11' THROUGH LANE AND ONE (1) 11' LEFT TURN LANE FOR EACH DIRECTION.

RODEO DR / REMINGTON BLVD

NO CONSTRUCTION

MAINTENANCE OF TRAFFIC

- SHIFT EASTBOUND TRAFFIC SOUTH UTILIZING PROPOSED AND TEMPORARY PAVEMENT BUILT IN PREVIOUS STAGES.
- PROVIDE ONE (1) 11' LEFT TURN LANE AT WEBER ROAD IN EACH DIRECTION.

LAKEVIEW DRIVE

CONSTRUCTION TO BE COMPLETED

CONSTRUCT WESTBOUND LANES AND NORTH CURB AND GUTTER

MAINTENANCE OF TRAFFIC

SHIFT EASTBOUND TRAFFIC SOUTH UTILIZING PROPOSED PAVEMENT AND WESTBOUND TRAFFIC TO REMAIN IN STAGE 2 CONFIGURATION.

STAGE 2C

SCALE: NONE

WEBER ROAD

CONSTRUCTION TO BE COMPLETED

COMPLETE CONSTRUCTION OF EAST SIDE INTERSECTION PAVEMENT ON NORMANTOWN ROAD, REMINGTON BLVD/WINDHAM PARKWAY, AND RODEO DRIVE/REMINGTON BLVD.

MAINTENANCE OF TRAFFIC (SEE STAGE 2)



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STAGE 2C (CONTINUED)

RAMP A / RAMP B / RAMP C / RAMP D / INTERSTATE 55

NO CONSTRUCTION

MAINTENANCE OF TRAFFIC (SEE STAGE 2A)

NORMANTOWN ROAD

NO CONSTRUCTION

MAINTENANCE OF TRAFFIC (SEE STAGE 2B)

ADD ONE (1) 12' RIGHT TURN LANE FOR WESTBOUND TRAFFIC.

REMINGTON BLVD / WINDHAM PKWY

NO CONSTRUCTION

MAINTENANCE OF TRAFFIC

SHIFT EASTBOUND TRAFFIC NORTH UTILIZING PROPOSED PAVEMENT. FOR THE
WESTBOUND DIRECTION MAINTAIN ONE (1) 11' THROUGH LANE AND ONE (1) 11'
LEFT TURN LANE. FOR THE EASTBOUND DIRECTION MAINTAIN ONE (1) 12'
COMBINED THROUGH AND LEFT LANE, AND ONE (1) 12' RIGHT TURN LANE.

RODEO DR / REMINGTON BLVD

CONSTRUCTION

 CONSTRUCT NORTH PROPOSED CURB AND GUTTER, PROPOSED PAVEMENT WIDENING, TEMPORARY PAVEMENT, AND TEMPORARY CURB AND GUTTER.

MAINTENANCE OF TRAFFIC

- SHIFT EASTBOUND TRAFFIC SOUTH UTILIZING PROPOSED AND TEMPORARY PAVEMENT BUILT IN PREVIOUS STAGES
- PROVIDE ONE (1) 11' LEFT TURN LANE AT WEBER ROAD IN EACH DIRECTION

LAKEVIEW DRIVE

NO CONSTRUCTION

MAINTENANCE OF TRAFFIC

• OPEN TO FINAL CONFIGURATION.

STAGE 3

WEBER ROAD

CONSTRUCTION TO BE COMPLETED

- CONSTRUCT RAISED BARRIER MEDIANS, LANDSCAPED MEDIANS, AND LEFT TURN LANES.
- CONSTRUCT OVERHEAD SIGN STRUCTURE AND BARRIER WALLS LOCATED WITHIN THE MEDIAN.
- CONSTRUCT CATCH BASINS AS INDICATED ON THE STAGE 3 TEMPORARY DRAINAGE AND EROSION CONTROL PLANS.

MAINTENANCE OF TRAFFIC

 SHIFT TRAFFIC TO OUTSIDE (LANES 2 AND 3) IN THEIR RESPECTIVE DIRECTIONS THROUGH LANES AND TURN LANES ARE TO BE 11' WIDE.

RAMP A

NO CONSTRUCTION

MAINTENANCE OF TRAFFIC

 MAINTAIN ONE (1) 16' EXIT ONLY AUXILIARY LANE FROM SOUTHBOUND I-55 ALONG NEW PAVEMENT BUILT IN STAGE 1. AT WEBER ROAD, PROVIDE TWO (2) 12' LEFT TURN LANES AND ONE (1) 12' RIGHT TURN LANE.

RAMP B / RAMP C / RAMP D / INTERSTATE 55

NO CONSTRUCTION

MAINTENANCE OF TRAFFIC (SEE STAGE 2A)

NORMANTOWN ROAD

NO CONSTRUCTION

MAINTENANCE OF TRAFFIC

 SHIFT TRAFFIC NORTH. PROVIDE ONE (1) 12' EASTBOUND THROUGH LANE AND ONE (1) 12' LEFT TURN LANE. PROVIDE ONE (1) 12' EASTBOUND RIGHT TURN LANE.

REMINGTON BLVD / WINDHAM PKWY

NO CONSTRUCTION

MAINTENANCE OF TRAFFIC

• SHIFT TRAFFIC NORTH UTILIZING PROPOSED PAVEMENT. MAINTAIN ONE (1) 11' THROUGH AND LEFT LANE WITH ONE (1) 11' RIGHT TURN LANE FOR THE WESTBOUND DIRECTION. MAINTAIN ONE (1) 11' THROUGH LANE AND ONE (1) 11' LEFT TURN LANE.

RODEO DR / REMINGTON BLVD / LAKEVIEW DRIVE

NO CONSTRUCTION

MAINTENANCE OF TRAFFIC (SEE STAGE 2C)

STAGE 3A

WEBER ROAD

CONSTRUCTION TO BE COMPLETED

- CONSTRUCT CENTER OF NORMANTOWN ROAD, RODEO DRIVE, AND WINDHAM PARKWAY INTERSECTIONS.
- INSIDE THE DDI AREA, REMOVE TEMPORARY PAVEMENT AND CONSTRUCT PROPOSED CURB AND GUTTER AND GUARDRAIL ON THE WEST SIDE.

MAINTENANCE OF TRAFFIC

- INSIDE THE DDI AREA, SHIFT SOUTHBOUND TRAFFIC EAST (LANES 1, 2). MAINTAIN TWO (2) THROUGH 11' LANES WITH ONE (1) 11' TURN LANES.
- OUTSIDE OF THE DDI AREA, TRAFFIC REMAINS IN STAGE 3 CONFIGURATION.

RAMP A / RAMP B / RAMP C / RAMP D / INTERSTATE 55 / LAKEVIEW DR

NO CONSTRUCTION

MAINTENANCE OF TRAFFIC (SEE STAGE 3)

NORMANTOWN ROAD

NO CONSTRUCTION

MAINTENANCE OF TRAFFIC

SHIFT WESTBOUND TRAFFIC NORTH, EASTBOUND TRAFFIC SOUTH. PROVIDE ONE

(1) 12' EASTBOUND THROUGH-RIGHT LANE AND ONE (1) 12' LEFT TURN LANE IN EACH DIRECTION. OPEN TWO (1) 12' EASTBOUND LANES EAST OF WEBER.

REMINGTON BLVD / WINDHAM PKWY

NO CONSTRUCTION

MAINTENANCE OF TRAFFIC

 SHIFT EASTBOUND TRAFFIC SOUTH AND WESTBOUND TRAFFIC TO REMAIN IN STAGE 3 CONFIGURATION. MAINTAIN ONE (1) 11' THROUGH AND LEFT LANE WITH ONE (1) 11' RIGHT TURN LANE FOR WESTBOUND DIRECTION. MAINTAIN ONE (1) 11' THROUGH LANE AND ONE (1) 11' LEFT TURN LANE.

RODEO DR / REMINGTON BLVD

NO CONSTRUCTION

MAINTENANCE OF TRAFFIC

SPLIT TRAFFIC TO OUTSIDE, UTILIZING BOTH PROPOSED AND TEMPORARY PAVEMENT. PROVIDE ONE (1) 11' COMBINATION RIGHT AND THROUGH TURN LANE, AND ONE (1) 11' LEFT TURN LANE.

STAGE 3B

WEBER ROAD

CONSTRUCTION TO BE COMPLETED

 COMPLETE CONSTRUCTION OF INTERSECTION PAVEMENT AT NORMANTOWN ROAD, RODEO DRIVE, AND WINDHAM PARKWAY INTERSECTIONS.

MAINTENANCE OF TRAFFIC

• TRAFFIC REMAINS IN STAGE 3 CONFIGURATION

RAMP A / RAMP B / RAMP C / RAMP D / INTERSTATE 55 / LAKEVIEW DR

NO CONSTRUCTION

MAINTENANCE OF TRAFFIC (SEE STAGE 3)

NORMANTOWN ROAD

NO CONSTRUCTION

MAINTENANCE OF TRAFFIC

 SHIFT TRAFFIC SOUTH. PROVIDE ONE (1) 12' COMBINED THROUGH AND RIGHT LANE AND ONE (1) 12' LEFT TURN LANE EAST BOUND. ONE (1) 12' LEFT LANE, ONE (1) 12' LEFT TURN LANE, AND ONE (1) RIGHT TURN LANE WESTBOUND.

REMINGTON BLVD / WINDHAM PKWY

NO CONSTRUCTION

MAINTENANCE OF TRAFFIC

SHIFT TRAFFIC SOUTH UTILIZING PROPOSED PAVEMENT. MAINTAIN ONE (1) 11'
COMBINED THROUGH AND RIGHT TURN, AND ONE (1) 11' LEFT TURN LANE.

RODEO DR / REMINGTON BLVD

CONSTRUCTION

• CONSTRUCT PROPOSED CURB AND GUTTER AND DRIVEWAY AS SHOWN IN PLANS.

MAINTENANCE OF TRAFFIC

 SHIFT TRAFFIC NORTH. PROVIDE ONE (1) 11' THROUGH LANE, AND ONE (1) 11' LEFT TURN LANE.



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STAGE 3C

WEBER ROAD

CONSTRUCTION TO BE COMPLETED

 CONSTRUCT BARRIER MEDIANS ON SIDE ROADS AND RIGHT TURN CHANNELIZATION ISLANDS OUTSIDE OF THE DDI.

MAINTENANCE OF TRAFFIC

TRAFFIC REMAINS IN STAGE 3 CONFIGURATION.

RAMP A / RAMP B / RAMP C / RAMP D / INTERSTATE 55/ LAKEVIEW DR

NO CONSTRUCTION

MAINTENANCE OF TRAFFIC (SEE STAGE 3)

NORMANTOWN ROAD

CONSTRUCTION

• CONSTRUCT PROPOSED MEDIANS.

MAINTENANCE OF TRAFFIC

SPLIT TRAFFIC AND SHIFT TO THE OUTSIDE LANES. PROVIDE ONE (1) 12'
COMBINED RIGHT AND THROUGH LANE, AND ONE (1) 12' LEFT TURN LANE.

REMINGTON BLVD / WINDHAM PKWY

CONSTRUCTION

• CONSTRUCT PROPOSED MEDIANS.

MAINTENANCE OF TRAFFIC

SPLIT TRAFFIC AND SHIFT TO THE OUTSIDE LANES. PROVIDE ONE (1) 12'
COMBINED RIGHT AND THROUGH LANE, AND ONE (1) 12' LEFT TURN LANE.

RODEO DR / REMINGTON BLVD / LAKEVIEW DR

CONSTRUCTION

CONSTRUCT PROPOSED MEDIAN.

MAINTENANCE OF TRAFFIC

SPLIT TRAFFIC AND SHIFT TO THE OUTSIDE LANES. PROVIDE ONE (1) 12'
COMBINED RIGHT AND THROUGH LANE, AND ONE (1) 12' LEFT TURN LANE.

STAGE 4

WEBER ROAD / RAMP A / RAMP B / RAMP C / RAMP D / INTERSTATE 55

CONSTRUCTION TO BE COMPLETED

- THIS STAGE HAS A 9.3 CALENDAR DAY RESTRICTION (FRIDAY EVENING THROUGH THE MONDAY MORNING OF THE FOLLOWING WEEK). SEE SPECIAL PROVISIONS.
- CONSTRUCT PERMANENT TRAFFIC SIGNALS AT THE DIVERGING DIAMOND INTERCHANGE (DDI) CROSSOVER INTERSECTIONS.

MAINTENANCE OF TRAFFIC

- ON WEBER ROAD, MAINTAIN TWO (2) 12' THROUGH LANES IN EACH DIRECTION THROUGHOUT THE DDI AREA ON PART OF THE PROPOSED PAVEMENT AND PART OF THE TEMPORARY PAVEMENT BUILT IN STAGES 1 AND 1A.
- ON WEBER ROAD, MAINTAIN ONE (1) RIGHT TURN LANE APPROACHING RAMPS B AND D.
- ON RAMP A, PROVIDE ONE (1) FREE-FLOW RIGHT TURN LANE
- ON RAMP C, MAINTAIN ONE (1) RIGHT TURN LANE.
- NO LEFT TURN MOVEMENTS ARE ALLOWED IN THE DDI AREA DURING THIS STAGE.
- DETOURS ARE REQUIRED DURING THIS STAGE FOR THE PROHIBITED MOVEMENTS. SEE DETOUR PLANS FOR ADDITIONAL INFORMATION.

NORMANTOWN ROAD

NO CONSTRUCTION

MAINTENANCE OF TRAFFIC

CLOSE INSIDE LEFT TURN LANE. PROVIDE ONE (1) 12' LEFT TURN LANE, TWO (2) THROUGH LANES EASTBOUND. ONE (1) 12' LEFT TURN LANE, ONE (1) THROUGH LANE, AND ONE (1) RIGHT TURN LANE WESTBOUND.

REMINGTON BLVD / WINDHAM PKWY / RODEO DR / LAKEVIEW DR

NO CONSTRUCTION

MAINTENANCE OF TRAFFIC

OPEN TO FINAL CONFIGURATION.

STAGE 4A

WEBER ROAD

CONSTRUCTION TO BE COMPLETED

CONSTRUCT TRAFFIC CHANNELIZATION ISLANDS FOR RAMPS A AND B.

MAINTENANCE OF TRAFFIC

- WITHIN THE DDI AREA, MAINTAIN TWO (2) 14' THROUGH LANES IN NORTHBOUND LANES 1 AND 2 AND TWO (2) 14' THROUGH LANES IN SOUTHBOUND LANES 2 AND 3.
- OUTSIDE THE DDI AREA, PLACE TRAFFIC IN FINAL CONFIGURATION.

RAMP A / RAMP C

NO CONSTRUCTION

MAINTENANCE OF TRAFFIC

• TRAFFIC ON RAMP IN FINAL CONFIGURATION, EXCEPT AT WEBER ROAD MAINTAIN ONE (1) 14' RIGHT TURN LANE AND ONE (1) 14' LEFT TURN LANE.

RAMP B / RAMP D / INTERSTATE 55

NO CONSTRUCTION

MAINTENANCE OF TRAFFIC

TRAFFIC IN FINAL CONFIGURATION.

NORMANTOWN RD / REMINGTON BLVD / WINDHAM PKWY / RODEO DR / LAKEVIEW DR

NO CONSTRUCTION

MAINTENANCE OF TRAFFIC (SEE STAGE 4)

STAGE 4B

WEBER ROAD

CONSTRUCTION TO BE COMPLETED

• CONSTRUCT TRAFFIC CHANNELIZATION ISLANDS FOR RAMPS C AND D.

MAINTENANCE OF TRAFFIC

 WITHIN THE DDI AREA, MAINTAIN TWO (2) 14' THROUGH LANES IN SOUTHBOUND LANES 1 AND 2 AND TWO (2) 14' THROUGH LANES IN NORTHBOUND LANES 2 AND 3.

RAMP C

NO CONSTRUCTION

MAINTENANCE OF TRAFFIC

 TRAFFIC ON RAMP IN FINAL CONFIGURATION, EXCEPT AT WEBER ROAD. MAINTAIN ONE (1) 14' RIGHT TURN LANE AND ONE (1) 14' LEFT TURN LANE.

RAMP A / RAMP B / RAMP D / INTERSTATE 55

NO CONSTRUCTION

MAINTENANCE OF TRAFFIC


TRAFFIC IN FINAL CONFIGURATION.


NORMANTOWN RD / REMINGTON BLVD / WINDHAM PKWY / RODEO DR / LAKEVIEW DR

NO CONSTRUCTION

SCALE: NONE


MAINTENANCE OF TRAFFIC (SEE STAGE 4)

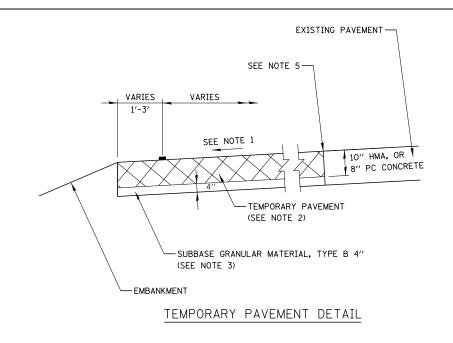

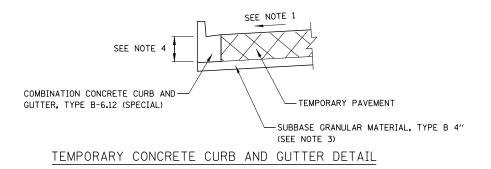

NOTES

- 1. CROSS SLOPE OF TEMPORARY PAVEMENT SHALL MATCH THE CROSS SLOPE OF THE ADJACENT EXISTING PAVEMENT BUT SHALL NOT BE LESS THAN 1.5%, UNLESS OTHERWISE DIRECTED BY THE ENGINEER OR AS OTHERWISE SHOWN ON THE CROSS SECTIONS.
- 2. THE TEMPORARY PAVEMENT SHALL BE CONSTRUCTED OF EITHER HOT-MIX ASPHALT OR CLASS PV CONCRETE. SEE TYPICAL SECTIONS HOT-MIX ASPHALT MIXTURE REQUIREMENTS.
- 3. SUBBASE GRANULAR MATERIAL, TYPE B 4" WILL BE MEASURED AND PAID FOR SEPARATELY.
- 4. THE COMBINATION CONCRETE CURB AND GUTTER TYPE B-6.12 (SPECIAL) SHALL MATCH THE THICKNESS OF THE ADJACENT TEMPORARY PAVEMENT.
- 5. WHERE EXISTING PAVEMENT IS DETERIORATED SAW CUT 1 FOOT OF EXISTING PAVEMENT AND REPLACE WITH TEMPORARY PAVEMENT. ADDITIONAL TEMPORARY PAVEMENT WILL BE PAID FOR AT THE CONTRACT UNIT PRICE FOR TEMPORTARY PAVEMENT. 1 FOOT AREA OF ADDITIONAL PAVEMENT REMOVAL SHALL NOT BE MEASURED FOR PAYMENT TWICE. SAWCUTTING SHALL BE CONSIDERED INCLUDED IN THE CONTACT UNIT COST FOR PAVEMENT REMOVAL.

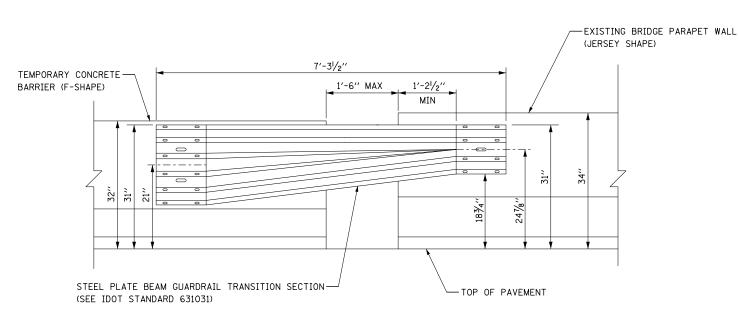

NOTES


- 1. THIS DETAIL APPLIES ONLY WHERE TEMPORARY CONCRETE BARRIER MEETS THE EXISTING WEBER ROAD BRIDGE PARAPET WALLS (JERSEY TYPE) AT THE LOCATIONS INDICATED IN THE MAINTENANCE OF TRAFFIC PLANS DURING STAGE CONSTRUCTION.
- 2. THE CONNECTION SHOWN IN THIS DETAIL BETWEEN TEMPORARY CONCRETE BARRIER AND EXISTING BRIDGE PARAPET WALL (JERSEY SHAPE) SHALL BE CONSIDERED INCLUDED IN THE CONTRACT UNIT COST FOR TEMPORARY CONCRETE BARRIER AND NO ADDITIONAL COMPENSATION WILL BE ALLOWED.


TEMPORARY CONCRETE WALL / EXISTING BRIDGE PARAPET CONNECTION DETAIL



	USER NAME = mmaestra	DESIGNED	WVN	REVISED -	
		DRAWN	WVN	REVISED -	
_	PLOT SCALE = 1:20	CHECKED	PJ0	REVISED -	
s	PLOT DATE = 5/13/2017	DATE	05/12/17	REVISED -	
					_

MAINTENANOE OF TRAFFIO DETAILO					SECTION	COUNTY TOTAL SHEET NO.		
	MAINTENANCE OF TRAFFIC DETAILS				(99-1HB-1) R-1	WILL	1508	150
						CONTRACT	NO. 6	0X10
SCALE: AS SHOWN	SHEET NO. 8 OF 226 SHEETS	STA.	TO STA.	* FAI 55,	FAP 856 ILLINOIS FED. AI	D PROJECT		

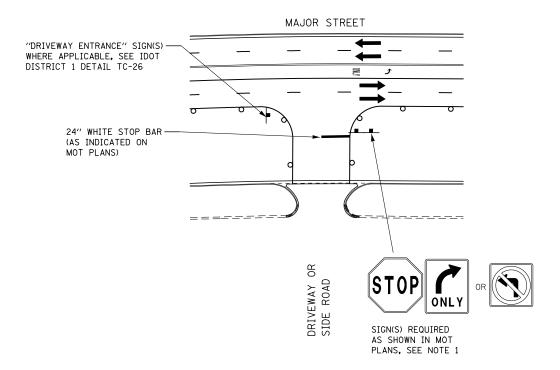

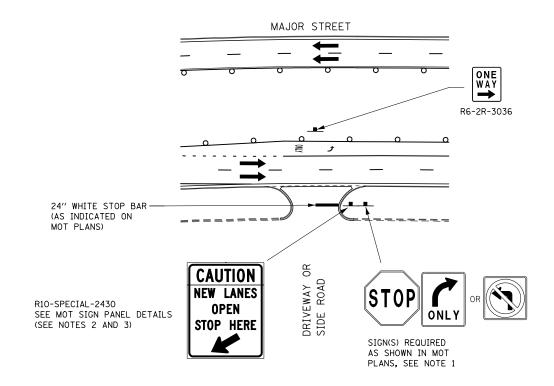

NEW TRAFFIC LANES OPEN OFFSET FROM EDGE OF PAVEMENT

NEW TRAFFIC LANES OPEN ADJACENT TO EDGE OF PAVEMENT

TEMPORARY INFORMATION SIGNING AT DRIVEWAYS/SIDE ROADS DETAIL


- . SIGNS SHOWN ON THE MOT PLANS SHALL BE INSTALLED TO THE RIGHT OF THE TEMPORARY INFORMATION SIGNAGE. THE MOT SIGNS ARE INCLUDED IN THE COST FOR TRAFFIC CONTROL AND PROTECTION (SPECIAL).
- 2. R10-SPECIAL-2430 SIGNS WILL BE MEASURED AND PAID FOR SEPARATELY UNDER TEMPORARY INFORMATION SIGNING. THESE SIGNS WILL NOT BE REMEASURED FOR PAYMENT IN SUBSEQUENT STAGES. THE RELOCATION OF THESE SIGNS SHALL BE INCLUDED IN THE COST FOR TEMPORARY INFORMATION SIGNING.
- 3. R10-SPECIAL-2430 SIGNS WILL BE MAINTAINED ONLY FOR A PERIOD OF 2 WEEKS AFTER INITATING THE STAGE.


KNIGHT	
Engineers &	Architects

	USER NAME = mmaestra	DESIGNED	WVN	REVISED	-
		DRAWN	WVN	REVISED	-
	PLOT SCALE = 1:9.99986	CHECKED	PJ0	REVISED	-
	PLOT DATE = 5/13/2017	DATE	05/12/17	REVISED	-
_					

	ANAINTENANOE OF TRAFFIO DETAILO				F.A.I/P RTE.			TOTAL SHEETS	SHEET NO.
	MAINTENANCE OF TRAFFIC DETAILS			*	(99-1HB-1) R-1	WILL	1508	151	
					MOT-9		CONTRACT	NO. 6	0X10
	SCALE: AS SHOWN	SHEET NO. 9 OF 226 SHEETS	STA.	TO STA.	* FAI 55,	FAP 856 ILLINOIS FED. AI	D PROJECT		


NAME = Di60Xi0-sht-staging09-details-02.ds

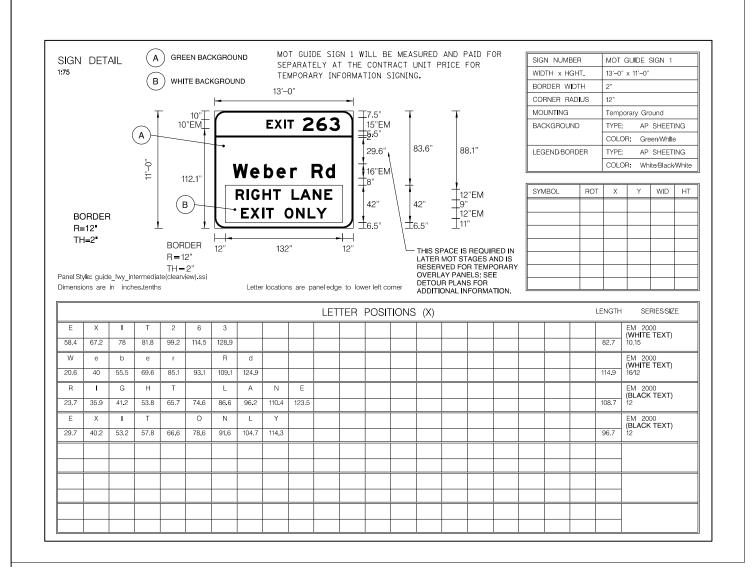


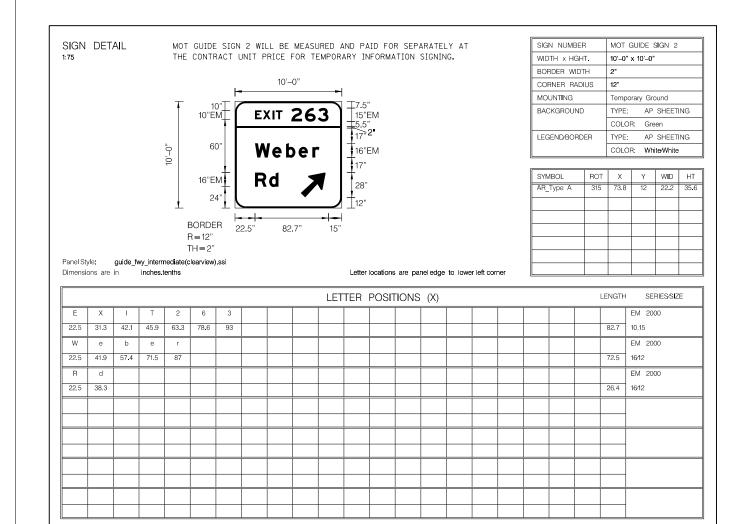

KNIGHT
Engineers & Architects

USER NAME = mmaestra	DESIGNED	MJM	REVISED -	Ī
	DRAWN	PAW	REVISED -	
PLOT SCALE = 1:9	CHECKED	PJ0	REVISED -	
PLOT DATE = 5/13/2017	DATE	05/12/17	REVISED -	

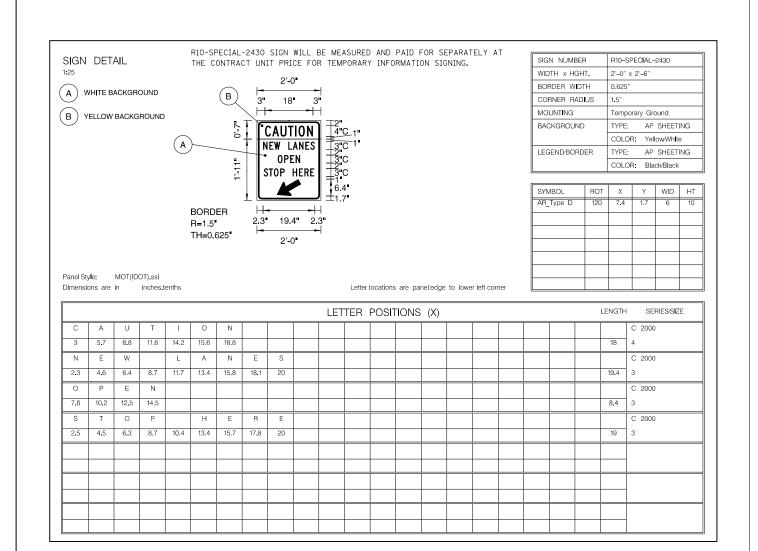

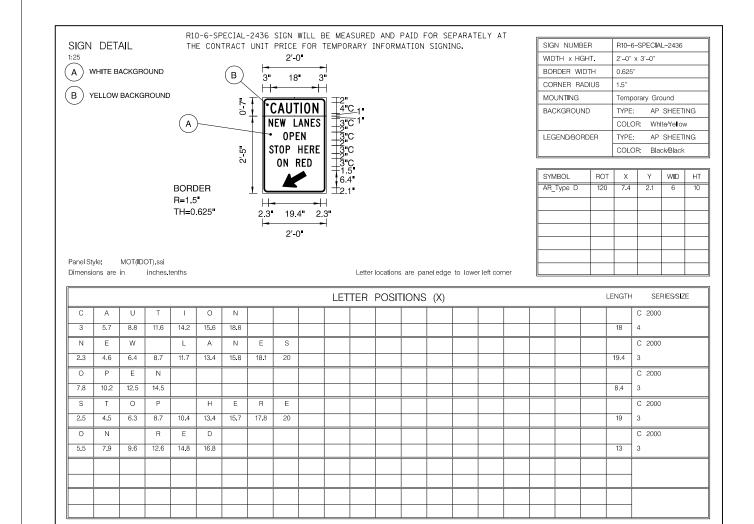

K	NIGHT		
	Engineers	&	Architect


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	DRAWN	PAW	REVISED -	
PLOT SCALE = 1:3	CHECKED	PJ0	REVISED -	
PLOT DATE = 5/13/2017	DATE	05/12/17	REVISED -	

SCALE: AS

				F.A.I/P RTE.	SECTION	COUNTY	TOTAL SHEETS	SHEET NO.
MA	INTENANCE OF TRAFFIC S	GN PANEL L	ETAILS	*	(99-1HB-1) R-1	WILL	1508	153
				MOT-11		CONTRACT	NO. 6	0X10
SHOWN	SHEET NO. 11 OF 226 SHEETS	STA.	TO STA.	* FAI 55,	FAP 856 ILLINOIS FED. AI	D PROJECT		

SIGN DETAIL

MOT TEMPORARY SIGN PANEL "LEFT LANE" WILL BE MEASURED AND PAID FOR SEPARATELY AT THE CONTRACT UNIT PRICE FOR TEMPORARY INFORMATION SIGNING.

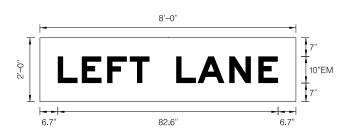

SIGN NUMBER	MOT PANEL "LEFT LANE"
WIDTH x HGHT.	8'-0" x 2'-0"
BORDER WIDTH	NONE
CORNER RADIUS	NONE
MOUNTING	Overhead
BACKGROUND	TYPE: ZZ Sheeting
	COLOR: Green
LEGEND/BORDER	TYPE; ZZ Sheeting
	COLOR: White/Green

SYMBOL	ROT	Х	Υ	WID	HT

Panel Style: guide_fwy_intermediate(clearview).ssi Dimensions are in inches tenths

Letter locations are panel edge to lower left corner


									LET	TER	POSIT	IONS	(X)				LENGTH	SERIES/SIZE
L	Е	F	Т		L	А	N	Е										EM 2000
6.7	15.7	25.2	33.7	41.1	51.1	59.1	71	81.9									82.6	10

SIGN DETAIL 1:75

Panel Style:

Dimensions are in inches tenths

MOT TEMPORARY SIGN PANEL "2 LEFT LANES" WILL BE MEASURED AND PAID FOR SEPARATELY AT THE CONTRACT UNIT PRICE FOR TEMPORARY INFORMATION SIGNING.

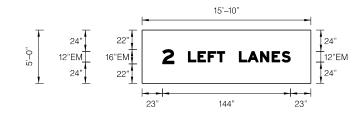

SIGN NUMBER MOT PANEL "2 LEFT LANES" WIDTH x HGHT. 15'-10" x 5'-0" BORDER WIDTH NONE CORNER RADIUS NONE BACKGROUND TYPE ZZ SHEETING COLOR: Green LEGEND/BORDER TYPE; ZZ SHEETING COLOR: White/Green

SYMBOL	ROT	Х	Υ	WID	НТ


LENGTH SERIES/SIZE LETTER POSITIONS (X) 144


Letter locations are panel edge to lower left corner

KNIGHT

USER NAME = mmaestra	DESIGNED	MJM	REVISED -
	DRAWN	PAW	REVISED -
PLOT SCALE = 1:3	CHECKED	PJ0	REVISED -
PLOT DATE = 5/13/2017	DATE	05/12/17	REVISED -


				F.A.I/P RTE.	SECTION	COUNTY	TOTAL SHEETS	SHEET NO.
MAI	INTENANCE OF TRAFFIC S	*	(99-1HB-1) R-1	WILL	1508	154		
				MOT-12		CONTRACT	NO. 6	0X10
SCALE: AS SHOWN	SHEET NO. 12 OF 226 SHEETS	STA.	TO STA.	* FAI 55, I	FAP 856 ILLINOIS FED, AI	D PROJECT		

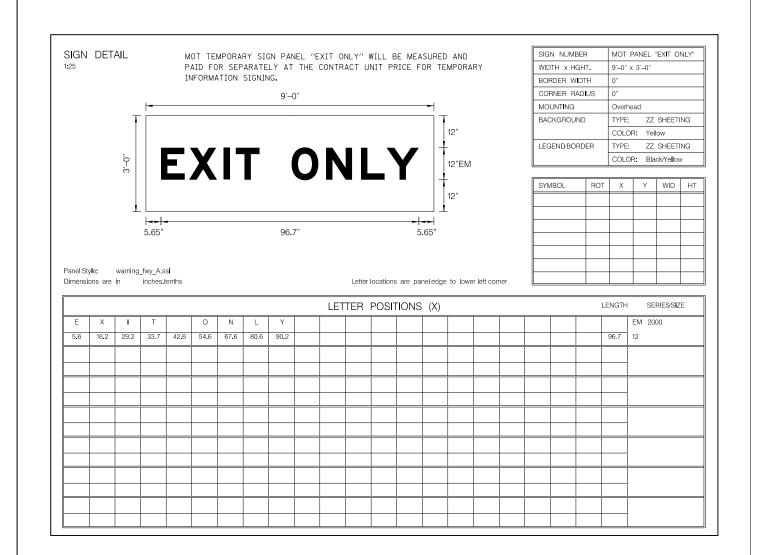


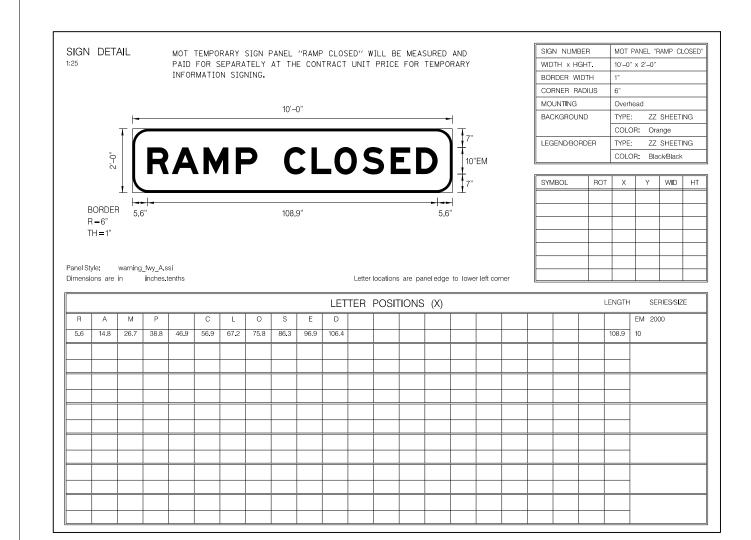



USER NAME = mmaestra	DESIGNED	MJM	REVISED -
	DRAWN	PAW	REVISED -
PLOT SCALE = 1:3	CHECKED	PJ0	REVISED -
PLOT DATE = 5/13/2017	DATE	05/12/17	REVISED -

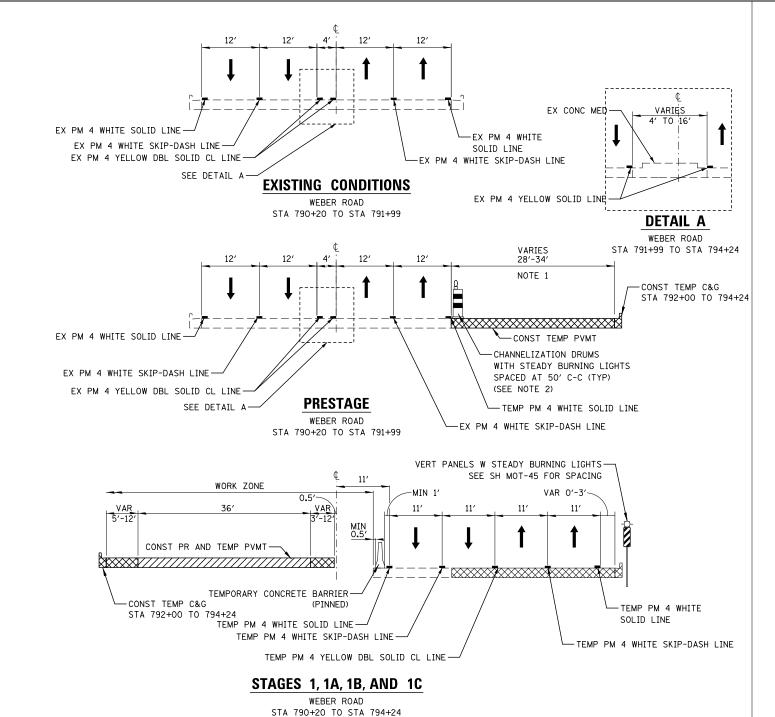

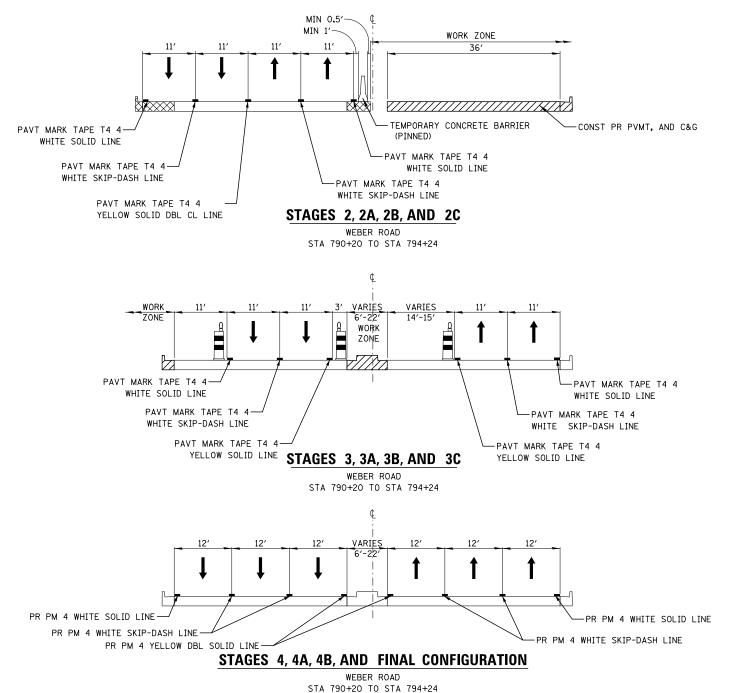

NOTES

- 1. THE RIGHT THROUGH LANE IS TO BE CLOSED IN ACCORDANCE WITH IDOT STANDARD 701421 DURING TEMPORARY PAVEMENT CONSTRUCTION ADJACENT TO EXISTING PAVEMENT.
 CHANNELIZATION DRUMS SHALL BE RELOCATED ALONG THE ADJACENT THROUGH LANE OPEN TO TRAFFIC. THIS WORK MUST BE DONE DURING OFF-PEAK PERIODS IN ACCORDANCE WITH "KEEPING ARTERIAL ROADWAYS OPEN TO TRAFFIC" SPECIAL PROVISION.
- 2. PAVEMENT DROP-OFF SHALL NOT EXCEED 18 INCHES BEHIND CHANNELIZATION DRUMS AND SHALL NOT EXCEED 85 CALENDAR DAYS. TEMPORARY GRADING TO REDUCE DROP-OFF HEIGHT DURING CONSTRUCTION SHALL BE INCLUDED IN THE COST FOR TRAFFIC CONTROL AND PROTECTION, (SPECIAL).


KNIGHT	
	& Architects

USER NAME = mmaestra	DESIGNED	WVN	REVISED	-
	DRAWN	WVN	REVISED	-
PLOT SCALE = 1:20	CHECKED	PJ0	REVISED	-
PLOT DATE = 5/13/2017	DATE	05/12/17	REVISED	-

STATE (OF ILLINOIS
DEPARTMENT OI	F TRANSPORTATION

	_		F.A.I/P RTE.	SECTION	COUNTY	TOTAL SHEETS	SHEET NO.		
	ſ	MOT TYPICAL SECTIONS -	*	(99-1HB-1) R-1	WILL	1508	156		
ļ					MOT-14		CONTRACT	NO. 6	0X10
	SCALE: AS SHOWN	SHEET NO. 14 OF 226 SHEETS	STA.	TO STA.	* FAI 55, FAP 856 ILLINOIS FED. AID PROJECT				
_									


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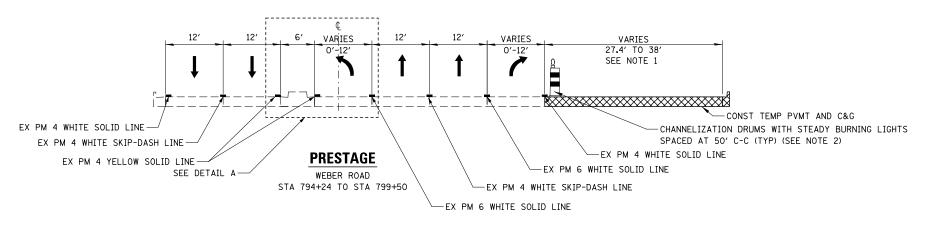
EXISTING CONDITIONS

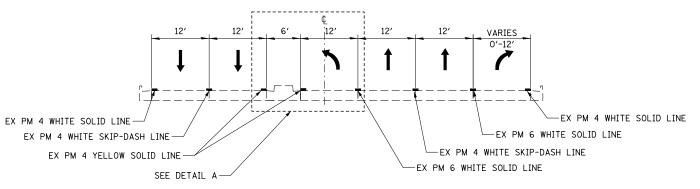
WEBER ROAD STA 794+24 TO STA 799+50

STA 794+24 TO STA 799+50



WEBER ROAD STA 791+99 TO STA 794+24

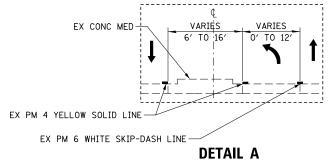

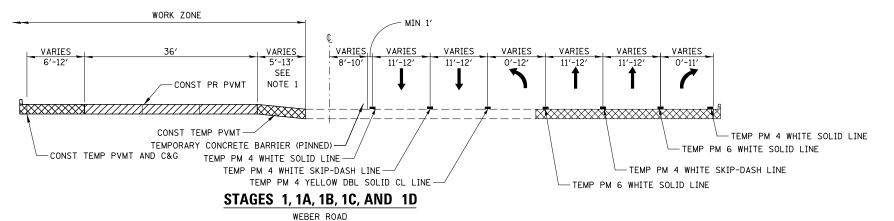

NOTES

- 1. THE RIGHT THROUGH AND/OR RIGHT TURN LANE ARE TO BE CLOSED IN ACCORDANCE WITH IDOT STANDARD 701421 DURING TEMPORARY PAVEMENT CONSTRUCTION ADJACENT TO EXISTING PAVEMENT. CHANNELIZATION DRUMS SHALL BE RELOCATED ALONG THE ADJACENT THROUGH LANE OPEN TO TRAFFIC. THIS WORK MUST BE DONE DURING OFF-PEAK PERIODS IN ACCORDANCE WITH "KEEPING ARTERIAL ROADWAYS OPEN TO TRAFFIC" SPECIAL PROVISION.
- 2. PAVEMENT DROP-OFF SHALL NOT EXCEED 18 INCHES BEHIND CHANNELIZATION DRUMS AND SHALL NOT EXCEED 85 CALENDAR DAYS. TEMPORARY GRADING TO REDUCE DROP-OFF HEIGHT DURING CONSTRUCTION SHALL BE INCLUDED IN THE COST FOR TRAFFIC CONTROL AND PROTECTION, (SPECIAL).


KNIGHT

Engineers & Architects

USER NAME = mmaestra	DESIGNED	WVN	REVISED -	
	DRAWN	WVN	REVISED -	
PLOT SCALE = 1:20	CHECKED	PJ0	REVISED -	
PLOT DATE = 5/13/2017	DATE	05/12/17	REVISED -	

STATE OF ILLINOIS	
DEPARTMENT OF TRANSPORTATION	

	MOT TYPICAL SECTIONS – WEBER ROAD SOUTH LIMITS TO NORMANTOWN ROAD							SECTION	COUNTY	TOTAL SHEETS	SHEET NO.
l								(99-1HB-1) R-1	WILL	1508	157
	SOUTH LIMITS TO MUNIMANTOWN NUAD								CONTRACT	NO. 6	0X10
	SCALE: AS SHOWN	SHEET NO. 15 OF 226 SHEETS	STA.	794+24	TO STA.	799+50	* FAI 55,	FAP 856 ILLINOIS FED. AI	D PROJECT		

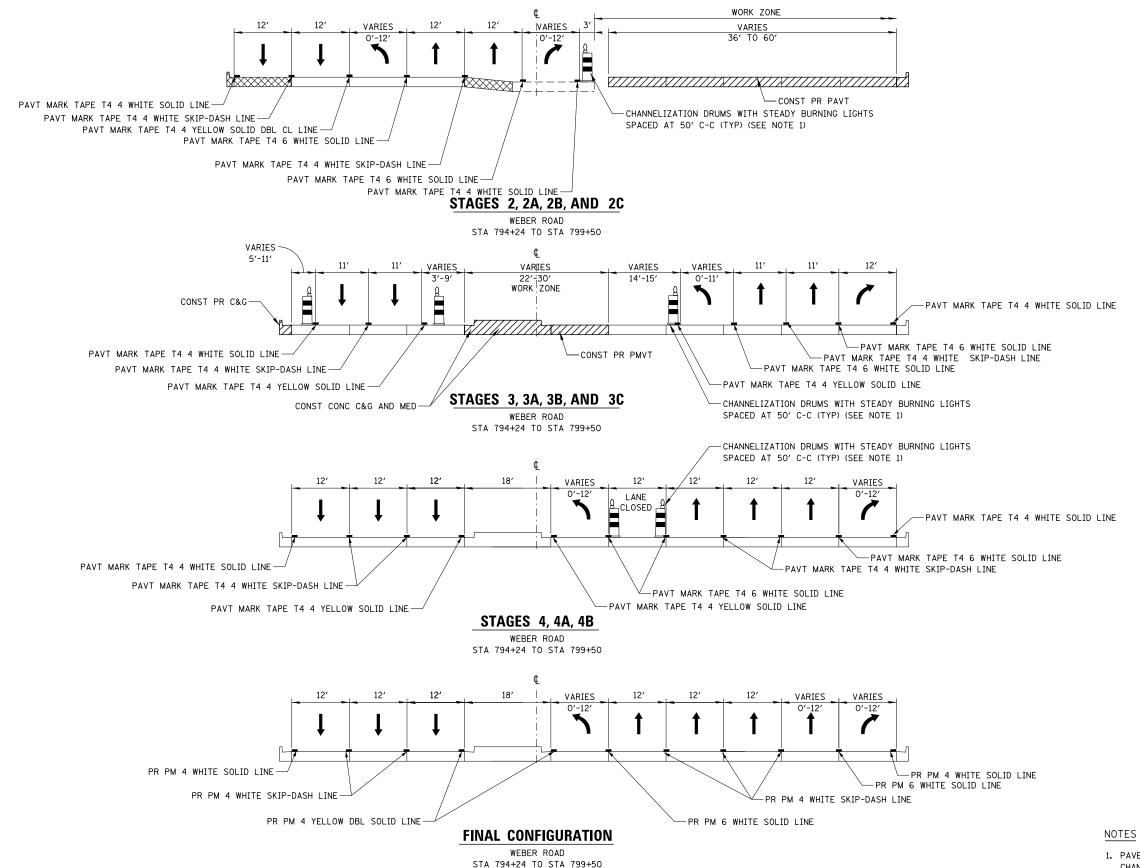


1. PAVEMENT DROP-OFF SHALL NOT EXCEED 18 INCHES BEHIND CHANNELIZATION DRUMS AND SHALL NOT EXCEED 85 CALENDAR DAYS. TEMPORARY GRADING TO REDUCE DROP-OFF HEIGHT DURING CONSTRUCTION SHALL BE INCLUDED IN THE COST FOR TRAFFIC CONTROL AND PROTECTION, (SPECIAL).

KNIGHT Engineers & Architects

USER NAME = mmaestra	DESIGNED	WVN	REVISED	-
	DRAWN	WVN	REVISED	-
PLOT SCALE = 1:20	CHECKED	PJ0	REVISED	-
PLOT DATE = 5/13/2017	DATE	05/12/17	REVISED	-

	MOT TYPICAL SECTIONS – WEBER ROAD SOUTH LIMITS TO NORMANTOWN ROAD							SECTION	COUNTY	TOTAL SHEETS	SHEET NO.
								(99-1HB-1) R-1	WILL	1508	158
	SOUTH ENVIES TO WORNIANTOWN HOAD						MOT-16		CONTRACT	NO. 6	0X10
SCALE:	: AS SHOWN	SHEET NO. 16 OF 226 SHEETS	STA.	794+24	TO STA.	799+50	* FAI 55,	FAP 856 ILLINOIS FED. AI	D PROJECT		

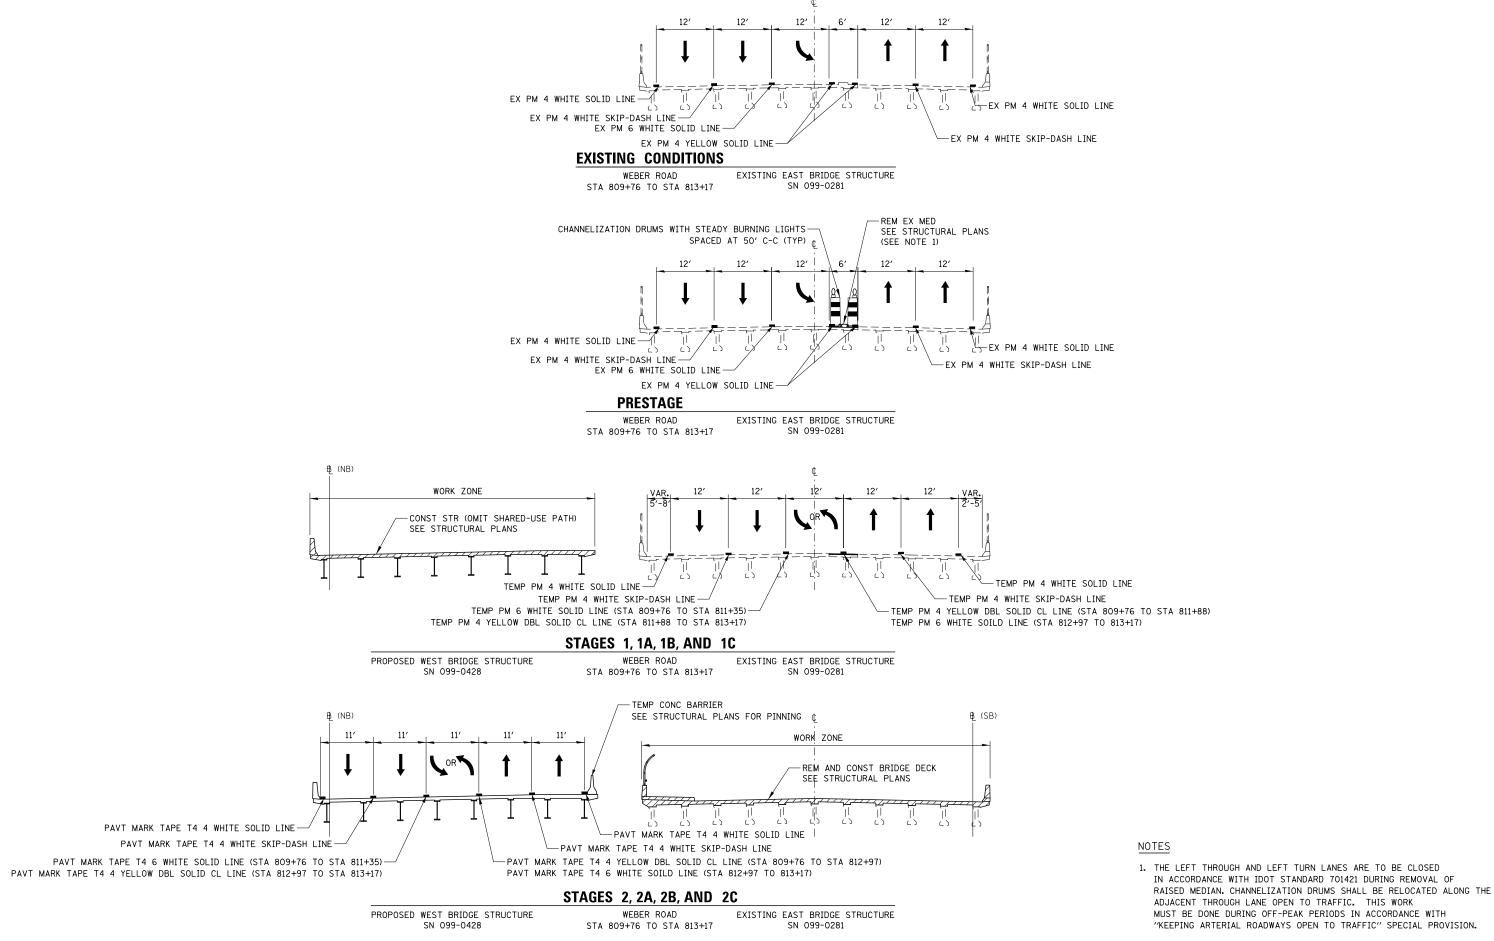

KNIGHT
Engineers & Architects


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 = mmaestro
 DESIGNED
 WVN
 REVISED


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 WVN
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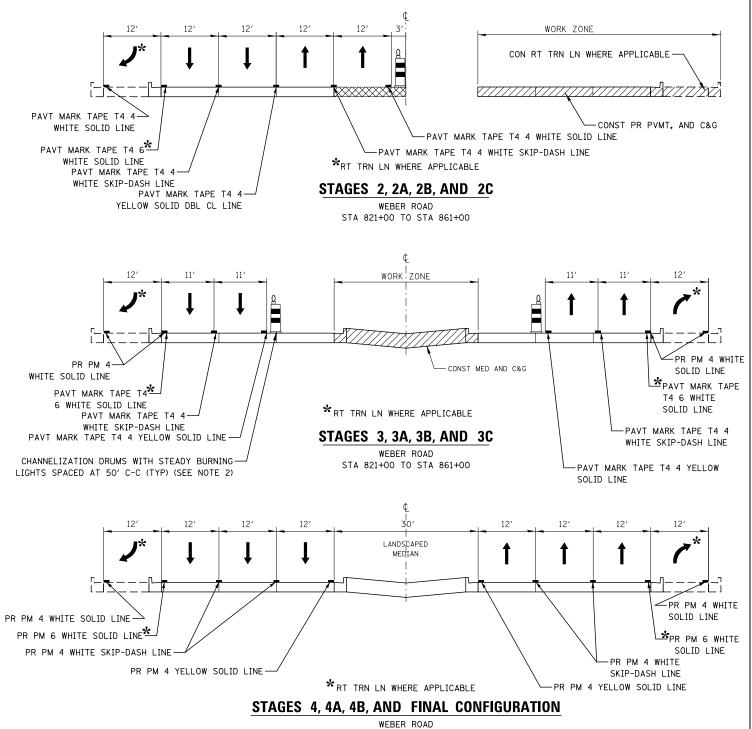
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 CHECKED
 PJO
 REVISED

 PLOT DATE = 5/13/2017
 DATE
 05/12/17
 REVISED

STATE OF ILLINOIS
DEPARTMENT OF TRANSPORTATION



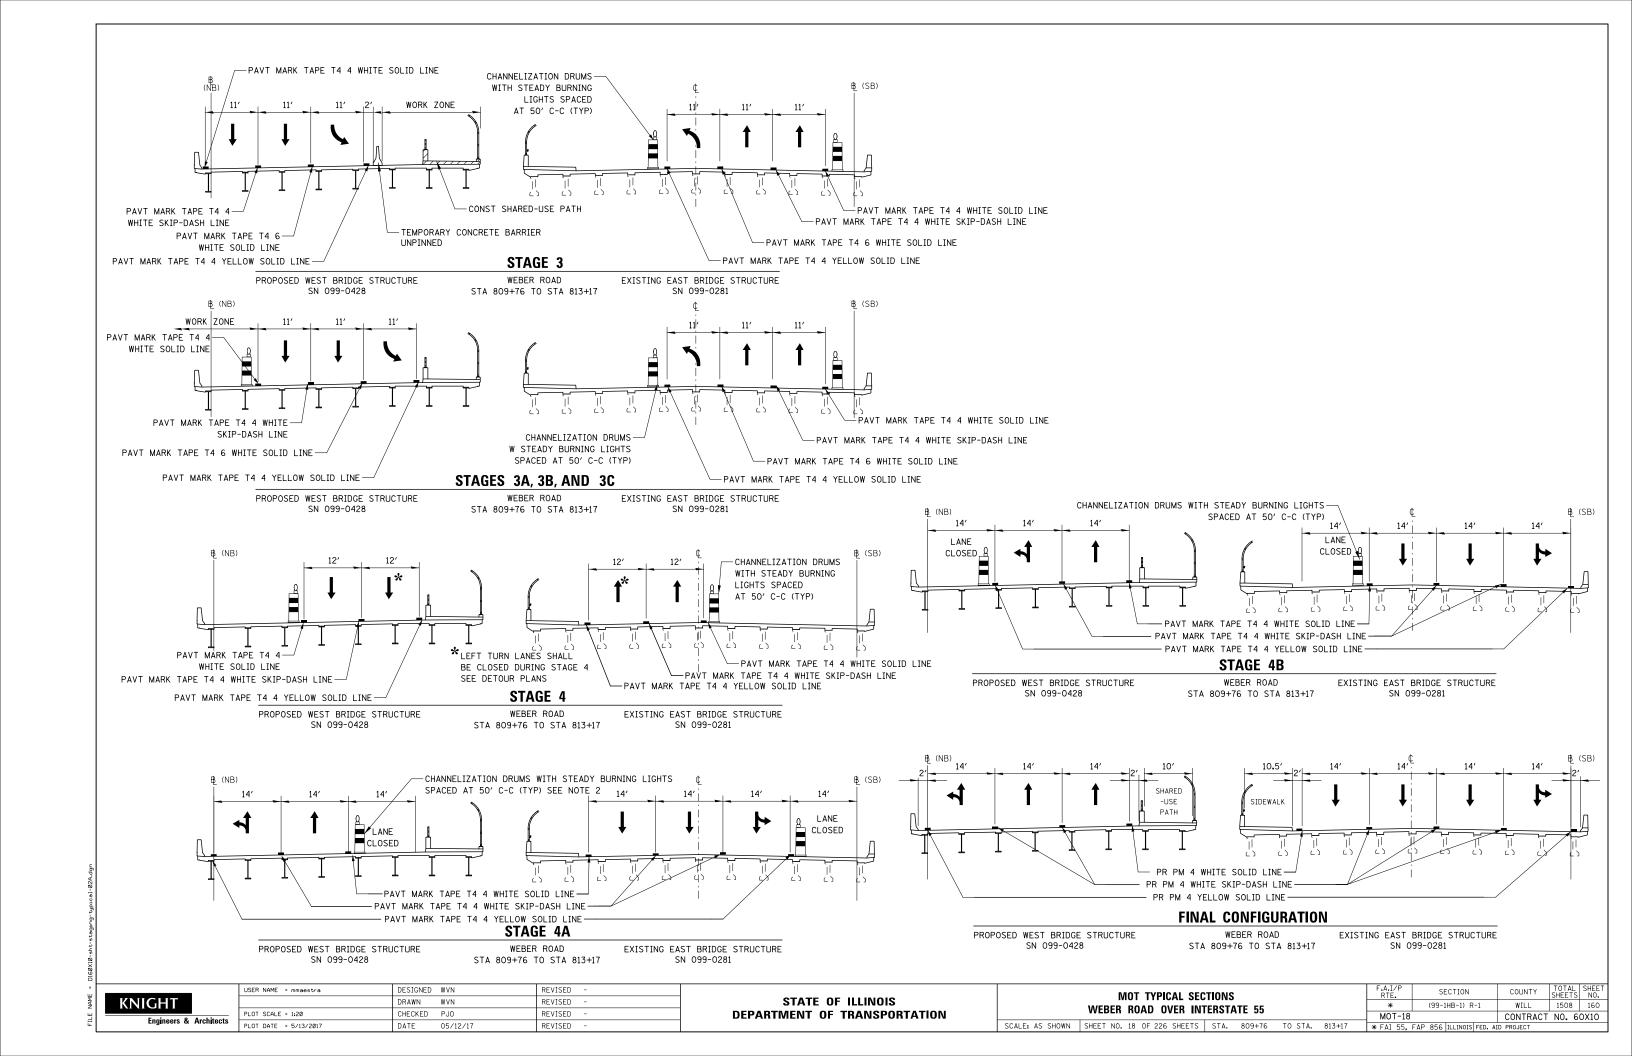

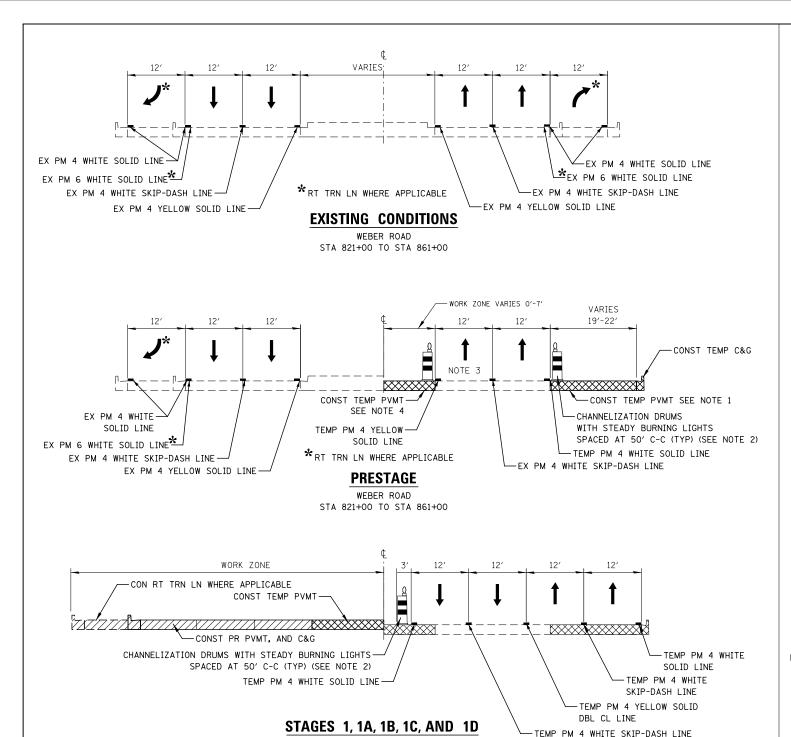

STA 821+00 TO STA 861+00

- 1. THE RIGHT THROUGH LANE IS TO BE CLOSED IN ACCORDANCE WITH IDOT STANDARD 701421 DURING TEMPORARY PAVEMENT CONSTRUCTION ADJACENT TO EXISTING PAVEMENT. CHANNELIZATION DRUMS SHALL BE RELOCATED ALONG THE ADJACENT THROUGH LANE OPEN TO TRAFFIC. THIS WORK MUST BE DONE DURING OFF-PEAK PERIODS IN ACCORDANCE WITH "KEEPING ARTERIAL ROADWAYS OPEN TO TRAFFIC" SPECIAL PROVISION.
- 2. PAVEMENT DROP-OFF SHALL NOT EXCEED 18 INCHES BEHIND CHANNELIZATION DRUMS AND SHALL NOT EXCEED 95 CALENDAR DAYS. TEMPORARY GRADING TO REDUCE DROP-OFF HEIGHT DURING CONSTRUCTION SHALL BE INCLUDED IN THE COST FOR TRAFFIC CONTROL AND PROTECTION, (SPECIAL).
- 3. THE LEFT THROUGH LANE IS TO BE CLOSED IN ACCORDANCE WITH IDOT STANDARD 701421 DURING CONSTRUCTION WITHIN THE EXISTING MEDIAN. CHANNELIZATION DRUMS SHALL BE RELOCATED ALONG THE ADJACENT THROUGH LANE OPEN TO TRAFFIC. THIS WORK MUST BE DONE DURING OFF-PEAK PERIODS IN ACCORDANCE WITH "KEEPING ARTERIAL ROADWAYS OPEN TO TRAFFIC" SPECIAL PROVISION.
- 4. THE CONTRACTOR IS REQUIRED TO PLACE TEMPORARY PAVEMENT IN ALL LOCATIONS WHERE THE RAISED MEDIAN IS REMOVED BY THE END OF THE WORK DAY.

SCALE:


KNIGHT Engineers & Architects


USER NAME = mmaestra	DESIGNED WVN	REVISED -
	DRAWN WVN	REVISED -
PLOT SCALE = 1:20	CHECKED PJO	REVISED -
PLOT DATE = 5/13/2017	DATE 05/12/17	REVISED -

WEBER ROAD

STA 821+00 TO STA 861+00


Ŋ	NOT TYPICAL SECTION	F.A.I/P RTE.	SECTION	COUNTY	TOTAL SHEETS	SHEET NO.			
LSS INTERC	I-55 INTERCHANGE TO RODEO DRIVE / REMINGTON BOULEVARD					(99-1HB-1) R-1	WILL	1508	161
I-33 INTERIO							CONTRACT	NO. 60	0X10
CALE: AS SHOWN	SHEET NO. 19 OF 226 S	HEETS	STA.	TO STA.	* FAI 55, I	FAP 856 ILLINOIS FED, AI	D PROJECT		

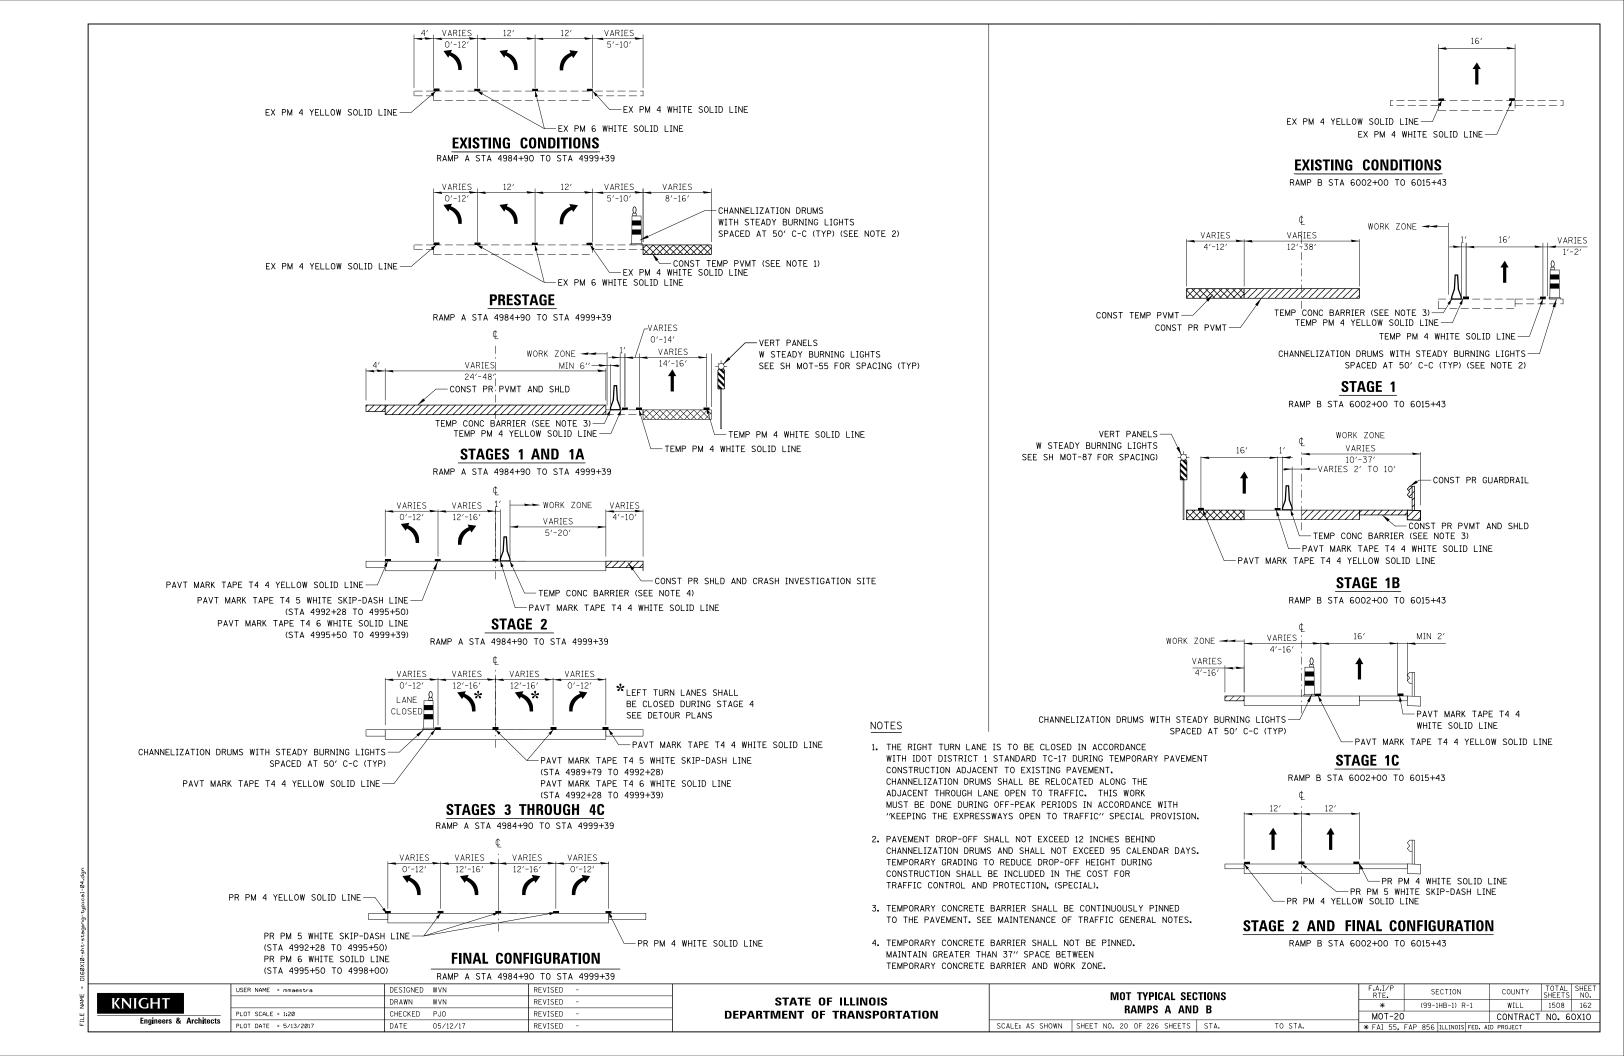

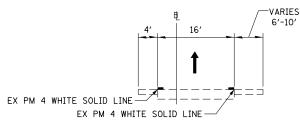


EXISTING CONDITIONS


RAMP C STA 7986+00 TO STA 7999+84

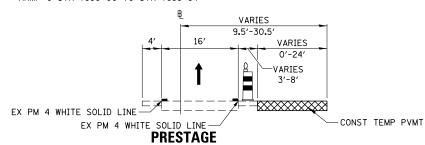

RAMP C STA 7986+00 TO STA 7999+84

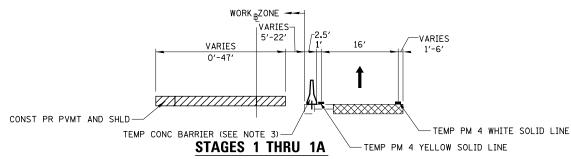


RAMP C STA 7986+00 TO STA 7999+84

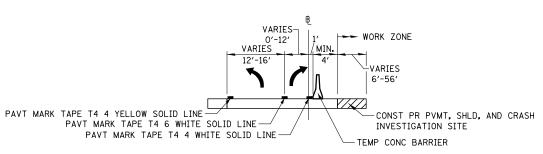

STAGES 1B THRU 1C

RAMP C STA 7986+00 TO STA 7999+84

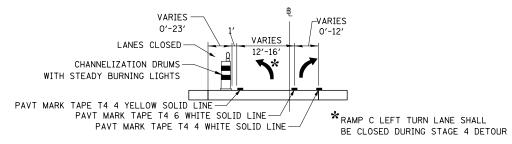

STAGES 2 THRU 4B


RAMP C STA 7986+00 TO STA 7999+84

NOTES

- 1. THE RIGHT TURN LANE IS TO BE CLOSED IN ACCORDANCE WITH IDOT DISTRICT 1 STANDARD TC-17 DURING TEMPORARY PAVEMENT CONSTRUCTION ADJACENT TO EXISTING PAVEMENT. CHANNELIZATION DRUMS SHALL BE RELOCATED ALONG THE ADJACENT THROUGH LANE OPEN TO TRAFFIC. THIS WORK MUST BE DONE DURING OFF-PEAK PERIODS IN ACCORDANCE WITH "KEEPING THE EXPRESSWAYS OPEN TO TRAFFIC" SPECIAL PROVISION.
- 2. PAVEMENT DROP-OFF SHALL NOT EXCEED 12 INCHES BEHIND CHANNELIZATION DRUMS AND SHALL NOT EXCEED 95 CALENDAR DAYS. TEMPORARY GRADING TO REDUCE DROP-OFF HEIGHT DURING CONSTRUCTION SHALL BE INCLUDED IN THE COST FOR TRAFFIC CONTROL AND PROTECTION, (SPECIAL).
- 3. TEMPORARY CONCRETE BARRIER SHALL BE CONTINUOUSLY PINNED TO THE PAVEMENT. SEE MAINTENANCE OF TRAFFIC GENERAL NOTES.


SCALE: AS SHOWN

4. TEMPORARY CONCRETE BARRIER SHALL NOT BE PINNED.
MAINTAIN GREATER THAN 37" SPACE BETWEEN
TEMPRORARY CONCRETE BARRIER AND WORK ZONE.

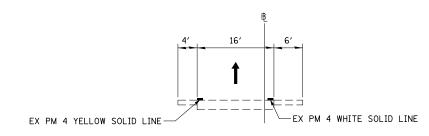


EXISTING CONDITIONS

RAMP D STA 9000+20 TO STA 9017+00

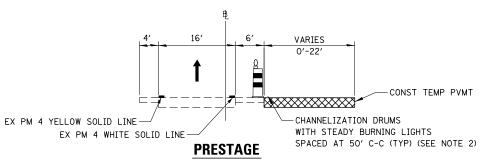


RAMP D STA 9000+20 TO STA 9017+00

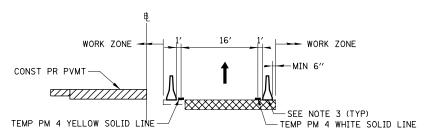


STAGE 1

RAMP D STA 9000+20 TO STA 9017+00

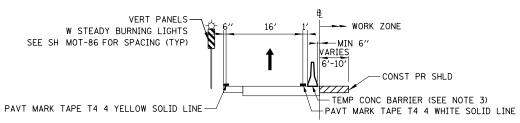

STAGE 1B

RAMP D STA 9000+20 TO STA 9017+00

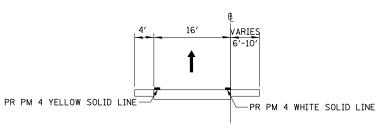


STAGE 2 AND FINAL CONFIGURATION

RAMP D STA 9000+20 TO STA 9017+00



USER NAME = mmaestra	DESIGNED	WVN	REVISED -
	DRAWN	WVN	REVISED -
PLOT SCALE = 1:20	CHECKED	PJ0	REVISED -
PLOT DATE = 5/13/2017	DATE	05/12/17	REVISED -
PLOT DATE = 5/13/2017	DATE	05/12/17	REVISED -

	MOT TYPICAL SECTIONS		F.A.I/P RTE.	SECTION	COUNTY	TOTAL SHEETS		
	RAMPS C AND D			*	(99-1HB-1) R-1	WILL	1508	163
				MOT-21		CONTRACT	NO. 6	0X10
	SHEET NO. 21 OF 226 SHEETS	STA.	TO STA.	* FAT 55.	FAP 856 ILLINOIS FED. AL	D PROJECT		

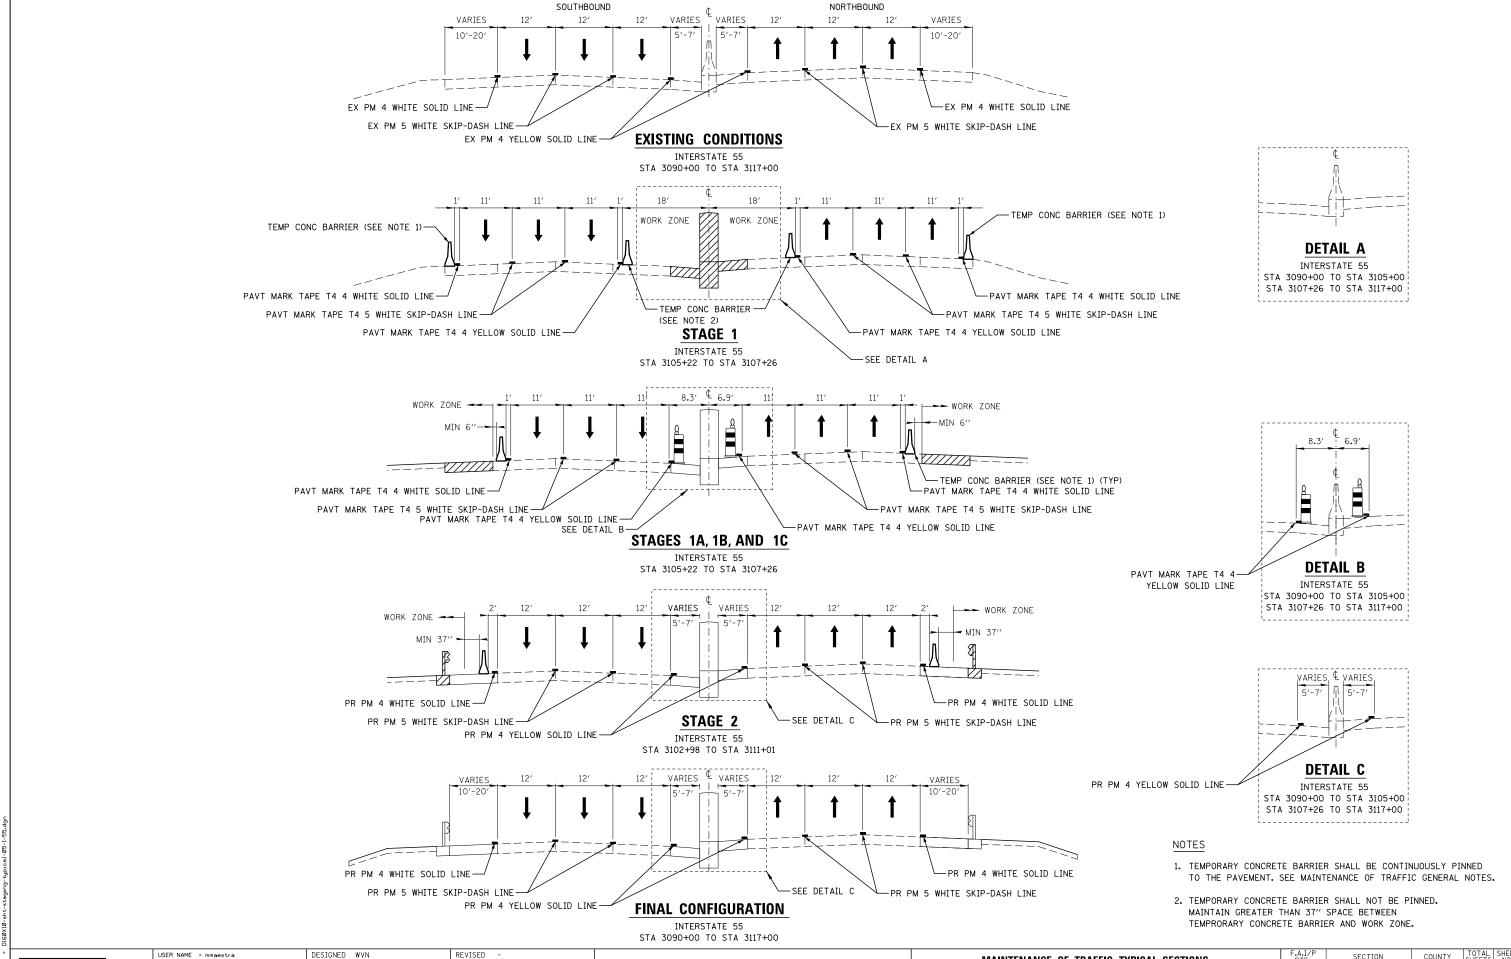

Engineers & Architects

 DRAWN
 WVN
 REVISED


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 CHECKED
 PJO
 REVISED


 PLOT DATE = 5/13/2017
 DATE
 05/12/17
 REVISED

STATE OF ILLINOIS DEPARTMENT OF TRANSPORTATION

MAINTENANCE OF TRAFFIC TYPICAL SECTIONS INTERSTATE 55

SCALE: AS SHOWN | SHEET NO. 22 OF 226 SHEETS | STA. TO STA.

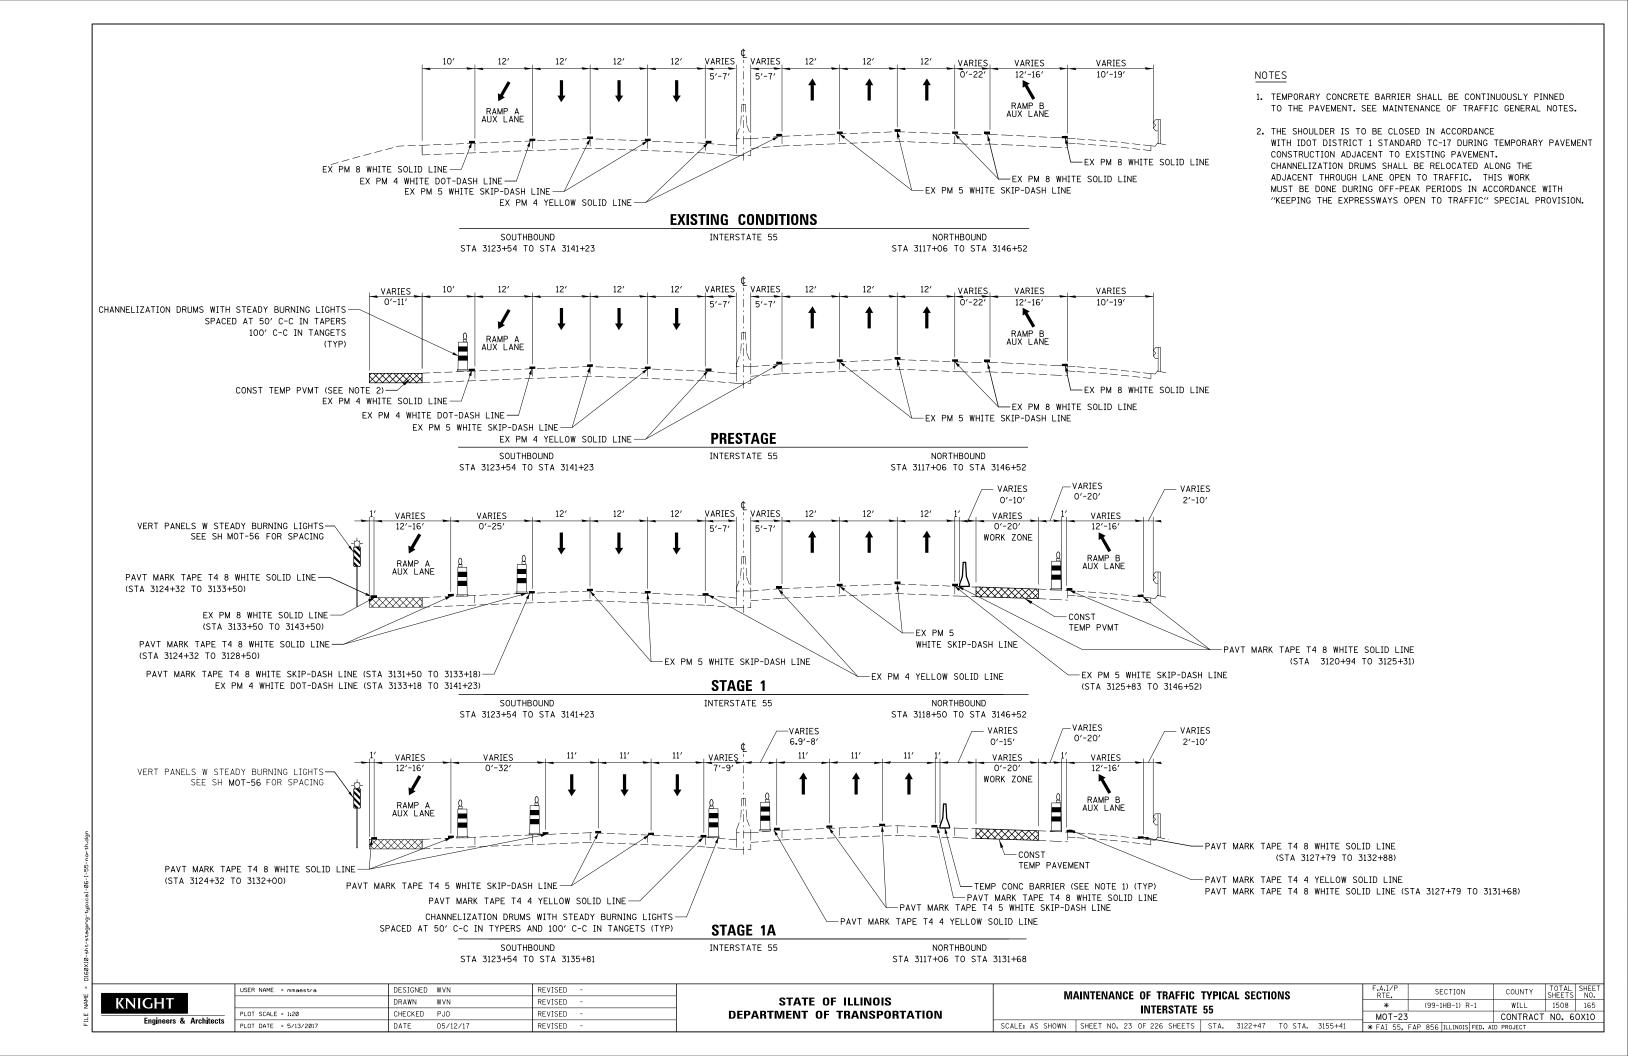

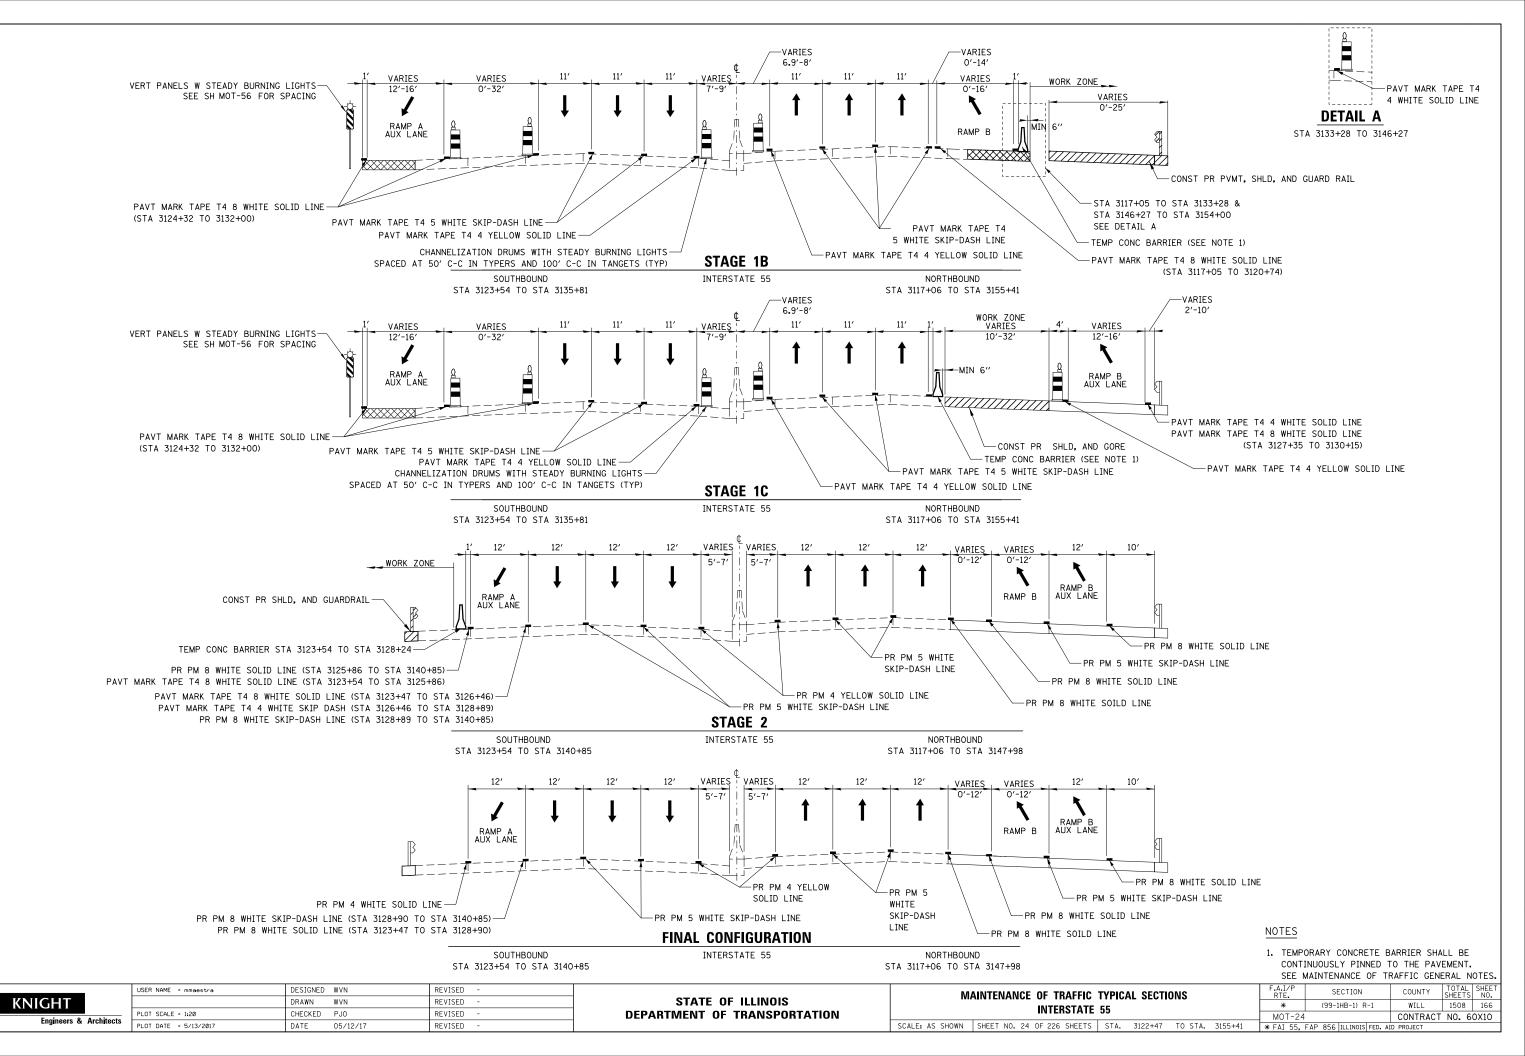

FILE NAME = D160X10-sht-stage





CONSTRUCTION WORK ZONE



TEMPORARY PAVEMENT PLACED IN THIS STAGE



PROPOSED PAVEMENT CONSTRUCTED IN PREVIOUS STAGE



TEMPORARY PAVEMENT PLACED IN PREVIOUS STAGE



DIRECTION OF TRAFFIC

0

CHANNELIZATION DRUM WITH STEADY BURNING LIGHT (SEE MOT GENERAL NOTE 14)

шшш

TEMPORARY IMPACT ATTENUATOR



TEMPORARY CONCRETE BARRIER



VERTICAL PANEL WITH STEADY BURNING LIGHT



SIGN



TYPE III BARRICADE LOCATION

SCALE:



FLASHING YELLOW LIGHT

MOT PAVEMENT MARKING LEGEND

- (1) EXISTING PAVEMENT MARKING
- 2 PROPOSED PAVEMENT MARKING (SEE PAVEMENT MARKING PLANS)
- (3) MAINTAIN PAVEMENT MARKING FROM PREVIOUS STAGE
- TEMPORARY PAVEMENT MARKING LINE 4", SOLID WHITE
- B TEMPORARY PAVEMENT MARKING LINE 4", WHITE SKIP-DASH (10' LINE 30' SPACE) (UNLESS OTHERWISE NOTED)
- (C) TEMPORARY PAVEMENT MARKING LINE 4", SOLID YELLOW
- TEMPORARY PAVEMENT MARKING LINE 4", DOUBLE YELLOW SPACED AT 11" C-C WITH TEMPORARY RAISED REFLECTIVE PAVEMENT MARKERS SPACED 40' C-C (BI-DIRECTIONAL AMBER, OR MONO-DIRECTIONAL AMBER AS SHOWN)
- (E) TEMPORARY PAVEMENT MARKING LINE 6", SOLID WHITE
- F TEMPORARY PAVEMENT MARKING LINE 6", WHITE DOTTED (2' LINE 6' SPACE) (UNLESS OTHERWISE NOTED)
- G TEMPORARY PAVEMENT MARKING LINE 8 ", SOLID WHITE

- H) TEMPORARY PAVEMENT MARKING LINE 12", SOLID WHITE
-) TEMPORARY PAVEMENT MARKING LINE 12", SOLID YELLOW
- J) TEMPORARY PAVEMENT MARKING LINE 24", SOLID WHITE
- (K) TEMPORARY PAVEMENT MARKING, LETTERS & SYMBOLS
- L) PAVEMENT MARKING TAPE, TYPE IV, 4", SOLID WHITE
- M PAVEMENT MARKING TAPE, TYPE IV, 4", WHITE SKIP-DASH (10' LINE 30' SPACE) (UNLESS OTHERWISE NOTED)
 -) PAVEMENT MARKING TAPE, TYPE IV, 4", SOLID YELLOW
- PAVEMENT MARKING TAPE, TYPE IV, 4", DOUBLE YELLOW SPACED AT 11" C-C WITH TEMPORARY RAISED REFLECTIVE PAVEMENT MARKERS SPACED 40' C-C (BI-DIRECTIONAL AMBER)

- P PAVEMENT MARKING TAPE, TYPE IV, 5", WHITE SKIP-DASH (10' LINE 30' SPACE)
- (Q) PAVEMENT MARKING TAPE, TYPE IV, 6", SOLID WHITE
- R PAVEMENT MARKING TAPE, TYPE IV, 6", WHITE DOTTED (2' LINE 6' SPACE) (UNLESS OTHERWISE NOTED)
- (S) PAVEMENT MARKING TAPE, TYPE IV, 8", SOLID WHITE
- (T) PAVEMENT MARKING TAPE, TYPE IV, 12", SOLID WHITE
- (U) PAVEMENT MARKING TAPE, TYPE IV, 12", SOLID YELLOW
- (V) PAVEMENT MARKING TAPE, TYPE IV, 24", SOLID WHITE
- (W) PAVEMENT MARKING TAPE, TYPE IV, LETTERS & SYMBOLS
- X) PAVEMENT MARKING TAPE, TYPE IV, 4", WHITE DOTTED (2' LINE 6' SPACE)
- Y PAVEMENT MARKING TAPE, TYPE IV, 8", WHITE DOTTED (3" LINE 9" SPACE)

KNIGHT
Engineers & Architects


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	DRAWN	WVN	REVISED	-
PLOT SCALE = 1:2	CHECKED	PJ0	REVISED	-
PLOT DATE = 5/13/2017	DATE	05/12/17	REVISED	-

STATE OF ILLINOIS	
DEPARTMENT OF TRANSPORTATION	

MOT LEGEND			F.A.I/P RTE.	SECTION	COUNTY	TOTAL SHEETS	SHEET NO.	
			*	(99-1HB-1) R-1	WILL	1508	167	
				M0T-25		CONTRACT	NO. 6	0X10
NONE	SHEET NO. 25 OF 226 SHEETS	STA.	TO STA.	* FAI 55,	FAP 856 ILLINOIS FED. A	ID PROJECT		

FOR TEMPORARY PAVEMENT CONSTRUCTION USE HIGHWAY STANDARDS NO. 701106, 701422, 701601, 701701 & 701101


> FOR STORM SEWER CONSTRUCTION USE HIGHWAY STANDARD NO. 701101 & 701106

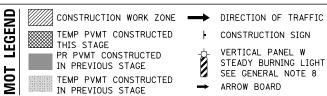

IN PREVIOUS STAGE

TYPE III BARRICADE WITH STEADY BURNING LIGHTS DRUM W STEADY BURNING LIGHT SEE MOT GENERAL NOTE 14

TEMP CONC BARRIER OR REL TEMP CONC BARRIER

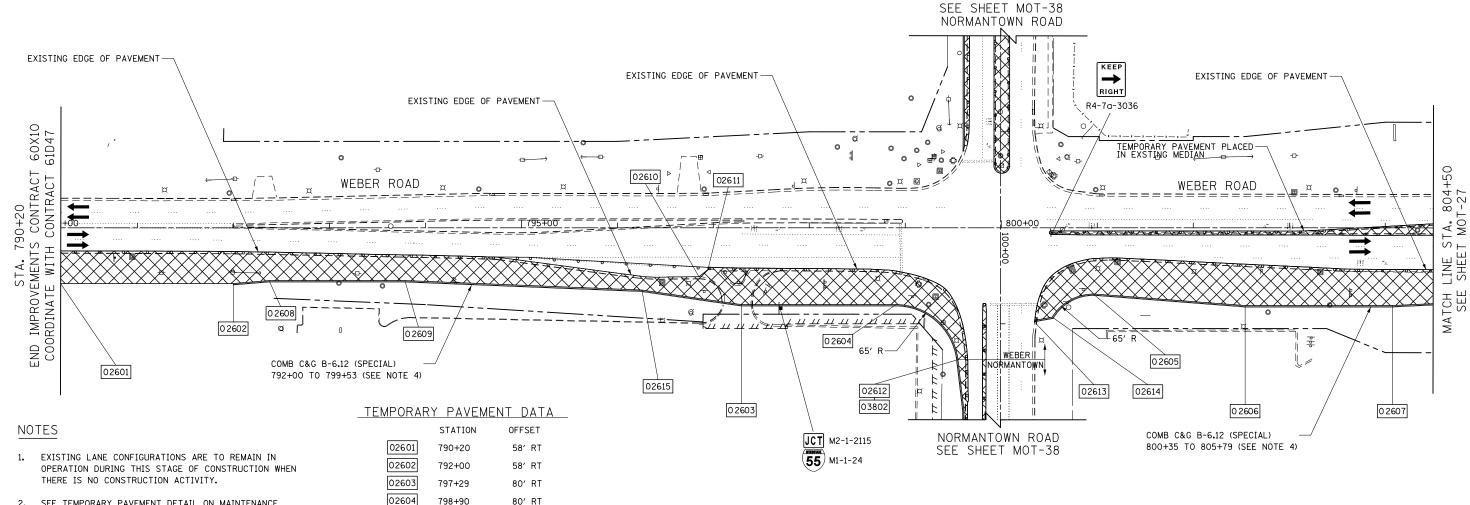

- 2. SEE TEMPORARY PAVEMENT DETAIL ON MAINTENANCE OF TRAFFIC DETAILS SHEET MOT-8.
- 3. LANE CLOSURES WILL BE PERMITTED ONLY DURING OFF-PEAK PERIODS AS ALLOWED BY THE "KEEPING THE EXPRESSWAY OPEN TO TRAFFIC" AND KEEPING ARTERIAL ROADWAYS OPEN TO TRAFFIC" DISTRICT 1 SPECIAL PROVISIONS.
- 4. AT THE LIMITS OF THE CURB AND GUTTER, HORIZONTAL AND VERTICAL TRANSITIONS SHALL BE INSTALLED IN ACCORDANCE WITH THE MAINTENANCE OF TRAFFIC DETAILS AND AS DIRECTED BY THE ENGINEER.

	MI ONANI		I DAIA
		STATION	OFFSET
	02601	790+20	58′ RT
	02602	792+00	58′ RT
	02603	797+29	80' RT
	02604	798+90	80' RT
	02605	800+96	69' RT
	02606	802+54	81′ RT
	02607	804+07	81' RT
	02608	792+37	55′ RT
	02609	793+79	55′ RT
	02610	796+85	51′ RT
	02611	796+94	43′ LT
03802	02612	799+55	137′ RT
	02613	800+35	98′ RT
	02614	800+53	93′ RT
	0 2615	796+26	65′ RT

	53	93′ RT
		98′ RT
43′ LT	5	137′ RT
		43′ LT
	9	55′ RT

o	50′	100′	150′	200′
		SCALE IN FEET	<u> </u>	

COUNTY


WILL 1508 168 CONTRACT NO. 60X10

KNIGHT		
Fngingers	R.	Architects

	USER NAME = mmaestra	DESIGNED WVN	REVISED -
NIGHT		DRAWN DAM	REVISED -
	PLOT SCALE = 1:100	CHECKED PJO	REVISED -
Engineers & Architects	PLOT DATE = 5/13/2017	DATE 05/12/17	REVISED -

STATI	OF ILLINOIS	
DEPARTMENT	OF TRANSPORT	TATION


MAINTENANCE OF TRAFFIC – PRESTAGE 1	F.A.I/P RTE.	SECTION
WEBER ROAD	*	(99-1HB-1) R-1
WEDEN HOAD	M0T-26	
SCALE: AS SHOWN SHEET NO. 26 OF 226 SHEETS STA. 790+00 TO STA. 804+50	* FAT 55.	FAP 856 ILLINOIS FED. AII

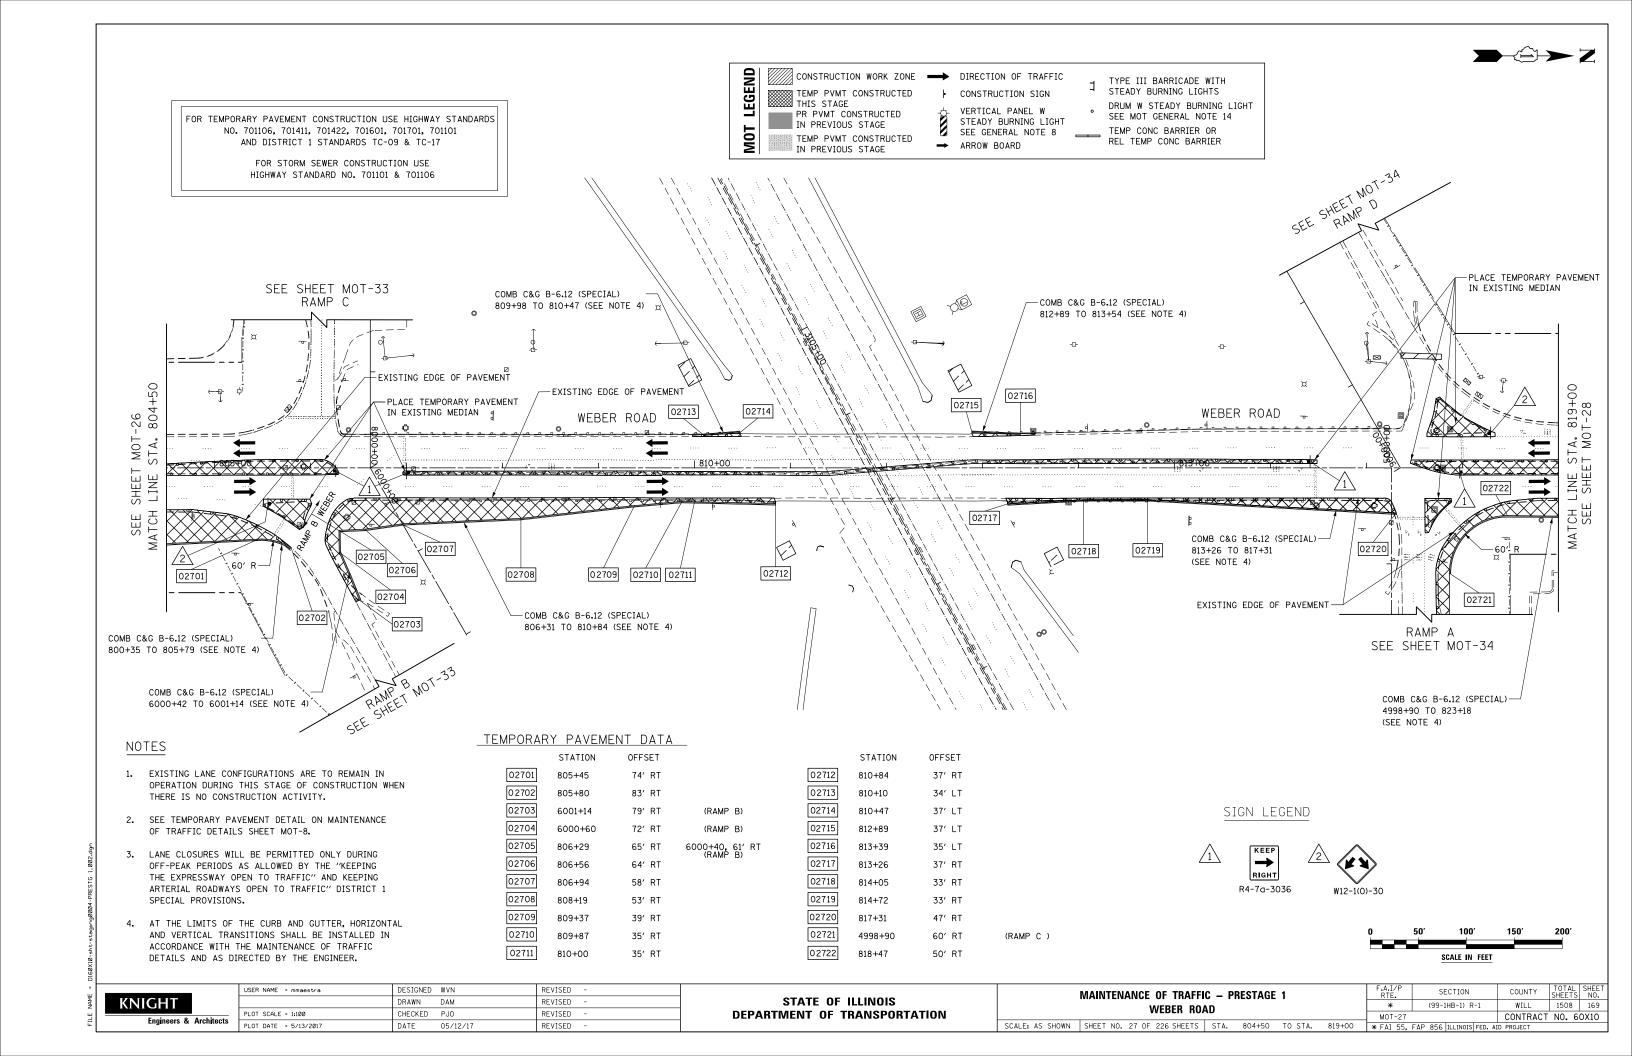

 $\rightarrow \bigcirc \rightarrow Z$

FOR TEMPORARY PAVEMENT CONSTRUCTION USE HIGHWAY STANDARDS NO. 701106, 701411, 701422, 701601, 701701, 701101, 701501, 701502, 70206, & 701201

> FOR STORM SEWER CONSTRUCTION USE HIGHWAY STANDARD NO. 701101 & 701106

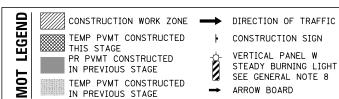


CONSTRUCTION SIGN

VERTICAL PANEL W STEADY BURNING LIGHT SEE GENERAL NOTE 8 → ARROW BOARD

TYPE III BARRICADE WITH STEADY BURNING LIGHTS

DRUM W STEADY BURNING LIGHT SEE MOT GENERAL NOTE 14 TEMP CONC BARRIER OR REL TEMP CONC BARRIER

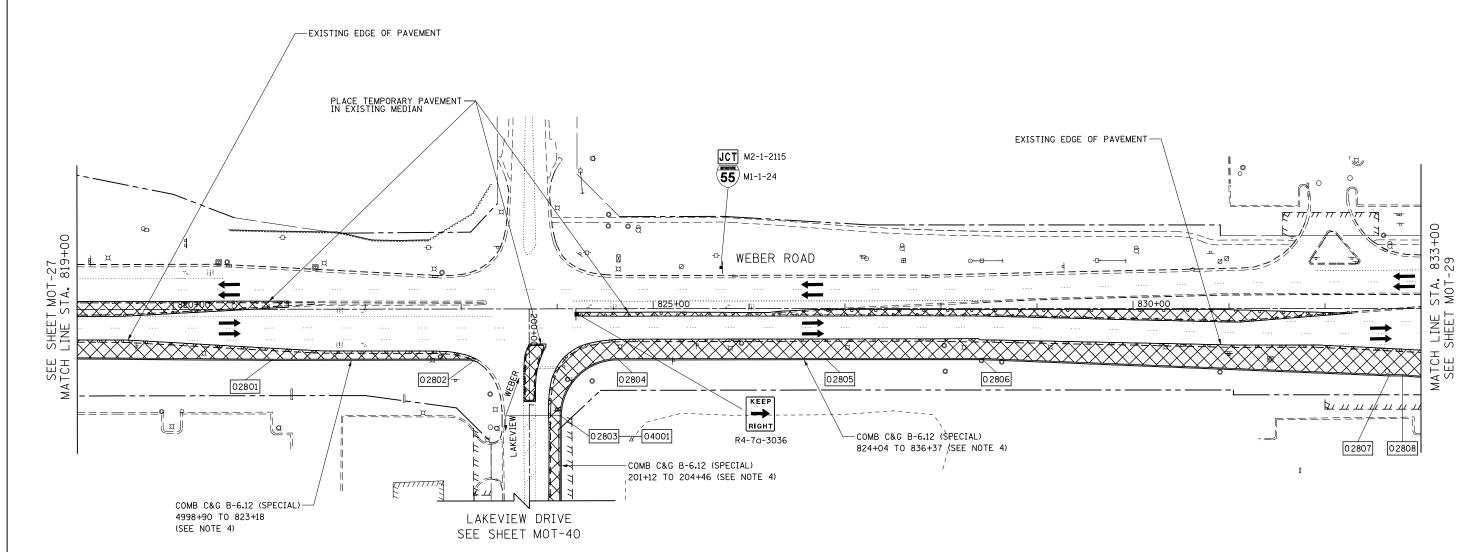


NOTES

- 1. EXISTING LANE CONFIGURATIONS ARE TO REMAIN IN OPERATION DURING THIS STAGE OF CONSTRUCTION WHEN THERE IS NO CONSTRUCTION ACTIVITY.
- 2. SEE TEMPORARY PAVEMENT DETAIL ON MAINTENANCE OF TRAFFIC DETAILS SHEET MOT-8.
- 3. LANE CLOSURES WILL BE PERMITTED ONLY DURING OFF-PEAK PERIODS AS ALLOWED BY THE "KEEPING THE EXPRESSWAY OPEN TO TRAFFIC" AND KEEPING ARTERIAL ROADWAYS OPEN TO TRAFFIC" DISTRICT 1 SPECIAL PROVISIONS.
- 4. AT THE LIMITS OF THE CURB AND GUTTER, HORIZONTAL AND VERTICAL TRANSITIONS SHALL BE INSTALLED IN ACCORDANCE WITH THE MAINTENANCE OF TRAFFIC DETAILS AND AS DIRECTED BY THE ENGINEER.

TEMPORARY PAVEMENT DATA

	STATION	OFFSET	
02801	821+04	52′ RT	
02802	823+15	52′ RT	
02803	824+03	111' RT	201+11, 32' LT
02804	824+63	52' RT	(LAKEVIEW)
02805	826+79	52' RT	
02806	828+42	52′ RT	
02807	832+67	69′ RT	
02808	832+81	69' RT	

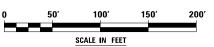




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		DRAWN	DAM	REVISED -	
_	PLOT SCALE = 1:100	CHECKED	PJ0	REVISED -	
ets	PLOT DATE = 5/13/2017	DATE	05/12/17	REVISED -	

Ī	MAINTENANCE OF TRAFFIC – PRESTAGE 1	F.A.I/P RTE.	SECTION	COUNTY	TOTAL SHEETS	SHEET NO.
١	WEBER ROAD	*	(99-1HB-1) R-1	WILL	1508	170
		MOT-28		CONTRACT	NO. 6	0X10
١	SCALE: AS SHOWN SHEET NO. 28 OF 226 SHEETS STA. 819+00 TO STA. 833+00	* FAT 55.	FAP 856 ILLINOIS FED. AL	D PROJECT		



FOR TEMPORARY PAVEMENT CONSTRUCTION USE HIGHWAY STANDARDS NO. 701106, 701411, 701422, 701601, 701501, 701701, 701101, 701206, & 701201


> FOR STORM SEWER CONSTRUCTION USE HIGHWAY STANDARD NO. 701101 & 701106

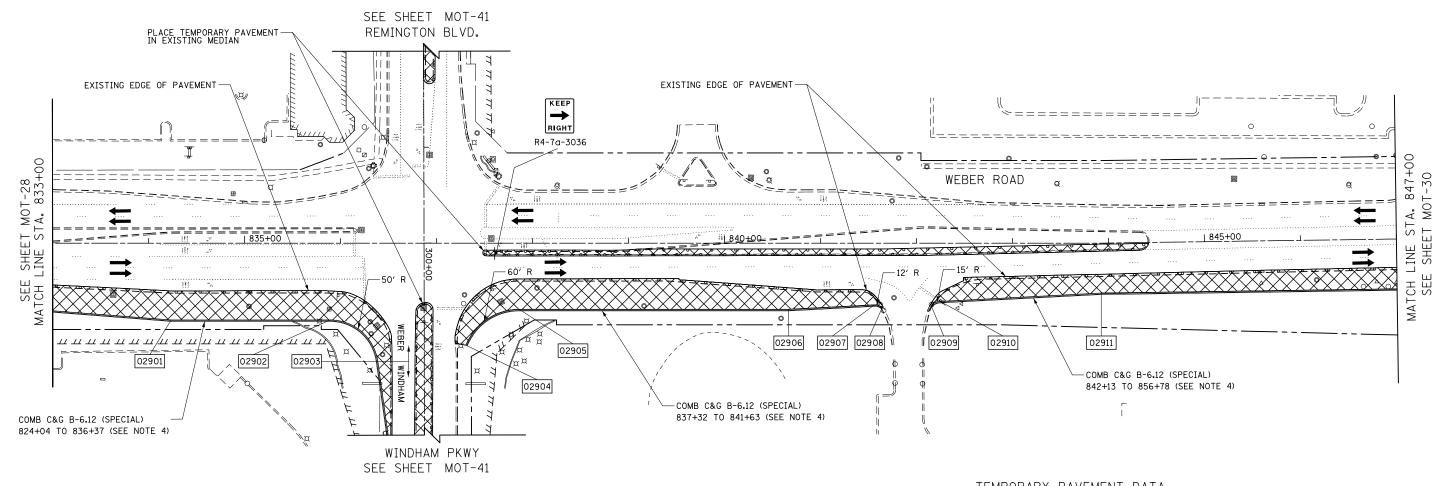

NOTES

- 1. EXISTING LANE CONFIGURATIONS ARE TO REMAIN IN OPERATION DURING THIS STAGE OF CONSTRUCTION WHEN THERE IS NO CONSTRUCTION ACTIVITY.
- 2. SEE TEMPORARY PAVEMENT DETAIL ON MAINTENANCE OF TRAFFIC DETAILS SHEET MOT-8.
- 3. LANE CLOSURES WILL BE PERMITTED ONLY DURING OFF-PEAK PERIODS AS ALLOWED BY THE "KEEPING THE EXPRESSWAY OPEN TO TRAFFIC" AND KEEPING ARTERIAL ROADWAYS OPEN TO TRAFFIC" DISTRICT 1 SPECIAL PROVISIONS.
- 4. AT THE LIMITS OF THE CURB AND GUTTER, HORIZONTAL AND VERTICAL TRANSITIONS SHALL BE INSTALLED IN ACCORDANCE WITH THE MAINTENANCE OF TRAFFIC DETAILS AND AS DIRECTED BY THE ENGINEER.

TEMP0	<u>rary</u>	<u>PAVEMEN</u>	<u>t data</u>	<u>\</u>	
		STATION	OFFSET		
029	01	834+24	80′ RT		
029	02	835+89	80' RT		
029	03	836+39	123′ RT		
029	04	837+31	106′ RT	301+23, 48' RT (WINDHAM)	
029	05	837+86	69′ RT		
029	06	840+67	69′ RT		
029	07	841+56	64′ RT		
029	08	841+64	67′ RT		
029	09	842+15	65′ RT		
029	10	842+25	61′ RT		0
029	11	843+92	52′ RT		_

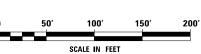




	USER NAME = mmaestra	DESIGNED	WVN	REVISED -
		DRAWN	DAM	REVISED -
	PLOT SCALE = 1:100	CHECKED	PJ0	REVISED -
ineers & Architects	PLOT DATE = 5/13/2017	DATE	05/12/17	REVISED -

	MAINTENANCE OF TRAFFIC - PRESTAGE 1	F.A.I/P RTE.	SECTION	COUNTY	TOTAL SHEETS	SHEET NO.
١	WEBER ROAD	*	(99-1HB-1) R-1	WILL	1508	171
	T	MOT-29		CONTRACT	NO. 6	0X10
١	SCALE: AS SHOWN SHEET NO. 29 OF 226 SHEETS STA. 833+00 TO STA. 847+00	* FAT 55.	FAP 856 ILLINOIS FED. AI	ID PROJECT		



FOR TEMPORARY PAVEMENT CONSTRUCTION USE HIGHWAY STANDARDS NO. 701106, 701411, 701422, 701601, 701606, 701701, 701101, 701201, & 701206


> FOR STORM SEWER CONSTRUCTION USE HIGHWAY STANDARD NO. 701101 & 701106

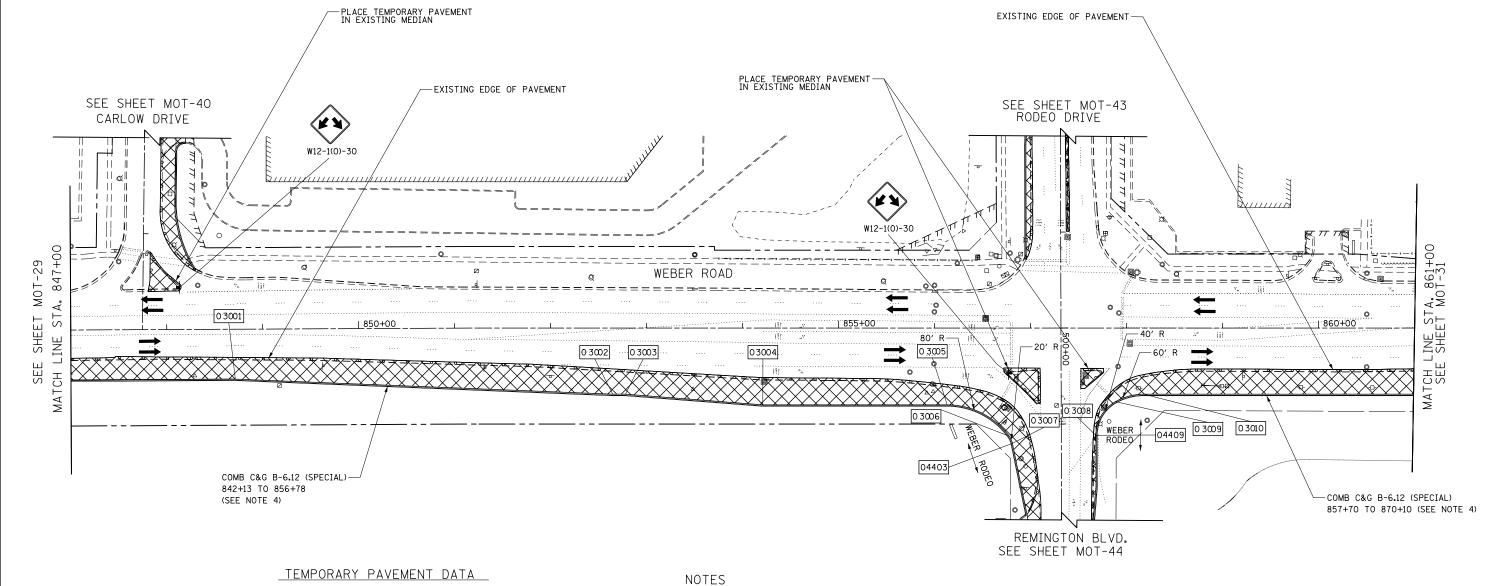

TEMPORARY	PAVEMENT	DATA
	CT4TION 0	FECET

	STATION	OFFSET	
0 3001	848+71	52′ RT	
0 3002	852+65	69′ RT	
03003	852+78	69′ RT	
03004	854+21	80′ RT	
0 3005	856+13	80′ RT	
03006	856+78	113' RT	
03007	856+81	120' RT	501+20, 51' RT (RODEO)
03008	857+68	112' RT	501+12, 36' LT (RODEO)
0 3009	857+88	77′ RT	(RODEO)
0 3010	858+18	69′ RT	

- 1. EXISTING LANE CONFIGURATIONS ARE TO REMAIN IN OPERATION DURING THIS STAGE OF CONSTRUCTION WHEN THERE IS NO CONSTRUCTION ACTIVITY.
- 2. SEE TEMPORARY PAVEMENT DETAIL ON MAINTENANCE OF TRAFFIC DETAILS SHEET MOT-8.
- 3. LANE CLOSURES WILL BE PERMITTED ONLY DURING OFF-PEAK PERIODS AS ALLOWED BY THE "KEEPING THE EXPRESSWAY OPEN TO TRAFFIC" AND KEEPING ARTERIAL ROADWAYS OPEN TO TRAFFIC" DISTRICT 1 SPECIAL PROVISIONS.
- 4. AT THE LIMITS OF THE CURB AND GUTTER, HORIZONTAL AND VERTICAL TRANSITIONS SHALL BE INSTALLED IN ACCORDANCE WITH THE MAINTENANCE OF TRAFFIC DETAILS AND AS DIRECTED BY THE ENGINEER.

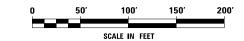






	USER NAME = mmaestra	DESIGNED WVN	REVISED -
TT		DRAWN DAM	REVISED -
	PLOT SCALE = 1:100	CHECKED PJO	REVISED -
ineers & Architects	PLOT DATE = 5/13/2017	DATE 05/12/17	REVISED -


STATE OF ILLINOIS				
DEPARTMENT OF TRANSPORTATION				


	MAINTENANCE OF TRAFFIC – PRESTAGE 1 WEBER ROAD				F.A.I/P RTE.	SECTION	COUNTY	TOTAL SHEETS	SHEET NO.		
					*	(99-1HB-1) R-1	WILL	1508	172		
	WEDER HOAD					MOT-30		CONTRACT	NO. 6	0X10	
	SCALE: AS SHOWN	SHEET NO. 30 OF 226 SHEETS	STA.	847+00	TO STA.	861+00	* FAI 55,	55, FAP 856 ILLINOIS FED. AID PROJECT			

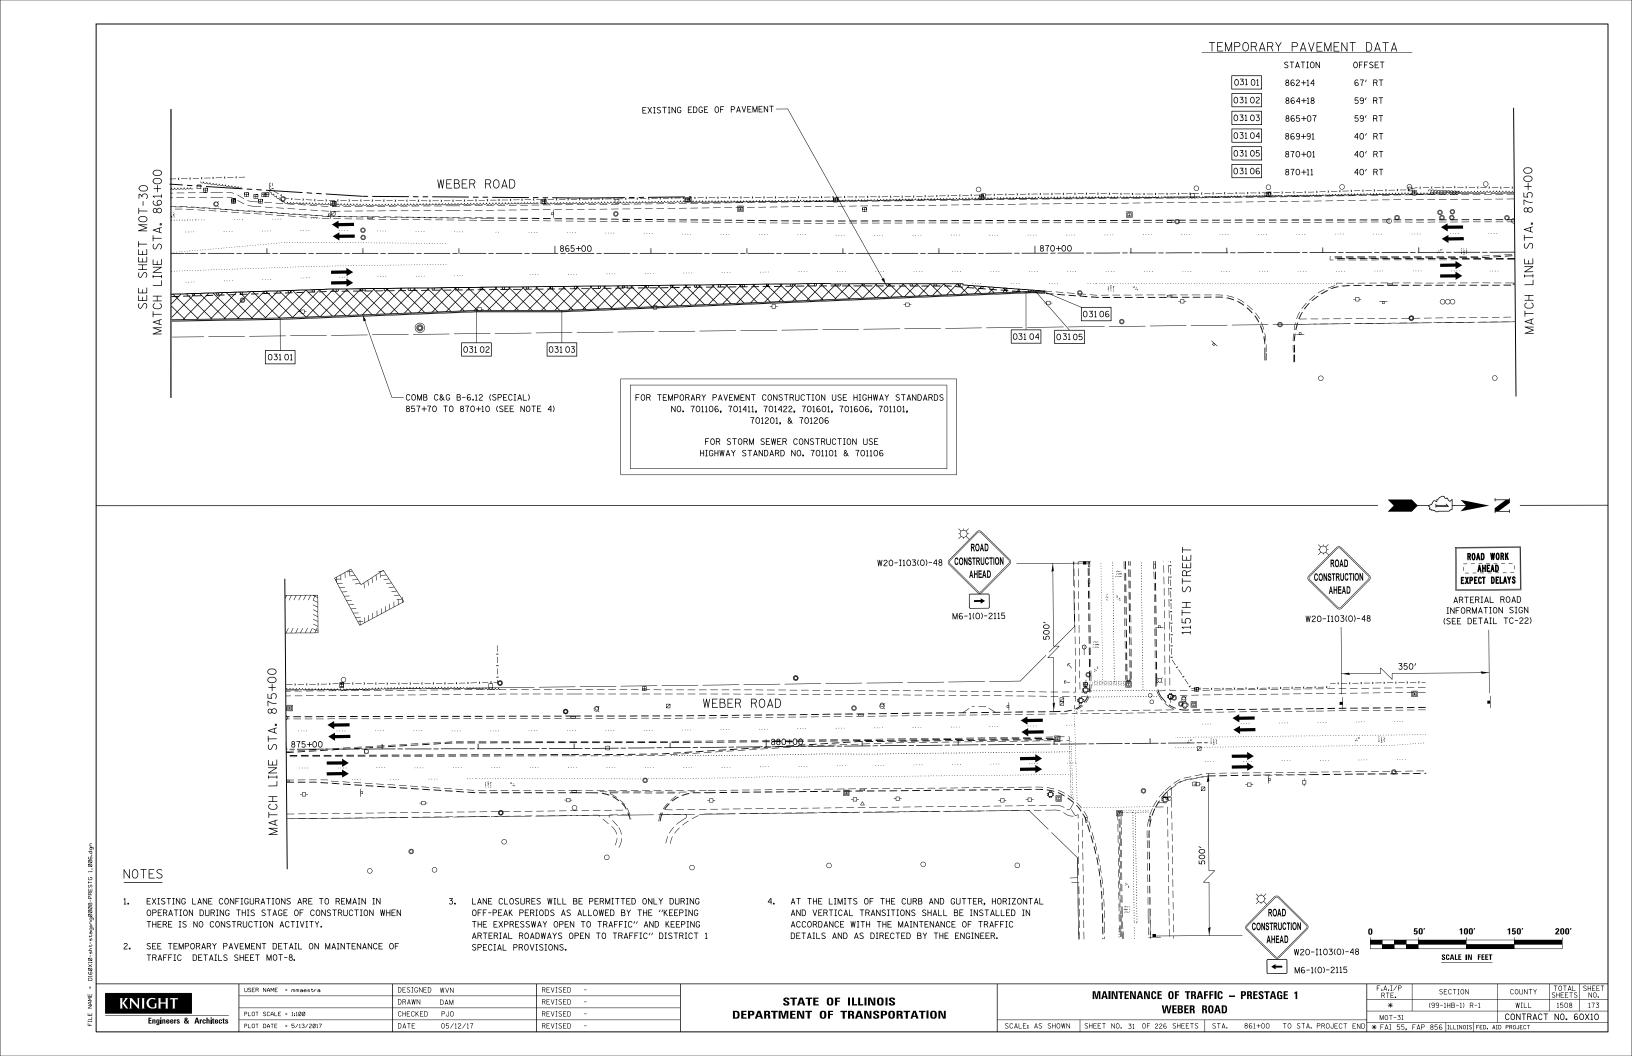

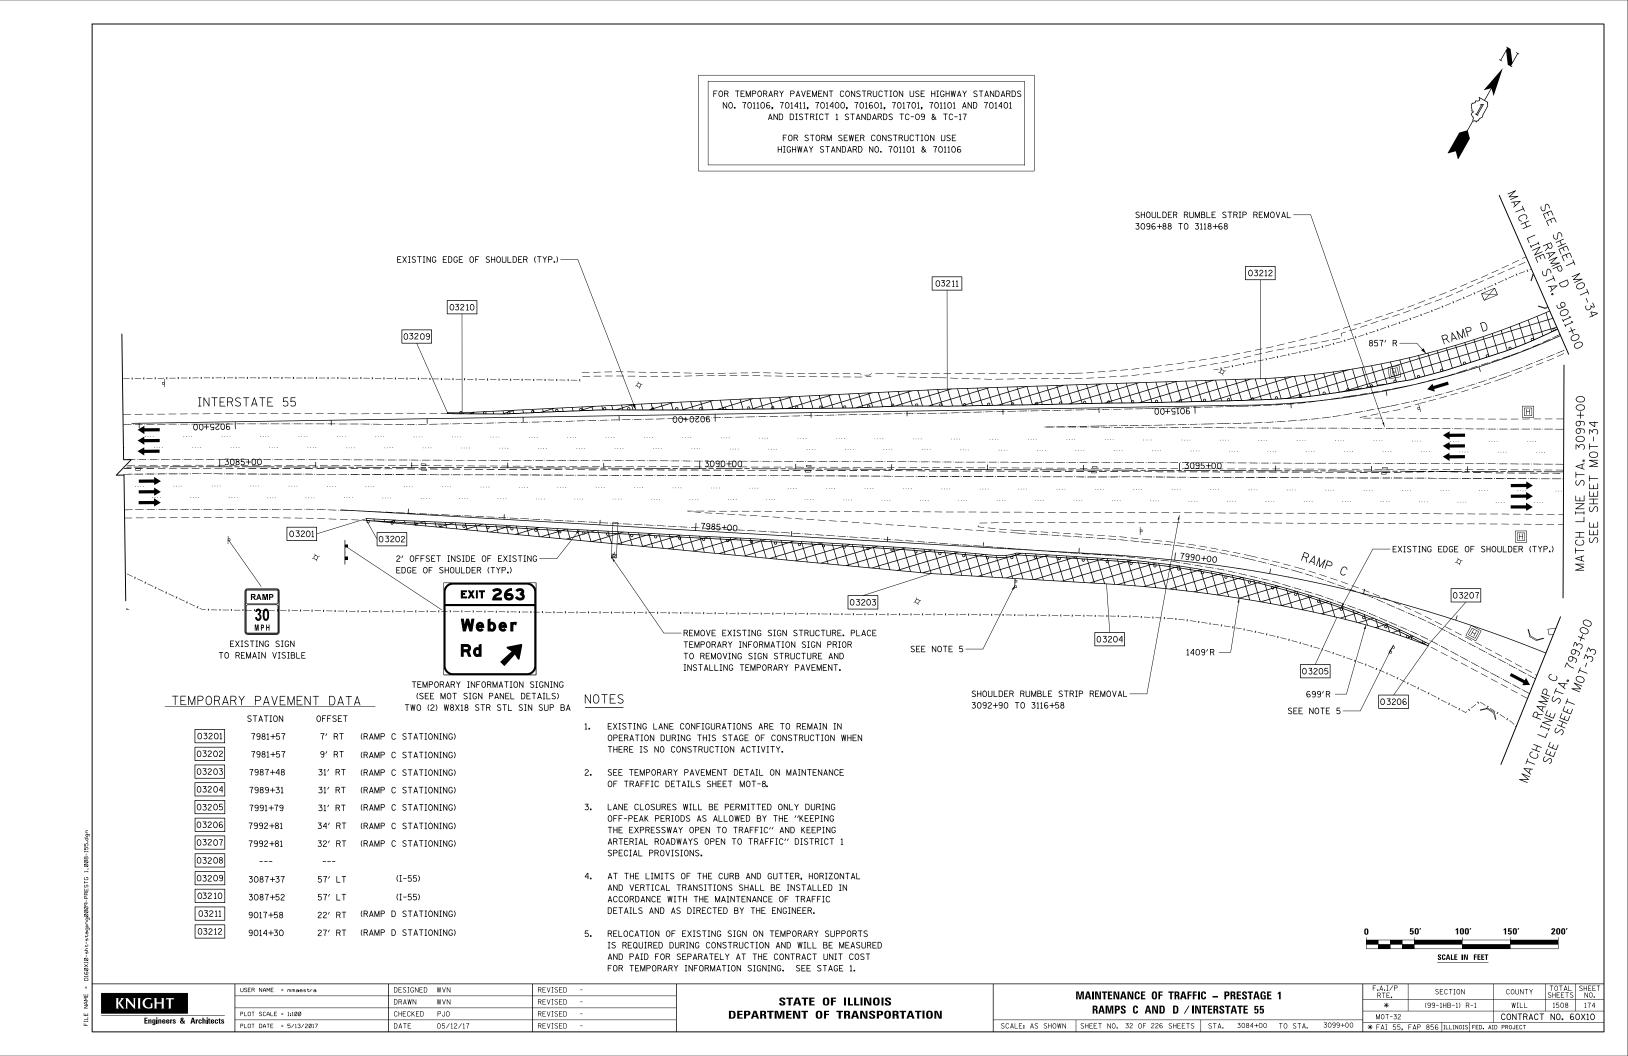

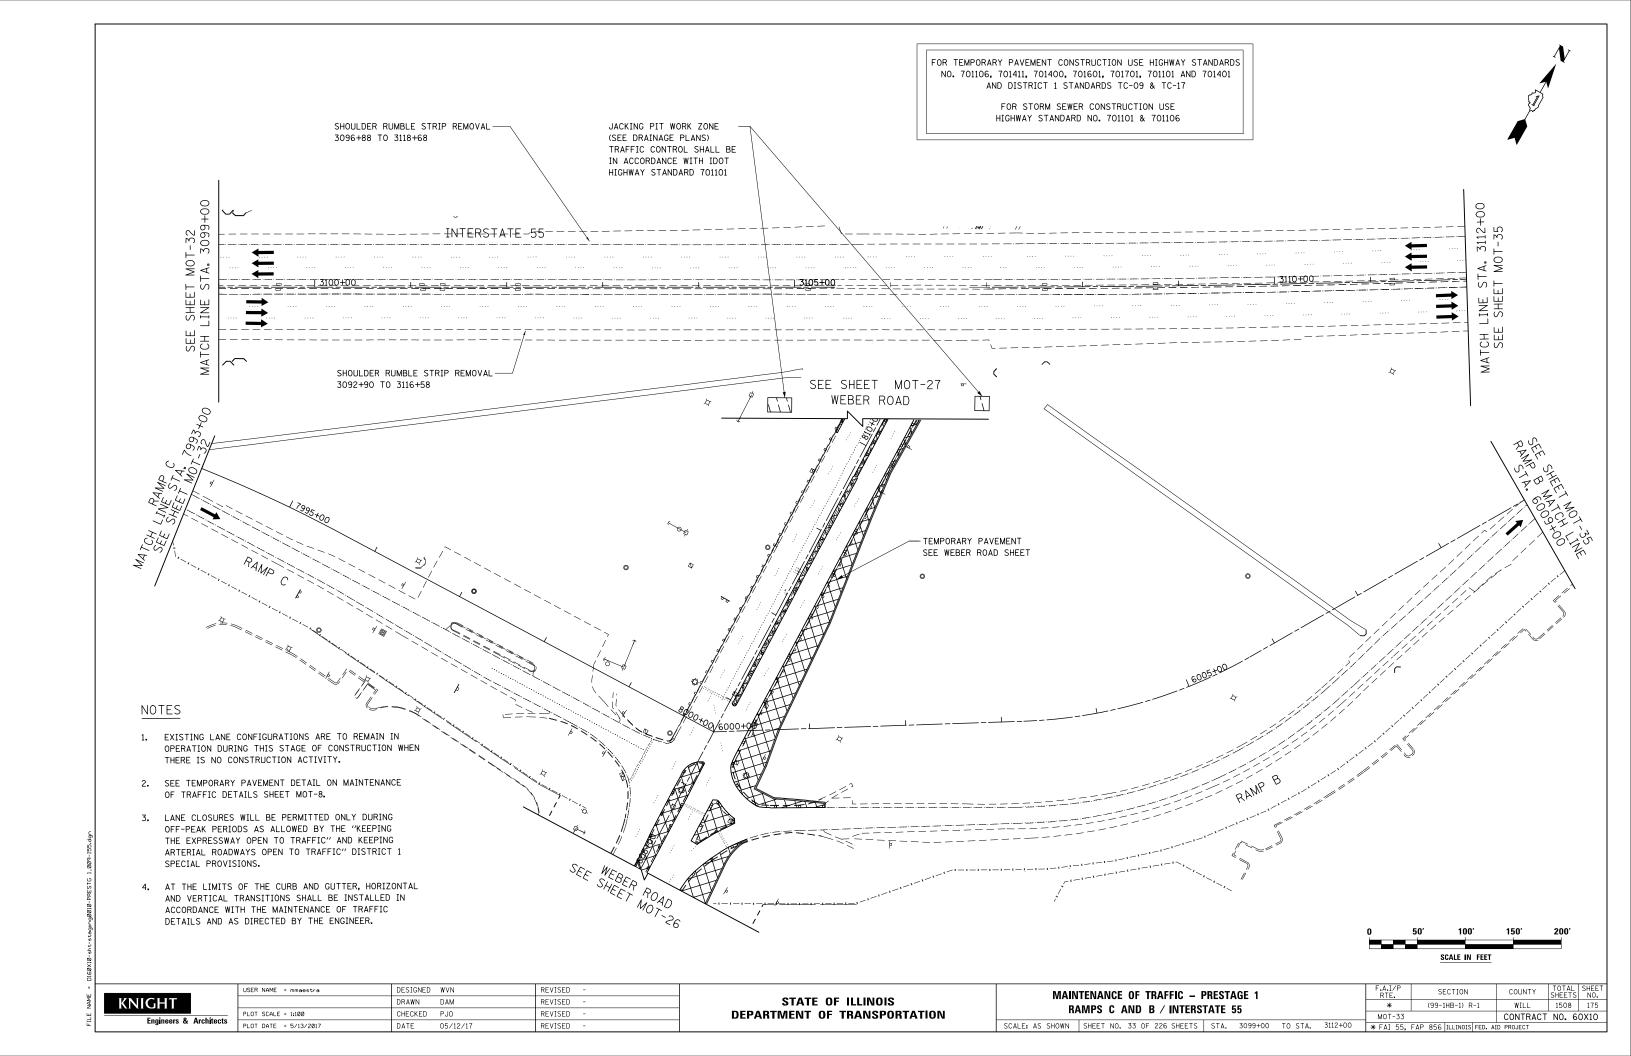

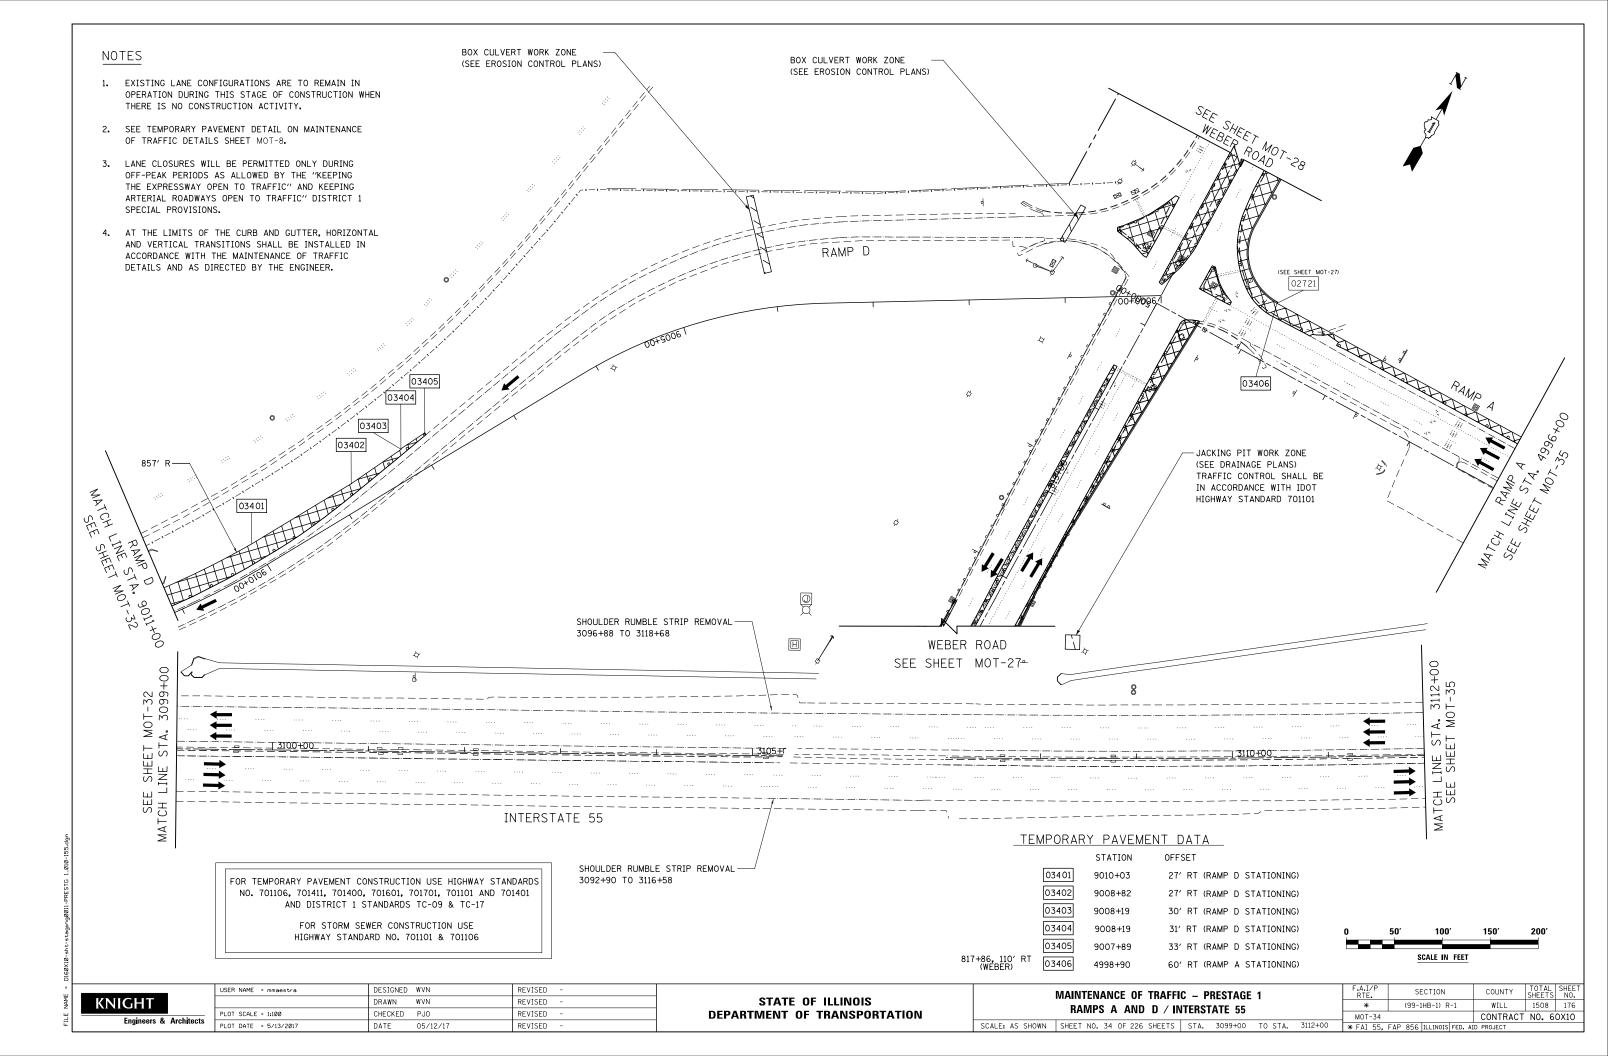

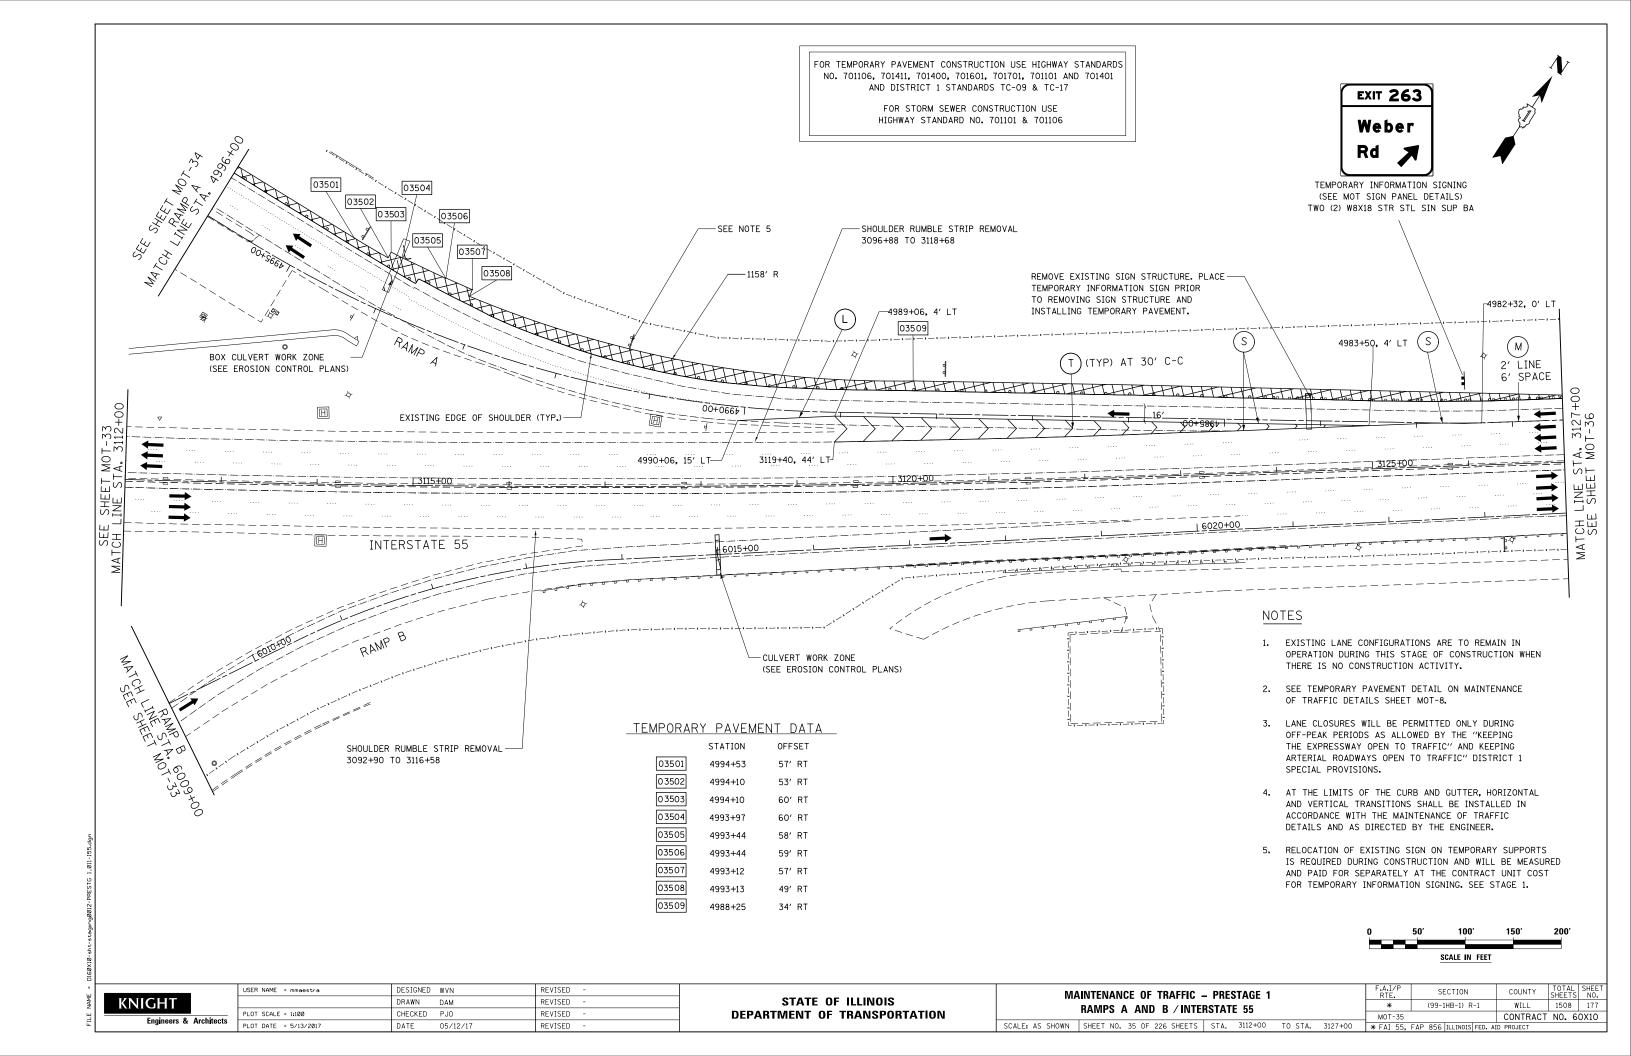

FOR TEMPORARY PAVEMENT CONSTRUCTION USE HIGHWAY STANDARDS NO. 701106, 701411, 701400, 701601, 701701, 701101 AND 701401 AND DISTRICT 1 STANDARDS TC-09 & TC-17

> FOR STORM SEWER CONSTRUCTION USE HIGHWAY STANDARD NO. 701101 & 701106



EXIT 263 Weber Rd RIGHT LANE

TEMPORARY INFORMATION SIGNING (SEE MOT SIGN PANEL DETAILS)

EXIT ONLY



INTERSTATE 55

-EXISTING EDGE OF SHOULDER (TYP.)

NOTES

- 1. EXISTING LANE CONFIGURATIONS ARE TO REMAIN IN OPERATION DURING THIS STAGE OF CONSTRUCTION WHEN THERE IS NO CONSTRUCTION ACTIVITY.
- 2. SEE TEMPORARY PAVEMENT DETAIL ON MAINTENANCE OF TRAFFIC DETAILS SHEET MOT-8.
- 3. LANE CLOSURES WILL BE PERMITTED ONLY DURING OFF-PEAK PERIODS AS ALLOWED BY THE "KEEPING THE EXPRESSWAY OPEN TO TRAFFIC" AND KEEPING ARTERIAL ROADWAYS OPEN TO TRAFFIC" DISTRICT 1 SPECIAL PROVISIONS.
- 4. AT THE LIMITS OF THE CURB AND GUTTER, HORIZONTAL AND VERTICAL TRANSITIONS SHALL BE INSTALLED IN ACCORDANCE WITH THE MAINTENANCE OF TRAFFIC DETAILS AND AS DIRECTED BY THE ENGINEER.

TEMPORARY PAVEMENT DATA

STATION OFFSET

03601

4981+19 4980+22

25' RT

24' RT

SCALE IN FEET

COUNTY

WILL

1508 178




MOT-35 A. 3127+00

SHEET MO

USER NAME = mmaestra	DESIGNED	WVN	REVISED -
	DRAWN	WVN	REVISED -
PLOT SCALE = 1:100	CHECKED	PJ0	REVISED -
PLOT DATE = 5/13/2017	DATE	05/12/17	REVISED -
•			

FOR TEMPORARY PAVEMENT CONSTRUCTION USE HIGHWAY STANDARDS NO. 701106, 701502, 701601, 701901, 701701 & 701101

> FOR STORM SEWER CONSTRUCTION USE HIGHWAY STANDARD NO. 701101 & 701106

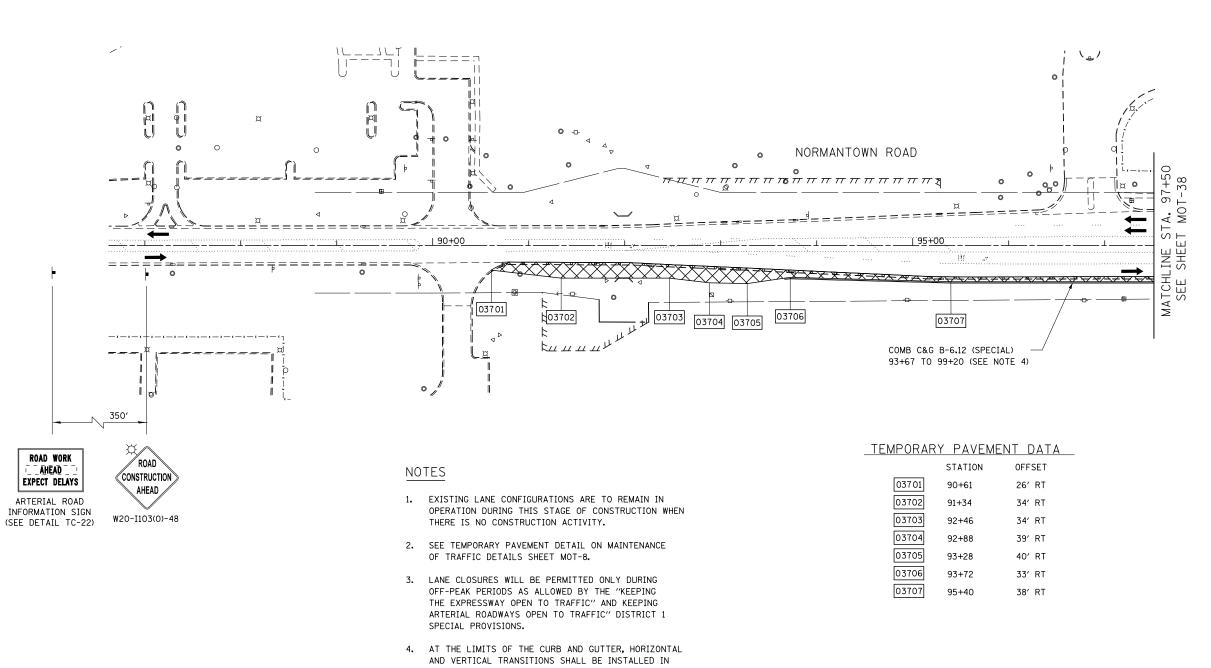



USER NAME = mmaestra	DESIGNED	WVN	REVISED	-
	DRAWN	DAM	REVISED	-
PLOT SCALE = 1:100	CHECKED	PJ0	REVISED	-
PLOT DATE = 5/13/2017	DATE	05/12/17	REVISED	-

STATE OF ILLINOIS **DEPARTMENT OF TRANSPORTATION**

SCALE: AS SHOWN


ACCORDANCE WITH THE MAINTENANCE OF TRAFFIC DETAILS AND AS DIRECTED BY THE ENGINEER.

ľ	MAINTENANCE OF TRAFFIC - PRESTAGE 1							F.A.I/P RTE.	SECTION	COUNTY	TOTAL SHEETS	SHEET NO.		
	NORMANTOWN ROAD						*	(99-1HB-1) R-1	WILL	1508	179			
			OIIIV	IAIN	104414	IIUAD				MOT-37	•	CONTRACT	NO. 6	0X10
٧N	SHEET N	10. 3	7 OF	226	SHEETS	STA.	86+50	TO STA.	97+50	* FAI 55.	FAP 856 ILLINOIS FED, AI	D PROJECT		

SCALE IN FEET

FOR TEMPORARY PAVEMENT CONSTRUCTION USE HIGHWAY STANDARDS NO. 701106, 701502, 701601, 701901, 701701 & 701101

> FOR STORM SEWER CONSTRUCTION USE HIGHWAY STANDARD NO. 701101 & 701106

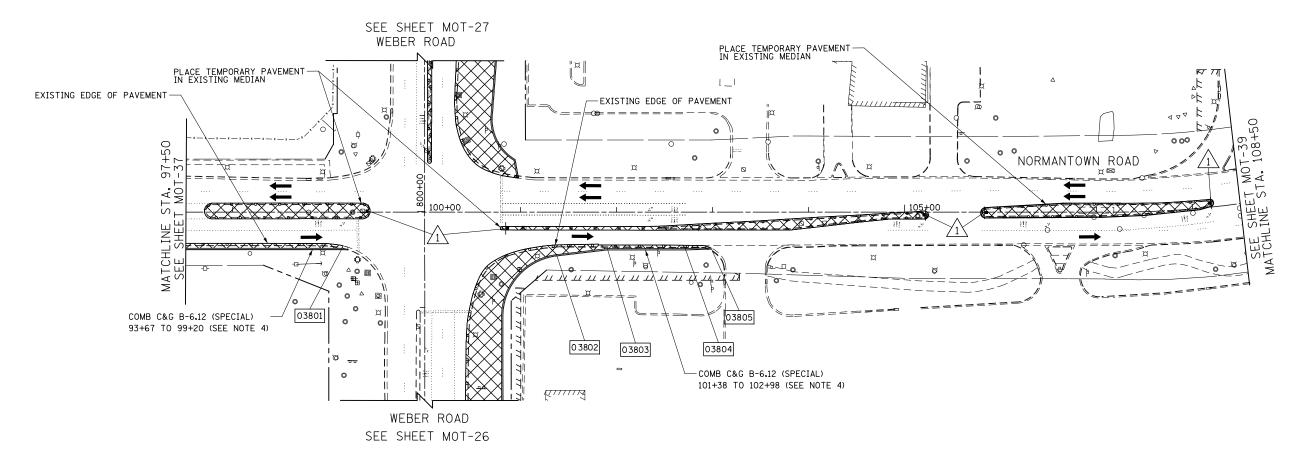

TEMPORARY PAVEMENT DATA


	STATION	OFFSET
03801	99+14	38′ RT
03802	101+37	44′ RT
03803	101+90	38′ RT
03804	102+71	38′ RT
03805	102+98	37′ RT

SIGN LEGEND



NOTES

- 1. EXISTING LANE CONFIGURATIONS ARE TO REMAIN IN OPERATION DURING THIS STAGE OF CONSTRUCTION WHEN THERE IS NO CONSTRUCTION ACTIVITY.
- 2. SEE TEMPORARY PAVEMENT DETAIL ON MAINTENANCE OF TRAFFIC DETAILS SHEET MOT-8.
- 3. LANE CLOSURES WILL BE PERMITTED ONLY DURING OFF-PEAK PERIODS AS ALLOWED BY THE "KEEPING THE EXPRESSWAY OPEN TO TRAFFIC" AND KEEPING ARTERIAL ROADWAYS OPEN TO TRAFFIC" DISTRICT 1 SPECIAL PROVISIONS.
- 4. AT THE LIMITS OF THE CURB AND GUTTER, HORIZONTAL AND VERTICAL TRANSITIONS SHALL BE INSTALLED IN ACCORDANCE WITH THE MAINTENANCE OF TRAFFIC DETAILS AND AS DIRECTED BY THE ENGINEER.

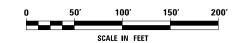





	USER NAME = mmaestra	DESIGNED	WVN	REVISED	-
		DRAWN	DAM	REVISED	-
	PLOT SCALE = 1:100	CHECKED	PJ0	REVISED	-
ects	PLOT DATE = 5/13/2017	DATE	05/12/17	REVISED	-

	MAINTENANCE OF TRAFFIC – PRESTAGE 1 NORMANTOWN ROAD							
l								
ļ	NOTIMIANTOWN TOAD							
	SCALE: AS SHOWN	SHEET NO. 38 OF 226 SHEETS	STA.	97+50	TO STA.	108+50	* FAI 55,	

RTE.			SECTION				COUNTY	SHEET	S	NO
* (99-1HB-1) R-1			WILL	1508	3	180				
MOT-	38						CONTRACT	NO.	6	0X10
* FAI	55,	FAP	856	ILLINOIS	FED.	AID	PROJECT			

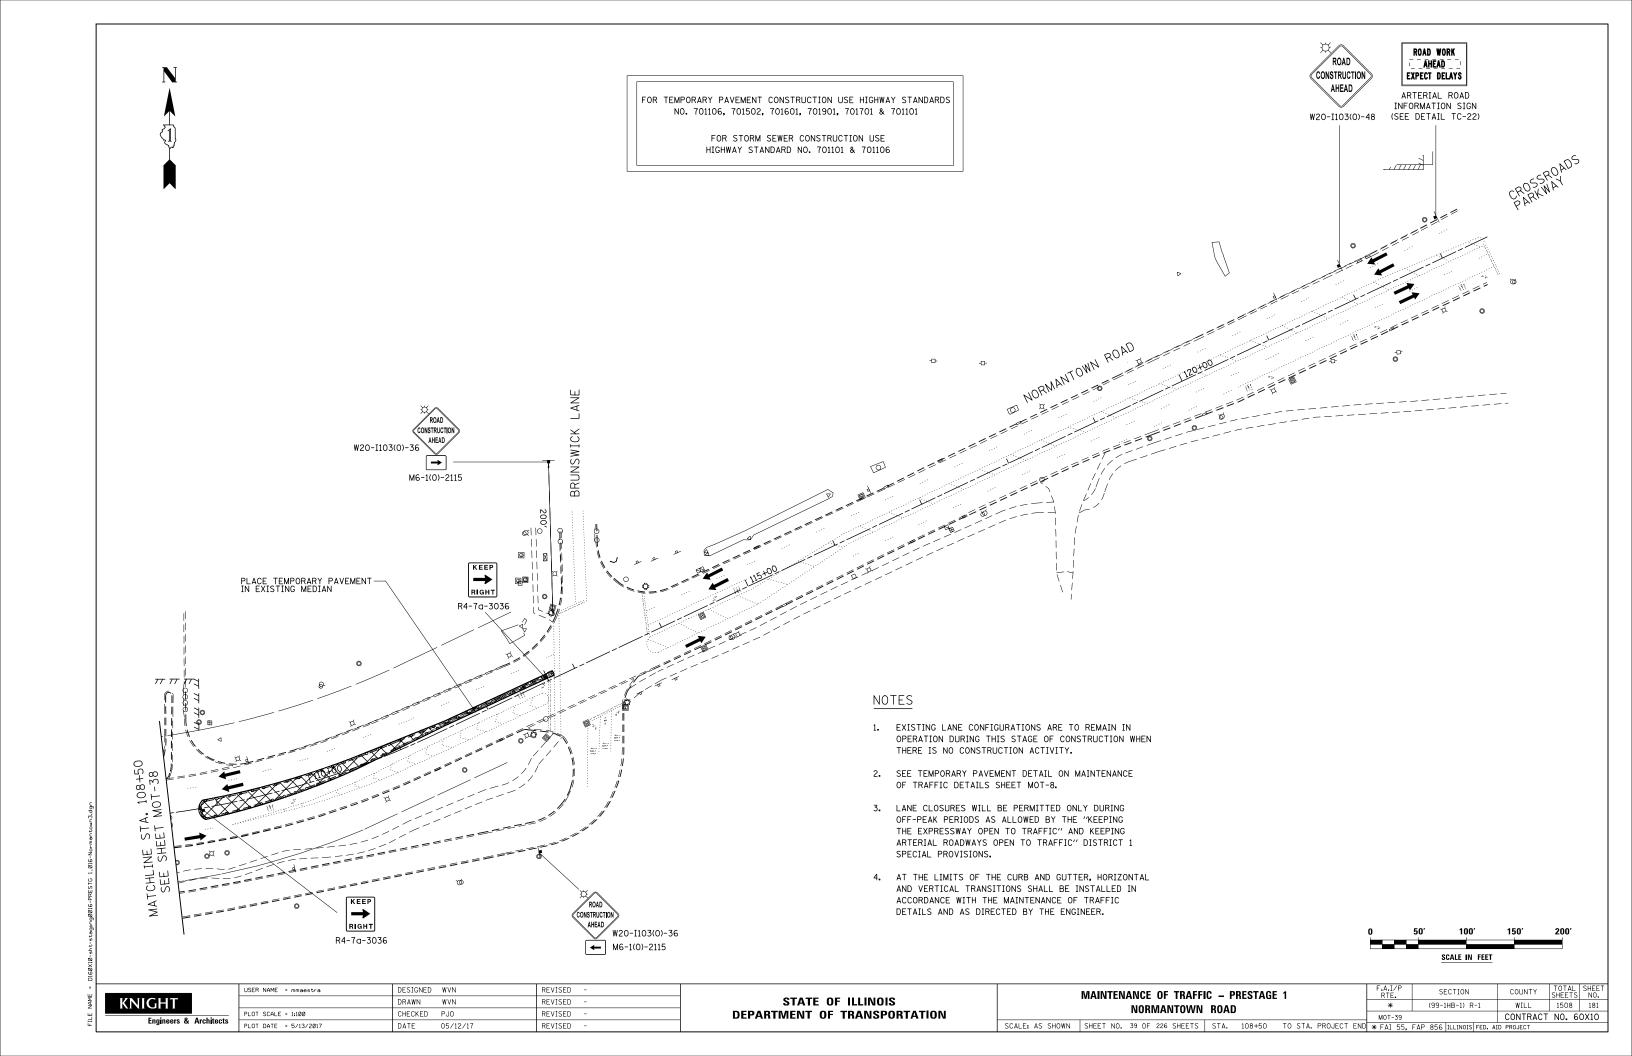

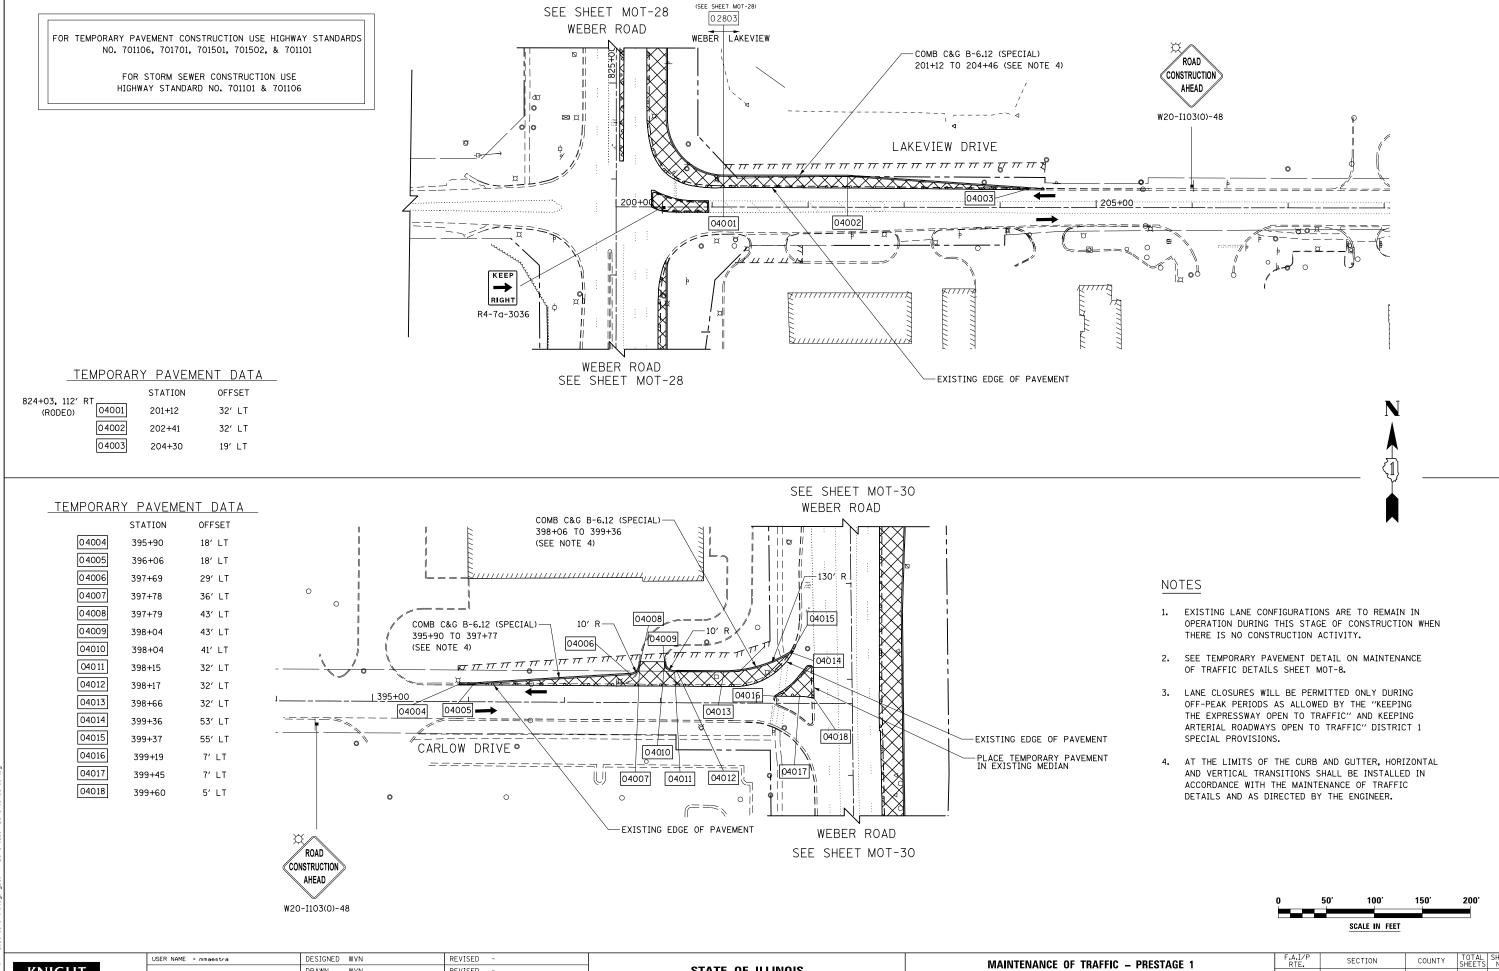

FILE NAME = D160X

Engineers & Architects

	USER NAME = mmaestra	DESIGNED	WVN	REVISED	-
		DRAWN	WVN	REVISED	-
_	PLOT SCALE = 1:100	CHECKED	PJ0	REVISED	-
s	PLOT DATE = 5/13/2017	DATE	05/12/17	REVISED	-

	MAINTENANCE OF TRAFFIC - PRESTAGE 1									
	LAKEVIEW DRIVE AND	CARLOW DRIVE								
SCALE: AS SHOWN	SHEET NO. 40 OF 226 SHEETS	STA. 200+00 TO STA.	400+00							


RTE.			SE	CTION			COUNTY	SHEET		NO.
*		(99-1HB-1) R-1				WILL	1508	3	182	
MOT-	40						CONTRACT	NO.	6	0X10
* FAI	55,	FAP	856	ILLINOIS	FED.	AID	PROJECT			

NOTES

- 1. EXISTING LANE CONFIGURATIONS ARE TO REMAIN IN OPERATION DURING THIS STAGE OF CONSTRUCTION WHEN THERE IS NO CONSTRUCTION ACTIVITY.
- 2. SEE TEMPORARY PAVEMENT DETAIL ON MAINTENANCE OF TRAFFIC DETAILS SHEET MOT-8.
- 3. LANE CLOSURES WILL BE PERMITTED ONLY DURING OFF-PEAK PERIODS AS ALLOWED BY THE "KEEPING THE EXPRESSWAY OPEN TO TRAFFIC" AND KEEPING ARTERIAL ROADWAYS OPEN TO TRAFFIC" DISTRICT 1 SPECIAL PROVISIONS.

FOR TEMPORARY PAVEMENT CONSTRUCTION USE HIGHWAY STANDARDS NO. 701106, 701601, 701701, 701501, & 701101

FOR STORM SEWER CONSTRUCTION USE HIGHWAY STANDARD NO. 701101 & 701106

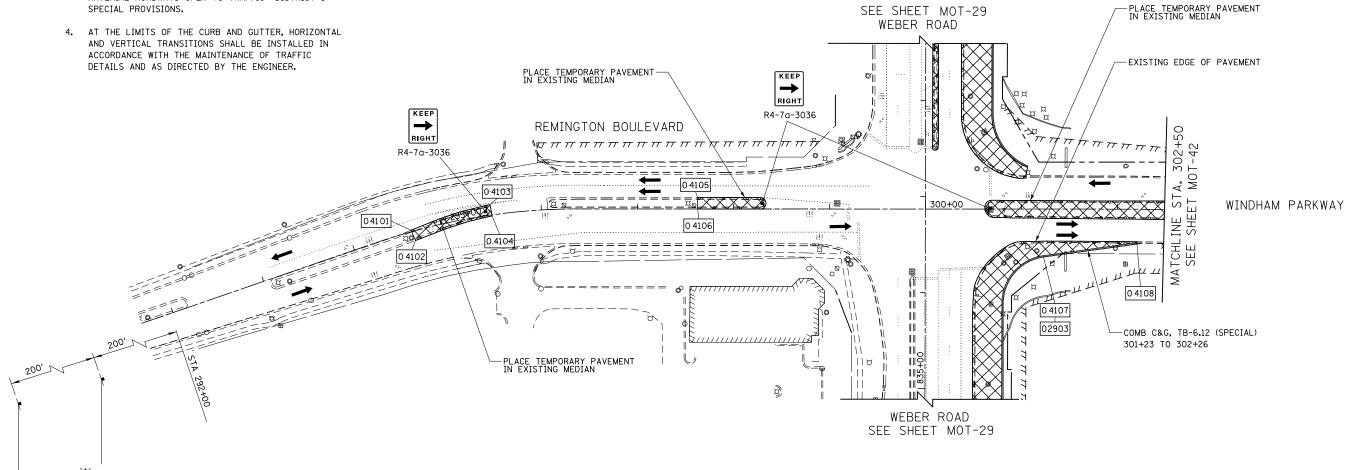

0	50′	100′	150′	200
		SCALE IN FEE	Т	



ROAD WORK

EXPECT DELAYS

ARTERIAL ROAD

INFORMATION SIGN (SEE DETAIL TC-22) ROAD

AHEAD

W20-I103(0)-48

	USER NAME = mmaestra	DESIGNED	WVN	REVISED -
		DRAWN	WVN	REVISED -
_	PLOT SCALE = 1:100	CHECKED	PJ0	REVISED -
ıs	PLOT DATE = 5/13/2017	DATE	05/12/17	REVISED -

0 41 01

0 4102

04103

04104

0 41 05

0 41 06

04107

04108

836+39, 123' RT

(WEBER)

TEMPORARY PAVEMENT DATA

OFFSET

2' LT

10' RT

11' LT

1' RT

12' LT

O' RT

49' RT

35′ RT

STATION

294+63

294+64

295+48

295+48

297+63

297+63

301+23


302+21

STATI	OF ILLINOIS	3
DEPARTMENT	OF TRANSPO	RTATION

		MAINTENANCE OF TRAFF	IC – P	RESTAGE	1		F.A.I/P RTE.	SECTION	COUNTY	TOTAL SHEETS	SHEET NO.
١	REMINGTON BOULEVARD / WINDHAM PARKWAY			*	(99-1HB-1) R-1	WILL	1508	183			
ILIVINGTON DOCEVAND / WINDHAW TANKWAT			MOT-41		CONTRACT	NO. 6	0X10				
١	SCALE: AS SHOWN	SHEET NO. 41 OF 226 SHEETS	STA.	292+50	TO STA.	302+50	* FAI 55.	FAP 856 ILLINOIS FED. A	ID PROJECT		

FOR TEMPORARY PAVEMENT CONSTRUCTION USE HIGHWAY STANDARDS NO. 701106, 701601, 701701, 701501, & 701101

FOR STORM SEWER CONSTRUCTION USE HIGHWAY STANDARD NO. 701101 & 701106

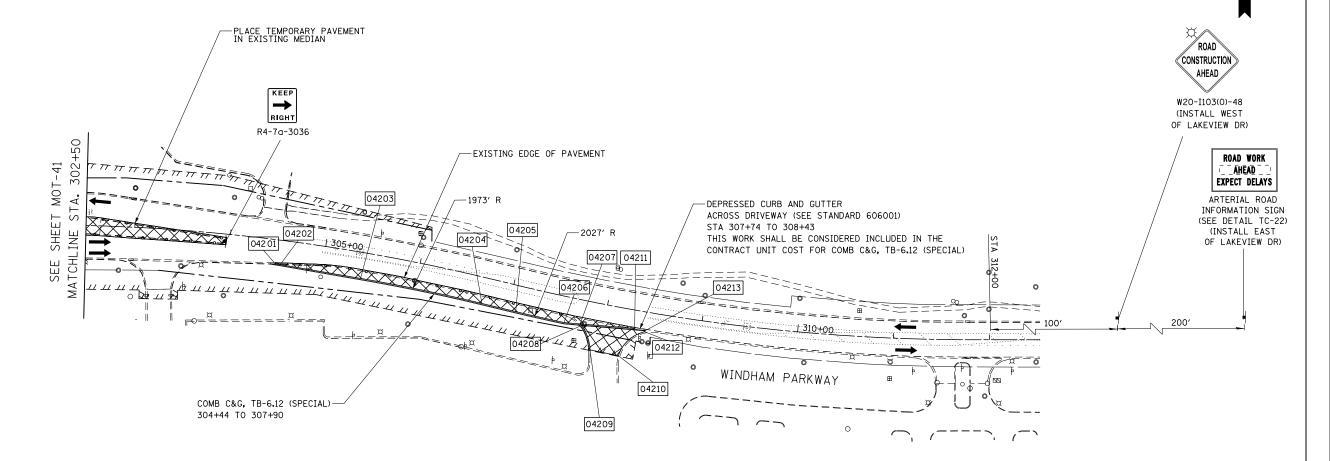


NOTES

- 1. EXISTING LANE CONFIGURATIONS ARE TO REMAIN IN OPERATION DURING THIS STAGE OF CONSTRUCTION WHEN THERE IS NO CONSTRUCTION ACTIVITY.
- 2. SEE TEMPORARY PAVEMENT DETAIL ON MAINTENANCE OF TRAFFIC DETAILS SHEET MOT-8.
- 3. LANE CLOSURES WILL BE PERMITTED ONLY DURING OFF-PEAK PERIODS AS ALLOWED BY THE "KEEPING THE EXPRESSWAY OPEN TO TRAFFIC" AND KEEPING ARTERIAL ROADWAYS OPEN TO TRAFFIC" DISTRICT 1 SPECIAL PROVISIONS.
- 4. AT THE LIMITS OF THE CURB AND GUTTER, HORIZONTAL AND VERTICAL TRANSITIONS SHALL BE INSTALLED IN ACCORDANCE WITH THE MAINTENANCE OF TRAFFIC DETAILS AND AS DIRECTED BY THE ENGINEER.

TEMPORARY PAVEMENT DATA

 1 011/11/1	1 / 1 / [[]]		<i>,</i> , , , , , ,
	STATION	OFF	SET
04201	304+50	25′	RT
04202	304+55	25′	RT
04203	305+41	27′	RT
04204	306+72	27′	RT
04205	307+08	27′	RT
04206	307+59	27′	RT
04207	307+76	25′	RT
04208	307+78	26′	RT
04209	307+91	49′	RT
04210	308+21	50′	RT
04211	308+32	19′	RT
04212	308+43	21′	RT
0 4213	308+43	20′	RT

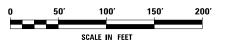





USER NAME = mmaestra	DESIGNED	WVN	REVISED	-
	DRAWN	WVN	REVISED	-
PLOT SCALE = 1:100	CHECKED	PJ0	REVISED	-
PLOT DATE = 5/13/2017	DATE	05/12/17	REVISED	-

MAINTENANCE OF TRAFFIC - PRESTAGE 1						
	REMINGTON BOULEVAR	D / WINDHAM	PARKWAY			
SCALE: AS SHOWN	SHEET NO. 42 OF 226 SHEETS	STA. 302+50	TO STA. 312+			

F.A.I/P RTE.		SECTION			COUNTY	TOTAL SHEETS	SHEE NO.
*	(99	9-1HB-1) R	-1		WILL	1508	184
M0T-42					CONTRACT	NO. 6	0X10
* FAT 55.	FAP 85	6 ILLINOIS	FED.	AID	PROJECT		

FOR STORM SEWER CONSTRUCTION USE HIGHWAY STANDARD NO. 701101 & 701106

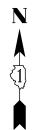

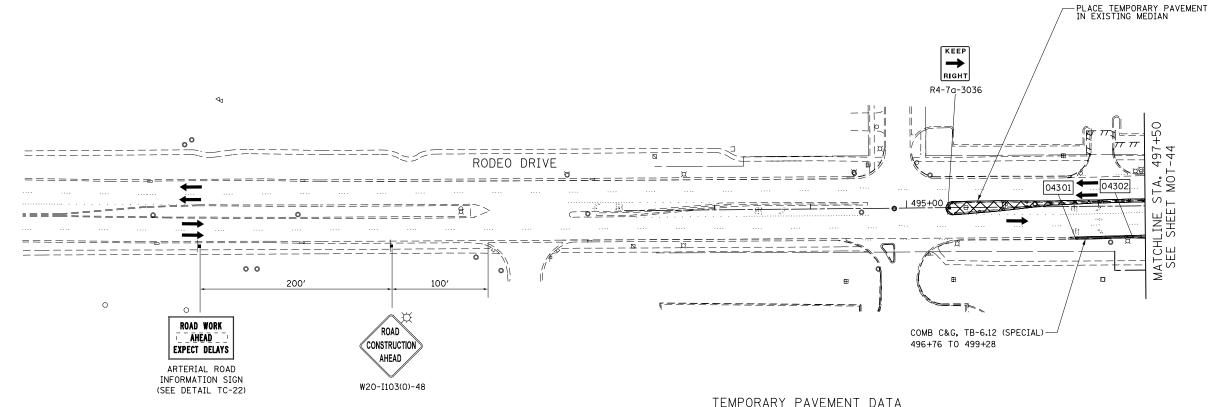

NOTES

- EXISTING LANE CONFIGURATIONS ARE TO REMAIN IN OPERATION DURING THIS STAGE OF CONSTRUCTION WHEN THERE IS NO CONSTRUCTION ACTIVITY.
- SEE TEMPORARY PAVEMENT DETAIL ON MAINTENANCE OF TRAFFIC DETAILS SHEET MOT-8.
- 3. LANE CLOSURES WILL BE PERMITTED ONLY DURING OFF-PEAK PERIODS AS ALLOWED BY THE "KEEPING THE EXPRESSWAY OPEN TO TRAFFIC" AND KEEPING ARTERIAL ROADWAYS OPEN TO TRAFFIC" DISTRICT 1 SPECIAL PROVISIONS.
- 4. AT THE LIMITS OF THE CURB AND GUTTER, HORIZONTAL AND VERTICAL TRANSITIONS SHALL BE INSTALLED IN ACCORDANCE WITH THE MAINTENANCE OF TRAFFIC DETAILS AND AS DIRECTED BY THE ENGINEER.

ILMITURARI	PAVEIME	<u>vi data</u>	

STATION OFFSET 496+76 33' RT

 04301
 496+76
 33' RT

 04302
 497+35
 32' RT

0	50′	50' 100'		200′		
SCALE IN FEET						




USER NAME = mmaestra	DESIGNED	WVN	REVISED -
	DRAWN	DAM	REVISED -
PLOT SCALE = 1:100	CHECKED	PJ0	REVISED -
PLOT DATE = 5/13/2017	DATE	05/12/17	REVISED -


MAINTENANCE OF TRAFFIC - PRESTAGE 1	F.A.I/P RTE.	SECTION	COUNTY	TOTAL SHEETS	SHEE'
RODEO DRIVE / REMINGTON BOULEVARD	*	(99-1HB-1) R-1	WILL	1508	185
HODEO DINVE / HEIMINGTON DOCESAND	MOT-43		CONTRACT	NO. 6	0X10
SCALE: AS SHOWN SHEET NO. 43 OF 226 SHEETS STA. 492+00 TO STA. 497+50	* FAI 55.	FAP 856 ILLINOIS FED. AI	D PROJECT		

FOR TEMPORARY PAVEMENT CONSTRUCTION USE HIGHWAY STANDARDS NO. 701106, 701601, 701701, 701501, 701206, 701201, & 701101

> FOR STORM SEWER CONSTRUCTION USE HIGHWAY STANDARD NO. 701101 & 701106

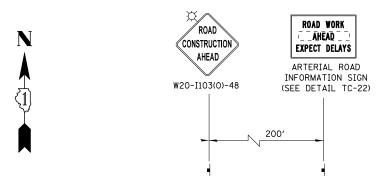

ADVANCE SIGNING FOR WESTBOUND REMINGTON BLVD

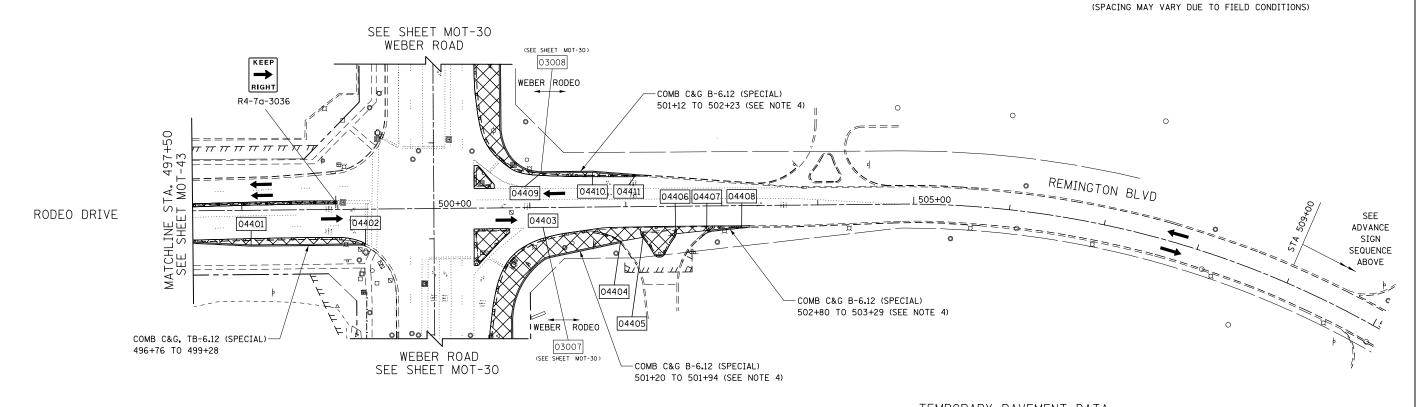

NOTES

- 1. EXISTING LANE CONFIGURATIONS ARE TO REMAIN IN OPERATION DURING THIS STAGE OF CONSTRUCTION WHEN THERE IS NO CONSTRUCTION ACTIVITY.
- 2. SEE TEMPORARY PAVEMENT DETAIL ON MAINTENANCE OF TRAFFIC DETAILS SHEET MOT-8.
- 3. LANE CLOSURES WILL BE PERMITTED ONLY DURING OFF-PEAK PERIODS AS ALLOWED BY THE "KEEPING THE EXPRESSWAY OPEN TO TRAFFIC" AND KEEPING ARTERIAL ROADWAYS OPEN TO TRAFFIC" DISTRICT 1 SPECIAL PROVISIONS.
- 4. AT THE LIMITS OF THE CURB AND GUTTER, HORIZONTAL AND VERTICAL TRANSITIONS SHALL BE INSTALLED IN ACCORDANCE WITH THE MAINTENANCE OF TRAFFIC DETAILS AND AS DIRECTED BY THE ENGINEER.

<u> TEMPURARY</u>	<u> PAVEMENI</u>	<u>DATA</u>
	STATION O	FFSFT
\$	STATION O	FFSET

		STATION	OFFSET
	04401	498+09	36′ RT
0EC 01 100/ DT	04402	499+28	36′ RT
856+81, 120' RT (WEBER)	04403	501+20	51′ RT
	04404	501+94	36′ RT
	04405	502+17	32′ RT
	04406	502+52	29' RT
	04407	502+84	26′ RT
057 - 74 - 05/ DT	04408	503+21	22′ RT
857+71, 95' RT (WEBER)	04409	500+95	40' LT
	04410	501+65	36′ LT
	04411	502+10	32′ LT


0	50′	100′	150′	200′	





USER NAME = mmaestra	DESIGNED	WVN	REVISED -
	DRAWN	DAM	REVISED -
PLOT SCALE = 1:100	CHECKED	PJ0	REVISED -
PLOT DATE = 5/13/2017	DATE	05/12/17	REVISED -


MAINTENANCE OF TRAFFIC - PRESTAGE 1							
RODEO DRIVE / REMINGTON BOULEVARD							
	4						
SCALE: AS SHOWN SHEET NO. 44 OF 226 SHEETS STA. 497+50 TO STA. 508+50	*						


RTE						COUNTY	SHEETS	NO.	
*		(99-1HB-1) R-1				WILL	1508	186	
MOT-	-44						CONTRACT	NO. 6	0X10
* FAI	55,	FAP	856	ILLINOIS	FED.	AID	PROJECT		

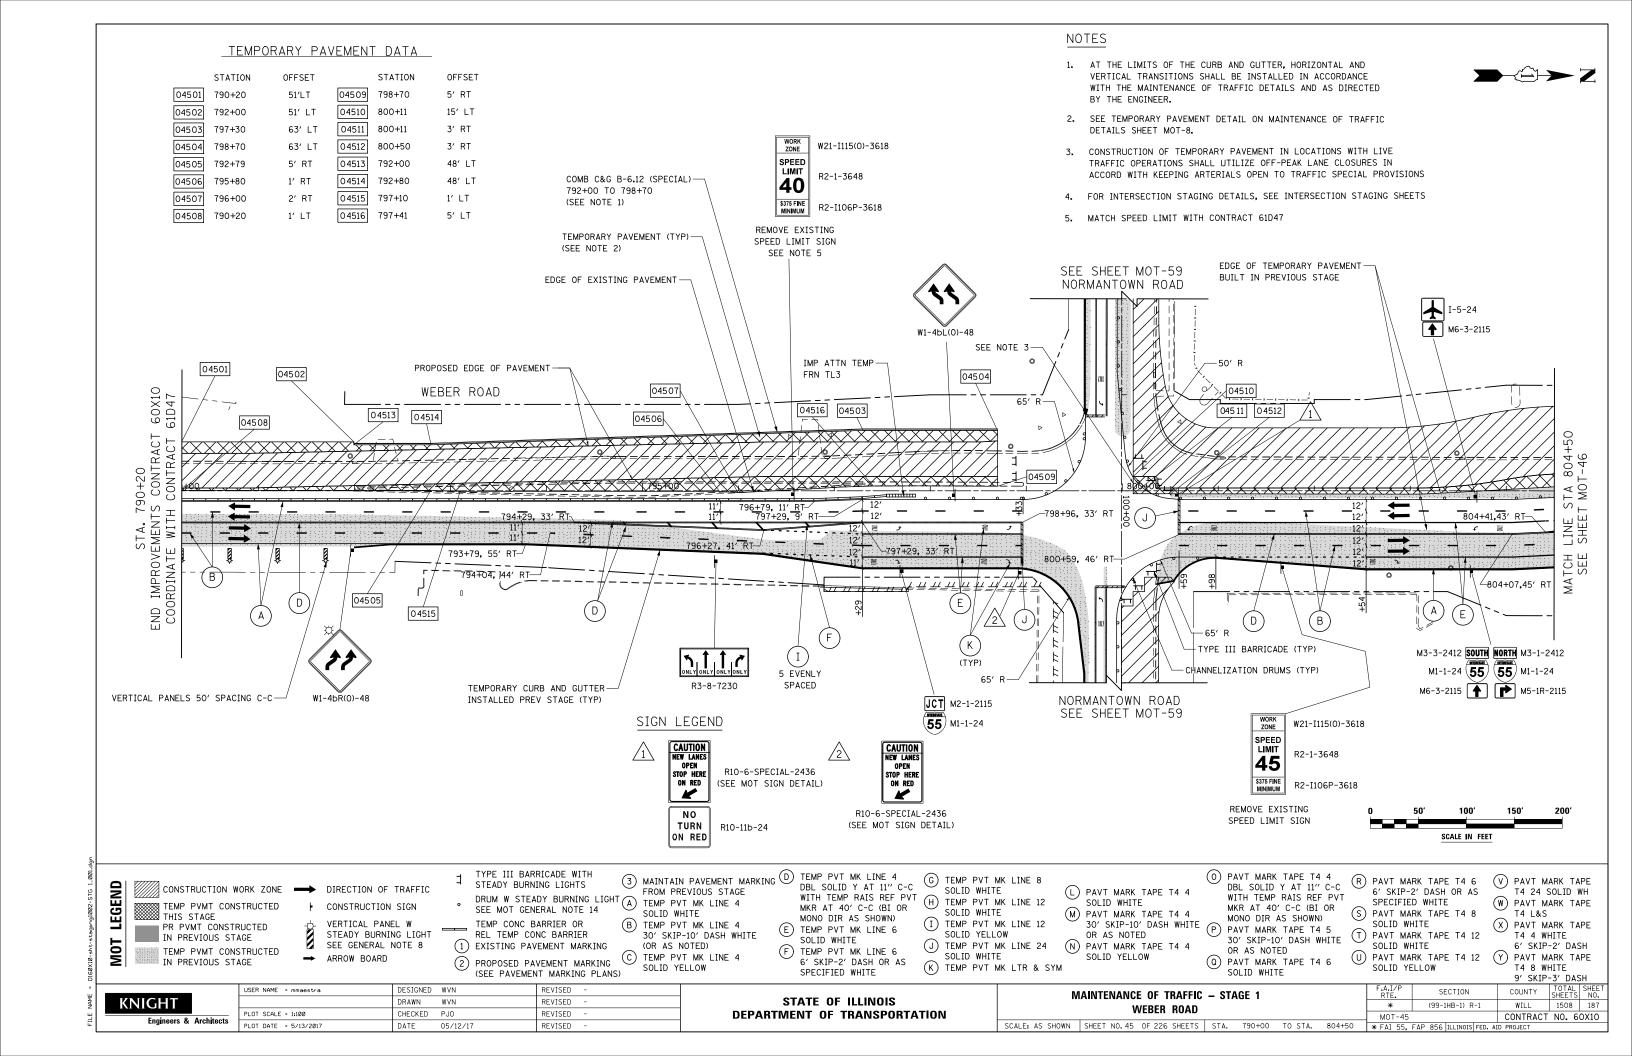


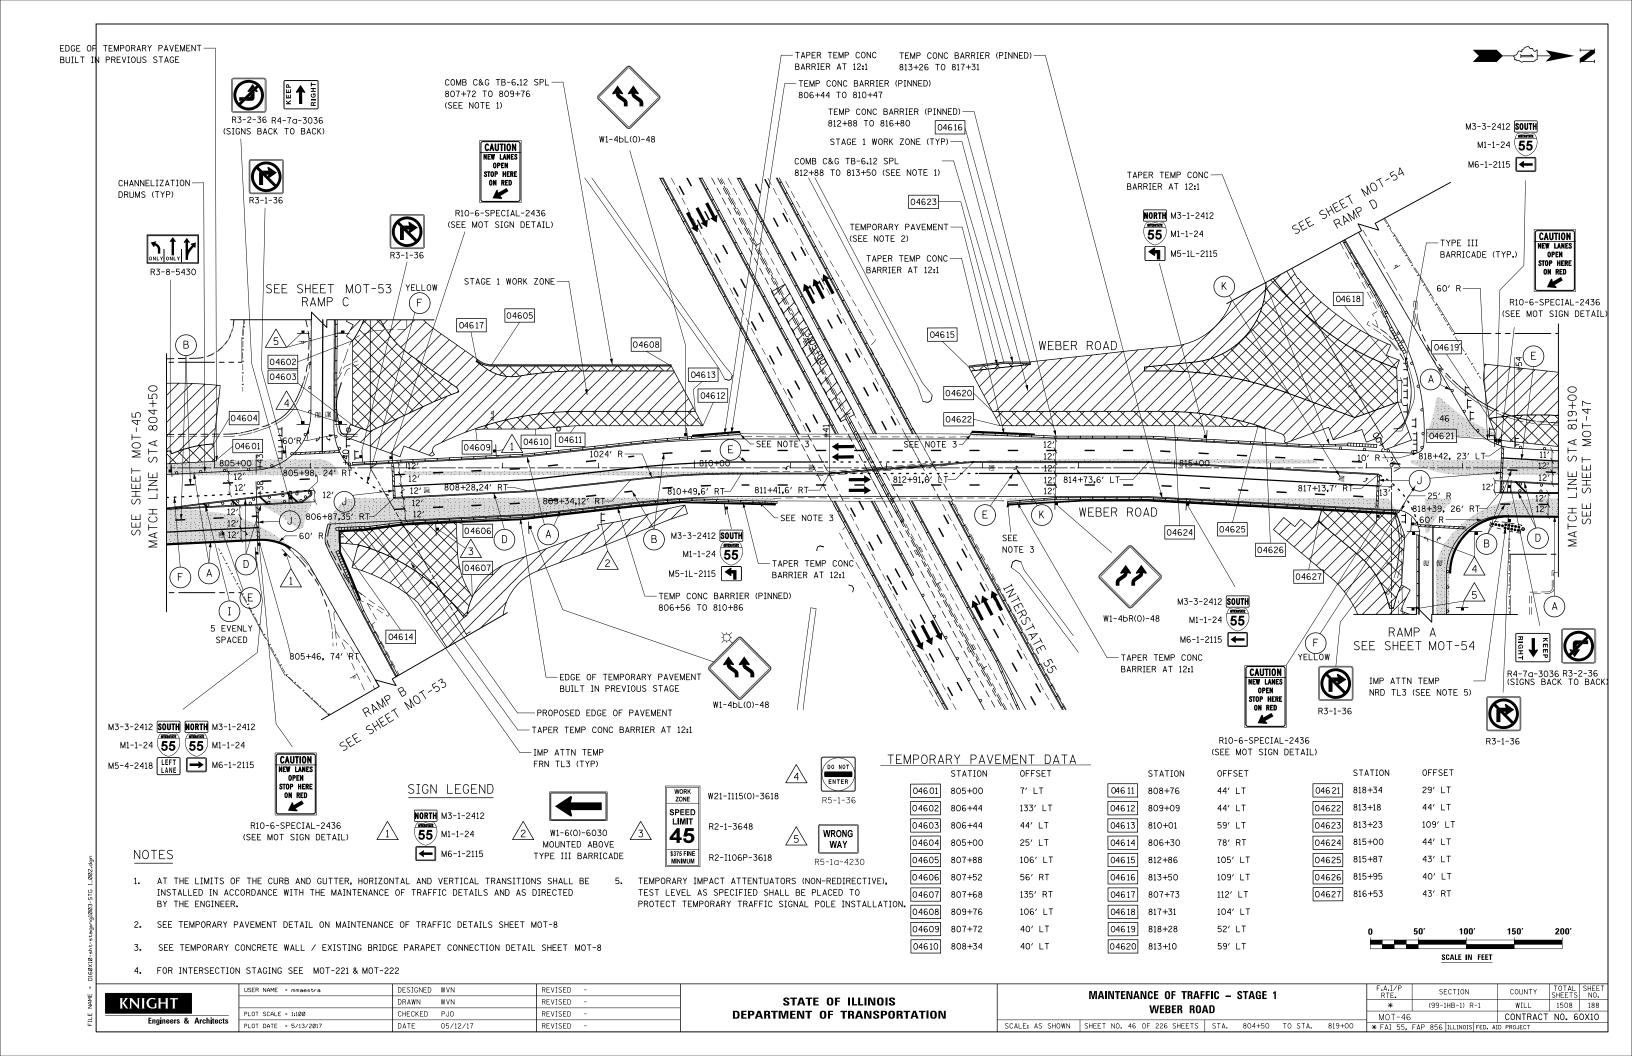


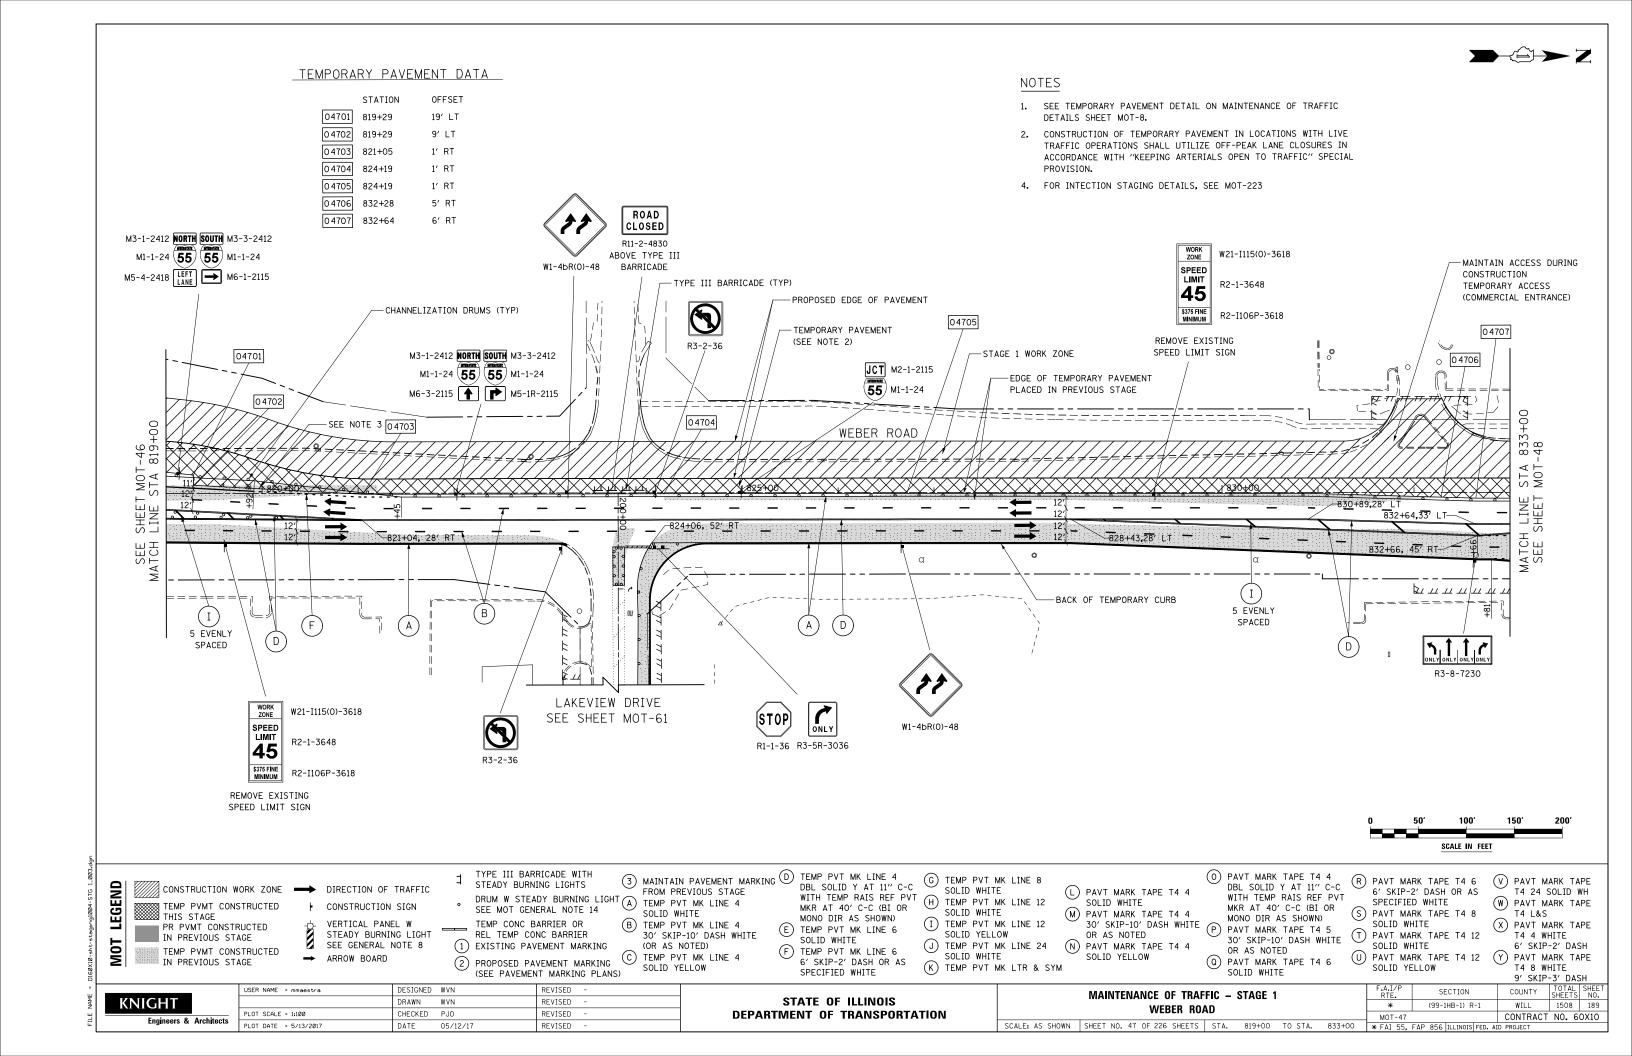


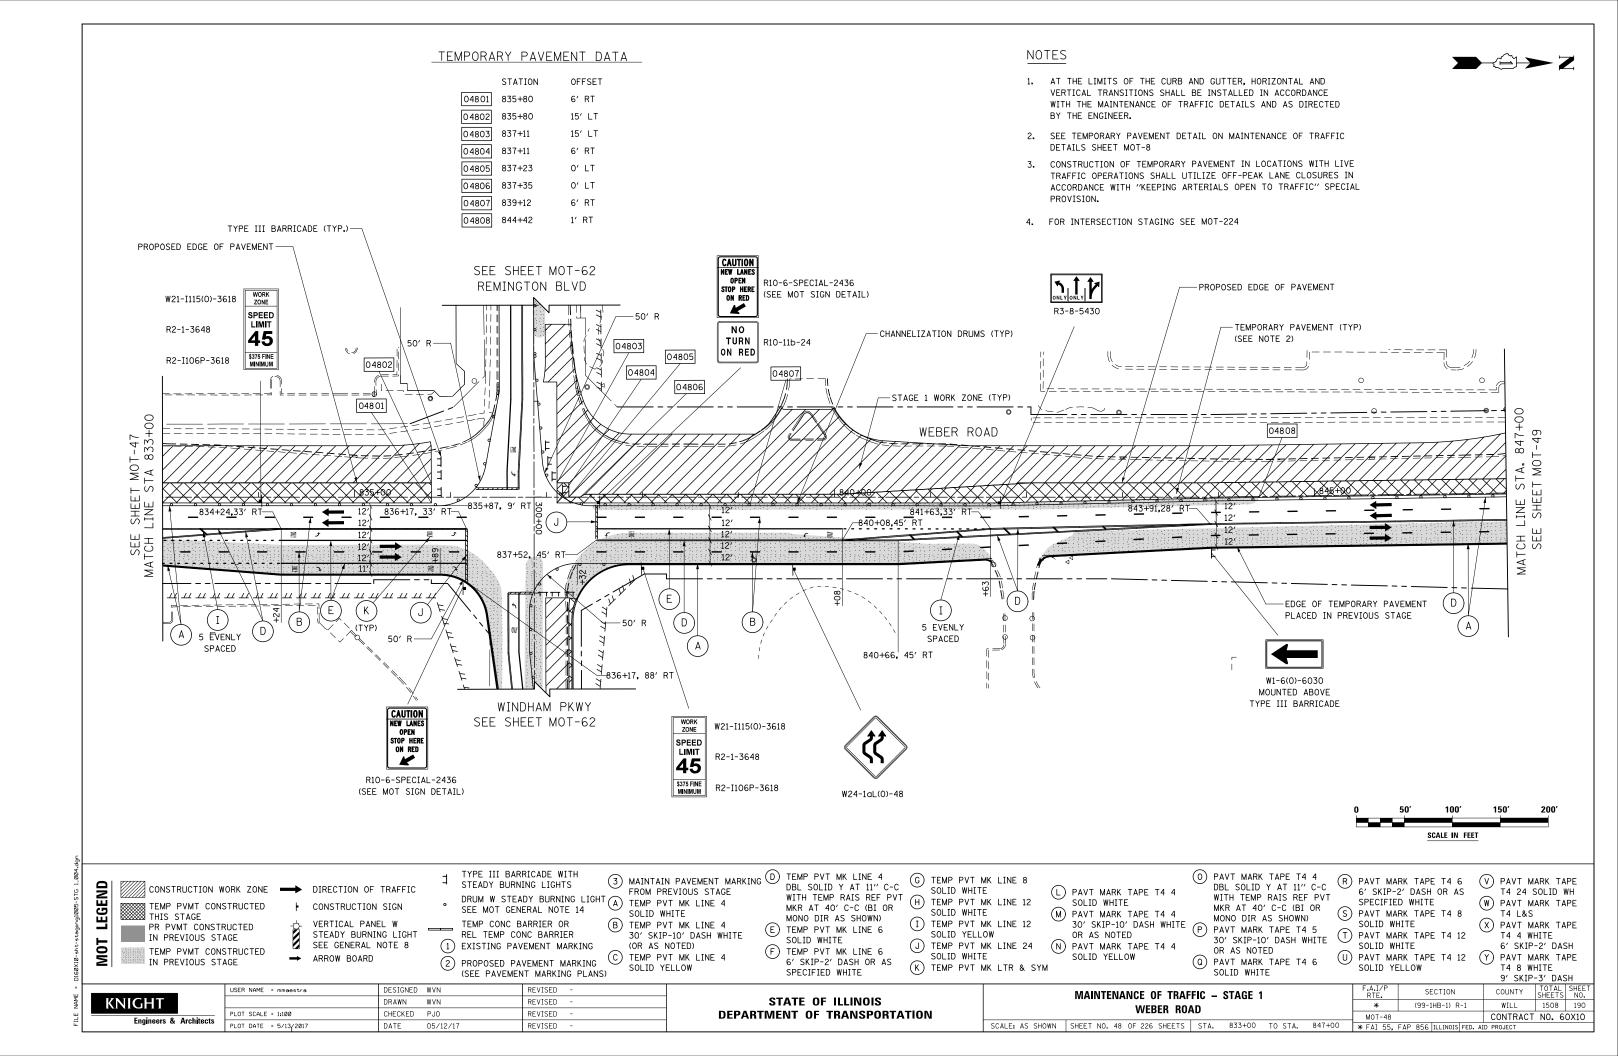


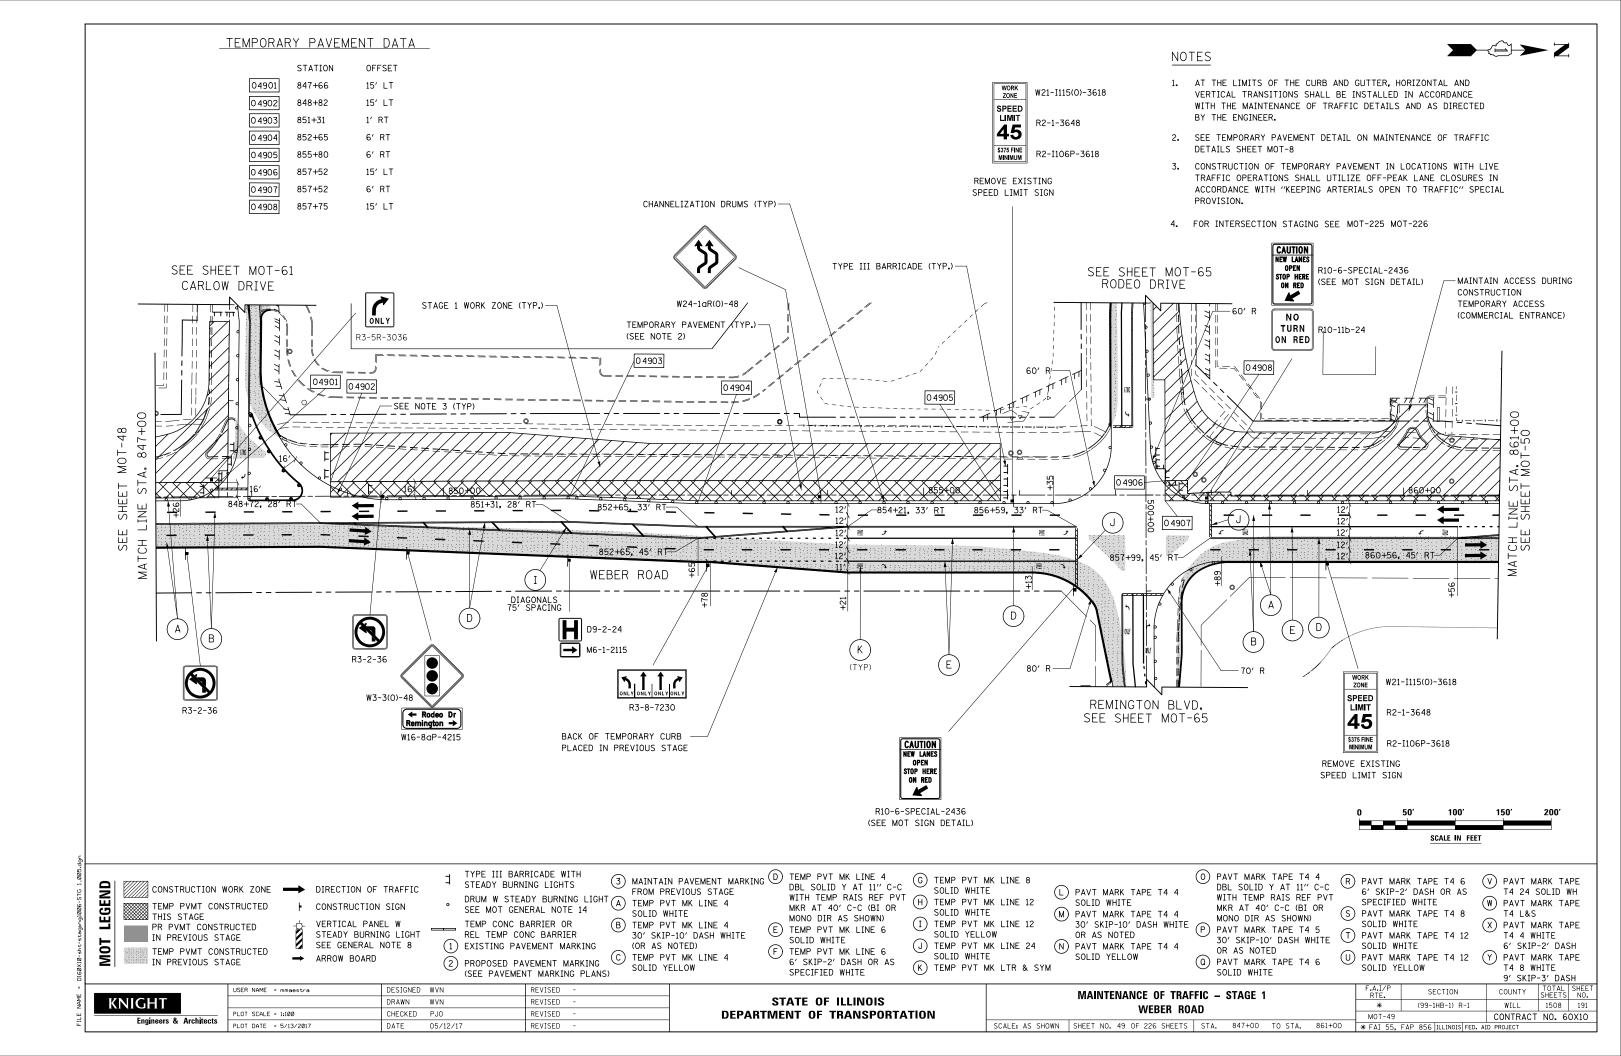


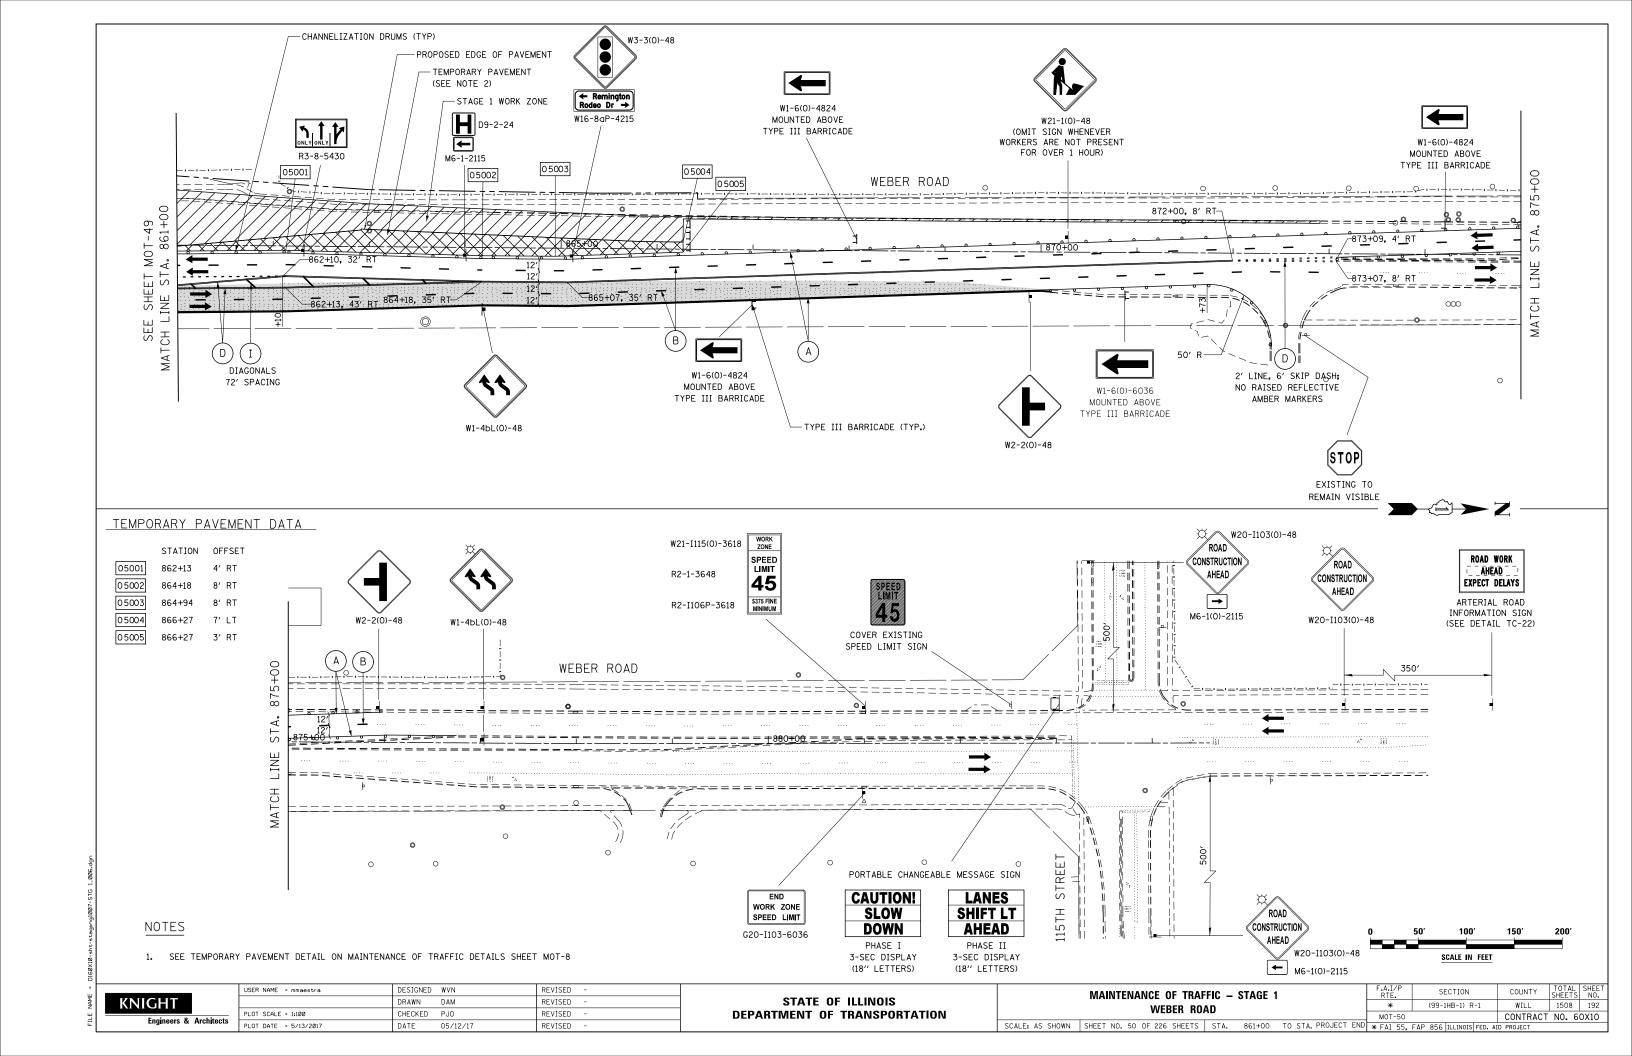


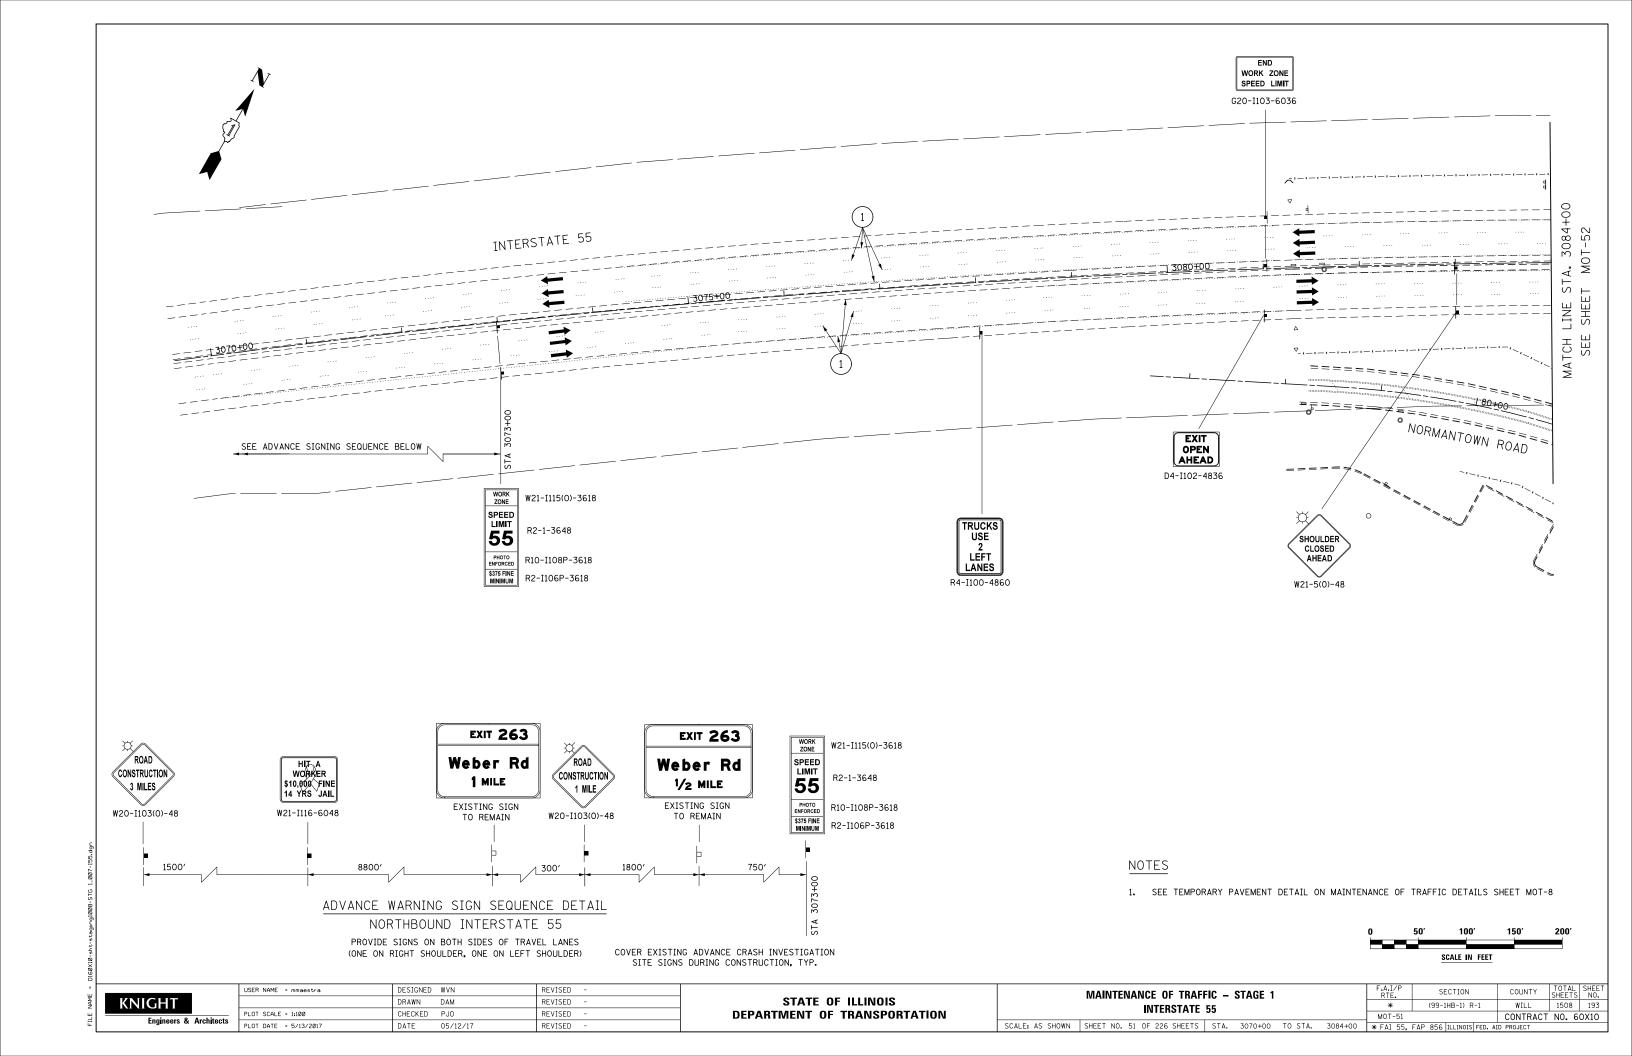


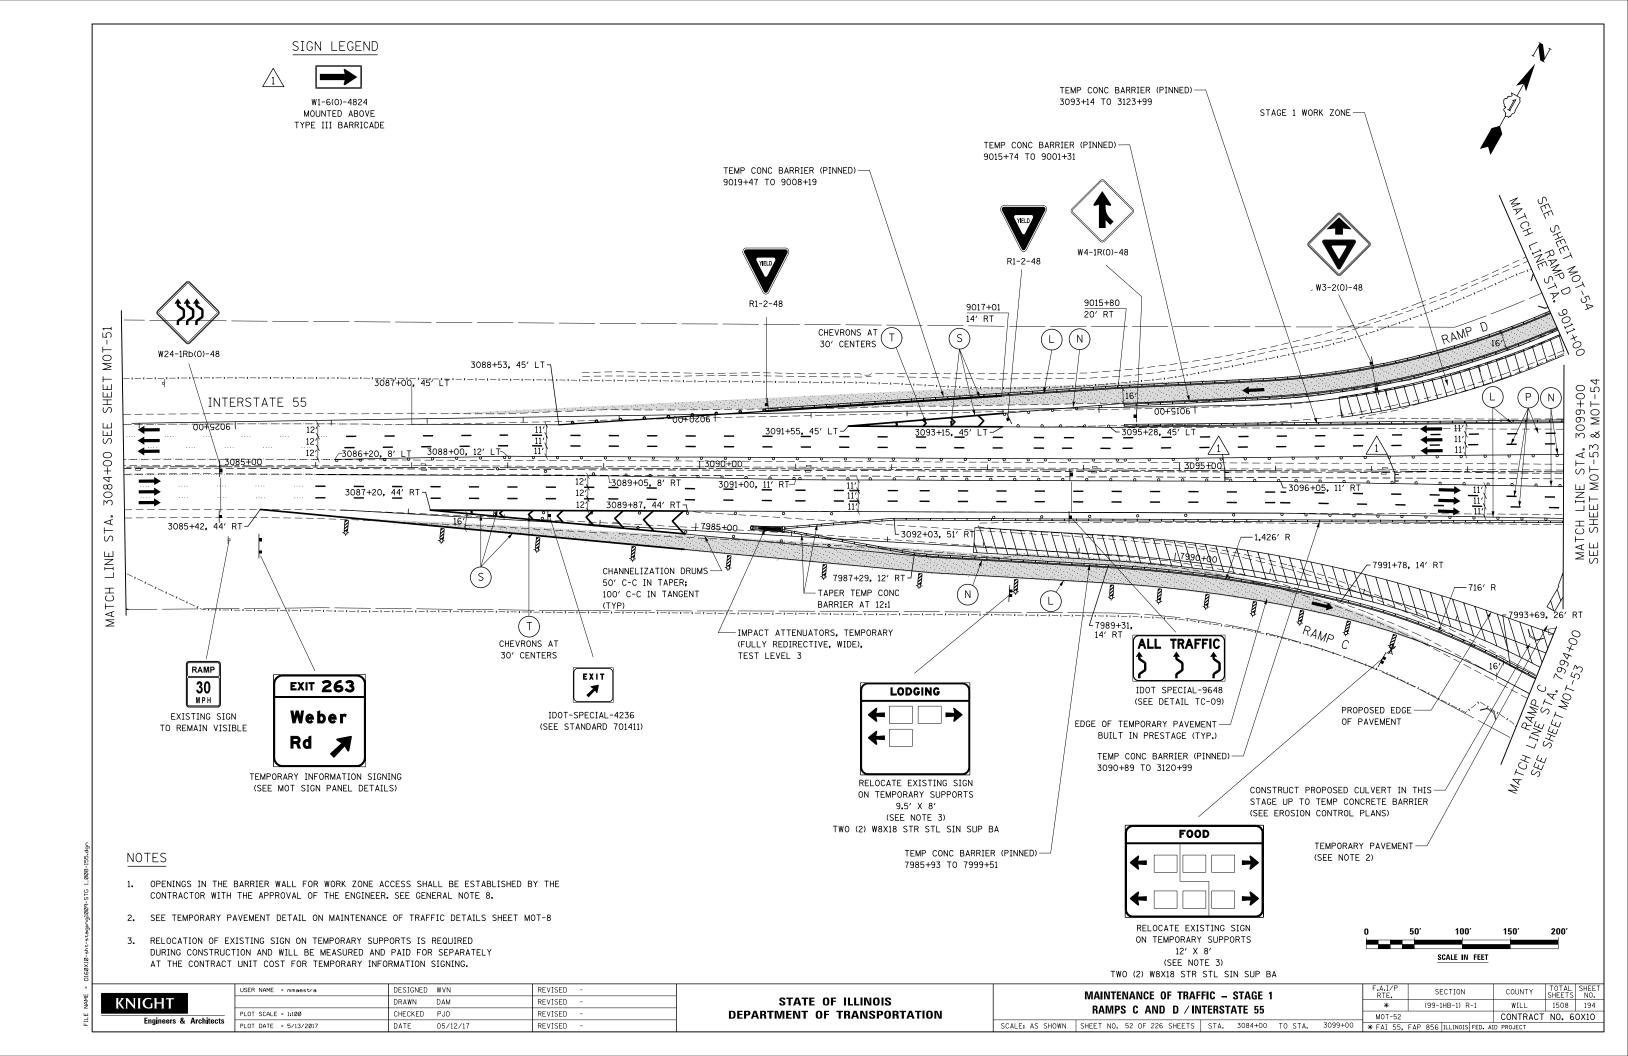


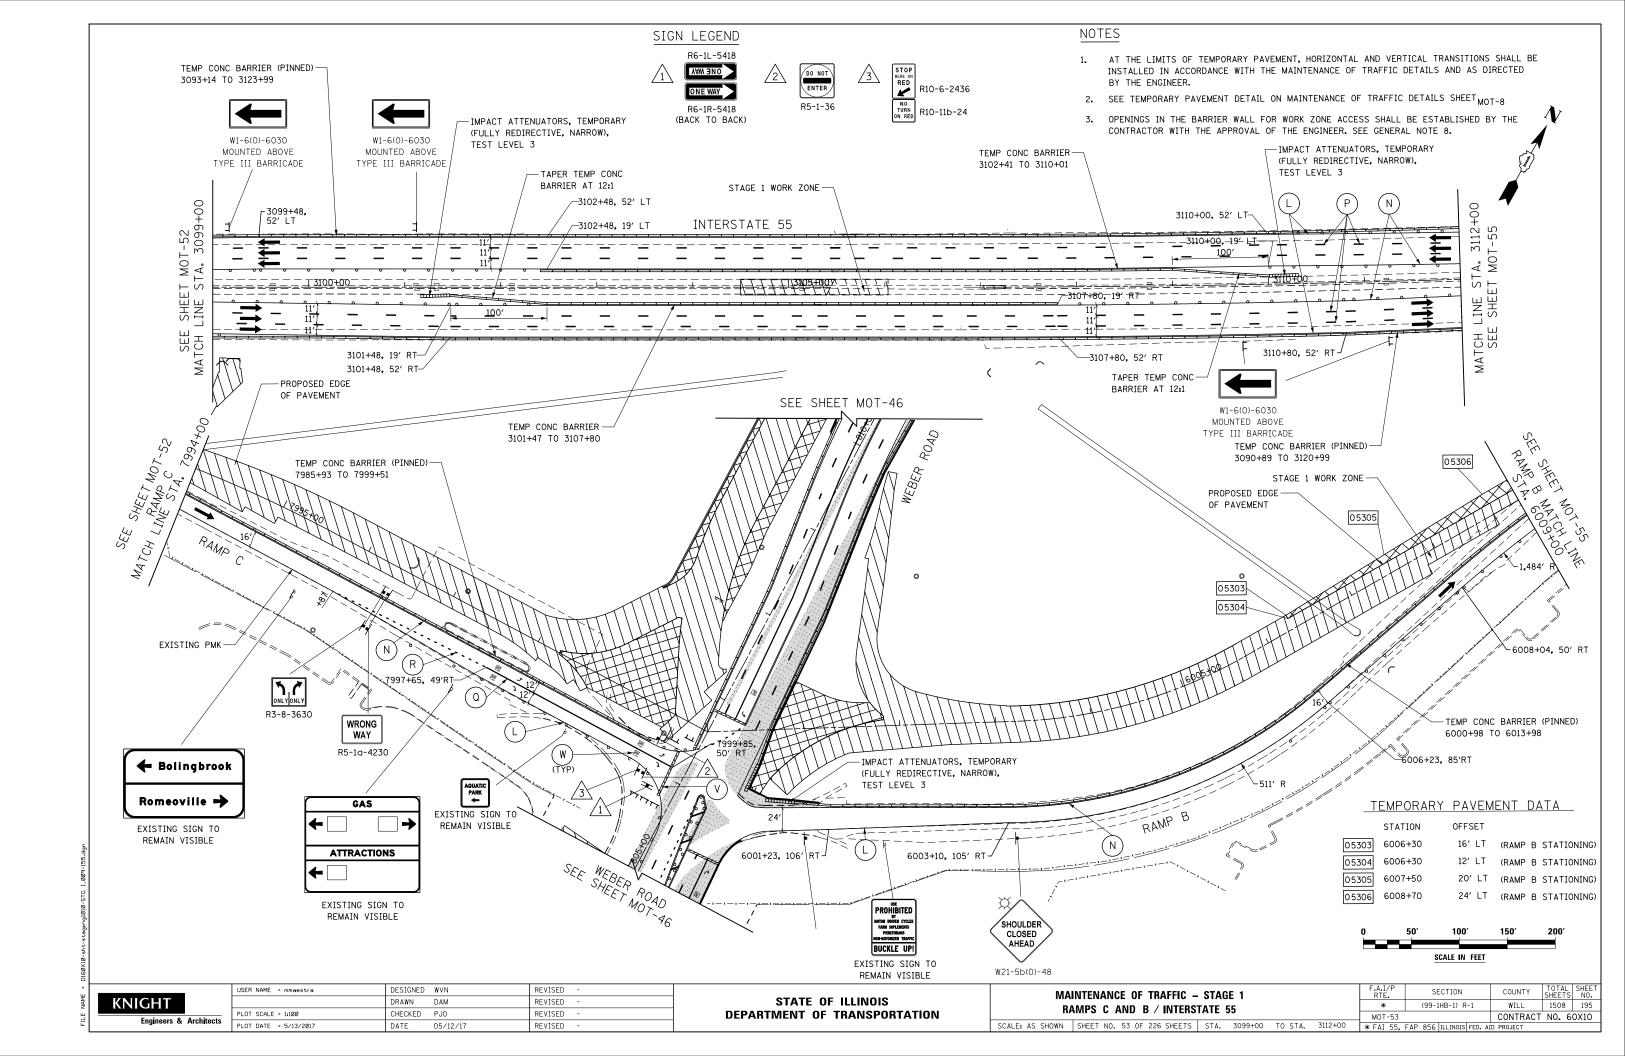

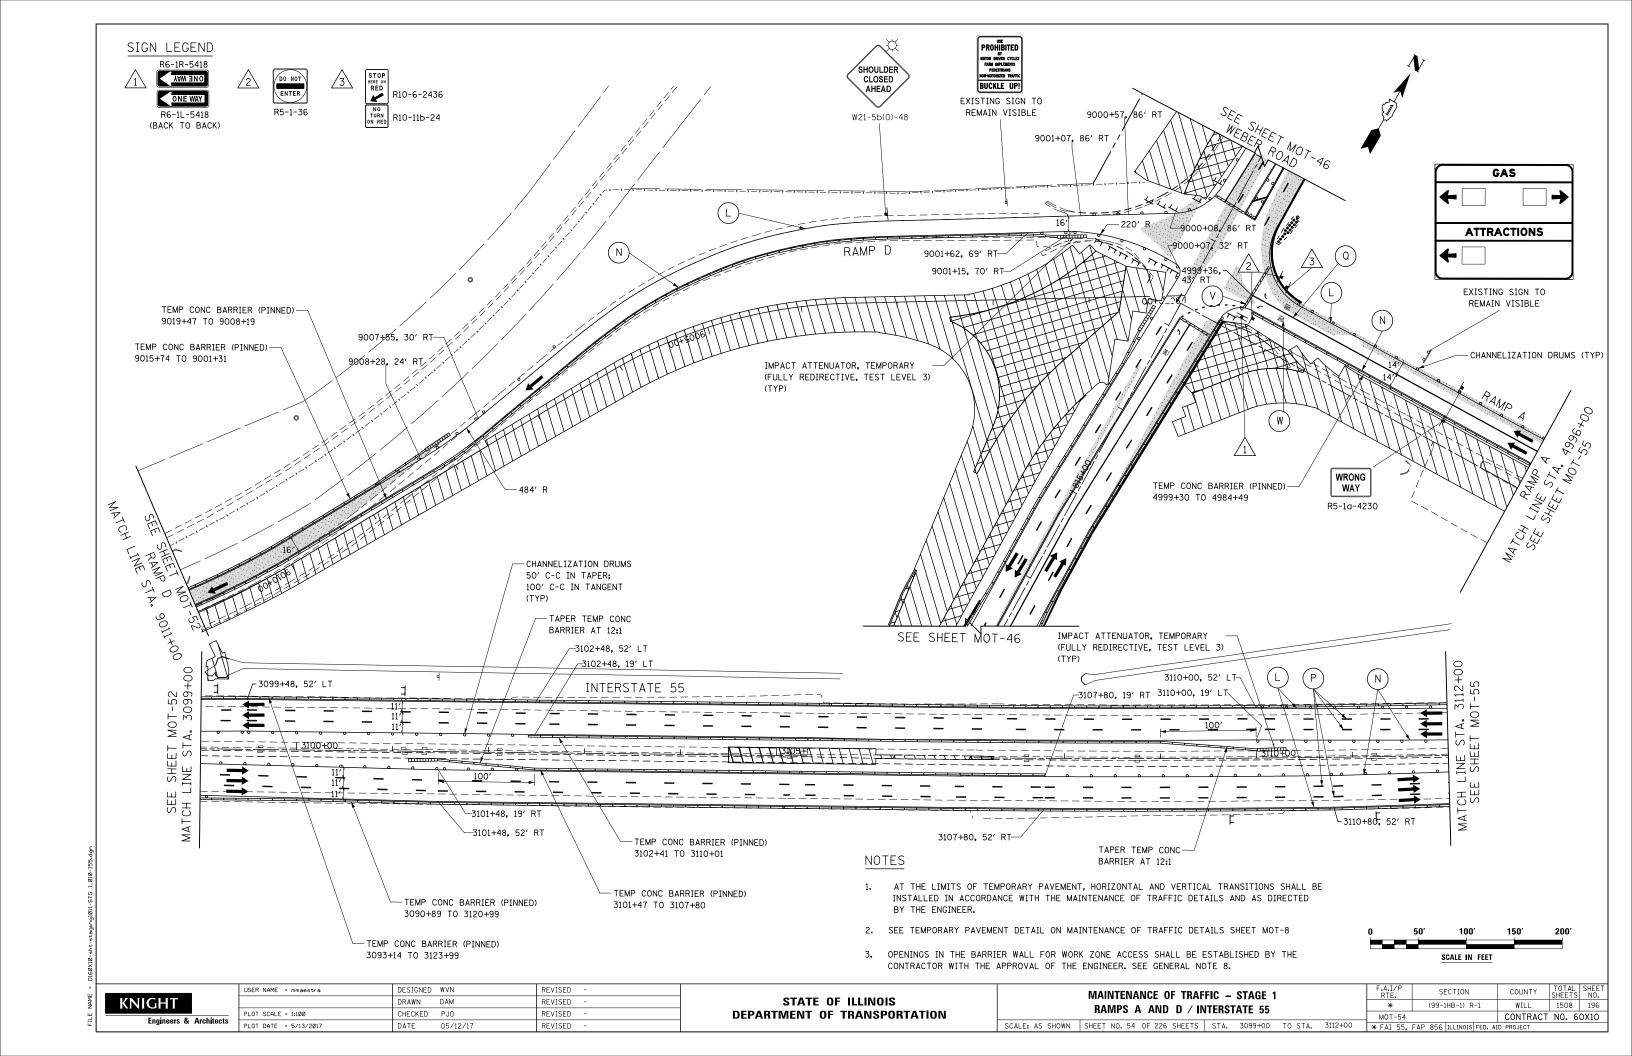

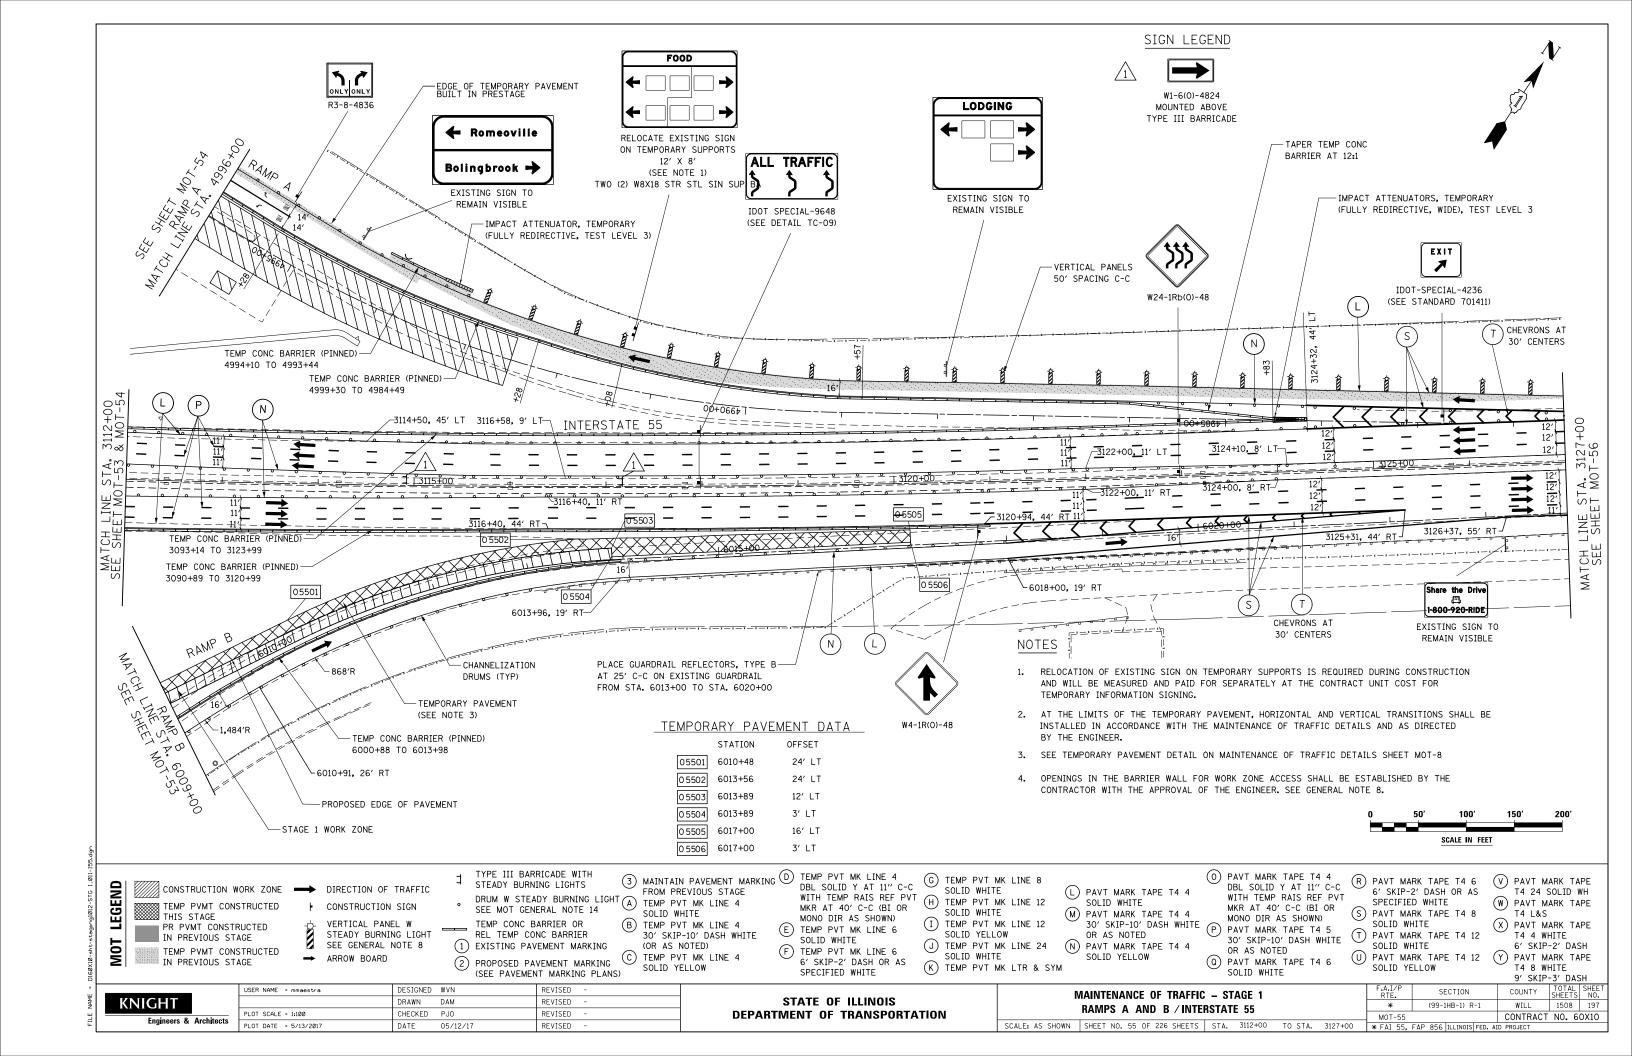

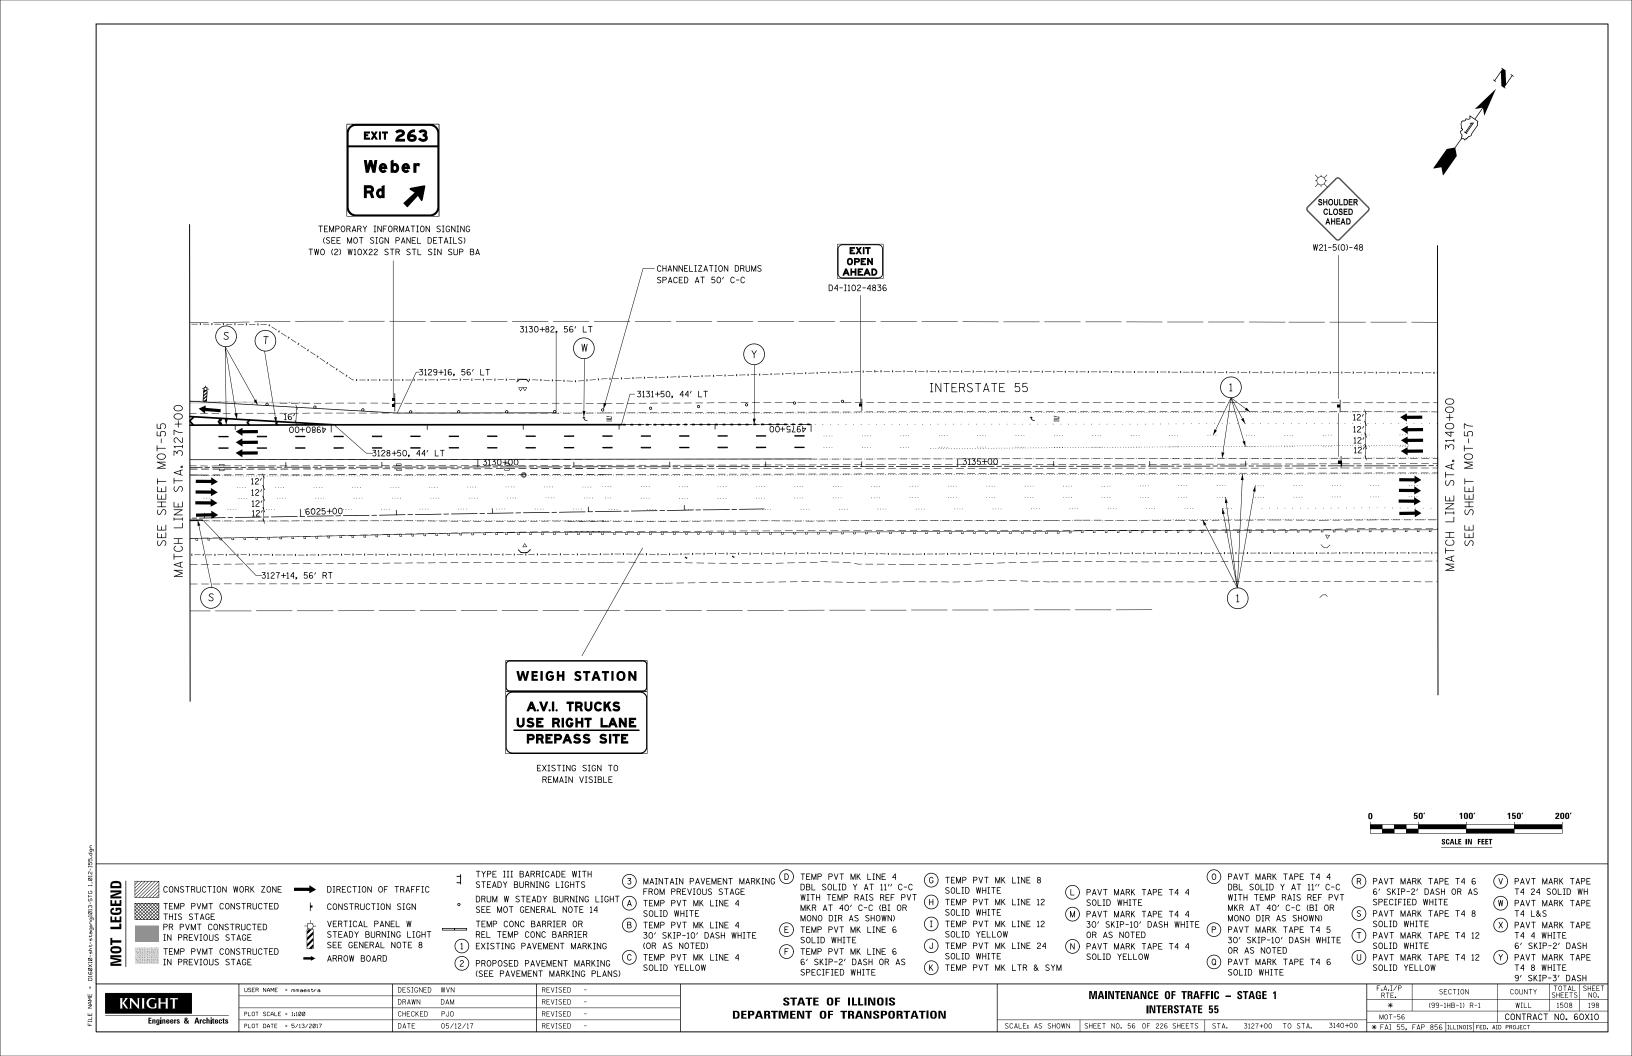

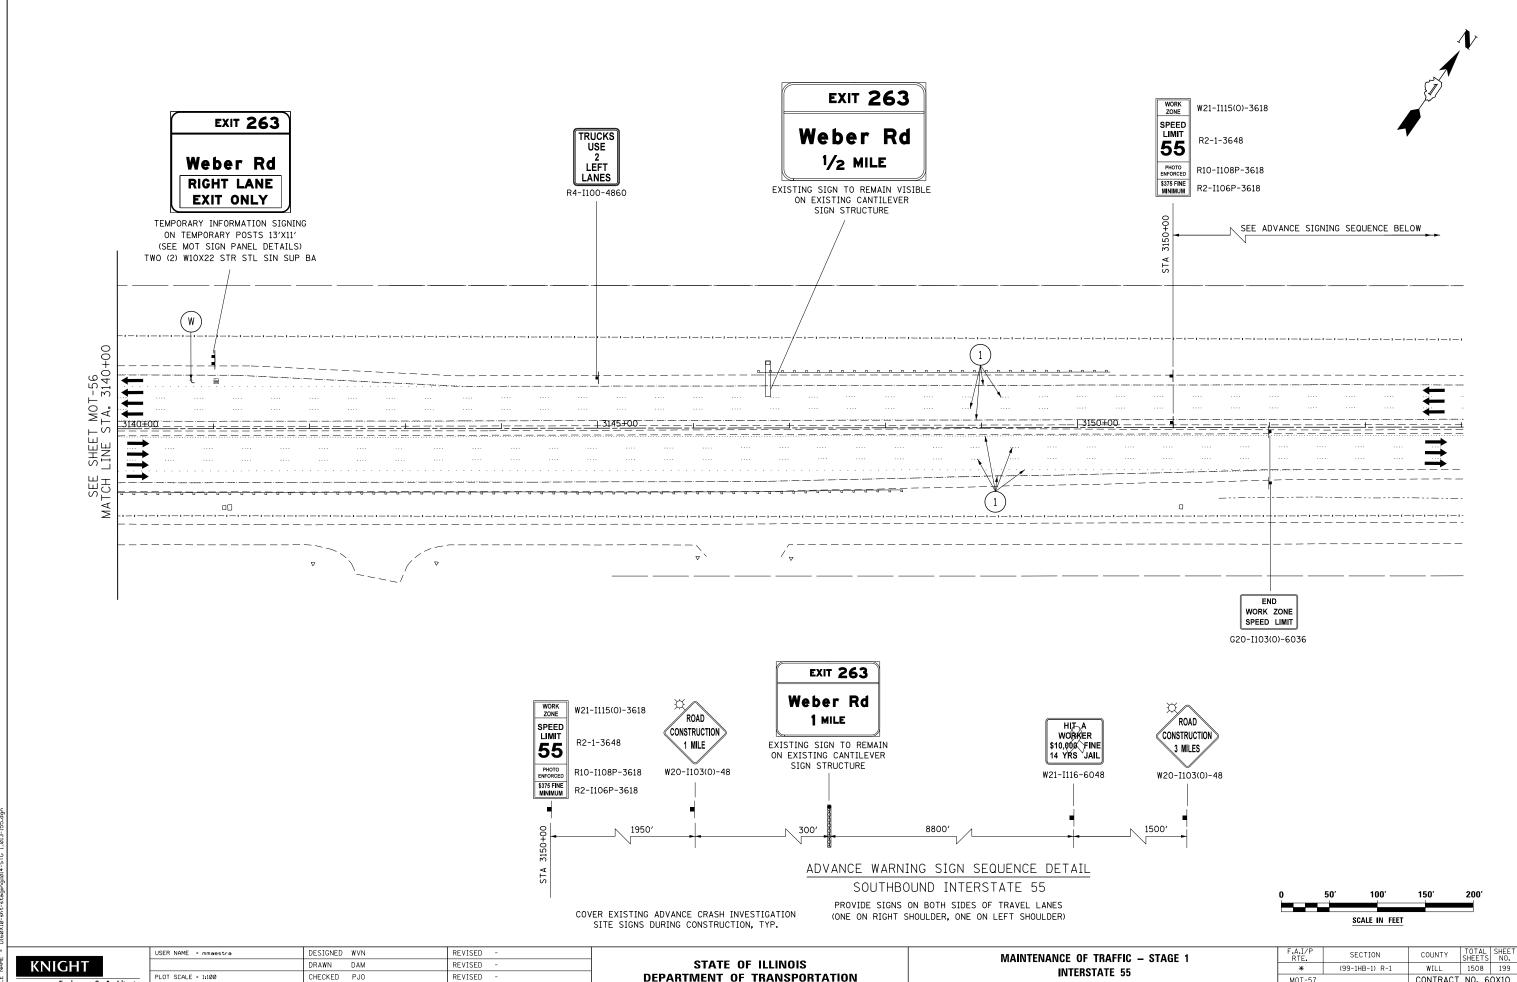

PLOT SCALE = 1:100 CHECKED PJO REVISED PLOT DATE = 5/13/2017 DATE 05/12/17 REVISED

DEPARTMENT OF TRANSPORTATION

CONTRACT NO. 60X10 SCALE: AS SHOWN | SHEET NO. 57 OF 226 SHEETS | STA. 3140+00 | TO STA. 3154+00 | ** FAI 55, FAP 856 | II

