

SCHEDULE OF STRUCTURES

FAU RTE	SECTION	COUNTY	TOTAL SHEETS	SHEET NO.
1447	03-00159-00-RS	COOK	24	11
F. HW. A. REG.	ILLINOIS	PROJECT STPM-8003(581)		

CONTRACT NO. 83835

- |  |  |  |  |   |   |
|--|--|--|--|---|---|
| 38. STA. 15+93, 2' L MANHOLE TO BE RECONSTRUCTED<br>PROP. RIM = 617.95                         | 46. STA. 18+10, 0' L MANHOLE TO BE ADJUSTED, SPECIAL<br>PROP. RIM = 617.42                     | 54. STA. 21+29, 37.5' L MANHOLE REHABILITATION AND ADJUSTMENT, SPECIAL<br>PROP. RIM = 617.85 | 62. STA. 25+21, 25' R CATCH BASIN TO BE ADJUSTED<br>PROP. RIM = 618.15     | 70. STA. 28+12, 16' L CATCH BASIN, TYPE A, 4' DIA. (SPECIAL)<br>PROP. INVERT = 612.75<br>PROP. RIM = 618.10 | 76. STA. 28+20, 4.3' R INLET TO BE ADJUSTED<br>PROP. RIM = 617.65   |
| 39. STA. 17+19, 25' R CATCH BASIN TO BE ADJUSTED<br>PROP. RIM = 617.00                         | 47. STA. 18+20, 18.5' R INLET, TYPE A (SPECIAL)<br>PROP. INVERT = 614.15<br>PROP. RIM = 616.95 | 55. STA. 21+66, 25' R CATCH BASIN TO BE RECONSTRUCTED<br>PROP. RIM = 617.89                  | 63. STA. 25+25, 18.5' R INLET TO BE ADJUSTED<br>PROP. RIM = 617.65         | 71. STA. 28+20, 45.5' L INLET TO BE ADJUSTED<br>PROP. RIM = 617.69  | 77. STA. 28+55, 45' L INLET TO BE ADJUSTED<br>PROP. RIM = 617.65  |
| 40. STA. 17+23, 18.5' R INLET, TYPE A (SPECIAL)<br>PROP. INVERT = 615.30<br>PROP. RIM = 617.00 | 48. STA. 18+24, 25' R CATCH BASIN TO BE ADJUSTED<br>PROP. RIM = 617.45                         | 56. STA. 21+70, 18.5' R INLET TO BE ADJUSTED<br>PROP. RIM = 617.39                           | 64. STA. 25+25, 18.5' L CATCH BASIN TO BE ADJUSTED<br>PROP. RIM = 617.65   | 72. STA. 28+19, 12.5' L VALVE VAULT TO BE RECONSTRUCTED<br>PROP. RIM = 617.80                               | 78. STA. 28+61, 10' L CATCH BASIN TO BE RECONSTRUCTED<br>PROP. RIM = 617.90                                 |
| 41. STA. 17+27, 18.5' L CATCH BASIN TO BE ADJUSTED<br>PROP. RIM = 617.50                       | 49. STA. 18+21, 18.5' L CATCH BASIN TO BE ADJUSTED<br>PROP. RIM = 616.95                       | 57. STA. 21+70, 18.5' L CATCH BASIN TO BE ADJUSTED<br>PROP. RIM = 617.45                     | 65. STA. 26+85, 25' R MANHOLE TO BE ADJUSTED<br>PROP. RIM = 617.95         | 73. STA. 28+25, 34' L VALVE VAULT TO BE RECONSTRUCTED<br>PROP. RIM = 617.80                                 | 79. STA. 28+62, 24' R CATCH BASIN, TYPE A, 4' DIA. (SPECIAL)<br>PROP. INVERT = 612.00<br>PROP. RIM = 617.55 |
| 42. STA. 17+64, 35.5' R VALVE VAULT TO BE ADJUSTED, SPECIAL<br>PROP. RIM = 617.40              | 50. STA. 19+24, 1' L MANHOLE TO BE ADJUSTED, SPECIAL<br>PROP. RIM = 617.73                     | 58. STA. 24+62, 35' R VALVE VAULT TO BE RECONSTRUCTED<br>PROP. RIM = 618.80                  | 66. STA. 27+74, 25' R MANHOLE TO BE ADJUSTED<br>PROP. RIM = 618.25         | 74. STA. 28+24, 39' R VALVE VAULT TO BE RECONSTRUCTED<br>PROP. RIM = 618.20                                 | 80. STA. 28+55, 39.5' R INLET TO BE ADJUSTED<br>PROP. RIM = 617.61  |
| 43. STA. 17+64, 33' L VALVE VAULT TO BE ADJUSTED, SPECIAL<br>PROP. RIM = 617.48                | 51. STA. 21+17, 32' R VALVE VAULT TO BE ADJUSTED, SPECIAL<br>PROP. RIM =                       | 59. STA. 24+81, 39' R MANHOLE TO BE ADJUSTED, SPECIAL<br>PROP. RIM = 618.20                  | 67. STA. 27+98, 12.5' L VALVE VAULT, TYPE A, 4' DIA.<br>PROP. RIM = 617.80 | 75. STA. 28+34, 20' R MANHOLE TO BE RECONSTRUCTED<br>PROP. RIM = 617.90                                     |   |
| 44. STA. 17+71, 0' L MANHOLE TO BE ADJUSTED, SPECIAL<br>PROP. RIM = 617.50                     | 52. STA. 21+24, 0' R MANHOLE TO BE ADJUSTED, SPECIAL<br>PROP. RIM = 618.10                     | 60. STA. 24+72, 32' L VALVE VAULT TO BE ADJUSTED, SPECIAL<br>PROP. RIM = 618.25              | 68. STA. 28+00, 18.5' L CATCH BASIN TO BE ADJUSTED<br>PROP. RIM = 617.65   |   |   |
| 45. STA. 17+73, 37' L MANHOLE TO BE ADJUSTED, SPECIAL<br>PROP. RIM = 617.20                    | 53. STA. 21+16, 34' L VALVE VAULT TO BE ADJUSTED, SPECIAL<br>PROP. RIM = 617.75                | 61. STA. 24+83, 37.5' L MANHOLE TO BE ADJUSTED, SPECIAL<br>PROP. RIM = 618.30                | 69. STA. 28+00, 18.5' R CATCH BASIN TO BE ADJUSTED<br>PROP. RIM = 617.65   |   |   |





WATER MAIN SCHEDULE

- Ⓢ 1-8" INSERTION VALVE
- 1-VALVE VAULT, 4' DIA.
- 1-TYPE 1 FRAME WITH "WATER" STAMPED ON CLOSED LID

**IMPORTANT!**  
FULL SIZE PLANS HAVE BEEN PREPARED USING STANDARD ENGINEERING SCALES. REDUCED SIZED PLANS WILL NOT CONFORM TO STANDARD SCALES INDICATED IN TITLE BLOCK.

ALL BUFFALO BOXES ON THIS PROJECT LOCATED BETWEEN THE CURB AND THE SIDEWALK ARE TO BE ADJUSTED TO GRADE. BROKEN OR OTHERWISE UNUSABLE BUFFALO BOXES SHALL BE REPAIRED AND BE PAID FOR AS DOMESTIC WATER SERVICE BOXES TO BE ADJUSTED, SPECIAL.

ALL SEWER LATERALS TO BE CLEANED IN OAK PARK AVE.

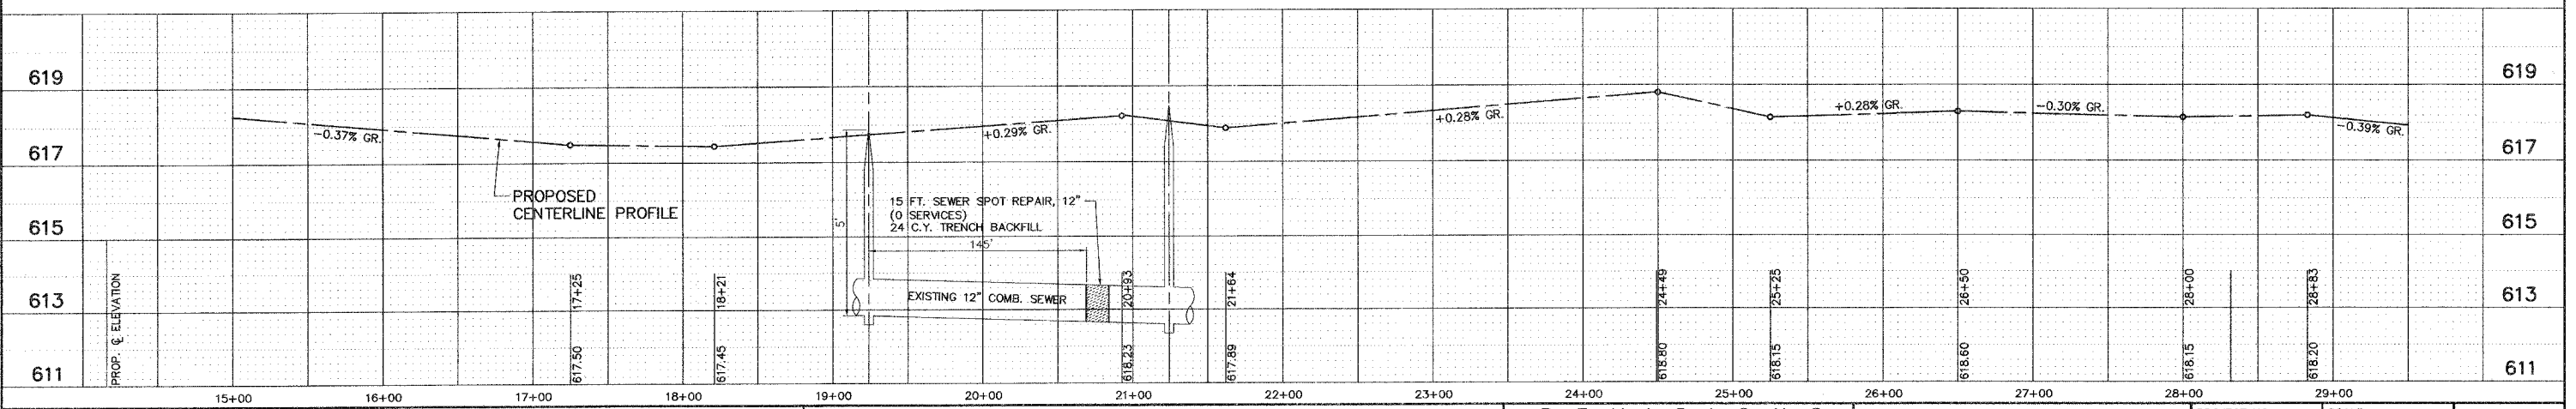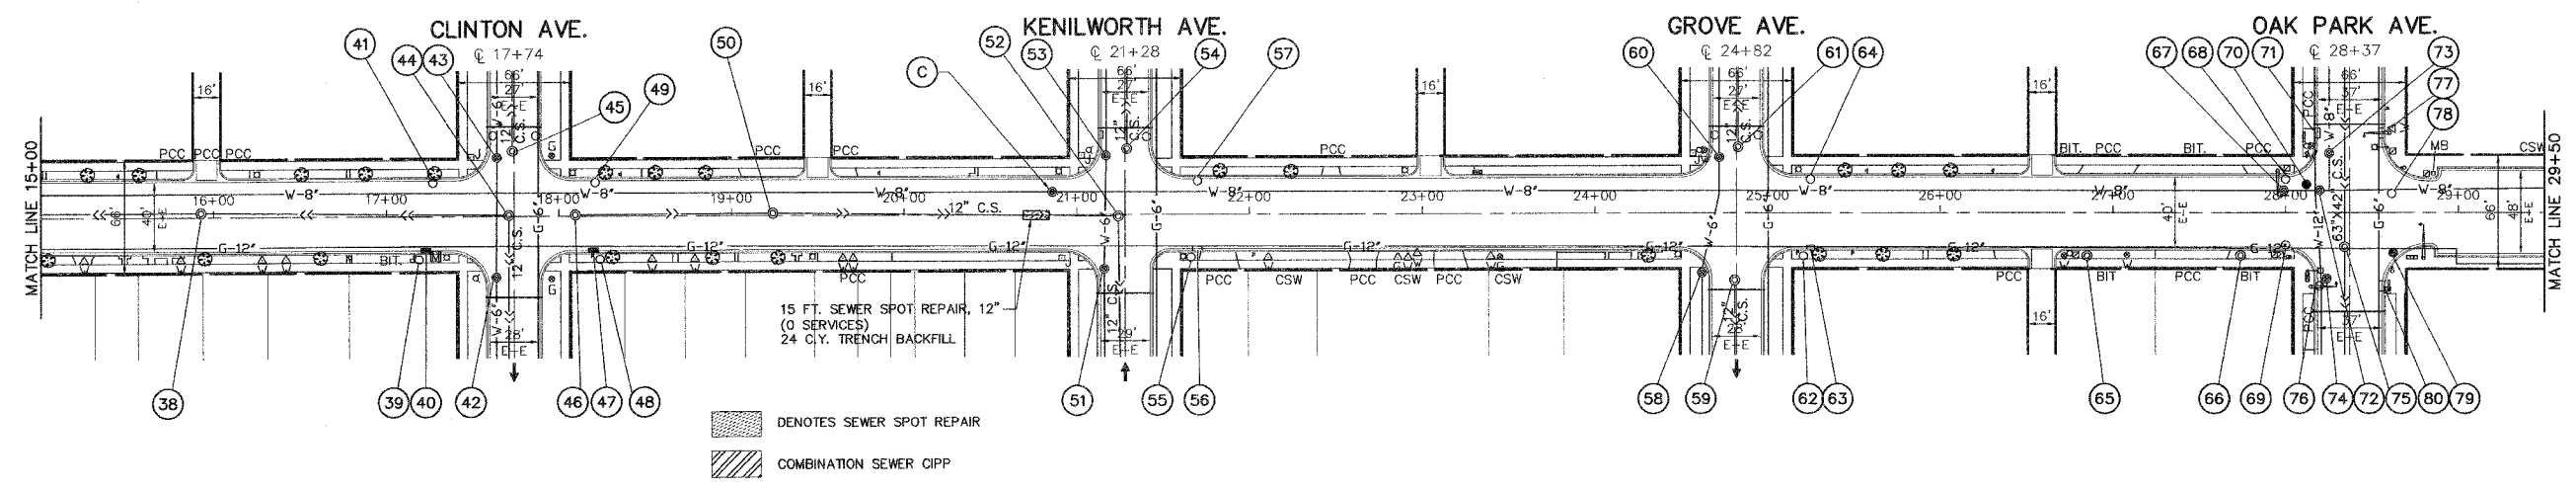

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PROJECT  
CITY OF BERWYN, ILLINOIS  
16TH STREET RESURFACING  
SECTION NO. 03-000159-00-RS

REVISIONS			
NO.	BY	DATE	DESCRIPTION
1	THK	11/30/05	PER IDOT DIST. 1 B.L.R. COMMENTS
2	THK	12/14/05	PER IDOT DIST. 1 B.L.R. COMMENTS
3	THK	12/16/05	PER IDOT DIST. 1 B.L.R. COMMENTS

**DRAINAGE PLAN**  
16TH STREET  
STA. 15+00 TO STA. 29+50

PROJECT NO. 02260	SCALE H: 1"=50'; V: 1"=1'	SHEET 11 OF 24 SHEETS
DRAWN/DESIGNED JEP-RAW/THK	DATE OCT., 2005	
CHECKED/APPROVED JEF	FIELD BOOK NO. FILE	

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