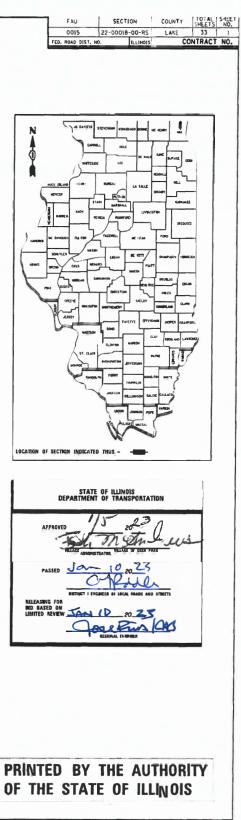


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GENERAL NOTES

THE CONTRACTOR SHALL CONTACT KALPANA KANNAN-HOSADURGA, THE DISTRICT ONE TRAFFIC CONTROL SUPERVISOR, AT KALPANA, KANNAN-HOSADURGADILLINDIS.GOV A MINIMUM OF 72 HOURS IN ADVANCE OF BEGINNING WORK.

SPECIFICATIONS. STANDARDS AND SPECIAL PROVISIONS

ALL CONSTRUCTION SHALL BE DONE IN ACCORDANCE WITH THE "STANDARD SPECIFICATIONS FOR ROAD AND BRIDGE CONSTRUCTION", ADOPTED JANUARY 1, 2022; THE "SUPPLEMENTAL SPECIFICATIONS AND RECURRING SPECIAL PROVISIONS", ADOPTED JANUARY 1, 2023; THE LATEST EDITION OF THE "ILLINDIS MANUAL ON UNIFORM TRAFFIC CONTROL DEVICES FOR STREETS AND HIGHWAYS", (IMUTCD); "THE STANDARD SPECIFICATIONS FOR WATER AND SEWER MAIN CONSTRUCTION IN ILLINDIS" JUNE 2014 SEVENTH EDITION, THE "DETAILS" IN THE PLANS AND THE "SPECIAL PROVISIONS" INCLUDED IN THE CONTRACT DOCUMENTS.

ANY REFERENCE TO STANDARDS THROUGHOUT THE PLANS OR SPECIAL PROVISIONS SHALL BE INTERPRETED AS THE LATEST IDOT HIGHWAY STANDARD.

CODES OF THE IEPA TITLE 35, AND O.S.H.A. SHALL BE ADHERED TO FOR THE CONSTRUCTION OF THIS PROJECT.

ALL TRAFFIC CONTROL AND OTHER ADVISORY SIGNS NEEDED FOR CONSTRUCTION ARE TO BE FURNISHED BY THE CONTRACTOR IN ACCORDANCE WITH SECTION 700 OF THE STANDARD SPECIFICATIONS.

ALL REOUIRED PERMITS FROM THE PROPER GOVERNING AGENCY SHALL BE OBTAINED FOR CONSTRUCTION ALONG OR ACROSS EXISTING STREETS OR HIGHWAYS. THE CONTRACTOR SHALL WAKE ARRANGEMENTS FOR THE PROPER BRACING, SHETING, SHORING AND OTHER REOURED PROTECTION OF ALL ROADWAYS BEFORE CONSTRUCTION BEGINS. THE CONTRACTOR SHALL BE RESPONSIBLE FOR ANY DAMAGE TO THE STREETS OR ROADWAYS AND ASSOCIATED STRUCTURES AND SHALL MAKE REPAIRS AS NECESSARY TO THE SATISFACTION OF THE AGENCY. THE CONTRACTOR SHALL BE RESPONSIBLE FOR THE INSTALLION AND MAINTENANCE OF ADEQUATE SIGNS AND WARNING DEVICES TO INFORM AND PROTECT THE PUBLIC.

<u>UTILITIES</u>

THE CONTRACTOR SHALL BE RESPONSIBLE FOR CONTACTING THE OWNERS OF ALL EXISTING UTILITY FACILITIES SO THAT THE UTILITIES AND THEIR APPURTENANCES MAY BE LOCATED AND ADJUSTED OR MOVED, IF NECESSARY, PRIOR TO THE START OF CONSTRUCTION OPERATIONS. THE CONTRACTOR SHALL COOPERATE WITH ALL UTILITY OWNERS AS PROVIDED FOR IN THE STANDARD SPECIFICATIONS.

THE LOCATIONS OF EXISTING DRAINAGE STRUCTURES, STORM AND SANITARY SEWERS, WATER SERVICE LINES AND OTHER UTILITY LINES ARE APPROXIMATE, AND THE VILLAGE DOES NOT GUARANTEE THEIR ACCURACY. THEIR EXACT HORIZONTAL AND VERTICAL LOCATIONS ARE TO BE DETERMINED IN THE FIELD BY THE CONTRACTOR AT HIS/HER OWN EXPENSE.

THE CONTRACTOR SHALL BE RESPONSIBLE FOR THE PROTECTION OF ALL UNDERGROUND OR SURFACE UTILITIES EVEN THOUGH THEY MAY NOT BE SHOWN ON THE PLANS. ANY UTILITY THAT IS DAMAGED DURING CONSTRUCTION SHALL BE REPAIRED OR REPLACED TO THE SATISFACTION OF THE ENGINEER. THIS WORK SHALL BE COVERED BY THE CONTRACTOR AT HIS/HER OWN EXPENSE.

BEFORE STARTING ANY EXCAVATION, THE CONTRACTOR SHALL CALL "JULIE" AT 8-1-1 FOR FIELD LOCATIONS OF BURIED ELECTRIC, TELEPHONE, GAS AND CABLE.

THE CONTRACTOR SHALL CONTACT IDOT'S BUREAU OF MATERIALS (PHONE 847-705-4337) AT LEAST 24 HOURS BEFORE PLACING HOT-MIX ASPHALT OR PORTLAND CEMENT CONCRETE.

ADJUSTMENTS WITH MILLING AND GENERAL ADJUSTMENTS: UNLESS NOTED ON THE PLANS OR IN FIELD, ALL ADJUSTMENTS SHALL USE EXISTING FRAME & LID.

CONTRACTOR SHALL POUR NEW CONCRETE BENCH ON ALL STRUCTURES NOTED IN THE PLANS OR BY THE ENGINEER IN THE FIELD.

MISCELLANEOUS

AND BEGINNING CONSTRUCTION.

ALL SAWCUTTING SHALL BE PERFORMED PRIOR TO BEGINNING REMOVAL. ANY ITEMS OF WORK REMOVED PRIOR TO SAWCUTTING WILL NOT BE MEASURED FOR PAYMENT.

THEY ARE TO BE PLACED.

CONCRETE FILL BETWEEN NEW CURB AND GUTTER AND EXISTING PAVEMENT: FILLING THE GAP BETWEEN THE EXISTING PAVEMENT AND PROPOSED CURB AND GUTTER REMOVAL AND REPLACEMENT SHALL BE IN ACCORDANCE WITH IDOT HIGHWAY STANDARD 606001. ALL DETECTABLE WARNING TACTILES SHALL BE FIELD VERIFIED AND THE SIZE TO BE DETERMINED THE CONTRACTOR PRIOR TO ORDERING.

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DIMENSIONS: IT SHALL BE THE CONTRACTOR'S RESPONSIBILITY TO VERIFY ALL DIMENSIONS AND CONDITIONS EXISTING IN THE FIELD PRIOR TO ORDERING MATERIALS

COMBINATION CONCRETE CURB AND GUTTER REMOVAL AND REPLACEMENT, SIDEWALK REMOVAL AND REPLACEMENT, DRIVEWAY REMOVAL AND REPLACEMENT, AND STRUCTURES TO BE ADJUSTED WILL BE DETERMINED BY THE ENGINEER IN THE FIELD.

THE THICKNESSES OF HOT-MIX ASPHALT MIXTURES SHOWN IN THE PLANS ARE NOMINAL. DEVIATIONS MAY OCCUR DUE TO IRREGULARITIES IN THE SURFACES OR BASIS ON WHICH

DETECTABLE WARNINGS SHALL BE INSTALLED AT INTERSECTING STREETS, DRIVEWAYS, AND ALLEYS AS SHOWN ON THE PLANS.

PAVEMENT GRADES: THE ELEVATIONS INDICATED ON THE PLANS ARE FINISHED GRADES OF PROPOSED PAVEMENT OR SURFACE COURSE, UNLESS OTHERWISE INDICATED.

CONTRACTOR SHALL NOT PLACE SOD UNTIL THE TEMPERATURE IS 80 OR LESS AND THE FORECAST FOR THE NEXT 7 DAYS SHOWS TEMPERATURES OF 80 OR LESS. IF ALL OTHER PAY ITEMS ARE COMPLETED. THE CONTRACTOR WILL NOT BE CHARGED WORKING DAYS FOR DELAYS IN PARKWAY RESTORATION DUE TO TEMPERATURE.

NO CONSTRUCTION SHALL BEGIN UNTIL ALL PROPER TEMPORARY SIGNS AND BARRICADES HAVE BEEN INSTALLED.

PAVING OF THE FULL ROADWAY WIDTH SHALL BE COMPLETED AT THE END OF EACH DAY OF PAVING TO PREVENT A LONGITUDINAL COLD JOINT FROM APPEARING WHEN OPPOSITE SIDES OF THE ROAD ARE PAVED ON DIFFERENT DAYS. THE CONTRACTOR SHALL ALSO ENSURE THAT AT THE END OF EACH DAY EACH PASS ENDS AT APPROXIMATELY THE SAME STATION TO PREVENT A COLD JOINT.

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SUMMARY OF QUANTITIES

SPECIALTY ITEM	SPECIAL PROVISION	ITEM NO.	ITEM	UNIT	CONSTRUCTION TYPE CODE 0005 (80% FEDERAL / 20% LOCAL)	CONSTRUCTIO TYPE CODE 004 (80% FEDERAL 20% LOCAL)
		20101100	TREE TRUNK PROTECTION	EACH	10	-
		20101200	TREE ROOT PRUNING	EACH	10	-
~	· · · ·	20101300	TREE PRUNING (1 TO 10 INCH DIAMETER)	EACH	10	
	*	20800150	TRENCH BACKFILL, SPECIAL	CU YD	75	
		21101615	TOPSOIL FURNISH AND PLACE, 4"	SQ YD	445	-
		25000110	SEEDING, CLASS 1A	SQ YD	445	
		25100630	EROSION CONTROL BLANKET	SQ YD	445	
		40600400	MIXTURE FOR CRACKS, JOINTS, AND FLANGEWAYS	TON	15	
		40600982	HOT-MIX ASPHALT SURFACE REMOVAL - BUTT JOINT	SQ YD	105	-
		40603200	POLYMERIZED HOT-MIX ASPHALT BINDER COURSE, IL-4.75, N50	TON	765	
		40604060	HOT-MIX ASPHALT SURFACE COURSE, IL-9.5, MIX "D", N50	TON	1530	-
		40600290	BITUMINOUS MATERIALS (TACK COAT)	POUND	11600	
		42400200	PORTLAND CEMENT CONCRETE SIDEWALK 5 INCH, SPECIAL	SQ FT	1070	-
	· · · · · · · · · · · · · · · · · · ·	42400800	DETECTABLE WARNINGS	SQ FT	110	
		44000100	PAVEMENT REMOVAL	SQ YD	86	
		44000157	HOT-MIX ASPHALT SURFACE REMOVAL, 2"	SQ YD	17320	

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SUMMARY OF QUANTITIES (cont.)

SPECIALTY ITEM	SPECIAL PROVISION	ITEM NO.	ITEM	UNIT	CONSTRUCTION TYPE CODE 0005 (80% FEDERAL / 20% LOCAL)	CONSTRUCTION TYPE CODE 0042 (80% FEDERAL) 20% LOCAL)
		44000200	DRIVEWAY PAVEMENT REMOVAL	SQ YD	175	
		44000600	SIDEWALK REMOVAL	SQ FT	1070	
		44000500	COMBINATION CONCRETE CURB AND GUTTER REMOVAL	FOOT	1100	-
		44201737	CLASS D PATCHES, TYPE I, 8 INCH	SQ YD	215	-
		44201741	CLASS D PATCHES, TYPE II, 8 INCH	SQ YD	215	
		44201745	CLASS D PATCHES, TYPE III, 8 INCH	SQ YD	215	-
		44201747	CLASS D PATCHES, TYPE IV, 8 INCH	SQ YD	215	_
	*	550A0050	STORM SEWERS, CLASS A, TYPE 1 12"	FOOT	100	_
		60201105	CATCH BASINS, TYPE A, 4'-DIAMETER, TYPE 11 FRAME AND GRATE	EACH	5	
		60236800	INLETS, TYPE A, TYPE 11 FRAME AND GRATE	EACH	3	
		60300105	FRAMES AND LIDS TO BE ADJUSTED	EACH	22	-
	*	60400105	FRAMES, TYPE 1	EACH	1	
		60404800	FRAMES AND GRATES, TYPE 11	EACH	1	
		60603800	COMBINATION CONCRETE CURB AND GUTTER, TYPE B-6.12	FOOT	1100	
		67100100	MOBILIZATION	LSUM	1	-
		70102620	TRAFFIC CONTROL AND PROTECTION, STANDARD 701501	LSUM	1	

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SUMMARY OF QUANTITIES (cont.)

SPECIALTY ITEM	SPECIAL PROVISION	ITEM NO.	ITEM	UNIT	CONSTRUCTION TYPE CODE 0005 (80% FEDERAL / 20% LOCAL)	CONSTRUCTION TYPE CODE 004 (80% FEDERAL 20% LOCAL)
		70102630	TRAFFIC CONTROL AND PROTECTION, STANDARD 701601	LSUM	1	-
		70102635	TRAFFIC CONTROL AND PROTECTION, STANDARD 701701	LSUM	1	-
		70102640	TRAFFIC CONTROL AND PROTECTION, STANDARD 701801	LSUM	1	-
		70300100	SHORT TERM PAVEMENT MARKING	FOOT	275	
		70300150	SHORT TERM PAVEMENT MARKING REMOVAL	SQ FT	95	-
		70300221	TEMPORARY PAVEMENT MARKING - LINE 4"- PAINT	FOOT	775	-
		70300281	TEMPORARY PAVEMENT MARKING - LINE 24"- PAINT	FOOT	250	
2		78000100	THERMOPLASTIC PAVEMENT MARKING - LETTERS AND SYMBOLS	FOOT	620	
۲		78000200	THERMOPLASTIC PAVEMENT MARKING - 4"	FOOT	4465	
~		78000400	THERMOPLASTIC PAVEMENT MARKING - 6"	FOOT	2350	
~		78000500	THERMOPLASTIC PAVEMENT MARKING - 8"	FOOT	490	
~		78000600	THERMOPLASTIC PAVEMENT MARKING - 12"	FOOT	165	
~		78000650	THERMOPLASTIC PAVEMENT MARKING - 24"	FOOT	250	
		78300202	PAVEMENT MARKING REMOVAL - WATER BLASTING	FOOT	225	
~		85000200	MAINTENANCE OF EXISTING TRAFFIC SIGNAL INSTALLATION	EACH	2	


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SUMMARY OF QUANTITIES (cont.)

SPECIALTY ITEM	SPECIAL PROVISION	ITEM NO.	ITEM	UNIT	CONSTRUCTION TYPE CODE 0005 (80% FEDERAL /	CONSTRUCTION TYPE CODE 004 (80% FEDERAL
~	*	88600600	DETECTOR LOOP REPLACEMENT	FOOT	20% LOCAL) 750	20% LOCAL) -
	*	X0326862	STRUCTURES TO BE ADJUSTED	EACH	9	
	*	X4022000	TEMPORARY ACCESS (COMMERCIAL ENTRANCE)	EACH	4	
	*	X4023000	TEMPORARY ACCESS (ROAD)	EACH	4	
	*	X5510100	STORM SEWER REMOVAL	FOOT	100	
~	*	X8800101	PEDESTRIAN PUSH BUTTON, SPECIAL	EACH	3	
	*	Z0004526	HOT-MIX ASPHALT DRIVEWAY PAVEMENT, 7 INCH	SQ YD	175	-
	*	Z0013798	CONSTRUCTION LAYOUT	LSUM	1	
	*	Z0018600	DRAINAGE STRUCTURES TO BE RECONSTRUCTED	EACH	1	
	*	Z0018700	DRAINAGE STRUCTURE TO BE REMOVED	EACH	7	-
	*	Z0030850	TEMPORARY INFORMATION SIGNING	SQ FT	120	-
	*	Z0076600	TRAINEES	HOUR		500
	*	Z0076604	TRAINEES TRAINING PROGRAM GRADUATE	HOUR	-	500

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- LEGEND
- EXISTING HOT-MIX ASPHALT PAVEMENT
- EXISTING AGGREGATE SUBBASE
- EXISTING PCC SIDEWALK
- HOT-MIX ASPHALT SURFACE REMOVAL, 2"
- HOT-MIX ASPHALT SURFACE COURSE, IL-9.5, MIX "D", N50 1.5"
- POLYMERIZED HOT-MIX ASPHALT BINDER COURSE, IL-4.75, N50 0.75"


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- CLASS D PATCHES, 8 INCH
- SEEDING, CLASS 1A
- PROPOSED PCC SIDEWALK 5 INCH REMOVAL AND REPLACEMENT (AS DETERMINED BY ENGINEER IN FIELD)
- SUBBASE GRANULAR MATERIAL, 4" (INCLUDED IN COST OF COMBINATION CONCRETE CURB AND GUTTER, TYPE B-6.12)
 - AT LOCATIONS AS DIRECTED BY THE ENGINEER


THE "AC TYPE" FOR POLYMERIZED HMA MIXES SHALL BE "SBS/SBR PG 76-22" AND FOR NON-POLYMERIZED HMA THE "AC TYPE" SHALL BE "PG 64-22" UNLESS MODIFIED BY RECLAIMED MATERIAL SPECIFICATIONS. 3. THE UNIT WEIGHT USED TO CALCULATE ALL HOT-MIX ASPHALT SURFACE MIXTURE IS 112 LBS/SY/IN.

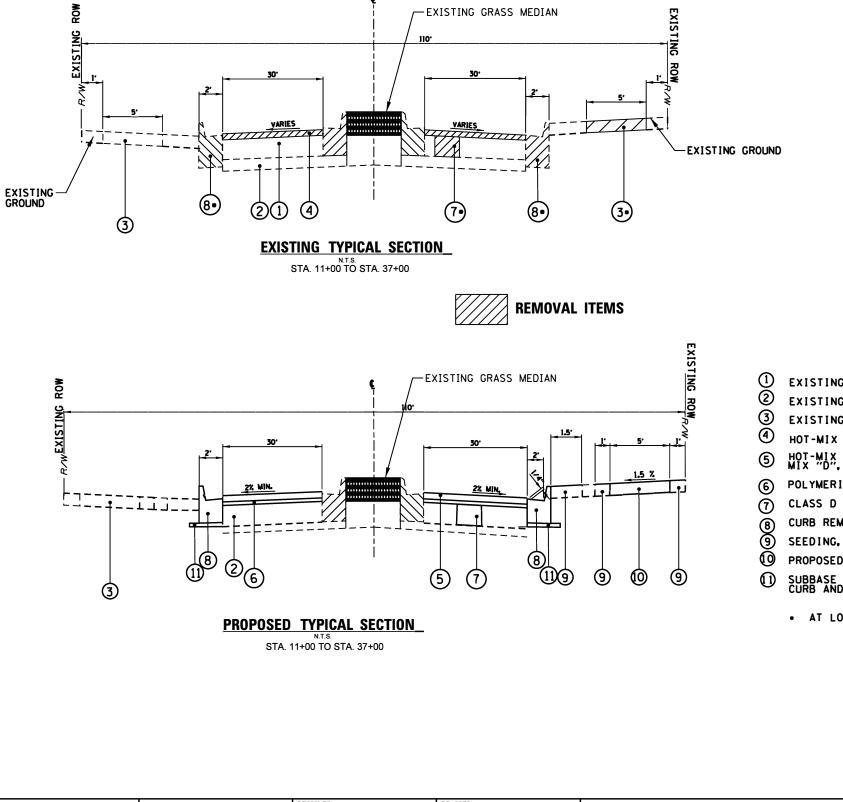CURB REMOVAL AND COMBINATION CONCRETE CURB AND GUTTER, TYPE B-6. 12 (AS DETERMINED BY ENGINEER IN FIELD)


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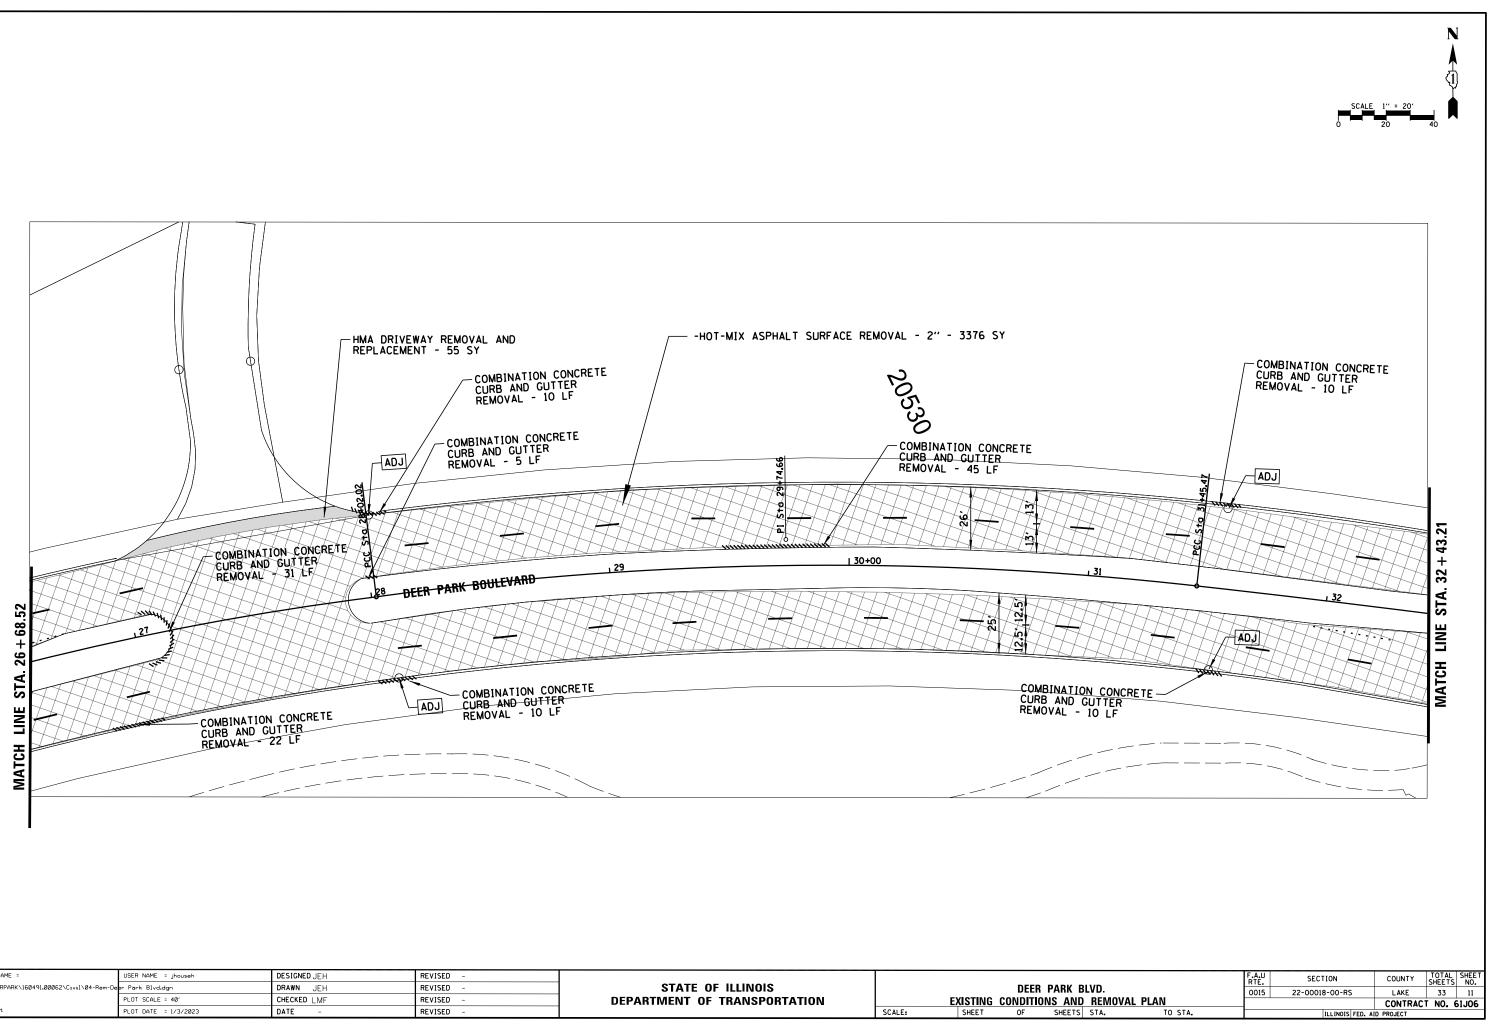
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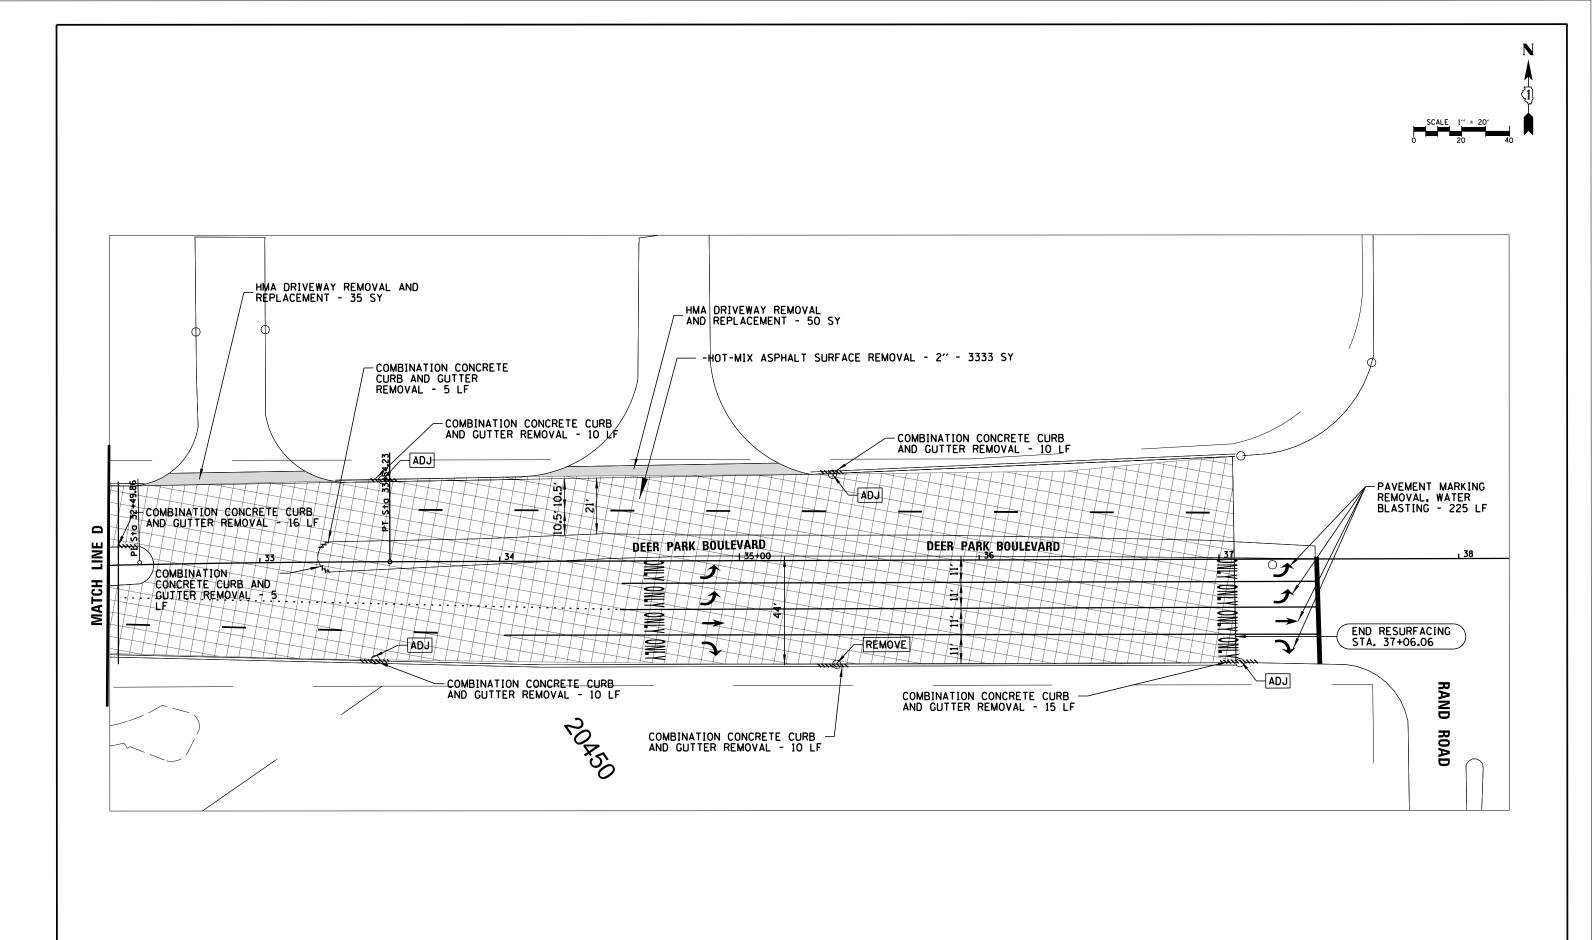
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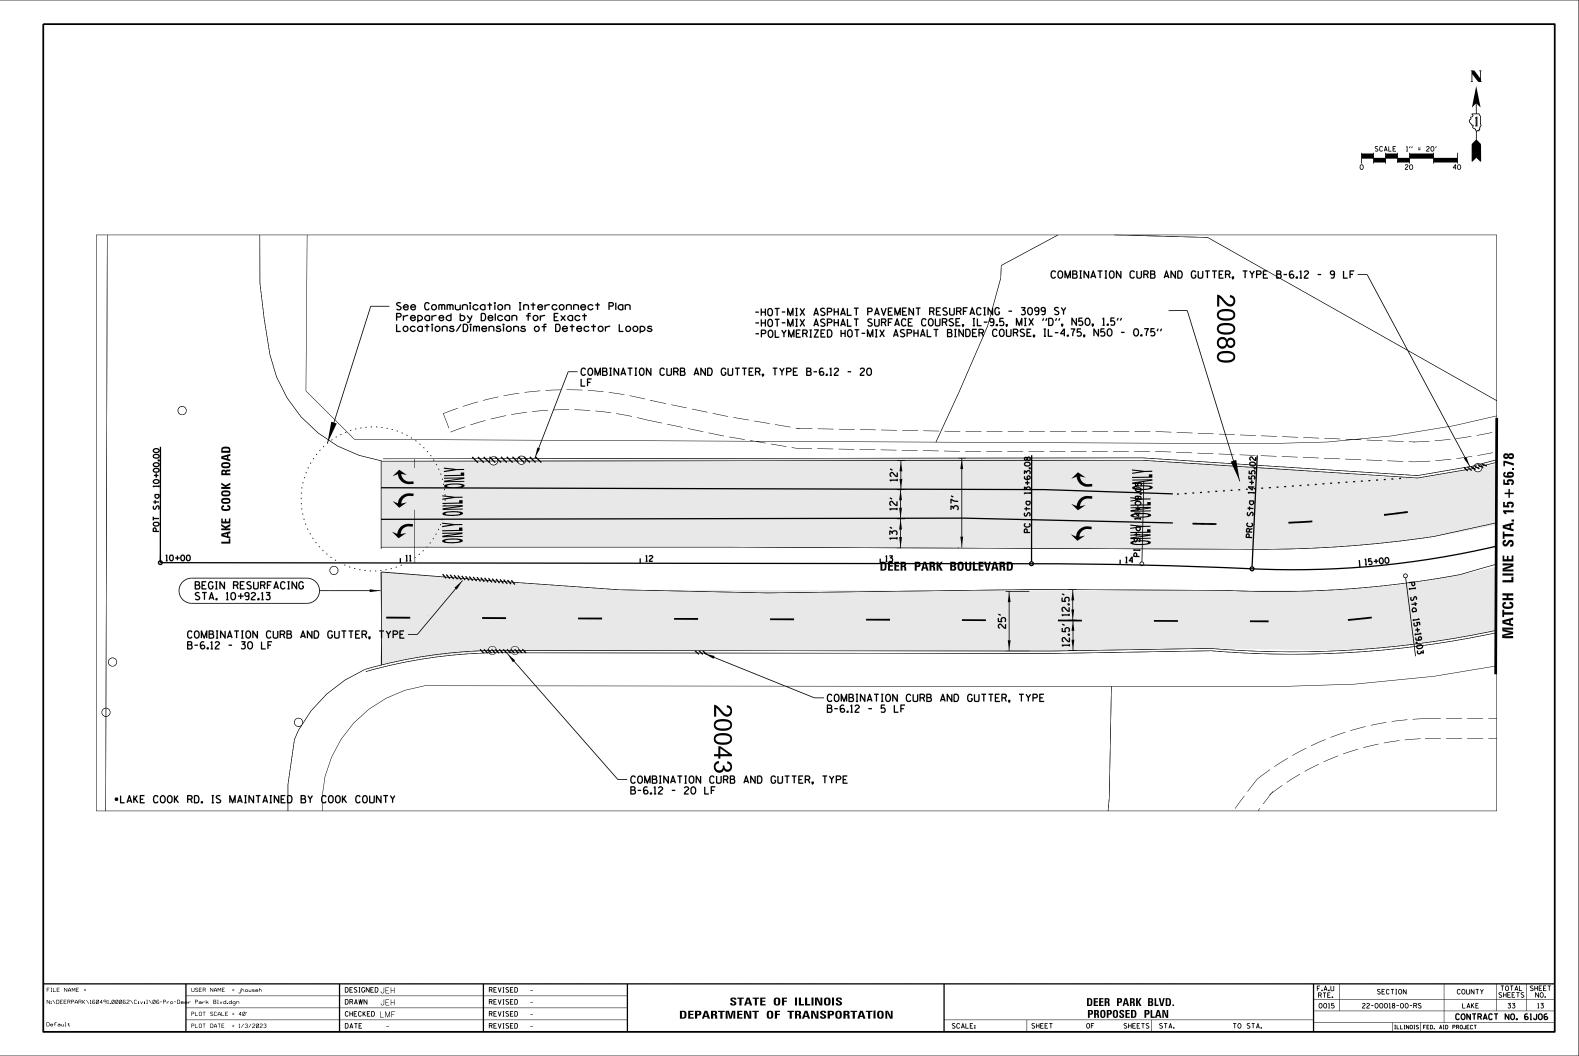
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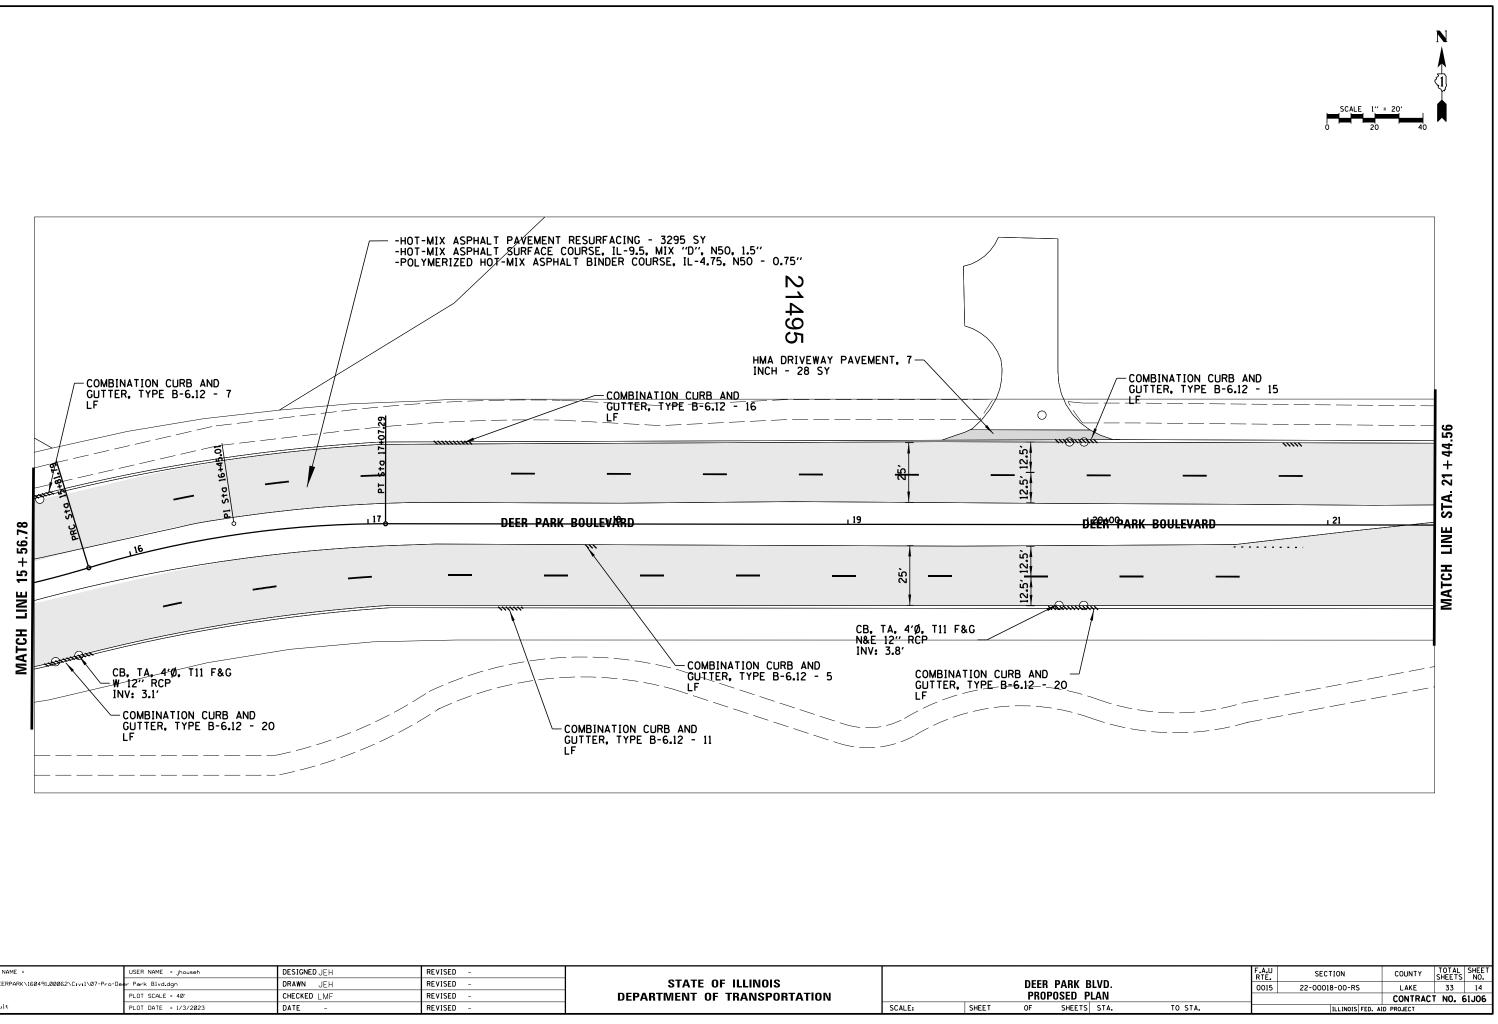


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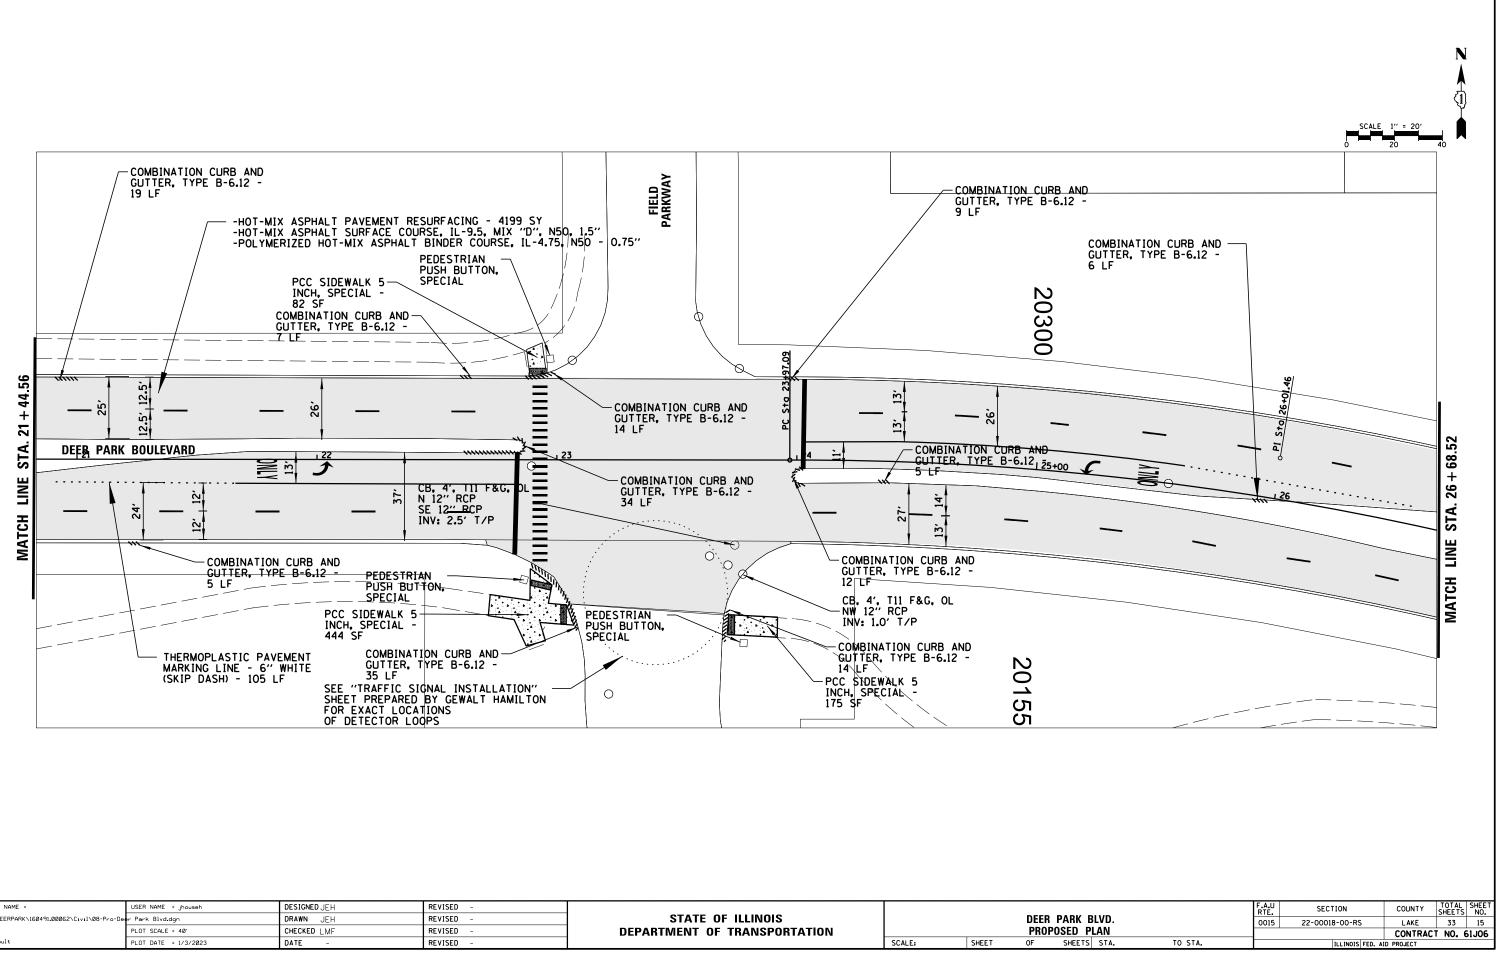

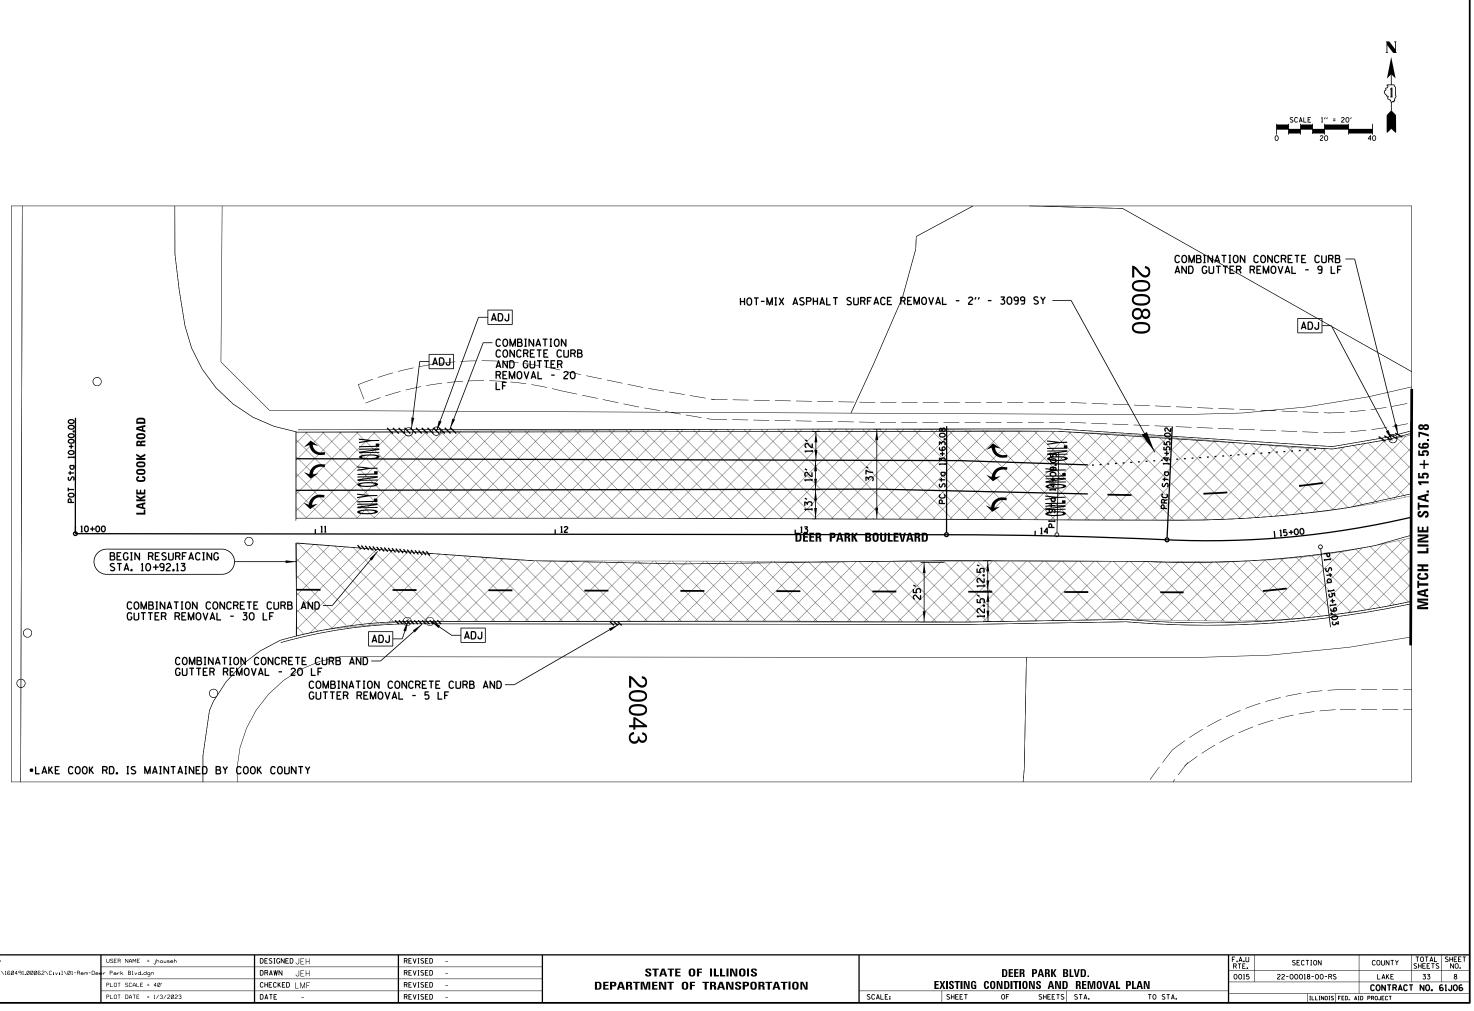
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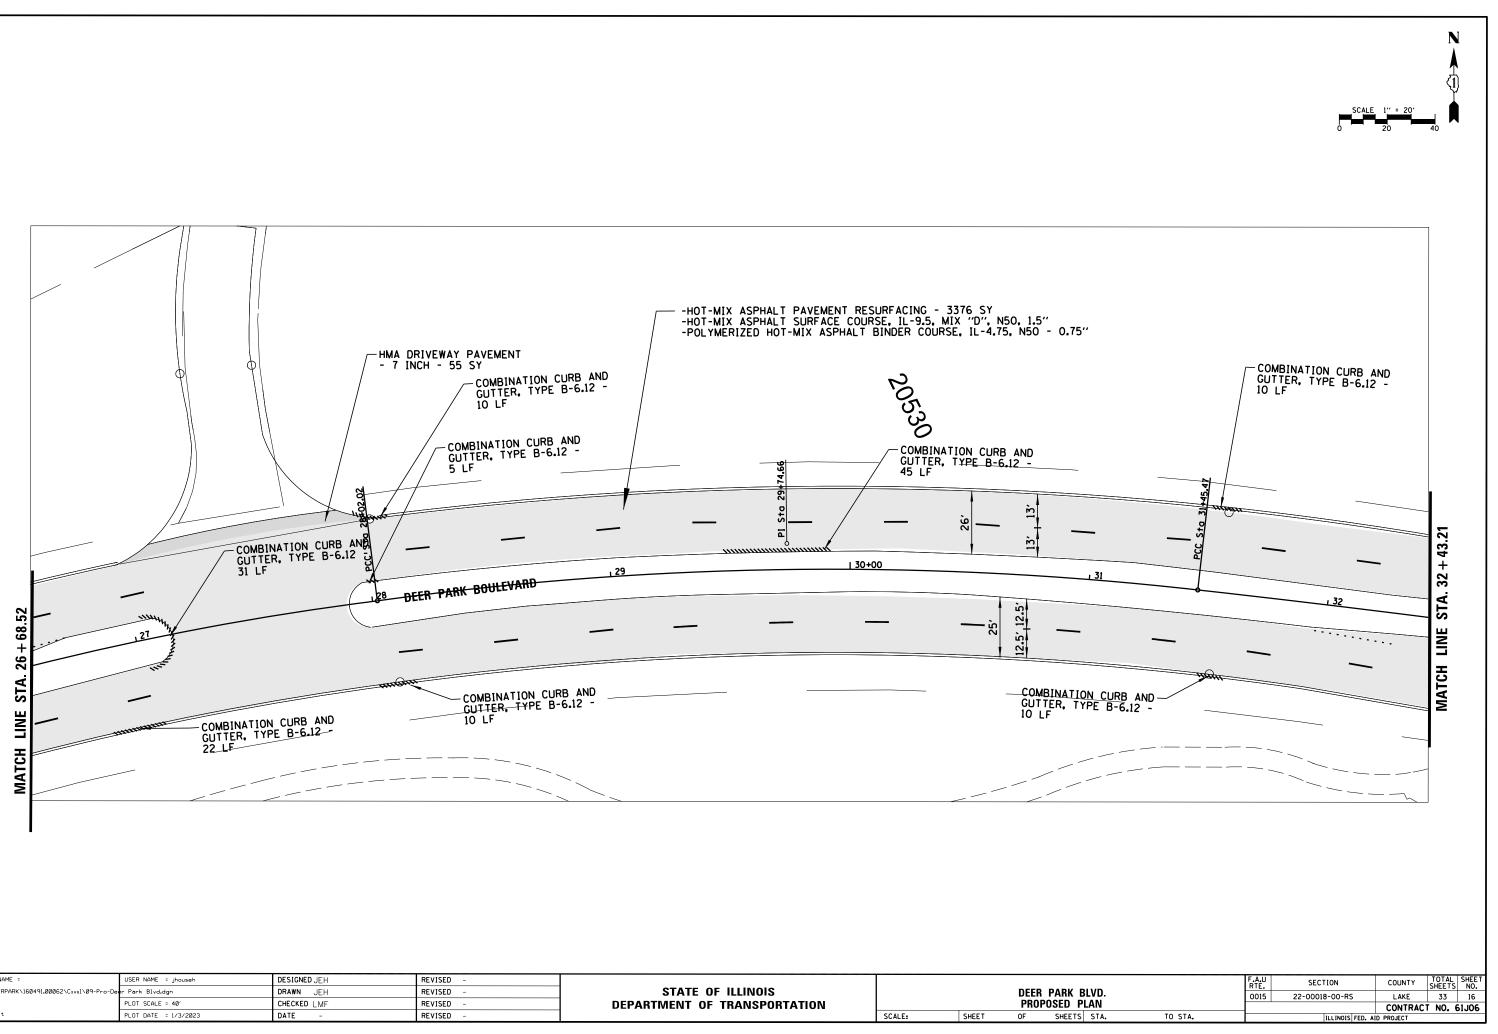


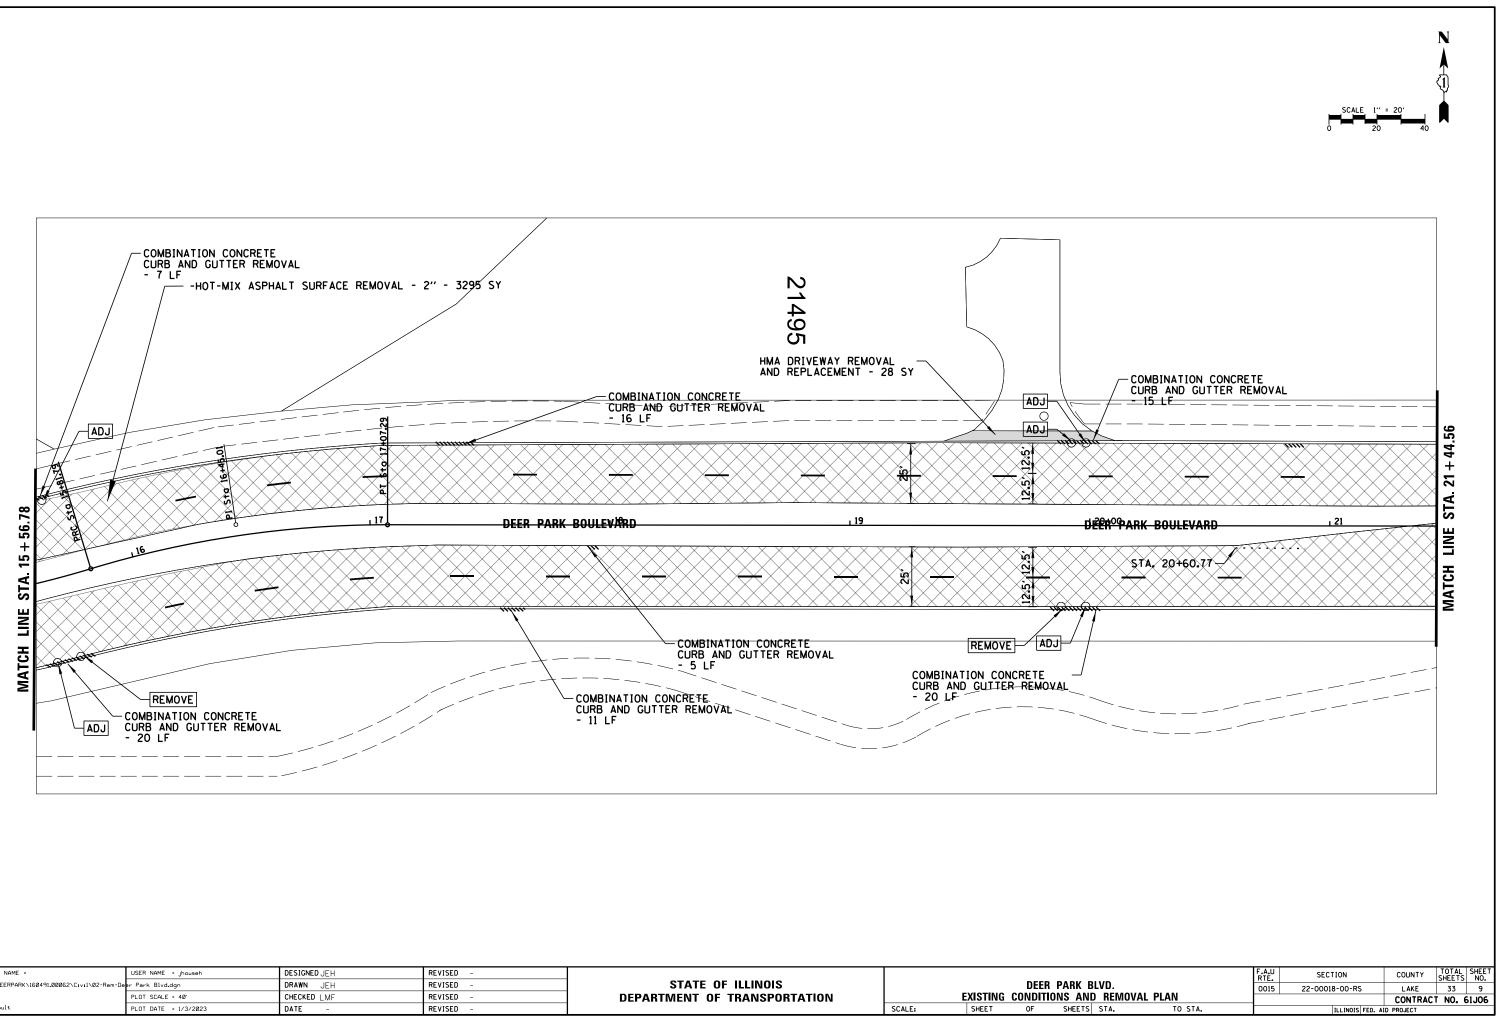


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N:\DEERPARK\160491.00062\C1v11\07-Pro-De	er Park Blvd.dgn	DRAWN JEH	REVISED -	STATE OF ILLINOIS	1		DEER	PARK B
	PLOT SCALE = 40'	CHECKED LMF	REVISED -	DEPARTMENT OF TRANSPORTATION	1		PROP	POSED PL
Default	PLOT DATE = 1/3/2023	DATE -	REVISED -		SCALE:	SHEET	OF	SHEETS

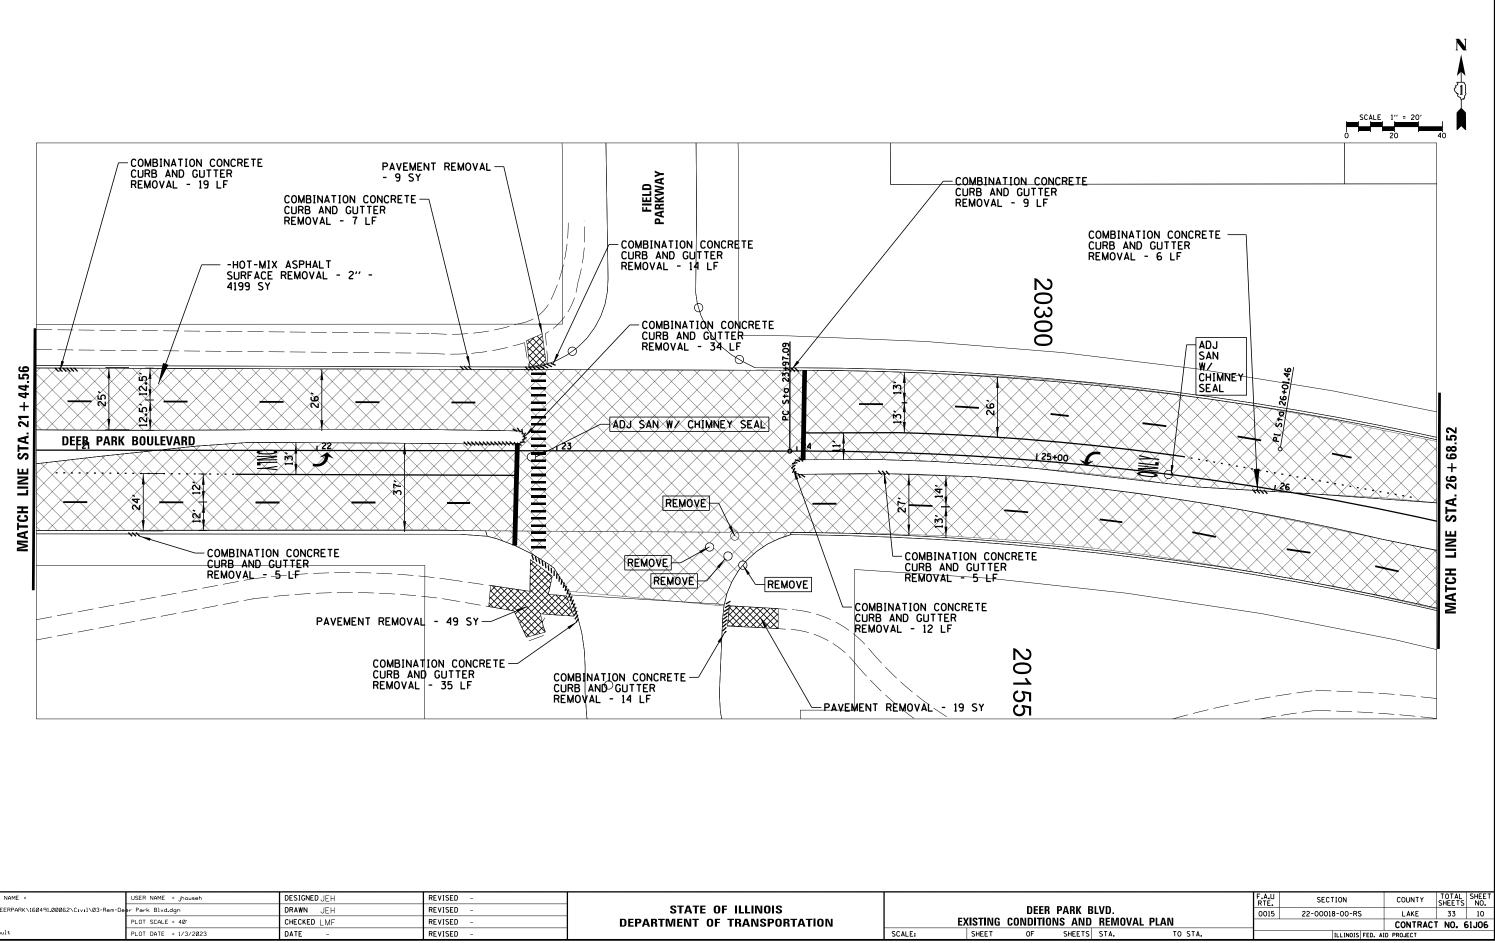


Г	FILE NAME =	USER NAME = Jhouseh	DESIGNED JEH	REVISED -					
	N:\DEERPARK\160491.00062\C1v11\08-Pro-Dee	r Park Blvd.dgn	DRAWN JEH	REVISED -	STATE OF ILLINOIS	1		DEER	PARK B
		PLOT SCALE = 40'	CHECKED LMF	REVISED -	DEPARTMENT OF TRANSPORTATION	1		PROPO	OSED PI
	Default	PLOT DATE = 1/3/2023	DATE -	REVISED -		SCALE:	SHEET	OF	SHEETS
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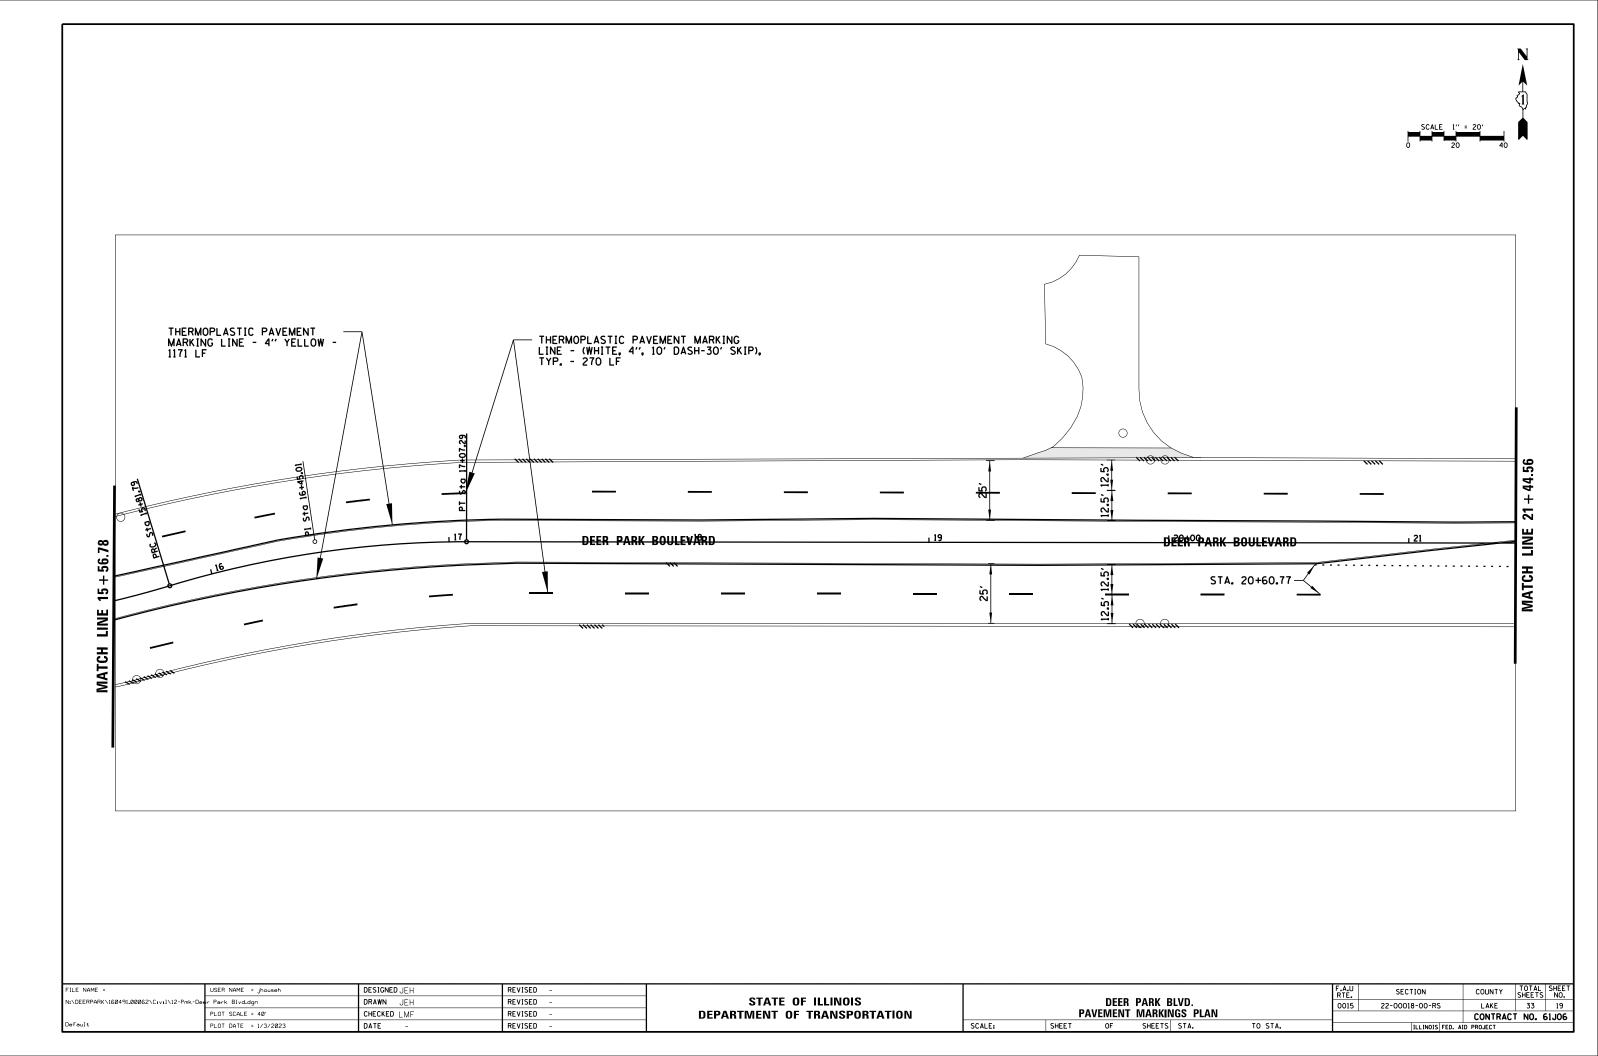
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N:\DEERPARK\160491.00062\Cıvıl\09-Pro-De	r Park Blvd.dgn	DRAWN JEH	REVISED -	STATE OF ILLINOIS			DEER	PARK BL
	PLOT SCALE = 40'	CHECKED LMF	REVISED -	DEPARTMENT OF TRANSPORTATION			PROP	POSED PL
Default	PLOT DATE = 1/3/2023	DATE -	REVISED -		SCALE:	SHEET	OF	SHEETS




FILE NAME =	USER NAME = jhouseh	DESIGNED JEH	REVISED -							F.A.U RTE.	SECTION	COUNTY	TOTAL SHEET SHEETS NO.
N:\DEERPARK\160491.00062\C1v1l\10-Pro-Dee	r Park Blvd.dgn	DRAWN JEH	REVISED -	STATE OF ILLINOIS				PARK BLVD.		0015	22-00018-00-RS	LAKE	33 17
	PLOT SCALE = 40'	CHECKED LMF	REVISED -	DEPARTMENT OF TRANSPORTATION			PROP	POSED PLAN				CONTRA	CT NO. 61J06
Default	PLOT DATE = 1/3/2023	DATE –	REVISED -		SCALE:	SHEET	OF	SHEETS STA.	TO STA.		ILLINOIS FED.	AID PROJECT	

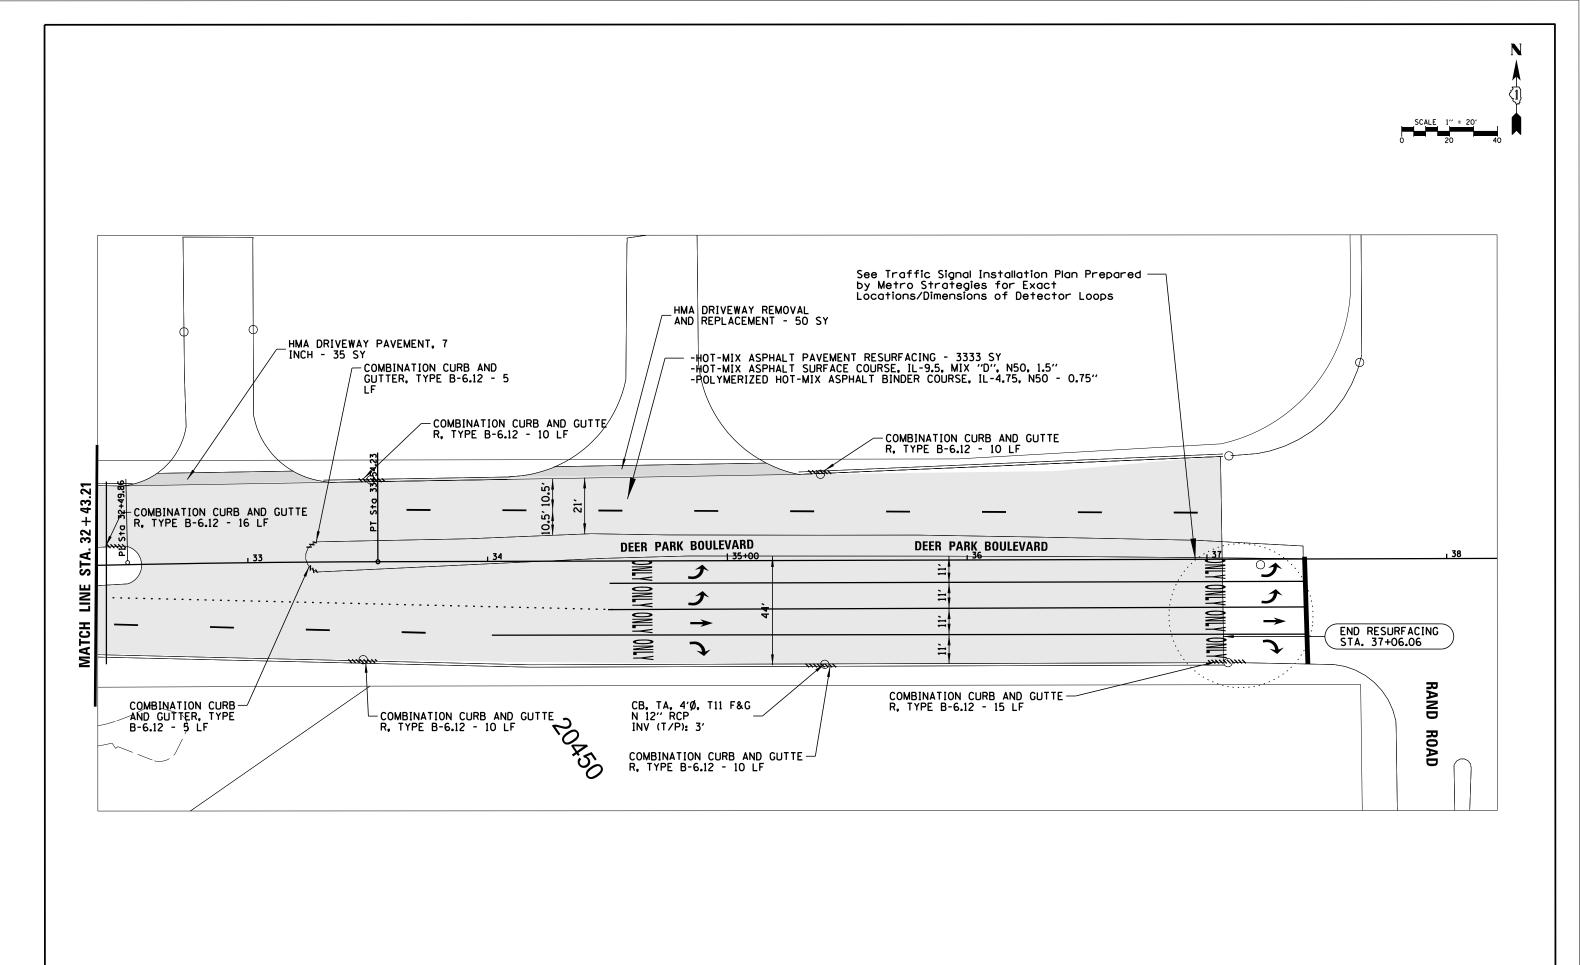



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N:\DEERPARK\160491.00062\Cıvıl\11-Pmk-D	eer Park Blvd.dgn	DRAWN JEH	REVISED -	STATE OF ILLINOIS			DEER	PARK BLVD.		0015	22-00018-00-RS	LAKE	33 18
	PLOT SCALE = 40'	CHECKED LMF	REVISED -	DEPARTMENT OF TRANSPORTATION		P	AVEMEN	T MARKINGS PLAN				CONTRAC	T NO. 61J06
Default	PLOT DATE = 1/3/2023	DATE -	REVISED -		SCALE:	SHEET	OF	SHEETS STA.	TO STA.		ILLINOIS FED. AI	ID PROJECT	

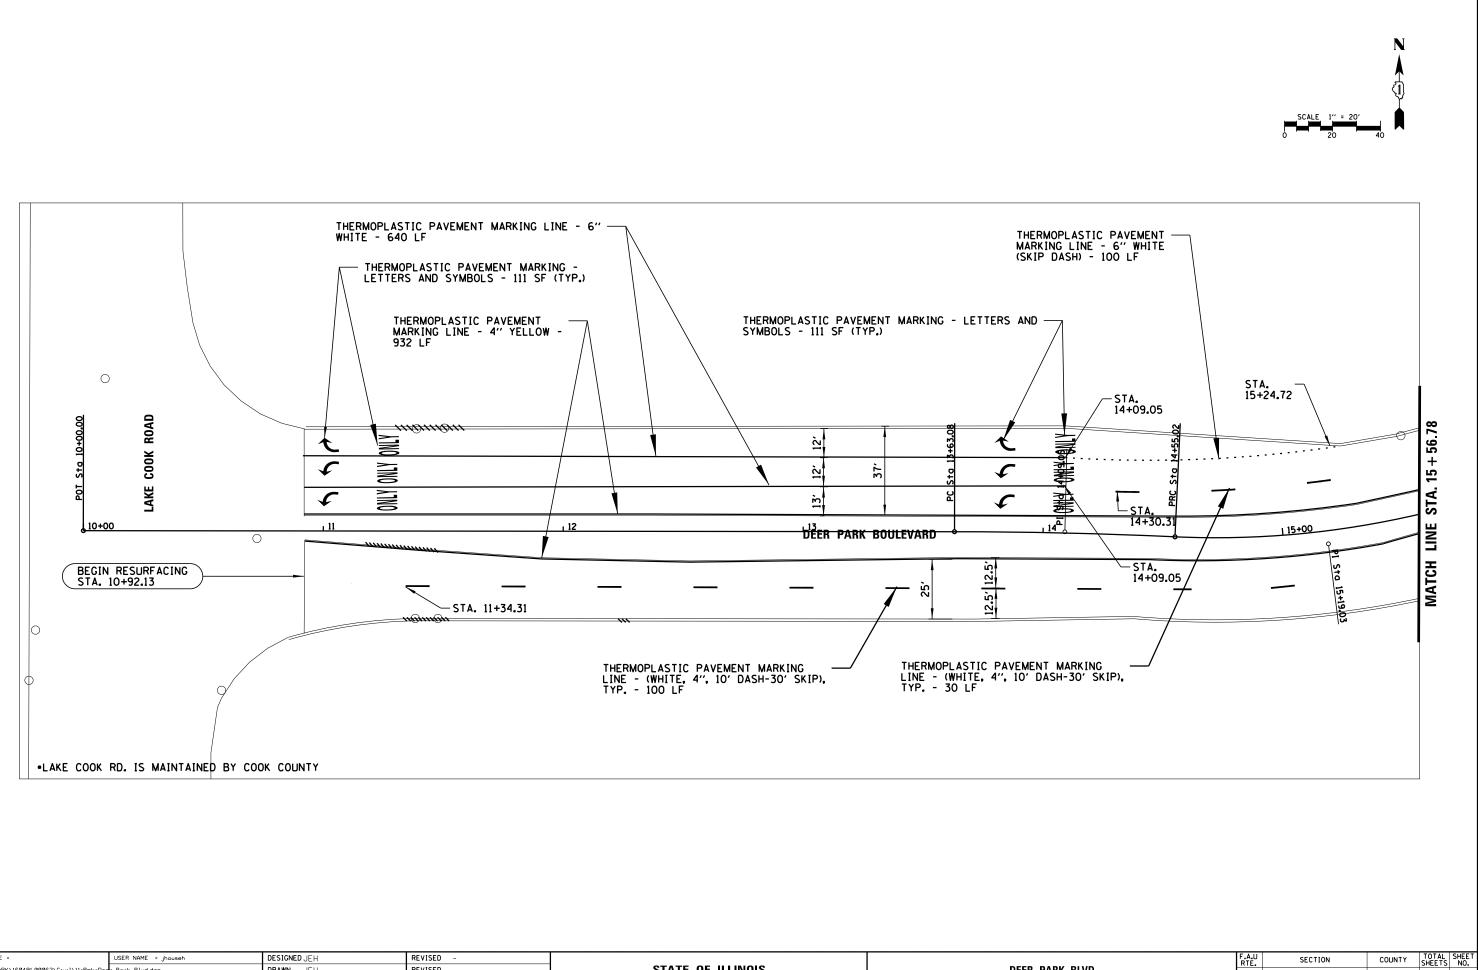

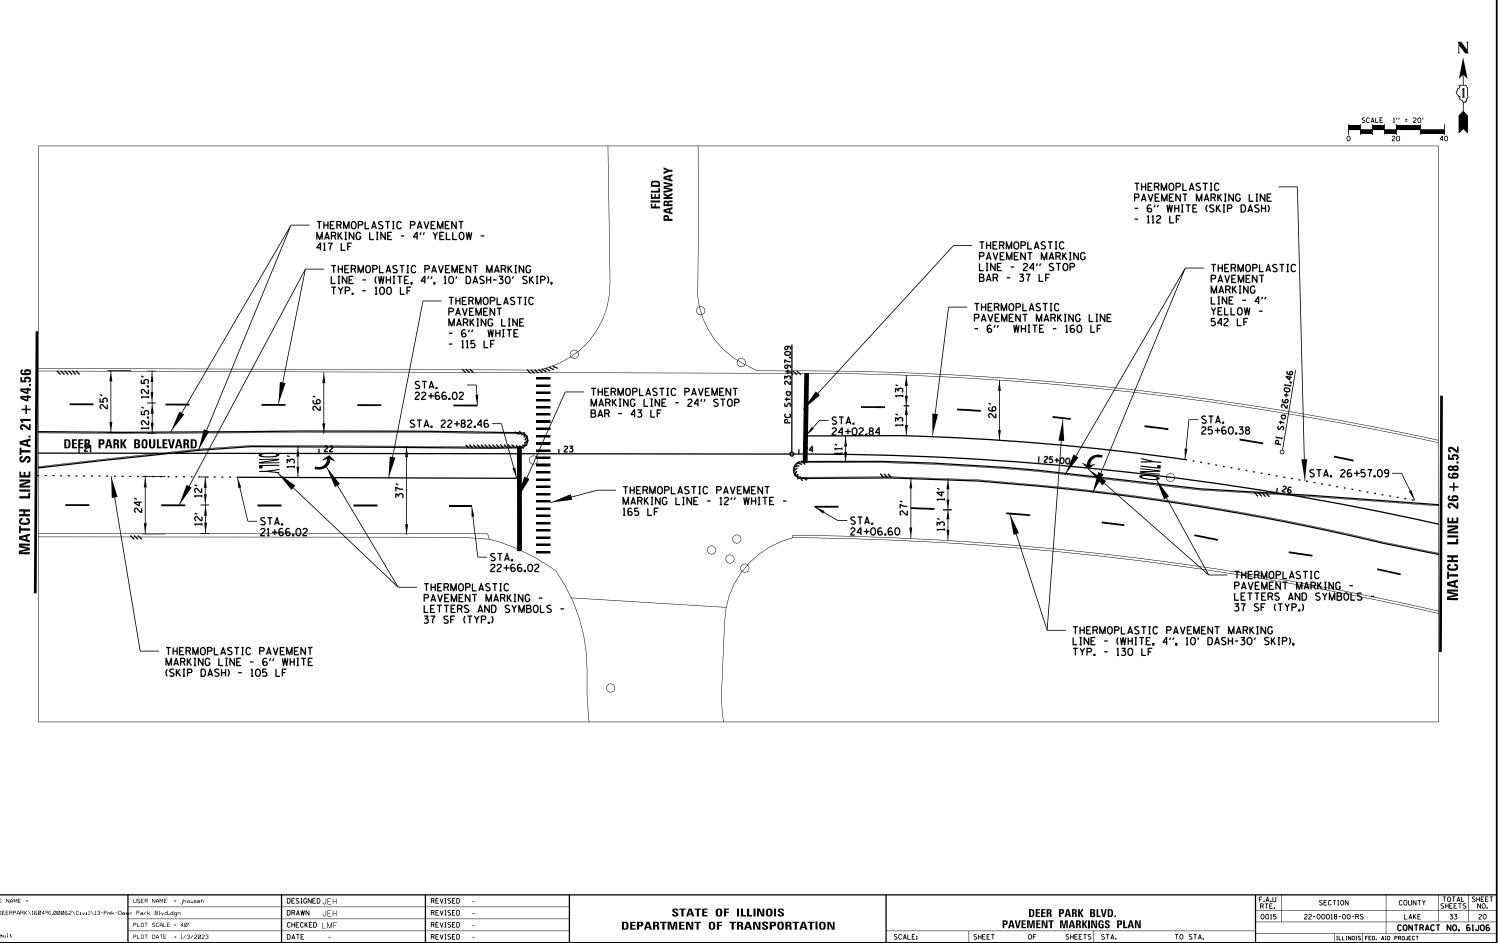

- F									
	FILE NAME =	USER NAME = jhouseh	DESIGNED JEH	REVISED -		1			
	N:\DEERPARK\160491.00062\Cıvıl\13-Pmk-Dee	r Park Blvd.dgn	DRAWN JEH	REVISED -	STATE OF ILLINOIS	1		DEER	PARK B
		PLOT SCALE = 40'	CHECKED LMF	REVISED -	DEPARTMENT OF TRANSPORTATION	1	PA	VEMENT	MARKIN
	Default	PLOT DATE = 1/3/2023	DATE -	REVISED -		SCALE:	SHEET	OF	SHEETS

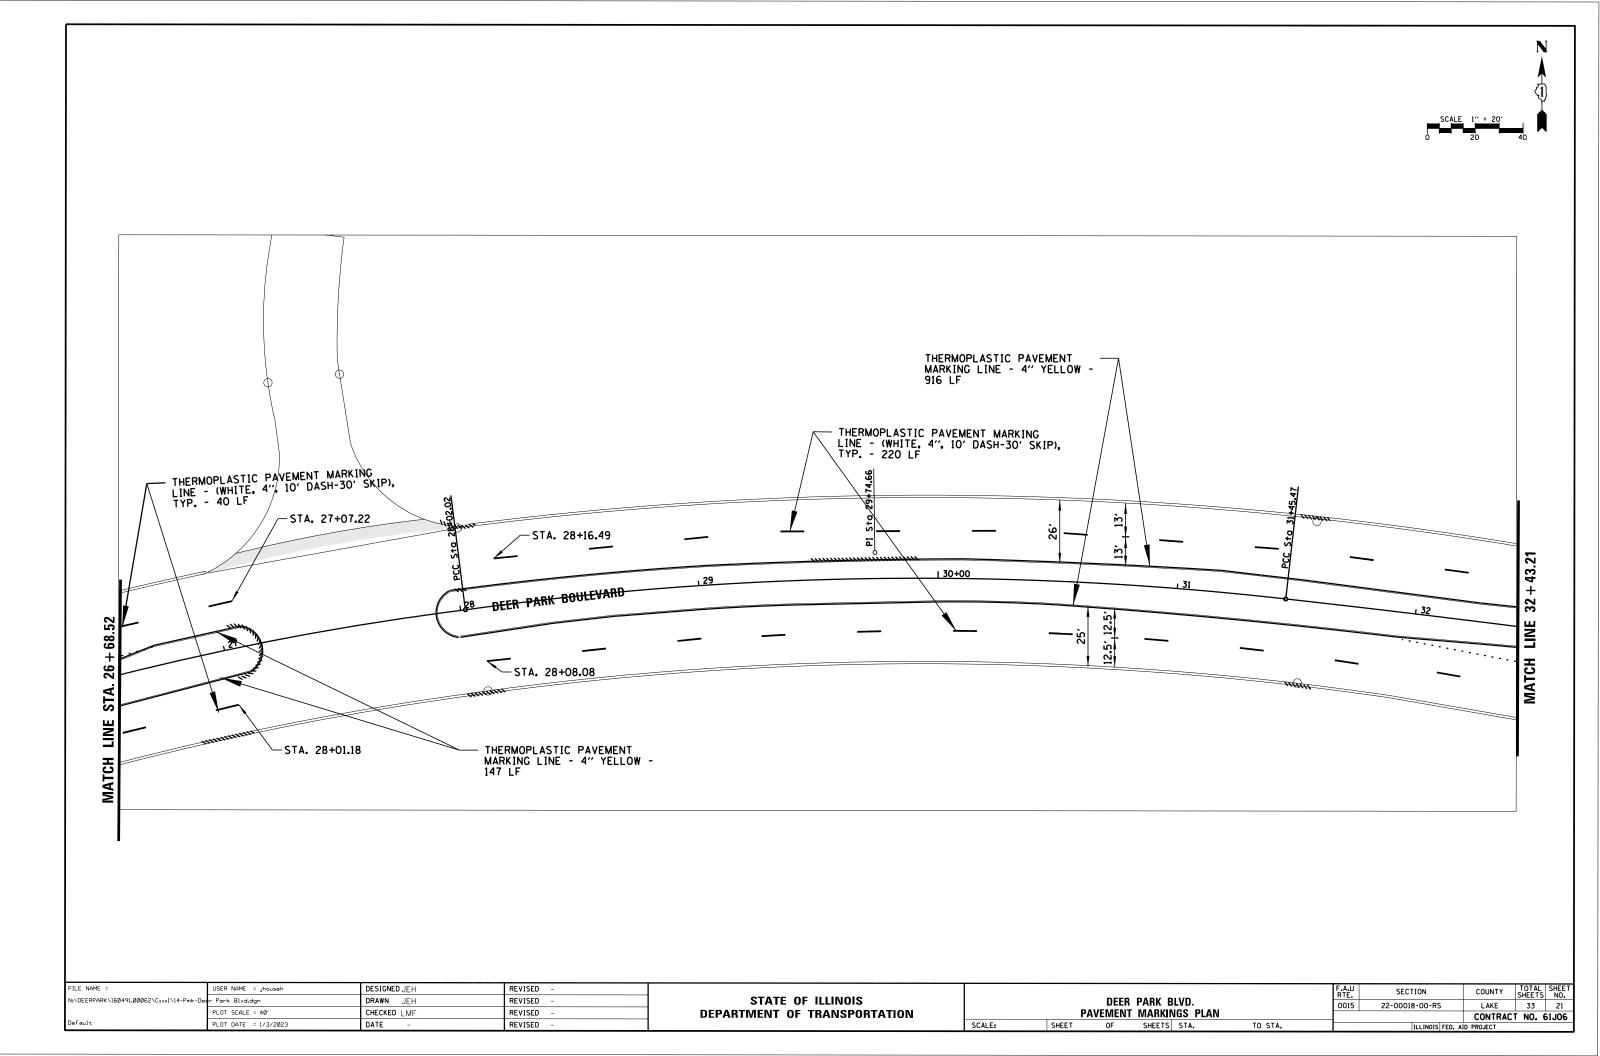

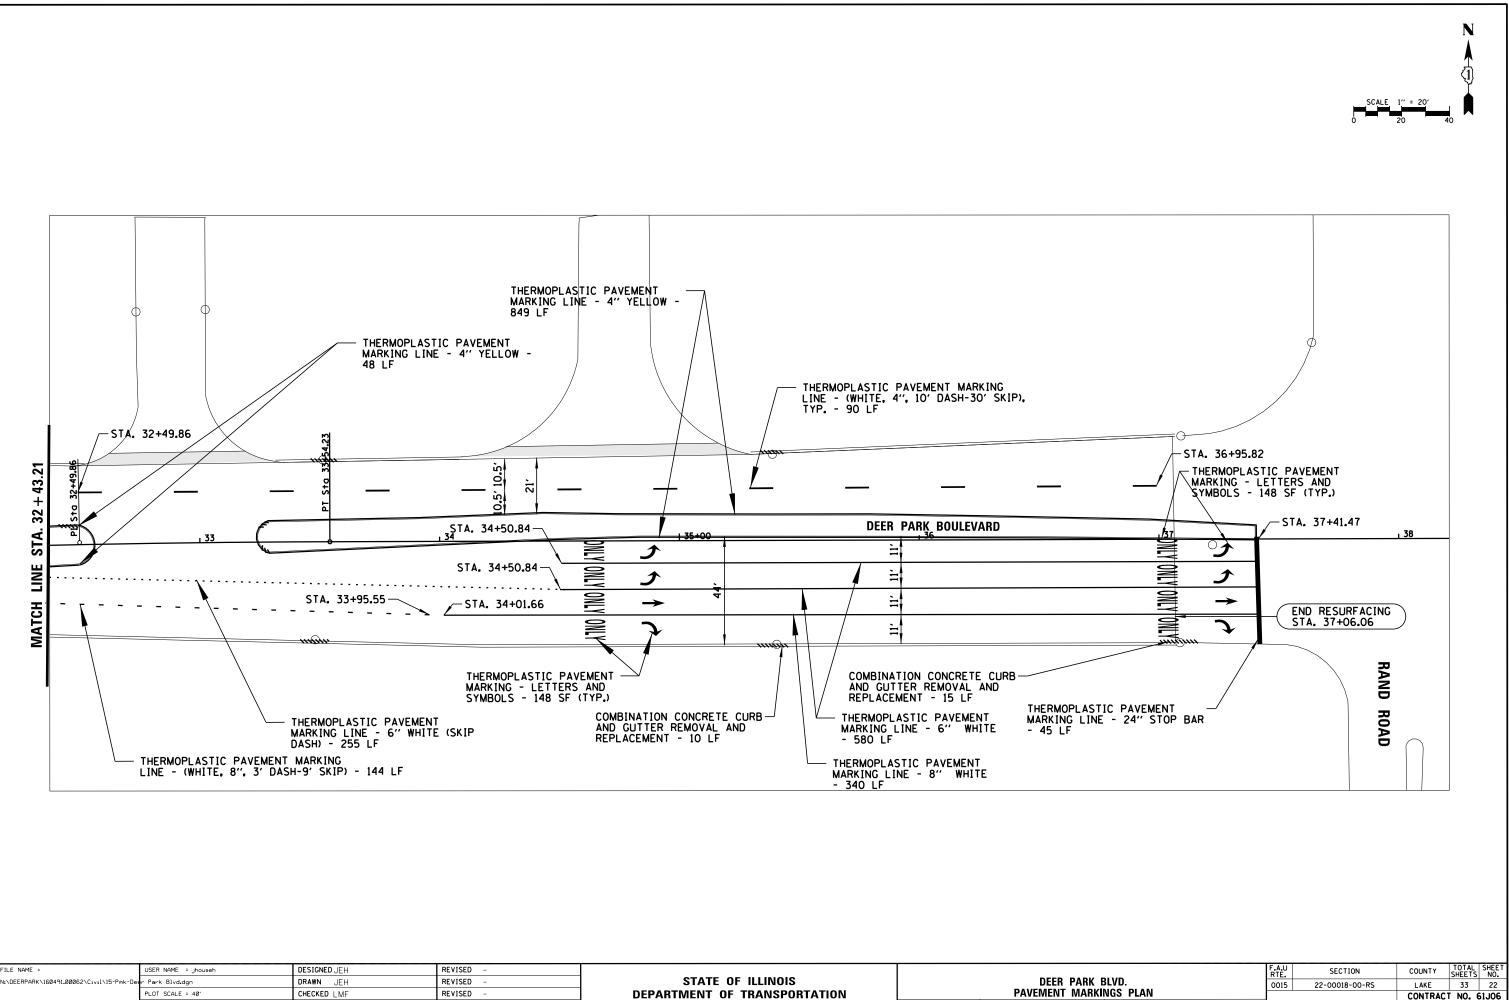

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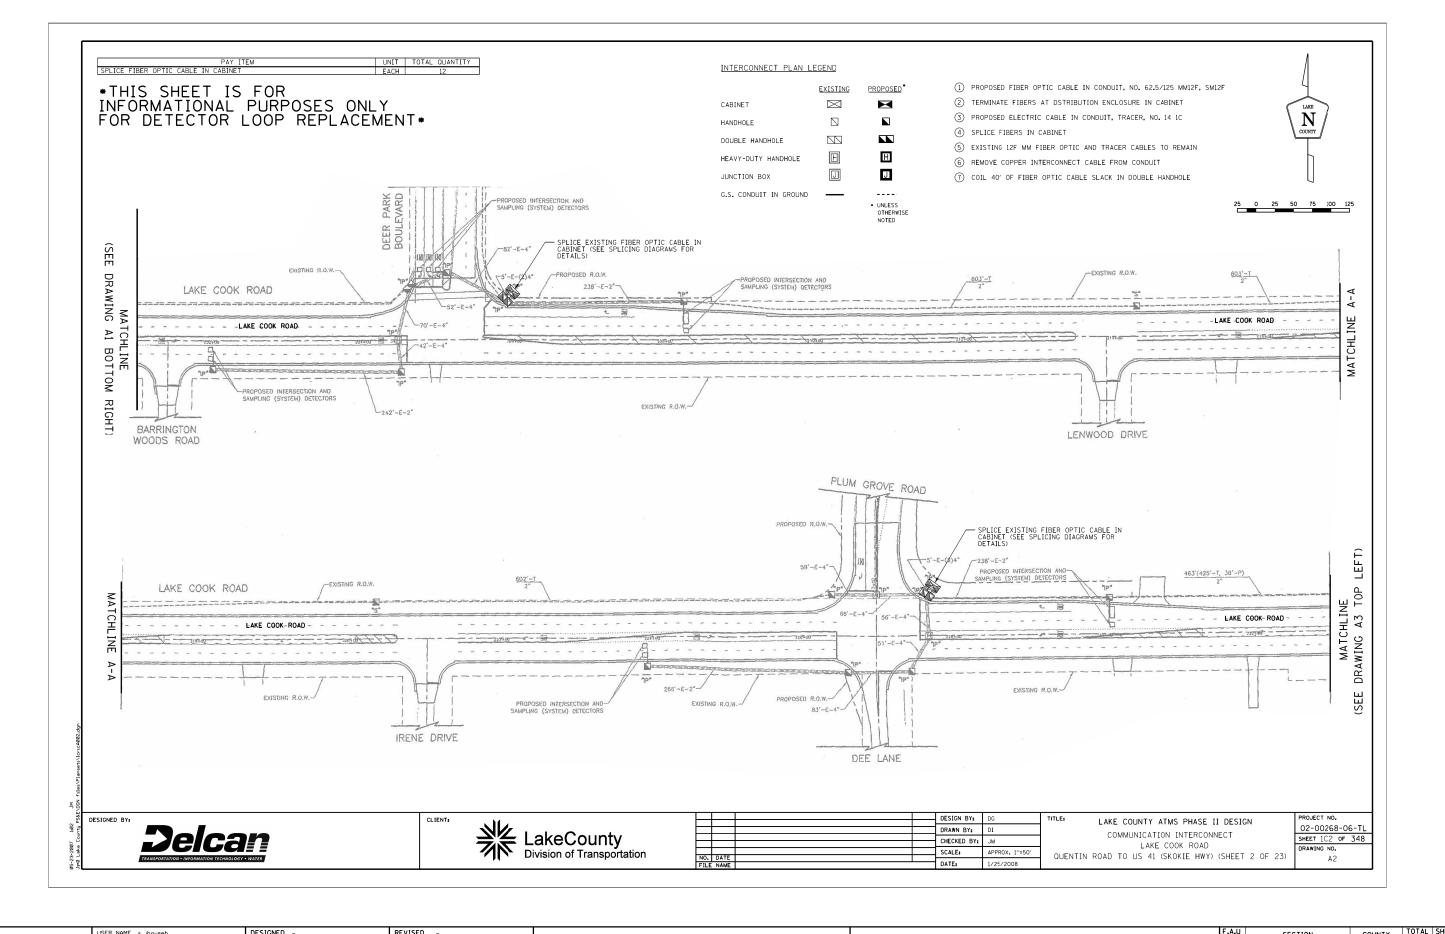
DATE

PLOT DATE = 1/3/2023

REVISED


PAVEMENT MARK SCALE: SHEET 0F

			F.A.U RTE.	SECTION	COUNTY	TOTAL SHEETS	SHEET NO.
	LVD.		0015	22-00018-00-RS	LAKE	33	22
	IGS PLAN				CONTRACT	NO. 6	51J06
SHEETS	STA.	TO STA.		ILLINOIS FED. A	D PROJECT		




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	PLOT SCALE = 33'	CHECKED -	REVISED -	DEPARTMENT OF TRANSPORTATION	1		SIGN	ial plan
Default	PLOT DATE = 1/3/2023	DATE -	REVISED -		SCALE: NTS	SHEET	OF	SHEETS

		F.A.U RTE.	SECTION	COUNTY	TOTAL SHEETS	SHEET NO.	
	BLVD.		0015	22-00018-00-RS	LAKE	33	23
ANS				CONTRAC	T NO. (51J06	
S	STA.	TO STA.		ILLINOIS FED. A	ID PROJECT		

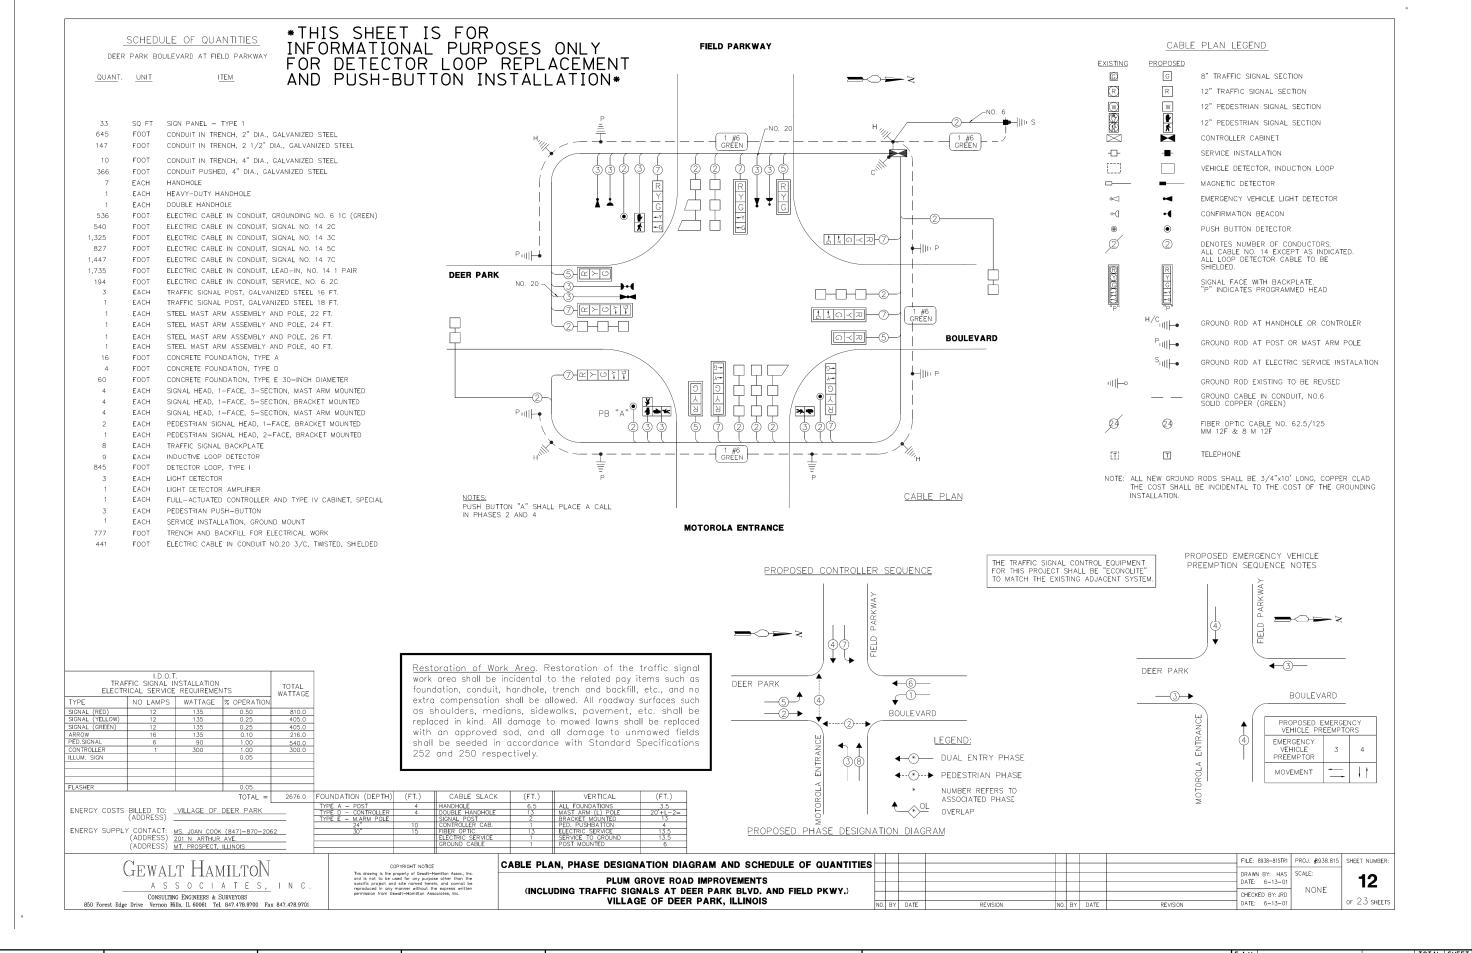


FILE NAME = DESIGNED USER NAME = jhouseh REVISED STATE OF ILLINOIS N:\DEERPARK\160491.00062\Civil\SIG_00062 02.sht DRAWN REVISED DEER PARK **DEPARTMENT OF TRANSPORTATION** PLOT SCALE = 30 CHECKED REVISED SIGNAL PL SCALE: NTS SHEET PLOT DATE = 1/3/2023 DATE REVISED SHEET OF

BLVD. ANS		F.A.U RTE.	SECTION	COUNTY	TOTAL SHEETS	SHEET NO.	
		0015	22-00018-00-RS	LAKE	33	24	
				CONTRAC	Γ NO. 6	51J06	
TS	STA.	TO STA.		ILLINOIS FED. A	D PROJECT		

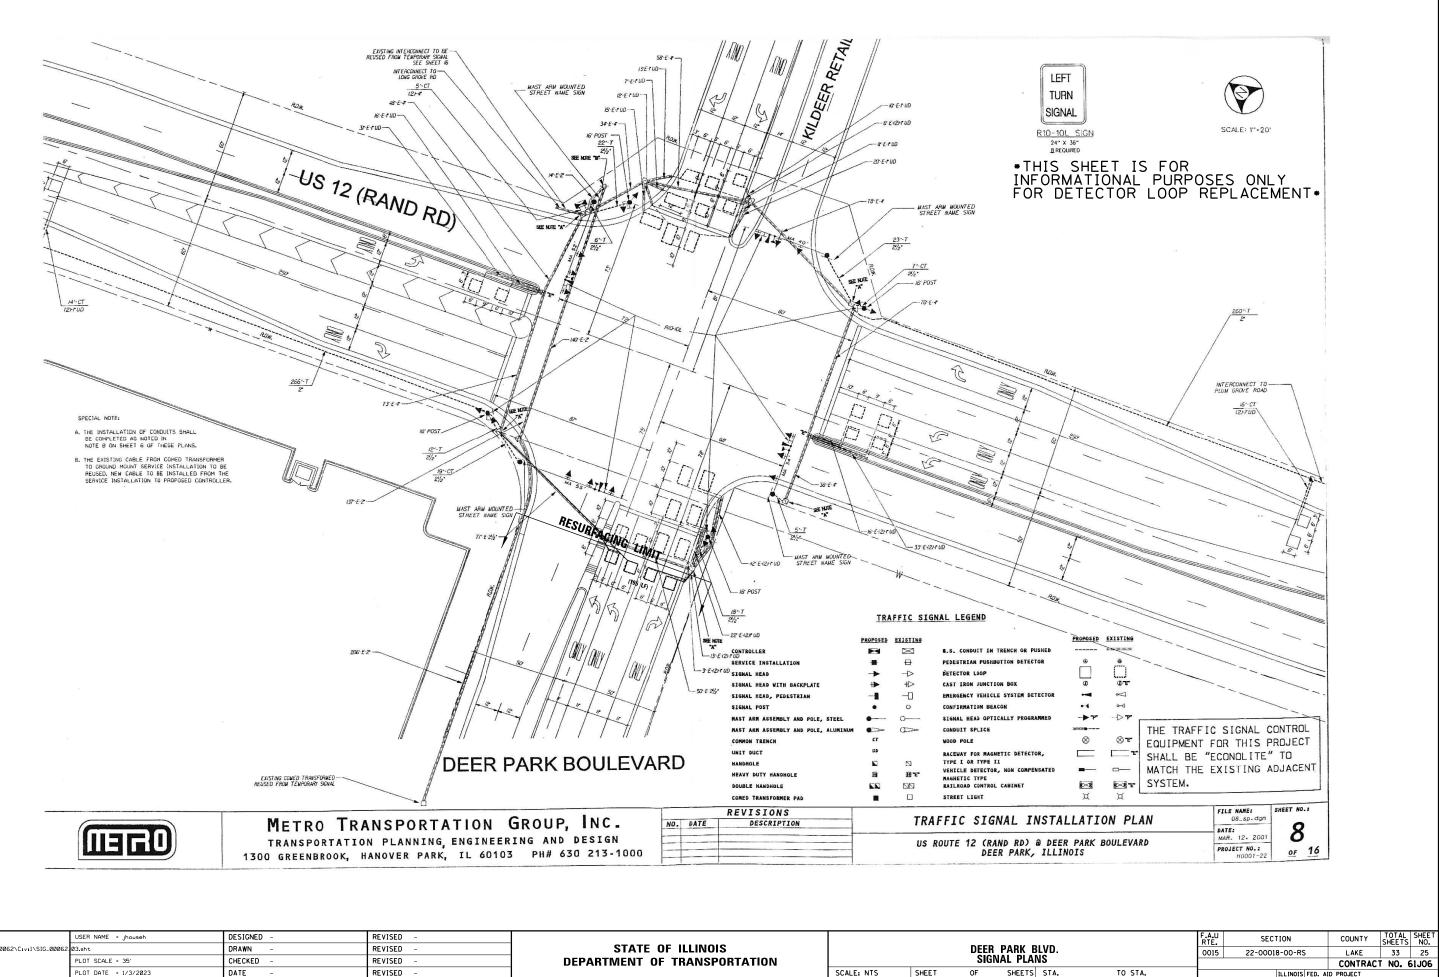

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	PLOT SCALE = 35'	CHECKED -	REVISED -	DEPARTMENT OF TRANSPORTATION			SIGI	NAL PLAN
Default	PLOT DATE = 1/3/2023	DATE -	REVISED -		SCALE: NTS	SHEET	OF	SHEETS

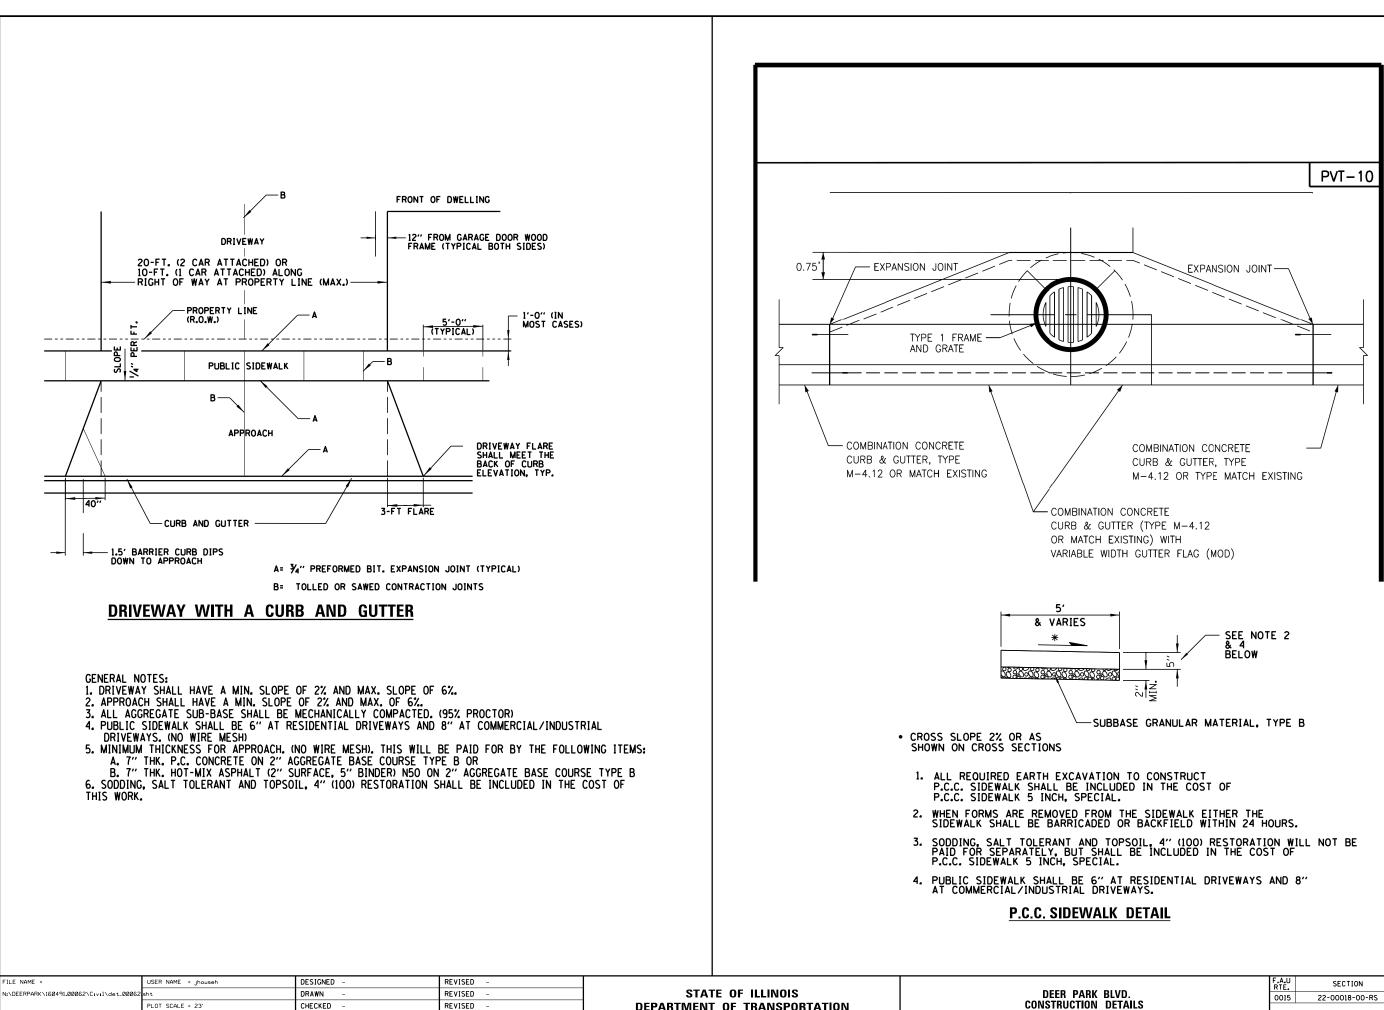

DEPARTMENT OF TRANSPORTATION CHECKED REVISED SCALE: NTS PLOT DATE = 1/3/2023 DATE REVISED

efault

SHEET

			F.A.U RTE.	SECTION	COUNTY	TOTAL SHEETS	SHEET NO.
BLVD.		0015	22-00018-00-RS	LAKE	33	26	
L	ETAILS				CONTRAC	T NO. 6	51J06
TS	STA.	TO STA.		ILLINOIS FED. A	ID PROJECT		

CONSTRUCTION PROCEDURES

- STAGE 1 (BEFORE PAVEMENT MILLING) AROUND THE STRUCTURE.

 - METAL PLATE.
 - AFTER MILLING).
- STAGE 2 (AFTER PAVEMENT MILLING)
- FINAL SURFACE ELEVATION.

THE PROCEDURE EXPLAINED ABOVE SHALL CONFORM TO THE APPLICABLE PORTIONS OF SECTIONS 353, 406, 602, AND 603 OF THE STANDARD SPECIFICATIONS EXCEPT THAT "THE CONTRACTOR SHALL ADJUST THE STRUCTURES TO THE FINISHED PAVEMENT ELEVATION NO MORE THAN 5 CALENDAR DAYS PRIOR TO PLACEMENT OF THE FINAL LIFT OF SURFACE UNLESS APPROVED BY THE ENGINEER."


- ① SUB-BASE GRANULAR MATERIAL
- (2) EXISTING PAVEMENT
- (3) 36 (900) DIAMETER META
- (4) PROPOSED CRUSHED STO HMA SURFACE MIX
- (5) EXISTING STRUCTURE

LOCATION OF STRUCTURES

BASIS OF PAYMENT

- (SPECIAL)."
- RECONSTRUCTION.
- 3. NEW FRAMES AND LIDS, WHEN SPECIFIED, WILL BE PAID FOR SEPARATELY.

SCALE: NONE

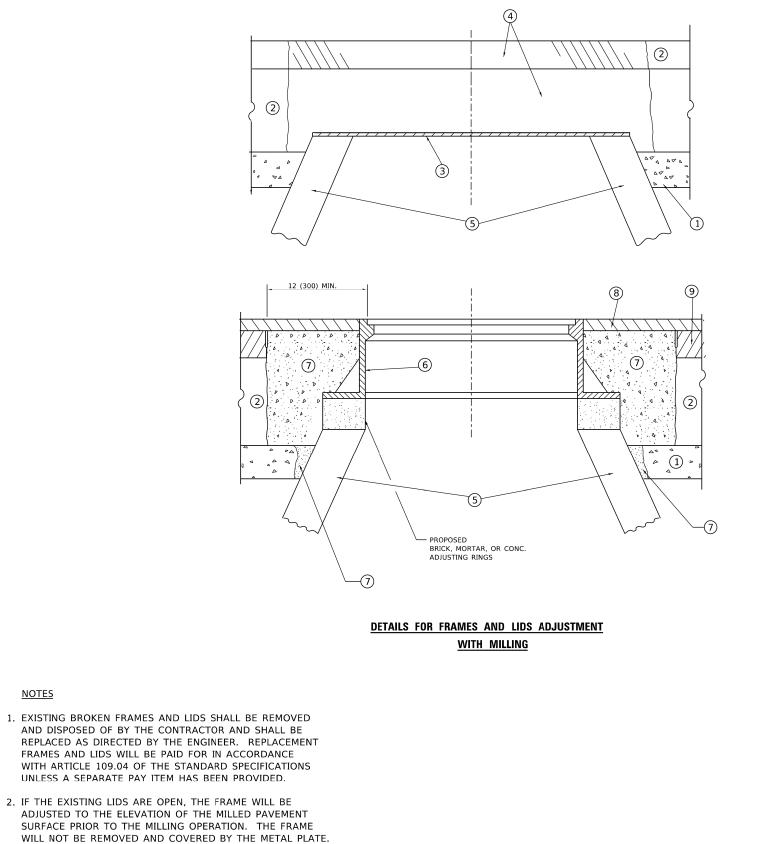

3. CITY OF CHICAGO CASTINGS ARE THE PROPERTY OF THE CITY AND THE CONTRACTOR SHALL NOTIFY THE CITY FOR REMOVAL AND DISPOSITION OF THE CASTINGS.

<u>NOTES</u>

4. THE METAL PLATE USED TO COVER THE STRUCTURE SHALL REMAIN THE PROPERTY OF THE CONTRACTOR.

JSER NAME = demanchelt DESIGNED -R. SHAH REVISED - R. BORO 01-01-07 DRAWN REVISED - R. BORO 03-09-11 PLOT SCALE = 100.0000 ' / in. HECKED REVISED - R. BORO 12-06-11 PLOT DATE = 2/2/2022 10-25-94 DATE REVISED - K. SMITH 02-01-22

STATE OF ILLINOIS **DEPARTMENT OF TRANSPORTATION**

FRAMES AND LIDS ADJUSTMENT WITH MILLING	33	27
BD600–03 (BD–08) CONTRAC	T NO. 61.	J06
SHEET 1 OF 1 SHEETS STA. TO STA. II.LINOIS FED. AID PROJECT		

A) REMOVE A MINIMUM OF 12 (300) OF THE PAVEMENT FROM B) REMOVE THE EXISTING FRAME AND LID FROM THE STRUCTURE. C) COVER THE STRUCTURE OPENING WITH A 36 (900) DIAMETER

D) BACKFILL WITH CRUSHED STONE AND HMA SURFACE MIX APPROVED BY THE ENGINEER. (MIN. 1 1/2 (40) HMA TO REMAIN

A) REMOVE THE HMA SURFACE MIX AND CRUSHED STONE. B) INSTALL THE FRAME AND LID; ADJUST THE FRAME TO ITS C) THE SURROUNDING SPACE SHALL BE FILLED WITH CLASS*PP-1 CONCRETE TO THE ELEVATION OF THE SURFACE OF THE EXISTING BASE COURSE OR THE BINDER COURSE. * UNLESS OTHERWISE SPECIFIED IN THE PLANS.

LEGEND

	6 FRAME AND LID (SEE NOTES)
	(7) CLASS*PP-1 CONCRETE
AL PLATE ONE AND	(8) PROPOSED HMA SURFACE COURSE
	(9) PROPOSED HMA BINDER COURSE


THE CONTRACTOR WILL BE REQUIRED TO KEEP A RECORD OF THE LOCATIONS OF THE BURIED STRUCTURES ACCORDING TO THE STATION AND DISTANCE LEFT OR RIGHT OF THE CENTERLINE OF PAVEMENT. UPON COMPLETION OF THE WORK, THE CONTRACTOR WILL DELIVER THE RECORD TO THE ENGINEER.

1. REMOVING FRAMES AND LIDS ON DRAINAGE AND UTILITY STRUCTURES IN THE PAVEMENT PRIOR TO MILLING, AND ADJUSTING TO FINAL GRADE PRIOR TO PLACING THE SURFACE COURSE, WILL BE PAID FOR AT THE CONTRACT UNIT PRICE EACH FOR "FRAMES AND LIDS TO BE ADJUSTED

2. THIS WORK WILL NOT BE PAID FOR WHEN DRAINAGE AND UTILITY STRUCTURES ARE SPECIFIED FOR PAYMENT AS STRUCTURE

4. WHEN STRUCTURES ARE TO BE ADJUSTED OR RECONSTRUCTED, THE LOWERING AND RAISING OF THE FRAMES AND LIDS WILL NOT BE PAID FOR SEPARATELY BUT WILL BE INCLUDED IN THE COST OF THE CORRESPONDING PAY ITEM.

ALL DIMENSIONS ARE IN INCHES (MILLIMETERS) UNLESS OTHERWISE SHOWN

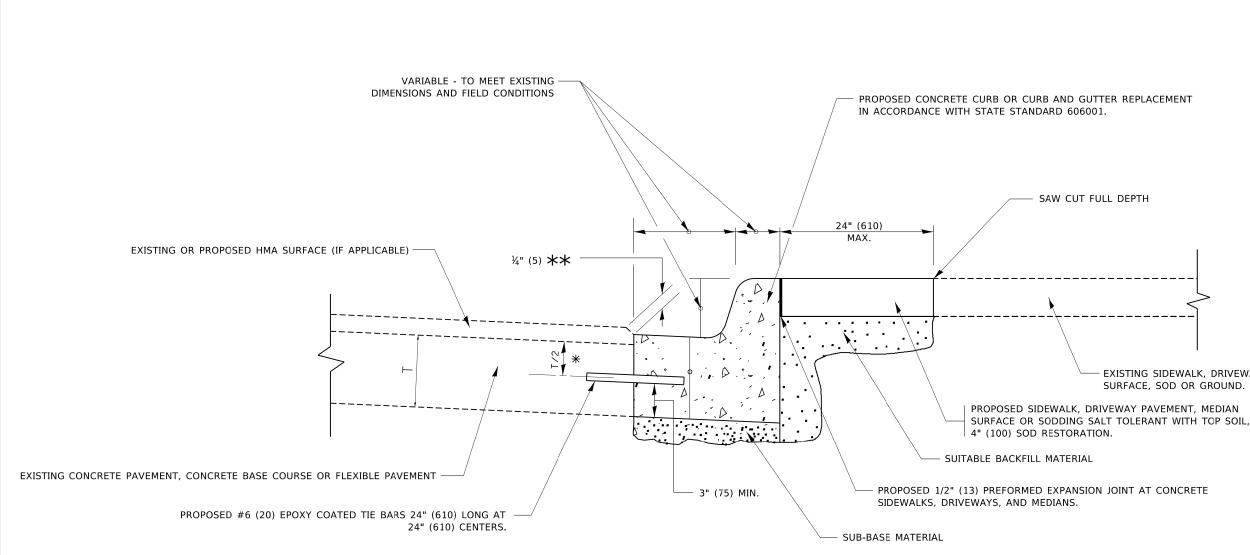

★ 3" (75) MINIMUM FROM TOP AND BOTTOM OF THE CONCRETE PAVEMENT OR BASE COURSE.

 $\star\star$ if the final surface of the pavement is concrete, the gutter is to be flush WITH THE PAVEMENT.


CURB OR CURB AND GUTTER REMOVAL AND REPLACEMENT

efault : pw:	USER NAME = footemj	DESIGNED - A. HOUSEH	REVISED - A. ABBAS 03-21-97			CURB OR CURB AND GUTTER		F.A. SECTION	COUNTY TOTAL SHEET
L: De		DRAWN -	REVISED - M. GOMEZ 01-22-01	STATE OF ILLINOIS		REMOVAL AND REPLACEMENT		0015 22-00018-00-RS	LAKE 33 28
ODE LE N	PLOT SCALE = 50.0000 ' / in.	CHECKED -	REVISED - R. BORO 12-15-09	DEPARTMENT OF TRANSPORTATION		REIVIUVAL AND REPLACEIVIENT		BD600–06 (BD–24)	CONTRACT NO. 61J06
ΣE	PLOT DATE = 7/11/2019	DATE - 03-11-94	REVISED - K. SMITH 07-11-19		SCALE: NONE	SHEET 1 OF 1 SHEETS STA.	TO STA.	ILLINOIS FED. A	AID PROJECT

EXISTING SIDEWALK, DRIVEWAY, MEDIAN SURFACE, SOD OR GROUND.




ALL DIMENSIONS ARE IN INCHES (MILLIMETERS) UNLESS OTHERWISE SHOWN.

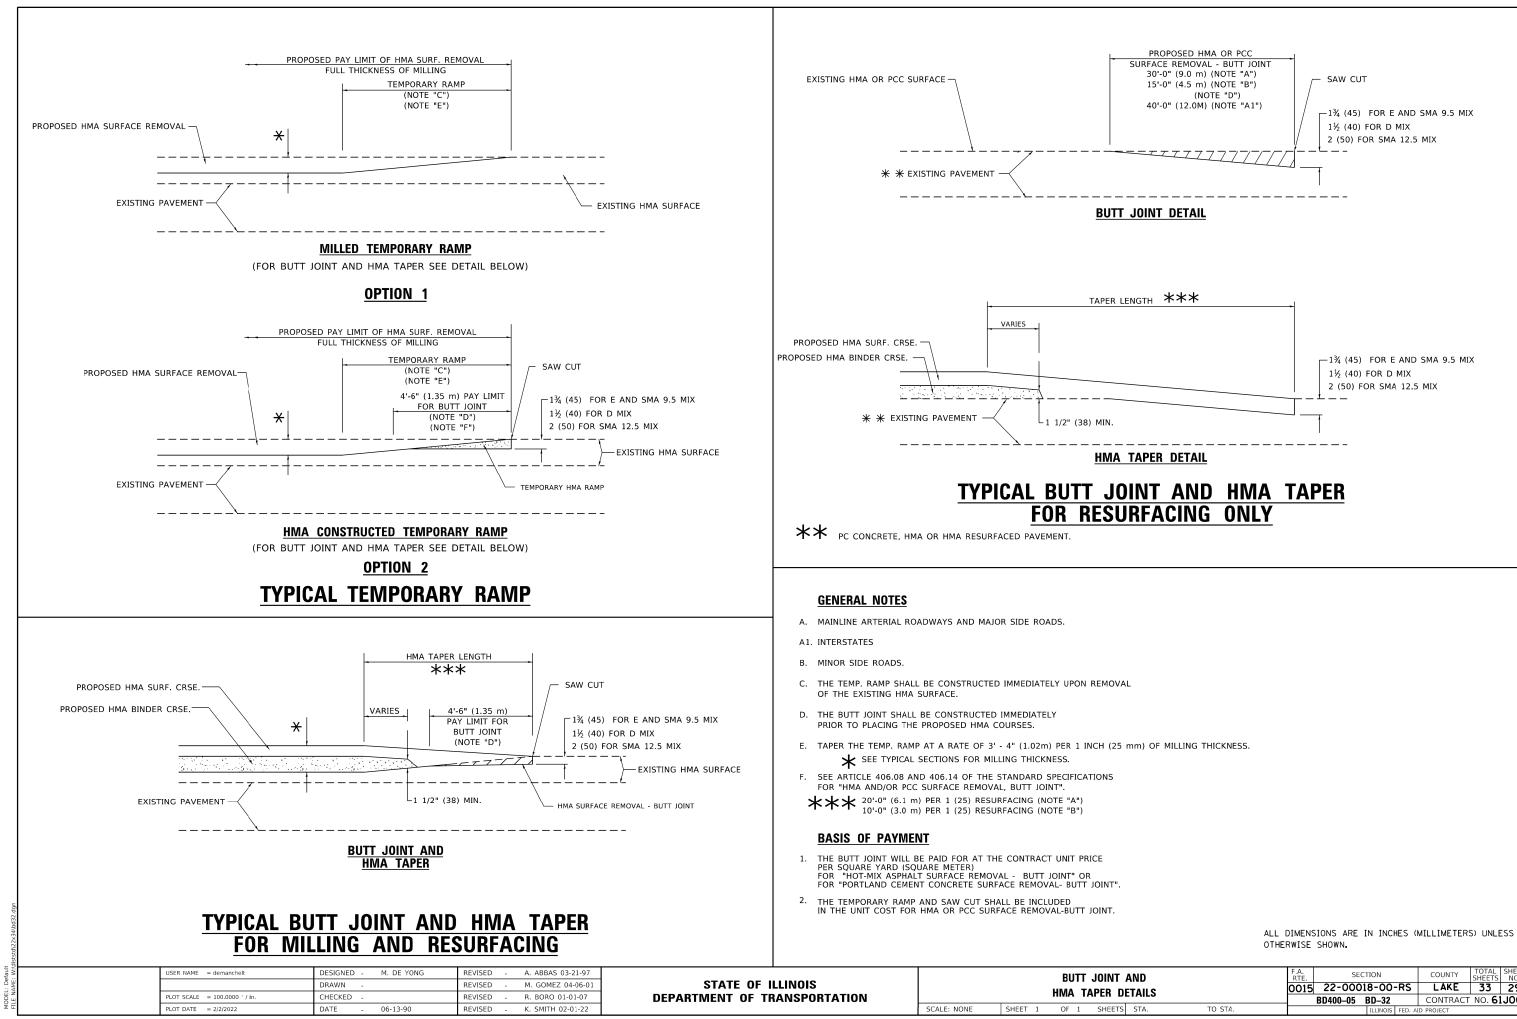



T AND DETAILS		SEC	CTION		COUNTY	TOTAL SHEETS	SHEET NO.
		22-000	18-00-	·RS	LAKE	33	29
		BD400-05	BD-32		CONTRACT	NO. 61	J06
TS STA. TO STA.			ILLINOIS	FED. AI	D PROJECT		

	IS 1980 IS 19800 IS 19800 IS 19800 IS 19800 IS 19800 IS 19800 IS 198
	 NOTES: 1. SIDE ROAD WITH A SPEED LIMIT OF 40 MPH (60 km/h) OR LESS AS SHOWN ON THE DRAWING AND AS DIRECTED BY THE ENGINEER: a) ONE "ROAD CONSTRUCTION AHEAD" SIGN 36 × 36 (900×900) WITH A FLASHER MOUNTED ON IT APPROXIMATELY 200' (60 m) IN ADVANCE OF THE MAIN ROUTE. b) THE CLOSED PORTION OF THE MAIN ROUTE SHALL BE PROTECTED BY BLOCKING WITH THE TRAFFIC CONTROL SET-UP. c) ONE "ROAD WITH A SPEED LIMIT GREATER THAN 40 MPH (60 km/h) AS SHOWN ON THE DRAWING AND AS DIRECTED BY THE ENGINEER: a) ONE "ROAD CONSTRUCTION AHEAD" SIGN 48 × 48 (1.2 m × 1.2 m) WITH A FLASHER MOUNTED ON IT APPROXIMATELY 500' (150 m) IN ADVANCE OF THE MAIN ROUTE. c) ONE "ROAD CONSTRUCTION AHEAD" SIGN 48 × 48 (1.2 m × 1.2 m) WITH A FLASHER MOUNTED ON IT APPROXIMATELY 500' (150 m) IN ADVANCE OF THE CLOSED PORTION. c) ONE "ROAD CONSTRUCTION OF THE MAIN ROUTE SHALL BE PROTECTED BY BLOCKING WITH TYPE III BARRICADES, 1/2 OF THE CROSS SECTION OF THE CLOSED PORTION. c) THE CLOSED PORTION OF THE MAIN ROUTE SHALL BE PROTECTED BY BLOCKING WITH TYPE III BARRICADES, 1/2 OF THE CROSS SECTION OF THE CLOSED PORTION. c) THE CLOSED PORTION OF THE MAIN ROUTE SHALL BE PROTECTED BY BLOCKING WITH TYPE III BARRICADES, 1/2 OF THE CROSS SECTION OF THE CLOSED PORTION. c) THE CLOSED PORTION OF THE MAIN ROUTE SHALL BE PROTECTED BY BLOCKING WITH TYPE III BARRICADES, 1/2 OF THE CROSS SECTION OF THE CLOSED PORTION. c) THE CLOSED PORTION. CONES SHALL BE A MINIMUM OF 28 (710) IN APPROXIMATELY 500' (150 m) IN ADVANCE OF THE CLOSED PORTION. c) THE CLOSED PORTION. CONES SHALL BE A MINIMUM OF 28 (710) IN HEIGHT. wHEIGHT. wHEN THE SIDE ROAD LIES BETWEEN THE BEGINNING OF THE MAINLINE SIGNING AND THE WERE RORD AND AND REPROPORAMING (MS-1) SHALL
FILE NAME = USER NAME = footemj DESIGNED - L.H.A. REVISED - A. HOUSEH 10-15-96 pw:\\lL084EBID:NTEG.illinois.gov;PWIDDT\Documents\IDOT Offices\District \Projects\District \Projects\District\Projects\District\Projects\District \Projects\District \Projects	BE USED IN LIEU OF THE DOUBLE HEADED ARROW (M6-4). All dimensions are in inches (millimeters) unless otherwise shown. STATE OF ILLINOIS TRAFFIC CONTROL AND PROTECTION FOR SIDE ROADS, INTERSECTIONS, AND DRIVEWAYS F.A. RTE. SECTION COUNTY TOTAL SHEETS NO.TOTAL STMENT OF TRANSPORTATION SIDE ROADS, INTERSECTIONS, AND DRIVEWAYS TC-10 CONTRACT NO. 61JOG

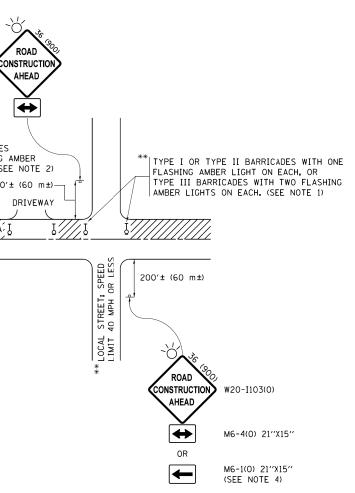

	5. WHEN WORK IS BEING PERFORMED ON A SIDE ROAD OR DRIVEWAY,
	FOLLOW THE APPLICABLE STANDARD(S). THE DIRECTIONAL
	ARROW (M6-1 OR M6-4) SHALL BE COVERED OR REMOVED WHEN
R	NO LONGER CONSISTENT WITH THE TRAFFIC CONTROL SET-UP.

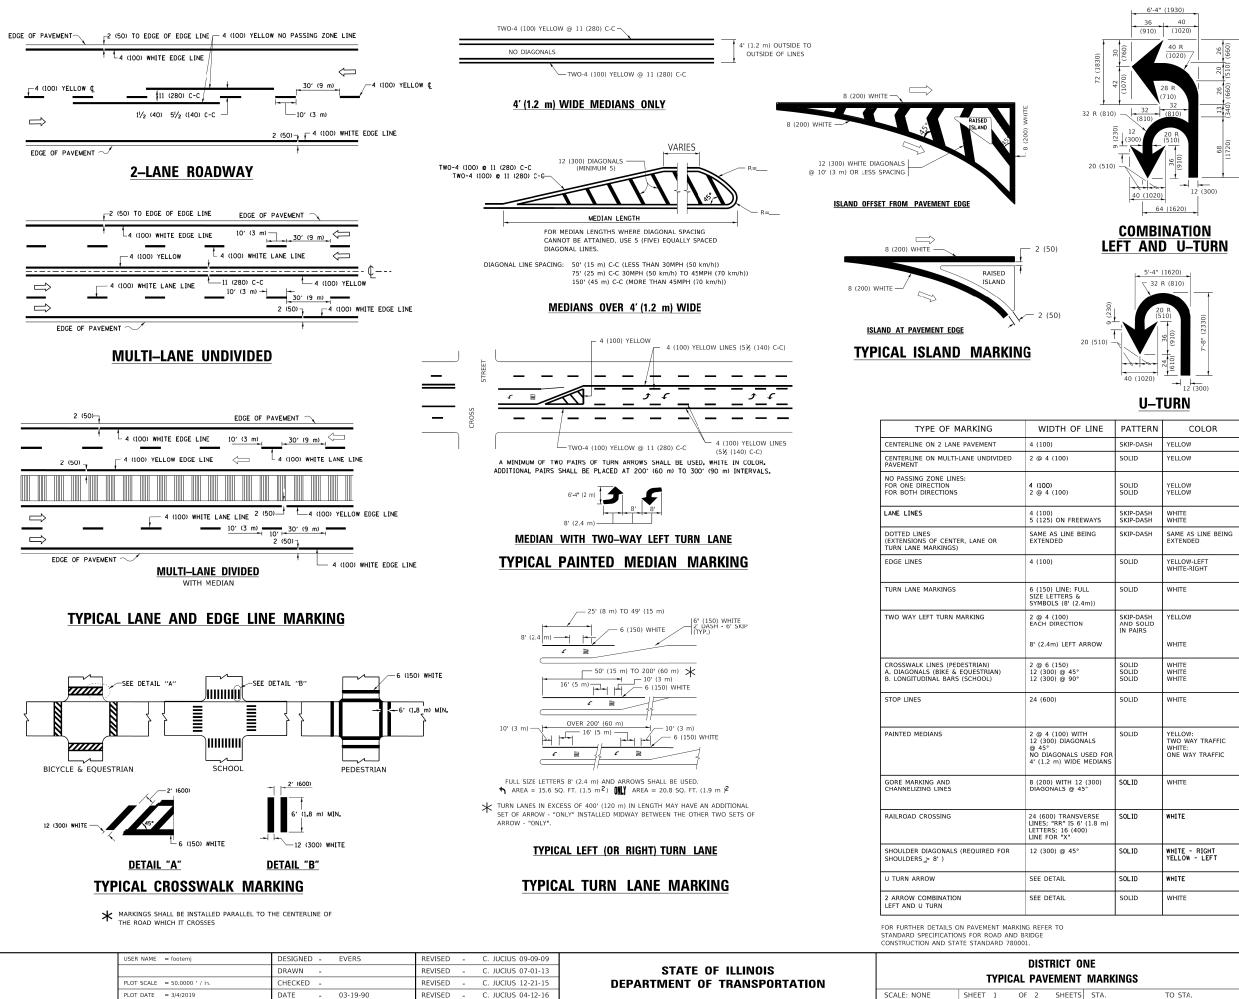

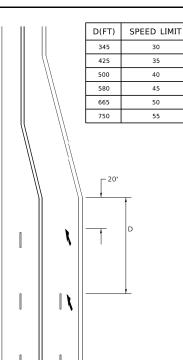


LANE REDUCTION TRANSITION

★ LANE REDUCTION ARROWS REQUIRED AT SPEEDS OF 45 MPH OR GREATER OR WHEN SPECIFIED IN PLANS.

F LINE	PATTERN	COLOR	SPACING / REMARKS							
	SKIP-DASH	YELLOW	10' (3 m) LINE WITH 30' (9 m) SPACE							
	SOLID	YELLOW	11 (280) C-C							
	SOLID SOLID	YELLOW YELLOW	5½ (140) C-C FROM SKIP-DASH CENTERLINE 11 (280) C-C OMIT SKIP-DASH CENTERLINE BETWEEN							
EEWAYS	SKIP-DASH SKIP-DASH	WHITE WHITE	10' (3 m) LINE WITH 30' (9 m) SPACE							
BEING	SKIP-DASH	SAME AS LINE BEING EXTENDED	2' (600) LINE WITH 6' (1.8 m) SPACE							
	SOLID	YELLOW-LEFT WHITE-RIGHT	OUTLINE MEDIANS IN YELLOW							
⁼ ULL & 2.4m))	SOLID	WHITE	SEE TYPICAL TURN LANE MARKING DETAIL							
ARROW	SKIP-DASH AND SOLID IN PAIRS	YELLOW	10' (3 m) LINE WITH 30' (9 m) SPACE FOR SKIP-DASH: 5½ (140) C-C DETWEEN SOLID LINE AND SKIP-DASH LINE SEE TYPICAL TWO-WAY LEFT TURN MARKING DETAIL							
0	SOLID SOLID SOLID	WHITE WHITE WHITE	NOT LESS THAN 6' (1.8 m) APART 2' (600) APART 2' (600) APART SEE TYPICAL CROSSWALK MARKING DETAILS.							
	SOLID	WHITE	PLACE 4' (1.2 m) IN ADVANCE OF AND PRALLEL TO CROSSWALK, IF PRESENT, OTHERWISE, PLACE AT DESIRED STOPPING POINT. PARALLEL TO CROSSROAD CENTERLINE, WHERE POSSIBLE							
ITH ONALS USED FOR E MEDIANS	SOLID	YELLOW: TWO WAY TRAFFIC WHITE: ONE WAY TRAFFIC	11 (280) C-C FOR THE DOUBLE LINE SEE TYPICAL PAINTED MEDIAN MARKING.							
12 (300) 45°			DIAGONALS: 15' (4.5 m) C-C (LESS THAN 30MPH (50 km/h)) 20' (6 m) C-C 30MPH (50 km/h) TO 45MPH (70 km/h)) 30' (9 m) C-C (OVER 45MPH (70 km/h))							
SVERSE 6' (1.8 m) 000)	SOLID	WHITE	SEE STATE STANDARD 780001 AREA OF: "R"=3.6 SQ. FT. (0.33 m 2 EACH "X"=54.0 SQ. FT. (5.0 m 2							
٥	SOLID	WHITE - RIGHT Yellow - Left	50' (15 m) C-C (LESS THAN 30MPH (50 km/h)) 75' (25 m) C-C (30 MPH (50 km/h) TO 45MPH (70 km/h)) 150' (45 m) C-C (OVER 45MPH (70 km/h))							
	SOLID	WHITE	16.3 SF							
	SOLID	WHITE	30.4 SF							

All dimensions are in inches (millimeters unless otherwise shown.


ONE	F.A. RTE.	SEC	TION		COUNTY	TOTAL SHEETS	SHEET NO.
IT MARKINGS		22-0001	8-00-	٠RS	LAKE	33	31
	_	TC-13			CONTRACT	NO. 6	1J06
TS STA. TO STA.			ILLINOIS	FED. A	ID PROJECT		

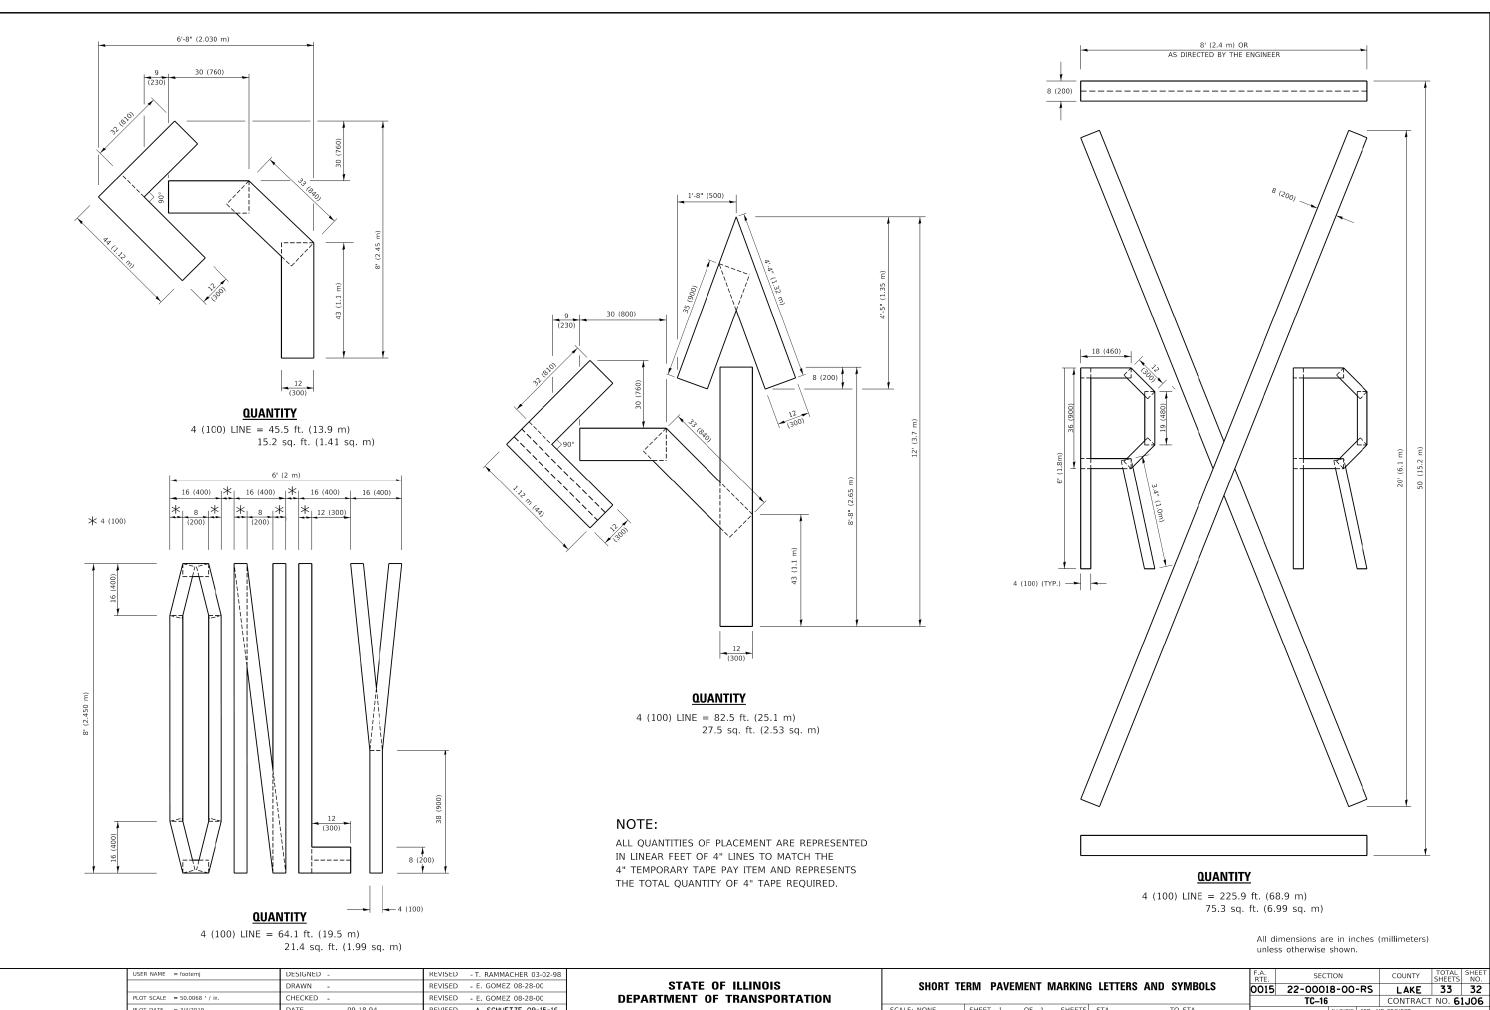

TO STA.

ILLINOIS FED. AID PROJECT

USER NAME = footemj		REVISED - T. RAMMACHER 03-02-98					
	DRAWN -	REVISED - E. GOMEZ 08-28-00	STATE OF ILLINOIS	SHORT TEF	RM PAVEM	ENT MARKI	NG LETTE
PLOT SCALE = 50.0068 ' / in.	CHECKED -	REVISED - E. GOMEZ 08-28-00	DEPARTMENT OF TRANSPORTATION				
PLOT DATE = 3/4/2019	DATE - 09-18-94	REVISED - A. SCHUETZE 09-15-16		SCALE: NONE	SHEET 1	OF 1 SHEE	TS STA.

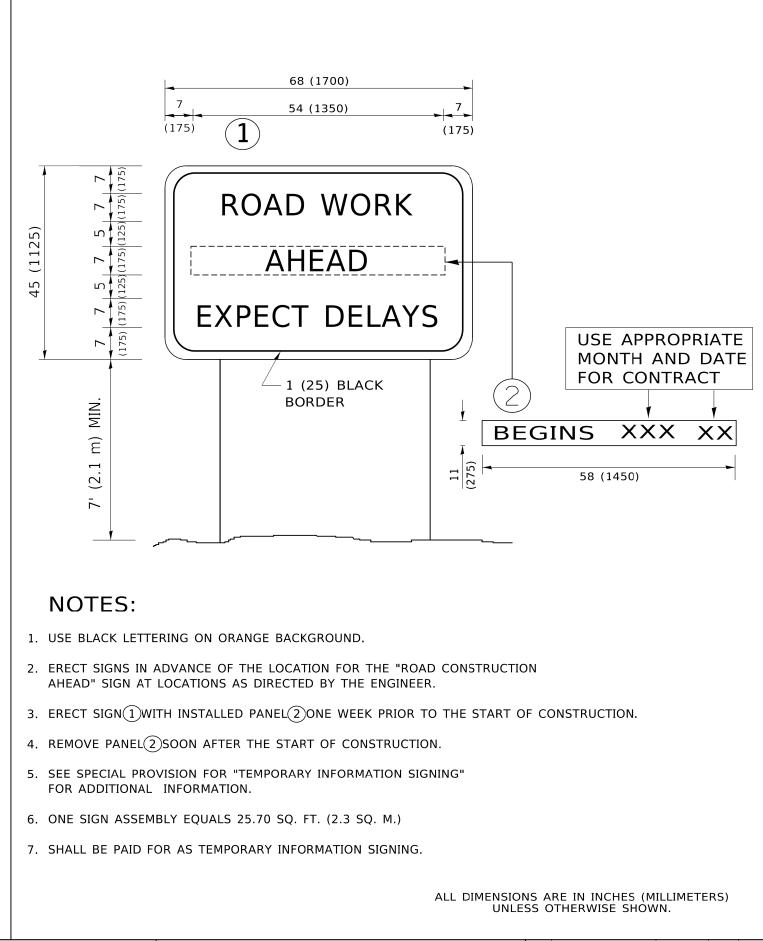

USER NAME = footemj	DESIGNED -	REVISED - R. MIRS 09-15-97			ARTERIAL ROAD			F.A. BTE	SECTION	COUNTY TOTAL SHEET	
	DRAWN -	REVISED - R. MIRS 12-11-97	STATE OF ILLINOIS						0015 22	2-00018-00-RS	LAKE 33 33
PLOT SCALE = 50.0000 ' / in.	CHECKED -	REVISED -T. RAMMACHER 02-02-99	DEPARTMENT OF TRANSPORTATION	INFORMATION SIGN			INFORMATION SIGN			TC-22	CONTRACT NO. 61J06
PLOT DATE = 3/4/2019	DATE -	REVISED - C. JUCIUS 01-31-07		SCALE: NONE	SHEET 1 O	F 1 SHEE	TS STA.	TO STA.			D PROJECT