03-10-2023 LETTING ITEM 083

FOR INDEX OF SHEETS, SEE SHEET NO. 2 FOR LIST OF HIGHWAY STANDARDS, SEE SHEET NO. 2

FAU 3791 (76TH AVENUE) FUNCTIONAL CLASSIFICATION: MINOR COLLECTOR

1,750 AADT (2018) 0% TRUCKS POSTED SPEED LIMIT = 30 MPH

SCHAUMBURG

(847)705-4021

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1°=20° 1°=50° 1°=50° 1°=100° 1°=100°

FULL SIZE PLANS HAVE BEEN PREPARED USING STANDARD ENGINEERING SCALES. REDUCED SIZED PLANS WILL NOT CONFORM TO STANDARD SCALES. IN MAKING MEASUREMENTS ON REDUCED PLANS, THE ABOVE SCALES MAY BE USED.

| SCALES | (PLAN | | 1 | INCH = | 100 | FEET |
|--------|---------|----------------------------|----------|--------|------------|------|
| | TRAFFIC | SIGNAL PLAN | 1 | INCH = | 5 0 | FEET |
| | TRAFFIC | SIGNAL PLAN SIGNAL PLAN | DETAIL 1 | INCH = | 20 | FEET |

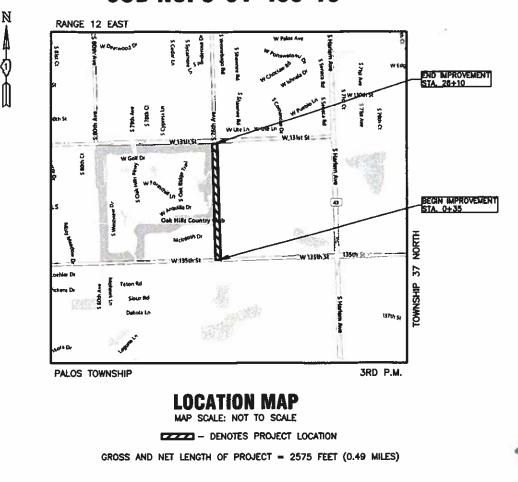
CONTRACT NO. 61J07

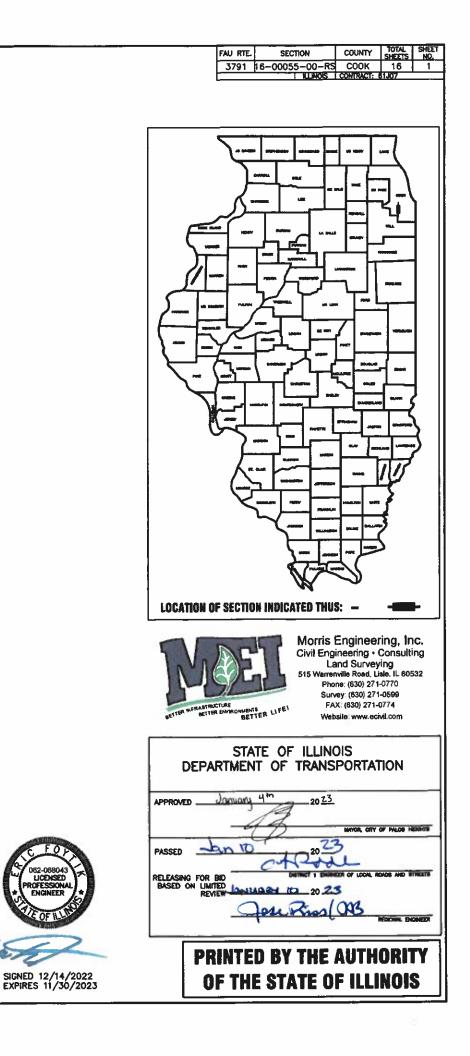


Know what's **below. Call** before you dig.

STATE OF ILLINOIS DEPARTMENT OF TRANSPORTATION DIVISION OF HIGHWAYS PLANS FOR PROPOSED FEDERAL AID HIGHWAY

(FAU 3791) S. 76TH AVENUE FROM 131ST STREET TO 135TH STREET RESURFACING SECTION NO. 16-00055-00-RS PROJECT G41R (895) PALOS TOWNSHIP COOK COUNTY JOB NO. C-91-409-16





INDEX OF SHEETS

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- INDEX OF SHEETS, HIGHWAY STANDARDS, AND GENERAL NOTES 2.
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- EXISTING TRAFFIC SIGNAL PLANS 131ST ST. AT 76TH AVE. 6 - 8
- PROPOSED TRAFFIC SIGNAL PLANS 131ST ST. AT 76TH AVE. 9.
- 10. DETAILS FOR FRAMES AND LIDS ADJUSTMENT WITH MILLING (BD-8)
- PAVEMENT PATCHING FOR HMA SURFACED PAVEMENT (BD-22) 11.
- BUTT JOINT AND HMA TAPER DETAILS (BD32) 12.
- 13. TRAFFIC CONTROL AND PROTECTION FOR SIDE ROADS, INTERSECTIONS, AND DRIVEWAYS (TC-10)
- 14. DISTRICT 1 TYPICAL PAVEMENT MARKINGS (TC-13)
- DISTRICT 1 SHORT TERM PAVEMENT MARKING LETTERS AND SYMBOLS (TC-16) 15.
- ARTERIAL ROAD INFORMATION SIGN (TC-22) 16.

- 12. THE CONTRACTOR SHALL PRESERVE AND PROTECT ALL EXISTING FIELD TILES. ANY FIFLD TILES DAMAGED BY In the CONTRACTOR'S OPERATIONS SHALL BE REPARED OR REPLACED BY THE CONTRACTOR'S OPERATIONS SHALL BE REPARED OR REPLACED BY THE CONTRACTOR AT HIS SOLE EXPENSE. INVESTIGATION SHALL BE MADE TO INSURE THAT FIELD TILES DO NOT CONVEY OFF SITE WATER. TILES THAT CONVEY OFF SITE WATER SHALL BE REROUTED THROUGH THE SITE. TILES THAT DO NOT CONVEY OFF SITE WATER SHALL BE ABANDONED IN AN APPROPRIATE MANNER APPROVED BY THE MUNICIPALITY. FIELD TILES WITHIN A RIGHT-OF-WAY SHALL BE REMOVED AND BACKFILLED WITH CA-6 COMPACTED IN EIGHT INCH LIFTS TO THE BOTTOM OF THE ROADWAY BASE. EXISTING FIELD TILES SHALL BE REMOVED BY SLIT TRENCHING
- 13. THE CONTRACTOR SHALL KEEP PUBLIC STREET PAVEMENTS CLEAN OF DIRT AND DEBRIS AND, WHEN NECESSARY, SHALL ON A DAILY BASIS CLEAN THE PAVEMENT OF SUCH DIRT AND DEBRIS RESULTING FROM CONSTRUCTION OPERATIONS
- 14. THE CONTRACTOR SHALL EXAMINE THE DRAINAGE PATTERNS SHOWN ON THE PLANS AND MAKE CERTAIN THAT ALL OVERFLOW POINT ELEVATIONS AND CROSS SECTIONS ARE CONSTRUCTED STRICTLY IN ACCORDANCE WITH THOSE SHOWN ON THE PLANS.
- 15. THE CONTRACTOR SHALL CONTACT J.U.L.I.E. (1-800-892-0123) PRIOR TO ANY WORK IN THE RIGHT OF WAY OR EASEMENTS TO LOCATE UTILITIES, AND CONTACT THE OWNER'S REPRESENTATIVE SHOULD PUBLIC UTILITIES APPEAR TO BE IN CONFLICT WITH THE PROPOSED IMPROVEMENTS.
- 16. CURB SHALL BE REMOVED IN A WAY TO PREVENT DAMAGE TO EXISTING LANDSCAPING BEHIND THE CURB. ANY DAMAGE TO THE EXISTING LANDSCAPING SHALL BE REPAIRED
- 17. CURB AND GUTTER TO BE REPLACED AROUND THE FRAMES AND GRATES THAT ARE TO BE ADJUSTED. AREAS BE MARKED IN THE FIELD BY THE ENGINEER
- THE LOCATION OF CLASS D PATCHING OF VARIOUS TYPES WILL BE DIRECTED BY THE ENGINEER IN THE FIELD PRIOR TO STARTING CONSTRUCTION.

TRAFFIC CONTROL AND PROTECTION

- 1. AT THE PRECONSTRUCTION MEETING THE CONTRACTOR SHALL FURNISH THE NAME OF THE AND MAINTENANCE OF THE TRAFFIC CONTROL FOR THIS PROJECT. IF THE INSTALLATION AND MAINTENANCE OF THE TRAFFIC CONTROL FOR THIS PROJECT. IF THE ACTUAL INSTALLATION AND MAINTENANCE ARE TO BE ACCOMPLISHED BY A SUBCONTRACTOR, CONSENT SHALL BE REQUESTED OF THE ENGINEER AT THE TIME OF THE PRECONSTRUCTION MEETING IN ACCORDANCE WITH ARTICLE 108.01 OF THE <u>STANDARD SPECIFICATIONS</u>. THIS SHALL NOT RELIEVE THE CONTRACTOR OF THE FOREGOING REQUIREMENT FOR A RESPONSIBLE INDIVIDUAL IN HIS DIRECT EMPLOY TO SUPERVISE THIS WORK.
- 2. THE GOVERNING FACTOR IN THE EXECUTION AND STAGING OF WORK FOR THIS PROJECT IS TO PROVIDE THE MOTORING PUBLIC WITH THE SAFEST POSSIBLE TRAVEL CONDITIONS ALONG THE ROADWAY THROUGH THIS CONSTRUCTION ZONE. THE CONTRACTOR SHALL SO ARRANGE HIS/HER OPERATION AS TO KEEP THE CLOSING OF ANY LANE OF THE ROADWAY TO A MINIMUM.
- 3. THE CONTRACTOR SHALL ENSURE THAT ALL TRAFFIC CONTROL DEVICES INSTALLED BY M/HER ARE OPERATIONAL 24 HOURS A DAY, INCLUDING SUNDAYS AND HOLIDAYS
- 4. CONTRACTOR VEHICLES SHALL ENTER OR LEAVE WORK AREAS IN A MANNER WHICH WILL NOT BE HAZARDOUS TO, OR WILL NOT INTERFERE WITH, TRAFFIC AND SHALL NOT PARK OR STOP EXCEPT WITHIN DESIGNATED WORK AREAS. PERSONAL VEHICLES SHALL NOT PARK WITHIN THE RIGHT-OF-WAY EXCEPT IN SPECIFIC AREAS DESIGNATED BY THE ENGINEER.
- 5. THE CONTRACTOR SHALL CONTACT THE IDOT TRAFFIC CONTROL SUPERVISOR AT KALPANA.KANNAN-HOSADURGA@ILLINOIS.GOV AT LEAST 72 HOURS IN ADVANCE OF BEGINNING
- 280001-07 442201-03 701301-04 701311-03 701501-06 701801-06 701901-08 780001-05

| | USER NAME = | DESIGNED - EF | REVISED - | | | GENERAL NOTES | | SECTION | COUNTY TOTAL SHEET | 1 |
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| | DRAWN | | REVISED - | STATE OF ILLINOIS | 707 | | 3791 | 16-00055-00-RS | COOK 16 2 | 1 |
| PLOT SCALE = | PLOT SCALE = | CHECKED - AS | REVISED - | DEPARTMENT OF TRANSPORTATION | 76TH AVENUE - 131ST STREET TO 135TH STREET | | | | CONTRACT NO. 61J07 | 1 |
| | PLOT DATE = Jan 10, 2023 | DATE - | REVISED - | | SCALE: – | SHEET NO. 1 OF 1 SHEETS STA. TO STA. | | ILLINOIS FED. A | ID PROJECT G41R(895) | 1 |

GENERAL NOTES

- ALL EARTHWORK, GRADING, UTILITIES, AND STREET IMPROVEMENTS WORK SHALL BE PERFORMED IN ACCORDANCE WITH THE JANUARY 1, 2022 EDITION OF THE ILLINOIS DEPARTMENT OF TRANSPORTATION DIVISION OF HIGHWAY'S <u>STANDARD SPECIFICATIONS FOR ROAD AND BRIDGE CONSTRUCTION</u>, AND ALL
- 2. THE CONTRACTOR SHALL BE RESPONSIBLE FOR PROVIDING SAFE AND HEALTHFUL WORKING CONDITIONS IN ACCORDANCE WITH SECTION 107 OF THE <u>STANDARD SPECIFICATIONS FOR ROAD AND BRIDGE</u> <u>CONSTRUCTION</u> THROUGHOUT THE CONSTRUCTION OF THE PROPOSED IMPROVEMENTS.
- 3. SOIL EROSION AND SEDIMENTATION CONTROL PRACTICES AND DEVICES SHALL BE IN ACCORDANCE WITH THE 1995 EDITION OF THE URBAN COMMITTEE OF THE ASSOCIATION OF ILLINOIS SOIL AND WATER CONSERVATION DISTRICTS' PROCEDURES AND STANDARDS FOR URBAN SOIL EROSION AND SEDIMENTATION CONTROL IN ILLINOIS AND ALL REVISIONS THERETO AND IN ACCORDANCE WITH THE DETAILS ON THE PLANS.
- 4. THE CONTRACTOR SHALL BE AWARE OF POTENTIAL CONFLICTS WITH EXISTING UTILITIES AS INDICATED ON THE PLANS. THE CONTRACTOR SHALL EXCAVATE AROUND UTILITIES TO DETERMINE ELEVATIONS BEFORE BEGINNING CONSTRUCTION
- 5. THE CONTRACTOR SHALL BE RESPONSIBLE FOR NOTIFYING EACH OF THE UTILITY COMPANIES BEFORE ANY WORK COMMENCES. ALL UTILITIES SHALL BE STAKED PRIOR TO CONSTRUCTION.
- 6. THE OWNER WILL FURNISH THE CONTRACTOR WITH LINES, GRADES AND ELEVATIONS NECESSARY TO THE PROPER PROSECUTION AND CONTROL OF THE WORK ONCE
- THE CONTRACTOR SHALL GIVE THE ENGINEER AT LEAST SEVENTY-TWO (72) HOURS NOTICE FOR ANY STAKING TO BE DONE. EACH OF THE VARIOUS ITEMS OF WORK COVERED BY THIS CONTRACT WILL BE STAKED ONCE
- 8. THE CONTRACTOR SHALL INFORM THE RESIDENT ENGINEER, CITY ENGINEER, AND THE MUNICIPALITY AT LEAST FORTY-EIGHT (48) HOURS PRIOR TO COMMENCEMENT OF CONSTRUCTION.

TELEPHONE NUMBERS: CITY ENGINEER (630) 271-0770 PALOS HEIGHTS PUBLIC WORKS - (708) 361-1806

- THE CONTRACTOR RESPONSIBLE FOR DRAINAGE IMPROVEMENTS (UNDERGROUND STRUCTURES AND CONDUITS) SHALL DISPOSE OF ALL SURPLUS EXCAVATED MATERIAL FROM TRENCHES OR STRUCTURE EXCAVATIONS AND SHALL DEPOSIT SAID SURPLUS MATERIALS ON THE SITE IN ACCORDANCE WITH THE 9 GRADING PLAN OR AS DIRECTED BY THE ENGINEER
- THE CONTRACTOR SHALL NOT PLACE ANY EXCAVATED MATERIAL UPON ANY TOPSOIL. THE TOPSOIL SHALL 10. BE REMOVED FROM ALL AREAS TO BE FILLED AND SHALL BE STOCKPILED IN AREAS AS DIRECTED BY THE ENGINEER
- THE CONTRACTOR SHALL NOT DISCHARGE INTO STREAMS, PONDS, WETLANDS OR ITS TRIBUTARIES ANY 11. MOTOR OIL, TRANSMISSION FLUID, LUBRICANTS OR ANY OTHER PETROLEUM DISTILLATES, ANY PETROLEUM DISTILLATES DISCHARGED ON THE GROUND SURFACE SHALL BE PROMPTLY AND PROPERLY REMOVED PRIOR TO THE RESUMPTION OF ANY WORK ON THE PROJECT

EXCAVATION

ALL SITE CLEARING, EXCAVATION, GRADING, COMPACTION, SUBGRADE PREPARATION, BASE COURSE, SURFACE COURSE, PCC CURB AND GUTTER AND SIDEWALKS SHALL BE CONSTRUCTED IN CONFORMANCE WITH THE APPLICABLE SECTIONS OF THE <u>STANDARD SPECIFICATIONS FOR ROAD</u> AND BRIDGE CONSTRUCTION, DEPARTMENT OF TRANSPORTATION, STATE OF ILLINOIS, JANUARY 1, 2022 EDITION. 1. ALL SITE CLEARING EXCAVATION GRADING COMPACTION SUBGRADE PREPARATION BASE

1. THE FOLLOWING PRINCIPLES SHALL APPLY TO ALL MOVEMENT OF EARTH AND STORM DRAINAGE. SEDIMENT AND EROSION CONTROL DEVICES SHALL BE FUNCTIONAL BEFORE LAND IS OTHERWISE DISTURBED ON SITE.

- - EROSION EFFECTS
- GOVERNING MUNICIPALITY
- TOWNSHIP

SOIL EROSION AND SEDIMENTATION CONTROL NOTES

2. THE SMALLEST PRACTICAL AREA OF LAND IS TO BE EXPOSED AT ANY GIVEN TIME DURING CONSTRUCTION. EXPOSURE SHALL BE KEPT TO AS SHORT A DURATION OF TIME AS IS PRACTICAL.

3. STABILIZE AND PROTECT DISTURBED AREAS. SOIL DISTURBANCE SHALL BE CONDUCTED IN SUCH A MANNER AS TO MINIMIZE EROSION. SOIL STABILIZATION MEASURES SHALL CONSIDER THE TIME OF YEAR, SITE CONDITIONS, AND THE USE OF TEMPORARY OR PERMANENT MEASURES. MECHANICAL, STRUCTURAL AND/OR VEGETATIVE CONTROL METHODS SHALL BE USED IN ORDER TO RETARD SOIL EROSION IF DIRECTED BY THE OWNER OR THE OWNER'S AUTHORIZED REPRESENTATIVE.

4. KEEP RUN-OFF VELOCITIES LOW WITH SHORT SLOPES AND LOW GRADIENTS. THE INSTALLATION OF NATURAL VEGETATIVE COVER HELPS TO KEEP STORM WATER VELOCITIES LOW, AND THUS LIMIT SOIL

5. PROTECT DISTURBED AREAS FROM STORM WATER RUN-OFF. SOIL EROSION AND SEDIMENT CONTROL FEATURES SHALL BE CONSTRUCTED PRIOR TO THE COMMENCEMENT OF UPLAND DISTURBANCE. PROTECTIVE MEASURES SHALL BE UTILIZED TO DIVERT RUN-OFF FROM DISTURBED AREAS.

6. ALL TEMPORARY EROSION AND SEDIMENT CONTROL MEASURES SHALL BE REMOVED WITHIN 30 DAYS AFTER FINAL SITE STABILIZATION IS ACHIEVED OR AFTER THE TEMPORARY MEASURES ARE NO LONGER NEEDED, TRAPPED SEDIMENT AND OTHER DISTURBED SOIL AREAS SHALL BE PERMANENTLY STABILIZED

7 NATURAL PLANT COVER SHALL BE MAINTAINED AND PROTECTED AND ALL TEMPORARY AND PERMANENT EROSION CONTROL MEASURES SHALL BE MAINTAINED AND REPAIRED AS NEEDED. THE GENERAL CONTRACTOR WILL BE RESPONSIBLE FOR INSPECTION AND REPAIR DURING CONSTRUCTION.

8. PROTECTION OF EXISTING FACILITIES AND UTILITIES - THE CONTRACTOR SHALL PROVIDE AND MAINTAIN ALL NECESSARY FACILITIES FOR THE PROTECTION OF ALL EXISTING UTILITIES ON OR ADJACENT TO THE PROJECT. ALL STORM SEWER FACILITIES THAT ARE OR WILL BE FUNCTIONING DURING CONSTRUCTION SHALL BE PROTECTED, FILTERED, OR OTHERWISE TREATED TO REMOVE SEDIMENT. FURTHERMORE, ANY DAMAGE DONE BY THE CONTRACTOR, THE CONTRACTOR'S AGENTS, OR ASSIGNS SHALL BE REPAIRED.

9. DIRT ON PAVEMENT - WHERE A CONTRACTOR'S EQUIPMENT IS OPERATED UPON AN EXISTING PAVEMENT USED BY TRAFFIC THE CONTRACTOR SHALL CLEAN THE PAVEMENT OF ALL DIRT AND DEBRIS AT THE END OF EACH DAY'S OPERATIONS AND AT OTHER TIMES AS DIRECTED BY THE OWNER, THE ENGINEER, OR THE

10. DUST CONTROL - THE CONTRACTOR SHALL BE RESPONSIBLE FOR THE CONTROL OF EXCESSIVE DUST DURING THE CONSTRUCTION PERIOD UNTIL PROPOSED IMPROVEMENTS COMPLETED. THE REQUIREMENT FOR DUST CONTROL SHALL BE AS DIRECTED BY THE LOCAL APPROVING AUTHORITIES OR THE ENGINEER.

11. THE EROSION CONTROL MEASURES INDICATED ON THE PLANS ARE THE MINIMUM REQUIREMENTS. ADDITIONAL MEASURES MAY BE REQUIRED. AS DIRECTED BY THE ENGINEER OR DOWNERS GROVE

12. THE CONTRACTOR SHALL MAKE AN EFFORT TO MINIMIZE USE OF HEAVY EQUIPMENT WITHIN THE DESIGNATED DRAINAGE FACILITIES.

LIST OF ILLINOIS DOT HIGHWAY STANDARDS

TEMPORARY EROSION CONTROL SYSTEMS

CLASS C AND D PATCHES

LANE CLOSURE, 2L, 2W, SHORT TIME OPERATIONS

LANE CLOSURE 2L. 2W MOVING OPERATIONS - DAY ONLY

URBAN LANE CLOSURE, 2L, 2W, UNDIVIDED

SIDEWALK CORNER OR CROSSWALK CLOSURE

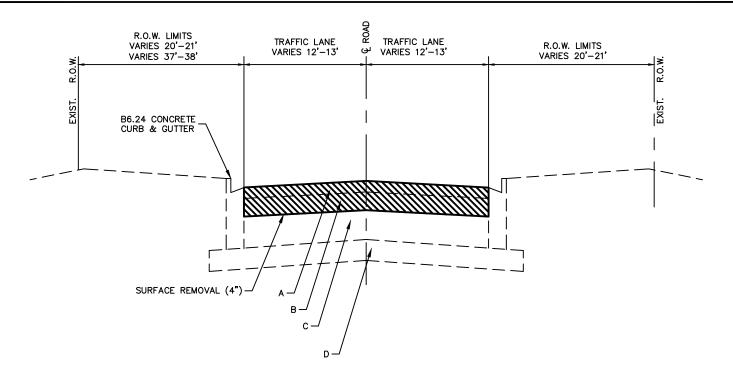
TRAFFIC CONTROL DEVICES

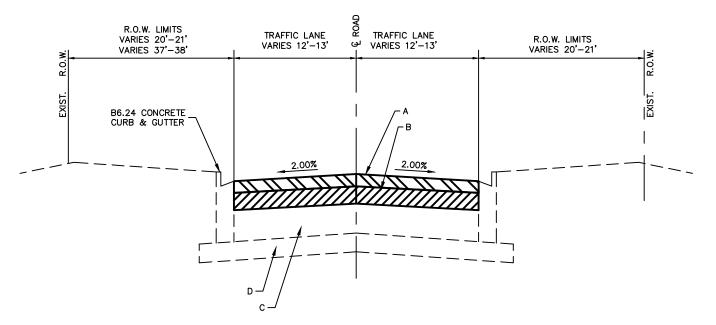
TYPICAL PAVEMENT MARKINGS

| | SUMMARY OF QUANTITIES | | | CONSTRUCTION CODE 0005 |
|----------|--|-------|-------|------------------------------|
| CODE NO. | ITEM DESCRIPTION | UNIT | TOTAL | SUBTOTAL |
| 28000510 | INLET FILTERS | EACH | 20 | 20 |
| 40600290 | BITUMINOUS MATERIALS (TACK COAT) | POUND | 5208 | 5208 |
| 40600370 | LONGITUDINAL JOINT SEALANT | FOOT | 2575 | 2575 |
| 40600982 | HOT-MIX ASPHALT SURFACE REMOVAL - BUTT JOINT | SQ YD | 110 | 110 |
| 40603085 | HOT-MIX ASPHALT BINDER COURSE, IL-19.0, N70 | TON | 1096 | 1096 |
| 40604062 | HOT-MIX ASPHALT SURFACE COURSE, IL-9.5, MIX "D", N70 | TON | 658 | 658 |
| 44000165 | HOT-MIX ASPHALT SURFACE REMOVAL, 4" | SQ YD | 7715 | 7715 |
| 44000500 | COMBINATION CURB AND GUTTER REMOVAL | FOOT | 515 | 515 |
| 44201713 | CLASS D PATCHES, TYPE I, 6 INCH | SQ YD | 200 | 200 |
| 44201717 | CLASS D PATCHES, TYPE II, 6 INCH | SQ YD | 200 | 200 |
| 44201721 | CLASS D PATCHES, TYPE III, 6 INCH | SQ YD | 200 | 200 |
| 60300105 | FRAMES AND GRATES TO BE ADJUSTED | EACH | 23 | 23 |
| 60605000 | COMBINATION CONCRETE CURB AND GUTTER, TYPE B-6.24 | FOOT | 515 | 515 |

| | SUMMARY OF QUANTITIES | | | CONSTRUC CODE 0005 |
|------------|--|-------|-------|--------------------------|
| CODE NO. | | | TOTAL | SUBTOT |
| 6710010 | MOBILIZATION | LSUM | 1 | 1 |
| 70102620 | TRAFFIC CONTROL AND PROTECTION, STANDARD 701501 | LSUM | 1 | 1 |
| 70102640 | TRAFFIC CONTROL AND PROTECTION, STANDARD 701801 | LSUM | 1 | 1 |
| 7030010 | SHORT TERM PAVEMENT MARKING | FOOT | 2600 | 2600 |
| 70300150 | SHORT TERM PAVEMENT MARKING REMOVAL | SQFT | 867 | 867 |
| 7030022 | TEMPORARY PAVEMENT MARKING - LINE 4"-PAINT | FOOT | 2600 | 2600 |
| 7030028 | I TEMPORARY PAVEMENT MARKING - LINE 24"-PAINT | FOOT | 72 | 72 |
| * 78000100 | THERMOPLASTIC PAVEMENT MARKING - LETTERS AND SYMBOLS | SQFT | 20.6 | 20.6 |
| 78000200 | THERMOPLASTIC PAVEMENT MARKING - LINE 4" | FOOT | 5024 | 5024 |
| * 78000400 | D THERMOPLASTIC PAVEMENT MARKING - LINE 6" | FOOT | 130 | 130 |
| * 78000650 | D THERMOPLASTIC PAVEMENT MARKING - LINE 24" | FOOT | 72 | 72 |
| * 8860060 | DETECTOR LOOP REPLACEMENT | FOOT | 317 | 317 |
| Z0030850 | TEMPORARY INFORMATION SIGNING | SQ FT | 55 | 55 |

| USER NAME * | DESIGNED - EF | REVISED - | SUMMARY OF QUANTITIES | | RE. SECTION COUNTY TOTAL SHEET NO. |
|--------------------------|---------------|-----------|------------------------------|---|------------------------------------|
| | DRAWN - CJS | REVISED - | STATE OF ILLINOIS | | 3791 16-00055-00-RS COOK 16 3 |
| PLOT SCALE * | CHECKED - AS | REVISED - | DEPARTMENT OF TRANSPORTATION | 76TH AVENUE - 131ST STREET TO 135TH STREET | CONTRACT NO. 61J07 |
| PLOT DATE . Dec 07, 2022 | DATE - | REVISED - | | SCALE: - SHEET NO. 1 OF 1 SHEETS STA. TO STA. | ILLINOIS FED. AD PROJECT G41R(895) |





| | HOT-MIX MIXTURE REQUIREMENTS | | | | | | |
|--------------------------|--|---------------|----------------|----------|--|--|--|
| | MIXTURE TYPE | VOIDS | LIFT THICKNESS | QMP | | | |
| PATCHING | CLASS D PATCH HMA BINDER COURSE, IL-19 | 4% @ 70 Gyr | | | | | |
| PAVEMENT RESURFACING | HMA SURFACE COURSE, IL-9.5, MIX "D", N70 | 4% @ 70 Gyr | 1.5" | LR1030-2 | | | |
| | HMA BINDER COURSE, IL-19.0, N70 | 3.5% @ 70 Gyr | 2.5" | LR1030-2 | | | |
| QMP DESIGNATION: QUALITY | MP DESIGNATION: QUALITY CONTROL/QUALITY ASSURANCE (QC/QA) PER LR1030-2 | | | | | | |

THE UNIT WEIGHT USED TO CALCULATE ALL HMA SURFACE MIXTURE QUANTITIES IS 112 LBS/SQ YD/IN.

THE LONGITUDINAL JOINT SEALANT SHALL BE PLACED OVER THE HMA BINDER COURSE IL-19.0, N70

THE "AC TYPE" FOR POLYMERIZED HMA MIXES SHALL BE "SBS/SBR PG 76-22" AND FOR NON-POLYMERIZED HMA THE "AC TYPE" SHALL BE "PG 64-22" UNLESS MODIFIED BY RECLAIMED MATERIALS SPECIFICATIONS.

| | USER NAME = | DESIGNED - EF | REVISED - | | | TYPICAL SECTIONS | | F.A.U. RTF | SECTION | | OTAL SHEET |
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| PLOT SCALE = | DRAWN - CJS | REVISED - | STATE OF ILLINOIS | | | | 3791 | 16-00055-00-RS | СООК | 16 4 | |
| | PLOT SCALE = | CHECKED - AS | REVISED - | DEPARTMENT OF TRANSPORTATION | 76TH AVENUE - 131ST STREET TO 135TH STREET | | | | | CONTRACT N | NO. 61J07 |
| | PLOT DATE = Dec 07, 2022 | DATE - | REVISED - | | SCALE: N.T.S. | SHEET NO. 1 OF 1 SHEETS | STA. TO STA. | | ILLINOIS FED. AI | D PROJECT G41R(89 | 95) |

EXISTING TYPICAL SECTION WITH CURB & GUTTER

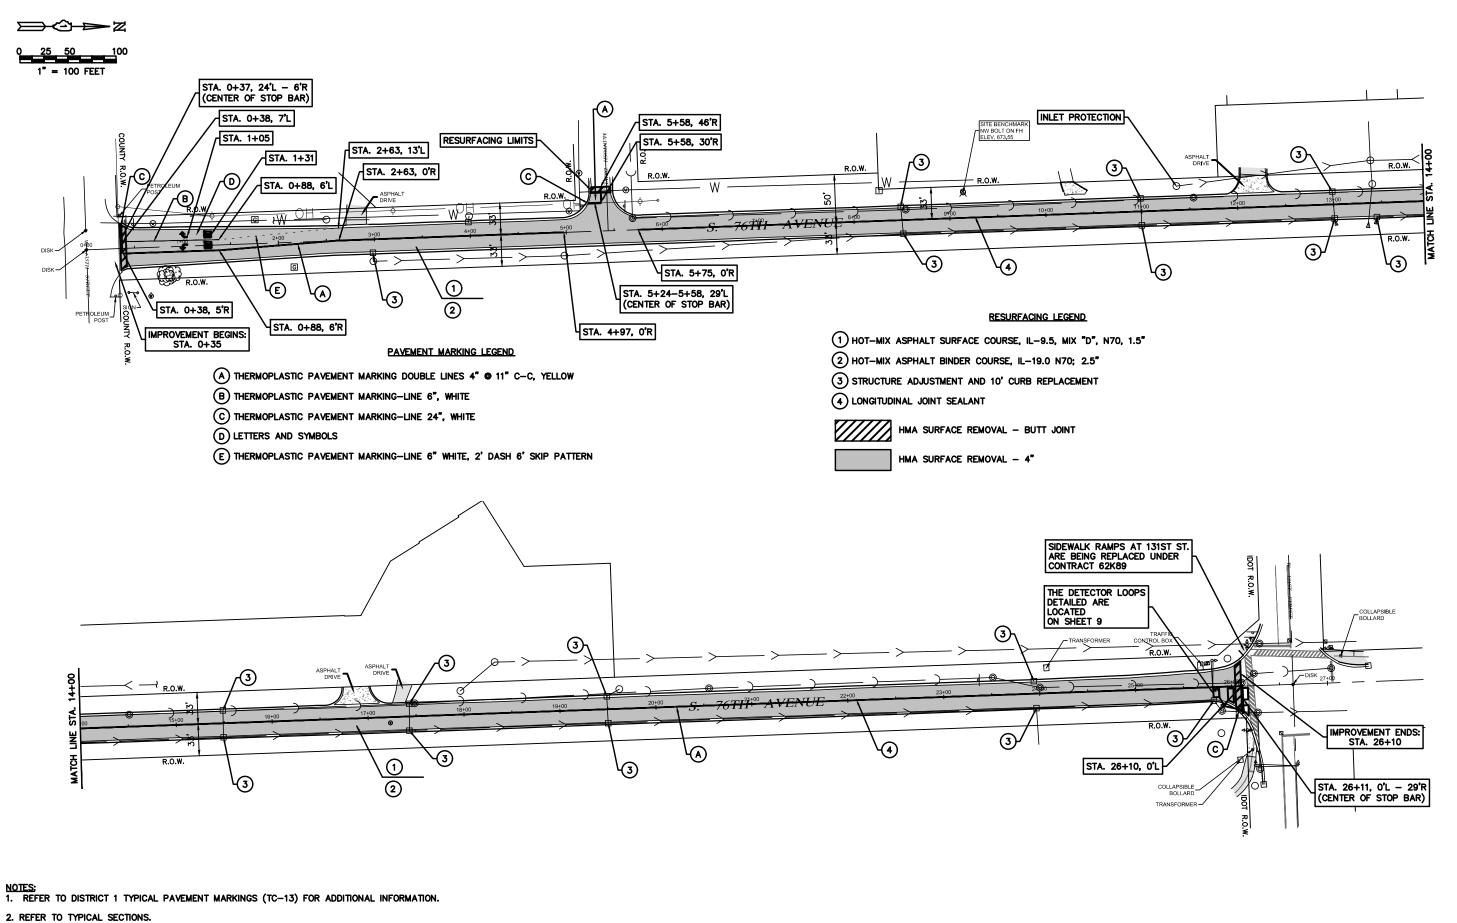
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(STA. 0+36 - STA. 26+10)

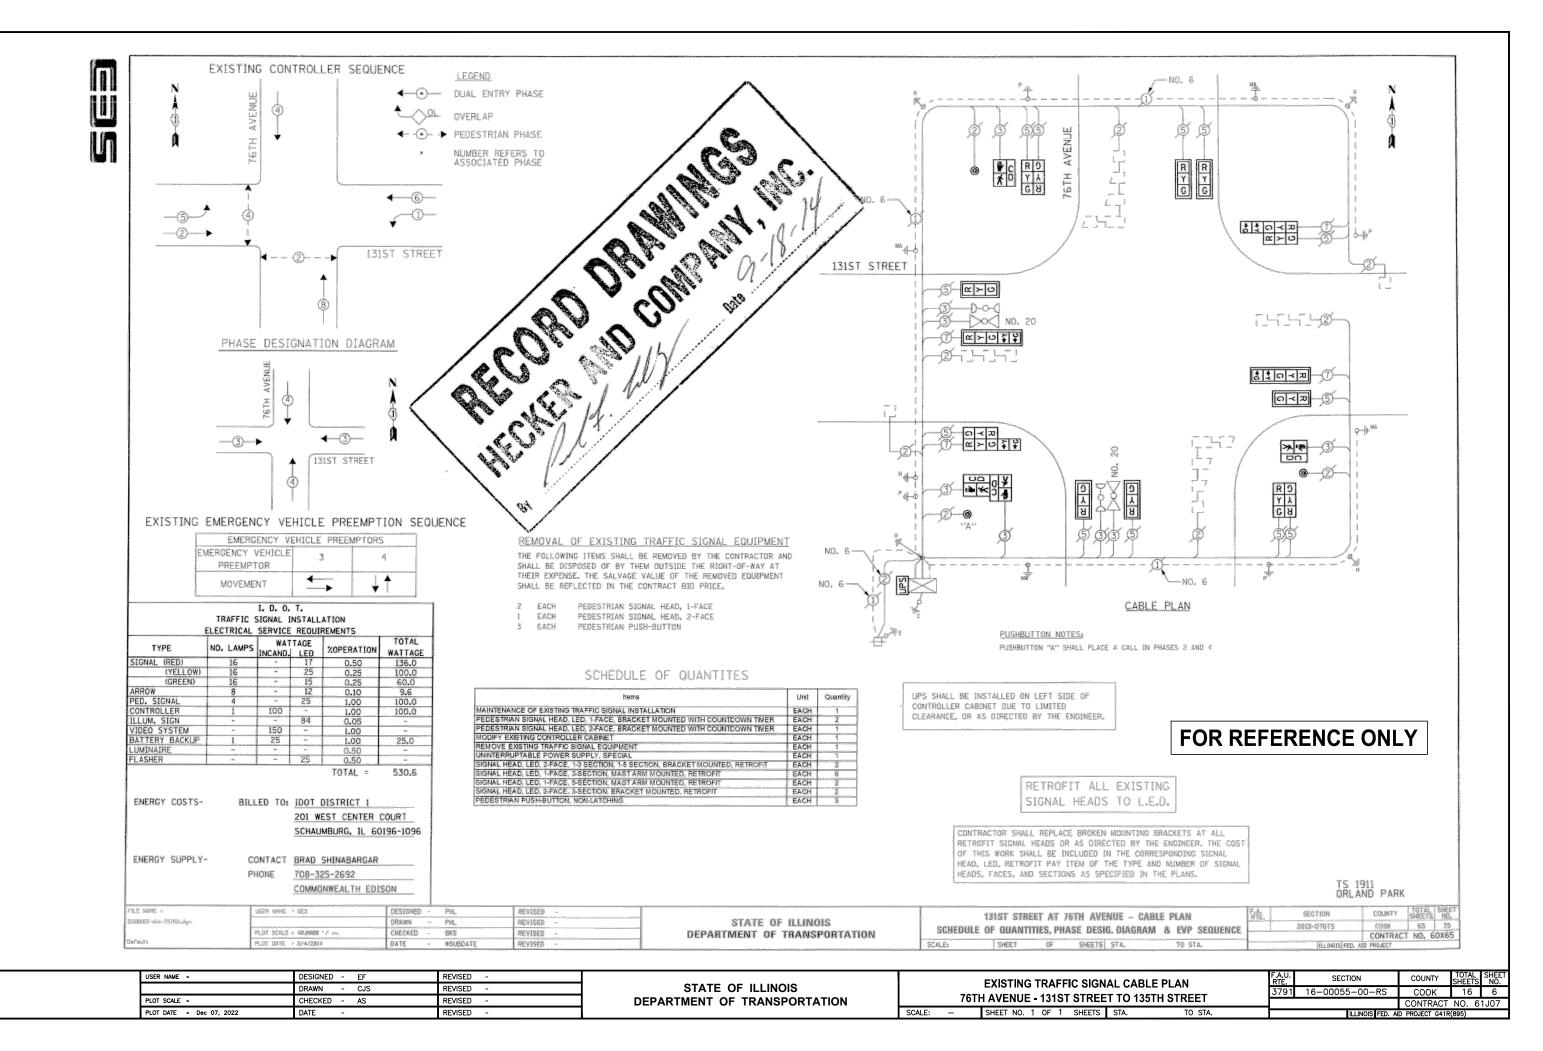
- A. EXISTING BITUMINOUS SURFACE COURSE (1.5")
- B. EXISTING BITUMINOUS BINDER COURSE (2.5")
- C. EXISTING BITUMINOUS BASE COURSE (6.5")
- D. EXISTING AGGREGATE SUB-BASE (4")

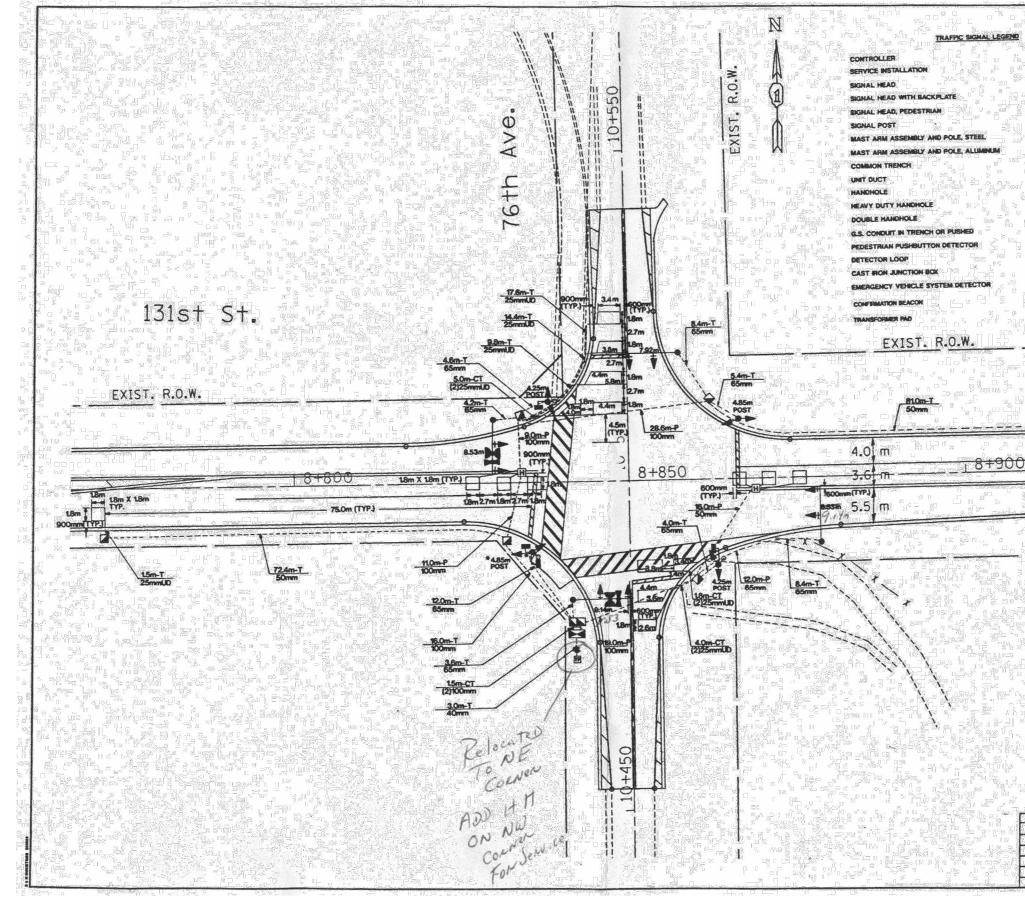
PROPOSED TYPICAL SECTION WITH CURB & GUTTER N.T.S (STA. 0+35 - STA. 26+10)

- A. PROPOSED HOT MIX ASPHALT SURFACE COURSE, IL-9.5, MIX "D", N70; 1.5"
- B. PROPOSED HOT MIX ASPHALT BINDER COURSE, IL-9.5, N70; 2.5"
- C. EXISTING PAVEMENT (5" 12")
- D. EXISTING AGGREGATE BASE COURSE (3.5" 9")



| | USER NAME = | DESIGNED - EF | REVISED - | | ROADWAY AND PAVEMENT MARKING PLANS - 76TH AVENUE | F.A.U. SECTION | COUNTY TOTAL SHEET |
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| PLOT SCALE = PLOT DATE = Dec 07, 2022 | DRAWN - CJS | REVISED - | STATE OF ILLINOIS | | 3791 16-00055-00-RS | соок 16 5 | |
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| | PLOT DATE = Dec 07, 2022 | DATE - | REVISED - | | SCALE: 1"=100' SHEET NO. 1 OF 1 SHEETS STA. 0+00 TO STA. 28+00 | ILLINOIS FED. AID | PROJECT G41R(895) |

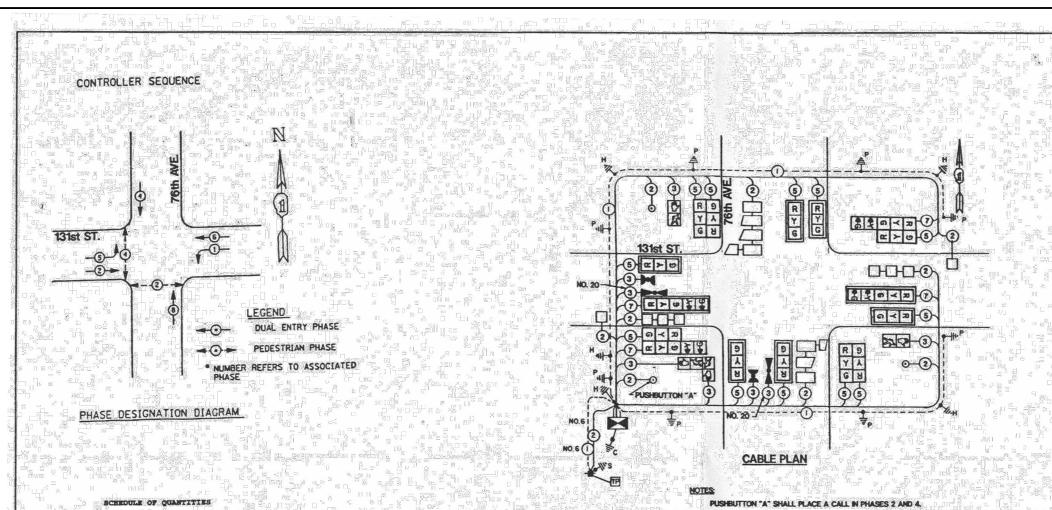




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| NAL PLANS TO 135TH STREET | | F.A.U. SECTION RTE. | | COUNTY | TOTAL SHEETS | SHEET NO. |
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| | | 91 | 16-00055-00-RS | COOK | 16 | 7 |
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SCHEDULE OF QUANTITIES

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| 6 | EACE | BANDROLL | - 116.6 | KETER - | ELECTRIC CABLE IN CONDUIT, SIGNAL NO. | 3.5 State 3 B | Part State | | 121 |
| | RACE | BEAVY-DUTY BANDROLE | | 0 0 2 2 8 | 14 2C | · 例子 ~ 11 | | " the side of the | 485 221 |
| . . . | EACH | DOUBLE HANDHOLE | 238.2 | RETER | ELECTRIC CABLE IN CONDUIT, SIGNAL NO. | | | | |
| | BACH | SIGNAL BEAD, 1-FACE, 3-SECTION, | art D. D. sa | 11.00 11 | 14 3C | | | | e di le |
| | f India | HAST ARM MOUNTED | 689.2 | METER | ELECTRIC CABLE IN CONDUIT, SIGNAL NO. | | nh Sanat | | 35 |
| 6-7 - 294 | EACH | SIGNAL HEAD, 1-FACE, 5-SECTION, | F D.D. | Same Same and | 14 SC | (bortes), · · · · · · · · · · · · · · · · · · · | EMERGENCY VEHICLE P | REEMPTION SEQUENCE | 2 D |
| gen aff | | MAST ARM MOUNTED | 253.4 | METER | ELECTRIC CABLE IN CONDUIT, SIGNAL NO. | | | to the state - 14 lives | |
| 14 Jan 12 11 | RACH | SIGNAL MEAD, 2-FACE, 3-SECTION, | 1000 m 1000 m 1000 m 1000 m 1 | Transmittered D.44 | 14 7C ELECTRIC CABLE IN CONDUIT, LEAD-IN, | 영화 관심 비율이 | | PROPOSED EMER | |
| | | BRACKET NOUNTED | 423.0 | METER | NO. 14 1 PAIR | | | FREEMP | 1-1-1-1-1-1-1-1-1-1-1-1-1-1-1-1-1-1-1- |
| c jil 2,* P | EACH | SIGNAL HEAD, 2-FACE, 1-3 SECTION, 1-5 | in here i | 1 | ELECTRIC CABLE IN CONDUIT, SERVICE, | 1 | | ENERGENCY VEHICLE | 3 |
| \$R≈°∭8R | | SECTION, BRACKET MOUNTED | 12 4 9 ⁵ - | METER | 10. 62C | | | PREEMPTOR | Signed . |
| 5- IR., 2 0 = | EACH | PEDESTRIAN SIGNAL HEAD, 1-FACE, | 3. 34 3. 4 · · · · · | RACH | TRAFFIC SIGNAL POST, | 131st ST. | | MOVEMENT | - |
| 17016 | e l'anne l'a | BRACKET MOUNTED | 2.000 | EACH | GALVANIZED STREL 4.25 METER | | | | 1. 0.0 |
| 1 1 1 | EACH | PEDESTRIAN SIGNAL HEAD, 2-FACE, | | RACE | TRAFFIC SIGNAL POST, GALVANIZED STEEL | -3- | | | |
| | - NLL - B | BRACKET MOUNTED | 174. J. M | | | | | | |
| s_dia | FACE | TRAFFIC SIGNAL BACKPLATE | a ale 🚛 🗟 | RACE | STEEL MAST ARM ASSEMBLY AND POLE, | | | | <u>.</u> п |
| | EACE | INDUCTIVE LOOP DETECTOR | | - Sanca | 7.92 MATER | 전 백왕 송양 집안 같다. | ೆ¶್ಲ ಎಂದರ್ಶಿ ಿ | Lucie A Lucie A | |
| • 2 | EACH | LIGHT DETECTOR | | EACH | STEEL MAST ARM ASSEMBLY AND POLE, | AL WALLS | 1 1 5 di grad | | Est. |
| • • 1 | EACH | LIGHT DETECTOR AMPLIFIER | i in the second second | | 8.53 MITTER | retrieven. | U TELEPART | | 3. Za |
| | EACH | FULL-ACTUATED CONTROLLER AND | A A A | BACH | STEEL MAST ARM ASSEMBLY AND POLE, | To said P | | | 10 1 |
| C | gi V E. T | TYPE IV CABINET | | | 9.14 DETTER | | R State Bay | | 1 M 4 |
| The second | EACH | PEDESTRIAN PUSE-BUTTON | 6.0 | METER | CONCRETE FOUNDATION, TYPE & | | | | Mr. 12 |
| | EACE | SERVICE INSTALLATION, POST MOUNT | | METER | CONCRETE FOUNDATION, TYPE D | | | 그는 날랐지만 날았어 | 0 0 |
| 2.2 | SQ X | SIGN PANEL - TYPE 2 | 12.0 | METER | CONCRETE FOUNDATION, TYPE E | ないる「「日本」「 | Pharman State | | i _n a Sa |
| 9_3.0 | METER. | CONDUIT IN TRENCH, 40MM DIA., | | | 600MM DIAMETER | | 8) ···································· | | - 0 |
| 2,2 0 | TALLE | CALVANILLED STEEL | 198.8 | METER | DETECTOR LOOP, TYPE I | | 말 : 동안 바람 옷을 ! | | Ĝ. |
| 153.4 | METER | CONDUIT IN TRENCE, SOUND DIA., | 280.1 | METER | TRENCE AND BACKFILL FOR ELECTRICAL | | 图 主义的法律 化算法 | 1977년 1월 79 Hours (Million) | S. 58 |
| | | GALVANIZED STEEL | | | WORK | | | | |
| 50.6 | METER | CONDUIT IN TRENCE, 65MM DIA., | . 90.6 | METER | ELECTRIC CABLE IN CONDUIT NO. 20 3/C. | 그야 맛요. ㅋ ㅋ | | | 202 1 |
| C 03 U | N | GALVANIZED STEEL | | a na an | TWISTED, SEIELDED | | 10 2345 25 | 1844년 1931년 1841년 1841년 1971년 1841년 1841 | . ufesa |
| 17.5 | METER | CONDUIT IN TRENCH, 100MM DIA., | 170.2 | METER | ELECTRIC CABLE IN CONDUIT, GROUNDING NO.6 IC (GREEN) | | The second second | | 20 mg |
| 1 \$1.98 m | 1 January 18 | CONDUIT PUSHED, 50MM DIA., GALVANIZED | _==×anseenee ⊻ICs 23 | ්ත ීප් දේ | · ' ' · · · · · · · · · · · · · · · · · | | | | -92 |
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| 12.0 | METER | STREE | in alle Ma | | | 영지:양상적 한 부가 | | | Ši E. |
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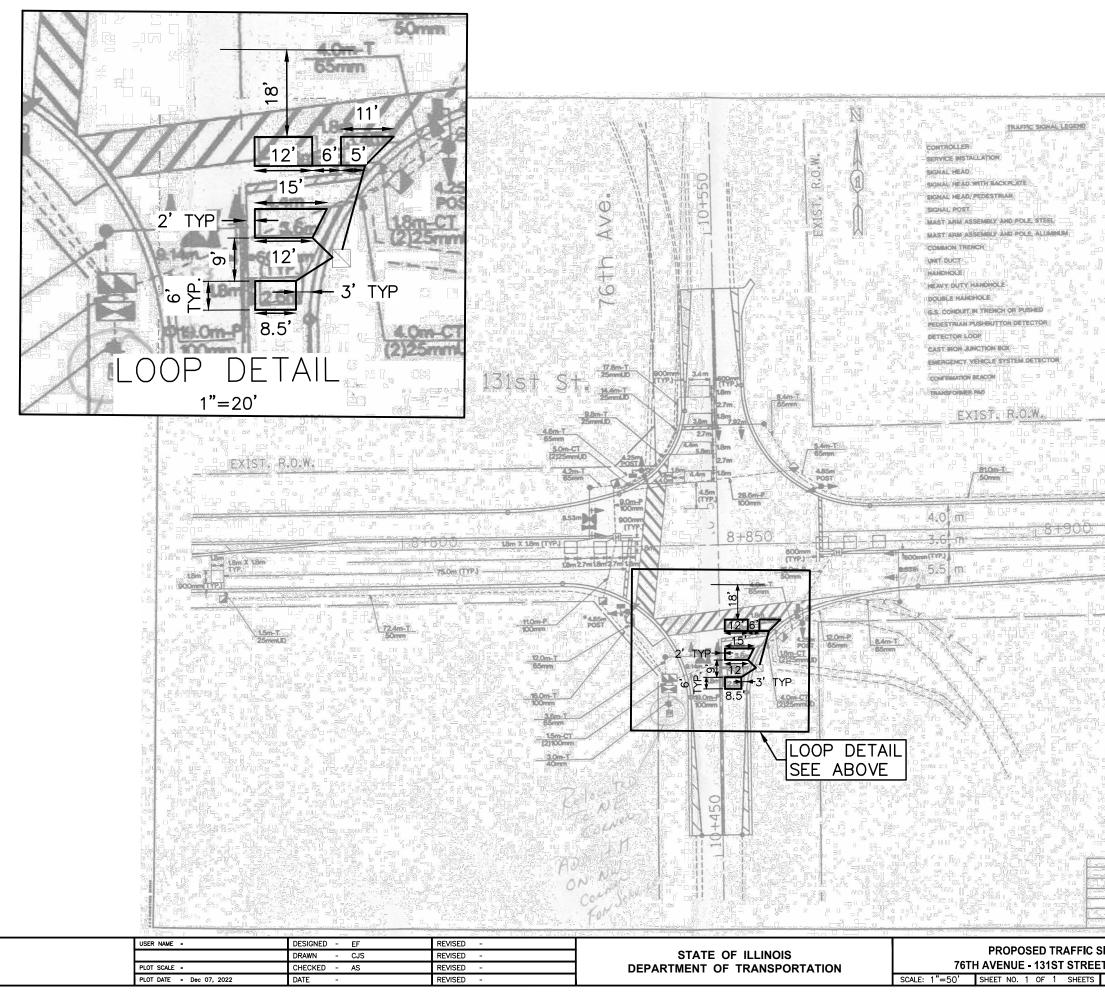
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| | DRAWN - CJS | REVISED - | STATE OF ILLINOIS | | EXISTING TRAFFIC SIGNAL |
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EMERGENCY VEHICLE

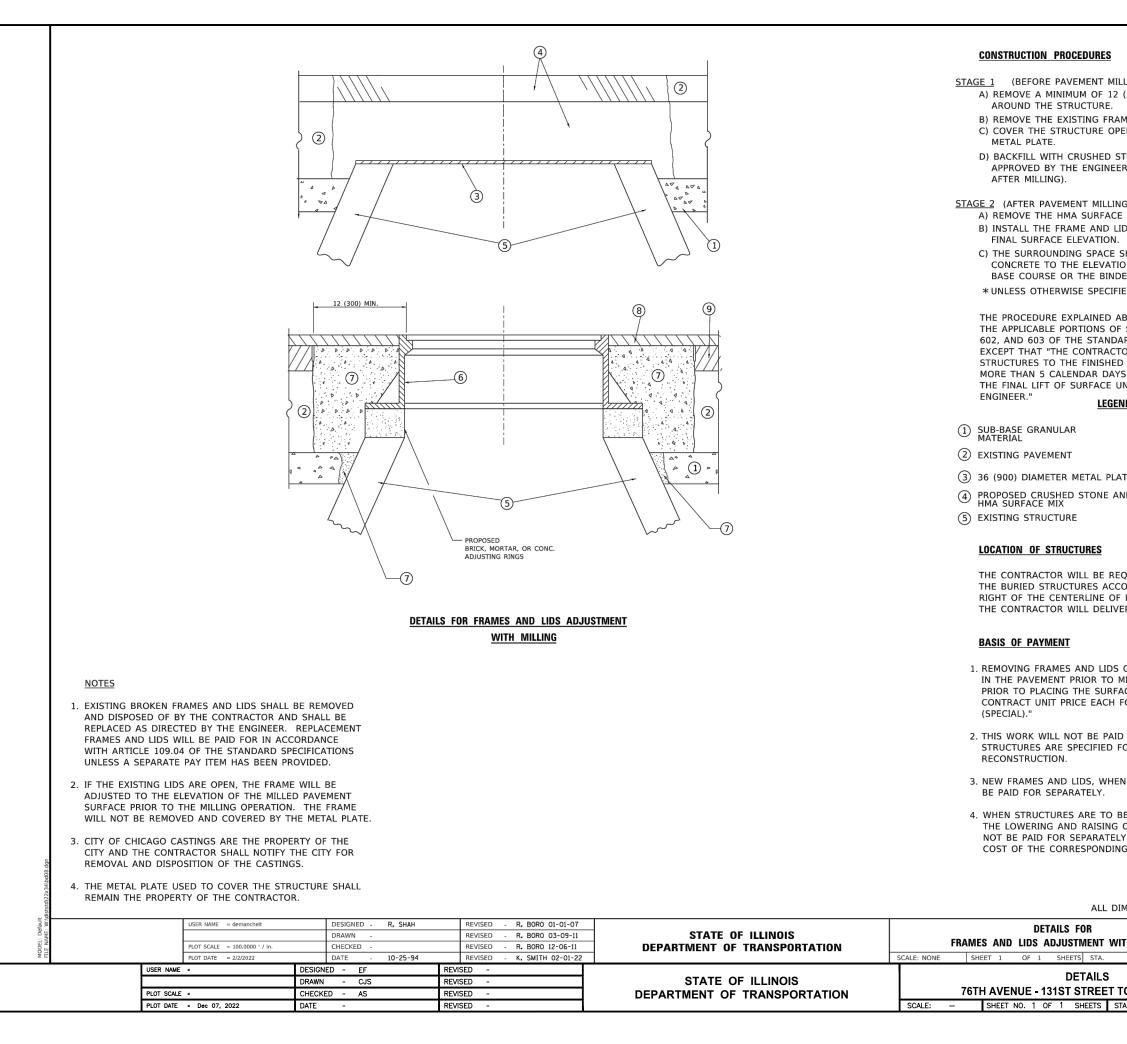
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DETAILS FOR

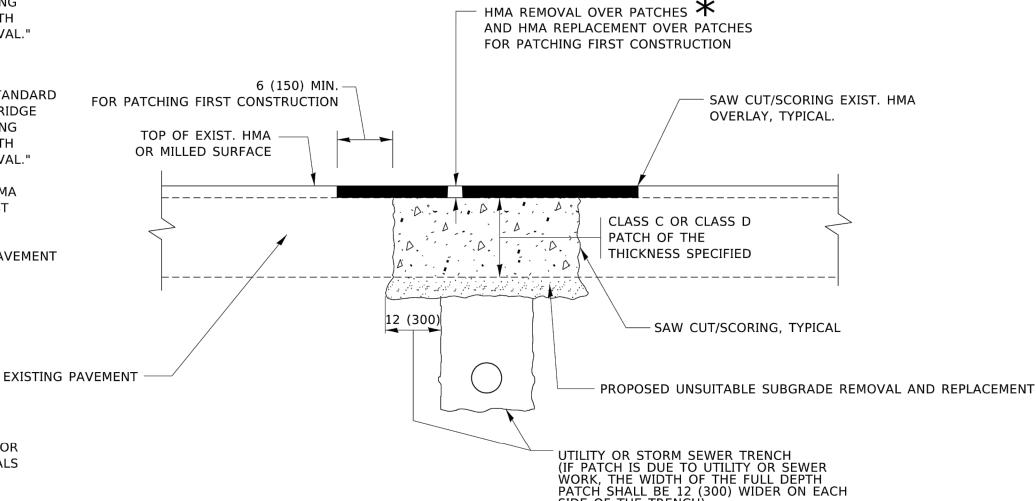
| ROCEDURES | | | | | | | | | | | | | | |
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| AVEMENT MILLING) IMUM OF 12 (300) OF THE PAVEMENT FROM TRUCTURE. XISTING FRAME AND UD FROM THE STRUCTURE | | | | | | | | | | | | | | |
| | ISTING FRAME AND LID FROM THE STRUCTURE. UCTURE OPENING WITH A 36 (900) DIAMETER | | | | | | | | | | | | | |
| CRUSHED STONE AND HMA SURFACE MIX HE ENGINEER. (MIN. 1 1/2 (40) HMA TO REMAIN | | | | | | | | | | | | | | |
| MENT MILLING) MA SURFACE MIX AND CRUSHED STONE. RAME AND LID; ADJUST THE FRAME TO ITS ELEVATION. DING SPACE SHALL BE FILLED WITH CLASS*PP-1 THE ELEVATION OF THE SURFACE OF THE EXISTING DR THE BINDER COURSE. WISE SPECIFIED IN THE PLANS. | | | | | | | | | | | | | | |
| EXPLAINED ABOVE PORTIONS OF SECT THE STANDARD S IE CONTRACTOR SI THE FINISHED PAV LENDAR DAYS PRI F SURFACE UNLES | | | | | | | | | | | | | | |
| LEGEND | | | | | | | | | | | | | | |
| _AR | 6 FRAME AND LI | D (SEE | NOTES | S) | | | | | | | | | | |
| NT | (7) CLASS*PP-1 C | ONCRET | Ē | | | | | | | | | | | |
| R METAL PLATE | (8) PROPOSED HM | | ACE (| OURCE | | | | | | | | | | |
| ED STONE AND | 0 | | | | | | | | | | | | | |
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| UCTURES | | | | | | | | | | | | | | |
| CTURES ACCORDIN | ED TO KEEP A RECO NG TO THE STATIO EMENT. UPON COM IE RECORD TO THE | N AND E | DISTAN N OF 1 | NCE LEFT OR | | | | | | | | | | |
| <u>NT</u> | | | | | | | | | | | | | | |
| T PRIOR TO MILLIN G THE SURFACE C | DRAINAGE AND UTIL IG, AND ADJUSTING OURSE, WILL BE PA FRAMES AND LIDS | G TO FIN AID FOR | IAL GF | RADE HE | | | | | | | | | | |
| | WHEN DRAINAGE AYMENT AS STRUC | | ILITY | | | | | | | | | | | |
| D LIDS, WHEN SPE ARATELY. | CIFIED, WILL | | | | | | | | | | | | | |
| ARATELY. LES ARE TO BE ADJUSTED OR RECONSTRUCTED, AND RAISING OF THE FRAMES AND LIDS WILL R SEPARATELY BUT WILL BE INCLUDED IN THE IRRESPONDING PAY ITEM. | | | | | | | | | | | | | | |
| ALL DIMENS | IONS ARE IN INCHE | S (MILL | ІМЕТЕ | RS) UNLESS | OTHERWIS | SE SHOWN | | | | | | | | |
| LS FOR | | F.A. RTE. | | SECTION | COUNTY | TOTAL SHEET SHEETS NO. | Т | | | | | | | |
| USTMENT WITH M | IILLING | B | 0600-0: | 3 (BD-08) | CONTRAC | T NO. | - | | | | | | | |
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| DETAILS | | | RTE. 3791 | SECTI 16-00055- | | COUNTY COOK | TOTAL SHEETS 16 | NÖ. 10 | | | | | | |
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| SHEETS STA. | TO STA. | | | IL | LINOIS FED. AI | D PROJECT G41R | (895) | | | | | | | |

METHOD OF MEASUREMENT

REFER TO SECTION 442 OF THE STANDARD SPECIFICATIONS FOR ROAD AND BRIDGE CONSTRUCTION AND THE RECURRING SPECIAL PROVISION "PATCHING WITH HOT-MIX ASPHALT OVERLAY REMOVAL."

BASIS OF PAYMENT

- 1. REFER TO SECTION 442 OF THE STANDARD SPECIFICATIONS FOR ROAD AND BRIDGE CONSTRUCTION AND THE RECURRING SPECIAL PROVISION "PATCHING WITH HOT-MIX ASPHALT OVERLAY REMOVAL."
- 2. SAW CUT/SCORING OF EXISTING HMA OVERLAY IS INCLUDED IN THE COST OF PAVEMENT PATCHING.
- 3. SAW CUT/SCORING OF EXISTING PAVEMENT IS INCLUDED IN THE COST OF PAVEMENT PATCHING.



SEE TYPICAL SECTIONS FOR * THICKNESS AND MATERIALS

SEQUENCE OF CONSTRUCTION (PATCHING FIRST)

- 1. REMOVE THE EXISTING HMA MATERIAL OVER THE AREA TO BE PATCHED.
- 2. REMOVE AND REPLACE WITH CLASS C OR D PATCH.
- 3. REPLACE HMA MATERIAL OVER THE AREA TO BE PATCHED.

SEQUENCE OF CONSTRUCTION (MILLING FIRST)

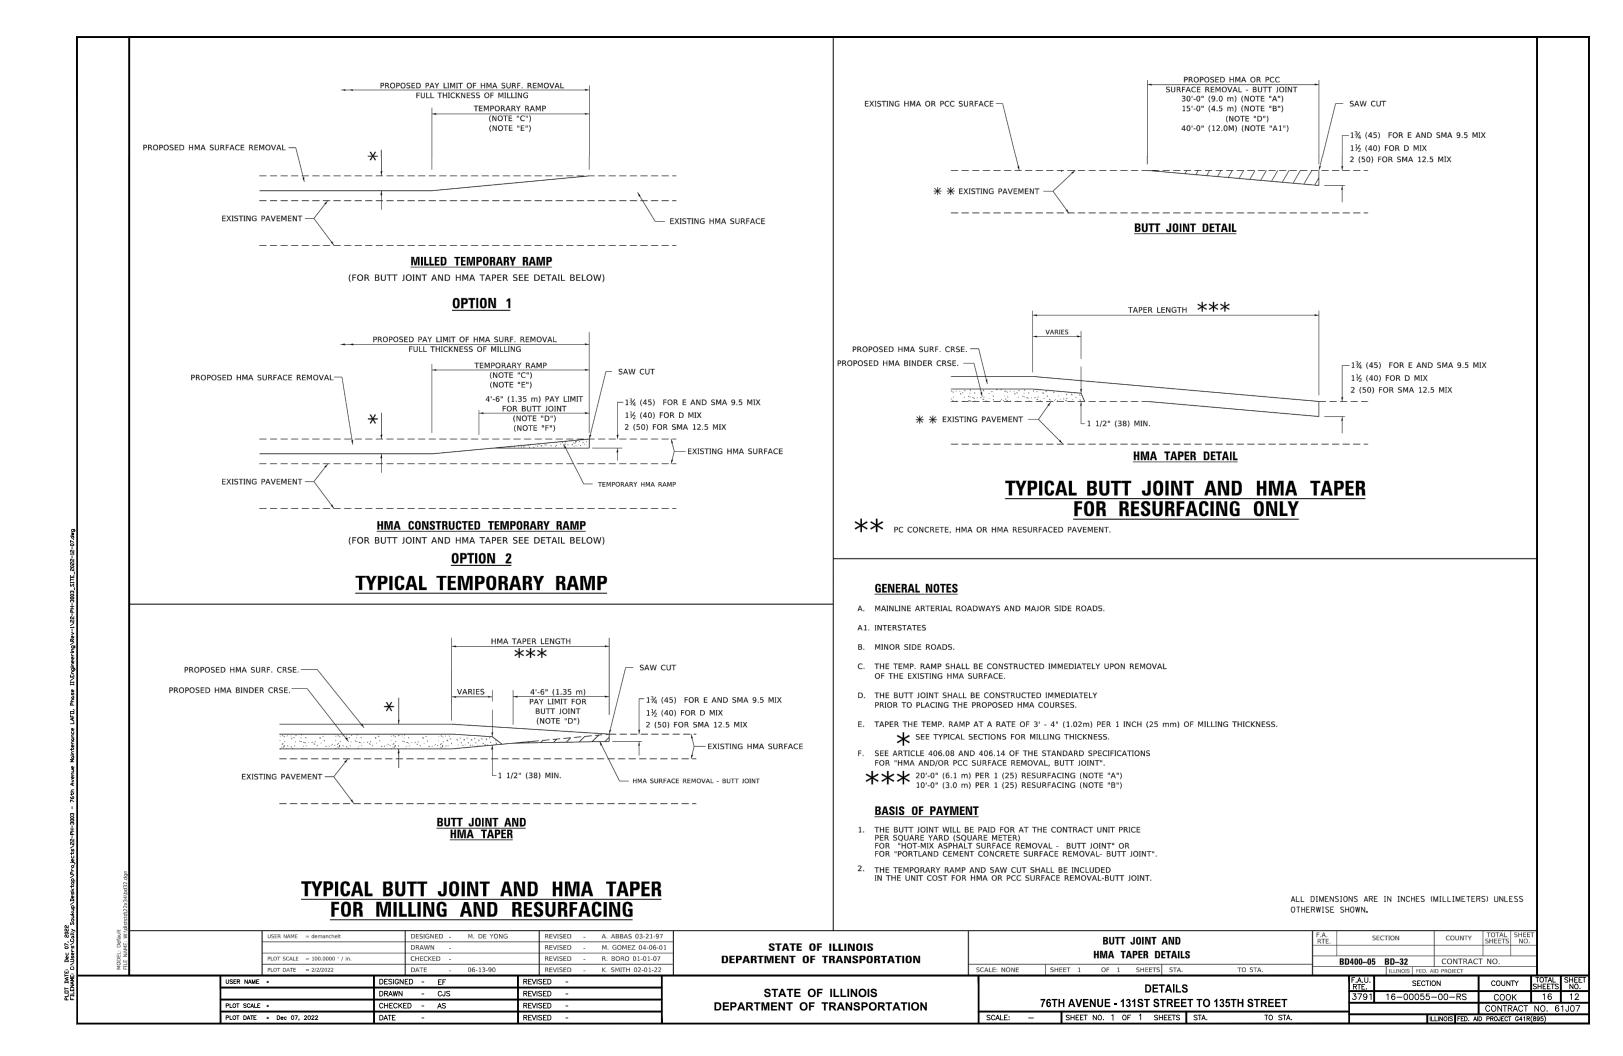
- 1. MILL HMA FIRST IF THERE IS AT LEAST $4\frac{1}{2}$ INCHES OR MORE OF HMA MATERIAL ON TOP OF THE EXISTING PAVEMENT OR IF THE PAVEMENT IS FULL DEPTH HMA. A MINIMUM OF 2 INCHES OF HMA MATERIAL SHALL BE IN PLACE AFTER MILLING.
- 2. REMOVE AND REPLACE WITH FULL DEPTH CLASS D PATCHES TO TOP OF MILLED SURFACE.

| | | USER NAME = demanchelt | DE | DESIGNED - R. SHAH | | RE | REVISED - R. BORO 01-01-07 | | | | | PΔ | VEMEN. | Т РАТСН | IING F | OR . | | | F.A. SECTION | | | COUNTY TOTAL SHEET SHEETS NO. | | - |
|----|------------|---|----|--------------------|-----------|---------------------------|------------------------------|-------------------|--|---|----|-------|--------|---------|------------------|---------------|---------|--------------|-----------------------------------|---------------------------|-------|----------------------------------|--|---|
| | [| | DF | RAWN - | | RE | REVISED - R. BORO 09-04-07 | | STATE OF ILLINOIS | | | | | | | INIE. | | | 511 | | | | | |
| | | PLOT SCALE = 100.0000 ' / in. CHECKED - | | | | REVISED - K. ENG 10-27-08 | | | DEPARTMENT OF TRANSPORTATION | HMA SURFACED PAVEMENT | | | | | BD400-04 (BD-22) | | | CONTRACT NO. | | | | | | |
| | | PLOT DATE = 2/2/2022 | DA | ATE - 10- | -25-94 | RE | VISED - K. SMITH 02-01-22 | | | SCALE: NONE | SH | EET 1 | OF 1 | SHEETS | STA. | | TO STA. | | | | | AID PROJECT | | |
| US | USER NAME | DRAWN - CJS | | R | REVISED - | | | STATE OF ILLINOIS | | DETAILS | | | | | | F.A.U. RTF | SECTIO | N C | OUNTY | TOTAL SHEET SHEETS NO. | | | | |
| | | | | - CJS REVIS | | EVISED | VISED - | | | | | | | | | | 3791 | 16-00055- | 00-RS | соок | 16 11 | | | |
| F | PLOT SCALE | | | R | REVISED - | | DEPARTMENT OF TRANSPORTATION | | 76TH AVENUE - 131ST STREET TO 135TH STREET | | | | | :ET | | | | | NTRACT | NO. 61J07 | | | | |
| | PLOT DATE | DATE = Dec 07, 2022 DATE | | E - REVISED - | | - | | | | SCALE: - SHEET NO. 1 OF 1 SHEETS STA. TO STA. | | | | |) STA. | | | | ILLINOIS FED. AID PROJECT G41R(89 | | | | | |

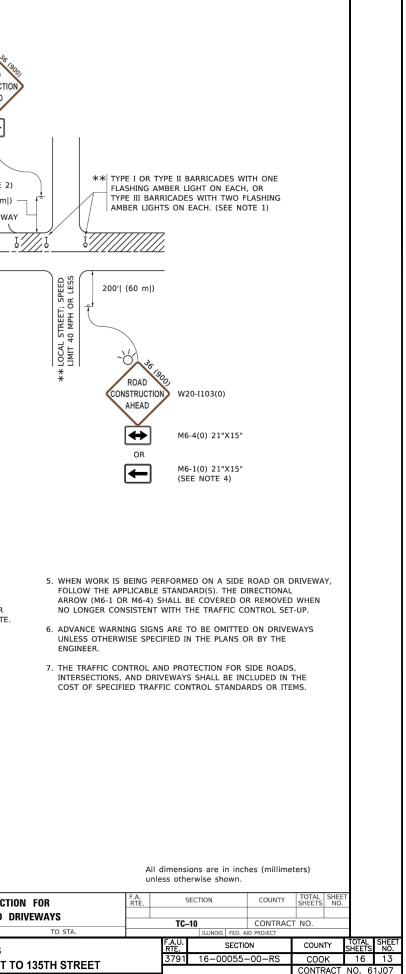


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ALL DIMENSIONS ARE IN INCHES (MILLIMETERS) UNLESS OTHERWISE SHOWN.

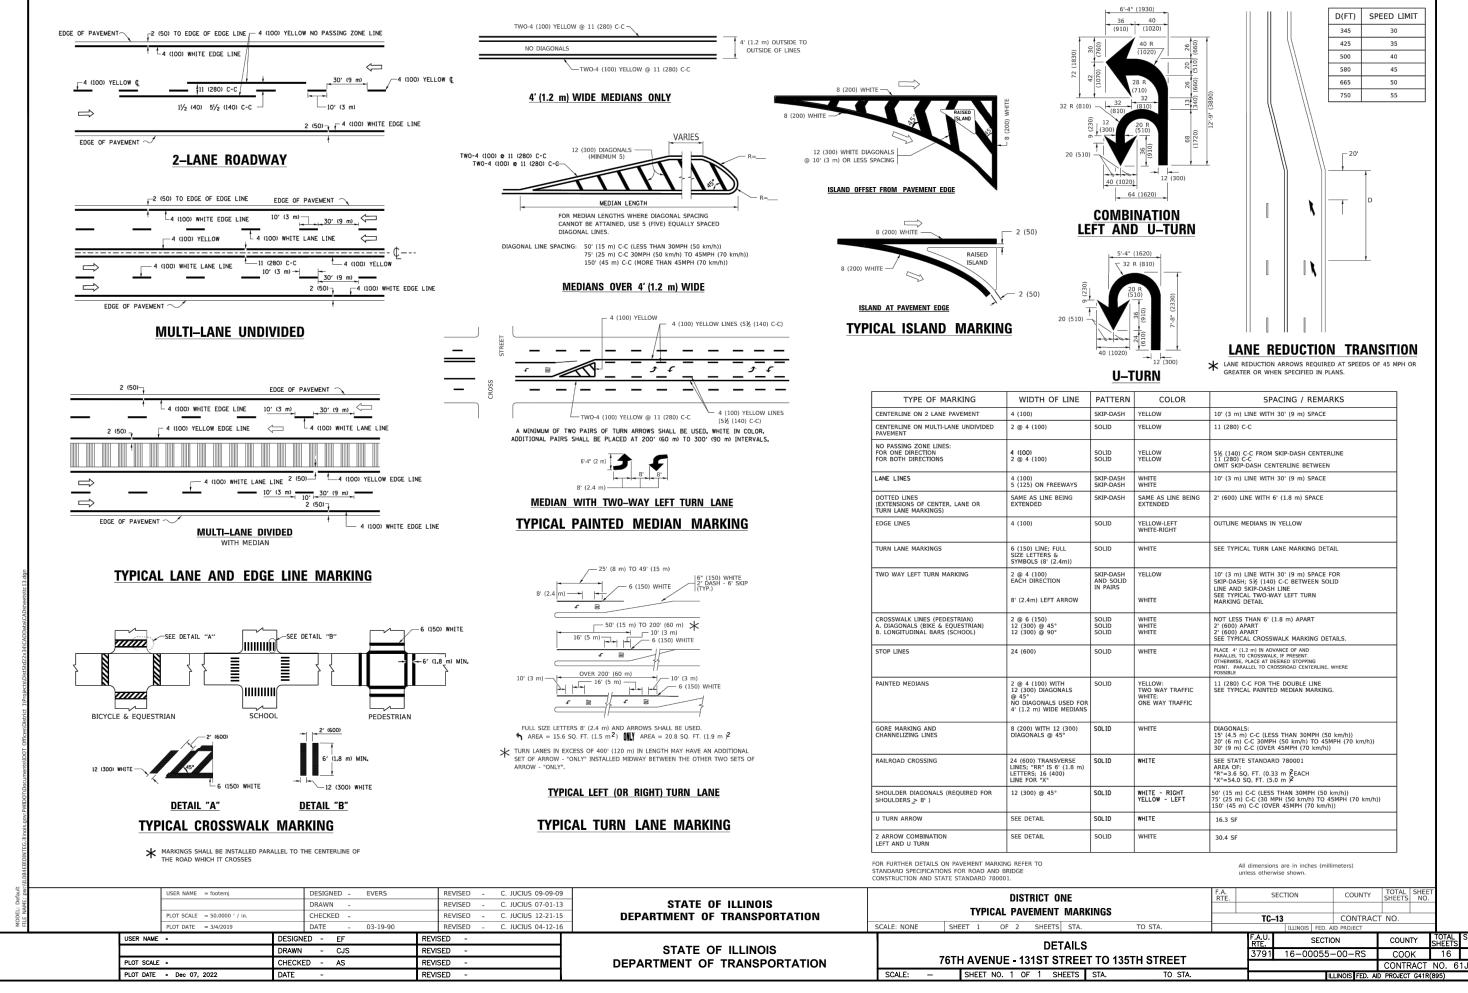


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|---|---|---|--|-----------------------------------|---|---|
| MODEL: Default FILE NAME: parvillogate | USER NAME = footemj PLOT SCALE = 50.0000 ' / in. PLOT DATE = 3/4/2019 | DESIGNED - L.H.A. DRAWN - CHECKED - DATE - 06-89 | REVISED - A. HOUSEH 10-15-96 REVISED - T. RAMMACHER 01-06-00 REVISED - A. SCHUETZE 07-01-13 REVISED - A. SCHUETZE 09-15-16 | STATE OF ILI DEPARTMENT OF TRA | | TRAFFIC CONTROL AND PROTECTION SIDE ROADS, INTERSECTIONS, AND DRIVE SCALE: NONE SHEET 1 OF 1 SHEETS STA. |
| 1464 | USER NAME = PLOT SCALE = PLOT DATE = Dec 07, 2022 | DESIGNED - EF DRAWN - CJS CHECKED - AS DATE - | REVISED - REVISED - REVISED - REVISED - REVISED - | STATE OF IL DEPARTMENT OF TR/ | | DETAILS 76TH AVENUE - 131ST STREET TO 1 SCALE: – SHEET NO. 1 OF 1 SHEETS STA. |

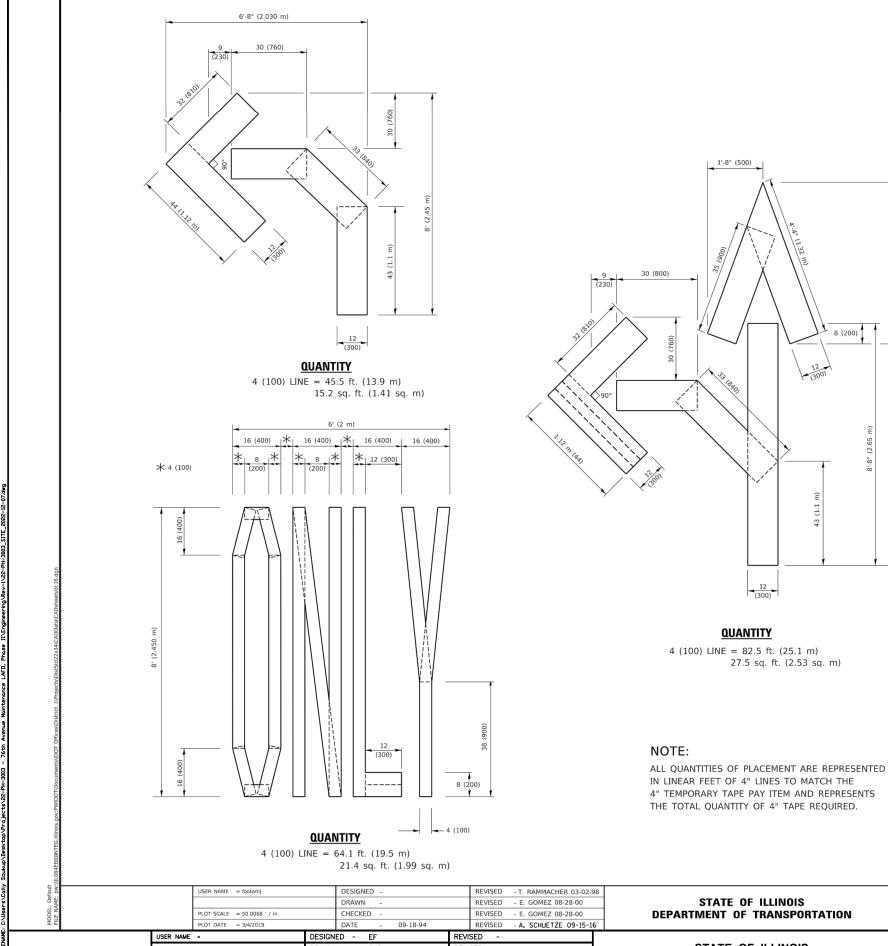


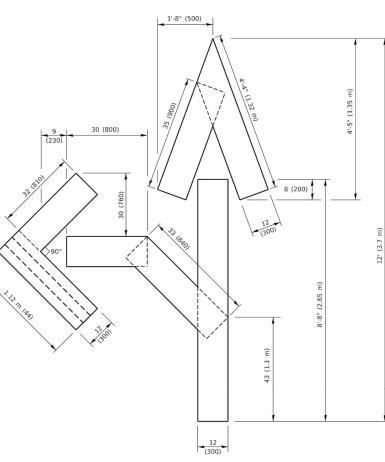
ILLINOIS FED. AID PROJECT G41R(895)

TO STA.



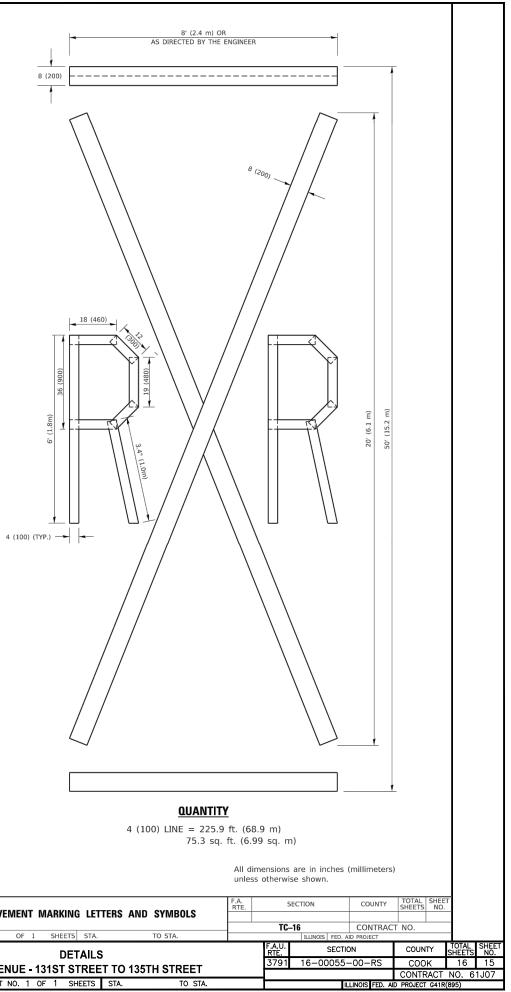
| | TO STA. | | ILLINOIS | | - | | |
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| | | F.A.U. RTE. | 5 | SECTION | COUNTY | TOTAL SHEETS | SHEE NO. |
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| STA. | TO STA. | | | ILLINOIS FED. A | D PROJECT G41R | 895) | |
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4 (100) LINE = 82.5 ft. (25.1 m) 27.5 sq. ft. (2.53 sq. m)



| | | | | · · · · · · · · · · · · · · · · · · · | | | | | | | | | | | | |
|--------------|--------------|--------------------|------------------------------|---------------------------------------|-------------|------------|-----------|---------------------------------|------------------------------|------------------------------|-------------|---------|----------|---------|---------|------|
| fault pw: | ILE NAME: pw | | USER NAME = footemj | | | DESIGNED - | | REVISED - T. RAMMACHER 03-02-98 | | | | | | | | |
| AME. | | | | DRAWN - | | | REVISED | ED - E. GOME | EZ 08-28-00 | STATE OF ILLINOIS | SHO | ARKING | LETTERS | | | |
| E N | | | PLOT SCALE = 50.0068 ' / in. | | CHECKED - | | REVIS | ED - E. GOME | EZ 08-28-00 | DEPARTMENT OF TRANSPORTATION | | | | | | |
| MIC | | | PLOT DATE = 3/4/2019 | | DATE - | 09-18-94 | REVIS | ED - A. SCHU | JETZE 09-15-16 | | SCALE: NONE | SH | EET 1 | OF 1 | SHEETS | STA. |
| | | USER NAME = | | | | REVISED | REVISED - | | | | | | | DETA | | |
| | | | | | | | REVISED - | | | STATE OF ILLINOIS | | | | | DETA | |
| | | PLOT SCALE = CHECK | | CKED - AS RE | | REVISED | REVISED - | | DEPARTMENT OF TRANSPORTATION | | 76T | H AVEN | UE - 13 | 1ST STF | REET TO | |
| | | PLOT DATE | LOT DATE = Dec 07, 2022 DATE | | - REVISED - | | - | | | SCALE: | - | SHEET N | 10. 1 OF | 1 SHEE | TS STA | |

