## 03-10-2023 LETTING ITEM 086

FOR INDEX OF SHEETS, SEE SHEET NO. 2

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**TRAFFIC DATA PINGREE ROAD:** ADT (2022) = 909 POSTED SPEED LIMIT = 55 MPH

HIGHWAY CLASSIFICATION: MINOR COLLECTOR

THIS PROJECT IS LOCATED IN THE VILLAGE OF LAKE IN THE HILLS

FULL SIZE PLANS HAVE BEEN PREPARED USING STANDAR ENGINEERING SCALES. REDUCED SIZED PLANS WILL NOT CONFORM TO STANDARD SCALES. IN MAKING MEASUREMENTS ON REDUCED PLANS, THE ABOVE SCALES MAY BE USED.

J.U.L.I.E. JOINT UTILITY LOCATION INFORMATION FOR EXCAVATORS 1-800-892-0123 OR 811

# FESSION BRENT PENDRY 062-067501 FOFILL WILLING THE 11/28/2022 EXP 11/30/2023

MMMMM,


**STATE OF ILLINOIS DEPARTMENT OF TRANSPORTATION** 

# PROPOSED **HIGHWAY PLANS**

**PINGREE ROAD VIRGINIA ROAD TO JAMES R RAKOW ROAD** RESURFACING

SECTION NO. 22-00041-00-RS **PROJECT NO. GLWV(725) VILLAGE OF LAKE IN THE HILLS MCHENRY COUNTY** 

C-91-002-23

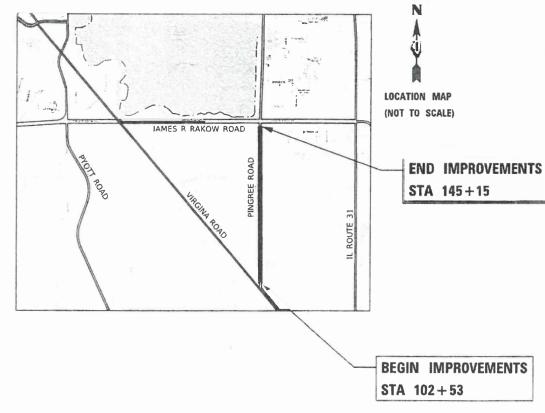


GROSS LENGTH = 4,262 FT. = 0.807 MILE NET LENGTH = 4,262 FT. = 0.807 MILE

SCHAUMBURG, IL Р. RAMOS, I щ CARMEN **ENGINEER:** PROGRAM AID FEDERAL

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#### **INDEX OF SHEETS**

- COVER SHEET 1
- INDEX OF SHEETS, GENERAL NOTES, AND HIGHWAY STANDARDS
- SUMMARY OF QUANTITIES 3
- 4 TYPICAL SECTIONS
- 5-8 PLAN SHEETS
- 9-12 DISTRICT 1 DETAILS

#### **HIGHWAY STANDARDS**

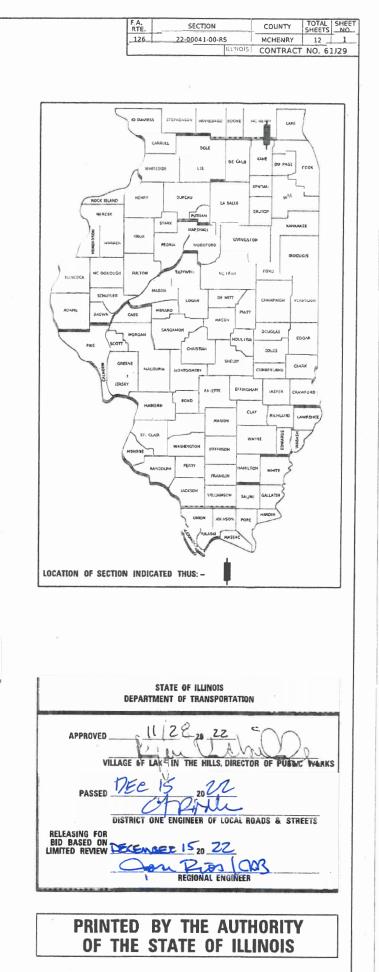000001-08 STANDARD SYMBOLS, ABBREVIATIONS AND PATTERNS 001006 DECIMAL OF AN INCH AND OF A FOOT 442201-03 CLASS C AND D PATCHES 701006-05 OFF-ROAD OPERATIONS, 2L, 2W, 15' (4.5 M) TO 24" (600 MM) FROM PAVEMENT EDGE 701201-05 LANE CLOSURE, 2L, 2W, DAY ONLY, FOR SPEEDS > 45 MPH 701301-04 LANE CLOSURE, 2L, 2W, SHORT TIME OPERATIONS 701306-04 LANE CLOSURE, 2L, 2W, SLOW MOVING OPERATIONS DAY ONLY, FOR SPEEDS > 45 MPH 701311-03 LANE CLOSURE, 2L, 2W, MOVING OPERATIONS - DAY ONLY 701336-07 LANE CLOSURE, 2L, 2W, WORK AREAS IN SERIES, FOR SPEEDS > 45 MPH 701701-10 URBAN LANE CLOSURE, MULTILANE INTERSECTION 701901-08 TRAFFIC CONTROL DEVICES 780001-05 TYPICAL PAVEMENT MARKINGS

#### **DISTRICT 1 DETAILS**

- BD32 BUTT JOINTS AND HMA TAPER
- DISTRICT ONE TYPICAL PAVEMENT MARKINGS TC13 TC16 SHORT-TERM PAVEMENT MARKING LETTERS AND SYMBOLS
- TC22 ARTERIAL ROAD INFORMATION SIGN

#### **GENERAL NOTES**

- 1. ALL REFERENCES TO "STANDARD SPECIFICATIONS" IN THESE GENERAL NOTES SHALL BE INTERPRETED TO MEAN "STANDARD SPECIFICATIONS FOR ROAD AND BRIDGE CONSTRUCTION" ADOPTED BY THE ILLINOIS DEPARTMENT OF TRANSPORTATION, JANUARY 1, 2022.
- ELECTRIC, TELEPHONE, AND GAS FACILITIES. (48 HOURS NOTIFICATION REQUIRED), THE CONTRACTOR SHALL BE RESPONSIBLE FOR CONTACTING THE OWNER OF ALL EXISTING UTILITY FACILITIES SO THAT THE UTILITIES AND THEIR APPLIRTENANCES MAY BE LOCATED AND ADJUSTED OR MOVED, IF NECESSARY, PRIOR TO THE START OF CONSTRUCTION OPERATIONS.
- THE LOCATION OF ALL AERIAL OR UNDERGROUND UTILITIES HAVE NOT BEEN SHOWN ON THE PLANS. THE CONTRACTOR SHALL BE 3 RESPONSIBLE FOR THE PROTECTION OF ALL UNDERGROUND OR SURFACE UTILITIES EVEN THOUGH THEY MAY NOT BE SHOWN ON THE PLANS. ANY UTILITY THAT IS DAMAGED DURING CONSTRUCTION SHALL BE REPAIRED OR REPLACED TO THE SATISFACTION OF THE ENGINEER AND VILLAGE
- TO THE START OF CONSTRUCTION ACTIVITIES.
- 5. THE CONTRACTOR WILL NOT BE ALLOWED TO SET UP A YARD OR FIELD OFFICE ON PUBLIC PROPERTY WITHOUT THE WRITTEN PERMISSION OF THE ENGINEER
- 6. PRIOR APPROVAL OF THE ENGINEER.
- 7. IT SHALL BE THE CONTRACTOR'S RESPONSIBILITY TO VERIFY ALL DIMENSIONS AND CONDITIONS EXISTING IN THE FIELD PRIOR TO CONSTRUCTION AND ORDERING OF MATERIALS
- 8. DO NOT SCALE PLANS FOR CONSTRUCTION DIMENSIONS.
- 9. THIS PROJECT
- PROVIDED FOR IN THE CONTRACT SPECIFICATIONS, OVERNIGHT CLOSURES SHALL NOT BE ALLOWED FOR REHABILITATION PROJECTS INVOLVING DAYTIME MILLING AND RESURFACING OPERATIONS AND CLASS D PATCHING.
- 11. BEFORE BEGINNING ANY WORK, THE CONTRACTOR SHALL RETAIN AND RECORD FOR FUTURE REFERENCE, ALL EXISTING PAVEMENT MARKINGS LINES IN ORDER THAT THESE LOCATIONS CAN BE RE-ESTABLISHED FOR STRIPING. EXACT LOCATIONS OF ALL PAVEMENT MARKINGS SHALL BE AS DIRECTED BY THE RESIDENT ENGINEER.
- 12. PAVEMENT MARKING TAPE, TYPE IV, SHALL BE USED FOR SHORT TERM PAVEMENT MARKINGS ON ALL FINAL SURFACES.
- 13. THE CONTRACTOR SHALL MAINTAIN THE SITE IN A CLEAN AND ORDERLY MANNER, DEBRIS AND SURPLUS MATERIAL SHALL BE REMOVED AND RESTORATION SHALL PROCEED AS THE WORK PROCEEDS. IF THE ENGINEER SO DIRECTS, THE CONTRACTOR SHALL STOP ALL OTHER WORK AND CONCENTRATE ON CLEAN-UP AND RESTORATION. DEBRIS AND SURPLUS MATERIAL SHALL BE DISPOSED BY THE CONTRACTOR OFF-SITE.
- 14. CONTRACTOR SHALL TAKE PRECAUTION BY PRESERVING EXISTING TREES WITHIN THE RIGHT OF WAY. IF ANY DAMAGE OCCURS, TREES SHALL BE REPLACED IN KIND PER ARTICLE 201.07 REPAIR OR REPLACEMENT OF EXISTING PLANT MATERIAL REQUIREMENTS STATED HEREIN.

NO COMMITMENTS

JSER NAME = bpendry DESIGNED - BNP REVISED PINGREE BOAD BI - RAWN STATE OF ILLINOIS DPW REVISED INDEX OF SHEETS, GENERAL NOTES LOT SCALE = 40,0000 ' / in. HECKED -SPF REVISED **DEPARTMENT OF TRANSPORTATION** SCALE: NTS SHEET PLOT DATE = 12/27/2022 REVISED OF DATE SHEE

2. BEFORE STARTING ANY EXCAVATION, THE CONTRACTOR SHALL CALL "JULIE" AT (800) 892-0123 OR 811 FOR FIELD LOCATIONS OF BURIED

4. THE CONTRACTOR SHALL COORDINATE CONSTRUCTION ACTIVITIES WITH VILLAGE OF LAKE IN THE HILLS, UTILITY COMPANIES AND THE ENGINEER. THE CONTRACTOR SHALL CONTACT THE VILLAGE OF LAKE IN THE HILLS AT (847) 960-7500 A MINIMUM OF 72 HOURS PRIOR

THE STORAGE OF EQUIPMENT AND/OR MATERIALS WITHIN THE RIGHT-OF-WAY OF ANY STREET AND/OR PARK PROPERTY SHALL REQUIRE

THE CONTRACTOR SHALL BE REQUIRED TO PROVIDE ACCESS TO ABUTTING PROPERTY AT ALL TIMES DURING THE CONSTRUCTION OF

10. UNLESS OTHER CONDITIONS WARRANT EXTENDED LANE CLOSURE AS DETERMINED AND APPROVED IN WRITING BY THE ENGINEER OR AS

## COMMITMENTS

F.A. RTE	SECT	ΓΙΟΝ		COUNTY	TOTAL SHEETS	SHEET NO.
126	22-0004	1-00-RS		MCHENRY	12	2
				CONTRACT	NO. 6	1J29
		ILLINOIS	FED. AI	D PROJECT		
	RTE.	RTE. SEC	RTE. SECTION 126 22-00041-00-RS	RTE. SECTION   126 22-00041-00-RS	RTE. SECTION COUNT   126 22-00041-00-RS MCHENRY   CONTRACT	RTE. SECTION COUNTY SHEETS   126 22-00041-00-RS MCHENRY 12   CONTRACT NO. 6


CODE NO.	ITEM	UNIT	TOTAL QUANTIT	
21101625	TOPSOIL FURNISH AND PLACE, 6"	SQ YD	902	
25000210	SEEDING, CLASS 2A	ACRE	0.25	
25100630	EROSION CONTROL BLANKET	SQ YD	902	
28000250	TEMPORARY EROSION CONTROL SEEDING	POUND	19	
40600290	BITUMINOUS MATERIALS (TACK COAT)	POUND	7754	
40600370	LONGITUDINAL JOINT SEALANT	FOOT	4262	
40600982	HOT-MIX ASPHALT SURFACE REMOVAL - BUTT JOINT	SQ YD	29	
40603200	POLYMERIZED HOT-MIX ASPHALT BINDER COURSE, IL-4.75, N50	TON	474	
40604060 HOT-MIX ASPHALT SURFACE COURSE, IL-9.5, MIX "D", N50		TON	1287	
44000157	44000157 HOT-MIX ASPHALT SURFACE REMOVAL, 2"		11487	
44201713	CLASS D PATCHES, TYPE I, 6 INCH	SQ YD	230	
44201717	CLASS D PATCHES, TYPE II, 6 INCH	SQ YD	230	
44201721	CLASS D PATCHES, TYPE III, 6 INCH	SQ YD		
44201723	CLASS D PATCHES, TYPE IV, 6 INCH	SQ YD	345	
48102100	AGGREGATE WEDGE SHOULDER, TYPE B	TON	144	
67100100	MOBILIZATION	L SUM	1	
70100450	TRAFFIC CONTROL AND PROTECTION, STANDARD 701201	L SUM	1	
70100460	TRAFFIC CONTROL AND PROTECTION, STANDARD 701306	L SUM	1	
70100600	TRAFFIC CONTROL AND PROTECTION, STANDARD 701336	L SUM	1	
70102635	TRAFFIC CONTROL AND PROTECTION, STANDARD 701701	L SUM	1	
70300100	SHORT TERM PAVEMENT MARKING	FOOT	6176	

CODE NO	D. ITEM	UNIT	TOTAL QUANTIT
7030015	0 SHORT TERM PAVEMENT MARKING REMOVAL	SQ FT	2059
7030021	1 TEMPORARY PAVEMENT MARKING LETTERS AND SYMBOLS - PAINT	SQ FT	36
7030022	1 TEMPORARY PAVEMENT MARKING - LINE 4"- PAINT	FOOT	8223
7030024	1 TEMPORARY PAVEMENT MARKING - LINE 6"- PAINT	FOOT	12
7030026	1 TEMPORARY PAVEMENT MARKING - LINE 12"- PAINT	FOOT	52
7800010	0 THERMOPLASTIC PAVEMENT MARKING - LETTERS AND SYMBOLS	SQ FT	36
7800020	0 THERMOPLASTIC PAVEMENT MARKING - LINE 4"	FOOT	8223
7800040	0 THERMOPLASTIC PAVEMENT MARKING - LINE 6"	FOOT	12
7800060	0 THERMOPLASTIC PAVEMENT MARKING - LINE 12"	FOOT	52
7810010	0 RAISED REFLECTIVE PAVEMENT MARKER	EACH	84
7830020	0 RAISED REFLECTIVE PAVEMENT MARKER REMOVAL	EACH	8
X202011	0 GRADING AND SHAPING SHOULDERS	UNIT	81
Z003085	0 TEMPORARY INFORMATION SIGNING	SQ FT	51.4
Z007660	0 TRAINEES	HOUR	500
Z007660	4 TRAINEES TRAINING PROGRAM GRADUATE	HOUR	500
8			-
2 2 2			


\* SPECIALTY ITEMS

# CONSTRUCTION TYPE CODE 0042


ESURFACING	F.A. RTE.	SECT	TION		COUNTY	TOTAL SHEETS	SHEET NO.
UANTITIES	126	22-0004	1-00-RS	Ĩ,	MCHENRY	12	3
IOANTITIE5					CONTRACT	NO. 61	1J29
TS STA. TO STA.			ILLINOIS FED	. AID	PROJECT		

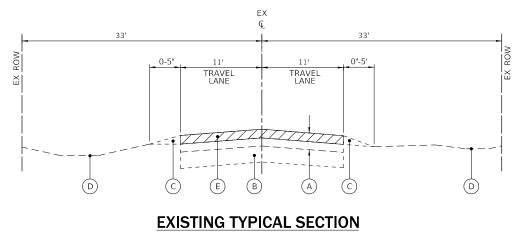

PINGREE ROAD STA 102+53 TO STA 134+15

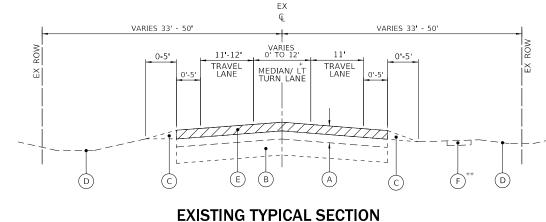


PINGREE ROAD STA 134+15 TO STA 145+15

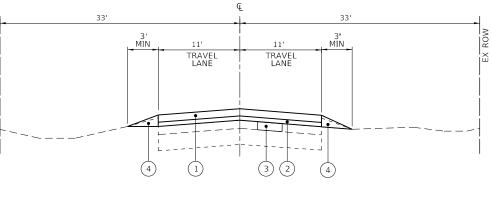

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## HOT-MIX ASPHALT MIXTURE REQUIREMENTS

EXISTING LEGEND
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ROW
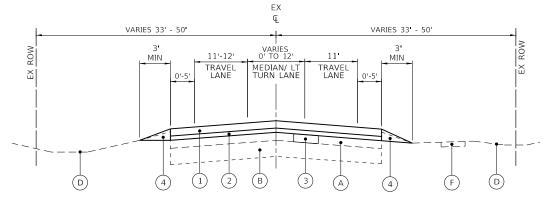
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- (A) EXISTING HOT-MIX ASPHALT PAVEMENT THICKNESS VARIES 6" TO 12"
- (B) EXISTING AGGREGATE BASE COURSE THICKNESS VARIES
- C EXISTING AGGREGATE/TURF SHOULDER
- D EXISTING GROUND
- (E) HOT-MIX ASPHALT SURFACE REMOVAL 2"

REMOVAL ITEMS

(F) EXISTING PORTLAND CEMENT CONCRETE SIDEWALK

- **PROPOSED LEGEND**
- (1) HOT-MIX ASPHALT SURFACE COURSE, MIX "D", IL-9.5, N50 2"
- 2 POLYMERIZED HOT-MIX ASPHALT BINDER COURSE, IL-4.75, N50 3/4"
- (3) CLASS D PATCHES, TYPE I IV, 6-INCH
- (4) AGGREGATE WEDGE SHOULDER, TYPE B
- NOTES: 1. THE LONGITUDINAL JOINT SEALANT SHALL BE PLACED OVER THE POLYMERIZED HMA BC IL-4.75, N50.

THE	UNIT	WEIGHT	USED	то
		TYPE"FOF		


USER NAME = bpendry	DESIGNED - BNP	REVISED -			PI	IGREE R	ROAD RESURFACING	3	F.A. BTE	SECTION	COUNTY	TOTAL SHEET
	DRAWN - DPW	REVISED -	STATE OF ILLINOIS						126	22-00041-00-RS	MCHENRY	12 4
PLOT SCALE = 20.0000 ' / in.	CHECKED - SPF	REVISED -	DEPARTMENT OF TRANSPORTATION			TYPIC	CAL SECTIONS				CONTRAC	T NO. 61J29
PLOT DATE = 12/27/2022	DATE -	REVISED -		SCALE:	SHEET	OF	SHEETS STA.	TO STA.		ILLINOIS FED. A	AID PROJECT	

# \* STA 139+27 TO JAMES R RAKOW ROAD \*\* STA 140+50 TO JAMES R RAKOW ROAD


MIXTURE TYPE	AIR VOIDS @NDES	QMP		
PAVEMENT RESURFACING				
HOT-MIX ASPHALT SURFACE COURSE, MIX "D", IL-9.5, N50 - 2"	4% @ 50 GYR.	LR1030-2		
POLYMERIZED HOT-MIX ASPHALT BINDER COURSE, IL-4.75, N50 - 3/4"	3.5% @ 50 GYR.	LR1030-2		
PAVEMENT PATCHING				
CLASS D PATCHES (HMA BINDER IL-19mm)	4% @ 70 GYR.	LR1030-2		
QMP DESIGNATION: QUALITY CONTROL/QUALITY ASSURANCE (QC/QA) PER LR1030-2				

CALCULATE ALL HMA SURFACE MIXTURE QUANTITIES IS 112 LBS/SQ YD/IN.

THE "AC TYPE"FOR POLYMERIZED HMA MIXES SHALL BE "SBS/SBR PG 76 -22"AND FOR NON-POLYMERIZED HMA THE "AC TYPE"SHALL BE "PG 64 -22"UNLESS MODIFIED BY RECLAIMED MATERIALS SPECIFICATIONS.

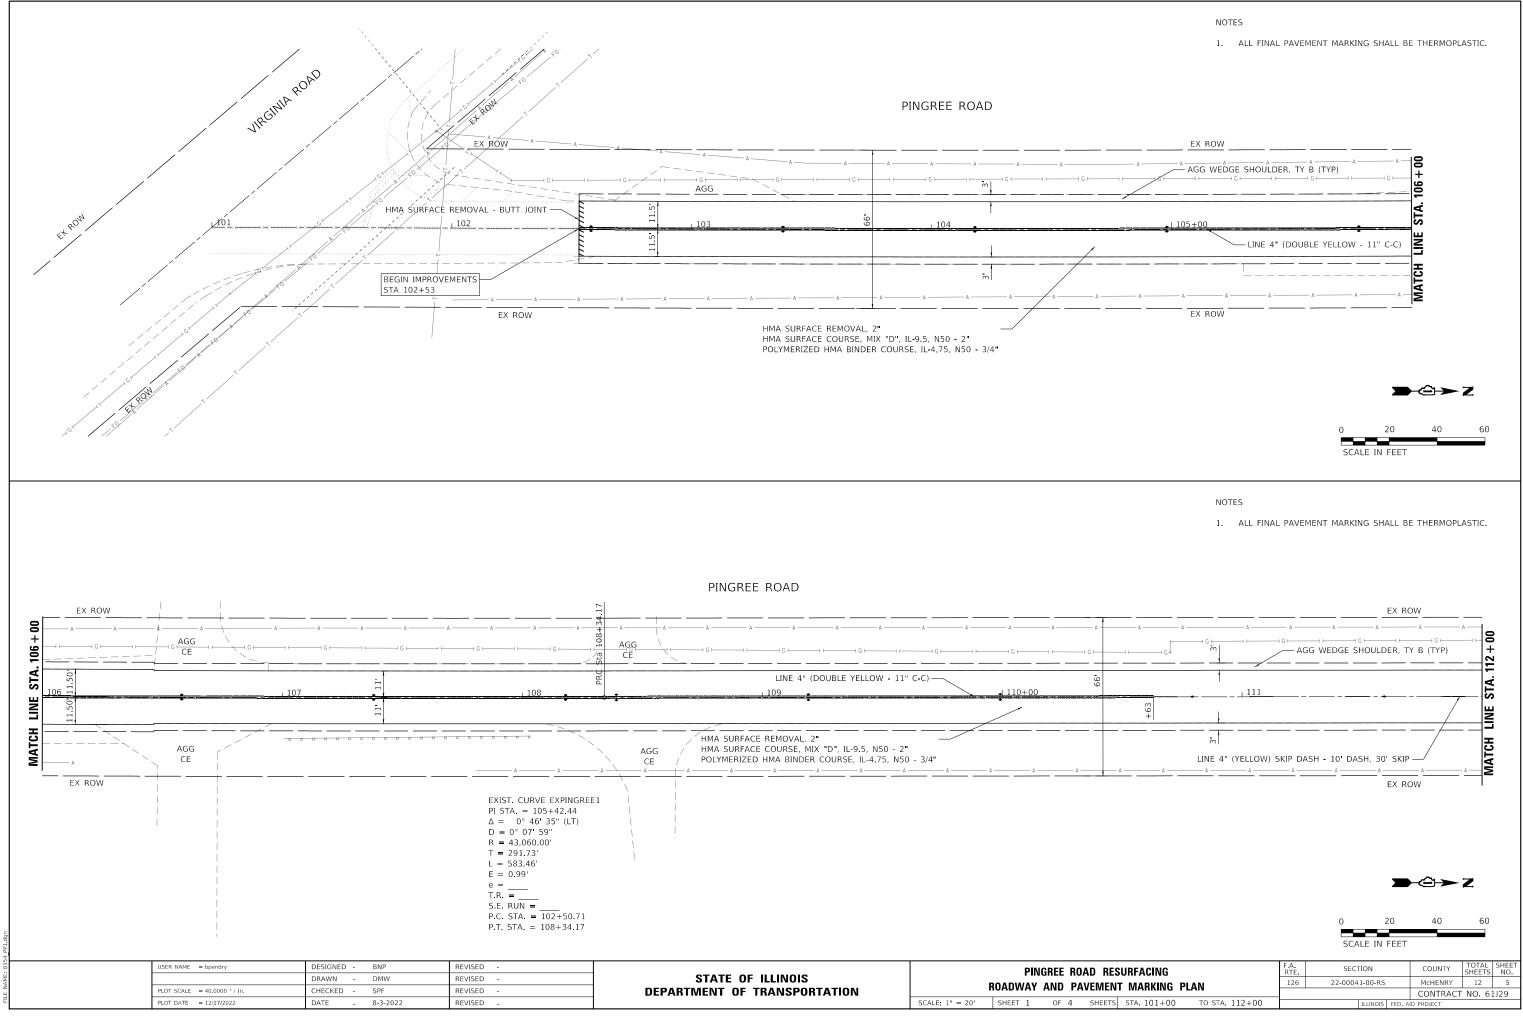


ESURFACING	F.A. RTE	SECTION	COUNTY	TOTAL SHEETS	SHEET NO.
NT MARKING PLAN	126	22-00041-00-RS	McHENRY	12	5
			CONTRACT	NO. 63	IJ29
TS STA. 101+00 TO STA. 112+00		ILLINOIS FED. A	ID PROJECT		

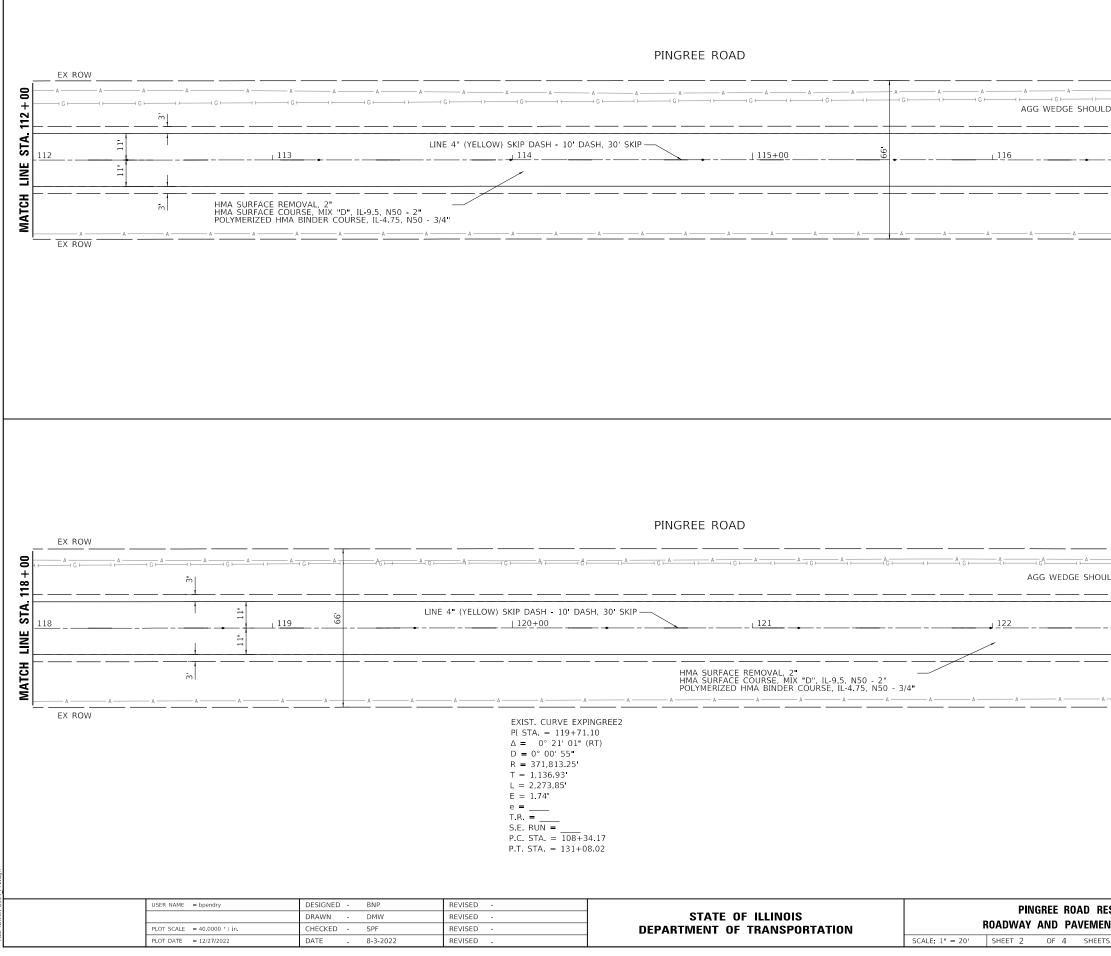


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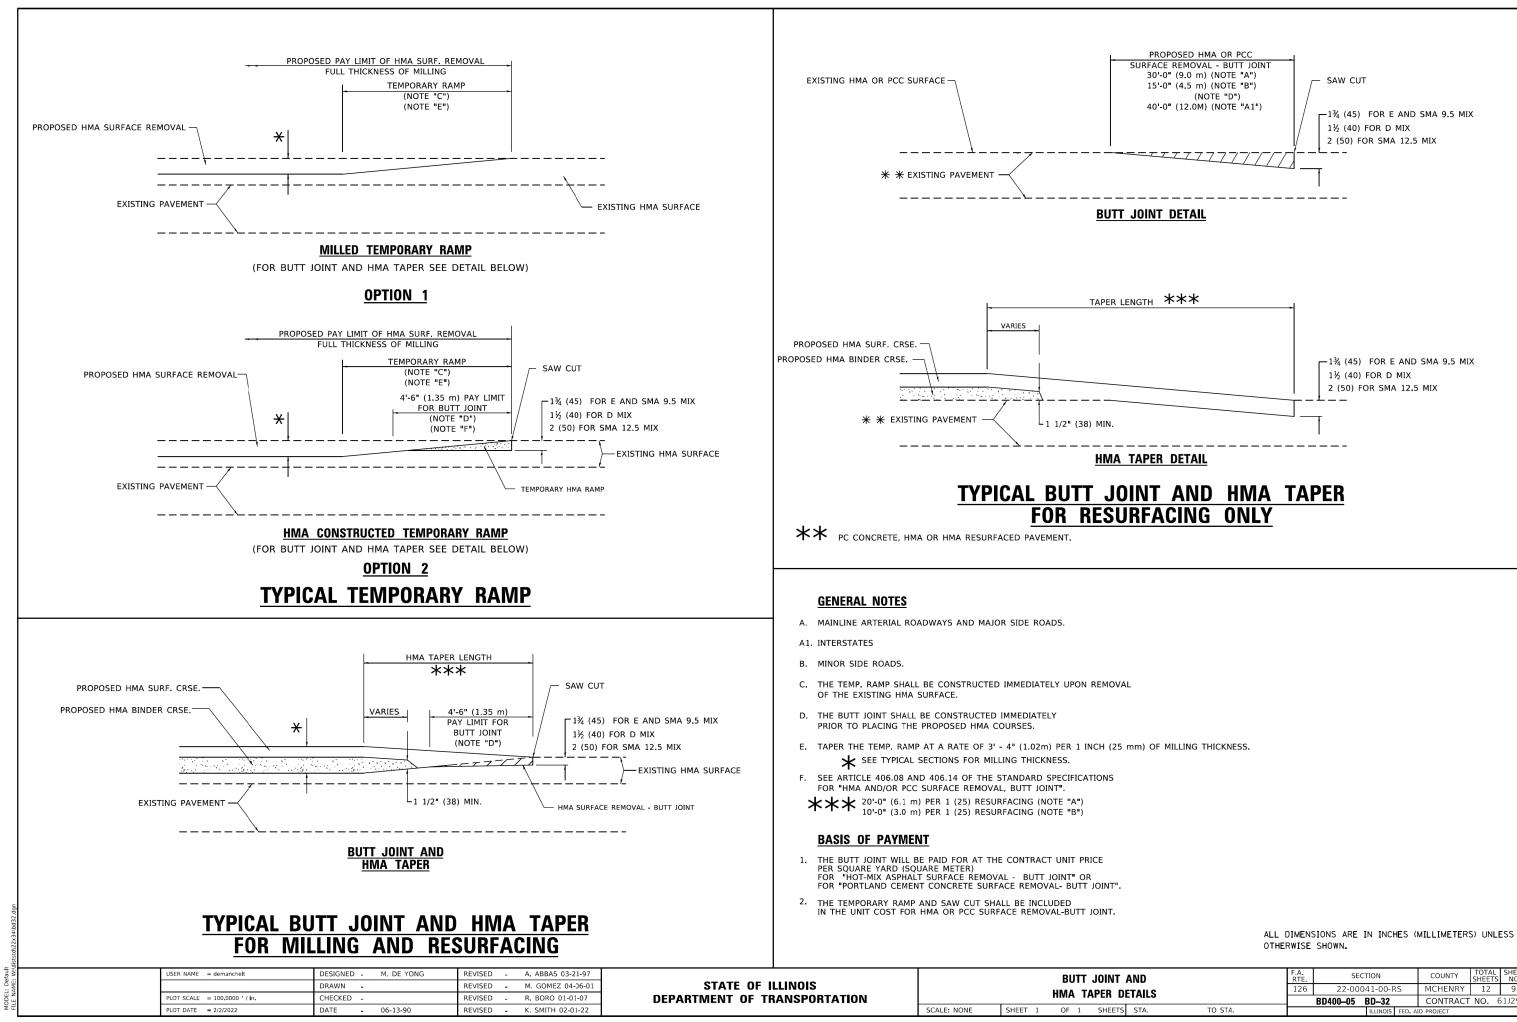
RFACING MARKING PLAN ITA. 112+00 TO STA. 124+00	F.A. RTE. 126	SECTI 22-00041			TOTAL SHEETS N 12 0 T NO. 61J29
		0 SCAL	20 E IN FEET	40	60
			-	Ҽ҅҇҇҅≻	Z
AA			A	EX ROW	
					MATCH LINE
<u>123</u>					S
ER, TY B (TYP)	G - A - I I	&	A	G F A	 [A. 124 + 00
				EX ROW	
			20 E IN FEET	40	60
A A A A	A	A	A	EX ROW	
	•				MATCH LINE STA. 118 + 00
					STA. 118 -
R, TY B (TYP)		A	G		



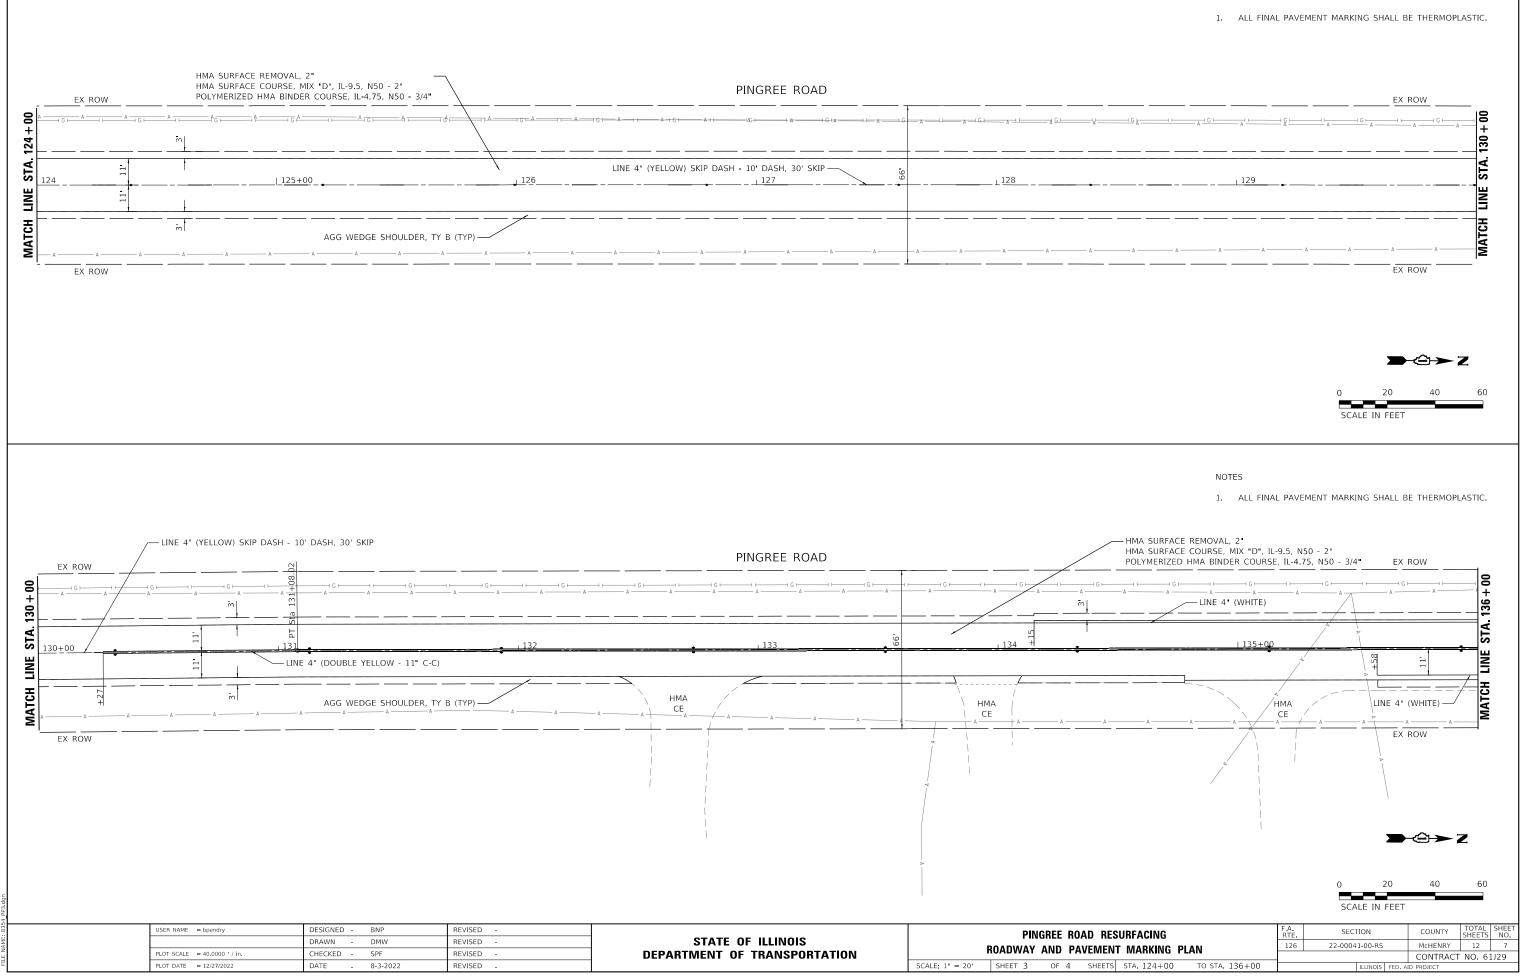




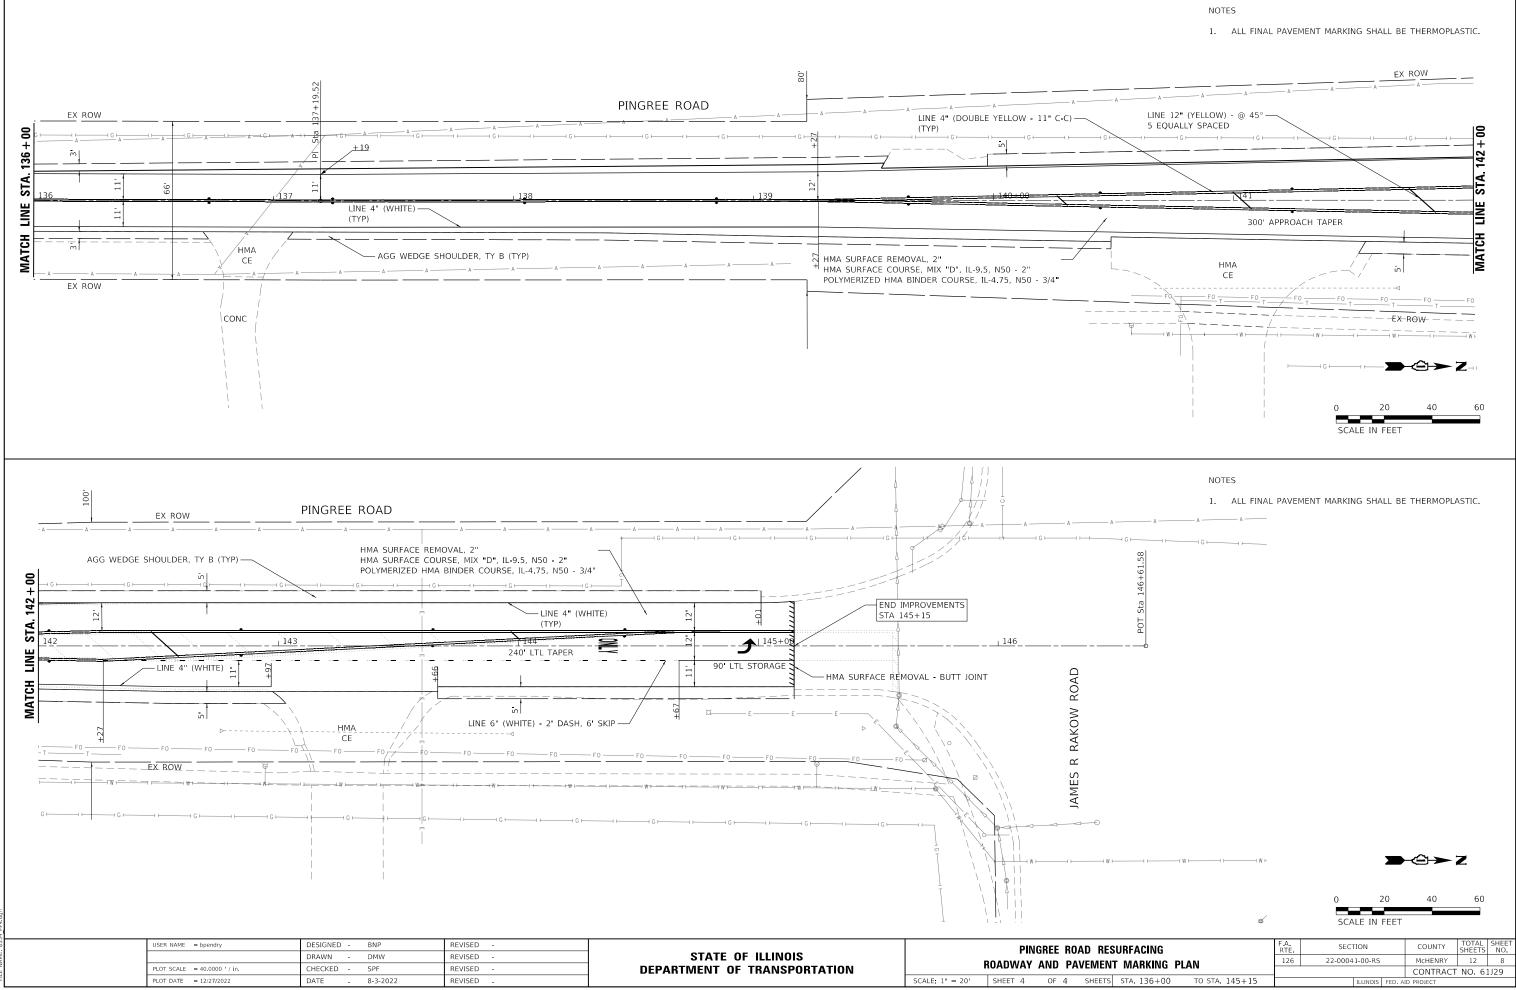



AND		SECTION	COUNTY	TOTAL SHEETS	SHEET NO.
DETAILS	126	22-00041-00-RS	MCHENRY	12	9
		BD400-05 BD-32	CONTRACT	NO. 6	51J29
TS STA. TO STA.		ILLINOIS FED. A	ID PROJECT		

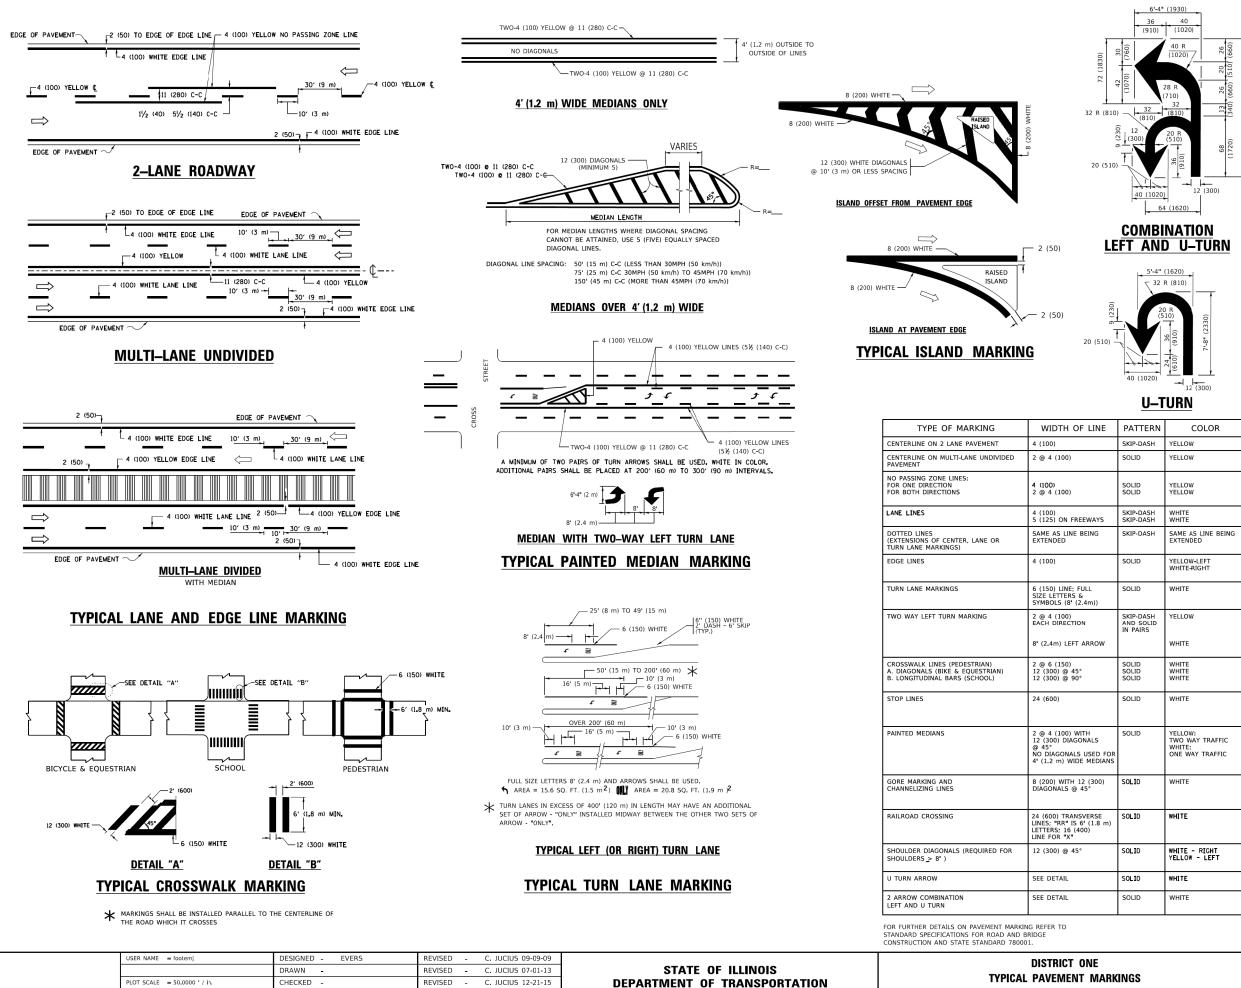

PLOT DATE = 3/4/2019

DATE

03-19-90

REVISED -

C IUCIUS 04-12-16

## LANE REDUCTION TRANSITION

 $\bigstar$  lane reduction arrows required at speeds of 45 MPH or greater or when specified in plans.


OF LINE	PATTERN	COLOR	SPACING / REMARKS
	SKIP-DASH	YELLOW	10' (3 m) LINE WITH 30' (9 m) SPACE
	SOLID	YELLOW	11 (280) C-C
	SOLID SOLID	YELLOW YELLOW	5½ (140) C-C FROM SKIP-DASH CENTERLINE 11 (280) C-C OMIT SKIP-DASH CENTERLINE BETWEEN
EEWAYS	SKIP-DASH SKIP-DASH	WHITE WHITE	10' (3 m) LINE WITH 30' (9 m) SPACE
BEING	SKIP-DASH	SAME AS LINE BEING EXTENDED	2' (600) LINE WITH 6' (1.8 m) SPACE
	SOLID	YELLOW-LEFT WHITE-RIGHT	OUTLINE MEDIANS IN YELLOW
FULL & 2.4m))	SOLID	WHITE	SEE TYPICAL TURN LANE MARKING DETAIL
ON T ARROW	SKIP-DASH AND SOLID IN PAIRS	YELLOW	10' (3 m) LINE WITH 30' (9 m) SPACE FOR SKIP-DASH; 5½ (140) C-C BETWEEN SOLID LINE AND SKIP-DASH LINE SEE TYPICAL TWO-WAY LEFT TURN MARKING DETAIL
5° )°	SOLID SOLID SOLID	WHITE WHITE WHITE	NOT LESS THAN 6' (1.8 m) APART 2' (600) APART 2' (600) APART SEE TYPICAL CROSSWALK MARKING DETAILS.
	SOLID	WHITE	PLACE 4' (1.2 m) IN ADVANCE OF AND PARALLEL TO CROSSWALK, IF PRESENT. OTHERWISE, PLACE AT DESIRED STOPPING POINT. PARALLEL TO CROSSROAD CENTERLINE, WHERE POSSIBLE
VITH ONALS S USED FOR DE MEDIANS	SOLID	YELLOW: TWO WAY TRAFFIC WHITE: ONE WAY TRAFFIC	11 (280) C-C FOR THE DOUBLE LINE SEE TYPICAL PAINTED MEDIAN MARKING.
12 (300) 45°	SOLID	WHITE	DIAGONALS: 15' (4.5 m) C-C (LESS THAN 30MPH (50 km/h)) 20' (6 m) C-C 30MPH (50 km/h) TO 45MPH (70 km/h)) 30' (9 m) C-C (OVER 45MPH (70 km/h))
ISVERSE 6' (1.8 m) 400)	SOLID	WHITE	SEE STATE STANDARD 780001 AREA OF: **=3.6 SQ, FT. (0.33 m <sup>2</sup> EACH *X==54.0 SQ. FT. (5.0 m <sup>2</sup>
5°	SOLID	WHITE - RIGHT Yellow - Left	50' (15 m) C-C (LESS THAN 30MPH (50 km/h)) 75' (25 m) C-C (30 MPH (50 km/h) TO 45MPH (70 km/h)) 150' (45 m) C-C (OVER 45MPH (70 km/h))
	SOLID	WHITE	16.3 SF
	SOLID	WHITE	30.4 SF

All dimensions are in inches (millimeters) unless otherwise shown.


ONE IT_MARKINGS			F.A. RTE.	SEC	COUNTY	TOTAL SHEETS	SHEET NO.		
			126	22-0004	41-00-R	S	MCHENRY	12	10
				TC-13			CONTRACT NO. 61J29		
TS	STA.	TO STA.	ILLINOIS FED. AID PROJECT						

SHEET 1 OF 2 SHEET

SCALE: NONE

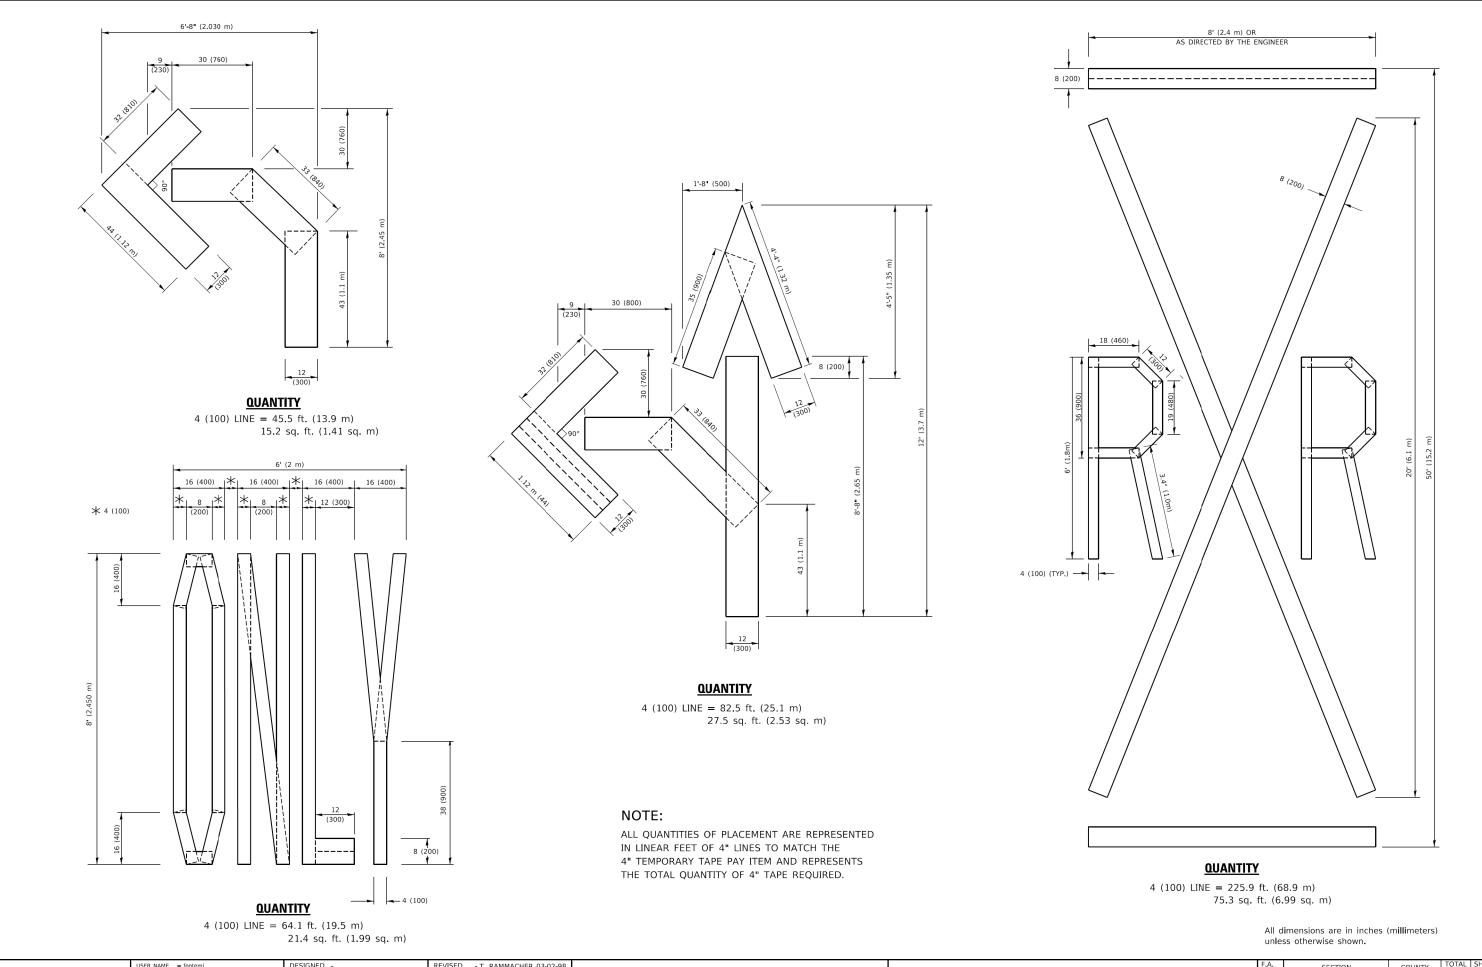

USER NAME = footemj	DESIGNED -	REVISED - T. RAMMACHER 03-02-98				F.A. RTE.	SECTION	COUNTY TOTAL SHEET SHEETS NO.
	DRAWN -	REVISED - E. GOMEZ 08-28-00	STATE OF ILLINOIS	SHORT TE	ERM PAVEMENT MARKING LETTERS AND SYMBOLS	126	22-00041-00-RS	MCHENRY 12 11
PLOT SCALE = 50.0068 ' / in.	CHECKED -	REVISED - E. GOMEZ 08-28-00	DEPARTMENT OF TRANSPORTATION				TC-16	CONTRACT NO. 61J29
PLOT DATE = 3/4/2019	DATE - 09-18-94	REVISED - A. SCHUETZE 09-15-16		SCALE: NONE	SHEET 1 OF 1 SHEETS STA. TO STA.		ILLINOIS FED	. AID PROJECT

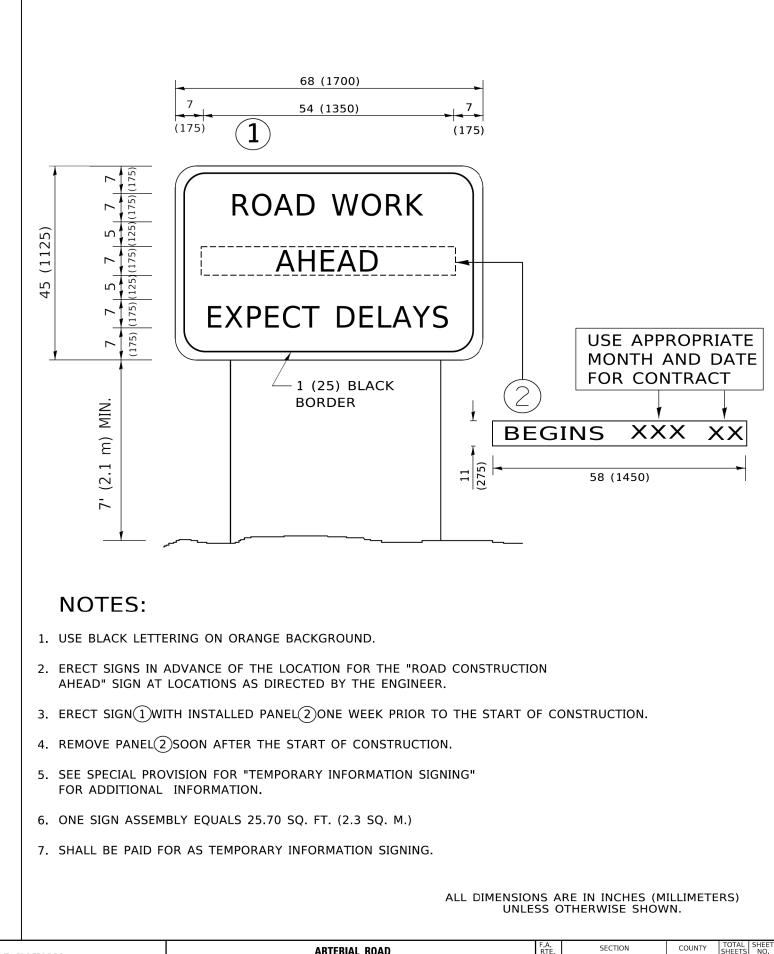

	USER NAME = footemj	DESIGNED -	REVISED - R. MIRS 09-15-97		ARTERIAL ROAD						F.A. BTE	SECTION	COUNTY TOTAL SHEET
		DRAWN -	REVISED - R. MIRS 12-11-97		INFORMATION SIGN					126	22-00041-00-RS	MCHENRY 12 12	
	PLOT SCALE = 50.0000 ' / in.	CHECKED -	REVISED -T. RAMMACHER 02-02-99							TC-22	CONTRACT NO. 61J29		
	PLOT DATE = 3/4/2019	DATE -	REVISED - C. JUCIUS 01-31-07		SCALE: NONE	SHEET 1	OF 1	SHEE	TS STA.	TO STA.		ILLINOIS FED. A	ID PROJECT