


F.A.I. ROUTE	SECTION	COUNTY	TOTAL SHEETS	SHEET NO.
80-55	99-1(K, BY&AC-B)	WILL	497	135
STA. 1033+50 TO STA. 1046+00		FED. ROAD DIST. NO. 1 ILLINOIS		
		FED. AID PROJECT		
CONTRACT NO. 80906				

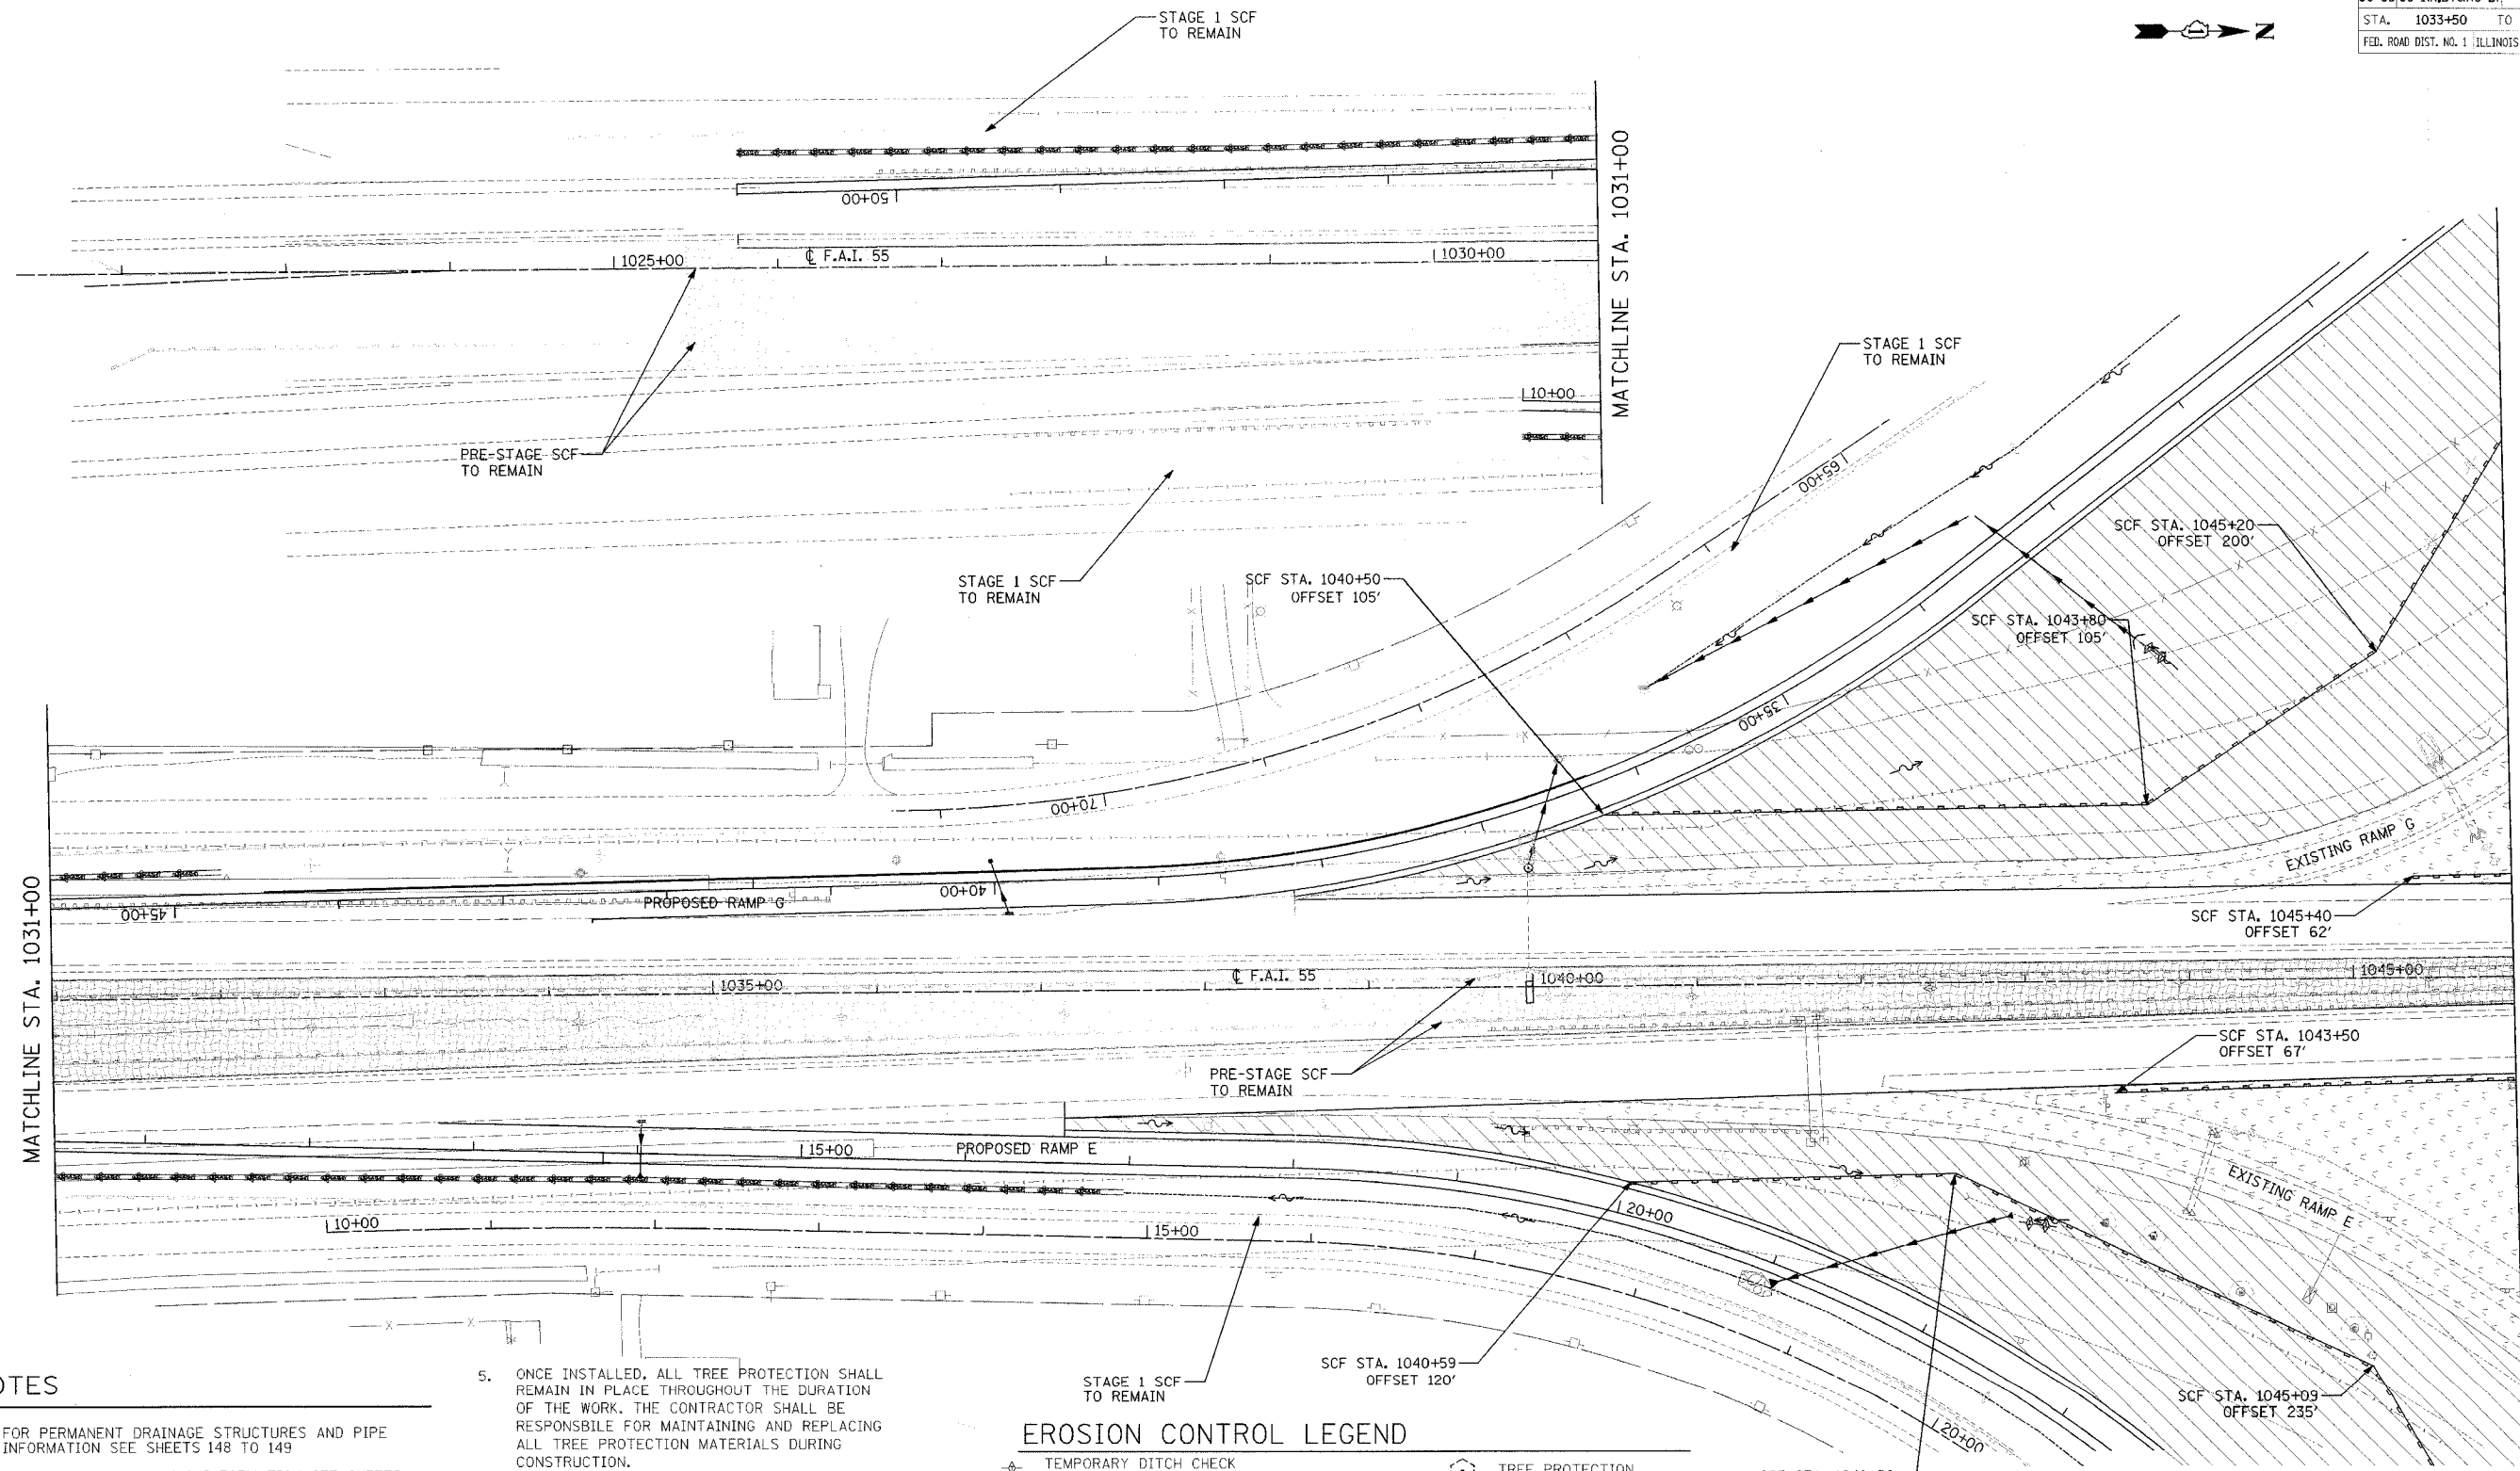

**NOTES**

- FOR PERMANENT DRAINAGE STRUCTURES AND PIPE INFORMATION SEE SHEETS 148 TO 149
- FOR PERMANENT SEEDING INFORMATION SEE SHEETS 189 TO 190
- PER STANDARD 28000001 ALL SEDIMENT BASINS TO BE PLACED AS SHOWN AND REMOVED AT THE END OF THE PROJECT. THE COST WILL BE PAID FOR AS EARTH EXCAVATION FOR EROSION CONTROL.
- AGGREGATE EROSION CONTROL IS NOT REQUIRED FOR SEDIMENT BASINS WHERE THESE DISCHARGE TO STONE RIPRAP.

- ONCE INSTALLED, ALL TREE PROTECTION SHALL REMAIN IN PLACE THROUGHOUT THE DURATION OF THE WORK. THE CONTRACTOR SHALL BE RESPONSIBLE FOR MAINTAINING AND REPLACING ALL TREE PROTECTION MATERIALS DURING CONSTRUCTION.
- ALL INLET PROTECTION DEVICES AND MATERIAL SHALL REMAIN IN PLACE THROUGHOUT CONSTRUCTION, UNLESS THE STRUCTURE IS TO BE REMOVED, WHEREUPON, ALL INLET PROTECTION MEASURES SHALL BE ALSO REMOVED BY THE CONTRACTOR.
- ALL AREAS DESIGNATED FOR TEMPORARY SEEDING WITHIN 30 FEET OF PAVEMENT SHALL INCLUDE EROSION CONTROL BLANKET. ALL OTHER TEMPORARY SEEDING AREAS SHALL INCLUDE MULCH, METHOD 2.

**EROSION CONTROL LEGEND**

- TEMPORARY DITCH CHECK
- SEDIMENT CONTROL, SILT FENCE (SCF)
- DRAINAGE STRUCTURE INLET FILTER
- PROPOSED FLOW ARROW
- TEMPORARY SEDIMENT BASIN
- EXISTING TEMPORARY EROSION CONTROL SEEDING
- TEMPORARY FENCE
- AGGREGATE DITCH
- TREE PROTECTION
- EXISTING FLOW ARROW
- TEMPORARY EROSION CONTROL SEEDING
- SEEDING CLASS 7 (TEMPORARY)
- TEMPORARY RIP-RAP
- TEMPORARY PAVEMENT
- PERMANENT SEEDING (SEE NOTE 2)

REVISIONS	
NAME	DATE

STATE OF ILLINOIS  
DEPARTMENT OF TRANSPORTATION  
F.A.I. 80 & F.A.I. 55 INTERCHANGE  
**STAGE 2**  
F.A.I. 55 EROSION CONTROL  
STA. 1023+50 TO STA. 1046+00

SCALE: 1"=50'  
DATE: JANUARY, 2005

DRAWN BY: DMW  
CHECKED BY: MJL

DATE: 01/03/2005  
FILENAME: n:\proj\28000000\28000000.dwg  
DESIGNER: m55atgill\2800\_erosion\_55\_stage1-17.dgn