


ROUTE	SECTION	COUNTY	TOTAL SHEETS	SHEET NO.
N/A	10-00045-00-SW	MASSAC	12	8
PLAN AND PROFILE - METROPOLIS ELEMENTARY SIDEWALK				
FEDERAL PROJECT NO. SRTS-4008(024)			CONTRACT NO. 99446	

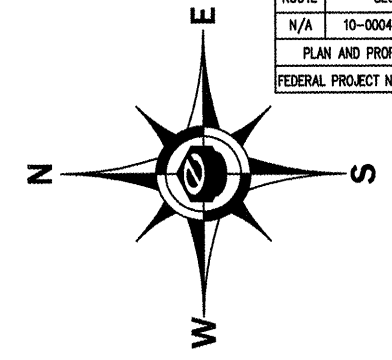

STA. 49+57.89 TO STA. 49+70.02
PORTLAND CEMENT CONCRETE SIDEWALK 4-INCH;
5.00 FEET WIDE; SEE TYPICAL SIDEWALK DETAILS;
SEE PLAN DIMENSIONS FOR SIDEWALK OFFSETS

STA. 49+65.30 TO STA. 49+67.30
DETECTABLE WARNING SURFACE

STA. 50+04.91 TO STA. 50+06.91
DETECTABLE WARNING SURFACE

STA. 50+31
RELOCATE STOP SIGN

STA. 50+00.00 TO STA. 52+13.21
PORTLAND CEMENT CONCRETE SIDEWALK 4-INCH;
5.00 FEET WIDE; SEE TYPICAL SIDEWALK DETAILS;
SEE PLAN DIMENSIONS FOR SIDEWALK OFFSETS

STA. 51+21
EXTEND 15" CMP WITH 8 FT.
PIPE CULVERT CL. C, TYPE 1, 15"

STA. 52+05.78 TO STA. 52+07.78
DETECTABLE WARNING SURFACE

STA. 52+13.21 TO STA. 52+37.24
CROSSWALK - SEE TYPICAL
CROSSWALK DETAIL

STA. 52+38.29 TO STA. 52+40.29
DETECTABLE WARNING SURFACE

STA. 52+37.24 TO STA. 54+14.05
PORTLAND CEMENT CONCRETE SIDEWALK 4-INCH;
5.00 FEET WIDE; SEE TYPICAL SIDEWALK DETAILS;
SEE PLAN DIMENSIONS FOR SIDEWALK OFFSETS

STA. 54+10.90 TO STA. 54+12.90
DETECTABLE WARNING SURFACE

STA. 54+14.05 TO STA. 54+46.96
CROSSWALK - SEE TYPICAL
CROSSWALK DETAIL

STA. 54+48.84 TO STA. 54+50.84
DETECTABLE WARNING SURFACE

STA. 54+46.96 TO STA. 54+76.41
PORTLAND CEMENT CONCRETE SIDEWALK 4-INCH;
5.00 FEET WIDE; SEE TYPICAL SIDEWALK DETAILS;
SEE PLAN DIMENSIONS FOR SIDEWALK OFFSETS


STA. 54+72.78 TO STA. 54+74.78
DETECTABLE WARNING SURFACE

STA. 54+76.41 TO STA. 54+86.63
CROSSWALK - SEE TYPICAL
CROSSWALK DETAIL

STA. 54+76.41 TO STA. 54+86.63
SAWCUT AND REMOVE APPROX. 10'x15' SECTION OF
EXISTING ALLEY. EXTEND 12" RCP APPROX. 8 FT.
BENEATH PROPOSED SIDEWALK AND BACKFILL FULL
DEPTH WITH CA-6. REMOVE 6" PIPE CROSSING
ALLEY AND REPLACE WITH 12 FT. PIPE CULVERT
CLASS C, TYPE 1, 12" AT NEW LOCATION AS SHOWN
REPLACE ALLEY SURFACE WITH PORTLAND CEMENT
CONCRETE CLASS C PATCH, TYPE III, 6-INCH.
GRADE AND RE-SHAPE DITCHES TO ACCOMMODATE
NEW PIPE AND ASSOCIATED DRAINAGE.


STA. 54+87.32 TO STA. 54+89.32
DETECTABLE WARNING SURFACE

STA. 54+86.63 TO STA. 54+94.95
PORTLAND CEMENT CONCRETE SIDEWALK 4-INCH;
4.00 FEET WIDE; SEE TYPICAL SIDEWALK DETAILS;
SEE PLAN DIMENSIONS FOR SIDEWALK OFFSETS;
TIE INTO EXISTING CONCRETE SIDEWALK

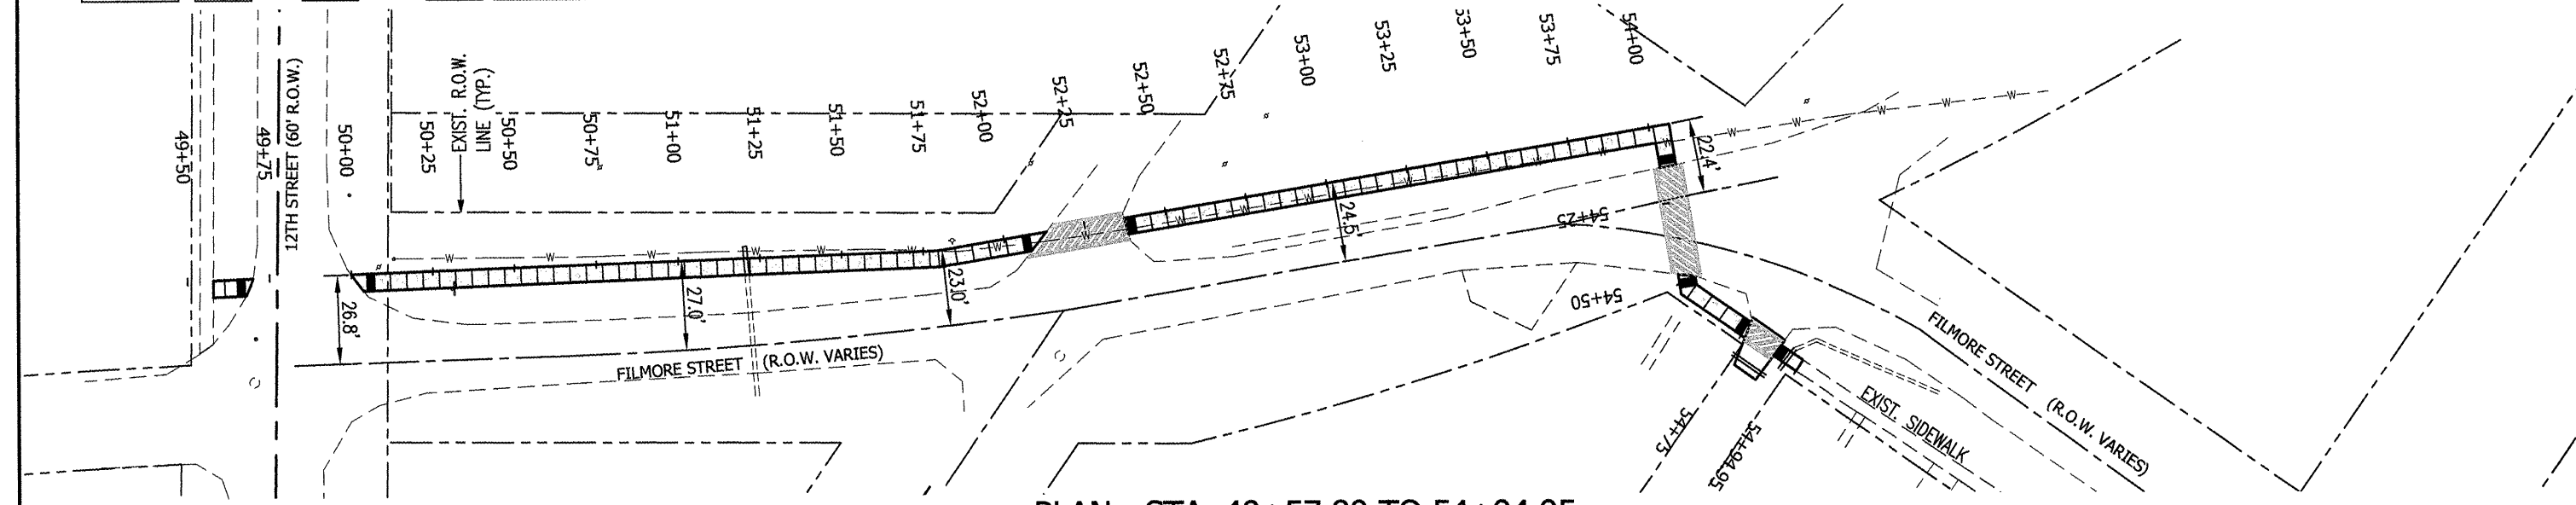

PLAN - STA. 49+57.89 TO 54+94.95

SCALE: 1" = 50'

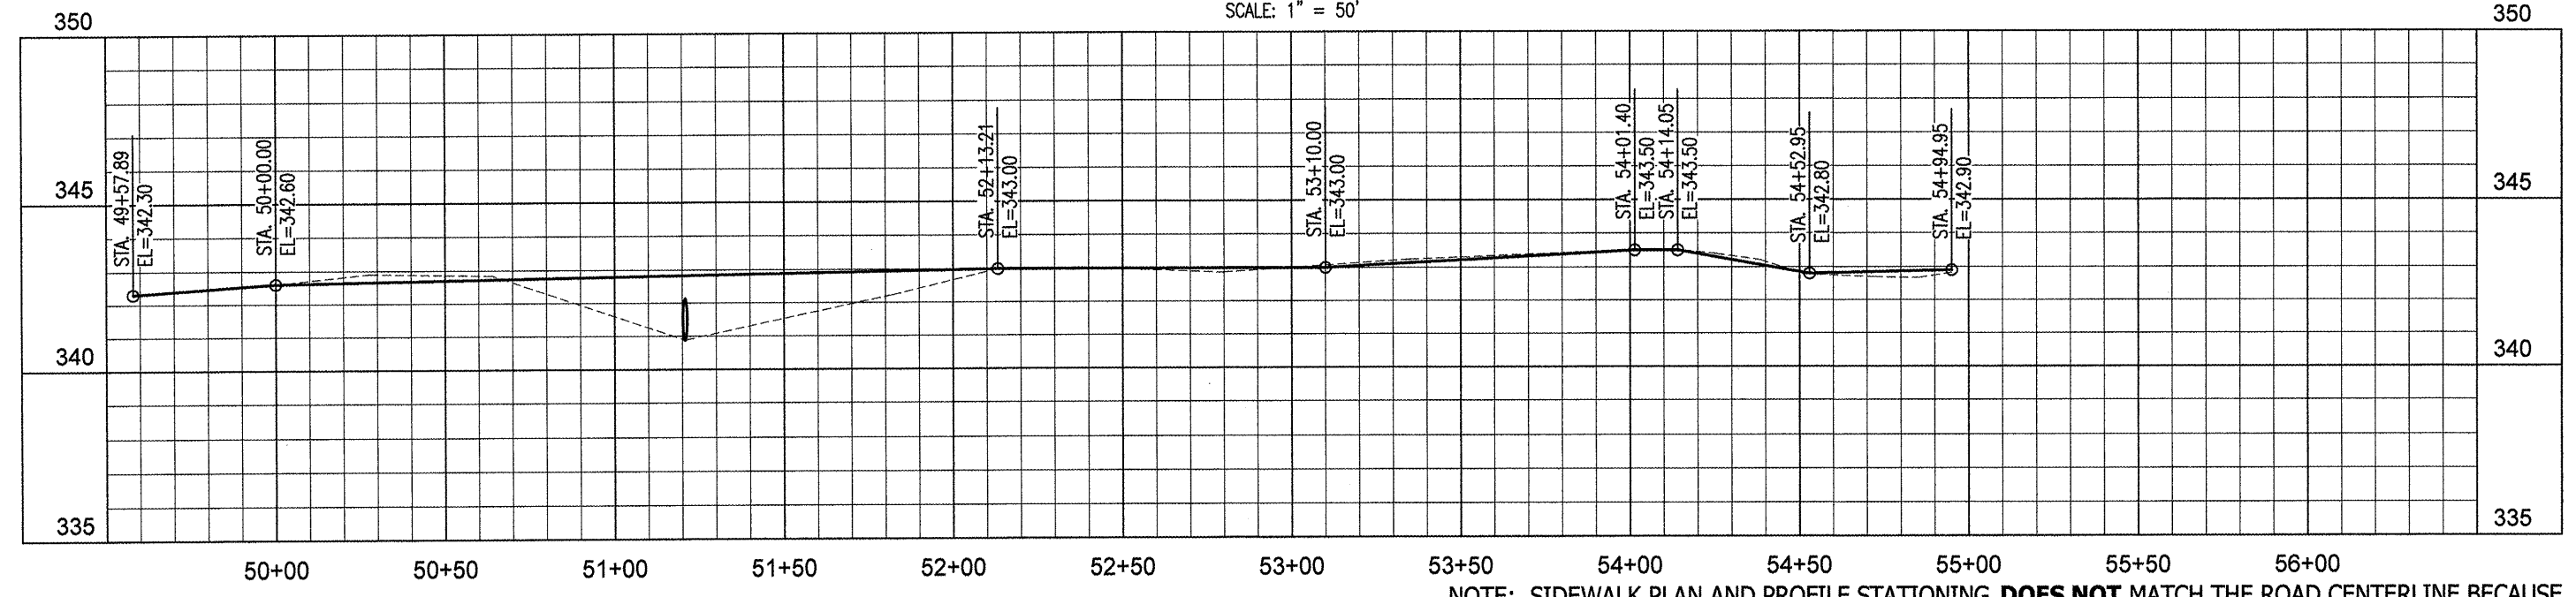

PROFILE - STA. 49+57.89 TO 54+94.95

SCALE: 1" = 50' (HORIZ.); 1" = 5' (VERT.)

NOTE: SIDEWALK PLAN AND PROFILE STATIONING **DOES NOT** MATCH THE ROAD CENTERLINE BECAUSE SIDEWALK DOES NOT PARALLEL ROAD CENTERLINE. PLAN AND PROFILE STATIONING IS ALONG THE BACK EDGE OF SIDEWALK.