

* Refer to the seeding schedule for seeding areas and quantities.

*- FAP's 310A, 753

*- 23BR, RS6, TS-5; 33BR-1, RS4, TS-2

FLE NAME : Verenskife DESIGNED - REVISED - STATE OF ILLINOIS DEFINITION OF TRANSPORTATION

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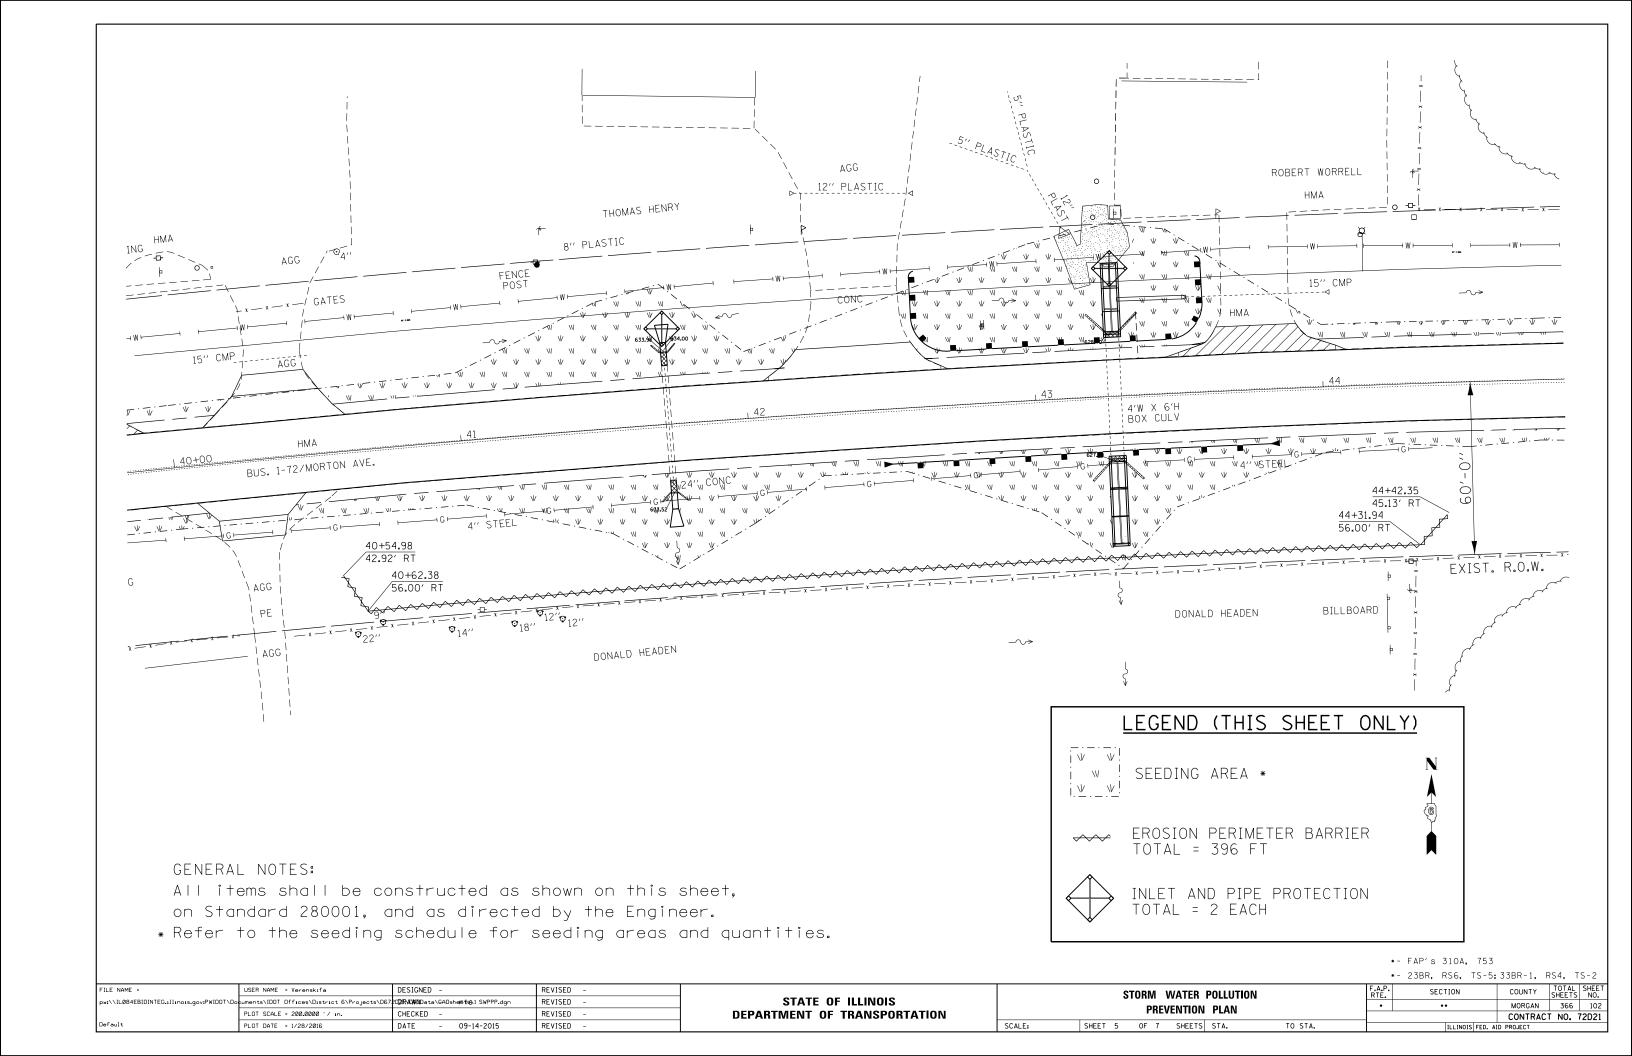
FILE NAME : Verenskife DESIGNED - REVISED - STATE OF ILLINOIS DEFINITION OF TRANSPORTATION


FILE NAME : Verenskife DESIGNED - REVISED - STATE OF ILLINOIS DEFINITION OF TRANSPORTATION

FILE NAME : Verenskife DESIGNED - REVISED - STATE OF ILLINOIS DEFINITION OF TRANSPORTATION

FILE NAME : Verenskife DESIGNED - REVISED - STATE OF ILLINOIS PROLUTION

FILE NAME : Verenskife DESIGNED - REVISED - REVI



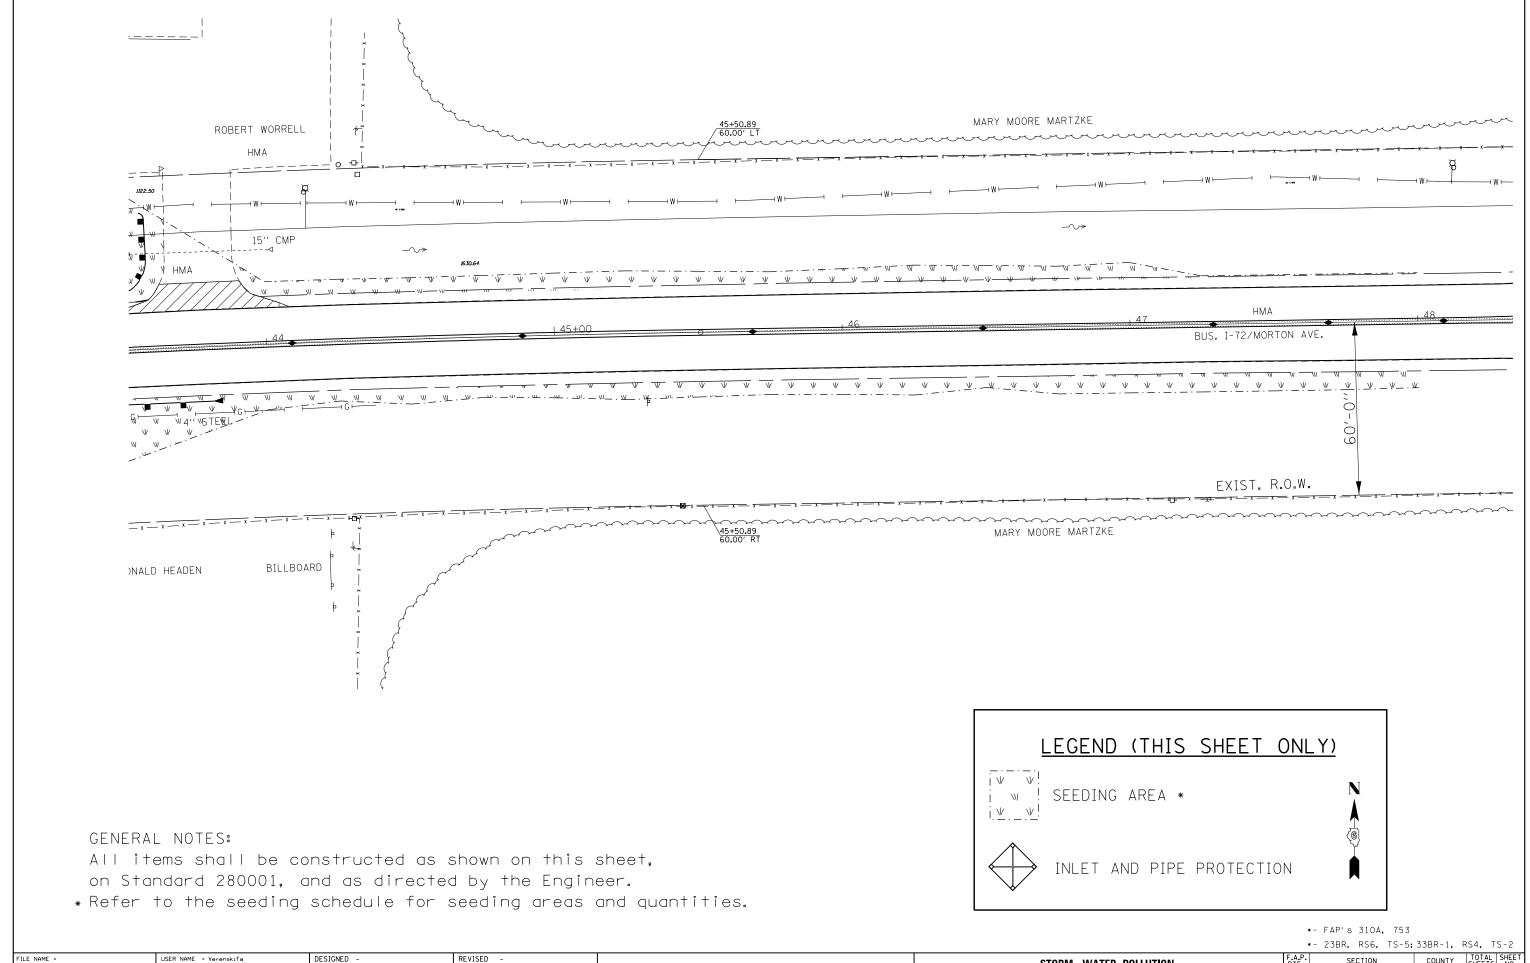

STATE OF ILLINOIS **DEPARTMENT OF TRANSPORTATION**

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PLOT DATE = 1/28/2016


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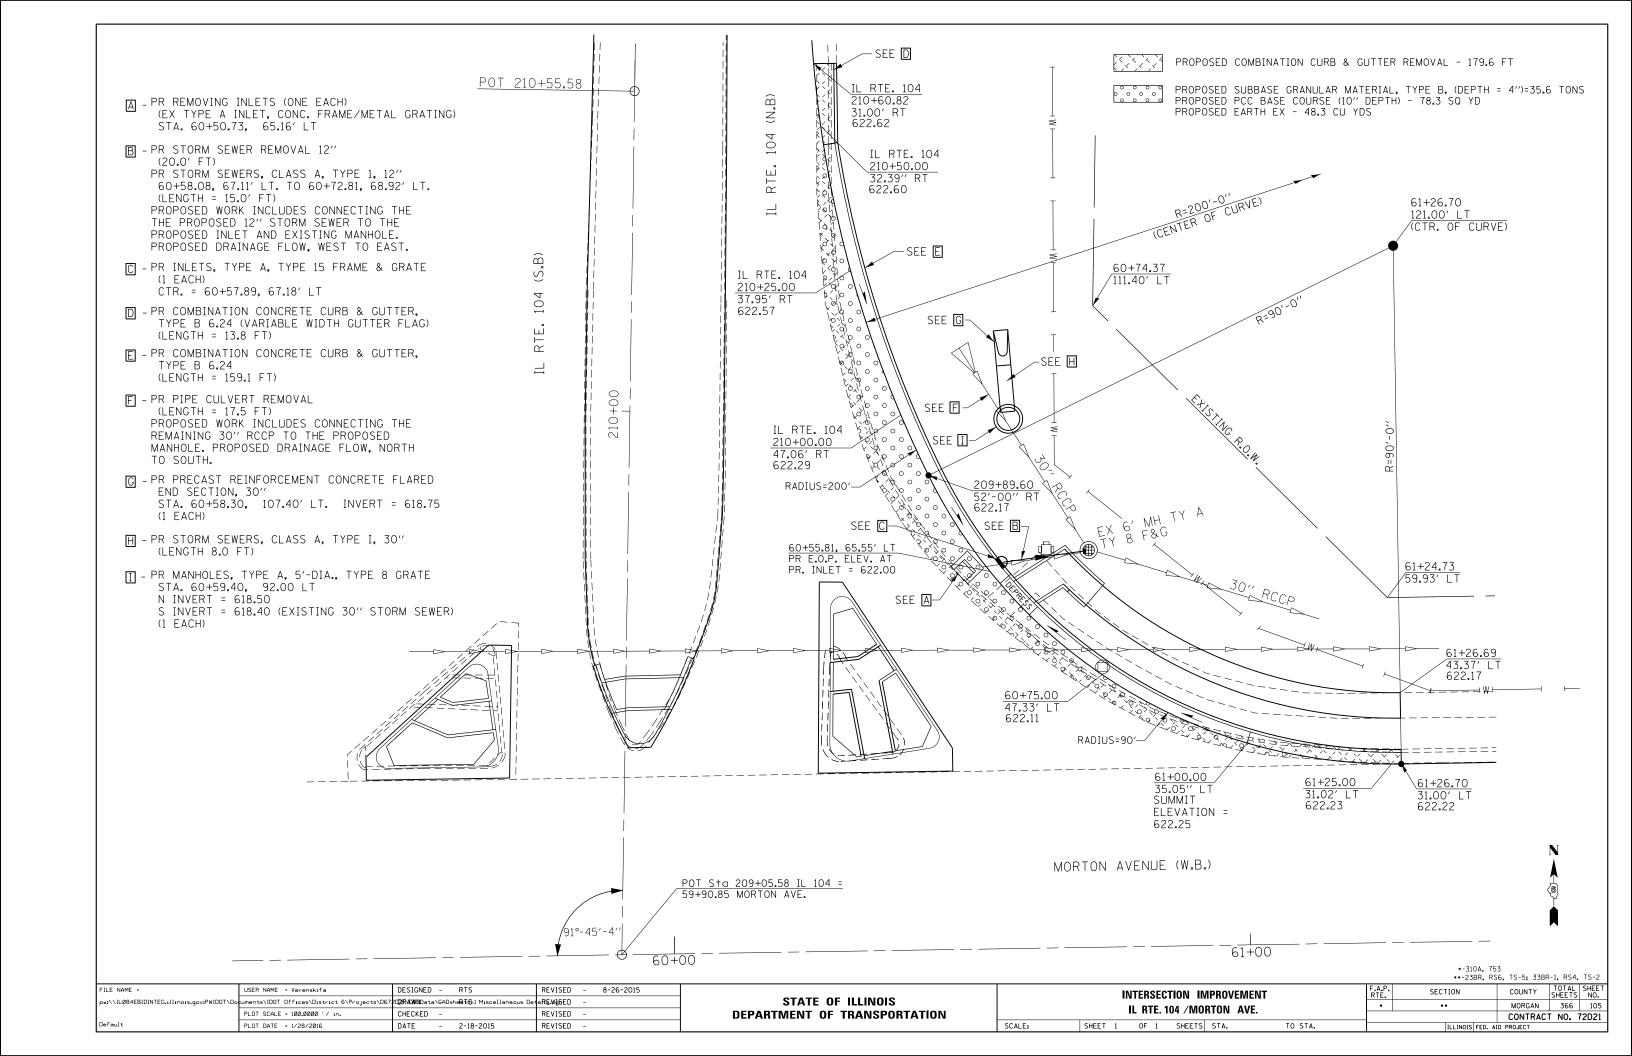
STORM WATER POLLUTION PREVENTION PLAN SHEET 6 OF 7 SHEETS STA.


MORGAN 366 103 CONTRACT NO. 72D21



*- 23BR, RS6, TS-5; 33BR-1, RS4, TS-2

FILE NAME = DESIGNED -REVISED STORM WATER POLLUTION STATE OF ILLINOIS ments\IDOT Offices\District 6\Projects\D67202RAUNDData\GADsheets\1 SWPPP.dgn REVISED PREVENTION PLAN **DEPARTMENT OF TRANSPORTATION** CHECKED -REVISED CONTRACT NO. 72D21 SHEET 7 OF 7 SHEETS STA.

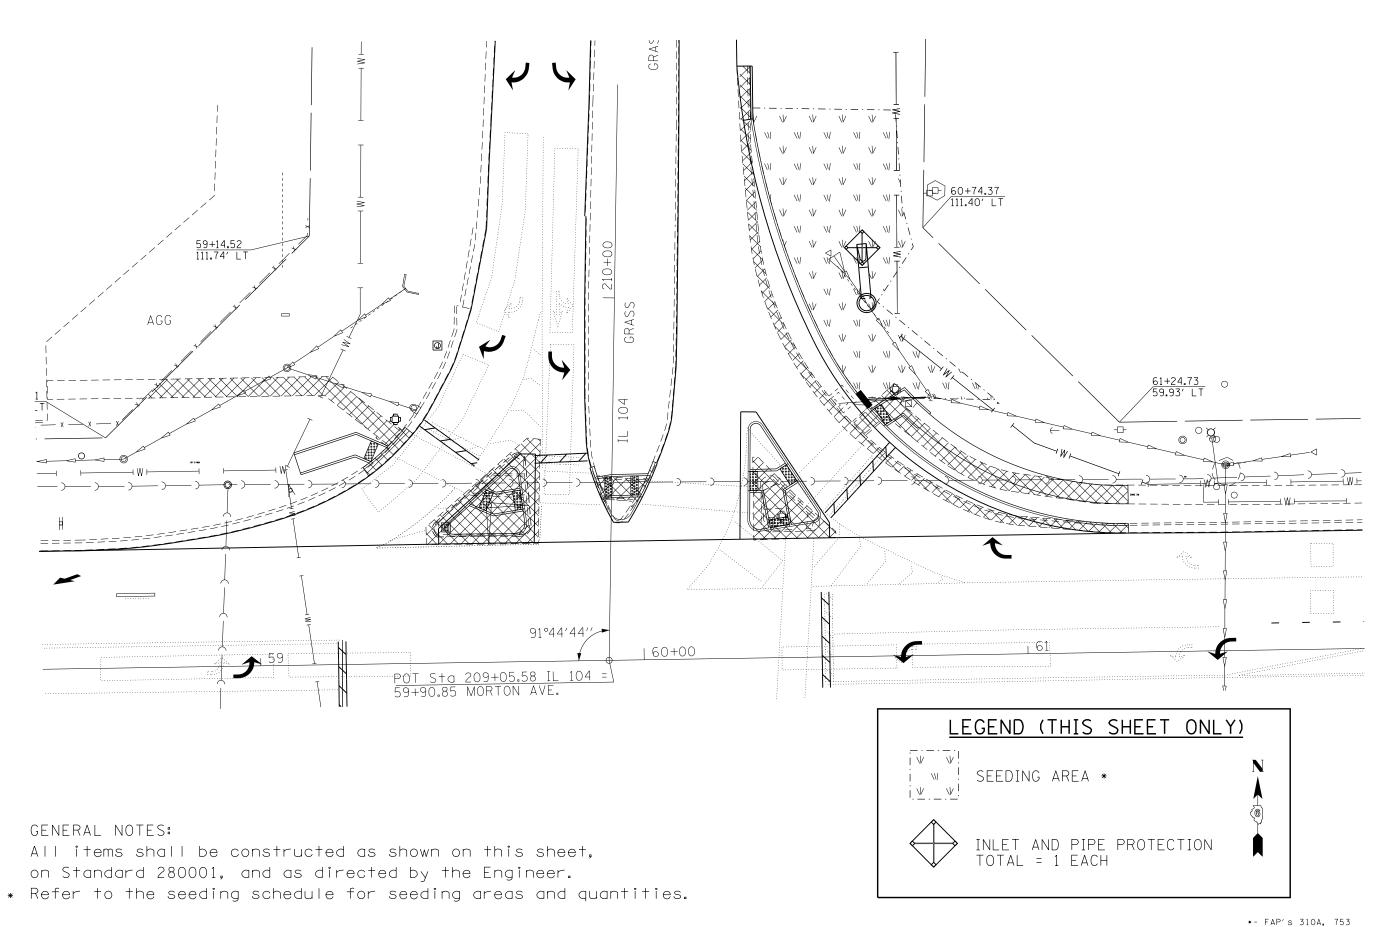

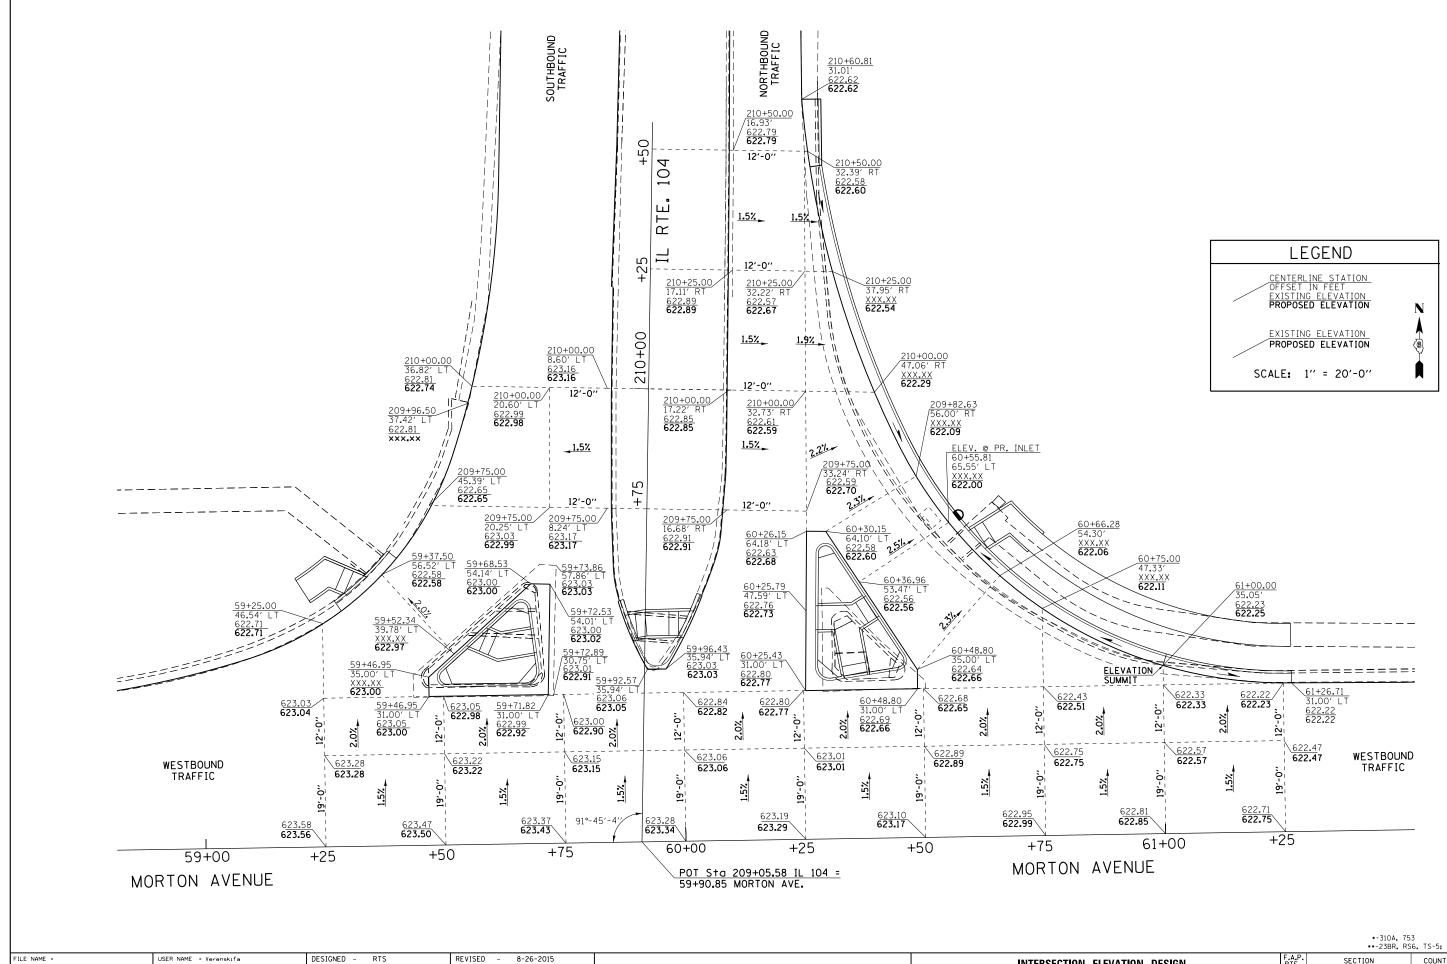

*-310A, 753 **-23BR, RS6, TS-5; 33BR-1, RS4, TS-2

DEPARTMENT OF TRANSPORTATION

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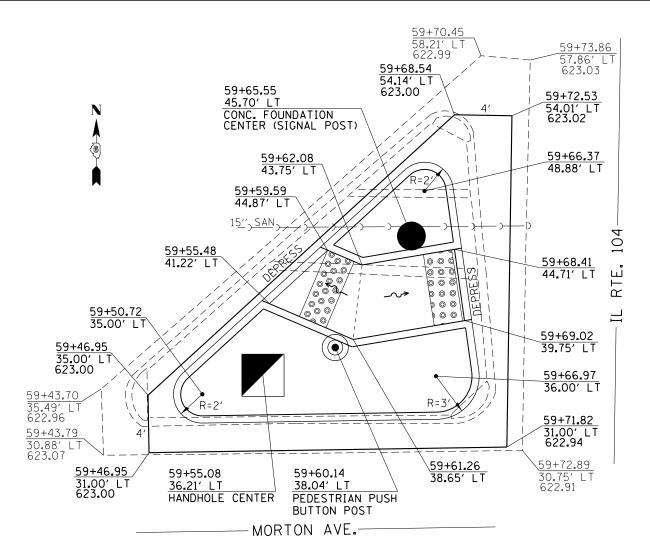
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INTERSECTION ELEVATION DESIGN IL RTE. 104 /MORTON AVE. SHEET 1 OF 1 SHEETS STA.

COUNTY MORGAN 366 106 CONTRACT NO. 72D21




MORTON AVENUE & IL RTE. 104 NORTHWEST ISLAND

(EXISTING RAISED CONCRETE ISLAND TO BE REMOVED AND REPLACED)

EXISTING RAISED CONCRETE ISLAND REMOVAL ITEMS:
COMBINATION CONCRETE CURB & GUTTER REMOVAL = 73.6 FT
CONCRETE MEDIAN SURFACE REMOVAL = 224.4 SQ FT
SIDEWALK REMOVAL = 68.8 SQ FT

PROPOSED RAISED CONCRETE ISLAND ITEMS:
SUB-BASE GRANULAR MATERIAL, TYPE B
(DEPTH = 4") = 5.2 TONS
COMBINATION CONCRETE CURB AND GUTTER,
TYPE M 6.06 = 20.9 FT
COMBINATION CONCRETE CURB AND GUTTER,
TYPE M 6.24 = 26.2 FT
COMBINATION CONCRETE CURB AND GUTTER,
TYPE M (VARIABLE WIDTH) 6.24 = 17.2 FT
PCC BASE COURSE 10" = 14.50 SQ YD


CONCRETE MEDIAN SURFACE, 4" = 135.1 SQ FT DETECTABLE WARNINGS = 20.0 SQ FT PRISMATIC CURB REFLECTOR = 18 EACH

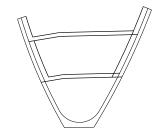

FOR PROPOSED MEDIAN AND SIDEWALK WORK. SEE SHEET 4 OF 4.

NOTES:

ALL SIDEWALKS WITHIN THE PROPOSED CONCRETE ISLANDS ARE 5'-0" IN WIDTH ALL SIDEWALK CURBING IS 6" IN WIDTH AND 6" IN HEIGHT.

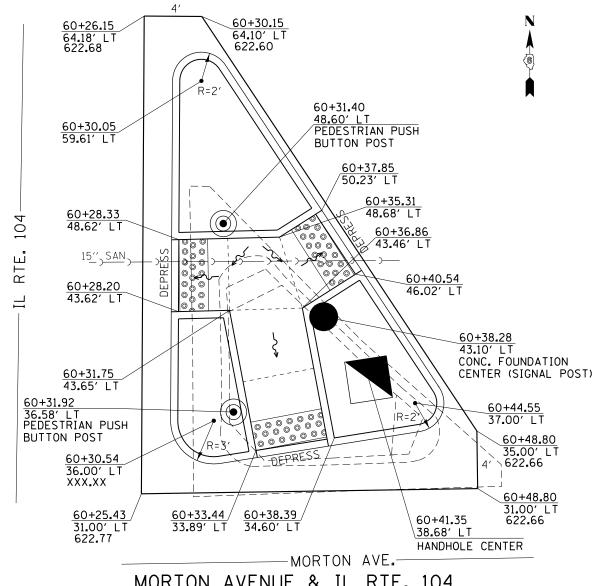

MORTON AVENUE & IL RTE. 104 NORTHEAST ISLAND

(EXISTING RAISED CONCRETE ISLAND TO BE REMOVED AND REPLACED)

EXISTING RAISED CONCRETE ISLAND REMOVAL ITEMS:
COMBINATION CONCRETE CURB & GUTTER REMOVAL = 43.8 FT
CONCRETE MEDIAN SURFACE REMOVAL = 10.9 SQ FT
SIDEWALK REMOVAL = 66.4 SQ FT
PAVEMENT REMOVAL = 27.0 SQ YD

PROPOSED RAISED CONCRETE ISLAND ITEMS:
SUB-BASE GRANULAR MATERIAL, TYPE B
(DEPTH = 4") = 7.4 TONS
COMBINATION CONCRETE CURB AND GUTTER,
TYPE M 6.06 = 26.9 FT
COMBINATION CONCRETE CURB AND GUTTER,
TYPE M 6.24 = 33.9 FT
COMBINATION CONCRETE CURB AND GUTTER,
TYPE M (VARIABLE WIDTH) 6.24 = 18.2 FT

CONCRETE MEDIAN SURFACE, 4" = 168.3 SQ FT DETECTABLE WARNINGS = 30 SQ FT PRISMATIC CURB REFLECTOR = 18 EACH

*-310A, 753 **-23BR, RS6, TS-5; 33BR-1, RS4, TS-2

STATE OF ILLINOIS
DEPARTMENT OF TRANSPORTATION

SCALE:


		**-ZJBR, R3	10, 13-3; JJDn	(-1, N34,	13-2
RAISED CONCRETE ISLAND DETAILS	F.A.P. RTE.	SECTION	COUNTY	TOTAL SHEETS	SHEET NO.
IL RTE. 104 /MORTON AVE.	•	••	MORGAN	366	107
IL IIIL. 1047 MOITTON AVE.			CONTRAC	T NO.	72D21
SHEET 1 OF 4 SHEETS STA. TO STA	Α	TILINOIS FED A	ID PROJECT		

NOTES:

ALL SIDEWALKS WITHIN THE PROPOSED CONCRETE ISLANDS ARE 5'-O" IN WIDTH. ALL SIDEWALK CURBING IS 6" IN WIDTH AND 6" IN HEIGHT.

= SUGGESTED SIDEWALK JOINT
---- = PROPOSED DRAINAGE FLOW

-MORTON AVE.-

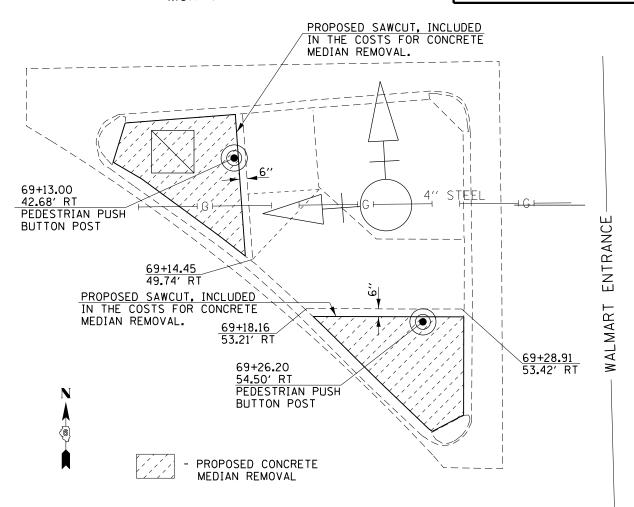


MORTON AVENUE & WALMART ENTRANCE SOUTHWEST ISLAND

(EXISTING RAISED CONCRETE ISLAND TO BE REMOVED AND REPLACED)

EXISTING RAISED CONCRETE ISLAND REMOVAL ITEMS: CONCRETE MEDIAN SURFACE REMOVAL = 101.2 SQ FT

PROPOSED RAISED CONCRETE ISLAND ITEMS:
CONCRETE MEDIAN SURFACE, 4" = 101.2 SQ FT
PRISMATIC CURB REFLECTOR = 18 EACH

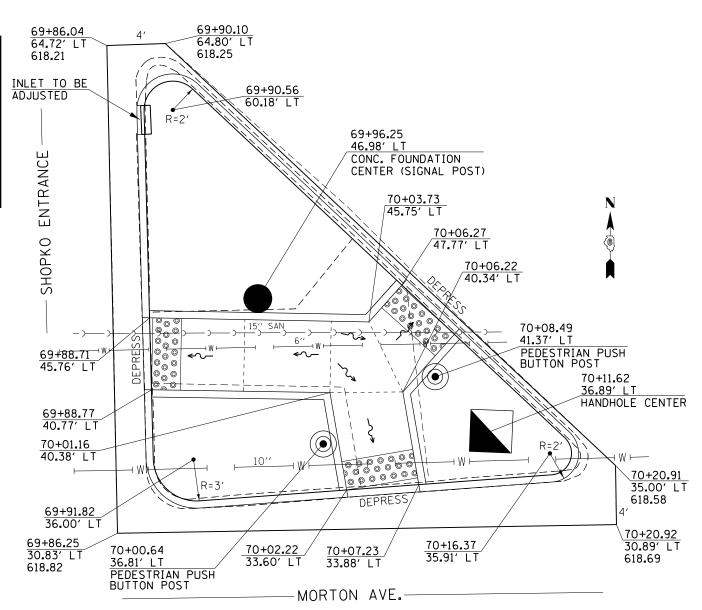

MORTON AVENUE & SHOPKO ENTRANCE NORTHEAST ISLAND

(EXISTING RAISED CONCRETE ISLAND TO BE REMOVED AND REPLACED)

EXISTING RAISED CONCRETE ISLAND REMOVAL ITEMS:

COMBINATION CONCRETE CURB & GUTTER REMOVAL = 100.1 FT

CONCRETE MEDIAN SURFACE REMOVAL = 340.4 SQ FT

SIDEWALK REMOVAL = 152.4 SQ FT

PROPOSED RAISED CONCRETE ISLAND ITEMS:
SUB-BASE GRANULAR MATERIAL, TYPE B
(DEPTH = 4") = 12.4 TONS
COMBINATION CONCRETE CURB AND GUTTER,
TYPE M 6.06 = 35.4 FT
COMBINATION CONCRETE CURB AND GUTTER,
TYPE M 6.24 = 33.7 FT
COMBINATION CONCRETE CURB AND GUTTER,
TYPE M (VARIABLE WIDTH) 6.24 = 28 FT

CONCRETE MEDIAN SURFACE, 4" = 328 SQ FT DETECTABLE WARNINGS = 30 SQ FT PRISMATIC CURB REFLECTOR = 18 EACH

•-310A, 753 ••-23BR, RS6, TS-5; 33BR-1, RS4, TS-2

STATE OF ILLINOIS
DEPARTMENT OF TRANSPORTATION

SCALE:

EXISTING RAISED CONCRETE ISLAND REMOVAL ITEMS:


COMBINATION CONCRETE CURB & GUTTER REMOVAL = 49.5 FT

CONCRETE MEDIAN SURFACE REMOVAL = 56.9 SQ FT

SIDEWALK REMOVAL = 82.5 SQ FT

PROPOSED RAISED CONCRETE ISLAND ITEMS:
SUB-BASE GRANULAR MATERIAL, TYPE B
(DEPTH = 4") = 3.7 TONS
COMBINATION CONCRETE CURB AND GUTTER,
TYPE M 6.06 = 15.4 FT
COMBINATION CONCRETE CURB AND GUTTER,
TYPE M 6.24 = 37.2 FT

CONCRETE MEDIAN SURFACE, 4" = 68.0 SQ FT DETECTABLE WARNINGS = 30 SQ FT PRISMATIC CURB REFLECTOR = 18 EACH

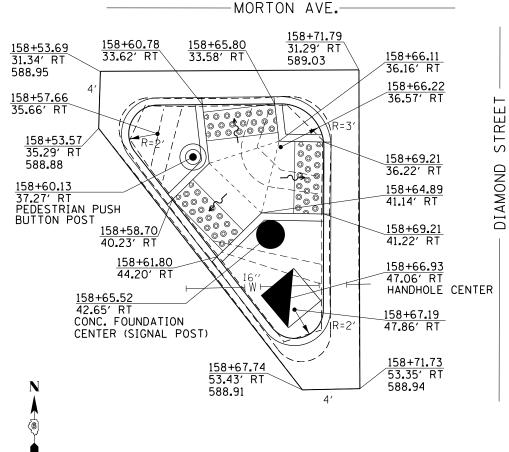

MORTON AVENUE & DIAMOND STREET SOUTHWEST ISLAND


(EXISTING RAISED CONCRETE ISLAND TO BE REMOVED AND REPLACED)

NOTES:

ALL SIDEWALKS WITHIN THE PROPOSED CONCRETE ISLANDS ARE 5'-0" IN WIDTH. ALL SIDEWALK CURBING IS 6" IN WIDTH AND 6" IN HEIGHT.

---- = SUGGESTED SIDEWALK JOINT

← = PROPOSED DRAINAGE FLOW

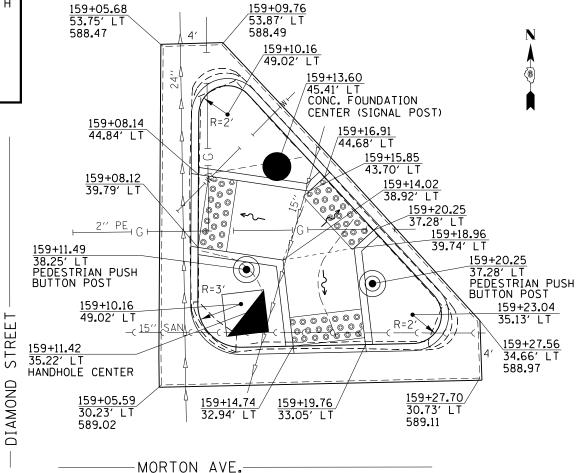

MORTON AVENUE & DIAMOND STREET NORTHEAST ISLAND

(EXISTING RAISED CONCRETE ISLAND TO BE REMOVED AND REPLACED)

EXISTING RAISED CONCRETE ISLAND REMOVAL ITEMS:

COMBINATION CONCRETE CURB & GUTTER REMOVAL = 57.7 FT

CONCRETE MEDIAN SURFACE REMOVAL = 97.6 SQ FT

SIDEWALK REMOVAL = 88.6 SQ FT

PROPOSED RAISED CONCRETE ISLAND ITEMS:
SUB-BASE GRANULAR MATERIAL, TYPE B
(DEPTH = 4") = 4.9 TONS
COMBINATION CONCRETE CURB AND GUTTER,
TYPE M 6.06 = 19.0 FT
COMBINATION CONCRETE CURB AND GUTTER,
TYPE M 6.24 = 42.4 FT

CONCRETE MEDIAN SURFACE, 4" = 95.2 SQ FT DETECTABLE WARNINGS = 30 SQ FT PRISMATIC CURB REFLECTOR = 18 EACH

> •-310A, 753 ••-23BR, RS6, TS-5; 33BR-1, RS4, TS-7

FILE NAME =	USER NAME = Verenskifa	DESIGNED - RTS	REVISED -	
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	PLOT SCALE = 100.0000 '/ in.	CHECKED -	REVISED -	
Default	PLOT DATE = 1/28/2016	DATE - 2-18-2015	REVISED -	

STATE OF ILLINOIS
DEPARTMENT OF TRANSPORTATION

						**-ZJDN, NJ	o, 13-3; 33br	1-1, N.SH,	13-2
RAISE	CON	CRETE ISL	AND D	ETAILS	F.A.P. RTE.	SECTION	COUNTY	TOTAL SHEETS	SHEET NO.
nı	лиом	D ST./MO	NETON	AVE	•	••	MORGAN	366	109
	AIVIOIVI	J 31. / IVIC	JII I OIV	AVL.			CONTRAC	T NO.	72D21
SHEET 3	OF 4	SHEETS	STA.	TO STA.		ILLINOIS FED. AI	D PROJECT		-

-MORTON AVE.— 184+97<u>.90</u> 24**.**02′ RT 185+04.78 21.70' RT XXX+XX.XX 184+92.86 XX.XX' RT HANDHOLE CENTER 184+77.16 24.16' RT 592.29 22.54' RT 592.18 184+98.93 27.09' RT 1000000 184+80.67 184+99.49 26.71' RT 27.23' RT 10000000 PEDESTRIAN PUSH BUTTON POST 184+99.06 31.75′ RT 184+77.41 27.74′ RT 592.22 185+01.82 STREET 31.98' RT 184+93.05 32.84' RT 184+97.94 PEDESTRIAN PUSH 36.68' RT BUTTON POST 185+01.60 36.98' RT MAIN 184+91.35 36.64' RT 184+98.67 38.48' RT CONC. FOUNDATION 184+94.24 CENTER (SIGNAL POST) 33.31' RT 41.82' RT 184+94.99 40.06′ RT /R=2' 184+99.92 47.13' RT 185+03.66 47.00' RT 592.32 592.40

MORTON AVENUE & MAIN STREET SOUTHWEST ISLAND

(EXISTING RAISED CONCRETE ISLAND TO BE REMOVED AND REPLACED)

EXISTING RAISED CONCRETE ISLAND REMOVAL ITEMS:

COMBINATION CONCRETE CURB & GUTTER REMOVAL = 67.7 FT

CONCRETE MEDIAN SURFACE REMOVAL = 142.2 SQ FT

SIDEWALK REMOVAL = 105.6 SQ FT

PROPOSED RAISED CONCRETE ISLAND ITEMS:
SUB-BASE GRANULAR MATERIAL, TYPE B
(DEPTH = 4") = 6.8 TONS
COMBINATION CONCRETE CURB AND GUTTER,
TYPE M 6.06 = 23.7 FT
COMBINATION CONCRETE CURB AND GUTTER,
TYPE M 6.24 = 51.1 FT

CONCRETE MEDIAN SURFACE, 4" = 160.9 SQ FT DETECTABLE WARNINGS = 30 SQ FT PRISMATIC CURB REFLECTOR = 18 EACH

60+04.19 59+86.66 51.17' LT 50.23′ L 59+92.18 47.89′ LT 60+01.58 10 104 47.97' LT 59+88.77 لْنا 59+99.14 59+92.58 47.37' LT RTE. R 42.94′ LT /42.89' LT|o 59+90.60 42.59' LT 59+94.58 39.61' LT RAMPED MEDIAN NOSE 59+92.57 AS PER STD 606301 35.94′ LT 59+96.43 35.94′ LT

NOTE: PROPOSED PAVEMENT REMOVAL AT THIS LOCATION SHALL BE INCLUDED IN THE COSTS FOR THE PAY ITEM FOR COMB. C&G. REMOVAL

MORTON AVENUE & IL RTE. 104 MIDDLE ISLAND

(EXISTING RAISED CONCRETE ISLAND TO BE REMOVED AND REPLACED)

EXISTING RAISED CONCRETE MEDIAN REMOVAL ITEMS:

COMBINATION CONCRETE CURB & GUTTER REMOVAL = 35.45 FT

CONCRETE MEDIAN SURFACE REMOVAL = 22.51 SQ FT

SIDEWALK REMOVAL = 60.22 SQ FT

PROPOSED RAISED CONCRETE MEDIAN ITEMS:

CONCRETE MEDIAN, TYPE SM 6.06 = 47.44 SQ FT

COMBINATION CONCRETE CURB AND GUTTER,

TYPE M 6.06 = 18.72 FT


PCC SIDEWALK, 4" = 64.53 SQ FT

DETECTABLE WARNINGS = 30 SQ FT

NOTES:

ALL SIDEWALKS WITHIN THE PROPOSED CONCRETE ISLANDS ARE 5'-0" IN WIDTH. ALL SIDEWALK CURBING IS 6" IN WIDTH AND 6" IN HEIGHT.

FILE NAME =	USER NAME = Verenskifa	DESIGNED - RTS	REVISED -			RAISED CONCRETE ISLAI	ND DETAILS	RTF.	SECTION	COUNTY	SHEFTS	NO.
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	PLOT SCALE = 100.0000 ' / 10.	CHECKED -	REVISED -	DEPARTMENT OF TRANSPORTATION		IVIAIN 31./IVIUN	IUN AVE.			CONTRACT	T NO. 72	2D21
Default	PLOT DATE = 1/28/2016	DATE - 2-18-2015	REVISED -		SCALE:	SHEET 4 OF 4 SHEETS S	STA. TO STA.		ILLINOIS FED.	AID PROJECT		

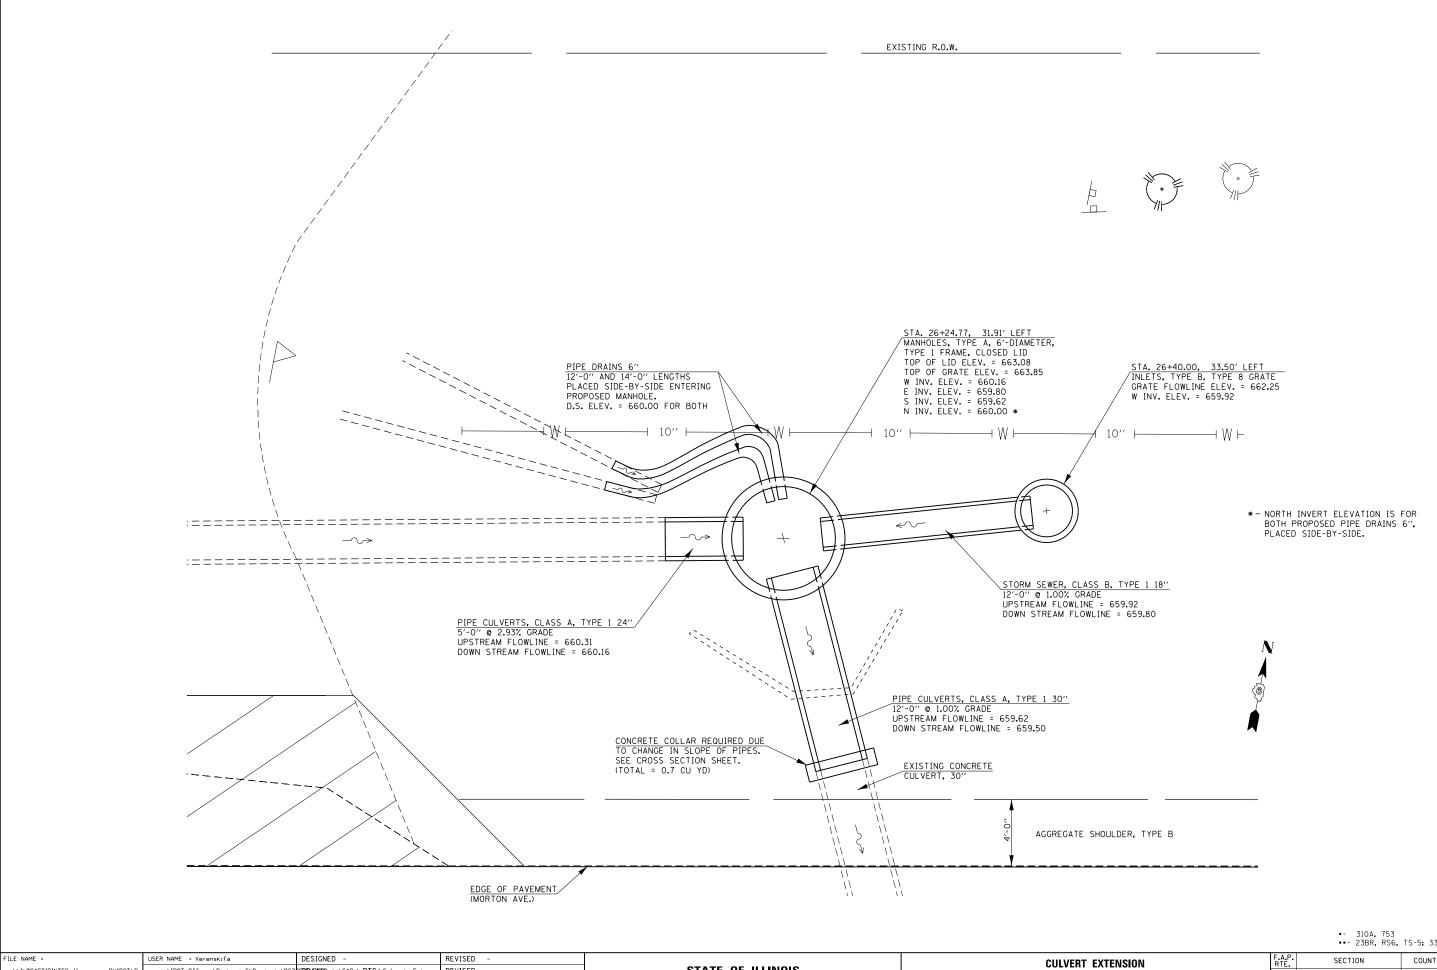

*- 310A, 753 **- 23BR, RS6, TS-5; 33BR-1, RS4, TS-2

STATE OF ILLINOIS pw:\\|L084EBIDINTEG.||llınois.gov:PWIDOT\Do¢uments\IDOT Offices\District 6\Projects\D67**2C2RxXWI**Dota\GADshe**&**Xs\l Culvert Extens: nsREòyHSED CHECKED REVISED **DEPARTMENT OF TRANSPORTATION** PLOT DATE = 1/28/2016 DATE REVISED 08-11-2015


SCALE:


STA. 26 + 33.00 SHEET 1 OF 2 SHEETS STA.

TO STA.


COUNTY TOTAL SHEETS NO.

MORGAN 366 111 CONTRACT NO. 72D21

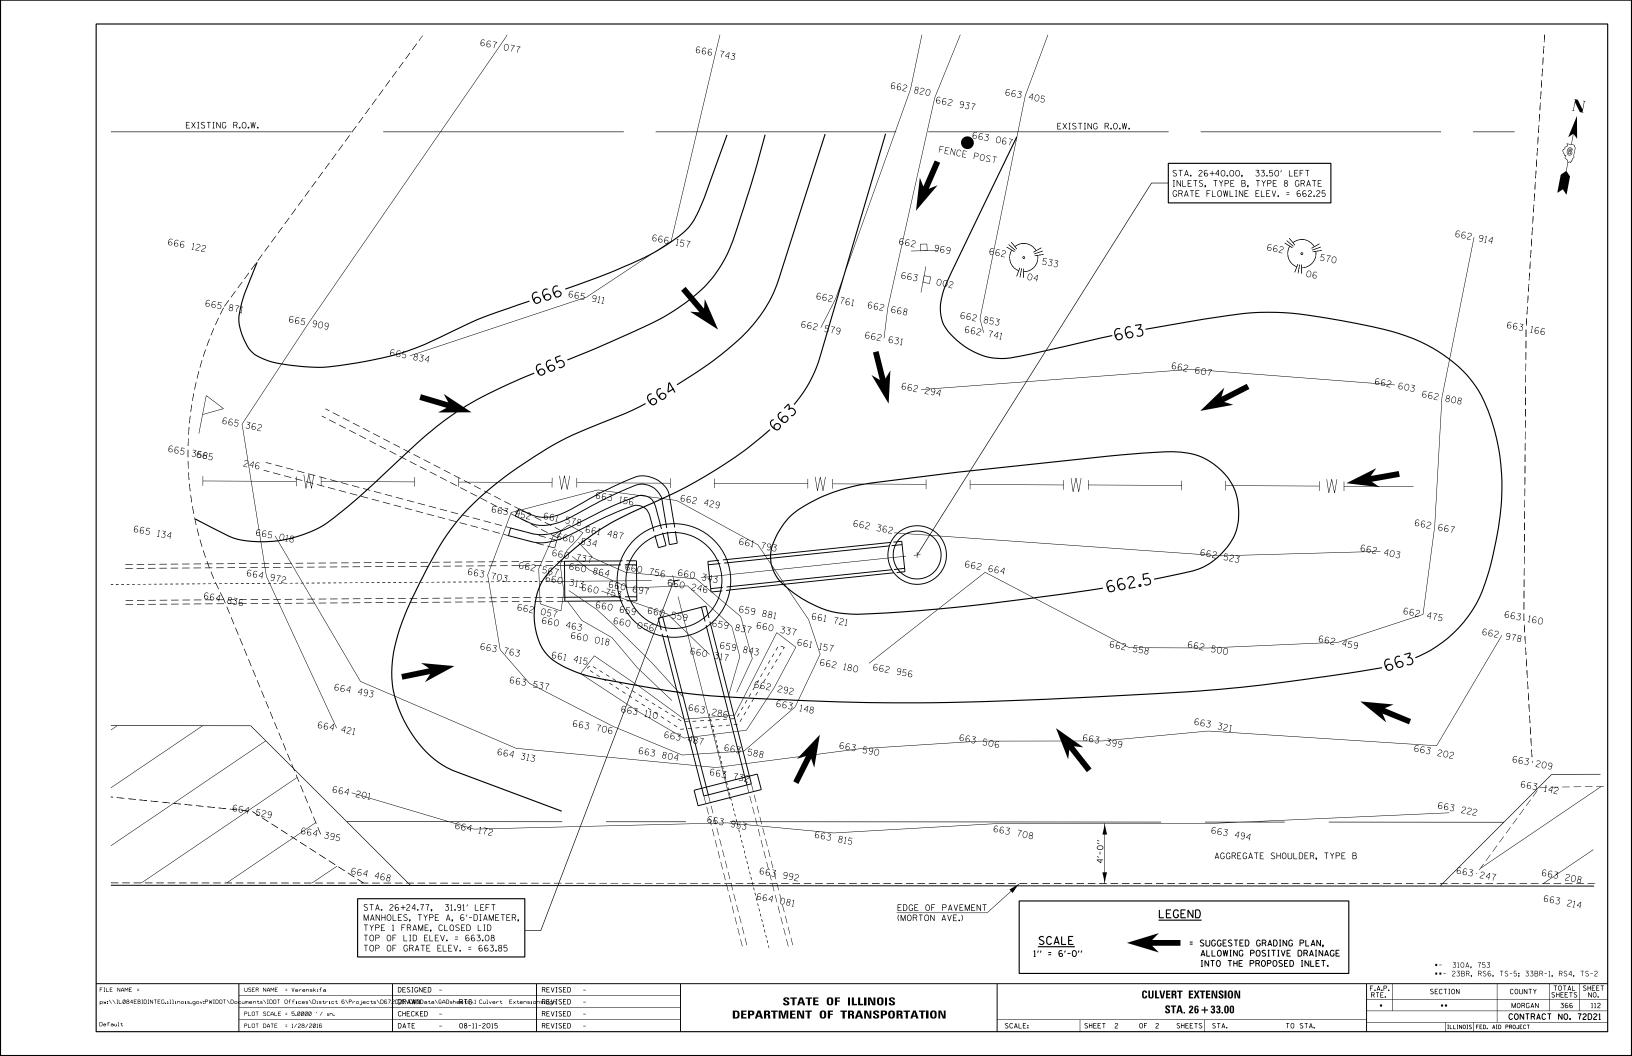

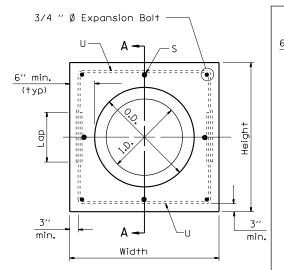

PIPE CULVERT EXTENSION COLLAR

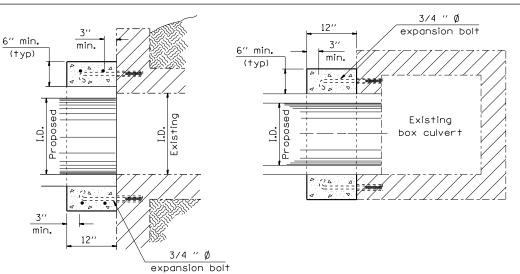

Notes:

Section Type B (Pipe in side extension)


Section A - A

1. Expansion bolts shall consist of self drilling expansion shields and $\frac{3}{4}$ " \emptyset hooked

bolts. Hooked bolts shall extend a minimum of 9" into new concrete. Minimum Certified Proof Load - 4,080 lbs.


2. Use minimum of 1 (one) expansion bolt

at each corner.

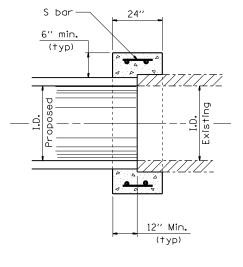


Section Type C

(Pipe end to pipe end extension No expansion bolts required)

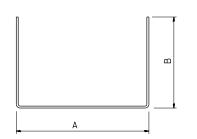

#4 U - bar

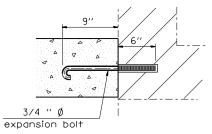

Section Type A

(Box end extension)

Expansion Bolt Detail

9" 6"
3/4 " Ø expansion bolt

Station	ection Type	Skew	Existing Culvert		posed lvert	Со	llar	St	oar .			einford bar	cement Bo	rs				Expansion Bolts 3/4 "	Class SI Concrete Collar
	Sec		Size	I.D.	0.D.	Height	Width	No.	Size	Length	No.	Size	Α	В	Lap	Length	Ιb	Each	yd ³
26+33 LT	С		30''	30′′	37′′	49′′	49''	8	#4	1'-8''	4	#4	43''	31′′	18′′	8'-9''	55.7	-	0.7
30+03 LT	С		18"	18"	23''	35"	35"	8	#4	1'-8''	4	#4	29"	24"	18"	6′-5′′	43.6	_	0.4
30+03 RT	С		18"	18"	23''	35"	35"	8	#4	1'-8''	4	#4	29"	24"	18"	6′-5′′	43.6	-	0.4
33+02 LT	С		30"	30′′	37''	49′′	49"	8	#4	1'-8''	4	#4	43′′	31"	18"	8′-9′′	43.6	_	0.4
33+02 RT	С		30"	30"	37"	49"	49"	8	#4	1'-8''	4	#4	43"	31''	18"	8'-9''	43.6	-	0.4
41+72.4 LT	С		24"	24"	30"	42''	42''	8	#4	1'-8''	4	#4	36"	27''	18"	7′-6′′	49.0	_	0.6
41+72.4	С		24"	24"	30"	42"	42"	8	#4	1'-8''	4	#4	36"	27"	18"	7'-6''	49.0	-	0.6
																1		1	

BOX CULVERT POURED IN PLACE EXTENSION clear span

Section Thru Barrel

See table for no. of exp. bolts per side

(S)									
	ar height (H)		Δ Δ Δ Δ Δ		EX	PANS]	expansion ION BOLTS JLVERT EXT	REQUI	
	clear			1		No. E	xpansion Bolt	ts Requ	d. Per Side
			(1)		H or S	Exter	nsion ≦15ft	Exten	sion > 15ft
		Δ			п 01 3	No.	Spacing	No.	Spacing
$\frac{\triangle}{\wedge} - \frac{2}{2}$	>			_	24''	*	*	*	*


U 05 C	Exter	nsion ≦15ft	Exten	sion > 15ft
H or S	No.	Spacing	No.	Spacing
24''	*	*	*	*
30''	2	18′′	2	18′′
36"	2	24''	2	24''
48''	3	18′′	3	18′′
60''	4	16''	3	24''
72''	5	15′′	4	20''
84''	5	18′′	4	24''
96′′	6	17''	5	21''
108''	6	19"	5	24''
120′′	7	18"	6	21''
132''	8	17''	6	24''
144''	8	19"	7	22"

Concrete Cóllar


Note: Number of expansion bolts in table based on non-skewed culverts.

* Use minimum 1 (one) expansion bolt in each corner.

FILE NAME =	USER NAME = Verenskıfa	DESIGNED -	REVISED -			CONCRETE COLLAR AND	F.A.P.	SECTION	COUNTY	TOTAL S
pw:\\ILØ84EBIDINTEG.:111:no1s.gov:PWIDOT\Do	cuments\IDOT Offices\District 6\Projects\D67	202RACWINData\GADsheets\1 Culvert Extens	on-REGAISED -	STATE OF ILLINOIS			•	••	MORGAN	366
	PLOT SCALE = 5.0000 '/ in.	CHECKED -	REVISED -	DEPARTMENT OF TRANSPORTATION		CULVERT EXTENSION DETAILS			CONTRACT	T NO. 72
Default	PLOT DATE = 1/28/2016	DATE - 12-05-2015	REVISED -		SCALE:	SHEET 1 OF 1 SHEETS STA. TO STA.		ILLINOIS FED. AI	.D PROJECT	

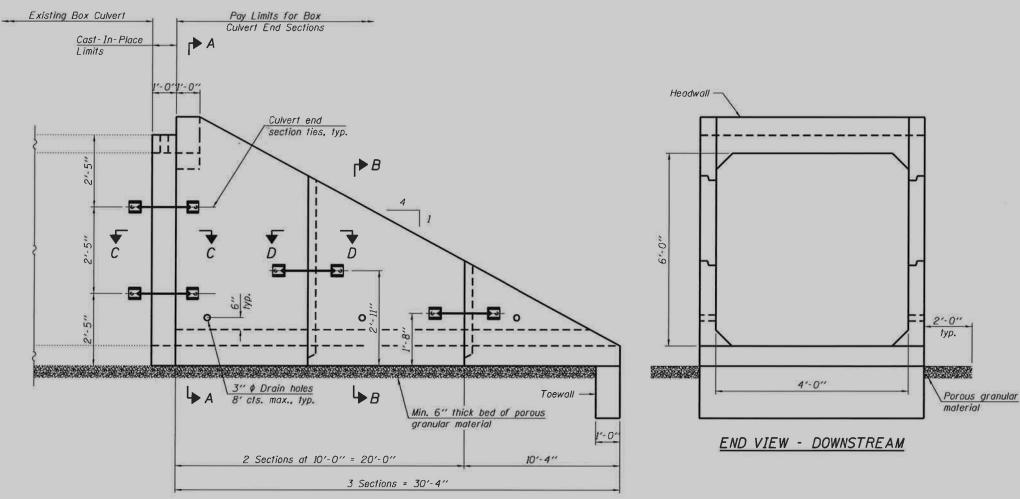

<u>ELEVATION - DOWNSTREAM</u>

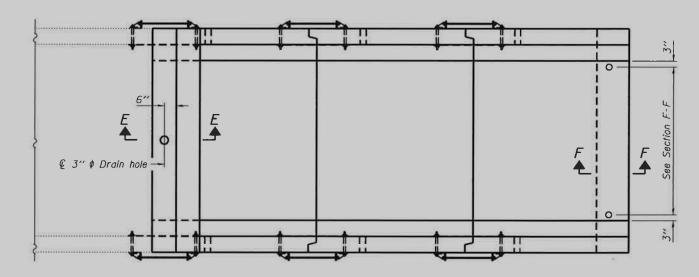


PLAN - DOWNSTREAM

E.M. Lagemann

CHECKED

PLOT DATE # 10/19/2015



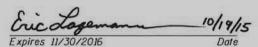

GENERAL NOTES

Box Culvert End Sections shall be constructed according to the requirements of Section 540 of the Standard Specifications except as modified herein. This work will be measured for payment as each, with each end of each culvert being one each. End sections will be poid for at the contract unit price per each for Box Culvert End Sections of the culvert number specified.

Typical box section dimensions, materials, and reinforcement details for Box Culvert End Sections shall be according to the requirements of ASTM C 1577 as required for the design of the portion of the culvert within the limits of Precast Concrete Box Culverts except as modified herein.

1" ϕ anchor rods for the culvert ties shall conform to the requirements of ASTM F1554. Grade 105. Structural steel for tie plate and restraint angle shall conform to the requirements of Article 1006.04 of the Standard Specifications. All components of the culvert tie detail shall be galvanized according to the requirements of AASHTO M 111 or M 232 as applicable. 2^1_4 " x 2^1_4 " x 2^1_6 " plate washers shall be provided under each nut required for the anchor rods. Anchor rods connecting precast sections shall be brought to a snug tight condition followed by an additional 1_2 turn on one of the nuts for anchor rods installed in the walls. Anchor rods connecting precast sections to existing section shall be brought up to a snug tight condition followed by an additional 1_2 turn on one of the nuts for anchor rods installed in the walls after closure pour has cured and before collar has been cast. Match marks shall be provided on the bolt and nut to verify relative rotation between the bolt and the nut. Holes in the walls for the culvert tie assembly may be drilled using core bits in lieu of using formed holes.

All costs associated with furnishing and installing or constructing the toewall and culvert ties will not be measured for payment but shall be included in the contract unit price for Box Culvert End Sections of the culvert number specified.

Reinforcement bars designated (E) shall be epoxy coated.

Drain holes shall conform to the requirements of Article 503.11 of the Standard Specifications unless noted otherwise.

Nonwoven geotextile fabric shall conform to the requirements of Article 1080.01. The minimum weight of the fabric shall be 6 oz. / sq. yd..

For end sections with traversoble pipe grate systems, see grate detail sheet for required modifications.

For flowline elevations, see roadway cross-sections.

TOTAL BILL OF MATERIAL

ITEM	UNIT	TOTAL
Concrete Removal	Cu. Yd.	15.2
Reinforcement Bars	Pound	110
Box Culvert End Sections, Culvert No. 1	Each	2
Concrete Box Culvert	Cu. Yd.	1.1
Expansion Bolts 34''	Each	28
Concrete Collar	Cu. Yd.	1.7
Traversable Pipe Grate	Foot	68

Notes

SHEET NO. 1 OF 5 SHEETS

Class SI Concrete Collar omitted for clarity. For Sections C-C and D-D, see sheet 2 of 5.


For Sections A-A, B-B, E-E, and F-F, see sheet 3 of 5.


For details of the Class SI Concrete Collar, see sheet 4 of 5.

• 310A, 753


ILLINOIS FED. AID PROJECT

.. 23BR, RS6, TS-5; 33BR-1, RS4, TS-2 DESIGNED T.S. Friederich COUNTY TOTAL SHEET NO. SECTION STA. 43 + 27.58 CULVERT EXTENSION HORNER USER NAME = tafraederich STATE OF ILLINOIS CHECKED E.M. Lagemann REVISED Morgan **GENERAL PLAN AND ELEVATION - DOWNSTREAM** PLOT SCALE = T.S. Friederich REVISED **DEPARTMENT OF TRANSPORTATION** CONTRACT NO. 72D21

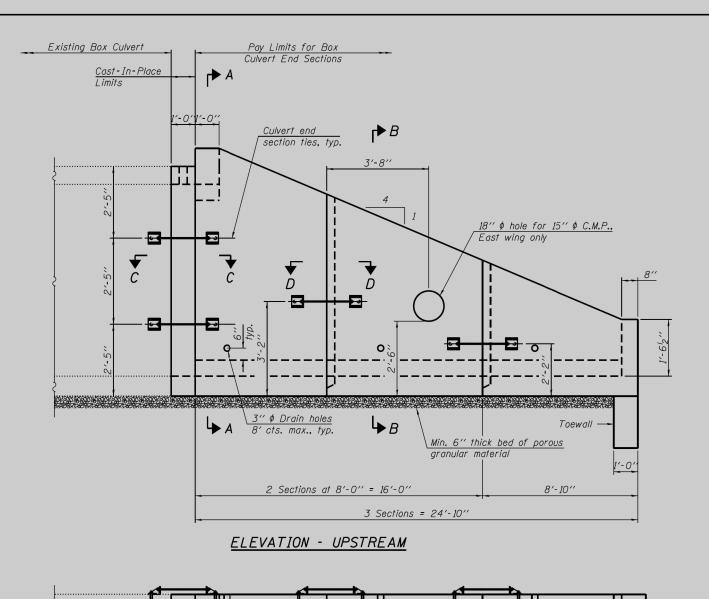


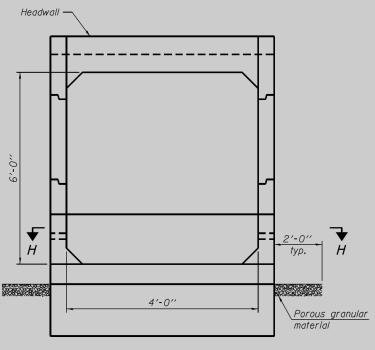

END VIEW - UPSTREAM

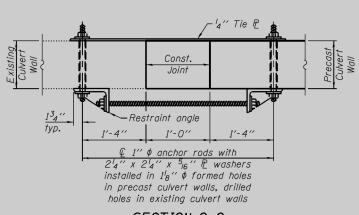


<u>SECTION C-C</u> (Showing end section tie details)

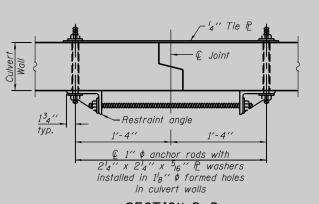

<u>SECTION D-D</u> (Showing end section tie details)

typ. $\frac{1}{5_{16}}$ L 6" x 4" x $\frac{1}{2}$ " $\frac{C}{2}$ $\frac{1}{4}$ " ϕ hole for 1" ϕ anchor rod with $\frac{C}{2}$ $\frac{1}{4}$ " ϕ hole in $\frac{1}{2}$ bottom leg of angle $\frac{1}{4}$ " x $\frac{1}{2}$ washer

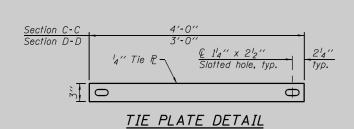

• 310A, 753

RESTRAINT ANGLE DETAIL

PLAN - UPSTREAM

Notes:

Class SI Concrete Collar omitted for clarity.

For Sections A-A, B-B, E-E, G-G, and H-H, see sheet 3 of 5.

For details of the Class SI Concrete Collar, see sheet 4 of 5.

** 23BR, RS6, TS-5; 33BR-1, RS4, TS-2

** STA. 43 + 27.58 CULVERT EXTENSION

GENERAL PLAN AND ELEVATION - UPSTREAM

** SHEET NO. 2 OF 5 SHEETS


	n37W07\Cad\S\1019707 Culvert Extension.dgn	DESIGNED	-	T.S. Friederich	REVISED	
HORNER	USER NAME = tsfriederich	CHECKED	-	E.M. Lagemann	REVISED	
SHIEBINI	PLOT SCALE =	DRAWN	-	T.S. Friederich	REVISED	
WWW, HORNERSHIFRIN, COM	PLOT DATE = 10/16/2015	CHECKED	-	E.M. Lagemann	REVISED	

φ

€ 3" ¢ Drain hole


STATE OF ILLINOIS
DEPARTMENT OF TRANSPORTATION

G

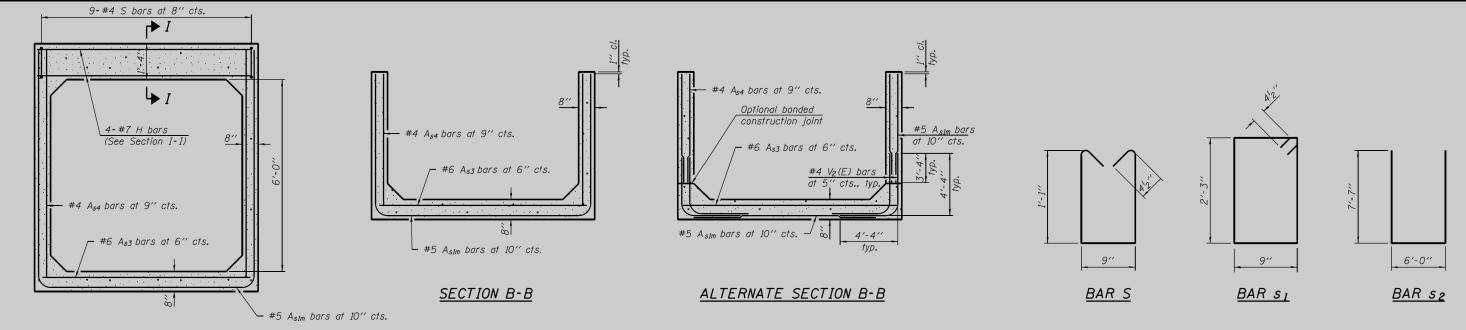


SECTION A-A

(Allow sidewall reinforcement to extend into end of headwall.)

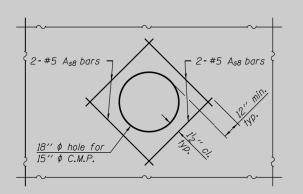




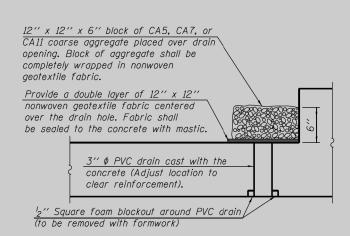

SECTION E-E


(All costs associated with furnishing and constructing the above drain detail will not be measured for payment but shall be included in the contract unit price for the associated work.)

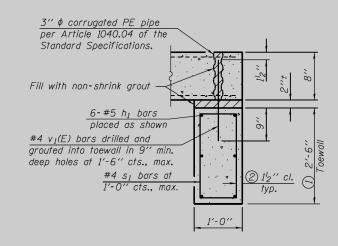


SECTION F-F

TOEWALL CONSTRUCTION SEQUENCE


- 1. Perform excavation and construct toewall.
- 2. Backfill according to the applicable paragraphs of Article 502.10 of the Standard Specifications and place bedding for precast box culvert end sections.
- 3. Set precast box culvert end section.
- 4. Drill and epoxy grout reinforcement in toewall in accordance with Section 584 of the Standard Specifications.
- 5. Pressure grout voids using non-shrink grout conforming to Section 1024 of the Standard Specifications.
- 1) The Contractor may furnish a precast or cast-in-place toewall. The Contractor shall be responsible for the strength and stability of the precast toewall during handling. Additional lifting points may be required depending upon the length of the toewall or the Contractor may need to modify the design of the toewall for the proposed handling the method.
- 2) If soil conditions permit, the sides of the toewall may be poured directly against the soil. The clear cover on the sides of the toewall shall be increased to 3" by increasing the thickness of the toewall.

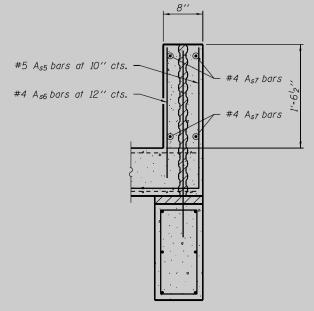

SECTION G-G (See Section F-F for details not shown.)

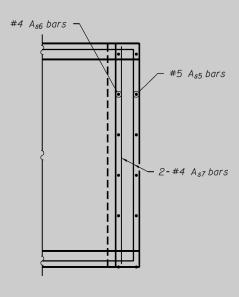

SECTION H-H

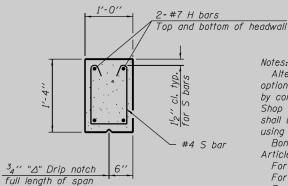

Alternate Section B-B is provided to allow the Contractor the option of casting the bottom slab of the end section first followed by construction of the sidewalls using conventional forming methods. Shop drawings that detail slab thickness and reinforcement layout shall be submitted to the Engineer for review and approval when using Alternate Section B-B.

Bonded construction joints shall be prepared according to Article 503.09 of the Standard Specifications.

For location of Sections A-A, B-B, and E-E, see sheets 1 and 2 of 5.

SECTION

For Location of Section F-F, see sheet 1 of 5. For Location of Section G-G and H-H, see sheet 2 of 5.

Reinforcement shown may be substituted with welded wire fabric conforming to AASHTO M 55 or M 221.

SECTION I-I

• 310A, 753 •• 23BR, RS6, TS-5; 33BR-1, RS4, TS-2

ILLINOIS FED. AID PROJECT

COUNTY TOTAL SHEET


CONTRACT NO. 72D21


Morgan


HORNER		DESIGNED - T.S. Friederich CHECKED - E.M. Lagemann DRAWN - T.S. Friederich	REVISED REVISED REVISED	STATE OF ILLINOIS DEPARTMENT OF TRANSPORTATION	STA. 43 + 27.58 CULVERT EXTENSION DETAILS
WWW, HORNERSHIFRIN, COM	PLOT DATE = 10/16/2015	CHECKED - E.M. Lagemann	REVISED		SHEET NO. 3 OF 5 SHEETS




Expansion Bolts shall consist of self drilling expansion shields and ${}^34'' \phi$ hooked bolts. Minimum certified proof load = 4,080 lbs.

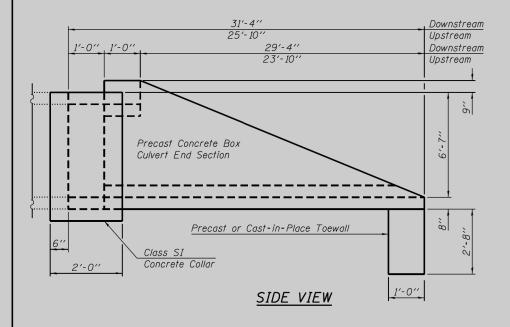


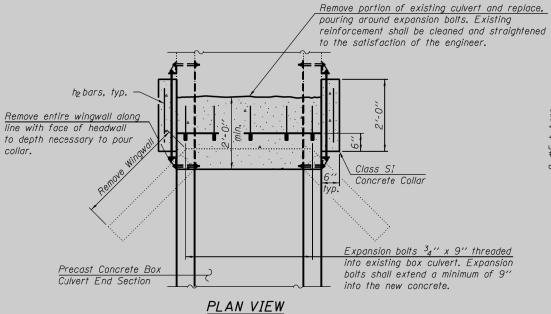

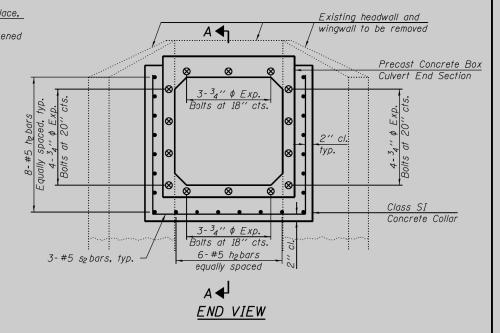

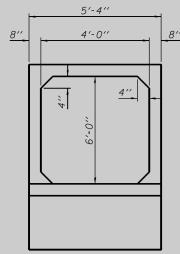

END VIEW

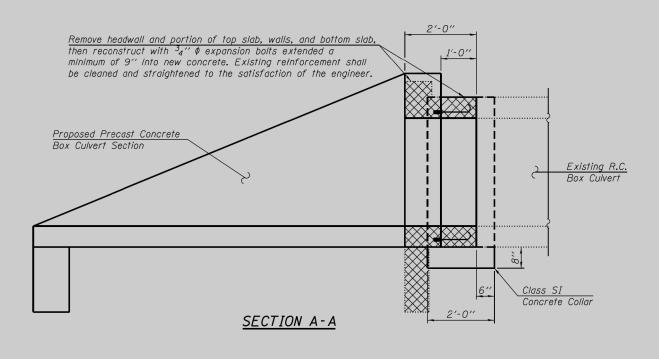

Expansion Bolts shall consist of self drilling expansion shields and $^3\!_4$ " $^\phi$ hooked bolts. Minimum certified proof load = 4,080 lbs.

Downstream side shown, Upstream side similar. For Bar szbending diagram, see sheet 3 of 5. Removal of existing culvert shall be paid for at the contract unit price for Concrete Removal. Cut existing reinforcement to maintain a $1^l_2{}^{\prime\prime}$ clearance from the precast section.


• 310A, 753


•• 23BR, RS6, TS-5; 33BR-1, RS4, TS-2


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HORNER	USER NAME = tsfriederich	CHECKED	-	E.M. Lagemann	REVISED
SHIFRIN	PLOT SCALE =	DRAWN	-	T.S. Friederich	REVISED
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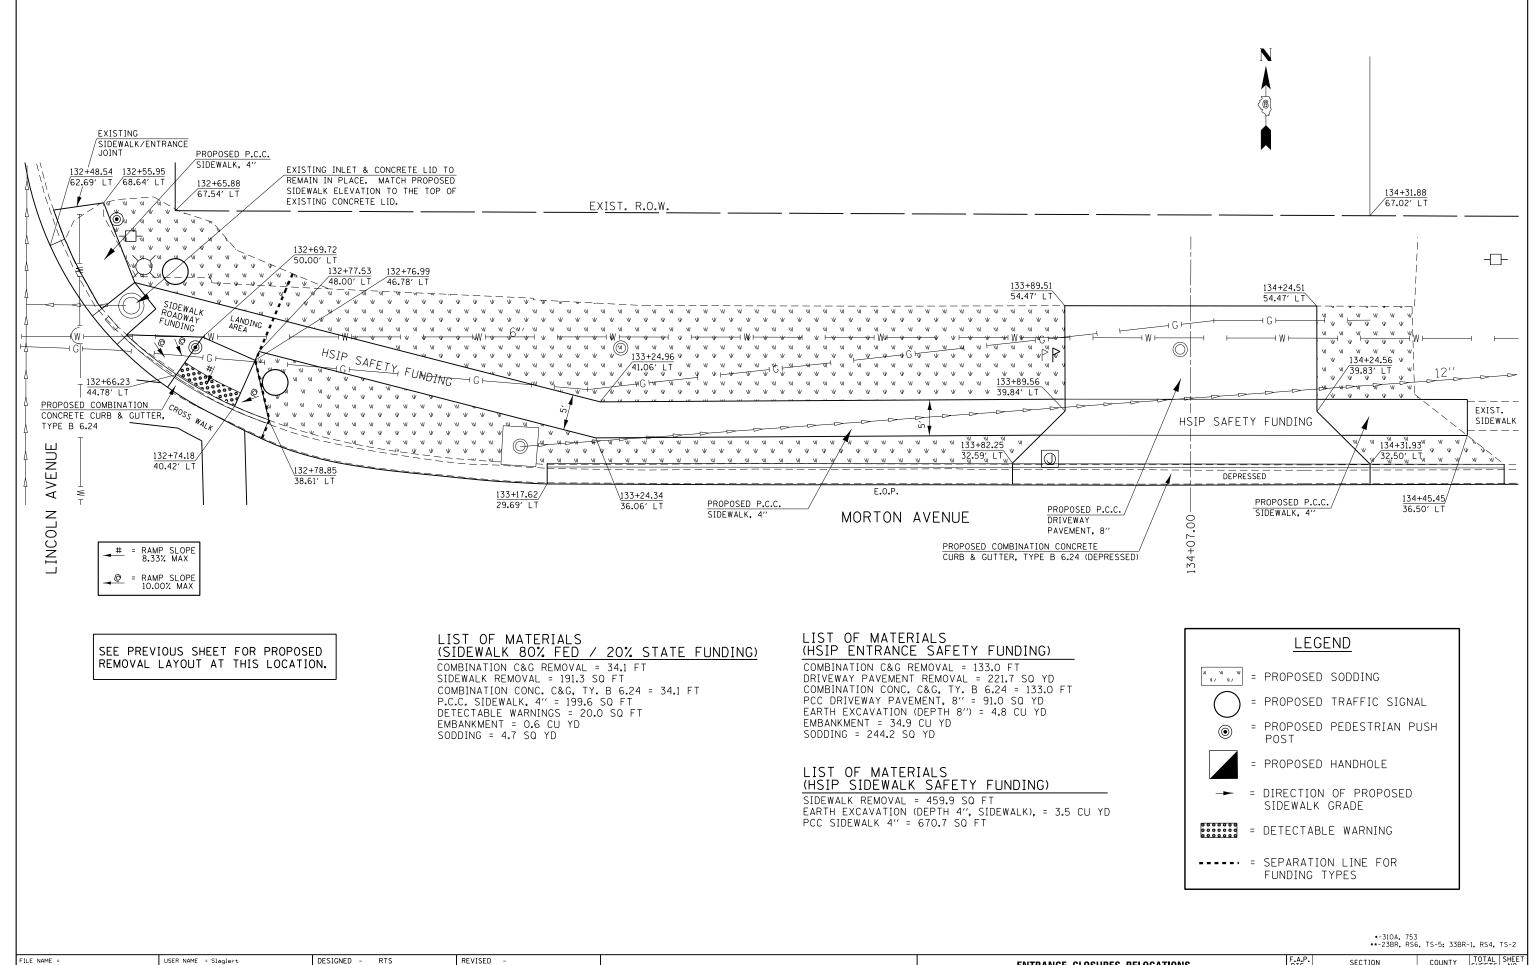
STATE OF ILLINOIS **DEPARTMENT OF TRANSPORTATION** STA. 43 + 27.58 CULVERT EXTENSION **REMOVAL DETAILS** SHEET NO. 4 OF 5 SHEETS

COUNTY TOTAL SHEET NO. SECTION Morgan CONTRACT NO. 72D21



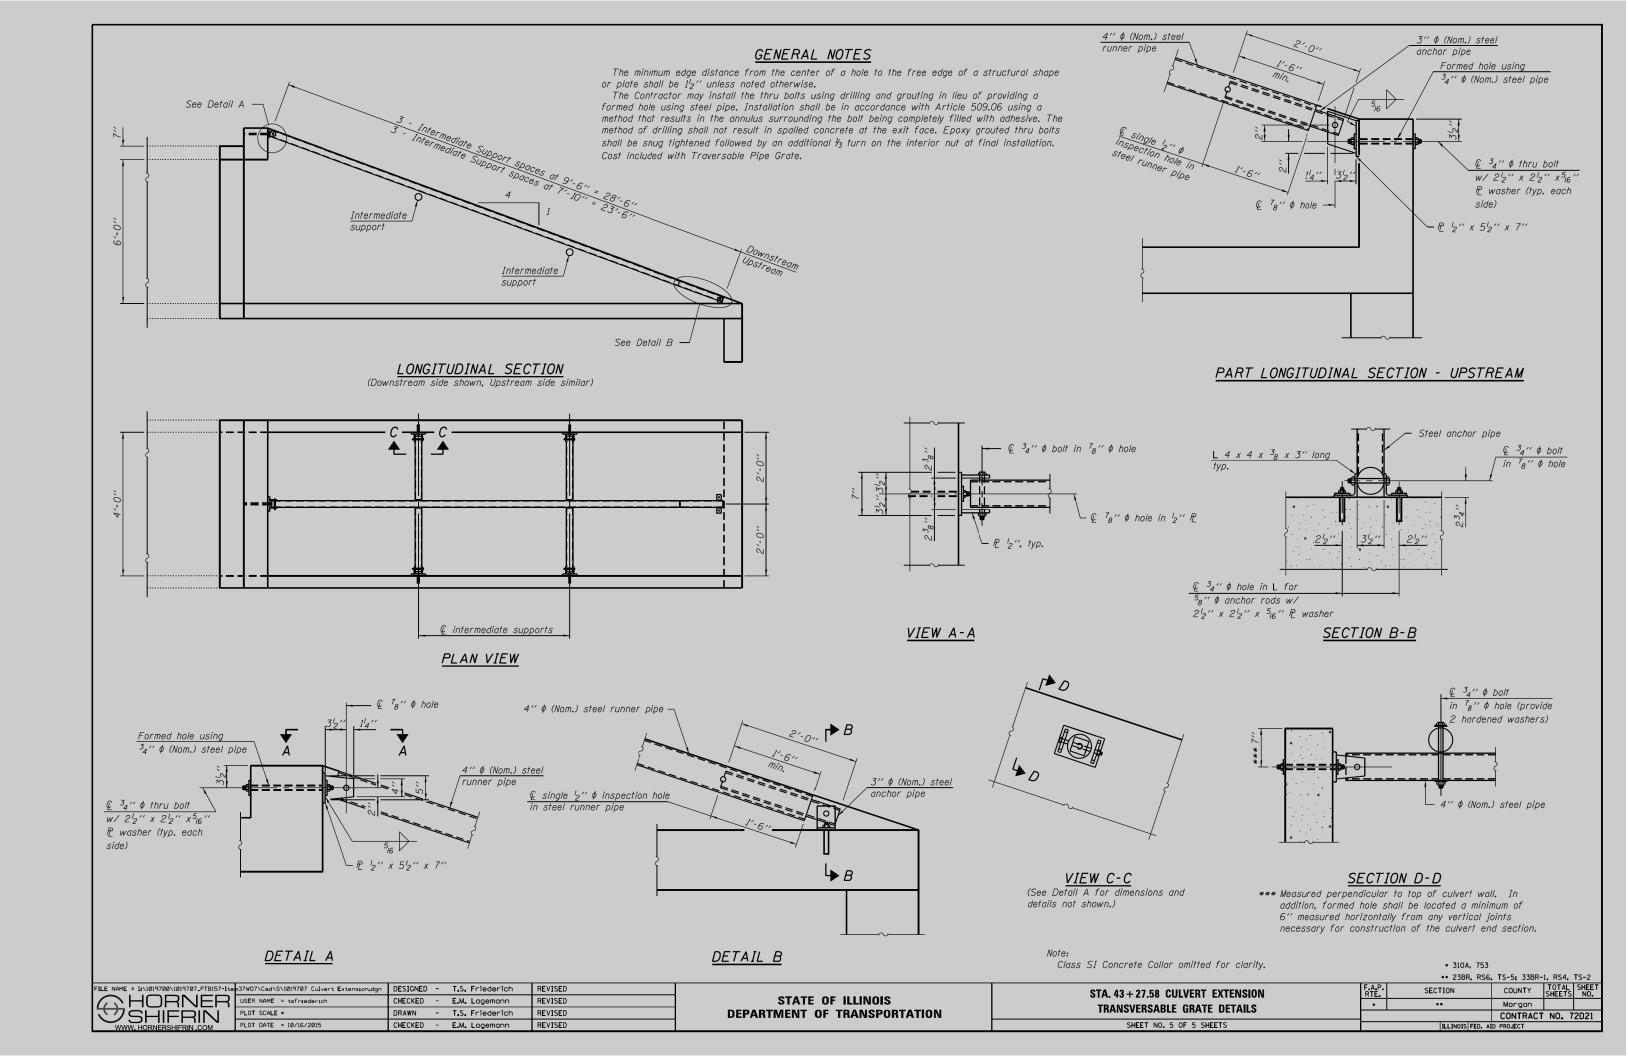

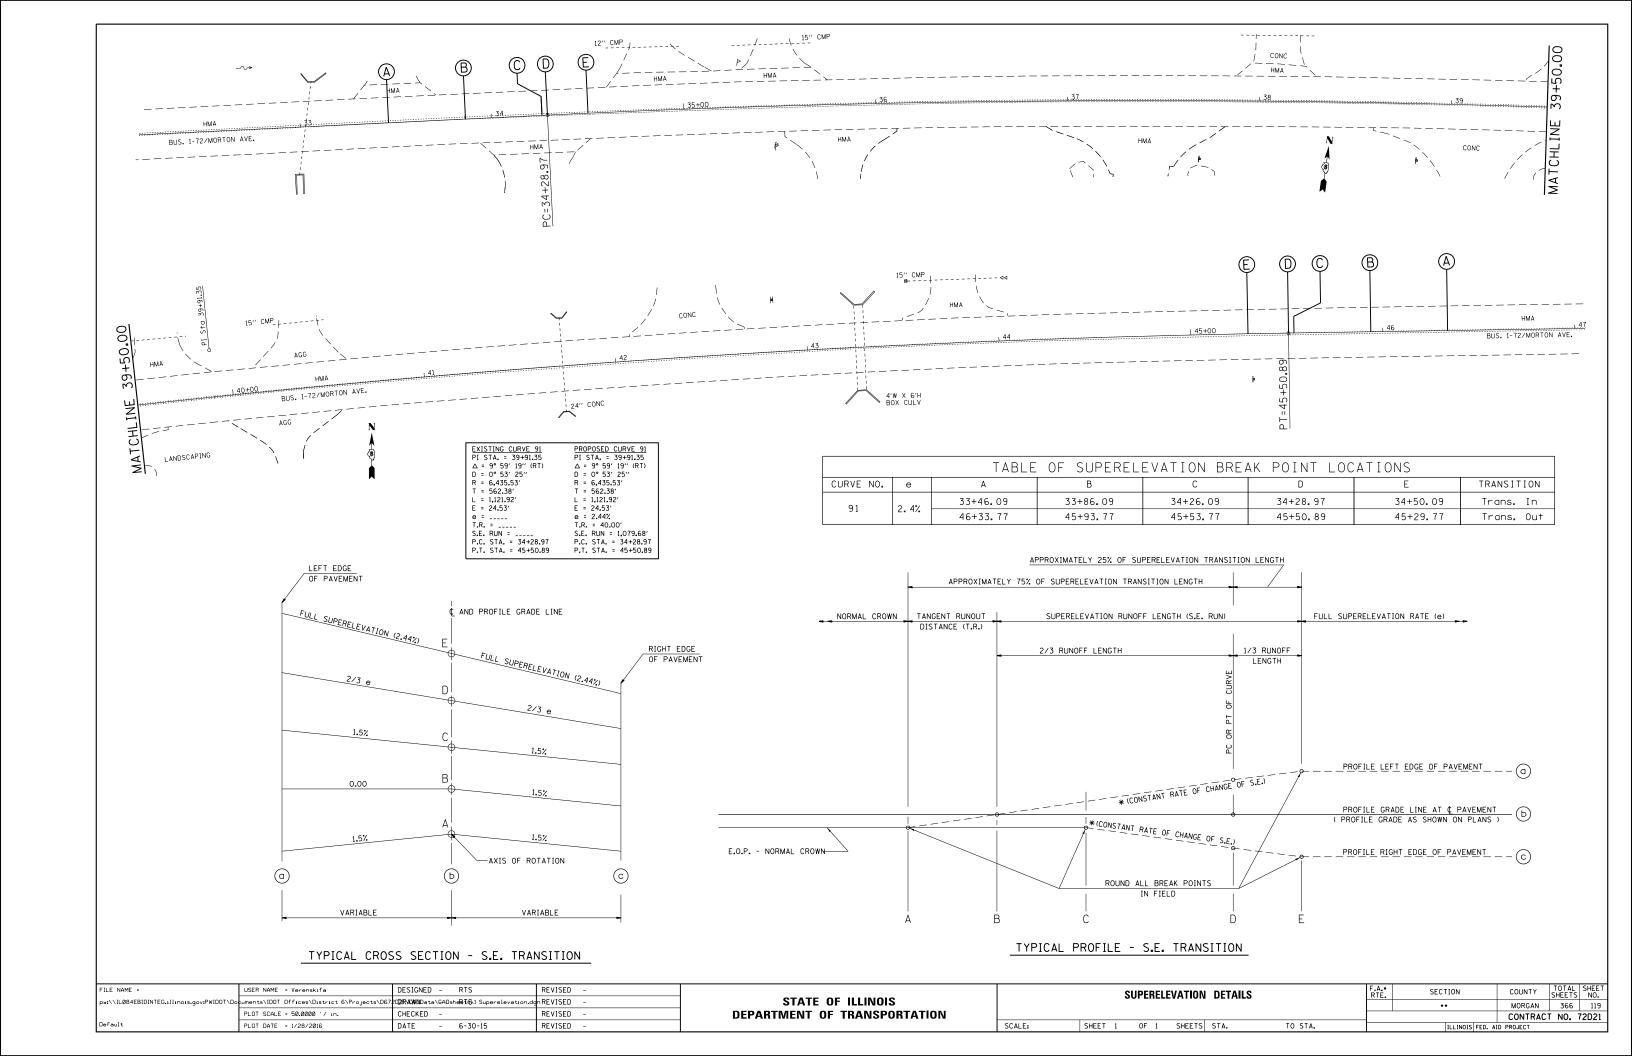

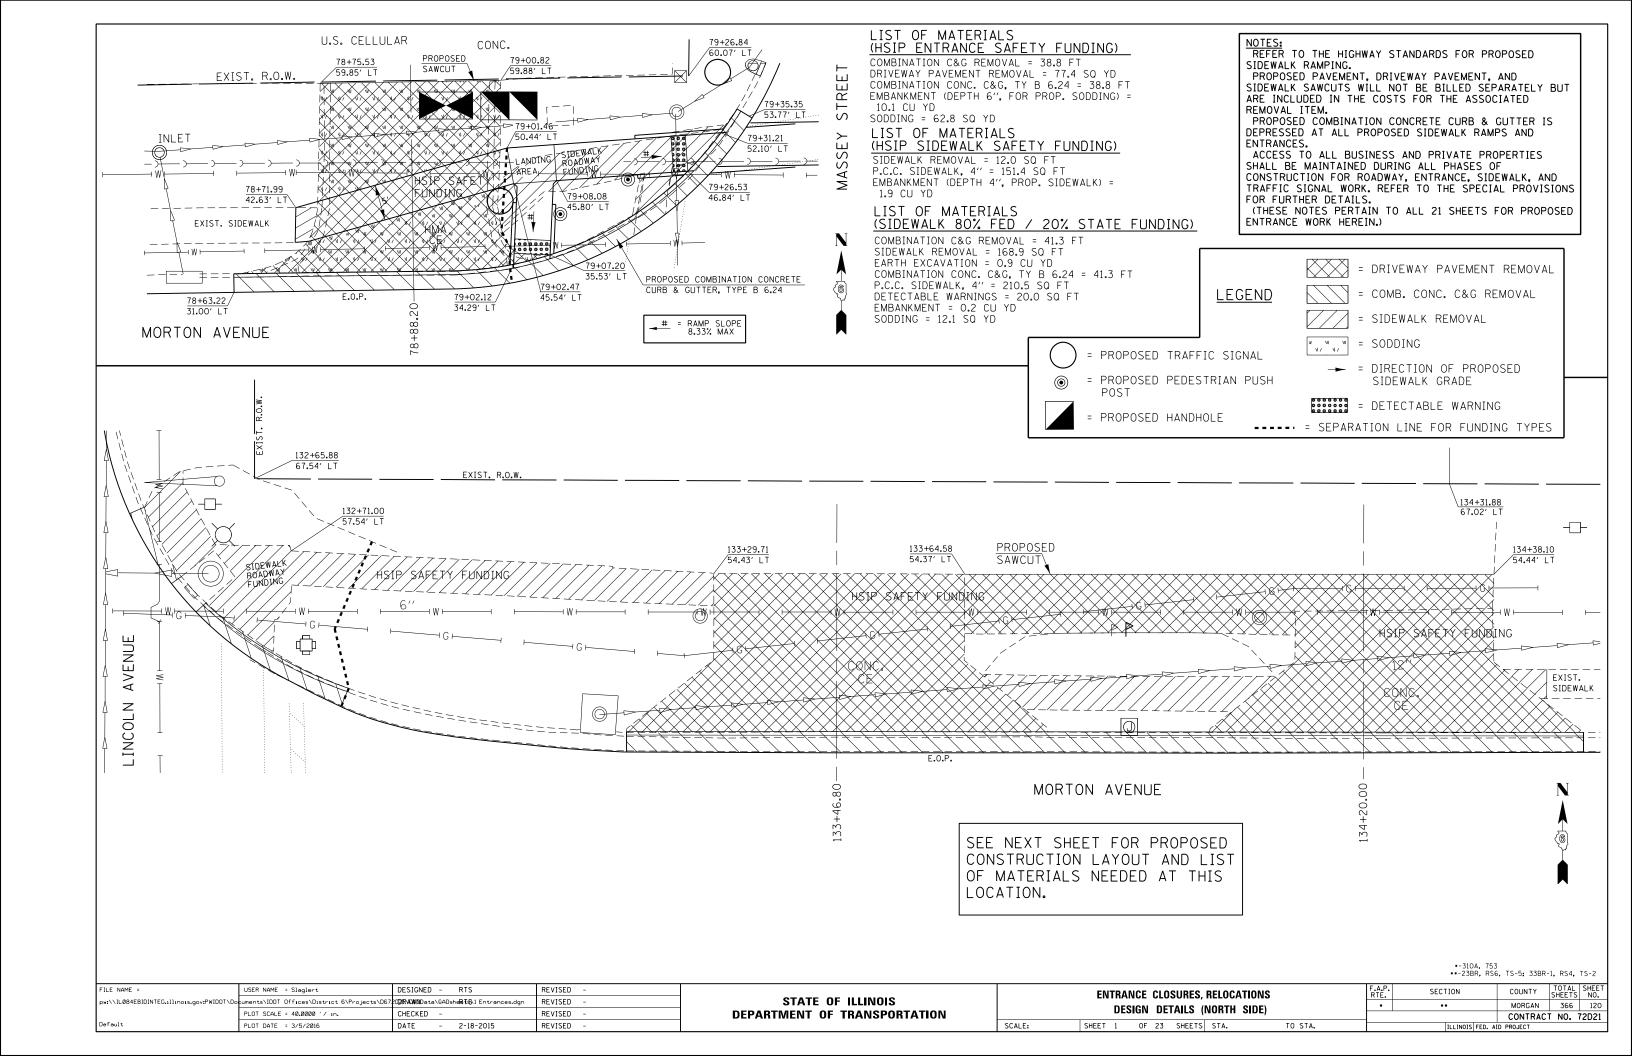

STATE OF ILLINOIS

DEPARTMENT OF TRANSPORTATION

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PLOT DATE = 3/5/2016

CHECKED

2-18-2015

DATE

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SECTION COUNTY TOTAL SHEETS NO.


MORGAN 366 121


CONTRACT NO. 72D21


SHEET 2 OF 23 SHEETS STA.

ENTRANCE CLOSURES, RELOCATIONS

DESIGN DETAILS (NORTH SIDE)

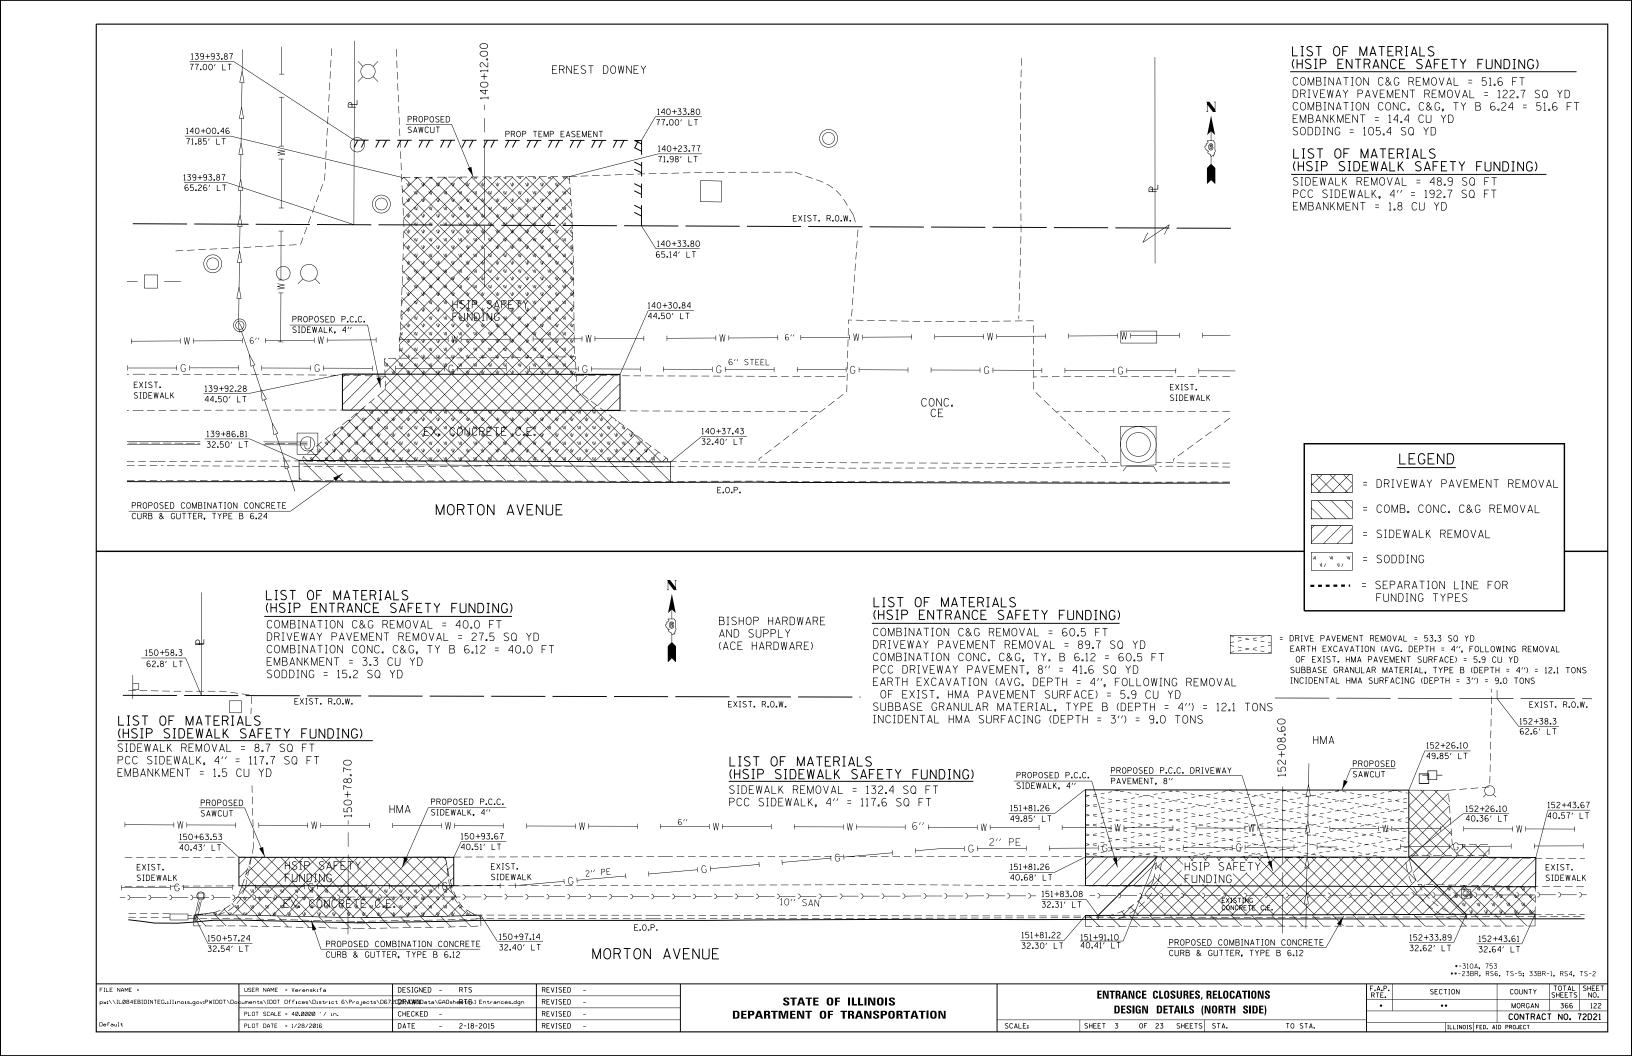

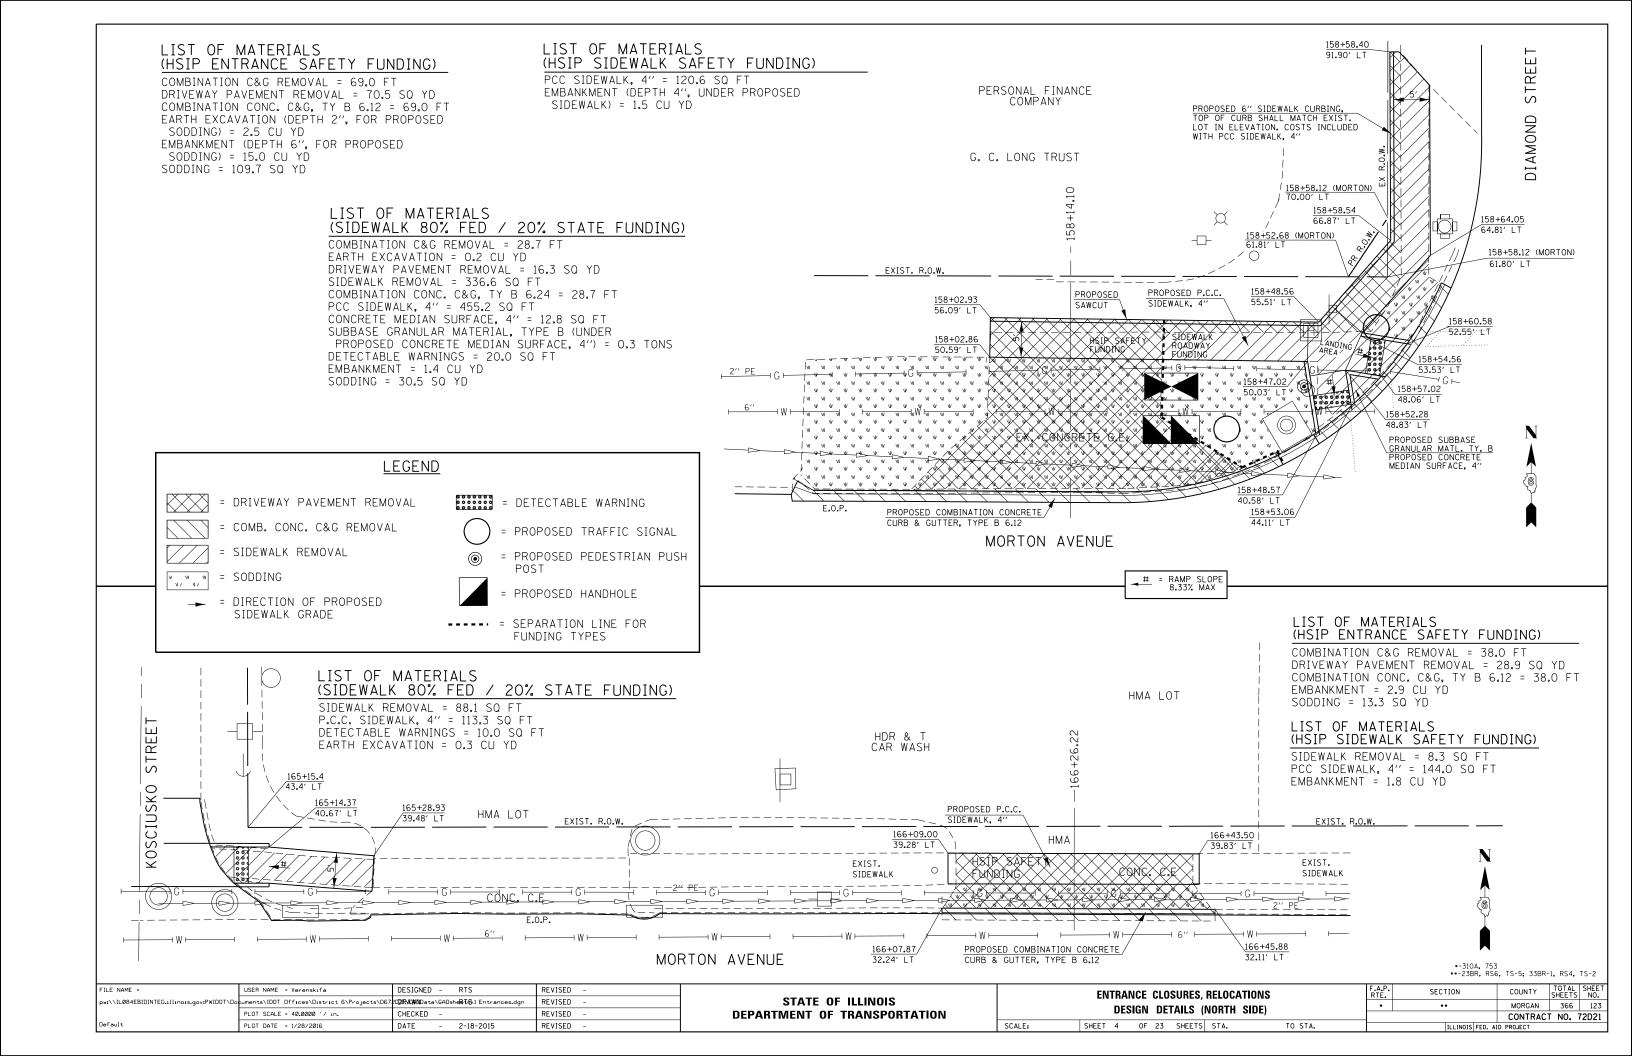

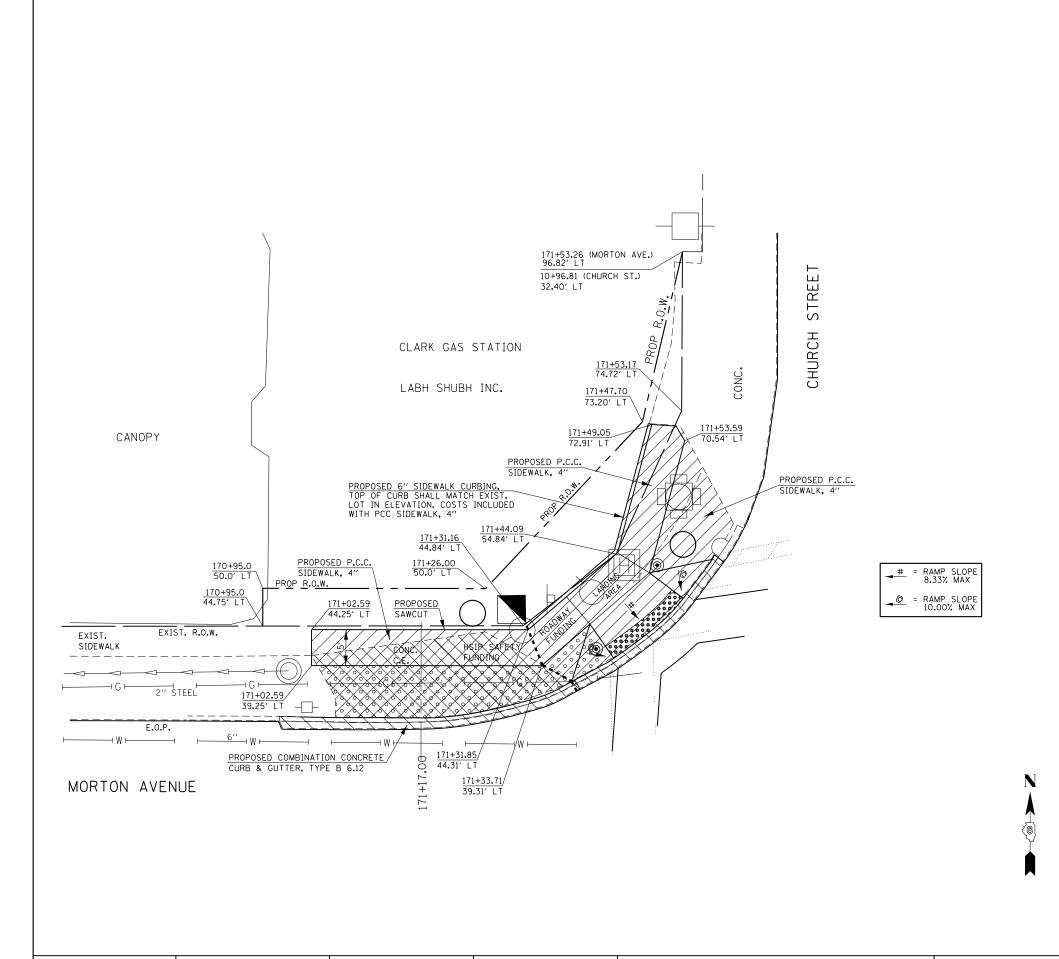

LIST OF MATERIALS
(SIDEWALK 80% FED / 20% STATE FUNDING)

COMBINATION C&G REMOVAL = 27.0 FT
SIDEWALK REMOVAL = 440.6 SQ FT
COMBINATION CONC. C&G, TY B 6.12 = 27.0 FT
PCC SIDEWALK, 4" = 411.6 SQ FT
DETECTABLE WARNINGS = 22.7 SQ FT
EMBANKMENT = 0.7 CU YD
SUBBASE GRANULAR MATERIAL TYPE B (4" DEPTH,
UNDER PROP. CONC. MEDIAN SURFACE) = 1.0 TONS
CONCRETE MEDIAN SURFACE, 4" = 40.7 SQ FT

LIST OF MATERIALS (HSIP ENTRANCE SAFETY FUNDING)

COMBINATION C&G REMOVAL = 42.5 FT
DRIVEWAY PAVEMENT REMOVAL = 32.6 SQ YD
COMBINATION CONC. C&G, TY B 6.12 = 42.5 FT
SUBBASE GRANULAR MATERIAL TYPE B (4" DEPTH,
UNDER PROP. CONC. MEDIAN SURFACE) = 5.2 TONS
CONCRETE MEDIAN SURFACE, 4" = 204.0 SQ FT

LIST OF MATERIALS (HSIP SIDEWALK SAFETY FUNDING)

SIDEWALK REMOVAL = 63.1 SQ FT PCC SIDEWALK, 4" = 155.6 SQ FT EMBANKMENT (DEPTH 4", UNDER SIDEWALK) = 1.9 CU YD

LEGEND

= DRIVEWAY PAVEMENT REMOVAL

= COMB. CONC. C&G REMOVAL

= SIDEWALK REMOVAL

CONCRETE MEDIAN SURFACE, 4"

= SUBBASE GRANULAR MATERIAL TY. B (4" DEPTH)

= DETECTABLE WARNING

) = proposed traffic signal

= PROPOSED PEDESTRIAN PUSH


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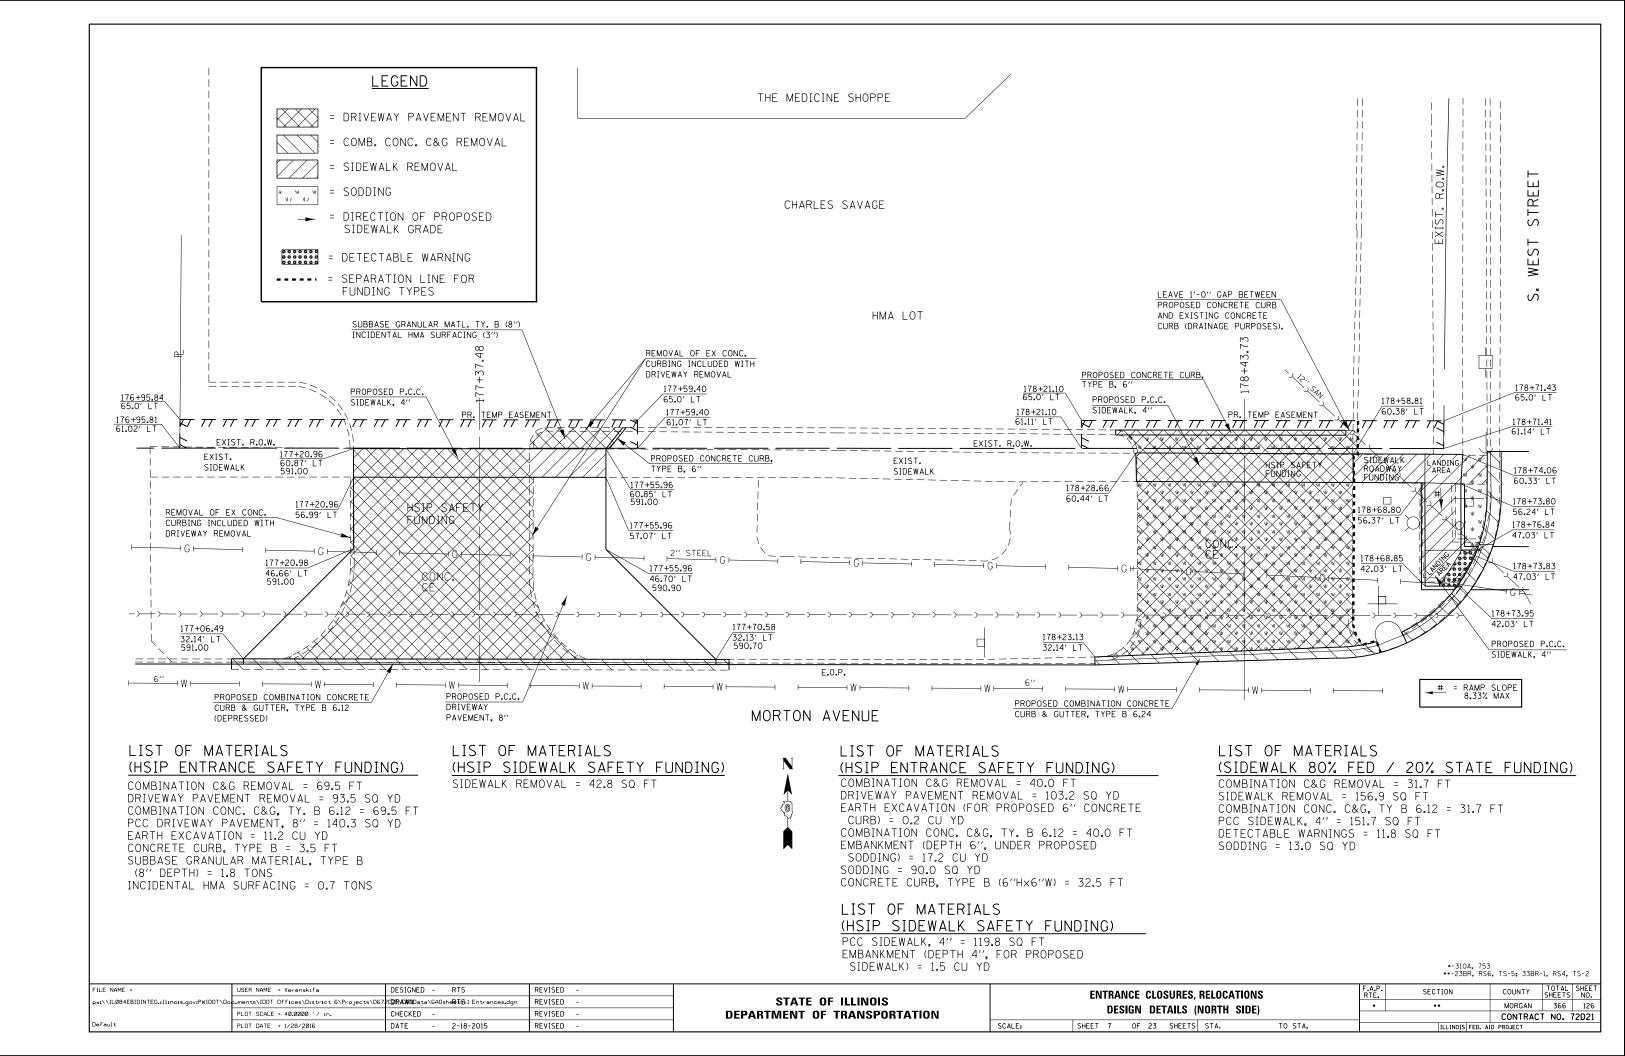
= PROPOSED HANDHOLE


= DIRECTION OF PROPOSED SIDEWALK GRADE


---- = SEPARATION LINE FOR FUNDING TYPES


	FILE NAME =	USER NAME = Slaglert	DESIGNED - RTS	REVISED -		ENTRANCE CLOSURES, RELOCATIONS		RTF.	SECTION	COUNTY SHEETS	NO.
	pw:\\IL084EBIDINTEG.:ll:no:s.gov:PWIDOT\Do	cuments\IDOT Offices\District 6\Projects\D67	:D2RAD#NData\GADsheRts\1 Entrances.dgn	REVISED -	STATE OF ILLINOIS			•	**	MORGAN 366	124
		PLOT SCALE = 40.0000 ' / in.	CHECKED -	REVISED -	DEPARTMENT OF TRANSPORTATION	DESIGN DETAILS (NORTH SIDE)				CONTRACT NO. 720	2D21
L	Default	PLOT DATE = 3/5/2016	DATE - 2-18-2015	REVISED -		SCALE:	SHEET 5 OF 23 SHEETS STA. TO STA.		ILLINOIS FED. AI	1	



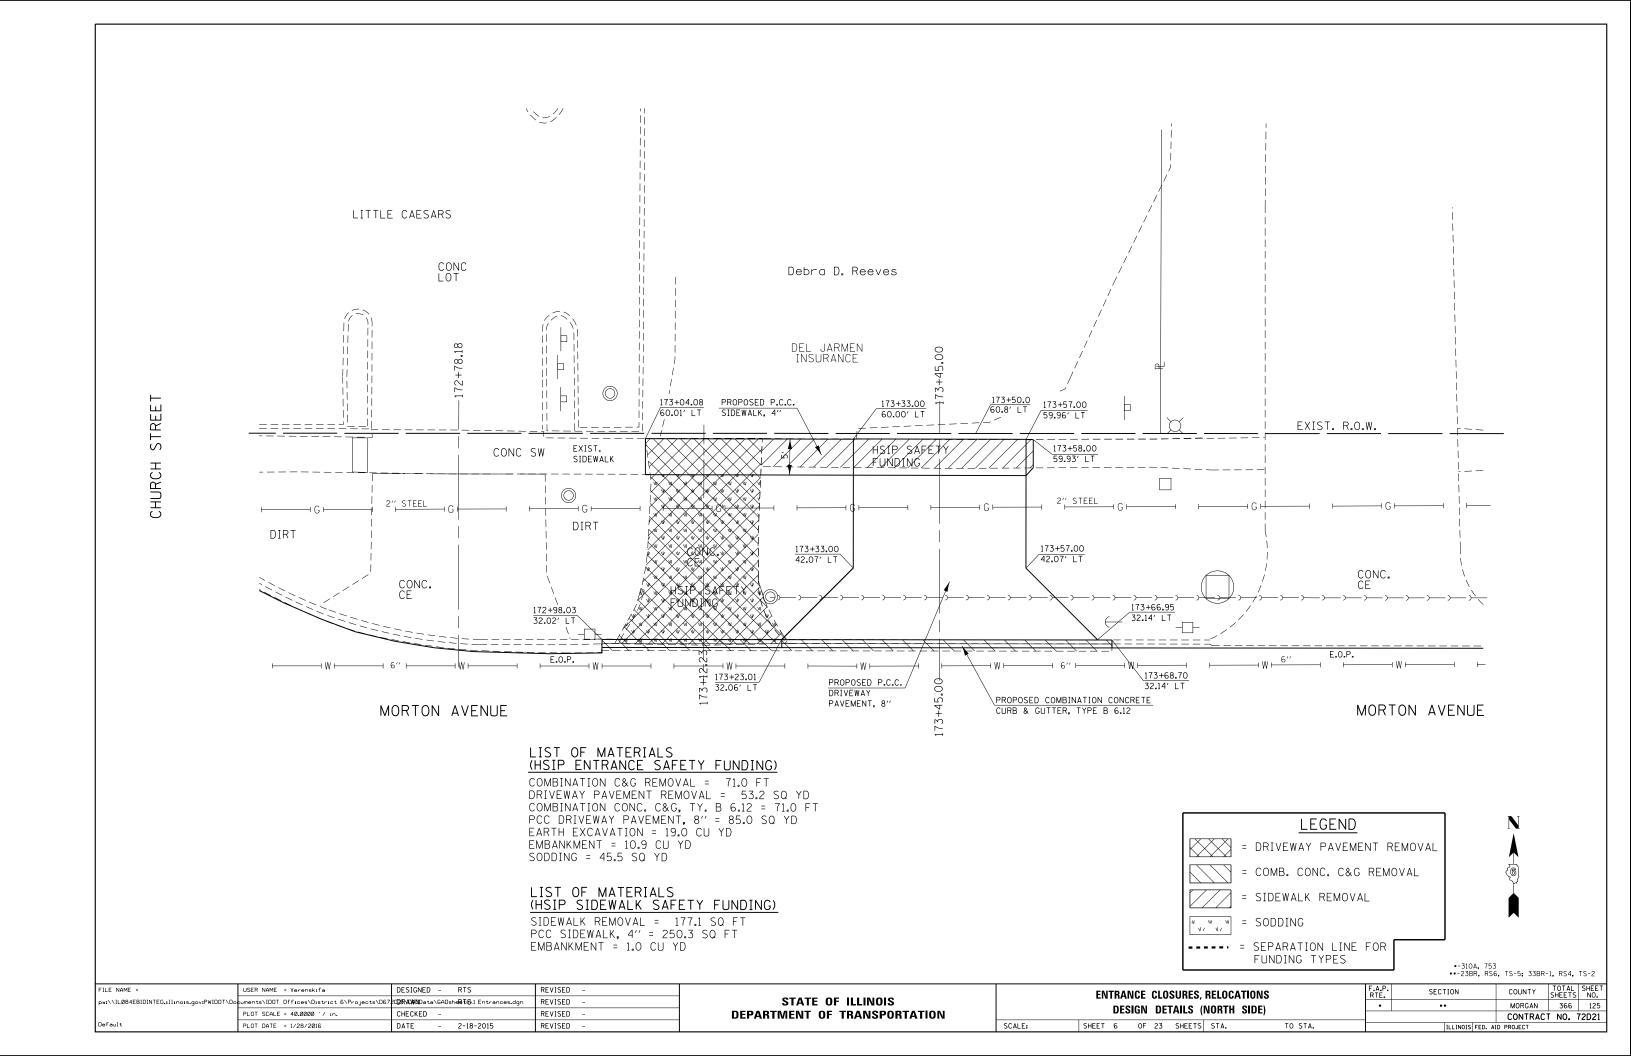

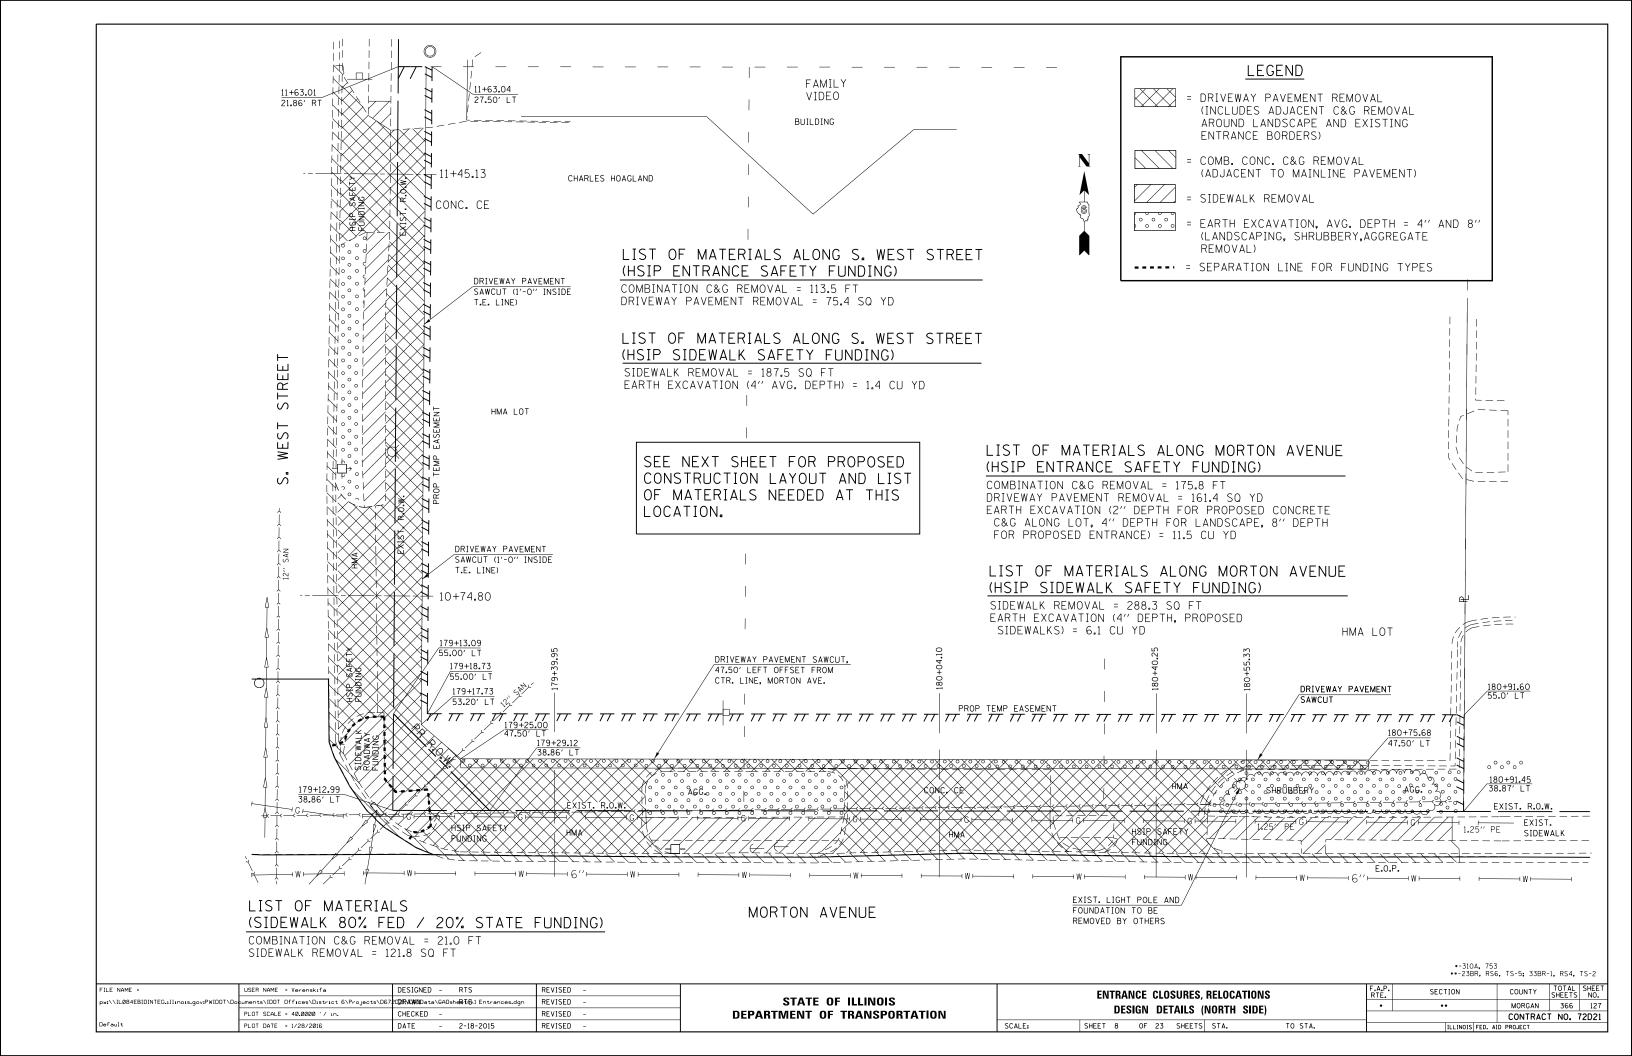


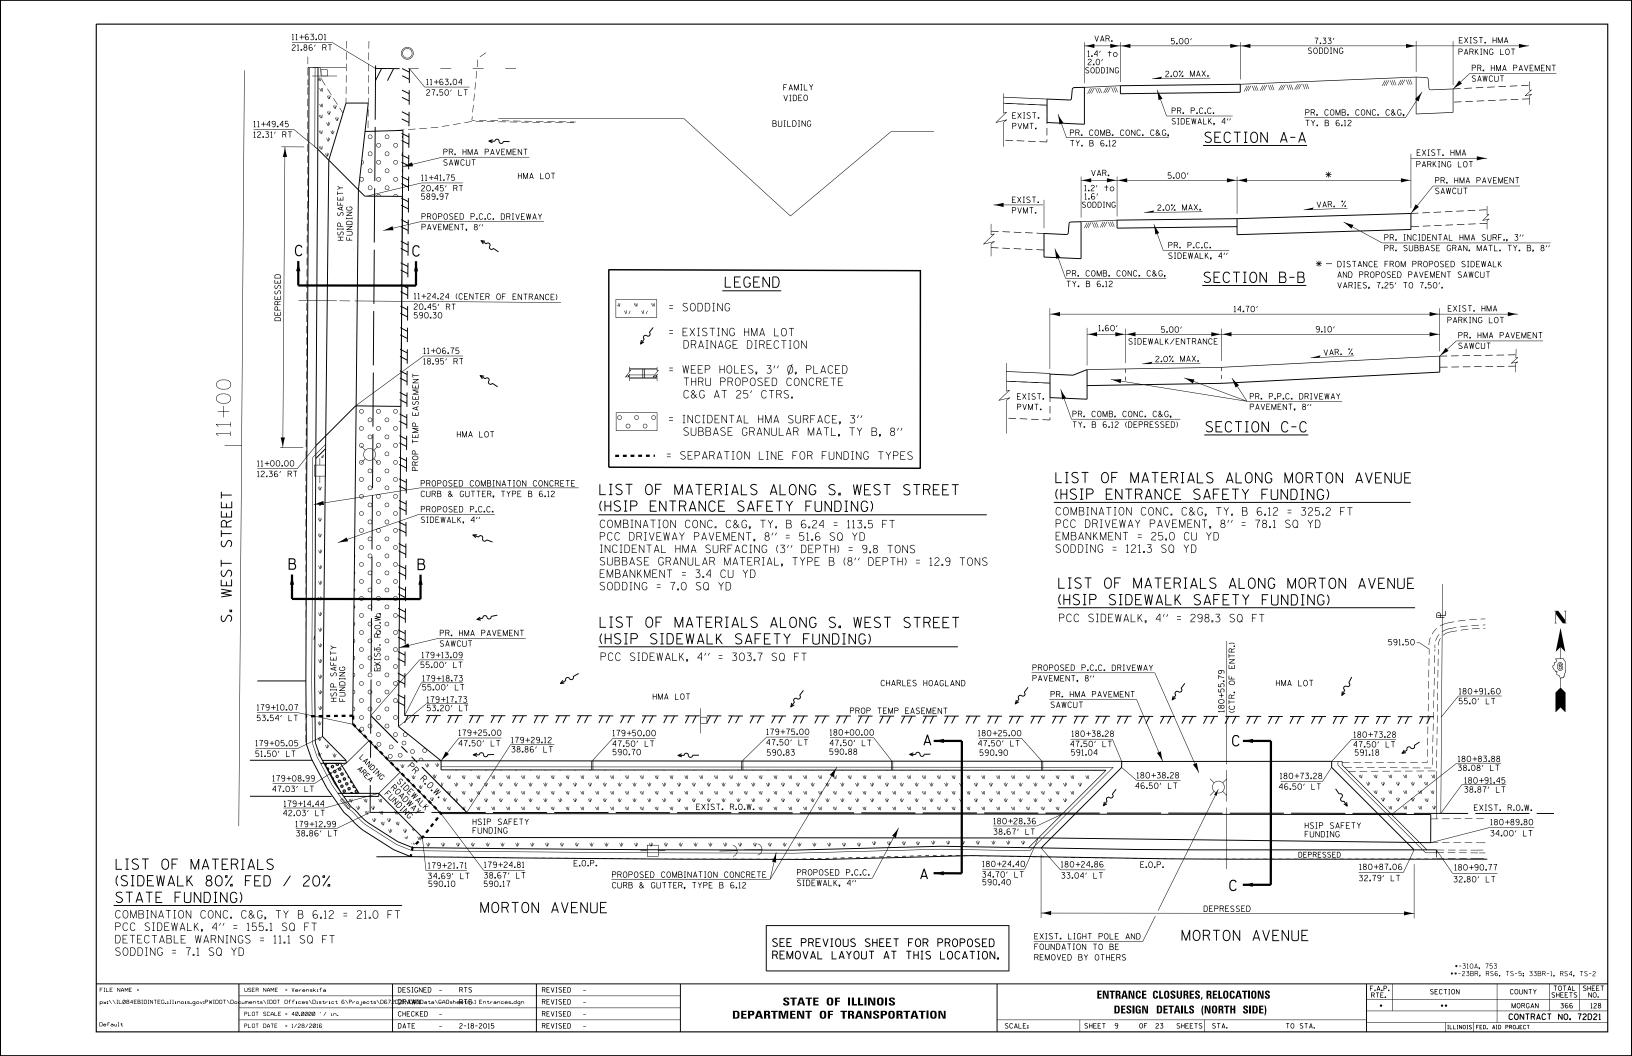

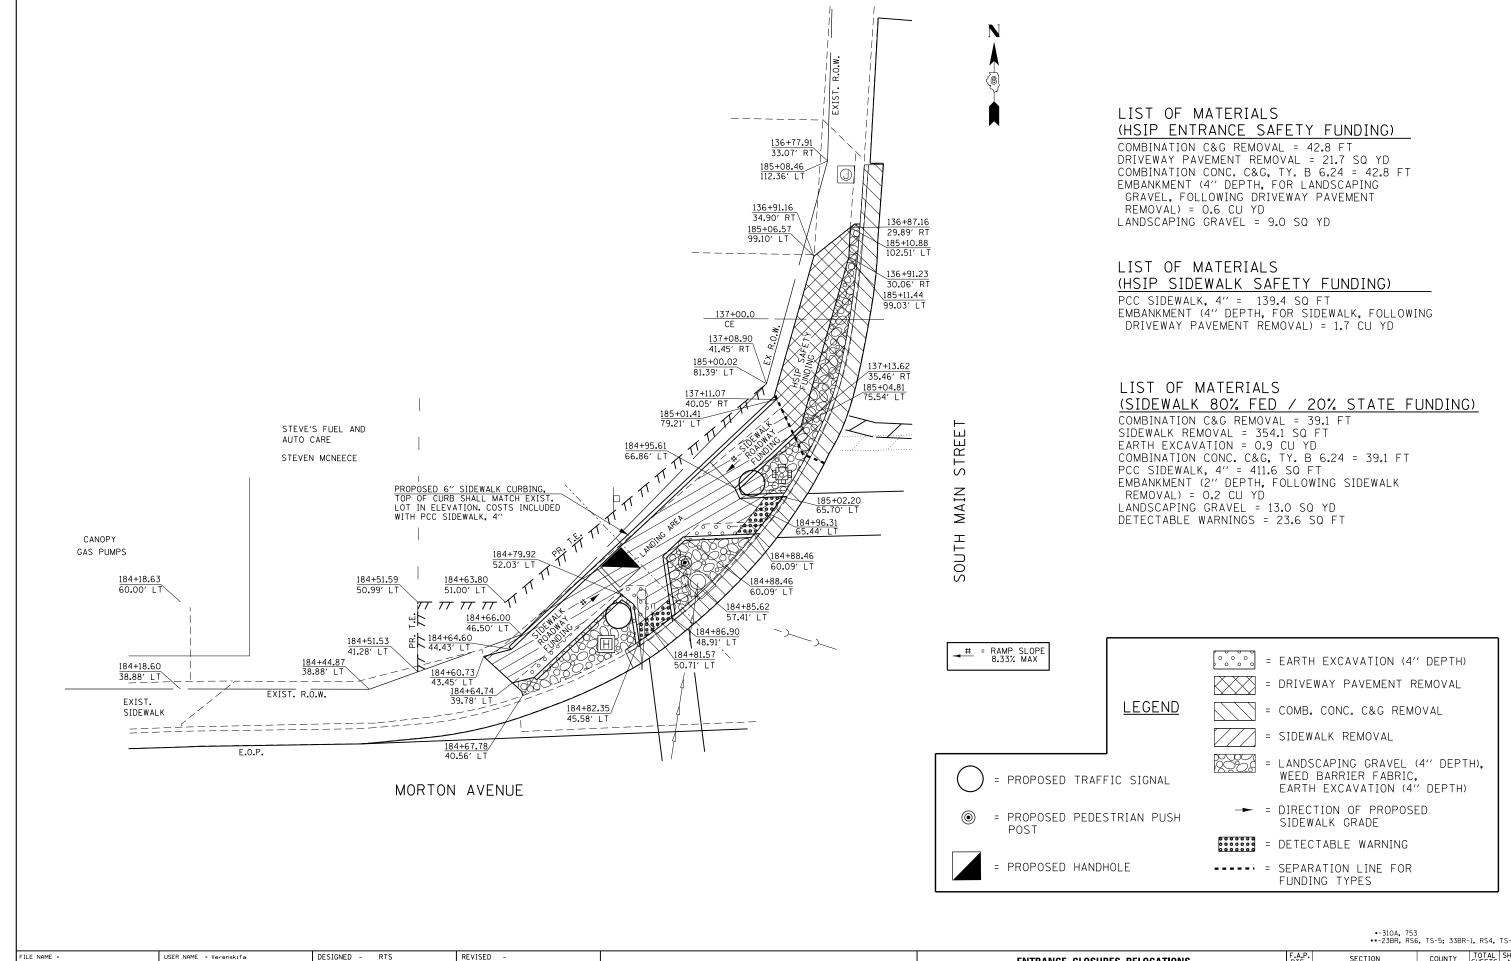

*-310A, 753 **-23BR, RS6, TS-5; 33BR-1, RS4, TS-2

SECTION COUNTY **ENTRANCE CLOSURES, RELOCATIONS** STATE OF ILLINOIS w:\\ILØ84EBIDINTEG.:111:no ments\IDOT Offices\District 6\Projects\D67202RVXWNData\GADsheRfs\1 Entrances.dor REVISED MORGAN 366 129 **DESIGN DETAILS (NORTH SIDE)** CHECKED REVISED **DEPARTMENT OF TRANSPORTATION** CONTRACT NO. 72D21 SHEET 10 OF 23 SHEETS STA. TO STA. PLOT DATE = 1/28/2016 DATE REVISED

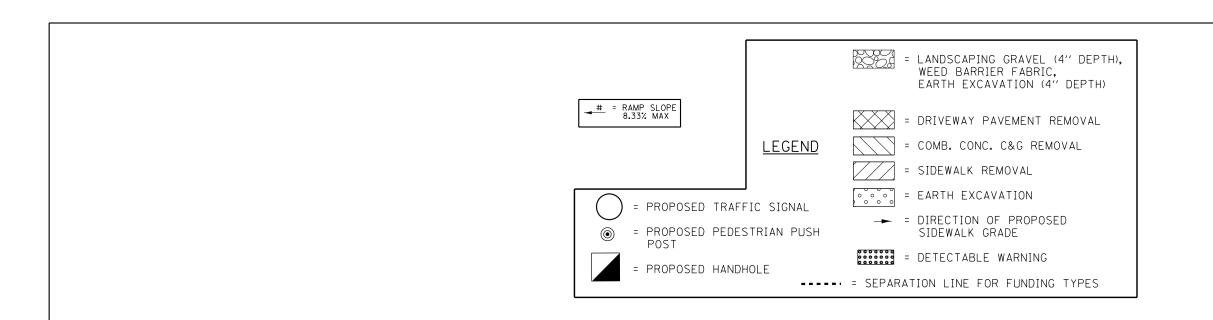


LIST OF MATERIALS (HSIP ENTRANCE SAFETY FUNDING)


COMBINATION C&G REMOVAL = 46.4 FT DRIVEWAY PAVEMENT REMOVAL = 62.6 SQ YD EARTH EXCAVATION (4" DEPTH) = 0.5 CU YD COMBINATION CONC. C&G, TY. B 6.24 = 46.4 FT

LIST OF MATERIALS (HSIP SIDEWALK SAFETY FUNDING)

PCC SIDEWALK, 4" = 609.9 SQ FT EMBANKMENT (4" DEPTH, FOR SIDEWALK FOLLOWING DRIVEWAY PVMT. REMOVAL) = 7.0 CU YD

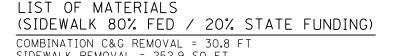

SIDEWALK REMOVAL = 252.9 SQ FT EARTH EXCAVATION (4" DEPTH) = 4.9 CU YD COMBINATION CONC. C&G, TY. B 6.24 = 30.8 FT PCC SIDEWALK, 4" = 416.9 SQ FT CONCRETE MEDIAN SURFACE, 4" = 6.0 SQ FT EMBANKMENT (4" DEPTH) = 1.6 CU YD DETECTABLE WARNINGS = 23.3 SQ FT LANDSCAPING GRAVEL = 7.3 SQ YD

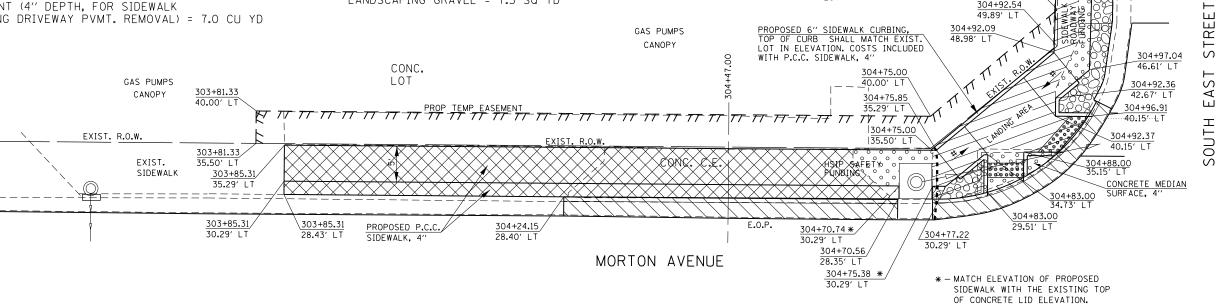

•-310A, 753 ••-23BR, RS6, TS-5; 33BR-1, RS4, TS-2

304+92.58 70.57' LT

304+92.52 54.97′ LT

304+92.54

CIRCLE K GAS STATION

CONC.


LOT

304+97.48 66.07′ LT

PROPOSED P.C.C.

SIDEWALK, 4"

FILE	LE NAME =	USER NAME = Slaglert	DESIGNED - RTS	REVISED -		ENTRANCE CLOSURES, RELOCATIONS		F.A.P.	SECTION	COUNTY	SHEETS NO.
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		PLOT SCALE = 40.0000 ' / in.	CHECKED -	REVISED -	DEPARTMENT OF TRANSPORTATION	DESIGN DETAILS (NORTH SIDE)				CONTRACT	T NO. 72D21
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LIST OF MATERIALS (ROADWAY, 80% FED / 20% STATE FUNDING)

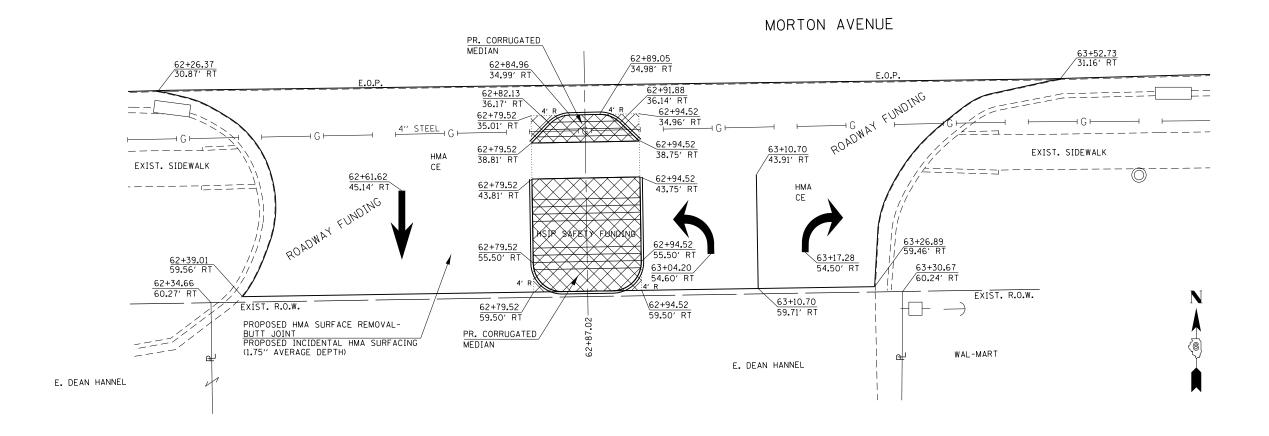
HMA SURFACE REMOVAL-BUTT JOINT = 258.3 SQ YD INCIDENTAL HMA SURFACING (1.75" AVG. DEPTH) = 25.3 TONS

LIST OF MATERIALS (HSIP ENTRANCE SAFETY FUNDING)

DRIVEWAY PAVEMENT REMOVAL = 32.5 SQ YD
EARTH EXCAVATION (2" DEPTH) = 1.8 CU YD
PCC BASE COURSE 10" = 2.5 SQ YD
CORRUGATED MEDIAN (10" DEPTH) = 270.7 SQ FT
THERMOPLASTIC PAVEMENT MARKING - LINE 5"
(MEDIAN BORDER, YELLOW) = 62.0 FT
THERMOPLASTIC PAVEMENT MARKING - LINE 6"
(LANE LINE, WHITE) = 16.0 FT
PREFORMED PLASTIC PAVEMENT MARKING - L & S
(DIRECTION ARROWS, WHITE) = 42.7 SQ FT



FILE NAME =	USER NAME = Verenskifa	DESIGNED - RTS	REVISED -			ENTRANCE CLOSURES, RELOCATIONS	F.A.P.	SECTION	COUNTY	TOTAL SHEET
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	PLOT SCALE = 40.0000 '/ in.	CHECKED -	REVISED -	DEPARTMENT OF TRANSPORTATION	DESIGN DETAILS (SOUTH SIDE)				CONTRACT	T NO. 72D21
Default	PLOT DATE = 1/28/2016	DATE - 2-18-2015	REVISED -		SCALE: SHEET 12 OF 23 SHEETS STA. TO STA.			ILLINOIS FED. AID PROJECT		
Default	PLOT DATE = 1/28/2016	DATE - 2-18-2015	REVISED -		SCALE:	SHEET 12 OF 23 SHEETS STA. TO STA.		ILLINOIS FED. AI		

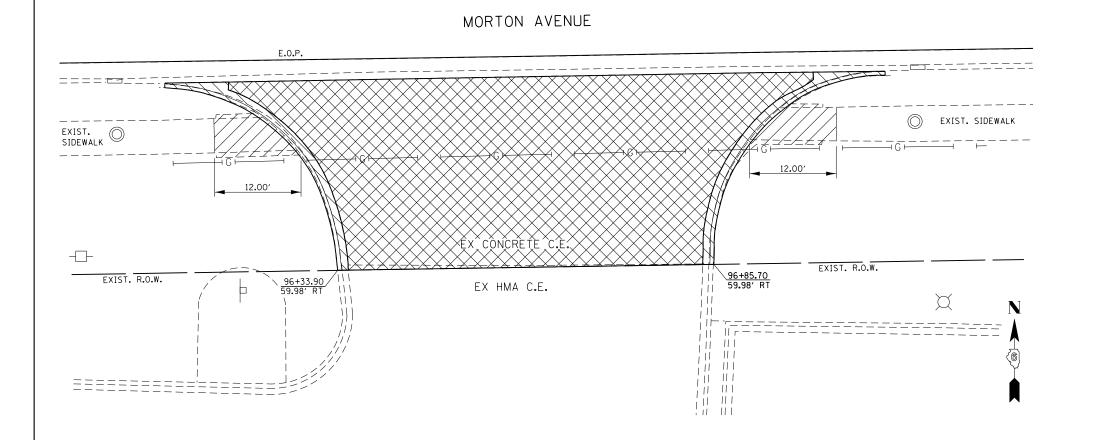

LEGEND

= DRIVEWAY PAVEMENT REMOVAL

= COMB. CONC. C&G REMOVAL

= SIDEWALK REMOVAL

NOTES:
SEE BELOW FOR PROPOSED CONSTRUCTION
LAYOUT AT THIS LOCATION.
ALL PROPOSED WORK ON THIS SHEET SHALL BE
PAYED FOR AS HSIP SAFETY FUNDING.

LIST OF MATERIALS

(HSIP ENTRANCE SAFETY FUNDING)

COMBINATION C&G REMOVAL = 82.9 FT


DRIVEWAY PAVEMENT REMOVAL = 172.7 SQ YD

LIST OF MATERIALS

(HSIP SIDEWALK SAFETY FUNDING)

SIDEWALK REMOVAL = 94.0 SQ FT

MORTON AVENUE

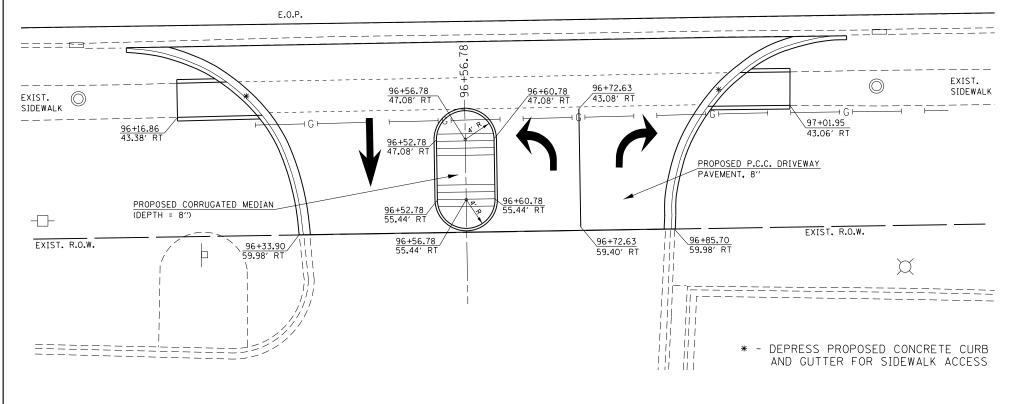


LIST OF MATERIALS (HSIP ENTRANCE SAFETY FUNDING)

COMBINATION CONC. C&C, TY. B 6.12 = 82.9 FT CORRUGATED MEDIAN (8" DEPTH) = 117.2 SQ FT PCC DRIVEWAY PAVEMENT, 8" = 159.7 SQ YD THERMOPLASTIC PAVEMENT MARKING - LINE 5" (MEDIAN BORDER, YELLOW) = 44.0 FT THERMOPLASTIC PAVEMENT MARKING - LINE 6" (LANE LINE, WHITE) = 16.4 FT PREFORMED PLASTIC PAVEMENT MARKING - L & S (DIRECTION ARROWS, WHITE) = 42.7 SQ FT


LIST OF MATERIALS (HSIP SIDEWALK SAFETY FUNDING)

PCC SIDEWALK, 4" = 98.0 SQ FT

FILE NAME =	USER NAME = Verenskifa	DESIGNED - RTS	REVISED -			ENTRANCE CLOSURES, R	ELOCATIONS	F.A.P. RTE.	SECTION	COUNTY TOTAL SHEET SHEETS NO.
pw:\\ILØ84EBIDINTEG.:ll:nois.gov:PWIDOT\Do	cuments\IDOT Offices\District 6\Projects\D67 CL2RAWND Data\EADsheR TS \I Entrances.dgn		REVISED - STATE OF ILLINOIS			DESIGN DETAILS (SOUTH SIDE)			••	MORGAN 366 132
	PLOT SCALE = 40.0000 ' / in.	CHECKED -	REVISED -	DEPARTMENT OF TRANSPORTATION	· · · · · · · · · · · · · · · · · · ·					CONTRACT NO. 72D21
Default	PLOT DATE = 1/28/2016	DATE - 2-18-2015	REVISED -		SCALE: SHEET 13 OF 23 SHEETS STA. TO STA.			ILLINOIS FED. AID PROJECT		

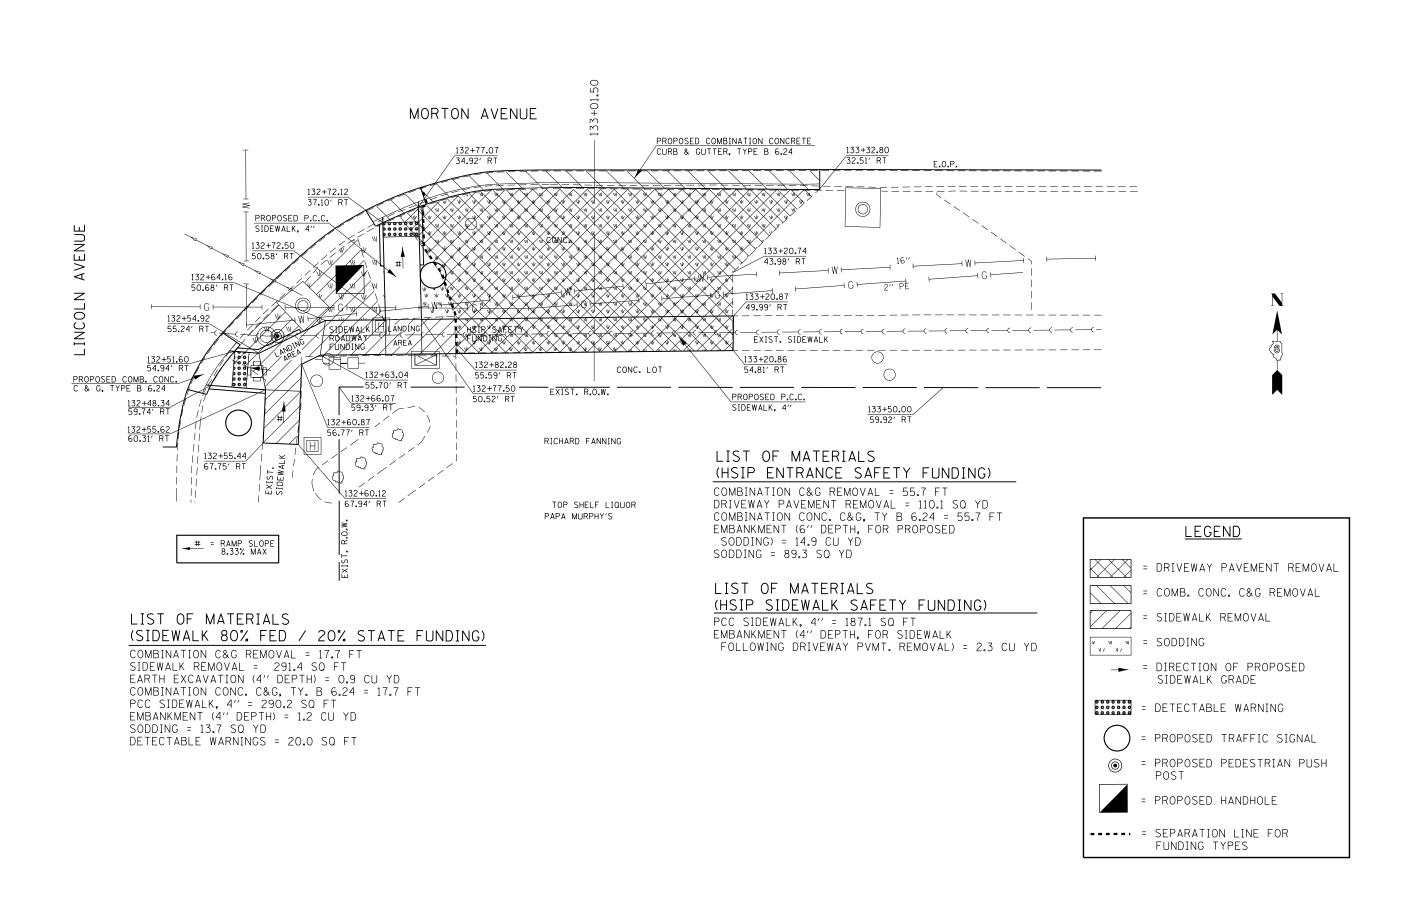

	FILE NAME =	USER NAME = Verenskifa	DESIGNED - RTS	REVISED -			ENTRANCE CLOSURES, RELOCATIONS	RTF SECTION	COUNTY SHEET NO.
	pw:\\IL084EBIDINTEG.:ll:no:s.gov:PWIDOT\Do	cuments\IDOT Offices\District 6\Projects\D672	□2RACWNData\GADsheR₹\$\1 Entrances.dgn	REVISED -	STATE OF ILLINOIS	· ·		• ••	MORGAN 366 133
		PLOT SCALE = 40.0000 ' / in.	CHECKED -	REVISED -	DEPARTMENT OF TRANSPORTATION		DESIGN DETAILS (SOUTH SIDE)	· ·	CONTRACT NO. 72D21
L	Default	PLOT DATE = 1/28/2016	DATE - 2-18-2015	REVISED -		SCALE: SHEET 14 OF 23 SHEETS STA. TO STA.		ILLINOIS FED.	AID PROJECT

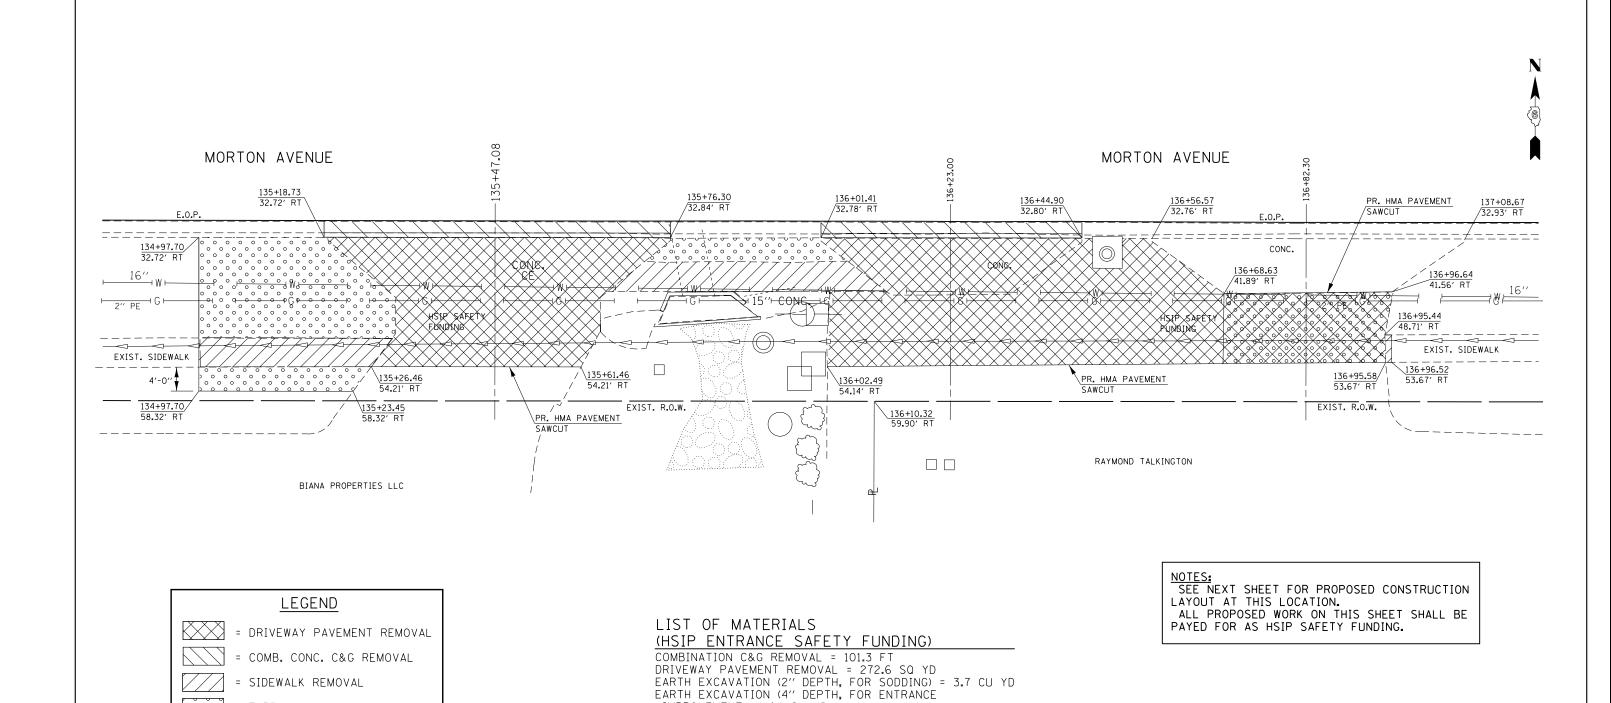

•-310A, 753 ••-23BR, RS6, TS-5; 33BR-1, RS4, TS-2

FILE NAME =	USER NAME = Verenskifa	DESIGNED - RTS	REVISED -			ENTRANCE CLOSURES, RELOCATIONS	F.A.P.	SECTION	COUNTY	TOTAL SHEET
pw:\\IL084EBIDINTEG.:111:nois.gov:PWIDOT\Documents\IDOT Offices\District 6\Projects\D67202RAWMData\GADsheRT\$:1 Entrances.dgn		REVISED -			·	•	••	MORGAN	366 134	
	PLOT SCALE = 40.0000 ' / in.	CHECKED -	REVISED -	DEPARTMENT OF TRANSPORTATION	DESIGN DETAILS (SOUTH SIDE)				CONTRACT	
Default	PLOT DATE = 1/28/2016	DATE - 2-18-2015	REVISED -		SCALE:	SHEET 15 OF 23 SHEETS STA. TO STA.		ILLINOIS FED. A	ID PROJECT	


IMPROVEMENT) = 4.1 CU YD

SIDEWALK REMOVAL = 347.8 SQ FT

(HSIP SIDEWALK SAFETY FUNDING)

LIST OF MATERIALS

= EARTH EXCAVATION

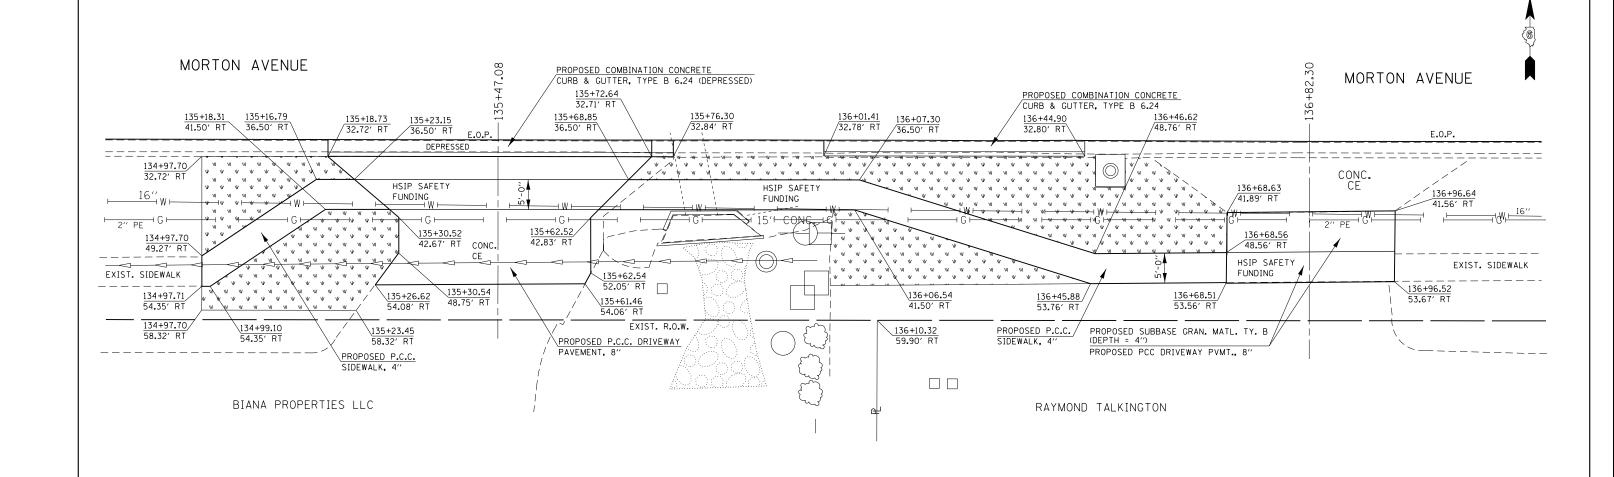

LEGEND

| | LEGEND | | SODDING

NOTES:
SEE PREVIOUS SHEET FOR PROPOSED REMOVAL LAYOUT AT THIS LOCATION.
ALL PROPOSED WORK ON THIS SHEET SHALL BE PAYED FOR AS HSIP SAFETY FUNDING.


LIST OF MATERIALS (HSIP ENTRANCE SAFETY FUNDING)


COMBINATION CONC. C&G, TY. B 6.24 = 101.3 FT PCC DRIVEWAY PAVEMENT, 8" = 125.8 SQ YD SUBBASE GRANULAR MATERIAL, TYPE B (4" DEPTH, FOR PROPOSED DRIVEWAY PAVEMENT) = 8.4 TONS SODDING = 186.8 SQ YD


LIST OF MATERIALS (HSIP SIDEWALK SAFETY FUNDING)


PCC SIDEWALK, 4" = 657.4 SQ FT EMBANKMENT (FOR PROPOSED SIDEWALK) = 6.0 CU YD


F	FILE NAME =	USER NAME = Verenskifa	DESIGNED - RTS	REVISED -		ENTRANCE CLOSURES, RELOCATIONS DESIGN DETAILS (SOUTH SIDE)		OCATIONS	F.A.P.	SECTION	COUNTY	TOTAL SHEET
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		PLOT SCALE = 40.0000 '/ in.	CHECKED -	REVISED -	DEPARTMENT OF TRANSPORTATION	DESIGN DETAILS (SOUTH SIDE)						T NO. 72D21
De	Default	PLOT DATE = 1/28/2016	DATE - 2-18-2015	REVISED -		SCALE:	SHEET 16 OF 23 SHEETS ST.	A. TO STA.		ILLINOIS FED.	. AID PROJECT	

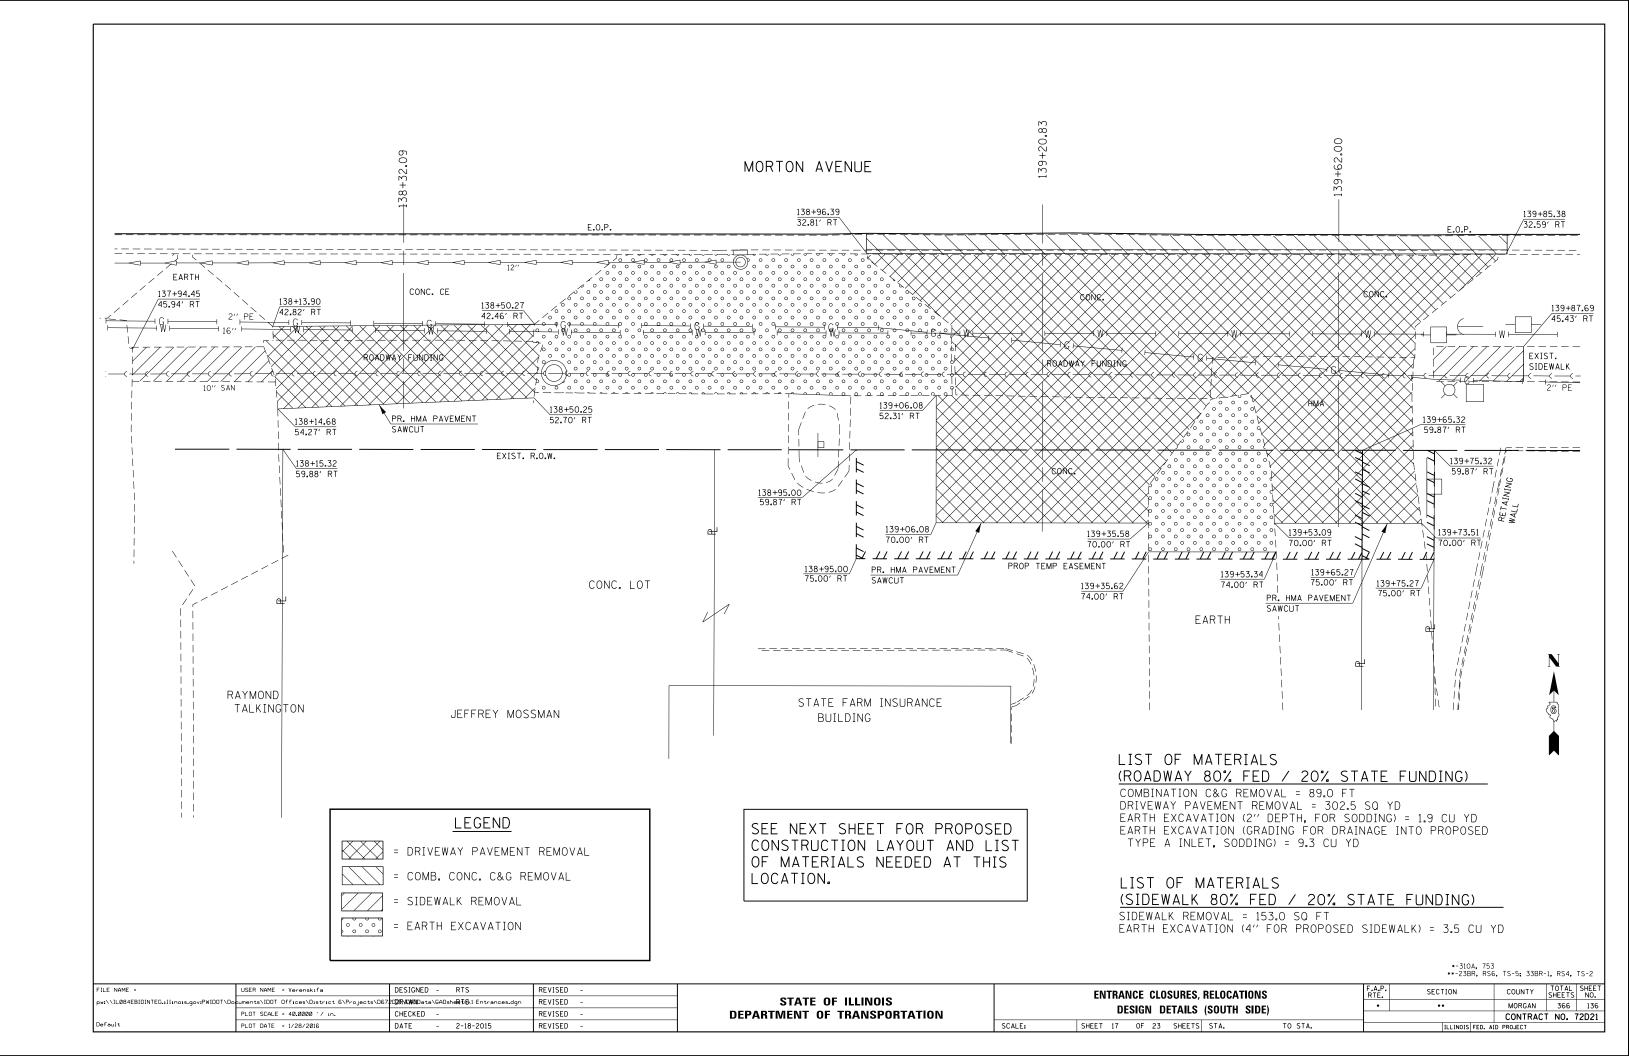

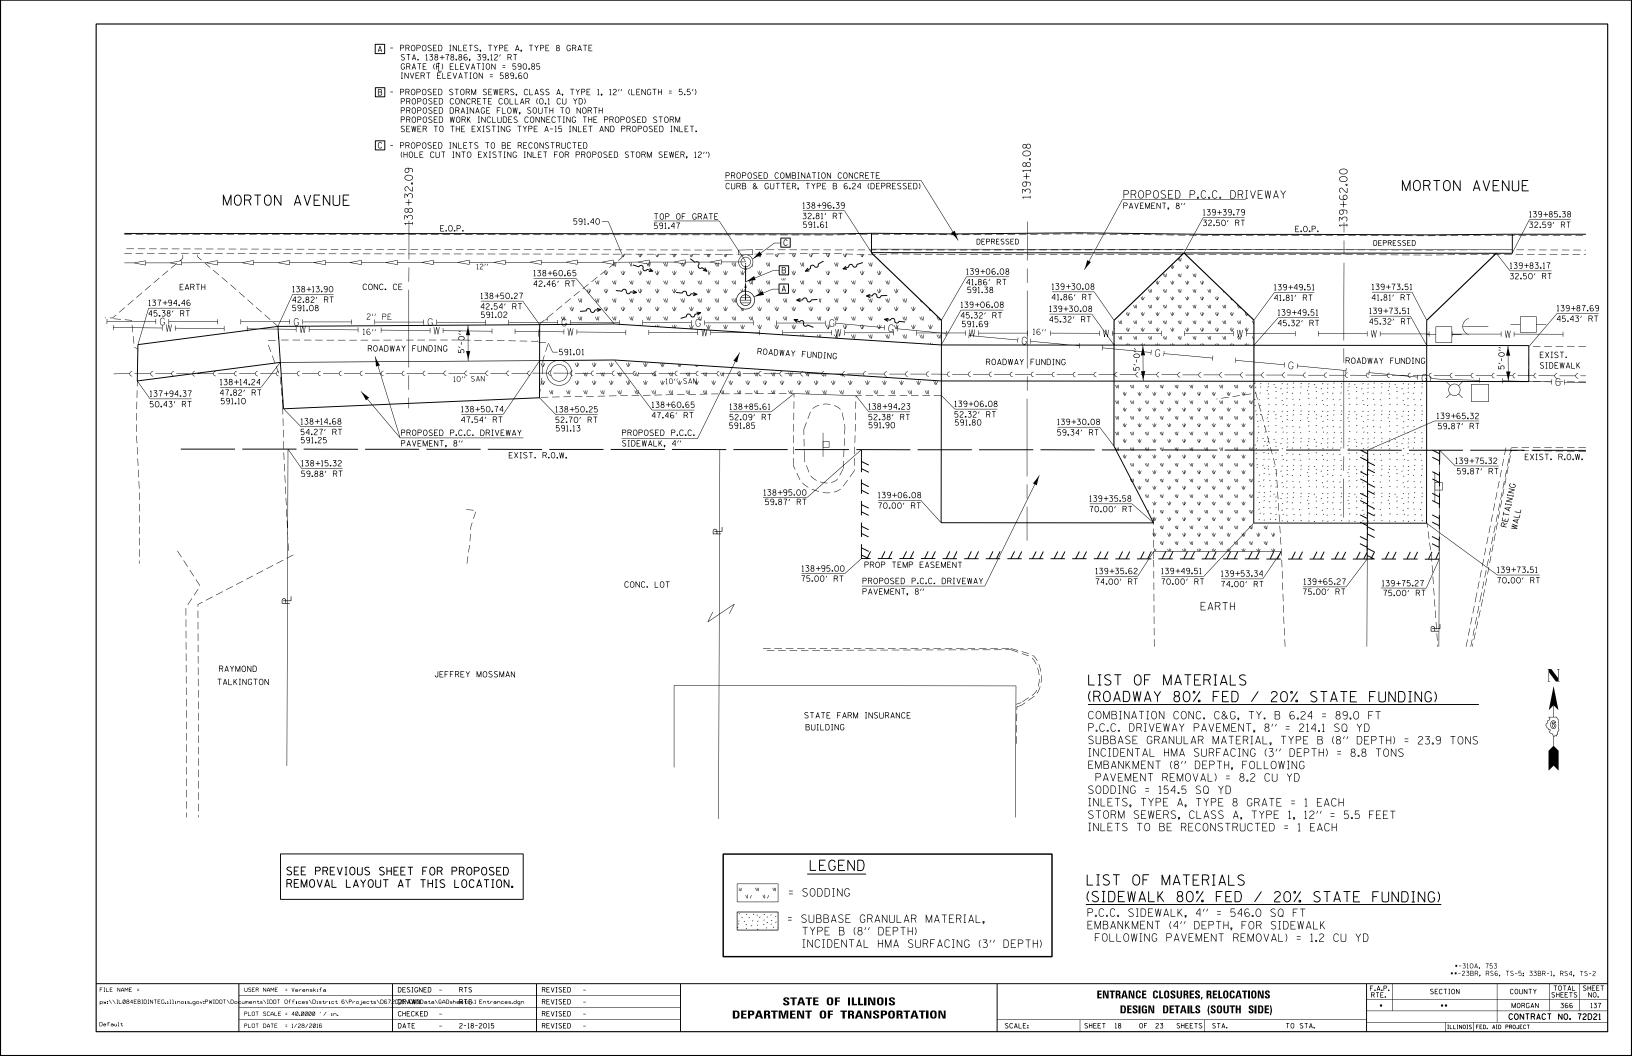

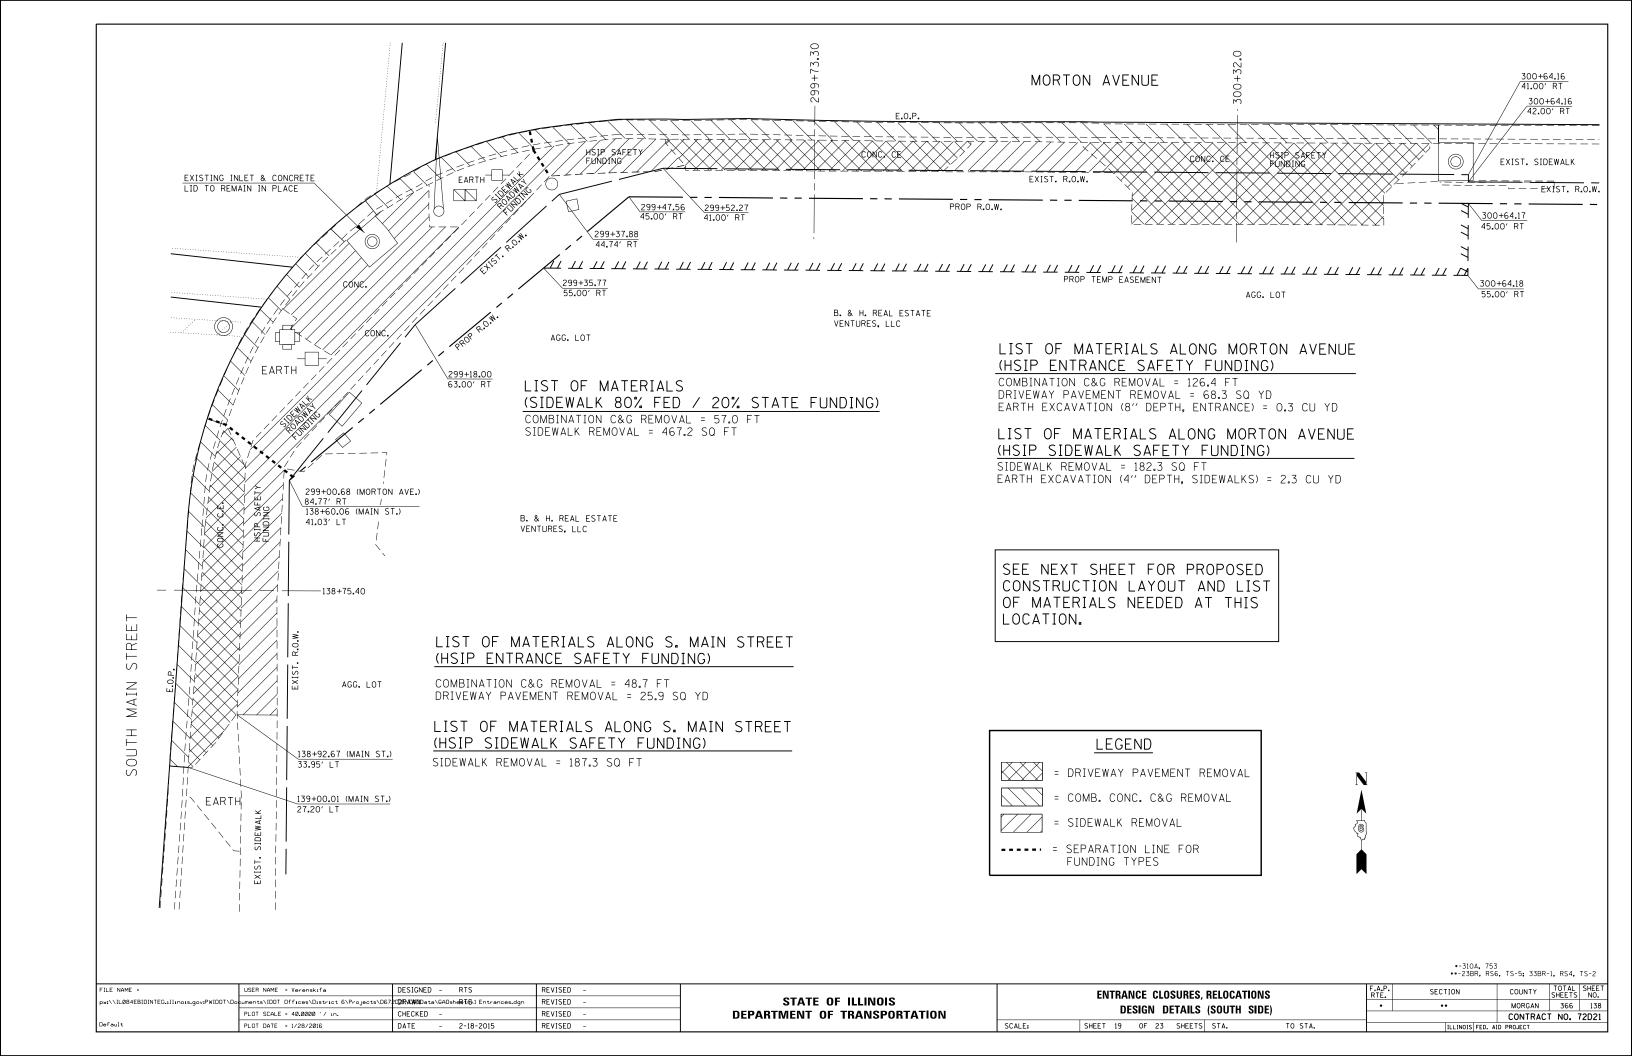


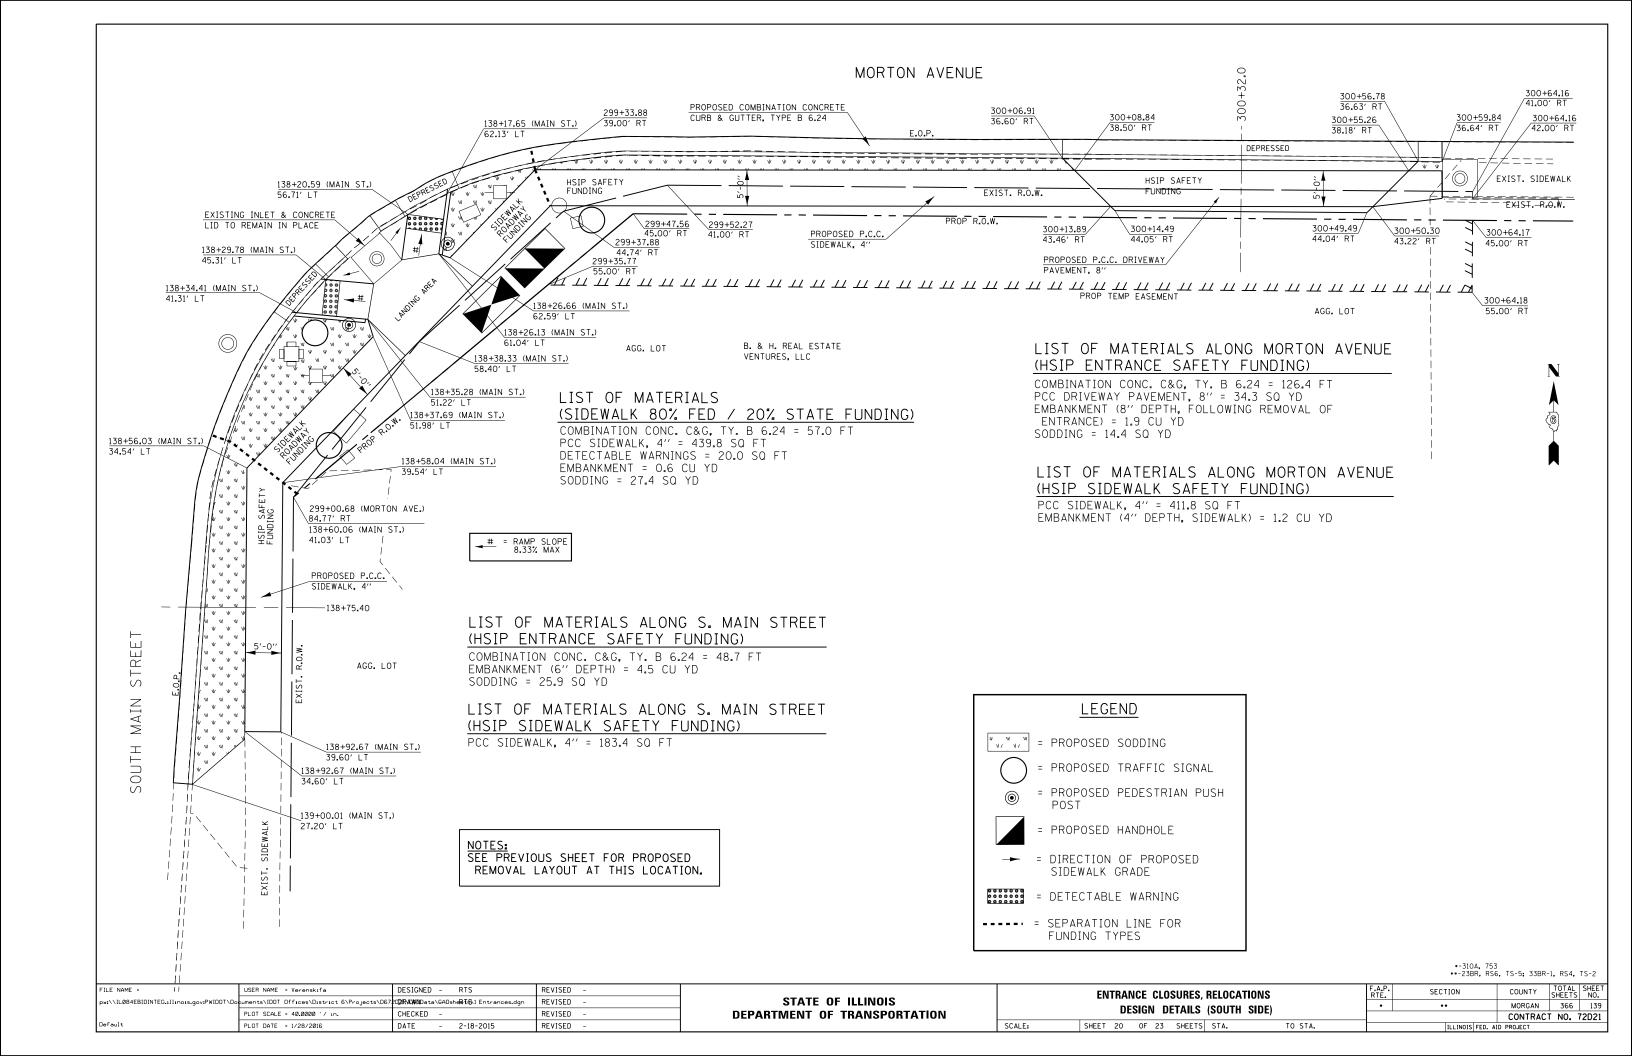

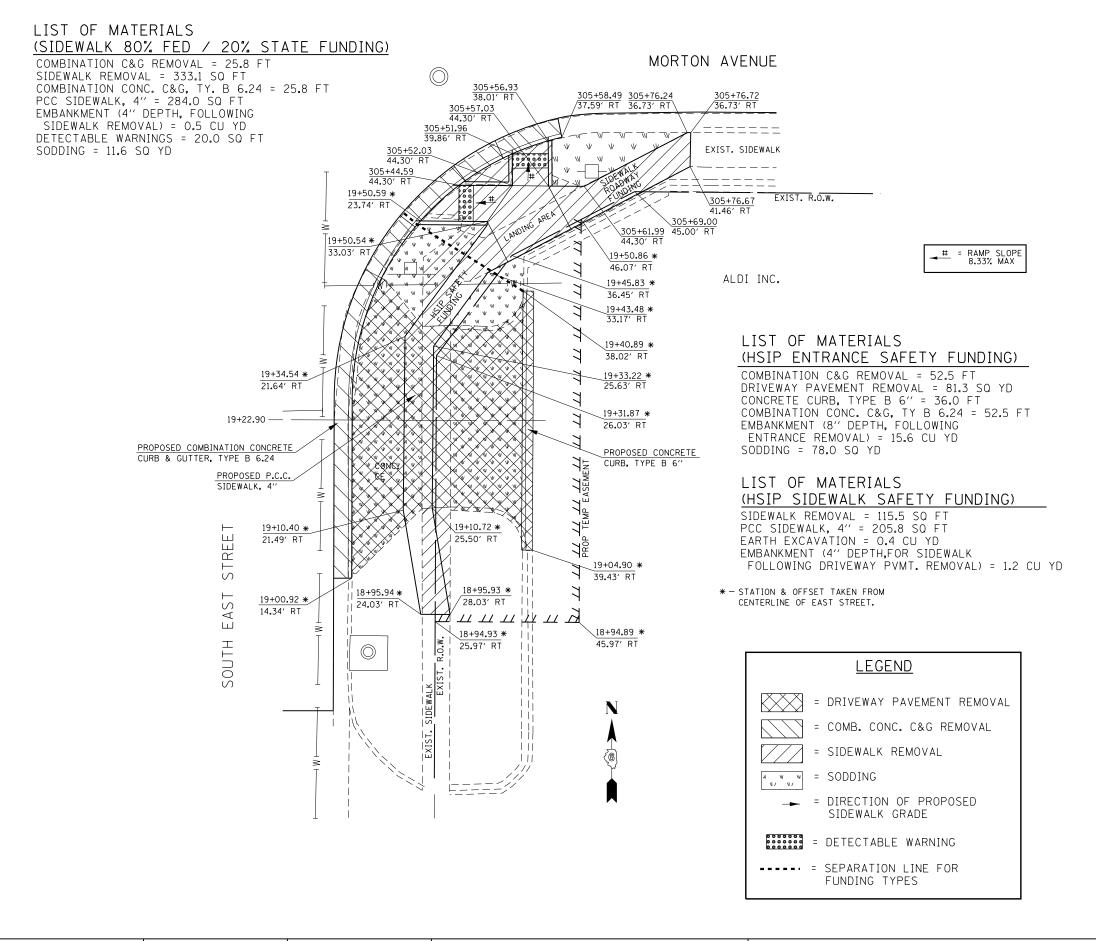

•-310A, 753 ••-23BR, RS6, TS-5; 33BR-1, RS4, TS-2

FILE NAME = USER NAME = Verenskife DESIGNED - RTS REVISED -	ENTRANCE CLOSURES, RELOCATIONS F.A.P. SECTION COUNTY SHEETS NO.
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PLOT SCALE = 40.0000 1/ In. CHECKED - REVISED - DEPARTMENT OF TRANSPORT.	ATION DESIGN DETAILS (SOUTH SIDE) CONTRACT NO. 72D21
Default PLOT DATE = 1/28/2016 DATE - 2-18-2015 REVISED -	SCALE: SHEET 21 OF 23 SHEETS STA. TO STA. ILLINOIS FED. AID PROJECT

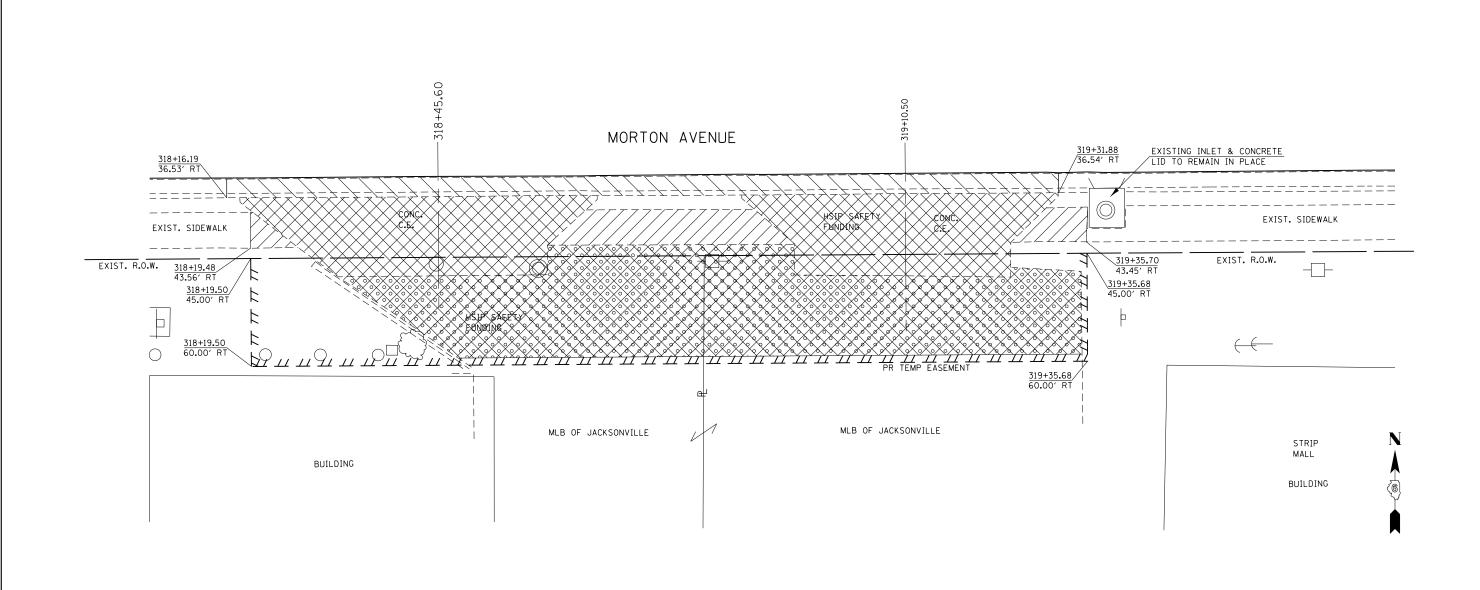

= DRIVEWAY PAVEMENT REMOVAL

= COMB. CONC. C&G REMOVAL

= SIDEWALK REMOVAL

= EARTH EXCAVATION (AVG. DEPTH = 4")

NOTES:
SEE NEXT SHEET FOR PROPOSED CONSTRUCTION LAYOUT AT THIS LOCATION.

ALL PROPOSED WORK ON THIS SHEET SHALL BE PAYED FOR AS HSIP SAFETY FUNDING.

LIST OF MATERIALS (HSIP ENTRANCE SAFETY FUNDING)


COMBINATION C&G REMOVAL = 115.6 FT DRIVEWAY PAVEMENT REMOVAL = 280.4 SQ YD
EARTH EXCAVATION (AVG. DEPTH = 4", FOLLOWING REMOVAL
OF EXIST. HMA PAVEMENT SURFACE) = 15.0 CU YD

LIST OF MATERIALS (HSIP SIDEWALK SAFETY FUNDING)

SIDEWALK REMOVAL = 199.7 SQ FT

•-310A, 753 •--23BR, RS6, TS-5; 33BR-1, RS4, TS-2

FILE NAME =	USER NAME = Verenskifa	DESIGNED - RTS	REVISED -			ENTRANCE CLOSURES, RELOCATIONS	F.A.P.	SECTION	COUNTY	TOTAL S SHEETS	HEET NO.
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	PLOT SCALE = 40.0000 ' / in.	CHECKED -	REVISED -	DEPARTMENT OF TRANSPORTATION		הבפומו הבואורפ (פחחנע פוהב)			CONTRAC	CT NO. 72	021
Default	PLOT DATE = 1/28/2016	DATE - 2-18-2015	REVISED -		SCALE:	SHEET 22 OF 23 SHEETS STA. TO STA.		ILLINOIS FED.	AID PROJECT		

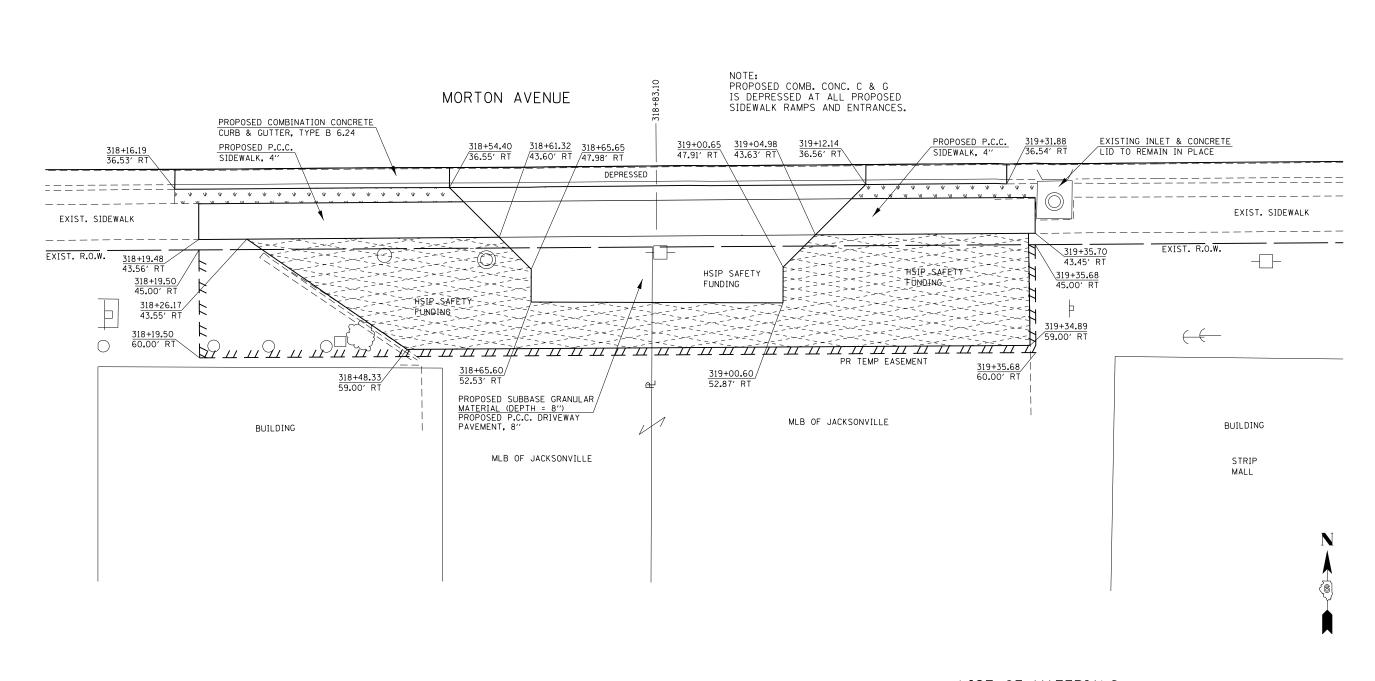

= SODDING

= SUBBASE GRANULAR MATERIAL, TYPE B (DEPTH 8") INCIDENTAL HMA SURFACING (3" DEPTH)

NOTES:
SEE PREVIOUS SHEET FOR PROPOSED REMOVAL LAYOUT AT THIS LOCATION.

ALL PROPOSED WORK ON THIS SHEET SHALL BE PAYED FOR AS HSIP SAFETY FUNDING.

LIST OF MATERIALS (HSIP ENTRANCE SAFETY FUNDING)


COMBINATION CONC. C&G, TY. B 6.24 = 115.6 FT P.C.C. DRIVEWAY PAVEMENT, 8" = 77.4 SQ YD
SUBBASE GRANULAR MATERIAL (DEPTH 8") = 59.3 TONS
INCIDENTAL HMA SURFACING (DEPTH 3") = 21.9 TONS SODDING = 14.1 SQ YD

LIST OF MATERIALS (HSIP SIDEWALK SAFETY FUNDING)

EMBANKMENT (4" DEPTH, FOLLOWING DRIVEWAY PAVEMENT REMOVAL) = 4.5 CU YD P.C.C. SIDEWALK, 4" = 334.8 SQ FT

•-310A, 753 ••-23BR, RS6, TS-5; 33BR-1, RS4, TS-2


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	PLOT SCALE = 40.0000 '/ in.	CHECKED -	REVISED -	DEPARTMENT OF TRANSPORTATION		DESIGN DETAILS (SOUTH SIDE)			CONTRACT	T NO. 72D21
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FILE NAME =	USER NAME = Verenskifa	DESIGNED - RTS	REVISED -			ENTRANCE CLOSURES, RELOCATIONS	F.A.P.	SECTION	COUNTY	TOTAL SHEET

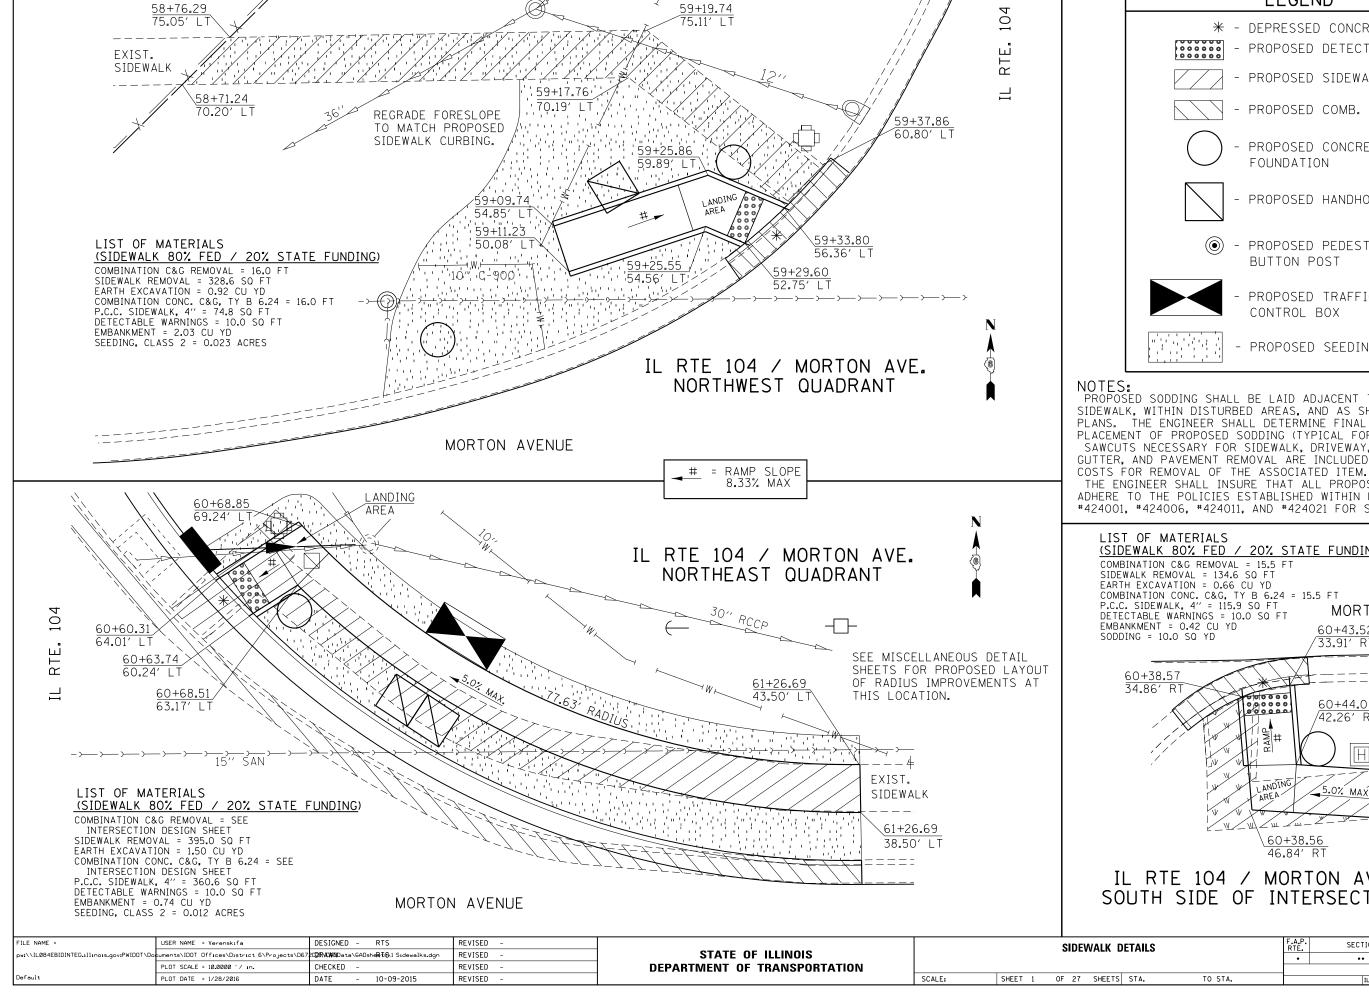

LEGEND * - DEPRESSED CONCRETE CURBING PROPOSED DETECTABLE WARNING PROPOSED SIDEWALK REMOVAL PROPOSED COMB. C&G REMOVAL PROPOSED CONCRETE SIGNAL PROPOSED HANDHOLE PROPOSED PEDESTRIAN PUSH PROPOSED TRAFFIC SIGNAL PROPOSED SEEDING, CLASS 2

NOTES:
PROPOSED SODDING SHALL BE LAID ADJACENT TO THE PROPOSED
AREAS. AND AS SHOWN IN THESE PLANS. THE ENGINEER SHALL DETERMINE FINAL LOCATIONS FOR THE PLACEMENT OF PROPOSED SODDING (TYPICAL FOR EACH LOCATION). SAWCUTS NECESSARY FOR SIDEWALK, DRIVEWAY, CONCRETE CURB & GUTTER, AND PAVEMENT REMOVAL ARE INCLUDED IN THE PAY ITEM


THE ENGINEER SHALL INSURE THAT ALL PROPOSED SIDEWALK WORK ADHERE TO THE POLICIES ESTABLISHED WITHIN HIGHWAY STANDARDS #424001, #424006, #424011, AND #424021 FOR SIDEWALK CONSTRUCTION

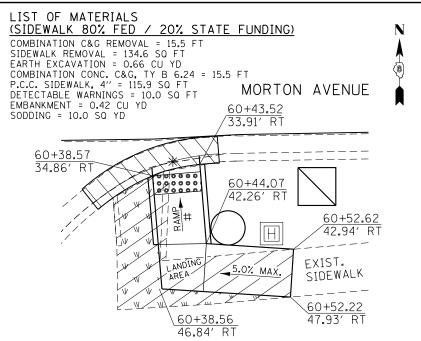

IL RTE 104 / MORTON AVE. SOUTH SIDE OF INTERSECTION

SCALE: 1'' = 10'-0''

COUNTY TOTAL SHEET SHEETS NO. SECTION MORGAN 366 143 CONTRACT NO. 72D21

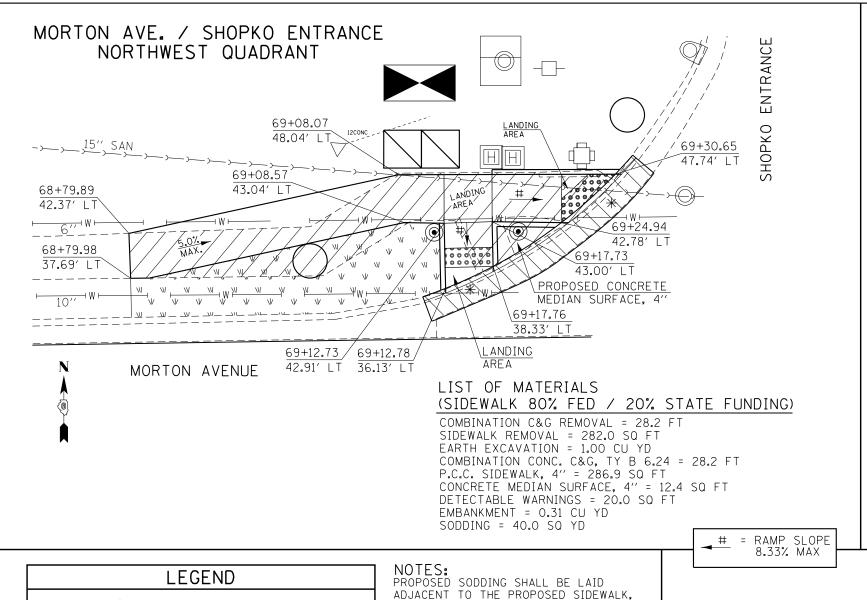

MORTON AVE. / SHOPKO ENTRANCE NORTHEAST QUADRANT

DNAMORTON AVENUE

T0+28.25

70+31.30

70+44.67

70+44.93

65.98' LT

70+42.21

61.83' LT

MORTON AVENUE

LIST OF MATERIALS (SIDEWALK 80% FED / 20% STATE FUNDING)

COMBINATION C&G REMOVAL = 14.6 FT SIDEWALK REMOVAL = 116.2 SQ FT EARTH EXCAVATION = 0.25 CU YD COMBINATION CONC. C&G, TY B 6.24 = 14.6 FT P.C.C. SIDEWALK, 4" = 117.2 SQ FT DETECTABLE WARNINGS = 10.0 SQ FT EMBANKMENT = 0.22 CU YD SODDING = 14.0 SQ YD

* - DEPRESSED CONCRETE CURBING

- PROPOSED SIDEWALK REMOVAL

PROPOSED DETECTABLE WARNING



- PROPOSED COMB. C&G REMOVAL



- PROPOSED CONCRETE SIGNAL FOUNDATION



- PROPOSED HANDHOLE



- PROPOSED PEDESTRIAN PUSH BUTTON POST



- PROPOSED TRAFFIC SIGNAL CONTROL BOX

- PROPOSED SODDING

PROPOSED SODDING SHALL BE LAID ADJACENT TO THE PROPOSED SIDEWALK, WITHIN DISTURBED AREAS, AND AS SHOWN IN THESE PLANS. THE ENGINEER SHALL DETERMINE FINAL LOCATIONS FOR THE PLACEMENT OF PROPOSED SODDING (TYPICAL FOR EACH LOCATION).

SAWCUTS NECESSARY FOR SIDEWALK, DRIVEWAY, CONCRETE CURB & GUTTER, AND PAVEMENT REMOVAL ARE INCLUDED IN THE PAY ITEM COSTS FOR REMOVAL OF THE ASSOCIATED ITEM.

THE ENGINEER SHALL INSURE THAT ALL PROPOSED SIDEWALK WORK ADHERE TO THE POLICIES ESTABLISHED WITHIN HIGHWAY STANDARDS #424001, #424006, #424011, AND #424021 FOR SIDEWALK CONSTRUCTION.

MORTON AVE. / WALMART ENTRANCE SOUTHEAST QUADRANT LIST OF MATERIALS (SIDEWALK 80% FED / 20% STATE FUNDING) COMBINATION C&G REMOVAL = 18.4 FT SIDEWALK REMOVAL = 116.7 SQ FT EXIST. EARTH EXCAVATION = 0.43 CU YD SIDEWALK 70+35.70 COMBINATION CONC. C&G, TY B 6.24 = 18.4 FT P.C.C. SIDEWALK. 4" = 121.8 SQ FT 46,60' RT DETECTABLE WARNINGS = 15.7 SQ FT EMBANKMENT = 0.26 CU YD 70+33.54 ENTRANC SODDING = 10.0 SQ YD 49.44' RT 47.49' RT 70+3<u>9.64</u> 70+20.22 49.59' RT 49.19' R WALMART 70+13.50 _ANDING 54.06' RT EXIST. R.O.W.

SCALE: 1" = 10'-0"

STATE OF ILLINOIS
DEPARTMENT OF TRANSPORTATION


SCALE:

						••- 23	BR, RS6, TS-5; 33	BR-1, RS	4, TS-2
	SIDI	EWALK [ETAILS		F.A.P. RTE.	SECTION	COUNTY	TOTAL SHEETS	SHEET NO.
					•	••	MORGAN	366	144
							CONTRAC	T NO.	72D21
SHEET 2	OF 27	SHEETS	STA.	TO STA.		ILLINOIS FED	. AID PROJECT		

59.99' RT

MORTON AVENUE

•- 310A, 753

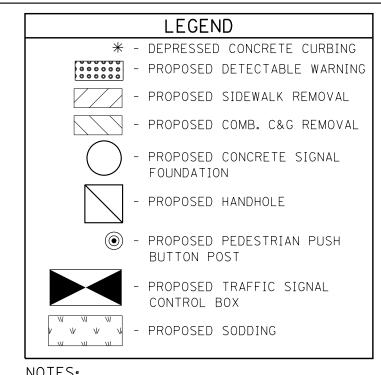



NOTES:

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PROPOSED SODDING SHALL BE LAID ADJACENT TO THE PROPOSED SIDEWALK, WITHIN DISTURBED AREAS, AND AS SHOWN IN THESE PLANS. THE ENGINEER SHALL DETERMINE FINAL LOCATIONS FOR THE PLACEMENT OF PROPOSED SODDING (TYPICAL FOR EACH LOCATION). SAWCUTS NECESSARY FOR SIDEWALK, DRIVEWAY, CONCRETE CURB & GUTTER, AND PAVEMENT REMOVAL ARE INCLUDED IN THE PAY ITEM COSTS FOR REMOVAL OF THE ASSOCIATED ITEM. THE ENGINEER SHALL INSURE THAT ALL PROPOSED SIDEWALK WORK

ADHERE TO THE POLICIES ESTABLISHED WITHIN HIGHWAY STANDARDS #424001, #424006, #424011, AND #424021 FOR SIDEWALK CONSTRUCTION.



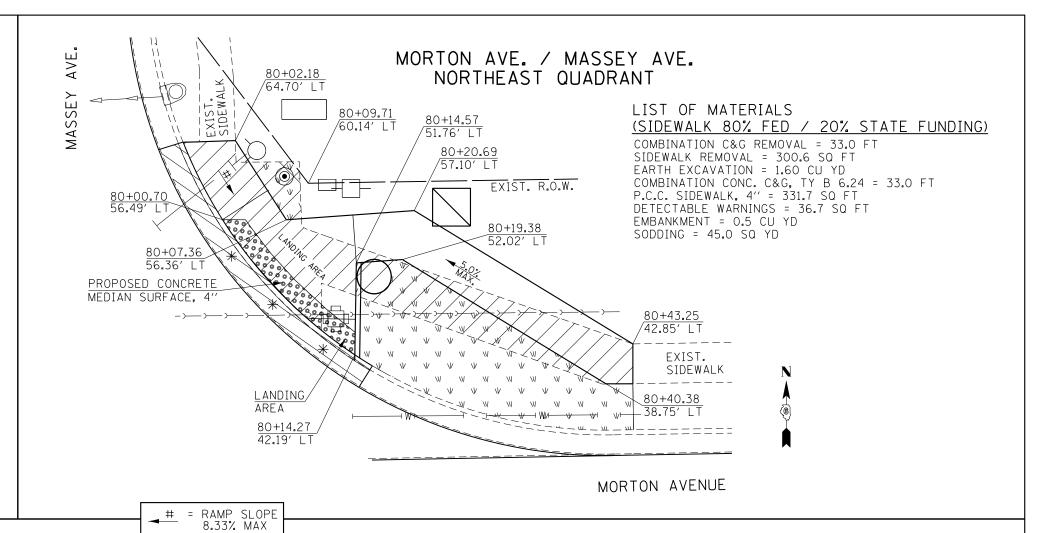
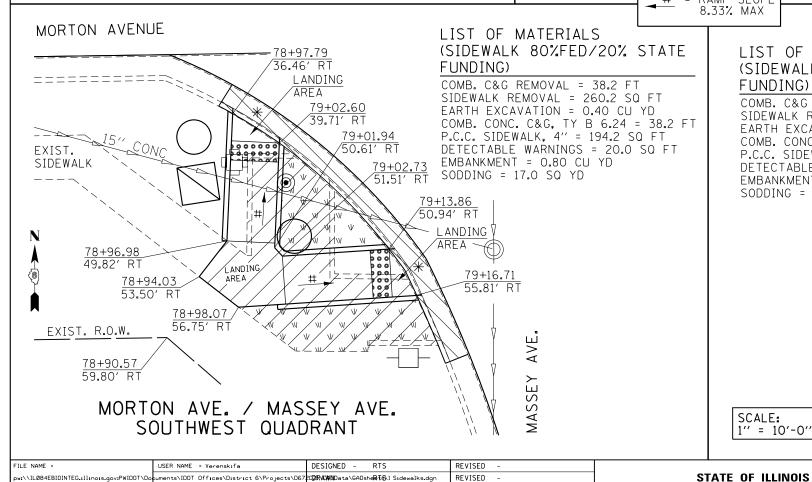
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DEPARTMENT OF TRANSPORTATION

SCALE:


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CHECKED

DATE

LOT SCALE = 10.0000 '/ in.

PLOT DATE = 1/28/2016

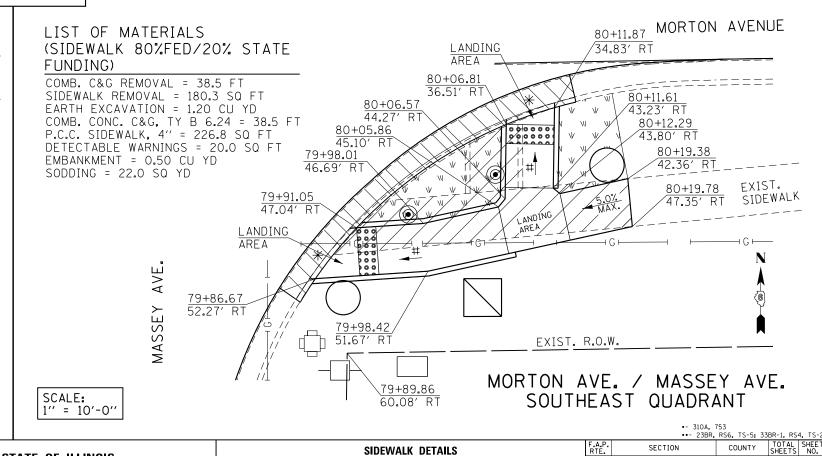


SHEET 3 OF 27 SHEETS STA.

TO STA.

MORGAN 366 145

CONTRACT NO. 72D21

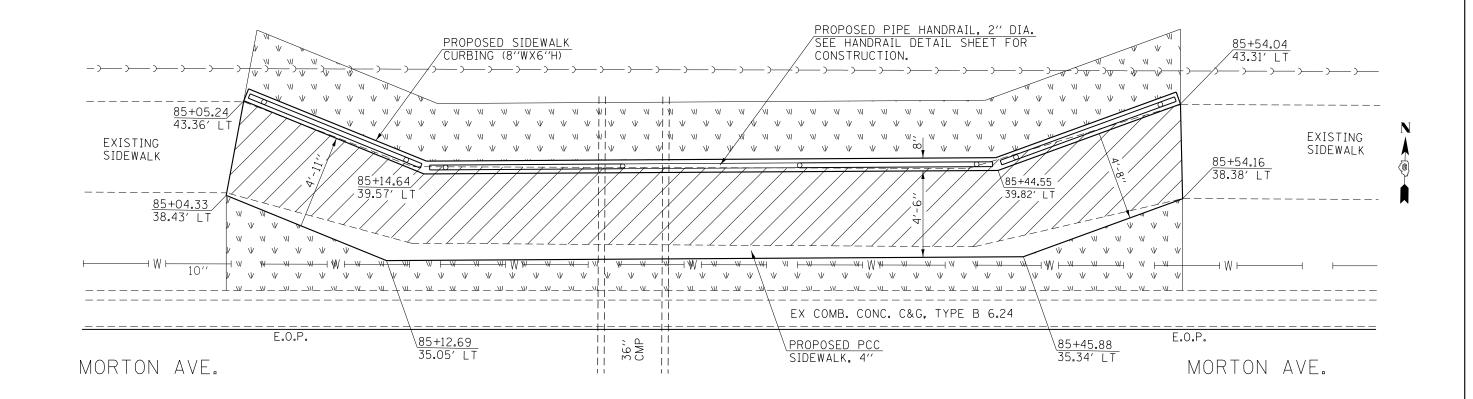

NOTES:

PROPOSED SEEDING, CLASS 2 SHALL BE LAID ADJACENT TO THE PROPOSED SIDEWALK, WITHIN DISTURBED AREAS, AND AS SHOWN IN THESE PLANS. THE ENGINEER SHALL DETERMINE FINAL LOCATIONS FOR THE PLACEMENT OF PROPOSED SEEDING. SAWCUTS NECESSARY FOR SIDEWALK REMOVAL ARE INCLUDED IN

THE PAY ITEM COSTS FOR SIDEWALK REMOVAL. SIDEWALK CURBING (8"Wx6"H) & (6"Wx6"H) ARE INCLUDED IN THE COSTS FOR PCC SIDEWALK, 4"".

LIST OF MATERIALS (SIDEWALK 80% FED / 20% STATE FUNDING)

SIDEWALK REMOVAL = 209.0 SQ FT EARTH EXCAVATION = 0.70 CU YD P.C.C. SIDEWALK, 4" = 266.6 SQ FT SODDING = 29.0 SQ YD

LEGEND

PROPOSED CONCRETE SIDEWALK REMOVAL

= PROPOSED SODDING


• = PROPOSED HANDRAIL POST


MORTON AVE., STATION 85+04.33 TO STATION 85+54.16 SIDEWALK ALONG NORTH SIDE OF MORTON AVE.

SCALE: 1'' = 5'-0''

-- 310A, 753 --- 23BR, RS6, TS-5; 33BR-1, RS4, TS-2 -- 310A, 753 -- 33BR-1, RS6, TS-5;

									••- 23BR	RS6, TS-5; 33	3BR-1, RS4,	, TS-2
FILE NAME =	USER NAME = Verenskifa	DESIGNED - RTS	REVISED -			SIDEWALK DETAILS		F.A.P.	SECTION	COUNTY	TOTAL S	SHEET
pw:\\ILØ84EBIDINTEG.:ll:no:s.gov:PWIDOT\Do	cuments\IDOT Offices\District 6\Projects\D67	720 2RAXWIN Data\GADshe R TS\1 Sidewalks.dgn	REVISED -	STATE OF ILLINOIS		SIDEWALK DETAILS		•	••	MORGAN	366	146
	PLOT SCALE = 10.0000 '/ in.	CHECKED -	REVISED -	DEPARTMENT OF TRANSPORTATION						CONTRAC	T NO. 77	2D21
Default	PLOT DATE = 1/28/2016	DATE - 10-09-2015	REVISED -		SCALE:	SHEFT 4 OF 27 SHEFTS STA.	TO STA.		TILINOIS EED A	ID PROJECT		-

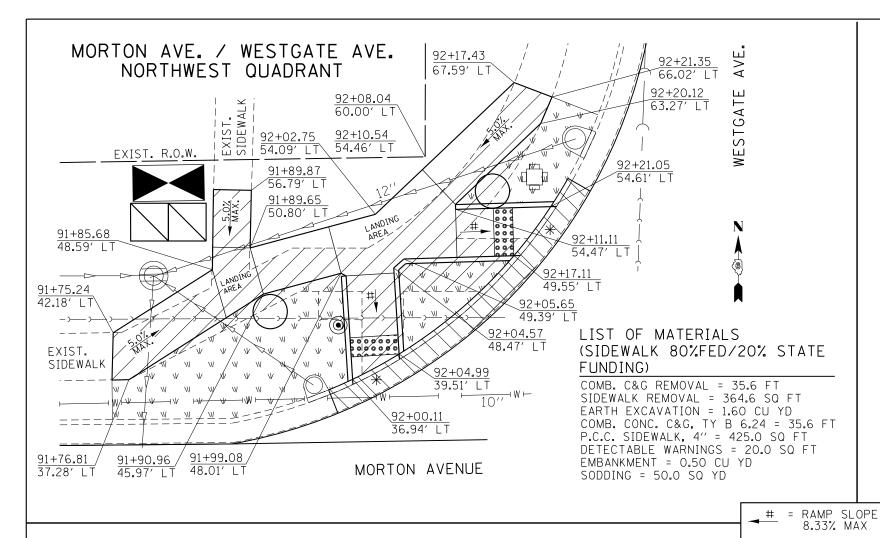

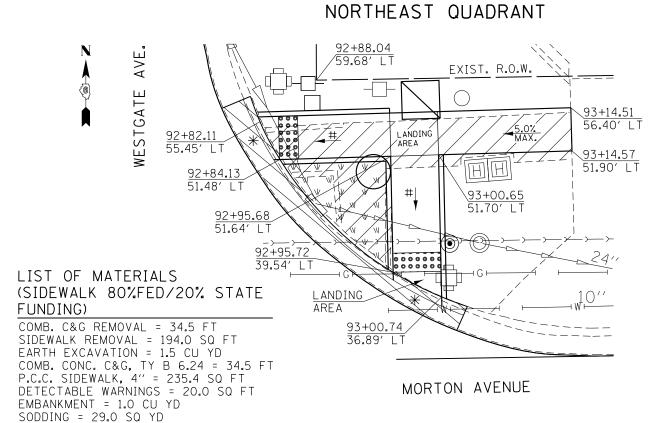


MORTON AVE. / WESTGATE AVE.

COUNTY TOTAL SHEET NO.

MORGAN 366 147

CONTRACT NO. 72D21

SECTION

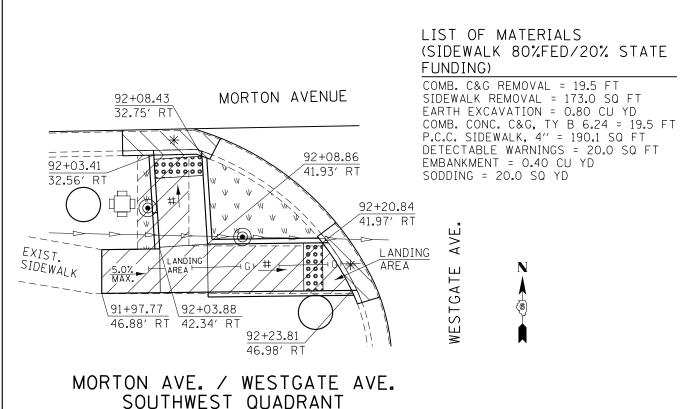

DESIGNED - RTS

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DATE

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USER NAME = Verenskifa

PLOT DATE = 1/28/2016

PLOT SCALE = 10.0000 '/ in.

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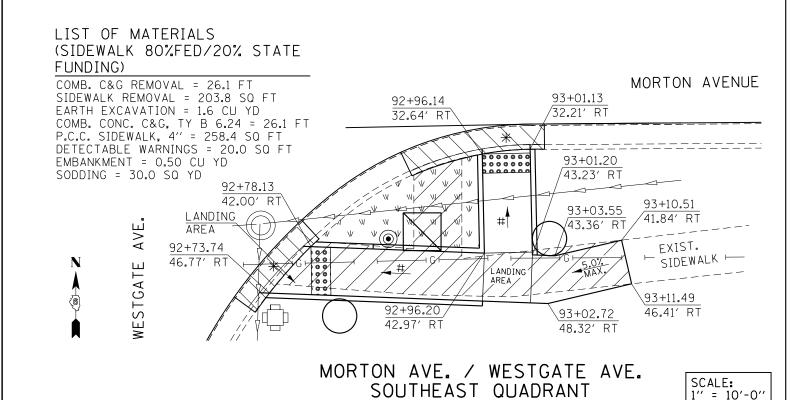
REVISED

STATE OF ILLINOIS

DEPARTMENT OF TRANSPORTATION

FILE NAME

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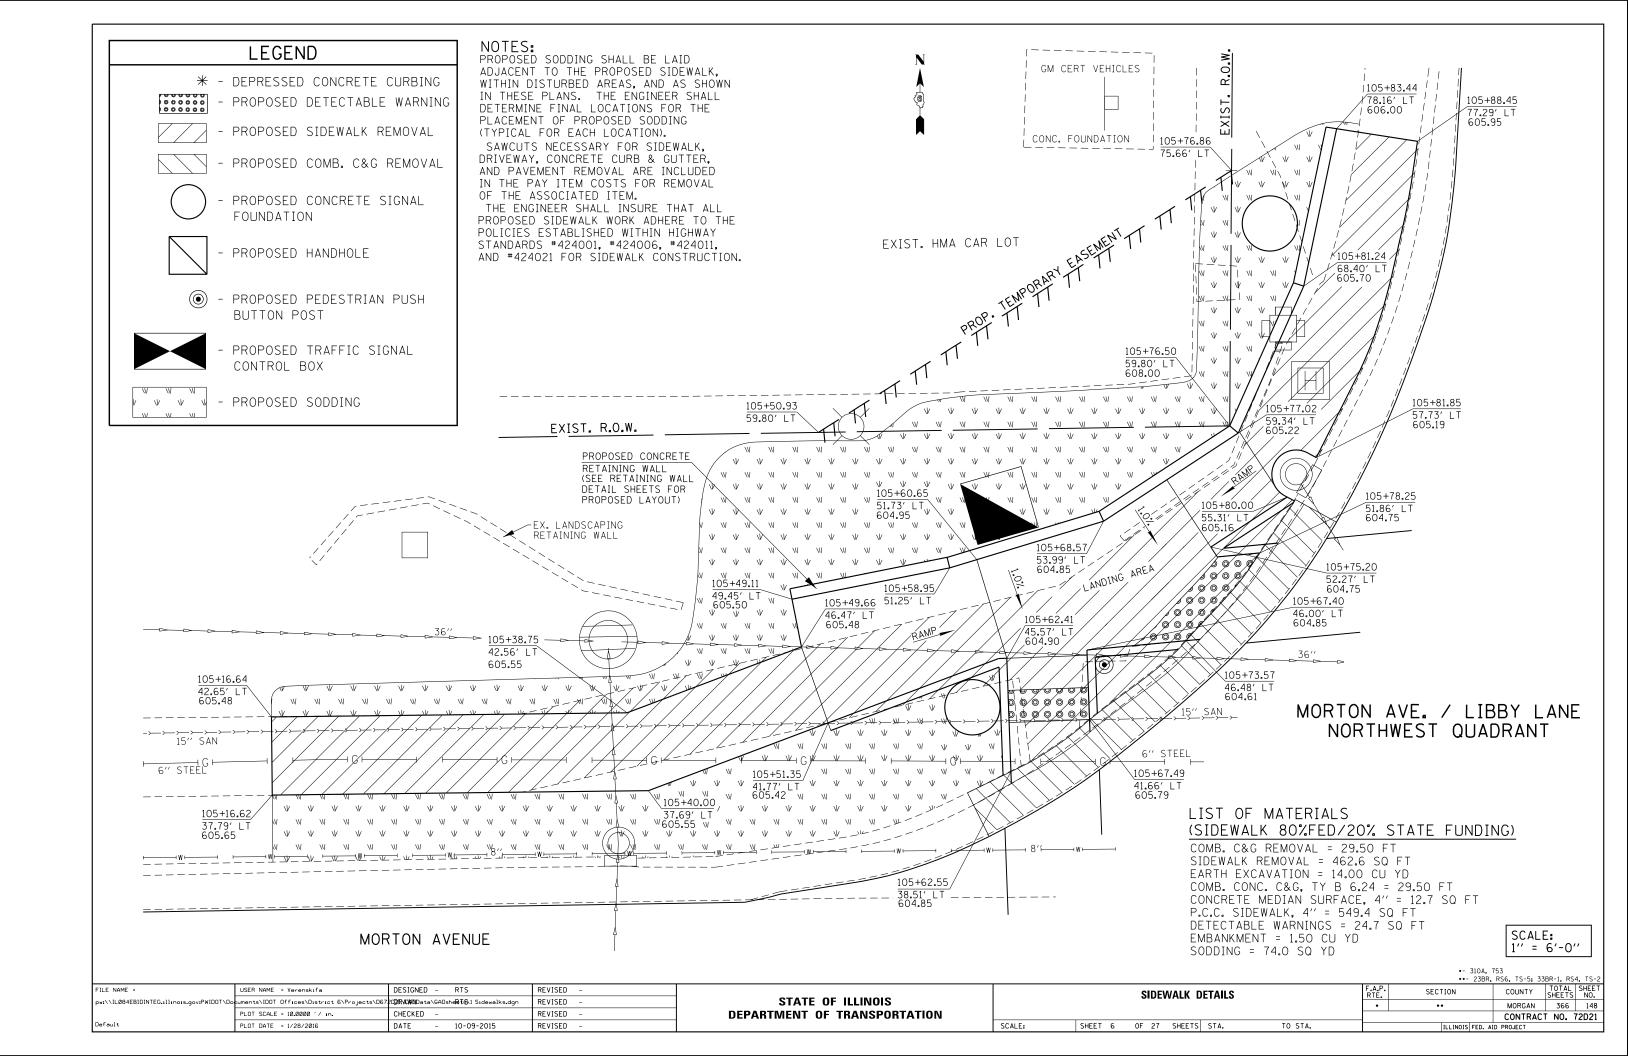



SIDEWALK DETAILS

TO STA.

SHEET 5 OF 27 SHEETS STA.

SCALE:



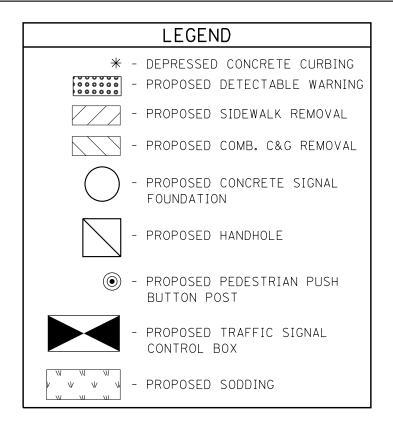


NOTES:


PLOT SCALE = 10.0000 '/ in.

PLOT DATE = 1/28/2016

PROPOSED SODDING SHALL BE LAID ADJACENT TO THE PROPOSED SIDEWALK, WITHIN DISTURBED AREAS, AND AS SHOWN IN THESE PLANS. THE ENGINEER SHALL DETERMINE FINAL LOCATIONS FOR THE PLACEMENT OF PROPOSED SODDING (TYPICAL FOR EACH LOCATION). SAWCUTS NECESSARY FOR SIDEWALK, DRIVEWAY, CONCRETE CURB & GUTTER, AND PAVEMENT REMOVAL ARE INCLUDED IN THE PAY ITEM COSTS FOR REMOVAL OF THE ASSOCIATED ITEM.

THE ENGINEER SHALL INSURE THAT ALL PROPOSED SIDEWALK WORK ADHERE TO THE POLICIES ESTABLISHED WITHIN HIGHWAY STANDARDS #424001, #424006, #424011, AND #424021 FOR SIDEWALK CONSTRUCTION.

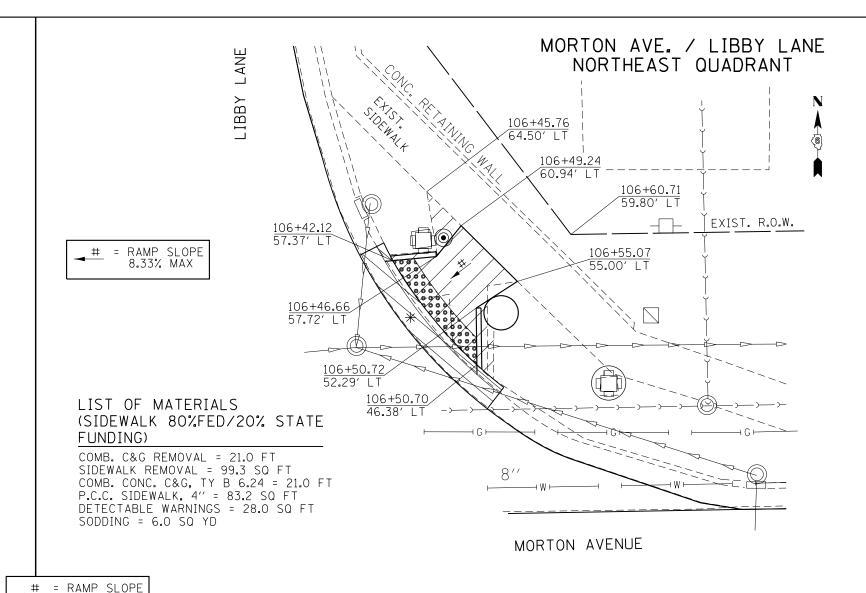

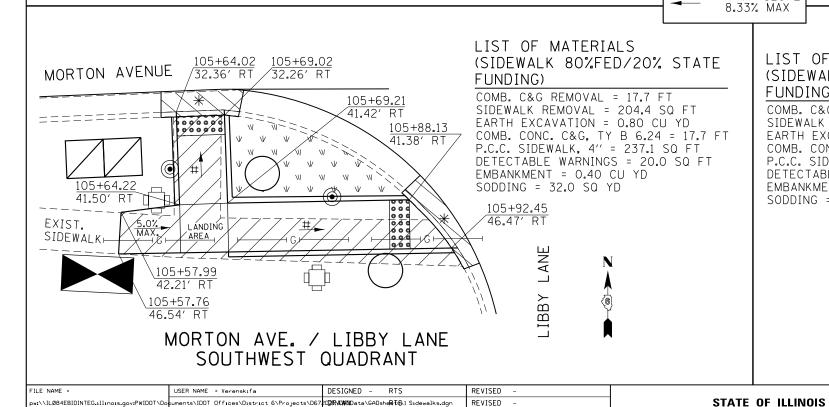

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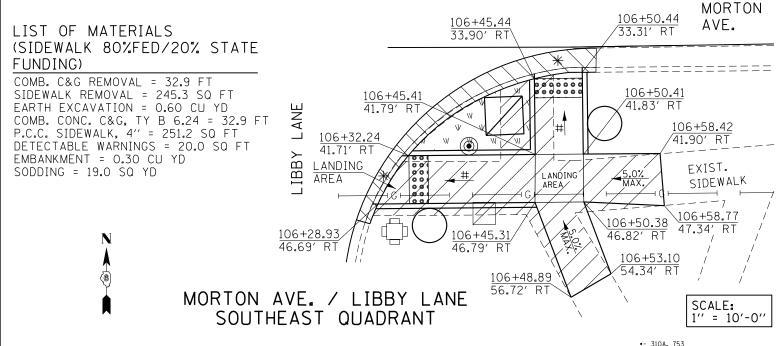
10-09-2015

DATE

REVISED

REVISED

DEPARTMENT OF TRANSPORTATION



SIDEWALK DETAILS

TO STA.

SHEET 7 OF 27 SHEETS STA.


SCALE:

COUNTY TOTAL SHEET NO.

MORGAN 366 149

CONTRACT NO. 72D21

SECTION

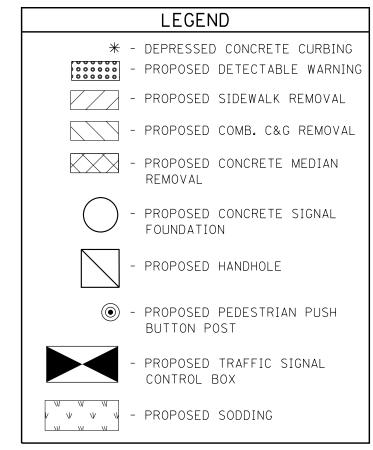


NOTEC.

PROPOSED SODDING SHALL BE LAID ADJACENT TO THE PROPOSED SIDEWALK, WITHIN DISTURBED AREAS, AND AS SHOWN IN THESE PLANS. THE ENGINEER SHALL DETERMINE FINAL LOCATIONS FOR THE PLACEMENT OF PROPOSED SODDING (TYPICAL FOR EACH LOCATION). SAWCUTS NECESSARY FOR SIDEWALK, DRIVEWAY, CONCRETE CURB & GUTTER, AND PAVEMENT REMOVAL ARE INCLUDED IN THE PAY ITEM COSTS FOR REMOVAL OF THE ASSOCIATED ITEM.

THE ENGINEER SHALL INSURE THAT ALL PROPOSED SIDEWALK WORK ADHERE TO THE POLICIES ESTABLISHED WITHIN HIGHWAY STANDARDS #424001, #424006, #424011, AND #424021 FOR SIDEWALK CONSTRUCTION.


LIST OF MATERIALS (SIDEWALK 80% FED / 20% STATE FUNDING)

COMBINATION C&G REMOVAL = 12.6 FT SIDEWALK REMOVAL = 94.4 SQ FT EARTH EXCAVATION = 0.40 CU YD COMBINATION CONC. C&G, TY B 6.24 = 12.6 FT P.C.C. SIDEWALK, 4" = 111.6 SQ FT DETECTABLE WARNINGS = 10.0 SQ FT EMBANKMENT = 0.20 CU YD SODDING = 9.0 SQ YD

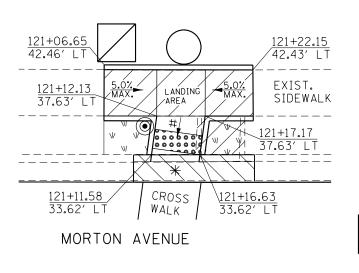

LIST OF MATERIALS (SIDEWALK 80% FED / 20% STATE FUNDING)

COMBINATION C&G REMOVAL = 13.1 FT
SIDEWALK REMOVAL = 97.9 SQ FT
EARTH EXCAVATION = 0.40 CU YD
COMBINATION CONC. C&G, TY B 6.24 = 13.1 FT
P.C.C. SIDEWALK, 4" = 115.4 SQ FT
DETECTABLE WARNINGS = 10.0 SQ FT
EMBANKMENT = 0.20 CU YD
SODDING = 9.0 SQ YD

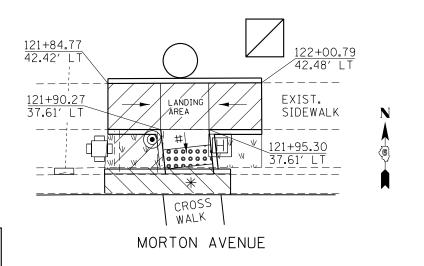

HOME DEPOT / COUNTY MARKET ENTRANCE NORTH SIDE OF INTERSECTION

= RAMP SLOPE 8.33% MAX

									•- 310A, ••- 23BR	. 753 R. RS6, TS-5; 33BR-1	1, RS4, TS-2
F	LE NAME =	USER NAME = Verenskifa	DESIGNED - RTS	REVISED -			SIDEWALK DETAILS	F.A.P.	SECTION	COUNTY TO	OTAL SHEET
P	:\\ILØ84EBIDINTEG.:ll:no:s.gov:PWIDOT\Do	cuments\IDOT Offices\District 6\Projects\D67	720 2RAWN Data\GADshe R T&1 Sidewalks.dgn	REVISED -	STATE OF ILLINOIS		SIDEWALK DETAILS		••	MORGAN 3	366 150
		PLOT SCALE = 10.0000 '/ in.	CHECKED -	REVISED -	DEPARTMENT OF TRANSPORTATION			· ·		CONTRACT N	NO. 72D21
D.	efault	PLOT DATE = 1/28/2016	DATE - 10-09-2015	REVISED -		SCALE:	SHEET 8 OF 27 SHEETS STA. TO STA.		ILLINOIS FED.	AID PROJECT	

PROPOSED DETECTABLE WARNING

* - DEPRESSED CONCRETE CURBING

PROPOSED SIDEWALK REMOVAL



PROPOSED COMB. C&G REMOVAL



PROPOSED CONCRETE MEDIAN SURFACE REMOVAL



PROPOSED CONCRETE SIGNAL FOUNDATION



PROPOSED HANDHOLE



(PROPOSED PEDESTRIAN PUSH BUTTON POST



PROPOSED TRAFFIC SIGNAL CONTROL BOX



PROPOSED SODDING

NOTES:

PROPOSED SODDING SHALL BE LAID ADJACENT TO THE PROPOSED SIDEWALK, WITHIN DISTURBED AREAS, AND AS SHOWN IN THESE PLANS. THE ENGINEER SHALL DETERMINE FINAL LOCATIONS FOR THE PLACEMENT OF PROPOSED SODDING (TYPICAL FOR EACH LOCATION). SAWCUTS NECESSARY FOR SIDEWALK, DRIVEWAY, CONCRETE CURB & GUTTER, AND PAVEMENT REMOVAL ARE INCLUDED IN THE PAY ITEM COSTS FOR REMOVAL OF THE ASSOCIATED ITEM.

THE ENGINEER SHALL INSURE THAT ALL PROPOSED SIDEWALK WORK ADHERE TO THE POLICIES ESTABLISHED WITHIN HIGHWAY STANDARDS #424001, #424006, #424011, AND #424021 FOR SIDEWALK CONSTRUCTION.


LIST OF MATERIALS

= RAMP SLOPE 8.33% MAX

LIST OF MATERIALS (SIDEWALK 80%FED/20% STATE FUNDING)

COMB. C&G REMOVAL = 25.4 FT SIDEWALK REMOVAL = 156.3 SQ FT EARTH EXCAVATION = 0.45 CU YD COMB. CONC. C&G, TY B 6.24 = 25.4 FT CONC. MEDIAN SURFACE, 4" = 11.0 SQ FT P.C.C. SIDEWALK, 4'' = 165.2 SQ FT DETECTABLE WARNINGS = 20.0 SQ FT EMBANKMENT = 0.10 CU YD SODDING = 20.0 SQ YD


MORTON AVENUE (RIGHT TURN LANE)

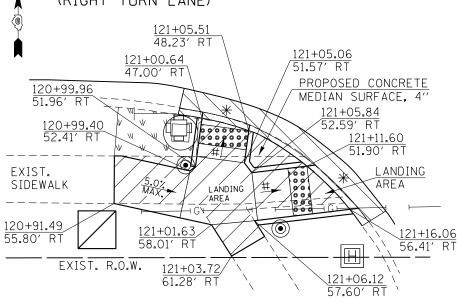

HOME DEPOT / COUNTY MARKET ENTRANCE SOUTHWEST QUADRANT


LIST OF MATERIALS (ROADWAY 80%FED/20% STATE FUNDING)

CONCRETE MEDIAN SURFACE REMOVAL = 93.6 SQ FT SUBBASE GRANULAR MATERIAL, TYPE B, 4" = 1.3 TONS PCC BASE COURSE 10" = 5.6 SQ YD CONCRETE MEDIAN, TYPE SM 6.06 = 43.6 SQ FT

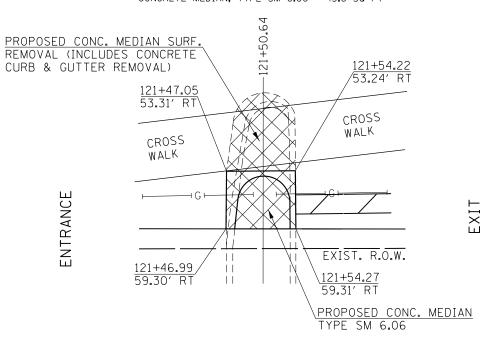

SCALE: 1" = 10'-0"

(SIDEWALK 80%FED/20% STATE FUNDING) COMB. C&G REMOVAL = 33.9 FT SIDEWALK REMOVAL = 168.5 SQ FT EARTH EXCAVATION = 1.00 CU YD COMB. CONC. C&G, TY B 6.24 = 33.9 FT P.C.C. SIDEWALK, 4" = 206.9 SQ FT DETECTABLE WARNINGS = 20.0 SQ FT EMBANKMENT = 0.50 CU YD SODDING = 18.0 SQ YD

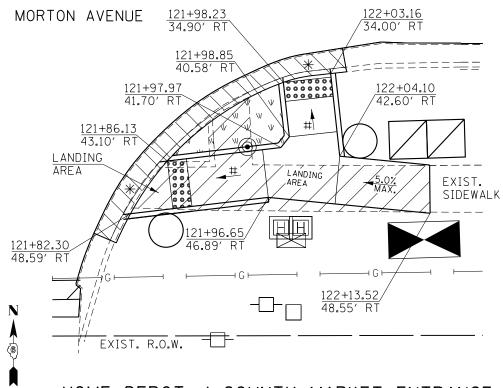

HOME DEPOT / COUNTY MARKET ENTRANCE SOUTHEAST QUADRANT

F.A.P.

		310A, 23BR,		TS-5:					
SECT	TION		cc	DUNTY		TOTA	ĽS	SHEE NO.	T
••		MORGAN			366	5	151		
			CC	NTRA	۱C)	T NO.	. 7	72D21	
	ILLINOIS	FED. A	D PRO	JECT					

FILE NAME =	USER NAME = Verenskifa	DESIGNED - RTS	REVISED -
pw:\\ILØ84EBIDINTEG.:ll:no:s.gov:PWIDOT\Do	cuments\IDOT Offices\District 6\Projects\D67	202RAWNData\GADsheRT&1 Sidewalks.dgn	REVISED -
	PLOT SCALE = 10.0000 '/ in.	CHECKED -	REVISED -
Default	PLOT DATE = 1/28/2016	DATE - 10-09-2015	REVISED -


STATE 0	F ILLINOIS
DEPARTMENT OF	TRANSPORTATION


								•	••	
SCALE:	SHEET	9	OF	27	SHEETS	STA.	TO STA.		1	L

SIDEWALK DETAILS

MORTON AVE. / LIST OF MATERIALS FARM & HOME SUPPLY (SIDEWALK 80%FED/20% STATE SOUTHWEST QUADRANT FUNDING) COMB. C&G REMOVAL = 13.5 FT SIDEWALK REMOVAL = 106.0 SQ FT EARTH EXCAVATION = 0.20 CU YD COMB. CONC. C&G, TY B 6.24 = 13.5 FT P.C.C. SIDEWALK, 4" = 102.4 SQ FT DETECTABLE WARNINGS = 10.0 SQ FT MORTON AVENUE EMBANKMENT = 0.14 CU YD (RIGHT TURN LANE) SODDING = 11.5 SQ YD 126+22.73 126+07.59 49.75' RT 50.88' RT EXIST. ENTRANCE SIDEWALK 126+07.61 126+29.26 55.85′ RT 54.27' RT EXIST. R.O.W. # = RAMP SLOPE 8.33% MAX



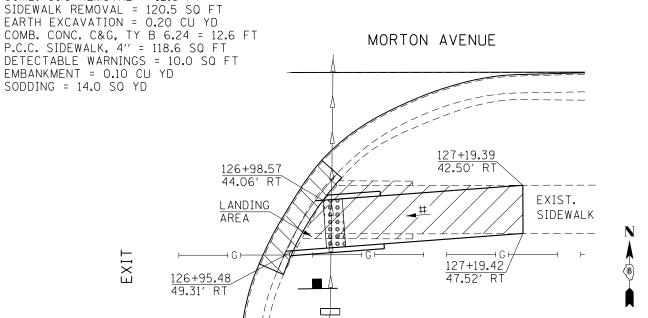

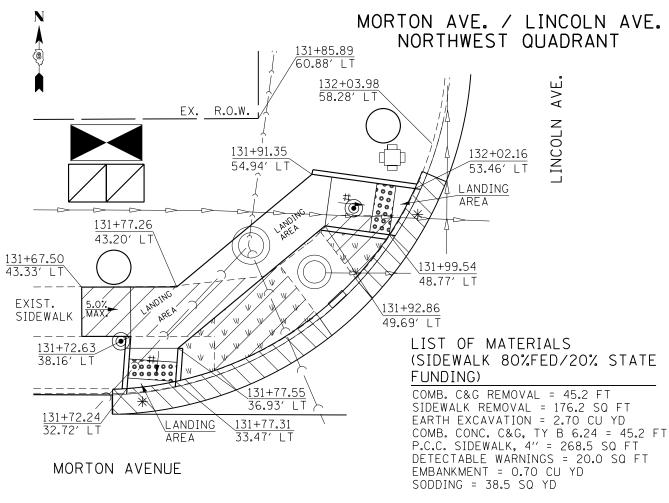

DESIGNED - RTS

10-09-2015

CHECKED

DATE

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USER NAME = Slaglert

PLOT DATE = 3/5/2016

PLOT SCALE = 10.0000 '/ in.

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FILE NAME


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MORTON AVE. / LINCOLN AVE. SOUTHWEST QUADRANT

LIST OF MATERIALS (SIDEWALK 80%FED/20% STATE FUNDING)

COMB. C&G REMOVAL = 21.7 FT SIDEWALK REMOVAL = 191.6 SQ FT EARTH EXCAVATION = 0.50 CU YD COMB. CONC. C&G, TY B 6.24 = 21.7 FT CONC. MEDIAN SURFACE, 4" = 5.8 SQ FT P.C.C. SIDEWALK, 4" = 203.0 SQ FT DETECTABLE WARNINGS = 21.5 SQ FT EMBANKMENT = 0.50 CU YD SODDING = 13.5 SQ YD

MORTON AVENUE

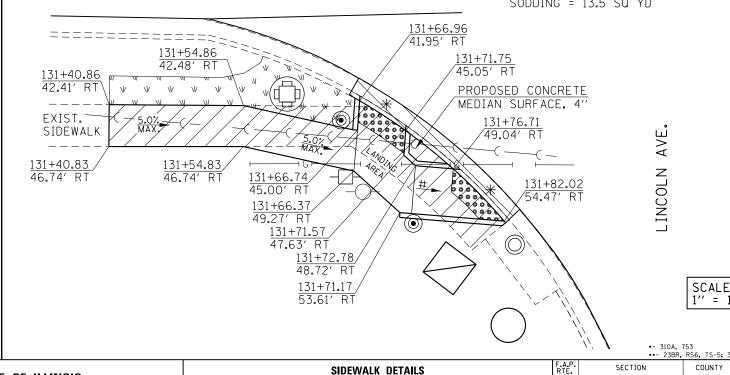

SCALE: 1" = 10'-0"

•- 310A, 753 •-- 23BR, RS6, TS-5; 33BR-1, RS4, TS-COUNTY

STATE OF ILLINOIS **DEPARTMENT OF TRANSPORTATION** SHEET 10 OF 27 SHEETS STA.

SCALE:

SECTION MORGAN 366 152 CONTRACT NO. 72D21



* - DEPRESSED CONCRETE CURBING



- PROPOSED DETECTABLE WARNING



PROPOSED SIDEWALK REMOVAL



PROPOSED COMB. C&G REMOVAL



PROPOSED CONCRETE MEDIAN REMOVAL



PROPOSED CONCRETE SIGNAL FOUNDATION



PROPOSED HANDHOLE



- PROPOSED PEDESTRIAN PUSH BUTTON POST



PROPOSED TRAFFIC SIGNAL CONTROL BOX



PROPOSED SODDING


PROPOSED SODDING SHALL BE LAID ADJACENT TO THE PROPOSED SIDEWALK, WITHIN DISTURBED AREAS, AND AS SHOWN IN THESE PLANS. THE ENGINEER SHALL DETERMINE FINAL LOCATIONS FOR THE PLACEMENT OF PROPOSED SODDING (TYPICAL FOR EACH LOCATION).

SAWCUTS NECESSARY FOR SIDEWALK, DRIVEWAY, CONCRETE CURB & GUTTER, AND PAVEMENT REMOVAL ARE INCLUDED IN THE PAY ITEM COSTS FOR REMOVAL

OF THE ASSOCIATED ITEM.
THE ENGINEER SHALL INSURE THAT ALL PROPOSED SIDEWALK WORK ADHERE TO THE POLICIES ESTABLISHED WITHIN HIGHWAY STANDARDS #424001, #424006, #424011, AND #424021 FOR SIDEWALK CONSTRUCTION.

MORTON AVE. / VETERANS DRIVE SOUTHWEST QUADRANT

MORTON AVENUE

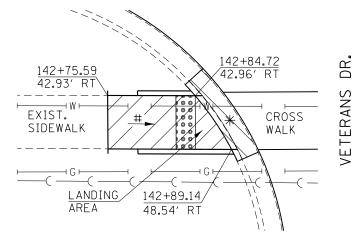


DR.

LIST OF MATERIALS (SIDEWALK 80%FED/20% STATE FUNDING)

COMB. C&G REMOVAL = 10.5 FT SIDEWALK REMOVAL = 70.1 SQ FT EARTH EXCAVATION = 0.15 CU YD COMB. CONC. C&G. TY B 6.24 = 10.5 FT P.C.C. SIDEWALK, 4" = 69.2 SQ FT DETECTABLE WARNINGS = 11.2 SQ FT SODDING = 8.0 SQ YD

MORTON AVE. / VETERANS DRIVE SOUTHEAST QUADRANT

MORTON AVENUE

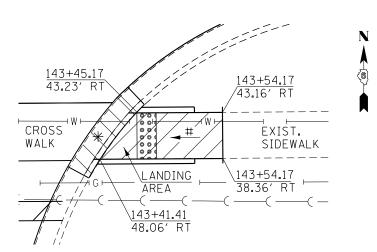

LIST OF MATERIALS (SIDEWALK 80%FED/20% STATE FUNDING)


COMB. C&G REMOVAL = 10.4 FT SIDEWALK REMOVAL = 52.6 SQ FT EARTH EXCAVATION = 0.15 CU YD COMB. CONC. C&G, TY B 6.24 = 10.4 FT P.C.C. SIDEWALK, 4" = 62.4 SQ FT DETECTABLE WARNINGS = 9.6 SQ FT SODDING = 7.2 SQ YD

= RAMP SLOPE 8.33% MAX

MORTON AVE. / GLADSTONE STREET NORTHWEST QUADRANT

LIST OF MATERIALS (SIDEWALK 80%FED/20% STATE FUNDING)

SIDEWALK REMOVAL = 68.2 SQ FT P.C.C. SIDEWALK. 4'' = 59.2 SQ FT DETECTABLE WARNINGS = 8.8 SQ FT EMBANKMENT = 0.10 CU YD SODDING =7.5 SQ YD

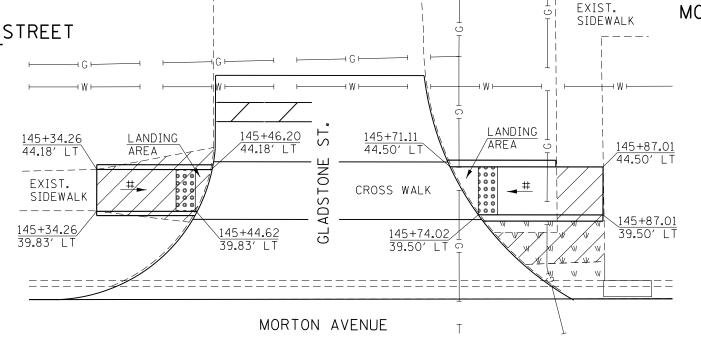

SCALE:

SHEET 11

MORTON AVE. / GLADSTONE STREET NORTHEAST QUADRANT

LIST OF MATERIALS (SIDEWALK 80%FED/20% STATE FUNDING)

SIDEWALK REMOVAL = 65.5 SQ FT EARTH EXCAVATION = 0.60 CU YD P.C.C. SIDEWALK, 4" = 86.8 SQ FT DETECTABLE WARNINGS = 10.0 SQ FT EMBANKMENT = 0.35 CU YD SODDING = 11.0 SQ YD



SCALE: 1" = 10'-0"

•- 310A, 753

FILE NAME =	USER NAME = Verenskifa	DESIGNED - RTS	REVISED -
ow:\\IL084EBIDINTEG.:1l1:no1s.gov:PWIDOT\Do	cuments\IDOT Offices\District 6\Projects\D67	20 2RAWN Data\GADshe R TS\1 Sidewalks.dgn	REVISED -
	PLOT SCALE = 10.0000 ' / in.	CHECKED -	REVISED -
Default	PLOT DATE = 1/28/2016	DATE - 10-09-2015	REVISED -

STATE OF ILLINOIS **DEPARTMENT OF TRANSPORTATION**

			••- 23BR,	RS6, 15-5; 33	BK-1, K2	4, 15
SIDEWALK DETA	ILS	F.A.P. RTE.	SECTION	COUNTY	TOTAL SHEETS	SHEE NO.
		•	••	MORGAN	366	15
				CONTRAC	T NO.	72D2
OF 27 SHEFTS STA	TO STA		THE THOUGHT FED. A	ID DDO IECT		



* - DEPRESSED CONCRETE CURBING

- PROPOSED DETECTABLE WARNING



PROPOSED SIDEWALK REMOVAL



PROPOSED COMB. C&G REMOVAL



- PROPOSED CONCRETE MEDIAN SURFACE REMOVAL



PROPOSED CONCRETE SIGNAL FOUNDATION



PROPOSED HANDHOLE



- PROPOSED PEDESTRIAN PUSH BUTTON POST



PROPOSED TRAFFIC SIGNAL CONTROL BOX




PROPOSED SODDING

NOTES:
PROPOSED SODDING SHALL BE LAID ADJACENT TO THE PROPOSED SIDEWALK, WITHIN DISTURBED AREAS, AND AS SHOWN IN THESE PLANS. THE ENGINEER SHALL DETERMINE FINAL LOCATIONS FOR THE PLACEMENT OF PROPOSED SODDING (TYPICAL FOR EACH LOCATION). SAWCUTS NECESSARY FOR SIDEWALK, DRIVEWAY, CONCRETE CURB & GUTTER, AND PAVEMENT REMOVAL ARE INCLUDED IN THE PAY ITEM COSTS FOR REMOVAL OF THE ASSOCIATED ITEM.

THE ENGINEER SHALL INSURE THAT ALL PROPOSED SIDEWALK WORK ADHERE TO THE POLICIES ESTABLISHED WITHIN HIGHWAY STANDARDS #424001, #424006, #424011, AND #424021 FOR SIDEWALK CONSTRUCTION.

MORTON AVE. / PAPA JOHNS ENTRANCE

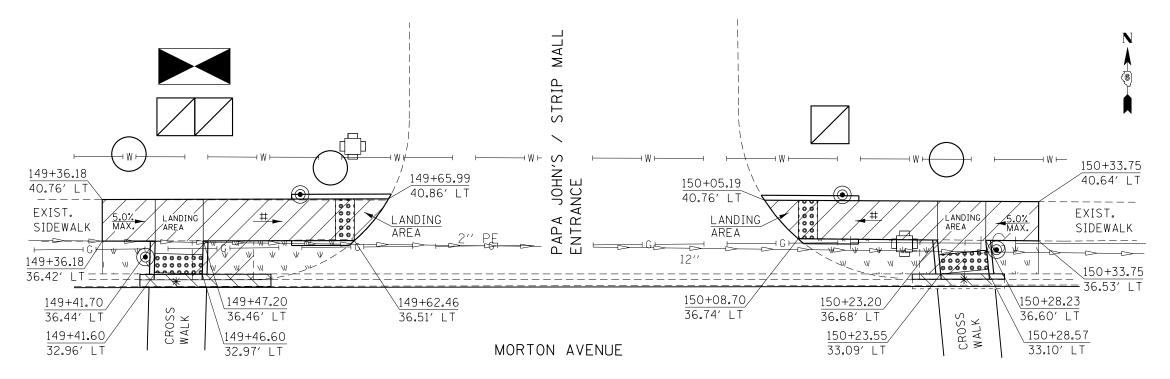

LIST OF MATERIALS (SIDEWALK 80%FED/20% STATE FUNDING)

COMB. C&G REMOVAL = 13.7 FT SIDEWALK REMOVAL = 145.4 SQ FT EARTH EXCAVATION = 0.20 CU YD COMB. CONC. C&G, TY B 6.12 = 13.7 FT P.C.C. SIDEWALK, 4" = 151.4 SQ FT DETECTABLE WARNINGS = 18.7 SQ FT EMBANKMENT = 0.16 CU YD SODDING = 16.5 SQ YD

= RAMP SLOPE 8.33% MAX

LIST OF MATERIALS (SIDEWALK 80%FED/20% STATE FUNDING)

COMB. C&G REMOVAL = 9.6 FT SIDEWALK REMOVAL = 127.9 SQ FT EARTH EXCAVATION = 0.13 CU YD COMB. CONC. C&G, TY B 6.12 = 9.6 FT P.C.C. SIDEWALK, 4" = 138.3 SQ FT DETECTABLE WARNINGS = 18.0 SQ FT EMBANKMENT = 0.1 CU YD SODDING = 15.7 SQ YD

	310A,	753				
• -	23BR,	RS6.	TS-5:	33BR-1,	RS4.	TS-2

FILE NAME =	USER NAME = Verenskifa	DESIGNED - RTS	REVISED -			SIDEWALK DETAILS		F.A.P.	SECTION	COUNTY TOTAL SHEET
pw:\\IL084EBIDINTEG.:111:nois.gov:PWIDOT\Do	cuments\IDOT Offices\District 6\Projects\D	67202RANANData\GADsheRTS\1 Sidewalks.dgn	REVISED -	STATE OF ILLINOIS		OIDEWALK BETALLO		•	••	MORGAN 366 154
	PLOT SCALE = 10.0000 '/ in.	CHECKED -	REVISED -	DEPARTMENT OF TRANSPORTATION				'		CONTRACT NO. 72D21
Default	PLOT DATE = 1/28/2016	DATE - 10-09-2015	REVISED -		SCALE:	SHEET 12 OF 27 SHEETS STA.	TO STA.		ILLINOIS FED. A	AID PROJECT



* - DEPRESSED CONCRETE CURBING



- PROPOSED DETECTABLE WARNING



- PROPOSED SIDEWALK REMOVAL



PROPOSED COMB. C&G REMOVAL



- PROPOSED CONCRETE MEDIAN SURFACE REMOVAL



PROPOSED CONCRETE SIGNAL FOUNDATION



PROPOSED HANDHOLE



- PROPOSED PEDESTRIAN PUSH BUTTON POST



- PROPOSED TRAFFIC SIGNAL CONTROL BOX




- PROPOSED SODDING

NOTES:

PROPOSED SODDING SHALL BE LAID ADJACENT TO THE PROPOSED SIDEWALK, WITHIN DISTURBED AREAS, AND AS SHOWN IN THESE PLANS. THE ENGINEER SHALL DETERMINE FINAL LOCATIONS FOR THE PLACEMENT OF PROPOSED SODDING (TYPICAL FOR EACH LOCATION). SAWCUTS NECESSARY FOR SIDEWALK, DRIVEWAY, CONCRETE CURB & GUTTER, AND PAVEMENT REMOVAL ARE INCLUDED IN THE PAY ITEM COSTS FOR REMOVAL OF THE ASSOCIATED ITEM. THE ENGINEER SHALL INSURE THAT ALL PROPOSED SIDEWALK WORK ADHERE TO THE POLICIES ESTABLISHED WITHIN HIGHWAY STANDARDS


#424001, #424006, #424011, AND #424021 FOR SIDEWALK CONSTRUCTION.

MORTON AVE. / LINCOLN SQUARE SOUTHWEST QUADRANT

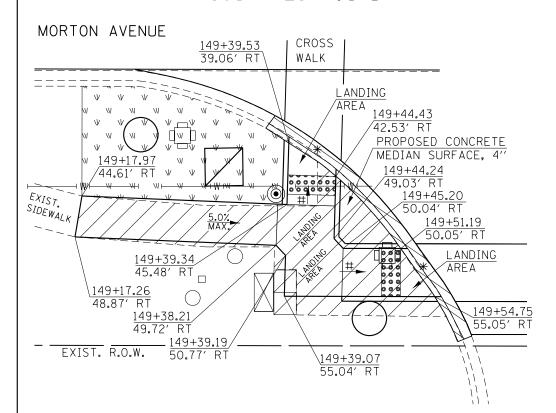

LIST OF MATERIALS (SIDEWALK 80%FED/20% STATE FUNDING)

COMB. C&G REMOVAL = 31.3 FT
SIDEWALK REMOVAL = 249.4 SQ FT
EARTH EXCAVATION = 0.30 CU YD
COMB. CONC. C&G, TY B 6.12 = 31.3 FT
CONCRETE MEDIAN SURFACE, 4" = 21.5 SQ FT
P.C.C. SIDEWALK, 4" = 224.4 SQ FT
DETECTABLE WARNINGS = 20.0 SQ FT
EMBANKMENT = 0.35 CU YD
SODDING = 24.0 SQ YD

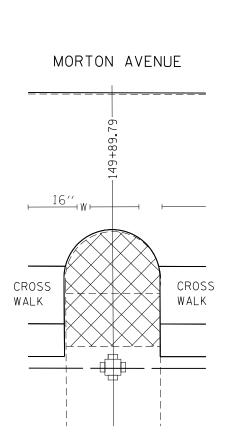


LIST OF MATERIALS (ROADWAY 80%FED/20% STATE FUNDING) CONCRETE MEDIAN SURFACE REMOVAL = 107.5 SQ FT

SUBBASE GRANULAR MATERIAL, TYPE B, 4" = 2.7 TONS

= RAMP SLOPE 8.33% MAX

PCC BASE COURSE 10" = 11.9 SQ YD

MORTON AVE. / LINCOLN SQUARE SOUTHEAST QUADRANT

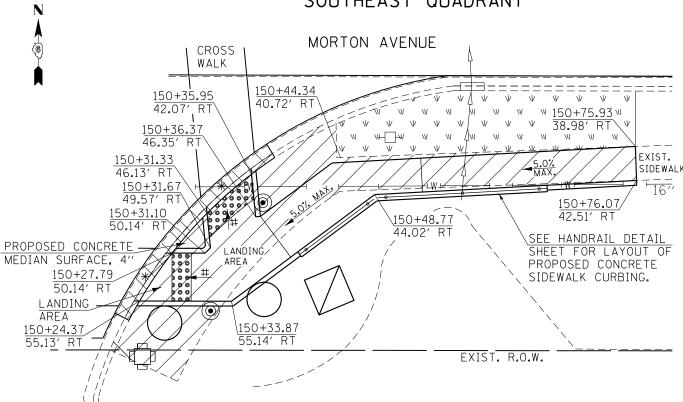

LIST OF MATERIALS (SIDEWALK 80%FED/20% STATE FUNDING)

COMB. C&G REMOVAL = 23.9 FT
SIDEWALK REMOVAL = 342.4 SO FT
EARTH EXCAVATION = 0.90 CU YD
COMB. CONC. C&G, TY B 6.12 = 23.9 FT
CONCRETE MEDIAN SURFACE, 4" = 5.1 SQ FT
P.C.C. SIDEWALK, 4" = 291.0 SQ FT
DETECTABLE WARNINGS = 22.9 SQ FT
EMBANKMENT = 1.0 CU YD
SODDING = 20.0 SQ YD

SCALE: 1" = 10'-0"

-- 310A, 753

FILE NAME =	USER NAME = Verenskifa	DESIGNED - RTS	REVISED -	Γ
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STATE OF ILLINOIS DEPARTMENT OF TRANSPORTATION

SHEET


					••- 23BR,	RS6, TS-5; 33	BR-1, RS	4, 15-2
	SIDEWALK D	ETAILS		F.A.P. RTE.	SECTION	COUNTY	TOTAL SHEETS	SHEET NO.
				•	••	MORGAN	366	155
						CONTRAC	T NO.	72D21
13	OF 27 SHEETS	STA.	TO STA.		TILINOIS EED A	IN PROJECT		

MORTON AVE. / TENDICK DRIVE SOUTHWEST QUADRANT

MORTON AVE. / TENDICK DRIVE SOUTHEAST QUADRANT

LIST OF MATERIALS (SIDEWALK 80%FED/20% STATE FUNDING)


SIDEWALK REMOVAL = 27.8 SQ FT EARTH EXCAVATION = 0.10 CU YD P.C.C. SIDEWALK, 4" = 36.3 SQ FT DETECTABLE WARNINGS = 7.4 SQ FT SODDING = 5.0 SQ YD

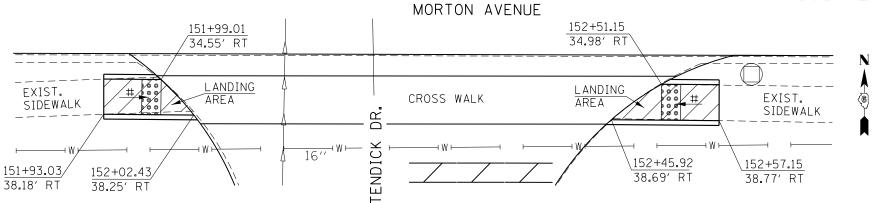

LIST OF MATERIALS (SIDEWALK 80%FED/20% STATE FUNDING)

SIDEWALK REMOVAL = 32.3 SQ FT EARTH EXCAVATION = 0.10 CU YD P.C.C. SIDEWALK, 4" = 41.6 SQ FT DETECTABLE WARNINGS = 7.5 SQ FT SODDING = 6.0 SQ YD

= RAMP SLOPE 8.33% MAX

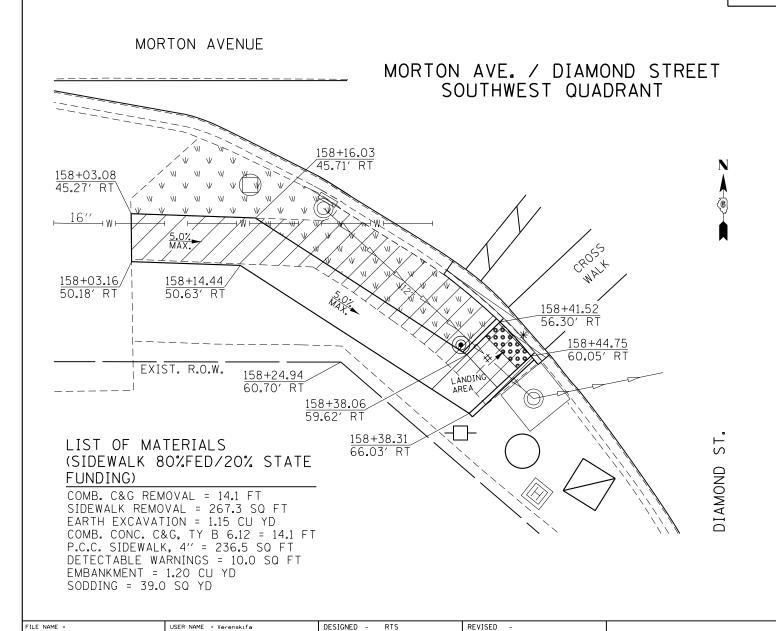


MORTON AVE. / DIAMOND STREET NORTHEAST QUADRANT

LIST OF MATERIALS
(SIDEWALK 80%FED/20% STATE FUNDING)

COMB. C&G REMOVAL = 37.2 FT

SIDEWALK REMOVAL = 37.2 FT SIDEWALK REMOVAL = 244.9 SQ FT DRIVEWAY PAVEMENT REMOVAL = 1.9 SQ YD COMB. CONC. C&G, TY B 6.12 = 37.2 FT P.C.C. SIDEWALK, 4" = 259.3 SQ FT DETECTABLE WARNINGS = 10.0 SQ FT

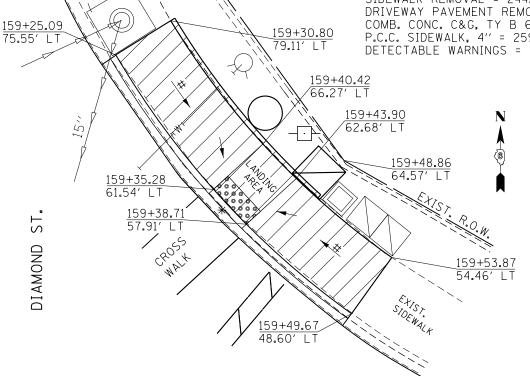

MORTON AVENUE


SCALE: 1" = 10'-0"

			TOT	4.1	6	·FF
••- 23BR,	RS6,					
•- 310A,	753					

		525151125	
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	PLOT SCALE = 10.0000 '/ in.	CHECKED -	REVISED -
Default	PLOT DATE = 1/28/2016	DATE - 10-09-2015	REVISED -

SCALE:

							23011,	1130, 13 3, 33	DIV 1. IV.	7, 13
		SIDEV	VALK D	ETAILS		F.A.P. RTE.	SECTION	COUNTY	TOTAL SHEETS	SHEE NO.
						•	••	MORGAN	366	156
								CONTRAC	T NO.	72D21
SHEET	14	OF 27	SHEETS	STA.	TO STA.		ILLINOIS FED. A	ID PROJECT		

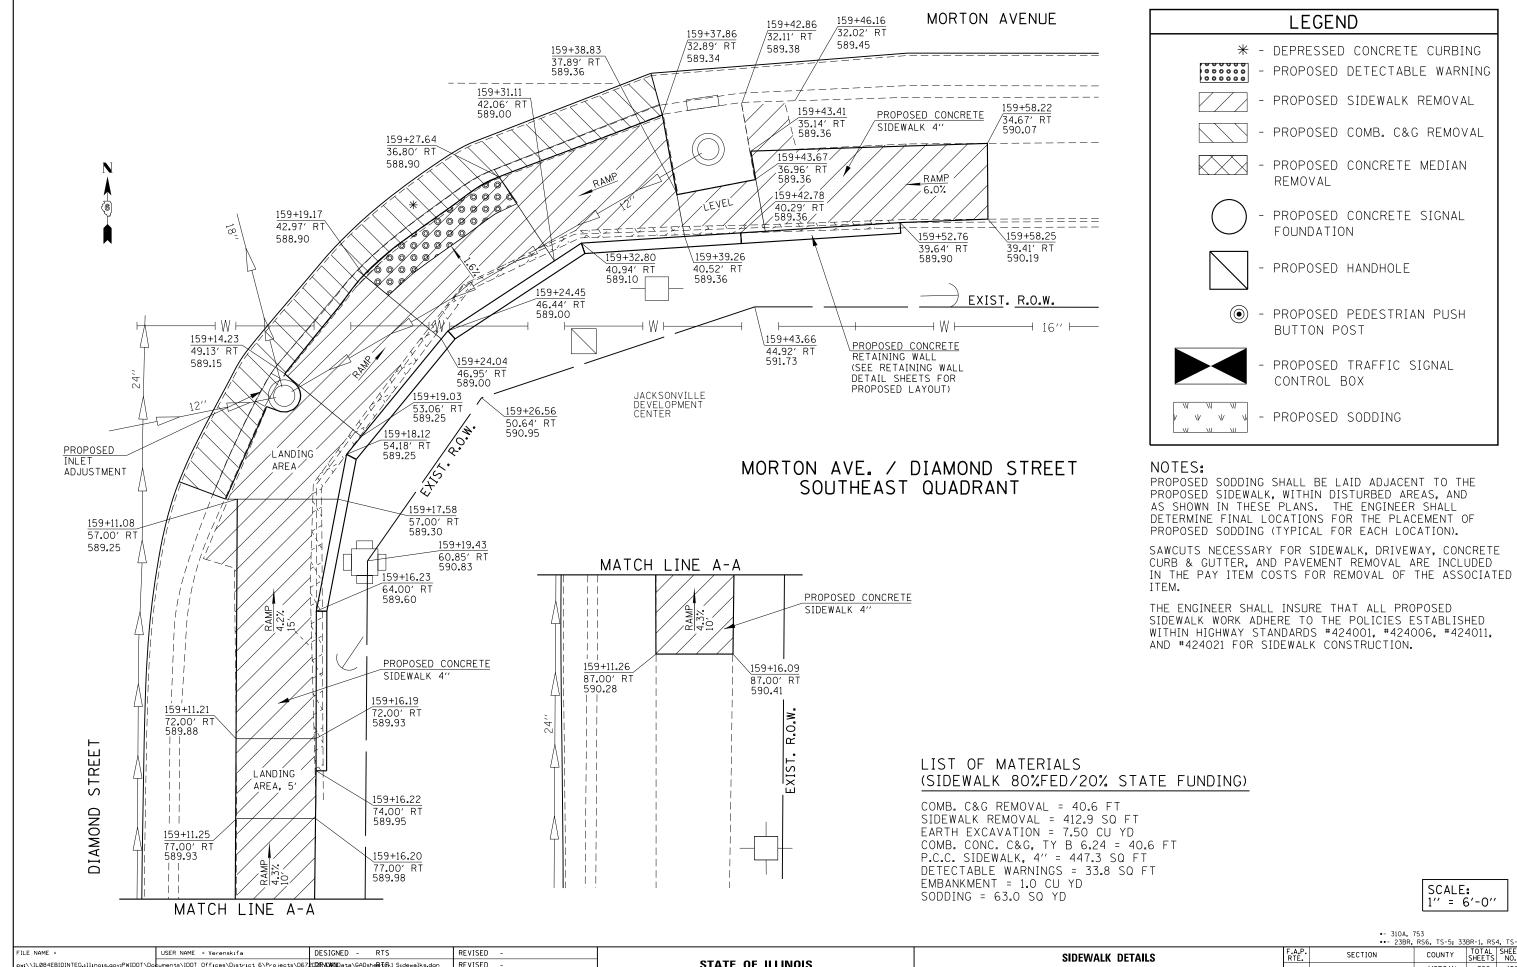

COUNTY TOTAL SHEET NO. MORGAN 366 157

STATE OF ILLINOIS **DEPARTMENT OF TRANSPORTATION**

CHECKED

10-09-2015

DATE

PLOT DATE = 1/28/2016

REVISED


REVISED

TO STA.

SHEET 15 OF 27 SHEETS STA.

SCALE:

CONTRACT NO. 72D21

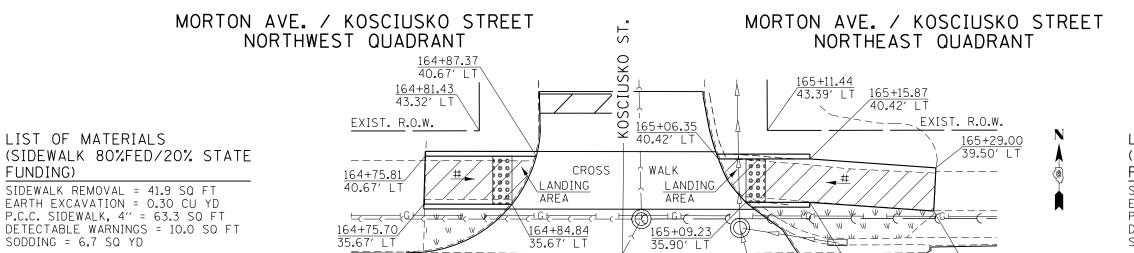


LIST OF MATERIALS (SIDEWALK 80%FED/20% STATE FUNDING)

SIDEWALK REMOVAL = 82.1 SQ FT EARTH EXCAVATION = 0.35 CU YD P.C.C. SIDEWALK, 4" = 104.7 SQ FT DETECTABLE WARNINGS = 10.0 SQ FT SODDING = 12.5 SQ YD

= RAMP SLOPE 8.33% MAX

MORTON AVENUE

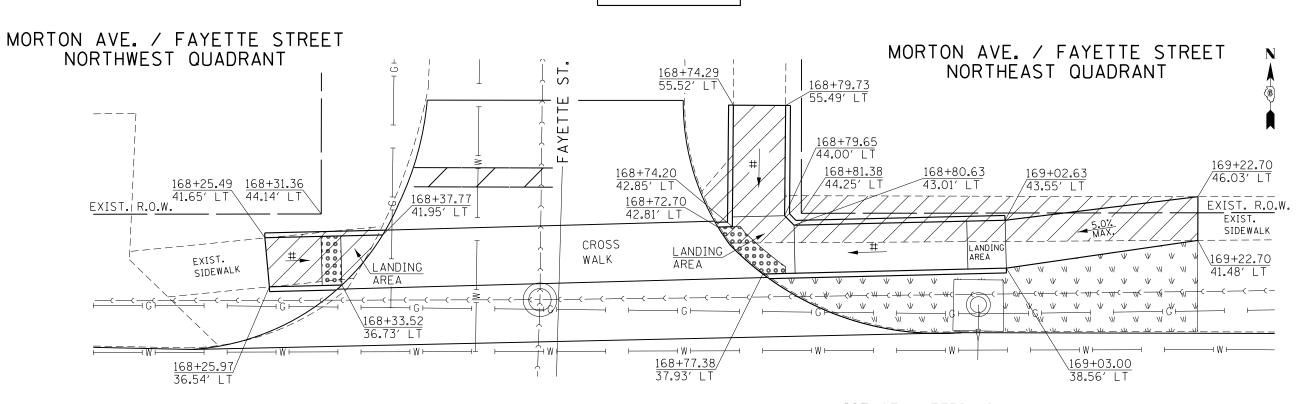

LIST OF MATERIALS (SIDEWALK 80%FED/20% STATE FUNDING)

SIDEWALK REMOVAL = 54.4 SQ FT EARTH EXCAVATION = 0.30 CU YD P.C.C. SIDEWALK, 4" = 61.6 SQ FT DETECTABLE WARNINGS = 10.0 SQ FT SODDING = 6.7 SQ YD

FUNDING)

MORTON AVENUE

LIST OF MATERIALS (SIDEWALK 80%FED/20% STATE FUNDING)

165+28.78 ⊣w⊢ 35.00′ LT

165+15.87 35.90′ LT

SIDEWALK REMOVAL = 298.4 SQ FT EARTH EXCAVATION = 1.70 CU YD P.C.C. SIDEWALK, 4" = 341.0 SQ FT DETECTABLE WARNINGS = 14.0 SQ FT EMBANKMENT = 0.90 CU YD SODDING = 30.0 SQ YD


											- 1
									•- 310A,	753	
									••- 23BR,	RS6, TS-5; 33BR-1, RS4, TS	2
FILE NAME =	USER NAME = Verenskifa	DESIGNED - RTS	REVISED -			SIDEWALK DETAILS		F.A.P.	SECTION	COUNTY TOTAL SHEE	ŋ.
pw:\\ILØ84EBIDINTEG.:ll:no:s.gov:PWIDOT\Do	cuments\IDOT Offices\District 6\Projects\D67	20 2RACWIN Data\GADshe R 75\1 Sidewalks.dgn	REVISED -	STATE OF ILLINOIS		SIDEWALK DETAILS		•		MORGAN 366 15	,
	PLOT SCALE = 10.0000 '/ in.	CHECKED -	REVISED -	DEPARTMENT OF TRANSPORTATION						CONTRACT NO. 72D2	.1
Default	PLOT DATE = 1/28/2016	DATE - 10-09-2015	REVISED _	1	SCALE.	SHEET 16 OF 27 SHEETS STA	TO STA		TILL THOSE FED. AT		\dashv

LEGEND * - DEPRESSED CONCRETE CURBING 000000 - PROPOSED DETECTABLE WARNING PROPOSED SIDEWALK REMOVAL PROPOSED COMB. C&G REMOVAL PROPOSED CONCRETE MEDIAN REMOVAL PROPOSED CONCRETE SIGNAL FOUNDATION PROPOSED HANDHOLE - PROPOSED PEDESTRIAN PUSH BUTTON POST PROPOSED TRAFFIC SIGNAL CONTROL BOX - PROPOSED SODDING

= RAMP SLOPE 8.33% MAX


NOTES:
PROPOSED SODDING SHALL BE LAID ADJACENT TO THE PROPOSED SIDEWALK, WITHIN DISTURBED AREAS, AND AS SHOWN IN THESE PLANS. THE ENGINEER SHALL DETERMINE FINAL LOCATIONS FOR THE PLACEMENT OF PROPOSED SODDING (TYPICAL FOR EACH LOCATION). SAWCUTS NECESSARY FOR SIDEWALK, DRIVEWAY, CONCRETE CURB & GUTTER, AND PAVEMENT REMOVAL ARE INCLUDED IN THE PAY ITEM COSTS FOR REMOVAL OF THE ASSOCIATED ITEM.

THE ENGINEER SHALL INSURE THAT ALL PROPOSED SIDEWALK WORK ADHERE TO THE POLICIES ESTABLISHED WITHIN HIGHWAY STANDARDS #424001, #424006, #424011, AND #424021 FOR SIDEWALK CONSTRUCTION.

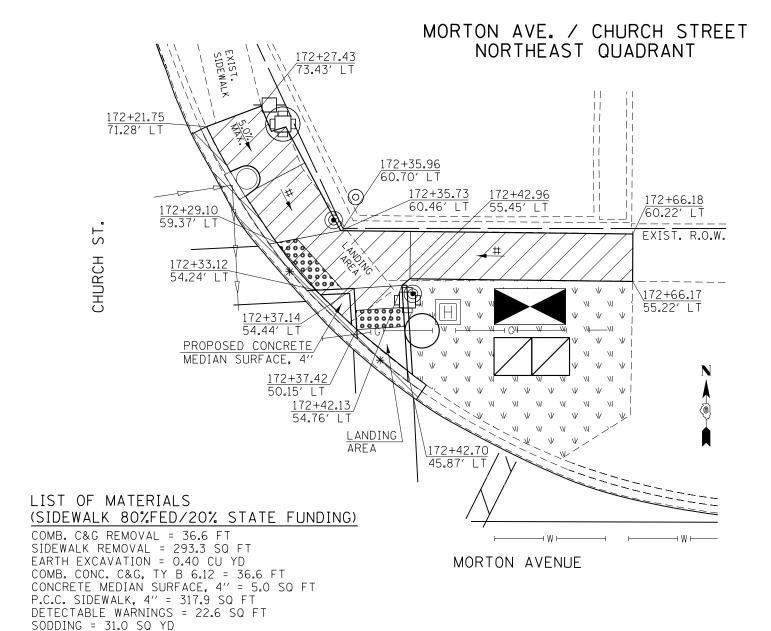

•- 310A, ••- 23BR.	753 RS6, TS-5; 33	BR-1, RS	4, TS-2	
TION	COUNTY	TOTAL SHEETS	SHEET NO.	

FILE NAME =	USER NAME = Verenskifa	DESIGNED - RTS	REVISED -			SIDEWALK DETA	NII S	F.A.P.	SECTION	COUNTY	TOTAL S SHEETS	SHEET
pw:\\ILØ84EBIDINTEG.:lll:nois.gov:PWIDOT\Do	puments\IDOT Offices\District 6\Projects\D67	202RAWNData\GADsheRf\$\1 Sidewalks.dgn	REVISED -	STATE OF ILLINOIS		SIDEWALK DETA	AILO	•	••	MORGAN		159
	PLOT SCALE = 10.00000 '/ in.	CHECKED -	REVISED -	DEPARTMENT OF TRANSPORTATION							CT NO. 72	/2D21
Default	PLOT DATE = 1/28/2016	DATE - 10-09-2015	REVISED -		SCALE:	SHEET 17 OF 27 SHEETS STA	A. TO STA.		ILL INOIS F	ED. AID PROJECT		

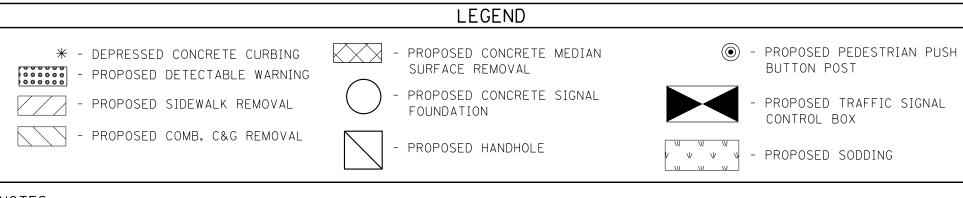


NOTES:
PROPOSED SODDING SHALL BE LAID ADJACENT TO THE PROPOSED SIDEWALK, WITHIN DISTURBED AREAS, AND AS SHOWN IN THESE PLANS. THE ENGINEER SHALL DETERMINE FINAL LOCATIONS FOR THE PLACEMENT OF PROPOSED SODDING (TYPICAL FOR EACH LOCATION). SAWCUTS NECESSARY FOR SIDEWALK, DRIVEWAY, CONCRETE CURB & GUTTER, AND PAVEMENT REMOVAL ARE INCLUDED IN THE PAY ITEM COSTS FOR REMOVAL OF THE ASSOCIATED ITEM. THE ENGINEER SHALL INSURE THAT ALL PROPOSED SIDEWALK WORK ADHERE TO THE POLICIES ESTABLISHED WITHIN HIGHWAY STANDARDS #424001, #424006, #424011, AND #424021 FOR SIDEWALK CONSTRUCTION.

= RAMP SLOPE 8.33% MAX

MORTON AVE. / JACKSONVILLE DEVELOPEMENT CENTER SOUTHWEST QUADRANT

MORTON AVE. / JACKSONVILLE DEVELOPEMENT CENTER SOUTHEAST QUADRANT

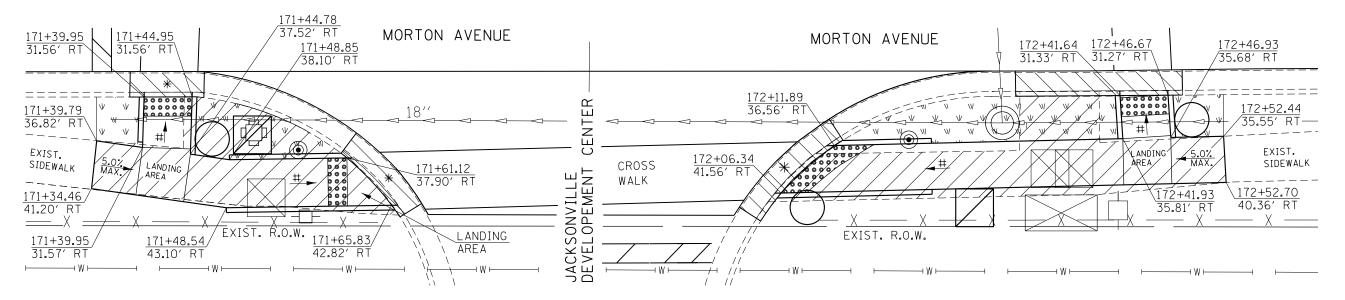

LIST OF MATERIALS (SIDEWALK 80%FED/20% STATE FUNDING)

COMB. C&G REMOVAL = 17.8 FT SIDEWALK REMOVAL = 224.0 SQ FT EARTH EXCAVATION = 0.40 CU YD COMB. CONC. C&G, TY B 6.24 = 17.8 FT P.C.C. SIDEWALK, 4" = 193.1 SQ FT DETECTABLE WARNINGS = 20.0 SO FT EMBANKMENT = 0.60 CU YD SODDING = 12.9 SQ YD

LIST OF MATERIALS (SIDEWALK 80%FED/20% STATE FUNDING)

COMB. C&G REMOVAL = 30.6 FT SIDEWALK REMOVAL = 264.4 SQ FT EARTH EXCAVATION = 0.70 CU YD COMB. CONC. C&G, TY B 6.24 = 30.6 FT P.C.C. SIDEWALK, 4" = 250.3 SQ FT DETECTABLE WARNINGS = 25.6 SO FT EMBANKMENT = 0.60 CU YD SODDING = 28.5 SQ YD


SCALE: 1" = 10'-0"

•- 310A, 753

									••- 23BR.	RS6, TS-5; 33B	JR-1, RS4, TS-2
FILE NAME =	USER NAME = Verenskifa	DESIGNED - RTS	REVISED -			SIDEWALK DETAILS		F.A.P.	SECTION	COUNTY	TOTAL SHEET
pw:\\IL084EBIDINTEG.:111:no:s.gov:PWIDOT\Do	cuments\IDOT Offices\District 6\Projects\D67	202RACWNData\GADsheRfS\1 Sidewalks.dgn	REVISED -	STATE OF ILLINOIS		SIDEWALK DETAILS		•	••	MORGAN	366 160
	PLOT SCALE = 10.0000 '/ in.	CHECKED -	REVISED -	DEPARTMENT OF TRANSPORTATION						CONTRACT	NO. 72D21
Default	PLOT DATE = 1/28/2016	DATE - 10-09-2015	REVISED -		SCALE:	SHEET 18 OF 27 SHEETS STA.	TO STA.		ILLINOIS FED. AI	D PROJECT	

MORTON AVE. / MAIN STREET SOUTHWEST QUADRANT

MORTON AVENUE

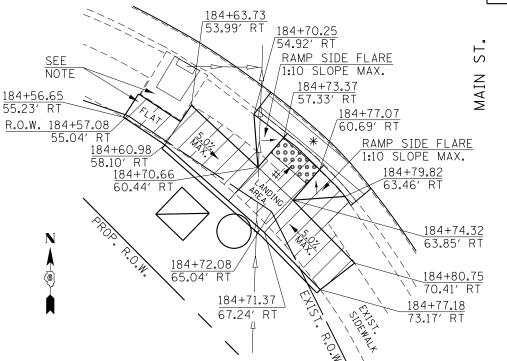

NOTE: PROPOSED SIDEWALK, 4" SURFACE ELEVATION SHALL MEET THE TOP OF THE EXISTING GRATE ELEVATION.

LIST OF MATERIALS (SIDEWALK 80%FED/20% STATE FUNDING)


COMB. C&G REMOVAL = 14.5 FT SIDEWALK REMOVAL = 147.5 SQ FT EARTH EXCAVATION = 0.50 CU YD COMB. CONC. C&G, TY B 6.24 = 14.5 FT P.C.C. SIDEWALK, 4" = 169.5 SQ FT DETECTABLE WARNINGS = 10.0 SQ FT EMBANKMENT = 0.30 CU YD SODDING = 9.0 SQ YD

= RAMP SLOPE 8.33% MAX


LIST OF MATERIALS (SIDEWALK 80%FED/20% STATE FUNDING)

COMB. C&G REMOVAL = 36.6 FT SIDEWALK REMOVAL = 380.9 SQ FT EARTH EXCAVATION = .30 CU YD COMB. CONC. C&G, TY B 6.24 = 36.6 FT CONCRETE MEDIAN SURFACE, 4" = 48.8 SQ FT P.C.C. SIDEWALK, 4" = 295.1 SQ FT DETECTABLE WARNINGS = 20.0 SQ FT EMBANKMENT = 0.5 CU YD SODDING = 22.0 SQ YD

MORTON AVE. / MAIN STREET NORTHEAST QUADRANT

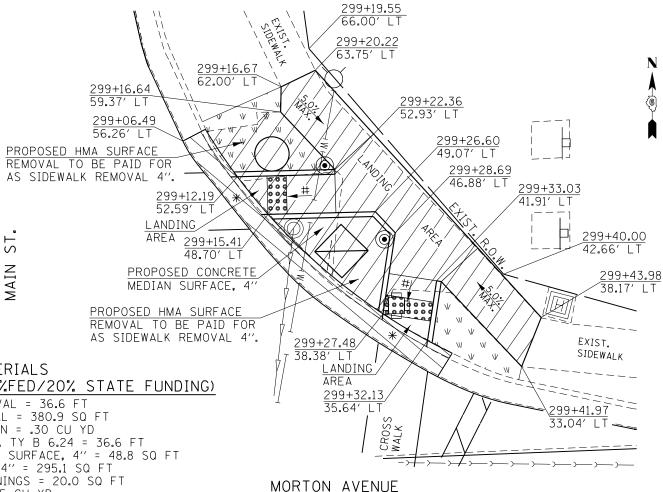

LEGEND

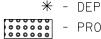

* - DEPRESSED CONCRETE CURBING - PROPOSED DETECTABLE WARNING



PROPOSED SIDEWALK REMOVAL



PROPOSED COMB. C&G REMOVAL



PROPOSED CONCRETE MEDIAN SURFACE REMOVAL



PROPOSED CONCRETE SIGNAL FOUNDATION

SCALE:



PROPOSED HANDHOLE



- PROPOSED PEDESTRIAN PUSH BUTTON POST



PROPOSED TRAFFIC SIGNAL CONTROL BOX



PROPOSED SODDING

NOTES:
PROPOSED SODDING SHALL BE LAID ADJACENT TO THE PROPOSED
AREAS. AND AS SHOWN IN THESE PLANS. THE ENGINEER SHALL DETERMINE FINAL LOCATIONS FOR THE PLACEMENT OF PROPOSED SODDING (TYPICAL FOR EACH LOCATION). SAWCUTS NECESSARY FOR SIDEWALK, DRIVEWAY, CONCRETE CURB & GUTTER, AND PAVEMENT REMOVAL ARE INCLUDED IN THE PAY ITEM COSTS FOR REMOVAL OF THE ASSOCIATED ITEM. THE ENGINEER SHALL INSURE THAT ALL PROPOSED SIDEWALK WORK ADHERE TO THE POLICIES ESTABLISHED WITHIN HIGHWAY STANDARDS

#424001, #424006, #424011, AND #424021 FOR SIDEWALK CONSTRUCTION.


SCALE: 1" = 10'-0"

•- 310A, 753

FILE NAME : DESIGNED - RTS REVISED USER NAME = Verenskifa ow:\\IL084EBIDINTEG.:111:no: ments\IDOT Offices\District 6\Projects\D67202RAUMNData\GADsheR-Ts\1 Sidewalks.dgn REVISED LOT SCALE = 10.0000 '/ in. CHECKED REVISED PLOT DATE = 1/28/2016 REVISED DATE 10-09-2015

STATE OF ILLINOIS	
DEPARTMENT OF TRANSPORTATION	

									••- 23BR.	. RS6, TS-5; 33	BR-1, RS	4, TS-2
	SIDEWALK DETAILS							F.A.P. RTE.	SECTION	COUNTY	TOTAL SHEETS	SHEET NO.
						•	••	MORGAN	366	161		
										CONTRAC	T NO.	72D21
	SHEET	19	OF	27	SHEETS	STA.	TO STA.		TILL INDIS FED. A	ID PROJECT		

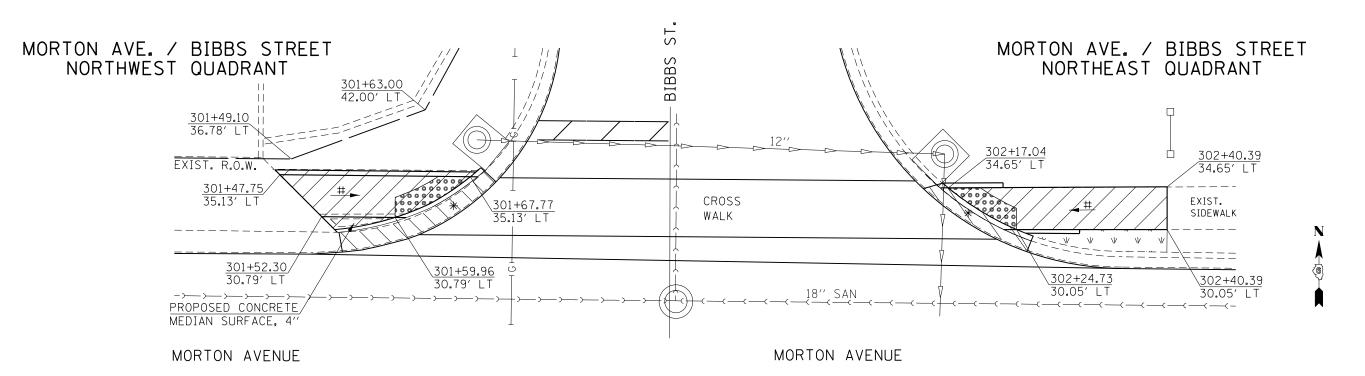


LIST OF MATERIALS (SIDEWALK 80%FED/20% STATE FUNDING)

COMB. C&G REMOVAL = 18.0 FT SIDEWALK REMOVAL = 79.7 SQ FT COMB. CONC. C&G, TY B 6.24 = 18.0 FT CONCRETE MEDIAN SURFACE, 4" = 5.8 SQ FT P.C.C. SIDEWALK, 4'' = 72.4 SQ FT DETECTABLE WARNINGS = 14.0 SQ FT EMBANKMENT = 0.20 CU YD SODDING = 7.3 SQ YD

= RAMP SLOPE 8.33% MAX

LIST OF MATERIALS (SIDEWALK 80%FED/20% STATE FUNDING)

COMB. C&G REMOVAL = 12.7 FT SIDEWALK REMOVAL = 85.8 SQ FT EARTH EXCAVATION = 0.10 CU YD COMB. CONC. C&G, TY B 6.24 = 12.7 FT P.C.C. SIDEWALK, 4" = 92.1 SQ FT DETECTABLE WARNINGS = 12.8 SQ FT SODDING = 10.0 SQ YD

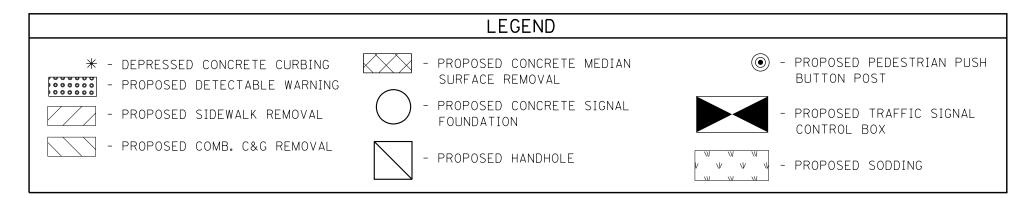


NOTES:
PROPOSED SODDING SHALL BE LAID ADJACENT TO THE PROPOSED SIDEWALK, WITHIN DISTURBED AREAS, AND AS SHOWN IN THESE PLANS. THE ENGINEER SHALL DETERMINE FINAL LOCATIONS FOR THE PLACEMENT OF PROPOSED SODDING (TYPICAL FOR EACH LOCATION). SAWCUTS NECESSARY FOR SIDEWALK, DRIVEWAY, CONCRETE CURB & GUTTER. AND PAVEMENT REMOVAL ARE INCLUDED IN THE PAY ITEM COSTS FOR REMOVAL OF THE ASSOCIATED ITEM. THE ENGINEER SHALL INSURE THAT ALL PROPOSED SIDEWALK WORK ADHERE TO THE POLICIES ESTABLISHED WITHIN HIGHWAY STANDARDS #424001, #424006, #424011, AND #424021 FOR SIDEWALK CONSTRUCTION.

SCALE: 1" = 10'-0"

•- 310A, 753

									••- 23BR,	RS6, TS-5; 33	3BR-1, RS4,	, TS-2
FILE NAME =	USER NAME = Verenskifa	DESIGNED - RTS	REVISED -			SIDEWALK DETAILS		F.A.P.	SECTION	COUNTY	TOTAL S	SHEET
pw:\\IL084EBIDINTEG.:ll:no:s.gov:PWIDOT\Do	cuments\IDOT Offices\District 6\Projects\D67	720 2RAWN Data\GADshe R T&1 Sidewalks.dgn	REVISED -	STATE OF ILLINOIS		SIDEWALK DETAILS			••	MORGAN	366	162
	PLOT SCALE = 10.0000 '/ in.	CHECKED -	REVISED -	DEPARTMENT OF TRANSPORTATION						CONTRAC	T NO. 72	2D21
Default	PLOT DATE = 1/28/2016	DATE - 10-09-2015	REVISED -		SCALE:	SHEET 20 OF 27 SHEETS STA.	TO STA.		TILLINOIS FED. A			

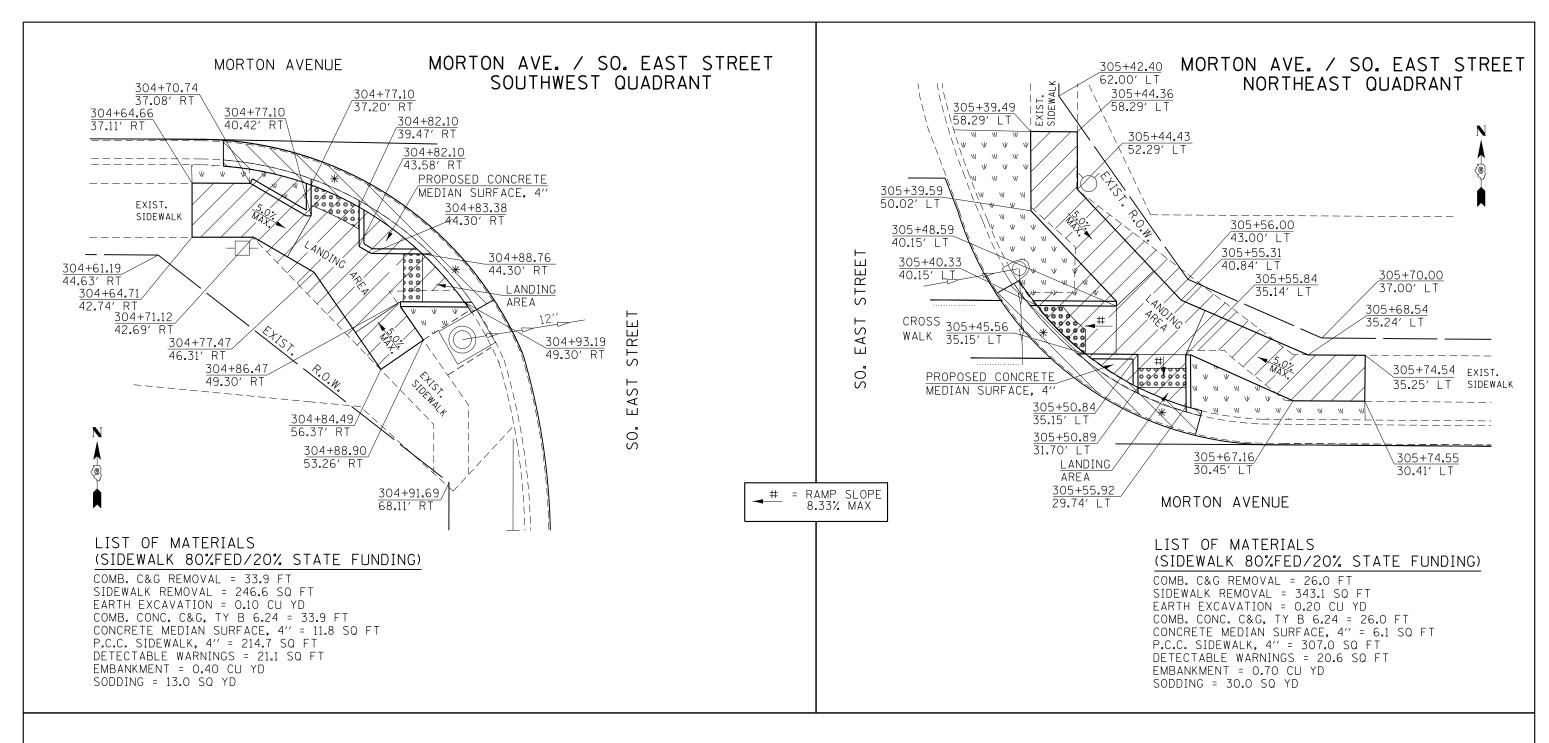

PRO

★ - DEPRESSED CONCRETE CURBING



- PROPOSED DETECTABLE WARNING - PROPOSED SIDEWALK REMOVAL





- PROPOSED COMB. C&G REMOVAL



- PROPOSED CONCRETE MEDIAN SURFACE REMOVAL



PROPOSED CONCRETE SIGNAL FOUNDATION



- PROPOSED HANDHOLE



- PROPOSED PEDESTRIAN PUSH BUTTON POST



PROPOSED TRAFFIC SIGNAL CONTROL BOX



- PROPOSED SODDING


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SCALE: 1" = 10'-0"

COUNTY TOTAL SHEET NO. FILE NAME : DESIGNED - RTS REVISED USER NAME = Verenskifa SECTION SIDEWALK DETAILS STATE OF ILLINOIS w:\\ILØ84EBIDINTEG.ıllınoı ments\IDOT Offices\District 6\Projects\D67202RAUMNData\GADsheR-Ts\1 Sidewalks.dgn REVISED MORGAN 366 163 LOT SCALE = 10.0000 '/ in. CHECKED REVISED **DEPARTMENT OF TRANSPORTATION** CONTRACT NO. 72D21 SCALE: SHEET 21 OF 27 SHEETS STA. TO STA. PLOT DATE = 1/28/2016 DATE 10-09-2015 REVISED



* - DEPRESSED CONCRETE CURBING

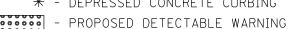

PROPOSED SIDEWALK REMOVAL



PROPOSED COMB. C&G REMOVAL



PROPOSED CONCRETE MEDIAN SURFACE REMOVAL



PROPOSED CONCRETE SIGNAL FOUNDATION



PROPOSED HANDHOLE



- PROPOSED PEDESTRIAN PUSH BUTTON POST



PROPOSED TRAFFIC SIGNAL CONTROL BOX



PROPOSED SODDING


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ADHERE TO THE POLICIES ESTABLISHED WITHIN HIGHWAY STANDARDS #424001, #424006, #424011, AND #424021 FOR SIDEWALK CONSTRUCTION.

MORTON AVE. / HUBER STREET NORTHWEST QUADRANT

MORTON AVE. / HUBER STREET NORTHEAST QUADRANT



LIST OF MATERIALS (SIDEWALK 80%FED/20% STATE FUNDING)

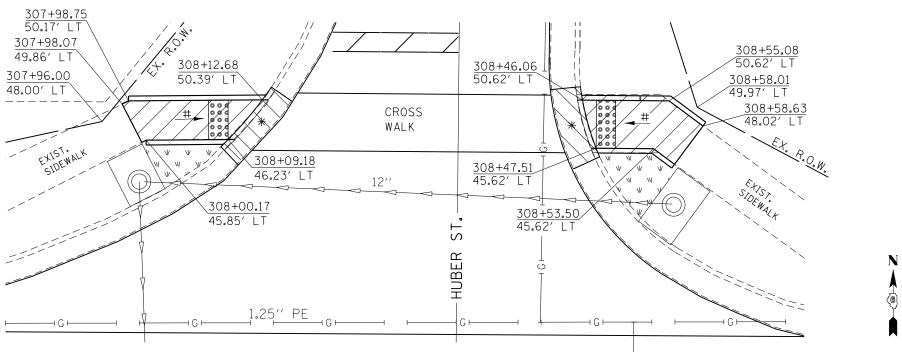COMB. C&G REMOVAL = 8.7 FT SIDEWALK REMOVAL = 48.7 SQ FT EARTH EXCAVATION = 0.15 CU YD COMB. CONC. C&G, TY B 6.24 = 8.7 FT P.C.C. SIDEWALK, 4" = 60.6 SQ FT DETECTABLE WARNINGS = 10.0 SQ FT SODDING = 7.0 SQ YD

MORTON AVENUE

= RAMP SLOPE 8.33% MAX


LIST OF MATERIALS (SIDEWALK 80%FED/20% STATE FUNDING)

COMB. C&G REMOVAL = 8.7 FT SIDEWALK REMOVAL = 64.0 SQ FT EARTH EXCAVATION = 0.10 CU YD COMB. CONC. C&G, TY B 6.24 = 8.7 FT P.C.C. SIDEWALK, 4" = 66.7 SQ FT DETECTABLE WARNINGS = 10.0 SQ FT SODDING = 6.0 SQ YD

SCALE: 1'' = 10'-0''

•- 310A, 753 ••- 23BR RS6 TS-5• 33BR-1 RS4 TS-1

FILE NAME =	USER NAME = Verenskifa	DESIGNED - RTS	REVISED -			SIDEWALK DETAILS		F.A.P.	SECTION	COUNTY TOTAL SHEET
pw:\\ILØ84EBIDINTEG.ıllınoıs.gov:PWIDOT\Do	*		ks.dgn REVISED -	STATE OF ILLINOIS		SIDEWALK DETAILS		•	••	MORGAN 366 164
	PLOT SCALE = 10.0000 '/ in.	CHECKED -	REVISED -	DEPARTMENT OF TRANSPORTATION						CONTRACT NO. 72D21
Default	PLOT DATE = 1/28/2016	DATE - 10-09-2015	REVISED -		SCALE:	SHEET 22 OF 27 SHEETS STA.	TO STA.		ILLINOIS FED. A	ID PROJECT

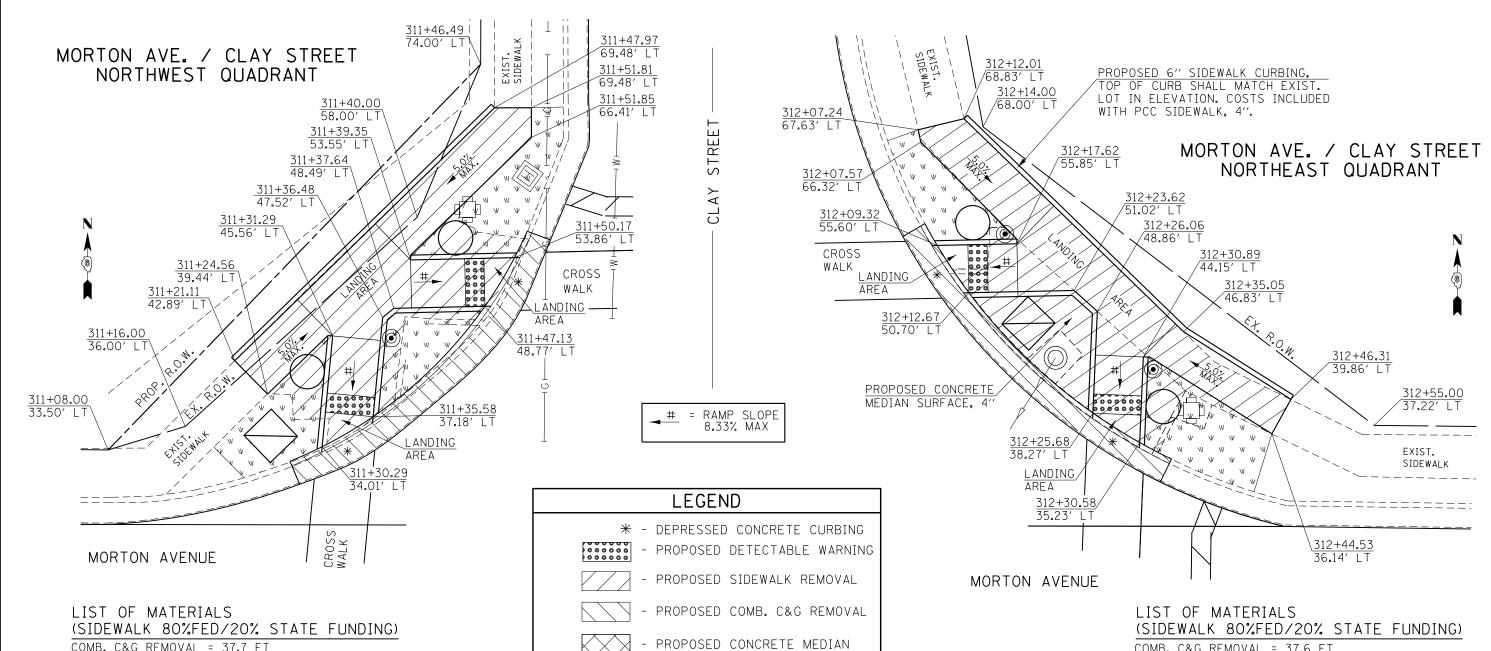

COMB. C&G REMOVAL = 37.7 FT SIDEWALK REMOVAL = 421.5 SQ FT EARTH EXCAVATION = 0.30 CU YD COMB. CONC. C&G, TY B 6.24 = 37.7 FT P.C.C. SIDEWALK, 4" = 358.2 SQ FT DETECTABLE WARNINGS = 20.0 SQ FT EMBANKMENT = 0.75 CU YD SODDING = 36.2 SQ YD

PLOT DATE = 1/28/2016



REMOVAL



PROPOSED CONCRETE SIGNAL FOUNDATION



PROPOSED HANDHOLE



- PROPOSED PEDESTRIAN PUSH BUTTON POST



PROPOSED TRAFFIC SIGNAL CONTROL BOX



PROPOSED SODDING

COMB. C&G REMOVAL = 37.6 FT SIDEWALK REMOVAL = 416.3 SQ FT EARTH EXCAVATION = 0.40 CU YD COMB. CONC. C&G, TY B 6.24 = 37.6 FT CONCRETE MEDIAN SURFACE, 4" = 48.0 SQ FT P.C.C. SIDEWALK, 4" = 363.5 SQ FT DETECTABLE WARNINGS = 20.0 SQ FT EMBANKMENT = 1.0 CU YD SODDING = 31.6 SQ YD

PROPOSED SODDING SHALL BE LAID ADJACENT TO THE PROPOSED SIDEWALK, WITHIN DISTURBED AREAS, AND AS SHOWN IN THESE PLANS. THE ENGINEER SHALL DETERMINE FINAL LOCATIONS FOR THE PLACEMENT OF PROPOSED SODDING (TYPICAL FOR EACH LOCATION).
SAWCUTS NECESSARY FOR SIDEWALK, DRIVEWAY, CONCRETE CURB & GUTTER, AND PAVEMENT REMOVAL ARE INCLUDED IN THE PAY ITEM COSTS FOR REMOVAL OF THE ASSOCIATED ITEM. THE ENGINEER SHALL INSURE THAT ALL PROPOSED SIDEWALK WORK

ADHERE TO THE POLICIES ESTABLISHED WITHIN HIGHWAY STANDARDS #424001, #424006, #424011, AND #424021 FOR SIDEWALK CONSTRUCTION.

SHEET 23

SCALE: 1" = 10'-0"

FILE NAME =	USER NAME = Verenskifa	DESIGNED - RTS	REVISED -	
pw:\\IL084EBIDINTEG.:1ll:no:s.gov:PWIDOT\Do	cuments\IDOT Offices\District 6\Projects\D67	202RAWNData\GADsheRT&1 Sidewalks.dgn	REVISED -	STATE OF
	PLOT SCALE = 10.0000 '/ in.	CHECKED -	REVISED -	DEPARTMENT OF

- 10-09-2015


REVISED

DATE

STATE OF ILLINOIS MENT OF TRANSPORTATION	
	SCALE:

•- 310A, 753 • 23BR, RS6, TS-5; 33BR-1, RS4, TS-2									
SIDEWALK DETAILS	F.A.P RTE.	P. SECTION		COUNTY	TOTAL SHEETS	SHEET NO.			
	•	••		MORGAN	366	165			
1				CONTRACT	NO. 7	'2D21			
OF 27 SHEETS STA.	TO STA.	ILLINO	IS FED. AID P	ROJECT					

MORTON AVE. / CLAY STREET SOUTHEAST QUADRANT MORTON AVE. / CLAY STREET MORTON AVENUE SOUTHWEST QUADRANT MORTON AVENUE 311+07.48 37.15′ RT 311+05.83 37.15′ RT 311+23.89 312+27.97 312+27.72 312+38.67 39**.**43′ RT 39.19' RT /46.09′ RT 41.39' RT LANDING AREA 312+22.89 41.56′ RT\ EXIST. 41**.**91′ RT SIDEWALK 000000 STOEWALK 312+18.13 50.66′ RT SURFACE ELEVATION OF PROPOSED EX. R.O.W. LANDING AREA SHALL MATCH CONCRETE LID ELEVATION OF EXISTING INLET 312+40.35 312+29.00 45.04′ RT 312+06.57 54.67′ RT 311+42.40 312+27.77 50.74′ RT 55.01′ RT 311+23.24 46.88' RT STREET 312+22.64 LANDING LANDING 311+27.63 54.04′ RT 48.62' RT AREA CROSS WALK AREA CROSS 312+14.91 311+28.51 55.08' RT WALK 54.62' RT PROPOSED 6" SIDEWALK CURBING, TOP OF CURB SHALL MATCH EXIST. 312+03.35 311+45.26 59.68' RT 311+31.18 59.99' RT 61.46' RT LOT IN ELEVATION. COSTS INCLUDED 312+10.42 WITH PCC SIDEWALK, 4". 59.65' RT \<u>312+13.92</u> 63.84′ RT 39+32.48 311+34.69 27.59' RT (CLAY ST.) LIST OF MATERIALS LIST OF MATERIALS 39+29.49 (SIDEWALK 80%FED/20% STATE FUNDING) (SIDEWALK 80%FED/20% STATE FUNDING) 30.98' RT COMB. C&G REMOVAL = 35.9 FT COMB. C&G REMOVAL = 37.0 FT (CLAY ST.) SIDEWALK REMOVAL = 336.0 SQ FT SIDEWALK REMOVAL = 221.5 SQ FT # = RAMP SLOPE EARTH EXCAVATION = 0.80 CU YD EARTH EXCAVATION = 0.25 CU YD 8.33% MAX COMB. CONC. C&G, TY B 6.24 = 37.0 FT COMB. CONC. C&G, TY B 6.24 = 35.9 FT P.C.C. SIDEWALK, 4" = 311.6 SQ FT CONCRETE MEDIAN SURFACE, 4" = SQ FT DETECTABLE WARNINGS = 20.0 SQ FT P.C.C. SIDEWALK, 4" = 335.5 SQ FT DETECTABLE WARNINGS = 20.0 SQ FT SODDING = 14.0 SQ YD EMBANKMENT = 0.50 CU YD SODDING = 43.0 SQ YD

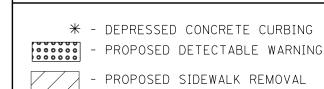

PROPOSED COMB. C&G REMOVAL

KXX

- PROPOSED CONCRETE MEDIAN SURFACE REMOVAL

LEGEND



- PROPOSED CONCRETE SIGNAL FOUNDATION



PROPOSED HANDHOLE



- PROPOSED PEDESTRIAN PUSH BUTTON POST



- PROPOSED TRAFFIC SIGNAL CONTROL BOX



- PROPOSED SODDING

NOTES


PROPOSED SODDING SHALL BE LAID ADJACENT TO THE PROPOSED SIDEWALK, WITHIN DISTURBED AREAS, AND AS SHOWN IN THESE PLANS. THE ENGINEER SHALL DETERMINE FINAL LOCATIONS FOR THE PLACEMENT OF PROPOSED SODDING (TYPICAL FOR EACH LOCATION). SAWCUTS NECESSARY FOR SIDEWALK, DRIVEWAY, CONCRETE CURB & GUTTER, AND PAVEMENT REMOVAL ARE INCLUDED IN THE PAY ITEM COSTS FOR REMOVAL OF THE ASSOCIATED ITEM.


THE ENGINEER SHALL INSURE THAT ALL PROPOSED SIDEWALK WORK ADHERE TO THE POLICIES ESTABLISHED WITHIN HIGHWAY STANDARDS #424001. #424006. #424011. AND #424021 FOR SIDEWALK CONSTRUCTION.


									•- 310A, ••- 23BR,	53 RS6, TS-5; 3	33BR-1, RS4,	S-2
FILE NAME =	USER NAME = Verenskifa	DESIGNED - RTS	REVISED -			SIDEWALK DETAILS		F.A.P.	SECTION	COUNTY	TOTAL SH	ĒΤ
pw:\\IL084EBIDINTEG.:111:nois.gov:PWIDOT\Do	cuments\IDOT Offices\District 6\Projects\D6	572 C2RACWN Data\GADshe R T S \1 Sidewalks.dgn	REVISED -	STATE OF ILLINOIS		SIDEWALK DETAILS		•	••	MORGAN	366 I	66
	PLOT SCALE = 10.0000 '/ in.	CHECKED -	REVISED -	DEPARTMENT OF TRANSPORTATION						CONTRAC	CT NO. 72D	21
Default	PLOT DATE = 1/28/2016	DATE - 10-09-2015	REVISED -		SCALE.	SHEET 24 OF 27 SHEETS STA	TO STA		TILL THOSE FED. AT			

MORTON AVE. / GOLTRA AVENUE NORTHWEST QUADRANT Ġ 316+18.38 316+23.40 59.33′ L 57**.**67′ L⁻ 316+18.48 51.97' LT 316+23.50 50.48′ L1 316+16.03 51.00' L PROPOSED 6" SIDEWALK CURBING, TOP OF CURB SHALL MATCH EXIST. LOT IN ELEVATION. COSTS INCLUDED WITH PCC SIDEWALK, 4". LIST OF MATERIALS 316+13.90 316+06.86 36.24′ LT (SIDEWALK 80%FED/20% STATE 35.62′ LT FUNDING) 316+19.64 316+03.00 35**.**17′ LT COMB. C&G REMOVAL = 15.7 FT 37.30′ LT SIDEWALK REMOVAL = 210.3 SQ FT DRIVEWAY PAVEMENT REMOVAL = 3.0 SQ YD AVE, EARTH EXCAVATION = 0.40 CU YD COMB. CONC. C&G, TY B 6.24 = 15.7 FT EXIST. CROSS P.C.C. SIDEWALK, 4" = 230.8 SQ FT SIDEWALK WALK GOLTRA DETECTABLE WARNINGS = 14.6 SQ FT EMBANKMENT = 0.35 CU YD SODDING = 14.6 SQ YD <u>316+14.4</u>3 35.30′ L1 316+01.17 35**.**19′ LT 316+11.90 30.35′ LT 316+01.17 30.48′ L1 MORTON AVENUE = RAMP SLOPE 8.33% MAX

MORTON AVE. / GOLTRA AVENUE NORTHEAST QUADRANT

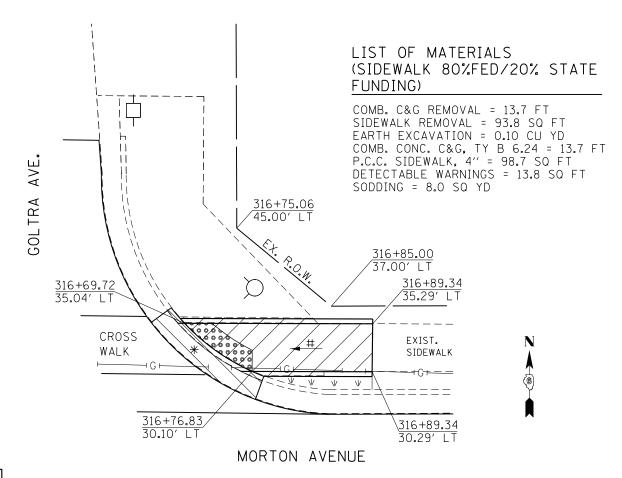

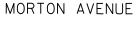

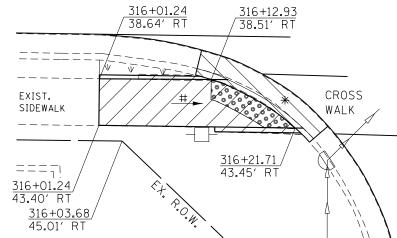

LIST OF MATERIALS (SIDEWALK 80%FED/20% STATE FUNDING)


COMB. C&G REMOVAL = 15.6 FT SIDEWALK REMOVAL = 91.3 SQ FT COMB. CONC. C&G, TY B 6.24 = 15.6 FT P.C.C. SIDEWALK, 4" = 90.6 SQ FT DETECTABLE WARNINGS = 16.5 SQ FT SODDING = 8.0 SQ YD

SOLTRA

MORTON AVE. / GOLTRA AVENUE SOUTHWEST QUADRANT

LIST OF MATERIALS (SIDEWALK 80%FED/20% STATE FUNDING)

COMB. C&G REMOVAL = 14.7 FT SIDEWALK REMOVAL = 58.8 SQ FT EARTH EXCAVATION = 0.20 CU YD COMB. CONC. C&G, TY B 6.24 = 14.7 FT P.C.C. SIDEWALK, 4" = 70.4 SQ FT DETECTABLE WARNINGS = 12.5 SQ FT SODDING = 6.7 SQ YD

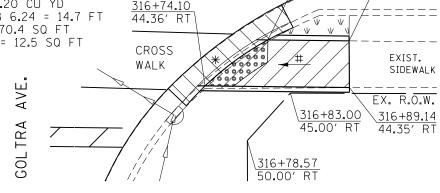

MORTON AVE. / GOLTRA AVENUE SOUTHEAST QUADRANT

SCALE: 1" = 10'-0"

		••- 23BR,		33BR-1, RS4, TS-2
SIDEWALK DETAILS	F.A.P. RTE.	SECTION	COUNTY	TOTAL SHEET SHEETS NO.

FILE NAME = DESIGNED - RTS REVISED USER NAME = Verenskifa w:\\ILØ84EBIDINTEG.:111:no ments\IDOT Offices\District 6\Projects\D67202RAUMNData\GADsheR-Ts\1 Sidewalks.dgn REVISED PLOT SCALE = 10.0000 '/ in. CHECKED REVISED PLOT DATE = 1/28/2016 REVISED DATE

STATE OF ILLINOIS **DEPARTMENT OF TRANSPORTATION**

SCALE: SHEET 25 OF 27 SHEETS STA. TO STA.

MORGAN 366 167 CONTRACT NO. 72D21

•- 310A 753


MORTON AVENUE

316+89.06

/39.48' RT

316+80.60

39.48' RT

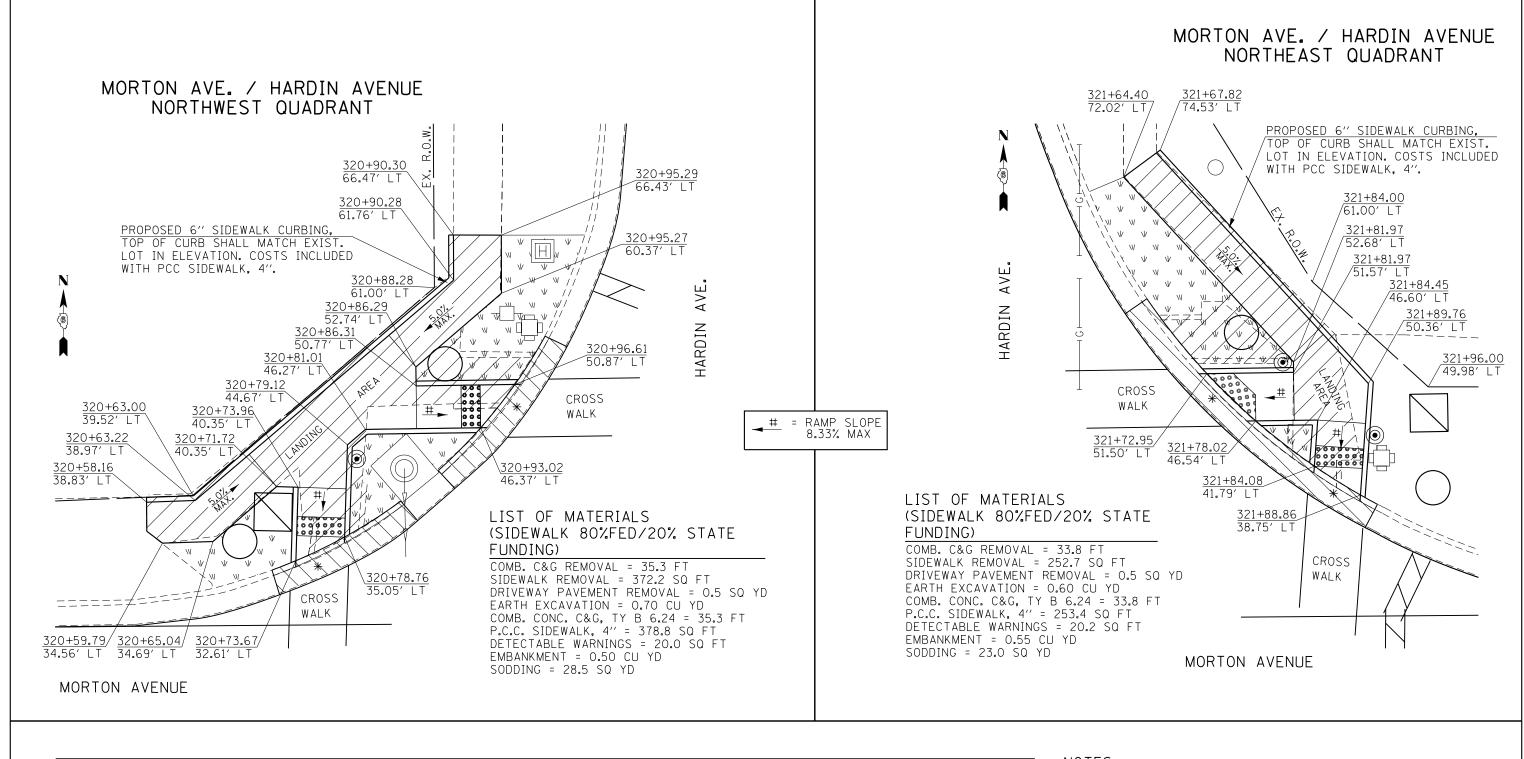



* - DEPRESSED CONCRETE CURBING



- PROPOSED DETECTABLE WARNING



PROPOSED SIDEWALK REMOVAL



PROPOSED COMB. C&G REMOVAL



PROPOSED CONCRETE MEDIAN SURFACE REMOVAL



PROPOSED CONCRETE SIGNAL FOUNDATION



PROPOSED HANDHOLE



- PROPOSED PEDESTRIAN PUSH BUTTON POST



PROPOSED TRAFFIC SIGNAL CONTROL BOX




- PROPOSED SODDING

PROPOSED SODDING SHALL BE LAID ADJACENT TO THE PROPOSED SIDEWALK, WITHIN DISTURBED AREAS, AND AS SHOWN IN THESE PLANS. THE ENGINEER SHALL DETERMINE FINAL LOCATIONS FOR THE PLACEMENT OF PROPOSED SODDING (TYPICAL FOR EACH LOCATION). SAWCUTS NECESSARY FOR SIDEWALK, DRIVEWAY, CONCRETE CURB & GUTTER, AND PAVEMENT REMOVAL ARE INCLUDED IN THE PAY ITEM COSTS FOR REMOVAL OF THE ASSOCIATED ITEM.

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•- 310A, 753

									••- ?	∠3BR, RS6, TS-5; 33BR-	1, RS4, TS-2
FILE NAME =	USER NAME = Verenskifa	DESIGNED - RTS	REVISED -			SIDEWALK DETAILS		F.A.P.	SECTION	COUNTY TO	TAL SHEET
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	PLOT SCALE = 10.0000 '/ in.	CHECKED -	REVISED -	DEPARTMENT OF TRANSPORTATION						CONTRACT N	NO. 72D21
Default	PLOT DATE = 1/28/2016	DATE - 10-09-2015	REVISED -		SCALE:	SHEET 26 OF 27 SHEETS STA.	TO STA.		ILL INDIS F	FD. AID PROJECT	



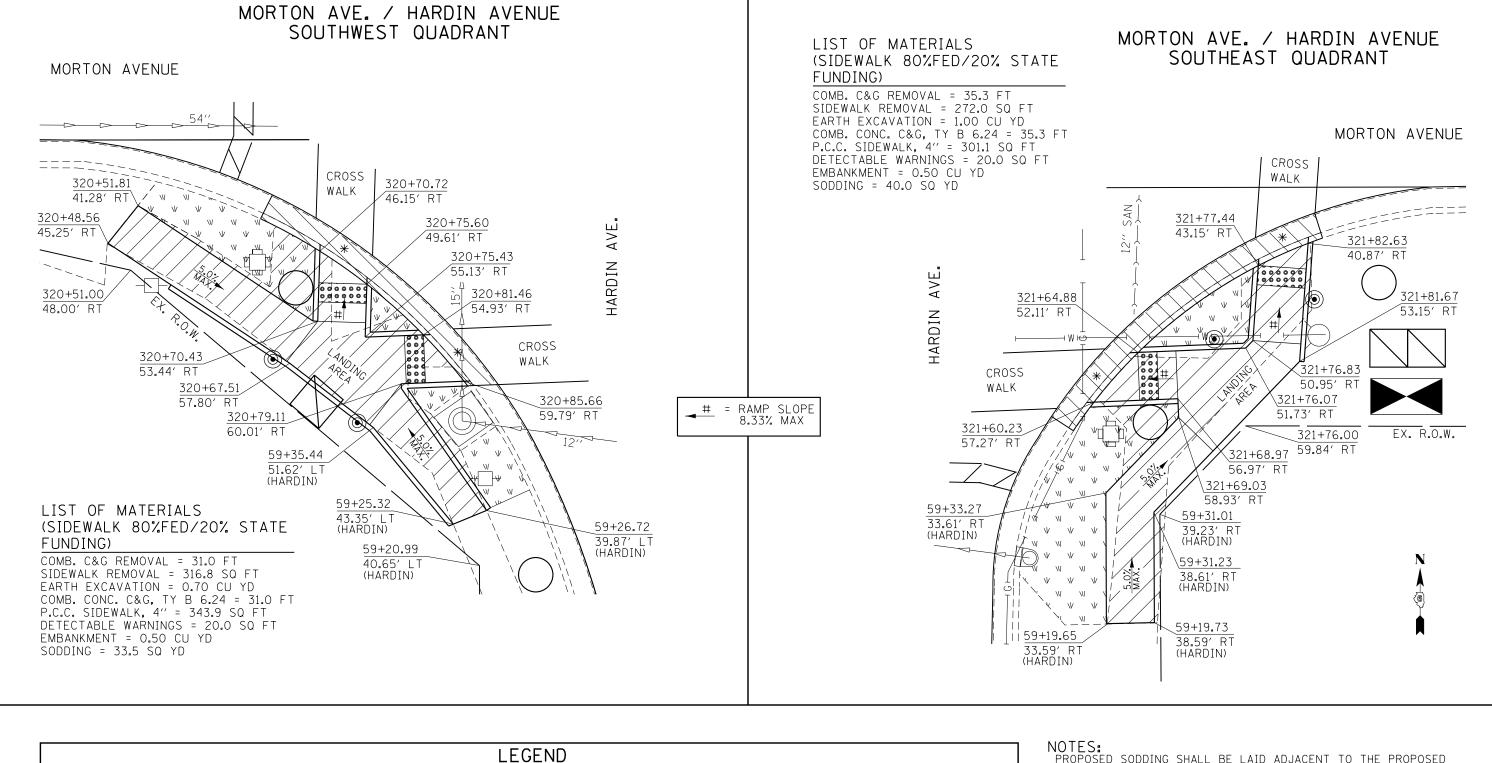

* - DEPRESSED CONCRETE CURBING



- PROPOSED DETECTABLE WARNING



PROPOSED SIDEWALK REMOVAL



PROPOSED COMB. C&G REMOVAL



PROPOSED CONCRETE MEDIAN SURFACE REMOVAL



PROPOSED CONCRETE SIGNAL FOUNDATION



PROPOSED HANDHOLE



- PROPOSED PEDESTRIAN PUSH BUTTON POST



PROPOSED TRAFFIC SIGNAL CONTROL BOX



- PROPOSED SODDING

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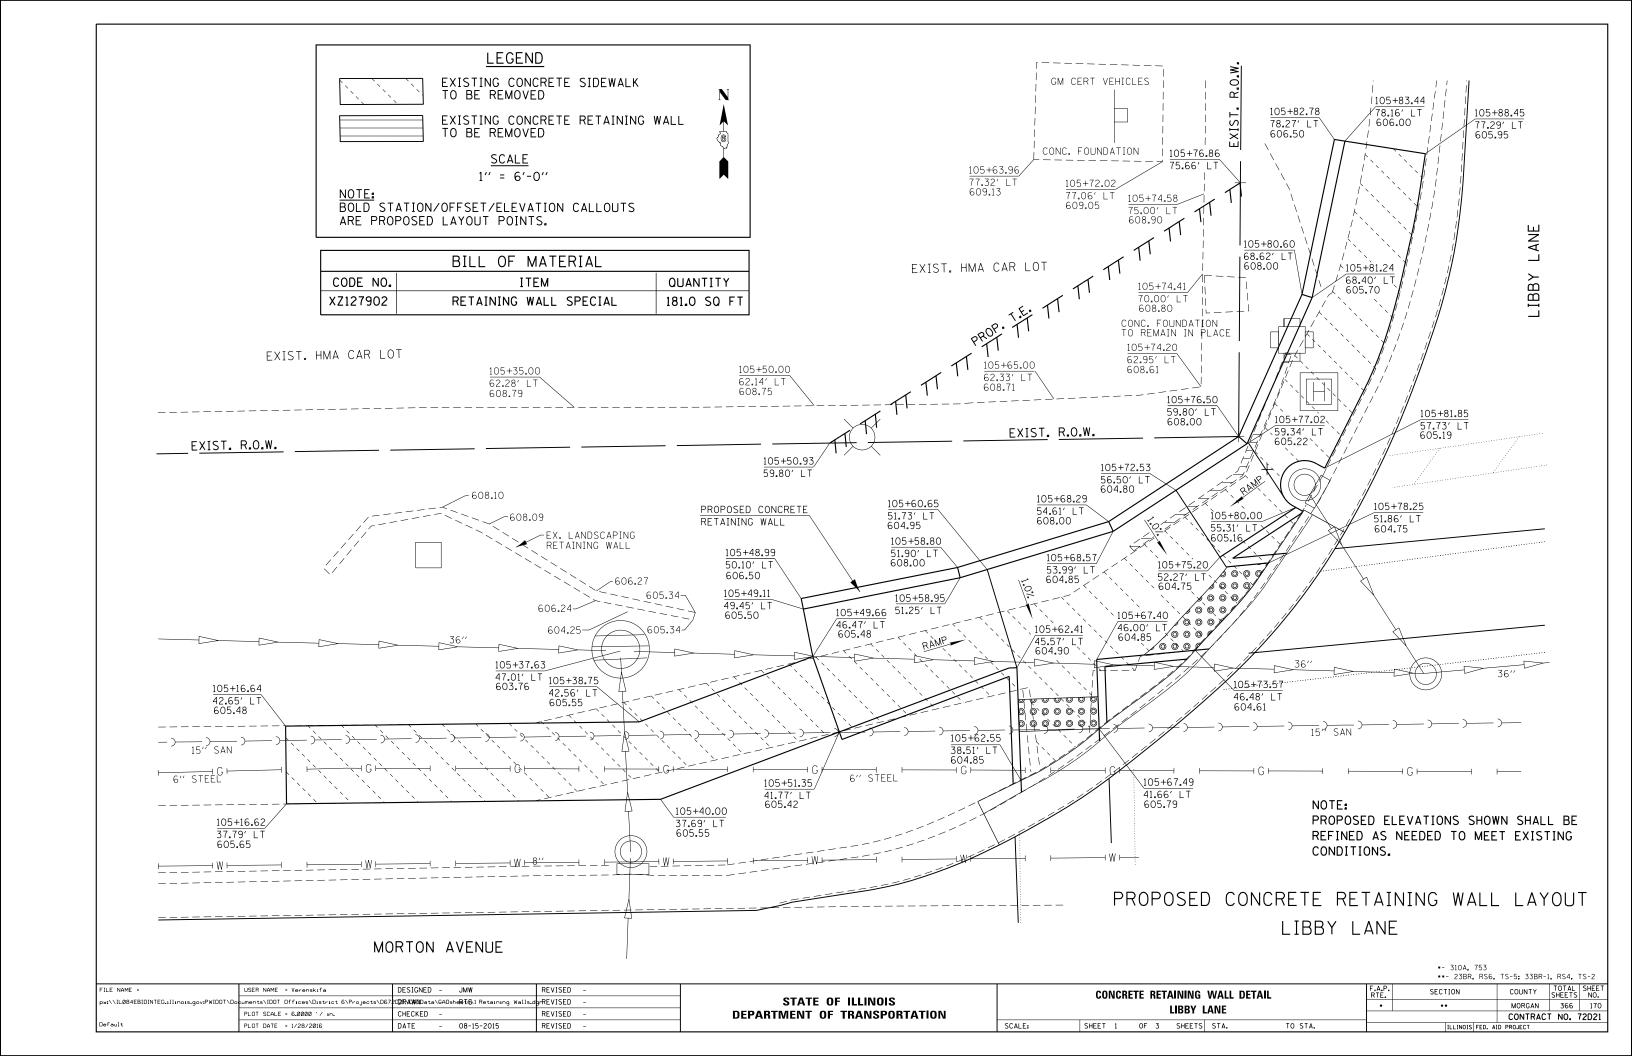
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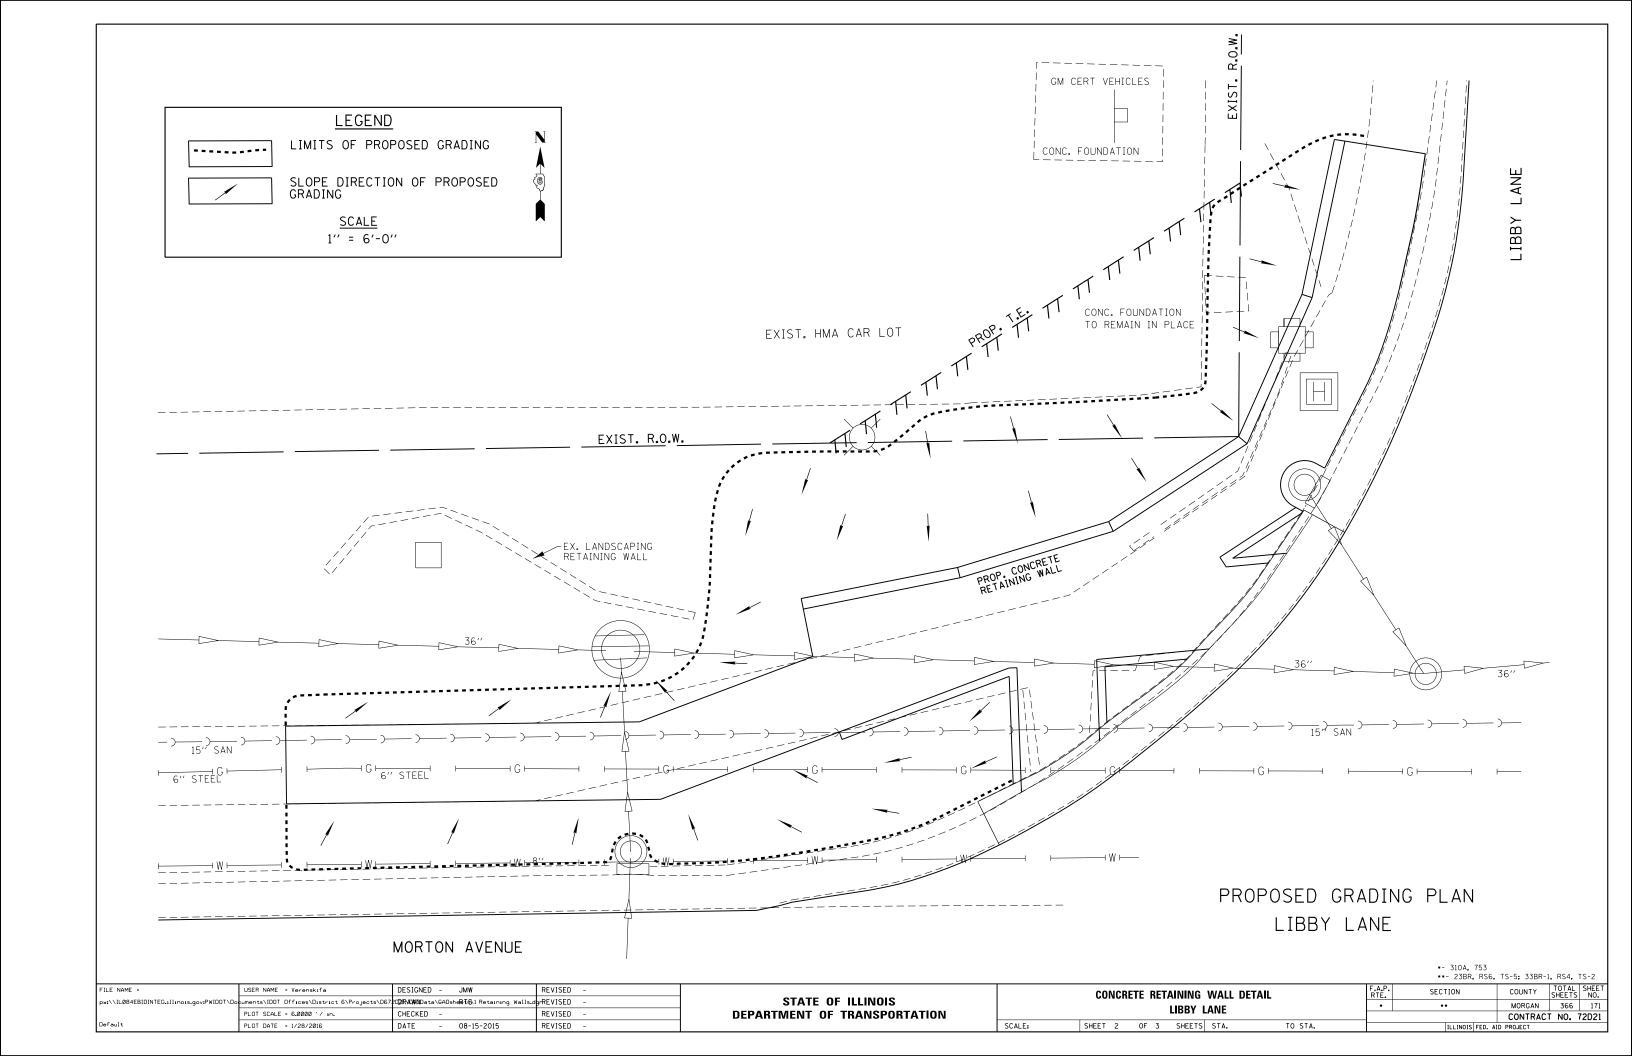
•- 310A, ••- 23BR	753 . RS6, TS-5; 33		
SECTION	COUNTY	TOTAL SHEETS	SHEET NO.
••	MORGAN	366	169
	CONTRAC	T NO.	72D21


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	PLOT SCALE = 10.0000 '/ in.	CHECKED -	REVISED -
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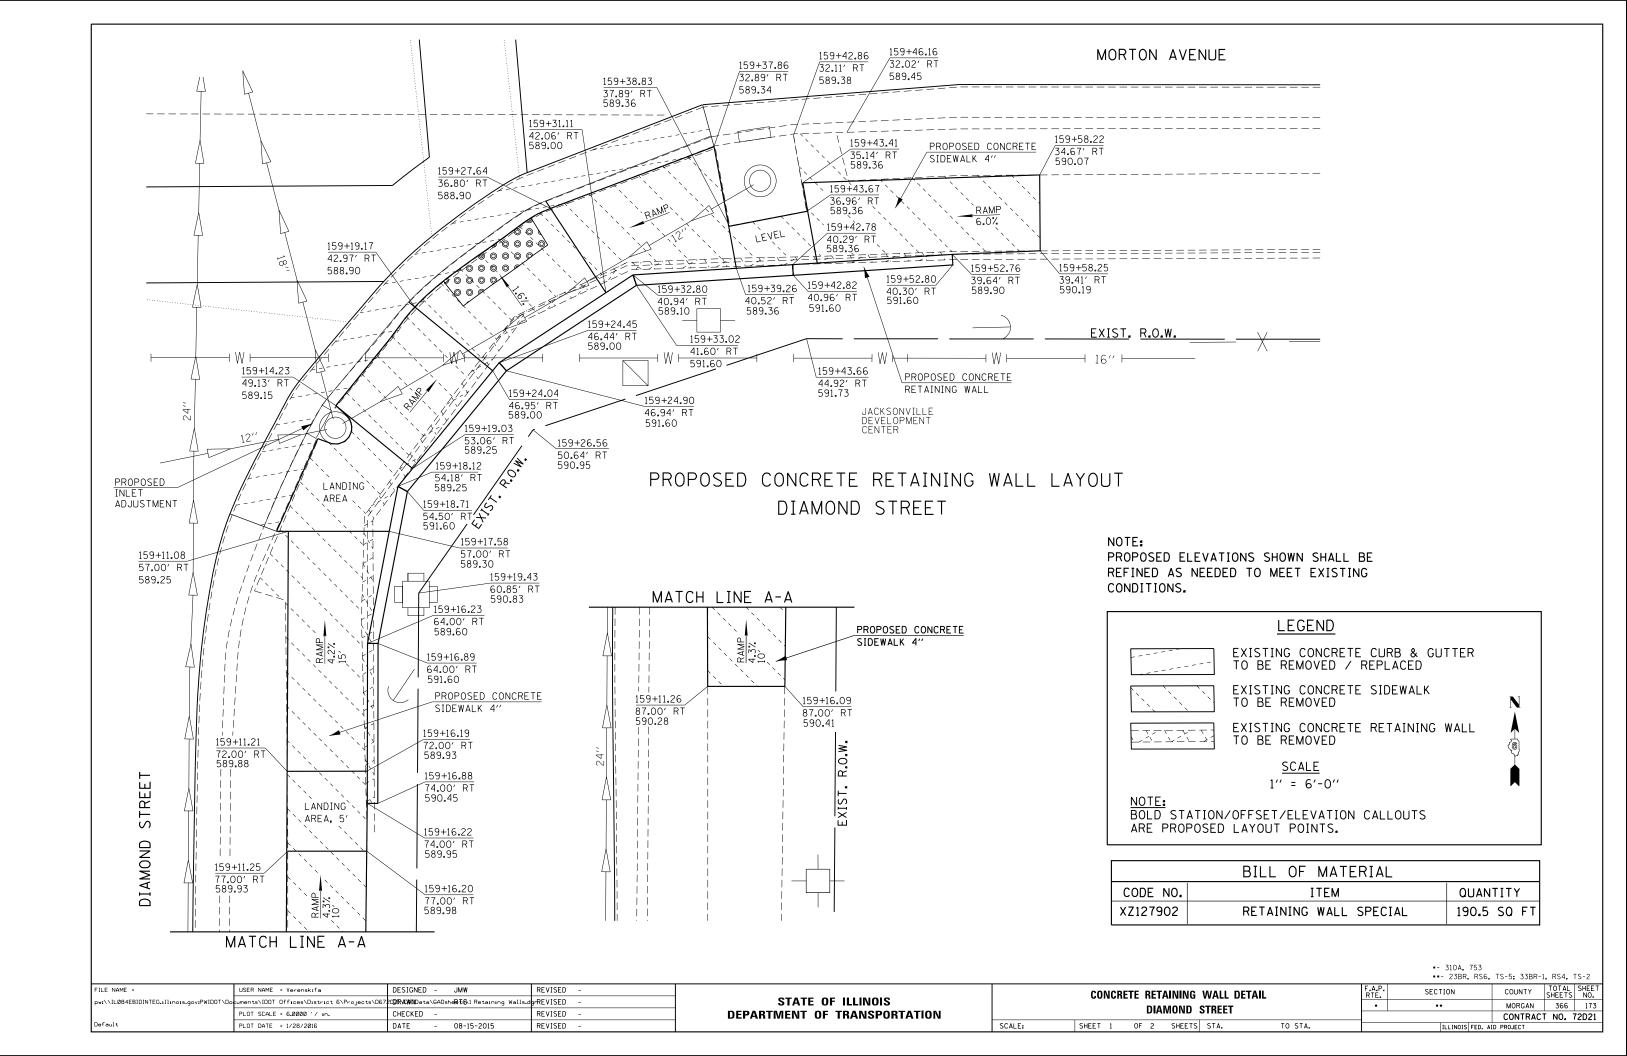
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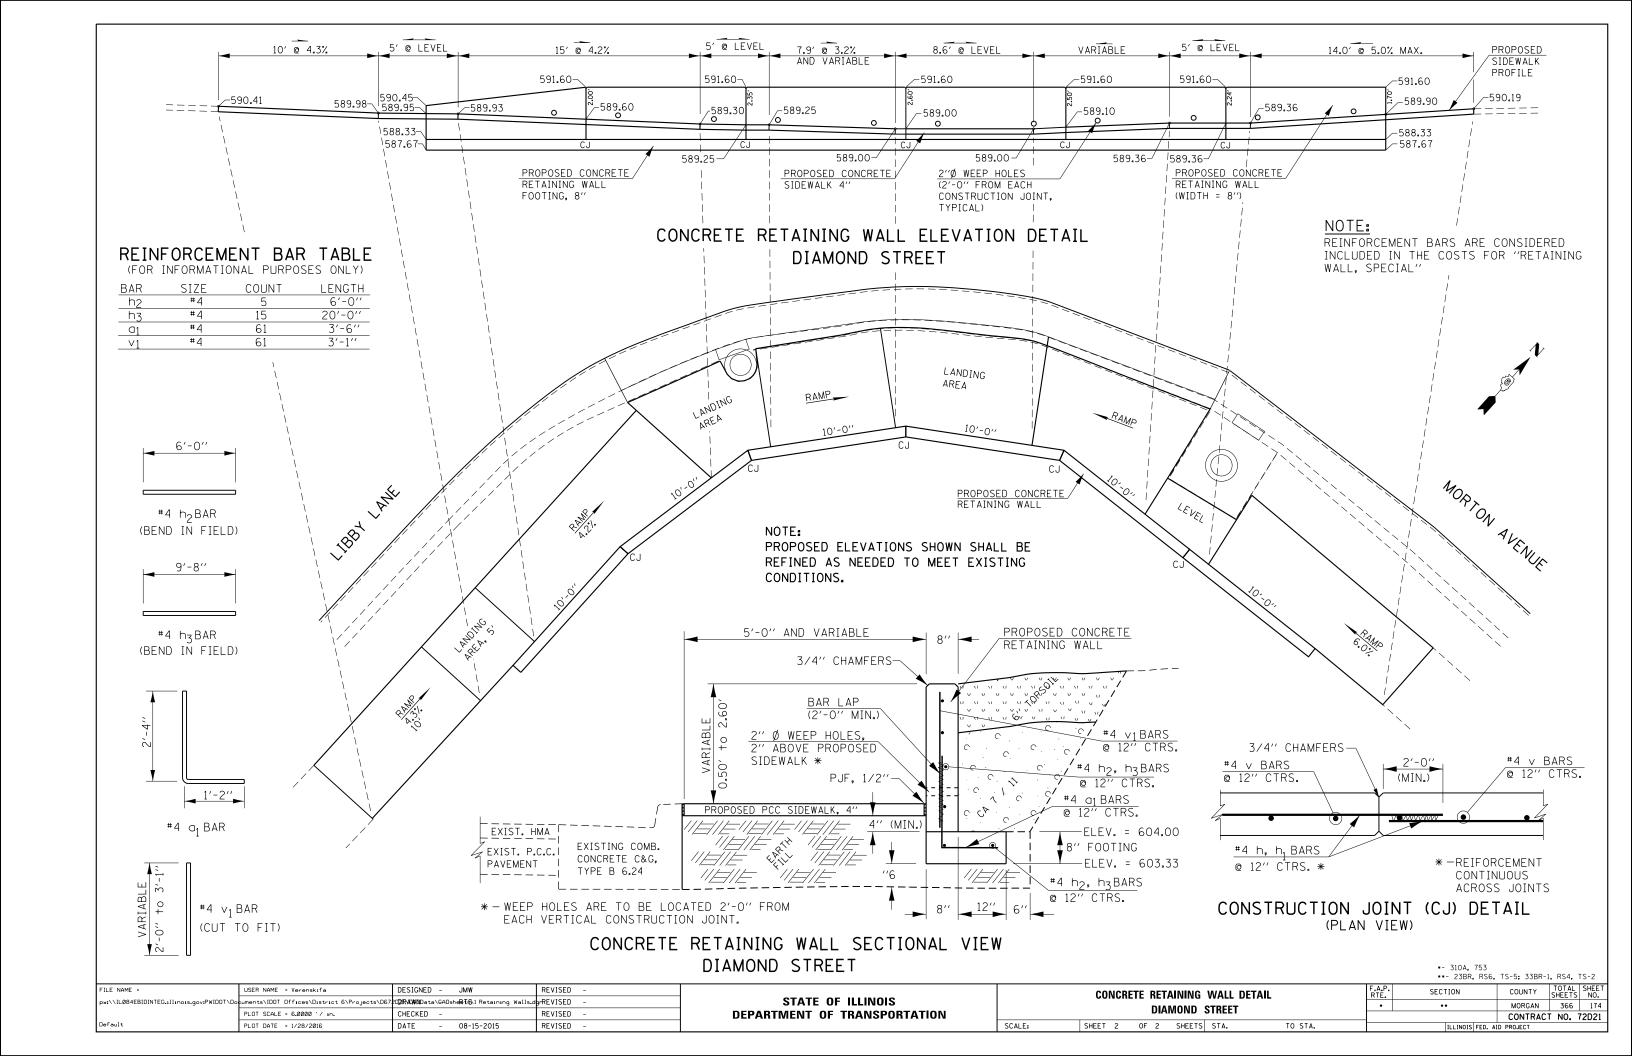
SIDEWALK DETAILS							F.A.P. RTE.	SECTION	COUNT		
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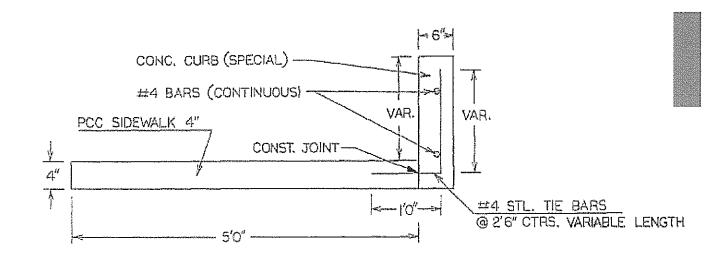












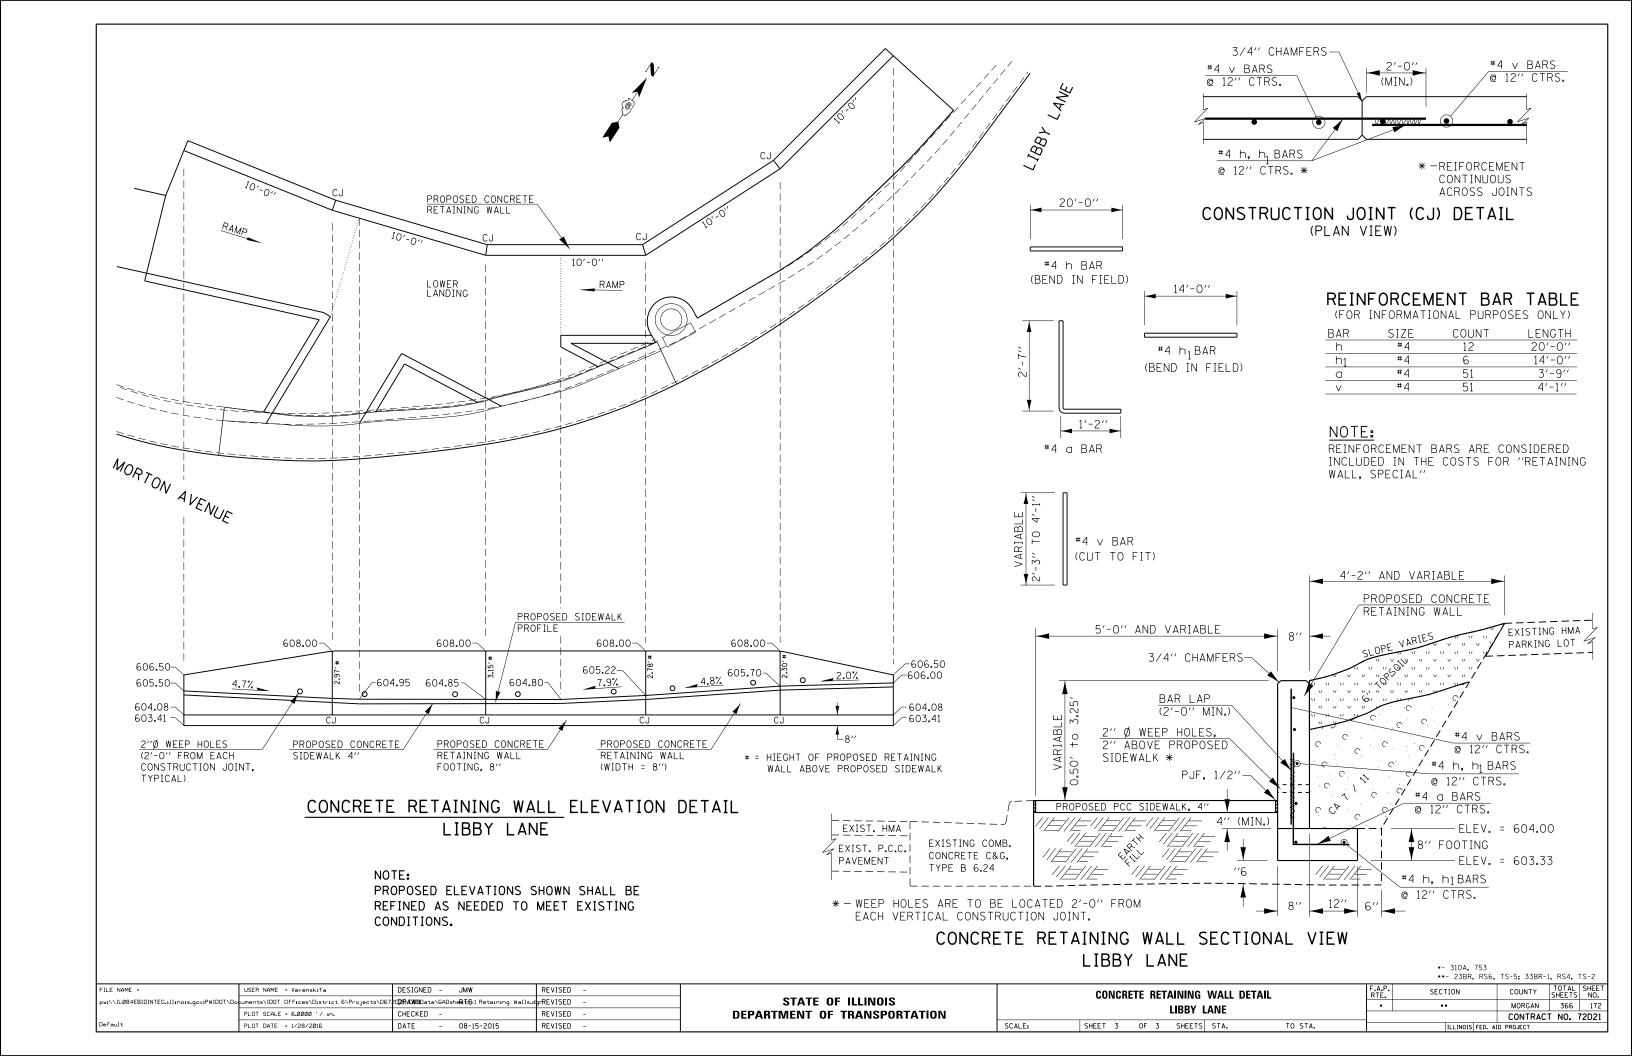

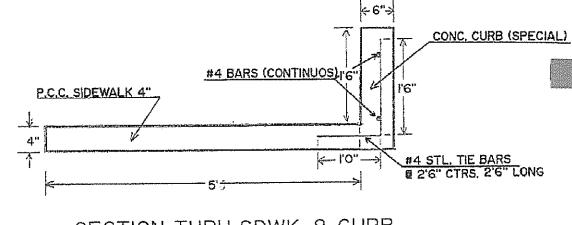


SECTION THRU SDWK. & CURB

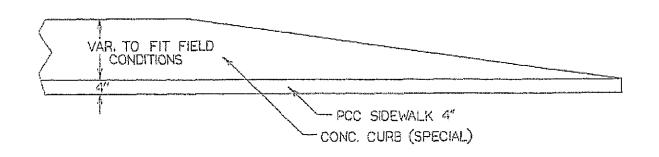

EXISTING CONCRETE RETAINING WALL DETAILS MORTON AVE. & LIBBY LANE

(ILLUSTRATIONS TAKEN FROM SECTION 23W-2, RS-5, TS-4)

	BILL OF MATERIAL	
CODE NO.	ITEM	OUANTITY
Z0075498	CONCRETE RETAINING WALL REMOVAL	16.5 FEET

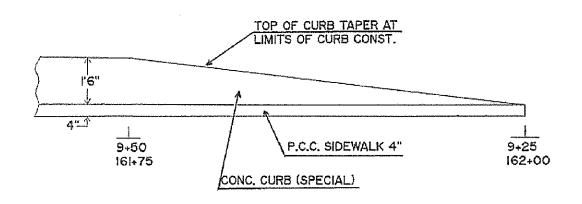


EXISTING CONCRETE RETAINING WALL DETAILS MORTON AVE. & DIAMOND STREET


(ILLUSTRATIONS TAKEN FROM SECTION 23(RS-4, TS-3)

	BILL OF MATERIAL	
CODE NO.	ITEM	QUANTITY
Z0075498	CONCRETE RETAINING WALL REMOVAL	63.8 FEET

-- 310A, 753 --- 23BR, RSG, TS-5; 33BR-1, RS4, TS-2

FILE NAME *	USER NAME * Slaglert	DESIGNED - JMW	REVISED -			EXIST. RETAINING WALL DETAILS	F.A.P. SECTION	COUNTY TOTAL SHEET
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	PLOT SCALE = 6.0000 '/ in.	CHECKEO -	REVISED -	DEPARTMENT OF TRANSPORTATION			1	CONTRACT NO. 72D21
Omfault	PLOT DATE : 12/9/2015	DATE - 09-15	5-ZD15 REVISED -		SCALE:	SHEET 1 OF 1 SHEETS STA. TO STA.	ILCINOIS FED	AID PROJECT

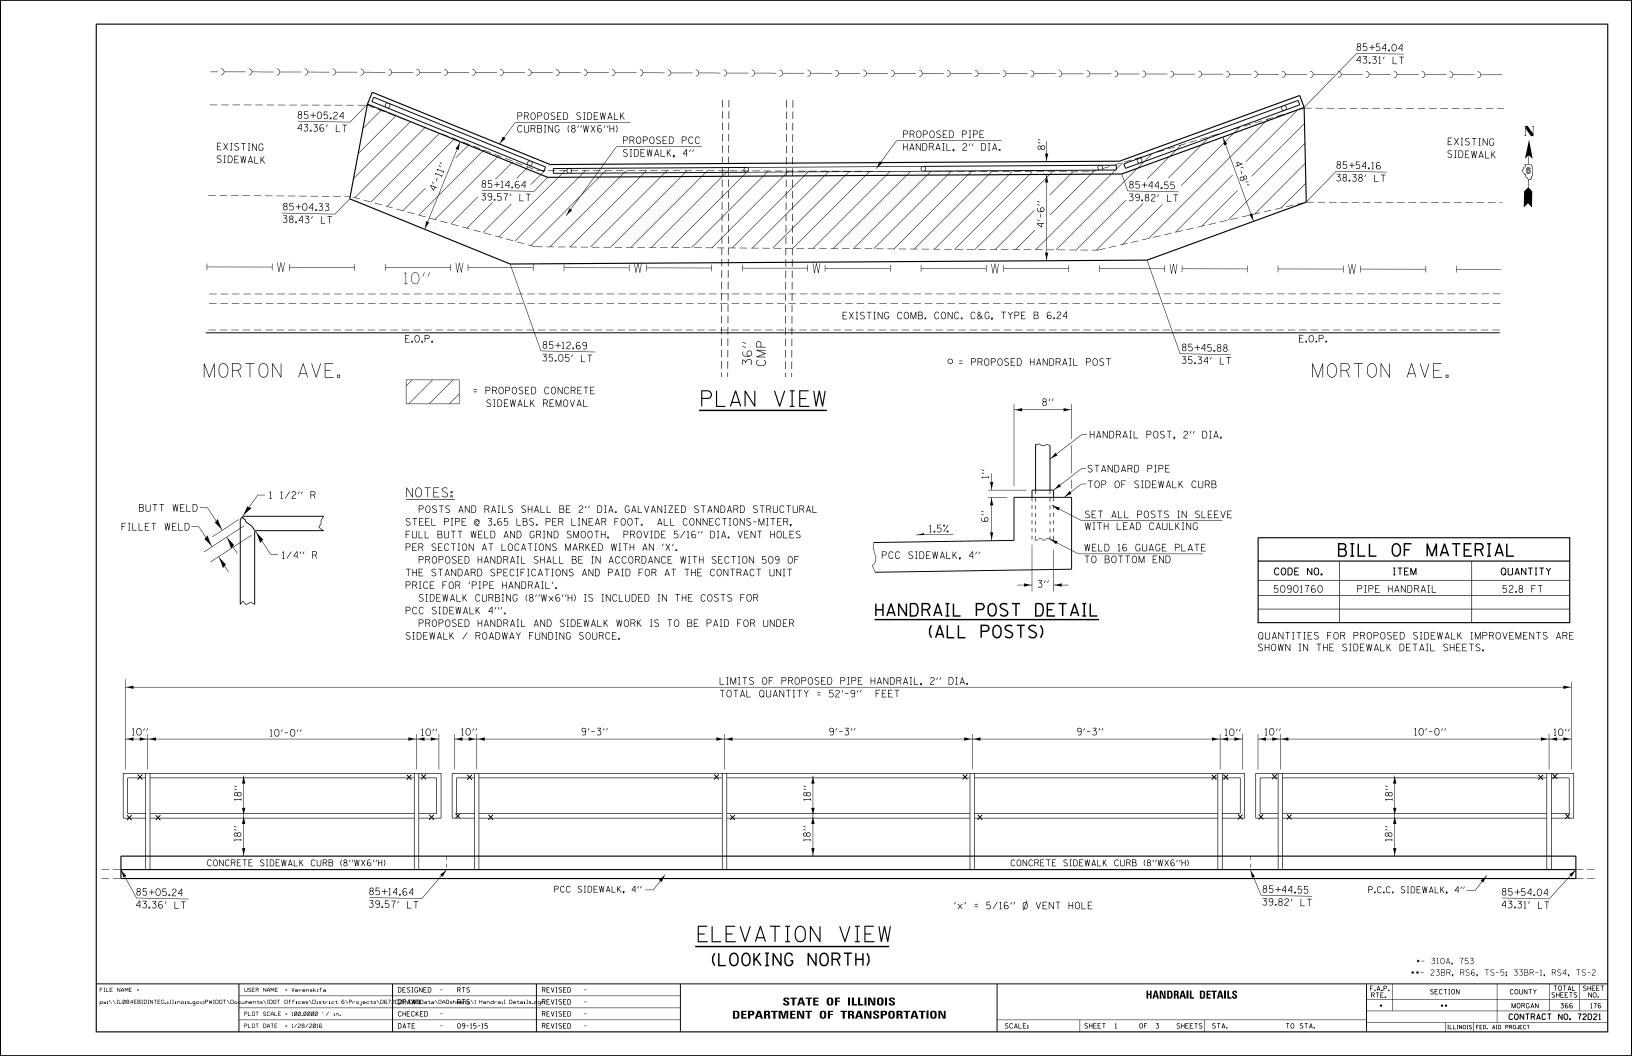

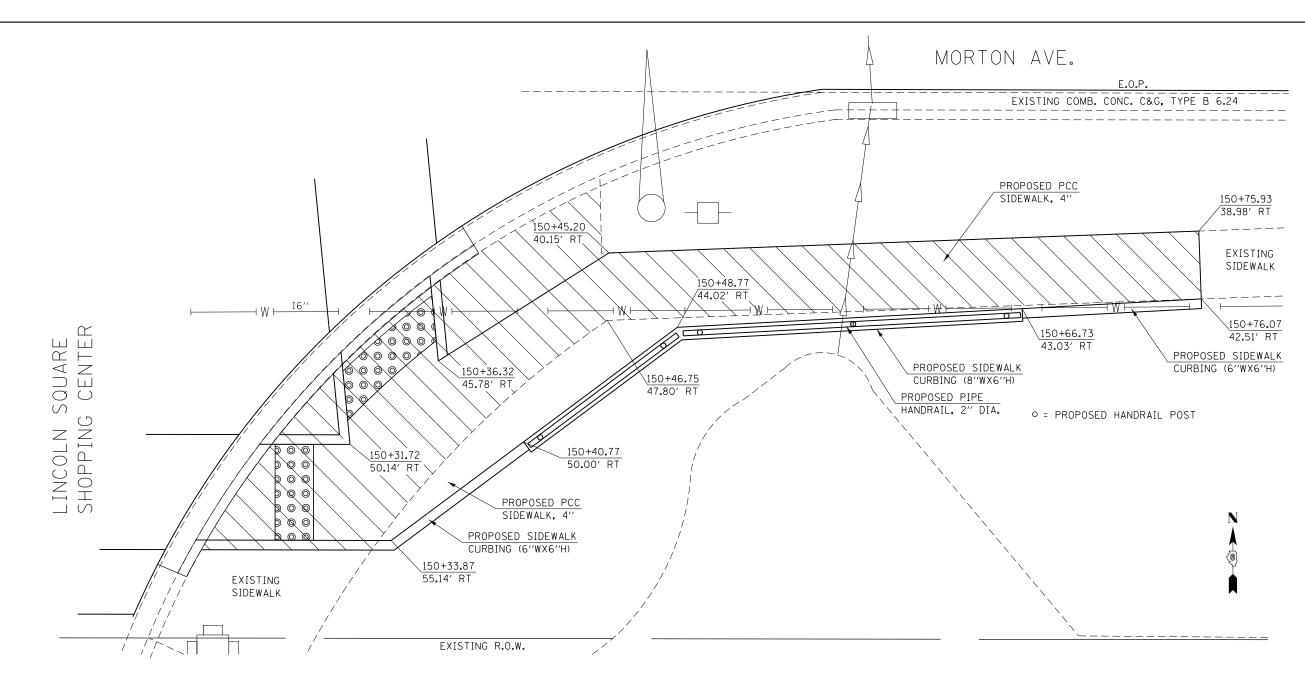

PLAN VIEW

MORTON AVE. / LINCOLN SQ. SHOPPING CTR., S.E. QUADRANT



= PROPOSED CONCRETE SIDEWALK REMOVAL

NOTES:

POSTS AND RAILS SHALL BE 2" DIA. GALVANIZED STANDARD STRUCTURAL STEEL PIPE @ 3.65 LBS. PER LINEAR FOOT. ALL CONNECTIONS-MITER, FULL BUTT WELD AND GRIND SMOOTH. PROVIDE 5/16" DIA. VENT HOLES PER SECTION AT LOCATIONS MARKED WITH AN 'X'.

PROPOSED HANDRAIL SHALL BE IN ACCORDANCE WITH SECTION 509 OF THE STANDARD SPECIFICATIONS AND PAID FOR AT THE CONTRACT UNIT PRICE FOR 'PIPE HANDRAIL'.

SIDEWALK CURBING (8"Wx6"H) IS INCLUDED IN THE COSTS FOR PCC SIDEWALK 4"".

PROPOSED HANDRAIL AND SIDEWALK WORK IS TO BE PAID FOR UNDER SIDEWALK / ROADWAY FUNDING SOURCE.


	BILL OF MATE	RIAL
CODE NO.	ITEM	QUANTITY
50901760	PIPE HANDRAIL	27.3 FT

QUANTITIES FOR PROPOSED SIDEWALK IMPROVEMENTS ARE SHOWN IN THE SIDEWALK DETAIL SHEETS.

*- 310A, 753


**- 23BR, RS6, TS-5; 33BR-1, RS4, TS-2


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ELEVATION VIEW

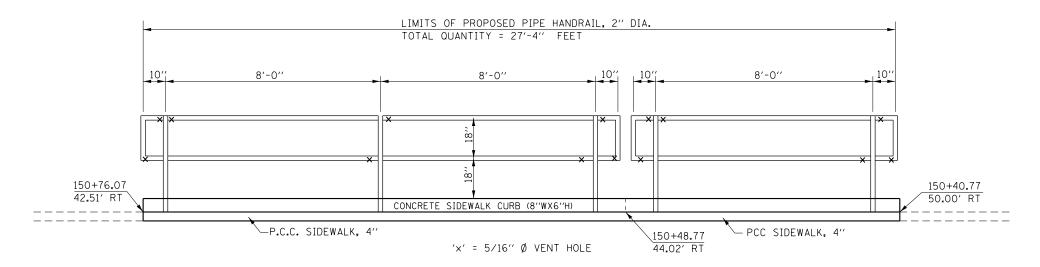MORTON AVE. / LINCOLN SQ. SHOPPING CTR., S.E. QUADRANT (LOOKING SOUTH)




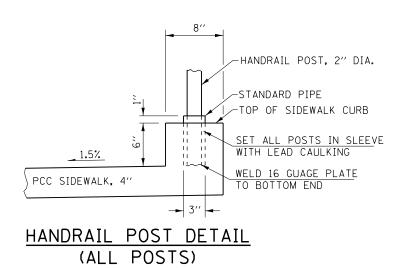

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pw:\\ILØ84EBIDINTEG.:llinois.gov:PWIDOT\Do	cuments\IDOT Offices\District 6\Projects\D6	COMMOData\CADsh@d\\$\1 Handrail Details.	gREVISED -	STATE OF ILLINOIS		HANDIAL DETAILS		•	••	MORGAN 366 178
	PLOT SCALE = 100.0000 ' / in.	CHECKED -	REVISED -	DEPARTMENT OF TRANSPORTATION				·		CONTRACT NO. 72D21
	PLOT DATE = 1/28/2016	DATE - 09-15-15	REVISED -		SCALE:	SHEET 3 OF 3 SHEETS STA.	TO STA.		ILLINOIS FED.	AID PROJECT

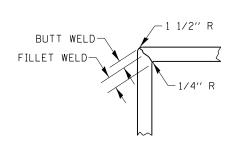EXISTING STRUCTURE

The existing structure (S.N. 069-0007) was constructed in 1952 as FA Rte. 10 (US 36), Section 23-X-B. The original structure consisted of a 16.5" concrete deck slab depth with closed abutments. In 1981, the structure was widened with 18" depth concrete slabs, sidewalks, and parapet walls/handralls on both sides of the structure. In 1993, the deck's microsilica concrete overlay was installed. The existing structure has an overall length of 32'-6" back-to-back of abutments, an overall width of 78'-0" out-to-out of parapet walls, and a roadway width of 66'-0" face-to-face of sidewalk curbs.

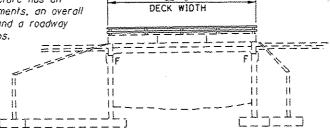

- <u>SCOPE OF WORK</u>
 Set up Staged Traffic Control as detailed in these plans. East and west bound traffic routed onto the outside lanes across the structure for Stage One, onto the inside lanes across the structure for Stage Two. Drums with warning lights shall be used in lieu of temporary concrete
- Remove the existing bridge deck micro-silica overlay by both milling and hydroscarifying operations within the designated work area for each stage of traffic control.
- Perform full depth patching within the designated work area for each stage of traffic control. Open bridge deck holes shall be temporarily covered with approved steel plating wherever necessary.
- Install proposed micro-silica overlay across the structure, within the designated work area for each stage of traffic control.


GENERAL NOTES


Plan dimensions and details relative to existing plans are subject to nominal construction variations. The contractor shall field verify existing dimensions and details affecting new construction and make necessary approved adjustments prior to construction or ordering of materials. Such variations shall not be cause for additional compensation for a change in scope of the work, however, the Contractor will be paid for the quantity actually furnished based at the unit price bid for the work.

Care shall be exercized by the Contractor during and following removal operations to ensure that the existing rebar remaining in place are not damaged. Any reinforcement bars that are damaged during concrete removal shall be replaced with rebar of similar size and characteristics as well as an approved bar splicer or anchoring system. Costs for this work shall be included in the costs for "Deck Slab Repair (Full Depth, Type I or II)".

Full depth patching locations are to be covered by steel plating or by another method approved by the Engineer. The full depth patches shall remain covered, when construction activities do not interfere, until patching material is in place and has reached sufficient strength. This work will be considered included in the costs for "Deck Slab Repair (Full Depth, Type I and Type II)". Reinforcement bars designated (E) shall be epoxy coated.

ELEVATION VIEW

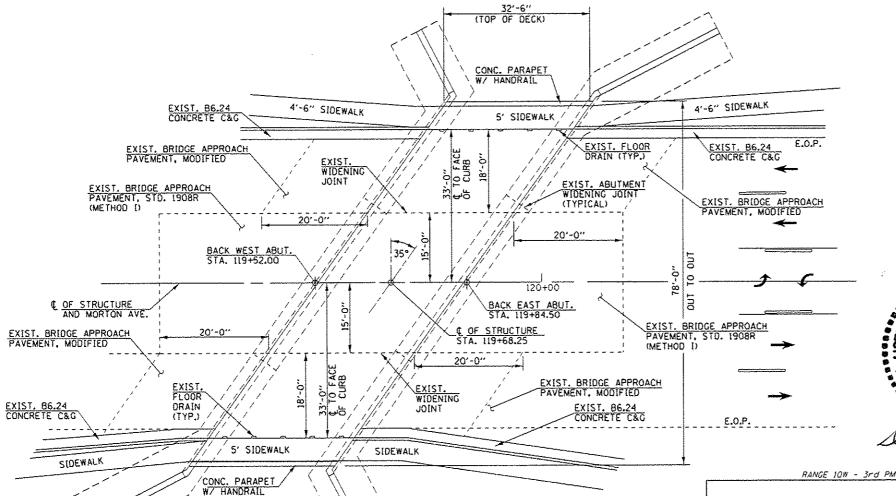

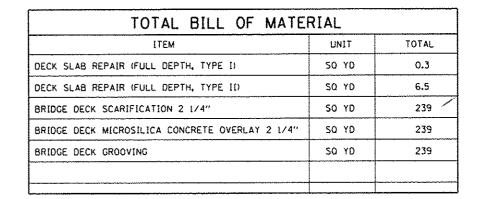

DAVID CARL PUZEY 081-005470 **SPRINGFIELD** ILLINOIS

INDEX OF SHEETS

GENERAL PLAN AND ELEVATION 2.3 BRIDGE DECK PATCHING LAYOUT

- 4 STAGED TRAFFIC CONTROL CROSS SECTIONS 5 BRIDGE DECK CROSS SECTION DETAILS
- 6 MISCELLANEOUS BRIDGE DETAILS

GENERAL PLAN FAP 753 (IL RTE. 104) OVER TOWN BROOK SECTION 23BR. RS-6. TS-5: 33BR-1. RS-4. TS-2 MORGAN COUNTY STATION 119+68.25 STRUCTURE NO. 069-0007

FILE NAME :	USER NAME & Yeranakifa	DESIGNED - RTS	REVISED ~
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Shaet 14	PLOT DATE # 1/28/2016	DATE - 5-03-15	REVISED -

S.N. 069-0007

PLAN VIEW

S.N. 069-0007 (EXISTING CONDITIONS)


> STATE OF ILLINOIS DEPARTMENT OF TRANSPORTATION


S.N. 069-0007-


LOCATION SKETCH

SCALE:


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TOWN BROOK (S.N. 069-0007		•	**	MORGAN	366 179
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SHEET 1 OF 6 SHEETS STA.	TO STÁ.		ILLINOIS FED.	AID PROJECT	

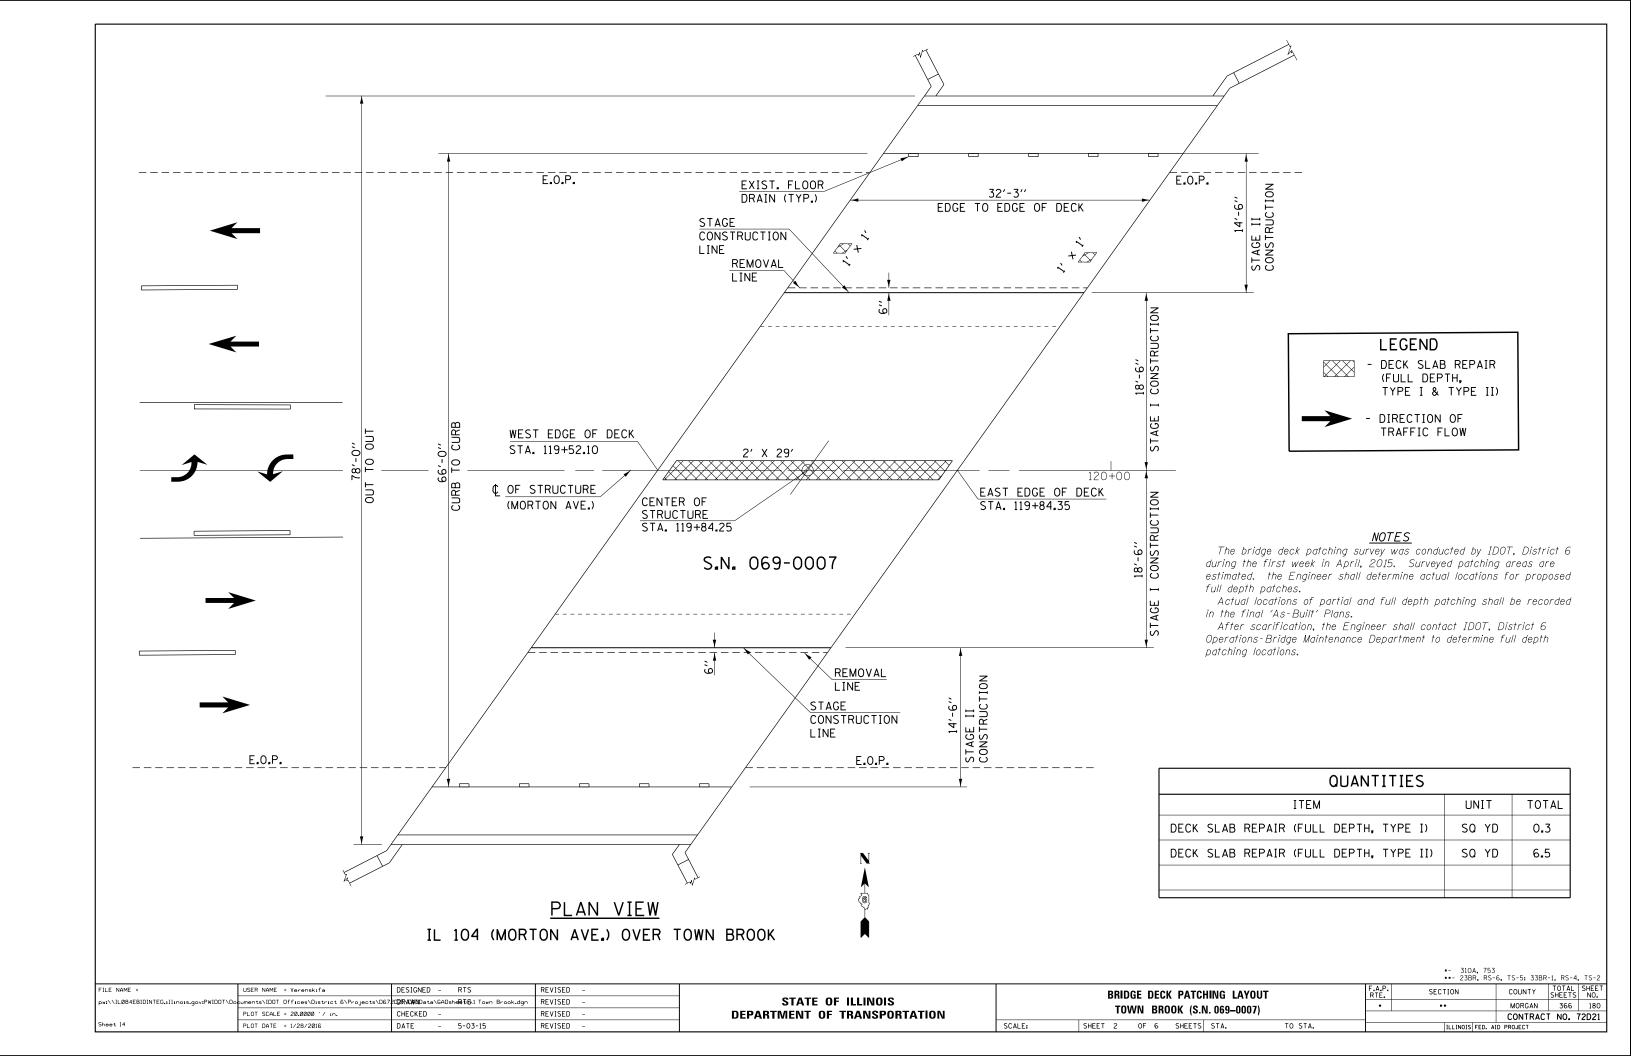

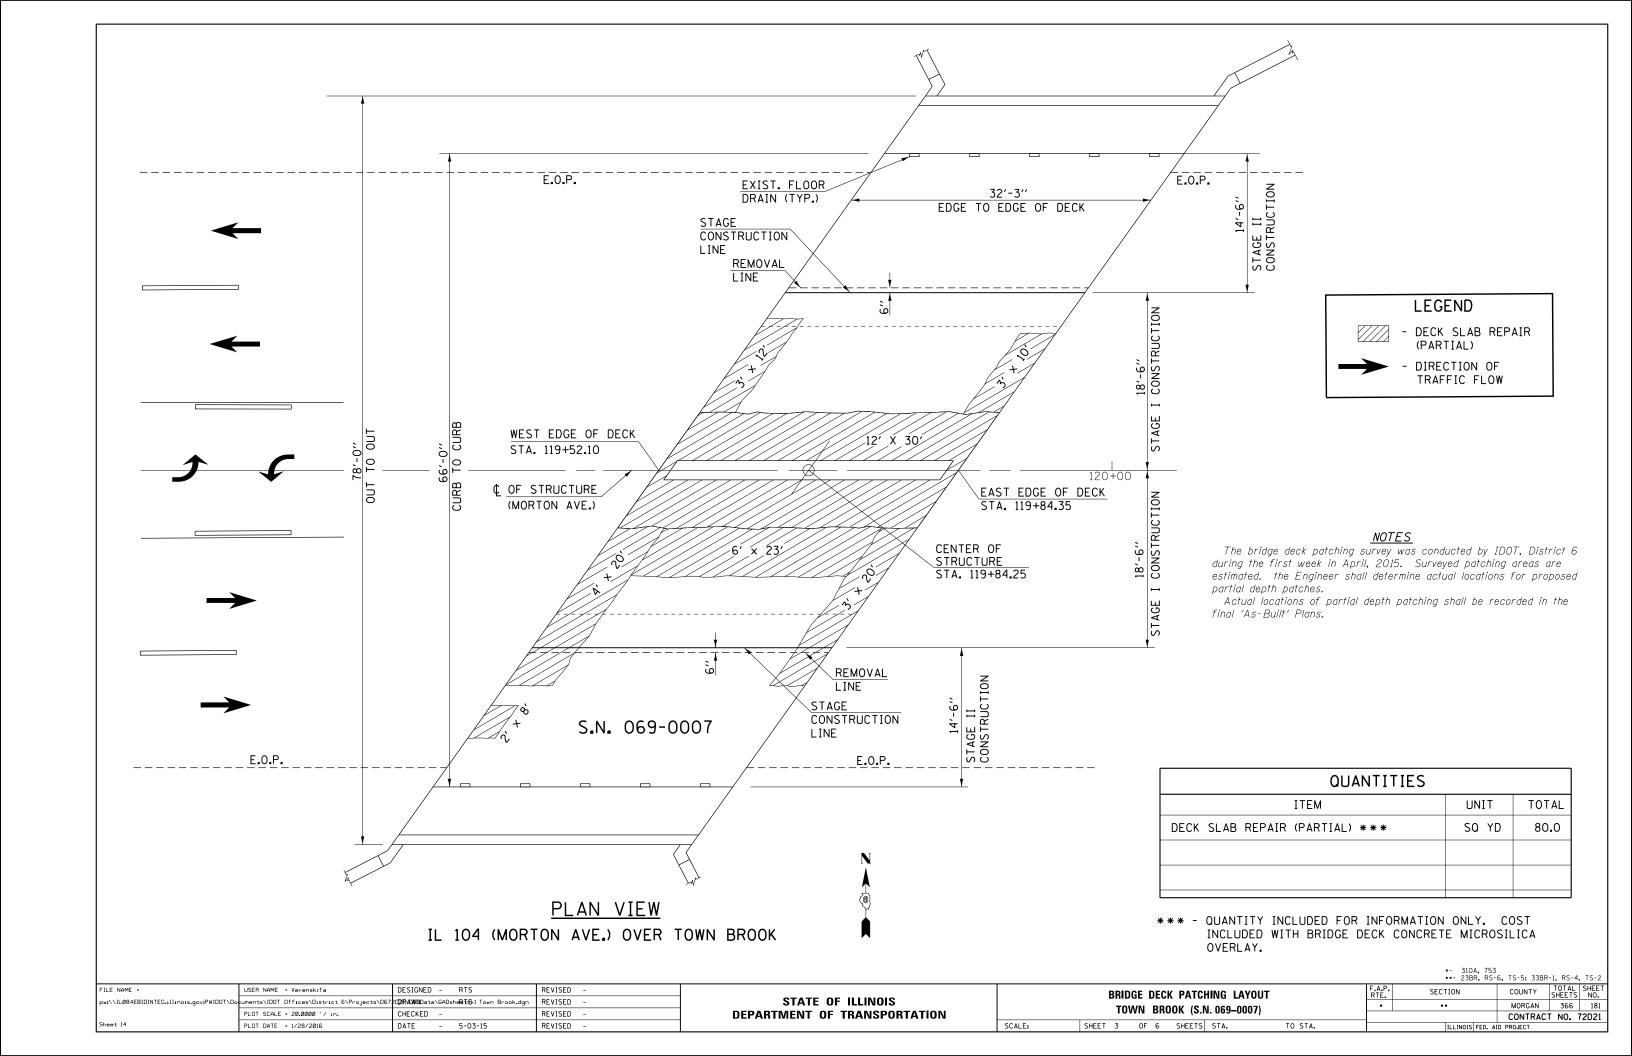

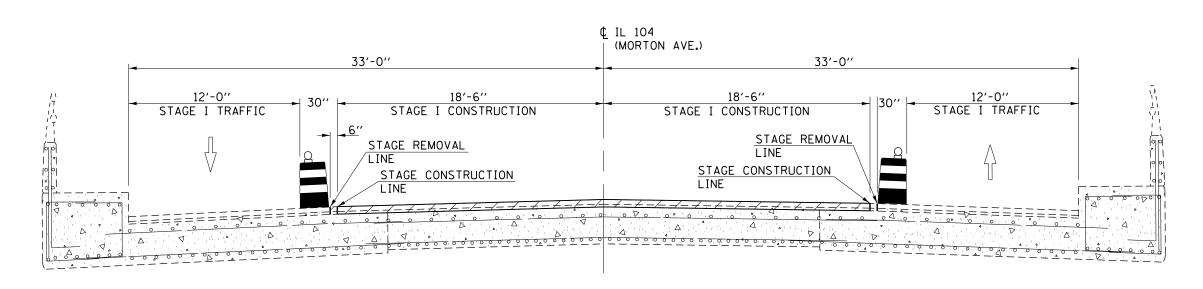


STAGE I TRAFFIC CONTROL S.N. 069-0007 (LOOKING EAST)

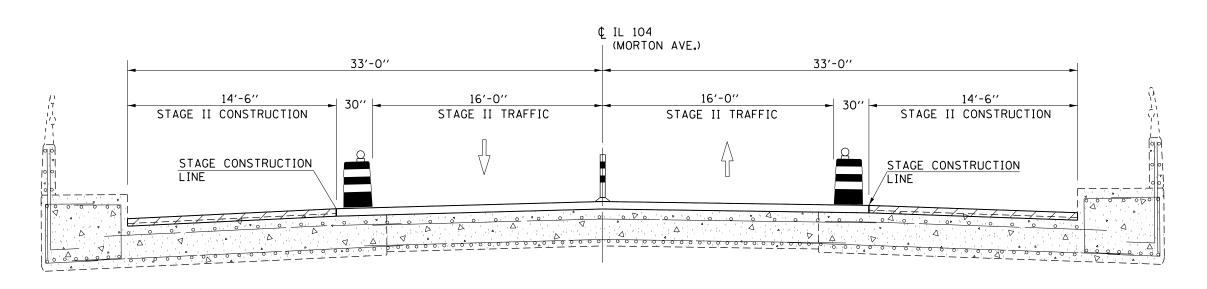

STAGE II TRAFFIC CONTROL


S.N. 069-0007 (LOOKING EAST)

								*- 310A, 75 **- 23BR, RS	3 -6, TS-5: 33BR-1	1, RS-4, TS-2
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	PLOT SCALE = 20.0000 '/ in.	CHECKED -	REVISED -	DEPARTMENT OF TRANSPORTATION	TOWN B	BROOK (S.N. 069–0007)			CONTRACT	NO. 72D21
Sheet 14	PLOT DATE = 1/28/2016	DATE - 5-03-15	REVISED -		SCALE: SHEET 4 OF 6	S SHEETS STA. TO STA.		ILLINOIS FED.	AID PROJECT	

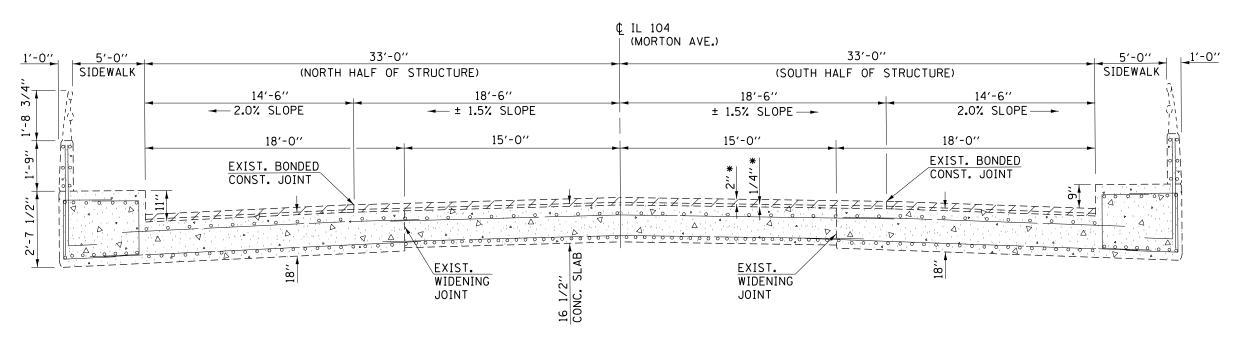

BRIDGE TYPICAL CROSS SECTION EXISTING CONDITIONS S.N. 069-0007 (LOOKING EAST)

*- PROPOSED REMOVAL OF THE EXISTING MICROSILICA CONCRETE OVERLAY (DEPTH=2") AND THE TOP 1/4" OF THE EXISTING CONCRETE BRIDGE DECK IS INCLUDED IN THE PAY ITEM BRIDGE DECK SCARIFICATION 2 1/4". SEE THE SPECIAL PROVISIONS FOR DETAILS OF THIS ITEM.

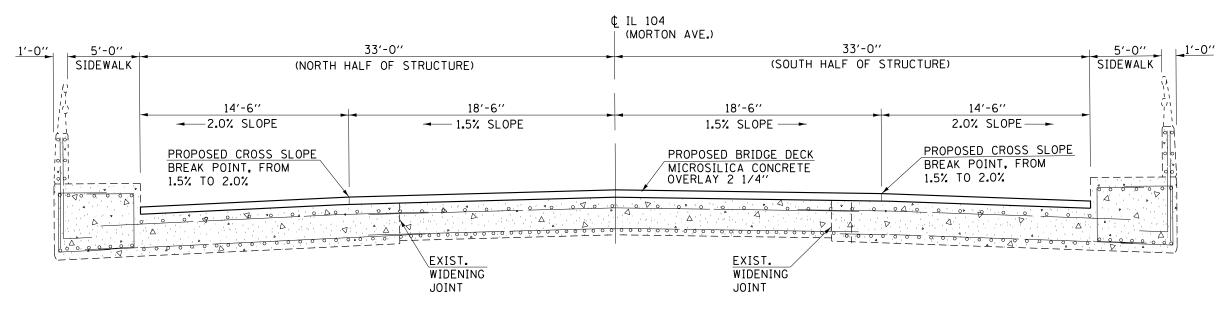



BRIDGE TYPICAL CROSS SECTION PROPOSED CONDITIONS S.N. 069-0007 (LOOKING EAST)

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Sheet 14	PLOT DATE = 1/28/2016	DATE - 5-03-15	REVISED -	

STATE OF ILLINOIS
DEPARTMENT OF TRANSPORTATION


| SPEELS NO. | SPE

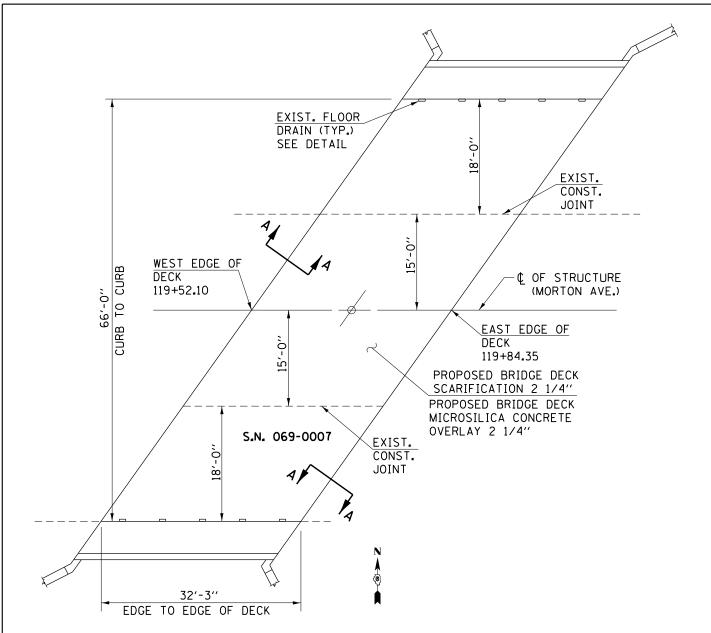

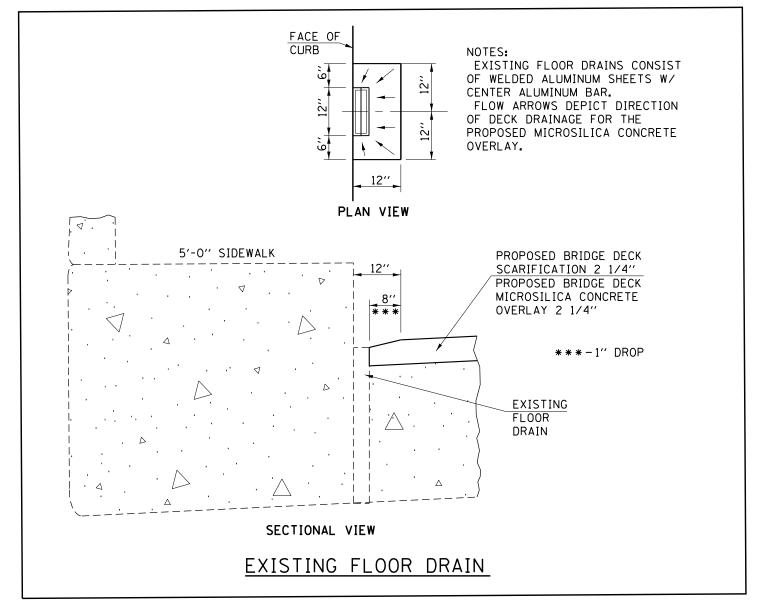

PLAN VIEW IL 104 (MORTON AVE.) OVER TOWN BROOK


UNIT	TOTAL
SQ YD	239
SQ YD	239
_	SQ YD

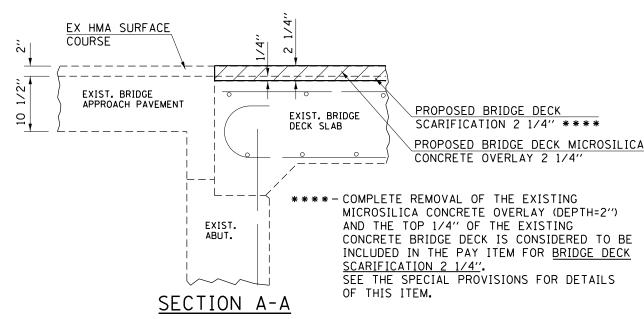


SCALE:

•- 310A, 753 •- 23BR, RS-6, TS-5: 33BR-1, RS-4, TS-2

STATE OF ILLINOIS
DEPARTMENT OF TRANSPORTATION

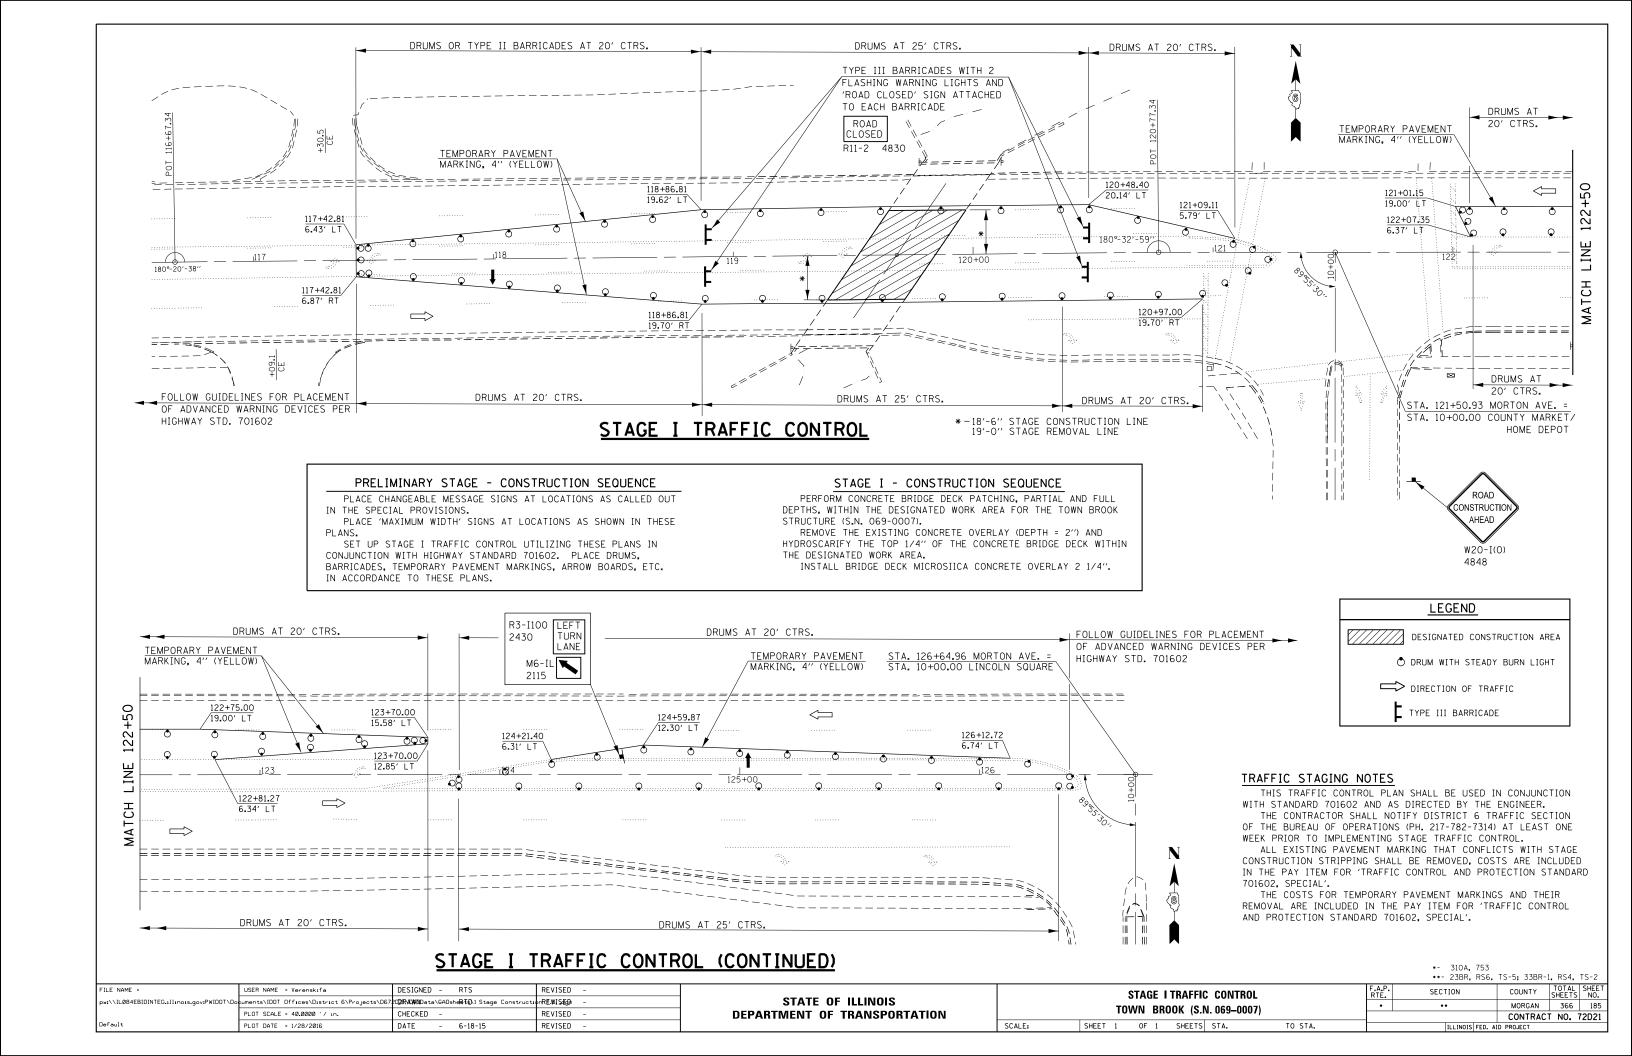

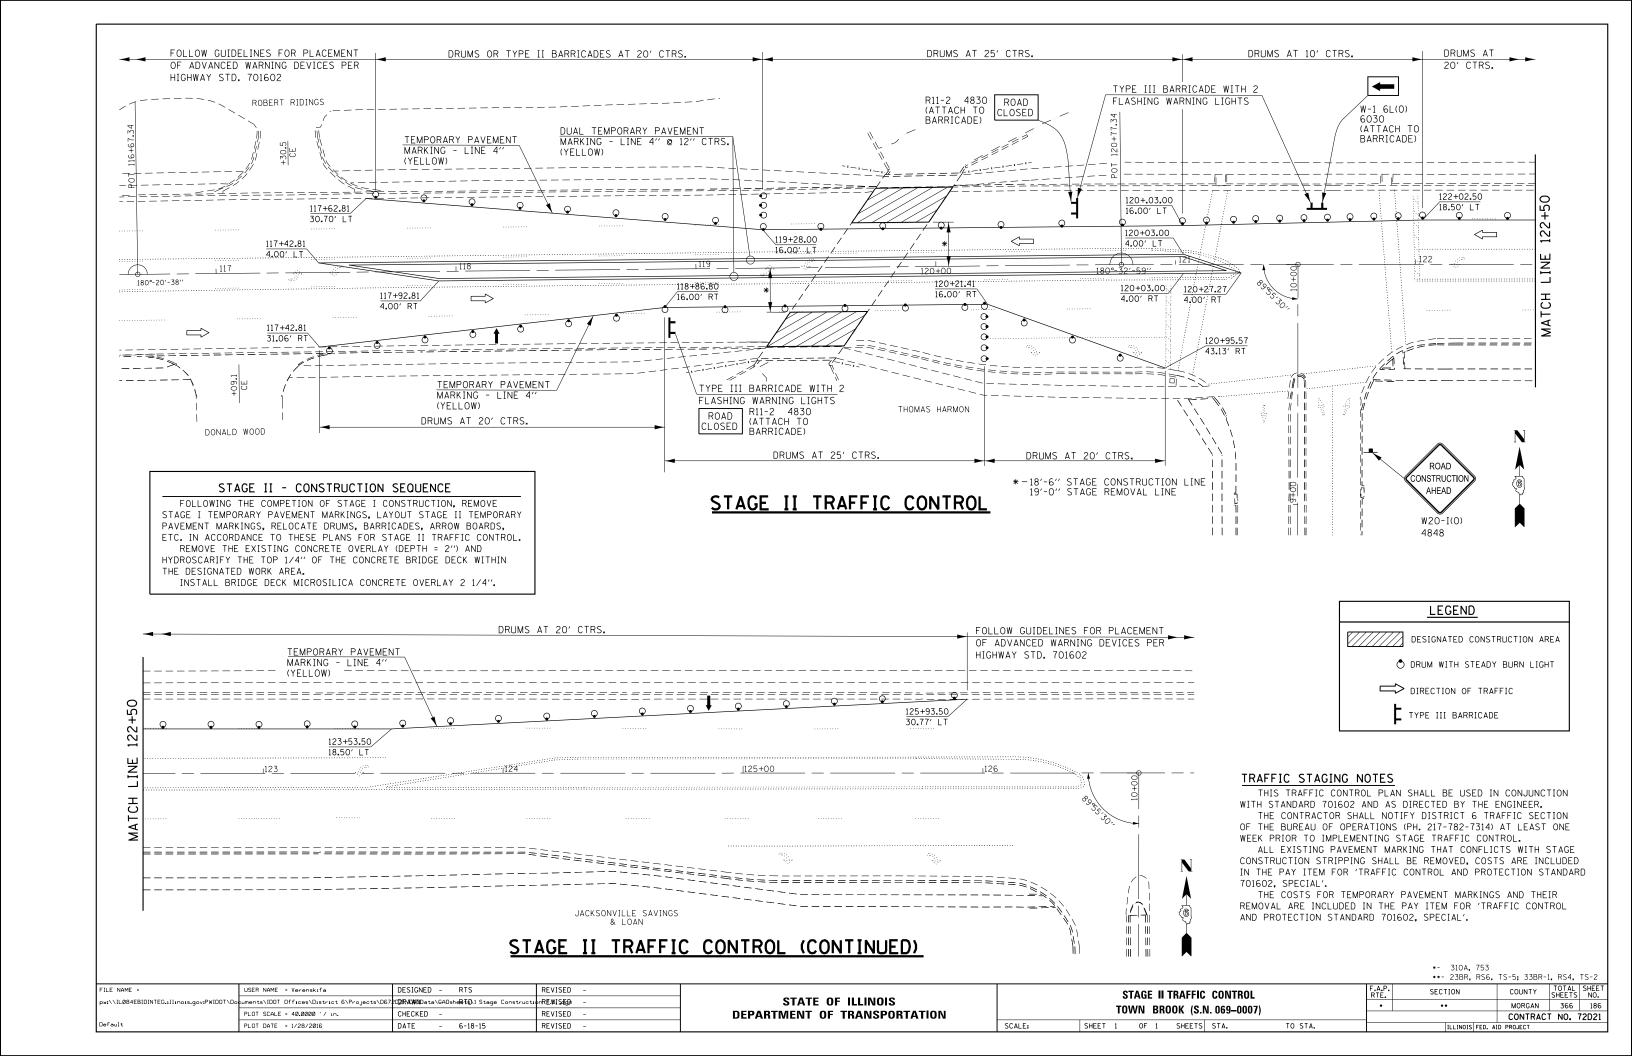


EXISTING STRUCTURE

The existing structure (S.N. 069-0009) was constructed in 1956 as SBI 10 (now FAP 753), Section 33BR. 33FR. This structure consists of steel I-Beams along 3 spans, each at 42.2' in length for a total bridge deck length of 130.0'. The structure's width is 54.0', face to face of curbs with a total width of 59.7'. Concrete abutments, pier posts, and piles are included in the makeup of the existing substructure. The existing superstructure consists of a 6.5" P.C.C. deck slab with a waterproofing membrane system, an I-11 wearing surface (depth = 1.25"), and iron bridge railing atop conCrete curbing/sidewalk.

SCOPE OF WORK

- Set up Staged Traffic Control as detailed in these plans. East and west bound traffic routed onto the inside lanes across the structure for Stage One, onto the outside lanes across the structure for Stage Two.
- Perform partial and full depth patching within the designated work area for each stage of traffic control.
- Remove and replace existing edge rails and joint seals at both ends of the structure, perform associated concrete work within the designated work area for each stage of traffic control.
- Apply backer rod and sillcon joint sealer along the whole length of the existing concrete median's open joint during Stage Two Traffic Control.
- Remove and replace the existing bridge diaphragms as shown in these plans.
- Install proposed floor drains and plug all existing floor drains along the north and south sides of the

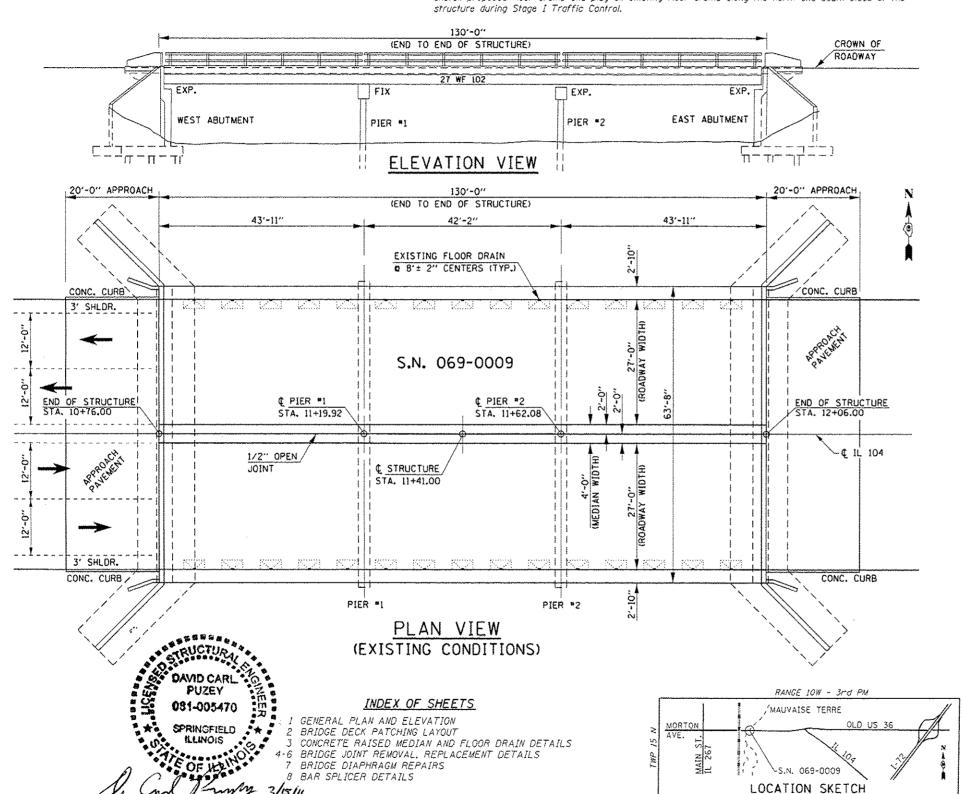

GENERAL NOTES

All structural steel shall conform to AASHTO Classification M-270 Grade 36 unless otherwise noted.

Reinforcement bars designated (E) shall be epoxy coated.

Plan dimensions and details relative to existing plans are subject to nominal construction variations. The Contractor shall field verify existing dimensions and details affecting new construction and make necessary approved adjustments prior to construction or ordering of materials. Such variations shall not be cause for additional compensation for a change in the scope of work, however, the Contractor will be paid for the quantity actually furnished at the unit price bid for the work.

Care shall be exercised by the Contractor during and following removal operations to ensure that existing rebar remaining in place are not damaged. Any reinforcement bars that are damaged during concrete removal shall be replaced with an approved bar splicer or anchoring system. Costs for this work shall be included in the costs for "Concrete Removal", The existing structural steel coating contains lead. The Contractor shall take appropriate

precautions to deal with the presence of lead on this project.

Prior to pouring new concrete for joint repairs, all heavy or loose rust, loose mill scale, and other loose or potentially detrimental foreign material shall be removed from the surfaces in contact with concrete. Tightly adhered paint may remain unless otherwise noted. Removal shall be accomplished by methods that will not damage the steel and the cost will be included In the pay item covering removal of the existing concrete.

Existing structural steel that will be in contact with new structural steel shall be cleaned and painted prior to erection as required by the Special Provision "Cleaning and Painting Contact Surface Areas of Existing Steel Structures".

All new structural steel shall be shop painted with an inorganic zinc rich primer per AASHTO M300, Type 1. Costs included in the pay item for "Furnishing and Erecting Structural Steel".

Field painting of structural steel shall be done under a separate painting contract. Fastners shall be ASTM A325 Type 1, mechanically galvanized bolts. Bolts 3/4" \$\phi\$, holes 13/16" \u00e9. unless otherwise noted.

No field welding is permitted except as specified in the contract documents.


Existing reinforcement bars extending into the removal area shall be cleaned, straightened, and incorporated into the new construction. Any reinforcement bars that are damaged during concrete removal shall be replaced with an approved bar splicer or anchorage system. Costs included with Concrete Removal.


Jaint openings shall be adjusted according to Article 520.04 of the Standard Specifications when the deck is poured at an ambient temperature other than 50° F.


TOTAL BILL OF MA	TERIAL	
ITEM	UNIT	TOTAL
DECK SLAB REPAIR (PARTIAL)	SO YO	51.9
DECK SLAB REPAIR (FULL DEPTH, TYPE I)	SO YD	5.8
DECK SLAB REPAIR (FULL DEPTH, TYPE II)	SQ YD	44.9
FURNISHING AND ERECTING STRUCTURAL STEEL	POUND	1,790
STRUCTURAL STEEL REMOVAL	POUND	1,790
SILICONE JOINT SEALER (1/2")	FOOT	130.0
SILICONE JOINT SEALER (2")	FOOT	12.0
FLOOR DRAINS	EACH	30
REINFORCEMENT BARS, EPOXY COATED	POUND	2,532
PREFORMED JOINT STRIP SEAL	F00T	118.0
BAR SPLICERS	EACH	24
CONCRETE REMOVAL	CU YD	14.5
CONCRETE SUPERSTRUCTURE	CU YD	14.5


GENERAL PLAN FAP 753 (IL RTE. 104) OVER MAUVAISE TERRE CREEK SECTION 23BR, RS-6, TS-5; 33BR-1, RS-4, TS-2 MORGAN COUNTY STATION 11+41.00 STRUCTURE NO. 069-0009


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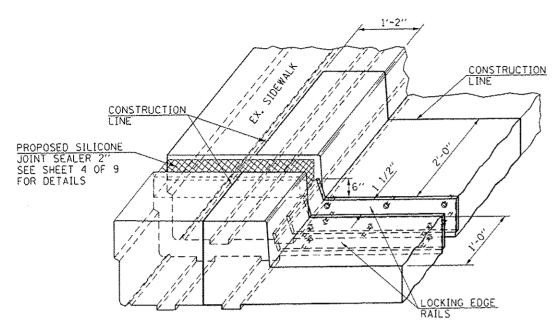


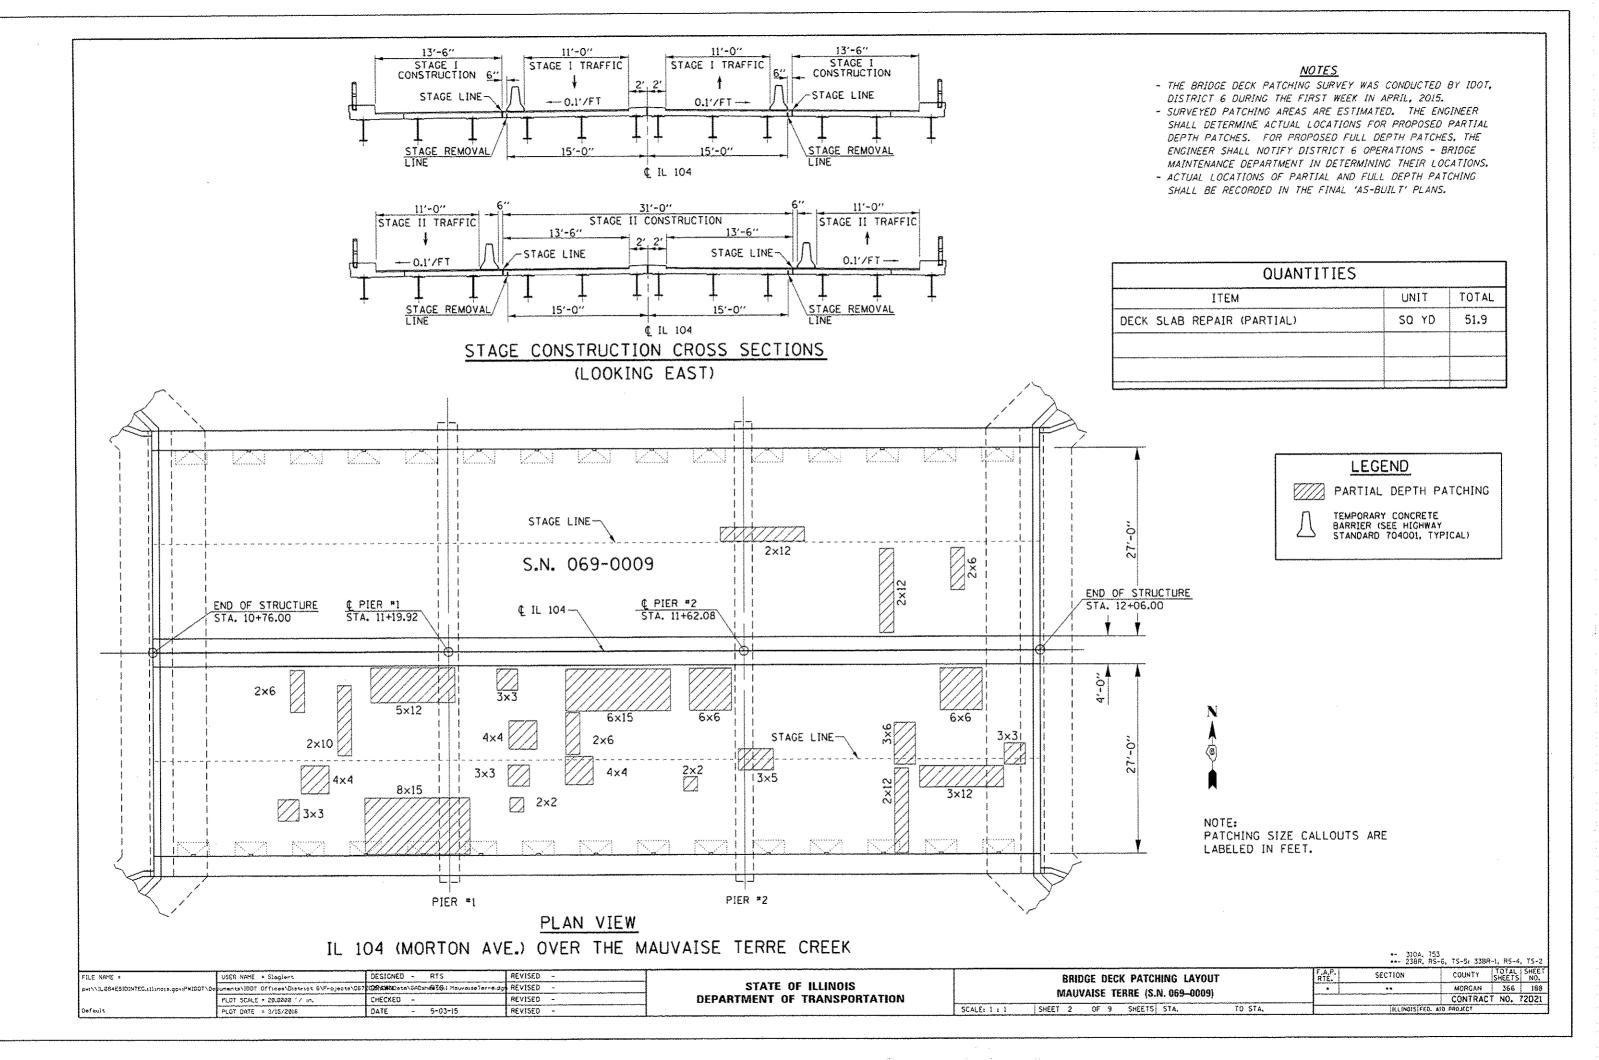

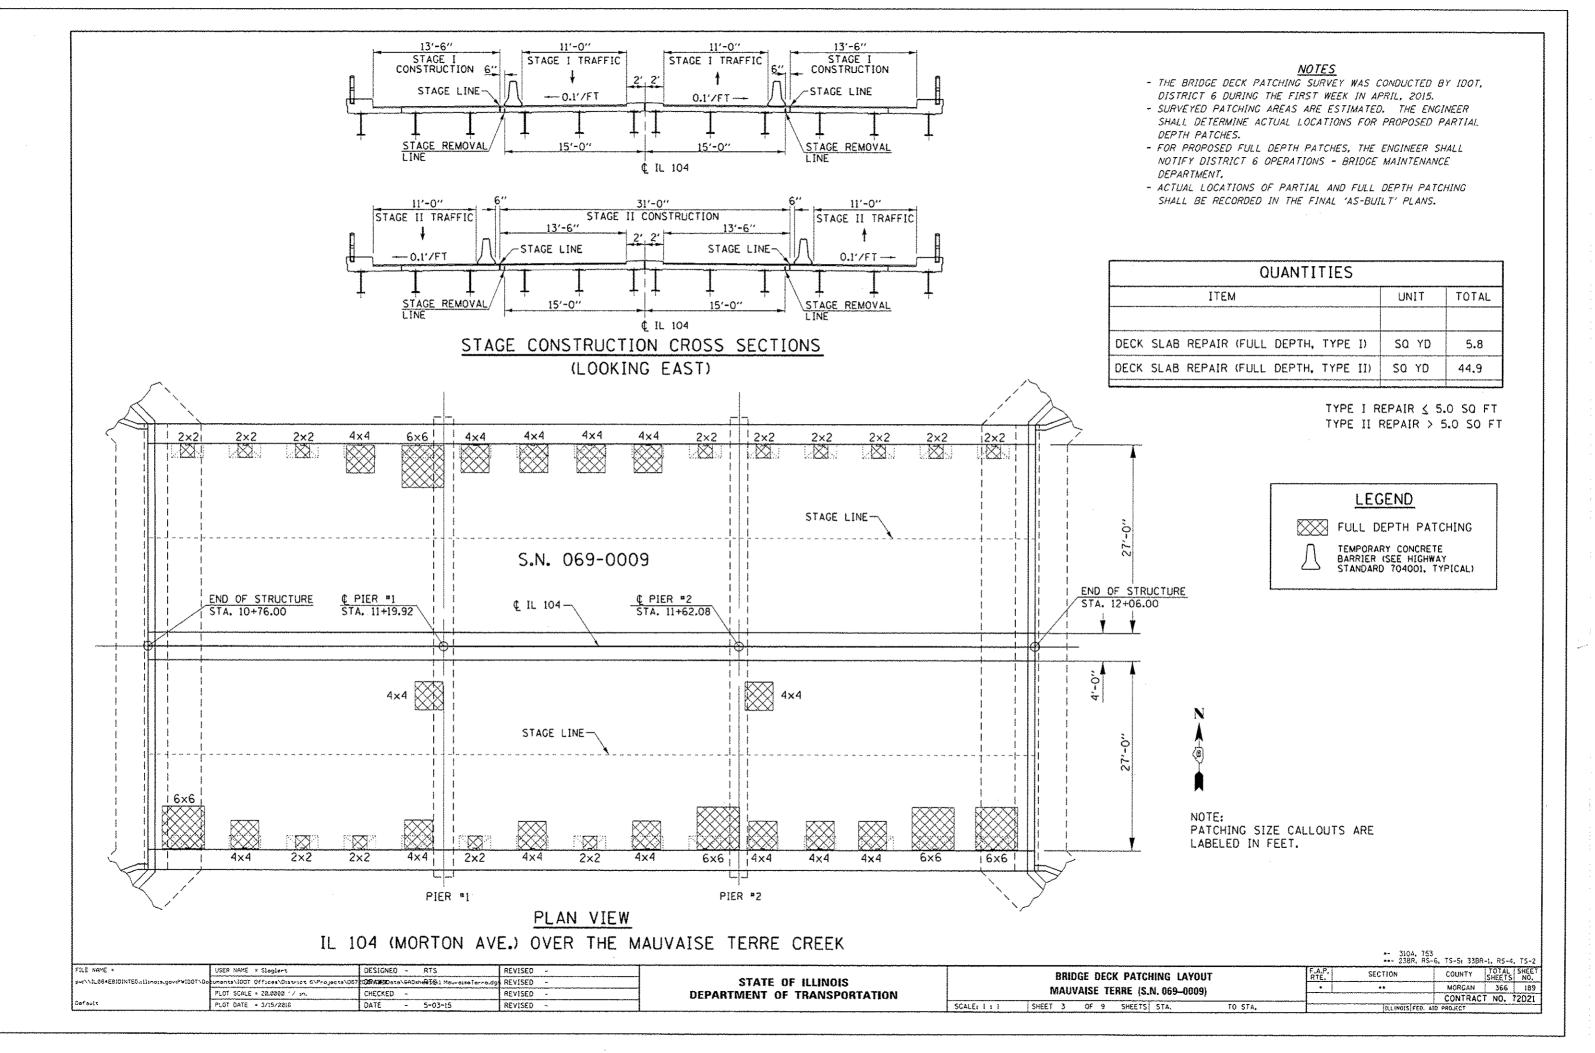

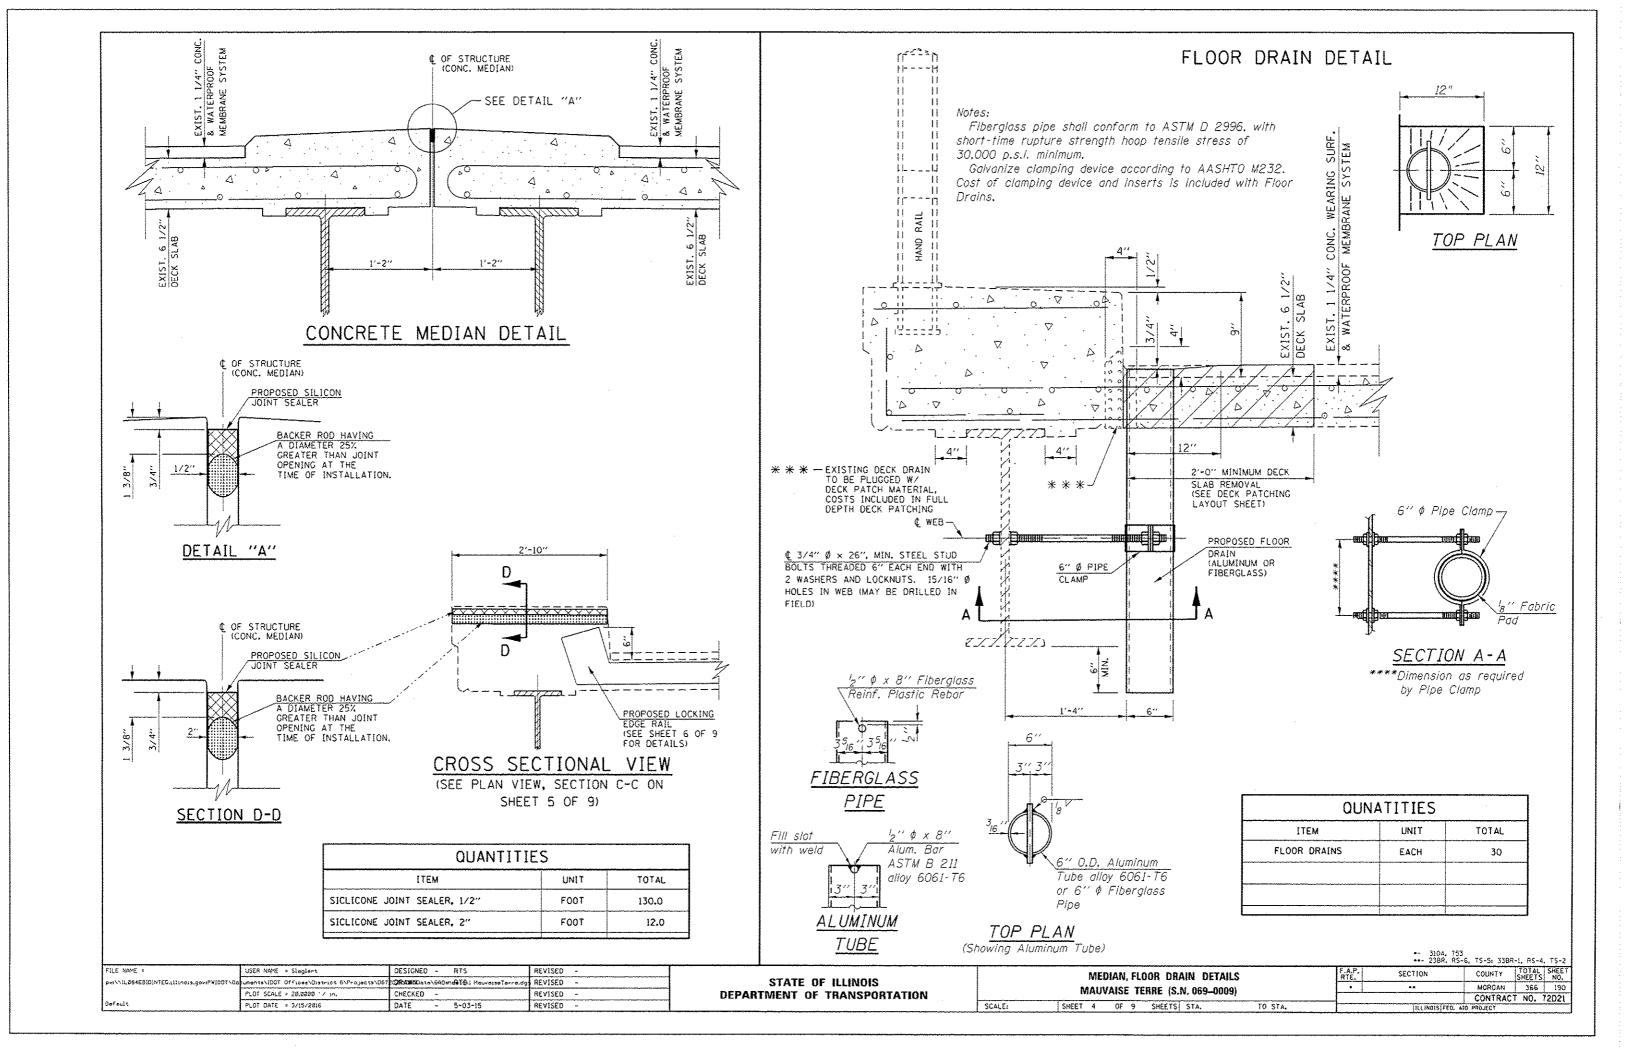

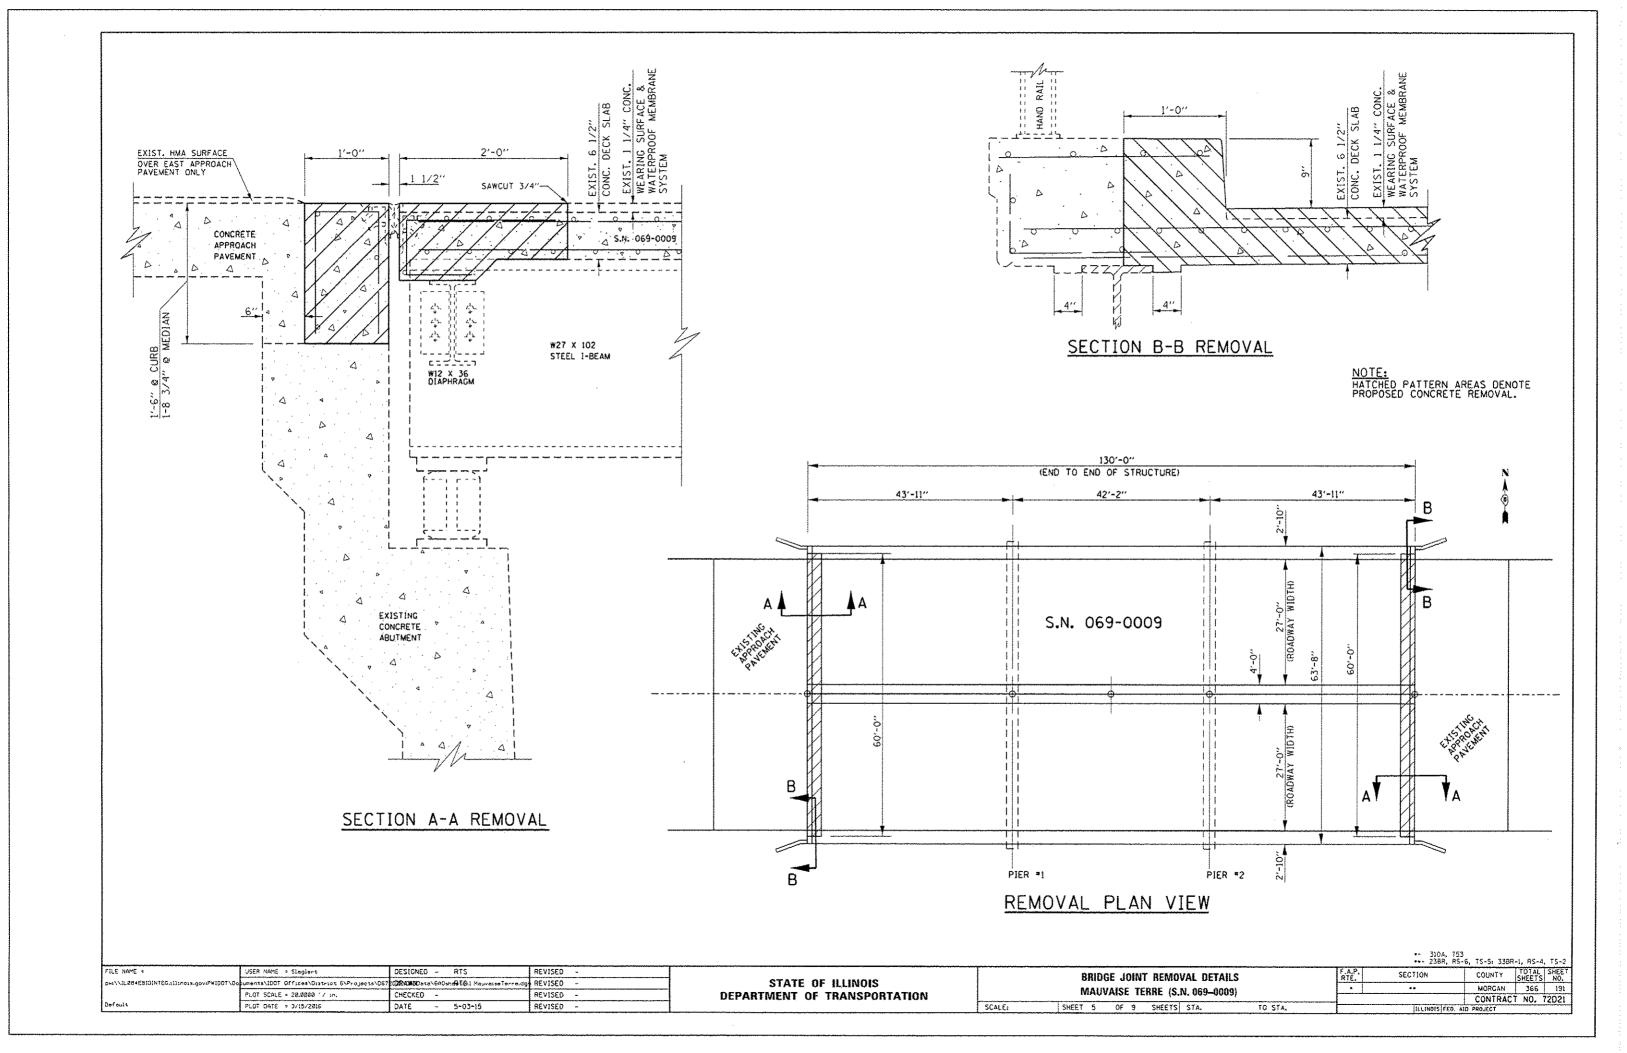

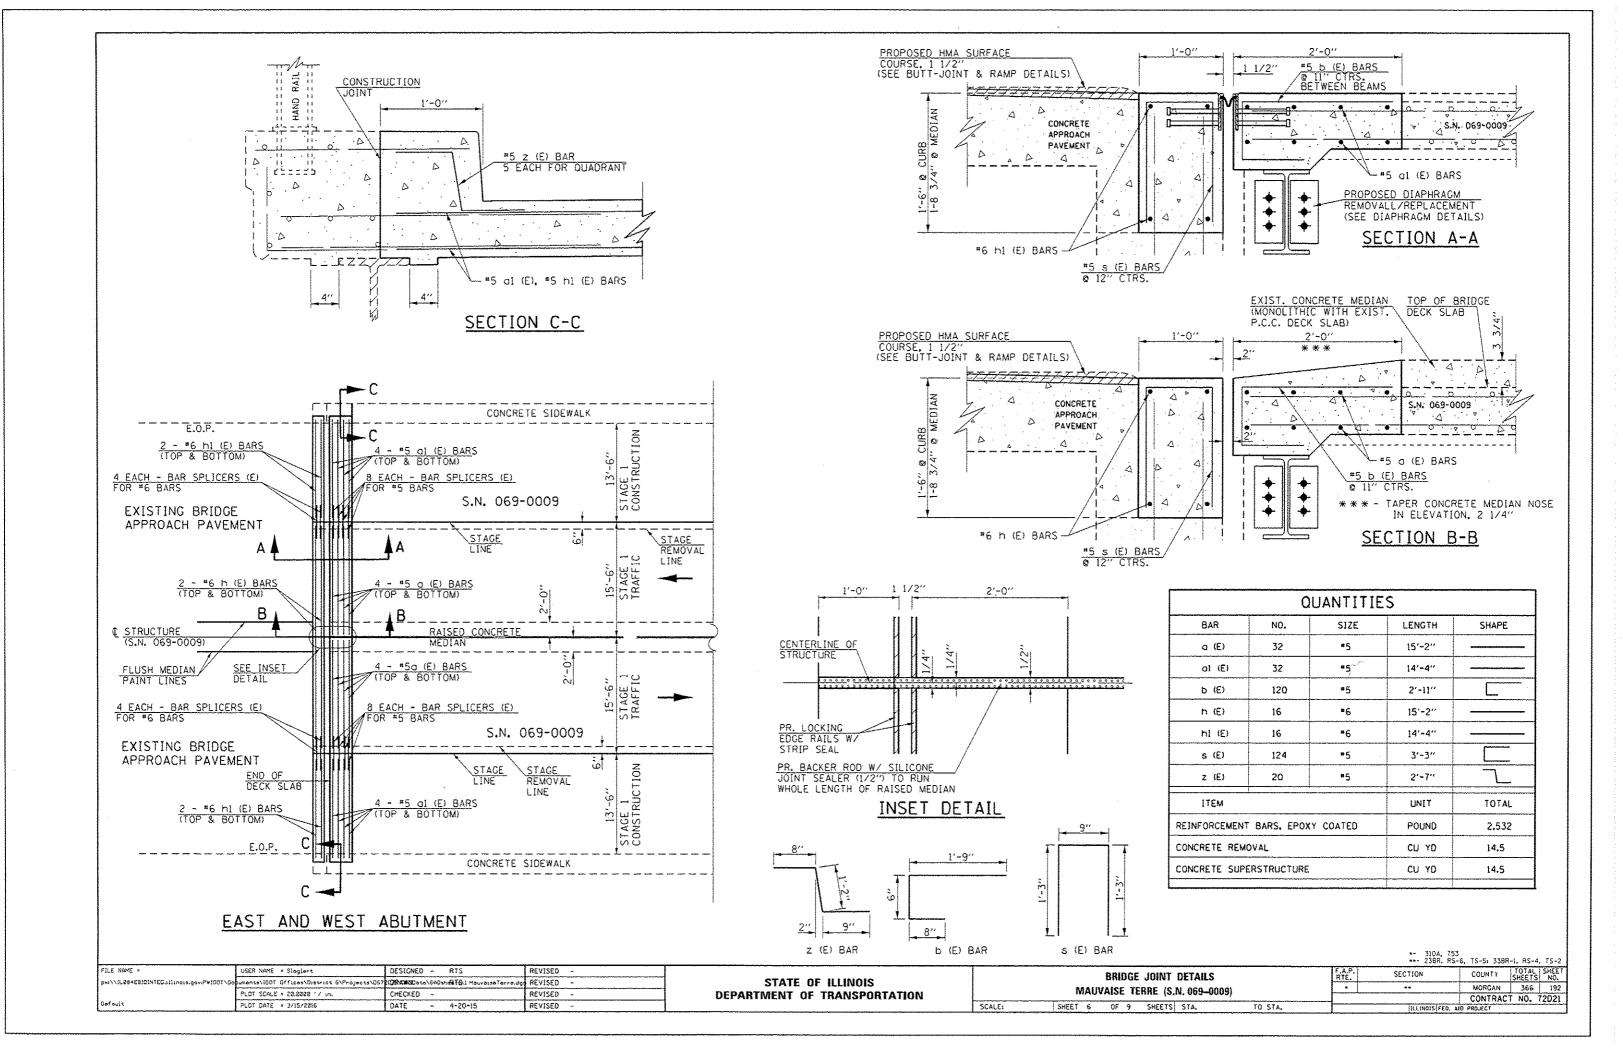

TYPICAL END TREATMENT FOR SIDEWALK ALONG BOTH OUTER SIDES OF STRUCTURE

Shorter plates with a single row of studs at 12" cts. may be necessary on medians which are shallower than 9". See manufacturer's recommendation.

Strip seal-

Locking edge rail-

Notes:

The strip seal shall be made continuous and shall have a minimum thickness of $\frac{1}{4}$ ". The configuration of the strip seal shall match the configuration of the Locking Edge Rails. Open or "webbed" strip seal gland configurations are not permitted. The aland shall be sized for a maximum rated movement of 4 inches.

The Locking Edge Ralls depicted are conceptual only. except for the minimum dimensions shown. The actual configuration of the Locking Edge Rails and matching strip seal may vary from manufacturer to manufacturer. Flanged edge rails will not be allowed. Locking Edge Rails may be spliced at slope discontinuities.

The manufacturer's recommended installation methods shall be followed.


The joint opening and deck dimensions detailed on the superstructure are based on a rolled rail expansion joint. If the Contractor elects to use the welded rail expansion joint, the opening and deck dimensions shall be modified according to the dimensions detailed on this sheet. Required modifications shall be made at no additional cost to the State.

All steel components shall be galvanized after fabrication according to Article 520.03 of the Standard Specifications.


Maximum space between rail segments shall be 316". sealed with a suitable sealant. Joints in ralls within 10 ft. of curbs shall be welded.

Parapet plates and anchorage studs for skews > 30° included in the cost of Preformed Joint Strip Seal.

OUANTITI	ES	
ITEM	UNIT	TOTAL
PREFORMED JOINT STRIP SEAL	FOOT	118.0

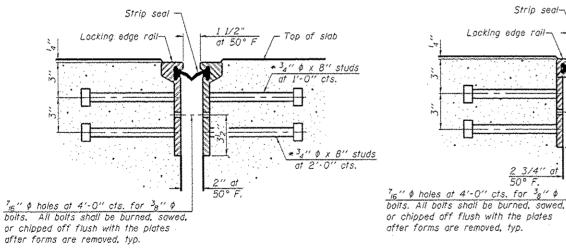


SECTION THRU SECTION THRU WELDED RAIL JOINT ROLLED RAIL JOINT

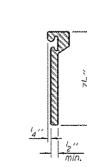

ROLLED EXTRUDED RAIL

SCALE:

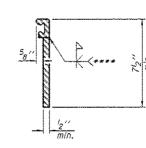

WELDED RAIL

LOCKING EDGE RAILS

TO STA.

**** Back gouge not required if complete joint penetration

is verified by mock-up.

LOCKING EDGE RAIL SPLICE

The inside of the locking edge rail groove shall be free of weld residue.

Rolled rall shown, welded rail similar.

NOTE: DATE PROTERNE EVERDOTER FORM FILCE 1.27.2012

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STATE OF ILLINOIS DEPARTMENT OF TRANSPORTATION

- Top of slab

*** Granular or solid flux filled headed

end welded.

of the Std. Specs., automatically

studs conforming to Article 1006.32

4" ∮ x 8" studs

cts.

" \$ x 8" studs


at 2'-0" cts.

at 50° F


BRIDGE JOINT DETAILS										
	٨	#AU	VAISE	TE	RRE	(S.	N. 069-0009)			
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*- 310A, 753 **- 238R, RS-6, TS-5: 33BR-1, RS-4, TS-2 COUNTY TOTAL SHEET NO. MORGAN 366 193 CONTRACT NO. 72D21

SECTION

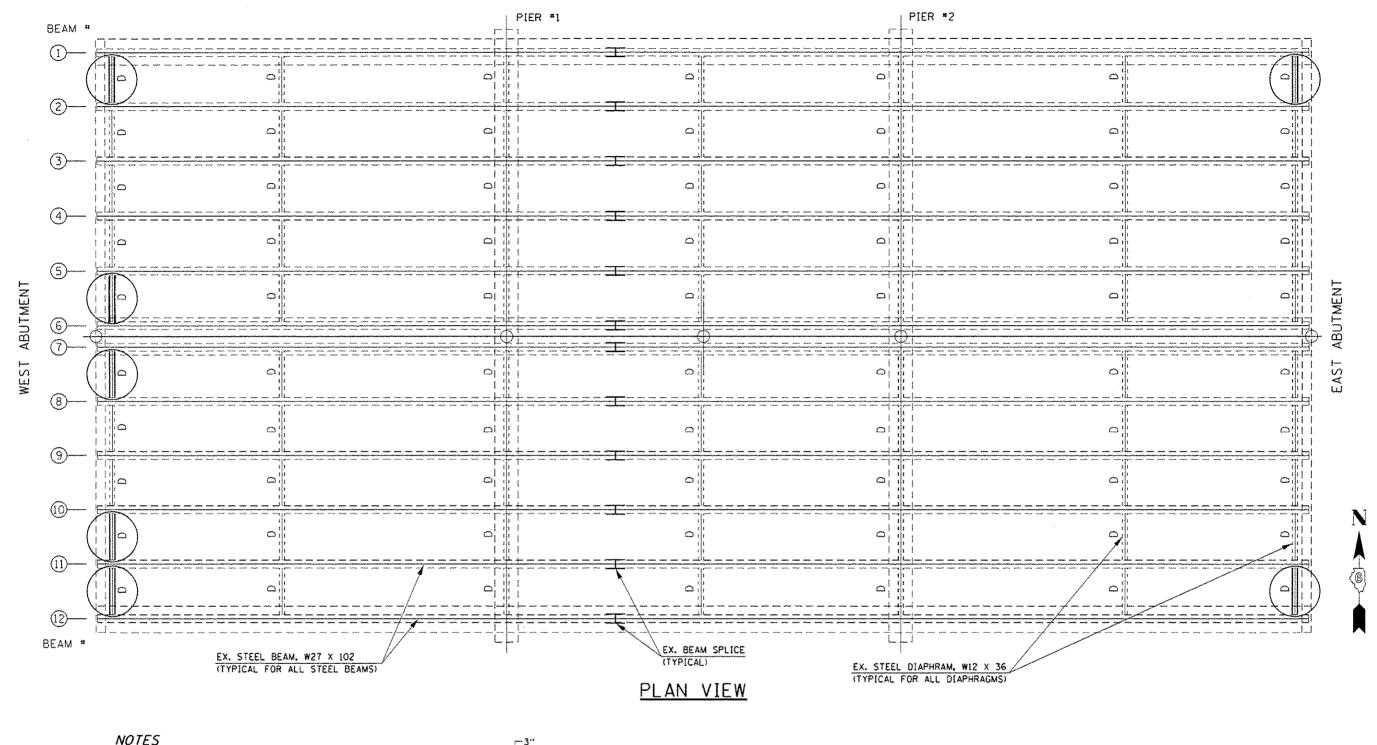

- TWO HARDENED WASHERS REQUIRED FOR EACH SET OF OVERSIZED HOLES.
- EXISTING END DIPHRAGMS AT ABUTMENTS SHALL BE REMOVED AND REPLACED AS SHOWN ON THIS SHEET. COSTS INCLUDED WITH STRUCTURAL STEEL REMOVAL.
- FIELD DRILL HOLES FOR 3/4" BOLTS IN NEW ANGLES USING HOLES IN EXISTING BEAMS AS TEMPLATES.

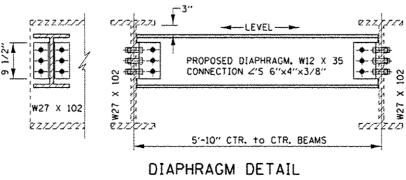

LEGEND


STEEL DIAPHRAGM, W12 X 36 TO BE REMOVED AND REPLACED WITH W12 X 35

- FIELD DRILLED HOLES FOR 3/4" BOLTS INTO 6"X4"X3/8" ANGLES

QUANT	ITIES	
ITEM	UNIT	TOTAL
FURNISHING AND ERECTING STRUCTURAL STEEL	POUND	1,790
STRUCTURAL STEEL REMOVAL	POUND	1.790

-- 310A, 753 --- 238R, 8S-6, TS-S: 339R-1, RS-4, TS-2

ſ	FILE NAME *	USER NAME - Slaglart	DESIGNED -	RTS	REVISED -				RRINGE I	DIAPHRAM REPAIR	9	F.A.P.	SECTION	COUNTY	TOTAL	HEET
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l		PLGT SCALE = 20.0000 1/ in.	CHECKED -		REVISED -	DEPARTMENT OF TRANSPORTATION	MAUVAISE TERRE (S.N. 069-0009)		Ţ,		CONTRA	CT NO. 7	021			
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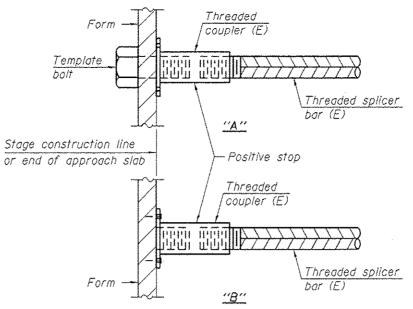
STANDARD BAR SPLICER ASSEMBLY

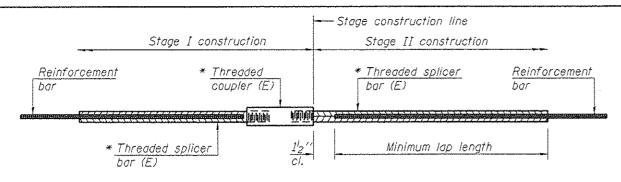Threaded splicer bar length = min, lap length + l_2^{l} " + thread length

* Epoxy not required on Bar Splicer Assembly components used in conjunction with black bars.

Location	Bar size	No. assemblies required	Minimum lap length
East abutment, bridge deck side	5	8	3\6
East abutment, approach side	6	4	4'-0"
West abutment, bridge deck side	5	8	3'-6"
West abutment, approach side	6	4	4'-0"

Total Required = 24 Each



INSTALLATION AND SETTING METHODS


"A": Set bar splicer assembly by means of a template bolt. "B": Set bar splicer assembly by nailing to wood forms or cementing to steel forms. (E): Indicates epoxy coating.

Stage line if applicable Stage I construction Stage II construction Mechanical coupler (E) Reinforcement bar -Reinforcement bar-

STANDARD MECHANICAL SPLICER

Location	Bar size	No. assemblies required

BAR SPLICER ASSEMBLY AND MECHANICAL SPLICER DETAILS **STRUCTURE NO. 069-0009**

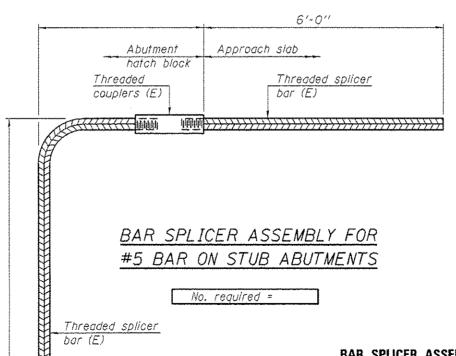

NOTES

Splicer bars shall be deformed with threaded ends and have a minimum 60 ksi yield strength.

All reinforcement shall be lapped and tied to the splicer bars. Bar splicer assemblies shall be epoxy coated according to the requirements for reinforcement bars. See Section 508 of the Standard Specifications. See approved list of bar splicer assemblies and mechanical splicers for alternatives.

BSD-1

6-8-15

BAR SPLICER ASSEMBLY AND MECHANICAL SPLICER DETAILS STRUCTURE NO.

							**- 236R, R	5-6, TS-Si 33BR-1, RS-4, TS-2
FILE NAME A	USER NAME = Slaglart	DESIGNED -	REVISED -		BAR SPLICERS	F.A.P.	SECTION	COUNTY TOTAL SHEET
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O DRUM WITH STEADY BURN LIGHT

DIRECTION OF TRAFFIC

DIRECTION INDICATOR
BARRICADE WITH LIGHTS

THIS TRAFFIC CONTROL PLAN SHALL BE USED IN CONJUNCTION WITH STANDARD 701423 AND AS DIRECTED BY THE ENGINEER.

THE CONTRACTOR SHALL NOTIFY DISTRICT 6 TRAFFIC SECTION OF THE BUREAU OF OPERATIONS (PH. 217-782-7314) AT LEAST ONE WEEK PRIOR TO IMPLEMENTING STAGE TRAFFIC CONTROL.


ALL EXISTING PAVEMENT MARKING THAT CONFLICTS WITH STAGE CONSTRUCTION STRIPPING SHALL BE REMOVED, COSTS FOR REMOVAL ARE INCLUDED IN THE PAY ITEM FOR ITEM FOR 'TRAFFIC CONTROL AND PROTECTION STANDARD 701423, SPECIAL'.

THE COSTS FOR TEMPORARY PAVEMENT MARKINGS ARE INCLUDED IN THE PAY ITEM FOR 'TRAFFIC CONTROL AND PROTECTION STANDARD 701423, SPECIAL'.

ADVANCED WARNING SIGNS PER TRAFFIC CONTROL STANDARD 701423 SHALL BE MODIFIED TO REFLECT A. WORK ZONG. SPEED LIMI WORKS AND MORE ARROW BOARD FOR EACH DIRECTION OF TRAFFIC SHALL BE UTILIZED.

LEGEND

ARROW BOARD

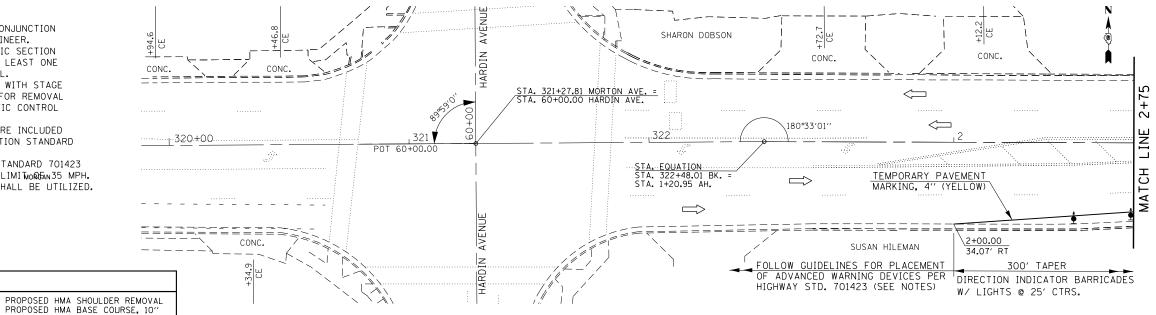

STAGE I TRAFFIC CONTROL

 SEE SHEET XX FOR SCHEDULES

PRELIMINARY STAGE - CONSTRUCTION SEQUENCE

SET UP PRELIMINARY STAGE TRAFFIC CONTROL UTILIZING HIGHWAY STD. 701602 FOR PROPOSED HMA SHOULDER WORK ALONG THE NORTH SIDE OF IL 104, ADJACENT EAST & WEST OF THE MAUVAISE TERRE STRUCTURE.

REMOVE EXISTING RAIL ELEMENT OF GUARDRAIL TO ALLOW FOR THE CONSTRUCTION OF THE HMA BASE COURSE.

REMOVE EXISTING HMA SHOULDERS, REPLACE WITH HMA BASE COURSE, 10".

REINSTALL EXISTING RAIL ELEMENT OF GUARDRAIL.
REMOVE PRELIMINARY STAGE TRAFFIC CONTROL FOLLOWING COMPLETION
OF NORTHSIDE HMA SHOULDER WORK ALONG IL 104.

REPEAT PRELIMINARY CONSTRUCTION SEQUENCE FOR PROPOSED HMA SHOULDER WORK ALONG THE SOUTH SIDE OF IL 104, ADJACENT EAST & WEST OF THE MAUVAISE TERRE STRUCTURE.

STAGE I - CONSTRUCTION SEQUENCE

PLACE CHANGEABLE MESSAGE SIGNS AT LOCATIONS AS CALLED OUT IN THE SPECIAL PROVISIONS.

PLACE 'MAXIMUM WIDTH' SIGNS AT LOCATIONS AS SHOWN IN THESE PLANS.

REMOVE CONFLICTING EXISTING PAVEMENT MARKINGS, COSTS INCLUDED IN THE PAY ITEM FOR TRAFFIC CONTROL HIGHWAY STANDARD 701423.


SET UP STAGE I TRAFFIC CONTROL UTILIZING THESE PLANS IN CONJUNCTION WITH HIGHWAY STANDARD 701423. PLACE TEMPORARY CONCRETE BARRIER, IMPACT ATTENUATORS, DRUMS, BARRICADES, TEMPORARY PAVEMENT MARKINGS, ARROW BOARDS, ETC. IN ACCORDANCE TO THESE PLANS.

PERFORM DECK SLAB REPAIRS, JOINT REPAIRS, AND REMOVAL/REPLACEMENT OF STEEL DIAPHRAGMS WITHIN THE DESIGNATED WORK AREA AS ILLUSTRATED IN THESE PLANS.

STAGE II - CONSTRUCTION SEQUENCE

FOLLOWING THE COMPLETION OF STAGE 1 CONSTRUCTION, RELOCATE THE TEMPORARY CONCRETE BARRIER WALL, IMPACT ATTENUATORS, DRUMS, ARROW BOARDS, BARRICADES, ETC. REMOVE STAGE I TEMPORARY PAVEMENT MARKING, PLACE STAGE II TEMPORARY PAVEMENT MARKING IN ACCORDANCE TO THESE PLANS.


PERFORM STAGE 2 DECK SLAB REPAIRS, JOINT REPAIRS, AND FLOOR DRAIN EXTENSIONS WITHIN THE DESIGNATED WORK AREA AS ILLUSTRATED IN THESE PLANS.

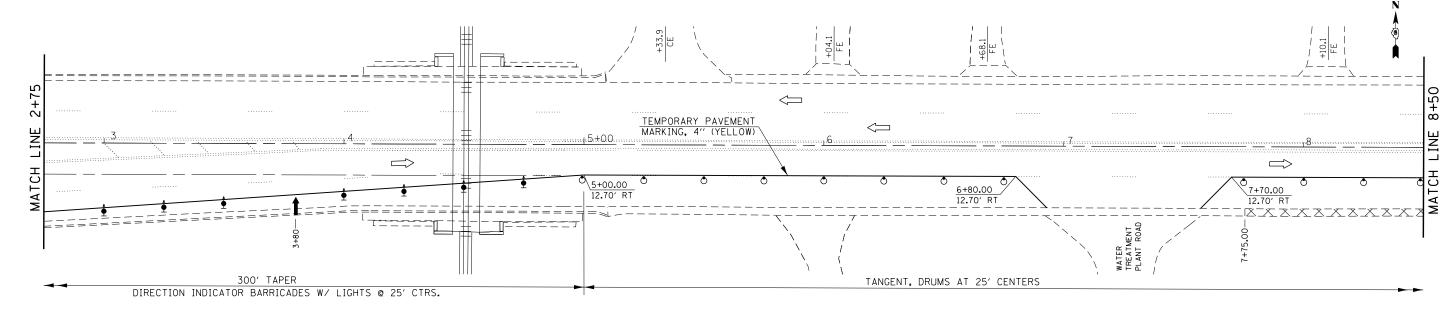


STAGE I TRAFFIC CONTROL (CONTINUED)

•- 310A, 753 ••- 23BR, RS6, TS5; 33BR-1, RS4, TS-2

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Default	PLOT DATE = 1/28/2016	DATE - 06-15-2015	REVISED -	SC				ILLINOIS FED. AI	D PROJECT	

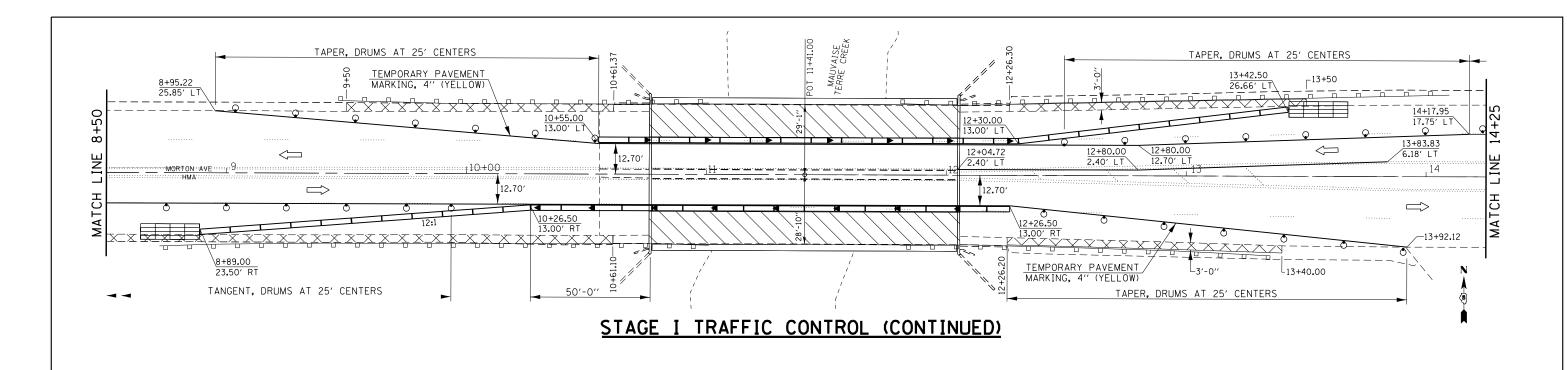

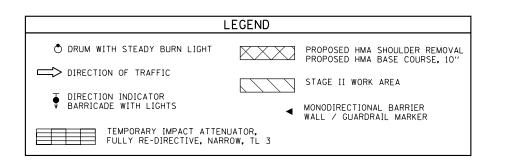

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STAGE I - CONSTRUCTION SEQUENCE

PLACE CHANGEABLE MESSAGE SIGNS AT LOCATIONS AS CALLED OUT IN THE SPECIAL PROVISIONS.

PLACE 'MAXIMUM WIDTH' SIGNS AT LOCATIONS AS SHOWN IN THESE PLANS.

REMOVE CONFLICTING EXISTING PAVEMENT MARKINGS, COSTS INCLUDED IN THE PAY ITEM FOR TRAFFIC CONTROL HIGHWAY STANDARD 701423.

SET UP STAGE I TRAFFIC CONTROL UTILIZING THESE PLANS IN CONJUNCTION WITH HIGHWAY STANDARD 701423. PLACE TEMPORARY CONCRETE BARRIER, IMPACT ATTENUATORS, DRUMS, BARRICADES, TEMPORARY PAVEMENT MARKINGS, ARROW BOARDS, ETC. IN ACCORDANCE TO THESE PLANS.

PERFORM DECK SLAB REPAIRS, JOINT REPAIRS, AND REMOVAL/REPLACEMENT OF STEEL DIAPHRAGMS WITHIN THE DESIGNATED WORK AREA AS ILLUSTRATED IN THESE PLANS.

STAGE II - CONSTRUCTION SEQUENCE

FOLLOWING THE COMPLETION OF STAGE I CONSTRUCTION, RELOCATE THE TEMPORARY CONCRETE BARRIER WALL, IMPACT ATTENUATORS, DRUMS, ARROW BOARDS, BARRICADES, ETC. REMOVE STAGE I TEMPORARY PAVEMENT MARKING, PLACE STAGE II TEMPORARY PAVEMENT MARKING, AND ADJUST "MAX WIDTH" SIGNS IN ACCORDANCE TO THESE PLANS.

PERFORM STAGE 2 DECK SLAB REPAIRS, JOINT REPAIRS, AND FLOOR DRAIN EXTENSIONS WITHIN THE DESIGNATED WORK AREA AS ILLUSTRATED IN THESE PLANS

STAGE I TRAFFIC CONTROL

TO STA.

MAUVAISE TERRE (S.N. 09-0009)

SHEET 2 OF 3 SHEETS STA.

SCALE:

•- 310A, 753 •-- 23BR, RS6, TS5; 33BR-1, RS4, TS-2


COUNTY

MORGAN

366 197


CONTRACT NO. 72D21

SECTION

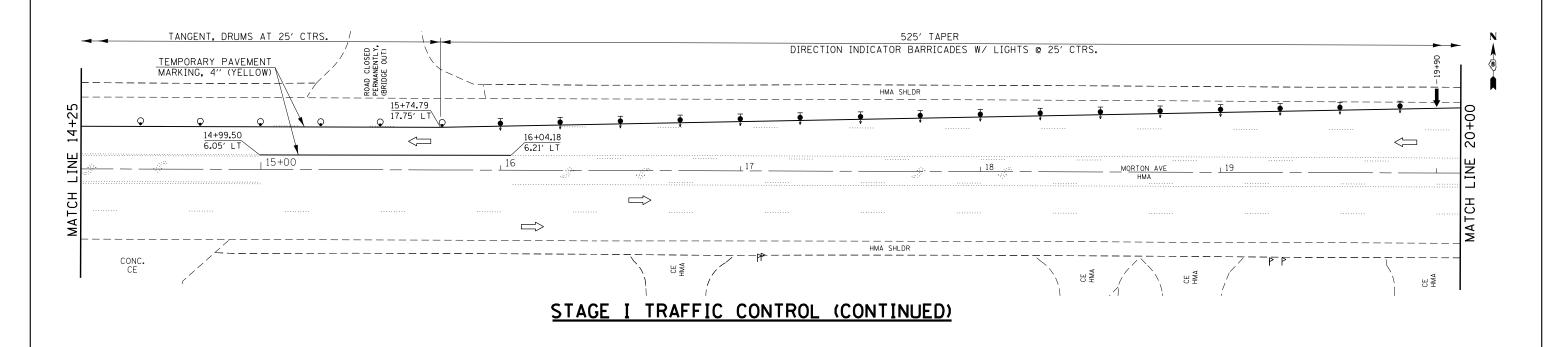

STATE OF ILLINOIS

DEPARTMENT OF TRANSPORTATION

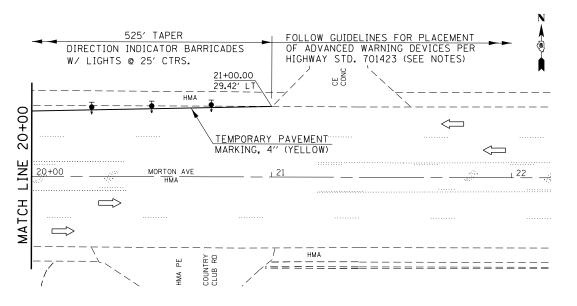

STAGE I TRAFFIC CONTROL (CONTINUED)

LEGEND

DIRECTION INDICATOR
BARRICADE WITH LIGHTS

TRAFFIC STAGING NOTES

THIS TRAFFIC CONTROL PLAN SHALL BE USED IN CONJUNCTION WITH STANDARD 701423 AND AS DIRECTED BY THE ENGINEER.

THE CONTRACTOR SHALL NOTIFY DISTRICT 6 TRAFFIC SECTION OF THE BUREAU OF OPERATIONS (PH. 217-782-7314) AT LEAST ONE WEEK PRIOR TO IMPLEMENTING STAGE TRAFFIC CONTROL.

ALL EXISTING PAVEMENT MARKING THAT CONFLICTS WITH STAGE CONSTRUCTION STRIPPING SHALL BE REMOVED.

THE COSTS FOR TEMPORARY PAVEMENT MARKINGS ARE INCLUDED IN THE PAY ITEM FOR 'TRAFFIC CONTROL AND PROTECTION STANDARD 701423, SPECIAL'.

ADVANCED WARNING SIGNS PER TRAFFIC CONTROL STANDARD 701423 SHALL BE MODIFIED TO REFLECT A WORK ZONE SPEED LIMIT OF 35 MPH. ONE ARROW BOARD FOR EACH DIRECTION OF TRAFFIC SHALL BE UTILIZED.

PRELIMINARY STAGE - CONSTRUCTION SEQUENCE

SET UP PRELIMINARY STAGE TRAFFIC CONTROL UTILIZING HIGHWAY STD. 701602 FOR PROPOSED HMA SHOULDER WORK ALONG THE NORTH SIDE OF IL 104, ADJACENT EAST & WEST OF THE MAUVAISE TERRE STRUCTURE.

REMOVE EXISTING RAIL ELEMENT OF GUARDRAIL TO ALLOW FOR THE CONSTRUCTION OF THE HMA BASE COURSE.

REMOVE EXISTING HMA SHOULDERS, REPLACE WITH HMA BASE COURSE. 10".

REINSTALL EXISTING RAIL ELEMENT OF GUARDRAIL.

REMOVE PRELIMINARY STAGE TRAFFIC CONTROL FOLLOWING COMPLETION OF NORTHSIDE HMA SHOULDER WORK ALONG IL 104.

REPEAT PRELIMINARY CONSTRUCTION SEQUENCE FOR PROPOSED HMA SHOULDER WORK ALONG THE SOUTH SIDE OF IL 104, ADJACENT EAST & WEST OF THE MAUVAISE TERRE STRUCTURE.

STAGE I - CONSTRUCTION SEQUENCE

PLACE CHANGEABLE MESSAGE SIGNS AT LOCATIONS AS CALLED OUT IN THE SPECIAL PROVISIONS.

PLACE 'MAXIMUM WIDTH' SIGNS AT LOCATIONS AS SHOWN IN THESE

REMOVE CONFLICTING EXISTING PAVEMENT MARKINGS, COSTS INCLUDED IN THE PAY ITEM FOR TRAFFIC CONTROL HIGHWAY STANDARD 701423. SET UP STAGE I TRAFFIC CONTROL UTILIZING THESE PLANS IN CONJUNCTION

WITH HIGHWAY STANDARD 701423. PLACE TEMPORARY CONCRETE BARRIER, IMPACT ATTENUATORS, DRUMS, BARRICADES, TEMPORARY PAVEMENT MARKINGS, ARROW BOARDS, ETC. IN ACCORDANCE TO THESE PLANS.

PERFORM DECK SLAB REPAIRS, JOINT REPAIRS, AND REMOVAL/REPLACEMENT OF STEEL DIAPHRAGMS WITHIN THE DESIGNATED WORK AREA AS ILLUSTRATED IN THESE PLANS.

STAGE II - CONSTRUCTION SEQUENCE

FOLLOWING THE COMPLETION OF STAGE 1 CONSTRUCTION, RELOCATE THE TEMPORARY CONCRETE BARRIER WALL, IMPACT ATTENUATORS, DRUMS, ARROW BOARDS, BARRICADES, ETC. REMOVE STAGE I TEMPORARY PAVEMENT MARKING, PLACE STAGE II TEMPORARY PAVEMENT MARKING IN ACCORDANCE TO THESE

PERFORM STAGE 2 DECK SLAB REPAIRS, JOINT REPAIRS, AND FLOOR DRAIN EXTENSIONS WITHIN THE DESIGNATED WORK AREA AS ILLUSTRATED IN THESE PLANS.

REMOVE AND REERECT RAIL ELEMENT OF EXISTING GUARDRAIL 63300575

STA. 09+46.70 TO STA. 11+01.10 LT = 154.4 FT STA. 11+80.80 TO STA. 13+55.80 LT = 175.0 FT STA, 08+71,90 TO STA, 11+01,10 RT = 229,2 FT STA. 11+80.80 TO STA. 13+35.20 RT = 154.4 FT TOTAL = 713.0 FT

TEMPORARY CONCRETE BARRIER 70400100

WB IL 104 - STA. 13+42.50 TO STA. 10+55.00 LT = 287.5 FT

EB IL 104 - STA. 08+89.00 TO STA. 12+26.50 RT = 337.5 FT

TOTAL = 625.0 FT

RELOCATE TEMPORARY CONCRETE BARRIER 70400200

WB IL 104 - STA. 13+42.50 TO STA. 10+55.00 LT = 287.5 FT EB IL 104 - STA. 08+89.00 TO STA. 12+26.50 RT = 337.5 FT

TOTAL = 625.0 FT

IMPACT ATTENUATORS, TEMPORARY (FULLY- REDIRECTIVE), TEST LEVEL 3

TOTAL = 211.6 SQ YD

70600260

STA. 08+89.00 23.5 RT = 1 EACH STA. 13+42.00 26.7 LT = 1 EACH

PAVED SHOULDER REMOVAL 44004250

STA. 09+50.00 TO STA. 10+61.37 LT - 3 FT = 37.1 SQ YD STA. 12+26.30 TO STA. 13+50.00 LT - 3 FT = 41.2 SQ YD STA. 07+75.00 TO STA. 10+61.10 RT - 3 FT = 95.4 SQ YD STA. 12+26.20 TO STA. 13+40.00 RT - 3 FT = 37.9 SQ YD

TOTAL = 2 EACH

IMPACT ATTENUATORS, RELOCATE (FULLY- REDIRECTIVE), TEST LEVEL 3

70600332

STA. 08+89.00 6.80 RT = 1 EACH STA. 13+42.00 4.20 LT = 1 EACH

TOTAL = 2 EACH


HMA BASE COURSE 10" 35501324

STA. 09+50.00 TO STA. 10+61.37 LT - 3 FT = 37.1 SQ YD STA. 12+26.30 TO STA. 13+50.00 LT - 3 FT = 41.2 SQ YD STA. 07+75.00 TO STA. 10+61.10 RT - 3 FT = 95.4 SQ YD STA. 12+26.20 TO STA. 13+40.00 RT - 3 FT = 37.9 SQ YD

TOTAL = 211.6 SQ YD

•- 310A, 753 ••- 23BR, RS6, TS5; 33BR-1, RS4, TS-2

DESIGNED - RTS REVISED FILE NAME : USER NAME = Verenskifa SECTION COUNTY STAGE I TRAFFIC CONTROL STATE OF ILLINOIS w:\\ILØ84EBIDINTEG.illino ments\[DOT Offices\District 6\Projects\D67202RAUWNData\GADsheR-Ts\1 Stage Constr -RPWISEO MORGAN 366 198 MAUVAISE TERRE (S.N. 09-0009) CHECKED REVISED **DEPARTMENT OF TRANSPORTATION** CONTRACT NO. 72D21 SCALE: SHEET 3 OF 3 SHEETS STA. TO STA. PLOT DATE = 1/28/2016 REVISED DATE 06-15-2015

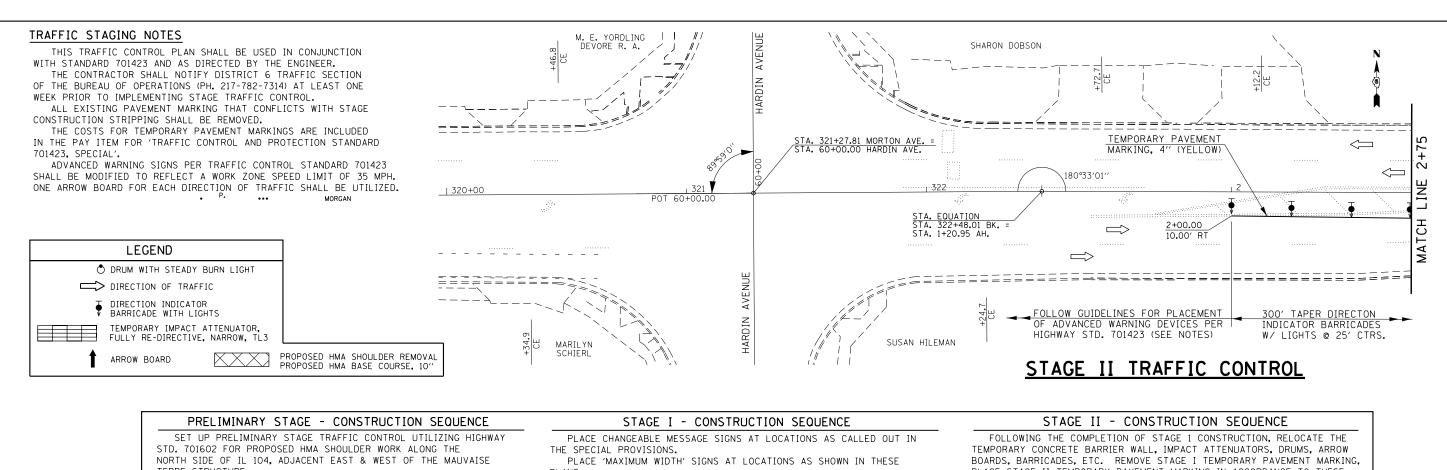

TERRE STRUCTURE.

REMOVE EXISTING RAIL ELEMENT OF GUARDRAIL TO ALLOW FOR THE CONSTRUCTION OF THE HMA BASE COURSE.

REMOVE EXISTING HMA SHOULDERS, REPLACE WITH HMA BASE COURSE, 10".

REINSTALL EXISTING RAIL ELEMENT OF GUARDRAIL. REMOVE PRELIMINARY STAGE TRAFFIC CONTROL FOLLOWING COMPLETION OF NORTHSIDE HMA SHOULDER WORK ALONG IL 104.

REPEAT PRELIMINARY CONSTRUCTION SEQUENCE FOR PROPOSED HMA SHOULDER WORK ALONG THE SOUTH SIDE OF IL 104, ADJACENT EAST & WEST OF THE MAUVAISE TERRE STRUCTURE.

PLANS.


REMOVE CONFLICTING EXISTING PAVEMENT MARKINGS, COSTS INCLUDED IN THE PAY ITEM FOR TRAFFIC CONTROL HIGHWAY STANDARD 701423.

SET UP STAGE I TRAFFIC CONTROL UTILIZING THESE PLANS IN CONJUNCTION WITH HIGHWAY STANDARD 701423. PLACE TEMPORARY CONCRETE BARRIER, IMPACT ATTENUATORS, DRUMS, BARRICADES, TEMPORARY PAVEMENT MARKINGS, ARROW BOARDS, ETC. IN ACCORDANCE TO THESE PLANS.

PERFORM DECK SLAB REPAIRS, JOINT REPAIRS, AND REMOVAL/REPLACEMENT OF STEEL DIAPHRAGMS WITHIN THE DESIGNATED WORK AREA AS ILLUSTRATED IN THESE PLANS.

PLACE STAGE II TEMPORARY PAVEMENT MARKING IN ACCORDANCE TO THESE

PERFORM STAGE 2 DECK SLAB REPAIRS, JOINT REPAIRS, AND FLOOR DRAIN EXTENSIONS WITHIN THE DESIGNATED WORK AREA AS ILLUSTRATED IN THESE

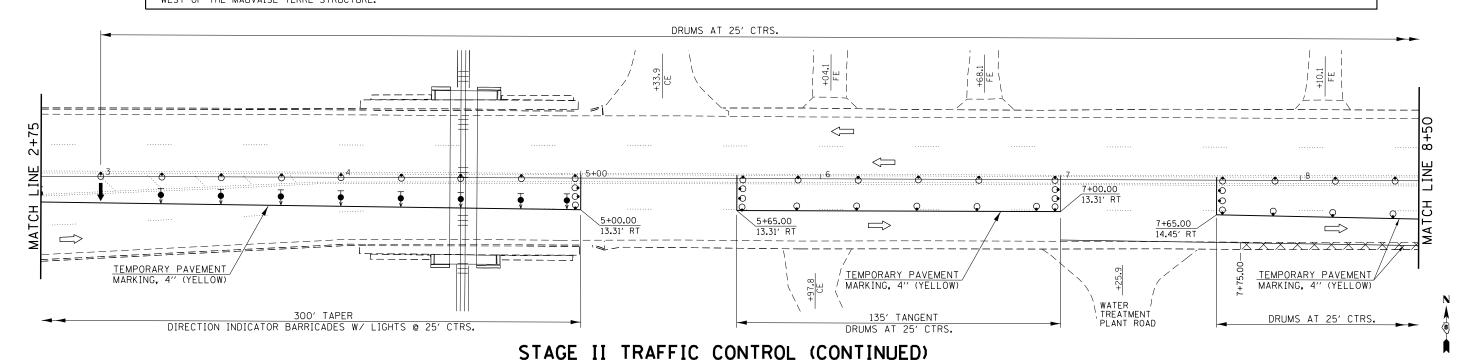

DESIGNED - RTS FILE NAME : REVISED USER NAME = Verenskifa w:\\ILØ84EBIDINTEG.ıllır ments\IDOT Offices\District 6\Projects\D67202RAD#NData\GADsheRFs\1 Stage Constru -RPWISEO CHECKED REVISED

REVISED

DATE

PLOT DATE = 1/28/2016

STATE OF ILLINOIS **DEPARTMENT OF TRANSPORTATION**

SCALE:

SHE

			•- 310A, 753 ••- 23BR, RS6,	TS5; 33BR-:	I, RS4,	TS-2
STAGE II TRAFFIC CONTROL MAUVAISE TERRE (S.N. 09–0009)		F.A. RTE.	SECTION	COUNTY	TOTAL SHEETS	SHEET NO.
		•	••	MORGAN	366	199
WAOVAISE TEIME (5.14. 09-0005)	CONTRACT NO. 72D2					
ET 1 OF 2 SHEETS STA.	TO STA.		ILLINOIS FED. AT	D PROJECT		

