04-22-2016 LETTING ITEM 082

FOR INDEX OF SHEETS, SEE SHEET NO. 2

IRAFFIC DATA

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| ADT: | 8150 | (2015) | |
|------|-------|--------|------|
| | 8300 | (2016) | EST. |
| | 10000 | (2036) | EST. |
| SU: | 6.7% | | |

2.5% MU:

FUNCTIONAL CLASSIFICATION: OTHER ARTERIAL

STATE OF ILLINOIS


DEPARTMENT OF TRANSPORTATION


DIVISION OF HIGHWAYS

PROPOSED HIGHWAY PLANS

FAP ROUTE 805 (IL 161) SECTION 125BR-3 **BRIDGE REPAIR ST. CLAIR COUNTY**

C-98-049-15

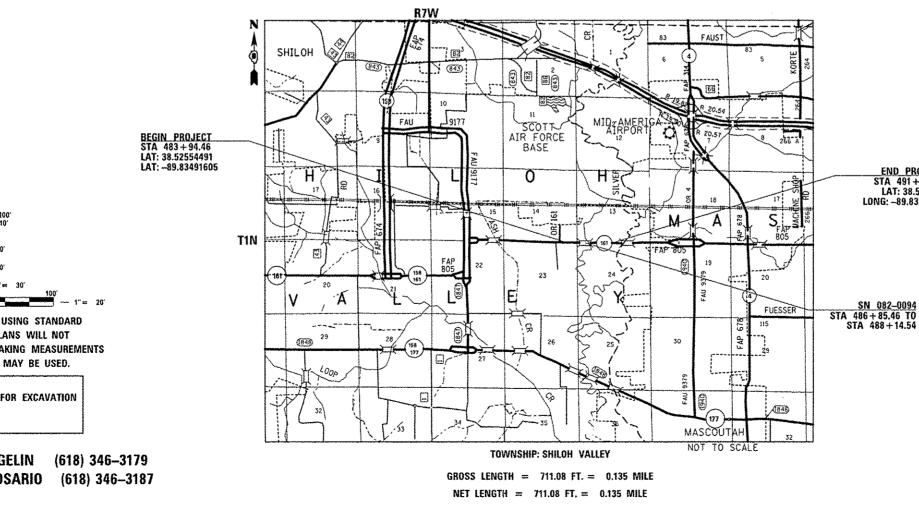

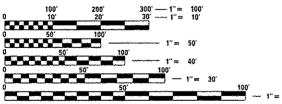


FULL SIZE PLANS HAVE BEEN PREPARED USING STANDARD ENGINEERING SCALES, REDUCED SIZED PLANS WILL NOT CONFORM TO STANDARD SCALES. IN MAKING MEASUREMENTS ON REDUCED PLANS, THE ABOVE SCALES MAY BE USED.

J.U.L.I.E. JOINT UTILITY LOCATION INFORMATION FOR EXCAVATION 1-800-892-0123 OR 811

CONTRACT NO. 76H99


PROJECT ENGINEER: HERVE GELIN (618) 346-3179 DESIGNER: ALVIN NIEVES-ROSARIO (618) 346-3187

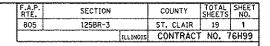



D-98-056-15

END PROJECT STA 491 + 05.54 LAT: 38.525471 LONG: --89.8324922

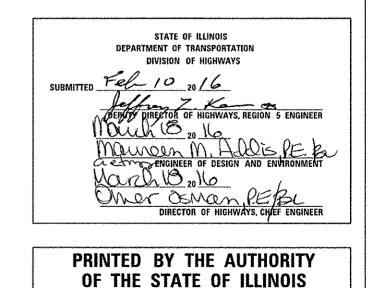

INDEX OF SHEETS

- 1 COVER SHEET 2 INDEX OF SHEETS, GENERAL NOTES, COMMITMENTS & HIGHWAY STANDARDS 3-4 SUMMARY OF QUANTITIES
- 5 TYPICAL SECTIONS
- 6 LOCATON MAP
- 7 SCHEDULES
- 8-18 BRIDGE PLANS 19 DETAIL SHEET

HIGHWAY STANDARDS

| 000001-06 | STANDARD SYMBOLS, ABBREVIATIONS AND PATTERNS |
|-----------|--|
| 001001-02 | AREAS OF REINFORCEMENT BARS |
| 001006 | DECIMAL OF AN INCH AND OF A FOOT |
| 701001-02 | OFF ROAD OPERATIONS, 2L, 2W, MORE THAN 15' (4.5m) AWAY |
| 701006-05 | OFF ROAD OPERATIONS, 2L, 2W, 15' TO 24" FROM PAVEMENT EDGE |
| 701011-04 | OFF ROAD MOVING OPERATIONS, 2L, 2W, DAY ONLY |
| 701201-04 | LANE CLOSURE, 2L, 2W, DAY ONLY, FOR SPEEDS ≥ 45 MPH |
| 701301~04 | LANE CLOSURE. 2L, 2W, SHORT TIME OPERATIONS |
| 701305-03 | LANE CLOSURE, 2L, 2W, SLOW MOVING OPERATIONS DAY ONLY, FOR SPEEDS ≥ 45 MPH |
| 701311-03 | LANE CLOSURE, 2L, 2W, MOVING OPERATIONS - DAY ONLY |
| 701321-15 | LANE CLOSURE, 2L, 2W, BRIDGE REPAIR WITH BARRIER |
| 701326-04 | LANE CLOSURE. 2L, 2W, PAVEMENT WIDENING, FOR SPEEDS ≥ 45 MPH |
| 701901-05 | TRAFFIC CONTROL DEVICES |
| 704001-08 | TEMPORARY CONCRETE BARRIER |
| 780001-05 | TYPICAL PAVEMENT MARKINGS |
| 781001-04 | TYPICAL APPLICATIONS RAISED REFLECTIVE PAVEMENT MARKERS |

MIXTURE REQUIREMENTS

| ROUTE | FAP 805 (IL 161) |
|----------|------------------|
| SECTION | 125BR-3 |
| COUNTY | ST. CLAIR |
| CONTRACT | 76Н99 |

| DESCRIPTION: | BRIDGE REPAIRS - REPLACING JOINTS MICROSILICA OVERLAY ON BRIDGE (SN 082-0094), HMA APPROACH TO MATCH. |
|--------------|--|
| | l |

| · [| IL 161 |
|---------------------------|--------|
| ADT (CONSTRUCTION YR,) | 8300 |
| MU%: | 3 |
| SU%: | 7 |
| 20 YR. ESAL: | 2.18 |

| MIXTURE USE | SURFACE | SHOULDERS > 2, 25" | SHOULDERS < 2.25" |
|--------------------------------|-----------------------|-----------------------|-----------------------|
| AC/PG | PG-64-22 | PC-64-22 | PG 64-22 |
| RAP % (MAX) | SEE SPECIAL PROVISION | SEE SPECIAL PROVISION | SEE SPECIAL PROVISION |
| DESIGN AIR VOIDS | 4.0% @ Ndes≈70 | 4.0% @ Ndes=30 | 4.0% @ Ndes=30 |
| MIX COMPOSITION (GRADATION) | 1L 9.5 | IL 19.0L | IL 9.5L |
| FRICTION AGG | MIXTURE "D" | | |
| QUALITY MGMT PROGRAM | DC/OA | 0C/0A | QC/ QA |

PLAN QUANTITIES FOR HMA SURFACE COURSE ITEMS ARE CALCULATED USING A UNIT WEIGHT OF 112 LB/SO YD/IN.

GENERAL NOTES

- 1. THE CONTRACTOR AND THE ENGINEER SHALL BE AWARE THAT NO FORMAL SURVEY WAS PERFORMED FOR THIS PROJECT. THE STATIONING AND TOPO SHOWN IN THE PLANS WAS CREATED USING MICROFILM AND FIELD MEASUREMENTS MADE BY DESIGN PERSONNEL. BOTH SHALL BE ASSUMED TO BE APPROXIMATE,
- 2. ILLINOIS STATE LAW REQUIRES A 48-HOUR NOTICE BE GIVEN TO ALL UTILITIES WITHIN THE PROJECT AREA BEFORE DIGGING. FIELD MARKING OF FACILITIES MAY BE OBTAINED BY CONTACTING J.U.L.I.E. OR FOR NON-MEMBERS, THE UTILITY COMPANY DIRECTLY. AGENCIES KNOWN TO HAVE FACILITIES WITHIN THE PROJECT AREA ARE AS FOLLOWS:

| •AT&T ILLINOIS - COMMUNICATIONS | | 8 | BURIED |
|--------------------------------------|----------|---|--------|
| CHARTER COMMUNICATIONS, INC CABLE TV | (AER) AL | & | BURIED |
| •FRONTIER NORTH, INC COMMUNICATIONS | (AERIAL | 8 | BURIED |

MEMBERS OF J.U.L.I.E. CALL TOLL FREE (800) 892-0123 OR 811 AND ARE INDICATED BY .. NON-JULLIE, MEMBERS MUST BE NOTIFIED INDIVIDUALLY.

- 3. THE CONTRACTOR SHALL VERIFY ALL DIMENSIONS AND CONDITIONS IN THE FIELD PRIOR TO ORDERING OF MATERIALS AND CONSTRUCTION.
- 4. THE THICKNESS OF THE BITUMINOUS MIXTURE SHOWN ON THE PLANS IS THE NOMINAL THICKNESS, DEVIATIONS FROM THE NOMINAL THICKNESS WILL BE PERMITTED WHEN SUCH DEVIATIONS OCCUR DUE TO IRREGULARITIES IN THE EXISTING SURFACE OR BASE ON WHICH THE BITUMINOUS MIXTURE IS PLACED.
- 5. THIS PROJECT INCLUDES REPLACEMENT OF THE EXISTING HMA SHOULDERS FOR TRAFFIC STAGING, EXISTING GUARDRAIL SHALL REMAIN IN PLACE.
- 6. NO SEEDING IS ANTICIPATED IN THIS CONTRACT. ALL AREAS DISTURBED BY THE CONTRACTOR OUTSIDE THE PROPOSED CONSTRUCTION LIMITS SHALL BE SEEDED AT THE CONTRACTOR'S EXPENSE.
- 7. THE PAVEMENT MARKING SHOWN IN THE SCHEDULES IS APPROXIMATE. THE LOCATION OF THE PROPOSED MARKINGS SHALL MATCH EXISTING LOCATIONS.
- 8. ALL TEMPORARY PAVEMENT MARKINGS SHALL BE PLACED IN SUCH A MANNER SO AS NOT TO INTERFERE WITH THE PLACEMENT OF PERMANENT PAVEMENT MARKINGS.
- 9. NO EQUIPMENT SHALL BE STORED OR LEFT IN PLACE LESS THAN 24" BEHIND TEMPORARY CONCRETE BARRIER OVERNIGHT.
- 10. THE DEPARTMENT STRONGLY ENCOURAGES THE PRIME CONTRACTOR AND THEIR APPROVED SUB-CONTRACTORS TO HIRE MINORITY, WOMEN AND DISADVANTAGED INDIVIDUALS FROM ITS FEDERALLY FUNDED HIGHWAY CONSTRUCTION CAREERS TRAINING PROGRAM (HCCTP) TO HELP MEET WORKFORCE AND TRAINEE GOALS, THIS PROGRAM IS TRAINING MINORITIES, WOMEN AND DISADVANTAGED INDIVIDUALS IN HIGHWAY CONSTRUCTION-RELATED SKILLS, E.G., MATH FOR THE TRADES. JOB READINESS. TECHNICAL SKILLS COURSEWORK (CARPENTRY, CONCRETE FLATWORK, BLUEPRINT READING, SITE PLANS, SITE WORK, TOOLS USE, ETC.) AND OSHA 10 HOUR CERTIFICATION, TO PREPARE THEM FOR A CAREER IN THE HIGHWAY CONSTRUCTION TRADES. GRADUATES ARE WELL-TRAINED AND READY TO BECOME PRODUCTIVE ENTRY-LEVEL CONSTRUCTION WORKERS. CONTACT THE DISTRICT & EEO OFFICE AT 618-346-3360 AND/OR THE HCCTP COORDINATOR AT 618-874-6528 TO LEARN MORE ABOUT THE PROGRAM AND FOR ASSISTANCE IN MEETING WORKFORCE AND TRAINEE GOALS.
- 11. IF CONSTRUCTION ACTIVITY IS PLANNED DURING THE INDIANA BAT AND NORTHERN LONG-EARED BAT ACTIVITY SEASON - DURING APRIL 1 THROUGH SEPTEMBER 30 - PERFORM A FINAL INSPECTION OF THE BRIDGE NO MORE THAN 7 DAYS PRIOR TO THE START OF CONSTRUCTION ACTIVITY TO ENSURE BATS HAVE NOT STARTED TO USE THE AREA OF THE BRIDGE PROPOSED FOR WORK AFTER THE ORIGINAL INSPECTION.

| FILE NAME = | USER NAME = nievose | DESIGNED - | REVISED - | | INDEX OF SHEETS, HIGHWAY STANDARDS, | F.A.P. SECTION | COUNTY TOTAL SHEET |
|--|--|--|------------|------------------------------|---|---------------------------------|--------------------|
| pwt\\ILØ84EBIOINTEG.J1Innois.goviPWIDDT\Do | umenta/1007 Officen/District 8/Projects/D8 | 7510RX0HDOata\EADshasts\d876h9-sht-plan. | 9REVISED - | STATE OF ILLINOIS | GENERAL NOTES & COMMITMENTS | 805 125BR-3 | ST. CLAIR 19 2 |
| | PLOT SCALE = 100.0000 ' / in. | CHECKED - | REVISEO - | DEPARTMENT OF TRANSPORTATION | | | CONTRACT NO. 76H99 |
| | PLOT DATE + 2/8/2016 | DATE - | REVISED - | | SCALE: NTS SHEET NO. 1 OF 1 SHEETS STA. TO STA. | FED. ROAD DIST. NO. ILLINDIS FE | 9. ALD PROJECT |
| | | | | | · · · · · · · · · · · · · · · · · · · | | |

COMMITMENTS NONE

| | | | | CONSTR. CODE | |
|----------------------|--|-----------|-----------------|-----------------|----------|
| | | | 100 %. STATE | | |
| | | | | BRIDGE | |
| CODE | | | TOTAL | 0014 | |
| NO. | ITEM | UNIT | QUANTITY | RURAL | |
| | | | | | |
| 20200100 | EARTH EXCAVATION | CU YD | 36 | 36 | |
| | | | | | |
| 40600290 | BITUMINOUS MATERIALS (TACK COAT) | POUND | 120 | 120 | |
| | · · · · · · · · · · · · · · · · · · · | | | | |
| 40600982 | HOT-MIX ASPHALT SURFACE REMOVAL - BUTT JOINT | SO YD | 400 | 400 | |
| | | | | | |
| 40603340 | HOT-MIX ASPHALT SURFACE COURSE, MIX "D", N70 | TON | 30 | 30 | |
| | HDI-MIA ASI AALI SURAACE COURSE, MIA D., MIO | | | | |
| 44004950 | | SQ_YD | 148 | 148 | |
| 44004250 | PAVED SHOULDER REMOVAL | | 140 | 140 | |
| | | | | | |
| 48102100 | AGGREGATE WEDGE SHOULDER, TYPE B | TON | 8 | 8 | |
| | | | | | |
| 48203029 | HOT-MIX ASPHALT SHOULDERS, 8" | SO YD | 248 | 248 | |
| | | | | | |
| 48203100 | HOT-MIX ASPHALT SHOULDERS | TON | 16 | 16 | |
| 50103400 | | CU YD | 9.6 | 9.6 | |
| 50102400 | CONCRETE REMOVAL | | 3. 0 | 5.0 | |
| 50300100 | | EACH | 12 | 12 | |
| 50300100 | FLOOR DRAINS | EACO | 12 | 12 | |
| | | | | 10.7 | |
| 50300255 | CONCRETE SUPERSTRUCTURE | | 10.7 | 10.7 | |
| | | CO VD | 400 | 420 | |
| 50300260 | BRIDGE DECK GROOVING | SO YD | 420 | 120 | |
| E0500205 | FURNISHING AND ERECTING STRUCTURAL STEEL | POUND | 1780 | 1780 | |
| 50500405 | FUNNISATING MAD ENERLING STRUCTURAL STEEL | | | 1100 | |
| | | BOUND | 17.0- | 1200 | |
| 50800205 | REINFORCEMENT BARS, EPOXY COATED | POUND | 1200 | 1200 | * |
| | | | 1 | <u> </u> | |
| 1E = | USER NAME = NOVOSO DESIGNED - | REVISED - | | | |
| 84EBIDINTEG.21120038 | .gov:PWIDOTNOouments/100T Offices/District 8/Projects/0072087X0900ata/602ahasts/d87EA99+sht:p PLDT SCALE = 100.0008 // in CHECKED - | REVISED - | | ST/ DEPARTME | ATE OF H |

| | | | | CONSTR. CODE |
|----------|---|--------|-----------------|--------------|
| | | | 100 %. STATE | |
| | | | | BRIDGE |
| CODE | | | TOTAL | 0014 |
| NO. | ITEM | UNIT | QUANTITY | RURAL |
| 50800515 | BAR SPLICERS | EACH | 26 | 26 |
| 52000110 | PREFORMED JOINT STRIP SEAL | FOOT | 68 | 68 |
| 52100010 | ELASTOMERIC BEARING ASSEMBLY, TYPE I | EACH | 10 | 10 |
| | | | | |
| 52100520 | ANCHOR BOLTS, 1" | EACH | 20 | 20 |
| 67000400 | ENGINEER'S FIELD OFFICE, TYPE A | CAL MO | 3 | 3 |
| 67100100 | MOBILIZATION | LSUM | 1 | 1 . |
| 70100405 | TRAFFIC CONTROL AND PROTECTION, STANDARD 701321 | EACH | 1 | 1 |
| | | | | |
| 70100450 | TRAFFIC CONTROL AND PROTECTION, STANDARD 701201 | LSUM | 1 | 1 |
| 70100460 | TRAFFIC CONTROL AND PROTECTION, STANDARD 701306 | L SUM | | 1 |
| 70100500 | TRAFFIC CONTROL AND PROTECTION, STANDARD 701326 | L SUM |] | 1 |
| 70103815 | TRAFFIC CONTROL SURVEILLANCE | CAL DA | 5 | 5 |
| 70106500 | TEMPORARY BRIDGE TRAFFIC SIGNALS | EACH |] | 1 |
| | | | | |
| 70106700 | TEMPORARY RUMBLE STRIPS | EACH | 6 | 6 |
| 70300100 | SHORT TERM PAVEMENT MARKING | FOOT | 28 | 28 |

FILE NAME : USER NAME : OBVISED DESIGNED - REVISED - STATE OF ILLINOIS PHOT GOTE : 2/8/2016 DATE - REVISED - STATE OF TRANSPORTATION PLOT GOTE : 2/8/2016 DATE - REVISED - SCALE : NTS SHEET NO. 1 OF 2 SHEETS ST.


| ITITIES | | F.A.P. RTE. | SECTION | COUNTY | TOTAL | SHEET NO. |
|---------|---------|----------------|-------------------------|-------------|---------|--------------|
| | | 805 | 12588-3 | ST. CLAIR | 19 | 3 |
| | | | | CONTRAC | F NO. 7 | 6H99 |
| TA. | TO STA. | FED. ROAD | DIST. NO. ILLINDIS FED. | ALC PROJECT | | |

| CODE NO. ITEM DRIDCE OOI4 OOI4 7030020 SHORT TERM PAVEMENT MARKING REMOVAL 50 F1 10 10 7030020 TEMPORARY PAVEMENT MARKING REMOVAL 50 F1 10 10 7030020 TEMPORARY PAVEMENT MARKING - LINE 4" F00T 884 884 7030020 TEMPORARY PAVEMENT MARKING - LINE 4" F00T 364 1864 70400100 TEMPORARY PAVEMENT MARKING - LINE 6" F00T 375 375 70400200 RELOCATE TEMPORARY CONCRETE BARRIER F00T 375 375 70600250 IMPACT ATTENUATORS, RELOCATE (NON- REDIRECTIVE). EACH 2 2 7800000 MODIFIED UNETHANE PAVEMENT MARKING - LINE 4" F00T 884 884 | |
|---|-------------|
| Image: Second | CODE NO. |
| Image: Constraint of the second sec | 78300200 |
| TO300240 TEMPORARY PAVEMENT MARKING - LINE 6" F00T 1884 1884 T0400100 TEMPORARY CONCRETE BARRIER F00T 375 375 T0400200 RELOCATE TEMPORARY CONCRETE BARRIER F00T 375 375 T0400200 RELOCATE TEMPORARY CONCRETE BARRIER F00T 375 375 T0400200 RELOCATE TEMPORARY CONCRETE BARRIER F00T 375 375 T0500250 IMPACT ATTENUATORS, TEMPORARY (NON- REDIRECTIVE), EACH 2 2 TEST LEVEL 3 | X5870015 |
| T040010 TEMPORARY CONCRETE BARRIER F00T 375 375 T0400200 RELOCATE TEMPORARY CONCRETE BARRIER F00T 375 375 T0400200 RELOCATE TEMPORARY CONCRETE BARRIER F00T 375 375 T0500250 IMPACT ATTENUATORS, TEMPORARY (NON- REDIRECTIVE), EACH 2 2 TEST LEVEL 3 | 20001899 |
| Impact attenuators, temporary (non- redirective). EACH 2 2 TEST LEVEL 3 Impact attenuators, relocate (non- redirective). EACH 2 2 Toboo350 Impact attenuators, relocate (non- redirective). EACH 2 2 Test Level 3 Impact attenuators, relocate (non- redirective). EACH 2 2 Toboo350 Impact attenuators, relocate (non- redirective). EACH 2 2 Test Level 3 Impact attenuators, relocate (non- redirective). EACH 2 2 Taboo9004 MODIFIED URETHANE PAVEMENT MARKING - LINE 4" FOOT B84 B84 Taboo100 RAISED REFLECTIVE PAVEMENT MARKER EACH 8 8 Taboo100 RAISED REFLECTIVE PAVEMENT MARKER (BRIDGE) EACH 2 2 Taboo005 GUARDRAIL REFLECTORS, TYPE A EACH 40 40 Taboo011 BARRIER WALL REFLECTORS, TYPE C EACH 56 56 | 20012130 |
| TEST LEVEL 3 Impact attenuators. relocate (non- redirective). EACH Z Z Test level 3 Impact attenuators. relocate (non- redirective). EACH Z Z Test level 3 Impact attenuators. Impact attenuators. Impact attenuators. Impact attenuators. Test level 3 Impact attenuators. Impact attenuators. Impact attenuators. Impact attenuators. T8009004 MODIFIED URETHANE PAVEMENT MARKING - LINE 4" FOOT 884 884 Impact attenuators. Impact attenuators. Impact attenuators. Impact attenuators. T8100100 RAISED REFLECTIVE PAVEMENT MARKER EACH 8 8 Impact attenuators. Impact attenuators. Impact attenuators. Impact attenuators. T8100105 RAISED REFLECTIVE PAVEMENT MARKER (BRIDGE) EACH 2 2 T8200005 GUARDRAIL REFLECTORS. TYPE A Impact attenuators. Impact attenuators. Impact attenuators. T8200011 BARRIER WALL REFLECTORS. TYPE C EACH 56 56 | 20012166 |
| TOST CERCE 0 Impact attenuators, relocate (non- redirective), EACH 2 2 TEST LEVEL 3 Impact attenuators, relocate (non- redirective), EACH 2 2 T8009004 MODIFIED URETHANE PAVEMENT MARKING - LINE 4" FOOT 884 884 78100100 RAISED REFLECTIVE PAVEMENT MARKER EACH 8 8 78100105 RAISED REFLECTIVE PAVEMENT MARKER (BRIDGE) EACH 2 2 78200005 GUARDRAIL REFLECTORS, TYPE A EACH 40 40 78200011 BARRIER WALL REFLECTORS, TYPE C EACH 56 56 | 20016002 |
| TEST LEVEL 3 | |
| 78009004 MODIFIED URETHANE PAVEMENT MARKING - LINE 4" FOOT 884 884 78100100 RAISED REFLECTIVE PAVEMENT MARKER EACH 8 8 78100105 RAISED REFLECTIVE PAVEMENT MARKER (BRIDGE) EACH 2 2 78100105 RAISED REFLECTIVE PAVEMENT MARKER (BRIDGE) EACH 2 2 78200005 GUARDRAIL REFLECTORS, TYPE A EACH 40 40 78200011 BARRIER WALL REFLECTORS, TYPE C EACH 56 56 | |
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| 78200011 BARRIER WALL REFLECTORS. TYPE C EACH 56 56 | |
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| SPECIALTY ITEM NAME = USER NAME = NJAVARA DESIGNED ~ REVISED ~ | |
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| PLOT SCALE + 109.0000 1 / 1n. CHECKED - REVISED - DEPARTMENT OF TRANSPO | JRIATION |

| | | · |
|---|-------------|---|
| | CODE NO. | ITEM |
| | 78300200 | RAISED REFLECTIVE PAVEMENT MARKER REMOV |
| | X5870015 | BRIDGE DECK CONCRETE SEALER |
| | 20001899 | JACK AND REMOVE EXISTING BEARINGS |
| | 20012130 | BRIDGE DECK SCARIFICATION 3/4" |
| | 20012166 | BRIDGE DECK MICROSILICA CONCRETE OVERLA |
| | | DECK SLAB REPAIR (FULL DEPTH, TYPE II) |
| 0 | | |
| - | | |
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| | | [| CONSTR. CODE | | |
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| | | 100 % STATE | | | |
| | | | BRIDGE | | |
| | | TOTAL | 0014 | | |
| | UNIT | QUANTITY | RURAL | | |
| | | | | | |
| VAL . | EACH | 10 | 10 | | |
| | | | | | |
| | SQ FT | 5097 | 5097 | | |
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| ****** | EACH | 10 | 10 | | |
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| | SQ YD | 434 | 434 | | |
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| AY 2 3/4" | SQ YD | 434 | 434 | | |
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| | F.A.P. RTE. | SECTION | COUNTY | TOTAL SHEETS | SHEET NO. |
|---|----------------|----------------------------|-----------|-----------------|--------------|
| SUMMARY OF QUANTITIES | 805 | 125BR-3 | ST. CLAIR | 19 | 4 |
| · | | | CONTRACT | | 76H99 |
| SCALE: NTS SHEET NO. 2 OF 2 SHEETS STA. TO STA. | FED. ROAD | DIST. NO. ILLINDIS FED. AL | O PROJECT | | |



| FILE NAME = | USER NAME = nievesa | DESIGNED - | REVISED - | | | | | F.A.P. | SECTION | COUNTY T | TOTAL SHEET | |
|---|------------------------------|---|------------|--|------------|-------------------------|---------|-----------|---------------|----------------------|---------------|--|
| pw://ILØ84EBIDINTEG.1111no15.gov:PWIDOT/Documents/IDOT_Offices/District_8/Projects/D8 | | H DRAMAN Data\EADsheets\d876h99-sht-plan.c | 9REVISED - | STATE OF ILLINOIS EXISTING & PROPOSED TYPICAL SECTIONS | | 805 | 125BR-3 | ST. CLAIR | 19 5 | | | |
| | PLOT SCALE = 100.0000 '/ in. | CHECKED - | REVISED - | DEPARTMENT OF TRANSPORTATION | | | | · · · · · | | CONTRACT I | NO. 76H99 | |
| | PLOT DATE = 2/8/2016 | DATE - | REVISED - | | SCALE: NTS | SHEET NO. 1 OF 1 SHEETS | STA. | TO STA. | FED. ROAD DIS | ST. NO. ILLINOIS FEE | . AID PROJECT | |
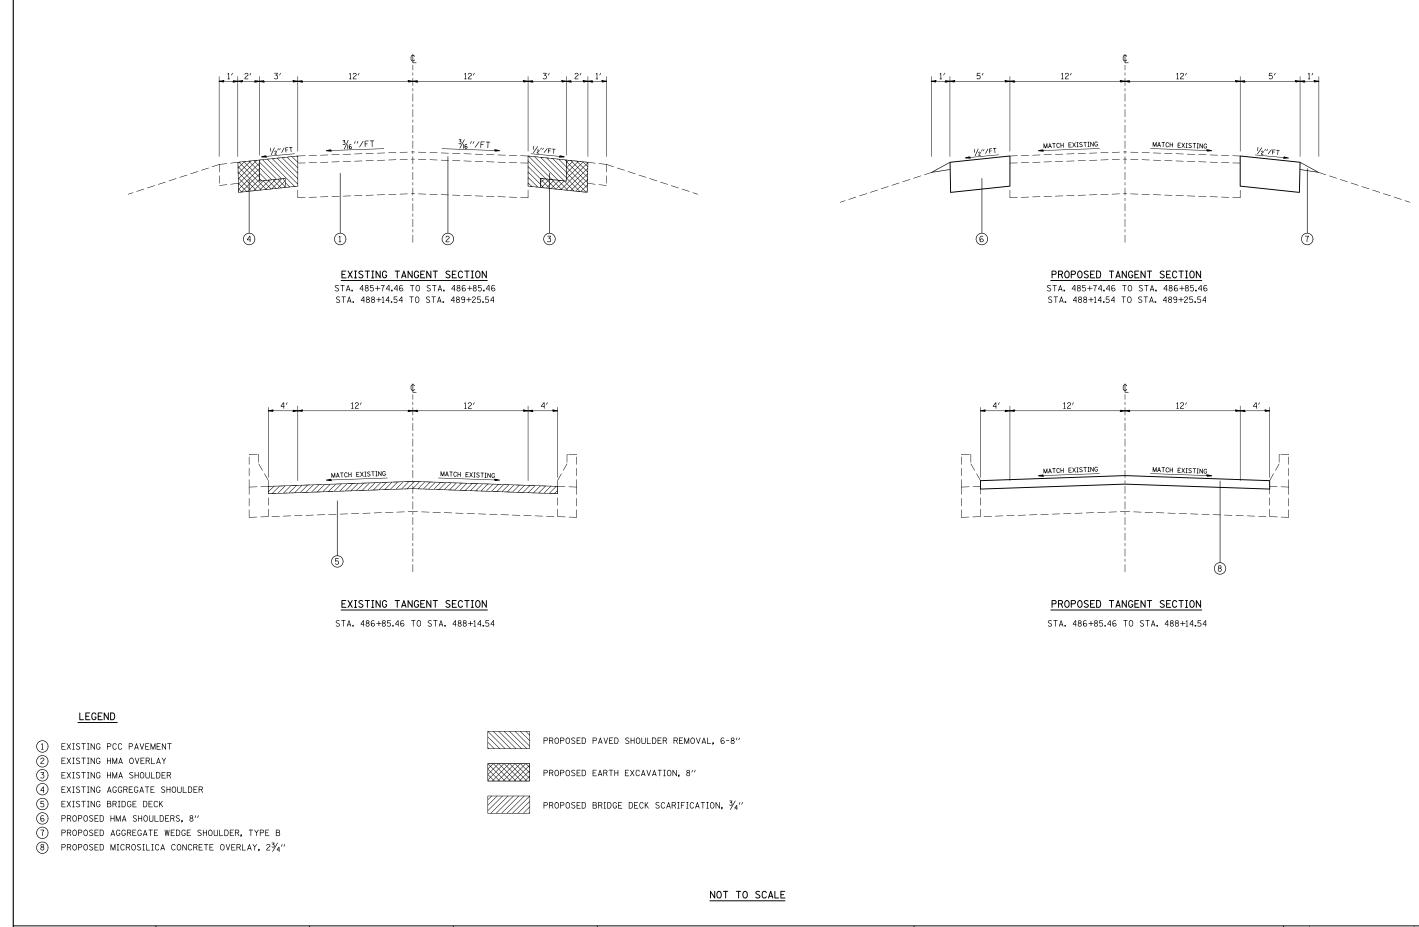
| | BEGIN PRO. STA. 483 + 9 | JECT 4.46 | 8" HMA SHOULDERS (LIMITS STA. 485 + 74.46 TO STA. 486 + 85.46 | 5) | | SN 08 STA. 486 + 8! STA. 488 | <u>32–0094</u> 5.46 T0 + 14.54 | 8" HMA SHOULDERS (LIMITS) STA. 488 + 14.54 TO STA. 489 + 25.54 | | END STA. 6 | <u>PROJECT</u> 191 + 05.54 |
|-------------------------------|----------------------------|--|---|--|----------------------------------|------------------------------------|--------------------------------------|--|---------------------------------------|--|--|
| | | | | | <u>NOT TO SCA</u> | <u>LE</u> | | | | | |
| AME = _084EBIDINTEG.1111nc | o1s.gov:PWIDOT\Do | puments\IDOT Offices\District 8\Projects\D8; PLOT SCALE = 100.0000 '/ in. | DESIGNED - CH CRAWND dta\EADsheets\d876h99-sht-plan. CHECKED - DATE - | REVISED - gREVISED - REVISED - REVISED - REVISED - | STATE OF IL Department of Tr/ | LINOIS ANSPORTATION | SCALE: NTS SHEET NO. 1 | LOCATION MAP | F.A.P. RTE. 805 FED. ROAD DI | SECTION 125BR-3 IST. NO. ILLINOIS FED. AI | COUNTY TOTAL SHEET SHEETS NO. ST. CLAIR 19 6 CONTRACT NO. 76H99 DD PROJECT |

| [| | | | | | |
|-----------|-----|-----------|----------------------|------------------------------|---|---------------------|
| | | | SHOULDE | R SCHEDULE | | |
| LOC | AT | ION | HMA SHOULDERS, 8″ | PAVED SHOULDER REMOVAL | AGGREGATE WEDGE SHOULDER, TYPE B | EARTH EXCAVATION |
| STATION | TO | STATION | SQ YD | SQ YD | TONS | CU YD |
| 485+74.46 | TO | 486+85.46 | 124 | 74 | 4 | 18 |
| 486+85.46 | TO | 488+14.54 | | | | |
| 488+14.54 | ΤO | 489+25.54 | 124 | 74 | 4 | 18 |
| | | | | | | |
| T | ΔΤΔ | L. | 248 | 148 | 8 | 36 |

| Н | MA SURFACE SCH | HEDULE | |
|------------------------|--|--------------------------------------|---------------|
| LOCATION | BITUMINOUS MATERIALS (TACK COAT) | HMA SURFACE COURSE, MIX D, N7O | HMA SHOULDERS |
| STATION TO STATION | POUND | TON | TON |
| 486+35.46 TO 486+85.46 | 60 | 15 | 8 |
| 486+85.46 TO 488+14.54 | | | |
| 488+14.54 TO 488+64.54 | 60 | 15 | 8 |
| | | | |
| TOTAL | 120 | 30 | 16 |


| | | | | | PAVEMENT MARKING | SCHEDULE | | | | |
|-----------|------|-----------|--------------------------|-----------------------------|--|----------------------------------|----------------------------------|------------------------|------------------------|---------------------|
| | | | MODIFIED URET MARKING | HANE PAVEMENT LINE - 4'' | RAISED REFLECTIVE PAVEMENT MARKERS (BRIDGE) AMBER | RAISED REFLECTIVE PAVEMENT | RAISED REFLECTIVE PAVEMENT | SHORT TERM PAVEMENT | SHORT TERM PAVEMENT | PAVEMENT MARKING |
| STA | TO | STA | WHITE SOLID | YELLOW SKIP DASH | | MARKERS AMBER | MARKERS | MARKING REMOVAL | MARKING | REMOVAL |
| | | | FOOT | | EACH | EACH | EACH | SQ FT | FOOT | SQ FT |
| 483+94.46 | ΤO | 485+74.46 | | 50 | | 3 | 3 | | | 94 |
| 485+74.46 | ΤO | 486+35.46 | 122 | 20 | | 1 | 1 | | | 156 |
| 486+35.46 | ΤO | 486+85.46 | 100 | 20 | | 1 | 1 | 3 | 8 | 130 |
| 486+85.46 | ΤO | 488+14.54 | 260 | 40 | 2 | | 2 | 4 | 12 | 330 |
| 488+14.54 | ΤO | 488+64.54 | 100 | 20 | | 1 | 1 | 3 | 8 | 130 |
| 488+64.54 | ΤO | 489+25.54 | 122 | 20 | | 1 | 1 | | | 156 |
| 489+25.54 | ΤO | 491+05.54 | | 50 | | 3 | 3 | | | 94 |
| | | | | | | | | | | |
| SUB | TO | TAL: | 704 | 220 | 2 | 10 | 12 | 10 | 28 | 1090 |
| Т | ΟΤΑΙ | _; | 92 | 24 | 2 | 10 | 12 | 10 | 28 | 1090 |

| | | | | | TRAF | FIC CONTRO | L SCHEDULE | | | | |
|--------------------|---------------------|-----------------------|----------------------------------|--|---|------------|------------------------------------|--|---|--|---|
| BRIDGE LOCATION | STRUCTURE NUMBER | CONSTRUCTION STAGE | TEMPORARY CONCRETE BARRIER | RELOCATE TEMPORARY CONCRETE BARRIER | TEMPORARY BRIDGE TRAFFIC SIGNALS | | GUARDRAIL REFLECTORS, TYPE A | BARRIER WALL REFLECTORS, TYPE C | IMPACT ATTENUATORS, TEMPORARY (NON-REDIRECTIVE), TEST LEVEL 3 | IMPACT ATTENUATORS, RELOCATE (NON-REDIRECTIVE), TEST LEVEL 3 | TEMPORARY PAVEMENT MARKING LINE 6'' WHITE* |
| | | | FOOT | FOOT | EACH | EACH | EACH | EACH | EACH | EACH | FOOT |
| IL 161 OVER | CN 092 0004 | 1 | 375.0 | | 1 | 6 | 20 | 28 | 2 | | 942 |
| SILVER CREEK | SN 082-0094 | 2 | | 375.0 | | | 20 | 28 | | 2 | 942 |
| | | | | | | | | | | | |
| | TOTAL | | 375.0 | 375.0 | 1 | 6 | 40 | 56 | 2 | 2 | 1884 |

* THE REMOVAL OF TEMPORARY PAVEMENT MARKING LINE 6" IS INCLUDED IN THE PAVEMENT MARKING REMOVAL PAY ITEM.

| FILE NAME = | USER NAME = nievesa | DESIGNED - | REVISED - | | | | | | F.A.P. | SECTION | COUNTY | TOTAL SHEET |
|---|------------------------------|------------|------------|--|------------|-------------------------|------|---------|-------------|---------------------------|-------------|-------------|
| pw:\\LL084EBIDINTEG.illinois.gov:PWIDOT\Documents\LDOT_Offices\District_8\Projects\D87 <mark>5HDR3WMM</mark> Dota\EADsheets\d876h99-sht-plan.gg | | | gREVISED - | STATE OF ILLINOIS SCHEDULE OF QUANTITIES | | | 805 | 125BR-3 | ST. CLAIR | 19 7 | | |
| | PLOT SCALE = 100.0000 // in. | CHECKED - | REVISED - | DEPARTMENT OF TRANSPORTATION | | | | | | | | NO. 76H99 |
| | PLOT DATE = 2/8/2016 | DATE - | REVISED - | | SCALE: NTS | SHEET NO. 1 OF 1 SHEETS | STA. | TO STA. | FED. ROAD [| DIST. NO. ILLINOIS FED. A | NID PROJECT | |

| BUTT JOIN | T SCHEDULE |
|-----------|--|
| LOCATION | HMA SURFACE REMOVAL – BUTT JOINT |
| STATION | SQ YD |
| 486+45.46 | 200 |
| 488+14.54 | 200 |
| | |
| TOTAL | 400 |

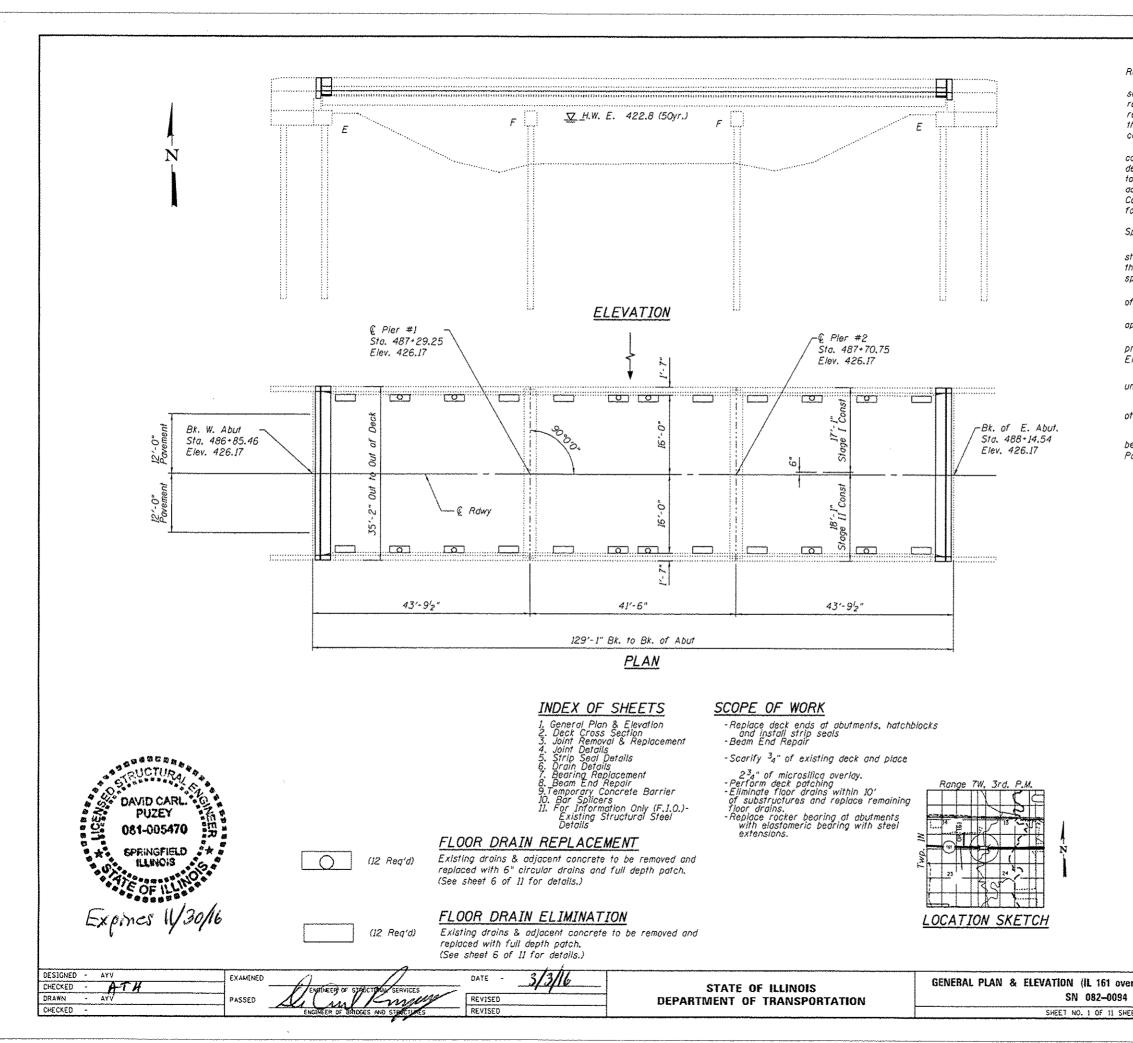

GENERAL NOTES

Reinforcement bars designated (E) shall be epoxy coated. Prior to pouring the new concrete deck, all heavy or loose rust, loose mill scale, and other loose or potentially detrimental foreign material shall be removed from the surfaces in contact with concrete. Tightly adhered paint may remain unless atherwise noted. Removal shall be accomplished by methods that will not damage the steel and the cost will be included in the pay item covering removal of the existing concrete.

Plan dimensions and details relative to existing plans are subject to nominal construction variations. The Contractor shall field verify existing dimensions and details affecting new construction and make necessary approved adjustments prior to construction or ordering of materials. Such variations shall not be cause for additional compensation for a change in scope of the work, however, the Contractor will be paid for the quantity actually furnished at the unit price bid for the work.

Joint opening shall be adjusted according to Article 520.04 of the Standard Specs. when the deck is poured at an ambient temperature other than 50° F.

Existing reinforcement bars extending into removal area shall be cleaned, stratghtened and incorporated into the new construction. Any reinforcement bars that are damaged during concrete removal shall be replaced with an approved bar splicer or anchorage system. Cost included with Concrete Removal, Bridge deck concrete sealer shall be placed on top/inside faces

of pararpet (full length) and wingwalls and on top of new concrete at joints. The existing structural steel coating contains lead. The Contractor shall take oppropriate precautions to deal with the presence of lead on this project. All structural steel shall be shop painted with the inorganic zinc rich

primer per AASHTO M300, Type 1. Cost included with Furnishing and Erecting Structural Steel.

All structural steel shall conform to AASHTO Classification M 270 Grade 36, unless otherwise noted.

Fasteners shall be high strength bolts. Bolts $7_{\theta}{}''\phi$ open holes ${}^{15}_{16}{}''\phi$ unless otherwise noted.


Existing structural steel that will be in contact with new structural steel shall be cleaned and painted prior to erection as required by the GBSP "Cleaning and Painting Contact Surface Areas of Existing Steel Structures".

TOTAL BILL OF MATERIAL


| ІТЕМ | UNIT | TOTAL |
|--|---------|-------|
| Concrete Removal | Cu. Yd. | 9.6 |
| Concrete Superstructure | Cu. Yd. | 10.7 |
| Elastomeric Bearing Assembly, Type I | Each | 10 |
| Bridge Deck Concrete Sealer | Sq. F1. | 5097 |
| Bar Splicers | Each | 26 |
| Reinforcement Bars, Epoxy Coated | Pound | 1200 |
| Preformed Joint Strip Seal | Foot | 68 |
| *Deck Slab Repair (Partial) | Sq. Yd. | 300 |
| Deck Slab Repair (Full Depth, Type II) | Sq. Yd. | 6 |
| Bridge Deck Microsilica Concrete Overlay, 2 ³ ª" | Sq. Yd. | 434 |
| Anchor Bolts, 1" | Each | 20 |
| Floor Drains | Each | 12 |
| Jack and Remove Existing Bearings | Each | 10 |
| Furnishing and Erecting Structural Steel | Pound | 1780 |
| Bridge Deck Scarification, 34" | Sq. Yd. | 434 |
| Bridge Deck Grooving | Sq. Yd. | 420 |
| | | |

"The quantities of deck slab repair are estimated. The Engineer in the field shall determine the actual quantity and locations.

| er SILVER CREEK OVERFLOW) | F,A.P. RTE. | SECTION | COUNTY | TOTAL SHEETS | SHEET NO. |
|---------------------------|----------------|------------------|-----------|-----------------|--------------|
| | 805 | 1258R-3 | ST. CLAIR | 19 | 8 |
| | | | CONTRACT | NO. 1 | 6H99 |
| IETS | | ILLINOIS FED. AI | O PROJECT | | |

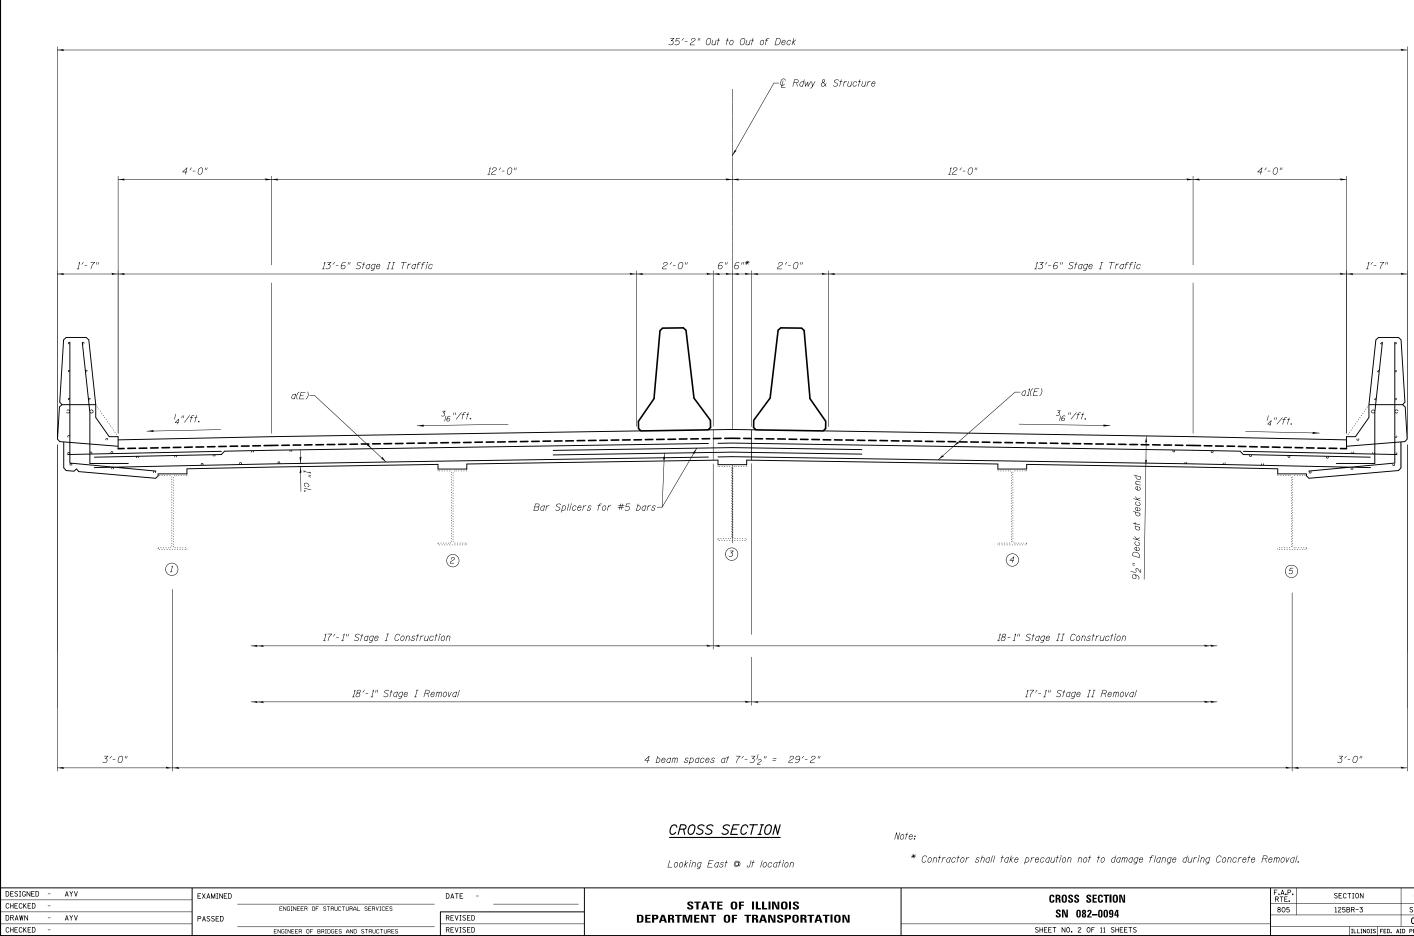

| CTION | F.A.P. RTE. | SECTION | COUNTY | TOTAL SHEETS | SHEET NO. |
|-----------|---------------------------|---------|-----------|-----------------|--------------|
| 0094 | 805 | 125BR-3 | ST. CLAIR | 19 | 9 |
| 0034 | | | CONTRACT | NO. 7 | '6H99 |
| 11 SHEETS | ILLINOIS FED. AID PROJECT | | | | |

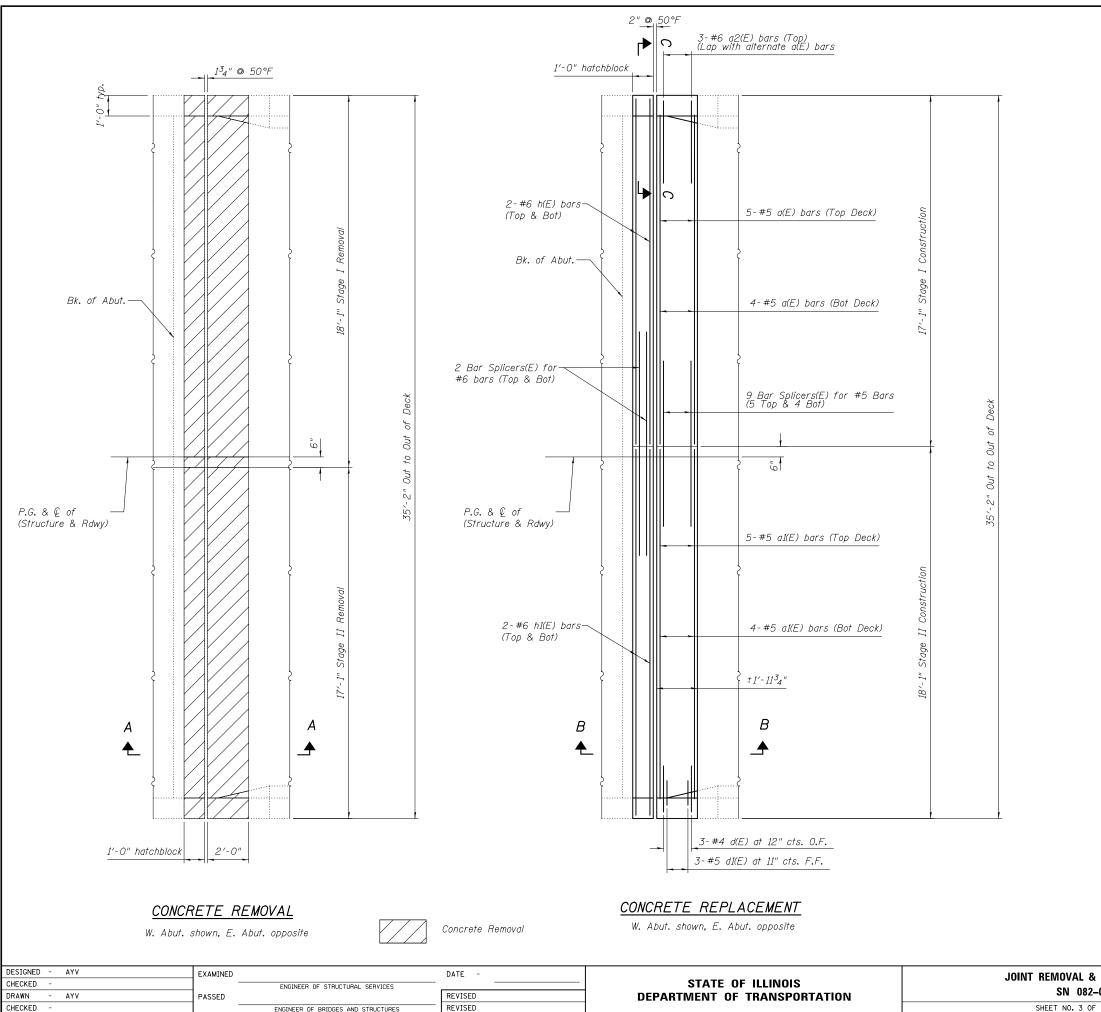


ENGINEER OF BRIDGES AND STRUCTURES

SN 082-0 SHEET NO. 3 OF 1


See Sheet 4 of 11 for Sections A-A, B-B & C-C

| REPLACEMENT | F.A.P. RTE. | SECTION | COUNTY | TOTAL SHEETS | SHEET NO. |
|-------------|---------------------------|---------|-----------|-----------------|--------------|
| 0094 | 805 | 125BR-3 | ST. CLAIR | 19 | 10 |
| 0094 | | | CONTRACT | NO. 7 | 6H99 |
| 11 SHEETS | ILLINOIS FED. AID PROJECT | | | | |

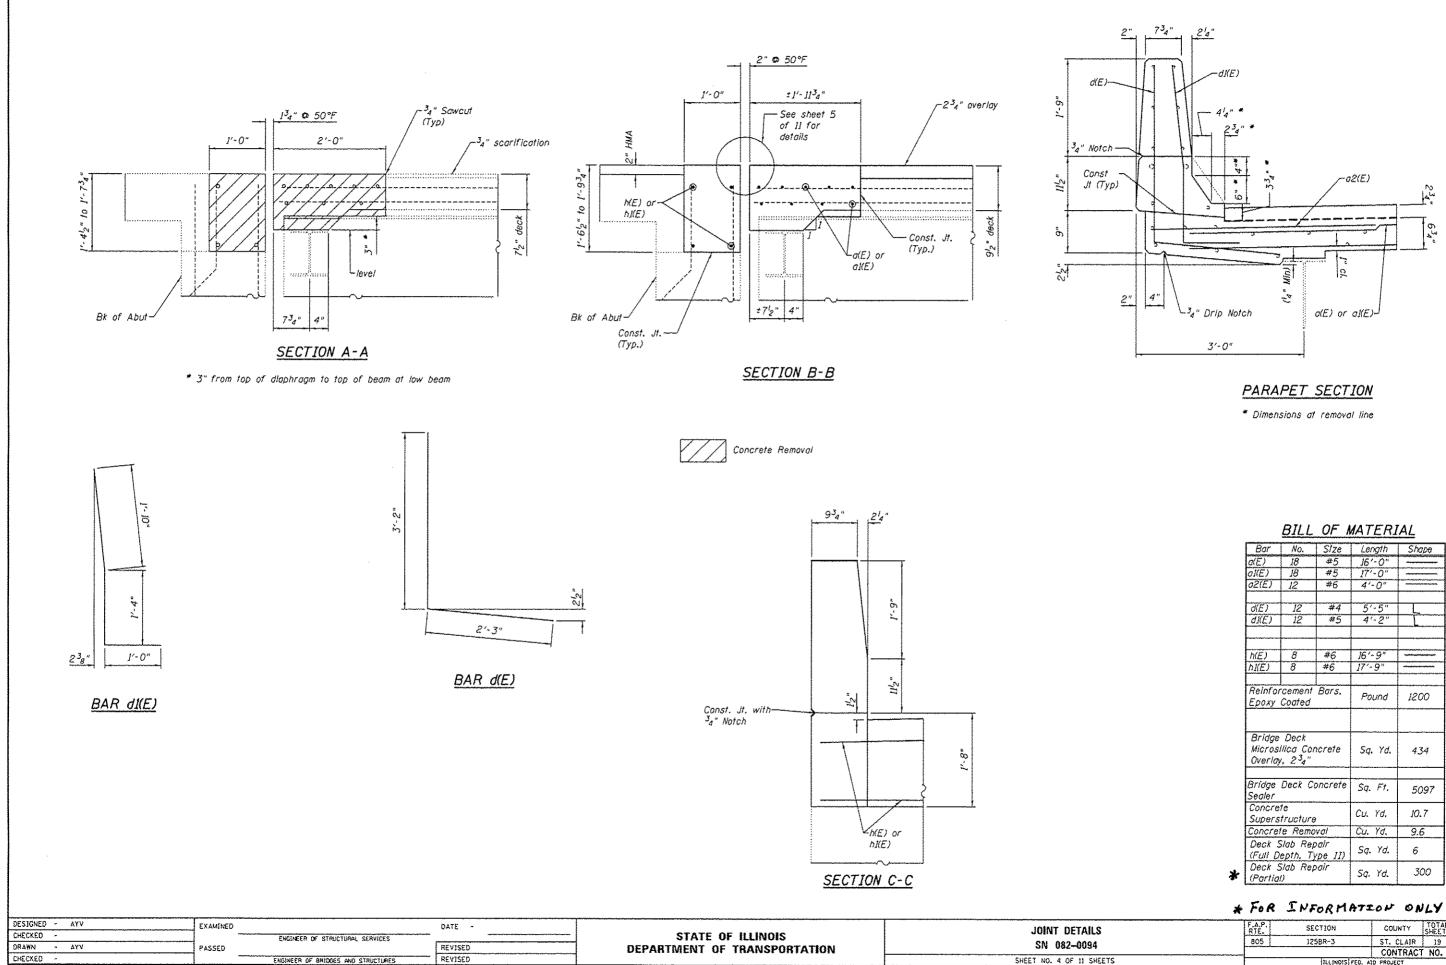


| | DILL | UF N | MAILMI | ML |
|---|------------------|------------|----------------|----------|
| Bar | No. | Size | Length | Shape |
| a(E) | 18 | #5 | <i>]6'-0</i> " | |
| ol(E) | 18 | #5 | 17'-0" | |
| 02(E) | 12 | #6 | 4'-0" | |
| | | | | |
| d(E) | 12 | #4 | 5'-5" | |
| dI(E) | 12 | #5 | 4'-2" | L |
| | | | | |
| h(E) | 8 | #6 | 16'-9" | |
| hI(E) | 8 | #6 | 17'-9" | |
| | <u> </u> | - <u> </u> | 1. 0 | |
| Reinfor Epoxy | cement Coated | Bors, | Pound | 1200 |
| Oridan | Deat | | | |
| Bridge Micros Overlay | ilica_Cor | ncrete | Sq. Yd. | 434 |
| Bridge Deck Concrete Sealer | | | Sq. Ft. | 5097 |
| Concrete Superstructure | | | Cu. Yd. | 10.7 |
| Concrete Removal | | | Cu. Yd. | 9.6 |
| Deck Slab Repair (Full Depth. Type II) | | | Sq. Yd. | 6 |
| Deck S (Partia | 51ab Rep 1) | odir | Sq. Yd. | 300 |

| S | F.A.P. RTE. | SECTION | COUNTY | TOTAL | SHEET NO. |
|------|----------------|-----------------|-----------|-------|--------------|
| | 805 | 125BR-3 | ST. CLAIR | 19 | 13 |
| · | | | CONTRACT | NO. 1 | 6Н99 |
| EETS | | ILLINOIS FED. A | O PROJECT | | |

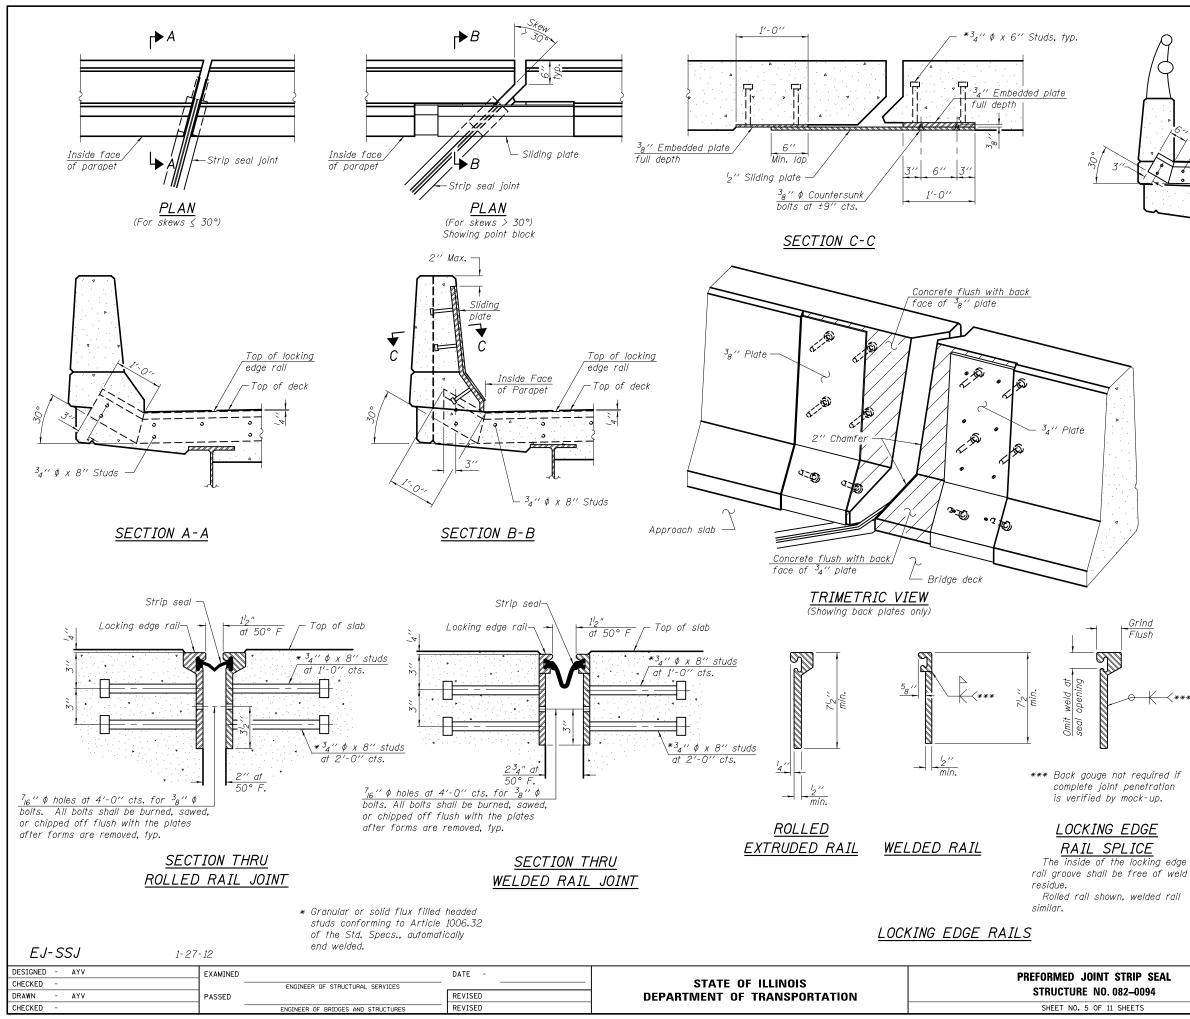

| | A | |
|-----|---|--|
| | - ³ 4'' \$ x 8'' Studs Top of sidewalk or median | |
| 3"\ | Top of locking edge rail | |
| | | |

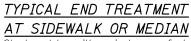

Shorter plates with a single row of studs at 12" cts. may be necessary on medians which are shallower than 9". See manufacturer's recommendation.

Notes:

The strip seal shall be made continuous and shall have a minimum thickness of ${}^{l}_{4}$ ". The configuration of the strip seal shall match the configuration of the Locking Edge Rails. Open or "webbed" strip seal gland configurations are not permitted. The gland shall be sized for a maximum rated movement of 4 inches.

The Locking Edge Rails depicted are conceptual only, except for the minimum dimensions shown. The actual configuration of the Locking Edge Rails and matching strip seal may vary from manufacturer to manufacturer. Flanged edge rails will not be allowed. Locking Edge Rails may be spliced at slope discontinuities.

The manufacturer's recommended installation methods shall be followed.

The joint opening and deck dimensions detailed on the superstructure are based on a rolled rail expansion joint. If the Contractor elects to use the welded rail expansion joint, the opening and deck dimensions shall be modified according to the dimensions detailed on this sheet. Required modifications shall be made at no additional cost to the State.

All steel components shall be galvanized after fabrication according to Article 520.03 of the Standard Specifications. Maximum space between rail segments shall be ${}^{3}_{16}{}^{\prime\prime}$ sealed with a suitable sealant. Joints in rails within 10 ft.


of curbs shall be welded.


Parapet plates and anchorage studs for skews > 30° included in the cost of Preformed Joint Strip Seal.

BILL OF MATERIAL

| Item | Unit | Total |
|----------------------------|------|-------|
| Preformed Joint Strip Seal | Foot | 68 |
| | | |

| T STRIP SEAL | F.A.P. RTE. | SECTION | COUNTY | TOTAL SHEETS | SHEET NO. |
|--------------|---------------------------|---------|-----------|-----------------|--------------|
| . 082–0094 | 805 | 125BR-3 | ST. CLAIR | 19 | 12 |
| . 002-0034 | | | CONTRACT | NO. 7 | 6H99 |
| 11 SHEETS | ILLINOIS FED. AID PROJECT | | | | |
| | | | | | |

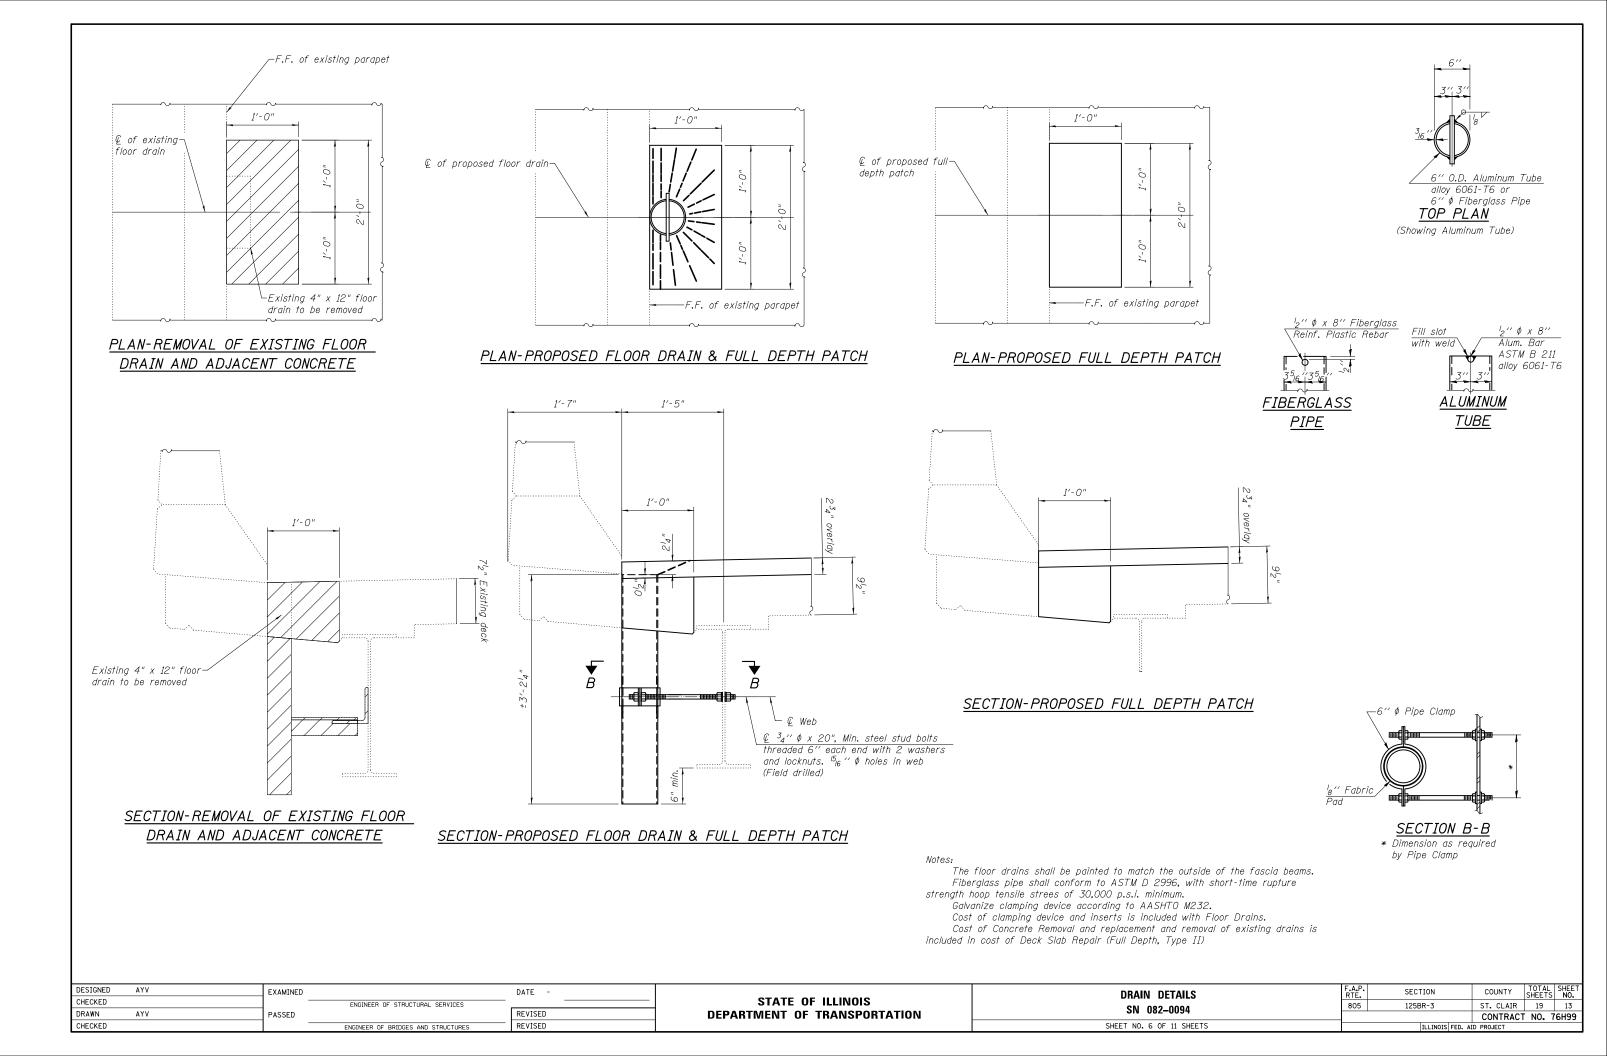

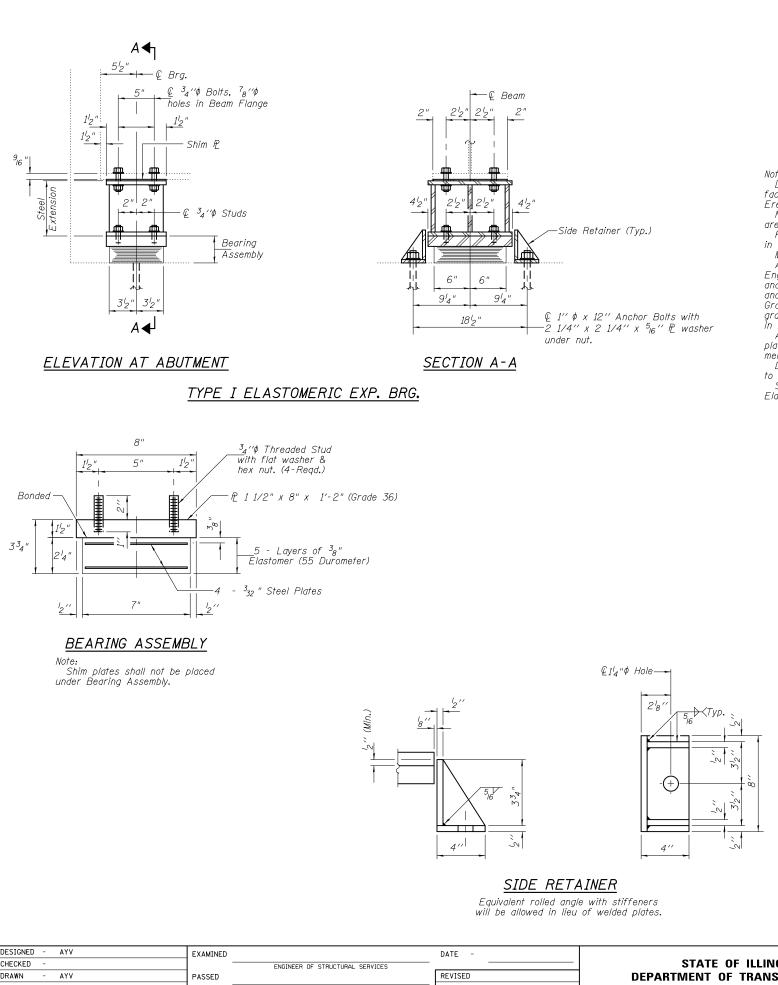

BEAM REACTIONS

| R₽ | (K) | 18.5 |
|-----------|-----|------|
| R4 | (K) | 35.9 |
| Imp. | (K) | 10.8 |
| R (Total) | (K) | 65.2 |

Notes:


Diaphragm removal and reinstallation may be required to facilitate drilling holes. Cost included with Furnishing and Erecting Structural Steel.

Erecting Structural Steel. New steel extensions, shim plates and connection bolts are included with Furnishing and Erecting Structural Steel. Prior to ordering any material, the Contractor shall verify in the field all bearing height and shim thickness dimensions. Min, jack capacity = 32 Tons. Anchor bolts shall be ASTM F1554 all-thread (or an Engineer-approved alternate material) of the grade(s) and diameter(s) specified. ASTM A307 Grade C anchor bolts may be used in lieu of ASTM F1554 anchor bolts may be used in lieu of ASTM F1554 Grade 36 (Fy=36ksi). The corresponding specified grade of AASHTO M314 anchor bolts may be used in lieu of ASTM F1554.

Anchor bolts at fixed bearings may be either cast in place or installed in holes drilled after the supported member is in place.


Drilled and set anchor bolts shall be installed according to Article 521.06 of the Standard Specifications. Side retainers shall be included in the cost of


Elastomeric Bearing Assembly, Type I.

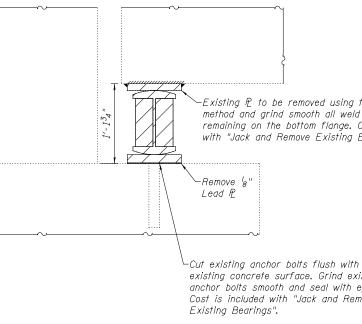



EXISTING BEARING REMOVAL DETAIL

| DESIGNED - AYV | EXAMINED | DATE - | | TYPE I BEARING REPLACEMENT (ABUTMENTS) | F.A.P. SECTION | COUNTY TOTAL SHEET |
|----------------|------------------------------------|---------|------------------------------|--|----------------|--------------------|
| CHECKED - | ENGINEER OF STRUCTURAL SERVICES | · | STATE OF ILLINOIS | | 805 125BR-3 | ST. CLAIR 19 14 |
| DRAWN - AYV | PASSED | REVISED | DEPARTMENT OF TRANSPORTATION | SN 082-0094 | | CONTRACT NO. 76H99 |
| CHECKED - | ENGINEER OF BRIDGES AND STRUCTURES | REVISED | | SHEET NO. 7 OF 11 SHEETS | ILLINOIS FED. | AID PROJECT |

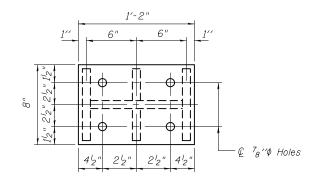

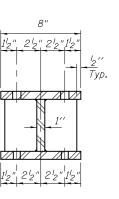

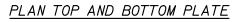

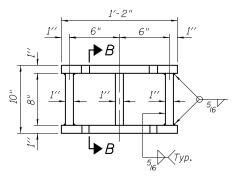

SECTION B-B

STEEL EXTENSION DETAIL


-Existing P to be removed using the air-arc method and grind smooth all weld material remaining on the bottom flange. Cost included with "Jack and Remove Existing Bearings".

| | • • |
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| | |

BILL OF MATERIAL

| Item | Unit | Total |
|---|-------|-------|
| Elastomeric Bearing Assembly, Type I | Each | 10 |
| Jack and Remove Existing Bearings | Each | 10 |
| Furnishing and Erecting Structural Steel | Pound | 1640 |
| Anchor Bolts 1''¢ | Each | 20 |

existing concrete surface. Grind existing anchor bolts smooth and seal with epoxy. Cost is included with "Jack and Remove"

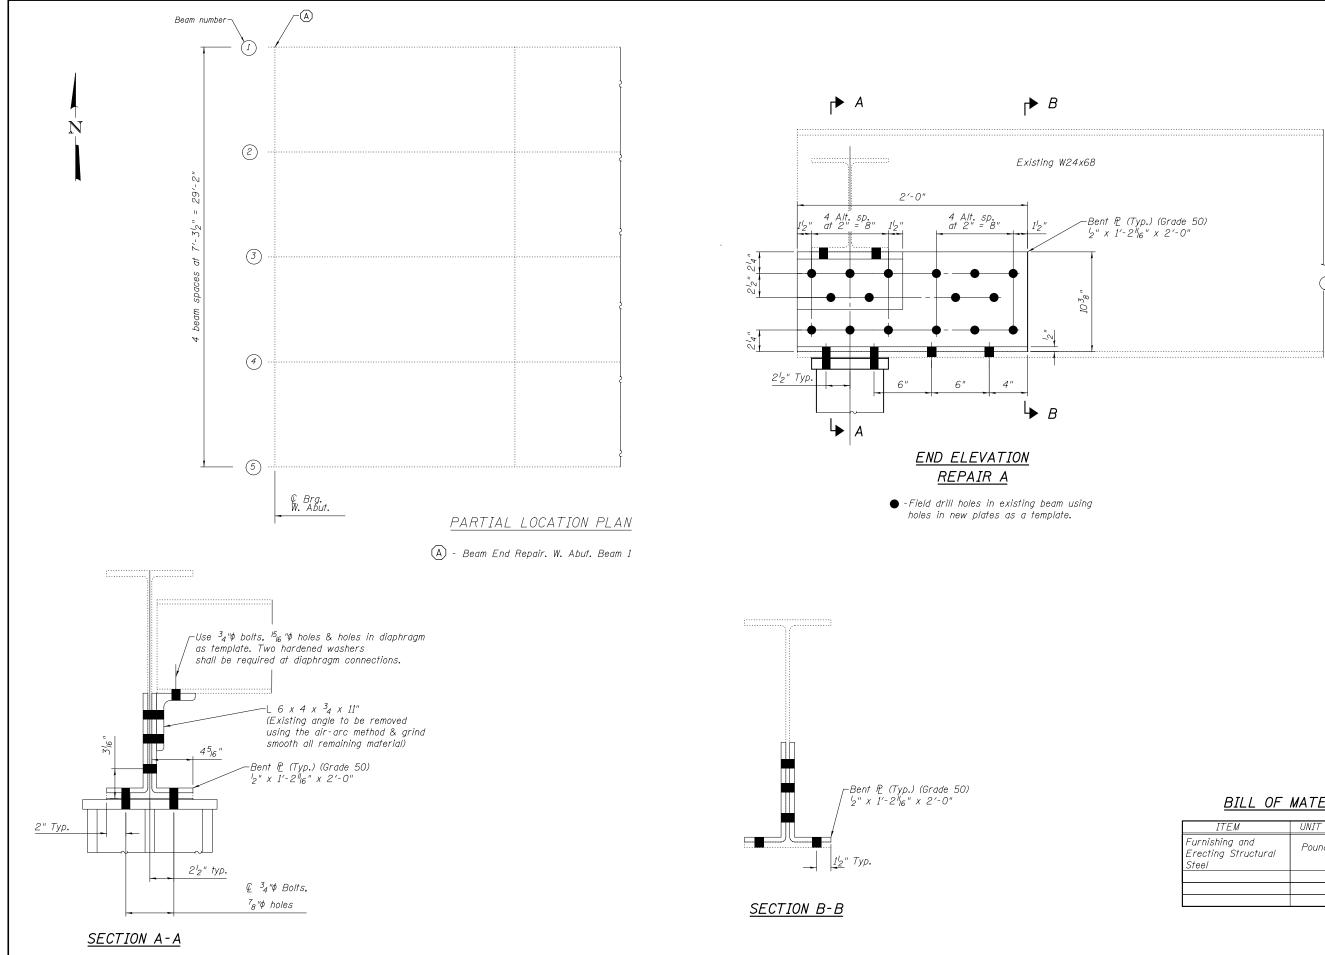


| DESIGNED - AYV | EXAMINED | | DATE - | | BEAM END REF |
|----------------|----------|------------------------------------|---------|------------------------------|----------------------|
| CHECKED - | | ENGINEER OF STRUCTURAL SERVICES | | STATE OF ILLINOIS | |
| DRAWN - AYV | PASSED | | REVISED | DEPARTMENT OF TRANSPORTATION | SN 082-0094 |
| CHECKED - |] | ENGINEER OF BRIDGES AND STRUCTURES | REVISED | | SHEET NO. 8 OF 11 SH |

<u>BILL OF MATERIAL</u>


| ITEM | UNIT | QUANTITY |
|--|-------|----------|
| Furnishing and Erecting Structural Steel | Pound | 140 |
| | | |
| | | |
| | | |

| | | | | - | - |
|----------|----------------|------------------|-----------|-----------------|--------------|
| REPAIR | F.A.P. RTE. | SECTION | COUNTY | TOTAL SHEETS | SHEET NO. |
| 094 | 805 | 125BR-3 | ST CLAIR | 19 | 15 |
| | | | CONTRACT | NO. 7 | 76H99 |
| 1 SHEETS | | ILLINOIS FED. AI | D PROJECT | | |
| | | | | | |

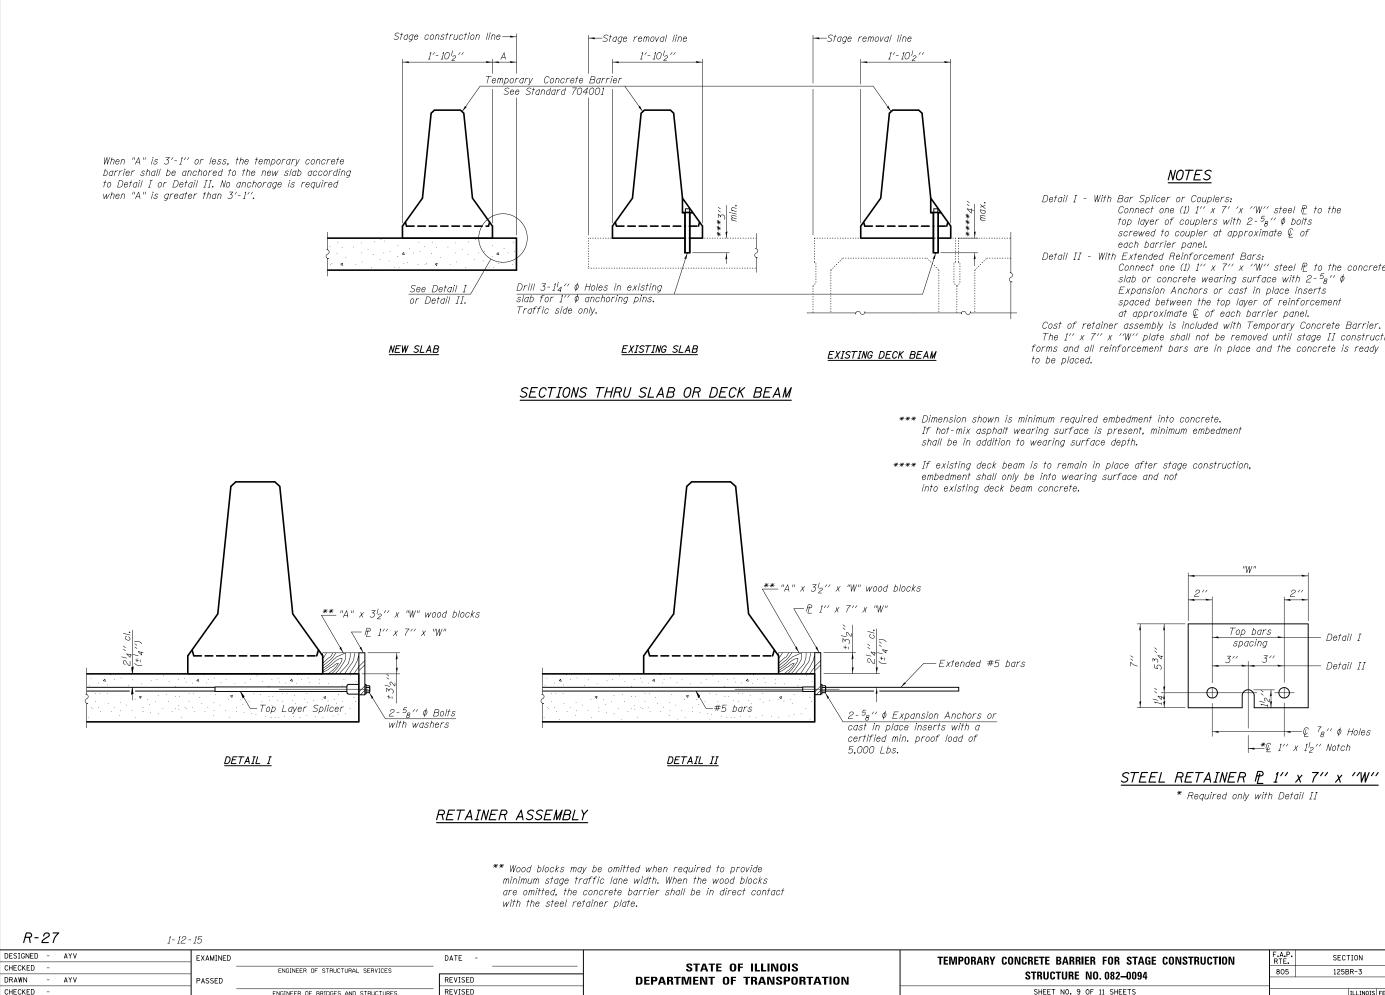


NOTES

Detail I - With Bar Splicer or Couplers: Connect one (1) 1" x 7' 'x "W" steel P to the top layer of couplers with $2-\frac{5}{8}$ " ϕ bolts screwed to coupler at approximate *Q* of each barrier panel. Detail II - With Extended Reinforcement Bars: Connect one (1) 1" x 7" x "W" steel P to the concrete slab or concrete wearing surface with 2- ${}^{5}\!\!8''\,\phi$ Expansion Anchors or cast in place inserts spaced between the top layer of reinforcement at approximate ∉ of each barrier panel. Cost of retainer assembly is included with Temporary Concrete Barrier. The 1" x 7" x 'W' plate shall not be removed until stage II construction

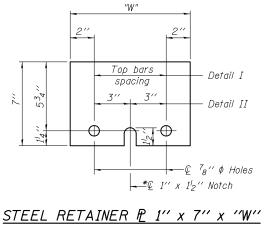

^{*} Required only with Detail II

| FOR STAGE CONSTRUCTION | F.A.P. RTE. | SECTION | COUNTY | TOTAL SHEETS | SHEET NO. |
|------------------------|----------------|------------------|-----------|-----------------|--------------|
| . 082–0094 | 805 | 125BR-3 | ST. CLAIR | 19 | 16 |
| . 002–0034 | | | CONTRACT | NO. 7 | 6H99 |
| 11 SHEETS | | ILLINOIS FED. AI | D PROJECT | | |

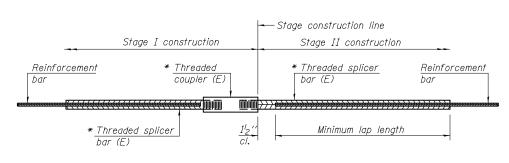

STANDARD BAR SPLICER ASSEMBLY


Threaded splicer bar length = min. lap length + $1_2^{\prime\prime}$ + thread length

* Epoxy not required on Bar Splicer Assembly components used in conjunction with black bars.

| Location | Bar size | No. assemblies required | Minimum Iap length |
|--------------------|-------------|----------------------------|-----------------------|
| W. Abut-Hatchblock | #6 | 4 | 4'-0" |
| W. Abut-Deck | #5 | 9 | 3′-6″ |
| E. Abut-Deck | #5 | 9 | 3′-6″ |
| E. Abut-Hatchblock | #6 | 4 | 4'-0" |
| | | | |


BSD-1

6-8-15

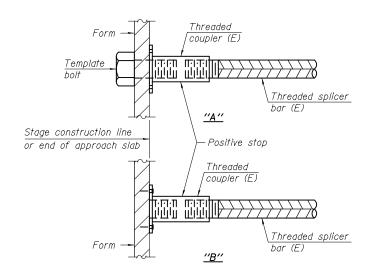


INSTALLATION AND SETTING METHODS

"A" : Set bar splicer assembly by means of a template bolt. "B" : Set bar splicer assembly by nailing to wood forms or cementing to steel forms. (E) : Indicates epoxy coating.

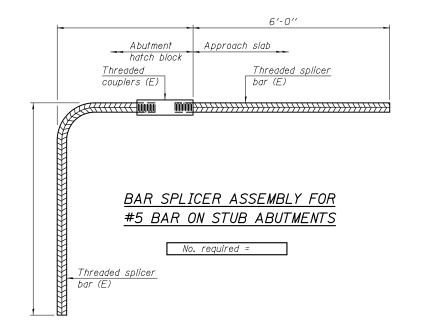

| | EXAMINED | | DATE - | | BAR SPLICER ASSEMBLY AND MECHANICAL SPLICER DETAILS | F.A.P. RTE. | SECTION | COUNTY | TOTAL | SHEET |
|--------------------------|----------|------------------------------------|--------------------|------------------------------|---|----------------|--------------|----------|-------|-------|
| CHECKED - | - | ENGINEER OF STRUCTURAL SERVICES | | | STRUCTURE NO. 082–0094 | 805 | 125BR-3 | ST CLAIR | 19 | 17 |
| DRAWN – AYV CHECKED – | PASSED – | ENGINEER OF BRIDGES AND STRUCTURES | REVISED REVISED | DEPARTMENT OF TRANSPORTATION | SHEET NO. 10 OF 11 SHEETS | | ILLINOIS FEE | CONTRAC | T NO. | 76H99 |

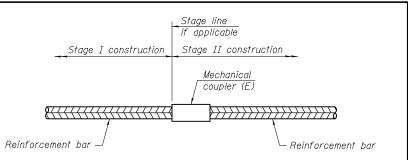


STANDARD MECHANICAL SPLICER

| Location | Bar size | No. assemblies required |
|----------|-------------|----------------------------|
| | | |
| | | |
| | | |

NOTES

Splicer bars shall be deformed with threaded ends and have a minimum 60 ksi yield strength.

All reinforcement shall be lapped and tied to the splicer bars. Bar splicer assemblies shall be epoxy coated according to the requirements for reinforcement bars. See Section 508 of the Standard Specifications. See approved list of bar splicer assemblies and mechanical splicers for alternatives.

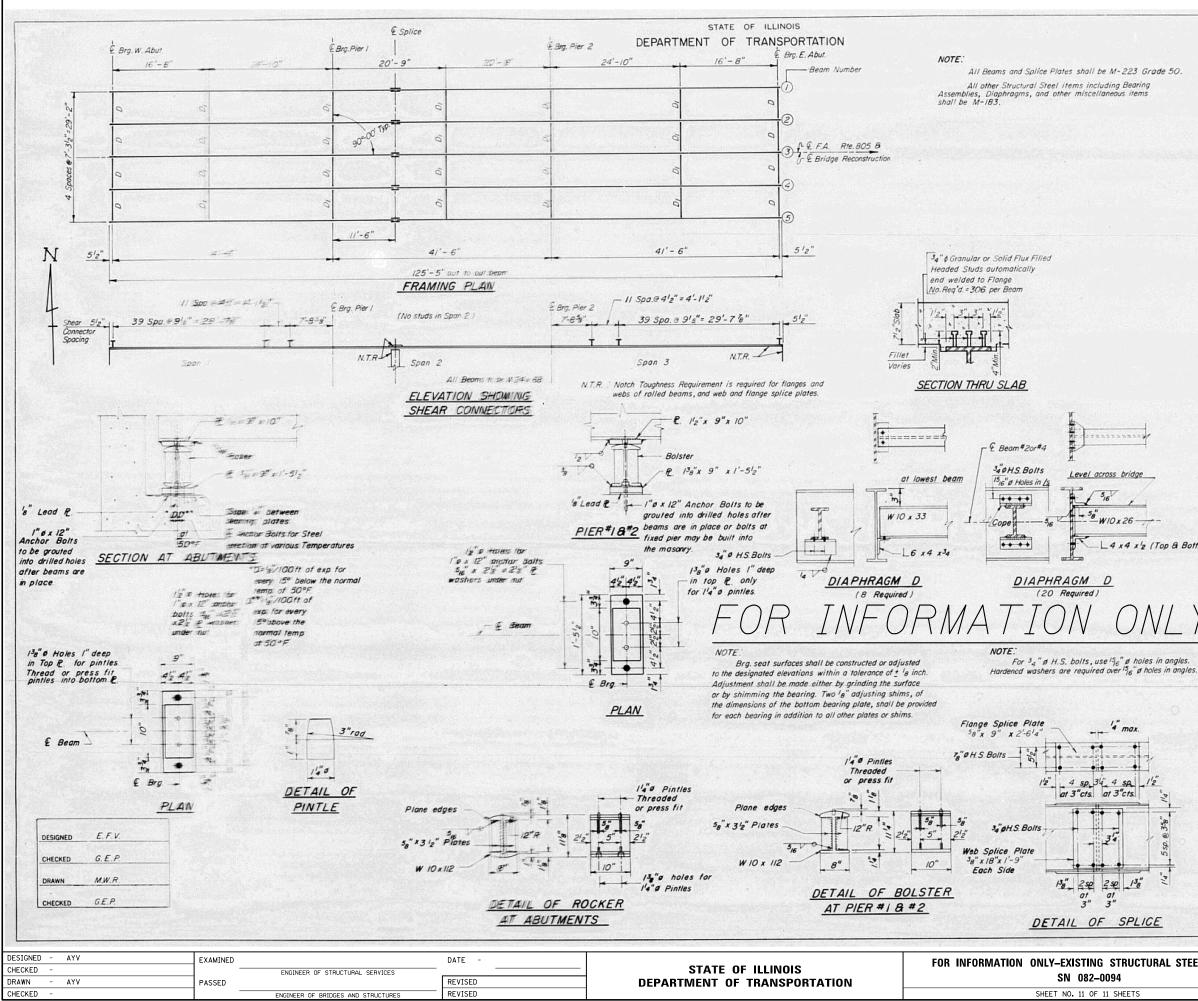

| ROUTE NO. | SACTOR | COUNTY | TOTAL | SHEET NO. | SHEET NO. 6 |
|-----------------------|------------|----------|----------------|--------------|-------------|
| S. R. L. F. A. 805 | 125 BR | ST. CLA | HR 32 | | 9 SHEETS |
| FED. ROAD B | 151. NO. 7 | ILLINOIS | TED. NO PHOJEC | T | |

INTERIOR BEAM MOMENT TABLE

| | 0.4 Sp.1 | Pier | 0.5 Sp.2 |
|-----------------------|----------|---------|--|
| Is (in ⁴) | 1830 | 1830 | 1830 |
| Ic (in 4) | 6013.7 | | 1997 (1997 - 19 97 - 1997 - 1 |
| Ss (in 3) | 154 | 154 | 154 |
| Sc (in 3) | 249 | - | - |
| € (k/1) | 0.777 | 1.101 | 1.101 |
| M2 (1k) | 139.4 | - 233.8 | 74.4 |
| fs comp (ksi) | 10.86 * | - 18.22 | 5.80 |
| St (k/1) | 0.324 | | |
| Ms £ (1k) | 62.9 | - | - |
| MŁ (1k) | 604.3 | - 310.3 | 386.1 |
| MIMp (1k) | 181.4 | -93.0 | 115.9 |
| Total (1k) | 848.6 | -403.3 | 502.0 |
| fs comp (ksi) | 40.90 * | - 31.43 | 39.12 |
| fs Total (ksi) | 50 ** | -49.65 | 44.92 |
| VR (k) | 48.0 | | - |

* Computed by conventional elastic beam formula. ** Computed using plastic theory - section is compact for positive moment.

INT. BEAM REACTION TABLE

| | Abut. | Pier |
|-------------|-------|-------|
| R₽ (k) | 18.5 | 50.1 |
| R± (k) | 35.9 | 42.1 |
| Imp. (k) | 10.8 | 12.6 |
| R Total (k) | 65.2 | 104.8 |

Is and Ss are the moment of inertia and section modulus of the steel section used in computing fs Total. Ic and Sc are the moment of inertia and section modulus of the

composite section used in computing fs Total.

VR is the maximum $\pounds +$ Impact shear range in span. The load factor (1.3) $[\pounds + 5_3(\pounds + Imp.)]$ is included for computing moments and stresses.

* ELEVATION TOP OF W BEAMS

| Location | Beam #1 | Beam#2 | Beam#3 | Beam#4 | Beam#5 |
|-----------------|---------|--------|--------|--------|--------|
| E Brg. W. Abut. | 425.02 | 425.15 | 425.26 | 425.15 | 425.02 |
| E Brg. Pier #1 | 425.02 | 425.15 | 425.26 | 425.15 | 425.02 |
| | 425.02 | 425.15 | 425.26 | 425.15 | 425.02 |
| & Brg. Pier #2 | 425.02 | 425.15 | 425.26 | 425.15 | 425.02 |
| E Brg. E. Abut. | 425.02 | 425.15 | 425.26 | 425.15 | 425.02 |

+ For Fabrication Only


| '4" max. | |
|-----------------|-----------|
| 4 sp. 3"cts. | 1/2 1/2 |
| F. | 5sp.@358" |
| se 138 | 14" |

| STRUCTURAL STEEL DETAILS |
|----------------------------------|
| F. A. 805 OVER SILVER CREEK |
| SECTION 125 BR, ST. CLAIR COUNTY |
| STA.487+50 |

| | | WENT TOWN TO THE TOWN TO THE TOWN | | | | | | |
|--------------------------|---------------------------|-----------------------------------|----------|-----------------|--------------|--|--|--|
| STRUCTURAL STEEL DETAILS | | SECTION | COUNTY | TOTAL SHEETS | SHEET NO. | | | |
| | | 125BR-3 | ST CLAIR | 19 | 18 | | | |
| 1034 | | | CONTRACT | NO. 7 | 6H99 | | | |
| 11 SHEETS | ILLINOIS FED. AID PROJECT | | | | | | | |
| | | | | | | | | |

L4 x4 x'2 (Top & Bott.)

BUTT JOINT DETAIL

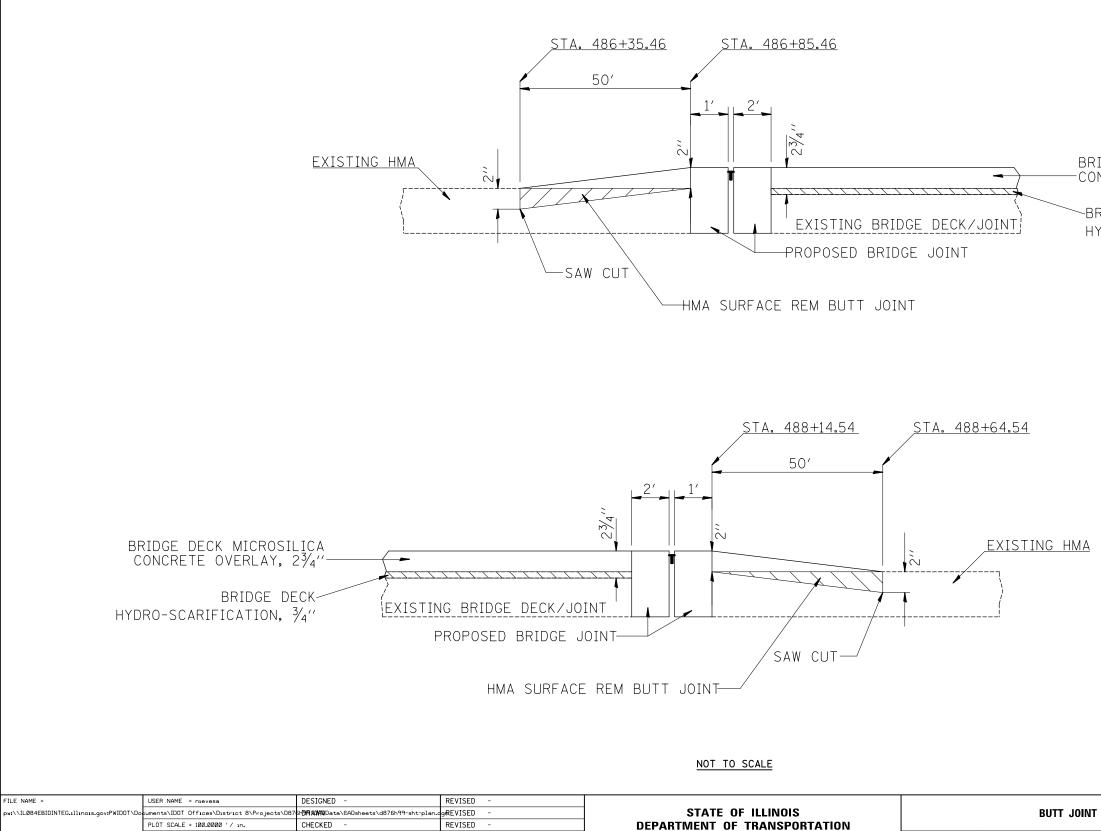

PLOT DATE = 2/8/2016

DATE

REVISED

SCALE: NTS SHEET NO. 1 OF 1 SHEETS

BRIDGE DECK MICROSILICA -CONCRETE OVERLAY, 2¾"

~BRIDGE DECK HYDRO-SCARIFICATION, 3⁄4′′

| | | F.A. RTE | P. | SECTION | | | | COUNTY | | TOTAL SHEETS | SHEET NO. | | |
|---|-------|-------------|-------------|---------|-------|----------|----------|--------|-----|-----------------|--------------|-------|-------|
| D | ETAIL | | 805 125BR-3 | | | ST. CLAI | R | 19 | 19 | | | | |
| | | | | | | | | | | CONTRA | ٩СТ | NO. ' | 76H99 |
| | STA. | TO STA. | FED. | ROAD | DIST. | NO. | ILLINOIS | FED. | AID | PROJECT | | | |