

STATE OF ILLINOIS
DEPARTMENT OF TRANSPORTATION
DIVISION OF HIGHWAYS

**PROPOSED
SAFE ROUTES TO SCHOOL
CITY OF SPRING VALLEY**

SECTION 10-00051-00-LT
PROJECT SRTS-4009 (187)
BUREAU COUNTY
JOB NO. C-40-070-09


F.A.U. RTE.	SECTION	COUNTY	TOTAL SHEETS	SHEET NO.
--	10-00051-00-TL	BUREAU	9	1
FED. ROAD DIST. NO.	ILLINOIS	CONTRACT NO. 87540		

INDEX OF SHEETS


- COVER SHEET
- INDEX OF SHEETS, TYPICAL SECTION AND GENERAL NOTES
- 4. SUMMARY OF QUANTITIES
- SCHEDULE OF QUANTITIES
- 9. PLAN SHEETS

HIGHWAY STANDARDS

- 000001-06 STANDARD SYMBOLS, ABBREVIATIONS AND PATTERNS
- 424001-08 PERPENDICULAR CURB RAMPS FOR SIDEWALKS
- 424002-03 DEPRESSED CORNER FOR SIDEWALKS
- 606001-06 CONCRETE CURB TYPE B AND COMBINATION CONCRETE CURB AND GUTTER
- 701501-06 URBAN LANE CLOSURE, 2L, 2W, UNDIVIDED
- 701801-06 SIDEWALK, CORNER OR CROSSWALK CLOSURE
- 701901-05 TRAFFIC CONTROL DEVICES
- 720001-01 SIGN PANEL MOUNTING DETAILS
- 873001-02 TRAFFIC SIGNAL GROUNDING & BONDING
- 878001-10 CONCRETE FOUNDATION DETAILS

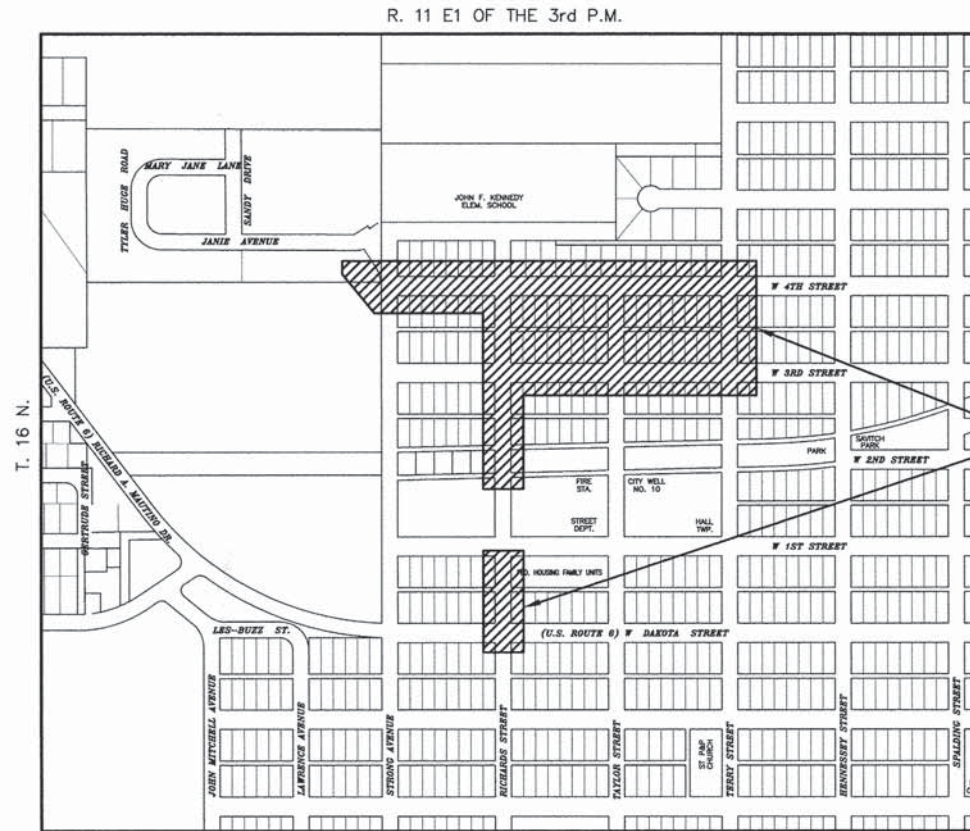

PROJECT AREA

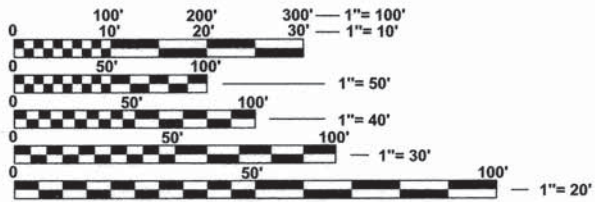


FULL SIZE PLANS HAVE BEEN PREPARED USING STANDARD ENGINEERING SCALES. REDUCED SIZED PLANS WILL NOT CONFORM TO STANDARD SCALES. IN MAKING MEASUREMENTS ON REDUCED PLANS, THE ABOVE SCALES MAY BE USED.

J.U.L.I.E.
JOINT UTILITY LOCATION INFORMATION FOR EXCAVATION
1-800-892-0123
OR 811

PROJECT ENGINEER
PROJECT MANAGER

CONTRACT NO. 87540

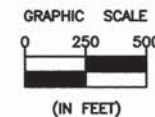

STATE OF ILLINOIS
DEPARTMENT OF TRANSPORTATION
DIVISION OF HIGHWAYS


SUBMITTED 2/11 2016
W. Marini
MAYOR, CITY OF SPRING VALLEY

2/15 2016
James K. Clinard
DISTRICT 3 LOCAL ROADS AND STREETS ENGINEER


PASSED 2/15 2016
Joe Wickert
DISTRICT 3 IMPLEMENTATION ENGINEER

RELEASED FOR BID 2/16 2016
BASED ON Paula Lutz
LIMITED REVIEW DEPUTY DIRECTOR OF HIGHWAYS, REGION 2 ENGINEER

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 C:\Users\jmorris\OneDrive\Documents\Projects\Spring-Valley-SRTS-Lump-Sum-Federal-Contract\CAD\3D\02-DETS.dwg Last Modified: Feb 10, 2016 - 8:58am Plotted on: Feb 10, 2016 - 12:38pm by nancy

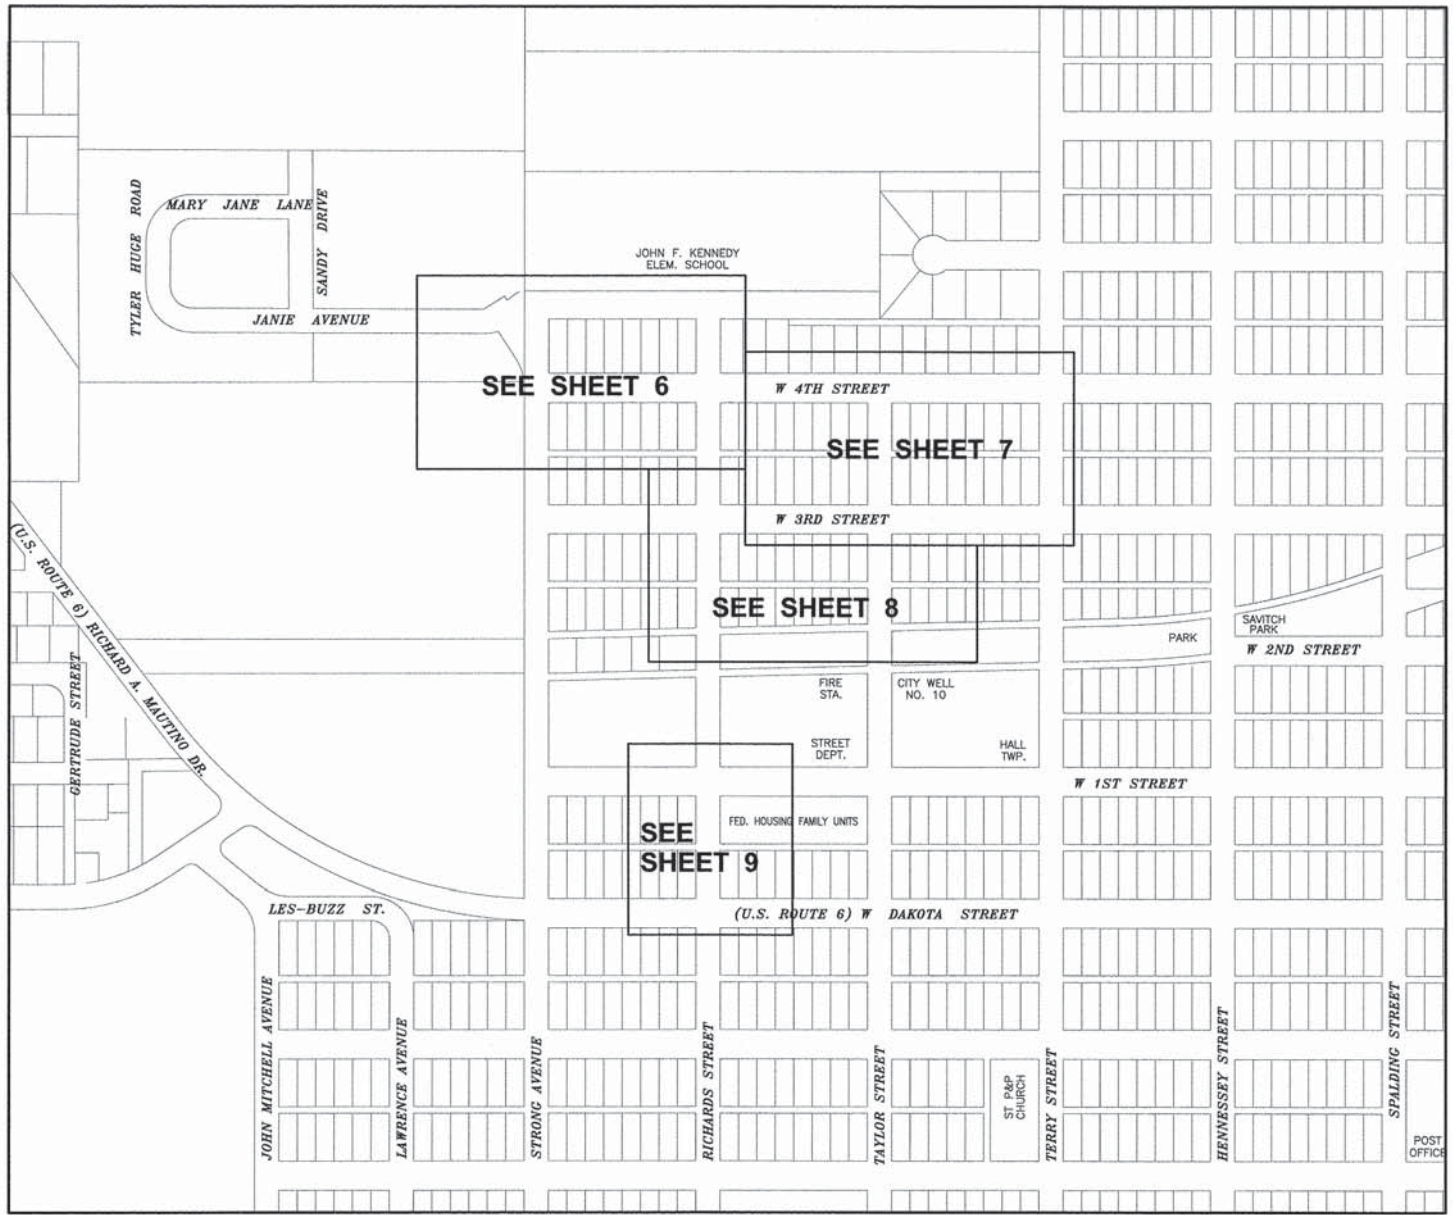


INDEX OF SHEETS
N.T.S.

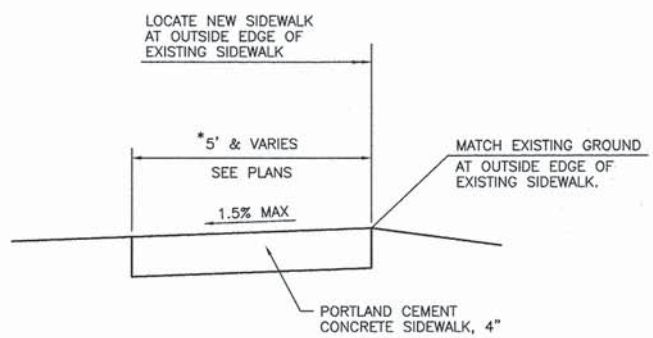

TYPICAL SECTION
N.T.S.

* TRANSITION WIDTH AND CROSS SLOPE TO MATCH THE EXISTING WHERE NEW SIDEWALK MEETS OLD OVER A DISTANCE OF 5'.

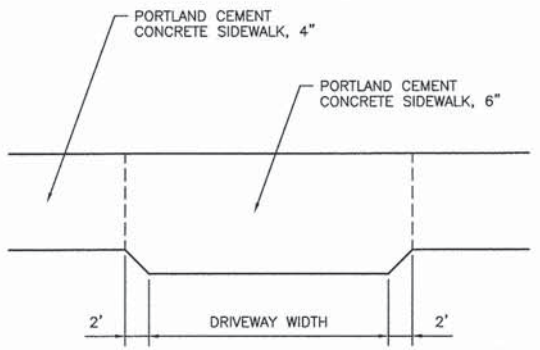

SIDEWALK DETAIL AT DRIVEWAYS
N.T.S.

GENERAL NOTES

1. LIMITS OF SIDEWALK REMOVAL IS INTENDED TO BE AT AN EXISTING JOINT IN THE SIDEWALK.
2. SIDEWALK REMOVAL AND REPLACEMENT WORK MAY NOT BEGIN UNTIL THE END OF THE CURRENT SCHOOL YEAR AT JOHN F. KENNEDY SCHOOL IN SPRING VALLEY ILLINOIS AND SHALL BE COMPLETED PRIOR TO THE NEXT SCHOOL YEAR.
3. SEEDING WILL NOT BE PERMITTED AT ANY TIME WHEN THE GROUND IS FROZEN, WET, OR IN AN UNTILLABLE CONDITION, LOCATIONS TO BE SEEDED WILL BE DETERMINED BY THE ENGINEER.
4. ONLY THOSE TREES DESIGNATED BY THE ENGINEER OR LISTED IN THE TREE REMOVAL SCHEDULE SHALL BE REMOVED, THE CONTRACTOR SHALL PROTECT ALL REMAINING TREES FROM DAMAGE DUE TO HIS OPERATIONS.
5. DETECTABLE WARNING SURFACES SHALL EXTEND 2.0 FT MINIMUM IN THE DIRECTION OF PEDESTRIAN TRAVEL. AT CURB RAMPS AND BLENDED TRANSITIONS, DETECTABLE WARNING SURFACES SHALL EXTEND THE FULL WIDTH OF THE RAMP RUN (EXCLUDING ANY FLARES) OR BLENDED TRANSITIONS. SOME DETECTABLE WARNING PRODUCTS REQUIRE A CONCRETE BORDER FOR PROPER INSTALLATION. THE CONCRETE BORDER SHALL NOT EXCEED 2 INCHES.
6. ANY REFERENCE TO A STANDARD IN THESE PLANS SHALL BE INTERPRETED TO MEAN THE EDITION AS INDICATED BY THE SUBNUMBER SHOWN IN THE LIST OF STANDARDS OR THE COPY INCLUDED IN THE PLANS.
7. THE CONTRACTOR SHALL CONTACT JULIE AT LEAST 48 HOURS PRIOR TO EXCAVATION TO DETERMINE WHICH UTILITIES ARE IN THE AREA.
8. HIGHWAY STANDARD 701501 WILL ONLY BE REQUIRED FOR WORK BY US6/IL89.
9. THE COST OF GRADING SUBBASE FOR SIDEWALK SHALL BE CONSIDERED INCLUDED IN THE COST OF ASSOCIATED SIDEWALK.
10. ALLOWANCES FOR EARTH EXCAVATION, SEEDING, AND ASSOCIATED PAY ITEMS HAVE BEEN INCLUDED IN THE PLAN FOR WORK 1' EACH SIDE OF THE SIDEWALK. BEYOND 1' WILL BE CONTRACTORS RESPONSIBILITY AND DISTURBANCES SHOULD BE MINIMIZED.
11. AN ALLOWANCE OF 30 SQ YD OF CLASS D PATCHES, TYPE I, 4 INCH HAS BEEN INCLUDED IN THE PLANS TO REPAIR PAVEMENT DAMAGE BY WORK TO REMOVE AND REPLACE CURB AND GUTTER. THIS WORK SHALL BE DONE AS DIRECTED BY THE ENGINEER.

CONTRACT NO. 87540

DRAWN BY: NV	REVISIONS			
CHECKED BY: JKC	LEVEL	BY	DATE	DESCRIPTION
DATE: 12/15				

CHAMLIN & ASSOCIATES, INC.
PERU MORRIS ILLINOIS

SPRING VALLEY SRTS SECTION 10-00051-00-LT
SPRING VALLEY, ILLINOIS

INDEX OF SHEETS, TYPICAL SECTION AND GENERAL NOTES

CONSTRUCTION PLANS

CURRENT AS OF: 02/10/2016	
SCALE: AS NOTED	SHEET 2
FILE NO.: 66119.01 Y-	OF 9

CHAMBLIN & ASSOCIATES, INC. © 2015
 Drawing Name: 10_Vetera_E166119-01-Spring-Valley-SRTS-Lump-Sum-Federal-Contract-C4012491003-004-300.dwg Layer: Hatched - Feb 10, 2016 - 1:22pm Hatched on: Feb 10, 2016 - 1:55pm by: amack

CODE NO.	ITEM	UNIT	TOTAL QUANTITY	CONSTRUCTION CODE	
				FED 100%	FED 100%
				ROADWAY	SIGNALS
				0021	0021
20200100	EARTH EXCAVATION	CU YD	23	23	--
25000100	SEEDING, CLASS 1	ACRE	0	0.043	--
25000400	NITROGEN FERTILIZER NUTRIENT	POUND	4	4	--
25000500	PHOSPHORUS FERTILIZER NUTRIENT	POUND	4	4	--
25000600	POTASSIUM FERTILIZER NUTRIENT	POUND	4	4	--
25100630	EROSION CONTROL BLANKET	SQ YD	206	206	--
Δ 42400100	PORTLAND CEMENT CONCRETE SIDEWALK 4 INCH	SQ FT	5106	5106	--
42400300	PORTLAND CEMENT CONCRETE SIDEWALK 6 INCH	SQ FT	365	365	--
42400800	DETECTABLE WARNINGS	SQ FT	243	243	--
44000500	COMBINATION CURB AND GUTTER REMOVAL	FOOT	226	226	--
44000600	SIDEWALK REMOVAL	SQ FT	4335	4335	--
44201690	CLASS D PATCHES, TYPE I, 4 INCH	SQ YD	30	30	--
60603800	COMBINATION CONCRETE CURB AND GUTTER, TYPE B-6.12	FOOT	78	78	--

Δ - SEE SPECIAL PROVISIONS
 * - SPECIALTY ITEM

DRAWN BY: NV	REVISIONS			
CHECKED BY: JKC	LEVEL	BY	DATE	DESCRIPTION
DATE: 12/15				

CHAMBLIN & ASSOCIATES, INC.
 PERU MORRIS ILLINOIS

SPRING VALLEY SRTS
SECTION 10-00051-00-LT
SPRING VALLEY, ILLINOIS

SUMMARY OF QUANTITIES

CONSTRUCTION PLANS	CURRENT AS OF: 02/10/2016	
	SCALE: AS NOTED	SHEET 3
	FILE NO.: 66119.01 Y-	OF 9

CONTRACT NO. 87540

CHAMLIN & ASSOCIATES, INC. © 2015
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 Orientation: Landscape
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 Plot Range: All
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 Print Copies: 1
 Print Range: All
 Print Date: 12/15/16
 Print Time: 1:54pm
 Print User: jvick

CODE NO.	ITEM	UNIT	TOTAL QUANTITY	CONSTRUCTION CODE	
				FED 100% ROADWAY	FED 100% SIGNALS
				0021	0021
60604400	COMBINATION CONCRETE CURB AND GUTTER, TYPE B-6.18	FOOT	22	22	--
60605000	COMBINATION CONCRETE CURB AND GUTTER, TYPE B-6.24	FOOT	126	126	--
67100100	MOBILIZATION	LSum	1	1	
Δ 70102620	TRAFFIC CONTROL AND PROTECTION, STANDARD 701501	LSUM	1	1	--
Δ 70102640	TRAFFIC CONTROL AND PROTECTION, STANDARD 701801	LSUM	1	1	--
* 72000100	SIGN PANEL - TYPE 1	SQ FT	44	44	--
* 78000400	THERMOPLASTIC PAVEMENT MARKING - LINE 6"	FOOT	85	85	--
* 78000600	THERMOPLASTIC PAVEMENT MARKING - LINE 12"	FOOT	85	85	--
* 87502690	TRAFFIC SIGNAL POST, ALUMINUM 15 FT.	EACH	2	--	2
* 87800100	CONCRETE FOUNDATION, TYPE A	FOOT	6	--	6
Δ* X0325714	FLASHING BEACON, POST MOUNTED, SOLAR POWERED INSTALLATION	EACH	2	--	2

Δ - SEE SPECIAL PROVISIONS
 * - SPECIALTY ITEM

DRAWN BY: NV	REVISIONS			
CHECKED BY: JKC	LEVEL	BY	DATE	DESCRIPTION
DATE: 12/15				

CHAMLIN & ASSOCIATES, INC.
 PERU MORRIS ILLINOIS

SPRING VALLEY SRTS
SECTION 10-00051-00-LT
SPRING VALLEY, ILLINOIS

SUMMARY OF QUANTITIES

CONSTRUCTION PLANS	CURRENT AS OF: 02/10/2016	
	SCALE: AS NOTED	SHEET 4
	FILE NO.: 66119.01 Y-	OF 9

CONTRACT NO. 87540

SCHEDULE OF QUANTITIES

LOCATION	EARTH EXCAVATION CU YD	SEEDING, CLASS 1 ACRE	EROSION CONTROL BLANKET SQ YD	PORTLAND CEMENT CONCRETE SIDEWALK 4 INCH SQ FT	PORTLAND CEMENT CONCRETE SIDEWALK 6 INCH SQ FT	DETECTABLE WARNINGS SQ FT	COMBINATION CURB AND GUTTER REMOVAL FOOT	SIDEWALK REMOVAL SQ FT	COMBINATION CURB AND GUTTER REMOVAL, TYPE B-6.12 FOOT	COMBINATION CURB AND GUTTER REMOVAL, TYPE B-6.18 FOOT	COMBINATION CURB AND GUTTER REMOVAL, TYPE B-6.24 FOOT	SIGN PANEL - TYPE 1 SQ FT	THERMOPLASTIC PAVEMENT MARKING - LINE 6" FOOT	THERMOPLASTIC PAVEMENT MARKING - LINE 12" FOOT	TRAFFIC SIGNAL POST, ALUMINUM 15 FT. EACH	CONCRETE FOUNDATION, TYPE A FOOT	FLASHING BEACON, POST MOUNTED, SOLAR POWERED INSTALLATION EACH
NE CORNER OF STRONG AVENUE & 4TH ST.	0.35	0.0007	3.2	114	---	24	20	90	---	---	20	---	---	---	---	---	---
SE CORNER OF STRONG AVENUE & 4TH ST.	0.44	0.0008	3.9	101	---	10	13	92.5	---	---	13	---	---	---	---	---	---
NE CORNER OF RICHARDS ST & 4TH ST.	0.22	0.0004	2.0	72	---	13	22	62	---	22	---	---	---	---	---	---	---
SE CORNER OF RICHARDS ST & 4TH ST.	0.37	0.0007	3.3	151	---	28	22	134	---	---	22	---	---	---	---	---	---
NW CORNER OF RICHARDS ST & 4TH ST.	0.24	0.0004	2.2	80	---	18	16	68	16	---	---	---	---	---	---	---	---
SW CORNER OF RICHARDS ST & 4TH ST.	0.22	0.0004	1.9	52	---	10	11	47.5	---	---	11	---	---	---	---	---	---
RICHARDS ST BETW 2ND & 3RD STREETS	0.37	0.0007	3.3	75	---	---	---	75	---	---	---	---	---	---	---	---	---
RICHARDS ST BETW 3RD & 4TH STREETS	0.25	0.0005	2.2	50	---	---	---	50	---	---	---	---	---	---	---	---	---
4TH ST BETW RICHARDS & TAYLOR STREETS	3.75	0.0070	33.7	770	90	10	10	680	10	---	---	---	---	---	---	---	---
3RD ST BETW RICHARDS & TAYLOR STREETS	10.33	0.0192	92.9	2141	195	46	53	1720	33	---	20	---	---	---	---	---	---
SW CORNER OF TAYLOR ST & 3RD ST.	0.33	0.0006	3.0	79	---	10	10	56	10	---	---	---	---	---	---	---	---
4TH ST BETW TAYLOR & TERRY STREETS	5.30	0.0099	47.7	1086	80	10	9	940	9	---	---	---	---	---	---	---	---
SE CORNER OF RICHARDS ST & 3RD ST.	0.38	0.0007	3.4	95	---	10	12	80	---	---	12	---	---	---	---	---	---
NE CORNER OF RICHARDS ST & 1ST ST.	0.32	0.0006	2.9	65	---	10	---	65	---	---	---	---	---	---	---	---	---
NE CORNER OF RICHARDS ST & DAKOTA ST.	---	---	---	175	---	44	28	175	---	---	28	22	85	85	1	3	1
SW CORNER OF RICHARDS ST & DAKOTA ST.	---	---	---	---	---	---	---	---	---	---	---	22	---	---	1	3	1
TOTAL	23	0.043	206	5106	365	243	226	4335	78	22	126	44	85	85	2	6	2

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CONTRACT NO. 87540

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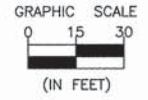
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PERU MORRIS ILLINOIS

SPRING VALLEY SRTS
SECTION 10-00051-00-LT
SPRING VALLEY, ILLINOIS

SCHEDULE OF QUANTITIES

CONSTRUCTION PLANS

CURRENT AS OF: 02/10/2016	
SCALE: AS NOTED	SHEET 5
FILE NO.: 66119.01 Y-	OF 9



SL=5.2%
ST=0.8%

REMOVE & REPLACE 18' OF 5' WIDE CONCRETE SIDEWALK WITH PORTLAND CEMENT CONCRETE SIDEWALK 4". CONSTRUCT DEPRESSED CORNER FOR SIDEWALK PER HIGHWAY STD. 424021. REMOVE 20 L.F. OF CONCRETE CURB AND GUTTER. REPLACE WITH COMBINATION CONCRETE CURB AND GUTTER TYPE B-6.24

SL=3.8%
ST=0.9%

REMOVE & REPLACE 18.5' OF 5' WIDE CONCRETE SIDEWALK WITH PORTLAND CEMENT CONCRETE SIDEWALK 4". CONSTRUCT DEPRESSED CURB RAMP FOR SIDEWALK PER HIGHWAY STD. 424001. REMOVE 13 L.F. OF CONCRETE CURB AND GUTTER. REPLACE WITH COMBINATION CONCRETE CURB AND GUTTER TYPE B-6.24

REMOVE & REPLACE 12.5' OF 5' WIDE CONCRETE SIDEWALK WITH PORTLAND CEMENT CONCRETE SIDEWALK 4". CONSTRUCT DEPRESSED CORNER FOR SIDEWALK PER HIGHWAY STD. 424021. REMOVE 16 L.F. OF CONCRETE CURB AND GUTTER. REPLACE WITH COMBINATION CONCRETE CURB AND GUTTER TYPE B-6.12

REMOVE & REPLACE 9.5' OF 5' WIDE CONCRETE SIDEWALK WITH PORTLAND CEMENT CONCRETE SIDEWALK 4". CONSTRUCT PERPENDICULAR CURB RAMP FOR SIDEWALK PER HIGHWAY STD. 424001. REMOVE 11 L.F. OF CONCRETE CURB AND GUTTER. REPLACE WITH COMBINATION CONCRETE CURB AND GUTTER TYPE B-6.24

REMOVE & REPLACE 16' OF 4' WIDE CONCRETE SIDEWALK WITH PORTLAND CEMENT CONCRETE SIDEWALK 4". CONSTRUCT DEPRESSED CORNER FOR SIDEWALK PER HIGHWAY STD. 424021. REMOVE 22 L.F. OF CONCRETE CURB AND GUTTER. REPLACE WITH COMBINATION CONCRETE CURB AND GUTTER TYPE B-6.18

SL=0.7%
ST=2.7%

REMOVE & REPLACE 31' OF 5' WIDE CONCRETE SIDEWALK WITH PORTLAND CEMENT CONCRETE SIDEWALK 4". CONSTRUCT DEPRESSED CORNER FOR SIDEWALK PER HIGHWAY STD. 424021. (USE 5' SIDEWALK WIDTH BOTH DIRECTIONS) REMOVE 22 L.F. OF CONCRETE CURB AND GUTTER. REPLACE WITH COMBINATION CONCRETE CURB AND GUTTER TYPE B-6.24

SL=5.4%
ST=0.7%

REMOVE & REPLACE 10' OF 5' WIDE CONCRETE SIDEWALK WITH PORTLAND CEMENT CONCRETE SIDEWALK 4"

MATCH LINE "B"
SEE SHEET 7

MATCH LINE "A"
SEE SHEET 8

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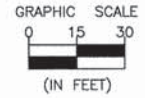
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PERU MORRIS ILLINOIS

SPRING VALLEY SRTS
SECTION 10-00051-00-LT
SPRING VALLEY, ILLINOIS

PLAN

CONSTRUCTION PLANS

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REMOVE & REPLACE 170'± OF 4' WIDE CONCRETE SIDEWALK WITH 5' WIDE PORTLAND CEMENT CONCRETE SIDEWALK 4". CONSTRUCT PERPENDICULAR CURB RAMP FOR SIDEWALK PER HIGHWAY STD. 424001. REMOVE 10 L.F. OF CONCRETE CURB AND GUTTER. REPLACE WITH COMBINATION CONCRETE CURB AND GUTTER TYPE B-6.12

REMOVE & REPLACE 230'± OF 4' WIDE CONCRETE SIDEWALK WITH 5' WIDE PORTLAND CEMENT CONCRETE SIDEWALK 4". CONSTRUCT PERPENDICULAR CURB RAMP FOR SIDEWALK PER HIGHWAY STD. 424001. REMOVE 9 L.F. OF CONCRETE CURB AND GUTTER. REPLACE WITH COMBINATION CONCRETE CURB AND GUTTER TYPE B-6.12

REMOVE & REPLACE 430'± OF 4' WIDE CONCRETE SIDEWALK BETWEEN RICHARDS STREET AND TAYLOR STREET WITH 5' WIDE PORTLAND CEMENT CONCRETE SIDEWALK 4".

CONSTRUCT DEPRESSED CORNER FOR SIDEWALK PER HIGHWAY STD. 424001. REMOVE 33 L.F. OF CONCRETE CURB AND GUTTER. REPLACE WITH COMBINATION CONCRETE CURB AND GUTTER TYPE B-6.12

REMOVE & REPLACE 14' OF 4' WIDE CONCRETE SIDEWALK WITH PORTLAND CEMENT CONCRETE SIDEWALK 4". CONSTRUCT PERPENDICULAR CURB RAMP FOR SIDEWALK PER HIGHWAY STD. 424001. REMOVE 10 L.F. OF CONCRETE CURB AND GUTTER. REPLACE WITH COMBINATION CONCRETE CURB AND GUTTER TYPE B-6.12

ST=1.2%

ST=1.5%

N TAYLOR STREET

N TERRY STREET

W 4TH STREET

W 3RD STREET

SL=2.3%
ST=2.6%

MATCH LINE "B"
SEE SHEET 6

MATCH LINE "C"
SEE SHEET 8

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C:\Users\jmorris\OneDrive\Documents\Projects\Spring Valley\Spring Valley - SRTS - Summary - Federal - Contract\CAD\007-PLAN-2.dwg Last Modified: Feb 10, 2016 - 9:03am. Plotted on: Feb 10, 2016 - 12:55pm by nancy

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DATE: 12/15				

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PERU MORRIS ILLINOIS


SPRING VALLEY SRTS
SECTION 10-00051-00-LT
SPRING VALLEY, ILLINOIS

PLAN

CONSTRUCTION PLANS

CONTRACT NO. 87540	
CURRENT AS OF: 02/10/2016	
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FILE NO.: 66119.01 Y-	OF 9

MATCH LINE "A"
SEE SHEET 6

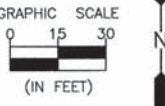

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 Company Name & Address \\\\S:\Projects\Spring Valley\SRIS-Lump-Sum-Federal-Contract\CAD\CAD\08-PLAN-3.dwg Last Modified: Feb 10, 2016 - 10:59am Plotted on: Feb 10, 2016 - 12:57pm by mack

DRAWN BY: NV CHECKED BY: JKC DATE: 12/15	REVISIONS			
	LEVEL	BY	DATE	DESCRIPTION




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SPRING VALLEY SRTS
 SECTION 10-00051-00-LT
 SPRING VALLEY, ILLINOIS


PLAN

CONSTRUCTION PLANS	CURRENT AS OF: 02/10/2016	
	SCALE: AS NOTED	SHEET 8
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CONTRACT NO. 87540



TYPICAL SPACING DETAIL FOR CROSSWALKS
N.T.S.

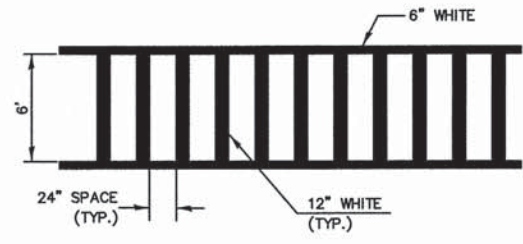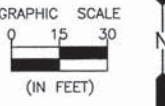

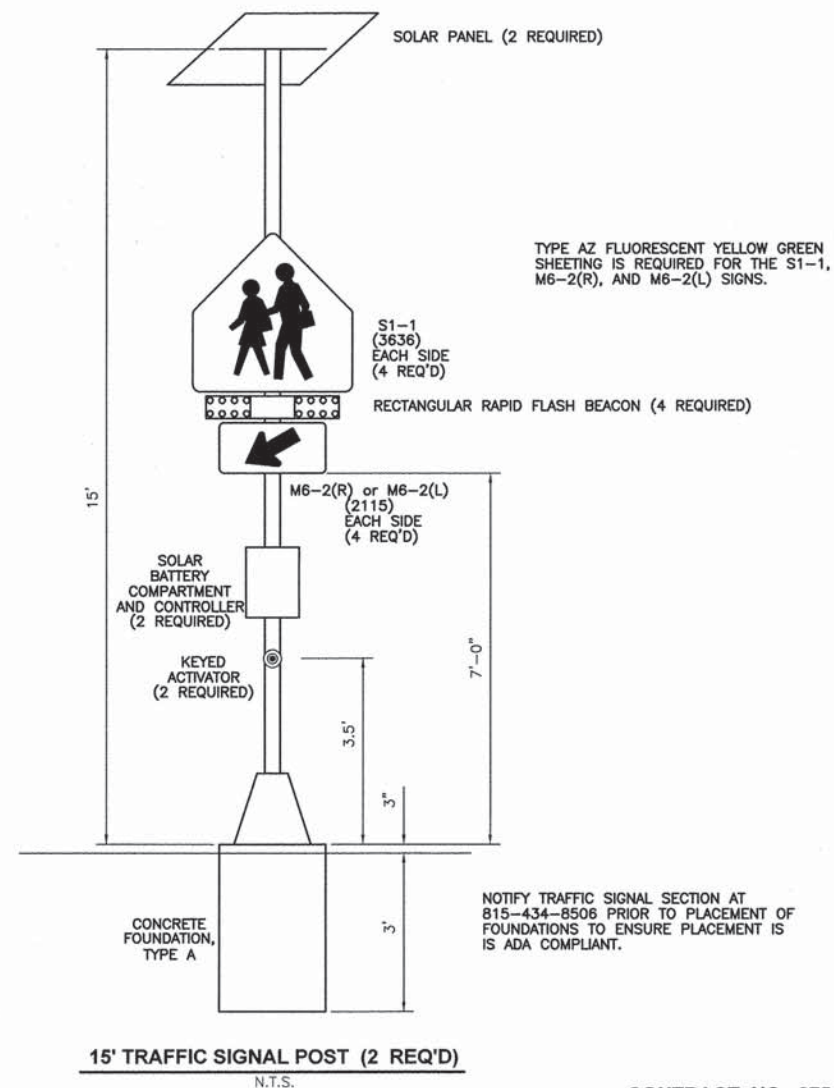15' TRAFFIC SIGNAL POST (2 REQ'D)
N.T.S.

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12132m Polled on: Feb 10, 2016 - 12:59pm by nandk
12132m Polled on: Feb 10, 2016 - 12:32pm
Contract: C:\3D\CAD\2015\Spring-Valley-SRTS-Lump-Sum-Federal-Contract\CAD\C3D\C3D09-PLAN-4.dwg
Last Modified: Feb 10, 2016 - 12:32pm
User: nandk

DRAWN BY: NV	REVISIONS			
CHECKED BY: JKC	LEVEL	BY	DATE	DESCRIPTION
DATE: 12/15				

CHAMLIN & ASSOCIATES, INC.
PERU MORRIS
ILLINOIS

SPRING VALLEY SRTS
SECTION 10-00051-00-LT
SPRING VALLEY, ILLINOIS

PLAN

CONSTRUCTION PLANS

CURRENT AS OF: 02/10/2016	
SCALE: AS NOTED	SHEET 9
FILE NO.: 66119.01 Y-	OF 9

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