EROSION CONTROL GENERAL NOTES

- SOIL DISTURBANCE SHALL BE CONDUCTED IN SUCH A MANNER AS TO MINIMIZE EROSION. AREAS OF THE DEVELOPMENT SITE THAT ARE NOT TO BE GRADED SHALL BE PROTECTED FROM CONSTRUCTION TRAFFIC OR OTHER DISTURBANCE UNTIL FINAL SEEDING IS PERFORMED.
- 2. PROPERTIES AND CHANNELS ADJOINING THE DEVELOPMENT SITE SHALL BE PROTECTED FROM EROSION AND SEDIMENTATION.
- 3. SOIL EROSION AND SEDIMENT CONTROL FEATURES SHALL BE CONSTRUCTED PRIOR TO THE COMMENCEMENT OF HYDROLOGIC DISTURBANCE OF UPLAND AREAS.
- 4. DISTURBED AREAS SHALL BE STABILIZED WITH TEMPORARY OR PERMANENT MEASURES WITHING SEVEN (7) CALENDAR DAYS FOLLOWING THE END OF ACTIVE HYDROLOGIC DISTURBANCE.
- ALL STORM SEWERS THAT ARE OR WILL BE FUNCTIONING DURING CONSTRUCTION SHALL BE PROTECTED BY AN APPROPRIATE SEDIMENT CONTROL MEASURE.
- 6. IF DEWATERING SERVICES ARE USED, ADJOINING PROPERTIES AND DISCHARGE LOCATIONS SHALL BE PROTECTED FROM EROSION. DISCHARGES SHALL BE ROUTED THROUGH AND EFFECTIVE SEDIMENT CONTROL MEASURE (E.G. SEDIMENT TRAP, SEDIMENT BASIN, OR OTHER APPROPRIATE MEASURE).
- 7. ALL TEMPORARY SOIL EROSION AND SEDIMENT CONTROL MEASURES SHALL BE REMOVED WITHIN THIRTY (30) DAYS AFTER FINAL SITE STABILIZATION IS ACHIEVED OR AFTER THE TEMPORARY MEASURES ARE NO LONGER NEEDED. TRAPPED SEDIMENT AND OTHER DISTURBED SOIL AREAS SHALL BE DEDIMENTLY STABILIZED. BE PERMANENTLY STABILIZED.
- 8. A STABILIZED MAT OF AGGREGATE UNDERLAIN WITH FILTER CLOTH (OR OTHER APPROPRIATE MEASURES) SHALL BE LOCATED AT ANY POINT WHERE TRAFFIC WILL BE ENTERING OR LEAVING A CONSTRUCTION-SITE OF A MAJOR DEVELOPMENT TO OR FROM A PUBLIC RIGHT-OF-WAY, STREET, ALLEY OR PARKING AREA, ANY SEDIMENT OR SIOL REACHING AN IMPROVED PUBLIC RIGHT-OF-WAY, STREET, ALLEY OR PARKING AREA SHALL BE REMOVED BY SCRAPING OR STREET CLEANING AS ACCUMULATIONS WARRANT AND TRANSPORTED TO A CONTROLLED SEDIMENT DISPOSAL AREA.
- SOIL STOCKPILES SHALL NOT BE LOCATED IN A FLOOD-PRONE AREA OR A DESIGNATED BUFFER PROTECTING WATERS OF THE UNITED STATES OR ISOLATED WATERS OF MCHENRY COUNTY.

EROSION CONTROL GENERAL NOTES (CONT.)

10. THE CONTRACTOR SHALL PROVIDE ADEQUATE RECEPTACLES FOR THE DEPOSITION OF ALL CONSTRUCTION MATERIAL DEBRIS GENERATED DURING THE DEVELOPMENT PROCESS. THE CONTRACTOR SHALL NOT CAUSE OR PERMIT DUMPING, DEPOSITING, DROPPING, THROWING, DISCARDING OR LEAVING OF CONSTRUCTION MATERIAL DEBRIS UPON OR INTO AND DEVELOPMENT SITE, CHANNEL, WATERS OF THE UNITED STATES OR ISOLATED WATERS OF MCHENRY COUNTY. THE CONTRACTOR SHALL MAINTAIN THE DEVELOPMENT SITE FREE OF CONSTRUCTION MATERIAL DEBRIS.

11. ALL TEMPORARY AND PERMANENT EROSION AND SEDIMENT CONTROL MEASURES SHALL BE MAINTAINED IN AN EFFECTIVE WORKING CONDITION.

12. TEMPORARY EROSION CONTROL SEEDING APPLIED AT THE RATE OF 100 POUNDS PER ACRE AS STATED IN ARTICLE 280.04 OF THE STANDARD SPECIFICATIONS.

13. PERMANENT EROSION CONTROL SHALL INCLUDE FURNISHING AND PLACING TOPSOIL, 6" AND SEEDING CLASS 2A TO BE PROVIDED IN ACCORDANCE WITH ARTICLE 250 OF THE STANDARD SPECIFICATIONS.

14. ALL WORK SHALL BE PERFORMED IN ACCORDANCE WITH THE STORM WATER POLLUTION PREVENTION PLAN FOR THIS PROJECT.


BEGIN PROJECT STA. 10+00

MATCHLINE STA. 106+00 -PERIMETER EROSION BARRIER (TYP.) PR ¢ CRYSTAL LAKE AVENUE INLET FILTERS (TYP.) -PR ¢ PINGREE ROAD رماا Q MATCHL] TEMPORARY EROSION (CONTROL SEEDING (TYP.)
(ALSO LIMITS OF PERMANENT MATCHLINE STA. 108+00 EROSION CONTROL) KENNETH DRIVE -TEMPORARY EROSION CONTROL SEEDING (ACRE) INLET FILTERS (EA)

>2→2

PERIMETER EROSION BARRIER (FT)

→⊕→Z

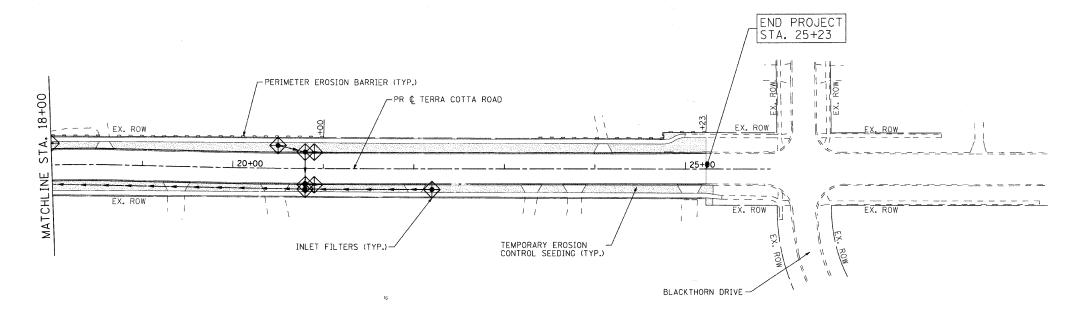

SEC Group, Inc.

# 184-000108	USER NAME = chartke	DESIGNED	-	JJS	REVISED
		DRAWN	~	JJS	REVISED
	PLOT SCALE = 1' = 50'	CHECKED	-	TCH	REVISED
90	PLOT DATE = 2/13/2009	DATE	-	2/13/09	REVISED

MCI	RY COUNTY	
DIVISION	OF	TRANSPORTATION

	EROSIO	N CO	NTROL	PLAN		-
PINGREE	ROAD	AND	TERRA	COTTA	ROAD	

F.A. RTE.	SEC	CTION			COUNTY	TOTAL SHEETS	SHEET NO.
0116	SECTION 116 08-00327-01-CH		T	MCHENRY	56	18	
				\top	CONTRAC	T NO. 6	53144
FED. ROA	D DIST. NO.	ILLINOIS	FED.	AID	PROJECT		

SCALE: 1" = 50' SHEET NO. 1 OF 2 SHEETS STA. BEGIN TO STA, END