#### 04-24-2020 LETTING ITEM 176

#### INDEX OF SHEETS

SHEET NO.	SHEET TITLE
1	TILE .
2	SUMMARY OF QUANTITIES
3	SCHEDULE OF QUANTITIES
4	GENERAL NOTES
5	GENERAL NOTES
6	LEGEND
7	TYPICAL SECTIONS
8	TYPICAL SECTIONS
9	4TH AVENUE PLAN AND PROFILE STA. 40+00 TO 46+00
10	4TH AVENUE PLAN AND PROFILE STA. 46+00 TO 52+00
11	4TH AVENUE PLAN AND PROFILE STA. 52+00 TO 58+00
12	4TH AVENUE PLAN AND PROFILE STA. 58+00 TO 64+00
13	4TH AVENUE PLAN AND PROFILE STA. 64+00 TO 70+00
14	4TH AVENUE PLAN AND PROFILE STA. 70+00 TO 76+00
15	4TH AVENUE PLAN AND PROFILE STA. 76+00 TO 82+00
16	4TH AVENUE PLAN AND PROFILE STA. 82+00 TO 85+21
17	GRAHAM STREET PLAN AND PROFILE STA. 200+00 TO 202+00
18	PARK STREET PLAN AND PROFILE STA. 100+00 TO 102+22
19	ADA RAMPS - 4TH AVENUE & CENTER
20	ADA RAMPS - 4TH AVENUE & LONG
21	ADA RAMPS - 4TH AVENUE & SCHOOL
22	ADA RAMPS - 4TH AVENUE & HILL
23	ADA RAMPS - 4TH AVENUE & GRAHAM
24	ADA RAMPS - 4TH AVENUE & PROSPECT
25	ADA RAMPS - 4TH AVENUE & PARK
26	ADA RAMPS - 4TH AVENUE & FERRIS
27	ADA RAMPS 4TH AVENUE & HUBBELL
28	TRAFFIC CONTROL PLAN - 4TH AVENUE
29	TRAFFIC CONTROL PLAN - 4TH AVENUE
30	4TH AVENUE - CROSS SECTIONS
31	PARK STREET CROSS SECTIONS
32	GRAHAM STREET CROSS SECTIONS
33	DETAILS
34	DETAILS
35	DETAILS


# CITY OF DIXON STREETS PROGRAM FY 2020

FOR

# CITY OF DIXON DIXON, IL

PROPOSED STREET PLANS FAU 5494 (4TH AVENUE)

LEE COUNTY
PROJECT NO. X3H4 (717)
JOB NO. C-92-078-19
CONTRACT NO. 85693
SECTION: 19-00180-00-RS

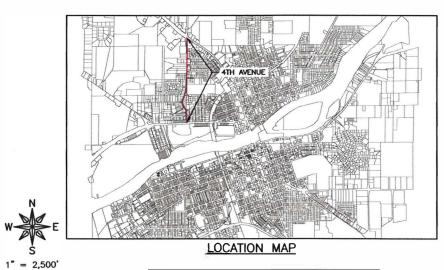

ADT LENGTH
4TH AVENUE 5500 0.83 MILE

SPEED LIMIT =  $\leq$  30 MPH

### FEHR GRAHAM ENGINEERING & ENVIRONMENTAL

ILLINOIS


**IOWA** 

WISCONSIN

ILLINOIS PROFESSIONAL DESIGN FIRM NUMBER: 184003525



# DIXON 1

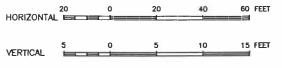

PLAN & PROFILE



SIGNATURE DATE

AGENCY RESPONSIBLE FOR LETTING

APPROVED 02/12/2020
CITY OF DOZON

PASSED 1/24/2020

CITY OF DOZON

PASSED 1/24/2020

RELEASING FOR BIO
BASED ON LIMITED REVIEW. 1/2/2020

DEPUTY DIRECTOR OF HIGHWAYS, REGION \$2 ENGINEER

#### UTILITIES

0	1.20
UTILITY TYPE	COMMON NAME
WATER & SEWER	CITY OF DIXON
ELECTRIC	COMED
TELEPHONE	CENTURYLINK
GAS	NICOR
CABLE	XFINITY

(CONTRACTOR TO BE RESPONSIBLE FOR ANY ADJUSTMENTS TO BE MADE.)

#### PRELIMINARY

DATE CREATED: 10/25/19

OFFICIAL SET FOR PROJECT: 18-633A

DESCRIPTION	DATE
	_
	DESCRIPTION

#### 6:\C30\18\18-6334\Plans\18-633 A - PLMS.dwg, TITLE

**STANDARDS** 

280001-07 TEMPORARY EROSION CONTROL SYSTEMS
424001-11 PERPENDICULAR CURB RAMPS FOR SIDEWALKS
424006-04 DUGONAL CURB RAMPS FOR SIDEWALKS
424011-04 CORNER PARALLE. CURB RAMPS FOR SIDEWALKS
424011-05 MID-BLOCK CURB RAMPS FOR SIDEWALKS
424021-05 DEPRESSED CORNER FOR SIDEWALKS
424021-05 MID-BLOCK CURB RAMPS FOR SIDEWALKS

424021-05 DEPRESSED CORPORER FOR SIDEWALKS
602701-02 MANHOLE SIEPS
602701-02 MANHOLE SIEPS
602701-07 CONGRETE CURB TYPE B AND COMBINATION CURB AND GUTTER
701006-05 OFF-ROAD OPERATIONS, 2L, 2W, 15' (4.5M) TO 24' (600 MM) FROM PAVEMENT EDGE
701101-05 OFF-ROAD OPERATIONS, MULTILANE, 15' (4.5M) TO 24' (600 MM) FROM PAVEMENT EDGE
701201-05 LANE CLOSURE, 2L, 2W, 3LOW MOVING OPERATIONS ON MIPH
701306-04 LANE CLOSURE, 2L, 2W, SLOW MOVING OPERATIONS ON YONLY, FOR SPEEDS ≥ 45 MPH
701311-03 LANE CLOSURE, 2L, 2W, MOVING OPERATIONS — DAY ONLY
701427-05 LANE CLOSURE, 2L, 2W, MOVING OPERATIONS — POR SPEEDS ≥ 40 MPH
701501-06 LANE CLOSURE, MULTILANE, INTERSITIENT OR MOVING OPERATIONS — FOR SPEEDS ≤ 40 MPH
701501-06 SIDEWALK, CORNER OR CROSSWALK CLOSURE
701901-08 TRAFFIC CONTROL DEVICES
720011-01 METAL POST FOR SIGNS, MARKERS AND DELINEATORS
728001-01 TELESCOPING STEEL SCON SUPPORT
729001-01 APPLICATIONS OF TYPES A & 8 METAL POSTS (FOR SIGNS & MARKERS)
780001-05 TYPICAL PAVEMENT MARKINGS

#### SUMMARY OF QUANTITIES

		19-00180-00-RS - CITY OF DIXON STREETS PROGRAM FY 2020	- SUMMARY C	F QUANTITIES	FOURTH AVENUE	PARK STREET	GRAHAM STRE
SP. PROV.	ITEM #	PAY ITEMS	UNIT	TOTAL QUANTITY	CONSTRUCTION CODE	CONSTRUCTION CODE	CONSTRUCTION O
				0005	0005	0005	0005
	20101400	NITROGEN FERTILIZER NUTRIENT	POUND	10	9	0.3	0.7
	20101500	PHOSPHORUS FERTILIZER NUTRIENT	POUND	10	9	0.3	0.7
	20101600	POTASSIUM FERTILIZER NUTRIENT	POUND	10	9	0.3	0.7
	20200100	EARTH EXCAVATION	CU YD	815	0	445	370
	21101615	TOPSOIL FURNISH AND PLACE, 4"	SQ YD	536	484	15	37
	25000110	SEEDING, CLASS 1A	ACRE	0.12	0.1	0.01	0.01
	25100630	EROSION CONTROL BLANKET	SQ YD	536	484	15	37
	28000500	INLET AND PIPE PROTECTION	EACH	25	25	0	0
	35101400	AGGREGATE BASE COURSE, TYPE B	TON	1087	165	443	479
	40600275	BITUMINOUS MATERIALS (PRIME COAT)	POUND	2815	0	1372	1443
	40600290	BITUMINOUS MATERIALS (TACK COAT)	POUND	13358	12795	274	289
	40604050	HOT-MIX ASPHALT SURFACE COURSE, IL-9.5 MIX "C", N50	TON	2639	2423	105	111
	42300300	PORTLAND CEMENT CONCRETE DRIVEWAY PAVEMENT, 7"	SQ YD	251	55	100	96
	42400100	PORTLAND CEMENT CONCRETE SIDEWALK 4 INCH	SQ FT	3608	3608	0	0
	42400800	DETECTABLE WARNINGS	SQ FT	384	384	0	0
	44000157	HOT-MIX ASPHALT SURFACE REMOVAL, 2"	SQ YD	1771	1771	0	0
	44000161	HOT-MIX ASPHALT SURFACE REMOVAL, 3"	SQ YD	13284	13075	209	0
	44000200	DRIVEWAY PAVEMENT REMOVAL	SQ YD	198	65	37	96
	44000500	COMBINATION CURB AND GUTTER REMOVAL	FOOT	823	· 823	0	0
	44000600	SIDEWALK REMOVAL	SQ FT	2832	2832	0	0
	44200050	WELDED WIRE REINFORCEMENT	SQ YD	251	55	100	96
	50800105	REINFORCEMENT BARS	POUND	14	0	14	0
	50901760	PIPE HANDRAIL	FOOT	33	0	33	0
*	60255500	MANHOLES TO BE ADJUSTED	EACH	17	16	0	1
	60260100	INLETS TO BE ADJUSTED	EACH	4	4	0	0
	60260300	INLETS TO BE ADJUSTED WITH NEW TYPE 1 FRAME, OPEN LID	EACH	1	1	0	0
	60266600	VALVE BOXES TO BE ADJUSTED	EACH	18	18	0	0
	60500060	REMOVING INLETS	EACH	1	1	0	0
	60600605	CONCRETE CURB, TYPE B	FOOT	47	0	47	0
	60604400	COMBINATION CONCRETE CURB AND GUTTER, TYPE B-6.18	FOOT	1557	823	328	406
	67100100	MOBILIZATION	L SUM	1	1	0	0
	70103815	TRAFFIC CONTROL SURVEILLANCE	CAL DA	30	0	20	10
	78000200	THERMOPLASTIC PAVEMENT MARKING - LINE 4"	F00T	7653	7653	0	0
	78000400	THERMOPLASTIC PAVEMENT MARKING - LINE 6"	F00T	640	640	0	0
	78000600	THERMOPLASTIC PAVEMENT MARKING - LINE 12"	F00T	69	69	0	. 0
	78000650	THERMOPLASTIC PAVEMENT MARKING - LINE 24"	FOOT	188	188	0	0
*	X0326806	WASHOUT BASIN	L SUM	1	1	0	0
*	X6024242	INLETS, SPECIAL, NO. 1	EACH	1	1	0	0
*	X7010216	TRAFFIC CONTROL AND PROTECTION (SPECIAL)	L SUM	1	1 .	0	0
*	X8140115	HANDHOLE TO BE ADJUSTED	EACH	1	1	0	0
*	Z0012450	CONCRETE STEPS	CU YD	0.5	0	0.5	. 0

A SPECTALTY ITEMS

FEHR GRAHAM

ENGINEERING & ENVIRONMENTAL
ILLINOIS DESIGN FIRM NO. 184-003525

ILLINOIS IOWA WISCONSIN OWNER/DEVELOPER:
CITY OF DIXON
121 WEST 2ND STREET
DIXON, IL 61021

PROJECT AND LOCATION: CITY OF DIXON STREETS PROGRAM FY 2020 DIXON, IL

DRAWN BY: YJ/JMV APPROVED BY: NJC DATE: 10/25/19 SCALE: AS NOTED

	REVISIONS	
REV. NO.	DESCRIPTION	DATE

DRAWING:
SUMMARY OF QUANTITIES

JOB NUMBER:
18-833A

SET TYPE: PRELIMINARY

G:\C30\18\18-83X\Plans\18-833 A - Plans.dmg, S00

18-833A SHEET NUMBER:

2 of 35

#### SCHEDULE OF QUANTITIES

20101400 - NITROGEN FERTILIZER NUTRIENT (LB)				
PROJECT	10			
20101500 - PHOSPHORU	JS FERTILZER NUTIENT (LB)			
PROJECT	10			
20101C00 DOTACCIUNA	FEDTUIZED AUITIDENT (LD)			
	FERTILIZER NUTIRENT (LB)			
PROJECT	10			
20200100 - FAI	RTH EXCAVATION			
PARK STREET	445			
GRAHAM STREET	370			
TOTAL:	815			
21101615 - TOPSOIL FU	RNISH AND PLACE, 4" (SY)			
PROJECT	536			
25000110 - SEED	ING, CLASS 1A (AC)			
PROJECT	0.12			
35400630 55061011	CONTROL DI ANIVET (CV)			
	CONTROL BLANKET (SY)			
PROJECT	536			
28000500 - INLET ANI	D PIPE PROTECTION (EA)			
PROJECT	25			
TROSECT	2.5			
35101400 - AGGREGATE	BASE COURSE, TYPE B (TN)			
FOURTH AVENUE	165			
PARK STREET	443			
GRAHAM STREET	479			
TOTAL:	1087			
42200200 DODTI AND CENTENT	CONCRETE DRIVENAV DAVERAFAIT			
	CONCRETE DRIVEWAY PAVEMENT, CH (SY)			
52+41 LT	39			
63+37 RT	16			
PARK STREET				
101+15 LT	81			
101+44.5 - 101+92.8 LT	19			
GRAHAM STREET				
201+07 LT	37			
201+14 RT	11			
201+84 LT	5			
202+27 LT	28			
202+27 RT	15			

42400100 - PORTLAND C SIDEWALK 4 II	
43+06 - 43+32 LT	124
43+67 - 43+96 LT	123
51+00 - 51+28 LT	140
51+58 - 51+86 LT	124
52+18 - 52+61 LT	73
55+80 - 56+31 LT	292
56+00 - 56+42 RT	490
59+43 - 59+66 LT	176
59+68 - 59+73 RT	92
64+26 - 64+46 RT	139
64+83 - 65+07 RT	119
67+74 - 68+03 RT	150
68+30 - 68+67 RT	180
71+26 - 71+51 RT	101
71+79 - 72+09 RT	143
74+84 - 74+91 RT	131
75+25 - 75+47 RT	300
78+62 -78+96 RT	361
79+30 - 79+56 RT	350
TOTAL:	3608
TOTAL	3000
42400800 - DETECTABL	L WARNINGS (SF)
43+24	32
43+73	10
51+24	10
51+65	10
56+05	20
56+06	20
59+64	13
59+68	10
64+43	17
64+88	28
67+98	26
68+39	27
71+42	29
71+88	27
74+86	27
75+33	20
78+94	28
79+35	30
73+33	30
T0T*	204
TOTAL:	384
44000200 - DRIVEWAY PAV	 
44+41 LT	10
52+41 LT	39
63+32 RT	16
1) 7C±CO	10
PARK STREET	
101+02 LT	18
101+28 LT	19
101+20 LI	13
GRAHAM STREET	
201+07 LT	37
201+14 RT	11
201+84 LT	5
202+27 LT	28
	15
202+27 RT	
202+27 RT  TOTAL:	198

	(FT)
43+10.9 - 43+43 LT	42
43+66 - 43+82 LT	35
44+29.2 - 44+52 LT	23
51+09 -51+31 LT	34
51+57 - 51+70 LT	25
52+18.8 - 52+61.8 LT	45
55+80.5 - 56+26.5 LT	45
55+93.3 - 56+17.8 RT	25
59+53.3 - 59+70.4 LT	24
59+60.8 - 59+75.5 RT	15
63+09.3 - 63+54.8 RT	45
63+34.7 - 64+49.7 RT	24
64+79 - 65+08.8 RT	36
67+74.1 - 68+07 RT	40
68+27.9 - 68+62.1 RT	40
71+29.9 - 71+53 RT	23
71+76 - 72+05.1 RT	35
74+74.7 - 74+95 RT	28
75+26 - 75+47.4 RT	62
76+33 - 76+56.3 RT	23
77+06.5 - 77+30.4 RT	24
78+24.3 - 79+01.8 RT	88
79+27 - 79+56 RT	42
TOTAL:	823
44000600 - SIDEWALK	REMOVAL (SF)
43+06 - 43+32 LT	100
43+67 - 43+96 LT	99
51+00 - 51+28 LT	112
51+58 - 51+86 LT	100
52+18 - 52+61 LT	73
55+80 - 56+31 LT	182
56+00 - 56+42 RT	392
59+43 - 59+66 LT	141
59+68 - 59+73 RT	74
64+26 - 64+46 RT	111
64+83 - 65+07 RT	96
67+74 - 68+03 RT	120
68+30 - 68+67 RT	144
71+26 - 71+51 RT	81
71+79 - 72+09 RT	94
74+84 - 74+91 RT	105
75+25 - 75+47 RT	239
78+62 -78+96 RT	289
79+30 - 79+56 RT	280
TOTAL:	2832
44200050 - WELDED WIRE R	EINFORCEMENT (SY)
52+41 LT	39
63+32 RT	16
PARK STREET	
101+15	81
101+44.5 - 101+92.8 LT	19
CDV IIVV CTDEET	
GRAHAM STREET	27
201+07 LT	37 11
201+14 RT 201+84 LT	11 5
201+84 LT 202+27 LT	28
202+27 LT 202+27 RT	28 15
202 · 21 IVI	13
•	

PARK STREET  101+14 RT	14
101+14 KT	14
ТОТ	AL: 14
* 60255500 - MAN	 HOLES TO BE ADJUSTED (EA
41+44	1
41+51	1
41+53	1
43+53	1
43+54	1
43+56	1
43+92	1
46+38	1
48+90	1
51+44	1
51+84 55+08	1
65+65	1
71+66	1
75+30	1
79+15	1
GRAHAM STREET	
200+80.9	1
ТОТ	AL: 17
C02C0400 ::::	TO DE ADULCTED (5.1)
	TS TO BE ADJUSTED (EA)
43+84 51+72	1
68+30	1 1
83+93	1
33.33	<u> </u>
тот	AL: 4
	BE ADJUSTED WITH NEW TY F, OPEN LID (EA)
78+92	1
60266600 - \/\\\E_	BOXES TO BE ADJUSTED (EA
43+30	1
43+30	1
43+51	1
43+84	1
48+71	1
	4
51+37	1
51+37 55+95	1 1
55+95	1
55+95 64+47	1 1
55+95 64+47 64+48 64+84 68+19	1 1 1 1 1
55+95 64+47 64+48 64+84 68+19 68+27	1 1 1 1 1 1
55+95 64+47 64+48 64+84 68+19 68+27 68+35	1 1 1 1 1 1 1
55+95 64+47 64+48 64+84 68+19 68+27 68+35 71+46	1 1 1 1 1 1 1 1 1 1 1 1 1 1 1 1
55+95 64+47 64+48 64+84 68+19 68+27 68+35 71+46 71+74	1 1 1 1 1 1 1 1 1 1 1 1 1 1 1 1 1 1
55+95 64+47 64+48 64+84 68+19 68+27 68+35 71+46 71+74	1 1 1 1 1 1 1 1 1 1 1 1 1 1 1 1 1 1 1
55+95 64+47 64+48 64+84 68+19 68+27 68+35 71+46 71+74 74+97 78+93	1 1 1 1 1 1 1 1 1 1 1 1 1 1 1 1 1 1 1
55+95 64+47 64+48 64+84 68+19 68+27 68+35 71+46 71+74	1 1 1 1 1 1 1 1 1 1 1 1 1 1 1 1 1 1 1

605000	60 - REMOVING INLETS (EA)
75+28	1
60600605	- CONCRETE CURB, TYPE B (FT)
PARK STREET	,
-	
101+40.8 - 101+87.9	47
60604400 - COMBINATION	CONCRETE CURB AND GUTTER TYPE B-6.18 (FT)
43+10.9 - 43+43 LT	42
43+66 - 43+82 LT	35
44+29.2 - 44+52 LT	23
51+09 -51+31 LT	34
51+57 - 51+70 LT	25
52+18.8 - 52+61.8 LT	45
55+80.5 - 56+26.5 LT	45
55+93.3 - 56+17.8 RT	25
59+53.3 - 59+70.4 LT	24
59+60.8 - 59+75.5 RT	15
63+09.3 - 63+54.8 RT	45
63+34.7 - 64+49.7 RT	24
64+79 - 65+08.8 RT	36
67+74.1 - 68+07 RT	40
68+27.9 - 68+62.1 RT	40
71+29.9 - 71+53 RT	23
71+76 - 72+05.1 RT	35
74+74.7 - 74+95 RT	28
75+26 - 75+47.4 RT	62
76+33 - 76+56.3 RT	23
77+06.5 - 77+30.4 RT	24
78+24.3 - 79+01.8 RT	88
79+27 - 79+56 RT	42
79+27 - 79+30 KT	42
DADY (TD 557	
PARK STREET	
100+52 - 101+92.9 LT	141
100+50 - 102+35 RT	187
<b>GRAHAM STREET</b>	
200+37.91 - 202+36.38 RT	198
200+28.96 - 202+36.38 LT	208
TOTAL:	1557
TOTAL.	1337
6710	0100 MODULTATION (LS)
	0100 - MOBILIZATION (LS)
PROJECT	1
70103815 - TRAF	FIC CONTROL SURVEILLANCE (CAL DA)
PARK STREET	20
GRAHAM STREET	10
TOTAL:	30
TOTAL	
78000200 - THERMOP	LASTIC PAVEMENT MARKING - LINE 4" (FT)
40+75 - 43+18	579
43+83 - 46+40	515
46+30 - 48+36	313
48+90 - 51+18	453
51+71 - 55+15	684
55+63 - 56+02	71
56+12 - 59+53	684
60+25 - 64+43.4	841
64+95.3 - 65+28.5	67
65+97.7 - 67+94.3	393
68+42.1 - 71+36.2	588
71+97.4 - 74+81.2	580
75+44.1 - 48+82.5	677
79+42.5 - 84+39	1208
15 .2.5 51.55	
TOTAL	7652
TOTAL:	7653

LINE 6" (	(FI)
42 27 4 42 70 5 1 5	· ,
43+27.4 - 43+70.5 LT	75
51+27.4 - 51+62.5 LT	66
56+05	90
59+62.7	28
59+68.8	32
64+49.2 - 64+86.1 RT	65
67+99.9 - 68+37.1 RT	62
71+45.2 - 71+86.7 RT	70
74+87.9 - 75+35.8 RT	84
78+95.5 - 79+33.2 RT	67
TOTAL:	640
78000600 - THERMOPLASTIC LINE 12"	
41+71 - 42+72	43
83+69 - 84+29	26
JJ. JJ JT12J	
TOTAL:	69
78000650 - THERMOPLASTIC	PAVEMENT MARKING -
LINE 24"	
43+47	15
43+60	13
46+61	10
48+57	11
51+38	14
55+48	12
55+81.2	13
56+31.2	14
59+78	16
64+73	12
65+55	16
68+23	7
71+71	10
75+20	13
79+22	11
TOTAL:	188
* <b>X0326806 - WASH</b> PROJECT	OUT BASIN (LS)
PROJECT	1
* X6024242 - INLETS, S	PECIAL, NO. 1 (EA)
75+28	1
* X7010216 - TRAFFIC CONT (SPECIAL)	
PROJECT	1
*X8140115 - HANDHOLE 1	 TO BE ADJUSTED (EA)
64+50 RT	1
	1
* 70040450 0000	DETE CTEDE (CV)
* <b>Z0012450 - CONC</b> I	RETE STEPS (CY)



ENGINEERING & ENVIRONMENTAL
ILLINOIS DESIGN FIRM NO. 184-003525

251

ILLINOIS IOWA

WISCONSIN

OWNER/DEVELOPER:

CITY OF DIXON
121 WEST 2ND STREET
DIXON, IL 61021

PROJECT AND LOCATION:

CITY OF DIXON STREETS PROGRAM

FY 2020

DIXON, IL

DRAWN BY: YJ/JMV
APPROVED BY: NJC
DATE: 10/25/19
SCALE: AS NOTED

	REVISIONS	
REV. NO.	DESCRIPTION	DATE

DRAWING:
SCHEDULE OF QUANTITIES

SET TYPE: PRELIMINARY
G:\C3D\18\18-833A\Pians\18-833 A - PLANS.dwg, SCHED.1

TOTAL:

#### GENERAL NOTES

- 1. THIS PROJECT SHALL BE CONSTRUCTED IN ACCORDANCE WITH THE MUNICIPAL CODE, CITY OF DIXON, ILLINOIS, CURRENT EDITION, THE ILLINOIS DEPARTMENT OF TRANSPORTATION'S "STANDARD SPECIFICATIONS FOR ROAD AND BRIDGE CONSTRUCTION IN ILLINOIS", CURRENT EDITION, "SUPPLEMENTAL SPECIFICATIONS AND RECURRING SPECIAL PROVISIONS," CURRENT EDITION, SPECIAL PROVISIONS AND THE "STANDARD SPECIFICATIONS FOR WATER AND SEWER MAIN CONSTRUCTION IN ILLINOIS", CURRENT EDITION. SIGN CONSTRUCTION AND PAVEMENT MARKINGS SHALL CONFORM TO THE REQUIREMENTS OF THE "MANUAL ON UNIFORM TRAFFIC CONTROL DEVICES", CURRENT EDITION.
- 2. IN THESE CONTRACT DOCUMENTS MENTION IS MADE OF THE "ENGINEER", WHICH SHALL MEAN FEHR GRAHAM OR THEIR DULY AUTHORIZED AGENT. IN THESE CONTRACT DOCUMENTS MENTION IS MADE OF THE "OWNER", WHICH SHALL MEAN CITY OF DIXON, OR THEIR DULY AWARDED AGENT.
- 3. AS PART OF THE BIDDING PROCEDURE, THE CONTRACTOR SHALL VERIFY THAT THE QUANTITIES FOR PAY ITEMS, AS PRESENTED IN THESE PLAN DOCUMENTS, ARE SUBSTANTIALLY CORRECT. IF DISCREPANCIES ARE DETECTED, THE CONTRACTOR SHALL NOTIFY THE ENGINEER OF THE DISCREPANCY PRIOR TO THE BID DATE.
- 4. QUANTITIES SHOWN ARE ESTIMATES FOR INFORMATION ONLY. PAYMENT WILL BE BASED ON ACTUAL QUANTITIES MEASURED IN THE FIELD OR ON PAYMENT LIMIT DETAILS.
- 5. THE CONTRACTOR SHALL BE PAID FOR MATERIALS AND EQUIPMENT SUCCESSFULLY INSTALLED IN ACCORDANCE WITH THE PLANS AND SPECIFICATIONS AS MEASURED OR VERIFIED IN PLACE BY THE ENGINEER OR HIS AGENT.
- 6. IN CASE OF CONFLICT BETWEEN THE ABOVE MENTIONED SPECIFICATIONS, THE ENGINEER SHALL DETERMINE WHICH OF THE SPECIFICATIONS SHALL GOVERN. THE ENGINEER'S DECISION SHALL BE FINAL AND NO ADDITIONAL COMPENSATION SHALL BE AWARDED UNLESS APPROVED BY THE ENGINEER.
- 7. THE PROPOSED IMPROVEMENTS MUST BE CONSTRUCTED IN ACCORDANCE WITH THE ENGINEERING PLANS AS APPROVED BY THE OWNER. IMPROVEMENT REPRESENTATIONS AS SHOWN ON THESE PLANS, ARE AS ACCURATE AS POSSIBLE FROM THE INFORMATION AVAILABLE. HOWEVER SOME FIELD REVISIONS MAY BE REQUIRED TO ACCOMMODATE UNFORESEEN CIRCUMSTANCES THE ENGINEER SHALL BE ADVISED OF ANY NECESSARY REVISIONS WITH SUFFICIENT LEAD TIME ALLOWED TO PROPERLY CONSIDER AND ACT UPON SAID REQUESTS. PROPER CONSTRUCTION TECHNIQUES MUST BE FOLLOWED IN CONSTRUCTING THOSE IMPROVEMENTS AS DETAILED IN THIS ENGINEERING PLAN.
- 8. THE ENGINEER SHALL HAVE THE AUTHORITY TO INSPECT, APPROVE OR REJECT THE WORKMANSHIP AND/OR MATERIALS WHICH GO TO MAKE UP IMPROVEMENTS AS DETAILED IN THESE PLANS AND SPECIFICATIONS.
- 9. GENERAL SAFETY PROVISION: TO PROVIDE DRIVERS WITH SAFE TRAVEL CONDITIONS DURING THE CONSTRUCTION PROJECT, AND TO PROVIDE SAFE WORKING CONDITIONS FOR ALL EMPLOYEES, THE RULES, REGULATIONS, AND CONDITIONS STATED BELOW WILL PREVAIL FOR THE DURATION OF THIS CONTRACT. ANY EMPLOYEE OF THE CONTRACTOR OR HIS SUBCONTRACTORS WHO REFUSES TO COMPLY WITH THESE GENERAL SAFETY PROVISIONS SHALL BE REMOVED FROM THE JOB SITE IN ACCORDANCE WITH STATE AND LOCAL REQUIREMENTS. THE CONTRACTOR AND ANY SUBCONTRACTORS RETAINED BY HIM SHALL COMPLY WITH THE STATE AND FEDERAL REQUIREMENTS OF THE OCCUPATIONAL SAFETY AND HEALTH ACT OF 1970 (OSHA), JULY 1, 1987 AS IT RELATES TO CONTRACTOR'S OPERATIONS.
- 10. THE CONTRACTOR SHALL COMPLY WITH ALL STATE REGULATIONS REGARDING AIR, WATER, AND NOISE POLLUTION. THE CONTRACTOR WILL NOT BE ALLOWED TO BUILD FIRES ON THE SITE.
- 11. THE SCALE SHOWN ON THE DRAWINGS APPLIES ONLY TO THE FULL SIZE PLANS NOT THE REDUCED SIZE PLANS.
- 12. IT SHALL BE THE CONTRACTOR'S RESPONSIBILITY TO MAINTAIN DRAINAGE FLOWS AT ALL TIMES DURING THE PERFORMANCE OF THE WORK. METHODS USED BY THE CONTRACTOR SHALL BE SUBJECT TO THE APPROVAL OF THE ENGINEER. COST OF MAINTAINING DRAINAGE FLOWS SHALL BE INCIDENTAL TO THE CONTRACT.
- 13. WHERE SECTION OR SUBSECTION MONUMENTS ARE ENCOUNTERED, THE ENGINEER SHALL BE NOTIFIED BEFORE SUCH MONUMENTS ARE REMOVED OR DISTURBED. THE CONTRACTOR SHALL PROTECT AND CAREFULLY PRESERVE ALL PROPERTY MARKERS, MONUMENTS AND RIGHT—OF—WAY PINS UNTIL THE OWNER, AND AUTHORIZED SURVEYOR, OR AGENT HAS WITNESSED OR OTHERWISE REFERENCED THEIR LOCATION. THE CONTRACTOR SHALL BE RESPONSIBLE FOR HAVING AN AUTHORIZED SURVEYOR RE—ESTABLISH ANY SECTION OR SUBSECTION MONUMENTS DESTROYED BY HIS OPERATIONS. REPLACEMENT OF MONUMENTS WILL BE DETERMINED BY THE ENGINEER.
- 14. THE CONTRACTOR SHALL REMOVE, STORE, AND RELOCATE TO THE SATISFACTION OF THE ENGINEER ALL EXISTING SIGNAGE IN ACCORDANCE WITH STATE AND LOCAL REQUIREMENTS, AND CONSIDER THIS AS INCIDENTAL TO THE CONTRACT.
- 15. OUTSIDE THE EXISTING RIGHT-OF-WAY, THE CONTRACTOR SHALL USE CARE IN GRADING OR EXCAVATION NEAR ANY AND ALL EXISTING SIGNS OUTSIDE THE RIGHT-OF-WAY. ANY SIGNS REMOVED FOR CONSTRUCTION PURPOSES SHALL BE CAREFULLY REMOVED AND RE-ERECTED BY THE CONTRACTOR AT A LOCATION NEAREST TO THE ORIGINAL LOCATION, OR AT A LOCATION DETERMINED BY THE ENGINEER IN THE FIELD. REMOVAL AND RE-ERECTED SIGNS AND ANY DAMAGE DONE TO EXISTING SIGNS BY THE CONTRACTOR'S OPERATIONS SHALL BE REPAIRED OR REPLACED AT NO ADDITIONAL EXPENSE TO THE OWNER.
- 16. ALL ITEMS SHALL INCLUDE ALL THE NECESSARY MATERIALS AND LABOR TO COMPLETE THE ITEM IN PLACE. MATERIALS AND LABOR NOT SPECIFICALLY IDENTIFIED SHALL BE CONSIDERED INCIDENTAL TO THE PROJECT.
- 17. AT THE END OF EACH DAY, THE CONTRACTOR SHALL SECURE THE CONSTRUCTION WORK ZONE FROM POTENTIAL INTRUDERS.
- 18. THE CONTRACTOR SHALL FIELD VERIFY THE ELEVATIONS OF THE BENCHMARKS PRIOR TO COMMENCING WORK. THE CONTRACTOR SHALL ALSO FIELD VERIFY LOCATION, ELEVATION AND SIZE OF EXISTING UTILITIES, AND VERIFY PAVEMENT ELEVATIONS WHERE MATCHING INTO EXISTING WORK. THE CONTRACTOR SHALL FIELD VERIFY HORIZONTAL CONTROL BY REFERENCING SHOWN COORDINATES TO KNOWN PROPERTY LINES. NOTIFY ENGINEER OF DISCREPANCIES IN EITHER VERTICAL OR HORIZONTAL CONTROL PRIOR TO PROCEEDING WITH WORK.
- 19. THE CONTRACTOR SHALL CONTACT THE ENGINEER OF ANY ERRORS OR DISCREPANCIES WHICH MAY BE SUSPECTED IN LINES AND GRADES, AND SHALL NOT PROCEED WITH THE WORK UNTIL ALL LINES AND GRADES WHICH ARE BELIEVED TO BE IN ERROR HAVE BEEN VERIFIED OR CORRECTED BY THE ENGINEER OR HIS REPRESENTATIVE.
- 20. THE ENGINEER AND OWNER ARE NOT RESPONSIBLE FOR THE CONSTRUCTION MEANS, METHODS, TECHNIQUES, SEQUENCE OR PROCEDURES, TIME OF PERFORMANCE, PROGRAMS OR ANY SAFETY PRECAUTIONS USED BY THE CONTRACTOR. THE CONTRACTOR IS SOLELY RESPONSIBLE FOR EXECUTION OF THEIR WORK IN ACCORDANCE WITH THE CONTRACT DOCUMENTS AND SPECIFICATIONS.
- 21. ALL ITEMS TO BE REMOVED AND NOT DEFINED AS A PAY ITEM SHALL BE CONSIDERED INCIDENTAL TO THE PROJECT.
- 22. ALL EXCESS EARTH EXCAVATION, EXCESS MATERIALS, OR OTHER REMOVED ITEMS SHALL BE HAULED OFF—SITE AT THE CONTRACTOR'S EXPENSE, UNLESS OTHERWISE APPROVED BY THE OWNER.
- 23. THIS WORK SHALL BE IN ACCORDANCE WITH SECTION 201 OF THE ILLINOIS DEPARTMENT OF TRANSPORTATION'S "STANDARD SPECIFICATIONS FOR ROAD AND BRIDGE CONSTRUCTION IN ILLINOIS", CURRENT EDITION. THE CONTRACTOR SHALL REMOVE AND DISPOSE OF ALL OBSTRUCTIONS, TREES, DEBRIS AND BRUSH AS DESIGNATED BY THE OWNER AND AS INDICATED ON THE PLANS. ALL MATERIALS SHALL BE DISPOSED OF AT THE CONTRACTOR'S EXPENSE. DURING CONSTRUCTION, CARE SHALL BE TAKEN TO MINIMIZE DAMAGE TO THE EXISTING TREES AND LANDSCAPING. ONLY THOSE ITEMS DESIGNATED BY THE OWNER SHALL BE REMOVED.
- 24. ALL ROADWAY REMOVAL ITEMS SHALL CONFORM TO THE ILLINOIS DEPARTMENT OF TRANSPORTATION'S "STANDARD SPECIFICATIONS FOR ROAD AND BRIDGE CONSTRUCTION IN ILLINOIS", CURRENT EDITION. ALL JOINTS BETWEEN THE PORTION REMOVED AND THAT LEFT IN PLACE SHALL BE SAWED TO SUCH A DEPTH THAT A CLEAN, NEAT EDGE WILL RESULT WITH NO SPALLING TO THE REMAINING PORTION. THE COST OF SAWING SHALL BE CONSIDERED INCIDENTAL TO THE CONTRACT. ADDITIONAL SAWING OR RE—SAWING MAY BE REQUIRED AS DIRECTED BY THE ENGINEER WITH NO ADDITIONAL COMPENSATION BEING ALLOWED. THE COST OF SAWCUTTING THE EXISTING PAVEMENT SHALL NOT BE PAID FOR SEPARATELY, BUT SHALL BE CONSIDERED INCIDENTAL TO THE CONTRACT.

#### GENERAL NOTES

- 25. WHEN ARTIFICIAL LIGHTING IS UTILIZED DURING NIGHT OPERATIONS, THE CONTRACTOR SHALL EXERCISE UTMOST PRECAUTIONS IN PREVENTING ADVERSE VISIBILITY TO THE MOTORING PUBLIC, AS WELL AS ADJOINING RESIDENTIAL AREAS.
- 26. THE CONTRACTOR IS REQUIRED TO STAY WITHIN THE NOTED PROPERTY BOUNDARIES RIGHT-OF-WAY AND EASEMENTS AS SHOWN IN THE PLANS. ANY ADDITIONAL EASEMENTS SHALL BE SECURED BY THE CONTRACTOR AT NO EXTRA COST.
- 27. ANY AREAS DAMAGED OR DISTURBED DURING THE PROJECT AS A DIRECT OR INDIRECT RESULT OF CONTRACTOR OPERATIONS, SHALL BE RESTORED TO A CONDITION EQUAL TO OR BETTER THAN THE ORIGINAL CONDITION. THE COST OF SAID RESTORATION OR REPAIR SHALL BE BORNE TOTALLY BY THE CONTRACTOR, WITH NO EXTRA COMPENSATION BEING AWARDED UNDER THIS CONTRACT. THE RESPONSIBILITY FOR THE REPAIR OR REPLACEMENT OF ANY UTILITY, STRUCTURE, LANDSCAPING, ETC., DAMAGED OR DESTROYED BY THE CONTRACTOR DURING MOBILIZATION OR CONSTRUCTION SHALL BE BORNE SOLELY BY THE CONTRACTOR, WITH NO EXPENSE BEING CHARGED TO THE ENGINEER OR OWNER. PRIOR TO ACCEPTANCE OF THIS REPAIR OR REPLACEMENT, THE CONTRACTOR SHALL PRESENT THE OWNER WITH A "SIGNOFF LETTER", SIGNED BY A RESPONSIBLE OFFICIAL OF THE OWNER OF THE DAMAGED UTILITY STATING THAT THE REPAIR OR REPLACEMENT IS ACCEPTABLE.

#### CONSTRUCTION STAKING

1. CONSTRUCTION STAKING SERVICES WILL BE PROVIDED BY THE OWNER. STAKE POINTS WILL BE STAKED ONE TIME WHEN REQUESTED BY THE CONTRACTOR. THE SAME STAKE POINTS REQUESTED BY THE CONTRACTOR A SECOND TIME WILL BE PAID FOR BY THE CONTRACTOR.

#### **EROSION CONTROL NOTES**

- 1. UNLESS OTHERWISE SPECIFIED, ALL EROSION AND SEDIMENT CONTROL MEASURES AND THEIR MAINTENANCE, CLEARING AND REMOVAL SHALL BE CONSIDERED INCIDENTAL TO CONSTRUCTION.
- 2. THIS WORK SHALL CONFORM TO THE APPLICABLE STANDARDS FROM THE ILLINOIS URBAN MANUAL, THE ILLINOIS DEPARTMENT OF TRANSPORTATION STANDARD SPECIFICATION, CURRENT EDITION, THE PROJECT SPECIFICATIONS, AND THE APPROPRIATE DETAILS.
- 3. THE CONTRACTOR SHALL IMPLEMENT THE EROSION AND SEDIMENT CONTROL MEASURES AS BEFORE CONSTRUCTION BEGINS.
- 4. THE CONTROLS SHALL BE INSTALLED IN ACCORDANCE WITH THE APPLICABLE STANDARDS FROM THE ILLINOIS URBAN MANUAL, THE ILLINOIS DEPARTMENT OF TRANSPORTATION STANDARD SPECIFICATION, CEMENT EDITION, THE PROJECT SPECIFICATION, CURRENT EDITION, THE PROJECT SPECIFICATION, AND THE APPROPRIATE DETAILS AND AS DIRECTED BY THE INSPECTOR.
- 5. SITE ACTIVITIES SHOULD ENSURE THAT EXISTING VEGETATION IS PRESERVED WHERE PRACTICABLE.
- 6. DISTURBED PORTIONS OF THE SITE SHALL BE STABILIZED (TEMPORARILY OR PERMANENTLY SEEDED, MULCHED, SODDED OR PAVED) AS SOON AS PRACTICABLE, BUT IN NO CASE MORE THAN 7 CALENDAR DAYS AFTER THE CONSTRUCTION ACTIVITY IN THAT PORTION OF THE SITE HAS TEMPORARILY OR PERMANENTLY CEASED.
- 7. UNTIL SUCH TIME AS THE PROJECT SITE REACHES FINAL STABILIZATION THE CONTRACTOR SHALL BE RESPONSIBLE TO ADJUST, REPAIR, OR REPLACE, ALL VEGETATION, EROSION CONTROLS, SEDIMENT CONTROLS, AND ANY OTHER PROTECTIVE MEASURES AS REQUIRED IN ORDER TO MAINTAIN THEIR INTENDED FUNCTION IN A GOOD AND EFFECTIVE OPERATING CONDITION.
- 8. EXCEPT FOR FLOWS FROM FIRE FIGHTING ACTIVITIES, SOURCES OF NON—STORM WATER EXPECTED DURING THE CONSTRUCTION PROCESS THAT MAY BE COMBINED WITH STORM WATER DISCHARGES SHALL BE DIRECTED AWAY FROM UNPROTECTED, BARE, OR OTHERWISE UNSTABILIZED SOIL, AND APPROPRIATE POLLUTION PREVENTION MEASURES SHALL BE IMPLEMENTED SO THAT THESE DISCHARGES DO NOT CAUSE EROSION OR DEGRADE THE QUALITY OF RUNOFF FROM THE CONSTRUCTION SITE.
- 9. THE INSPECTOR SHALL HAVE AUTHORIZATION TO DETERMINE THE ADEQUACY OF THE CONTRACTOR'S EROSION CONTROL EFFORTS. THE OWNER OR THE INSPECTOR SHALL HAVE FULL AUTHORITY OVER THE GENERAL CONTRACTOR AND ANY SUBCONTRACTOR TO CAUSE POLLUTANT CONTROL MEASURES TO BE REPAIRED, MODIFIED, MAINTAINED, SUPPLEMENTED, OR WHATEVER ELSE IS NECESSARY IN ORDER TO ACHIEVE EFFECTIVE POLLUTANT CONTROL OR TO SUSPEND OR LIMIT THE CONTRACTORS OPERATIONS PENDING ADEQUATE PERFORMANCE.
- 10. PERIMETER EROSION BARRIER TO BE CONSTRUCTED OF SILT FENCE UNLESS NOTED OTHERWISE.
- 11. A TEMPORARY CONCRETE WASHOUT FACILITY SHALL BE CONSTRUCTED AT A LOCATION APPROVED BY THE ENGINEER. WASHOUT FACILITY SHALL BE UTILIZED FOR ALL APPLICABLE OPERATIONS.
- 12. TEMPORARY EROSION CONTROL MEASURES INCLUDE TEMPORARY DITCH CHECKS, PERIMETER EROSION BARRIER, INLET AND PIPE PROTECTION, TEMPORARY SEEDING, AND ANY OTHER TEMPORARY EROSION CONTROL MEASURE NEEDED TO LIMIT THE AMOUNT OF SOIL EROSION AND SEDIMENTATION DURING CONSTRUCTION.
- 13. AT THE COMPLETION OF THE PROJECT, ALL TEMPORARY EROSION CONTROL ITEMS SHALL BE REMOVED FROM THE SITE, AND BECOME THE PROPERTY OF THE CONTRACTOR. CONTRACTOR MUST STABILIZE ANY AREA DISTURBED BY THE REMOVAL OF EROSION CONTROL ITEMS.
- 14. CONTRACTOR SHALL CLEAN ANY DEBRIS TRACKED OFFSITE DAILY.

#### SEEDING OF DISTURBED AREAS

- 1. THE FINAL TOP 4" INCHES OF SOIL IN ANY DISTURBANCE AREA MUST BE A COHESIVE SOIL CAPABLE OF SUPPORTING VEGETATION.
- 2. FERTILIZER HAVING AN ANALYSIS OF 10-10-10 SHALL BE APPLIED AT A RATE OF 90 LBS/ACRE TO ALL DISTURBED AREAS AND INCORPORATED INTO THE SEEDBED PRIOR TO SOWING THE SEED.
- 3. THE CONTRACTOR SHALL SEED AND MULCH ALL DISTURBED AREAS ADJACENT TO IMPROVEMENTS WITH SEEDING, IDOT CLASS 1A AND MULCH, IDOT METHOD 2 IN ACCORDANCE WITH IDOT STANDARD SPECIFICATION OR AS APPROVED BY THE ENGINEER.
- 4. <u>GUARANTEE</u>: ALL SEEDED AREAS SHALL BE MAINTAINED AND MOWED FOR AT LEAST 30 DAYS AFTER GERMINATION. SCATTERED BARE SPOTS NO LARGER THAN TWO SQUARE FOOT WILL BE ALLOWED UP TO A MAXIMUM OF 5% OF ANY SEEDED AREA INCLUDING 30—DAY MAINTENANCE, MOWING AND WATERING AS NECESSARY.
- 5. THIS WORK SHALL CONFORM TO THE APPLICABLE STANDARDS FROM THE ILLINOIS URBAN MANUAL, THE ILLINOIS DEPARTMENT OF TRANSPORTATION STANDARD SPECIFICATION SECTIONS, CURRENT EDITION, THE PROJECT SPECIFICATIONS, AND THE APPROPRIATE DETAILS.
- 6. RESTORATION THE CONTRACTOR SHALL RESTORE ALL AREAS DISTURBED DURING CONSTRUCTION OF THE IMPROVEMENTS AND RELATED APPURTENANCES OR AS PART OF ANY OF THEIR ACTIVITIES TO A CONDITION EQUAL TO OR BETTER THAN THE ORIGINAL CONDITION.

FEHR GRAHAM

**ENGINEERING & ENVIRONMENTAL** 

ILLINOIS DESIGN FIRM NO. 184-003525

ILLINOIS IOWA

WISCONSIN

CITY OF DIXON 121 WEST 2ND STREET DIXON, IL 61021

OWNER/DEVELOPER:

PROJECT AND LOCATION:

CITY OF DIXON STREETS PROGRAM FY 2020 DIXON, IL DRAWN BY: YJ/JMV
APPROVED BY: NJC
DATE: 10/25/19
SCALE: AS NOTED

REVISIONS

REV. NO. DESCRIPTION DATE

DRAWING:
GENERAL NOTES

SET TYPE: PRELIMINARY

 $G:\C3D\18\18-833A\Plans\18-833\ A\ -\ PLANS.dwg,\ NOTES$ 

18-833A

SHEET NUMBER:

**4** of **35** 

JOB NUMBER:

PLOT DATE: 2/18/20 © 2020 FEHR GRAHAM

#### MATERIAL AND COMPACTION TESTING

1. A GEOTECHNICAL REPRESENTATIVE WILL BE PROVIDED AND PAID FOR BY THE OWNER FOR ANY REQUIRED TESTING. THE CONTRACTOR IS RESPONSIBLE TO FOLLOW AND MEET GUIDELINES SET BY THE GEOTECHNICAL REPRESENTATIVE.

#### **UTILITIES**

- 1. UTILITIES SHOWN ON THE PLANS ARE FOR ILLUSTRATIVE PURPOSES ONLY AND NO GUARANTEE OF THEIR ACCURACY IS MADE OR INFERRED. THE LOCATION OF EXISTING UTILITIES AS SHOWN ON THE DRAWINGS REPRESENT DATA RECEIVED FROM VARIOUS SOURCES. IT IS NOT GUARANTEED TO BE CORRECT OR ALL—INCLUSIVE. THE CONTRACTOR SHALL CONDUCT HIS OWN INVESTIGATION INTO THE LOCATION, SIZE, DEPTH AND NATURE OF ANY AND ALL EXISTING UTILITIES THAT MAY INTERFERE WITH THE WORK UNDER THIS CONTRACT. ANY EXISTING UTILITIES THAT ARE TO REMAIN IN SERVICE SHALL BE FULLY PROTECTED BY THE CONTRACTOR AND ANY DAMAGE CAUSED BY THE CONSTRUCTION OPERATIONS SHALL BE IMMEDIATELY REPAIRED OR REPLACED TO THE SATISFACTION OF THE ENGINEER OR THE OWNER. THE CONTRACTOR SHALL BE RESPONSIBLE FOR CONTACTING ANY AND ALL UTILITY COMPANIES REGARDING ADJUSTMENTS NECESSARY. THIS WORK SHALL BE AT THE CONTRACTOR'S EXPENSE AND CONSIDERED INCIDENTAL TO THE PROJECT COST. THE CONTRACTOR SHALL BE RESPONSIBLE FOR THE PROTECTION OF ALL UNDERGROUND, OVERHEAD, OR SURFACE UTILITIES EVEN THOUGH THEY MAY NOT BE SHOWN ON THE PLANS. ANY UTILITY THAT IS DAMAGED DURING CONSTRUCTION SHALL BE REPAIRED TO THE SATISFACTION OF THE ENGINEER OR THE OWNER OR REPLACED. THIS WORK SHALL BE AT THE CONTRACTOR'S EXPENSE.
- 2. THE CONTRACTOR MUST VERIFY AND LOCATE ALL EXISTING UTILITIES ON OR ADJACENT TO THE SITE. PRIOR TO BEGINNING CONSTRUCTION ACTIVITIES, CONTACT J.U.L.I.E. AT 1-800-892-0123 (OR 811) FOR EXACT FIELD LOCATION OF UTILITIES. DAMAGE, AND THE COST THEREOF, TO ANY AND ALL UTILITIES SHALL BE THE SOLE RESPONSIBILITY OF THE CONTRACTOR. ANY AND ALL EXISTING UTILITIES SHOWN HEREON ARE APPROXIMATE. THE ENGINEER AND SURVEYOR ASSUMES NO RESPONSIBILITY FOR THE LOCATION OF THE EXISTING UTILITIES SHOWN HEREON.
- 3. IF THERE ARE ANY UTILITIES WHICH ARE NOT MEMBERS OF THE J.U.L.I.E. SYSTEM, THE CONTRACTOR SHALL BE SOLELY RESPONSIBLE FOR DETERMINING THIS AND REQUESTING SAID UTILITIES TO FIELD VERIFY AND MARK PERTINENT UTILITY LOCATIONS.
- 4. THE UTILITY LOCATIONS, DEPTHS, ETC. SHOWN ON THESE PLANS ARE APPROXIMATE ONLY, AND SHALL BE VERIFIED BY THE CONTRACTOR WITH ALL AFFECTED UTILITY COMPANIES PRIOR TO INITIATING CONSTRUCTION OPERATIONS; THE ENGINEER AND OWNER ASSUME NO RESPONSIBILITY FOR THE ADEQUACY, SUFFICIENCY OR EXACTNESS OF THESE UTILITY REPRESENTATIONS.
- 5. THE CONTRACTOR SHALL CONTACT THE NECESSARY UTILITY COMPANIES FOR ANY UTILITY RELOCATIONS. THE CONTRACTOR SHALL PAY FOR ALL COSTS ASSOCIATED WITH RELOCATION OF UTILITIES ON OR ADJACENT TO THE SUBJECT PROPERTY OR WITHIN THE ROAD RIGHT-OF-WAY.
- 6. TRENCH BACKFILL SHALL BE FILL MATERIAL TYPE A (GRAVEL OR CA6 CRUSHED STONE.) OR TYPE C (SAND FA-1 OR SAND FA-2) IN ACCORDANCE WITH AASHTO T27 GUIDELINES AND THE ILLINOIS DEPARTMENT OF TRANSPORTATION'S "STANDARD SPECIFICATIONS FOR WATER & SEWER CONSTRUCTION IN ILLINOIS", CURRENT EDITION. COST SHALL BE INCLUDED IN UNIT PRICE OF PIPE.
- 7. TRENCH BACKFILL SHALL BE USED IN LOCATIONS WHERE THERE IS AN EXISTING OR PROPOSED PERMANENT SURFACE.
- 8. ABANDONED UNDERGROUND UTILITIES THAT CONFLICT WITH CONSTRUCTION OR HAVE THE POTENTIAL FOR CREATING FUTURE PROBLEMS SHALL BE DISPOSED OF OUTSIDE THE LIMITS OF THE PROJECT AT AN APPROVED LOCATION OBTAINED BY THE CONTRACTOR, ACCORDING TO THE "STANDARD SPECIFICATIONS FOR WATER & SEWER CONSTRUCTION IN ILLINOIS", CURRENT EDITION, AND AS DIRECTED BY THE ENGINEER. THIS WORK WILL NOT BE PAID FOR SEPARATELY, BUT SHALL BE CONSIDERED INCIDENTAL TO EARTH EXCAVATION AND NO ADDITIONAL COMPENSATION WILL BE ALLOWED.
- 9. COST FOR REPAIRS, REPLACEMENT, AND/OR CONNECTION SHALL BE INCIDENTAL TO THE VARIOUS CONTRACT ITEMS.

#### TRAFFIC CONTROL

- 1. THE CONTRACTOR SHALL PROVIDE, INSTALL AND MAINTAIN ALL TRAFFIC CONTROL ITEMS NECESSARY FOR THE CONSTRUCTION OF ITEMS WITH IN THE ROAD RIGHT—OF—WAY. ALL WORK PERFORMED SHALL HAVE TRAFFIC CONTROL IN ACCORDANCE WITH THE "MANUAL ON UNIFORM TRAFFIC CONTROL DEVICES" AND OF THE ILLINOIS DEPARTMENT OF TRANSPORTATION'S "STANDARD SPECIFICATIONS FOR ROAD AND BRIDGE CONSTRUCTION IN ILLINOIS", CURRENT EDITION.
- 2. ALL TRAFFIC CONTROL DEVICES USED FOR THE MAINTENANCE OF TRAFFIC SHALL BE REFLECTORIZED PRIOR TO INSTALLATION AND CLEANED AS NECESSARY THROUGHOUT THE DURATION OF THE CONTRACT. ALL SIGNS SHALL BE FURNISHED, INSTALLED AND MAINTAINED BY THE CONTRACTOR. PAYMENT SHALL BE CONSIDERED INCIDENTAL TO THE PROJECT.
- 3. TRAFFIC CONDITIONS, ACCIDENTS, AND OTHER UNFORESEEN CONDITIONS MAY REQUIRE THE ENGINEER TO MODIFY THE LOCATION OF THE TRAFFIC CONTROL DEVICES. THE CONTRACTOR SHALL MAKE THE NECESSARY ADJUSTMENTS AS DIRECTED BY THE ENGINEER WITHOUT DELAY. THE CONTRACTOR SHALL RESPOND WITHIN 30 MINUTES FROM THE TIME OF NOTIFICATION BY THE ENGINEER TO ANY REQUEST MADE BY THE ENGINEER FOR CORRECTION, IMPROVEMENT OR MODIFICATION OF THE MAINTENANCE OF TRAFFIC CONTROL DEVICES. DURING CONSTRUCTION OPERATIONS, THE CONTRACTOR SHALL TAKE NECESSARY PRECAUTIONS TO PROTECT ADJACENT TRAFFIC LANES OPEN TO TRAFFIC FROM DEBRIS BEING BLOWN OR OTHERWISE REMOVED FROM THE CONSTRUCTION AREAS. THE CONTRACTOR SHALL ALSO BE RESPONSIBLE FOR KEEPING DEBRIS OFF THE ADJACENT TRAVELED LANE SURFACE. COST INCIDENTAL TO THE PROJECT.
- 4. THE CONTRACTOR SHALL SUBMIT MAINTENANCE OF TRAFFIC AND STAGING OF CONSTRUCTION PLANS FOR APPROVAL BY THE ENGINEER PRIOR TO COMMENCING WORK.
- 5. THE CONTRACTOR SHALL PERFORM THE WORK UNDER STAGE CONSTRUCTION IN THE EVENT THAT THE CONTRACTOR WILL NEED TO CLOSE PUBLIC ROADS, CONTRACTOR SHALL SUBMIT PROPOSED DETOUR ROUTE AND ASSOCIATED SIGNAGE TO THE ENGINEER PRIOR TO COMMENCING WORK.
- 6. TRAFFIC CONTROL DEVICES, STREET NAME SIGNS, AND PAVEMENT MARKINGS SHALL BE INSTALLED IN ACCORDANCE WITH CITY OF DIXON ORDINANCES AND THE "MANUAL ON UNIFORM TRAFFIC CONTROL DEVICES". LOCATIONS OF SIGNS AND MARKINGS SHALL BE SPECIFIED BY THE PLANS, AND/OR AS DIRECTED BY THE ENGINEER.
- 7. PROVIDE TO THE ENGINEER AND THE OWNER THE NAME AND PHONE NUMBER OF INDIVIDUALS RESPONSIBLE FOR MAINTAINING TRAFFIC CONTROL MEASURES DURING CONSTRUCTION. THIS INDIVIDUAL SHALL BE AVAILABLE TO CORRECT TRAFFIC CONTROL PROBLEMS 24 HOURS PER DAY.
- 8. THE CONTRACTOR SHALL NOTIFY THE POST OFFICE, POLICE DEPARTMENT, FIRE DEPARTMENT, 911 DISPATCH CENTER, ILLINOIS DEPARTMENT OF TRANSPORTATION, STATE POLICE, APPROPRIATE SCHOOL DISTRICT AND THE LOCAL AGENCY A MINIMUM OF 5 DAYS PRIOR TO CLOSING ANY PORTION OF THE STREET OR ALLEY.

#### SUBGRADES, SUBBASES, AND BASE COURSES

- 1. THE CONTRACTOR WILL BE REQUIRED TO SUBSTANTIATE BASE COURSE THICKNESSES AND FINISH PAVEMENT THICKNESSES. THE ENGINEER SHALL INSPECT BASE COURSE COREOUT PRIOR TO PLACING BASE COURSE TO ENSURE REQUIRED BASE COURSE DEPTH IS PRESENT. IN ADDITION, THE ENGINEER AND/OR THE CITY ENGINEER SHALL WITNESS THE PLACEMENT OF BITUMINOUS BINDER AND SURFACE COURSE. CORE DRILLING MAY BE REQUIRED TO DEMONSTRATE THAT BASE COURSE AND PAVEMENT THICKNESSES CONFORM TO THE SPECIFICATIONS. PRIOR TO PLACING BASE COURSE MATERIAL, THE CONTRACTOR SHALL TEST ROLL THE SUBGRADE, IN THE PRESENCE OF THE ENGINEER OR HIS AGENT TO DEMONSTRATE THAT SAID SUBGRADE IS READY FOR BASE. PRIOR TO PLACEMENT OF THE BITUMINOUS SURFACE, THE SAME VERIFICATION PROCEDURE SHALL BE PERFORMED ON THE BASE COURSE MATERIAL. THE CONTRACTOR SHALL NOTIFY THE ENGINEER AT LEAST 48 HOURS PRIOR TO PERFORMING ANY OF THE REQUIRED TESTS SO THAT A REPRESENTATIVE MAY BE PRESENT.
- 2. PAVEMENT REMOVAL AND PATCHING ADJACENT TO AND NECESSARY FOR CONSTRUCTION OF COMBINATION CONCRETE AND GUTTER SHALL BE CONSIDERED INCIDENTAL TO THE COMBINATION CONCRETE CURB AND GUTTER, TYPE SPECIFIED.

#### EXCAVATION/EARTHWORK

- 1. THE CONTRACTOR SHALL USE CARE IN GRADING OR EXCAVATION NEAR ANY AND ALL EXISTING ITEMS WHICH ARE NOT INDICATED TO BE REMOVED. ANY DAMAGE DONE TO EXISTING ITEMS BY THE CONTRACTOR'S OPERATIONS SHALL BE REPAIRED AT NO ADDITIONAL EXPENSE TO THE OWNER.
- 2. PRIOR TO STARTING EARTHWORK OR UTILITY TRENCHING, THE CONTRACTOR SHALL STRIP THE SITE OF TOPSOIL TO A DEPTH OF 4" AND TO THE LIMITS APPROVED BY THE ENGINEER. THIS MATERIAL SHALL BE STOCKPILED IN A REMOTE LOCATION OF THE SITE (APPROVED BY THE ENGINEER) UNTIL THE PLAN IMPROVEMENTS ARE COMPLETED AND THE EXCESS MATERIAL SPREAD AS DIRECTED. IT SHALL THEN BE THE RESPONSIBILITY OF THE CONTRACTOR TO SPREAD THIS TOPSOIL MATERIAL IN AREAS OF THE SITE, OVER AREAS WHERE EXCESS EXCAVATED MATERIAL, SAND, GRAVEL HAS BEEN SPREAD OR IN OTHER AREAS AS DESIGNATED BY THE ENGINEER. THE MATERIAL SHALL THEN BE COMPACTED TO A MINIMAL DEPTH OF 4" AND FINE GRADED IN A MANNER ACCEPTABLE TO THE ENGINEER. THIS WORK SHALL BE IN ACCORDANCE WITH THE ILLINOIS DEPARTMENT OF TRANSPORTATION'S "STANDARD SPECIFICATIONS FOR ROAD AND BRIDGE CONSTRUCTION IN ILLINOIS", CURRENT EDITION.
- 3. ROCK IS NOT ANTICIPATED TO BE ENCOUNTERED.
- 4. ALL EXCAVATIONS FOR STRUCTURES AND PIPE SHALL BE KEPT DEWATERED DURING CONSTRUCTION UNTIL BACKFILL IS IN PLACE. DURING DEWATERING OPERATIONS, WATER SHALL BE PUMPED INTO SEDIMENT BASINS OR SILT TRAPS. (COST INCIDENTAL)
- 5. EARTH EXCAVATION SHALL CONFORM TO SECTION 202 OF THE ILLINOIS DEPARTMENT OF TRANSPORTATION'S "STANDARD SPECIFICATIONS FOR ROAD AND BRIDGE CONSTRUCTION IN ILLINOIS", CURRENT EDITION. THIS WORK SHALL INCLUDE THE EXCAVATION OF ALL MATERIALS TO DESIGN SUBGRADE ELEVATIONS INDICATED IN THE PLANS.
- 6. A SOIL REPORT CAN BE PROVIDED IN AN ELECTRONIC FORMAT TO THE CONTRACTOR UPON REQUEST FROM THE OWNER.
- 7. SHEETING AND SHORING SHALL BE CONSIDERED INCIDENTAL TO CONTRACT IF REQUIRED.
- 8. WHENEVER THE CONTRACTOR WORKS NEAR EXISTING FACILITIES WITHIN THE LIMITS OF THE IMPROVEMENTS DURING TRENCHING OPERATIONS, HE WILL BE REQUIRED TO HAND TRENCH IN THAT AREA IN ORDER NOT TO DAMAGE THESE FACILITIES. PUSH HOLES AND SEARCH HOLES THAT ARE DUG BY THE CONTRACTOR SHALL BE BACKFILLED BY TAMPING THE EXCAVATED MATERIAL BACK IN PLACE TO KEEP SETTLEMENT TO A MINIMUM. NO ADDITIONAL COMPENSATION WILL BE ALLOWED.
- 9. EMBANKMENT WORK SHALL CONSIST OF THE CONSTRUCTION OF EMBANKMENTS BY DEPOSITING, PLACING AND COMPACTING EARTH, STONE, GRAVEL OR OTHER MATERIALS OF ACCEPTABLE QUALITY ABOVE THE NATURAL GROUND OR OTHER SURFACE IN ACCORDANCE WITH THE ILLINOIS DEPARTMENT OF TRANSPORTATION'S "STANDARD SPECIFICATIONS FOR ROAD AND BRIDGE CONSTRUCTION IN ILLINOIS", CURRENT EDITION.
- 10. IF SUFFICIENT TOPSOIL IS NOT PRESENT, THE CONTRACTOR SHALL SPREAD FURNISHED TOPSOIL SO AS TO MEET THE REQUIREMENTS OF THE CONTRACT. FURNISHED TOPSOIL SHALL ONLY BE USED WITH APPROVAL BY THE ENGINEER. THIS FURNISHED TOPSOIL SHALL BE PAID FOR AS FURNISHED TOPSOIL IN PLACE, 4".
- 11. IN PROPOSED FILL AREAS FOR PAVEMENT AND EMBANKMENT, TOPSOIL AND TURF SHALL BE SCARIFIED AND REMOVED PRIOR TO CONSTRUCTING THE EMBANKMENT.

FEHR GRAHAM

**ENGINEERING & ENVIRONMENTAL** 

ILLINOIS DESIGN FIRM NO. 184-003525

ILLINOIS IOWA

**WISCONSIN** 

OWNER/DEVELOPER:

CITY OF DIXON

121 WEST 2ND STREET

DIXON, IL 61021

PROJECT AND LOCATION:

CITY OF DIXON STREETS PROGRAM FY 2020 DIXON, IL DRAWN BY: YJ/JMV
APPROVED BY: NJC
DATE: 10/25/19
SCALE: AS NOTED

REVISIONS

REV. NO. DESCRIPTION DATE

DRAWING:
GENERAL NOTES

SET TYPE: PRELIMINARY


 $C:\C3D\18\18-833A\Plans\18-833$  A - PLANS.dwg, NOTES (2

JOB NUMBER:

18-833A

SHEET NUMBER:

5 of 35

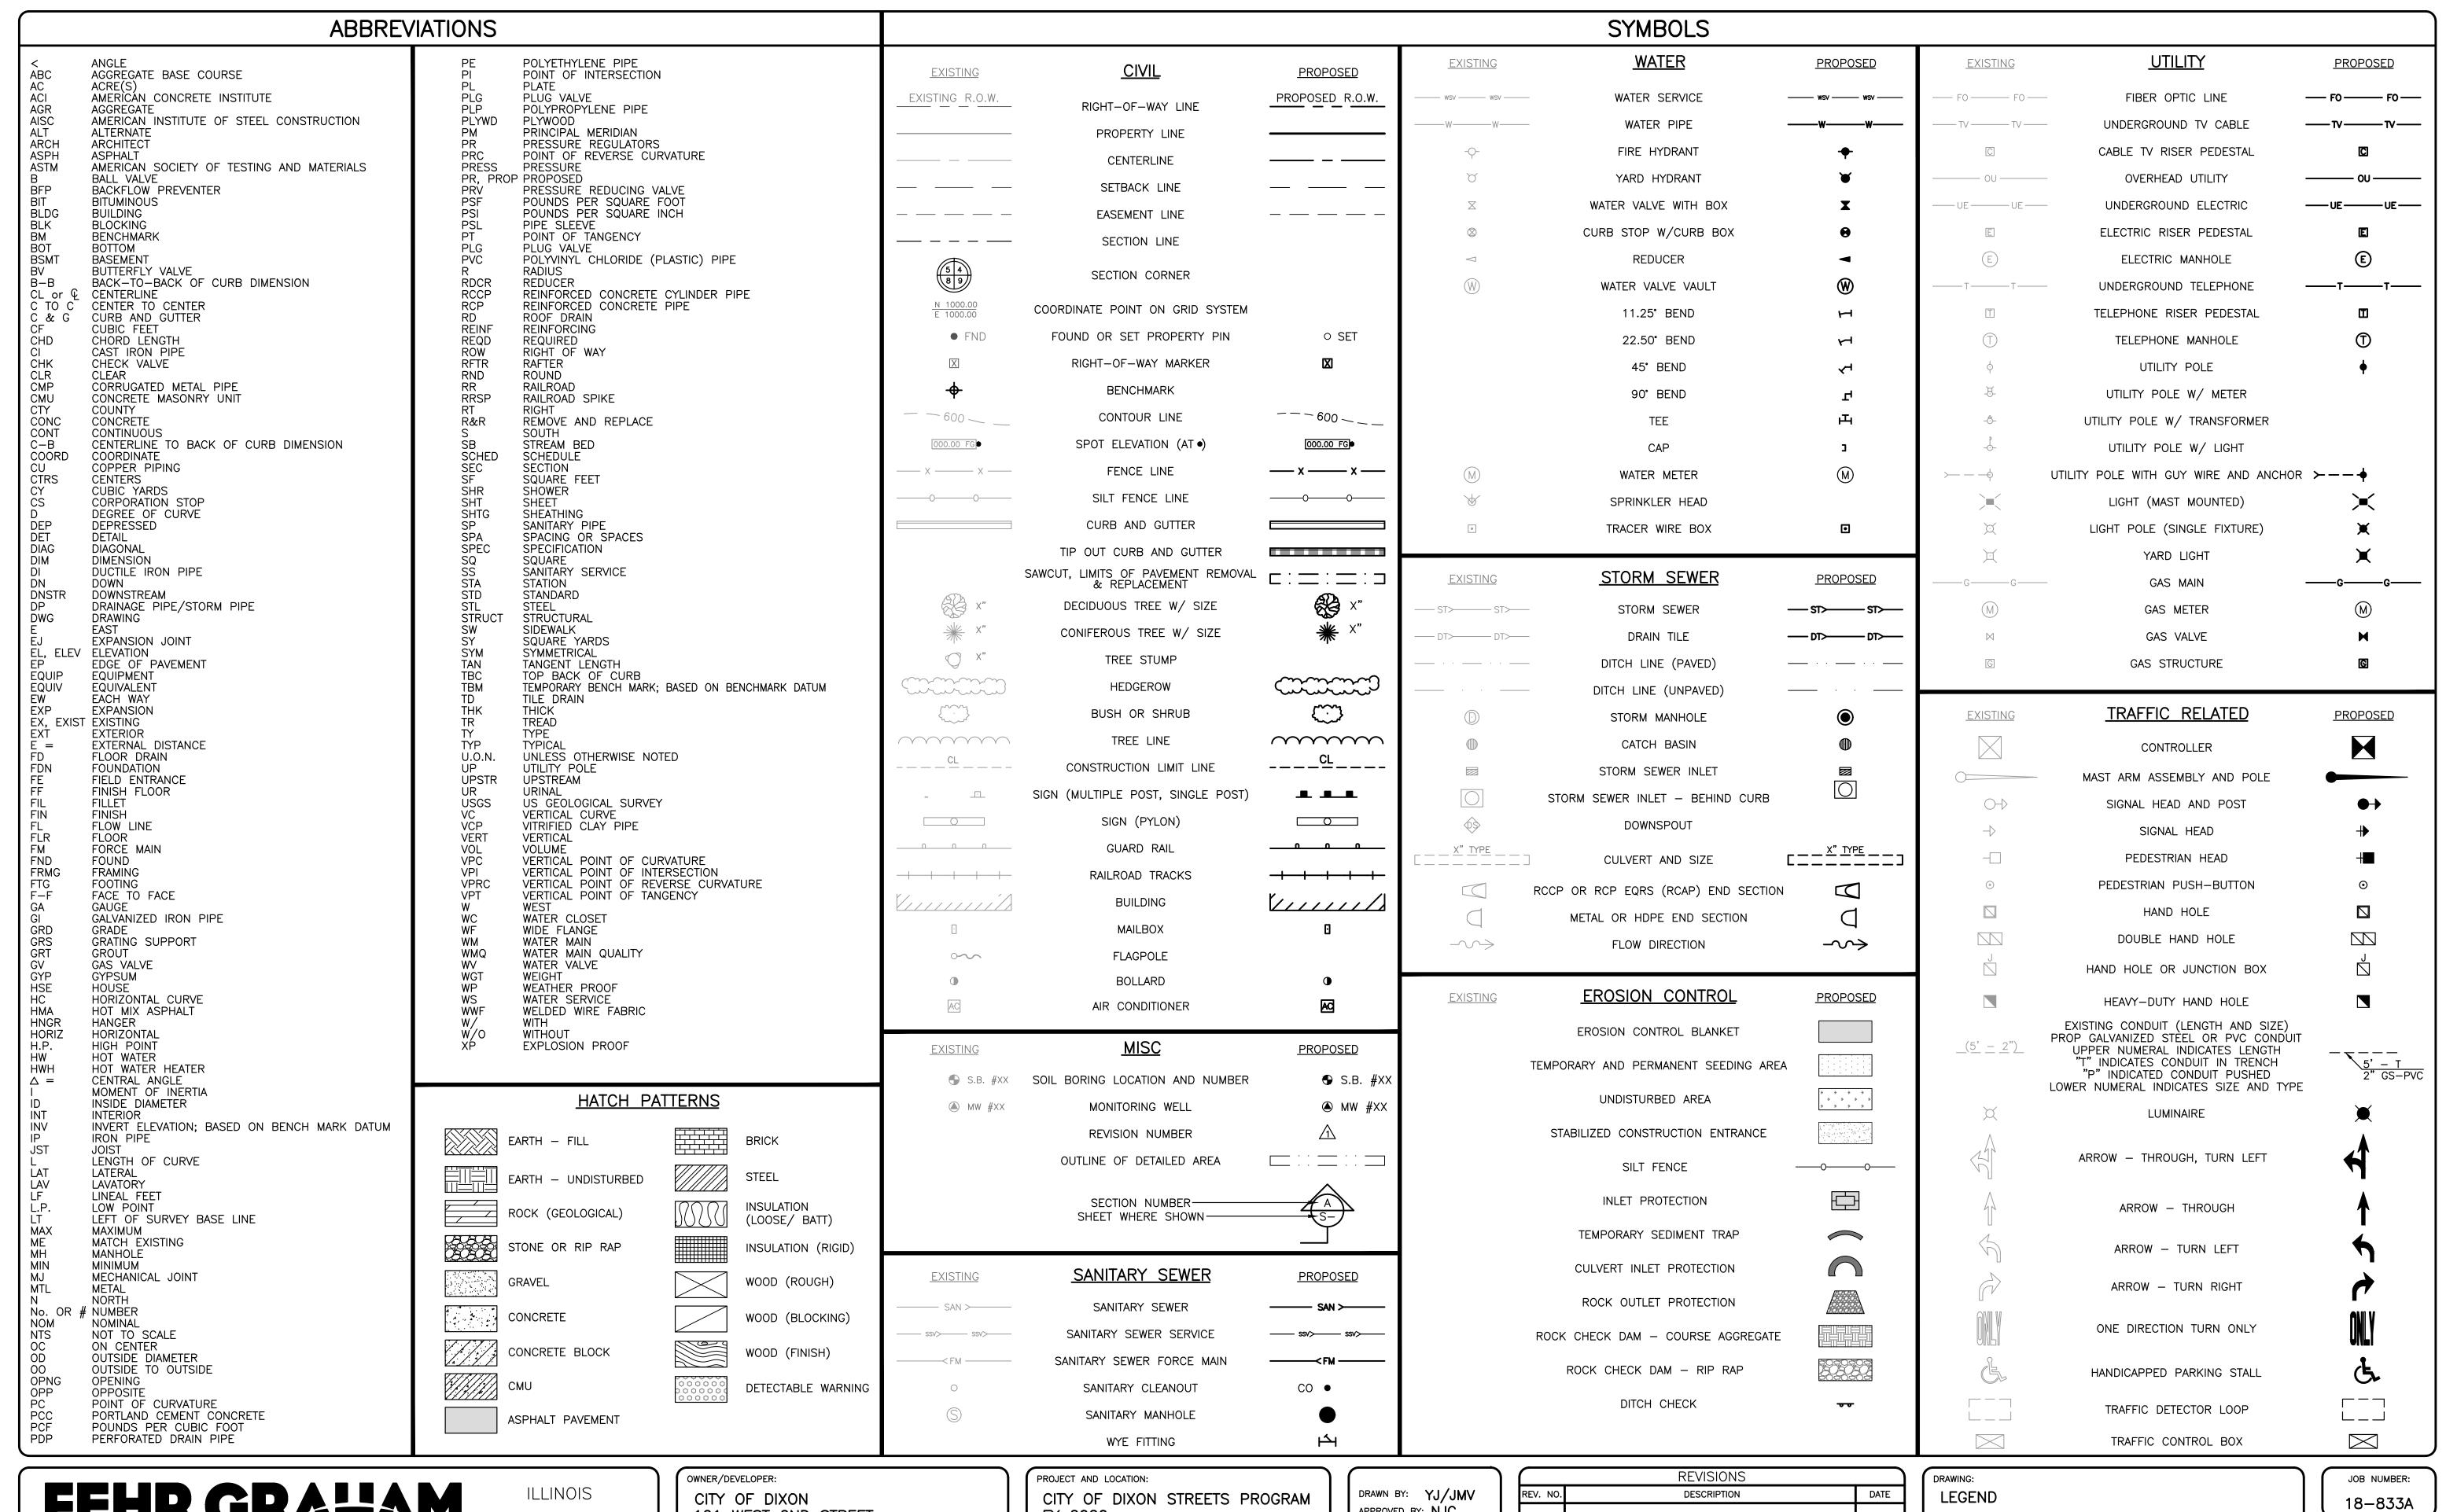

**ENGINEERING & ENVIRONMENTAL** 

ILLINOIS DESIGN FIRM NO. 184-003525

IOWA

WISCONSIN

121 WEST 2ND STREET DIXON, IL 61021

FY 2020 DIXON, IL

APPROVED BY: NJC DATE: 10/25/19 SCALE: AS NOTED

REVISIONS						
REV. NO.	DESCRIPTION	DATE				


SET TYPE: PRELIMINARY :\C3D\18\18-833A\Plans\18-833 A - PLANS.dwg, LEGEND

SHEET NUMBER: 6 of 35

THE FOLLOWING HM REQUIREMENTS ARE AP THIS PROJE	PLICABLE FOR
LOCATION:	4TH AVENUE
MIXTURE USE(S):	SURFACE
PG:	PG 58-28
DESIGN AIR VOIDS:	3.0 % @ N50
MIXTURE COMPOSITION: (MIXTURE GRADATION)	IL 9.5
FRICTION AGGREGATE:	С
MIXTURE WEIGHT:	112 LB/SY/IN
QUALITY MANAGEMENT PROGRAM:	QC/QA
SUBLOT SIZE:	_
NUMBER OF ROLLER PASSES:	_

#### FIELD CORE REPORT


CORE NO.	PAVEMENT THICKNESS (INCHES)	BASE THICKNESS (INCHES)	STATION
CN3	12" ASPHALT	24" STONE	44+00
CN4	12" ASPHALT	12" STONE	55+83
CN5	12.5" ASPHALT	12" STONE	67+83
CN6	2" ASPHALT, 10.75" CONCRETE	8" STONE	81+62

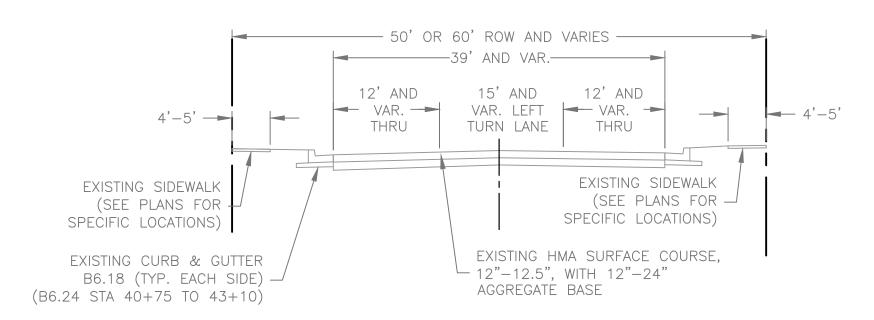

EXISTING TYPICAL SECTION 4TH AVENUE

STA 40+75 - 43+80


NOT TO SCALE

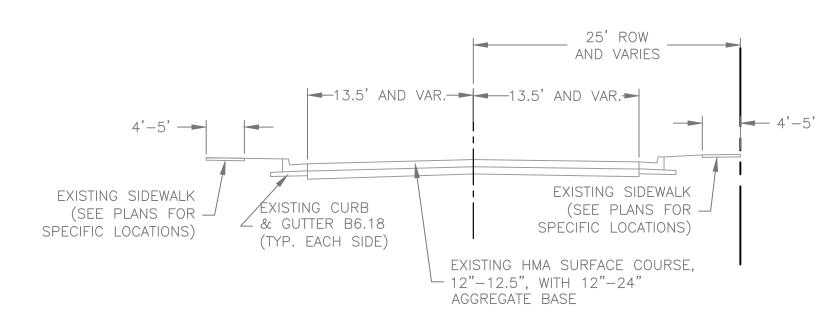

EXISTING TYPICAL SECTION 4TH AVENUE

STA 43+80 - 79+61


NOT TO SCALE

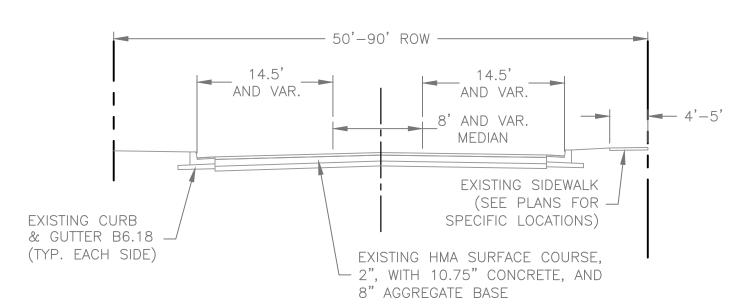

EXISTING TYPICAL SECTION 4TH AVENUE

STA 79+61 - 84+39


NOT TO SCALE

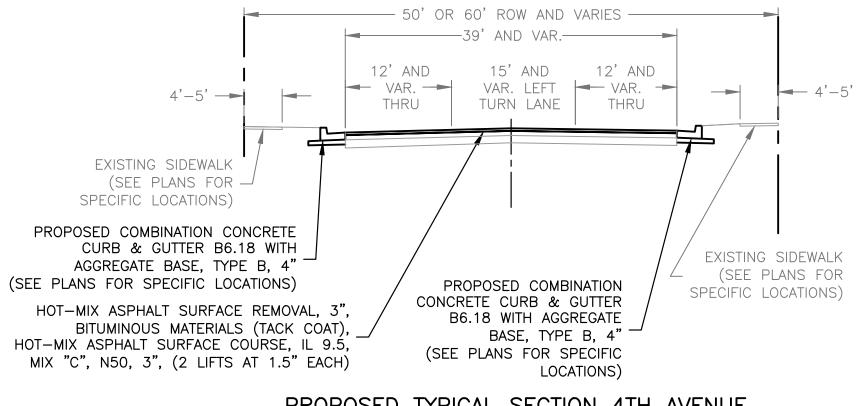

PROPOSED TYPICAL SECTION 4TH AVENUE

STA 40+75 - 43+80


NOT TO SCALE

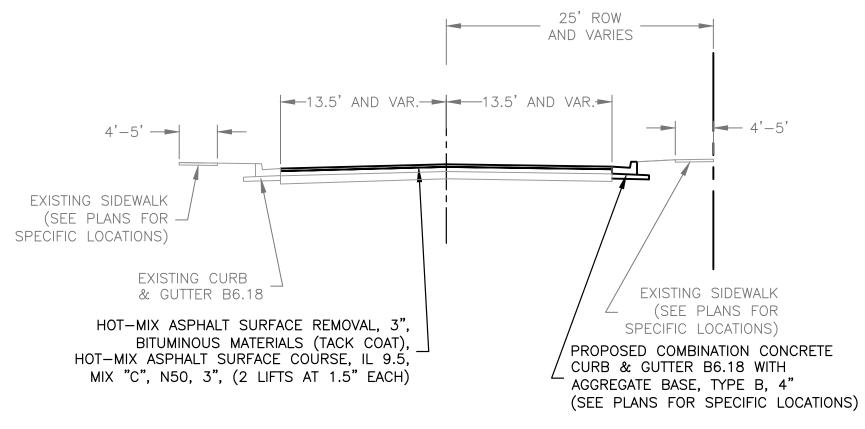

PROPOSED TYPICAL SECTION 4TH AVENUE

STA 43+80 - 79+61

NOT TO SCALE

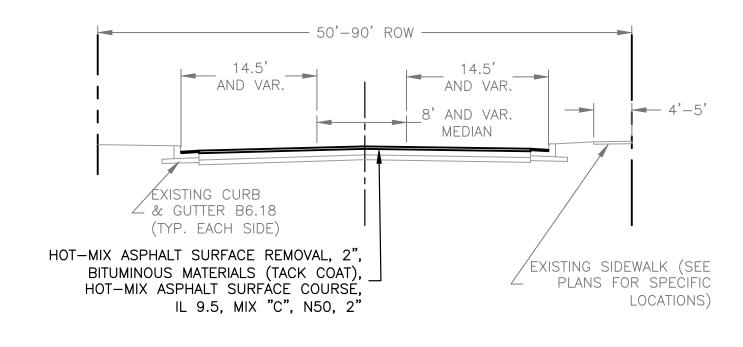

PROPOSED TYPICAL SECTION 4TH AVENUE

STA 79+61 - 84+39

NOT TO SCALE



**ENGINEERING & ENVIRONMENTAL** 

ILLINOIS DESIGN FIRM NO. 184-003525

ILLINOIS IOWA

WISCONSIN

OWNER/DEVELOPER:

CITY OF DIXON

121 WEST 2ND STREET

DIXON, IL 61021

PROJECT AND LOCATION:

CITY OF DIXON STREETS PROGRAM
FY 2020
DIXON, IL

DRAWN BY: YJ/JMV
APPROVED BY: NJC
DATE: 10/25/19
SCALE: AS NOTED

REVISIONS

REV. NO. DESCRIPTION DATE

DRAWING:
TYPICAL SECTIONS

SET TYPE: PRELIMINARY
G:\C3D\18\18-833A\Plans\18-833 A - PLANS.dwg, TYP


JOB NUMBER:


18-833A


SHEET NUMBER:


7 of 35

PLOT DATE: 2/18/20 © 2020 FEHR GRAHAM

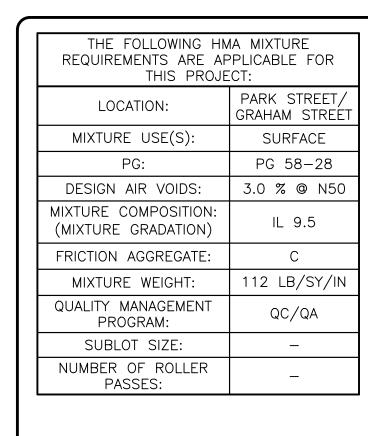

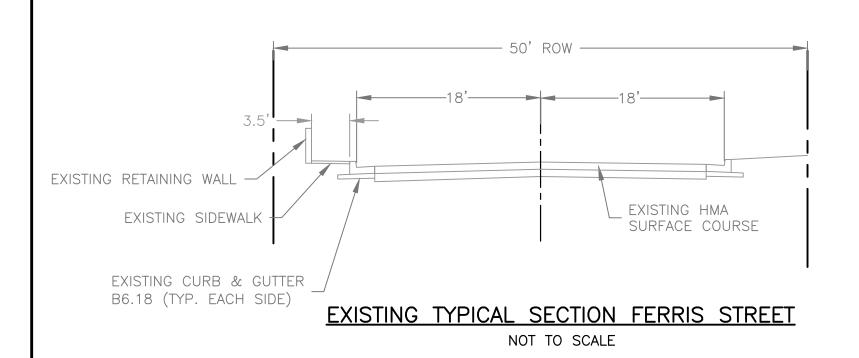

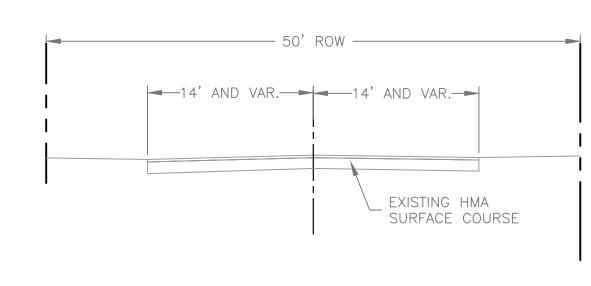

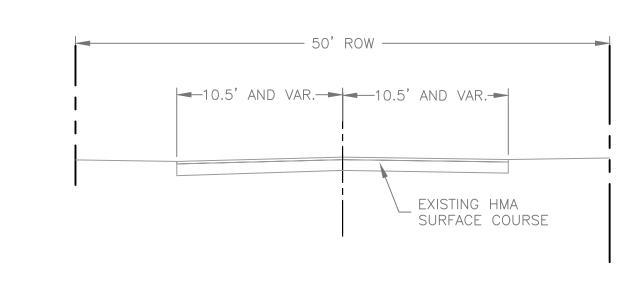

EXISTING TYPICAL SECTION PARK STREET


STA 100+50 -102+56


NOT TO SCALE


EXISTING TYPICAL SECTION GRAHAM STREET

STA 200+25 -202+36

NOT TO SCALE

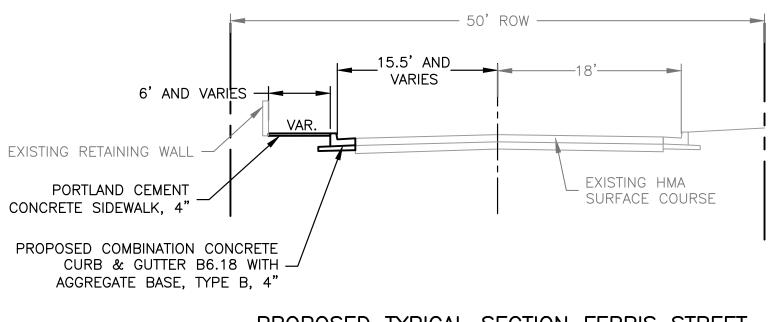

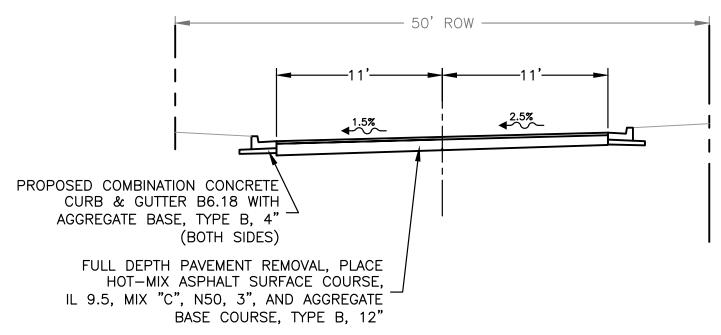

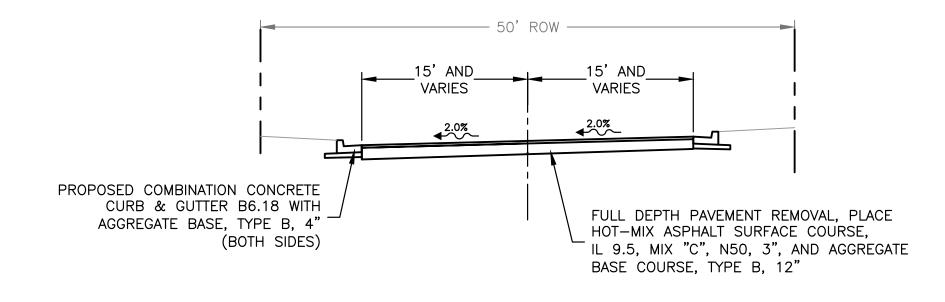

PROPOSED TYPICAL SECTION FERRIS STREET

NOT TO SCALE

PROPOSED TYPICAL SECTION PARK STREET


STA 100+50 - 100+86


NOT TO SCALE

PROPOSED TYPICAL SECTION GRAHAM STREET

STA 200+25 - 200+50

STA 201+30 - 202+14

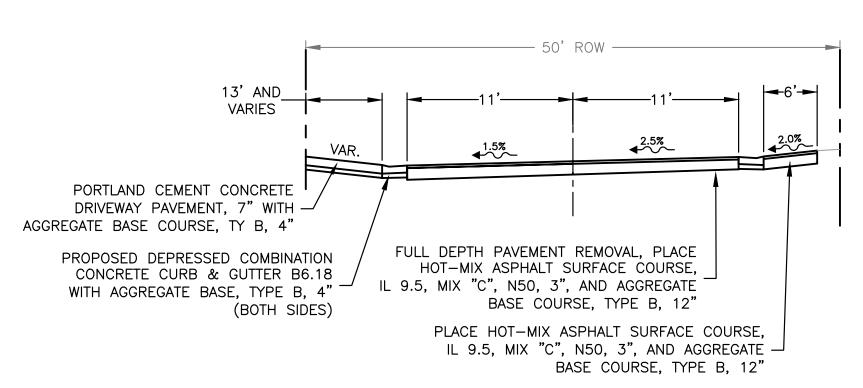

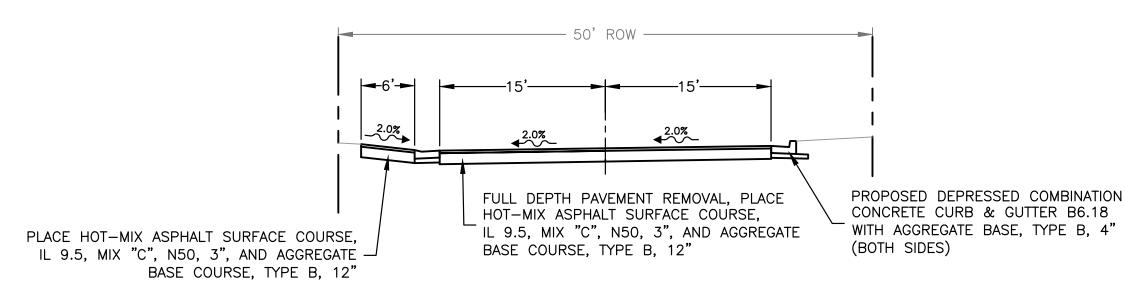

PROPOSED TYPICAL SECTION PARK STREET


STA 100+86 - 101+80


NOT TO SCALE

PROPOSED TYPICAL SECTION GRAHAM STREET

STA 200+50 - 200+92

NOT TO SCALE

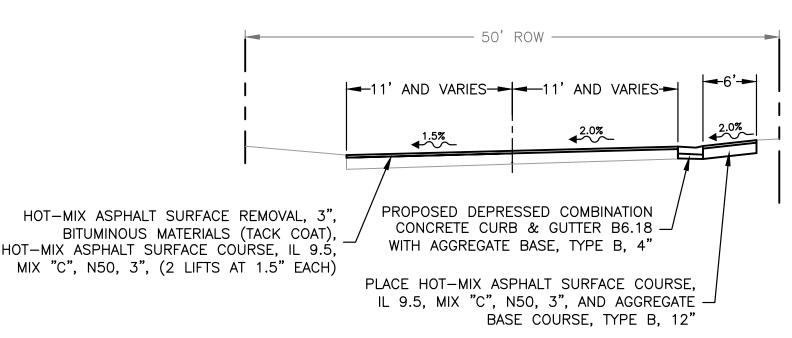

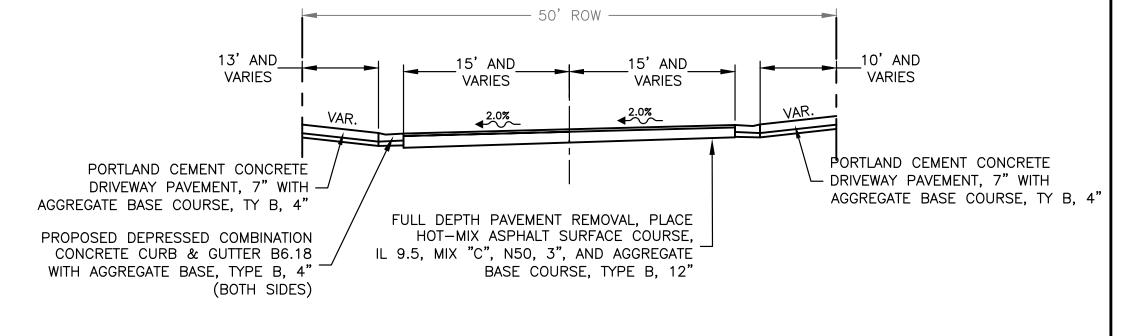

PROPOSED TYPICAL SECTION PARK STREET

STA 101+80 - 102+56

NOT TO SCALE

PROPOSED TYPICAL SECTION GRAHAM STREET

STA 200+92 - 201+30

STA 202+14 - 202+36

NOT TO SCALE

**ENGINEERING & ENVIRONMENTAL** 

ILLINOIS IOWA

WISCONSIN

OWNER/DEVELOPER:

CITY OF DIXON

121 WEST 2ND STREET

DIXON, IL 61021

PROJECT AND LOCATION:

CITY OF DIXON STREETS PROGRAM
FY 2020
DIXON, IL

DRAWN BY: YJ/JMV
APPROVED BY: NJC
DATE: 10/25/19
SCALE: AS NOTED

	REVISIONS		(
REV. NO.	DESCRIPTION	DATE	١
			١
			ſ
			l

DRAWING:
TYPICAL SECTIONS

SET TYPE: PRELIMINARY
G:\C3D\18\18-833A\Plans\18-833 A - PLANS.dwg, TYP (2)


JOB NUMBER:


18-833A

SHEET NUMBER:

8 of 35

PLOT DATE: 2/18/20 © 2020 FEHR GRAHAM

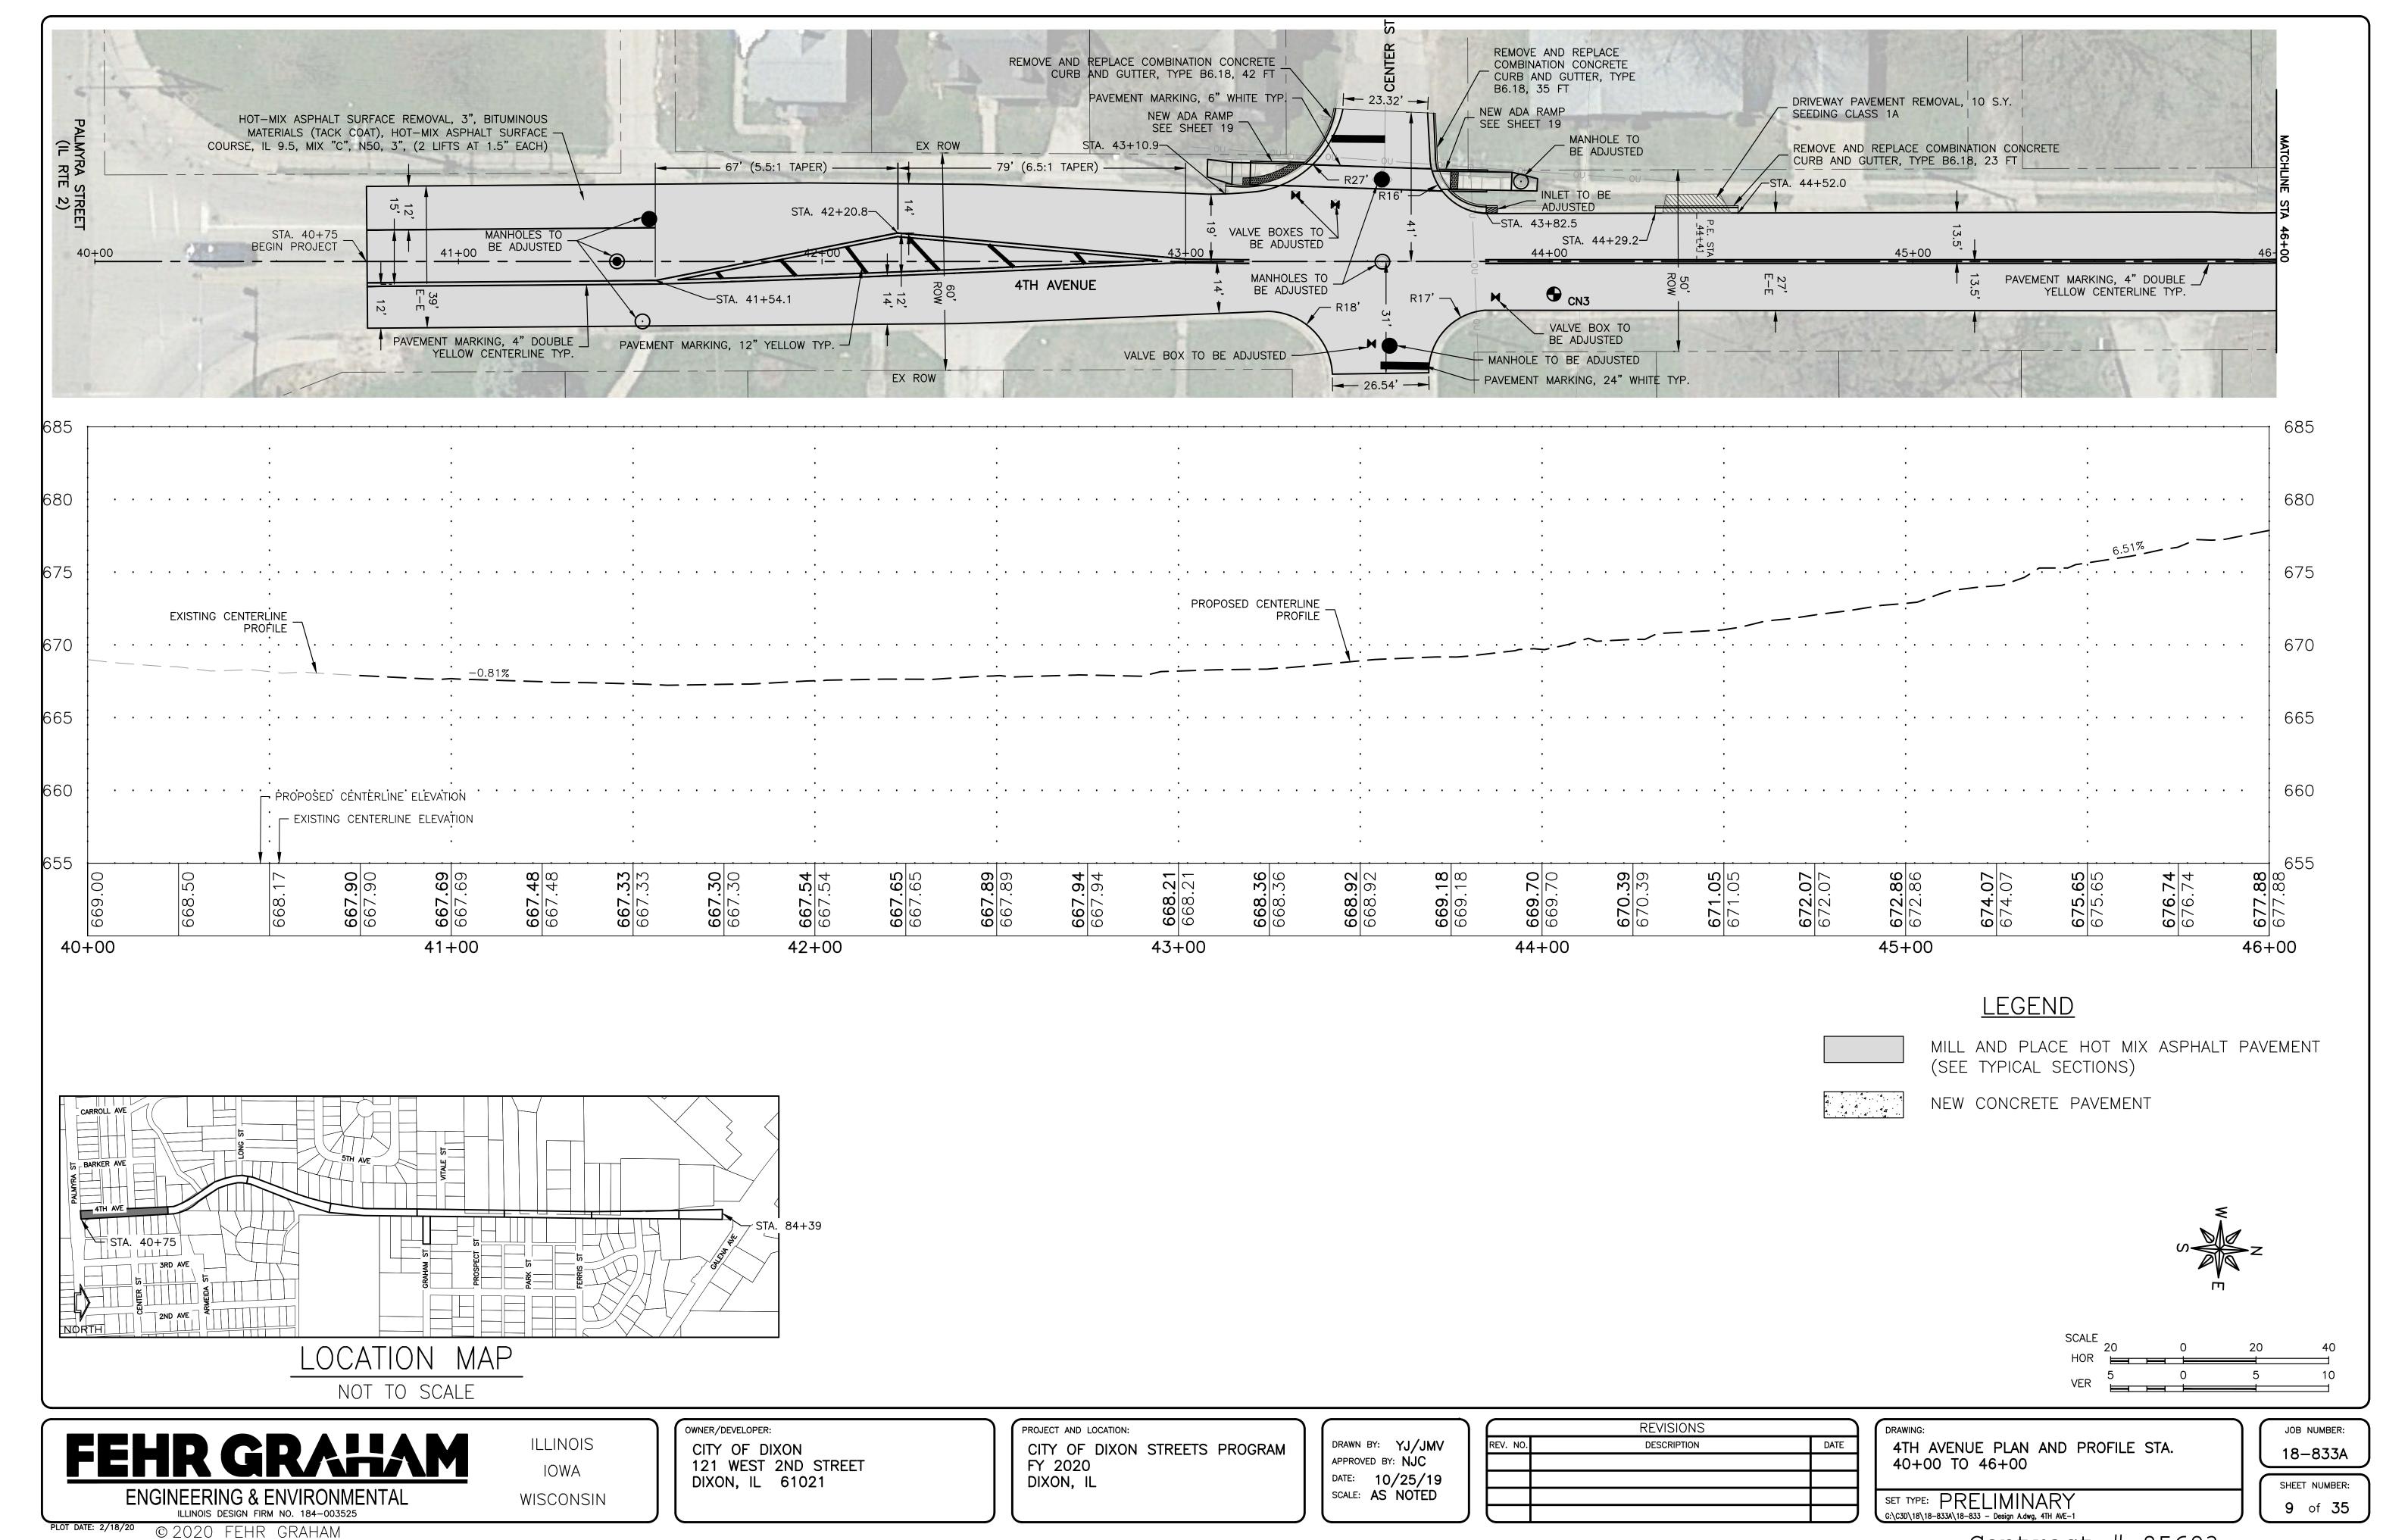


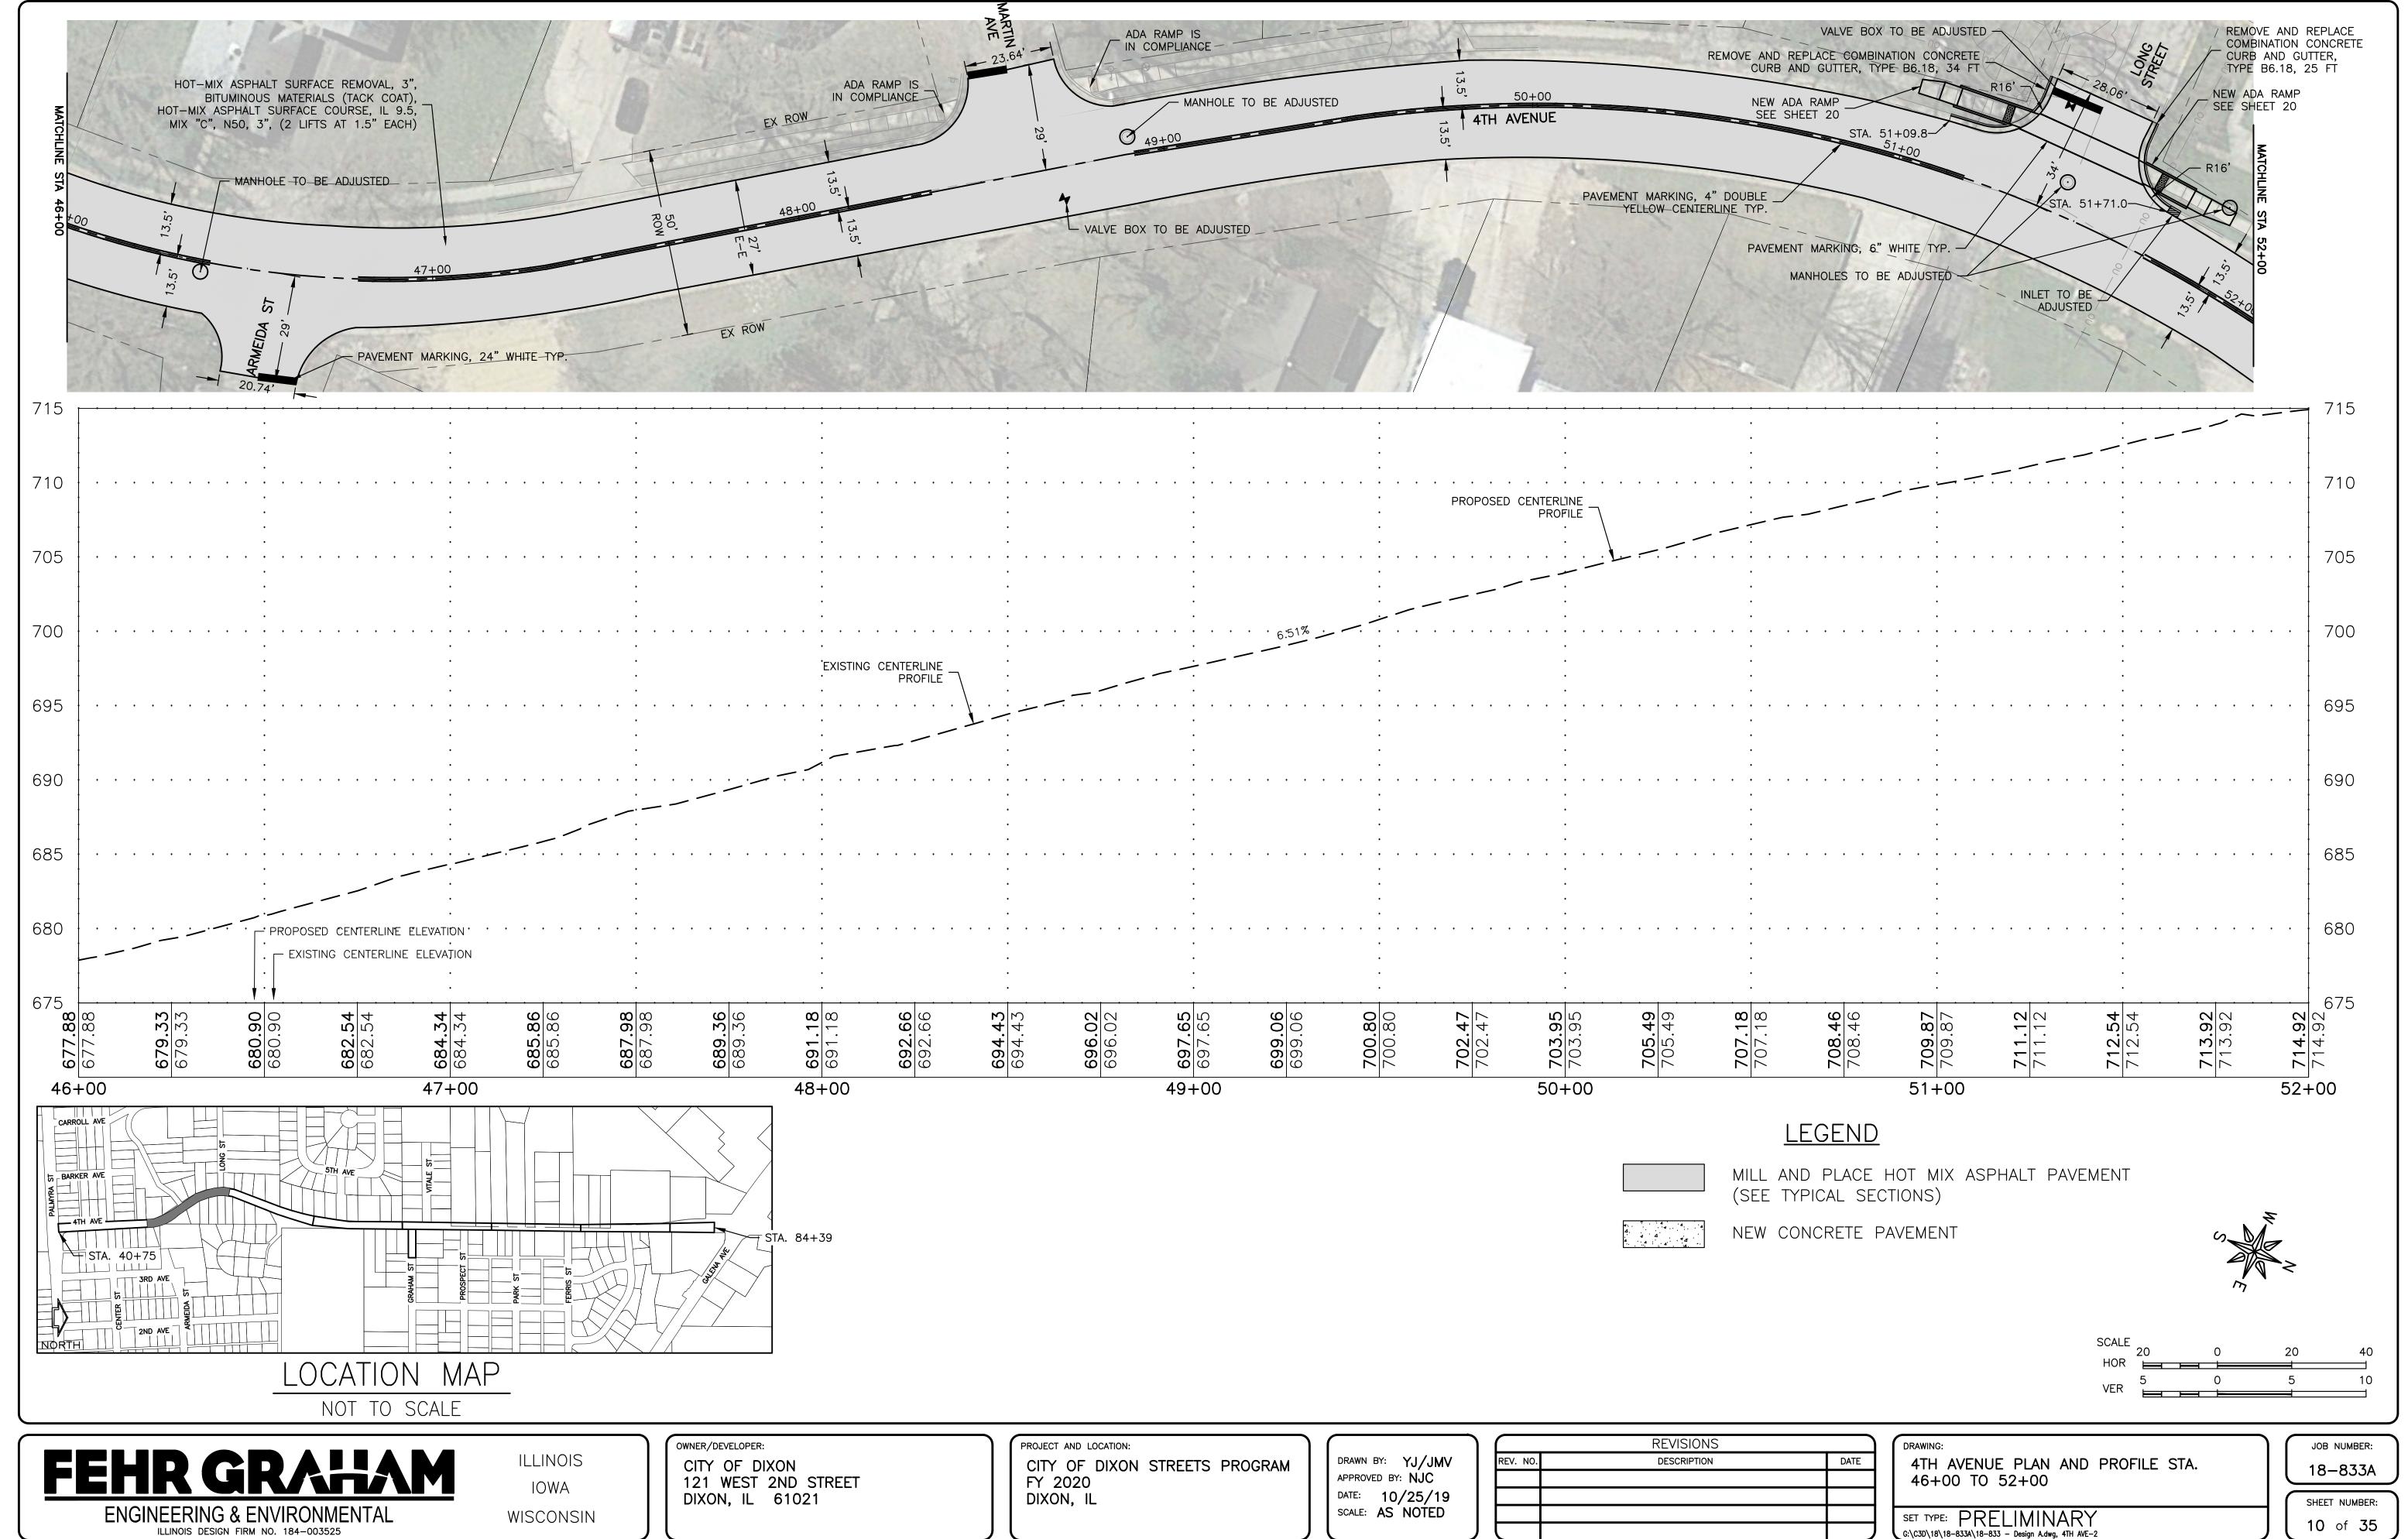



PLOT DATE: 2/18/20 © 2020 FEHR GRAHAM


REVISIONS						
REV. NO.	DESCRIPTION	DATE				


SET TYPE: PRELIMINARY
G:\C3D\18\18-833A\18-833 - Design Adwg, 4TH AVE-2

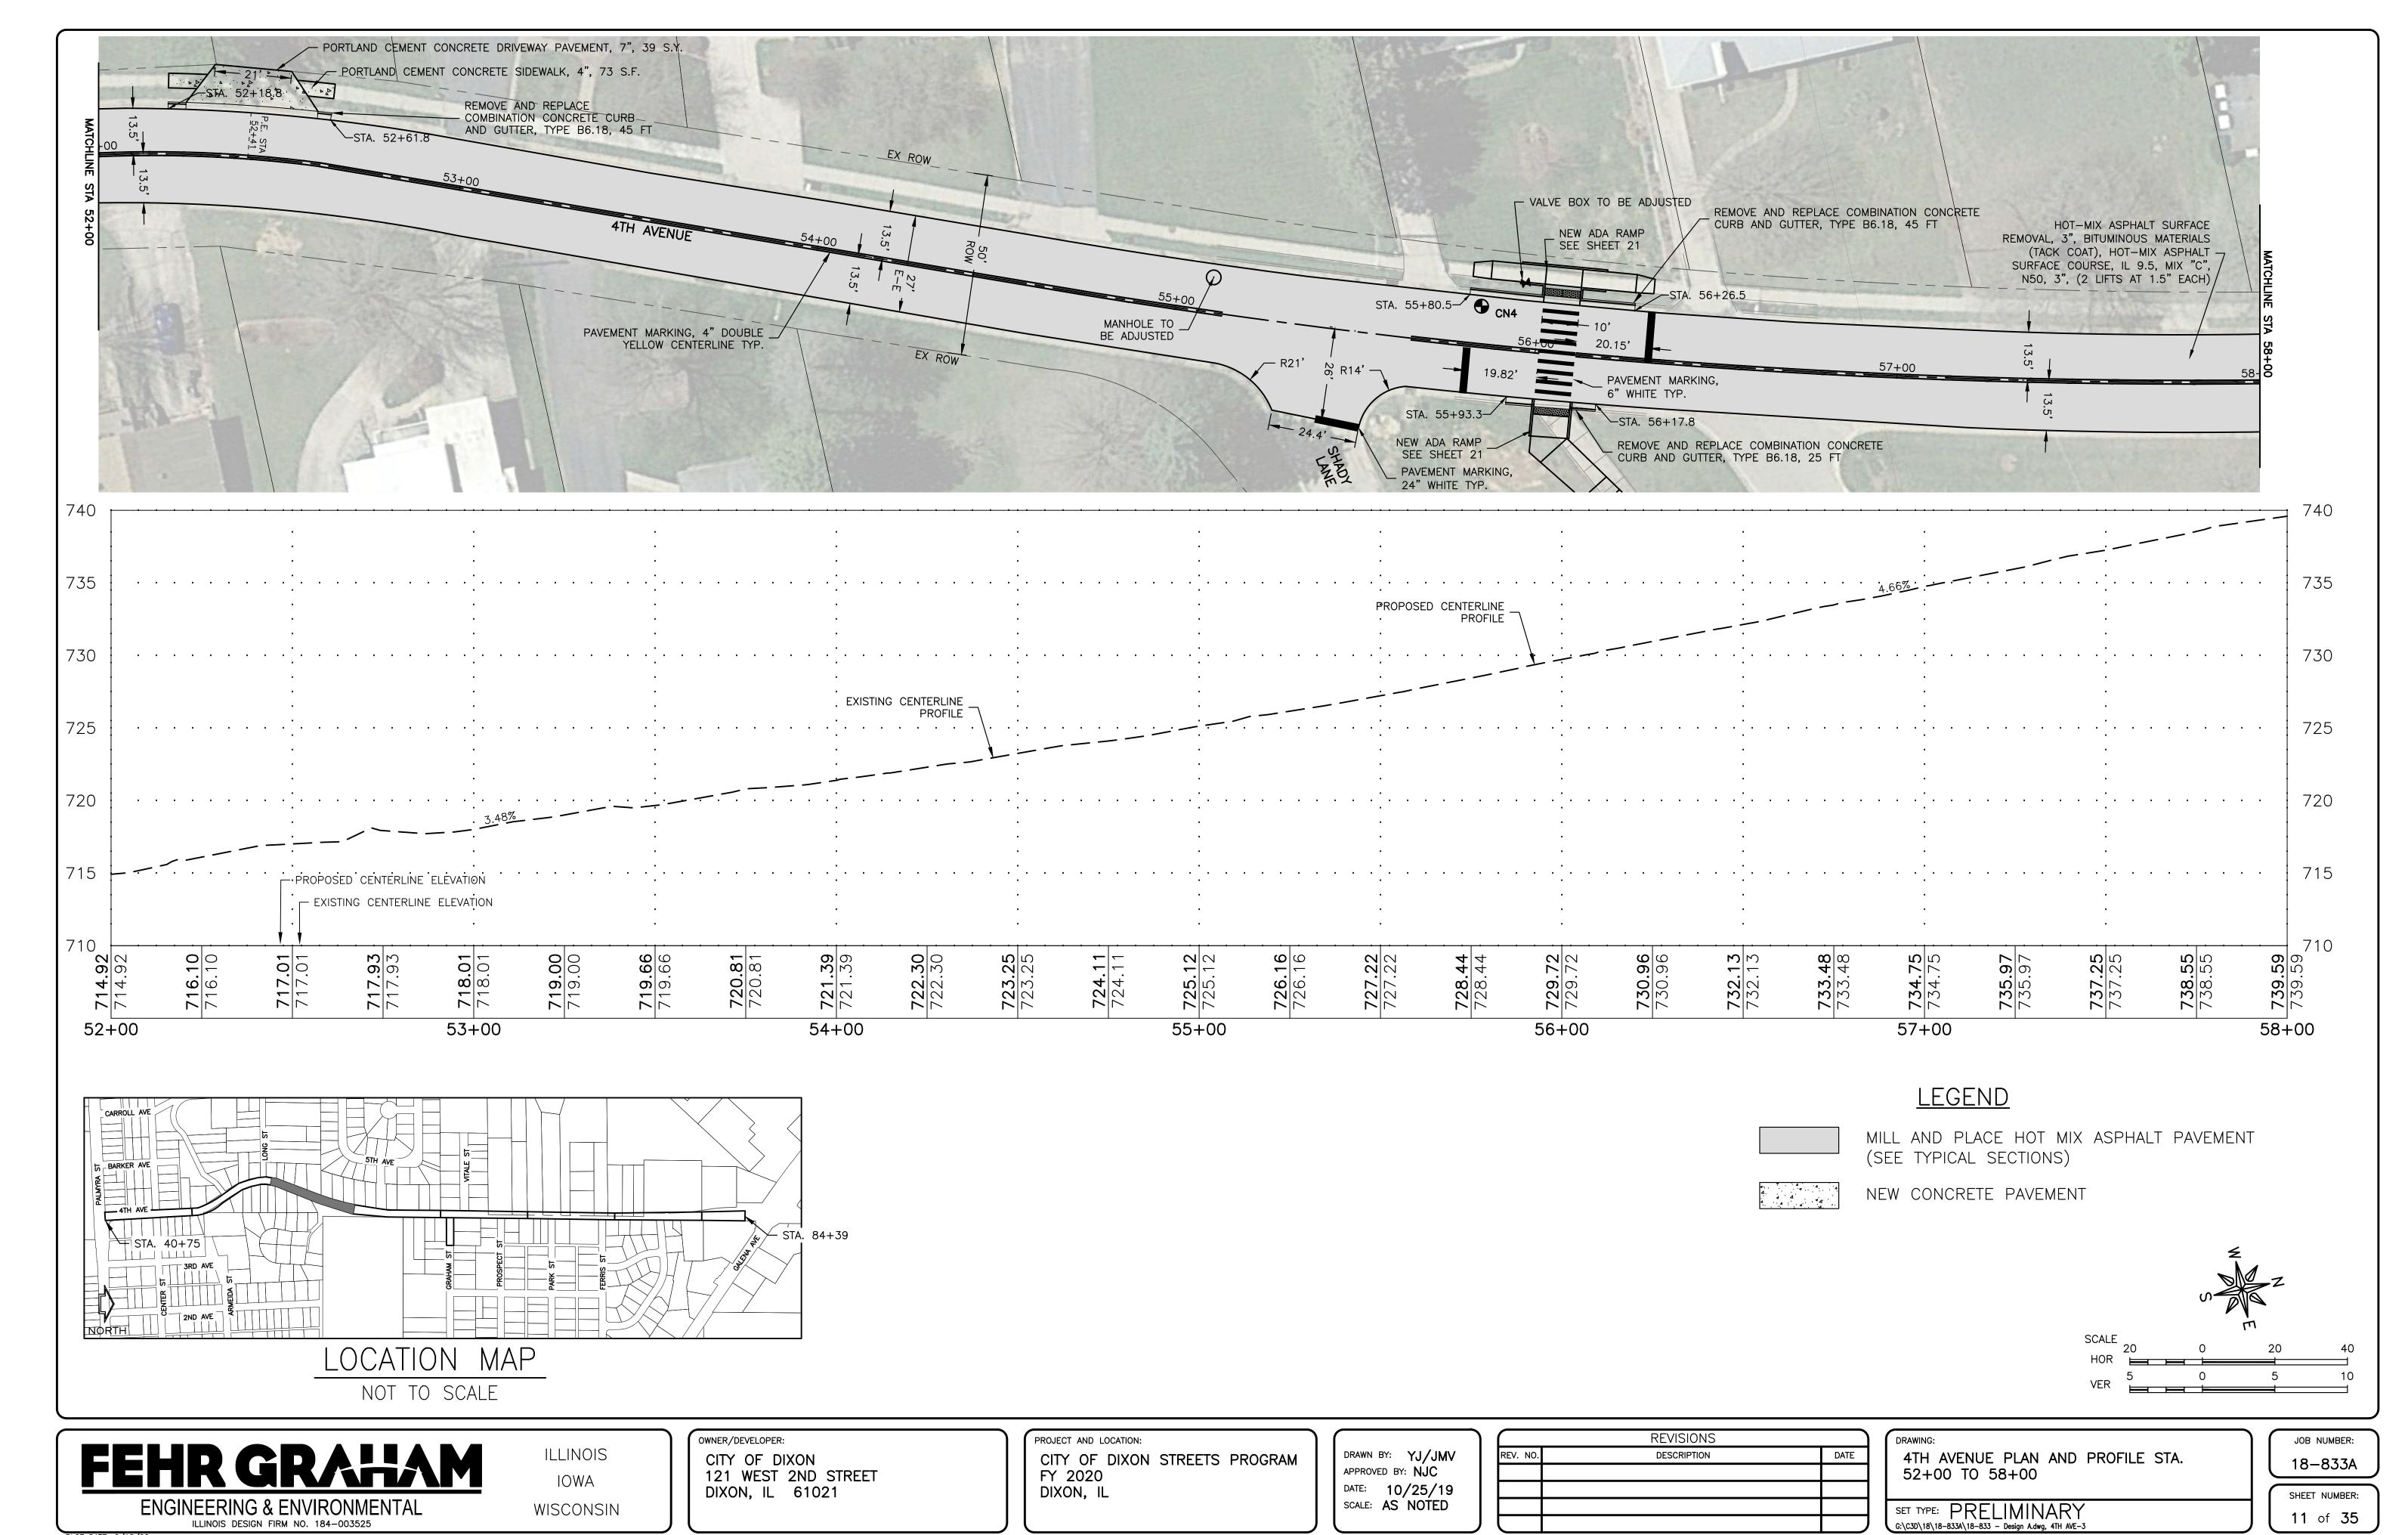


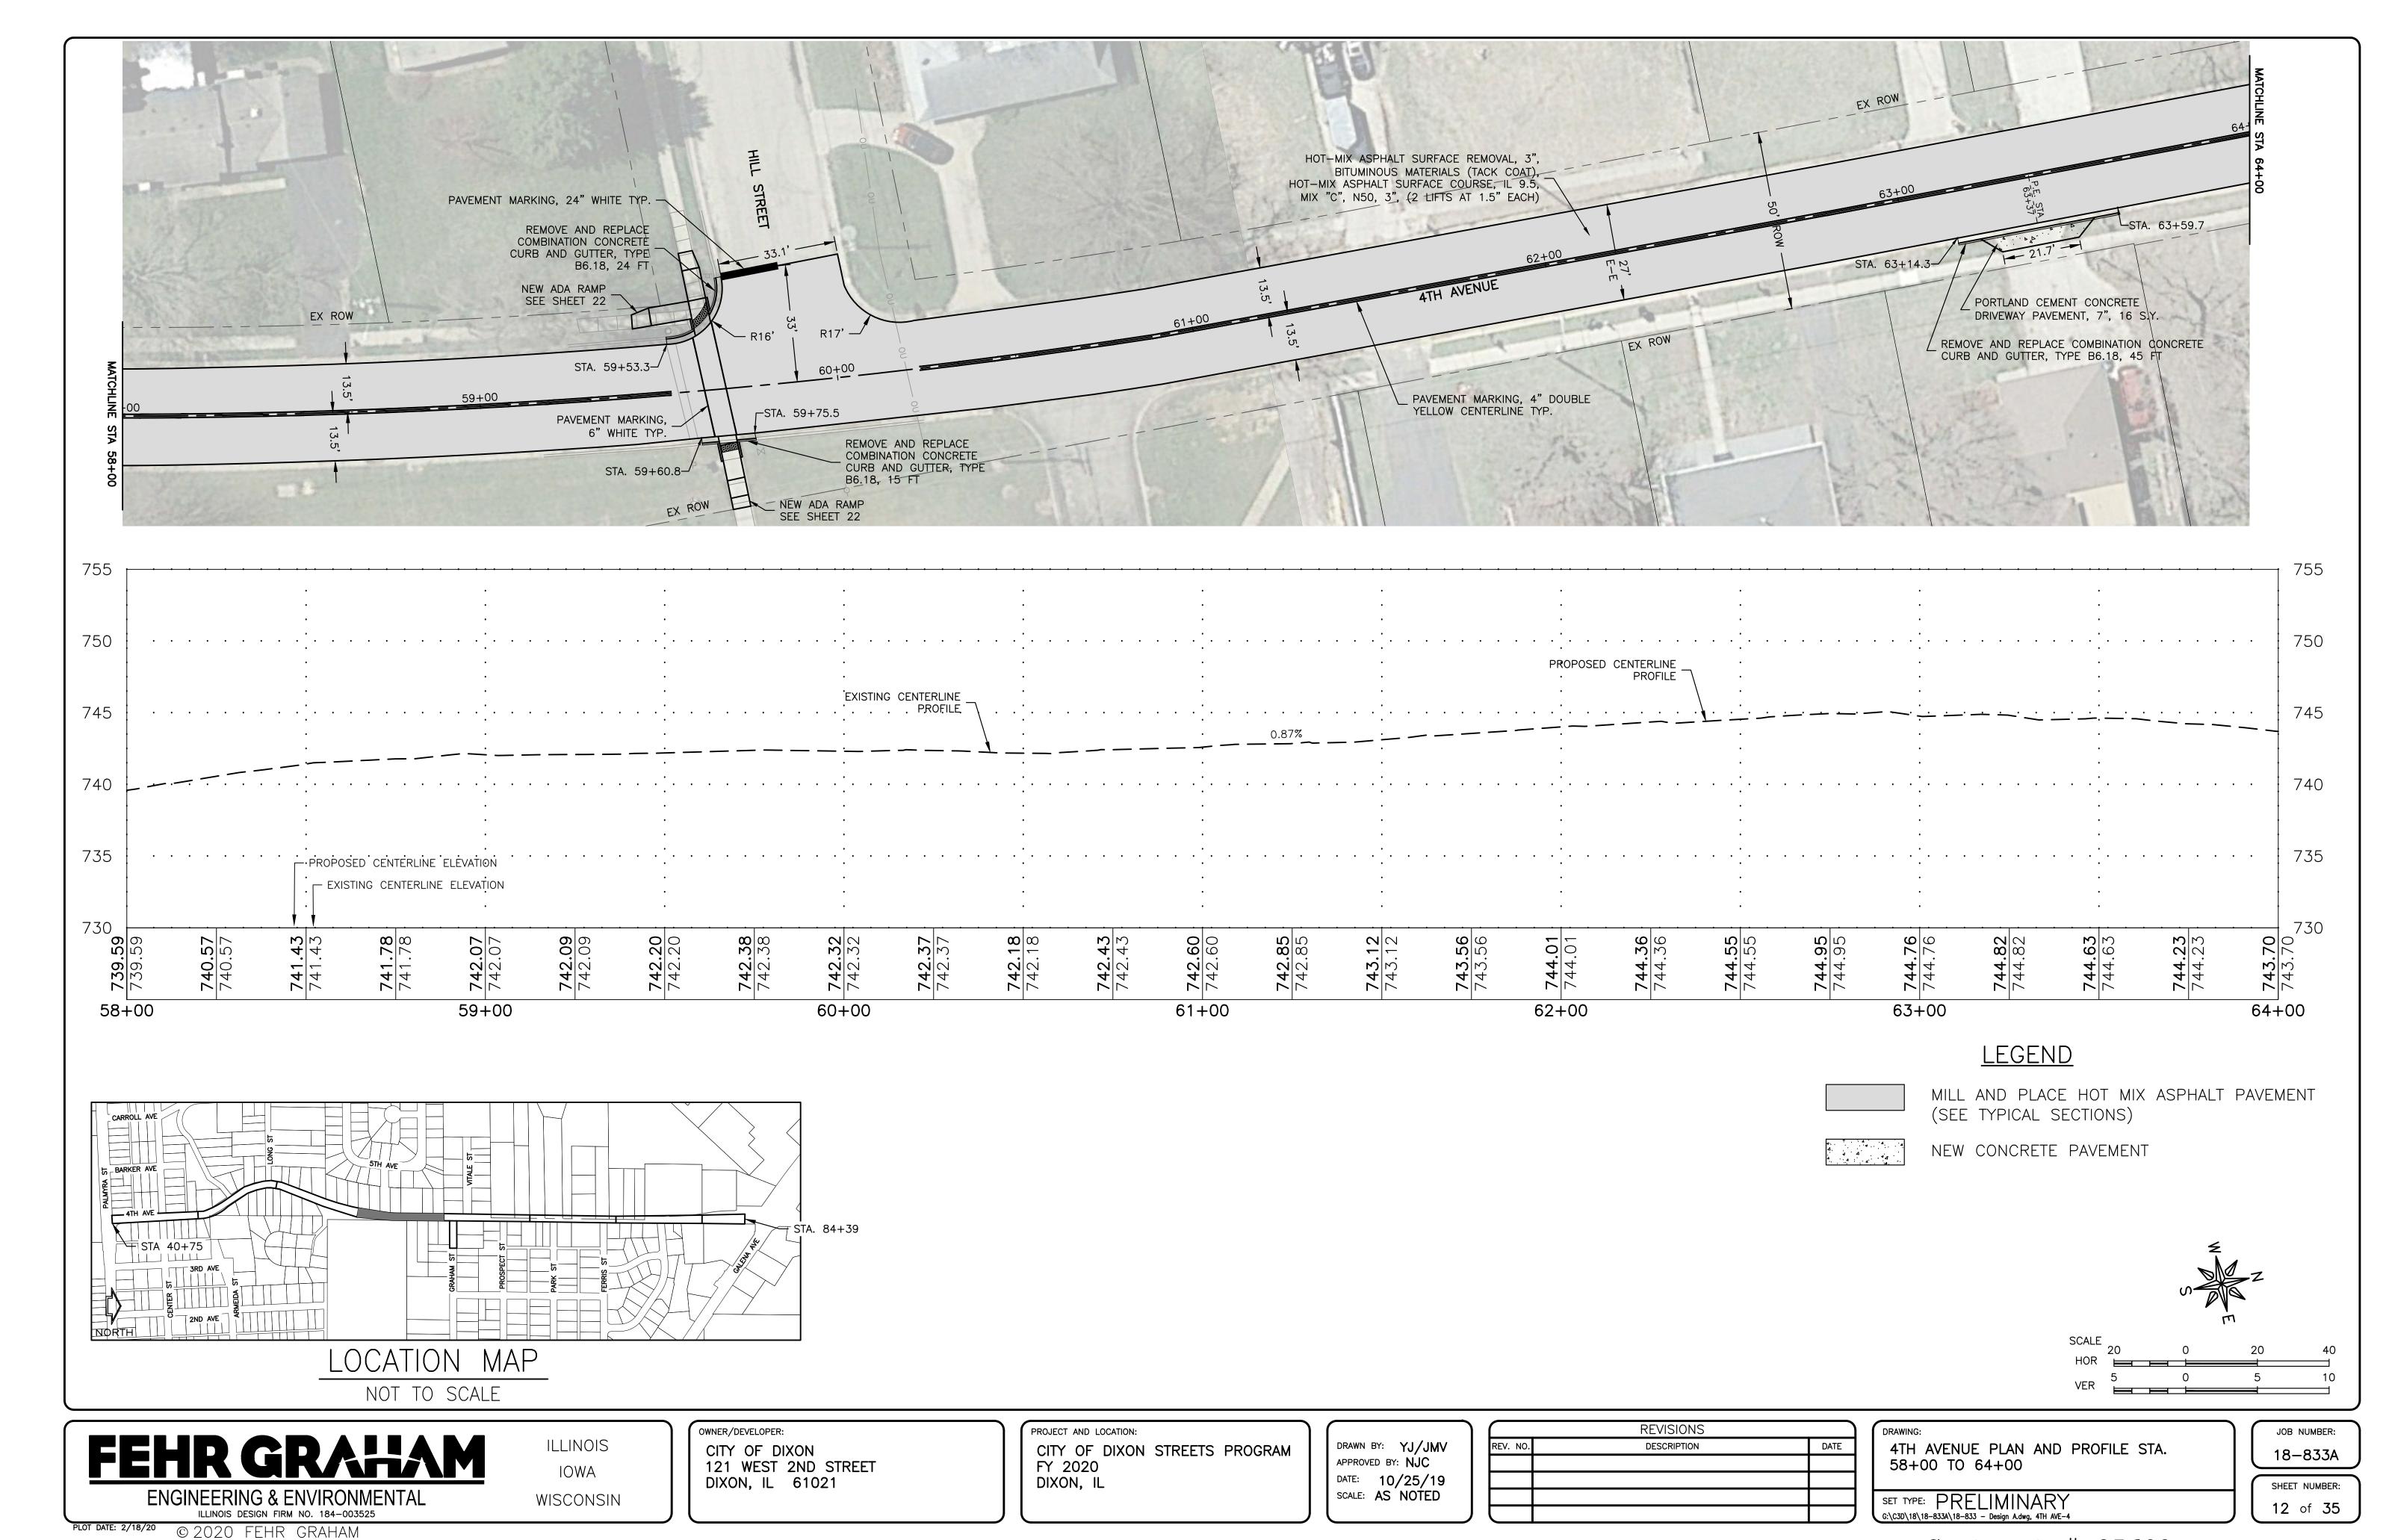


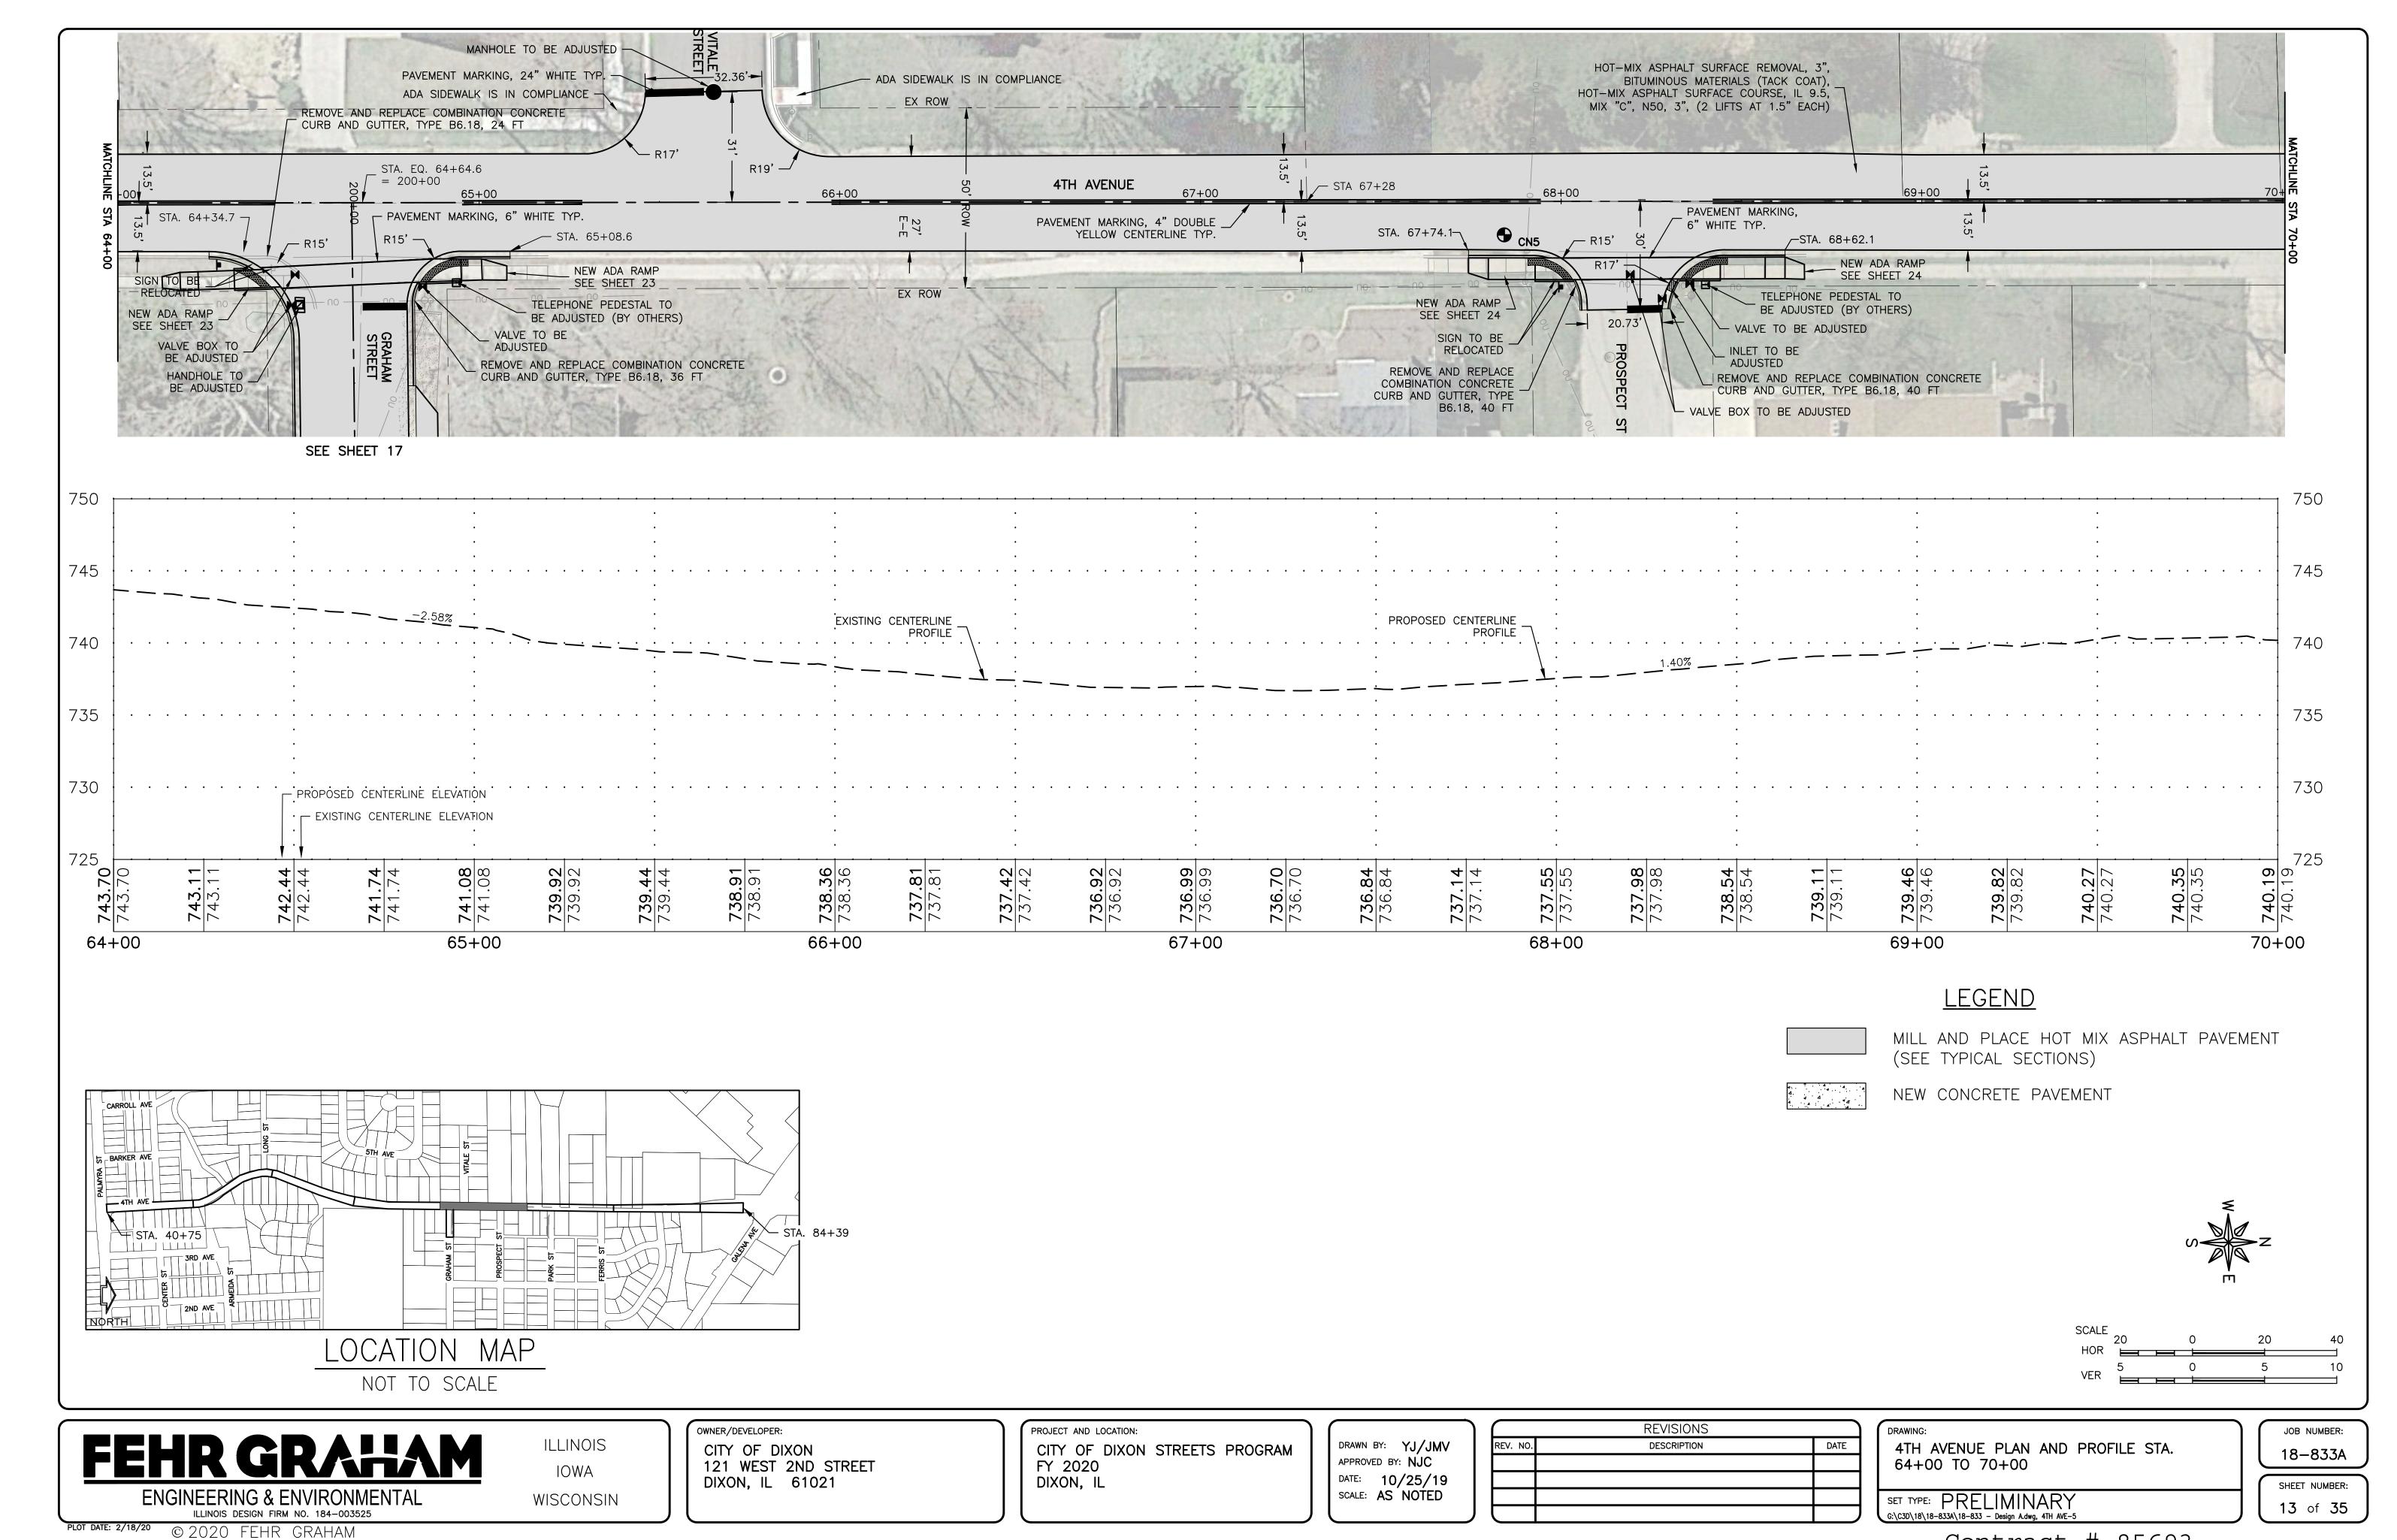


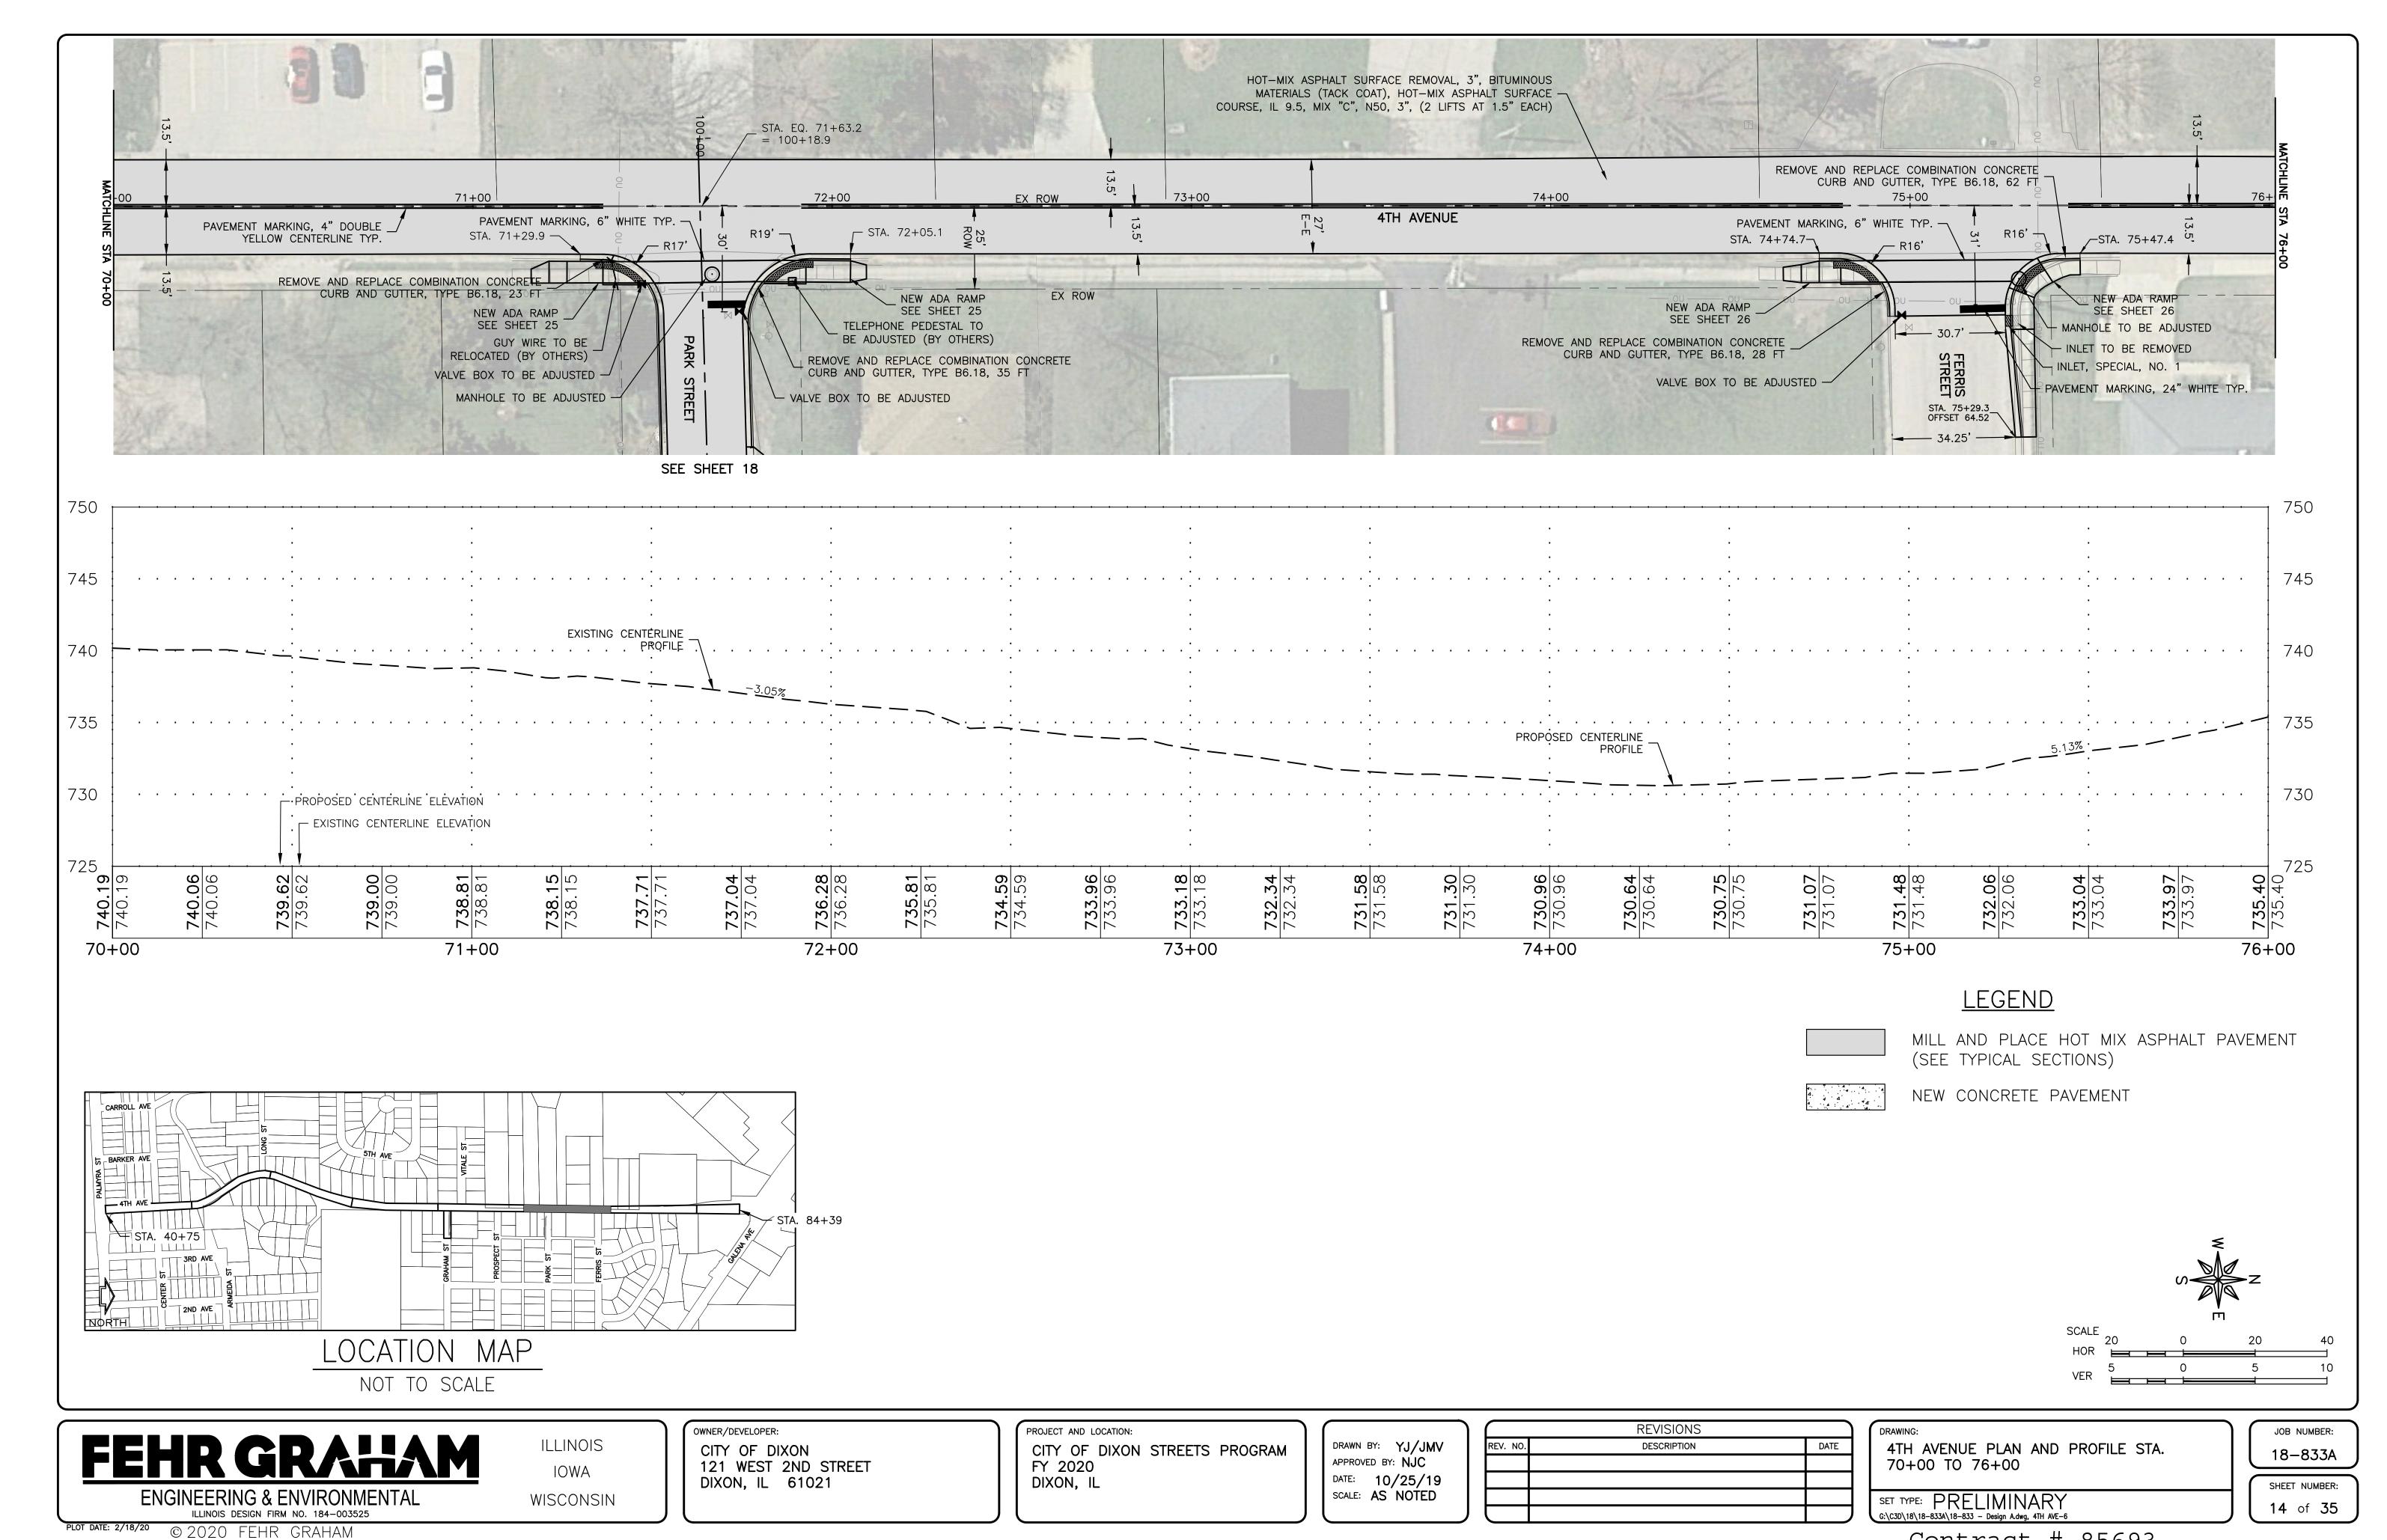

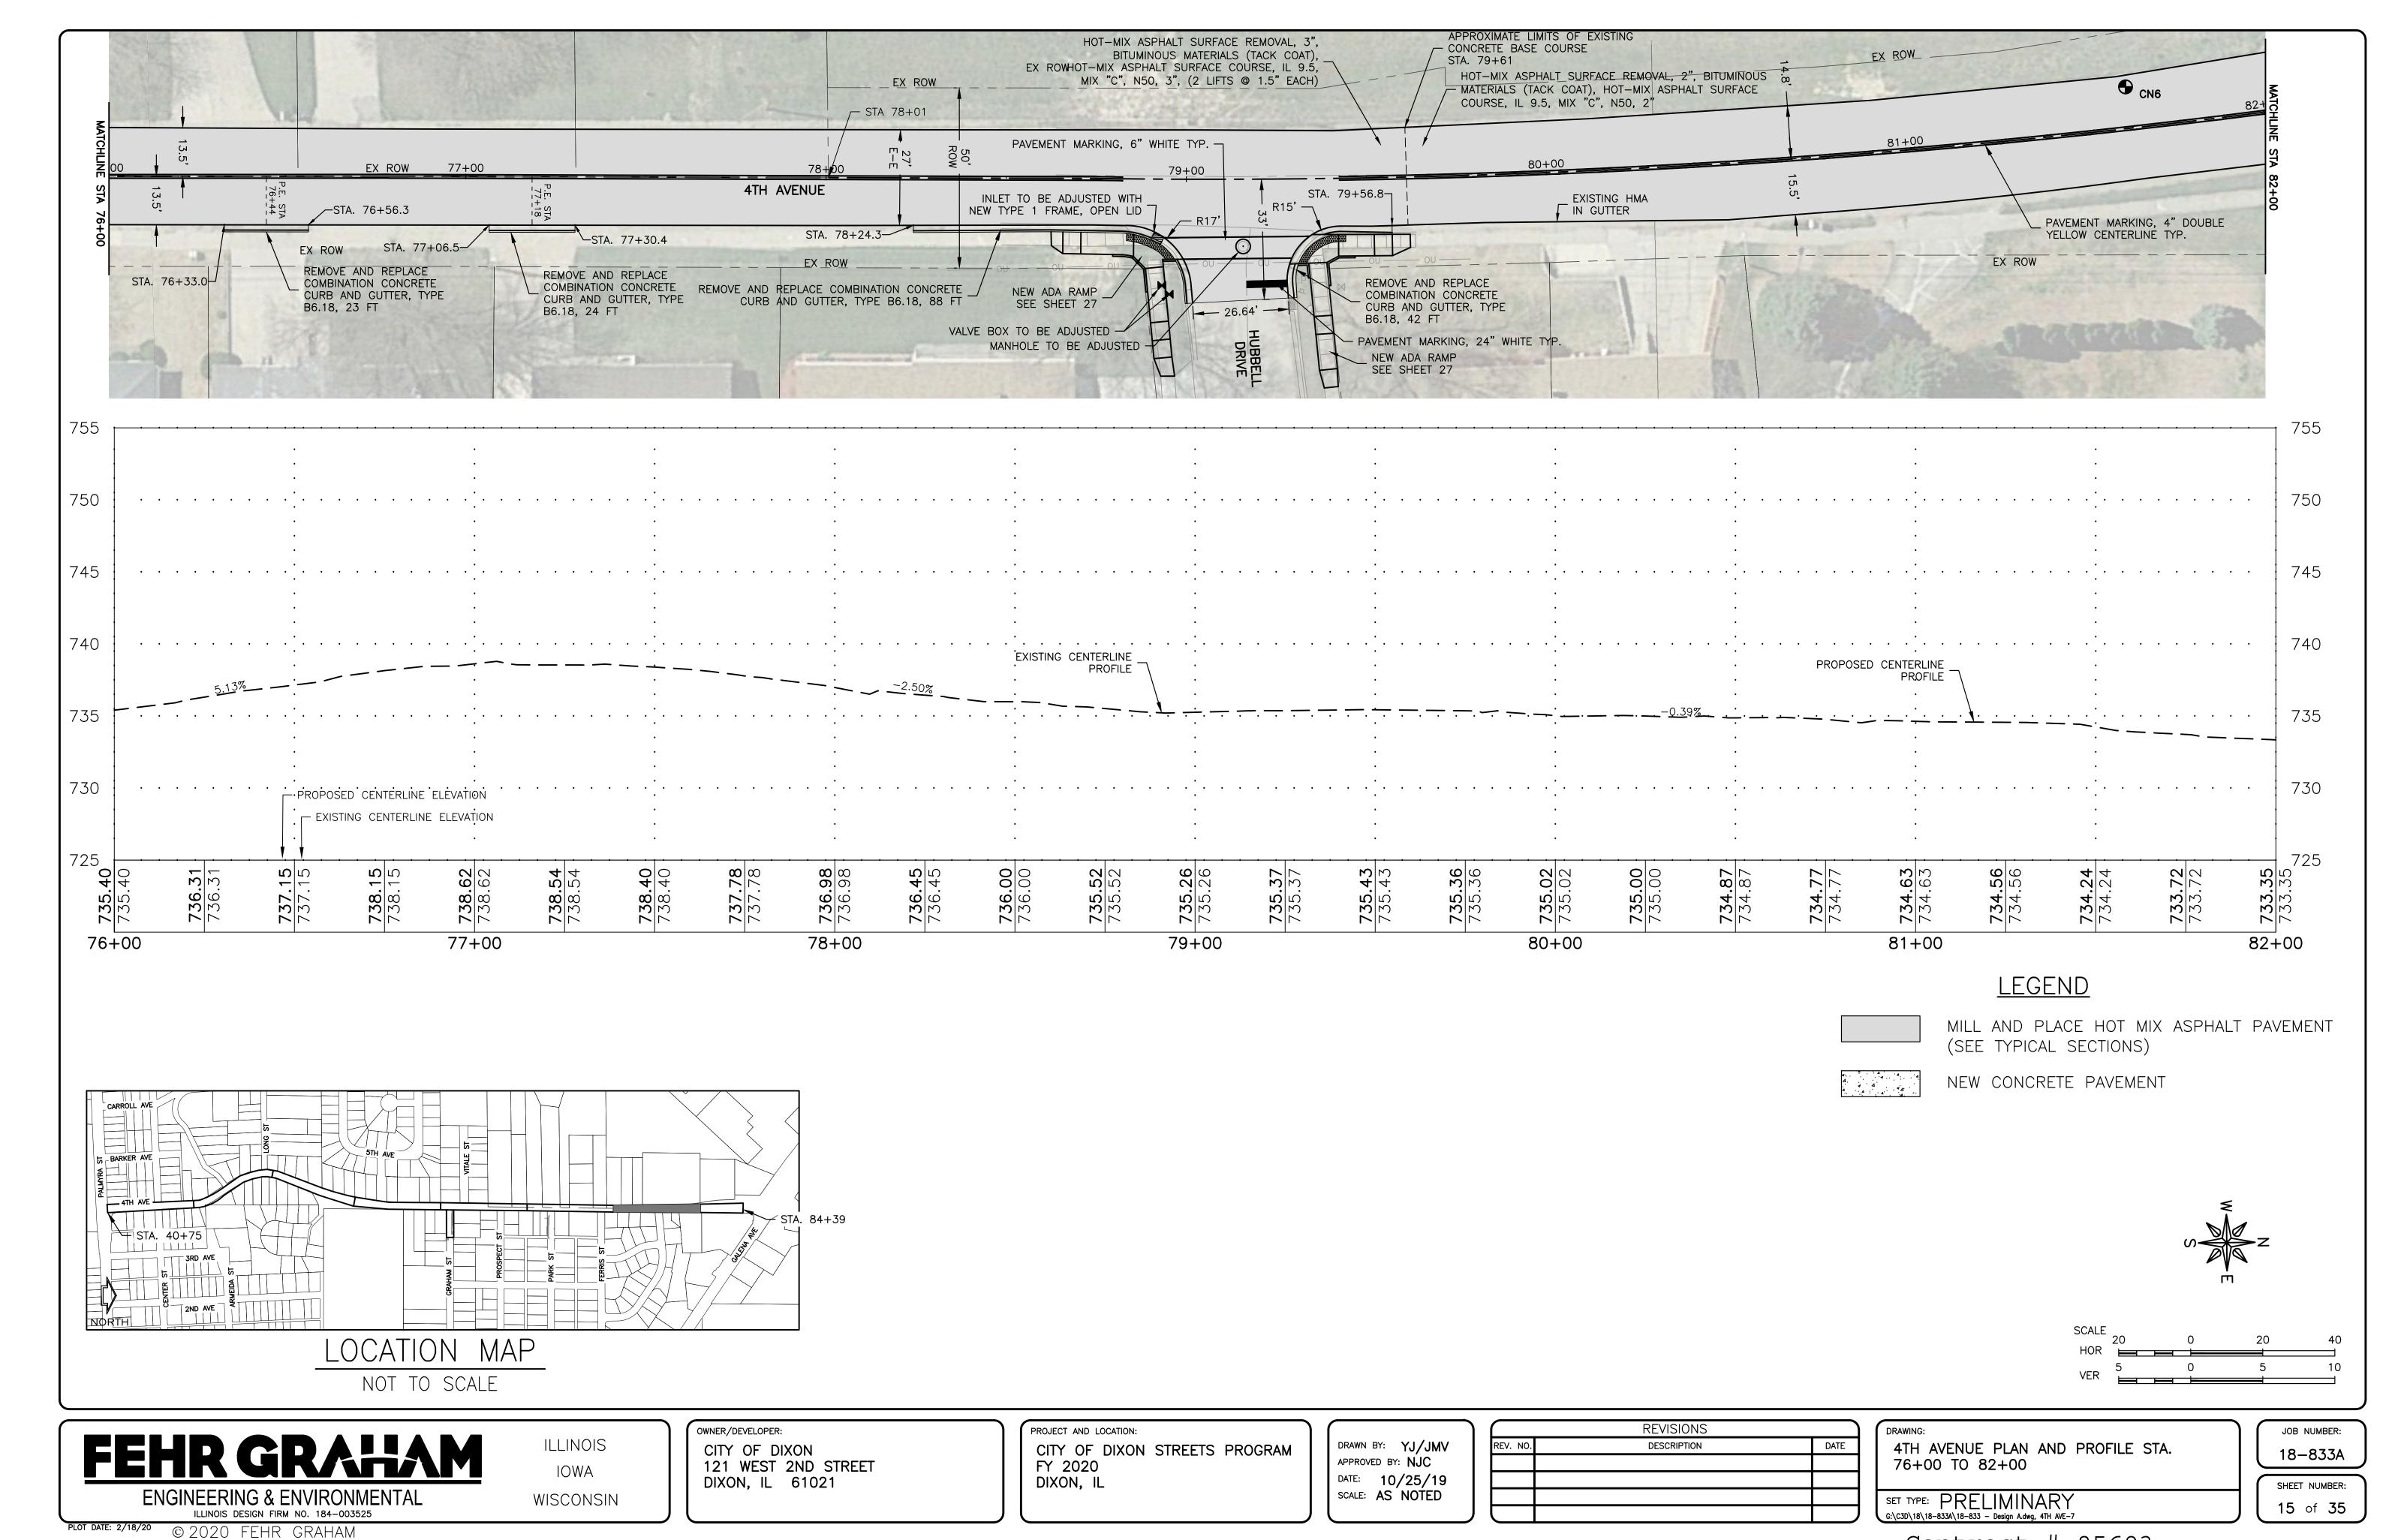

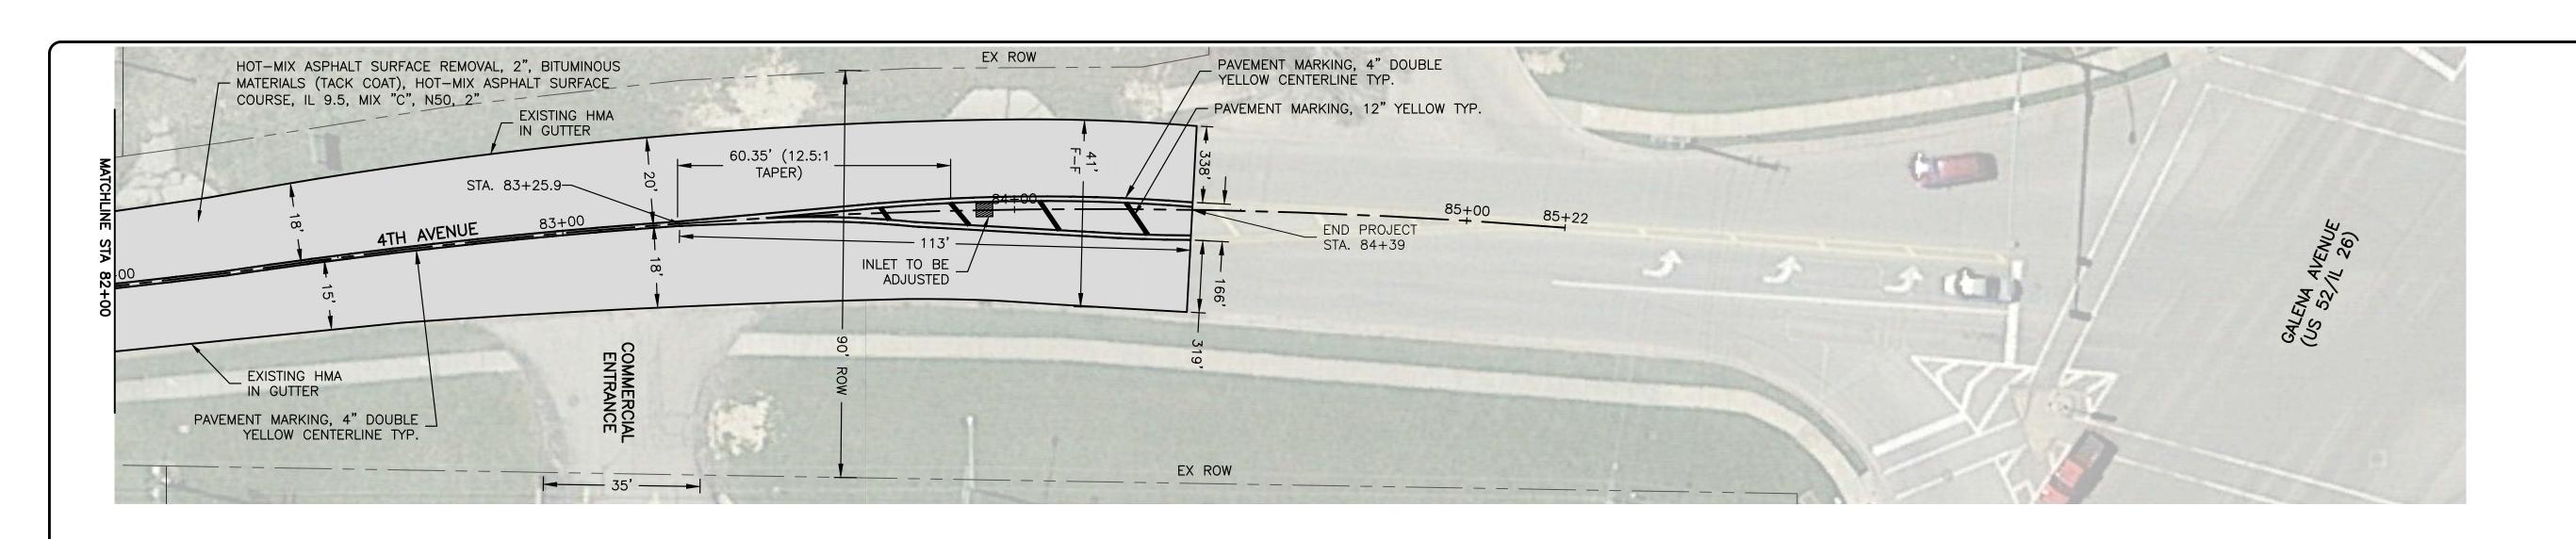

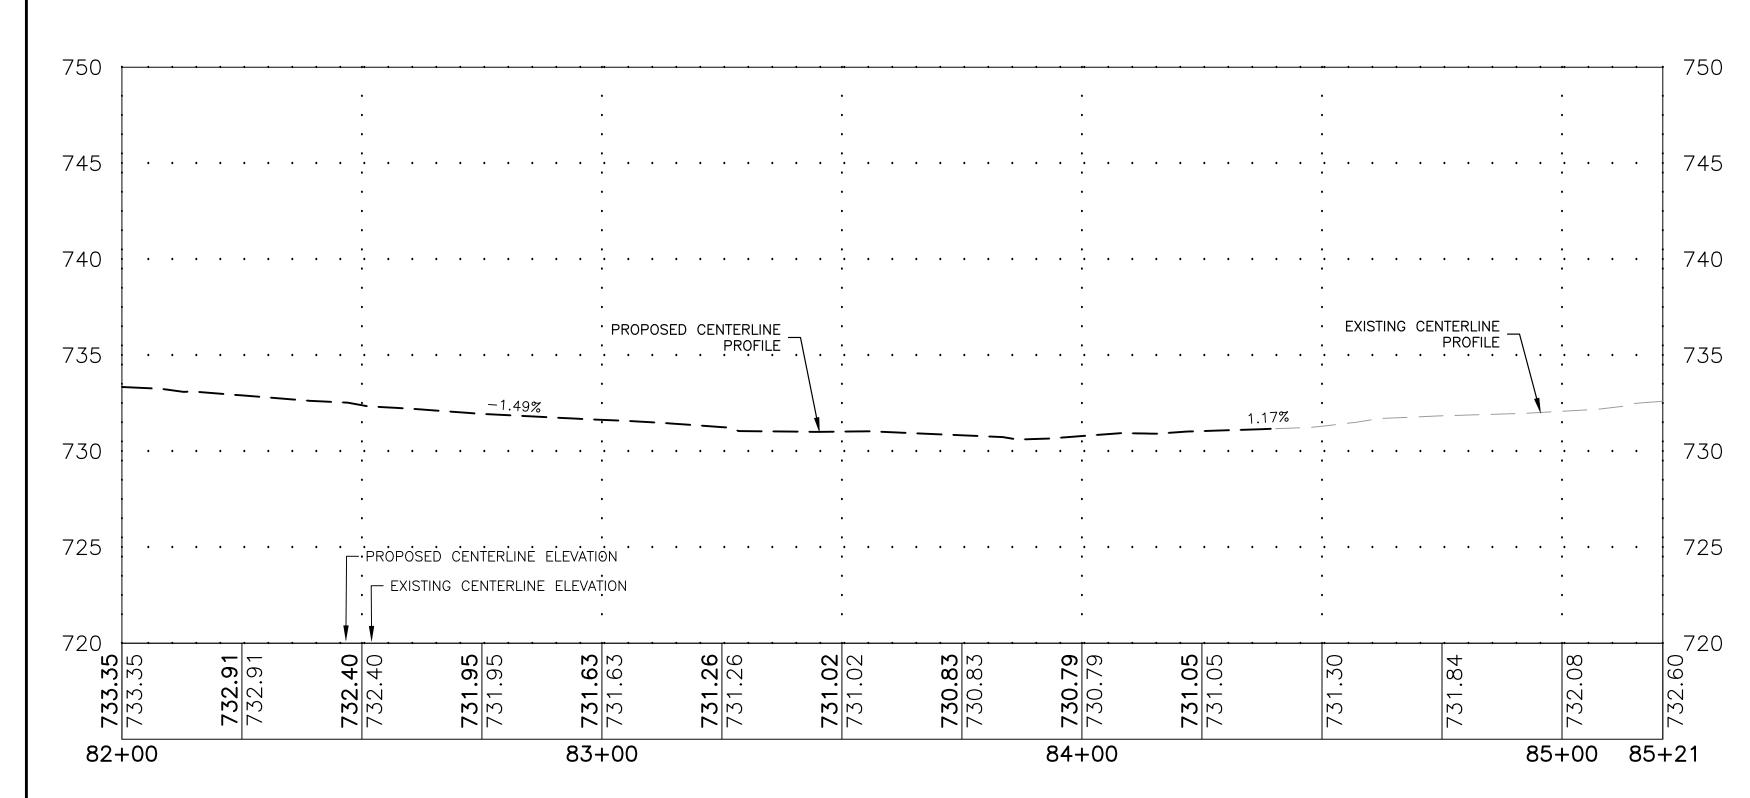

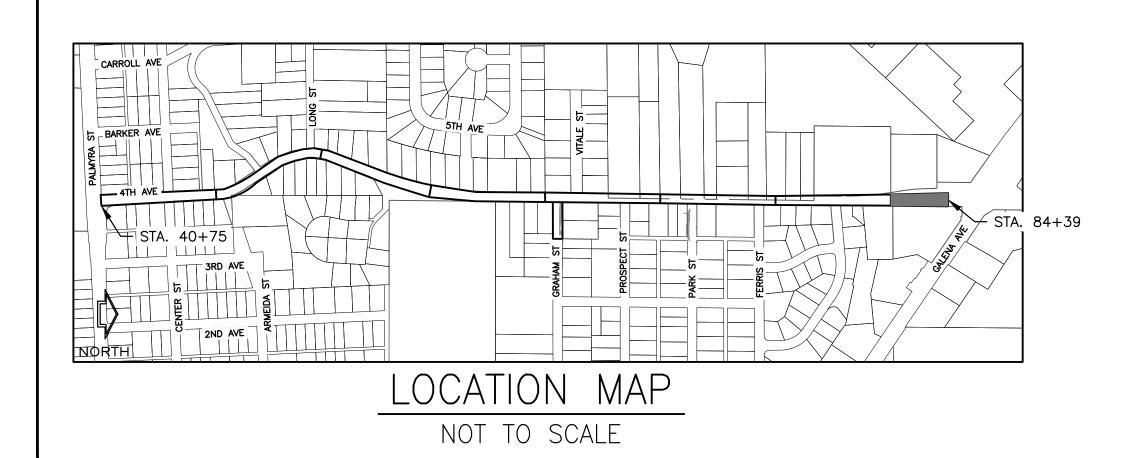


#### **LEGEND**

MILL AND PLACE HOT MIX ASPHALT PAVEMENT

(SEE TYPICAL SECTIONS)

NEW CONCRETE PAVEMENT

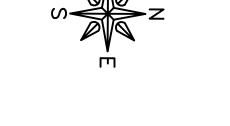

## FEHR GRAHAM

ENGINEERING & ENVIRONMENTAL ILLINOIS DESIGN FIRM NO. 184-003525

PLOT DATE: 2/18/20 © 2020 FEHR GRAHAM

ILLINOIS IOWA WISCONSIN OWNER/DEVELOPER: CITY OF DIXON 121 WEST 2ND STREET DIXON, IL 61021

PROJECT AND LOCATION: CITY OF DIXON STREETS PROGRAM FY 2020

DIXON, IL

DRAWN BY: YJ/JMV APPROVED BY: NJC DATE: 10/25/19 SCALE: AS NOTED

	REVISIONS	
REV. NO.	DESCRIPTION	DATE


4TH AVENUE PLAN AND PROFILE STA. 82+00 TO 85+21


SET TYPE: PRELIMINARY
G:\C3D\18\18-833A\18-833 - Design A.dwg, 4TH AVE-8

SHEET NUMBER: **16** of **35** 

JOB NUMBER:

18-833A

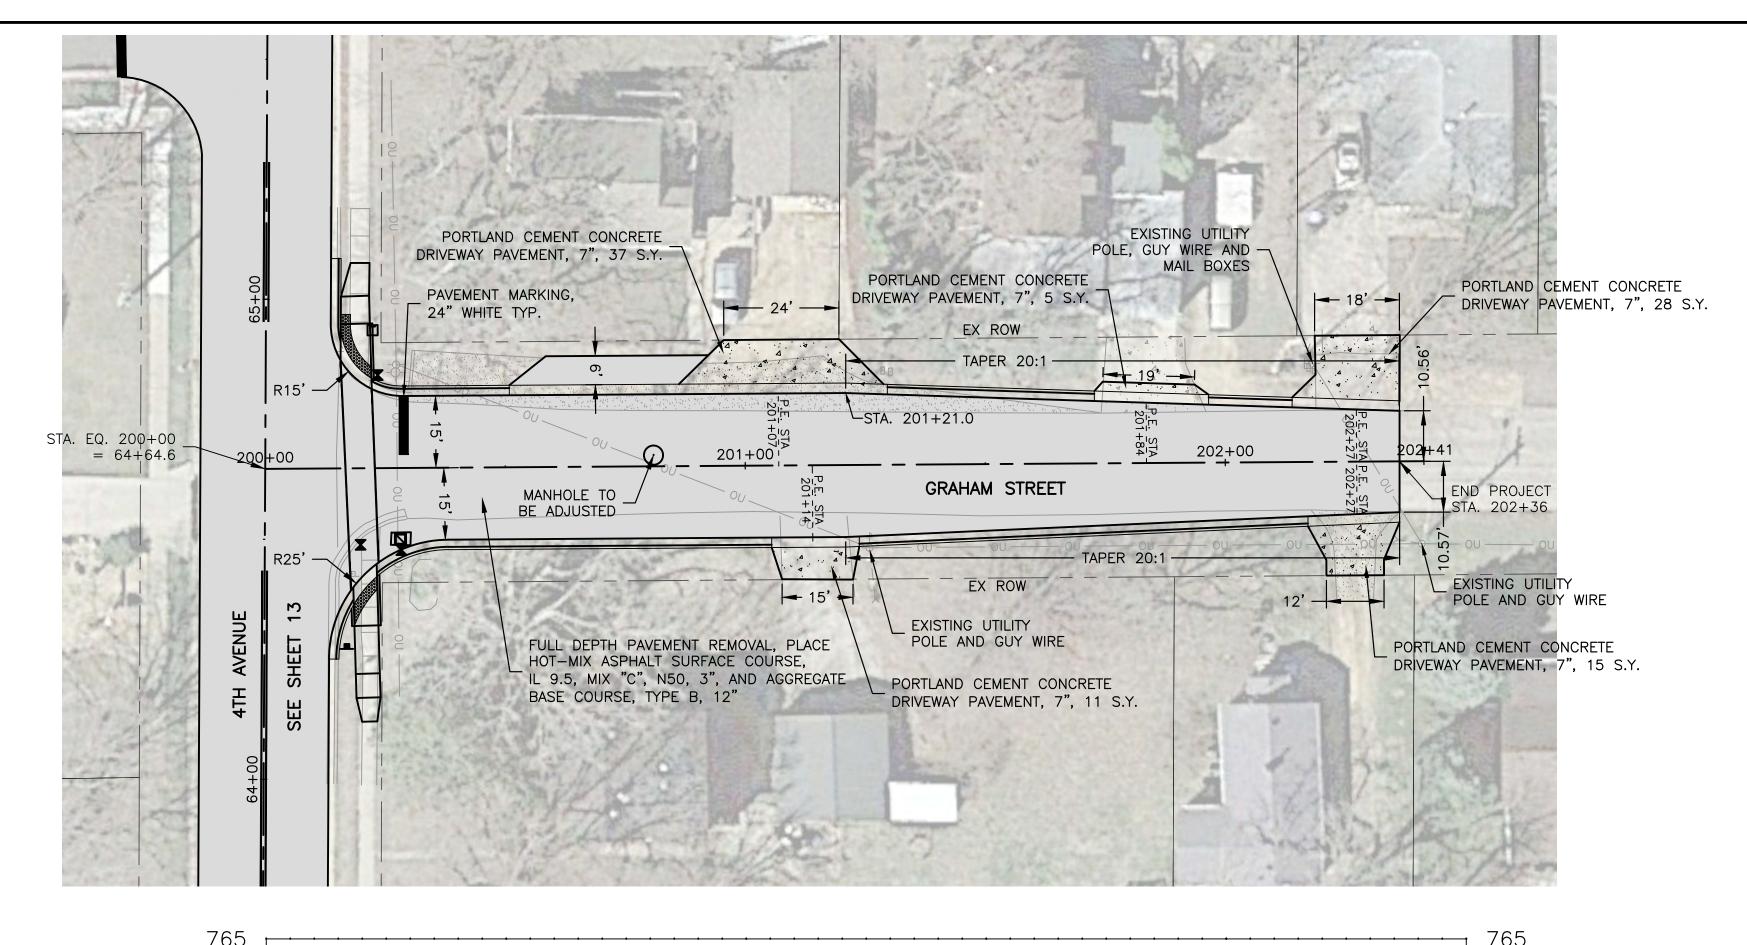

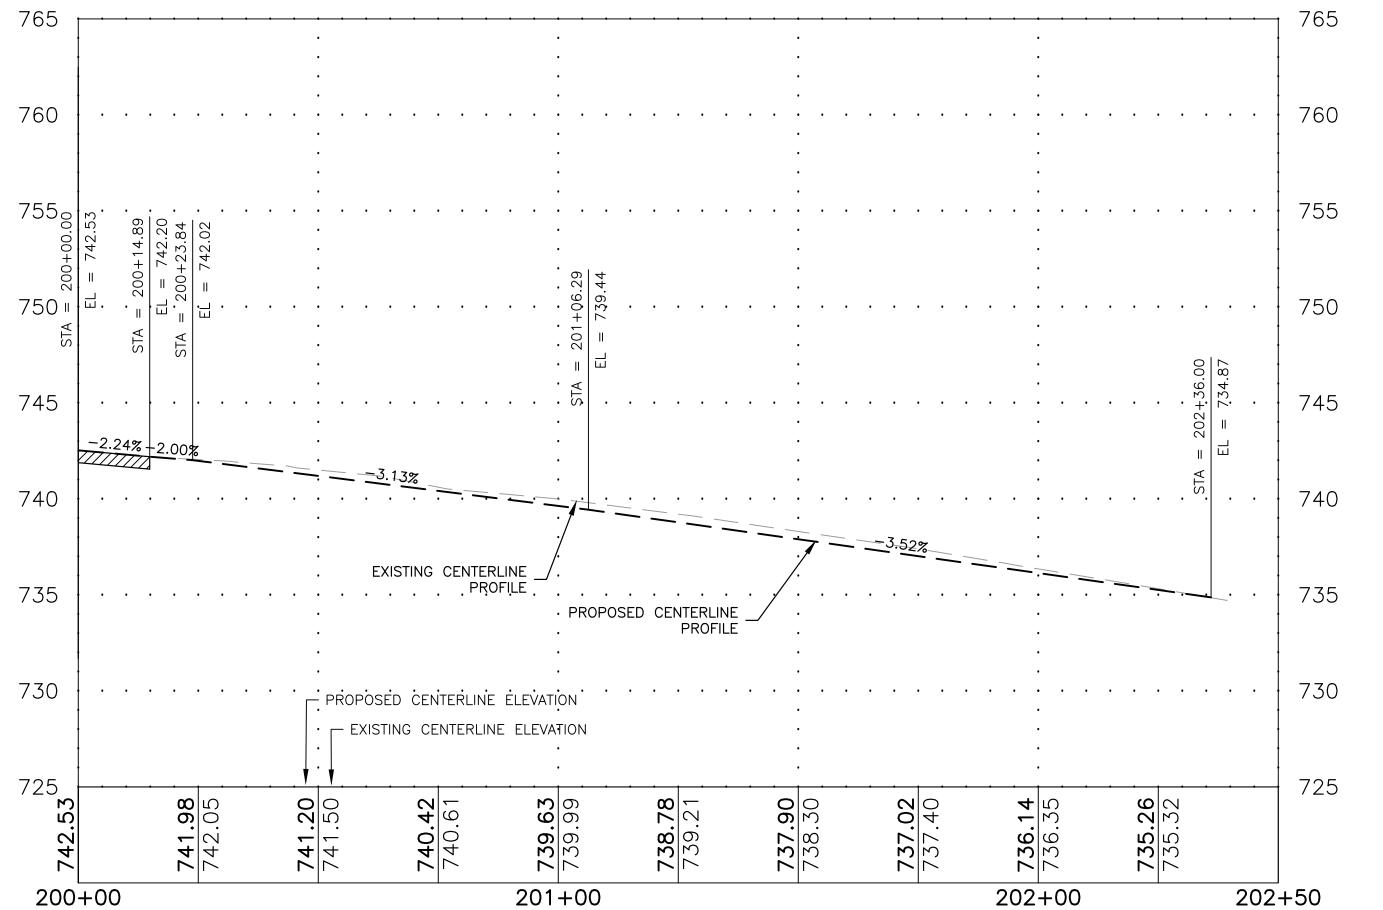


#### <u>LEGEND</u>





NEW CONCRETE PAVEMENT



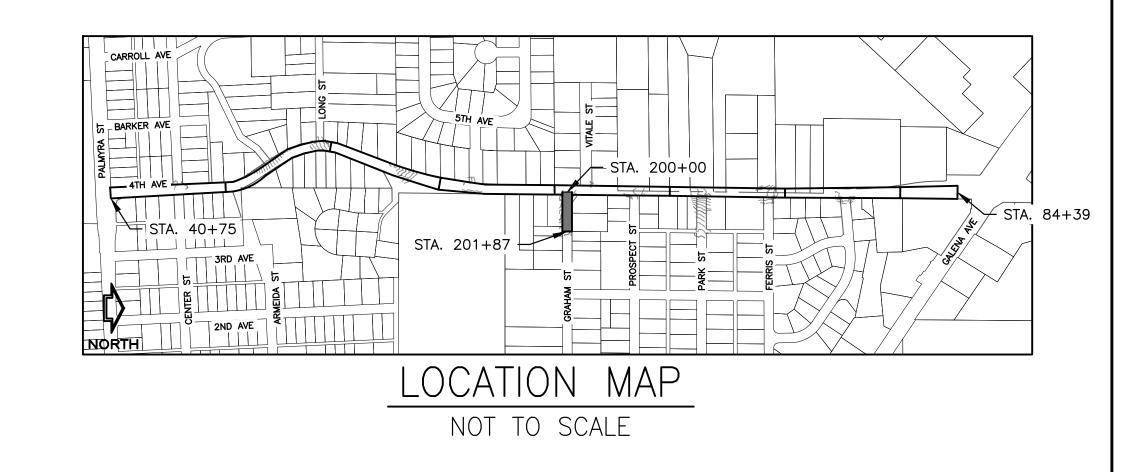

FEHR GRAHAM

ENGINEERING & ENVIRONMENTAL ILLINOIS DESIGN FIRM NO. 184-003525

ILLINOIS IOWA

WISCONSIN

OWNER/DEVELOPER: CITY OF DIXON 121 WEST 2ND STREET DIXON, IL 61021

PROJECT AND LOCATION:

CITY OF DIXON STREETS PROGRAM FY 2020 DIXON, IL

DRAWN BY: YJ/JMV APPROVED BY: NJC DATE: 10/25/19 SCALE: AS NOTED


	REVISIONS	
REV. NO.	DESCRIPTION	DATE


GRAHAM STREET PLAN AND PROFILE STA. 200+00 TO 202+00

SET TYPE: PRELIMINARY
G:\C3D\18\18-833A\18-833 - Design A.dwg, GRAHAM P&P

18-833A SHEET NUMBER: **17** of **35** 


JOB NUMBER:

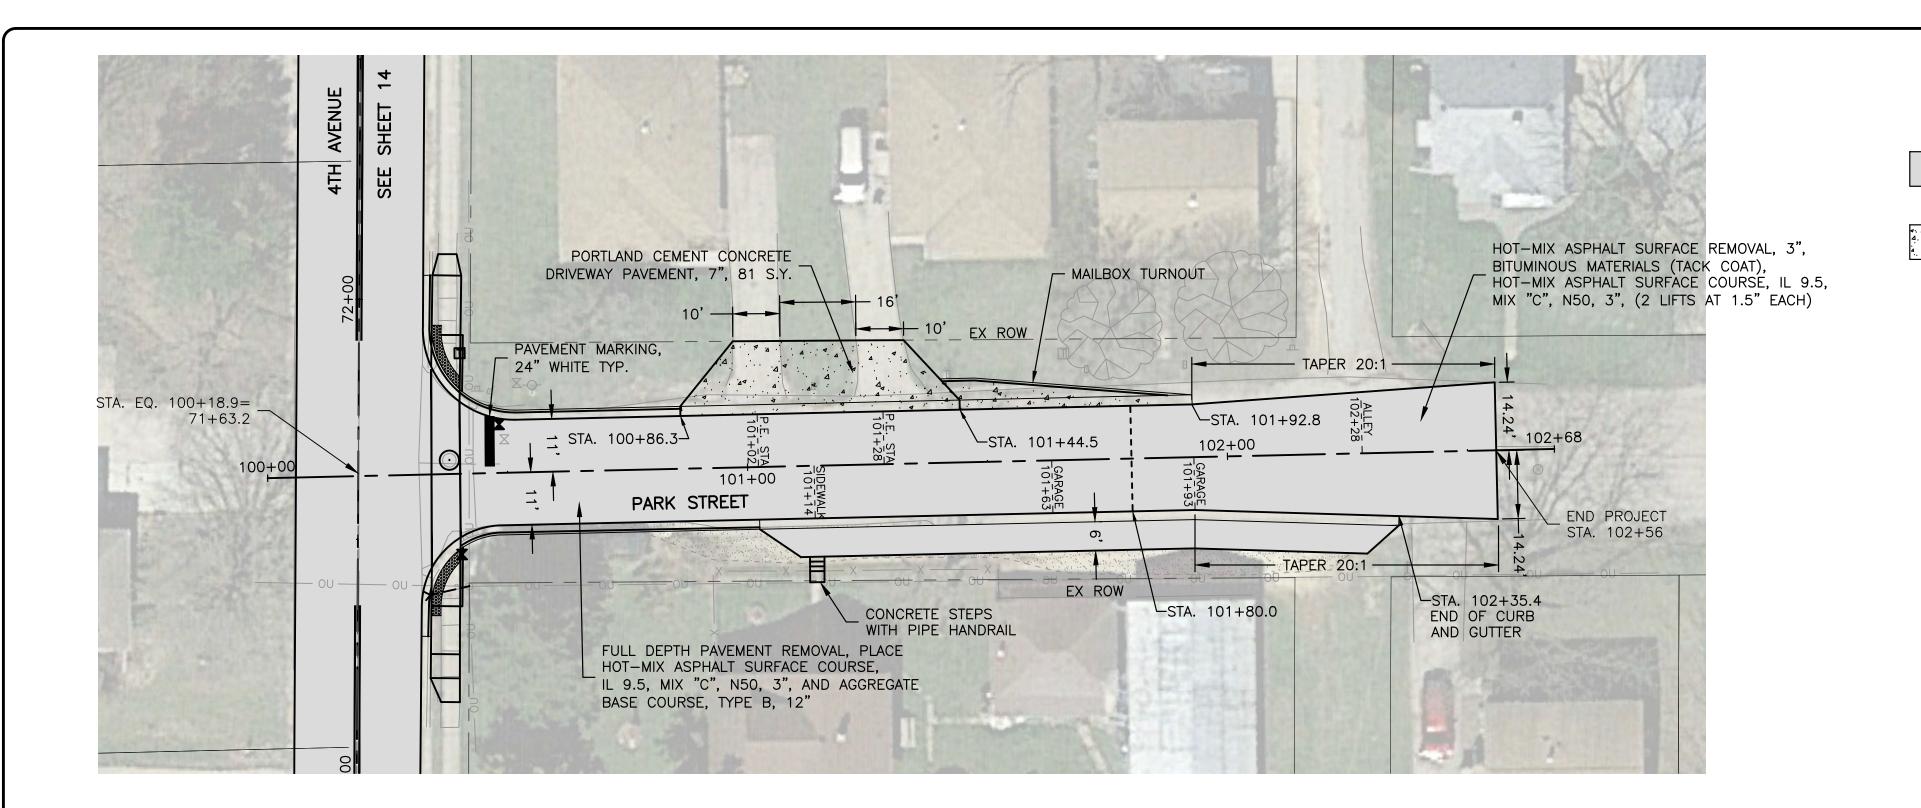

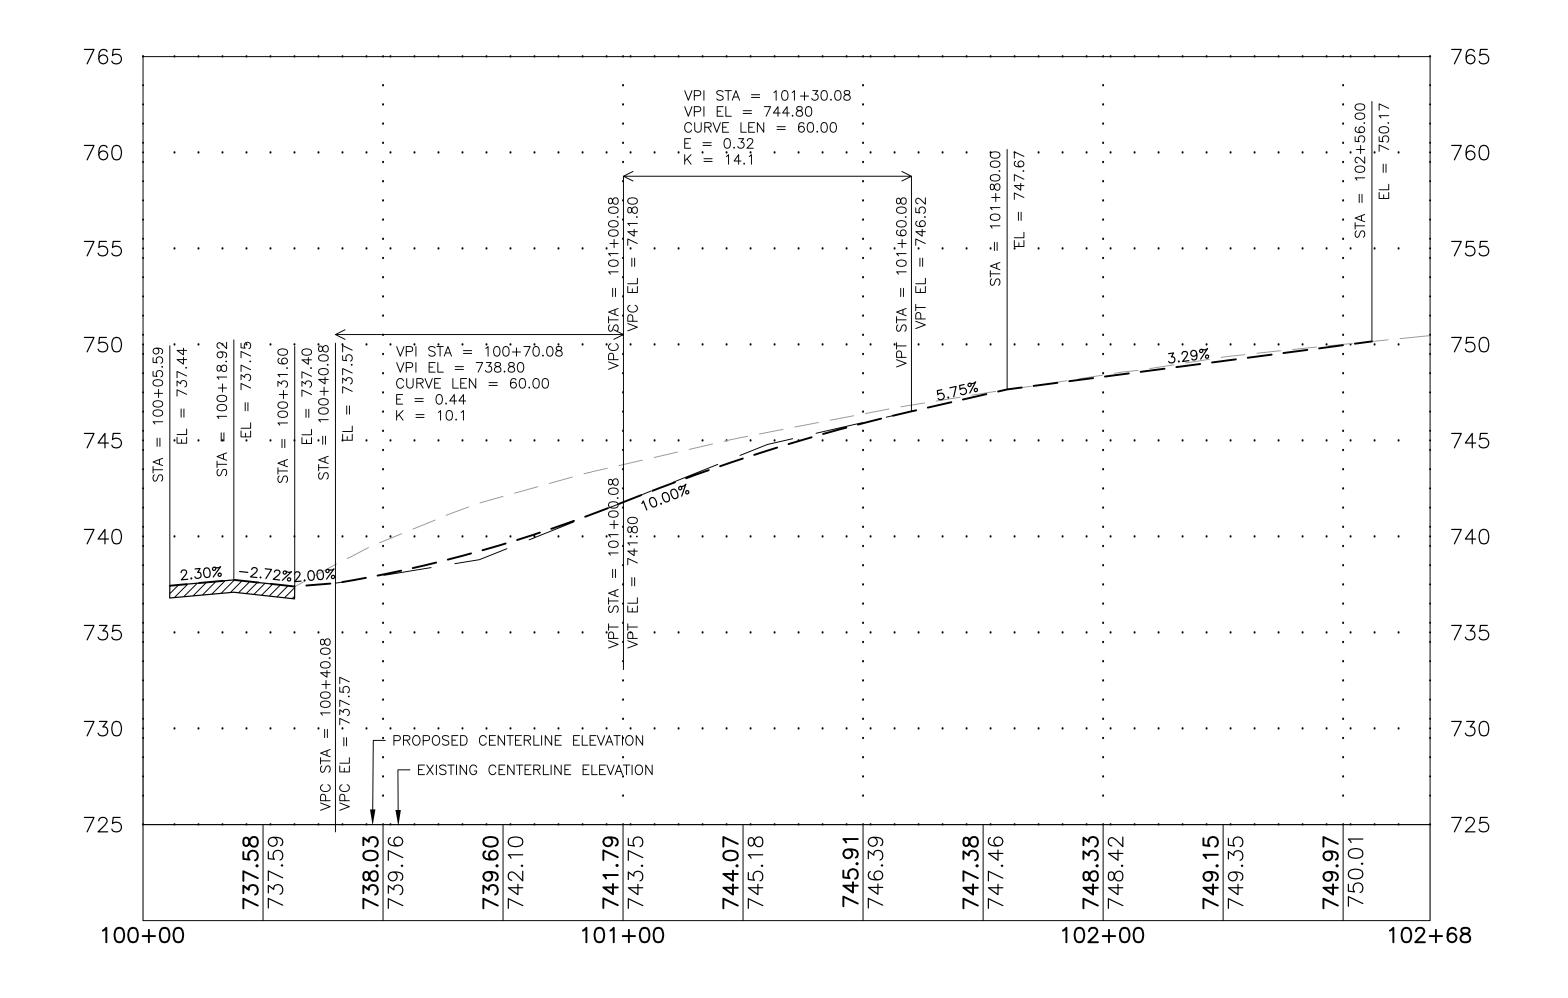


#### <u>LEGEND</u>



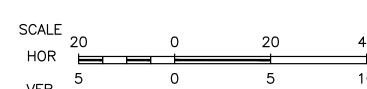

NEW CONCRETE PAVEMENT

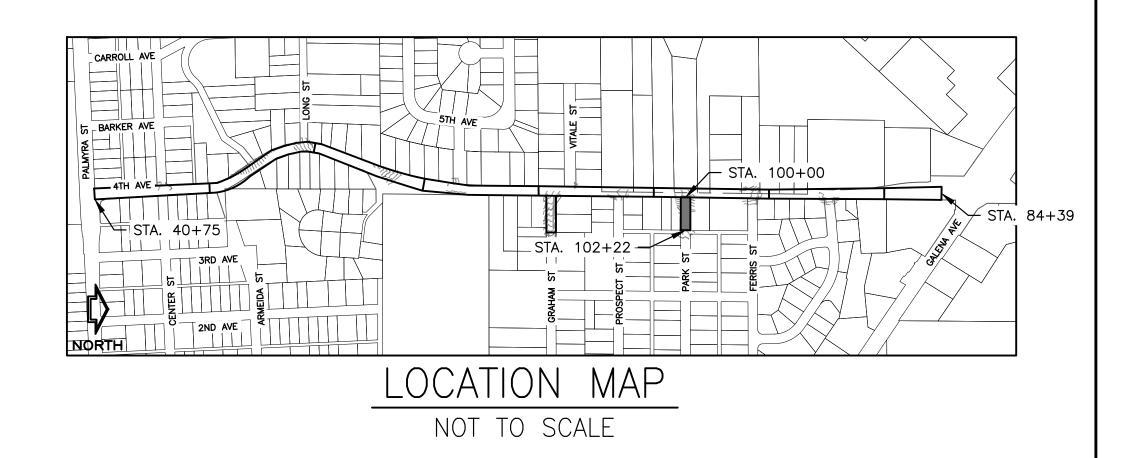

FEHR GRAHAM

ILLINOIS IOWA

WISCONSIN

OWNER/DEVELOPER: CITY OF DIXON 121 WEST 2ND STREET DIXON, IL 61021

PROJECT AND LOCATION:

CITY OF DIXON STREETS PROGRAM FY 2020 DIXON, IL

DRAWN BY: YJ/JMV APPROVED BY: NJC DATE: 10/25/19 SCALE: AS NOTED


	REVISIONS	
REV. NO.	DESCRIPTION	DATE

PARK STREET PLAN AND PROFILE STA. 100+00 TO 102+22

18-833A SHEET NUMBER: 18 of 35

JOB NUMBER:

SET TYPE: PRELIMINARY
G:\C3D\18\18-833A\18-833 - Design A.dwg, PARK P&P

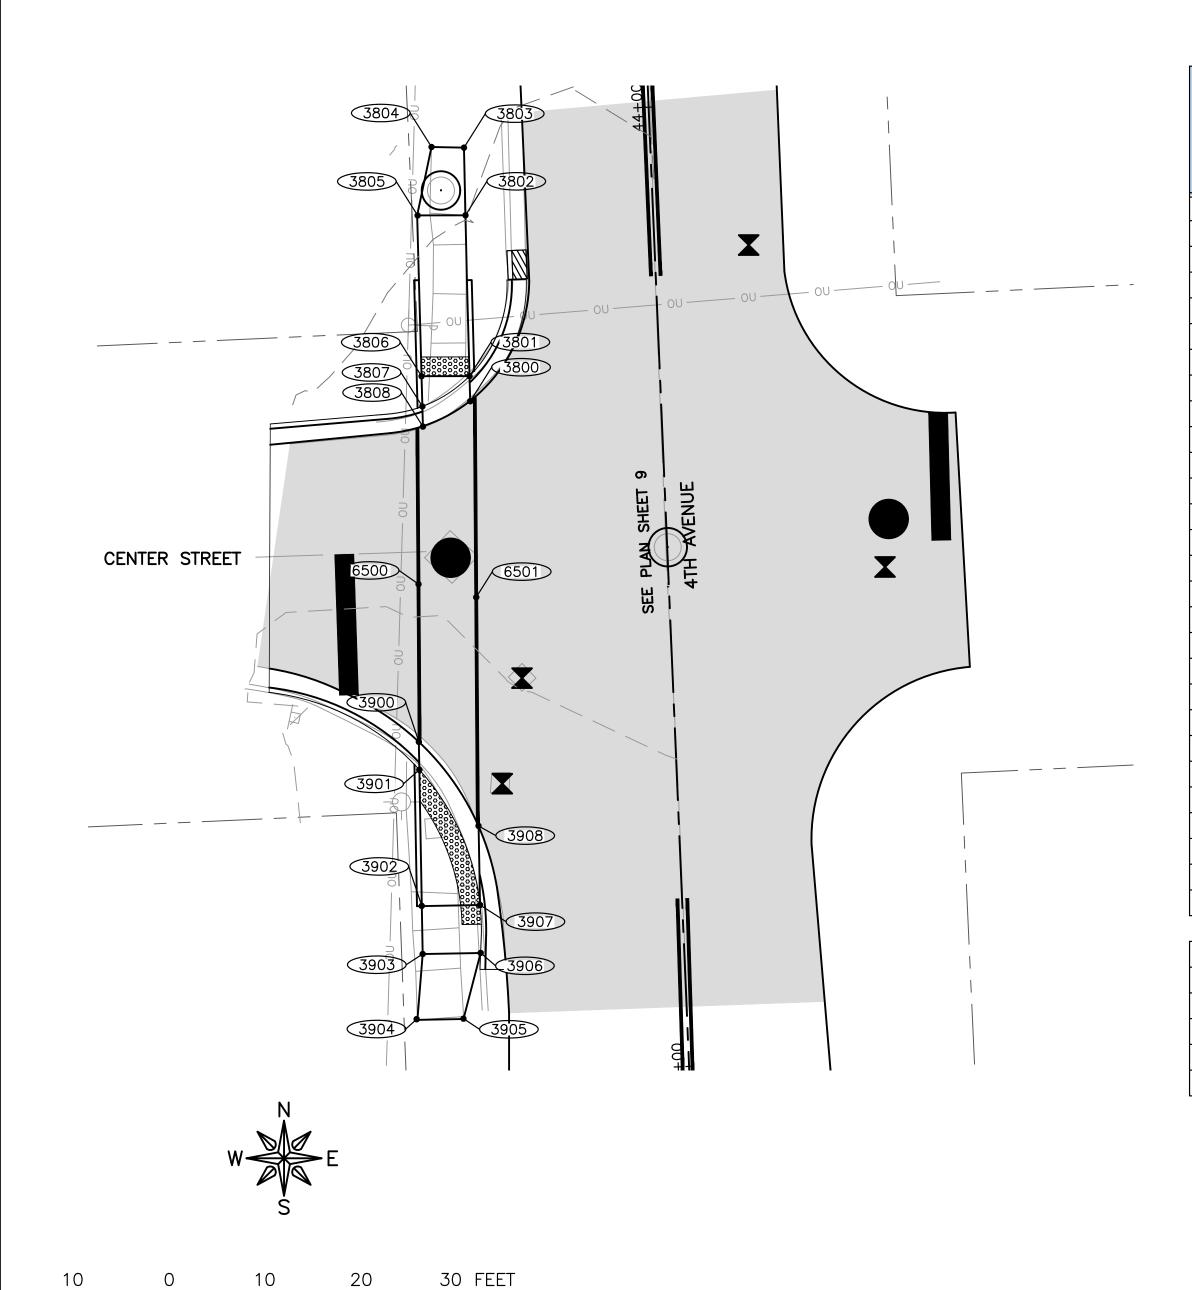

POINT T	O POINT	SIDEWALK DESIGNATIONS	DISTANCE	Δ ELEVATION	SLOPE	ACCEPTAE (POS. o		COMMENTS	FOR INFORMATION ONLY: VALUES USED TO DETERMINE DESIGN			
			FT	FT	%	MIN.	MAX.		POINT	STATION	OFFSET	ELEVATION
			•									
3800	3801	SIDEWALK RUNNING SLOPE	2.50	0.03	1.20%	0.50%	5.00%		3800			669.25
3801	3802	RAMP RUNNING SLOPE	16.75	0.70	4.18%	0.50%	8.33%		3801			669.28
3802	3803	SIDEWALK RUNNING SLOPE	7.00	0.27	3.86%	0.50%	5.00%		3802			669.98
3803	3804	SIDEWALK CROSS SLOPE	4.00	0.20	5.00%	0.50%	2.00%	MATCH EXISTING	3803			670.25
3804	3805	SIDEWALK RUNNING SLOPE	7.00	0.54	7.71%	0.50%	5.00%	MATCH EXISTING	3804			670.45
3805	3806	RAMP RUNNING SLOPE	16.75	0.70	4.18%	0.50%	8.33%		3805			669.91
3806	3807	LANDING	3.25	0.02	0.62%	0.10%	2.00%		3806			669.21
3807	3808	SIDEWALK RUNNING SLOPE	2.00	0.02	1.00%	0.50%	5.00%		3807			669.19
3800	3808	SIDEWALK CROSS SLOPE	5.75	0.08	1.39%	0.50%	2.00%		3808			669.17
3801	3807	LANDING	6.00	0.09	1.50%	0.10%	2.00%					
3801	3806	LANDING	5.00	0.07	1.40%	0.10%	2.00%					
3802	3805	SIDEWALK CROSS SLOPE	5.00	0.07	1.40%	0.50%	2.00%					
3900	3901	SIDEWALK RUNNING SLOPE	3.00	0.04	1.33%	0.50%	5.00%		3900			668.49
3901	3902	LANDING	14.00	0.17	1.21%	0.10%	2.00%		3901			668.53
3902	3903	RAMP RUNNING SLOPE	5.00	0.06	1.20%	0.50%	8.33%		3902			668.70
3903	3904	SIDEWALK RUNNING SLOPE	7.00	0.09	1.29%	0.50%	5.00%		3903			668.76
3904	3905	SIDEWALK CROSS SLOPE	5.00	0.18	3.60%	0.50%	2.00%	MATCH EXISTING	3904			668.85
3905	3906	SIDEWALK RUNNING SLOPE	7.00	0.02	0.29%	0.50%	5.00%		3905			668.67
3906	3907	RAMP RUNNING SLOPE	5.00	0.08	1.60%	0.50%	8.33%		3906			668.69
3907	3908	SIDEWALK RUNNING SLOPE	8.00	0.20	2.50%	0.50%	5.00%		3907			668.61
3900	3908	SIDEWALK CROSS SLOPE	11.00	0.08	0.73%	0.50%	2.00%		3908			668.41
3901	3907	LANDING	15.50	0.08	0.52%	0.10%	2.00%					
3902	3907	LANDING	6.00	0.09	1.50%	0.10%	2.00%					
3903	3906	SIDEWALK CROSS SLOPE	6.00	0.07	1.17%	0.50%	2.00%					
										į.		
6500	6501	SIDEWALK CROSS SLOPE	6.00	0.06	1.00%	0.50%	2.00%		6500			669.08
6500	3808	SIDEWALK RUNNING SLOPE	16.00	0.09	0.56%	0.50%	5.00%		6501			669.14
6500	3900	SIDEWALK RUNNING SLOPE	16.00	0.59	3.69%	0.50%	5.00%		3800			669.25
6501	3800	SIDEWALK RUNNING SLOPE	21.50	0.11	0.51%	0.50%	5.00%		3808			669.17
6501	3908	SIDEWALK RUNNING SLOPE	21.50	0.73	3.40%	0.50%	5.00%		3900			668.49
									3908			668.41

ILLINOIS IOWA

WISCONSIN

OWNER/DEVELOPER:

CITY OF DIXON

121 WEST 2ND STREET

DIXON, IL 61021

PROJECT AND LOCATION:

CITY OF DIXON STREETS PROGRAM

FY 2020

DIXON, IL

DRAWN BY: YJ/JMV
APPROVED BY: NJC
DATE: 10/25/19
SCALE: AS NOTED

	REVISIONS	
REV. NO.	DESCRIPTION	DATE

ADA RAMPS — 4TH AVENUE & CENTER

SET TYPE: PRELIMINARY
G:\C3D\18\18-833A\Plans\18-833 A - PLANS.dwg, 4TH & Center

18-833A


SHEET NUMBER:

19 of 35

JOB NUMBER:

ENGINEERING & ENVIRONMENTAL ILLINOIS DESIGN FIRM NO. 184-003525

PLOT DATE: 2/18/20 © 2020 FEHR GRAHAM

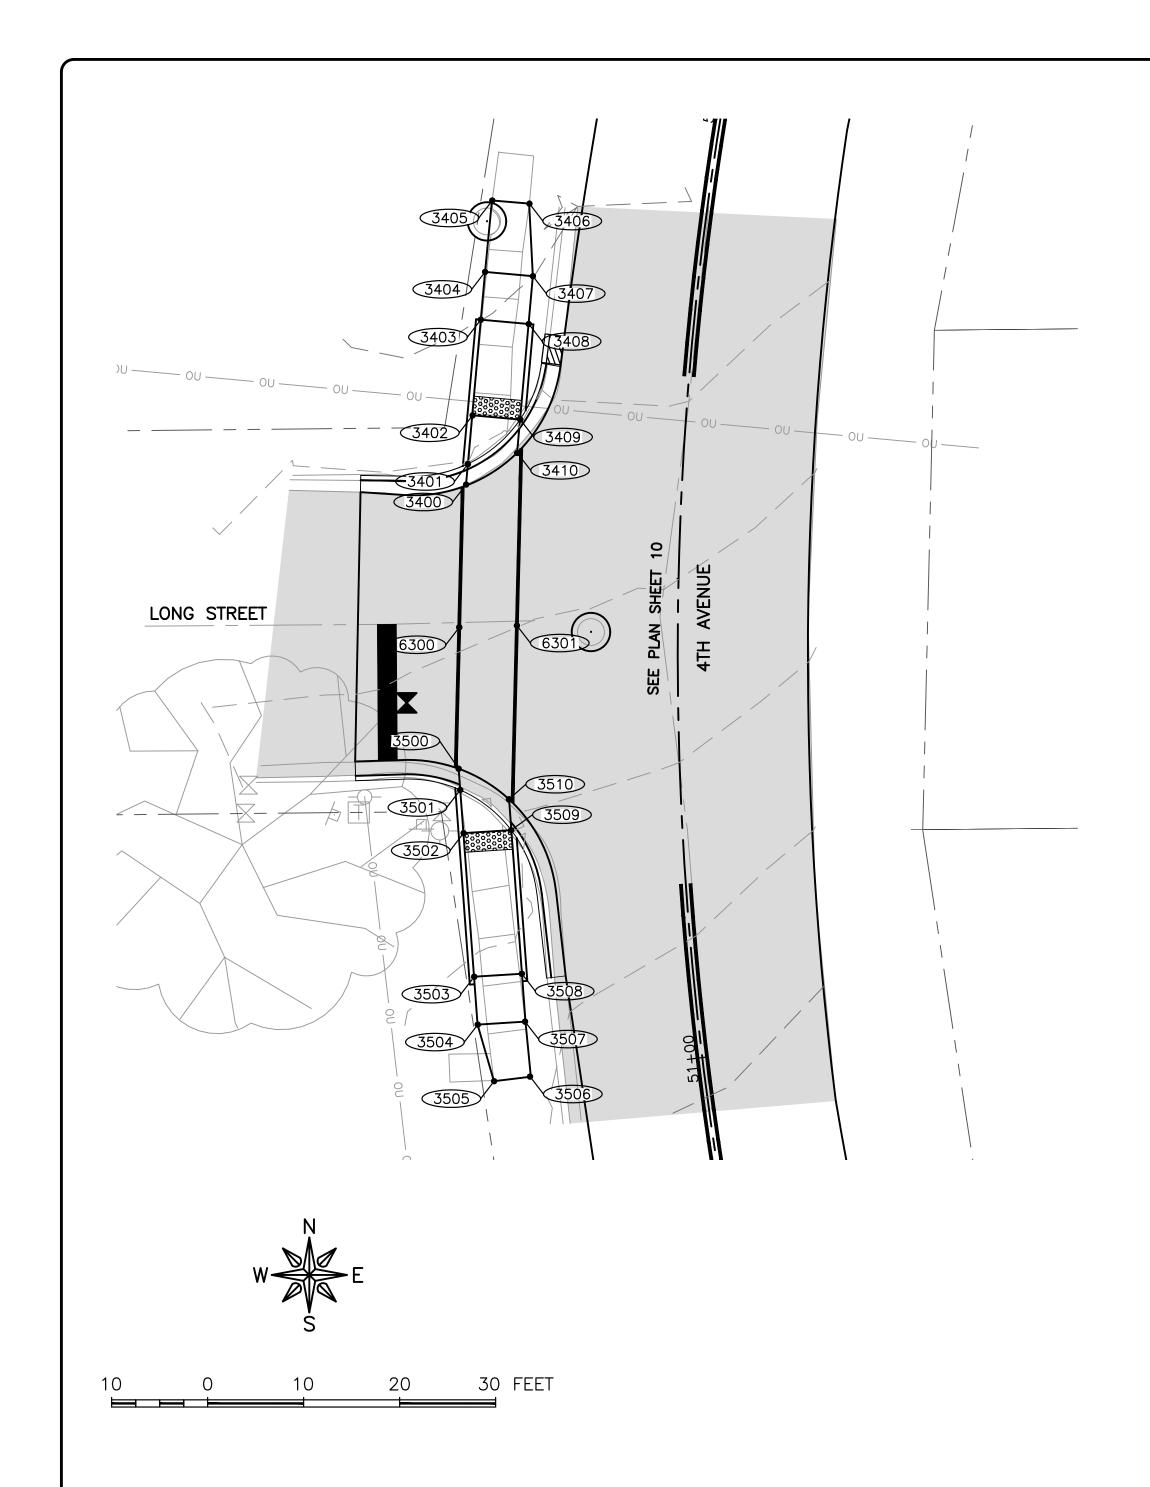

POINT T	O POINT	SIDEWALK DESIGNATIONS	DISTANCE	Δ ELEVATION	SLOPE	(POS. of NEG.) VALUES USED TO DETERMINE						ED SLOPES
			FT	FT	%	MIN.	MAX.		POINT	STATION	OFFSET	ELEVATION
2400	2404	OIDEWALK BUNNING OLODE	0.00	0.00	4.000/	0.50%	5.000/		0.400			744.05
3400	3401	SIDEWALK RUNNING SLOPE	2.00	0.02	1.00%	0.50%	5.00%		3400			714.35
3401 3402	3402 3403	RAMP RUNNING SLOPE	5.00	0.08 0.75	7.50%	0.10%	2.00% 8.33%		3401			714.37 714.45
3402	3404	LANDING	5.00	0.75	1.60%	0.50%	2.00%		3402			714.45
3403	3404	RAMP RUNNING SLOPE	7.00	0.08	5.00%	0.10%	6.50%	STREET GRADE	3403			715.20
3404	3405	SIDEWALK CROSS SLOPE	4.00	0.35	1.25%	0.50%	2.00%	MATCH EXISTING	3404			715.26
3405	3406	RAMP RUNNING SLOPE	7.00	0.05	5.14%	0.50%	6.50%	STREET GRADE	3405			715.63
3407	3407	LANDING	5.00	0.30	1.40%	0.30%	2.00%	STREET GRADE	3400			715.36
3407	3409	RAMP RUNNING SLOPE	10.00	0.07	7.50%	0.10%	8.33%		3407			715.22
3408	3410	SIDEWALK RUNNING SLOPE	1.00	0.73	1.00%	0.50%	5.00%		3408			713.13
3409	3410	LANDING	6.20	0.01	0.65%	0.10%	2.00%		3410			714.40
3400	3409	LANDING	7.70	0.04	0.03%	0.10%	2.00%		3410			7 14.39
3402	3409	LANDING	5.00	0.05	1.00%	0.10%	2.00%					
3402	3408	LANDING	5.00	0.05	1.00%	0.10%	2.00%					
3404	3407	LANDING	5.00	0.06	1.20%	0.10%	2.00%					
3404	3407	LANDING	3.00	0.00	1.20 /0	0.1076	2.00 /6					
3500	3501	SIDEWALK RUNNING SLOPE	2.00	0.03	1.50%	0.50%	5.00%		3500			713.00
3501	3502	LANDING	5.00	0.09	1.80%	0.10%	2.00%		3501			712.97
3502	3503	RAMP RUNNING SLOPE	15.00	1.12	7.47%	0.50%	8.33%		3502			712.88
3503	3504	LANDING	5.00	0.07	1.40%	0.10%	2.00%		3503			711.76
3504	3505	RAMP RUNNING SLOPE	5.00	0.33	6.60%	0.50%	6.50%	STREET GRADE	3504			711.69
3505	3506	SIDEWALK CROSS SLOPE	4.00	0.00	0.00%	0.50%	2.00%	MATCH EXISTING	3505			711.36
3506	3507	RAMP RUNNING SLOPE	5.00	0.35	7.00%	0.50%	6.50%	STREET GRADE	3506			711.36
3507	3508	LANDING	5.00	0.07	1.40%	0.10%	2.00%		3507			711.71
3508	3509	RAMP RUNNING SLOPE	15.00	1.12	7.47%	0.50%	8.33%		3508			711.78
3509	3510	SIDEWALK RUNNING SLOPE	2.00	0.02	1.00%	0.50%	5.00%		3509			712.90
3500	3510	SIDEWALK CROSS SLOPE	6.10	0.08	1.31%	0.50%	2.00%		3510			712.92
3501	3509	LANDING	6.80	0.07	1.03%	0.10%	2.00%					
3502	3509	LANDING	5.00	0.02	0.40%	0.10%	2.00%					
3503	3508	LANDING	5.00	0.02	0.40%	0.10%	2.00%					
3504	3507	LANDING	5.00	0.02	0.40%	0.10%	2.00%					
		•	-			•	•	•	•		,	
6300	6301	SIDEWALK CROSS SLOPE	6.00	0.09	1.50%	0.50%	2.00%		6300			713.68
6300	3400	SIDEWALK RUNNING SLOPE	14.50	0.67	4.62%	0.50%	5.00%		6301			713.59
6300	3500	SIDEWALK RUNNING SLOPE	14.50	0.68	4.69%	0.50%	5.00%		3400			714.35
6301	3410	SIDEWALK RUNNING SLOPE	18.50	0.79	4.27%	0.50%	5.00%		3410			714.38
6301	3510	SIDEWALK RUNNING SLOPE	18.50	0.67	3.62%	0.50%	5.00%		3500			713.00
									3510			712.92

ILLINOIS IOWA WISCONSIN OWNER/DEVELOPER:

CITY OF DIXON

121 WEST 2ND STREET

DIXON, IL 61021

PROJECT AND LOCATION:

CITY OF DIXON STREETS PROGRAM

FY 2020

DIXON, IL

DRAWN BY: YJ/JMV
APPROVED BY: NJC
DATE: 10/25/19
SCALE: AS NOTED

	REVISIONS	
REV. NO.	DESCRIPTION	DATE

DRAWING:

ADA RAMPS — 4TH AVENUE & LONG


SET TYPE: PRELIMINARY
G:\C3D\18\18-833A\Plans\18-833 A - PLANS.dwg, 4TH & Long

JOB NUMBER:

18-833A

SHEET NUMBER:

20 of 35

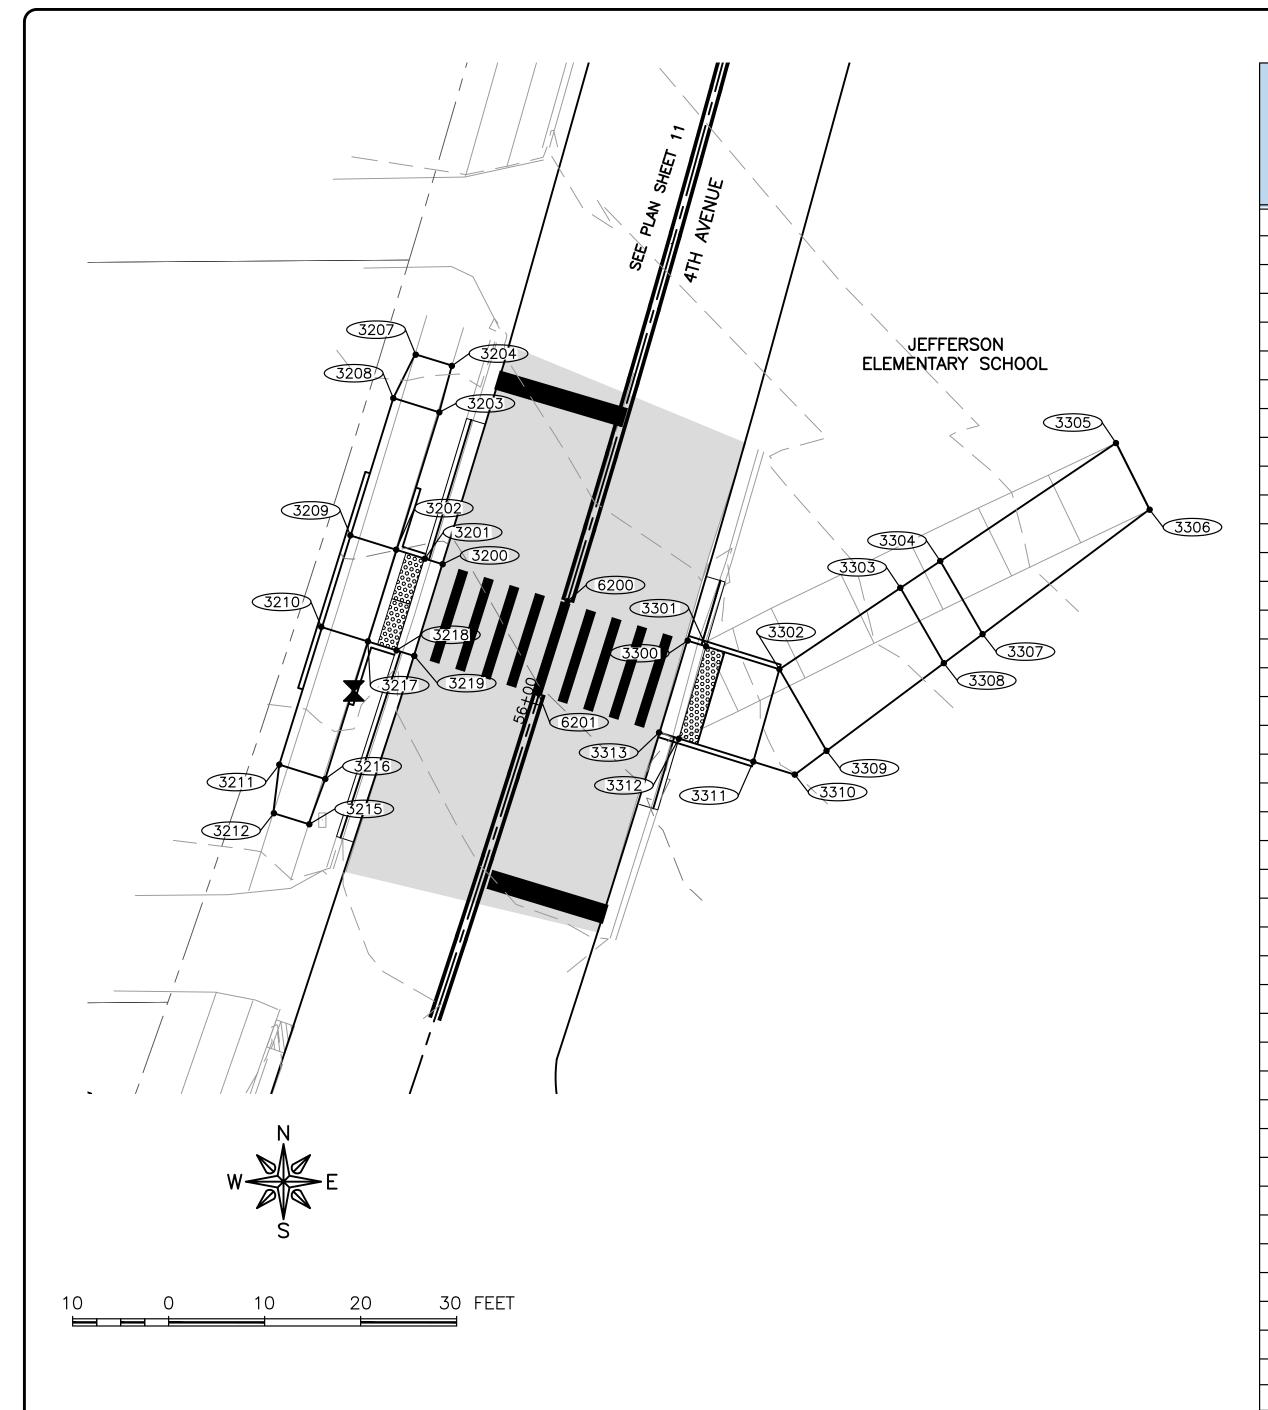

POINT T	O POINT SIDEWALK DESIGNATIONS		DISTANCE	Δ ELEVATION	SLOPE		BLE RANGE or NEG.)	COMMENTS	VALUE	FOR INFO	DRMATION ONL TERMINE DESIG	
			FT	FT	%	MIN.	MAX.		POINT	STATION	OFFSET	ELEVATION
	Γ					T						
3200	3201	SIDEWALK RUNNING SLOPE	2.00	0.03	1.50%	0.50%	5.00%		3200			729.84
3201	3202	LANDING	2.70	0.04	1.48%	0.10%	2.00%		3201			729.87
3202	3203	RAMP RUNNING SLOPE	15.00	1.12	7.47%	0.50%	8.33%		3202			729.91
3203	3204	LANDING	5.00	0.07	1.40%	0.10%	2.00%		3203			731.03
3204	3207	LANDING	4.00	0.06	1.50%	0.10%	2.00%	MATCH EXISTING	3204			731.10
3207	3208	LANDING	5.00	0.07	1.40%	0.10%	2.00%		3207			731.16
3208	3209	RAMP RUNNING SLOPE	15.00	1.12	7.47%	0.50%	8.33%		3208			731.09
3209	3210	LANDING	10.00	0.15	1.50%	0.10%	2.00%		3209			729.97
3210	3211	RAMP RUNNING SLOPE	15.00	1.12	7.47%	0.50%	8.33%		3210			729.82
3211	3212	LANDING	5.00	0.07	1.40%	0.10%	2.00%		3211			728.70
3212	3215	LANDING	4.00	0.07	1.75%	0.10%	2.00%	MATCH EXISTING	3212			728.63
3215	3216	LANDING	5.00	0.08	1.60%	0.10%	2.00%		3215			728.56
3216	3217	RAMP RUNNING SLOPE	15.00	1.12	7.47%	0.50%	8.33%		3216			728.64
3217	3218	LANDING	2.70	0.04	1.48%	0.10%	2.00%		3217			729.76
3218	3219	SIDEWALK RUNNING SLOPE	2.00	0.03	1.50%	0.50%	5.00%		3218			729.72
3200	3219	LANDING	10.00	0.15	1.50%	0.10%	2.00%		3219			729.69
3201	3218	LANDING	10.00	0.15	1.50%	0.10%	2.00%					
3202	3217	LANDING	10.00	0.15	1.50%	0.10%	2.00%					
3202	3209	LANDING	5.00	0.06	1.20%	0.10%	2.00%					
3203	3208	LANDING	5.00	0.06	1.20%	0.10%	2.00%					
3210	3217	LANDING	5.00	0.06	1.20%	0.10%	2.00%					
3211	3216	LANDING	5.00	0.06	1.20%	0.10%	2.00%					
3300	3301	SIDEWALK RUNNING SLOPE	2.00	0.03	1.50%	0.50%	5.00%		3300			730.67
3301	3302	LANDING	8.00	0.12	1.50%	0.10%	2.00%		3301			730.70
3302	3303	RAMP RUNNING SLOPE	15.00	1.12	7.47%	0.50%	8.33%		3302			730.82
3303	3304	LANDING	5.00	0.07	1.40%	0.10%	2.00%		3303			731.94
3304	3305	RAMP RUNNING SLOPE	22.00	1.65	7.50%	0.50%	8.33%		3304			732.01
3305	3306	RAMP CROSS SLOPE	7.70	0.10	1.30%	0.10%	2.00%	MATCH EXISTING	3305			733.66
3306	3307	RAMP RUNNING SLOPE	22.00	1.82	8.27%	0.50%	8.33%		3306			733.76
3307	3308	LANDING	5.00	0.07	1.40%	0.10%	2.00%		3307			731.94
3308	3309	RAMP RUNNING SLOPE	15.00	1.12	7.47%	0.50%	8.33%		3308			731.87
3309	3310	LANDING	4.00	0.04	1.00%	0.10%	2.00%		3309			730.75
3310	3311	LANDING	4.50	0.04	0.89%	0.10%	2.00%		3310			730.71
3311	3312	LANDING	8.00	0.12	1.50%	0.10%	2.00%		3311			730.67
3312	3313	SIDEWALK RUNNING SLOPE	2.00	0.03	1.50%	0.50%	5.00%		3312			730.55
3300	3313	SIDEWALK CROSS SLOPE	10.00	0.15	1.50%	0.50%	2.00%		3313			730.52
3301	3312	LANDING	10.00	0.15	1.50%	0.10%	2.00%					
3302	3311	LANDING	10.00	0.15	1.50%	0.10%	2.00%					
3302	3310	LANDING	10.50	0.11	1.05%	0.10%	2.00%					
3302	3309	LANDING	10.00	0.07	0.70%	0.10%	2.00%					
3303	3308	LANDING	10.00	0.07	0.70%	0.10%	2.00%					
3304	3307	LANDING	10.00	0.07	0.70%	0.10%	2.00%	<u> </u>				

6200	6201	SIDEWALK CROSS SLOPE	10.00	0.15	1.50%	0.50%	2.00%	6200	730.47
6200	3200	SIDEWALK RUNNING SLOPE	13.50	0.63	4.67%	0.50%	5.00%	6201	730.32
6200	3300	SIDEWALK RUNNING SLOPE	13.50	0.20	1.48%	0.50%	5.00%	3200	729.84
6201	3219	SIDEWALK RUNNING SLOPE	13.50	0.63	4.67%	0.50%	5.00%	3219	729.69
6201	3313	SIDEWALK RUNNING SLOPE	13.50	0.20	1.48%	0.50%	5.00%	3300	730.67
								3313	730.52

ILLINOIS IOWA WISCONSIN OWNER/DEVELOPER:

CITY OF DIXON

121 WEST 2ND STREET

DIXON, IL 61021

PROJECT AND LOCATION:

CITY OF DIXON STREETS [

CITY OF DIXON STREETS PROGRAM FY 2020 DIXON, IL

		REVISIONS	
DRAWN BY: YJ/JMV	REV. NO.	DESCRIPTION	
APPROVED BY: NJC			
DATE: 10/25/19			
SCALE: AS NOTED			

ADA RAMPS — 4TH AVENUE & SCHOOL

SET TYPE: PRELIMINARY


G:\C3D\18\18-833A\Plans\18-833 A - PLANS.dwg, 4TH & School

JOB NUMBER:

18-833A

SHEET NUMBER:

21 of 35

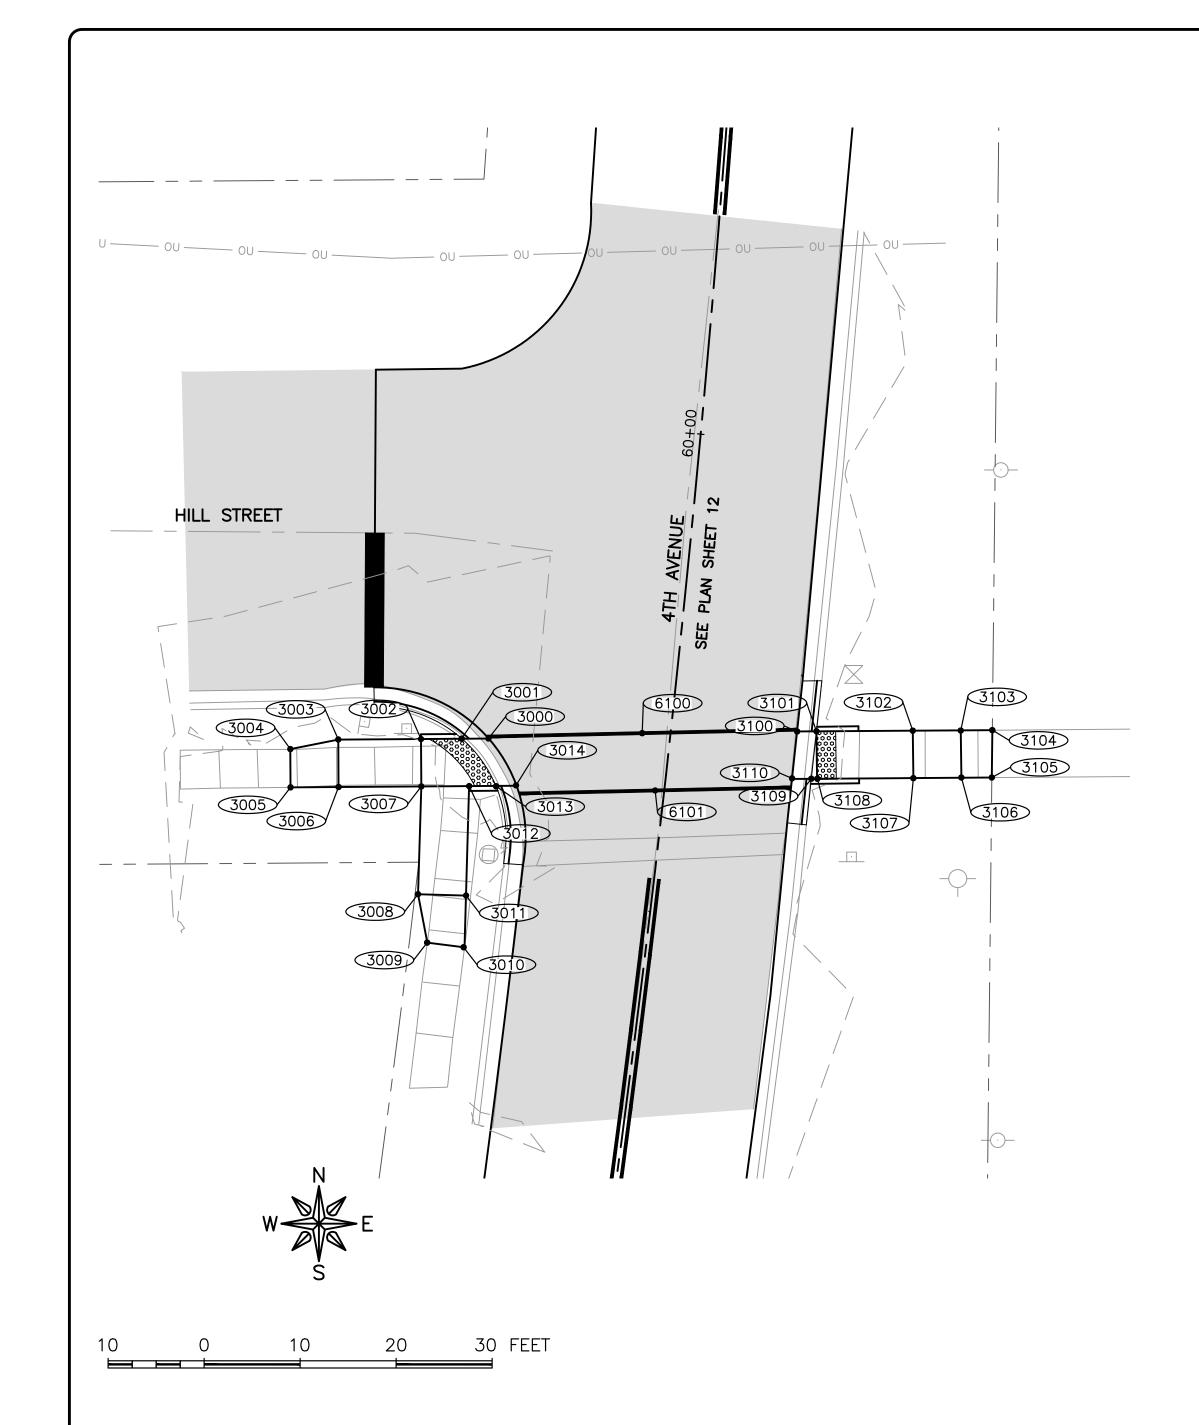

POINT TO POINT		SIDEWALK DESIGNATIONS	DISTANCE		COMMENTS	FOR INFORMATION ONLY: VALUES USED TO DETERMINE DESIGNED SLOPES						
			FT	FT	%	MIN.	MAX.		POINT	STATION	OFFSET	ELEVATION
	Γ	T	T	T T	/							
3000	3001	SIDEWALK RUNNING SLOPE	2.00	0.03	1.50%	0.50%	5.00%		3000			741.77
3001	3002	LANDING	4.25	0.04	0.94%	0.10%	2.00%		3001			741.80
3002	3003	SIDEWALK RUNNING SLOPE	8.50	0.31	3.65%	0.50%	5.00%		3002			741.84
3003	3004	SIDEWALK RUNNING SLOPE	5.00	0.10	2.00%	0.50%	5.00%		3003			742.15
3004	3005	SIDEWALK CROSS SLOPE	4.00	0.13	3.25%	0.50%	2.00%	MATCH EXISTING	3004			742.05
3005	3006	SIDEWALK RUNNING SLOPE	5.00	0.04	0.80%	0.50%	5.00%		3005			742.18
3006	3007	SIDEWALK RUNNING SLOPE	8.50	0.31	3.65%	0.50%	5.00%		3006			742.22
3007	3008	SIDEWALK RUNNING SLOPE	11.00	0.27	2.45%	0.50%	5.00%		3007			741.91
3008	3009	SIDEWALK RUNNING SLOPE	5.00	0.10	2.00%	0.50%	5.00%		3008			742.18
3009	3010	SIDEWALK CROSS SLOPE	4.00	0.18	4.50%	0.50%	2.00%	MATCH EXISTING	3009	-		742.28
3010	3011	SIDEWALK RUNNING SLOPE	5.00	0.03	0.60%	0.50%	5.00%		3010	1		742.10
3011	3012	SIDEWALK RUNNING SLOPE	11.00	0.27	2.45%	0.50%	5.00%		3011	1		742.13
3012	3013	LANDING	2.75	0.01	0.36%	0.10%	2.00%		3012			741.86
3013	3014	SIDEWALK RUNNING SLOPE	2.00	0.02	1.00%	0.50%	5.00%		3013			741.85
3000	3014	SIDEWALK CROSS SLOPE	5.75	0.06	1.04%	0.50%	2.00%		3014			741.83
3001	3013	LANDING	6.00	0.05	0.83%	0.10%	2.00%					
3003	3006	SIDEWALK CROSS SLOPE	5.00	0.07	1.40%	0.50%	2.00%					
3002	3007	LANDING	5.00	0.07	1.40%	0.10%	2.00%					
3012	3007	LANDING	5.00	0.05	1.00%	0.10%	2.00%					
3008	3011	SIDEWALK CROSS SLOPE	5.00	0.05	1.00%	0.50%	2.00%					
3100	3101	SIDEWALK RUNNING SLOPE	2.00	0.03	1.50%	0.50%	5.00%		3100			742.73
3101	3102	RAMP RUNNING SLOPE	10.00	0.63	6.30%	0.50%	8.33%		3101			742.76
3102	3103	LANDING	5.00	0.07	1.40%	0.10%	2.00%		3102			743.39
3103	3104	RAMP RUNNING SLOPE	3.00	0.06	2.00%	0.50%	8.33%		3103			743.46
3104	3105	RAMP CROSS SLOPE	5.00	0.07	1.40%	0.10%	2.00%	MATCH EXISTING	3104			743.52
3105	3106	RAMP RUNNING SLOPE	3.00	0.20	6.67%	0.50%	8.33%		3105			743.59
3106	3107	LANDING	5.00	0.07	1.40%	0.10%	2.00%		3106			743.39
3107	3108	RAMP RUNNING SLOPE	10.00	0.62	6.20%	0.50%	8.33%		3107			743.32
3108	3109	LANDING	0.50	0.01	2.00%	0.10%	2.00%		3108			742.70
3109	3110	SIDEWALK RUNNING SLOPE	2.00	0.02	1.00%	0.50%	5.00%		3109			742.69
3100	3109	SIDEWALK CROSS SLOPE	5.00	0.04	0.80%	0.50%	2.00%		3110			742.67
3101	3108	LANDING	5.00	0.06	1.20%	0.10%	2.00%					
3102	3107	LANDING	5.00	0.07	1.40%	0.10%	2.00%					
3103	3106	LANDING	6.00	0.07	1.17%	0.10%	2.00%					
3101	3109	LANDING	5.00	0.07	1.40%	0.10%	2.00%					
		•	'	•			,			•		
6100	6101	SIDEWALK CROSS SLOPE	6.00	0.09	1.50%	0.50%	2.00%		6100			742.39
6100	3000	SIDEWALK RUNNING SLOPE	16.00	0.62	3.88%	0.50%	5.00%		6101			742.48
6100	3100	SIDEWALK RUNNING SLOPE	16.00	0.34	2.13%	0.50%	5.00%		3000			741.77
6101	3014	SIDEWALK RUNNING SLOPE	14.00	0.64	4.57%	0.50%	5.00%		3014	1		741.84
6101	3110	SIDEWALK RUNNING SLOPE	14.00	0.19	1.36%	0.50%	5.00%		3100	1		742.73
_ · • ·	2		1		1.00,0	0.00,0	1 2.20,0		3110	†		742.67



ILLINOIS IOWA WISCONSIN OWNER/DEVELOPER:

CITY OF DIXON

121 WEST 2ND STREET

DIXON, IL 61021

PROJECT AND LOCATION:

CITY OF DIXON STREETS PROGRAM

FY 2020

DIXON, IL

DRAWN BY: YJ/JMV
APPROVED BY: NJC
DATE: 10/25/19
SCALE: AS NOTED

	REVISIONS	
REV. NO.	DESCRIPTION	DATE

ADA RAMPS — 4TH AVENUE & HILL


SET TYPE: PRELIMINARY
G:\C3D\18\18-833A\Plans\18-833 A - PLANS.dwg, 4TH & Hill

JOB NUMBER:

18-833A

SHEET NUMBER:

22 of 35

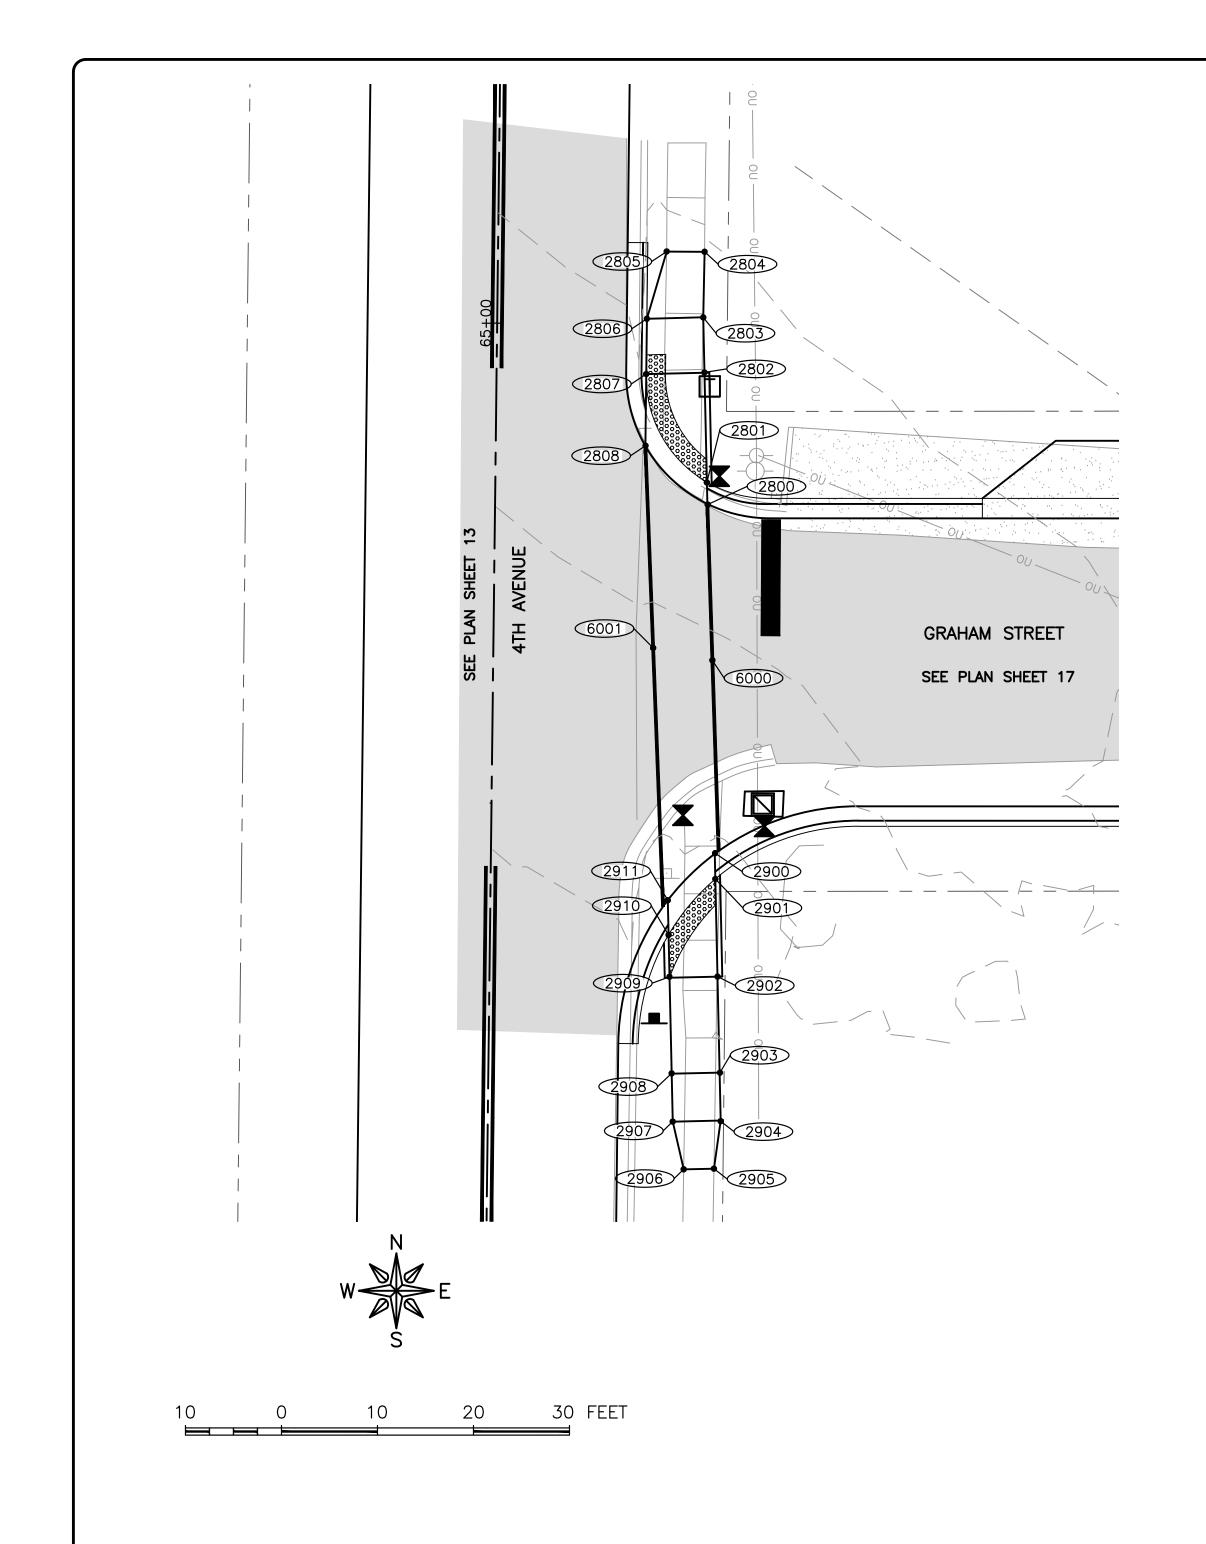

POINT T	O POINT	SIDEWALK DESIGNATIONS	DISTANCE	Δ ELEVATION	SLOPE		BLE RANGE or NEG.)	COMMENTS	FOR INFORMATION ONLY: VALUES USED TO DETERMINE DESIGNED SLOPES				
			FT	FT	%	MIN.	MAX.		POINT	STATION OFFSET	ELEVATION		
2800	2801	SIDEWALK RUNNING SLOPE	2.25	0.03	1.33%	0.50%	5.00%		2800		741.59		
2801	2802	LANDING	11.50	0.18	1.57%	0.10%	2.00%		2801		741.62		
2802	2803	SIDEWALK RUNNING SLOPE	5.75	0.20	3.48%	0.50%	5.00%		2802		741.44		
2803	2804	SIDEWALK RUNNING SLOPE	7.00	0.24	3.43%	0.50%	5.00%		2803		741.24		
2804	2805	SIDEWALK CROSS SLOPE	4.00	0.15	3.75%	0.50%	2.00%	MATCH EXISTING	2804		741.00		
2805	2806	SIDEWALK RUNNING SLOPE	7.00	0.02	0.29%	0.50%	5.00%		2805		741.15		
2806	2807	SIDEWALK RUNNING SLOPE	5.75	0.20	3.48%	0.50%	5.00%		2806		741.17		
2807	2808	SIDEWALK RUNNING SLOPE	7.50	0.10	1.33%	0.50%	5.00%		2807		741.37		
2800	2808	SIDEWALK CROSS SLOPE	9.00	0.12	1.33%	0.50%	2.00%		2808		741.47		
2801	2807	LANDING	13.50	0.25	1.85%	0.10%	2.00%						
2802	2807	LANDING	6.00	0.07	1.17%	0.10%	2.00%						
2803	2806	SIDEWALK CROSS SLOPE	6.00	0.07	1.17%	0.50%	2.00%						
2900	2901	SIDEWALK RUNNING SLOPE	2.50	0.04	1.60%	0.50%	5.00%		2900		742.34		
2901	2902	LANDING	10.00	0.13	1.30%	0.10%	2.00%		2901		742.38		
2902	2903	RAMP RUNNING SLOPE	10.00	0.75	7.50%	0.50%	8.33%		2902		742.51		
2903	2904	LANDING	5.00	0.07	1.40%	0.10%	2.00%		2903		743.26		
2904	2905	SIDEWALK RUNNING SLOPE	5.00	0.24	4.80%	0.50%	5.00%		2904		743.33		
2905	2906	SIDEWALK CROSS SLOPE	4.00	0.04	1.00%	0.50%	2.00%		2905		743.57		
2906	2907	SIDEWALK RUNNING SLOPE	5.00	0.25	5.00%	0.50%	5.00%		2906		743.61		
2907	2908	LANDING	5.00	0.08	1.60%	0.10%	2.00%		2907		743.36		
2908	2909	RAMP RUNNING SLOPE	10.00	0.75	7.50%	0.50%	8.33%		2908		743.28		
2909	2910	SIDEWALK RUNNING SLOPE	4.50	0.07	1.56%	0.50%	5.00%		2909		742.53		
2910	2911	SIDEWALK RUNNING SLOPE	3.00	0.04	1.33%	0.50%	5.00%		2910		742.46		
2900	2911	SIDEWALK CROSS SLOPE	5.00	0.08	1.60%	0.50%	2.00%		2911		742.42		
2901	2910	LANDING	5.00	0.08	1.60%	0.10%	2.00%						
2902	2909	LANDING	5.00	0.02	0.40%	0.10%	2.00%						
2903	2908	LANDING	5.00	0.02	0.40%	0.10%	2.00%						
2904	2907	LANDING	5.00	0.03	0.60%	0.10%	2.00%						
6000	6001	SIDEWALK CROSS SLOPE	6.00	0.12	2.00%	0.50%	2.00%		6000		742.04		
6000	2800	SIDEWALK RUNNING SLOPE	16.00	0.45	2.81%	0.50%	5.00%		6001		742.16		
6000	2900	SIDEWALK RUNNING SLOPE	20.00	0.30	1.50%	0.50%	5.00%		2800		741.59		
6001	2808	SIDEWALK RUNNING SLOPE	22.00	0.69	3.14%	0.50%	5.00%		2808		741.47		
6001	2911	SIDEWALK RUNNING SLOPE	24.75	0.26	1.05%	0.50%	5.00%		2900		742.34		
									2911		742.42		

ILLINOIS IOWA WISCONSIN OWNER/DEVELOPER:

CITY OF DIXON
121 WEST 2ND STREET
DIXON, IL 61021

PROJECT AND LOCATION:

CITY OF DIXON STREETS PROGRAM

FY 2020

DIXON, IL

DRAWN BY: YJ/JMV
APPROVED BY: NJC
DATE: 10/25/19
SCALE: AS NOTED

	REVISIONS	
REV. NO.	DESCRIPTION	DATE

ADA RAMPS — 4TH AVENUE & GRAHAM


SET TYPE: PRELIMINARY
G:\C3D\18\18-833A\Plans\18-833 A - PLANS.dwg, 4TH & Graham

JOB NUMBER:

18-833A

SHEET NUMBER:

23 of 35

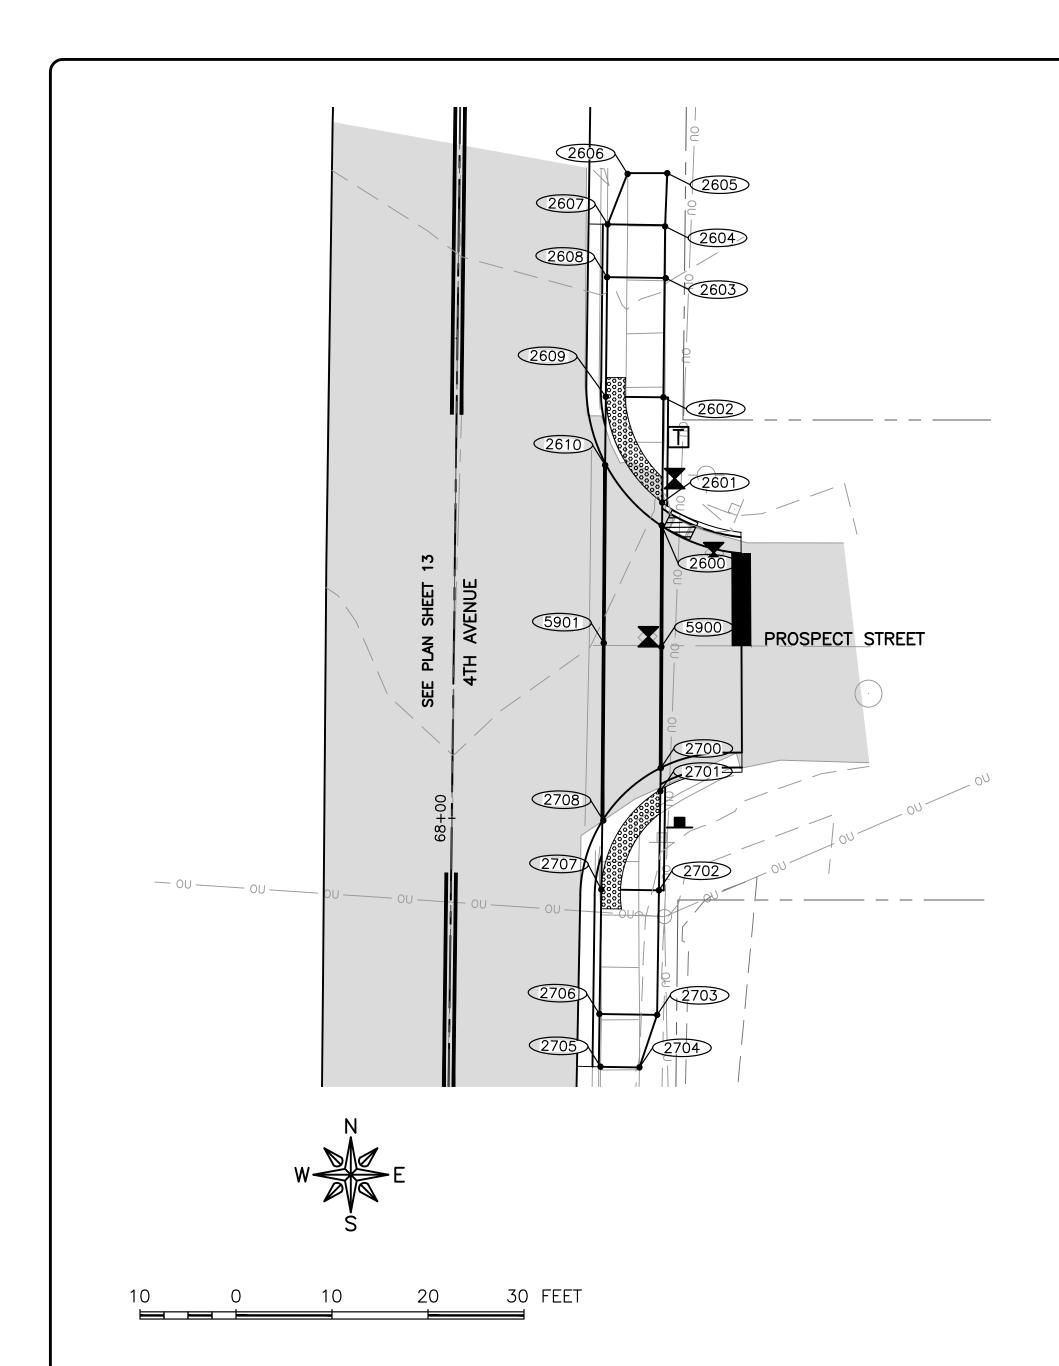

POINT TO POINT		SIDEWALK DESIGNATIONS	DISTANCE	DISTANCE $\Delta$ ELEVATION SLOPE ACCEPTABLE RANGE (POS. or NEG.) COMMENTS				COMMENTS	FOR INFORMATION ONLY: VALUES USED TO DETERMINE DESIGNED SLOPES					
			FT	FT	%	MIN.	MAX.		POINT	STATION	OFFSET	ELEVATION		
2600	2601	SIDEWALK RUNNING SLOPE	2.50	0.03	1.20%	0.50%	5.00%		2600			737.96		
2601	2602	LANDING	11.00	0.09	0.82%	0.10%	2.00%		2601			737.99		
2602	2603	RAMP RUNNING SLOPE	12.50	0.82	6.56%	0.50%	8.33%		2602			738.08		
2603	2604	LANDING	5.50	0.07	1.27%	0.10%	2.00%		2603			738.90		
2604	2605	RAMP RUNNING SLOPE	5.50	0.30	5.45%	0.50%	8.33%		2604			738.97		
2605	2606	RAMP CROSS SLOPE	4.00	0.06	1.50%	0.10%	2.00%	MATCH EXISTING	2605			739.27		
2606	2607	RAMP RUNNING SLOPE	5.50	0.43	7.82%	0.50%	8.33%		2606			739.33		
2607	2608	LANDING	5.50	0.08	1.45%	0.10%	2.00%		2607			738.90		
2608	2609	RAMP RUNNING SLOPE	11.00	0.80	7.27%	0.50%	8.33%		2608			738.82		
2609	2610	SIDEWALK RUNNING SLOPE	7.00	0.04	0.57%	0.50%	5.00%		2609			738.02		
2600	2610	LANDING	8.75	0.10	1.14%	0.10%	2.00%		2610			738.06		
2601	2609	LANDING	13.00	0.03	0.23%	0.10%	2.00%							
2602	2609	LANDING	6.00	0.06	1.00%	0.10%	2.00%							
2603	2608	LANDING	6.00	0.08	1.33%	0.10%	2.00%							
2604	2607	LANDING	6.00	0.07	1.17%	0.10%	2.00%							
2700	2701	SIDEWALK RUNNING SLOPE	2.50	0.03	1.20%	0.50%	5.00%		2700			737.56		
2701	2702	LANDING	10.50	0.06	0.57%	0.10%	2.00%		2701			737.59		
2702	2703	RAMP RUNNING SLOPE	13.00	0.61	4.69%	0.50%	8.33%		2702			737.65		
2703	2704	SIDEWALK RUNNING SLOPE	5.75	0.07	1.22%	0.50%	5.00%		2703			737.04		
2704	2705	SIDEWALK CROSS SLOPE	4.00	0.36	9.00%	0.50%	2.00%	MATCH EXISTING	2704			736.97		
2705	2706	SIDEWALK RUNNING SLOPE	5.50	0.22	4.00%	0.50%	5.00%		2705			737.33		
2706	2707	RAMP RUNNING SLOPE	13.00	0.57	4.38%	0.50%	8.33%		2706			737.11		
2707	2708	SIDEWALK RUNNING SLOPE	7.25	0.02	0.28%	0.50%	5.00%		2707			737.68		
2700	2708	LANDING	8.25	0.10	1.21%	0.10%	2.00%		2708			737.66		
2701	2707	LANDING	12.50	0.09	0.72%	0.10%	2.00%							
2702	2707	LANDING	6.00	0.03	0.50%	0.10%	2.00%							
2703	2706	SIDEWALK CROSS SLOPE	6.00	0.07	1.17%	0.50%	2.00%							
5900	5901	SIDEWALK CROSS SLOPE	6.00	0.07	1.17%	0.50%	2.00%		5900			737.89		
5900	2600	SIDEWALK RUNNING SLOPE	13.00	0.07	0.54%	0.50%	5.00%		5901			737.96		
5900	2700	SIDEWALK RUNNING SLOPE	13.00	0.33	2.54%	0.50%	5.00%		2600			737.96		
5901	2610	SIDEWALK RUNNING SLOPE	18.50	0.10	0.54%	0.50%	5.00%		2610			738.06		
5901	2708	SIDEWALK RUNNING SLOPE	18.50	0.30	1.62%	0.50%	5.00%		2700			737.56		
									2708			737.66		

ILLINOIS IOWA WISCONSIN OWNER/DEVELOPER:

CITY OF DIXON

121 WEST 2ND STREET

DIXON, IL 61021

PROJECT AND LOCATION:

CITY OF DIXON STREETS PROGRAM
FY 2020
DIXON, IL

DRAWN BY: YJ/JMV
APPROVED BY: NJC
DATE: 10/25/19
SCALE: AS NOTED

	REVISIONS	
REV. NO.	DESCRIPTION	DATE

ADA RAMPS — 4TH AVENUE & PROSPECT

18-833A

SHEET NUMBER:
24 of 35


JOB NUMBER:

ENGINEERING & ENVIRONMENTAL ILLINOIS DESIGN FIRM NO. 184-003525

PLOT DATE: 2/18/20 © 2020 FEHR GRAHAM

Contract # 85693

SET TYPE: PRELIMINARY
G:\C3D\18\18-833A\Plans\18-833 A - PLANS.dwg, 4TH & Prospect

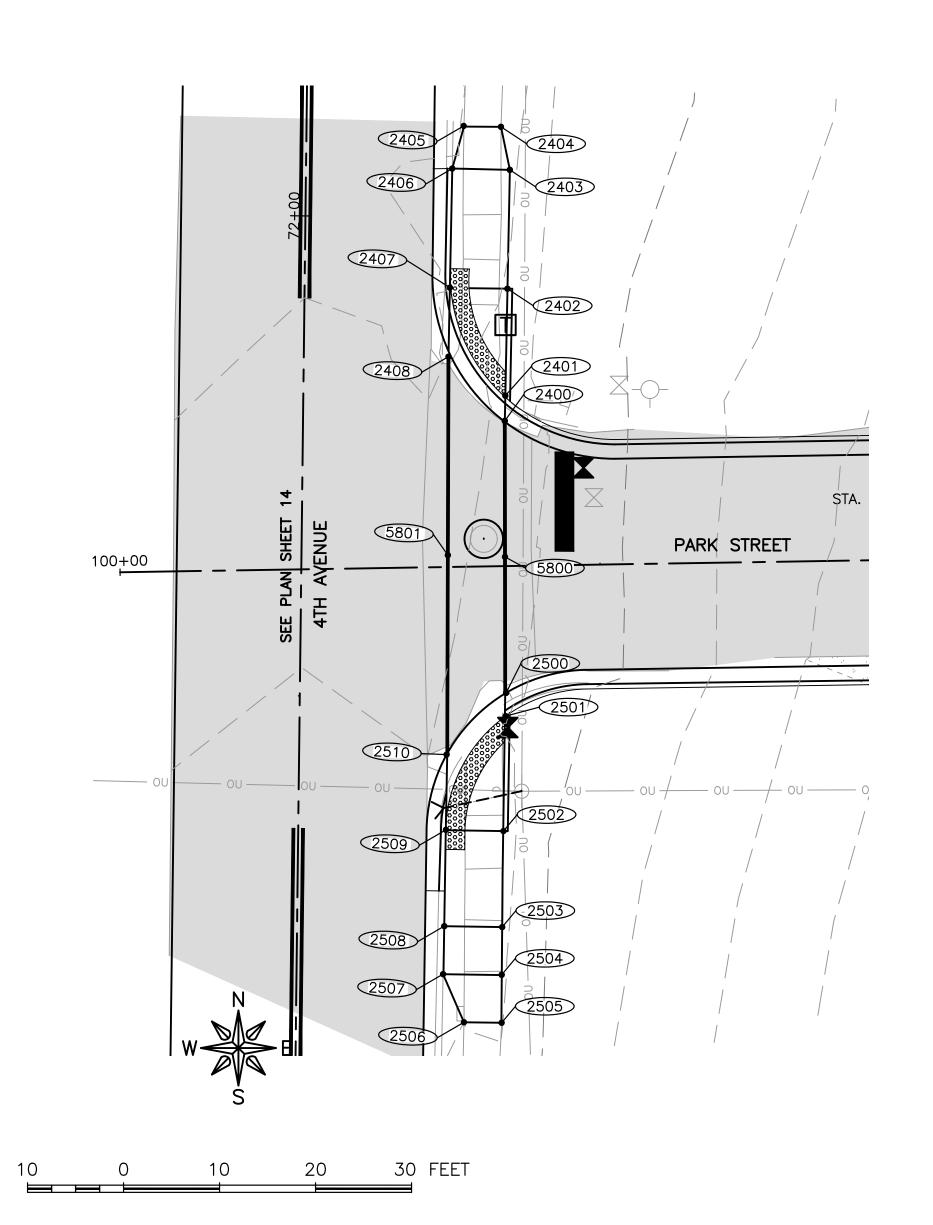

POINT T	O POINT	SIDEWALK DESIGNATIONS	(POS. of NEG.)				COMMENTS	Y: GNED SLOPES				
			FT	FT	%	MIN.	MAX.		POINT	STATION	OFFSET	ELEVATION
2400	2401	SIDEWALK RUNNING SLOPE	2.50	0.03	1.20%	0.50%	5.00%		2400			737.43
2401	2402	LANDING	10.50	0.09	0.86%	0.10%	2.00%		2401			737.40
2402	2403	SIDEWALK RUNNING SLOPE	12.50	0.07	0.56%	0.50%	5.00%		2402			737.31
2403	2404	SIDEWALK RUNNING SLOPE	4.50	0.02	0.44%	0.50%	5.00%		2403			737.24
2404	2405	SIDEWALK CROSS SLOPE	4.00	0.15	3.75%	0.50%	2.00%	MATCH EXISTING	2404			737.26
2405	2406	SIDEWALK RUNNING SLOPE	4.50	0.05	1.11%	0.50%	5.00%		2405			737.11
2406	2407	SIDEWALK RUNNING SLOPE	12.50	0.07	0.56%	0.50%	5.00%		2406			737.16
2407	2408	SIDEWALK RUNNING SLOPE	7.25	0.10	1.38%	0.50%	5.00%		2407			737.23
2400	2408	SIDEWALK CROSS SLOPE	7.75	0.10	1.29%	0.50%	2.00%		2408			737.33
2401	2407	LANDING	12.00	0.17	1.42%	0.10%	2.00%					
2402	2407	LANDING	6.00	0.08	1.33%	0.10%	2.00%					
2403	2406	SIDEWALK CROSS SLOPE	6.00	0.08	1.33%	0.50%	2.00%					
2500	2501	SIDEWALK RUNNING SLOPE	2.50	0.03	1.20%	0.50%	5.00%		2500			737.87
2501	2502	LANDING	12.00	0.18	1.50%	0.10%	2.00%		2501			737.90
2502	2503	RAMP RUNNING SLOPE	10.00	0.75	7.50%	0.50%	8.33%		2502			738.08
2503	2504	LANDING	5.00	0.07	1.40%	0.10%	2.00%		2503			738.83
2504	2505	SIDEWALK RUNNING SLOPE	5.00	0.09	1.80%	0.50%	5.00%		2504			738.90
2505	2506	SIDEWALK RUNNING SLOPE	4.00	0.01	0.25%	0.50%	5.00%		2505			738.99
2506	2507	SIDEWALK RUNNING SLOPE	5.00	0.17	3.40%	0.50%	5.00%		2506			738.98
2507	2508	LANDING	5.00	0.06	1.20%	0.10%	2.00%		2507			738.81
2508	2509	RAMP RUNNING SLOPE	10.00	0.70	7.00%	0.50%	8.33%		2508			738.75
2509	2510	LANDING	13.75	0.09	0.65%	0.10%	2.00%		2509			738.05
2502	2509	LANDING	6.00	0.03	0.50%	0.10%	2.00%		2510			737.96
2503	2508	LANDING	6.00	0.08	1.33%	0.10%	2.00%					
2504	2507	LANDING	6.00	0.09	1.50%	0.10%	2.00%					
2500	2510	LANDING	6.00	0.09	1.50%	0.10%	2.00%					
2501	2509	LANDING	13.50	0.15	1.11%	0.10%	2.00%					
									•		•	
5800	5801	SIDEWALK CROSS SLOPE	6.00	0.12	2.00%	0.50%	2.00%		5800			737.57
5800	2400	SIDEWALK RUNNING SLOPE	14.00	0.14	1.00%	0.50%	5.00%		5801			737.45
5800	2500	SIDEWALK RUNNING SLOPE	14.00	0.30	2.14%	0.50%	5.00%		2400			737.43
5801	2408	SIDEWALK RUNNING SLOPE	21.00	0.12	0.57%	0.50%	5.00%		2408			737.33
5801	2510	SIDEWALK RUNNING SLOPE	21.00	0.51	2.43%	0.50%	5.00%		2500			737.87
									2510			737.96

ILLINOIS IOWA

WISCONSIN

OWNER/DEVELOPER:

CITY OF DIXON

121 WEST 2ND STREET

DIXON, IL 61021

PROJECT AND LOCATION:

CITY OF DIXON STREETS PROGRAM
FY 2020
DIXON, IL

DRAWN BY: YJ/JMV
APPROVED BY: NJC
DATE: 10/25/19
SCALE: AS NOTED

	REVISIONS	
REV. NO.	DESCRIPTION	DATE

DRAWING:

ADA RAMPS — 4TH AVENUE & PARK


SET TYPE: PRELIMINARY
G:\C3D\18\18-833A\Plans\18-833 A - PLANS.dwg, 4TH & Park

JOB NUMBER:

18-833A

SHEET NUMBER:

**25** of **35** 

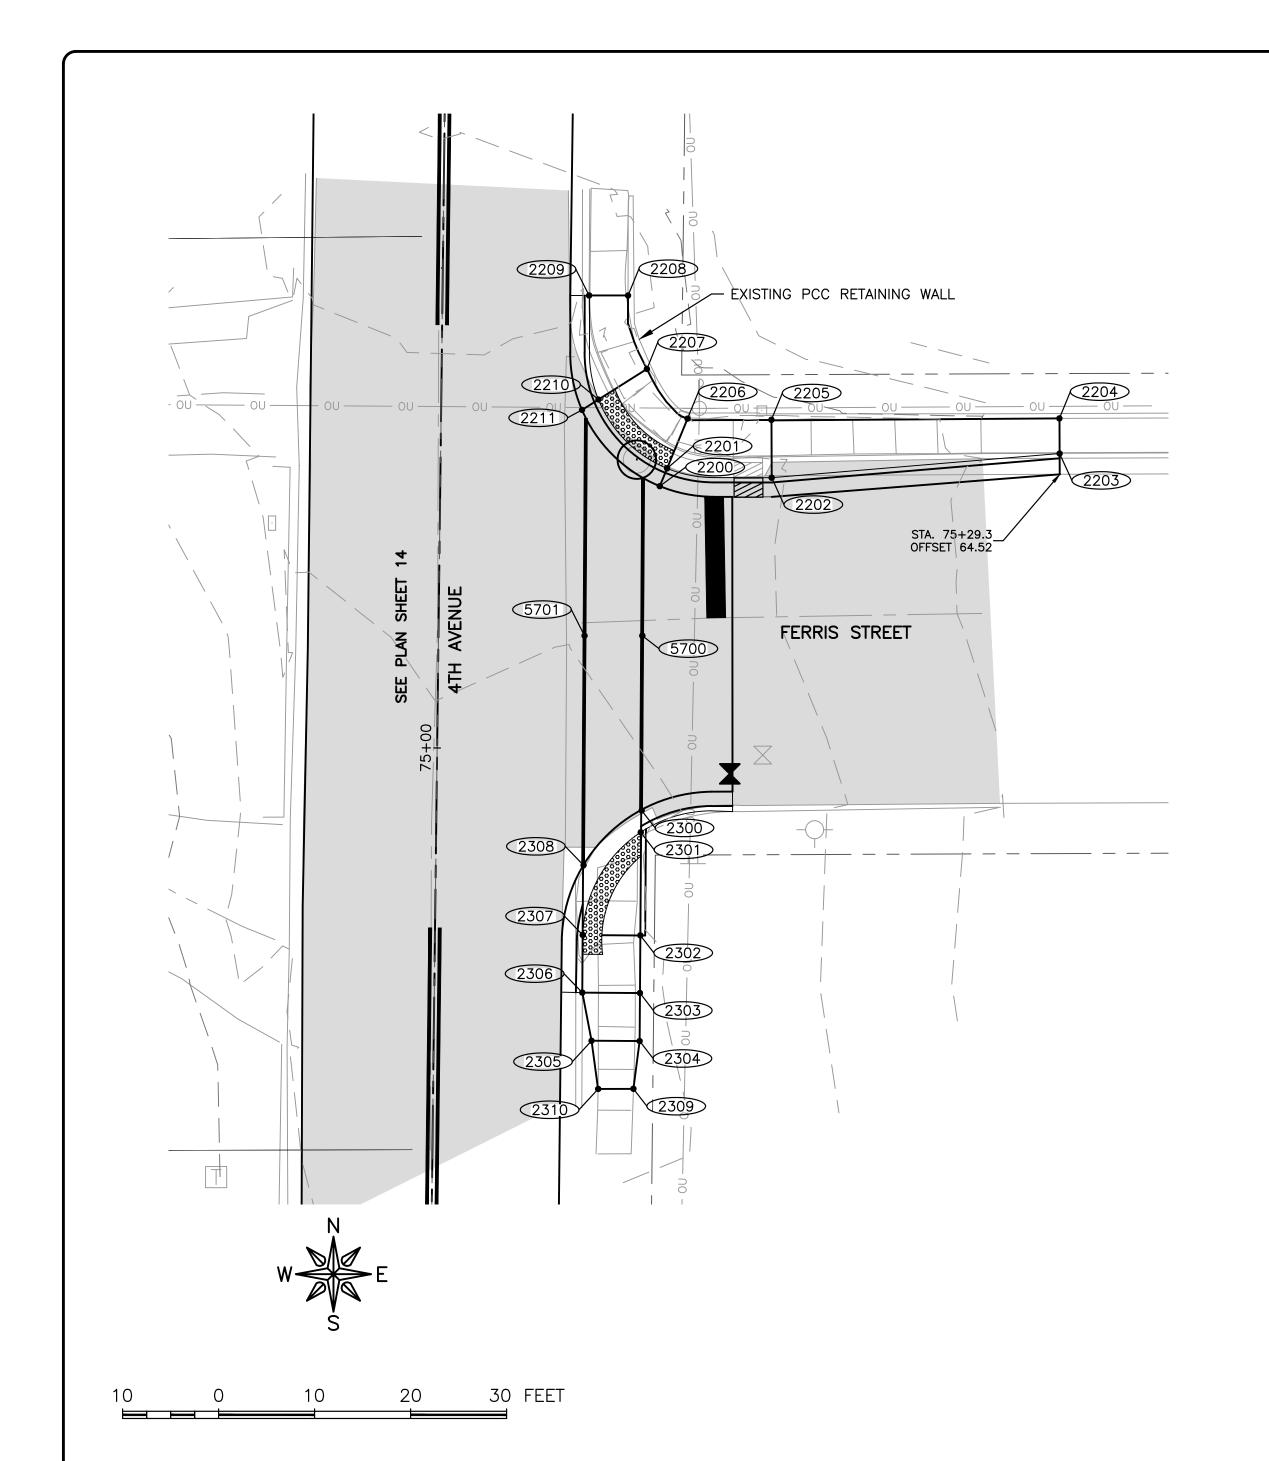

2200   2201   SIDEWALK RUNNING SLOPE   2.00   0.38   1.50%   0.30%	POINT 1	TO POINT	SIDEWALK DESIGNATIONS	DISTANCE A ELEVATION SLOPE ACCEPTABLE RANGE (POS. or NEG.) COMMENTS				FOR INFORMATION ONLY: VALUES USED TO DETERMINE DESIGNED SLOPES					
22211   22212   22203   SIDEWALK RUNNING SLOPE   30 00   1.02   3.40%   0.50%   5.50%   5.50%   2201   2202   2203   2204   SIDEWALK RUNNING SLOPE   30 00   1.02   3.40%   0.50%   5.50%   5.50%   2203   2204   2205   SIDEWALK RUNNING SLOPE   30 00   1.01   3.37%   0.50%   5.50%   5.50%   MATCH EXISTING   2203   2206   2206   RAMP RUNNING SLOPE   8.70   0.77   4.23%   0.50%   5.50%   5.50%   MATCH EXISTING   2206   2206   RAMP RUNNING SLOPE   8.70   0.77   4.23%   0.50%   5.50%   5.50%   0.20%   2.206   2206   2207   2208   SIDEWALK CROSS SLOPE   4.00   0.127   0.510%   0.50%   5.50%   0.50%   8.33%   2.20%   2208   2209   2210   2209   2210   2209   2210   2209   2210   2209   2210   2209   2210   2209   2210   2209   2210   2209   2210   2209   2210   2209   2210   2209   2210   2209   2210   2209   2210   2209   2210   2209   2210   2209   2209   2210   2209				FT	FT	%	MIN.	MAX.		POINT	STATION	OFFSET	ELEVATION
2201   2202   2203   SIDEWALK RUNNING SLOPE   30.00   1.02   3.40%   0.50%   6.30%   2.00%   MATCH EXISTING   2003   2204   2205   SIDEWALK CROSS SLOPE   4.00   0.05   1.50%   0.50%   0.50%   5.00%   2.00%   MATCH EXISTING   2203   2204   2205   SIDEWALK RUNNING SLOPE   30.00   1.01   3.37%   0.05%   5.00%   5.00%   MATCH EXISTING   2204   2206   RAMP RUNNING SLOPE   8.70   0.77   4.23%   0.05%   5.00%   2.20%   2206   RAMP RUNNING SLOPE   8.00   0.40   6.00%   0.10%   2.20%   2.		1											
2202   2203   SIDEWALK RUNNING SLOPE   30.00   1.02   3.40%   0.59%   5.00%     2.00%	2200	2201	SIDEWALK RUNNING SLOPE	2.00	0.03	1.50%	0.50%	5.00%		2200			732.71
2203   2204   SDEWALK CROSS SLOPE   4.00   0.06   1.50%   0.50%   2.00%   MATCH EXISTING   2203   2204   2205   SDEWALK RUNNING SLOPE   3.000   1.01   3.37%   0.50%   0.50%   MATCH EXISTING   2204   2205   2206   RAMP RUNNING SLOPE   0.75   0.37   4.23%   0.50%   0.50%   MATCH EXISTING   2205   2206   2207   LANDING   7.00   0.08   0.86%   0.10%   2.00%   MATCH EXISTING   2207   2208   SDEWALK RUNNING SLOPE   8.00   0.48   0.00%   0.50%   0.50%   MATCH EXISTING   2207   2208   SDEWALK RUNNING SLOPE   4.00   0.02   0.50%   0.50%   MATCH EXISTING   2207   2208   SDEWALK RUNNING SLOPE   4.00   0.02   0.50%   0.50%   0.50%   MATCH EXISTING   2208   2209   2210   RAMP RUNNING SLOPE   11.00   0.54   4.91%   0.50%   0.50%   8.33%   2200   2210   SDEWALK RUNNING SLOPE   2.00   0.03   1.50%   0.50%   0.50%   2.20%   2200   2211   SDEWALK RUNNING SLOPE   2.00   0.03   1.50%   0.50%   0.50%   2.20%   2200   2211   SDEWALK RUNNING SLOPE   2.00   0.03   1.50%   0.50%   0.50%   2.20%   2	2201	2202	RAMP RUNNING SLOPE	11.00	0.38	3.45%	0.50%	8.33%		2201			732.74
2204   2205   SIDEWALK RUNNING SLOPE   30.00   1.01   3.37%   0.50%   5.00%   MATCH EXISTING   2204	2202	2203	SIDEWALK RUNNING SLOPE	30.00	1.02	3.40%	0.50%	5.00%		2202			733.12
2205   2206   RAMP RUNNING SLOPE   8.75   0.37   4.23%   0.56%   8.33%   2205	2203	2204	SIDEWALK CROSS SLOPE	4.00	0.06	1.50%	0.50%	2.00%	MATCH EXISTING	2203			734.14
2206   2207	2204	2205	SIDEWALK RUNNING SLOPE	30.00	1.01	3.37%	0.50%	5.00%	MATCH EXISTING	2204			734.20
2207   2208   SIDEWALK RUNNING SLOPE   8.00   0.48   8.00%   0.50%   5.00%   MATCH EXISTING   2207	2205	2206	RAMP RUNNING SLOPE	8.75	0.37	4.23%	0.50%	8.33%		2205			733.19
2208   2209   SIDEWALK CROSS SLOPE   4.00   0.02   0.50%   0.50%   2.00%   MATCH EXISTING   2208   2209   2210   2210   2211   SIDEWALK CROSS SLOPE   11.00   0.54   4.91%   0.50%   8.33%   2209   2210   2210   2211   SIDEWALK CROSS SLOPE   11.50   0.06   0.52%   0.50%   2.00%   2211   2205   2	2206	2207	LANDING	7.00	0.06	0.86%	0.10%	2.00%		2206			732.82
2210	2207	2208	SIDEWALK RUNNING SLOPE	8.00	0.48	6.00%	0.50%	5.00%	MATCH EXISTING	2207			732.76
2210   2211   SIDEWALK RUNNING SLOPE   2.00   0.03   1.50%   0.50%   5.00%   5.00%   2210	2208	2209	SIDEWALK CROSS SLOPE	4.00	0.02	0.50%	0.50%	2.00%	MATCH EXISTING	2208			733.24
2200   2211   SIDEWALK CROSS SLOPE   11.50   0.06   0.52%   0.50%   2.00%   2.211	2209	2210	RAMP RUNNING SLOPE	11.00	0.54	4.91%	0.50%	8.33%		2209			733.22
2201   2210	2210	2211	SIDEWALK RUNNING SLOPE	2.00	0.03	1.50%	0.50%	5.00%		2210			732.68
2201   2206	2200	2211	SIDEWALK CROSS SLOPE	11.50	0.06	0.52%	0.50%	2.00%		2211			732.65
2202   2205   SIDEWALK CROSS SLOPE   6.00   0.07   1.17%   0.50%   2.00%   MATCH EXISTING	2201	2210	LANDING	10.50	0.06	0.57%	0.10%	2.00%					
2207   2210   LANDING   6.00   0.08   1.33%   0.10%   2.00%	2201	2206	LANDING	5.50	0.08	1.45%	0.10%	2.00%					
2300   2301   SIDEWALK RUNNING SLOPE   2.25   0.03   1.33%   0.50%   5.00%   2300	2202	2205	SIDEWALK CROSS SLOPE	6.00	0.07	1.17%	0.50%	2.00%	MATCH EXISTING				
2301   2302	2207	2210	LANDING	6.00	0.08	1.33%	0.10%	2.00%					
2301   2302													
2302         2303         RAMP RUNNING SLOPE         6.00         0.13         2.17%         0.50%         8.33%         2302           2303         2304         SIDEWALK RUNNING SLOPE         5.00         0.11         2.20%         0.50%         5.00%         2303           2304         2305         SIDEWALK CROSS SLOPE         5.00         0.07         1.40%         0.50%         2.00%         2304           2305         2306         SIDEWALK RUNNING SLOPE         5.00         0.11         2.20%         0.50%         5.00%         2305           2306         2307         RAMP RUNNING SLOPE         6.00         0.13         2.17%         0.50%         8.33%         2306           2307         2308         SIDEWALK RUNNING SLOPE         7.00         0.14         2.00%         0.50%         5.00%         2307           2300         2308         LANDING         8.50         0.02         0.24%         0.10%         2.00%         2308           2301         2307         LANDING         13.00         0.09         0.69%         0.10%         2.00%         2309           2302         2307         LANDING         6.00         0.07         1.17%         0.10% <td< td=""><td>2300</td><td>2301</td><td>SIDEWALK RUNNING SLOPE</td><td>2.25</td><td>0.03</td><td>1.33%</td><td>0.50%</td><td>5.00%</td><td></td><td>2300</td><td></td><td></td><td>731.85</td></td<>	2300	2301	SIDEWALK RUNNING SLOPE	2.25	0.03	1.33%	0.50%	5.00%		2300			731.85
2303         2304         SIDEWALK RUNNING SLOPE         5.00         0.11         2.20%         0.50%         5.00%         2303         2304           2304         2305         SIDEWALK CROSS SLOPE         5.00         0.07         1.40%         0.50%         2.00%         2304         2304           2305         2306         SIDEWALK RUNNING SLOPE         5.00         0.11         2.20%         0.50%         5.00%         2305         2305           2306         2307         RAMP RUNNING SLOPE         6.00         0.13         2.17%         0.50%         8.33%         2306         2306         2307         2308         SIDEWALK RUNNING SLOPE         7.00         0.14         2.00%         0.50%         5.00%         2307         2307         2307         2307         2308         2307         2308         2307         2308         2307         2308         2308         2307         2308         2308         2308         2308         2308         2308         2308         2309         2308         2309         2309         2309         2309         2309         2309         2310         2309         2310         2309         2310         2309         2310         2306         200%         <	2301	2302	LANDING	10.75	0.16	1.49%	0.10%	2.00%		2301			731.88
2304         2305         SIDEWALK CROSS SLOPE         5.00         0.07         1.40%         0.50%         2.00%         2304         2304           2305         2306         SIDEWALK RUNNING SLOPE         5.00         0.11         2.20%         0.50%         5.00%         2305         2305           2306         2307         RAMP RUNNING SLOPE         6.00         0.13         2.17%         0.50%         8.33%         2306         2307           2307         2308         SIDEWALK RUNNING SLOPE         7.00         0.14         2.00%         0.50%         5.00%         2307           2300         2308         LANDING         8.50         0.02         0.24%         0.10%         2.00%         2308           2301         2307         LANDING         13.00         0.09         0.69%         0.10%         2.00%         2309           2302         2307         LANDING         6.00         0.07         1.17%         0.10%         2.00%         2310           2303         2306         SIDEWALK CROSS SLOPE         6.00         0.07         1.17%         0.50%         2.00%           2304         2309         SIDEWALK RUNNING SLOPE         5.00         0.10 <td< td=""><td>2302</td><td>2303</td><td>RAMP RUNNING SLOPE</td><td>6.00</td><td>0.13</td><td>2.17%</td><td>0.50%</td><td>8.33%</td><td></td><td>2302</td><td></td><td></td><td>732.04</td></td<>	2302	2303	RAMP RUNNING SLOPE	6.00	0.13	2.17%	0.50%	8.33%		2302			732.04
2305         2306         SIDEWALK RUNNING SLOPE         5.00         0.11         2.20%         0.50%         5.00%         2305         2305         2306         2307         RAMP RUNNING SLOPE         6.00         0.13         2.17%         0.50%         8.33%         2306         2306         2307         2308         SIDEWALK RUNNING SLOPE         7.00         0.14         2.00%         0.50%         5.00%         2307         2307         2307         2300         2308         LANDING         8.50         0.02         0.24%         0.10%         2.00%         2308         2308         2308         2308         2308         2308         2308         2309         2309         2309         2309         2309         2309         2309         2309         2309         2309         2309         2310         2309         2310         2306         2310         2310         2310         2310         2310         2310         2310         2309         2310         2309         2310         2309         2310         2309         2310         2309         2310         2309         2310         2309         2310         2309         2310         2309         2309         2309         2309         2309	2303	2304	SIDEWALK RUNNING SLOPE	5.00	0.11	2.20%	0.50%	5.00%		2303			731.91
2306         2307         RAMP RUNNING SLOPE         6.00         0.13         2.17%         0.50%         8.33%         2306         2307           2307         2308         SIDEWALK RUNNING SLOPE         7.00         0.14         2.00%         0.50%         5.00%         2307         1           2300         2308         LANDING         8.50         0.02         0.24%         0.10%         2.00%         2308         2308         2308         2309         2309         2309         2309         2309         2309         2309         2309         2309         2309         2309         2310         2309         2309 <td>2304</td> <td>2305</td> <td>SIDEWALK CROSS SLOPE</td> <td>5.00</td> <td>0.07</td> <td>1.40%</td> <td>0.50%</td> <td>2.00%</td> <td></td> <td>2304</td> <td></td> <td></td> <td>731.80</td>	2304	2305	SIDEWALK CROSS SLOPE	5.00	0.07	1.40%	0.50%	2.00%		2304			731.80
2307         2308         SIDEWALK RUNNING SLOPE         7.00         0.14         2.00%         0.50%         5.00%         2307            2300         2308         LANDING         8.50         0.02         0.24%         0.10%         2.00%         2308            2301         2307         LANDING         13.00         0.09         0.69%         0.10%         2.00%         2309            2302         2307         LANDING         6.00         0.07         1.17%         0.10%         2.00%         2310            2303         2306         SIDEWALK CROSS SLOPE         6.00         0.07         1.17%         0.50%         2.00%         2.00%            2304         2309         SIDEWALK RUNNING SLOPE         5.00         0.10         2.00%         0.50%         5.00%         MATCH EXISTING            2310         2305         SIDEWALK RUNNING SLOPE         5.00         0.18         3.60%         0.50%         5.00%         5.00%	2305	2306	SIDEWALK RUNNING SLOPE	5.00	0.11	2.20%	0.50%	5.00%		2305			731.73
2300         2308         LANDING         8.50         0.02         0.24%         0.10%         2.00%         2308         2308         2309         2309         2309         2309         2309         2309         2309         2309         2309         2309         2309         2309         2309         2309         2309         2309         2310         2309         2310         2309         2310         2309         2310         2309         2310         2309         2310         2309         2310         2309         2310         2309         2310         2309         2310         2309         2310         2309         2310         2309         2310         2309	2306	2307	RAMP RUNNING SLOPE	6.00	0.13	2.17%	0.50%	8.33%		2306			731.84
2301         2307         LANDING         13.00         0.09         0.69%         0.10%         2.00%         2309         13.00         0.09         0.69%         0.10%         2.00%         2309         2310         2310         2309         2310         2309         2310         2309         2310         2309         2310         2309         2310         2309         2310         2309         2310         2309         2310         2309         2310         2309	2307	2308	SIDEWALK RUNNING SLOPE	7.00	0.14	2.00%	0.50%	5.00%		2307			731.97
2302         2307         LANDING         6.00         0.07         1.17%         0.10%         2.00%         2310           2303         2306         SIDEWALK CROSS SLOPE         6.00         0.07         1.17%         0.50%         2.00%           2304         2309         SIDEWALK RUNNING SLOPE         5.00         0.10         2.00%         0.50%         5.00%           2309         2310         SIDEWALK CROSS SLOPE         4.00         0.15         3.75%         0.50%         2.00%         MATCH EXISTING           2310         2305         SIDEWALK RUNNING SLOPE         5.00         0.18         3.60%         0.50%         5.00%	2300	2308	LANDING	8.50	0.02	0.24%	0.10%	2.00%		2308			731.83
2303         2306         SIDEWALK CROSS SLOPE         6.00         0.07         1.17%         0.50%         2.00%           2304         2309         SIDEWALK RUNNING SLOPE         5.00         0.10         2.00%         0.50%         5.00%           2309         2310         SIDEWALK CROSS SLOPE         4.00         0.15         3.75%         0.50%         2.00%         MATCH EXISTING           2310         2305         SIDEWALK RUNNING SLOPE         5.00         0.18         3.60%         0.50%         5.00%	2301	2307	LANDING	13.00	0.09	0.69%	0.10%	2.00%		2309			731.70
2304         2309         SIDEWALK RUNNING SLOPE         5.00         0.10         2.00%         0.50%         5.00%           2309         2310         SIDEWALK CROSS SLOPE         4.00         0.15         3.75%         0.50%         2.00%         MATCH EXISTING           2310         2305         SIDEWALK RUNNING SLOPE         5.00         0.18         3.60%         0.50%         5.00%	2302	2307	LANDING	6.00	0.07	1.17%	0.10%	2.00%		2310			731.55
2309         2310         SIDEWALK CROSS SLOPE         4.00         0.15         3.75%         0.50%         2.00%         MATCH EXISTING           2310         2305         SIDEWALK RUNNING SLOPE         5.00         0.18         3.60%         0.50%         5.00%	2303	2306	SIDEWALK CROSS SLOPE	6.00	0.07	1.17%	0.50%	2.00%					
2310 2305 SIDEWALK RUNNING SLOPE 5.00 0.18 3.60% 0.50% 5.00%	2304	2309	SIDEWALK RUNNING SLOPE	5.00	0.10	2.00%	0.50%	5.00%					
	2309	2310	SIDEWALK CROSS SLOPE	4.00	0.15	3.75%	0.50%	2.00%	MATCH EXISTING				
5700	2310	2305	SIDEWALK RUNNING SLOPE	5.00	0.18	3.60%	0.50%	5.00%					
5700 5701 SIDEWALK CROSS SLODE 5.00 0.00 1.500/ 0.500/ 0.500/ 5.700				1			1	1		•	1		
3700   3701   31DEVVALK CROSS SLOPE   0.00   0.08   1.30%   0.50%   2.00%       5700     5700	5700	5701	SIDEWALK CROSS SLOPE	6.00	0.09	1.50%	0.50%	2.00%		5700			732.36
5700 2200 SIDEWALK RUNNING SLOPE 18.00 0.35 1.94% 0.50% 5.00% 5701	5700	2200	SIDEWALK RUNNING SLOPE	18.00	0.35	1.94%	0.50%	5.00%		5701			732.27
5700 2300 SIDEWALK RUNNING SLOPE 18.00 0.51 2.83% 0.50% 5.00% 2200			SIDEWALK RUNNING SLOPE	18.00		2.83%	0.50%	5.00%		2200			732.71
5701 2211 SIDEWALK RUNNING SLOPE 24.00 0.38 1.58% 0.50% 5.00% 2211			SIDEWALK RUNNING SLOPE	<del> </del>				5.00%		<u> </u>			732.65
5701 2308 SIDEWALK RUNNING SLOPE 24.00 0.44 1.83% 0.50% 5.00% 2300					+					+			731.85
2308													731.83

ILLINOIS IOWA WISCONSIN OWNER/DEVELOPER:

CITY OF DIXON

121 WEST 2ND STREET

DIXON, IL 61021

PROJECT AND LOCATION:

CITY OF DIXON STREETS PROGRAM

FY 2020

DIXON, IL

DRAWN BY: YJ/JMV
APPROVED BY: NJC
DATE: 10/25/19
SCALE: AS NOTED

	REVISIONS	
REV. NO.	DESCRIPTION	DATE

ADA RAMPS — 4TH AVENUE & FERRIS

SET TYPE: PRELIMINARY
G:\C3D\18\18-833A\Plans\18-833 A - PLANS.dwg, 4TH & Ferris

JOB NUMBER:


18-833A

SHEET NUMBER:

**26** of **35** 

ENGINEERING & ENVIRONMENTAL
ILLINOIS DESIGN FIRM NO. 184-003525

PLOT DATE: 2/18/20 © 2020 FEHR GRAHAM

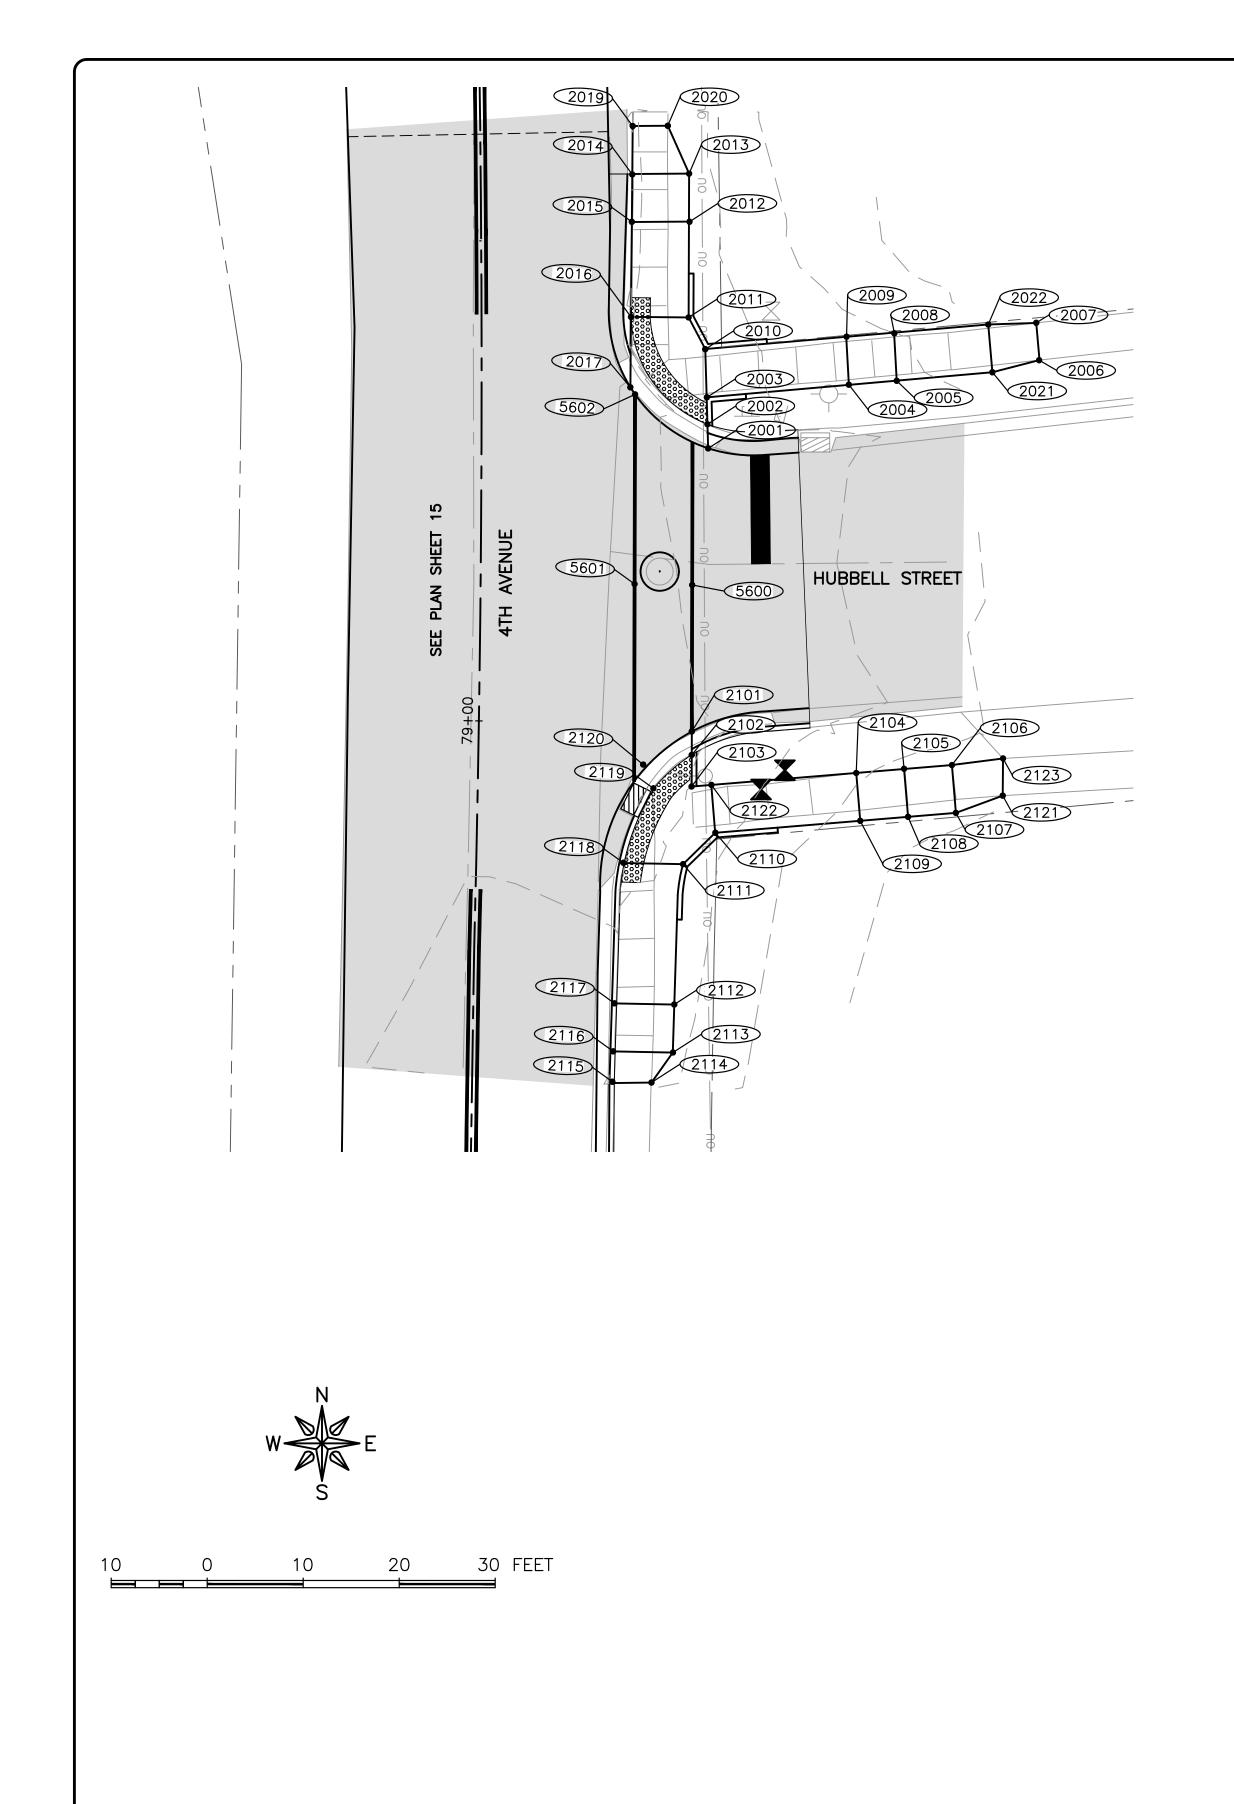

POINT T	O POINT	SIDEWALK DESIGNATIONS	DISTANCE	Δ ELEVATION	SLOPE	ACCEPTAE (POS. o	BLE RANGE or NEG.)	COMMENTS	VALUE		DRMATION ONL TERMINE DESI	.Y: GNED SLOPES
			FT	FT	%	MIN.	MAX.		POINT	STATION	OFFSET	ELEVATIO
2001	2002	SIDEWALK RUNNING SLOPE	2.50	0.03	1.20%	0.50%	5.00%		2001			736.37
2002	2003	LANDING	3.50	0.06	1.71%	0.10%	2.00%		2002			736.40
2003	2004	RAMP RUNNING SLOPE	15.00	1.16	7.73%	0.50%	8.33%		2003			736.46
2004	2005	LANDING	5.00	0.07	1.40%	0.10%	2.00%		2004			737.62
2005	2021	SIDEWALK RUNNING SLOPE	10.00	0.49	4.90%	0.50%	5.00%		2005			737.69
2006	2007	SIDEWALK CROSS SLOPE	4.00	0.27	6.75%	0.50%	2.00%	MATCH EXISTING	2006			738.21
2007	2022	SIDEWALK RUNNING SLOPE	5.00	0.23	4.60%	0.50%	5.00%		2007			738.48
2008	2022	SIDEWALK RUNNING SLOPE	10.00	0.49	4.90%	0.50%	5.00%		2008			737.76
2009	2010	RAMP RUNNING SLOPE	15.00	1.16	7.73%	0.50%	8.33%		2009			737.69
2010	2011	LANDING	3.75	0.07	1.87%	0.10%	2.00%		2010			736.53
2011	2012	RAMP RUNNING SLOPE	10.00	0.16	1.60%	0.50%	8.33%		2011			736.46
2012	2013	SIDEWALK RUNNING SLOPE	5.00	0.06	1.20% 0.77%	0.50%	5.00%	MATCH EVICTING	2012			736.30
2013	2020	SIDEWALK RUNNING SLOPE SIDEWALK RUNNING SLOPE	6.50 5.00	0.05 0.06	1.20%	0.50% 0.50%	5.00% 5.00%	MATCH EXISTING	2013			736.24 736.15
2014	2015	RAMP RUNNING SLOPE	10.00	0.06	1.40%	0.50%	8.33%		2014			736.13
2016	2017	LANDING	7.75	0.14	1.81%	0.10%	2.00%		2016			736.35
2001	2017	SIDEWALK CROSS SLOPE	10.50	0.14	1.52%	0.50%	2.00%		2017			736.21
2002	2016	LANDING	10.00	0.05	0.50%	0.10%	2.00%		2019			736.05
2003	2010	LANDING	5.00	0.07	1.40%	0.10%	2.00%		2020			736.19
2004	2009	LANDING	5.00	0.07	1.40%	0.10%	2.00%		2021			738.18
2005	2008	LANDING	5.00	0.07	1.40%	0.10%	2.00%		2022			738.25
2011	2016	LANDING	6.00	0.11	1.83%	0.10%	2.00%					
2012	2015	SIDEWALK CROSS SLOPE	6.00	0.09	1.50%	0.50%	2.00%					
2019	2020	SIDEWALK CROSS SLOPE	4.00	0.14	3.50%	0.50%	2.00%	MATCH EXISTING				
2014	2019	SIDEWALK RUNNING SLOPE	6.50	0.10	1.54%	0.50%	5.00%					
2021	2006	SIDEWALK RUNNING SLOPE	5.00	0.03	0.60%	0.50%	5.00%					
2101	2102	SIDEWALK RUNNING SLOPE	2.00	0.03	1.50%	0.50%	5.00%		2101			735.26
2102	2103	LANDING	3.50	0.05	1.43%	0.10%	2.00%		2102			735.29
2103	2104	RAMP RUNNING SLOPE	16.25	1.13	6.95%	0.50%	8.33%		2103			735.34
2104	2105	LANDING	5.00	0.07	1.40%	0.10%	2.00%		2104			736.47
2105	2106	SIDEWALK RUNNING SLOPE	5.00	1.12	22.40%	0.50%	5.00%	MATCH EXISTING	2105			736.54
2106	2107	SIDEWALK CROSS SLOPE	5.00	0.07	1.40%	0.50%	2.00%	MATCH EVICTING	2106			737.66
2107	2108 2109	SIDEWALK RUNNING SLOPE  LANDING	5.00	1.12 0.07	22.40% 1.40%	0.50% 0.10%	5.00% 2.00%	MATCH EXISTING	2107			737.73 736.61
2100	2109	RAMP RUNNING SLOPE	15.00	1.12	7.47%	0.10%	8.33%		2108			736.54
2110	2110	LANDING	5.00	0.07	1.40%	0.10%	2.00%		2110			735.42
2111	2112	RAMP RUNNING SLOPE	15.00	0.77	5.13%	0.50%	8.33%		2111			735.49
2112	2113	LANDING	5.00	0.07	1.40%	0.10%	2.00%		2112			736.26
2113	2114	SIDEWALK RUNNING SLOPE	4.00	0.17	4.25%	0.50%	5.00%		2113			736.33
2114	2115	SIDEWALK CROSS SLOPE	4.00	0.15	3.75%	0.50%	2.00%	MATCH EXISTING	2114			736.50
2115	2116	SIDEWALK RUNNING SLOPE	3.25	0.09	2.77%	0.50%	5.00%		2115			736.35
2116	2117	LANDING	5.00	0.07	1.40%	0.10%	2.00%		2116			736.26
2117	2118	RAMP RUNNING SLOPE	15.00	0.68	4.53%	0.50%	8.33%		2117			736.19
2118	2119	SIDEWALK RUNNING SLOPE	10.00	0.13	1.30%	0.50%	5.00%		2118			735.51
2105	2108	LANDING	5.00	0.07	1.40%	0.10%	2.00%		2119			735.38
2104	2109	LANDING	5.00	0.07	1.40%	0.10%	2.00%		2120			735.35
2122	2110	LANDING	5.50	0.05	0.91%	0.10%	2.00%		2121			738.85
2118	2111	LANDING	6.00	0.02	0.33%	0.10%	2.00%		2122			735.37
2112	2117	LANDING	6.00	0.07	1.17%	0.10%	2.00%		2123			738.56
2113	2116	LANDING	6.00	0.07	1.17%	0.10%	2.00%		1			
2101	2120	SIDEWALK CROSS SLOPE	6.00	0.09	1.50%	0.50%	2.00%		1			
2102	2118	LANDING	14.50	0.22	1.52%	0.10%	2.00%	11170117007015				
2107	2121	SIDEWALK CROSS SLOPE	5.00	1.12	22.40%	0.50%	5.00%	MATCH EXISTING	+			
2121	2123	SIDEWALK CROSS SLOPE	4.00	0.29	7.25%	0.50%	2.00%	MATCH EXISTING	1			
2123	2106	SIDEWALK RUNNING SLOPE	5.00	0.90	18.00%	0.50%	5.00%	MATCH EXISTING				
2103	2122 2120	LANDING SIDEWALK CROSS SLOPE	2.50	0.03	1.20% 1.20%	0.10% 0.50%	2.00%					
2119	2120	SIDEWALK CROSS SLOPE SIDEWALK CROSS SLOPE	5.25	0.03	1.20% 1.71%	0.50%	2.00%					
	· · · · · · · · · · · · · · · · · · ·			1		I			<u> </u>	1	T	Γ
5600	5601	SIDEWALK CROSS SLOPE	6.00	0.04	0.67%	0.50%	2.00%		5600			735.91
5600	2001	SIDEWALK RUNNING SLOPE	14.50	0.46	3.17%	0.50%	5.00%		5601			735.87
5600	2101	SIDEWALK RUNNING SLOPE	14.50	0.65	4.48%	0.50%	5.00%		5602			736.23
5601	5602	SIDEWALK RUNNING SLOPE	19.00	0.36	1.89%	0.50%	5.00%		2001			736.37
5601	2120	SIDEWALK RUNNING SLOPE	19.00	0.52	2.74%	0.50%	5.00%		2101	1	Ì	735.26

ILLINOIS IOWA WISCONSIN OWNER/DEVELOPER: CITY OF DIXON 121 WEST 2ND STREET DIXON, IL 61021

PROJECT AND LOCATION: CITY OF DIXON STREETS PROGRAM FY 2020 DIXON, IL

DRAWN BY: YJ/JMV APPROVED BY: NJC DATE: 10/25/19
SCALE: AS NOTED


	REVISIONS		DRAWING:
REV. NO.	DESCRIPTION	DATE	ADA RAMPS - 4TH AVENUE &
			SET TYPE: PRELIMINARY
			G:\C3D\18\18-833A\Plans\18-833 A - PLANS.dwg, 4TH & Hubbell

ADA RAMPS - 4TH AVENUE & HUBBELL

JOB NUMBER: 18-833A SHEET NUMBER:

**27** of **35** 

ENGINEERING & ENVIRONMENTAL ILLINOIS DESIGN FIRM NO. 184-003525 PLOT DATE: 2/18/20 © 2020 FEHR GRAHAM

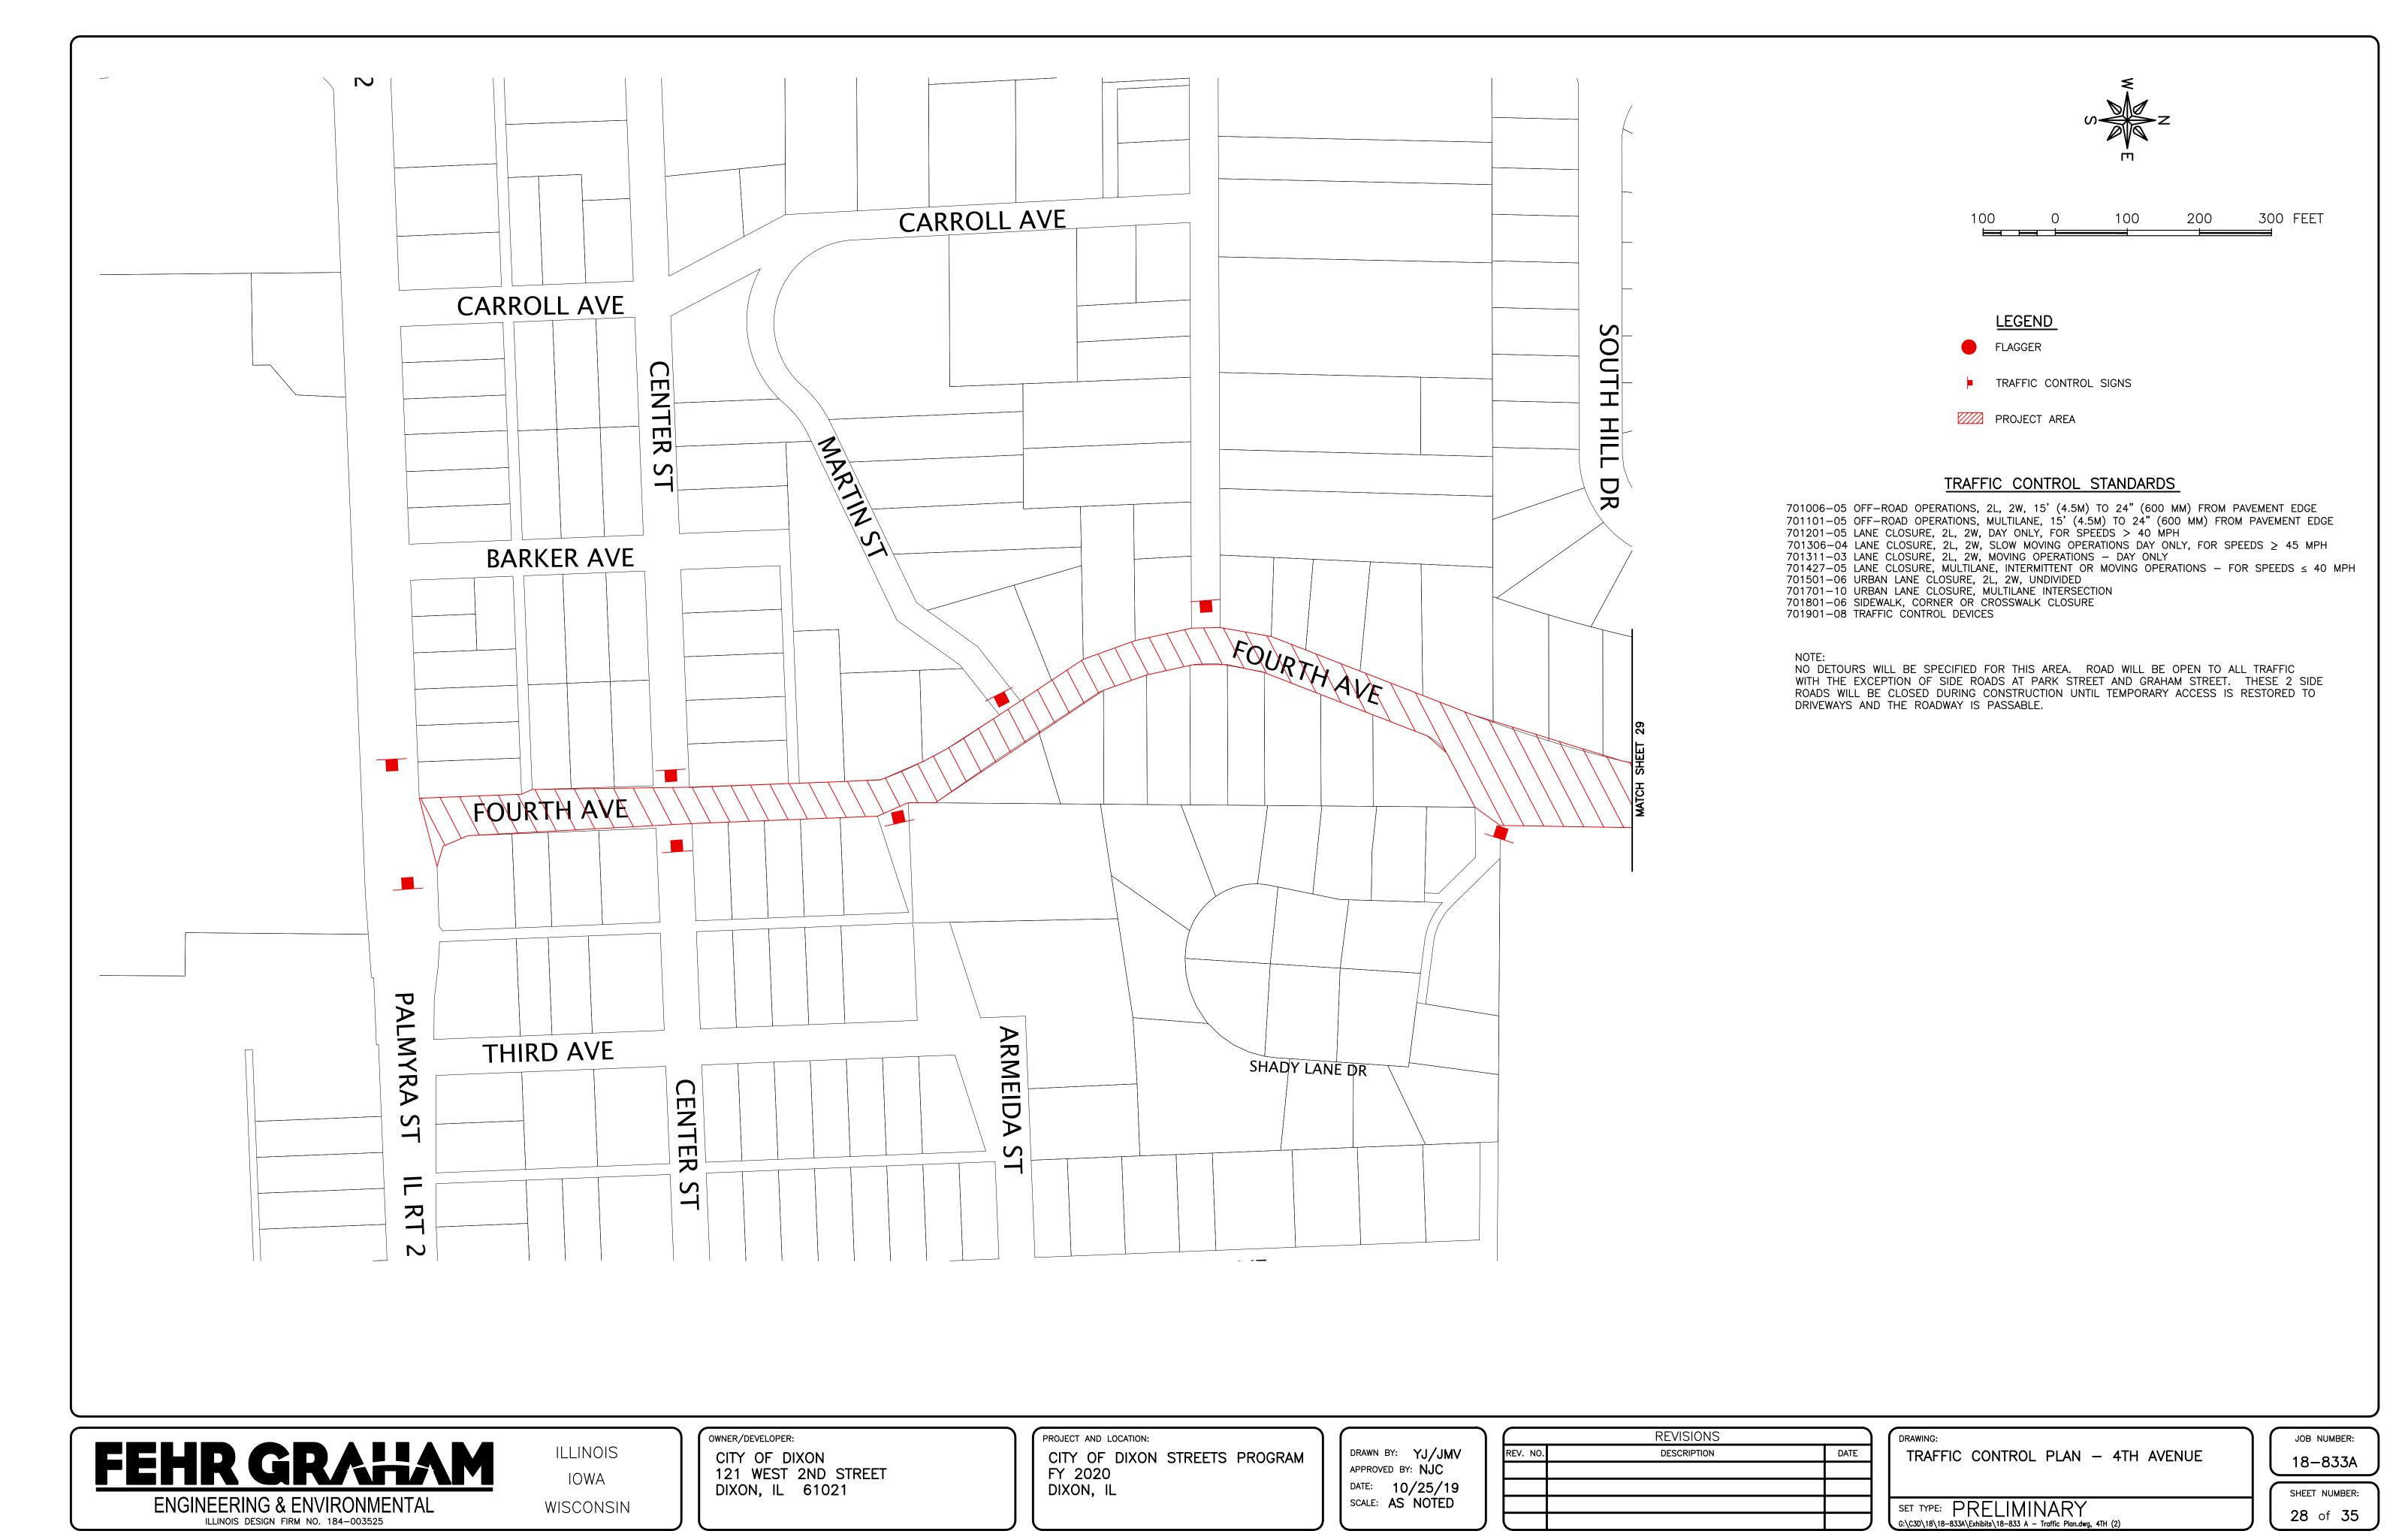

#### TRAFFIC CONTROL STANDARDS

701006-05 OFF-ROAD OPERATIONS, 2L, 2W, 15' (4.5M) TO 24" (600 MM) FROM PAVEMENT EDGE 701101-05 OFF-ROAD OPERATIONS, MULTILANE, 15' (4.5M) TO 24" (600 MM) FROM PAVEMENT EDGE 701201-05 LANE CLOSURE, 2L, 2W, DAY ONLY, FOR SPEEDS > 40 MPH

701306-04 LANE CLOSURE, 2L, 2W, SLOW MOVING OPERATIONS DAY ONLY, FOR SPEEDS ≥ 45 MPH 701311-03 LANE CLOSURE, 2L, 2W, MOVING OPERATIONS - DAY ONLY 701427-05 LANE CLOSURE, MULTILANE, INTERMITTENT OR MOVING OPERATIONS - FOR SPEEDS ≤ 40 MPH

701427-05 LANE CLOSURE, MULTILANE, INTERMITTENT OR MOVING OPERATIONS - FOR SI
701501-06 URBAN LANE CLOSURE, 2L, 2W, UNDIVIDED
701701-10 URBAN LANE CLOSURE AND THANK INTERSECTION

701701-10 URBAN LANE CLOSURE, MULTILANE INTERSECTION 701801-06 SIDEWALK, CORNER OR CROSSWALK CLOSURE

701901-08 TRAFFIC CONTROL DEVICES

<u>LEGEND</u>

FLAGGER

TRAFFIC CONTROL SIGNS

PROJECT AREA

S

00 0 100 200 300 FEET

NOTE:
NO DETOURS WILL BE SPECIFIED FOR THIS AREA.
ROAD WILL BE OPEN TO ALL TRAFFIC WITH THE
EXCEPTION OF SIDE ROADS AT PARK STREET AND
GRAHAM STREET. THESE 2 SIDE ROADS WILL BE
CLOSED DURING CONSTRUCTION UNTIL TEMPORARY
ACCESS IS RESTORED TO DRIVEWAYS AND THE ROADWAY
IS PASSABLE.



FEHR GRAHAM

ILLINOIS IOWA

WISCONSIN

OWNER/DEVELOPER:

CITY OF DIXON
121 WEST 2ND STREET
DIXON, IL 61021

PROJECT AND LOCATION:

CITY OF DIXON STREETS PROGRAM
FY 2020
DIXON, IL

DRAWN BY: YJ/JMV
APPROVED BY: NJC
DATE: 10/25/19
SCALE: AS NOTED

	REVISIONS	
REV. NO.	DESCRIPTION	DATE

DRAWING:

TRAFFIC CONTROL PLAN — 4TH AVENUE


SET TYPE: PRELIMINARY
G:\C3D\18\18-833A\Exhibits\18-833 A - Traffic Plan.dwg, 4TH

18-833A

SHEET NUMBER:
29 of 35

JOB NUMBER:

ENGINEERING & ENVIRONMENTAL ILLINOIS DESIGN FIRM NO. 184-003525
PLOT DATE: 2/18/20 © 2020 FEHR GRAHAM

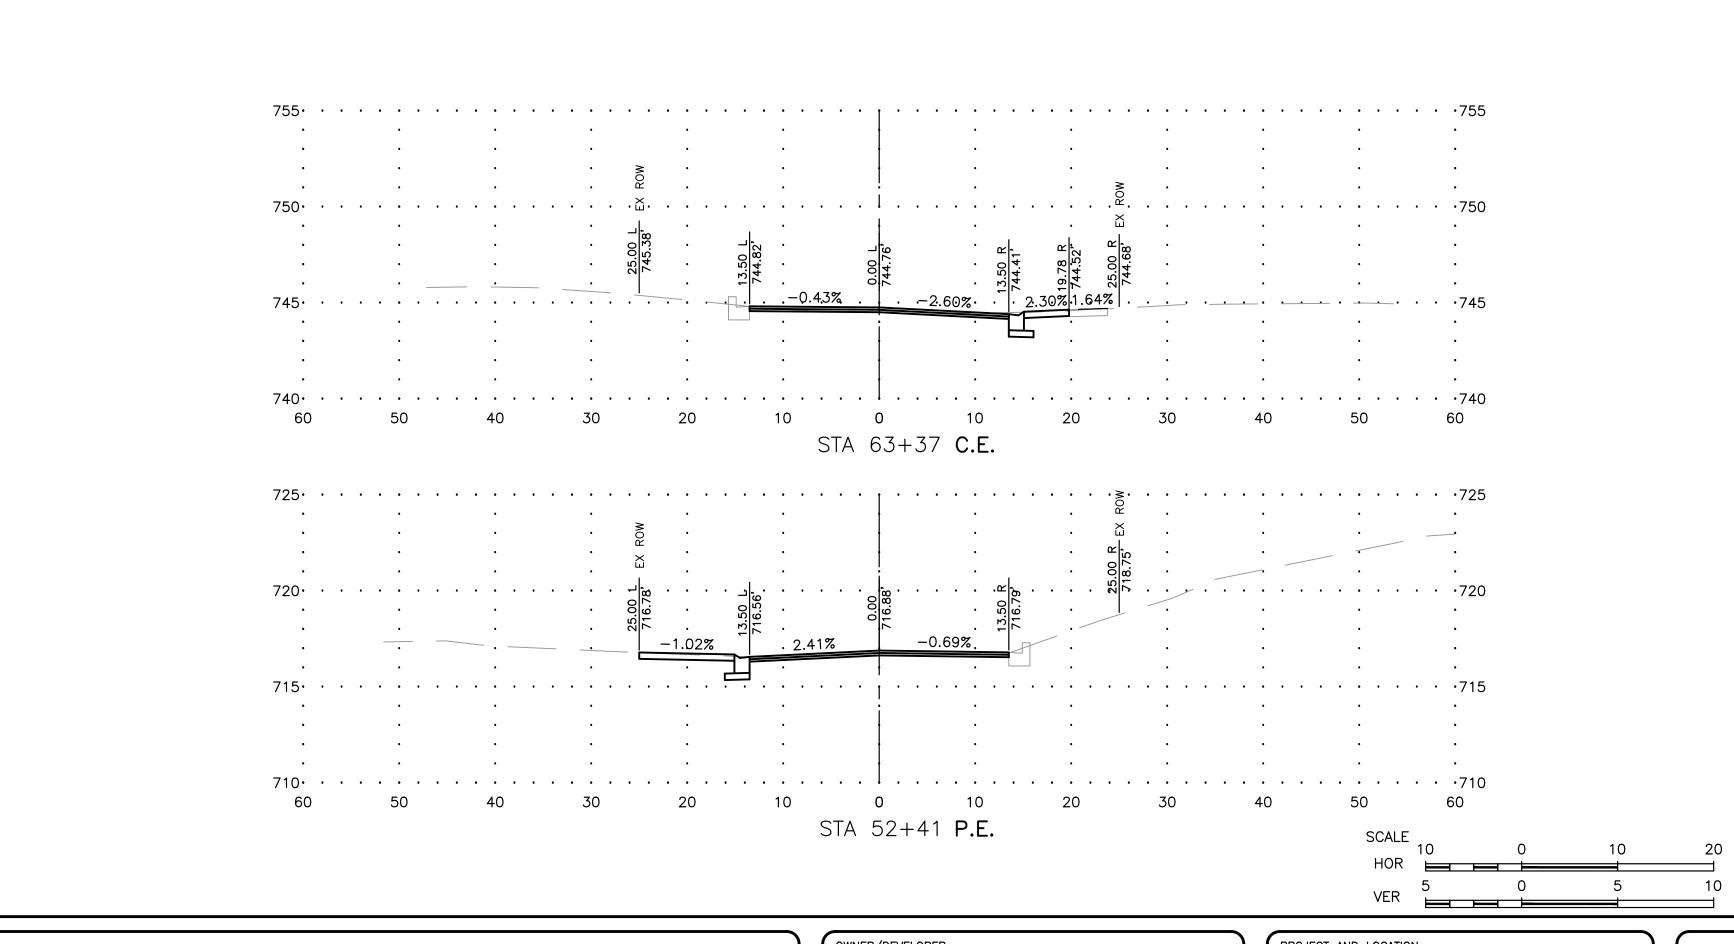

ILLINOIS IOWA

WISCONSIN

OWNER/DEVELOPER: CITY OF DIXON 121 WEST 2ND STREET DIXON, IL 61021

PROJECT AND LOCATION: CITY OF DIXON STREETS PROGRAM FY 2020

DIXON, IL

DRAWN BY: YJ/JM APPROVED BY: NJC DATE: 10/25/1 SCALE: AS NOTED

`	1		REVISIONS	
MV		REV. NO.	DESCRIPTION	DATE
19				
ED .				
	) (			


4TH AVENUE - CROSS SECTIONS

SET TYPE: PRELIMINARY
G:\C3D\18\18-833A\18-833 - Design A.dwg, 4TH-S1

18-833A SHEET NUMBER: **30** of **35** 

JOB NUMBER:

ENGINEERING & ENVIRONMENTAL ILLINOIS DESIGN FIRM NO. 184-003525 PLOT DATE: 2/18/20 © 2020 FEHR GRAHAM

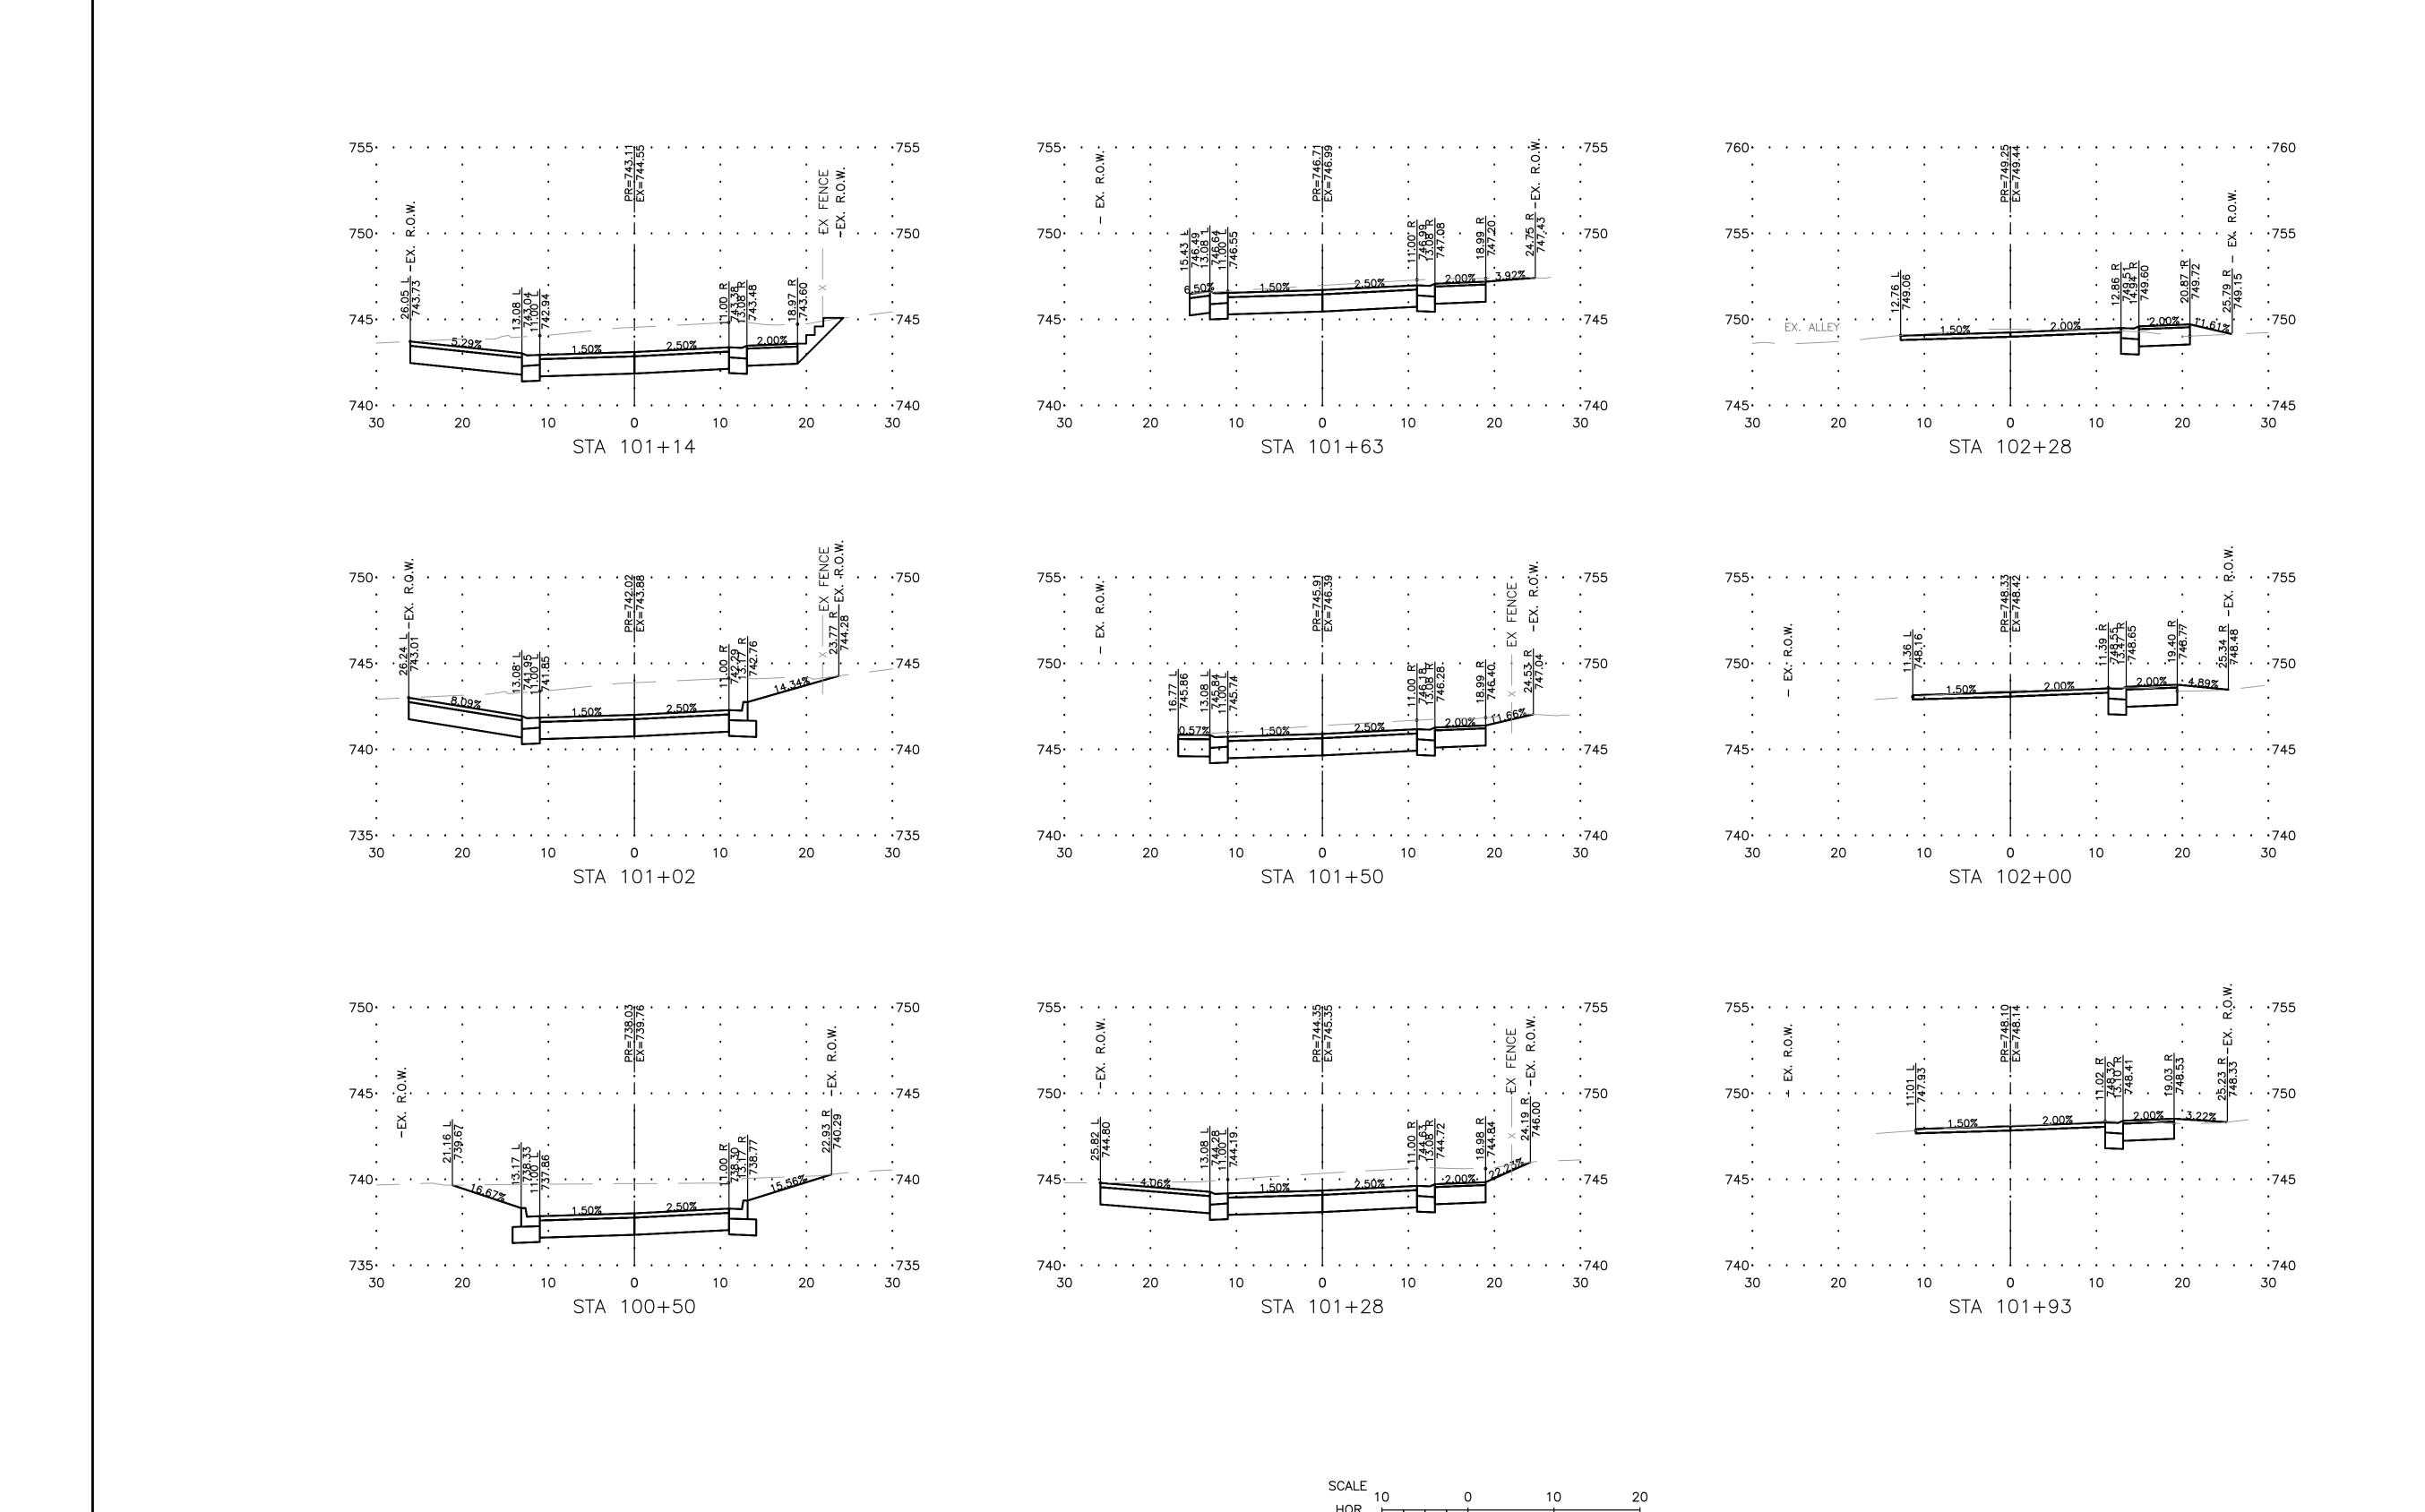

ILLINOIS IOWA WISCONSIN OWNER/DEVELOPER:

CITY OF DIXON

121 WEST 2ND STREET

DIXON, IL 61021

PROJECT AND LOCATION:

CITY OF DIXON STREETS PROGRAM

FY 2020

DIXON, IL

VER

DRAWN BY: YJ/JMV
APPROVED BY: NJC
DATE: 10/25/19
SCALE: AS NOTED

	REVISIONS	
REV. NO.	DESCRIPTION	DATE

PARK STREET CROSS SECTIONS


SET TYPE: PRELIMINARY
G:\C3D\18\18-833A\18-833 - Design A.dwg, XS-PARK

18-833A

SHEET NUMBER:

31 of 35

JOB NUMBER:

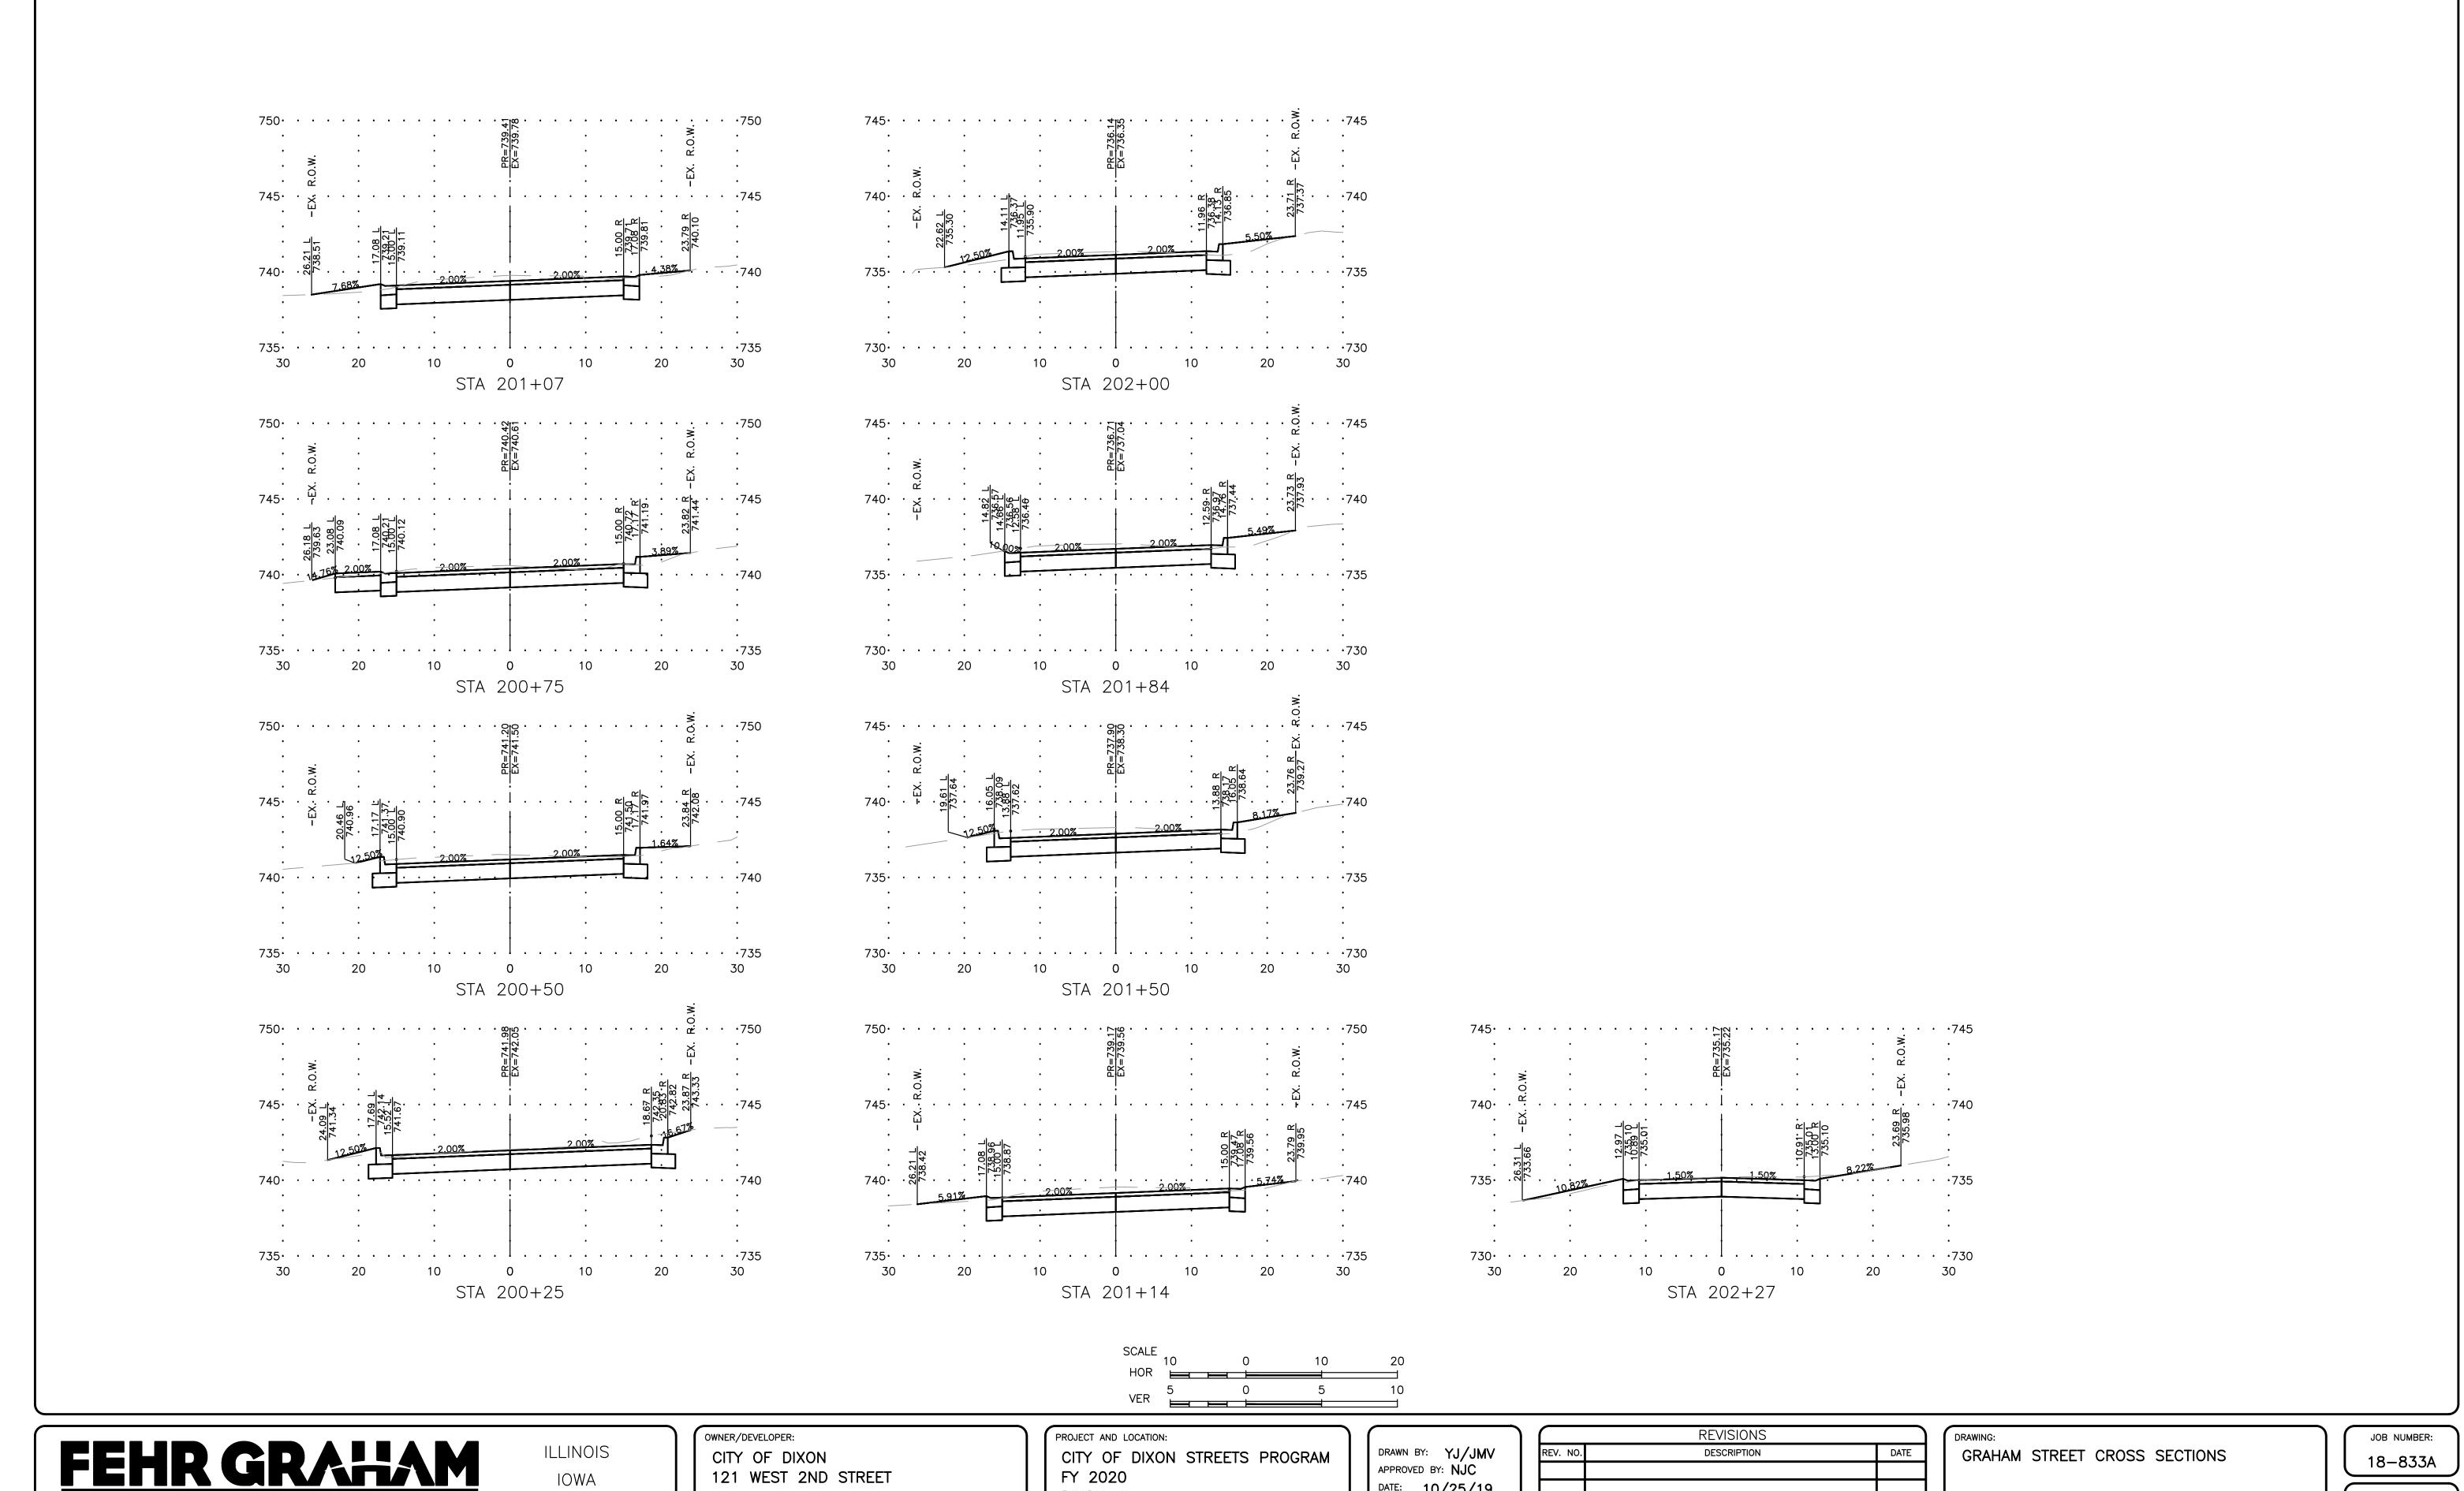

ENGINEERING & ENVIRONMENTAL ILLINOIS DESIGN FIRM NO. 184-003525 PLOT DATE: 2/18/20 © 2020 FEHR GRAHAM

IOWA WISCONSIN 121 WEST 2ND STREET DIXON, IL 61021

DIXON, IL


DATE: 10/25/19 SCALE: AS NOTED


	REVISIONS	
EV. NO.	DESCRIPTION	DATE


SET TYPE: PRELIMINARY
G:\C3D\18\18-833A\18-833 - Design A.dwg, GR-XS

**32** of **35** 

SHEET NUMBER:

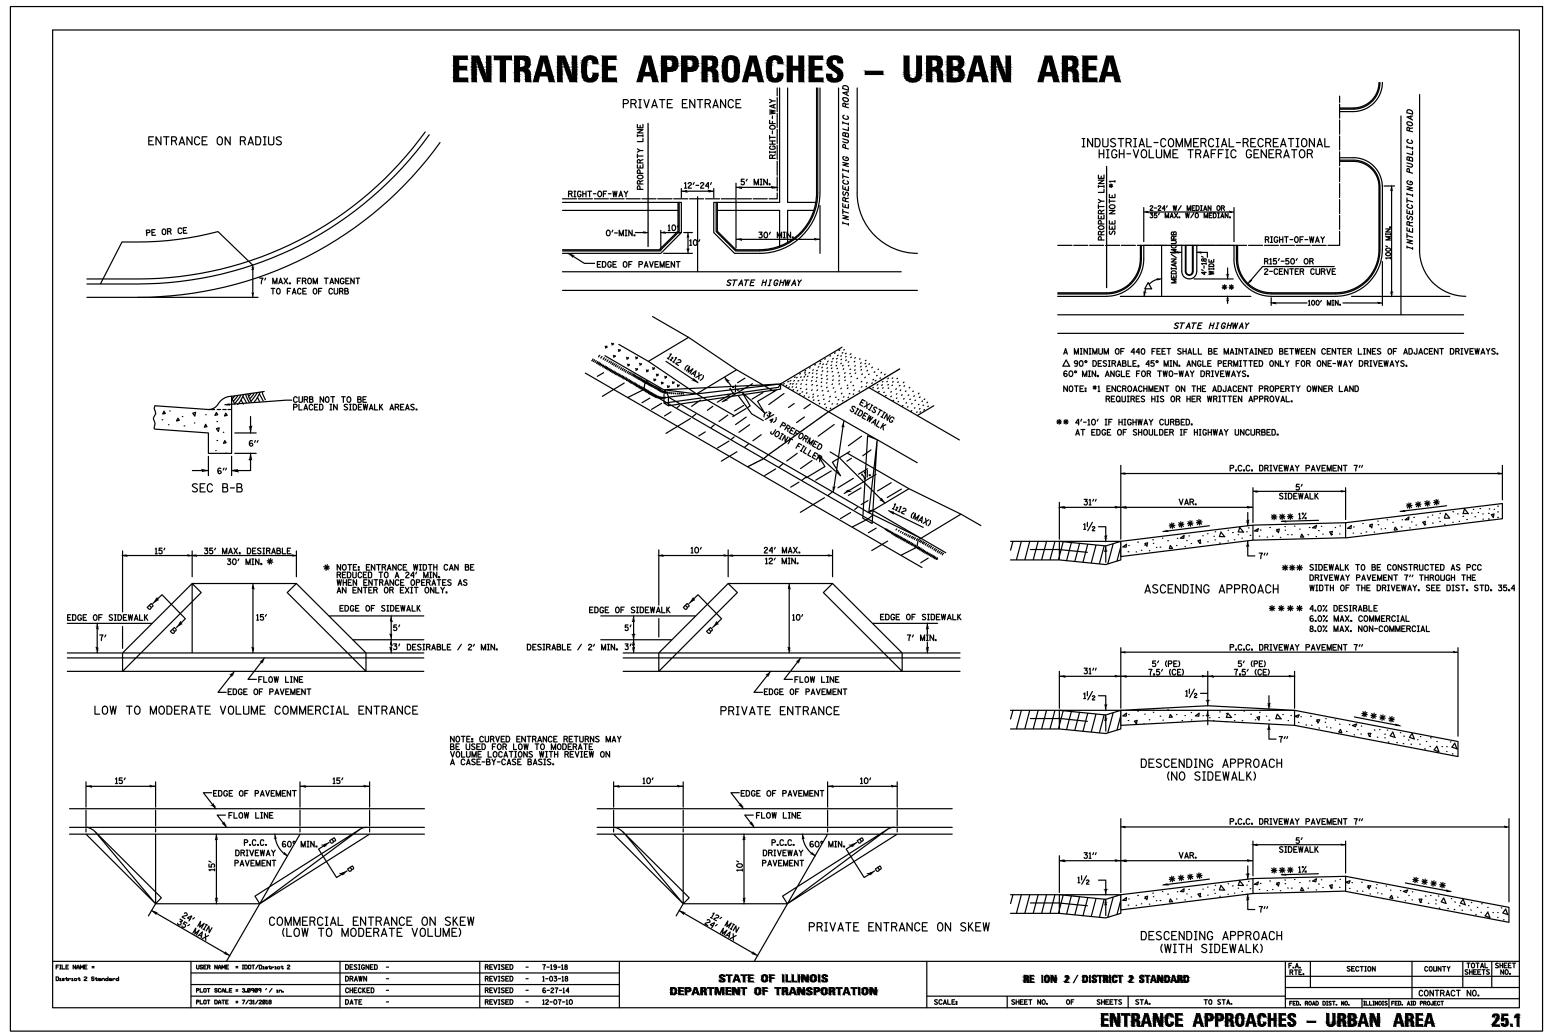

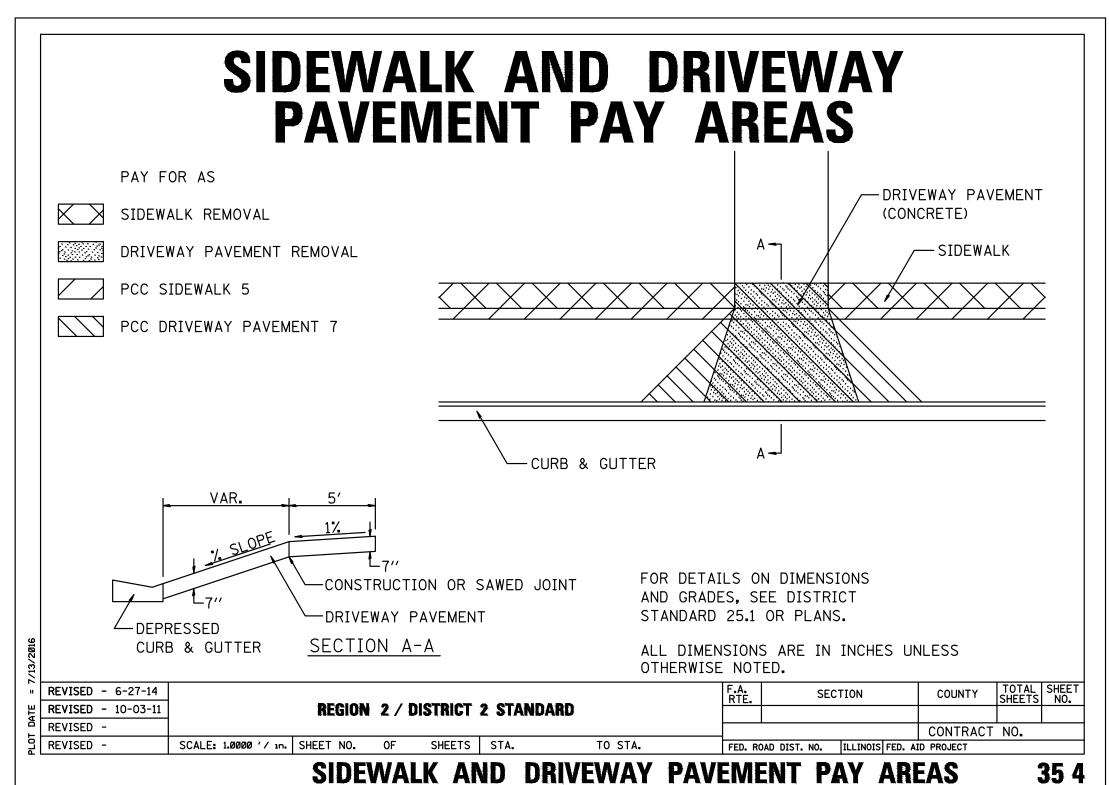

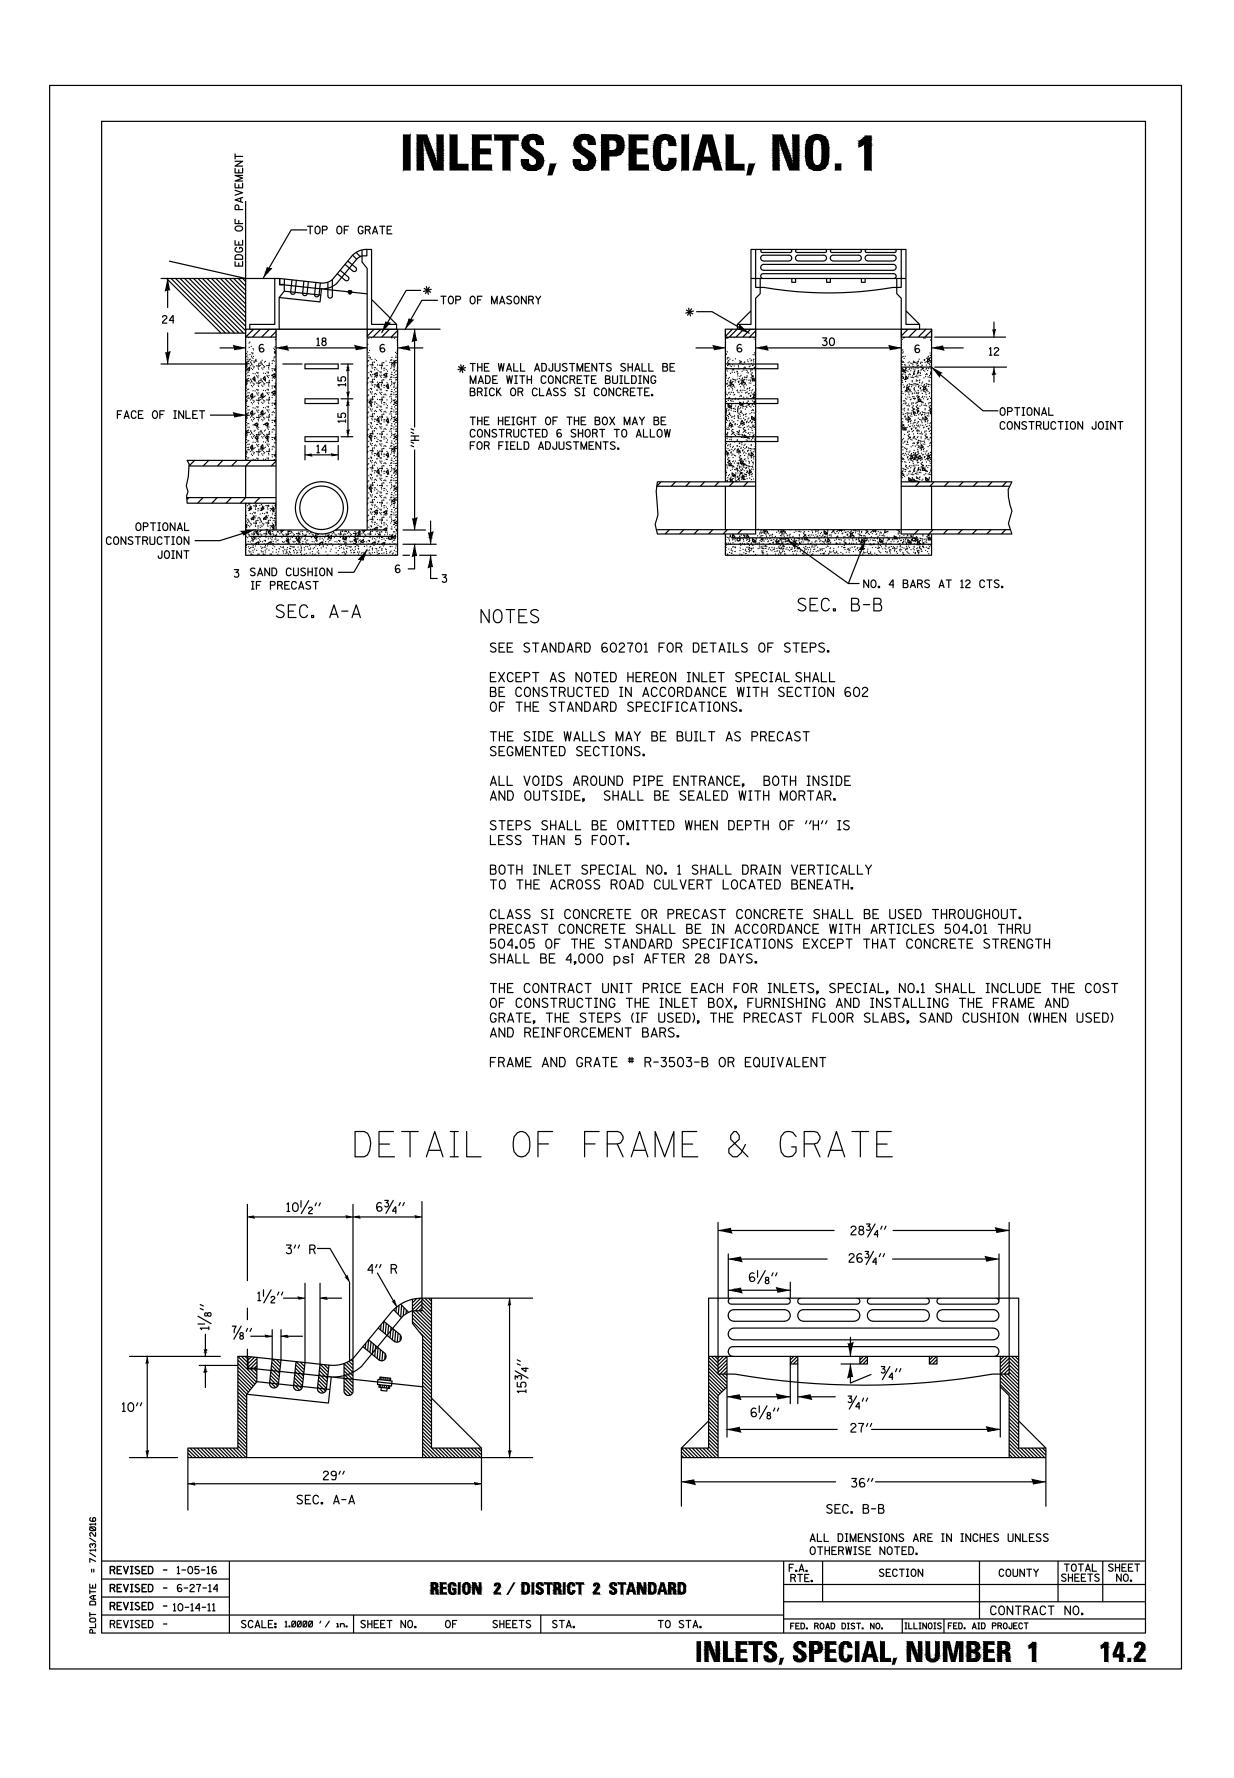



**ENGINEERING & ENVIRONMENTAL** 

ILLINOIS DESIGN FIRM NO. 184-003525

ILLINOIS IOWA

WISCONSIN

OWNER/DEVELOPER:

CITY OF DIXON

121 WEST 2ND STREET

DIXON, IL 61021


CITY OF DIXON STREETS PROGRAM
FY 2020
DIXON, IL


DRAWN BY: YJ/JMV
APPROVED BY: NJC
DATE: 10/25/19
SCALE: AS NOTED


	REVISIONS	
REV. NO.	DESCRIPTION	DATE

DETAILS

SET TYPE: PRELIMINARY
G:\C3D\18\18-833A\Plans\18-833 A - PLANS.dwg, DETAIL

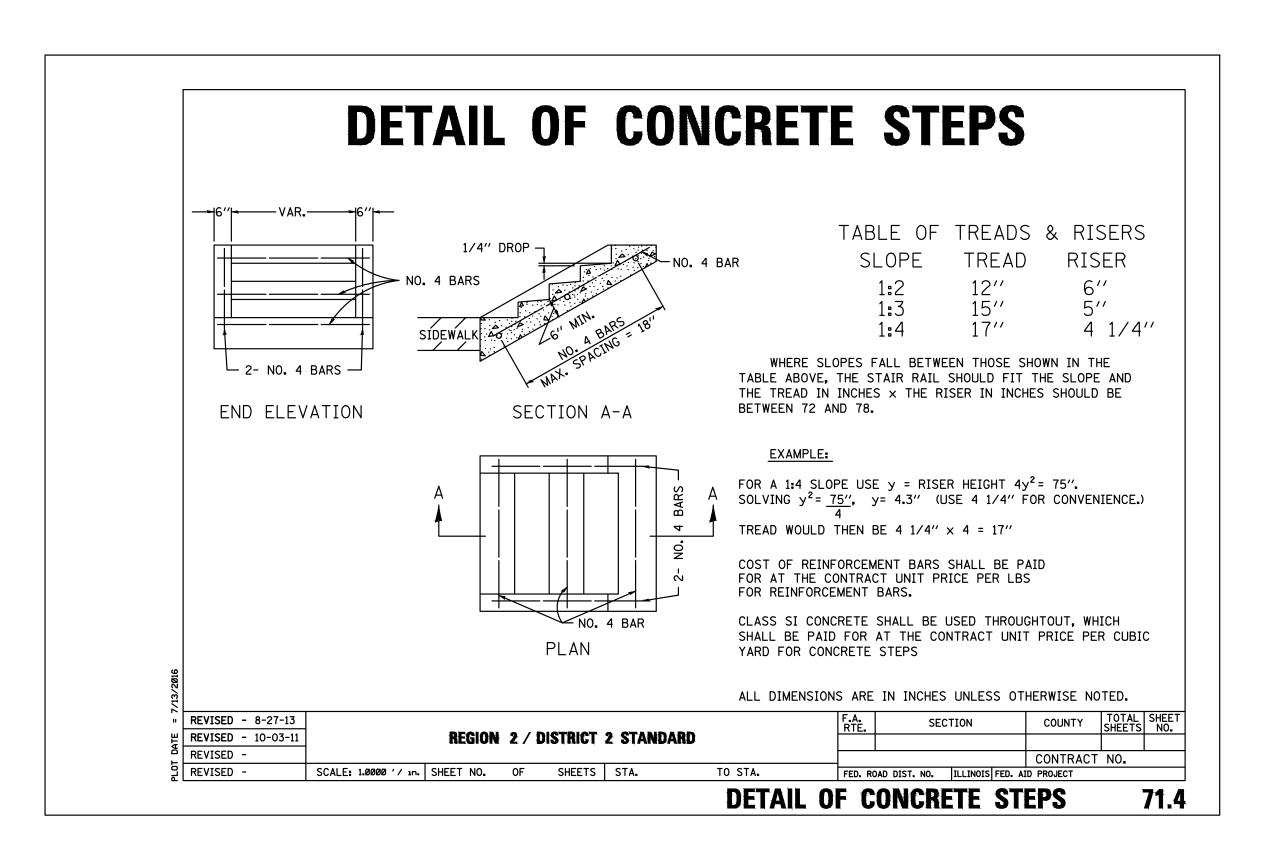

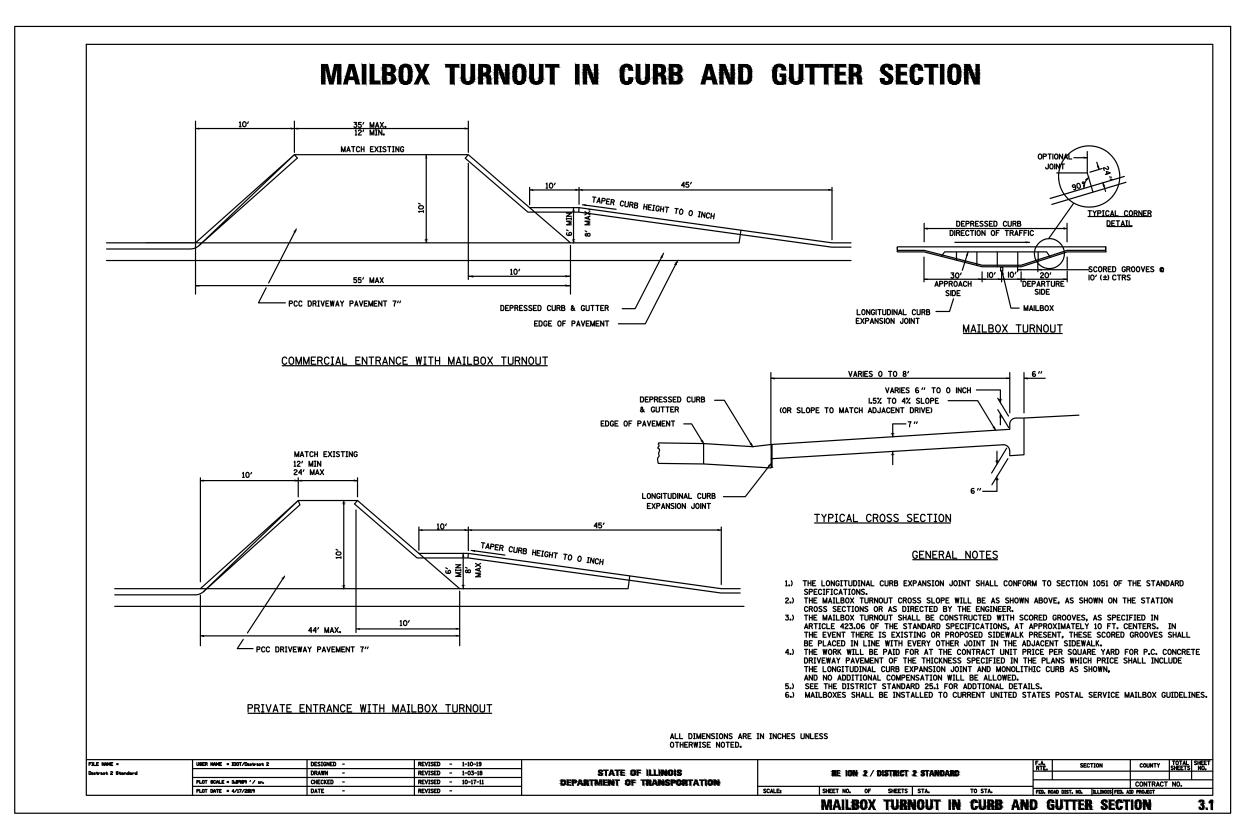

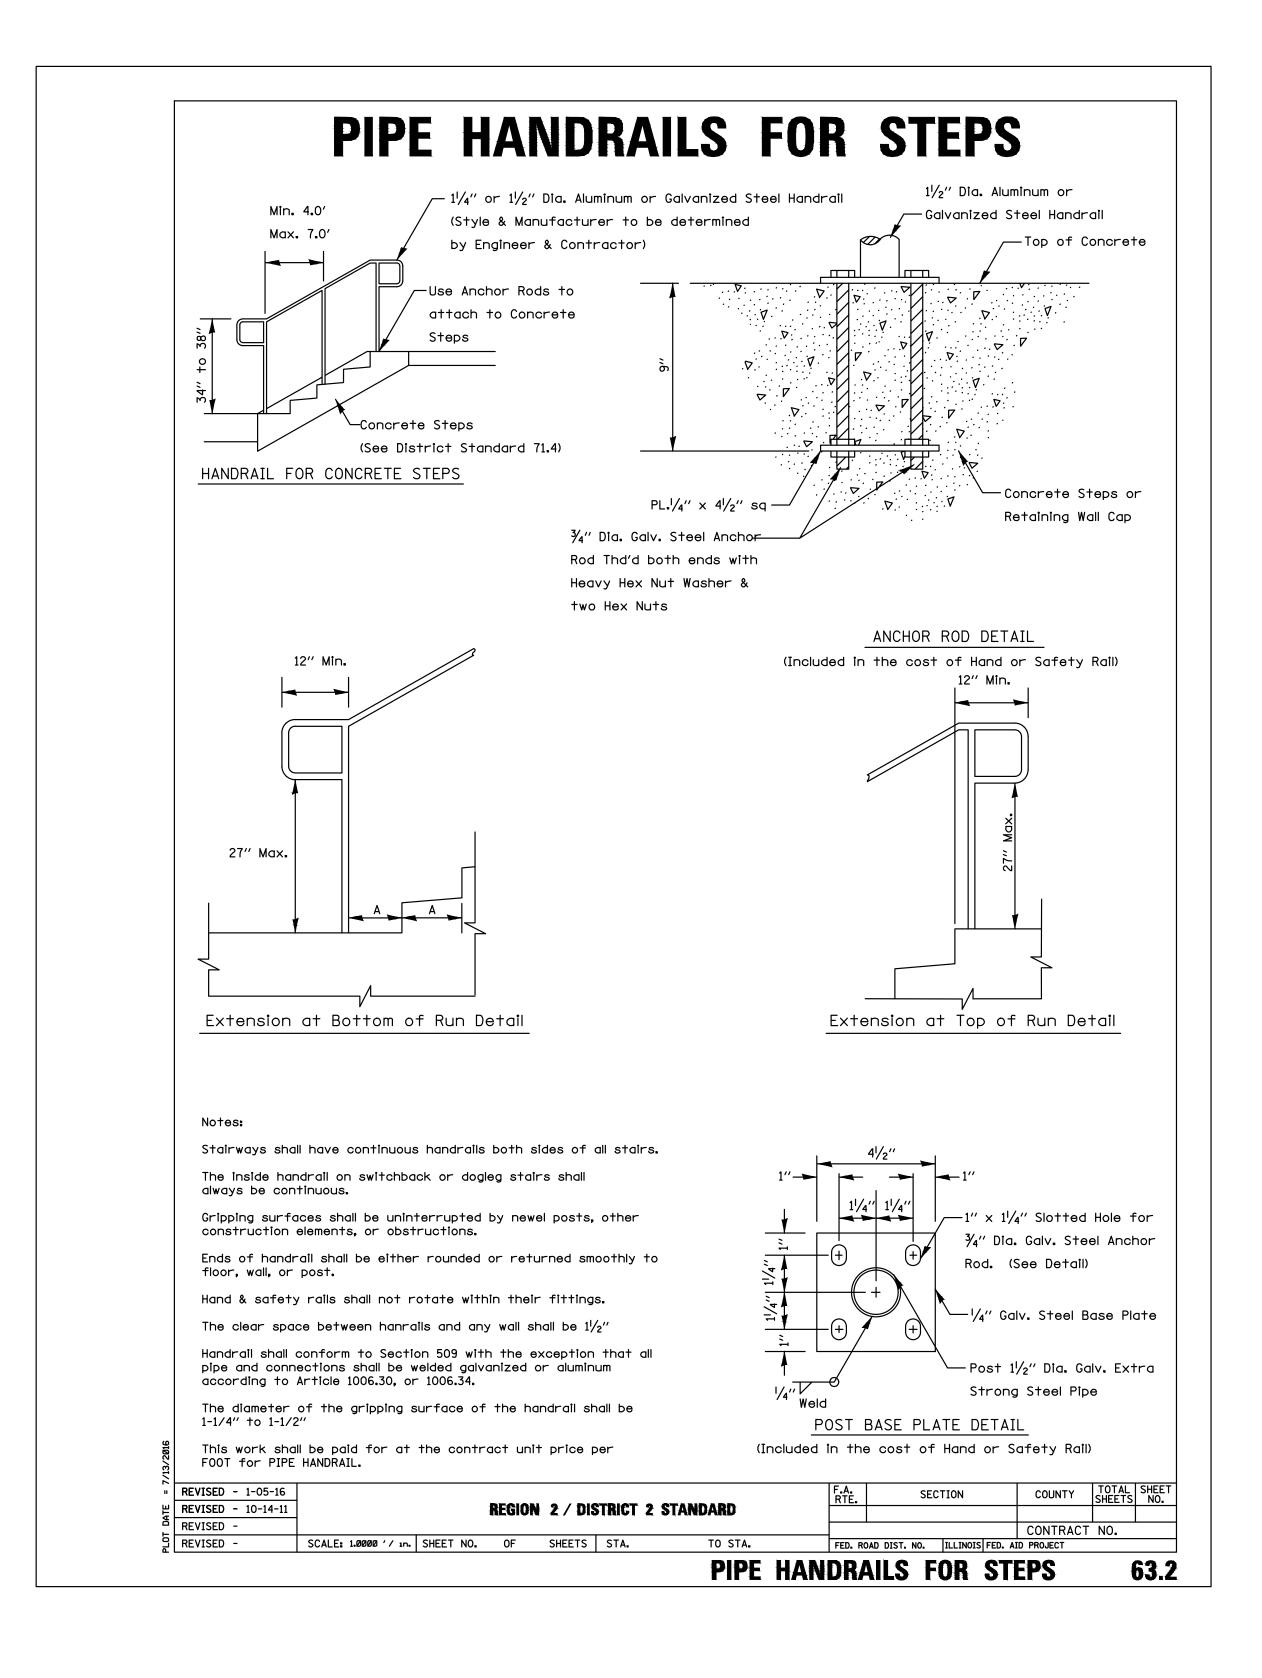



ILLINOIS DESIGN FIRM NO. 184-003525

ILLINOIS IOWA

WISCONSIN

OWNER/DEVELOPER:

CITY OF DIXON

121 WEST 2ND STREET

DIXON, IL 61021

PROJECT AND LOCATION:

CITY OF DIXON STREETS PROGRAM
FY 2020
DIXON, IL

DRAWN BY: YJ/JMV
APPROVED BY: NJC
DATE: 10/25/19
SCALE: AS NOTED

	REVISIONS	
REV. NO.	DESCRIPTION	DATE

DRAWING:
DETAILS


SET TYPE: PRELIMINARY
G:\C3D\18\18-833A\Plans\18-833 A - PLANS.dwg, DET-1

JOB NUMBER:

18-833A

SHEET NUMBER:

**34** of **35** 

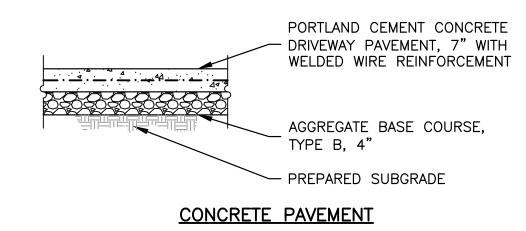

DRIVEWAY PAVEMENT CROSS SECTION

1. ADJUST MANHOLE AFTER PAVING IS COMPLETED.

- 2. SAW CUT SQUARE OPENING SET AT DIAGONAL, WITH ALL DIAGONAL CUTS CONSISTING OF 5'X5' DIAMOND CONFIGURATION AROUND THE CENTER OF THE
- FRAME.


  3. REMOVE PAVEMENT MATERIAL AND ADJUST MANHOLE TO WITHIN 1/4" TO 3/8" OF TOP OF NEW PAVEMENT IF STRING IS PULLED FROM POINT A TO B. CHECK C TO D WITH STRING FOR POTENTIAL CONFLICT AND ADJUST AS NEEDED.
- 4. PRIOR TO PLACEMENT OF CONCRETE, MAKE SURE BASE IS COMPACTED SUFFICIENTLY & OUTSIDE EDGE OF OPENING HAS VERTICAL WALLS.


  5. FILL VOID WITH MINIMUM OF 10" OF CONCRETE, THIS WORK SHALL MEET THE REQUIREMENTS OF ARTICLE 442.02 NOTE #1 AND ARTICLE
- 701.17(e)(2)&(3).
  6. TROWEL OFF CONCRETE FLUSH WITH NEW PAVEMENT AND BROOM FINISH. MANHOLE FRAME SHALL BE RECESSED FROM CONCRETE NO MORE THAN
- 3/8".
  7. IF MANHOLE FRAME AND LID IS WITHIN 2" OF FINAL ADJUSTMENT, AN ADJUSTING RING MAY BE USED INSTEAD OF COMPLETE REMOVAL OF CASTING AND ADJUSTMENT. THIS WORK SHALL CONFORM TO SECTION 602 OF THE "STANDARD SPECIFICATIONS FOR ROAD AND BRIDGE CONSTRUCTION IN ILLINOIS", LATEST EDITION. THE WORK SHALL BE PAID FOR AT THE CONTRACT UNIT PRICE PER EACH FOR MANHOLE TO BE ADJUSTED, WHICH SHALL
- INCLUDE SAW CUTTING, REMOVAL OF MATERIAL, RISER RING AND PLACEMENT OF CONCRETE.

  8. IF MANHOLE FRAME AND LID REQUIRES AN ADJUSTMENT OF GREATER THAN 2", THEN REMOVAL OF CASTING AND LID SHALL BE REQUIRED WITH NEEDED ADJUSTMENT AS PER SECTION 602 OF THE "STANDARD SPECIFICATIONS FOR ROAD AND BRIDGE CONSTRUCTION IN ILLINOIS", LATEST EDITION. THE WORK SHALL BE PAID FOR AT THE CONTRACT UNIT PRICE PER EACH FOR MANHOLES TO BE ADJUSTED, WHICH SHALL INCLUDE SAW CUTTING, REMOVAL OF MATERIAL, ADJUSTMENT OF MANHOLE FRAME AND LID AND CONCRETE PLACEMENT.
- 9. THE CONTRACTOR SHALL ALSO MARK THE LOCATION OF EACH MANHOLE PRIOR TO PAVING ALONG THE EDGE OF THE PAVEMENT OR CURB WITH A LATH AND OR PAINT MARKS SO THAT IT CAN BE READILY FOUND. THE ABOVE WORK SHALL BE INCIDENTAL TO THE MANHOLE ADJUSTMENT.

#### NOTE:

IF DURING THE PAVING OPERATION AN ADJUSTING RING IS USED AND ADJUSTED MANHOLE MATCHES THE NEW PAVEMENT, THEN SAW CUTTING, REMOVAL OF MATERIAL AND CONCRETE PLACEMENT WILL NOT BE REQUIRED. THIS WORK SHALL BE INCIDENTAL AND SHALL BE CONSIDERED A PART OF THE MANHOLE TO BE ADJUSTED. THIS WORK SHALL CONFORM TO SECTION 602 OF THE "STANDARD SPECIFICATIONS FOR ROAD AND BRIDGE CONSTRUCTION IN ILLINGTON, LATER TO BE ADDITIONAL THE SAW CUTTING AND ADDITION AND THE PROPERTY OF THE PROPE

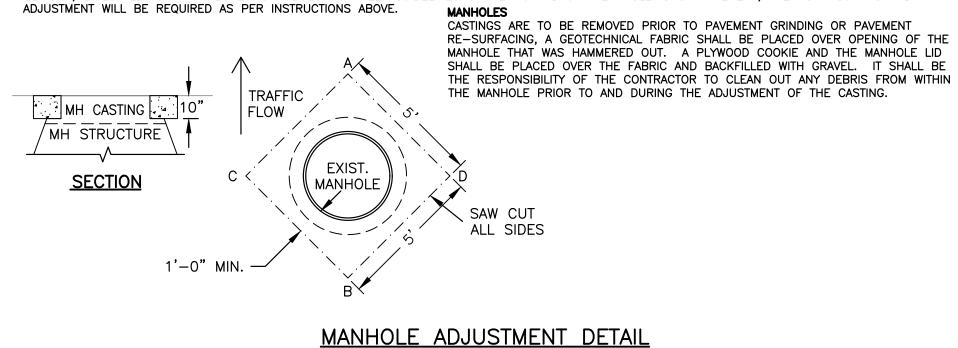

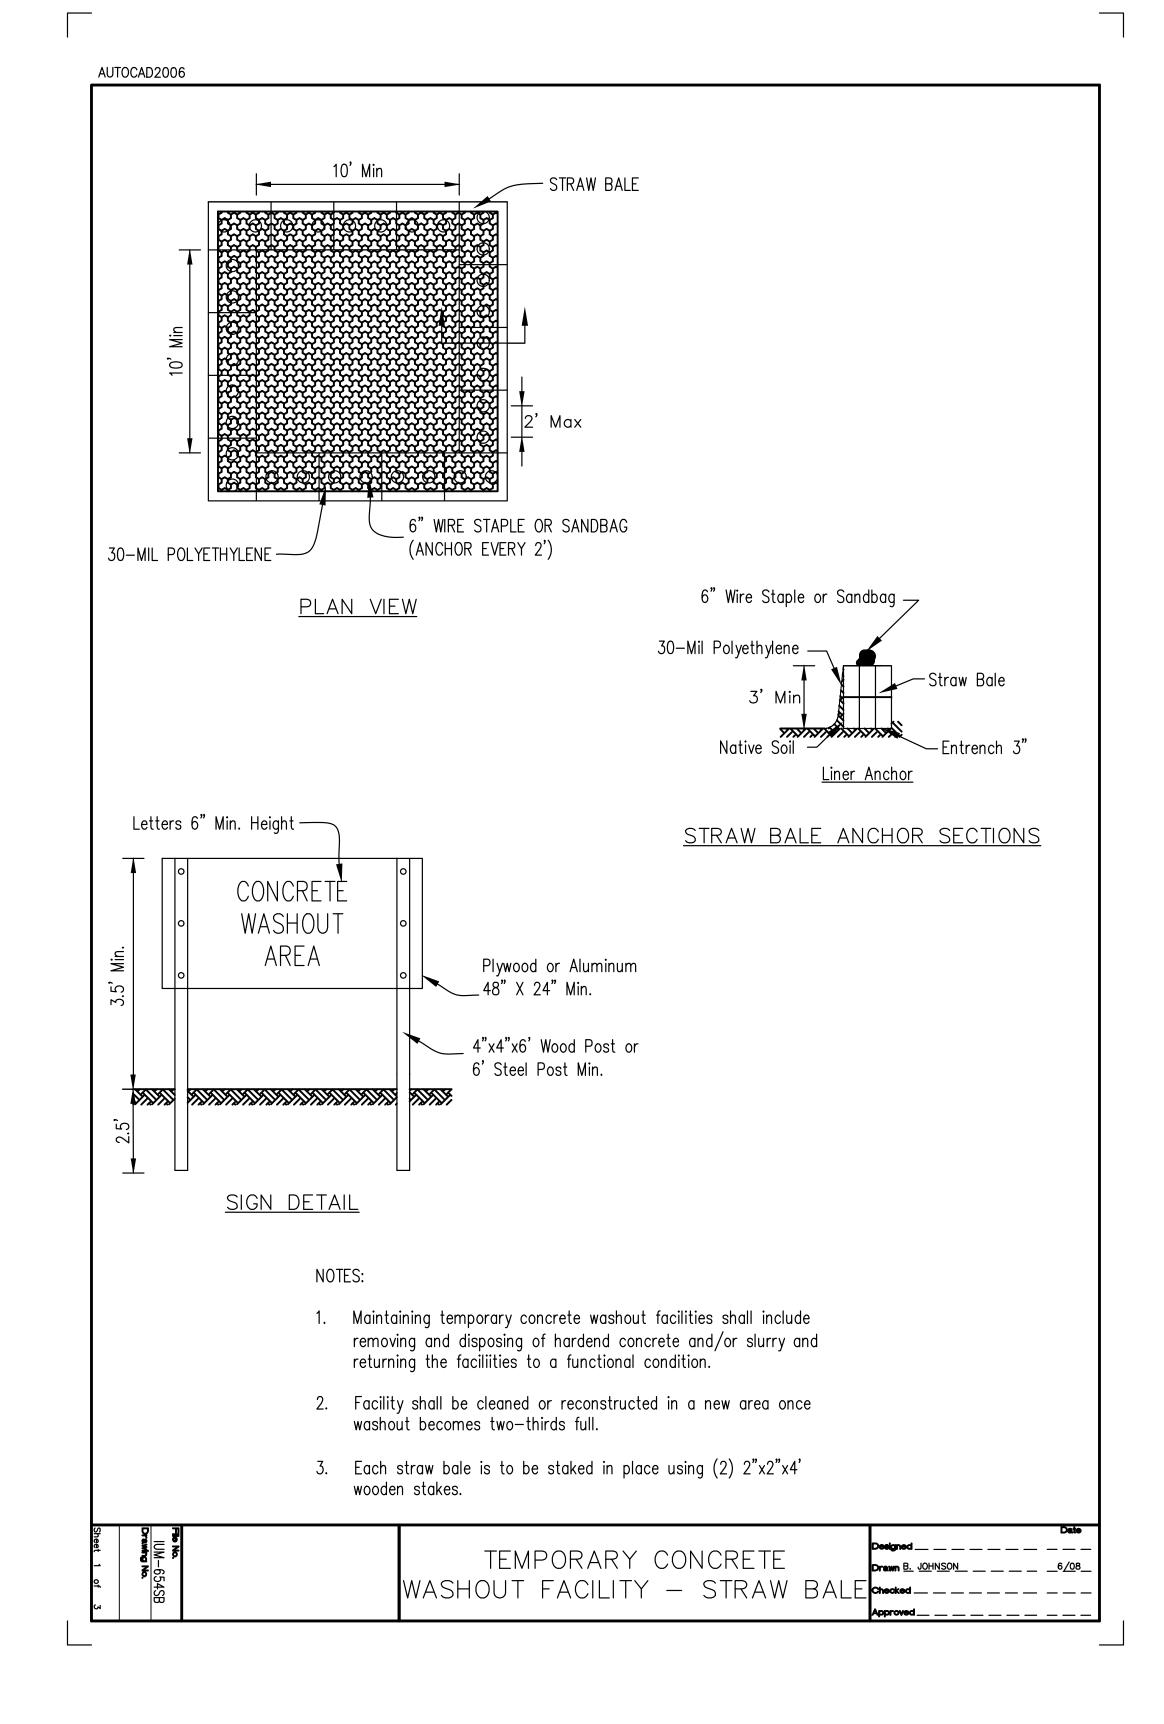



**ENGINEERING & ENVIRONMENTAL** 

ILLINOIS DESIGN FIRM NO. 184-003525

ILLINOIS IOWA

WISCONSIN

CITY OF DIXON 121 WEST 2ND STREET DIXON, IL 61021


OWNER/DEVELOPER:

PROJECT AND LOCATION:

CITY OF DIXON STREETS PROGRAM
FY 2020

DIXON, IL

DRAWN BY: YJ/JMV
APPROVED BY: NJC
DATE: 10/25/19
SCALE: AS NOTED

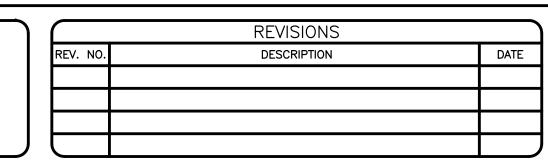

DETAILS

SET TYPE: PRELIMINARY
G:\C3D\18\18-833A\Plans\18-833 A - PLANS.dwg, DETAIL (2)

JOB NUMBER:

18-833A

SHEET NUMBER:

35 of 35