



FOR INFORMATION ONLY

ROUTE NO.	SEC.	COUNTY	TOTAL SHEETS	SHEET NO.
EA. 194	3VB	WINNEBAGO	17	9
STA.	+0 STA.			
FED. ROAD DIST. NO.	ILLINOIS	PROJ.		

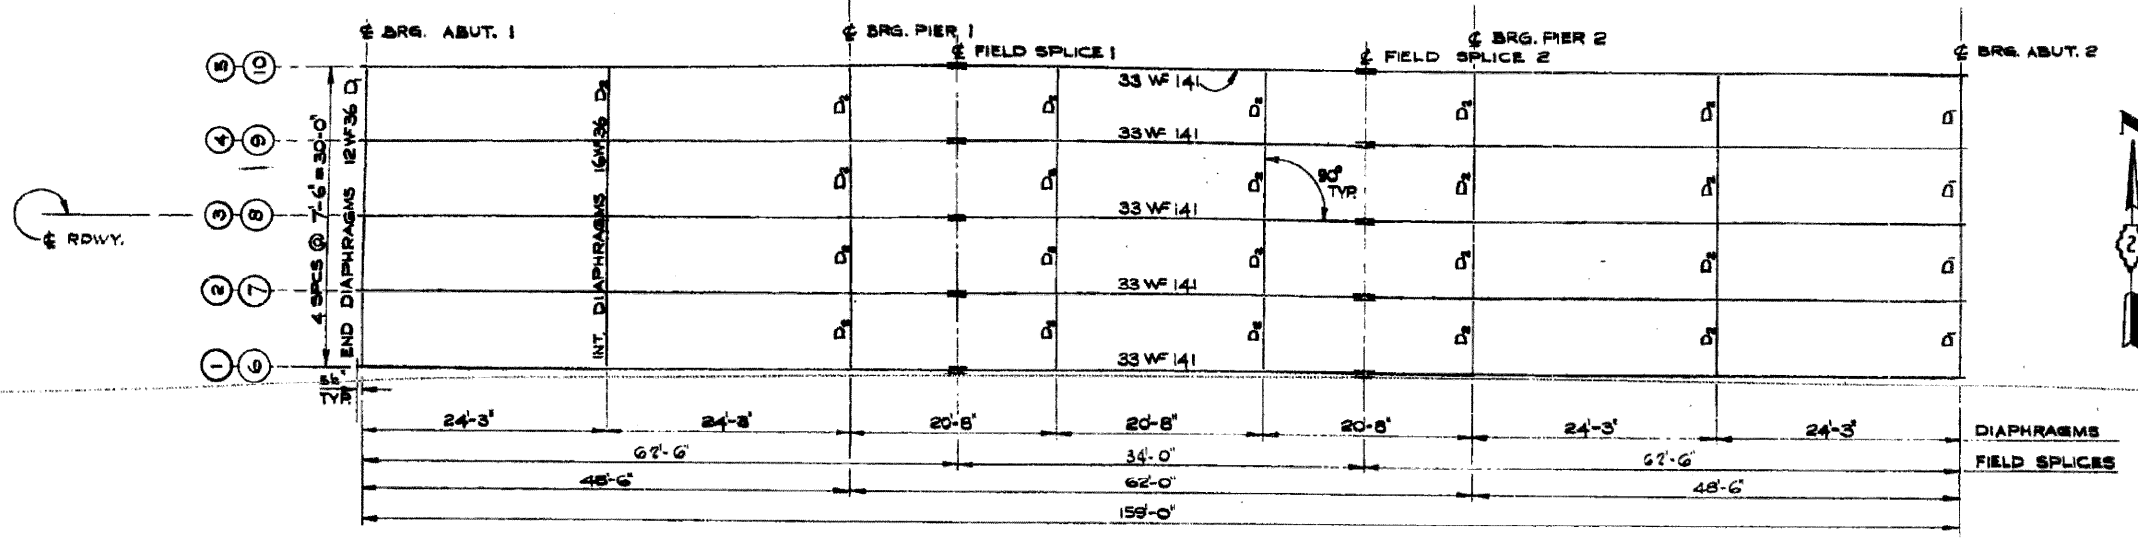


FRAMING PLAN
SCALE 1/8" = 1'-0"


BEAM NO.		LOCATION	¢ BRG. ABUT. 1	¢ BRG. PIER 1	¢ FIELD SPLICE 1	¢ FIELD SPLICE 2	¢ BRG. PIER 2	¢ BRG. ABUT. 2
E.B. RDWY.	W.B. RDWY.							
1 & 5	6 & 10	TOP OF SLAB	752.16	751.44	751.22	750.67	750.42	749.59
		TOP OF BEAM	751.57	750.80	750.58	750.03	749.80	749.00
2 & 4	7 & 9	TOP OF SLAB	752.30	751.58	751.26	750.81	750.57	749.73
		TOP OF BEAM	751.71	750.94	750.71	750.16	749.93	749.14
3	8	TOP OF SLAB	752.35	751.63	751.41	750.86	750.62	749.77
		TOP OF BEAM	751.76	750.99	750.76	750.21	749.98	749.19

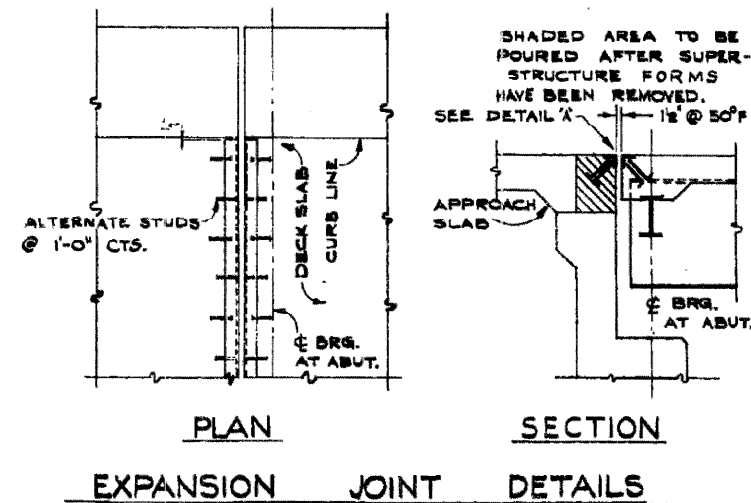

7/16" φ HOLES @ 12" CTS. FOR 3/8" φ BOLTS.
ALL BOLTS SHALL BE BURNED, SAWED,
OR CLIPPED OFF FLUSH WITH BACK OF
ANGLES AFTER FORMS ARE REMOVED.

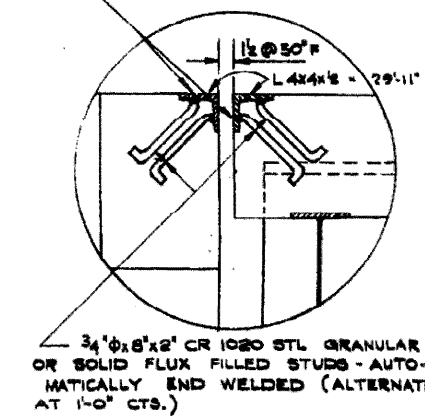

DETAIL 'A'

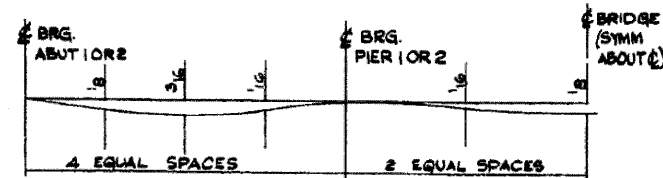

DEAD LOAD DEFLECTION DIAGRAM
(FOR SLAB ONLY) SAME DEFLECTION FOR ALL BEAMS

FOR STEEL DETAILS SEE SHT. NO. 10.			
ILLINOIS DIVISION OF HIGHWAYS ROCKFORD BYPASS			
F. A. ROUTE 194			
PROJECT	SECTION 3VB		
WINNEBAGO COUNTY			
STEEL FRAMING PLAN			
Designed By: JWF	Drawn By: JWF	Checked By: L.P.	

LOCATION 2 STRUCTURES 101-0063 & 101-0064

FILE NAME = F:\PAINTING\64D91\paint2008-3.dgn	USER NAME = 1nkldj	DESIGNED -	REVISED -	STATE OF ILLINOIS DEPARTMENT OF TRANSPORTATION	EXISTING BRIDGE PLANS	F.A.P. RTE. 301	SECTION	COUNTY WINNEBAGO	TOTAL SHEETS 19	SHEET NO. 19
PLOT SCALE = 50.0000" / IN.	CHECKED -	REVISED -	SCALE:			SHEET NO. OF SHEETS	STA. TO STA.	CONTRACT NO. 64D91		ILLINOIS FED. AID PROJECT
PLOT DATE = Thu Jan 24 07:59:43 2008	DATE -	REVISED -								