

PROPOSED LEGEND

- ① 4" TOPSOIL PLACEMENT
- ② SEEDING, CLASS 2A
- ③ SEEDING, CLASS 4
- ④ AGGREGATE SUBGRADE IMPROVEMENT 12"
- ⑤ SUBBASE GRANULAR MATERIAL, TYPE C 4"
- ⑥ STABILIZED SUBBASE - HOT-MIX ASPHALT, 4"
- ⑦ BITUMINOUS MATERIALS (PRIME COAT)
- ⑧ PORTLAND CEMENT CONCRETE PAVEMENT 9 3/4" (JOINTED)
- ⑨ PORTLAND CEMENT CONCRETE SHOULDERS 9 3/4"
- ⑩ PIPE UNDERDRAINS 6"
- ⑪ COMBINATION CONCRETE CURB AND GUTTER, TYPE B-6.24
- ⑫ COMBINATION CONCRETE CURB AND GUTTER, TYPE B-6.24 (ABUTTING EXISTING PAVEMENT)
- ⑬ COMBINATION CONCRETE CURB AND GUTTER, TYPE M-6.06
- ⑭ COMBINATION CONCRETE CURB AND GUTTER, TYPE M-6.24 (ABUTTING EXISTING PAVEMENT)
- ⑮ CONCRETE MEDIAN SURFACE, 4 INCH
- ⑯ LONGITUDINAL CONSTRUCTION JOINT DRILL AND GROUT *6 TIE BARS 30" LONG AT 18" CTS
- ⑰ LONGITUDINAL SAWED JOINT *6 TIE BARS 36" LONG AT 18" CTS
- ⑱ LONGITUDINAL CONSTRUCTION JOINT DRILL AND GROUT *8 TIE BARS 30" LONG AT 18" CTS
- ⑲ CLASS SI CONCRETE (OUTLET)


NOTE:

SEE ROADWAY PLAN AND PROFILE SHEETS FOR LOCATIONS OF PRECAST CONCRETE PAVEMENT SLABS.


DENOTES WORK INCLUDED IN THE COST OF OTHER ITEMS.

EXISTING LEGEND

- A 12" TOP SOIL
- B 12" AGGREGATE SUBGRADE IMPROVEMENT
- C 4" STABILIZED SUBBASE - HOT-MIX ASPHALT
- D 9 3/4" PCC PAVEMENT
- E 9 3/4" PCC SHOULDERS
- F 9 3/4" AGGREGATE SHOULDERS
- G COMB. CONCRETE CURB AND GUTTER, B-6.24
- H TIE BARS
- I TURF MEDIAN

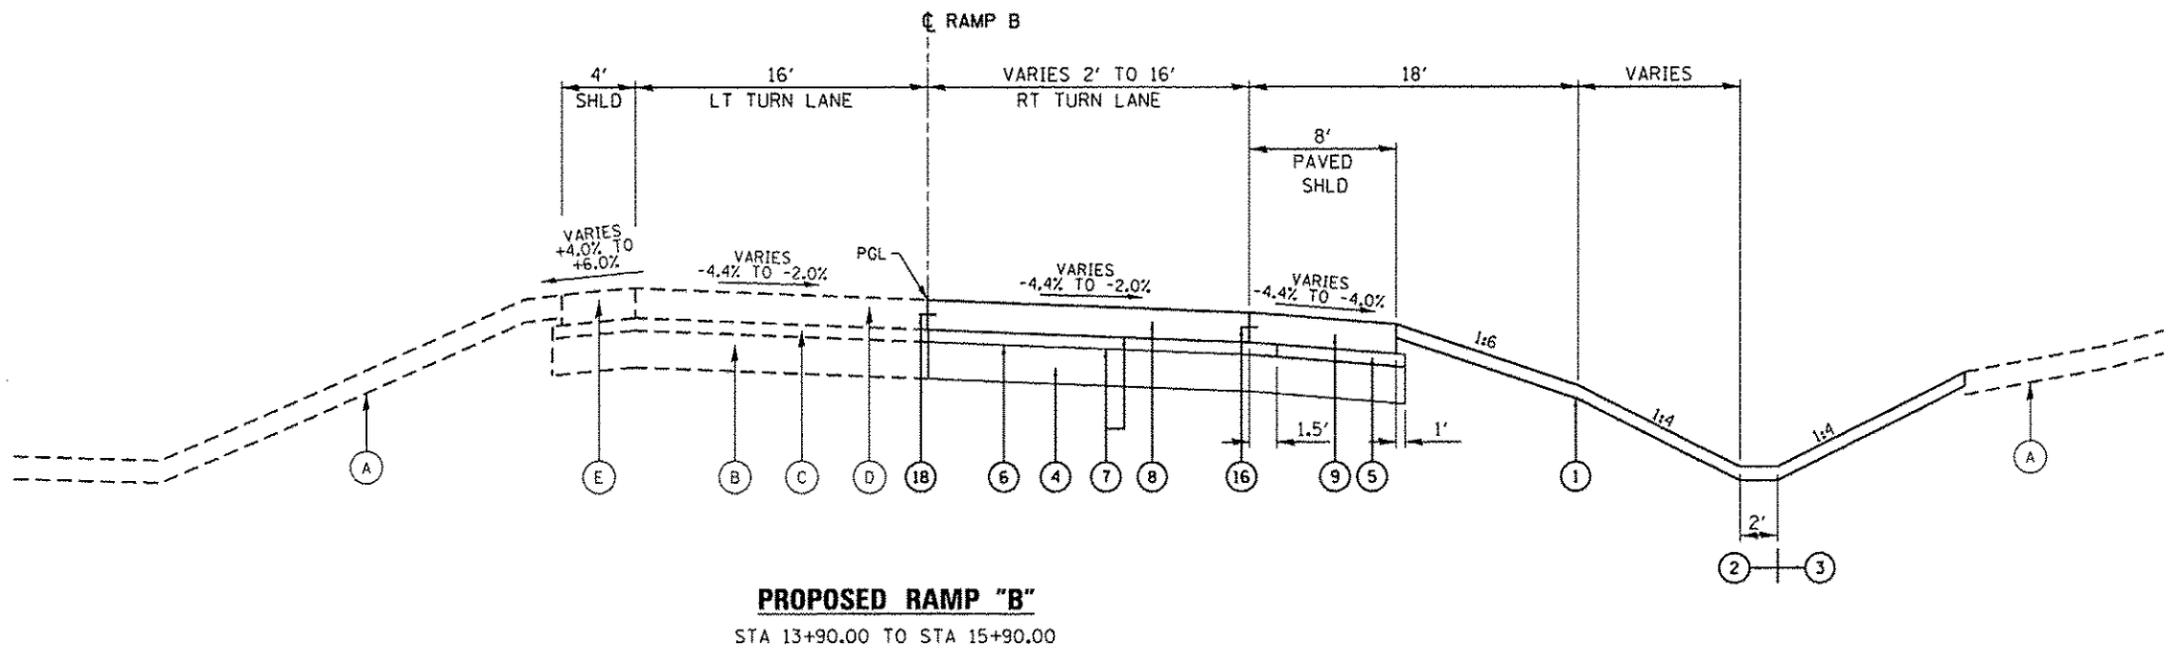

PROPOSED RAMP "B"
STA 13+90.00 TO STA 15+90.00

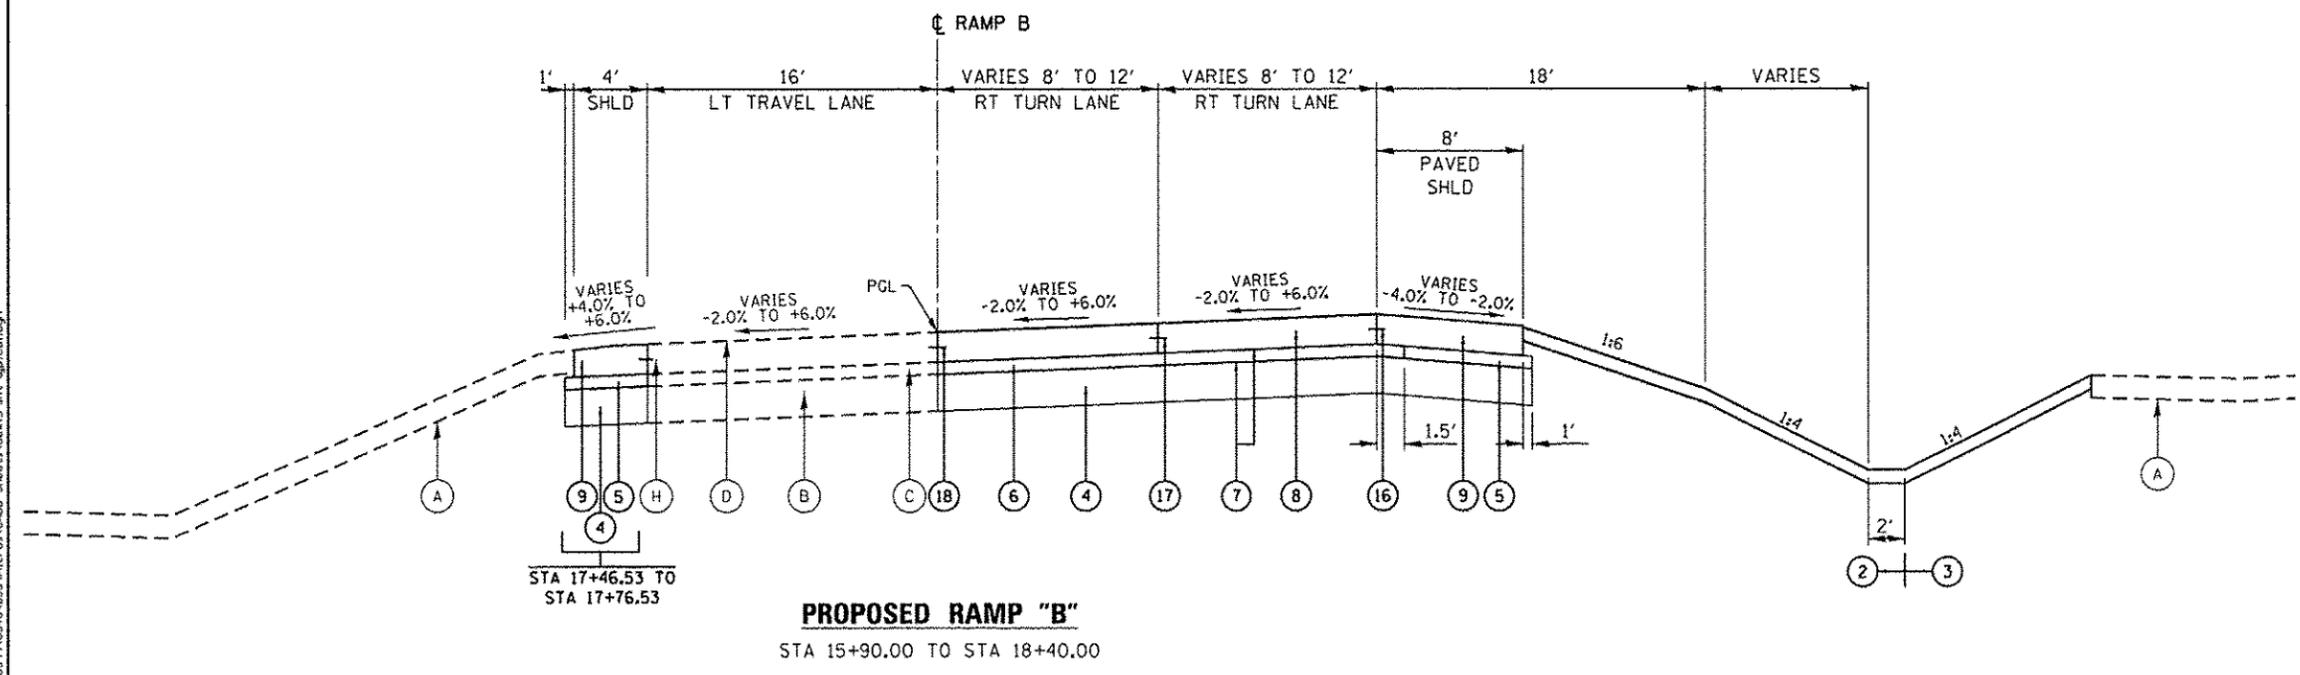

PROPOSED RAMP "B"
STA 15+90.00 TO STA 18+40.00

FILE NAME = S:\A\2013\12\17\13\6346\855\MicroStation\Drawings\13-12-17-13-11.dgn

SA STRAND ASSOCIATES
1170 SOUTH HOUBOLT ROAD
JOLIET, ILLINOIS 60431
(815) 744-4200

USER NAME = dennis	DESIGNED - JLB	REVISED -
MODEL NAME = Default	DRAWN - DJW	REVISED -
PLOT SCALE = 10.0000' / in.	CHECKED - BMA	REVISED -
PLOT DATE = 12/10/2013	DATE - 12/17/13	REVISED -

**STATE OF ILLINOIS
DEPARTMENT OF TRANSPORTATION**

TYPICAL SECTIONS	
SCALE: NTS	SHEET 3 OF 7 SHEETS STA. TO STA.

F.A.P. RTE. 575	SECTION 14-N	COUNTY WILL	TOTAL SHEETS 163	SHEET NO. 20
CONTRACT NO. 60W13			ILLINOIS FED. AID PROJECT	