## SCHEDULE OF QUANTITIES

TEMPORARY CONCRETE BARRIER STATION STATION <u>T0</u>

TEMPORARY BRIDGE TRAFFIC SIGNALS - 1 EACH

425

TEMPORARY RUMBLE STRIPS - 6 EACH

IMPACT ATTENUATORS, TEMPORARY

(NON-REDIRECTIVE), TEST LEVEL 3 - 2 EACH

## **LEGEND**

TRAFFIC SIGNAL WITH BACKPLATE, SIGNAL DIRECTION INDICATED

DETECTOR LOOP

DRUM WITH STEADY BURNING BI-DIRECTIONAL LIGHT

TYPE III BARRICADE

PAVEMENT REMOVAL

BASE COURSE WIDENING, 10'

HMA SHOULDER, 8'

CHECKED

5:20:31 PM DATE

PLOT DATE = 1/22/2014


JMS

11/13

REVISED

REVISED

IMPACT ATTENUATORS (TEMPORARY NON-REDIRECTIVE) TEST LEVEL 3

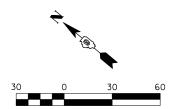

SCALE IN FEET

## **GENERAL NOTES**

- 1. PRE-STAGE I: CONSTRUCT THE BASE COURSE FROM LT. STA. 995+20 TO LT. STA. 999+53 AS SHOWN ON THIS SHEET PRIOR TO PLACING THE SIGNALS IN OPERATION AND PLACEMENT OF THE TEMPORARY BARRIERS.
- TRAFFIC CONTROL SHALL BE ERECTED AS SHOWN AND ACCORDING TO TRAFFIC CONTROL AND PROTECTION, STANDARD 701321. SEE STANDARD 701321 FOR THE COMPLETION OF THE STAGE CONSTRUCTION TRAFFIC CONTROL THAT IS NOT SHOWN THAT INCLUDES, BUT IS NOT LIMITED TO, ADVANCE SIGNING, ADVANCE LOOP PLACEMENT, DRUMS WITH STEADY BURNING LIGHTS, DOUBLE VERTICAL PANELS AND BARRIER WALL/ GUARDRAIL MARKERS.
- 3. SEE SPECIAL PROVISIONS FOR ADDITIONAL TRAFFIC CONTROL REQUIREMENTS.
- 4. COORDINATE LOCATION OF SIGNALS WITH FINAL WORK AS DIRECTED BY THE ENGINEER.
- 5. CONSTRUCT TEMPORARY RUMBLE STRIPS AT LOCATIONS SHOWN ON STANDARD 701321.
- 6. ADVANCE WIDTH RESTRICTION WARNING SHALL BE INCLUDED IN THE COST OF STANDARD 701321.
- 7. THE DIMENSION SHOWN ON THE WIDTH RESTRICTION SIGN (W12-I102(0)-48) SHOWN ON STANDARD 701321 AND ON THE ADVANCE WARNING SIGN (W12-I103) SHOWN ON SHEET 18 SHALL BE 11'-3" FOR STAGE I CONSTRUCTION.

  13. THE CONTRACTOR AND THE ENGINEER SHALL COORDINATE ACCESS WITH THE PROPERTY OWNER DURING CONSTRUCTION FOR THE FIELD ENTRANCE AT RT. STA. 995+06.
- THE ADVANCE DETECTOR LOOPS ARE TYPICALLY LOCATED 275 FEET IN ADVANCE OF THE STOP BAR. THE BUREAU OF OPERATIONS SHOULD APPROVE THE LOOP LOCATIONS PRIOR TO INSTALLATION.
- 9. THE CENTERLINE PAVEMENT MARKING SHOULD BE REMOVED FROM THE STOP BAR TO THE SAND ATTENUATORS OR DRUMS. EDGE LINE PAVEMENT MARKING SHOULD BE REMOVED IF A 10 FOOT LANE WIDTH CANNOT BE MAINTAINED. TEMPORARY EDGE LINES SHOULD BE INSTALLED WHEN THE EDGE LINES ARE REMOVED.
- 10. VERTICAL PANELS SHOWN ON STANDARD 701321 WILL NOT BE REQUIRED ON THE STAGE II NEW BRIDGE PARAPET. THE BARRIER WALL REFLECTORS SHALL BE INSTALLED PRIOR TO OPENING TO TRAFFIC.

- 11. ANY TIME THE CONCRETE BARRIER IS NOT IN THE PROPER POSITION, FLAGGERS SHALL BE IN PLACE TO CONTROL TRAFFIC AND THE TEMPORARY TRAFFIC SIGNALS
- 12. THE STAGE I CONSTRUCTION SHALL INCLUDE COMPLETION OF THE EARTHWORK,
  BASE COURSE, HMA SHOULDERS, GUARDRAIL AND TRAFFIC BARRIER TERMINALS
  FROM RT. STA. 995+01 TO RT. STA. 999+53 AS REFERENCED ON THIS SHEET AND
  DESCRIBED IN DETAIL ON THE PLAN AND PROFILE SHEETS. THE LEVELING BINDER
  (MACHINE METHOD) AND THE HMA SURFACE COURSE SHALL ALSO BE PLACED ON THE
  TRAFFIC LANE ADJACENT TO THE PROPOSED HMA SHOULDERS TO ALLOW COMPLETION
  OF THE HMA SHOULDERS PRIOR TO THE INSTALLATION OF THE GUARDRAIL AND TERMINALS.
  PLACEMENT OF THE LEVELING BINDER AND HMA SURFACE AS INDICATED MAY REQUIRE
  RELOCATION OF THE TEMPORARY BARRIERS AND THE IMPACT ATTENUATORS DURING
  THE DAYTIME HOURS AND ALSO PLACEMENT OF A TEMPORARY RAMP IN ACCORDANCE
  WITH ARTICLE 406.08 OF THE STANDARD SPECIFICATIONS. THE CONTRACTOR WILL SUBMIT
  A WRITTEN PLAN TO THE ENGINEER FOR APPROVAL THAT DETAILS THE STAGING OF THE
  HMA RESURFACING FOR STAGE I CONSTRUCTION TO MEET THESE REQUIREMENTS. THE
  COST ASSOCIATED WITH THE STAGING OF THE HMA RESURFACING, INCLUDING THE
  TEMPORARY RAMP, WILL NOT BE PAID FOR SEPARATELY BUT WILL BE INCLUDED IN THE
  COST OF THE VARIOUS HMA PAY ITEMS INCLUDED IN THE PLANS. COST OF THE VARIOUS HMA PAY ITEMS INCLUDED IN THE PLANS.

782

FED. ROAD DIST. NO.

TO STA. 1001+00

STRUCTURE NO. 035-0017


SCALE: 1"=30'-0" SHEET NO. 1 OF 2 SHEETS STA. 992+00

115B-1

HARDIN

70 17

CONTRACT NO. 78263

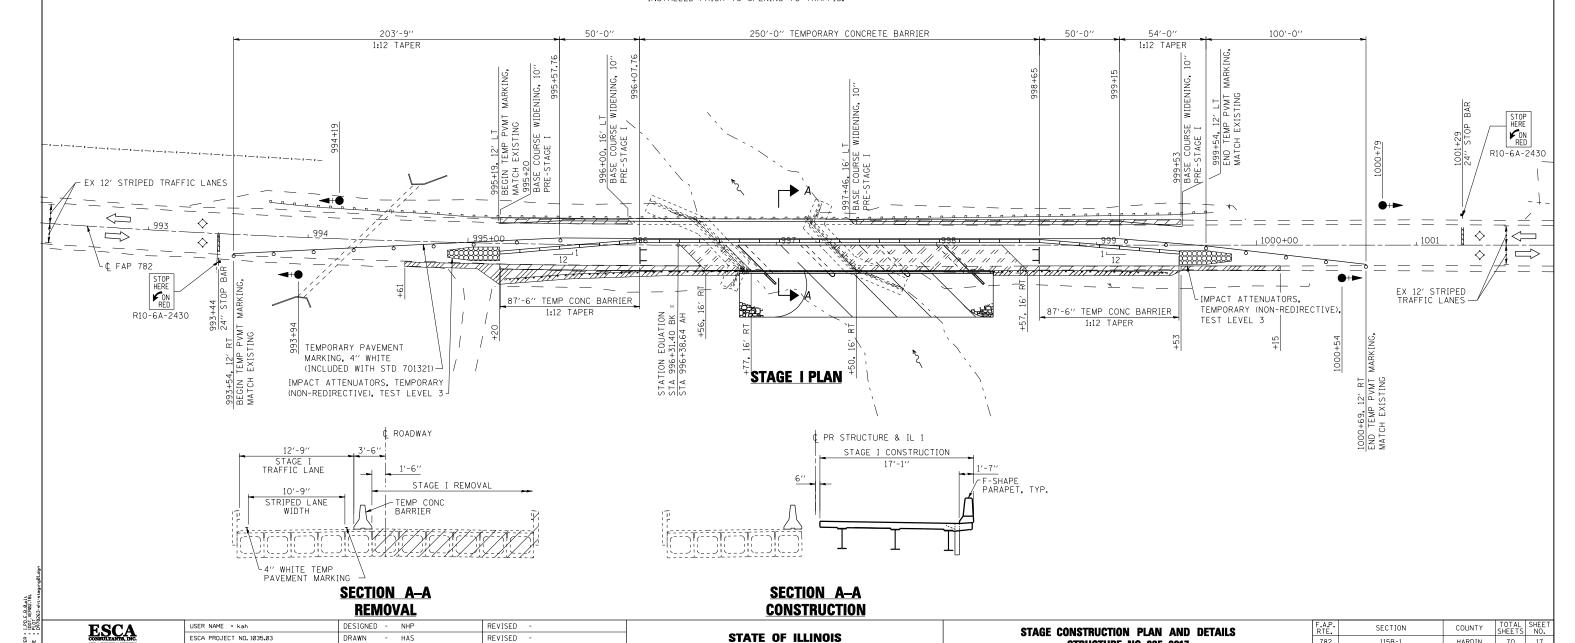

**DEPARTMENT OF TRANSPORTATION**