INDEX OF SHEETS 04-25-14 LETTING ITEM 149

STATE OF ILLINOIS

DEPARTMENT OF TRANSPORTATION

11-00026-02-PV 9393 MADISON ILLINOIS CONTRACT NO. 97550 FEO. ROAD DIST, NO.

FEDERAL AID PROJECT

PLANS FOR PROPOSED

CITY OF TROY N. MAIN STREET RECONSTRUCTION **FAU ROUTE 9393**

SECTION: 11-00026-02-PV PROJECT: TCSP IL11 (025)

JOB NO.: C-98-319-12 **MADISON COUNTY**

HIGHWAY STANDARDS

COVER SHEET

TYPICAL SECTIONS

SUMMARY OF QUANTITIES

SCHEDULE OF QUANTITIES

TRAFFIC CONTROL STAGING PLANS

PLAN & PROFILE SHEET

INTERSECTION DETAILS

CONSTRUCTION DETAILS

CROSS SECTIONS

SHEET NO.

3-4

5-6

9-11

12 13 14--15

16-19

20-21

 \circ

0

0

 \circ

000001-06	STANDARD SYMBOLS, ABBREVIATIONS AND PATTERNS
28000107	TEMPORARY EROSION CONTROL SYSTEMS
424001-07	PERPENDICULAR CURB RAMPS FOR SIDEWALKS
424016-01	MID BLOCK CURB RAMPS FOR SIDEWALKS
442201-03	CLASS C AND D PATCHES
60600105	CONC CURB TYPE B AND COMB CONC CURB AND GUTTER
701001-02	OFF-RD OPERATIONS, 2L, 2W, MORE THAN 15' (4,5 m) AWAY
70100605	OFF-RD OPERATIONS, 2L, 2W 15' (4.5 m) TO 24" (600 mm) FROM PAVEMENT ED(
70180105	LANE CLOSURE MULTILANE 1W OR 2W CROSSWALK OR SIDEWALK CLOSURE

GENERAL NOTES, UTILITIES, & ALIGNMENT TIE POINTS


EROSION CONTROL SIGNING, AND PAVEMENT MARKING PLAN

701901-03 TRAFFIC CONTROL DEVICES SIGN PANEL ERECTION DETAILS 720006...04 TYPICAL PAVEMENT MARKINGS

WENDELL **END SECTION** STA 110 + 45.00 **BEGIN SECTION** STA 107 + 82.02

DESIGN DESIGNATION

ROADWAY CLASSIFICATION = URBAN COLLECTOR DESIGN SPEED = 30 M.P.H. CURRENT TRAFFIC (2012) = 2,000 A.D.T. PROJECTED TRAFFIC (2032) = 2,450 A.D.T.

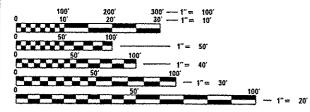

FULL SIZE PLANS HAVE BEEN PREPARED USING STANDARD ENGINEERING SCALES. REDUCED SIZED PLANS WILL NOT CONFORM TO STANDARD SCALES, IN MAKING MEASUREMENTS ON REDUCED PLANS, THE ABOVE SCALES MAY BE USED.


JOINT UTILITY LOCATION INFORMATION FOR EXCAVATION 1-800-892-0123

LOCATION MAP

SCALE 1" = 2,000"

GROSS LENGTH = 262.98 FEET (0.050 MILES)

SCALE IN	FEET
PLAN	1" = 20"
PROFILE HORIZ	1"=20'
PROFILE VERT	1"=5"
CROSS SECTION	1"=10"

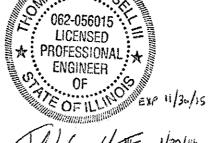

OATES ASSOCIATES

100 Lanter Court, Suite 1

LOCATION OF SECTION INDICATED THUS: -

20 E. Main Street

720 Olive, Suite 1660 St. Louis, MO 63101 tel 314.588.8381

1-28-14

MAYOR OF TROY

ILLINOIS DESIGN FIRM LICENSE NO: 184.001115

PRINTED BY THE AUTHORITY OF THE STATE OF ILLINOIS

STATE OF ILLINOIS DEPARTMENT OF TRANSPORTATION DIVISION OF HIGHWAYS

GENERAL NOTES

UTILITIES

- 1. UNDERGROUND FACILITIES, STRUCTURES AND UTILITIES HAVE BEEN PLOTTED FROM AVAILABLE SURVEYS AND RECORDS. THEIR LOCATIONS MUST BE CONSIDERED TO BE APPROXIMATE ONLY. IT IS POSSIBLE THERE MAY BE OTHERS, THE EXISTENCE OF WHICH IS NOT PRESENTLY KNOWN OR SHOWN. IT IS THE CONTRACTOR'S RESPONSIBILITY TO DETERMINE THEIR EXISTENCE AND EXACT LOCATION AND TO AVOID DAMAGE THERETO. ILLINOIS LAW REQUIRES A MINIMUM 48-HOUR NOTICE TO ALL UTILITY COMPANIES BEFORE DIGGING. FIELD LOCATIONS OF UNDERGROUND FACILITIES MAY BE OBTAINED BY CALLING THE JULLIE. SYSTEM AT 800-892-0123 AND PROVIDING 48 HOURS ADVANCE NOTICE. NON-JULLIE MEMBERS MUST BE NOTIFIED INDIVIDUALLY. AGENCIES KNOWN TO HAVE FACILITIES WITHIN THE PROJECT LIMITS ARE LISTED BELOW.
- 2. ANY FACILITIES OR APPURTENANCES WHICH ARE THE PROPERTY OF ANY PUBLIC UTILITY LOCATED WITHIN THE LIMITS OF CONSTRUCTION SHALL BE RELOCATED OR ADJUSTED BY THEIR RESPECTIVE OWNERS UNLESS NOTED OTHERWISE ON THE PLANS. THE CONTRACTOR SHALL NOTIFY AND COOPERATE WITH THE OWNERS OF ANY SUCH FACILITY IN THEIR REMOVAL AND REARRANGEMENT OPERATIONS IN ORDER THAT THESE OPERATIONS AND THE CONSTRUCTION OF THIS PROJECT MAY PROGRESS IN A REASONABLE MANNER. ALL ROADSIDE OBJECTS (UTILITY POLES, FIRE HYDRANTS, SIONS, ETC.) SHALL BE RELOCATED TO PROVIDE A MINIMUM OF 1.5 FEET CLEARANCE. MEASURED FROM THE FACE OF CURB TO THE NEAR EDGE OF THE OBJECT.
- 3. THE FOLLOWING UTILITY COMPANIES MAY HAVE FACILITIES LOCATED WITHIN THE LIMITS OF CONSTRUCTION WHICH MAY REQUIRE ADJUSTMENT, RELOCATION OR REMOVAL. ALL ARE MEMBERS OF J.U.L.I.E., UNLESS NOTED OTHERWISE.

CITY OF TROY (WATER & SANITARY SEWER) 116 EAST MARKET STREET TROY, IL 62294 (618) 667-9924 AMEREN IP (GAS & ELECTRIC) 2600 NORTH CENTER MARYVILLE, IL 62062 (618) 346-1287

CHARTER COMMUNICATIONS (CABLE TV)
210 WEST DIVISION STREET
MARYVILLE, IL 62062

ATT (TELEPHONE)
203 COETHE STREET
COLLINSVILLE, IL 62234
(618) 346-6400

4. THE ABOVE UTILITY INFORMATION REPRESENTS THE BEST INFORMATION AVAILABLE TO THE LOCAL AGENCY AND IS ONLY INCLUDED FOR THE CONVENIENCE OF THE BIDDER. IT IS UNDERSTOOD AND AGREED THAT THE CONTRACTOR HAS TAKEN THE FOREGOING INTO CONSIDERATION IN PREPARING HIS/HER BID, AND NO ADDITIONAL COMPENSATION WILL BE ALLOWED FOR ANY DELAYS OR INCONVENIENCE CAUSED BY SAME.

GENERAL CONSTRUCTION

- THE CONTRACTOR SHALL VERIFY ALL DIMENSIONS AND CONDITIONS IN THE FIELD PRIOR TO ORDERING MATERIALS
 AND COMMENCING CONSTRUCTION.
- 6. THE CONTRACTOR SHALL STAGE ALL WORK IN SUCH A WAY AS TO MAINTAIN INCRESS AND EGRESS TO ALL ABUTTING PROPERTIES AT ALL TIMES DURING CONSTRUCTION. AGGREGATE FOR TEMPORARY ACCESS WILL BE MEASURED FOR PAYMENT AS SPECIFIED IN THE CONTRACT. THE COST OF ALL OTHER MATERIALS REQUIRED AND ALL OTHER LABOR NECESSARY TO COMPLY WITH THIS PROVISION WILL NOT BE PAID FOR SEPARATELY, BUT SHALL BE CONSIDERED AS INCLUDED IN THE UNIT BID PRICES OF THE CONTRACT. SEE LOCAL ACCESS SPECIAL PROVISION FOR MORE INFORMATION.
- 7. THE CONTRACTOR SHALL CONFINE ALL OPERATIONS TO THE CONSTRUCTION LIMITS LINE SHOWN ON THE PLANS.
 ANY AREA DISTURBED BEYOND THESE LIMITS SHALL BE RESTORED TO ITS ORIGINAL CONDITION AT THE
 CONTRACTOR'S EXPENSE
- 8. THE CONTRACTOR SHALL FERTILIZE, SEED, AND MULCH ALL EARTH SURFACES DISTURBED BY CONSTRUCTION. THIS WORK WILL NOT BE PAID FOR SEPARATELY, BUT SHALL BE CONSIDERED AS INCLUDED IN THE UNIT BID PRICES OF THE CONTRACT.
- 9. REMOVAL AND DISPOSAL OF UNSUITABLE MATERIAL INCLUDES THE REMOVAL OF THE EXISTING BITUMINOUS (OIL & CHIP) ROADWAY SURFACE AND AGGREGATE BASE. SURPLUS AND/OR UNSUITABLE MATERIAL SHALL BE DISPOSED OUTSIDE THE LIMITS OF THE RIGHT OF WAY ACCORDING TO ARTICLE 202.03 OF THE "STANDARD SPECIFICATIONS FOR ROAD AND BRIDGE CONSTRUCTION."
- 10. THE CONTRACTOR SHALL NOTE THE LOCATION OF ALL MANHOLE AND VALVE COVER FRAMES AND LIDS LOCATED WITHIN RESURFACING LIMITS AT IL ROUTE 162 AND MAIN STREET. APPROPRIATE CARE SHALL BE TAKEN TO PROTECT THESE ITEMS DURING MILLING OPERATIONS.
- 11. THE THICKNESS OF THE HOT-MIX ASPHALT MIXTURES SHOWN ON THE PLANS IS THE NOMINAL THICKNESS. DEVIATIONS FROM THE NOMINAL THICKNESS WILL BE PERMITTED WHEN SUCH DEVIATIONS OCCUR DUE TO IRREGULARITIES IN THE EXISTING SURFACE OR BASE ON WHICH THE HMA MIXTURES ARE PLACED.
- 12. HIGH EARLY STRENGTH CONCRETE MIX SHALL BE USED FOR THE CONSTRUCTION OF PCC ENTRANCES AND CROSSWALKS. THE COST OF THIS WORK WILL NOT BE PAID FOR SEPARATELY, BUT SHALL BE CONSIDERED AS INCLUDED IN THE CONTRACT UNIT PRICE FOR THE VARIOUS PCC PAVEMENT ITEMS INCLUDED IN THE CONTRACT.
- 13. AT VARIOUS LOCATIONS, IT MAY BE NECESSARY TO TRANSITION PROPOSED COMBINATION CONCRETE CURB AND GUTTER TO MEET EXISTING CURBS OR GUTTERS. THE MINIMUM LENGTH OF TRANSITIONAL COMBINATION CURB AND GUTTER SHALL BE 10 FEET, UNLESS DIRECTED OTHERWISE BY THE ENGINEER.
- 14. THE CONTRACTOR SHALL NOT REMOVE ANY CURB OR SIDEWALK THAT CANNOT BE RECONSTRUCTED WITHIN FIVE CALENDAR DAYS. ACCESS TO ALL BUSINESSES AND RESIDENCES SHALL BE MAINTAINED AT ALL TIMES EXCEPT DURING CONCRETE PLACEMENT. THE CONTRACTOR SHALL CONTACT BUSINESS OWNERS AND RESIDENTS 48 HOURS PRIOR TO CONSTRUCTION ADJACENT TO THEIR AFFECTED PROPERTIES.

- 15. ALL EXISTING ROADWAY FEATURES INCLUDING PAVEMENT, CURB, SIDEWALK, DRIVEWAY PAVEMENT, CULVERTS, HEADWALLS, RIPRAP, FENCING, RETAINING WALLS, AND ANY OTHER FEATURES WHICH INTERFERE WITH THE PROPOSED CONSTRUCTION SHALL BE REMOVED BY THE CONTRACTOR UNLESS NOTED OTHERWISE ON THE PLANS. ALL FEATURES WHICH ARE TO BE REMOVED AND FOR WHICH THERE IS NO SPECIFIC PAY ITEM, WILL NOT BE MEASURED SEPARATELY FOR PAYMENT AND THE COST OF THIS REMOVAL WORK SHALL BE CONSIDERED AS INCLUDED IN THE CONTRACT UNIT PRICE FOR REMOVAL AND DISPOSAL OF UNSUITABLE MATERIAL.
- DECORATIVE SIGN POSTS AND FRAMES MUST MEET FEDERAL CRASHWORTHINESS STANDARDS. DOCUMENTATION IS REQUIRED.

DRAINAGE

- 17. THE OFFSETS TO ALL INLETS AND MANHOLES ARE GIVEN TO THE CENTER OF THE OPENING AT THE BASE OF THE FRAME AND GRATE OR LID.
- 18. THE CONTRACTOR SHALL INCLUDE THE COST OF MAKING CONNECTIONS TO EXISTING DRAINAGE STRUCTURES IN THE CONTRACT UNIT PRICE FOR THE STORM SEWER ITEMS INVOLVED.
- 19. ALL DRAINAGE STRUCTURES CONSTRUCTED. ADJUSTED OR RECONSTRUCTED UNDER THE CONTRACT, SHALL BE CLEANED OF ANY ACCUMULATION OF SILT, DEBRIS OR FOREIGN MATTER AT THE END OF EACH WORKING DAY AND AT THE TIME OF FINAL INSPECTION. THE COST OF THIS WORK WILL NOT BE PAID FOR SEPARATELY, BUT SHALL BE CONSIDERED AS INCLUDED IN THE CONTRACT UNIT PRICE FOR THE VARIOUS DRAINAGE STRUCTURE ITEMS INCLUDED IN THE CONTRACT.

MISCELLANEOUS

- 20. A QUANTITY FOR TEMPORARY PAVEMENT MARKING EQUAL TO THE AMOUNT OF PERMANENT PAVEMENT MARKING TIMES THE NUMBER OF REQUIRED APPLICATIONS HAS BEEN INCLUDED IN THE PLANS. ONLY THE FINAL APPLICATION OF TEMPORARY PAVEMENT MARKINGS SHALL BE REMOVED AND SEPARATE PAYMENT WILL BE MADE FOR WORK ZONE PAVEMENT MARKING REMOVAL.
- 21. THE PAVEMENT MARKING LOCATIONS SHOWN IN THE PLANS ARE APPROXIMATE. PROPOSED CROSSWALKS AND STOP BARS SHALL BE ADJUSTED AS DIRECTED BY THE ENGINEER, IF NECESSARY, TO MATCH FIELD CONDITIONS.
- 22. THE FOLLOWING ITEMS AND APPROXIMATE QUANTITIES ARE INCLUDED IN THE "SUMMARY OF QUANTITIES" IN ORDER TO ESTABLISH A UNIT COST FOR WORK WHICH MAY BE REQUIRED TO CONSTRUCT THIS SECTION. THE ACTUAL QUANTITY OF EACH ITEM SHALL BE DETERMINED BY THE ENGINEER IN THE FIELD.

AGGREGATE FOR TEMPORARY ACCESS

50 TON

23. THE FOLLOWING SYMBOLS, ABBREVIATIONS AND PATTERNS SUPPLEMENT OR SUPERCEDE HIGHWAY STANDARD 000001:

BO BY OTHERS (USED IN CONJUNCTION WITH TBA & TBR)

CMP CORRUGATED METAL PIPE

CONSTR CONSTRUCTION

CP CONTROL POINT

DND DO NOT DISTURB
FC FLOWLINE OF GUTTE

FG FLOWLINE OF GUTTER

K LENGTH OF VERTICAL CURVE PER PERCENT GRADE DIFFERENCE

LSA LANDSCAPE AREA

ME MATCH EXISTING

N/F NOW OR FORMERLY

/C OIL AND CHIP

PERM PERMANENT

PVI POINT OF VERTICAL INTERSECTION

C TOP OF CURB

TBA TO BE ADJUSTED

TBRL TO BE RELOCATED
TYP TYPICAL

width

ALIGNMENT TIE POINTS

DESCRIPTION: OFFSET NORTHING: EASTING: P.O.T. 107+00.00 CL 751,051.88 2,377,437.86 P.T. 107+80.21 CL 751,131.22 2,377,449.69 P.T. 109+13.38 CL 751,263.18 2,377,467.63 P.O.T. 110+76.82 CL 751,424.74 2,377,492.30

COMMITMENTS

NONE TO DATE

SCALE: NTS

FILE NAME :	USER NAME = default	DESIGNED -	REVISED -	
D8268591,003-shs-germote.dgn	PLOT TIME = 7:42:58 AM	DRAWN -	REVISED -	STATE OF ILLINOIS
	PLOT SCALE = 48,0888 '/ IN.	CHECKED -	REVISEO ~	DEPARTMENT OF TRANSPORTATION
	PLOT DAYE = 1/28/2014	DATE -	REVISED -	

CENERAL	NOTES, UTILITIES, &	ALICMBERIT	TIE	DOINTS
WEST WILLIAM	HOTEO, OTHERTIES, G	PERSONALISTE	***	1 011110

TO STA.

SHEET NO. ! OF ! SHEETS STA.

1	ILL INDIS FED. A	IN DOMEST		
N. H	AIN STREET RECONSTRUCTION	CONTRAC	NO. S	7550
9393	11-00026-02-PV	MADISON	21	2
F.A.U. RTE.	SECTION	COUNTY	TOTAL	SHEE NO.

CODE NO.	ITEM	UNIT	TOTAL QUANTIT
			UUANTII
20201200	REMOVAL AND DISPOSAL OF UNSUITABLE MATERIAL	CU YD	77
28000500	INLET AND PIPE PROTECTION	EACH	
31100910	SUBBASE GRANULAR MATERIAL, TYPE A 12"	SO YD	1,55
40201000	AGGREGATE FOR TEMPORARY ACCESS	TON	5
40600100	BITUMINOUS MATERIALS (PRIME COAT)	GALLON	2
40600990	TEMPORARY RAMP	SO YD	6
40603085	HOT-MIX ASPHALT BINDER COURSE, IL-19.0, N70	TON	39
40603315	HOT-MIX ASPHALT SURFACE COURSE, MIX "C", N70	TON	. 17
42300400	PORTLAND CEMENT CONCRETE DRIVEWAY PAVEMENT, 8 INCH	SO YD	10
42400100	PORTLAND CEMENT CONCRETE SIDEWALK 4 INCH	SO FT	3,48
42400800	DETECTABLE WARNINGS	SO FT	3
44000100	PAVEMENT REMOVAL	SO YO	29
44000157	HOT-MIX ASPHALT SURFACE REMOVAL. 2"	so yp	37
	DRIVEWAY PAVEMENT REMOVAL		

CODE NO.	ITEM	UNIT	TOTAL QUANTITY
44000500	COMBINATION CURB AND GUTTER REMOVAL	F00T	535
44000600	SIDEWALK REMOVAL	SO FT	3,507
44201737	CLASS D PATCHES, TYPE I, 8 INCH	SO YD	32
60603800	COMBINATION CONCRETE CURB AND GUTTER, TYPE B-6.12	FOOT	540
67100100	MOBILIZATION	L SUM	1
70300220	TEMPORARY PAVEMENT MARKING - LINE 4"	FOOT	898
70300260	TEMPORARY PAVEMENT MARKING - LINE 12"	FOOT	385
70300280	TEMPORARY PAVEMENT MARKING - LINE 24"	F00T	290
70301000	WORK ZONE PAVEMENT MARKING REMOVAL	SO FT	1,265
72000100	SIGN PANEL - TYPE 1	SO FT	13.3
78000200	THERMOPLASTIC PAVEMENT MARKING - LINE 4"	FOOT	898
78000650	THERMOPLASTIC PAVEMENT MARKING - LINE 24"	FOOT	290
78001150	PAINT PAVEMENT MARKING - LINE 12"	FOOT	385
81028350	UNDERGROUND CONDUIT, PVC, 2" DIA,	FOOT	940

SP SEE PROJECT SPECIFIC SPECIAL PROVISIONS
• SPECIALTY ITEM

- 3	~~~~~~~~~~~~~~~~~~~~~~~~~~~~~~~~~~~~~~				
	FILE NAME .	USER NAME : default	DESIGNED -	REVISED -	_
	D8268591.883~#ht+500.dgA	PLOT TIME 4 7:43:88 AM	DRAWN -	REVISED -	
		PLOT SCALE = 48.0800 1/ IN.	CHECKED -	REVISEO -	
1		PLOT DATE = 1/28/2014	DATE -	DEVICEO	

STATE OF ILLINOIS
DEPARTMENT OF TRANSPORTATION

SUMMARY OF QUANTITIES						F.A.U. RTE.	SECTION	COUNTY	SHEET NO.				
	SUMMARY OF QUANTITIES					9393	11-00026-02-PV	MADISON	21	3			
SCALE: N	rs :	SHEET NO. 1	OF 2	SHEETS	STA,	TO 517		N. MAIN STREET RECONSTRUCTION CONTRACT NO. 97550					

	CODE NO.	ITEM	UNIT	TOTAL QUANTITY
•	87900200	ORILL EXISTING HANDHOLE	EACH	2
•	A2005140	TREE, KOELREUTERIA PANICULATA (GOLDEN RAINTREE). 2" CALIPER, BALLED AND BURLAPPED	EACH	2
•	B2001116	TREE, CERCIS CANADENSIS (EASTERN REDBUD), 2" CALIPER, TREE FORM, BALLED AND BURLAPPED	EACH	3
SP	x0322024	TRENCH DRAIN	EACH	1
SP	X4240420	PORTLAND CEMENT CONCRETE SIDEWALK 4 INCH, SPECIAL	SO FT	1,260
SP	-X6024242	INLETS, SPECIAL, NO. 1	EACH	1
SP	×7010216	TRAFFIC CONTROL AND PROTECTION. (SPECIAL)	L SUM	1
5P •	X8140105	HANDHOLE (SPECIAL)	EACH	2
3P •	XX002918	TREE FRAME AND GRATES	EACH	5
SP	XX006213	METAL POST. SPECIAL	EACH	3
SP	XX008225	HIGH-EARLY-STRENGTH PORTLAND CEMENT CONCRETE PAVEMENT 10", STAMPED & COLORED	SQ YD	183
-				
PROTEST PROPERTY VICE AND				
-				
L		NOTES:	And the state of t	

ITEM	UNIT	TOTAL QUANTITY
	ITEM	

SP SEE PROJECT SPECIFIC SPECIAL PROVISIONS
• SPECIALTY ITEM

DESIGNED -DRAWN -FILE NAME = USER NAME : dafault REVISED -PLOT TIME * 7:43:88 AM PLOT SCALE * 46.0000 ' / IN. D8268591.883-sht-\$00.dgn REVISED -CHECKED -DATE -REVISED -PLOT DATE . 1/28/2014 REVISED -

STATE OF ILLINOIS
DEPARTMENT OF TRANSPORTATION


SCALE: NTS

SUMMARY OF QUANTITIES SHEET NO. 2 OF 2 SHEETS STA. TO STA.

RTE. SECTION COUNTY TOTAL SHEET NO.


9393 11-00026-02-PV MADISON 21 4

N. MAIN STREET RECONSTRUCTION CONTRACT NO. 97550

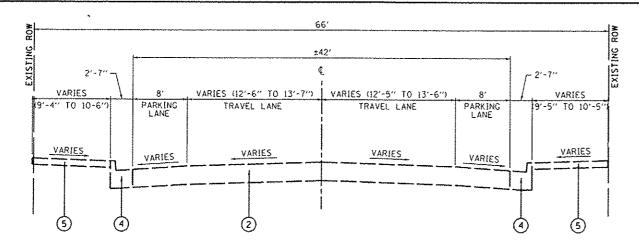


EXISTING TYPICAL SECTION

(NOT TO SCALE) STA. 108+12.30 TO STA. 109+18.65

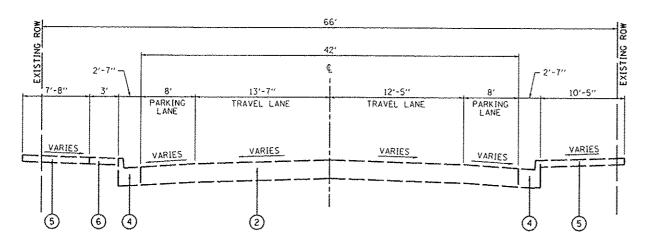

EXISTING TYPICAL SECTION

(NOT TO SCALE) STA. 108+03.00 TO STA. 108+12.30

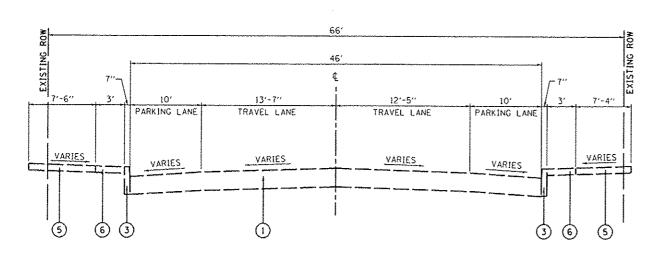

EXISTING TYPICAL SECTION

(NOT TO SCALE) STA. 107+82.02 TO STA. 108+03.00

TYPICAL SECTION LEGEND

- (1) EXISTING HOT-MIX ASPHALT / OIL AND CHIP PAVEMENT [5]
- (2) EXISTING OIL AND CHIP PAVEMENT
- 3 EXISTING CONCRETE CURB. TYPE B-6
- (4) EXISTING COMBINATION CONCRETE CURB AND GUTTER, TYPE B-6.24
- (5) EXISTING PORTLAND CEMENT CONCRETE SIDEWALK, 4 INCH
- (6) EXISTING PORTLAND CEMENT CONCRETE SIDEWALK, 4 INCH SPECIAL (BRICK PATTERN)
- (7) EXISTING LAWN AREA
- (B) PROPOSED HOT-MIX ASPHALT SURFACE COURSE, MIX "C", N70, 2"
- (9) PROPOSED HOT-MIX ASPHALT BINDER COURSE. IL-19.0. N70, 6"
- (10) PROPOSED SUBBASE GRANULAR MATERIAL, TYPE A 12"
- (11) PROPOSED COMBINATION CONCRETE CURB AND CUTTER, TYPE B-6.12
- (12) PROPOSED PORTLAND CEMENT CONCRETE SIDEWALK, 4 INCH
- 13) PROPOSED PORTLAND CEMENT CONCRETE SIDEWALK 4 INCH, SPECIAL


TYPICAL SECTION NOTES

- STA. 107+82.02 LT TO STA. 108+20.00 LT CROSS SLOPE TRANSITIONS FROM -3.5% TO -2.0%
 - STA. 108+50.00 LT TO STA. 108+75.00 LT CROSS SLOPE TRANSITIONS FROM -2.0% TO -4.0%
- STA. 107+82.02 RT TO STA. 108+20.00 RT CROSS SLOPE TRANSITIONS FROM -4.5% TO -2.0% STA. 108+90.00 RT TO STA. 109+20.00 RT CROSS SLOPE TRANSITIONS FROM -2.0% TO -4.0%
- 3 STA, 107+82.02 LT TO STA, 108+15 LT PARKING LANE TRANSITIONS FROM 11' TO 8'

STA. 107+82.02 RT TO STA. 108+10 RT PARKING LANE TRANSITIONS FROM 9'-6" TO 8'

STA. 110+22.57 LT TO STA. 110+37.50 LT PARKING LANE TRANSITIONS FROM 8' TO 9'-6"


- ATA. 110+41.83 LT TO STA. 110+45.00 LT PARKING LANE TRANSITIONS FROM 9'-6" TO 10'-2" STA. 110+41.83 RT TO STA, 110+45.00 RT PARKING LANE TRANSITIONS FROM 8' TO 8'-4"
- 5 SEE REMOVAL PLAN SHEET FOR EXISTING PAVEMENT THICKNESSES.

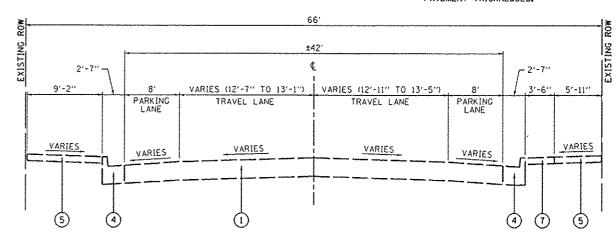

EXISTING TYPICAL SECTION


(NOT TO SCALE) STA. 109+18.65 TO STA. 110+55.00

FILE NAME .	USER NAME = default	DESIGNED -	REVISED -		<u> </u>	·	,,		F.A.U.	SECTION	COUNTY	TOTAL	SHEET
00260591.003-sht-typical.dgn	PLOT TIME = 7:43:82 AM	DRAWN -	REVISED -	STATE OF ILLINOIS		TYPI	CAL SECTIO	NS	RTE.	11-00036-03-DV		SHEETS	NO.
	PLOT SCALE . 40.0000 '/ IN.	CHECKED -	REVISED -	DEPARTMENT OF TRANSPORTATION	HITICAL SECTIONS		9393	11-00026-02-PV	MADISON		-5-		
	PLOT DATE * 1/28/2014	DATE -	REVISED -		SCALE:	SHEET I OF 2	SHEETS	STA, TO STA.	- 	ILLINOIS FEO.		CT NO. 9	1230

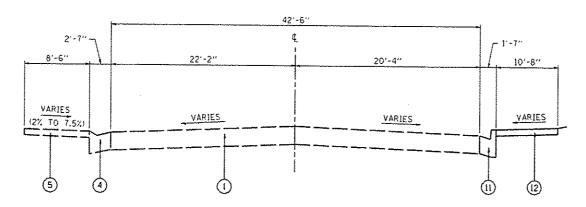


PROPOSED TYPICAL SECTION

(NOT TO SCALE) STA. 110+45.00 TO STA. 110+55.71

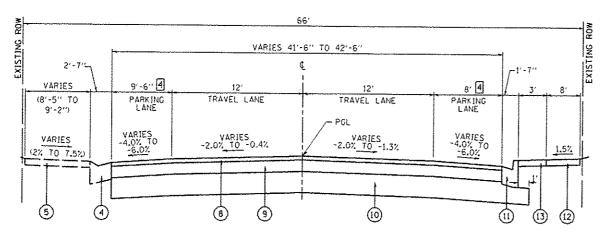

PROPOSED TYPICAL SECTION

(NOT TO SCALE) STA. 110+37.50 TO STA. 110+45.00

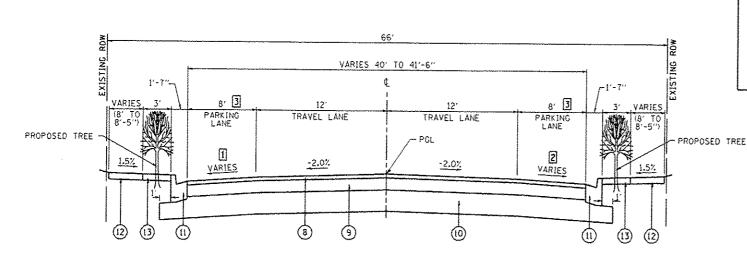

PROPOSED TYPICAL SECTION

(NOT TO SCALE) STA. 107+82.02 TO STA. 110+37,50

TYPICAL SECTION LEGEND

- EXISTING HOT-MIX ASPHALT / OIL AND CHIP PAYEMENT
- 2 EXISTING OIL AND CHIP PAYEMENT
- 3 EXISTING CONCRETE CURB. TYPE 8-6
- (4) EXISTING COMBINATION CONCRETE CURB AND CUTTER, TYPE B-6.24
- 5 EXISTING PORTLAND CEMENT CONCRETE SIDEWALK, 4 INCH
- 6 EXISTING PORTLAND CEMENT CONCRETE SIDEWALK, 4 INCH SPECIAL (BRICK PATTERN)
- (7) EXISTING LAWN AREA
- 8) PROPOSED HOT-MIX ASPHALT SURFACE COURSE, MIX "C", N70, 2"
- 9 PROPOSED HOT-MIX ASPHALT BINDER COURSE, IL-19.0, N70, 6"
- PROPOSED SUBBASE CRANULAR MATERIAL, TYPE A 12"
- (1) PROPOSED COMBINATION CONCRETE CURB AND GUTTER, TYPE 8-6.12
- 12) PROPOSED PORTLAND CEMENT CONCRETE SIDEWALK, 4 INCH
- 13) PROPOSED PORTLAND CEMENT CONCRETE SIDEWALK 4 INCH. SPECIAL

STRUCTURAL DESIGN TRAFFIC: YEAR: 2024 PV = 2,122 SU = 66 ₩U = 22 ROAD/STREET CLASSIFICATION: CLASS:__II PERCENT OF STRUCTURAL DESIGN TRAFFIC IN DESIGN LANE: P = 96% S = 3% M = 12 TRAFFIC FACTOR: ACTUAL = 0.16 MIN = PG GRADE: BINDER: 64-22 SURFACE: 64-22 STRUCTURAL SUPPORT RATINGS SSR = POOR

SHEET 2

SCALE

TYPICAL SECTION NOTES

- STA. 107+82.02 LT TO STA. 108+20.00 LT CROSS SLOPE TRANSITIONS FROM -3.5% TO -2.0%

 STA. 108+50.00 LT TO STA. 108+75.00 LT CROSS SLOPE TRANSITIONS FROM -2.0% TO -4.0%
- [2] STA. 107+82.02 RT TO STA. 108+20.00 RT CROSS SLOPE TRANSITIONS FROM -4.5% TO -2.0% STA. 108+90.00 RT TO STA. 109+20.00 RT CROSS SLOPE TRANSITIONS FROM -2.0% TO -4.0%
- 3 STA. 107+82.02 LT TO STA. 108+15 LT PARKING LANE TRANSITIONS FROM 11' TO 8'

STA, 107+82.02 RT TO STA, 108+10 RT PARKING LANE TRANSITIONS FROM 9'-6" TO 8'

STA. 110+22.57 LT TO STA. 110+37.50 LT PARKING LANE TRANSITIONS FROM 8' TO 9'-6"

- A STA. 110+41.83 LT TO STA. 110+45.00 LT PARKING LANE TRANSITIONS FROM 9'-6" TO 10'-2" STA. 110+41.83 RT TO STA. 110+45.00 RT PARKING LANE TRANSITIONS FROM 8' TO 8'-4"
- SEE REMOVAL PLAN SHEET FOR EXISTING PAVEMENT THICKNESSES.

HOT-MIX ASPHALT DESIGN MIX TABLE									
20 YEAR ESALS									
MIXTURE USE	SURFACE COURSE	BINDER COURSE	PAVEMENT PATCHES						
THICKNESS	2"	6"	8"						
AC/PG	PG 64-22	PC 64-22	PG 64-22						
RAP % (MAX)	SEE BOE SPECIAL PROVISIONS	SEE BOE SPECIAL PROVISIONS	SEE BOE SPECIAL PROVISIONS						
DESIGN AIR VOIDS	4.0% @ Ndes=70	4.0% @ Ndes=70	4.0% o Ndes=70						
MIX COMPOSITION	(L-9.5	IL-19,0	IL -9.5						
FRICTION AGG	MIXTURE "C"	MIXTURE "B"	MIXTURE "C"						
DENSITY TEST METHOD	CORES / NUCLEAR	CORES / NUCLEAR	CORES / NUCLEAR						

SEE CROSS SECTIONS FOR VARIABLE DIMENSIONS

	FILE NAME .	USER NAME × default	DESIGNED -	REVISED -
	0200591.902-sht-typical.dgn	PLOT TIME + 2:47:55 PM	DRAWN -	REVISED -
		PLOT SCALE = 40,0000 1/ IN,	CHECKED -	REVISED -
-		PLOT DATE = 2/11/2014	DATE -	REVISED -

STATE OF ILLINOIS
DEPARTMENT OF TRANSPORTATION

TYPICAL SECTIONS		F.A.U. RTE.	SECTION	COUNTY	TOTAL SHEETS	SHEE NO.
HILICAT SECTIONS		9393	11-00026-02-PV	MADISON	21	6
OF 2 SHEETS STA.	TO STA.	H, HAI	STREET RECONSTRUCTION	CONTRACT	NO.	37550
6, 5 2147.	10 31A,	L	HLLINOIS FEO. AL	O PROJECT		

CURR & GUTTER SCHEDULE

JUILD G	QUITER	OULLED	VLL	
STATION	STATION	OFFSET	COMB CONC GUTTER	COMB CC&G
3181104	3181104	OFFSET	REM	TB6,12
			(F00T)	(F00T)
107+82	110+38	LT	255	255
107+84	110+57	RT	280	285
TOTAL			535	540

TREE SCHEDULE

HILL JU	HLUVLL			
		T-KOEL	T-CERCIS	TREE FRAME
STATION	OFFSET	PANICULAT	CAN TF 2	AND GRATES
		2		py and a second
		(EACH)	(EACH)	(EACH)
108+59	LT	 	1	1
108+95	RT	1		1
109+22	LT	1		1
109+98	RT		1	1
110+19	LT		1	1
TOTAL		. 2	3	5

ENTRANCE SCHEDULE

STATION	OFFSET	ENTRANCE TYPE	ENTRANCE WIDTH "W"	EXISTING SURFACE TYPE	PCC ORIVEWAY PAVT 8 (NOTE 1)	DRIVEWAY PAVEMENT REM
			(F00T)	·	(SO YD)	(SO YD)
108+55	RT	CE	56	CONC	70	61
109+53	LT	CE	25	HMA	32	28
TOTAL	····	<u> </u>			102	89

ENTRANCE NOTES:

SIGN AND POST SCHEDULE

NO. ON SIGN PLAN	STATION	OFFSET	TYPE	DESCRIPTION	NOMINAL SIZE	SIGN PANEL TI	METAL POST SPECIAL	NOTES
					(FT x FT)	(SO FT)	(EACH)	
	108+15	24' LT	R7-8	RESERVED PARKING	1 × 1.5	1,5	1	REVERSE SIDE BLACK, INCLUDE FRAME
2	109+37	24' RT	R7-303	TWO HOUR PARKING	1 × 1.5	1.5	1	REVERSE SIDE BLACK, INCLUDE FRAME (REMOVE EXISTING SIGN)
3	110+38	24' RT	R1-1	STOP	2.5 × 2.5	6.3	1	REVERSE SIDE BLACK, INCLUDE FRAME (REMOVE EXISTING SIGN)
	110+38	24' RT	STREET SIGN	STREET NAME	3 × 0.67	2.0		"N. Main St."
	110+38	24' RT	STREET SIGN	STREET NAME	3 × 0.67	2.0		"W. Clay St."
TOTAL	· ·	<u></u>		1	L	13.3	3	

SIGN AND POST NOTES;

1. EXISTING SIGNS THAT ARE REMOVED SHALL BE THE PROPERTY OF THE CITY OF TROY. THIS WORK SHALL BE INCLUDED IN THE COST OF PROPOSED SIGNS.

METAL SIGN POSTS SHALL BE FACTORY FINISHED IN BLACK.

TRAFFIC SIGNS MOUNTED TO DECORATIVE METAL POSTS SHALL HAVE THE REVERSE SIDE FACTORY FINISHED IN BLACK.

TRAFFIC SIGNS MOUNTED TO DECORATIVE METAL POSTS SHALL HAVE THE REVERSE SIDE FACTORY FINISHED IN BLACK. ALL STREET SIGNS ARE DOUBLE FACED. SHAPE SHALL CONFORM TO DECORATIVE METAL POST MANUFACTURER STREET SIGN FRAMES,

PAVEMENT SCHEDULE

			SUB GRAN	BIT MATES		HMA BC	HMA SC	PAVEMENT	HMA SURF	CL D	HES
STATION	STATION	OFFSET	MAT A 12	PR CT	RAMP	IL-19.0.	"C" N70	REM	REM 2	PATCH	PCC PVT
			Andrews			N70			Andrew Parker Pa	T1 B	10 S & C
			dia sire	(NOTE 1)		(NOTE 1)	(NOTE 1)	*********	A		
			(SO YD)	(GAL)	(SQ YD)	(TON)	(TON)	(SQ YD)	(SO YD)	(SO YD)	(SO YD)
107+14	107+82	RT/LT	183					183			183
107+22	107+74	RT/LT		28			42		373		
107+82	110+45	RT/LT	1,328		60	396	132	111			
110+45	110+60	RT	16				Ī			9	
110+45	110+68	RT	10				<u> </u>			10	1
110+59	110+77	RT	13							13	
TOTAL	i		1,550	28	60	396	174	294	373	32	183

PAVEMENT NOTES;

1. APPLICATION RATES USED FOR QUANTITY ESTIMATES ARE AS FOLLOWS:

BITUMINOUS MATERIALS PRIME COAT

0,075 GAL/SY
112 LBS/SY/INI HOT-MIX ASPHALT 112 LBS/SY/INCH THICKNESS

FIECTRICAL SCHEDULE

STATION	STATION	OFFSET	UNDRGRD C PVC 2	DRILL EX HANDHOLE	HANDHOLE (SPL)
((NOTEI) (FOOT)	(EACH)	(EACH)
107+97	110+35	RT	480	 	1
108+10	110+35	LΥ	460	1	1
TOTAL	<u></u>		940	2	2

ELECTRICAL NOTES:

1. TWO CONDUIT RUNS ARE REQUIRED FOR BOTH SIDES OF THE ROAD.

EARTHWORK SCHEDULE

STATION	STATION	REM & DISP UNS MATL	EMBANKMENT	BALANCE WASTE (+) OR SHORTAGE (-)
		(CU YD)	(NOTE 1) (CU YD)	(NOTE 2) (CU YD)
107+14	107+82	60	0	60
107+82	110+45	700	0	700
110+45	110+60	10	0	10
TOTAL		770	0	770

EARTHWORK NOTES:

- UNSUITABLE MATERIAL SHALL NOT BE USED AS EMBANKMENT AND SHALL BE REMOVED FROM THE RICHT-OF-WAY. FOR BIDDING PURPOSES. THE CONTRACTOR SHALL FIGURE ALL EXCAVATION TO BE HAULED OFF-SITE. APPROXIMATE BALANCE IS SHOWN FOR INFORMATION ONLY.

PAVEMENT MARKING SCHEDULE

					ì	TEMP PVT MK		WORK ZONE	THPL PVT	THPL PVT	PAINT
STATION	STATION	OFFSET	COMMENT	COLOR	LINE 4	LINE 12	LINE 24	PAVT MK	MK LINE 4	MK LINE 24	PAVT MK
	Touristand a strange of the strange				(NOTE 2)	(NOTE 2)	(NOTE 2)	REM	(NOTE 1)	(NOTE 1)	LINE 12 (NOTE 1)
					(FOOT)	(FOOT)	(F00T)	(SO FT)	(F00T)	(F00T)	(FOOT)
107+14	107+82	LT/RT	X-WALK & STOP BARS	WHITE	-	385	48	481		48	385
107+86	107+86	LŤ	STOP BAR	WHITE	<u> </u>		20	40		20	303
107+86	110+38	CL	DOUBLE CL	YELLOW	500			167	500		
108+15	109+25	LT	PARKING STALL	WHITE	158			53	158		
108+98	110+22	RT	PARKING STALL	WHITE	172			57	172		
109+78	110+22	LT	PARKING STALL	WHITE	68			23	68		
110+38	110+38	RT	STOP BAR	WHITE			20	40		20	
110+45	110+45	LT/RT	X-WALK	WHITE			88	176		88	
110+57	110+76	LT	STOP BAR	WHITE			20	40		20	
110+60	110+98	RT	X-WALK	WHITE			72	144		72	
110+76	110+98	RT	STOP BAR	WHITE			22	44		22	·
TOTAL			I		898	385	290	1.265	898	290	385

PAYEMENT MARKING NOTES:

1. SEE HIGHWAY STANDARD 780001 FOR PAYEMENT MARKING DETAILS.

2. THE QUANTITY FOR TEMPORARY PAYEMENT MARKING ASSUMES ONE APPLICATION IN THE EVENT OF A TEMPORARY SHUTDOWN. THE CONTRACTOR SHALL APPLY AS NECESSARY AND AS DIRECTED BY THE ENGINEER IN THE FIELD.

CIDEMINIK CCHEDIIIE


STATION	STATION	OFFSET	PC CONC SIDEWALK 4 (NOTE 1)	DETECTABLE WARNINGS (NOTE 1)	SIDEWALK REM	PCC SW 4 SP
			(SO FT)	(SO FT)	(S0 FT)	(SO FT)
107+82	109+40	ĻŤ	1,100		1,272	450
107+84	108+27	RT	330		405	130
108+83	110+55	RT	1,345	18	1.050	470
109+65	110+38	LĪ	545		645	210
111+00	111+10	RT	160	12	135	
TOTAL	L		3,480	30	3,507	1,260

SIDEWALK NOTES:

SIDEWALK RAMPS ACCESSIBLE TO THE DISABLED ARE REQUIRED.
SEE PLAN SHEETS FOR LOCATIONS AND TYPES.
SEE HIGHWAY STANDARD 424001 & 424016 FOR SIDEWALK RAMP DETAILS.


FILE NAME .	USER NAME = default	DESIGNED -	REVISEO -		I				F.A.U.	SECTION	COUNTY	TOTAL	SHEET
D8268591.883-sht-schedules.dgn	PLOT TIME = 7:43:84 AM	DRAWN -	REVISED -	STATE OF ILLINOIS	SCHEDULE OF QUANTITIES			9393	11-00026-02-PV	MADISON	- SHEE!	3 80.	
	PLOT SCALE : 40.0000 '/ IN.	CHECKED -	REVISEO -	DEPARTMENT OF TRANSPORTATION				3333 L	AIN STREET RECONSTRUCTION	CONTRAC	T NO	97550	
	PLOT DATE = 1/28/2014	DATE -	REVISED -		SCALE: NTS SHEET NO.	OF 1 SHEET	S STA,	TO STA.		ILLINOIS FED.	AID PROJECT		31300

DEPRESSED CURB AND GUTTER THROUGH ENTRANCES SHALL BE MEASURED FOR PAYMENT AS COMBINATION CONCRETE CURB AND GUTTER, TYPE B-6.12.

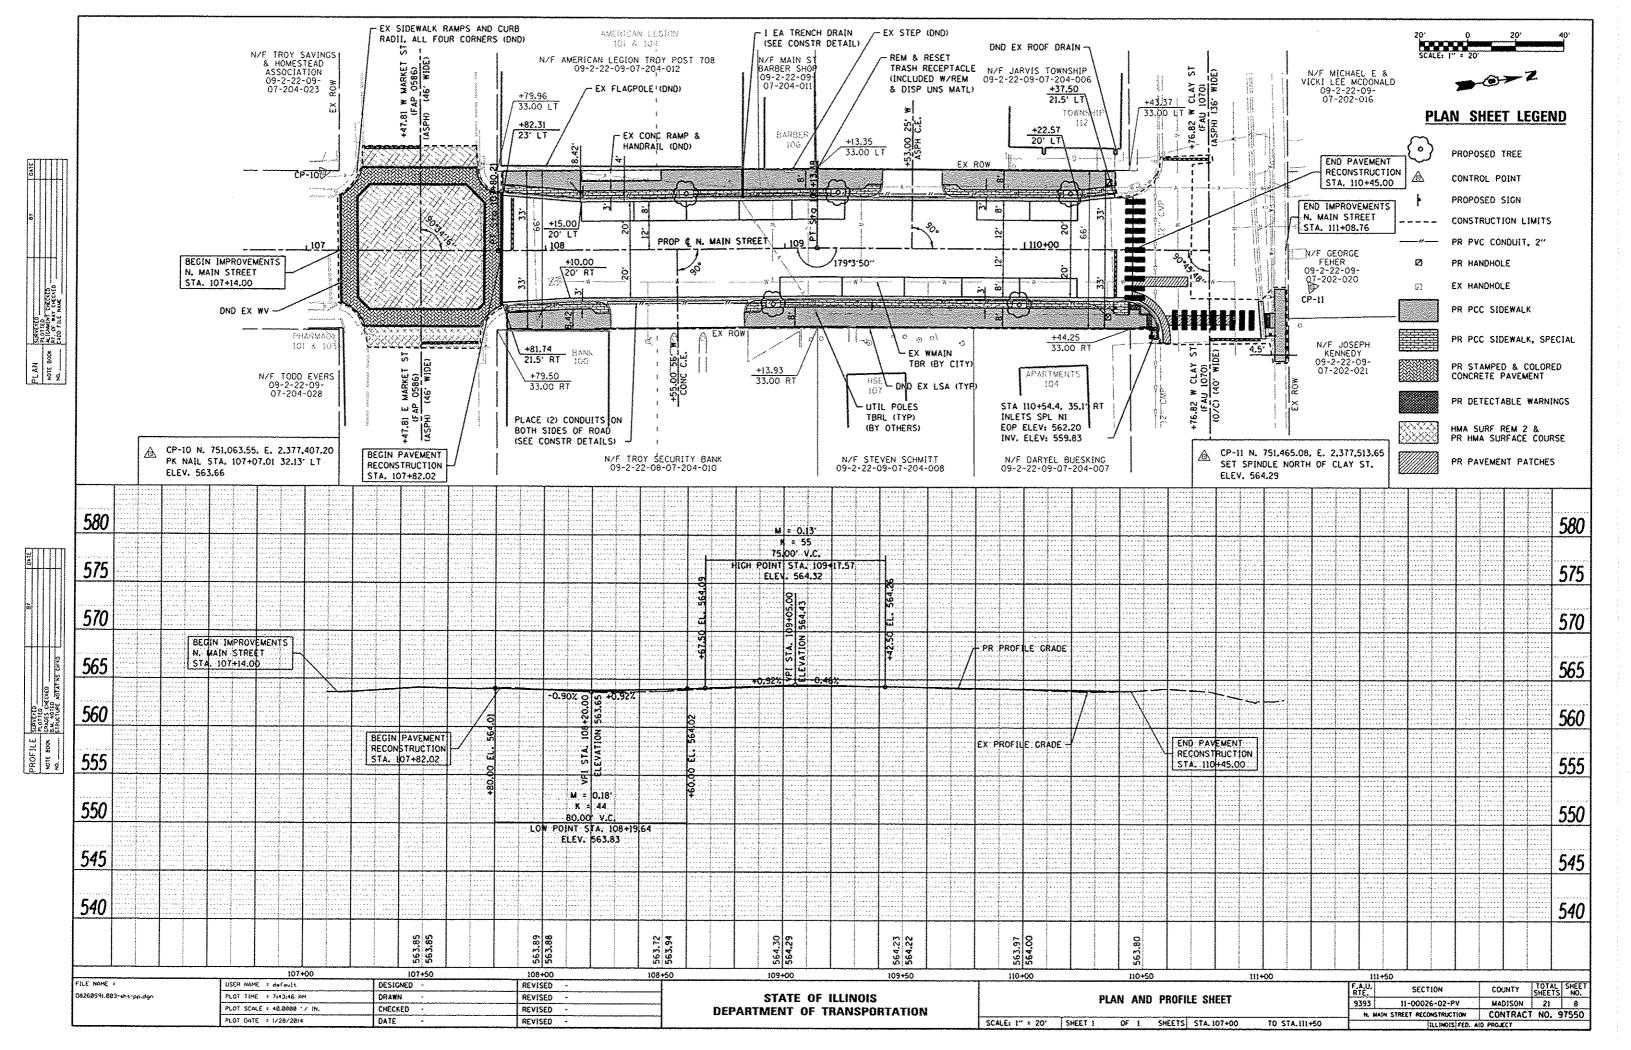

TRAFFIC CONTROL - STAGE 1 CONSTRUCTION OF SOUTHBOUND IMPROVEMENTS

- ALL SERVICES AND PROPERTY OWNERS FRONTING THE PROJECT SHALL BE NOTIFIED AT LEAST 48 HOURS PRIOR TO ROAD CLOSURES AFFECTING THEIR ACCESS.
- 2. SET UP TRAFFIC CONTROL ACCORDING TO THE LAYOUT SHOWN ON THIS SHEET.
- 3. MAINTAIN NORTHBOUND TRAFFIC FOR THROUGH AND PARKING LANES AS WELL AS PEDESTRIAN TRAFFIC ON THE ADJACENT SIDEWALK.
- REMOVE EXISTING CURB, GUTTER, PAVEMENT, SIDEWALK, ETC NECESSARY TO CONSTRUCT THE IMPROVEMENTS ON THE WEST SIDE OF THE PROJECT.
- 5. CONSTRUCT THE WEST SIDE OF THE PROJECT CONSISTING OF RECONSTRUCTION OF THE SOUTHBOUND THROUGH AND PARKING LANES AND ALL ADJACENT ITEMS SUCH AS CONCRETE CURB AND GUTTER AND SIDEWALK. DO NOT PLACE HMA SURFACE COURSE UNTIL STAGE 3.
- 6. SET UP TRAFFIC CONTROL FOR STAGE 2.

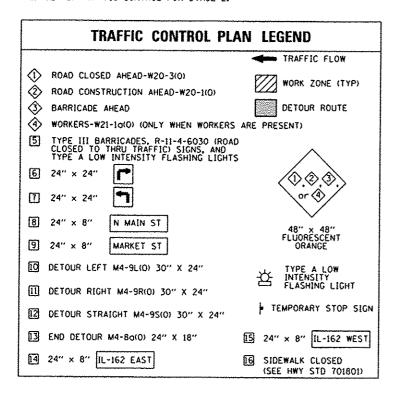

NOTES

- 1. TYPE III BARRICADES AND ROAD CLOSURE SIGNS SHALL BE POSITIONED AS SHOWN, IN ACCORDANCE WITH HIGHWAY STANDARD 701901, THE MANUAL ON UNIFORM TRAFFIC CONTROL DEVICES, AND AS DIRECTED BY THE ENGINEER.
- 2. TYPE A LOW INTENSITY FLASHING WARNING LIGHTS SHALL BE USED ON THE FIRST SIGN IN ADVANCE OF THE WORK SITE AND TYPE III BARRICADES DURING HOURS OF DARKNESS.
- 3. ALL WARNING SIGNS SHALL BE A MINIMUM OF 48" x 48" AND HAVE A BLACK LEGEND AND BORDER ON A FLUORESCENT GRANGE REFLECTORIZED BACKGROUND.
- 4. WARNING SIGNS SHALL BE PLACED AT THE ENTRANCE TO THE PROJECT TO NOTIFY MOTORISTS OF THE UPCOMING ROAD CLOSURE.
- 5. EXACT LOCATION OF WARNING SIGNS AND BARRICADES SHALL BE STAKED IN THE FIELD FOR APPROVAL BY THE ENGINEER PRIOR TO INSTALLATION.
- 6. THE CONTRACTOR SHALL MAINTAIN ACCESS TO ENTRANCES AT ALL TIMES.
- 7. SEE HIGHWAY STANDARDS 701801 AND 701901 FOR ADDITIONAL TRAFFIC CONTROL GUIDELINES
- 8. AT NO TIME SHALL THE COMPLETE CLOSURE OF THE U.S. BANK'S ENTRANCE ALONG NORTH MAIN STREET BE PERMITTED.
- STORE FRONT ACCESS SHALL BE MAINTAINED UTILIZING A COMBINATION OF HIGH EARLY-STRENGTH CONCRETE AND TEMPORARY WOODEN RAMPS.
- 10. TRAFFIC CONTROL SIGNS, PLACEMENT, AND MAINTENANCE PAID FOR IN UNIT COST FOR TRAFFIC CONTROL AND PROTECTION, (SPECIAL).



FILE NAME : 08268591.883-whentraffic.control.dgn

STATE OF ILLINOIS
DEPARTMENT OF TRANSPORTATION

TRAFFIC CONTROL STAGING PLAN - STAGE 1

RYE. SECTION

9393 11-00256-1


N. MAIN STREET RECOMS

SCALE: 1" = 60' SHEET NO. 1 OF 3 SHEETS STA. TO STA.

ALL SECTION COUNTY TOTAL SHEETS NO. 393 11-00026-02-PV MADISON 21 9 N. MAIN STREET RECONSTRUCTION CONTRACT NO. 97550


TRAFFIC CONTROL - STAGE 2 **CONSTRUCTION OF NORTHBOUND IMPROVEMENTS**

- ALL SERVICES AND PROPERTY OWNERS FRONTING THE PROJECT SHALL BE NOTIFIED AT LEAST 48 HOURS PRIOR TO ROAD CLOSURES AFFECTING THEIR ACCESS.
- 2. SET UP TRAFFIC CONTROL ACCORDING TO THE LAYOUT SHOWN ON THIS SHEET.
- 3. MAINTAIN SOUTHBOUND TRAFFIC FOR THROUGH AND PARKING LANES AS WELL AS PEDESTRIAN TRAFFIC ON THE ADJACENT SIDEWALK.
- 4. REMOVE EXISTING CURB, GUTTER, PAVEMENT, SIDEWALK, ETC NECESSARY TO CONSTRUCT THE IMPROVEMENTS ON THE EAST SIDE OF THE PROJECT.
- CONSTRUCT THE EAST SIDE OF THE PROJECT CONSISTING OF RECONSTRUCTION OF THE SOUTHBOUND THROUGH AND PARKING LANES AND ALL ADJACENT ITEMS SUCH AS CONCRETE CURB AND GUTTER AND SIDEWALK. DO NOT PLACE HMA SURFACE COURSE UNTIL STAGE 3.
- 6. SET UP TRAFFIC CONTROL FOR STAGE 3.

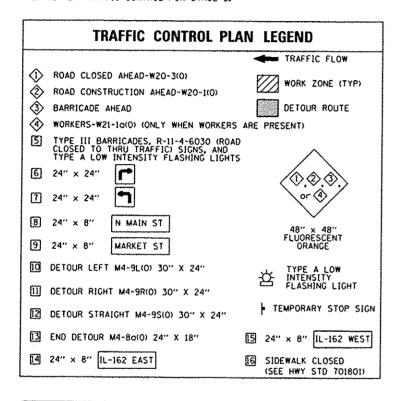

NOTES

- TYPE III BARRICADES AND ROAD CLOSURE SIGNS SHALL BE POSITIONED AS SHOWN, IN ACCORDANCE WITH HIGHWAY STANDARD TO1901, THE MANUAL ON UNIFORM TRAFFIC CONTROL DEVICES, AND AS DIRECTED BY THE ENGINEER.
- TYPE A LOW INTENSITY FLASHING WARNING LIGHTS SHALL BE USED ON THE FIRST SIGN IN ADVANCE OF THE WORK SITE AND TYPE III BARRICADES DURING HOURS OF DARKNESS.
- ALL WARNING SIGNS SHALL BE A MINIMUM OF 48" x 48" AND HAVE A BLACK LEGEND AND BORDER ON A FLUORESCENT GRANGE REFLECTORIZED BACKGROUND.
- 4. WARNING SIGNS SHALL BE PLACED AT THE ENTRANCE TO THE PROJECT TO NOTIFY MOTORISTS OF THE UPCOMING ROAD CLOSURE.
- 5. EXACT LOCATION OF WARNING SIGNS AND BARRICADES SHALL BE STAKED IN THE FIELD FOR APPROVAL BY THE ENGINEER PRIOR TO INSTALLATION.
- 6. THE CONTRACTOR SHALL MAINTAIN ACCESS TO ENTRANCES AT ALL TIMES.
- SEE HIGHWAY STANDARDS 701801 AND 701901 FOR ADDITIONAL TRAFFIC CONTROL GUIDELINES
- 8. AT NO TIME SHALL THE COMPLETE CLOSURE OF THE U.S. BANK'S ENTRANCE ALONG NORTH MAIN STREET BE PERMITTED.
- STORE FRONT ACCESS SHALL BE MAINTAINED UTILIZING A COMBINATION OF HIGH EARLY-STRENGTH CONCRETE AND TEMPORARY WOODEN RAMPS.
- 10. TRAFFIC CONTROL SIGNS, PLACEMENT, AND MAINTENANCE PAID FOR IN UNIT COST FOR TRAFFIC CONTROL AND PROTECTION, (SPECIAL).

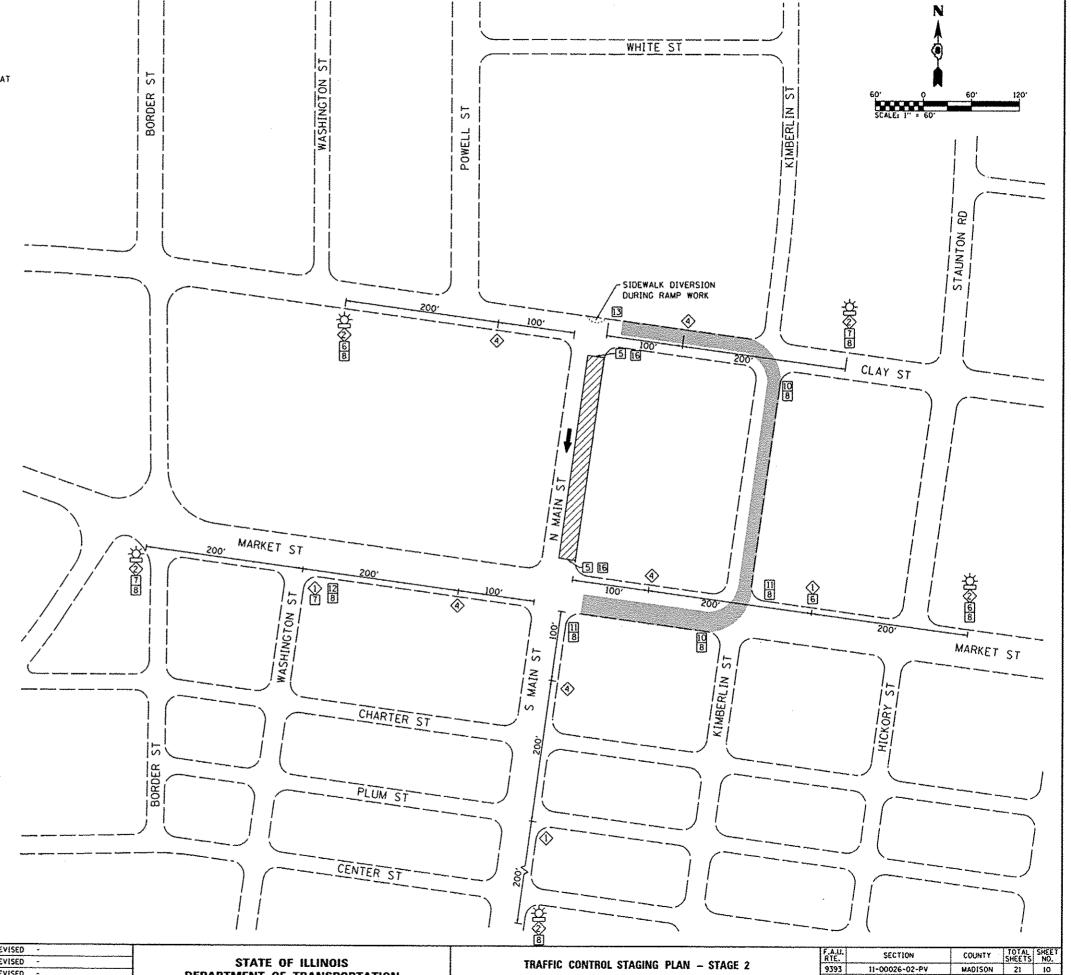

FILE NAME : 8260591.003-sht-traffic_control.dgn

USER NAME = default DESIGNED - WAM REVISED PLOT TIME = 7:43:49 AM DRAWN - WAM REVISED PLOT SCALE = 40.0000 1/ IN. CHECKED REVISED PLOT DATE = 1/28/2014 DATE REVISED


DEPARTMENT OF TRANSPORTATION

SCALE: 1" = 60' SHEET NO. 2 OF 3 SHEETS STA. TO STA.

CONTRACT NO. 97550 M. MAIN STREET RECONSTRUCTION ILLINOIS FED. AID PROJEC


TRAFFIC CONTROL - STAGE 3 **CONSTRUCTION OF INTERSECTION IMPROVEMENTS**

- ALL SERVICES AND PROPERTY OWNERS FRONTING THE PROJECT SHALL BE NOTIFIED AT LEAST 48 HOURS PRIOR TO ROAD CLOSURES AFFECTING THEIR ACCESS.
- 2. SET UP TRAFFIC CONTROL ACCORDING TO THE LAYOUT SHOWN ON THIS SHEET.
- 3. LOCAL EMERGENCY RESPONSE AGENCIES, AS WELL AS POSTAL AND SCHOOL SERVICES, SHALL BE INFORMED OF ALL OPERATIONS PRIOR TO ANY ROAD CLOSURES.
- THE INTERSECTION MAY BE CLOSED FOR A MAXIMUM OF SIX CONSECUTIVE CALENDAR DAYS. AFTER THIS PERIOD THE INTERSECTION SHALL BE REOPENED TO ALL TRAFFIC.
- REMOVE EXISTING PAVEMENT, SURFACE COURSE, ETC NECESSARY TO CONSTRUCT THE INTERSECTION IMPROVEMENTS.
- CONSTRUCT THE CONCRETE STAMPED PAVEMENT AND ALL OTHER INTERSECTION ITEMS. PLACE HMA SURFACE COURSE AND PAVEMENT MARKINGS THROUGHOUT ENTIRE PROJECT.

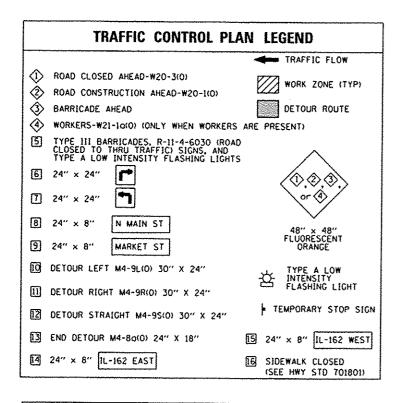

NOTES

- TYPE III BARRICADES AND ROAD CLOSURE SIGNS SHALL BE POSITIONED AS SHOWN, IN ACCORDANCE WITH HIGHWAY STANDARD 701901, THE MANUAL ON UNIFORM TRAFFIC CONTROL DEVICES, AND AS DIRECTED BY THE ENGINEER.
- TYPE A LOW INTENSITY FLASHING WARNING LIGHTS SHALL BE USED ON THE FIRST SIGN IN ADVANCE OF THE WORK SITE AND TYPE III BARRICADES DURING HOURS OF DARKNESS.
- ALL WARNING SIGNS SHALL BE A MINIMUM OF 48" x 48" AND HAVE A BLACK LEGEND AND BORDER ON A FLUORESCENT GRANGE REFLECTORIZED BACKGROUND.
- 4. WARNING SIGNS SHALL BE PLACED AT THE ENTRANCE TO THE PROJECT TO NOTIFY MOTORISTS OF THE UPCOMING ROAD CLOSURE.
- 5. EXACT LOCATION OF WARNING SIGNS AND BARRICADES SHALL BE STAKED IN THE FIELD FOR APPROVAL BY THE ENGINEER PRIOR TO INSTALLATION.
- 6. THE CONTRACTOR SHALL MAINTAIN ACCESS TO ENTRANCES AT ALL TIMES.
- 7. SEE HIGHWAY STANDARDS 701801 AND 701901 FOR ADDITIONAL TRAFFIC CONTROL GUIDELINES
- 8. AT NO TIME SHALL THE COMPLETE CLOSURE OF THE U.S. BANK'S ENTRANCE ALONG NORTH MAIN STREET BE PERMITTED.
- STORE FRONT ACCESS SHALL BE MAINTAINED UTILIZING A COMBINATION OF HIGH EARLY-STRENGTH CONCRETE AND TEMPORARY WOODEN RAMPS.
- 10. TRAFFIC CONTROL SIGNS, PLACEMENT, AND MAINTENANCE PAID FOR IN UNIT COST FOR TRAFFIC CONTROL AND PROTECTION, (SPECIAL).

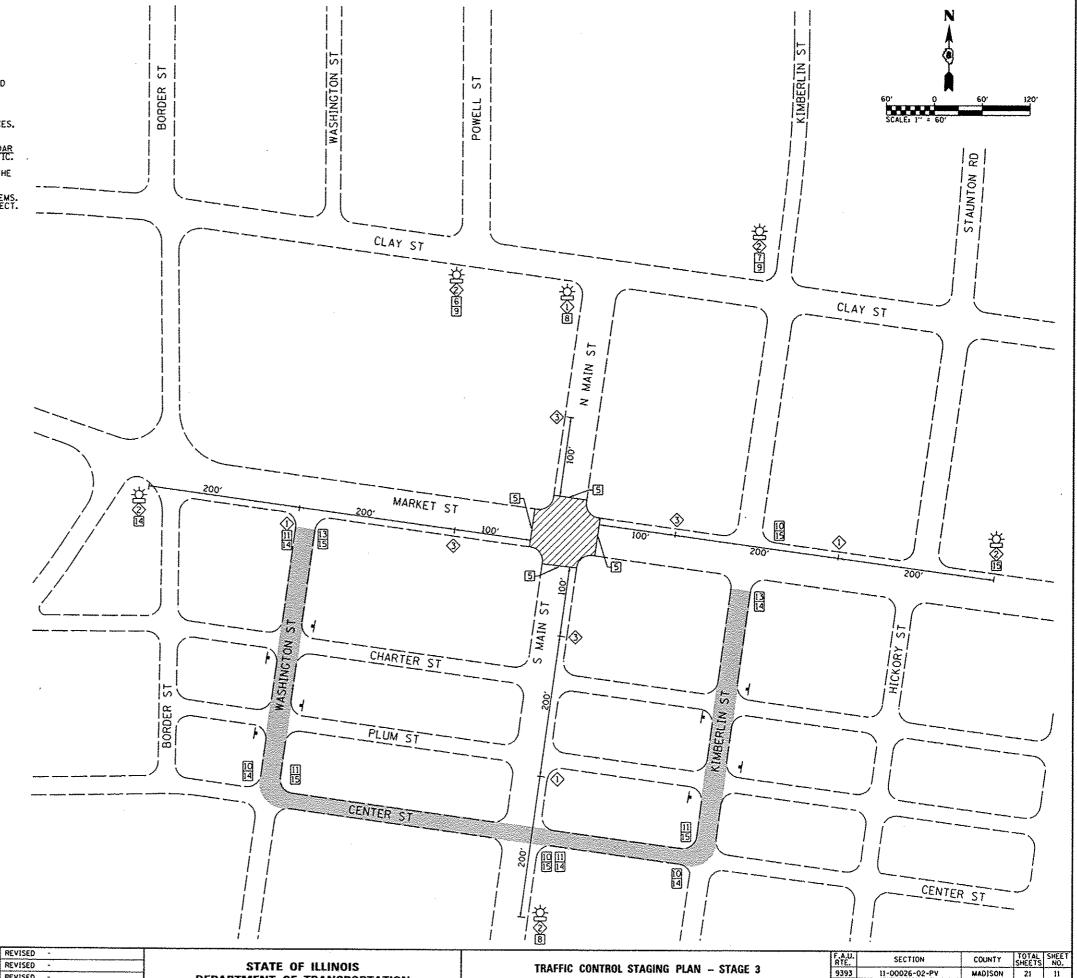


FILE NAME : 08260591.003-sht-traffic.control.dga

USER NAME : default DESIGNED - WAN PLOT TIME = 7:43:50 AM DRAWN -REVISED PLOT SCALE = 40.0000 1/ IN. CHECKED -REVISED -PLOT DATE = 1/28/2014 DATE REVISED

DEPARTMENT OF TRANSPORTATION


MADISON 21 11 CONTRACT NO. 97550 N. MAIN STREET RECONSTRUCTION SCALE: 1" = 60' SHEET NO. 3 OF 3 SHEETS STA. ILLINOIS FED. AID PROJECT

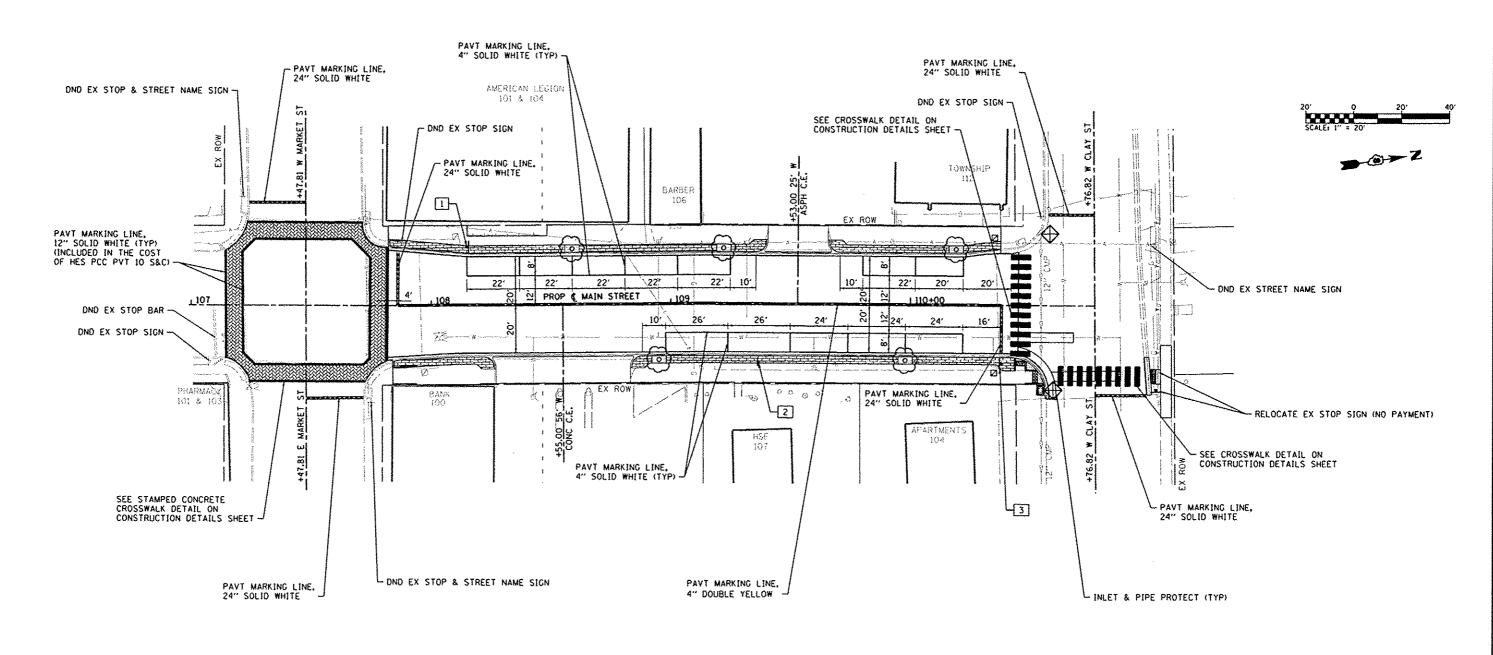


NOTES


- NUMBERS CORRESPOND TO NUMBERS ON SIGN AND POST SCHEDULE. SEE SCHEDULE FOR MORE INFORMATION.
- PROP SIGN LOCATIONS ARE APPROXIMATE. LOCATIONS MAY BE MOVED SLIGHTLY TO AVOID CONFLICTS WITH OTHER PHYSICAL FEATURES.


FILE NAME 1	USER NAME & default	DESIGNED -	REVISED -			F.A. SECTION	COUNTY TOTAL
D8268591.883-sht-eros-pmk,dgn	PLOT TIME = 7:43:52 AM	DRAWN -	REVISED -	STATE OF ILLINOIS DEPARTMENT OF TRANSPORTATION	EROSION CONTROL, SIGNING, AND PAVEMENT MARKING PLAN	TX S En.A.	Janceia
	PLOT SCALE . 40,0000 ' / IN.	CHECKED -	REVISED -		Endotors doternot, professed, New 1 Machines I Millioned 1 Tale	1 33331 11 00020 02-77	MADISON 21
<u></u>	PLOT DATE > 1/28/2814	DATE -	REVISED -		SCALE; SHEET 1 OF 1 SHEETS STA, TO STA.	N. MAIN STREET RECONSTRUCTION	CONTRACT NO. S
						(123,00),1201,	ip (looke)

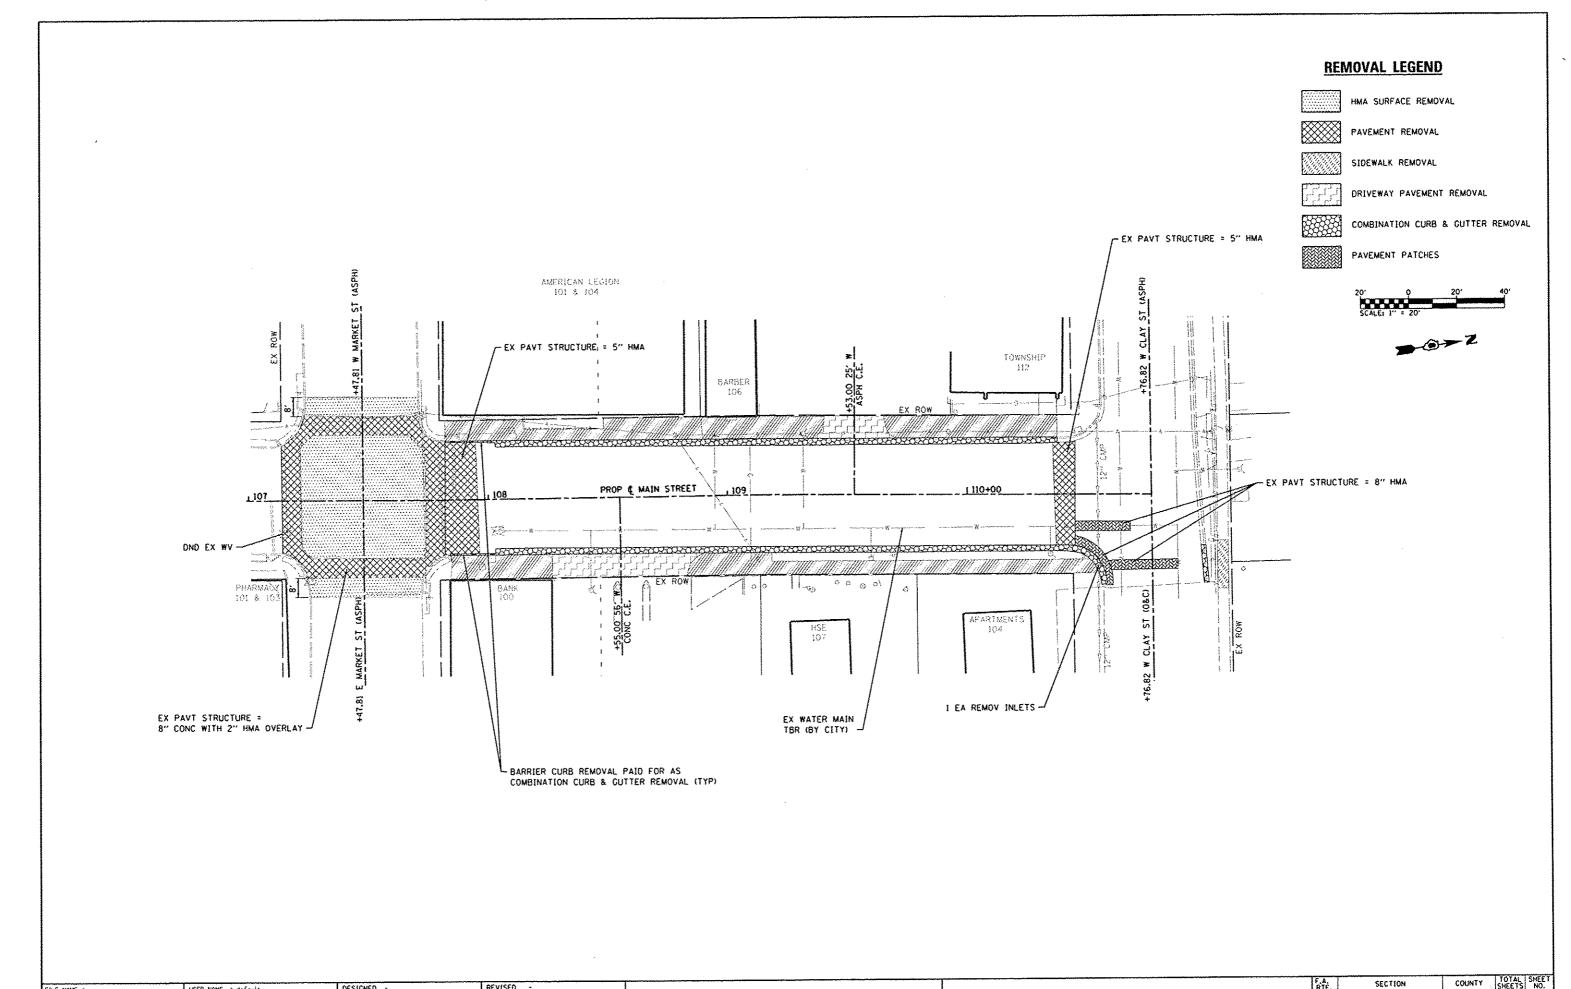

FILE NAME :	USER NAME = default	DESIGNED -	REVISED -		DESCRIPTION OF THE PROPERTY OF	RTE. SECTION SHEETS NO.
D8266591.883-sht-rem.dgn	PLOT TIME = 7:43:54 AM	DRAWN -	REVISED -	STATE OF ILLINOIS	REMOVAL PLAN	9393 11-00026-02-PV MADISON 21 13
	PLOT SCALE = 40.0000 '/ IN.	CHECKED -	REVISED -	DEPARTMENT OF TRANSPORTATION		N. MAIN STREET RECONSTRUCTION CONTRACT NO. 97550
	PLOT DATE . 1/28/2014	DATE -	REVISED -		SCALE: 1" = 20' SHEET 1 OF 1 SHEETS STA. TO STA.	ILLINOIS FED. AID PROJECT

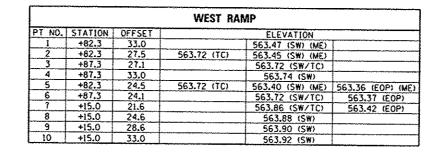

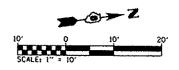

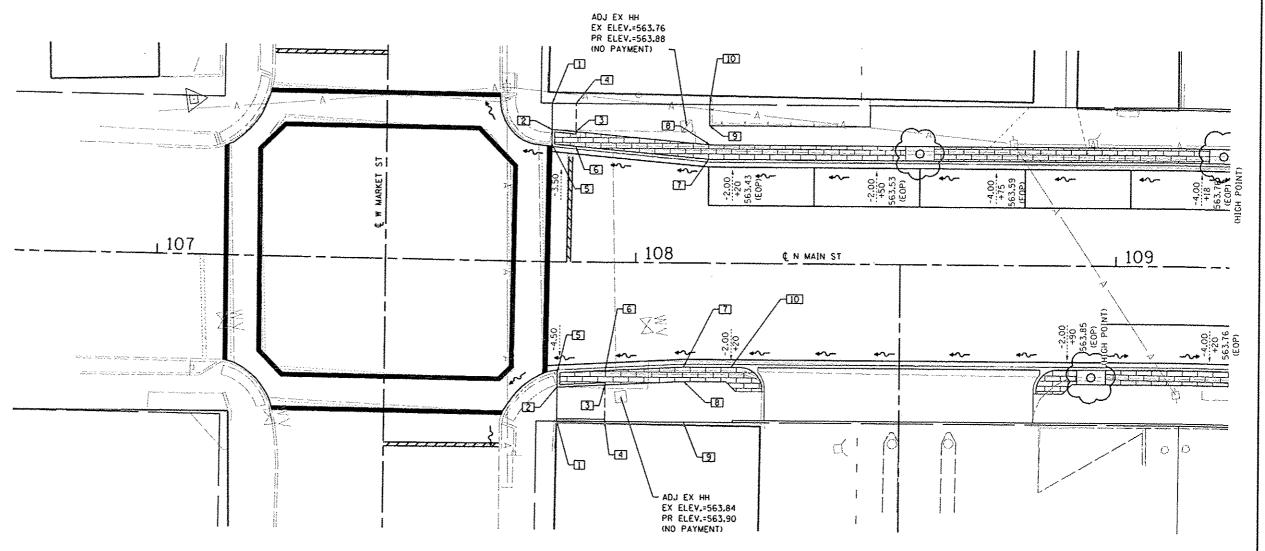

EAST RAMP										
PT NO.	STATION	OFFSET		ELEVATION						
1	+83.8	33.0	563.91 (TC) (ME)	563.20 (SW) (ME)	T					
2	+83.8	25.9	563.77 (TC)	563.32 (SW) (ME)						
3	+93.8	25.4		563.84 (SW/TC)						
4	+93.8	33.0		563.95 (SW/TC)						
5	+83.8	23.0	563.77 (TC)	563,35 (SW) (ME)	563.33 (EOP) (ME)					
6	+93,8	22.4		563.79 (SW/TC)	563,35 (EOP)					
7	+10.0	21.6		563.83 (SW/TC)	563.39 (EOP)					
8	+10.0	24.6		563.88 (SW)	503133 12011					
9	+10.0	33.0		564.00 (SW)						
10	+20.0	21.6		563.88 (SW/TC)	563.44 (EOP)					

-X.XXX PAVEMENT CROSS SLOPE

ABBREVIATIONS:

TC - TOP OF CURB
FG - FLOWLINE OF GUTTER

EOP - EDGE OF PAVEMENT

SW - SIDEWALK

ME - MATCH EXISTING


FILE	NAME.	*
0826	8591,86	83-ehtrinterseoidgn


USER NAME + default	DESIGNED -	REVISEO -
PLOT TIME = 7:45:02 AM	DRAWN -	REVISED -
PLOT SCALE = 20,0000 1/ IN,	CHECKED -	REVISED -
 PLOT DATE * 1/28/2014	DATE -	REVISED -

STATI	E 01	FILLINOIS
DEPARTMENT	0F	TRANSPORTATION

INTERSECTION DETAILS							F.A.U. RTÉ.	SECTION	COUNTY	TOTAL	SHEET NO.
	MICHOCUTUM DETAILS							11-00026-02-PV	MADISON	21	14
SCALE	SHEET 1	OF		CHECKE			N, N	IAIN STREET RECONSTRUCTION	CONTRACT	NO. S	7550
DOMECT	3145.61 1	Ur	- 4	SHEETS	5 ! A.	TO STA.		ILLINOIS FED. AL	D PROJECT		

			WEST RAMP	
PT NO.	STATION	OFFSET	ELEVATION	
1	+37.5	32.6	563.69 (SW) (ME)	
2	+37.5	26.6	563.57 (SW) (ME)	***************************************
3	+37.5	23.6	563.51 (SW/TC) (ME)	563.20 (EOP) (ME)
4	+22.6	21.6	563.77 (SW/TC)	563.33 (EOP)
5	+22.6	24.6	563,82(SW)	
6	+22.6	32.6	563.93 (SW)	

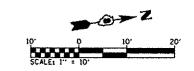

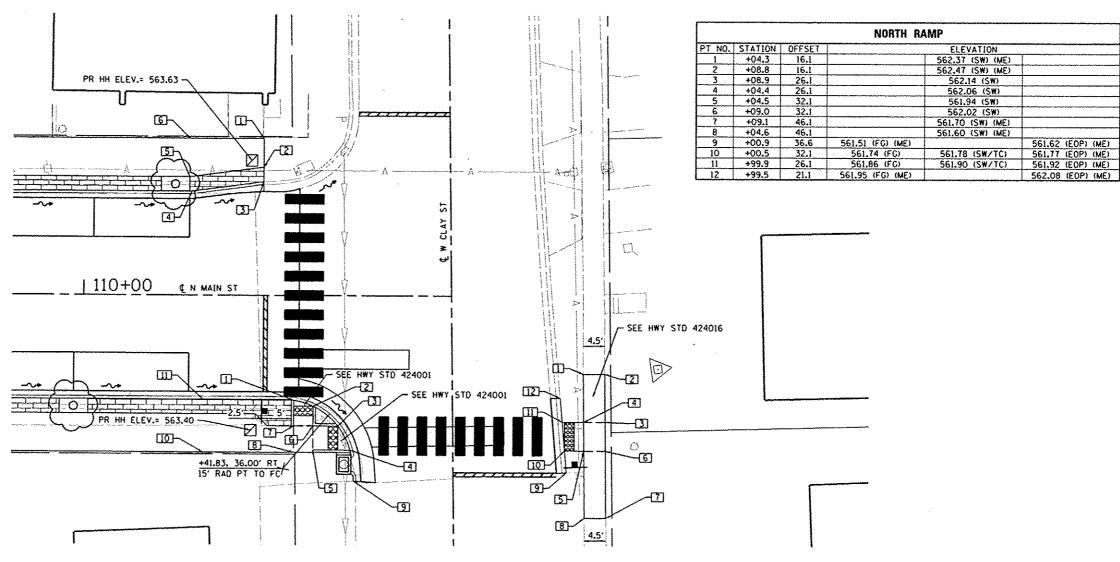


SOUTH RAMPS											
PT NO.	STATION	OFFSET		ELEVATION	······································						
1	+44.0	21.7	563.60 (TC)	563.14 (SW)	563.15 (EOP)						
2	+48.0	23.0	563.52 (TC)	563.06 (SW)	563.07 (EOP)						
3	+53.2	27.1	563.06 (TC)	562.60 (SW)	562.61 (EOP)						
4	+55.7	32.1	562.96 (TC)	562.50 (SW)	562.51 (EOP)						
5	+48.0	32.1		563.01 (SW/TC)							
6	+48.0	27.1		563.02 (SW/TC)							
7	+44.0	27.1		563.10 (SW/TC)							
8	+44.0	32.6		563.09 (SW)	1						
9	+56.5	38.6	562.10 (TC)		561.90 (EOP) (ME)						
10	+25.0	32.6		563.71 (SW)	1						
11	+25.0	21.6		563.76 (SW/TC)	563.32 (EOP)						

ABBREVIATIONS:

TC - TOP OF CURB
FG - FLOWLINE OF GUTTER
EOP - EDGE OF PAVEMENT
SW - SIDEWALK
ME - MATCH EXISTING

FILE NAME :	USER NAME = default	DESIGNED -	REVISED -		T			F.A.U. SCENIOU	TOTAL	SHE
D8268591.883-yht-intersec.dgn	PLOT TIME = 7:45:84 AM	ORAWN -	REVISED -	STATE OF ILLINOIS	INTERSECTION DETAILS			RTE. SECTION	COUNTY SHEETS	NO.
	PLOT SCALE = 20.0000 ' / IN.	CHECKED .	REVISED -	DEPARTMENT OF TRANSPORTATION	INTERSECTION DETAILS			9393 11-00026-02-PV	MADISON 21	15
	PLOT DATE = 1/28/2014	DATE -	REVISED Y	DEI MITTIETT VI TIMBIT VIITATIVII	SCALE	SHEET 2 OF 2 SHEETS STA.	70 CT.	N. MAIN STREET RECONSTRUCTION	" CONTINACT 110. 3	7550
					1 3CMEET	STREET & UT & STREETS STA,	O STA,	ILL INDIS F	ED. AID PROJECT	

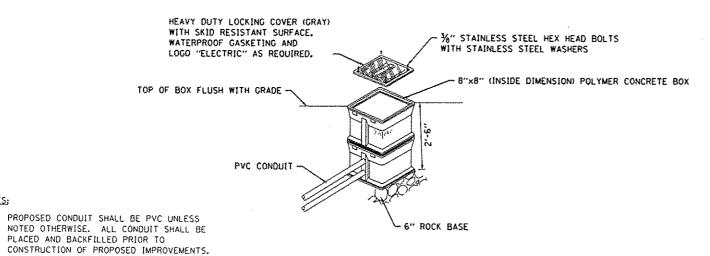


HANDHOLE (SPECIAL) DETAIL (NOT TO SCALE)


NOTES:

A 1/4" DIAMETER NYLON PULL ROPE SHALL BE


INSTALLED IN ALL CONDUITS.

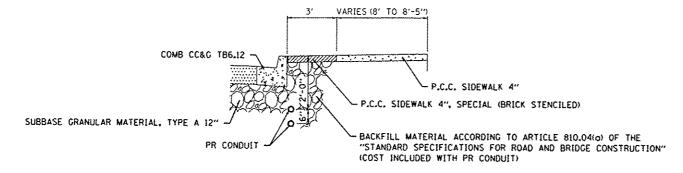

TYPICAL CONDUIT PLACEMENT DETAIL (NOT TO SCALE)

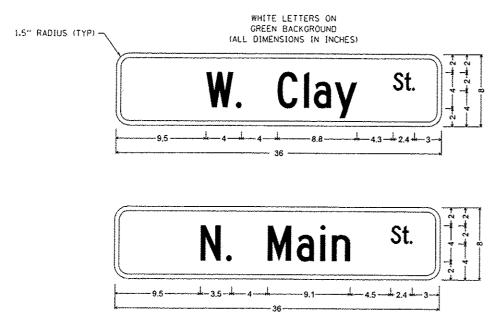

STREET SIGN DETAIL (NOT TO SCALE)

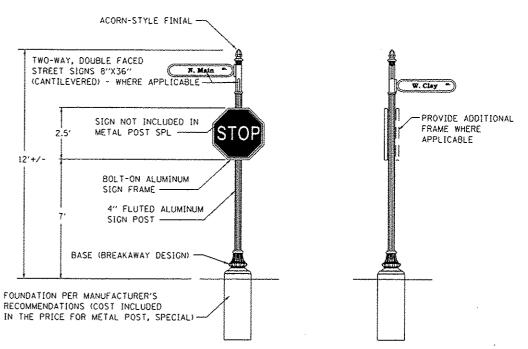

NOTES:

- 1. ALL APPLICABLE PARTS SHALL RECEIVE A STANDARD ELECTROSTATICALLY APPLIED THERMOSET POLYESTER POWDER COAT OR ENAMELED STEEL SMOOTH SEMI-GLOSS BLACK FINISH.


 2. ALL FASTENERS SHALL BE STAINLESS STEEL.
- 2. ALL FASTENERS SHALL BE STAINLESS STEEL.
 3. SIGN MANUFACTURER AND TYPE SHALL BE
 ONE OF THE FOLLOWING:
 HOLOPHANE INDUSTRIES,
 THE STREETSCAPE COMPANY, LLC, STYLE: VICTORIAN
 BRANDON INDUSTRIES,
 4. MEET PROVISIONS OF ARTICLE 106.01 IN THE "STANDARD
 SPECIFICATIONS FOR ROAD AND BRIDGE CONSTRUCTION"
- FOR DOMESTICALLY PRODUCED MATERIALS.
- 5. SIGN POSTS AND FRAMES MUST MEET FEDERAL CRASHWORTHINESS GUIDELINES.

FRONT VIEW NOT TO SCALE

SIDE VIEW NOT TO SCALE

AT STREET CORNERS

NOT TO SCALE

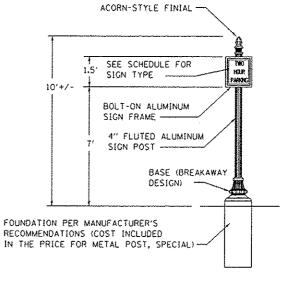


FRONT VIEW NOT TO SCALE


MID-BLOCK NOT TO SCALE

METAL POST, SPECIAL

NOT TO SCALE

FILE NAME +FILE NAME x USER NAME = default DESIGNED -REVISED -SECTION TOTAL SHEE SHEETS NO. 08260591.883-sht-data:1x,dan PLOT TIME = 7:43:89 AM DRAWN REVISED -STATE OF ILLINOIS **CONSTRUCTION DETAILS** 9393 11-00026-02-PV MADISON 21 16 PLOT SCALE : 40.0000 '/ IN. CHECKED REVISED -**DEPARTMENT OF TRANSPORTATION** N. MAIN STREET RECONSTRUCTION CONTRACT NO. 97550 PLOT DATE = 1/28/2014 DATE REVISED SCALE SHEET 1 OF 4 SHEETS STA. TO STA. ILLINOIS FED. AID PROJECT

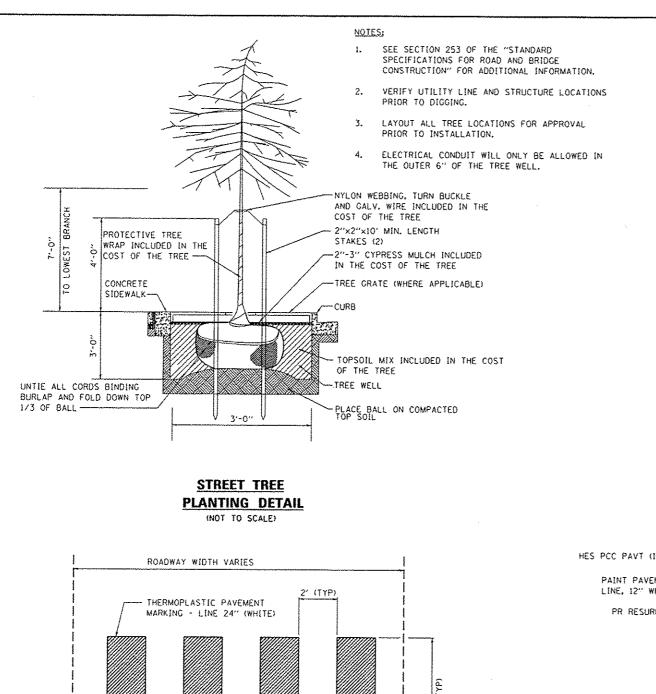


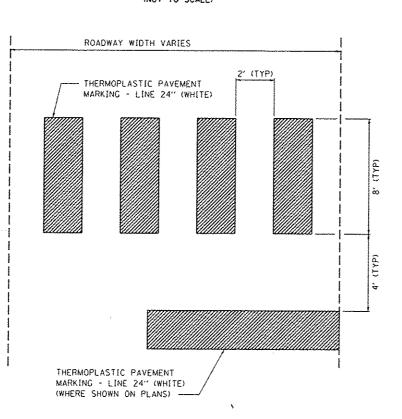

CROSSWALK DETAIL (NOT TO SCALE)

SOLDIER COURSE CONCRETE CURB

SOLDIER COURSE EDGE WITH RUNNING BOND PATTERN

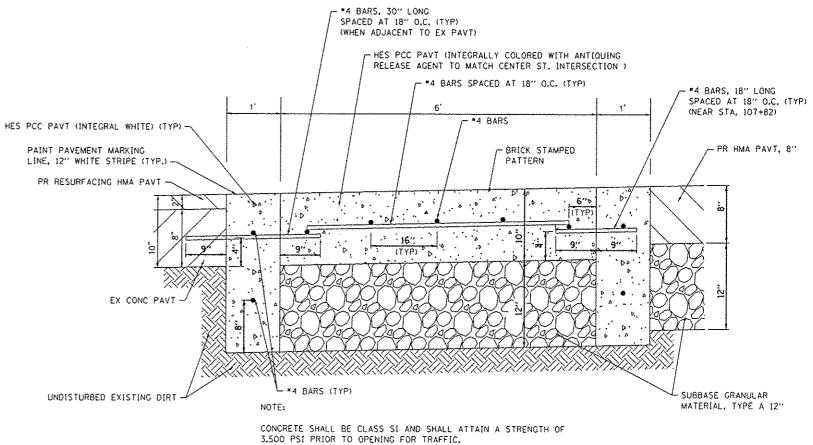


CROSS SECTION

CONCRETE CONTROL JOINTS SHALL BE DETERMINED BY THE ENGINEER.

HIGH-EARLY-STRENGTH PORTLAND CEMENT CONCRETE PAVEMENT 10", STAMPED & COLORED


(NOT TO SCALE)

FILE NAME :	USER NAME & default	DESIGNED -	REVISED -		<u> </u>	F.A.U. SECTION	COLUMN TOTAL SHEET
Q8268591,883-sht-details.dgn	PLOT TIME = 7:43:18 AM	DRAWN -	REVISED -	STATE OF ILLINOIS	CONSTRUCTION DETAILS	RTE. SECTION	COUNTY SHEETS NO.
	PLOT SCALE : 48.0000 '/ IN.	CHECKED -	REVISED -	DEPARTMENT OF TRANSPORTATION	SOUCHIOVION DETRIES	9393 11-00026-02-PV	MADISON 21 17
	PLOT DATE = 1/28/2814	DATE -	REVISED -		SCALE: SHEET 2 OF 4 SHEETS STA. TO STA.	M. MAIN STREET RECONSTRUCTION	CONTRACT NO. 97550
				**************************************		1 INCHANGE PER MIN	/ PROCE!

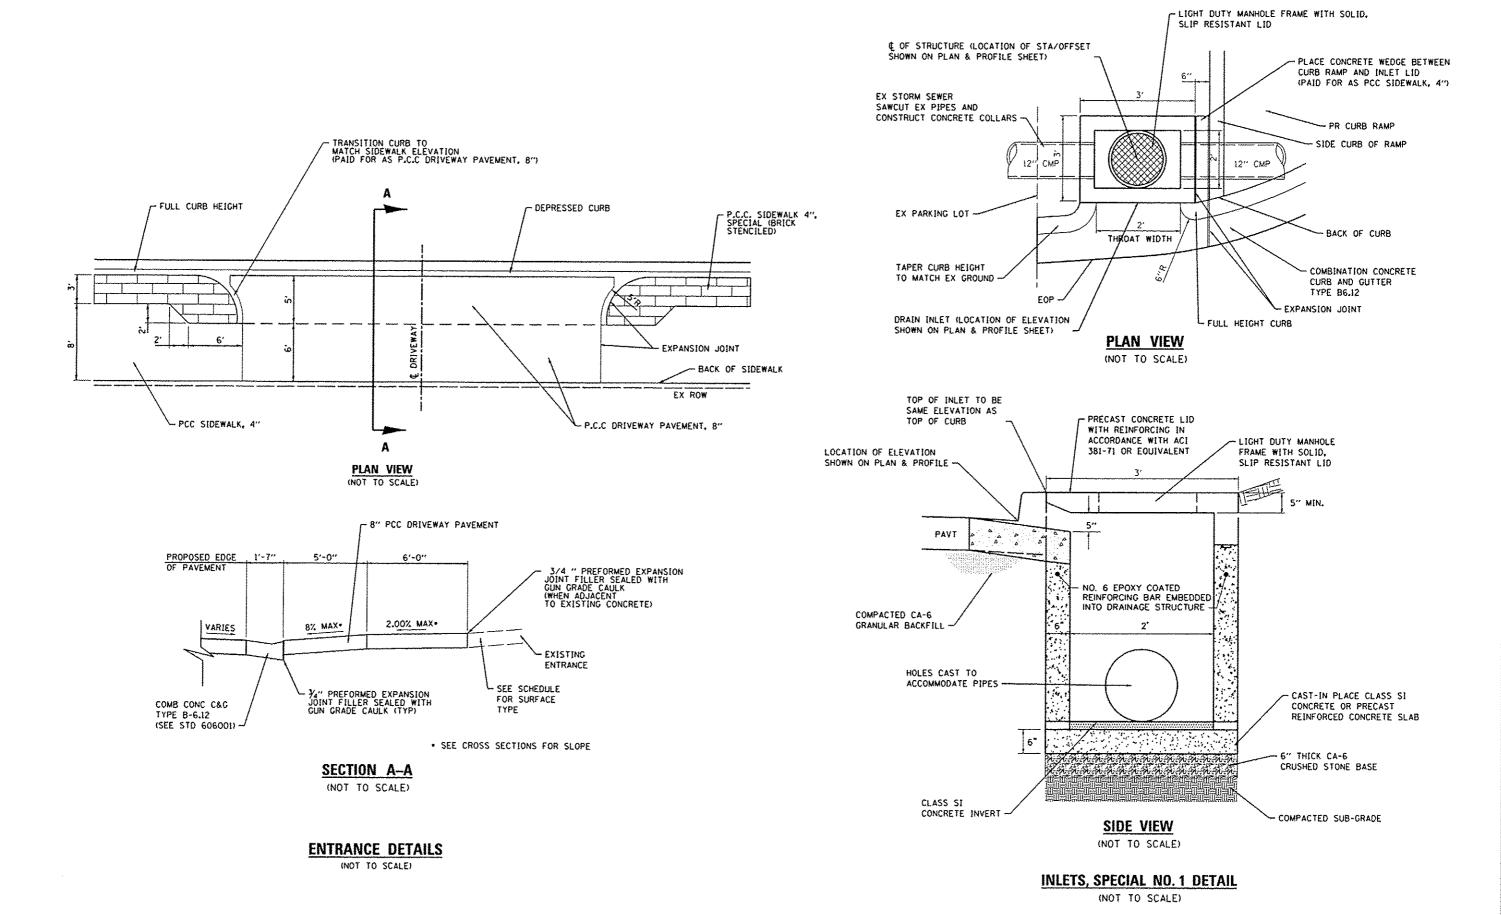


FILE NAME : USER NAME & default DESIGNED -REVISED COUNTY SHEETS NO.

MADISON 21 18 SECTION DS260591.003~sht-details.dgn PLOT TIME + 7:43:11 AM DRAWN REVISED STATE OF ILLINOIS **CONSTRUCTION DETAILS** 9393 11-00026-02-PV PLOT SCALE . 40.0000 '/ IN. CHECKED -REVISED -**DEPARTMENT OF TRANSPORTATION** M. MAIN STREET RECONSTRUCTION CONTRACT NO. 97550 PLOT DATE # 1/28/2014 DATE REVISED SCALE: SHEET 3 OF 4 SHEETS STA. TO STA. ILLINOIS FED. AID PROJECT

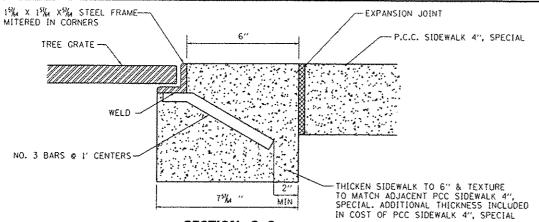

SECTION C-C TREE GRATE FRAME DETAIL OPTION 1

(NOT TO SCALE)

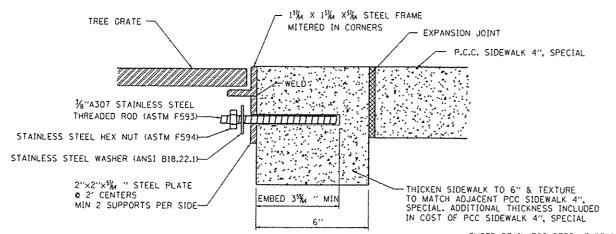


SECTION C-C TREE GRATE FRAME DETAIL OPTION 2


(NOT TO SCALE)

EMBED STAINLESS STEEL THREADED ROD WITH A CAPSULE OR ADHESIVE CARTRIDGE TYPE EPOXY SYSTEM. THE CONTRACTOR SHALL INSTALL THE RODS IN PRE-DRILLED HOLES ACCORDING TO THE MANUFACTURER'S RECOMMENDATIONS AND PROCEDURES. THE CAPSULE OR THE ADHESIVE CARTRIDGE SHALL BE SEALED WITH PREMEASURED AMOUNTS OF THE ADHESIVE CHEMICAL.

STEEL MUST MEET PROVISIONS OF ARTICLE 106.01 OF THE "STANDARD SPECIFICATIONS FOR ROAD AND BRIDGE CONSTRUCTION" AND SHALL BE DOMESTICALLY MANUFACTURED OR PRODUCED AND FABRICATED IN THE UNITED STATES.

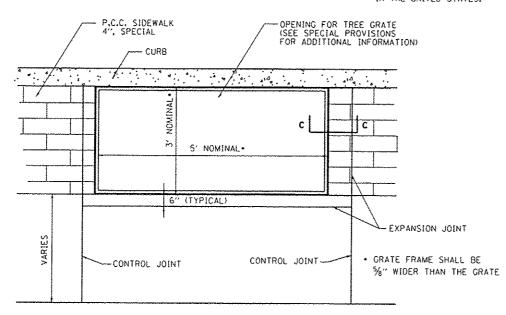


TREE GRATE FRAME DETAIL
(NOT TO SCALE)

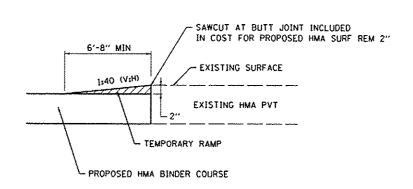


BUTT JOINT DETAIL

(NOT TO SCALE)

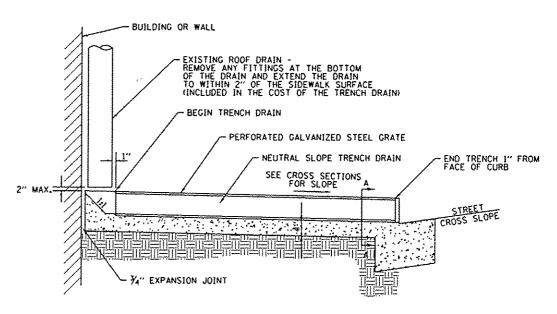

SIDE VIEW (NOT TO SCALE)

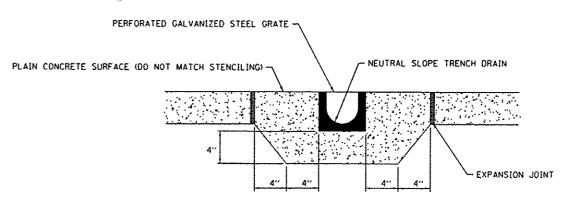

SECTION A-A

TRENCH DRAIN DETAIL

(NOT TO SCALE)

	FILE NAME :	USER NAME & default	DESIGNED -	REVISED -				
1	08268591.883-sht-deteils.dgn	PLOT TIME = 7:43:11 AM	DRAWN -	REVISEO -				
		PLOT SCALE * 48,0800 1/ IN,	CHECKED -	REVISED -				
		PLOT DATE . 1/28/2014	DATE -	REVISED -				

STATE OF ILLINOIS
DEPARTMENT OF TRANSPORTATION

SCALE:

CONSTRUCTION DETAILS						n	~	F.A.U. RTE.	SECTION	COUNTY	TOTAL	SHEET NO.
						UEIAIL	S	9393	11-00026-02-PV	MADISON	21	19
	1				· · · · · · · · · · · · · · · · · · ·		·····	N. M.	AIN STREET RECONSTRUCTION	CONTRACT	NO.	7550
	SHEET	4	0F	4	SHEETS	STA.	TO STA.	ILLINOIS FED, AID PROJECT				

