


**QUAD CITIES INTERNATIONAL AIRPORT  
METROPOLITAN AIRPORT AUTHORITY  
OF ROCK ISLAND COUNTY  
REALIGN THE GENERAL  
AVIATION ENTRANCE ROAD  
ROCK ISLAND COUNTY, IL  
PROJECT NO. MLI-5023 | CONTRACT NO. QU025  
100% DESIGN**



**FEBRUARY 28, 2025**




INDEX OF SHEETS	
SHEET NUMBER	DESCRIPTION
1	COVER SHEET & INDEX
2	GENERAL NOTES
3-4	SUMMARY OF QUANTITIES
5	PROPOSED SITE LAYOUT
6	ADD ALT PLAN
7	MAINTENANCE OF TRAFFIC PLAN
8-9	CONSTRUCTION SAFETY PLAN
10	EXISTING CONDITIONS & PROPOSED REMOVALS
11-15	PROPOSED PLAN & PROFILES
16	TYPICAL SECTIONS
17-18	PAVEMENT MARKING & SIGNING PLAN
19-27	DRAINAGE PLAN & PROFILES
28-32	STRUCTURAL SHEETS
33-37	LIGHTING PLANS
38-39	SWPPP & EROSION CONTROL PLANS
40-56	MISCELLANEOUS DETAILS
57-61	CROSS SECTIONS

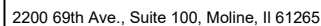

Date \_\_\_\_\_

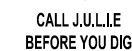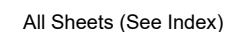

APPROVALS	ENGINEER	DATE	PREPARED FOR	
			 <b>QUAD CITIES</b> INTERNATIONAL AIRPORT	
			CLIENT ENGINEER	DATE
PROJECT NO. MLI-5023 HDR PROJECT NO. 10404260			SHEET  1	

GENERAL NOTES

1. WORK FOR THIS PROJECT SHALL CONSIST OF, BUT IS NOT LIMITED TO, REALIGNMENT OF GENERAL AVIATION ENTRANCE ROAD (CURRENT 68TH STREET) BETWEEN 74TH AVENUE AND 78TH AVENUE (INDIAN BLUFF ROAD), REMOVAL OF OLD 68TH STREET NORTH OF THE USPS ENTRANCE, EXTENSION OF 75TH AVENUE TO THE REALIGNED GENERAL AVIATION ENTRANCE ROAD, A NEW ENTRANCE TO NOAA PARKING LOT FROM 75TH AVENUE, AND NECESSARY DRAINAGE MODIFICATIONS.
2. THE CONTRACTOR SHALL FURNISH ALL LABOR, MATERIAL, EQUIPMENT, AND TRANSPORTATION NECESSARY TO CONSTRUCT ALL ELEMENTS OF THE PROJECT AS DESCRIBED IN THE CONSTRUCTION PLANS AND SPECIFICATIONS. THE PROJECT PAY ITEMS ARE INTENDED TO BE INCLUSIVE OF ALL WORK TO BE PERFORMED AS SHOWN IN THESE PLANS. ALL INCIDENTAL WORK REQUIRED TO COMPLETE THE PROJECT TO THE SATISFACTION OF THE RESIDENT ENGINEER/TECHNICIAN IS TO BE INCLUDED IN THE COSTS OF PERFORMING THESE ITEMS.
3. THE RULES, REGULATIONS, AND SPECIFICATIONS ENUMERATED HEREIN SHALL BE CONSIDERED AS MINIMUM REQUIREMENTS. THEY SHALL NOT PROHIBIT THE CONTRACTOR FROM FURNISHING AND INSTALLING HIGHER GRADES OF MATERIAL THAN ARE SPECIFIED HEREIN.
4. IT SHALL BE THE RESPONSIBILITY OF THE CONTRACTOR TO PROTECT, PRESERVE AND REPAIR THE EXISTING ROADWAY PAVEMENTS AT ALL TIMES. THE CONTRACTOR SHALL REPAIR ANY DAMAGE TO EXISTING UTILITIES, DRAINAGE, AND PAVEMENT STRUCTURES AT NO ADDITIONAL COST TO THE CONTRACT.
5. NO EQUIPMENT SHALL BE PERMITTED TO CROSS OR USE ANY EXISTING PAVEMENT OUTSIDE THE CONSTRUCTION LIMITS, GENERAL PROJECT AREA OR HAUL ROUTE.
6. CONTRACTOR IS REQUIRED TO PROVIDE THEIR OWN RESTROOM FACILITIES.
7. UNLESS OTHERWISE NOTED, ALL DISTURBED AREAS OUTSIDE OF THE PROPOSED CONSTRUCTION LIMITS SHALL BE GRADED, SEEDED AND MULCHED, OR HYDROMULCH SEEDED, AT NO ADDITIONAL COST TO THE CONTRACT.
8. EXCESS EXCAVATION MATERIAL SHALL BE PLACED AT A LOCATION ON AIRPORT PROPERTY TO BE DETERMINED BY THE AIRPORT MANAGER. ALL OTHER WASTE MATERIAL SHALL BE HAULED FROM THE AIRPORT AND PROPERLY DISPOSED OF UNLESS OTHERWISE SPECIFIED HEREIN.
9. THE CONTRACTOR SHALL BE RESPONSIBLE FOR OBTAINING PERMITS FOR HAULING ON PUBLIC ROADS, AS APPLICABLE. THE CONTRACTOR SHALL BE RESPONSIBLE FOR CORRECTING ANY DAMAGES TO ANY PAVEMENTS (PUBLIC OR PRIVATE) CAUSED BY THEIR CONSTRUCTION EQUIPMENT OR PERSONNEL.
10. THE OWNER SHALL HAVE THE RIGHT OF FIRST REFUSAL FOR ALL SALVAGEABLE MATERIAL REMOVED ON THE PROJECT.
11. THE CONTRACTOR SHALL COORDINATE WITH THE RESIDENT ENGINEER/TECHNICIAN SO THEY MAY DEVELOP ONE SET OF REDLINED AS-BUILT DRAWINGS AT THE COMPLETION OF THE PROJECT.
12. CONTRACTOR SHALL NOTE THAT ALL AREAS WITHIN THE AIRPORT PROPERTY LINE AND OUTSIDE THE CONSTRUCTION LIMITS MAY BE USED FOR AGRICULTURAL PURPOSES. THE CONSTRUCTION LIMITS SHALL BE RESTRICTED TO AREAS THAT ARE ABSOLUTELY NECESSARY TO DISTURB TO COMPLETE THE REQUIRED WORK ITEMS. LIMITS SHALL BE COORDINATED WITH THE RESIDENT ENGINEER PRIOR TO BEGINNING ANY WORK. ALL AREAS WHICH HAVE BEEN FARMED AND/OR DESIGNATED TO BE FARMED AFTER THE PROJECT COMPLETION, AND HAVE BEEN DISTURBED BY CONSTRUCTION ACTIVITY, SHALL BE CHISEL PLOWED (36" MAX.) OR OTHERWISE SCARIFIED TO RETURN THE AREA TO A REASONABLE TILLABLE CONDITION (IF SO PERMITTED BY THE AIRPORT MANAGER.)
13. CONTRACTOR SHALL RESTORE TO ORIGINAL CONDITION ALL GRASS, STONE, OR PAVEMENT DISTURBED BY CONTRACTOR'S CONSTRUCTION OPERATIONS, STAGING, AND CONSTRUCTION ACCESS ROUTES. DISTURBED AREAS TO BE REPAIRED, GRADED, AND MULCHED SEEDED UNLESS OTHERWISE NOTED. STAGING AREA AND SITE ACCESS RESTORATION SHALL BE INCLUDED IN THE COST OF THE HAUL ROUTE.
14. APPROXIMATE LOCATIONS OF UNDERGROUND UTILITIES ARE SHOWN. THE CONTRACTOR SHALL DETERMINE EXACT LOCATIONS AND PROTECT THESE UTILITIES DURING CONSTRUCTION. ANY UTILITIES DAMAGED DURING CONSTRUCTION SHALL BE REPAIRED AT THE CONTRACTOR'S EXPENSE. CONTRACTOR SHALL COORDINATE WITH THE PROPER PERSONS FOR THE PURPOSE OF LOCATING AND PROTECTING EXISTING UNDERGROUND UTILITIES.
15. THE CONTRACTOR MUST AT ALL TIMES MAINTAIN PROPER DRAINAGE FOR ALL AREAS AFFECTED BY THEIR WORK.
16. THIS PLAN HAS BEEN PREPARED TO COMPLY WITH THE PROVISIONS OF THE NPDES PERMIT NUMBER ILR10, ISSUED BY THE ILLINOIS ENVIRONMENTAL AGENCY FOR STORM WATER DISCHARGES FROM CONSTRUCTION SITE ACTIVITIES.

UTILITY NOTES

THE LOCATION, SIZE, AND TYPE OF MATERIAL OF EXISTING UNDERGROUND AND/OR ABOVEGROUND UTILITIES INDICATED ON THE PLANS ARE NOT REPRESENTED AS BEING ACCURATE, SUFFICIENT OR COMPLETE. NEITHER THE OWNER NOR THE ENGINEER ASSUMES ANY RESPONSIBILITY WHATSOEVER IN RESPECT TO THE ACCURACY, COMPLETENESS, OR SUFFICIENCY OF THE INFORMATION. THERE IS NO GUARANTEE, EITHER EXPRESSED OR IMPLIED, THAT THE LOCATIONS, SIZE AND TYPE OF MATERIAL OF EXISTING UNDERGROUND UTILITIES INDICATED ARE REPRESENTATIVE OF THOSE TO BE ENCOUNTERED IN THE CONSTRUCTION. IT SHALL BE THE CONTRACTOR'S RESPONSIBILITY TO DETERMINE THE ACTUAL LOCATION OF ALL SUCH FACILITIES, INCLUDING SERVICE CONNECTIONS TO UNDERGROUND UTILITIES. PRIOR TO CONSTRUCTION, THE CONTRACTOR SHALL NOTIFY THE UTILITY COMPANIES OF THEIR OPERATIONAL PLANS AND SHALL OBTAIN FROM THE RESPECTIVE UTILITY COMPANIES DETAILED INFORMATION AND ASSISTANCE RELATIVE TO THE LOCATION OF THEIR FACILITIES AND THE WORKING SCHEDULE OF THE COMPANIES FOR REMOVAL OR ADJUSTMENT WHERE REQUIRED. IN THE EVENT AN UNEXPECTED UTILITY INTERFERENCE IS ENCOUNTERED DURING CONSTRUCTION, THE CONTRACTOR SHALL IMMEDIATELY NOTIFY THE UTILITY COMPANY OF JURISDICTION. THE OWNER'S REPRESENTATIVE AND/OR THE RESIDENT ENGINEER SHALL ALSO BE IMMEDIATELY NOTIFIED. ANY DAMAGE TO SUCH MAINS AND SERVICES SHALL BE RESTORED TO SERVICE AT ONCE AND PAID FOR BY THE CONTRACTOR AT NO ADDITIONAL COST TO THE CONTRACT. ALL UTILITY CABLES AND LINES SHALL BE LOCATED BY THE RESPECTIVE UTILITY. CONTACT JULIE (JOINT UTILITY LOCATION INFORMATION FOR EXCAVATORS) FOR UTILITY INFORMATION, PHONE: 1-800-892-0123. CONTACT THE FAA (FEDERAL AVIATION ADMINISTRATION) FOR ASSISTANCE IN LOCATING FAA CABLES AND UTILITIES. LOCATION OF FAA POWER, CONTROL, AND COMMUNICATION CABLES SHALL BE COORDINATED WITH AND/OR LOCATED BY THE FAA. ALSO CONTACT AIRPORT DIRECTOR/MANAGER AND AIRPORT PERSONNEL FOR ASSISTANCE IN LOCATING UNDERGROUND AIRPORT CABLES AND/OR UTILITIES. ALSO COORDINATE WORK WITH ALL ABOVEGROUND UTILITIES.

UTILITY CONTACT INFORMATION

<b>MIDAMERICAN</b> NATE TEAGER  NATHAN.TEAGER@MIDAMERICAN.COM  563-333-8721	<b>METRONET</b> 811DESIGN@METRONET.COM  812-213-1050	<b>GENESEO COMMUNICATIONS</b> JAY CHALDER  JAY.CHALDER@GENESEO.COM  309-944-8005
<b>LUMEN</b> SAMANTHA MEYER  SAMANTHA.MEYER@LUMEN.COM  515-336-6366	<b>AT&amp;T</b> KARI MARTIN  KM2618@ATT.COM  630.573.5789	<b>LUMEN</b> PAT CAIRNS  PAT.CAIRNS@LUMEN.COM  CTL-RDMV-IA@LUMEN.COM
<b>MEDIACOM</b> MITCH HANCOCK  MHANCOCK@MEDIACOMCC.COM  309-743-4735	<b>CITY OF MOLINE</b> DEVON MILLER  DMILLER@MOLINE.IL.US  309-524-2362	

SURVEY NOTES

1. ALL COORDINATE VALUES SHOWN IN TABLE ARE BASED ON ILLINOIS STATE PLANE - WEST ZONE NAD-83 (2007).

BENCHMARK INFORMATION				
BM #	NORTHING	EASTING	ELEVATION	DESCRIPTION
BM #1	1738232.336	2203635.408	590.97	BM/ TOP CONC E
BM #2	1738829.297	2203385.347	578.59	BM/ CENTER BOLT HYD
BM #3	1738814.215	2203945.550	582.46	BM/ CENTER BOLT HYD

CONTROL POINTS INFORMATION				
BM #	NORTHING	EASTING	ELEVATION	DESCRIPTION
CP #1	1738905.435	2202601.739	575.65	CP/ NAIL
CP #2	1738916.646	2202126.890	576.32	CP/ NAIL
CP #3	1738887.110	2203402.498	576.38	CP/ NAIL
CP #4	1739051.750	2203866.234	579.61	CP/ NAIL
CP #5	1739005.361	2204350.530	575.24	CP/ NAIL
CP #6	1738632.793	2203805.980	582.70	CP/ NAIL
CP #7	1738191.642	2203723.439	589.04	CP/ NAIL



CALL 811 BEFORE YOU DIG

METROPOLITAN AIRPORT AUTHORITY OF ROCK ISLAND COUNTY (QUAD CITIES INTERNATIONAL AIRPORT)  
REALIGN THE GENERAL AVIATION ENTRANCE ROAD

GENERAL NOTES

CLIENT APPROVAL

CLIENT APPROVAL

PROJECT NO.  
MLI-5023

HDR PROJECT NO.  
10404260

SHEET NO.  
2 of 61

CONSULTANTS

4620 E 53RD STREET  
DAVENPORT, IA 52807-3620  
(563) 293-7684

PREPARED FOR

QUAD CITIES  
INTERNATIONAL AIRPORT

Date: 25 Feb 2025 - 10:38am User: STOJENSEN Layout: GNO-101  
Drawing Name: 02-GENERAL NOTES.dwg

Date: 20 Feb 2025 - 8:18am User: STOJENSEN Layout: S001-01  
Drawing Name: 03-SUMMARY OF QUANTITIES.dwg

SUMMARY OF QUANTITIES					
ITEM NO.	DESCRIPTION	UNIT	QUANTITY		ESTIMATE REFERENCE NOTE
			TOTAL	AS-BUILT	
AR108005	TEST ELECTRICAL CIRCUIT	L SUM	1		SEE LIGHTING SPECIAL PROVISION
AR108401	1/C #1 600 V UG CABLE	FOOT	250		SEE LIGHTING SPECIAL PROVISION
AR108406	1/C #6 600 V UG CABLE	FOOT	150		SEE LIGHTING SPECIAL PROVISION
AR108408	1/C #8 600 V UG CABLE	FOOT	11800		SEE LIGHTING SPECIAL PROVISION
AR108960	REMOVE CABLE	FOOT	6800		SEE LIGHTING SPECIAL PROVISION
AR109909	REMOVE CONTROL PANEL	L SUM	1		SEE LIGHTING SPECIAL PROVISION
AR110312	2" STEEL DUCT, JACKED	FOOT	408		SEE LIGHTING SPECIAL PROVISION
AR110610	ELECTRICAL HANDHOLE	EACH	15		SEE LIGHTING SPECIAL PROVISION
AR110906	REMOVE ELECTRICAL HANDHOLE	EACH	6		SEE LIGHTING SPECIAL PROVISION
AR150520	MOBILIZATION	L SUM	1		6% OF ALL OTHER ITEMS.
AR151420	CLEARING TREES 0--2.5' BUTT DIA.	EACH	4		
AR151455	CLEARING AND GRUBBING	L SUM	1		
AR152410	UNCLASSIFIED EXCAVATION/EMBANKMENT	CU YD	9590		CUT VOLUME = 762 CY, FILL VOLUME = 8827 CY. SEE SPECIAL PROVISION
AR152411	UNCLASSIFIED EXCAVATION (BOX CULVERT UNDERCUT)	L SUM	1		ASSUMED QUANTITY UNDER RCB. SEE STRUCTURAL SHEETS
AR152541	STABILIZATION GEOGRID	SQ YD	6201		
AR156510	SILT FENCE	FOOT	1339		ENTIRE DOWNSTREAM SIDE OF PROJECT TO BE LINED WITH SILT FENCE.
AR156514	DITCH CHECK (ROLLED EXCELSIOR)	FOOT	525		
AR156520	INLET PROTECTION	EACH	8		
AR156530	TEMPORARY SEEDING	ACRE	1.5		
AR156531	EROSION CONTROL BLANKET	SQ YD	4432		
AR208515	POROUS GRANULAR EMBANKMENT	CU YD	111		SEE STRUCTURAL SHEETS
AR209606	CRUSHED AGG. BASE COURSE - 6"	SQ YD	6201		BASE COURSE FOR CONCRETE PAVEMENT SECTIONS.
AR209608	CRUSHED AGG. BASE COURSE - 8"	SQ YD	233		BASE COURSE FOR ASPHALT PAVEMENT SECTIONS.
AR401610	BITUMINOUS SURFACE COURSE	TON	22		
AR401900	REMOVE BITUMINOUS PAVEMENT	SQ YD	120		REMOVAL OF PORTION OF ASHPALT PARKING LOT.
AR403610	BITUMINOUS BASE COURSE	TON	29		
AR501508	8" PCC PAVEMENT	SQ YD	5841		CONCRETE ROADWAY & INTEGRAL CURB.
AR501900	REMOVE PCC PAVEMENT	SQ YD	1530		REMOVAL OF PORTION OF EXISTING 68TH ST.
AR602510	BITUMINOUS PRIME COAT	GALLON	58		
AR603510	BITUMINOUS TACK COAT	GALLON	49		
AR620520	PAVEMENT MARKING-- WATERBORNE	SQ FT	1675		SEE PAVEMENT MARKING & SIGNING PLAN
AR701183	PRECAST 8' X 3' BOX CULVERT	FOOT	76		SEE STRUCTURAL SHEETS
AR701512	12" RCP, CLASS IV	FOOT	173		
AR701515	15" RCP, CLASS IV	FOOT	76		
AR701548	48" RCP, CLASS IV	FOOT	168		
AR701900	REMOVE PIPE	FOOT	300		
AR705506	6" PERFORATED UNDERDRAIN	FOOT	2024		
AR705546	6" NON PERFORATED UNDERDRAIN	FOOT	212		
AR705610	CONCRETE HEADWALL FOR UNDERDRAIN	EACH	7		
AR705640	UNDERDRAIN CLEANOUT	EACH	19		
AR751411	INLET - TYPE A	EACH	2		
AR751540	MANHOLE 4'	EACH	1		
AR751550	MANHOLE 5'	EACH	1		
AR751560	MANHOLE 6'	EACH	1		
AR751900	REMOVE CURB INLET	EACH	2.0		
AR751903	REMOVE MANHOLE	EACH	1		
AR752900	REMOVE END SECTION	EACH	1		
AR754900	REMOVE CONCRETE CURB	FOOT	360		
AR752600	CONCRETE HEADWALL (BOX CULVERT END SECTIONS)	EACH	2		SEE STRUCTURAL SHEETS
AR752412	PRECAST REINFORCED CONC. FES 12"	EACH	3		
AR752415	PRECAST REINFORCED CONC. FES 15"	EACH	1		
AR752448	PRECAST REINFORCED CONC. FES 48"	EACH	2		
AR754410	CONCRETE CURB AND GUTTER	FOOT	285		
AR901510	SEEDING	ACRE	1.5		
AR905530	TOPSOILING (4")	SQ YD	7225		
AR910110	RDWY LIGHT POLE W/FIXTURE	EACH	27		SEE LIGHTING SPECIAL PROVISION
AR910200	ROADWAY SIGN	EACH	12		SEE PAVEMENT MARKING & SIGNING PLAN
AR910430	MAINTENANCE OF TRAFFIC	L SUM	1		
AR910905	REMOVE RDWY LGT POLE W/FIXTURE	EACH	13		SEE LIGHTING SPECIAL PROVISION
AR910915	REMOVE ROAD SIGNS	EACH	5		
AR800400	MEMBRANE WATERPROOFING SYSTEM FOR BURIED STRUCTURES	SQ YD	101		SEE STRUCTURAL SHEETS
AR800402	FLEXAMAT PLUS	SQ YD	1189		SEE SPECIAL PROVISION. EROSION CONTROL MEASURE AT CURB CUTS & HEADWALL/FES STRUCTURES.
AR800403	REMOVE FUSIBLE SERVICE DISCONNECT SWITCH	EACH	1		SEE LIGHTING SPECIAL PROVISION
AR800404	LIGHT POLE FOUNDATION	EACH	27		SEE LIGHTING SPECIAL PROVISION
AR800405	FUSIBLE SERVICE DISCONNECT, 100	EACH	1		SEE LIGHTING SPECIAL PROVISION
AR800406	LIGHTING CONTROL CABINET	EACH	1		SEE LIGHTING SPECIAL PROVISION
AR800407	HDPE DUCT, 600 V	FOOT	3200		SEE LIGHTING SPECIAL PROVISION
AR800409	ROCKFILL	CU YD	180		SEE STRUCTURAL SHEETS

NOTE:

1. EARTHWORK QUANTITIES (CUT/FILL VOLUMES) SHOWN WERE CALCULATED UTILIZING AUTODESK CIVIL3D SOFTWARE THROUGH AUTOCAD. THE CALCULATION METHOD WAS BY A COMPARISON OF SURFACE MODELS CREATED WITH EXISTING SURVEY DATA AND PROPOSED DESIGN GRADES. THE VOLUMES WERE CALCULATED IN TWO PARTS: THE CUT/FILL VOLUME REQUIRED TO CORE OUT AND FILL FOR THE PROPOSED PAVEMENT SECTION AS COMPARED TO THE EXISTING SUBGRADE DATUM, AND THE CUT/FILL VOLUMES REQUIRED FOR PROPOSED GRADING WORK OUTSIDE OF THE PROPOSED PAVEMENT LIMITS AS COMPARED TO THE EXISTING GROUND SURFACE. THE VALUE IN THE SUMMARY TABLE REPRESENT A TOTAL OF THESE TWO PARTS ADDED TOGETHER FOR CLARITY. NOTE THAT A CUT AND FILL FACTOR OF 1 WAS USED.
2. QUANTITY OF PAVEMENT CONCRETE (AR501508) IS UNDER 2000 CY AND PWL IS THEREFORE NOT APPROPRIATE FOR ACCEPTANCE CRITERIA. SEE STANDARD SPECIFICATIONS AND SPECIAL PROVISIONS FOR MORE INFORMATION.



CALL 811  
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METROPOLITAN AIRPORT AUTHORITY OF ROCK ISLAND  
COUNTY (QUAD CITIES INTERNATIONAL AIRPORT)  
REALIGN THE GENERAL AVIATION  
ENTRANCE ROAD

SUMMARY OF QUANTITIES (1 OF 2)

CLIENT APPROVAL

CLIENT APPROVAL

PROJECT NO.  
MLI-5023

HDR PROJECT NO.  
10404260

SHEET NO.  
3 of 61

CONSULTANTS  
PREPARED FOR

QUAD CITIES  
INTERNATIONAL AIRPORT

4620 E 53RD STREET  
DAVENPORT, IA 52807-3620  
(563) 293-7684

Date: 11 Feb 2025 - 3:45pm User: STOJENSEN Layout: S001-02  
Drawing Name: 03-SUMMARY OF QUANTITIES.dwg

ADD ALT 1 – 78TH AVE SHOULDER IMPROVEMENT (SOUTH ONLY)				
ITEM NO.	DESCRIPTION	UNIT	QUANTITY	
			TOTAL	AS–BUILT
AS152410	UNCLASSIFIED EXCAVATION/EMBANKMENT	CU YD	52	
AS209608	CRUSHED AGGREGATE BASE COURSE – 8”	SQ YD	155	
AS403610	BITUMINOUS BASE COURSE	TON	34	
AS401610	BITUMINOUS SURFACE COURSE	TON	34	
AS602510	BITUMINOUS PRIME COAT	GALLON	39	
AS603510	BITUMINOUS TACK COAT	GALLON	39	
AS800401	AGGREGATE SHOULDER REMOVAL	CU YD	60	
SEE ADD ALT PLAN SHEET FOR MORE DETAILS				

ADD ALT 2 – ADDITIONAL STREET LIGHT REPLACEMENTS				
ITEM NO.	DESCRIPTION	UNIT	QUANTITY	
			TOTAL	AS–BUILT
AT108408	1/C #8 600 V UG CABLE	FOOT	5985	
AT108960	REMOVE CABLE	FOOT	5550	
AT910110	RDWY LIGHT POLE W/FIXTURE	EACH	13	
AT910905	REMOVE RDWY LGT POLE W/ FIXTURE	EACH	13	
AT800408	1 1/2” HDPE CONDUIT	FOOT	1945	
SEE LIGHTING SHEETS FOR MORE DETAILS				

ADD ALT 3 – PAVEMENT PATCHING ON 68TH STREET				
ITEM NO.	DESCRIPTION	UNIT	QUANTITY	
			TOTAL	AS–BUILT
AU501910	REMOVE & REPLACE PCC PAVEMENT	SQ YD	482	
SEE ADD ALT PLAN SHEET FOR MORE DETAILS				



METROPOLITAN AIRPORT AUTHORITY OF ROCK ISLAND COUNTY (QUAD CITIES INTERNATIONAL AIRPORT) REALIGN THE GENERAL AVIATION ENTRANCE ROAD		
SUMMARY OF QUANTITIES (2 OF 2)		
CLIENT APPROVAL	CLIENT APPROVAL	PROJECT NO. MLI-5023
		HDR PROJECT NO. 10404260
		SHEET NO. 4 of 61

CONSULTANTS



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PREPARED FOR


QUAD CITIES  
INTERNATIONAL AIRPORT



1. SEE LIGHTING SHEETS FOR ADD ALT 2

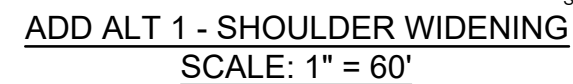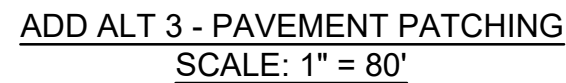

1. EXISTING CROSS SLOPES ON 78TH AVE APPROXIMATELY 1.5 - 2.5 %. PROPOSED SHOULDER CROSS SLOPE TO BE 0.5 % STEEPER THAN ADJACENT TRAVEL LANE.
2. SHOULDER TO BE 8" THICK HMA OVER 8" AGGREGATE BASE COURSE. SEE TYPICAL SECTION FOR DETAILS.

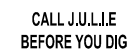

ADD ALT PLAN

CLIENT APPROVAL	CLIENT APPROVAL	PROJECT NO. MLI-5023
		HDR PROJECT NO. 10404260
		SHEET NO. <b>6 of 61</b>

CONSULTANTS



4020 E 33RD STREET  
DAVENPORT, IA 52807-3620  
(563) 293-7684




**QUAD CITIES**  
INTERNATIONAL AIRPORT

[illegible]

DATE: \_\_\_\_\_



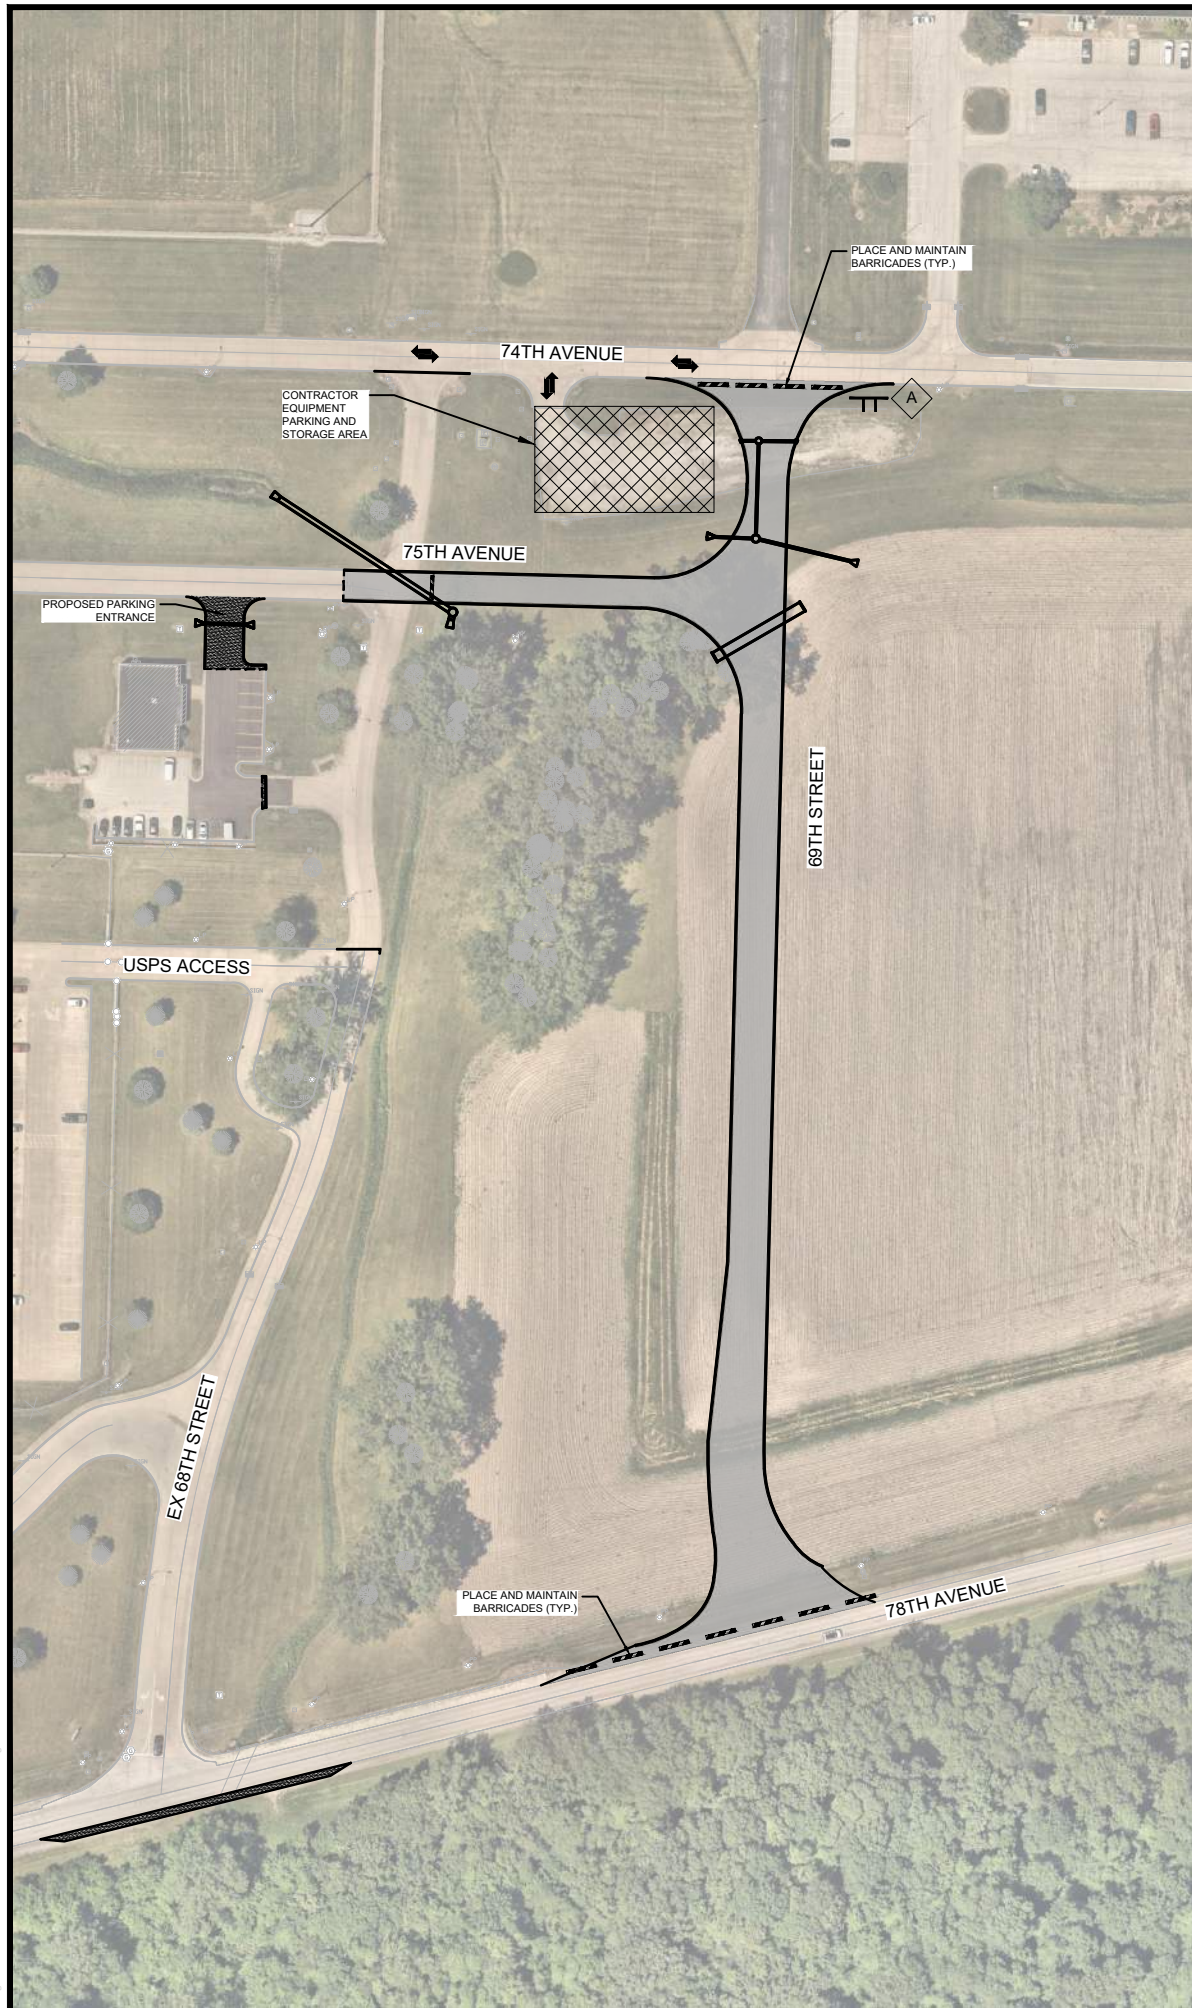

CLIENT APPROVAL	CLIENT APPROVAL	PROJECT NO. MLI-5023
		HDR PROJECT NO. 10404260
		SHEET NO. <b>8 of 61</b>

SAFETY NOTES

1.

THE FOLLOWING NOTES ARE THE CONSTRUCTION SAFETY PROCEDURES THAT THE CONTRACTOR SHALL FOLLOW THROUGHOUT THIS PROJECT. ADDITIONAL REQUIREMENTS ARE SHOWN ON THE CONSTRUCTION SAFETY AND PHASING PLAN SHEET AND THIS SHEET.
2.

ALL PROVISIONS OF THE LATEST EDITION OF FAA ADVISORY CIRCULAR AC 150/5370-2G (CURRENT EDITION), "OPERATIONAL SAFETY ON AIRPORTS DURING CONSTRUCTION", APPLY TO THIS CONTRACT.
3.

THE CONTRACTORS SHALL MINIMIZE DISRUPTION OF STANDARD OPERATING PROCEDURES FOR AERONAUTICAL ACTIVITY BY REMAINING WITHIN THE PRESCRIBED STAGING, CONSTRUCTION, AND PHASING AREAS PRESENTED ON THE CONSTRUCTION SAFETY AND PHASING PLAN SHEETS.
4.

NO UNAUTHORIZED PERSONNEL SHALL ENTER ANY AREA OF THE AIRPORT THAT COULD POTENTIALLY BE HAZARDOUS. THE AIRPORT MANAGER RESERVES THE RIGHT TO SUSPEND OPERATIONS IN ORDER TO MAINTAIN SAFETY AT THE AIRPORT.
5.

CONTRACTOR EQUIPMENT, VEHICLES, AND PROJECT MATERIALS SHALL BE STORED AT THE STAGING AREA SHOWN ON THE PLAN VIEW.
6.

ALL CONSTRUCTION EQUIPMENT OPERATING IN THE PRESCRIBED CONSTRUCTION AREA IS REQUIRED TO DISPLAY A CHECKERBOARD FLAG PROPERLY LOCATED OR A ROTATING BEACON (STROBE) AS SPECIFIED IN AC 150/5210-5D, "PAINTING, MARKING, AND LIGHTING OF VEHICLES USED ON AN AIRPORT" LATEST EDITION.
7.

NO CONSTRUCTION MATERIAL STOCKPILES SHALL BE LOCATED WITHIN 125' OF ANY ACTIVE RUNWAY CENTERLINE, WITHIN 44.5' OF ANY OTHER ACTIVE AIRPORT OPERATIONS AREA (EX. TAXIWAY), OR PENETRATE A PART 77 IMAGINARY SURFACE (PROVIDED BY THE RESIDENT ENGINEER/TECHNICIAN) EXTENDING OUT AND UPWARDS FROM ALL SIDES OF AN ACTIVE RUNWAY.
8.

OPEN TRENCHES, EXCAVATIONS, AND STOCKPILED MATERIALS AT THE CONSTRUCTION SITE SHOULD BE PROMINENTLY MARKED WITH ORANGE FLAGS AND LIGHTED WITH FLASHING RED LIGHTS DURING HOURS OF RESTRICTED VISIBILITY AND/OR DARKNESS.
9.

NO CONSTRUCTION EQUIPMENT GREATER THAN 25' TALL WILL BE PERMITTED ON THE AIRPORT UNLESS PERMITTED WITH THE APPROVAL OF THE AIRPORT MANAGER AND AIRSPACE APPROVAL BY THE FAA.
10.

NO OPEN FLAME WELDING OR TORCH CUTTING OPERATION IS PERMITTED UNLESS ADEQUATE FIRE AND SAFETY PRECAUTIONS ARE PROVIDED AND HAVE BEEN APPROVED BY THE AIRPORT MANAGER NO FLARE POTS ARE ALLOWED ON THE PROJECT.
11.

SOIL, DEBRIS, AND LOOSE MATERIAL DROPPED OR TRACKED ONTO AIRPORT ROADS, TAXIWAYS, AND SOD SURFACES, OR WHICH CAN BE BLOWN ONTO SUCH SURFACES, SHALL BE IMMEDIATELY SWEPT, PICKED UP AND REMOVED, OR PLACED INTO CLOSED CONTAINERS. ANY DAMAGE TO AIRPORT PROPERTY SHALL BE REPAIRED IMMEDIATELY AT NO COST TO THE OWNER.
12.

EACH CONTRACTOR SHALL BE RESPONSIBLE FOR LOCATING AND MAINTAINING AIRPORT LIGHTING AND NAVIGATIONAL ELECTRICAL SYSTEMS DURING CONSTRUCTION. A CONTACT PERSON AND TELEPHONE NUMBER FOR 24 HOUR EMERGENCY IMMEDIATE REPAIR SHALL BE SUBMITTED TO THE AIRPORT MANAGER AND RESIDENT ENGINEER/TECHNICIAN. HAUL ROUTES CROSSING PAVEMENT, DRAINAGE, MISCELLANEOUS. STRUCTURES AND/OR AIRFIELD CABLES SHALL BE PROTECTED FROM DAMAGE.
13.

ALL AIRPORT OPERATIONS HAVE THE RIGHT-OF-WAY. CONTRACTOR TO YIELD TO VEHICLES AND REMAIN CLEAR AT ALL TIMES.
14.

CONTRACTOR SHALL MARK HAZARDOUS AREA WITH STEADY-BURNING OR FLASHING RED LIGHTS DURING PERIODS OF LOW VISIBILITY AS REQUIRED.
15.

THE CONTRACTOR SHALL PERIODICALLY PERFORM ONSITE INSPECTIONS THROUGHOUT THE DURATION OF THE PROJECT WITH THE IMMEDIATE REMEDY OF ANY DIFFERENCES, WHETHER CAUSED BY NEGLIGENCE, OVERSIGHT, OR PROJECT SCOPE CHANGE.
16.

CONTRACTOR SHALL MOVE MAINTENANCE OF TRAFFIC COMPONENTS AT THE WRITTEN DIRECTION OF THE RESIDENT ENGINEER/TECHNICIAN AT NO ADDITIONAL COST.
17.

CONTRACTOR SHALL NOT REMOVE THE BARRICADES WITHOUT THE APPROVAL BY THE RESIDENT ENGINEER/TECHNICIAN.
18.

CONTRACTOR SHALL MAINTAIN FLASHERS, SIGNS AND/OR BARRICADES AS REQUIRED BY THE PLANS, CITY OR COUNTY REGULATIONS OR CONTRACTOR ACTIVITIES. CONTRACTOR SHALL OBTAIN ANY AND ALL REQUIRED LOCAL PERMITS UNLESS SPECIFIED OTHERWISE.
19.

THE CONTRACTOR SHALL UTILIZE WATER AND/OR CHEMICALS APPROVED BY THE RESIDENT ENGINEER/TECHNICIAN AS NECESSARY TO CONTROL DUST.
20.

UNLESS SPECIFIED OTHERWISE, COST FOR THE ABOVE IS TO BE CONSIDERED INCIDENTAL TO THE PROJECT. SEPARATE PAYMENT SHALL NOT BE MADE.

SIGNAGE NOTES

1.


ALL CONSTRUCTION SIGNS AND TRAFFIC CONTROL DEVICES SHALL CONFORM TO THE MANUAL ON UNIFORM TRAFFIC CONTROL DEVICES INCLUDING THE ILLINOIS SUPPLEMENT (LATEST EDITION) AND THE FAA ADVISORY CIRCULARS (LATEST EDITION) UNLESS NOTED OTHERWISE. THE FAA OR MORE STRINGENT SPECIFICATIONS SHALL GOVERN.
2.

UNLESS OTHERWISE SPECIFIED, CONSTRUCTION SIGNS SHALL BE MOUNTED ON PORTABLE OR NON-PORTABLE SUPPORTS. A PORTABLE SUPPORT IS DEFINED AS A TYPICAL SIGN STANDARD AS SHOWN ON THIS SHEET, OR A SMALL LIGHT WEIGHT TRAILER. A NON-PORTABLE SUPPORT IS DEFINED AS DRIVEN METAL OR WOOD POST. ALL SIGNS, REGARDLESS OF THE TYPE OF SUPPORTS USED, SHALL BE MOUNTED SUCH THAT THE MESSAGE ON THE SIGN IS LEVEL IN THE HORIZONTAL PLANE AFTER PLACEMENT. THE COST OF CONSTRUCTION WARNING LIGHTS SHALL BE INCLUDED IN THE COST OF THE CONSTRUCTION SIGNS.
3.



CONSTRUCTION RED WARNING LIGHT: THESE ARE PORTABLE, LENS DIRECTED, ENCLOSED LIGHTS. THE COLOR OF THE LIGHT EMITTED SHALL BE RED. THEY ARE TO BE USED IN A LOW INTENSITY FLASHING MODE (TYPE A).
4.

THE LIGHTING SHALL BE MAINTAINED IN OPERATION DURING THE HOURS OF DARKNESS BETWEEN 1/2 HOUR AFTER SUNSET AND 1/2 HOUR BEFORE SUNRISE AND WHEN CONDITIONS EXIST WHICH TEND TO OBSCURE VISION.
5.

COST FOR PROVIDING, PLACING, MAINTAINING, AND REMOVING SIGNS SHALL BE PAID FOR UNDER ITEM AR150520 MOBILIZATION.

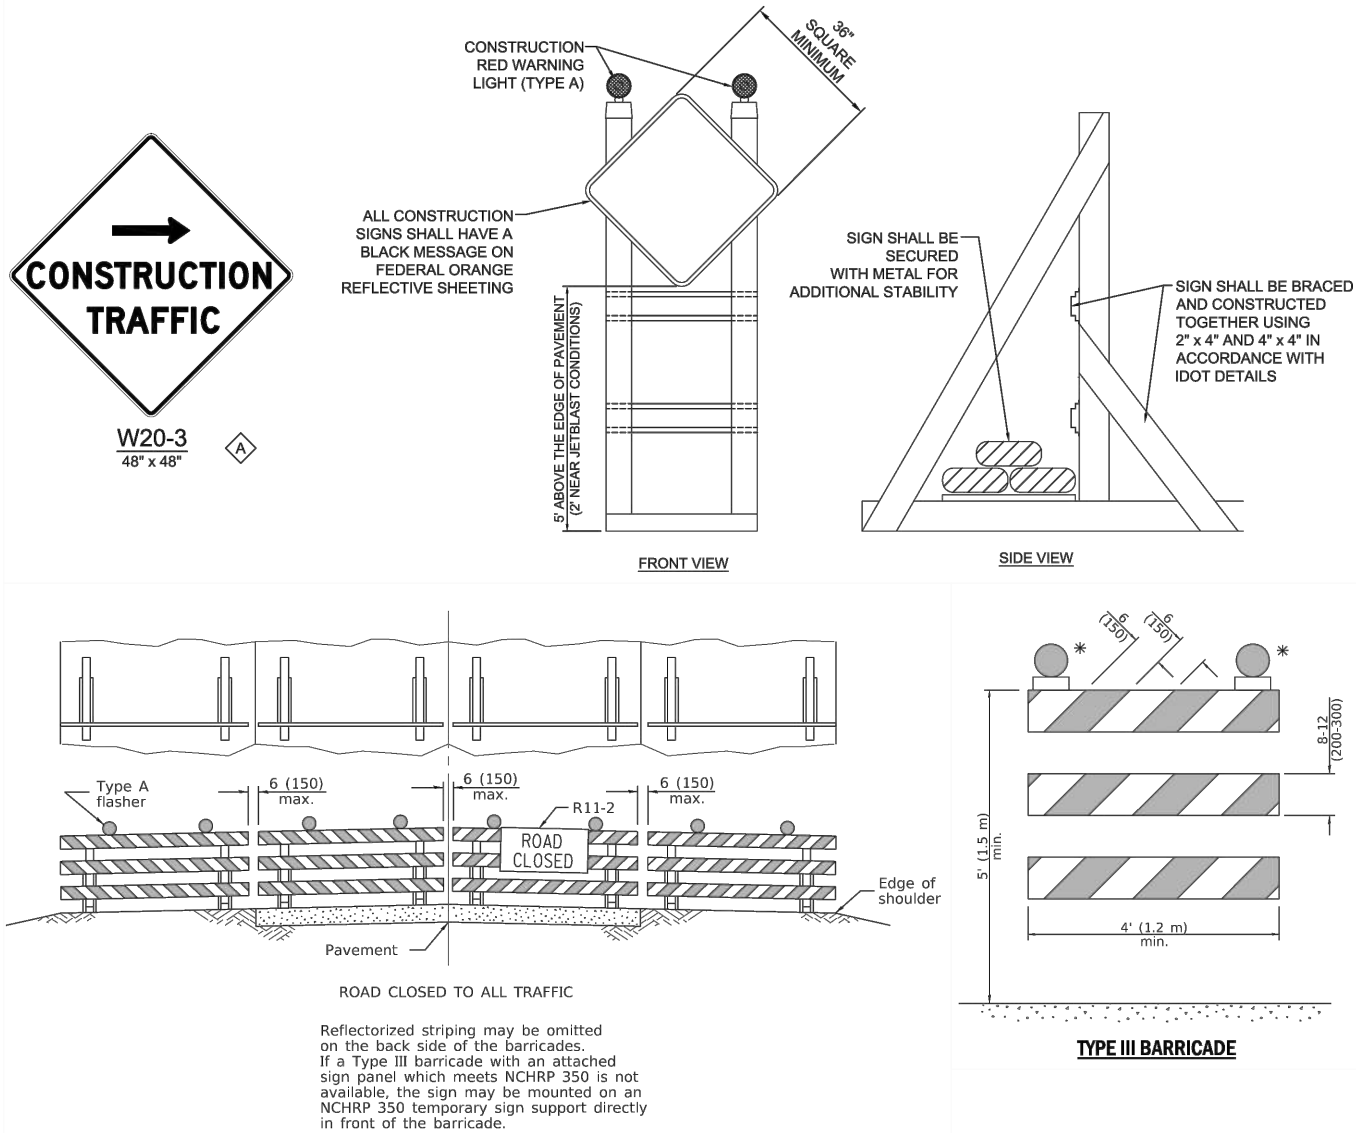



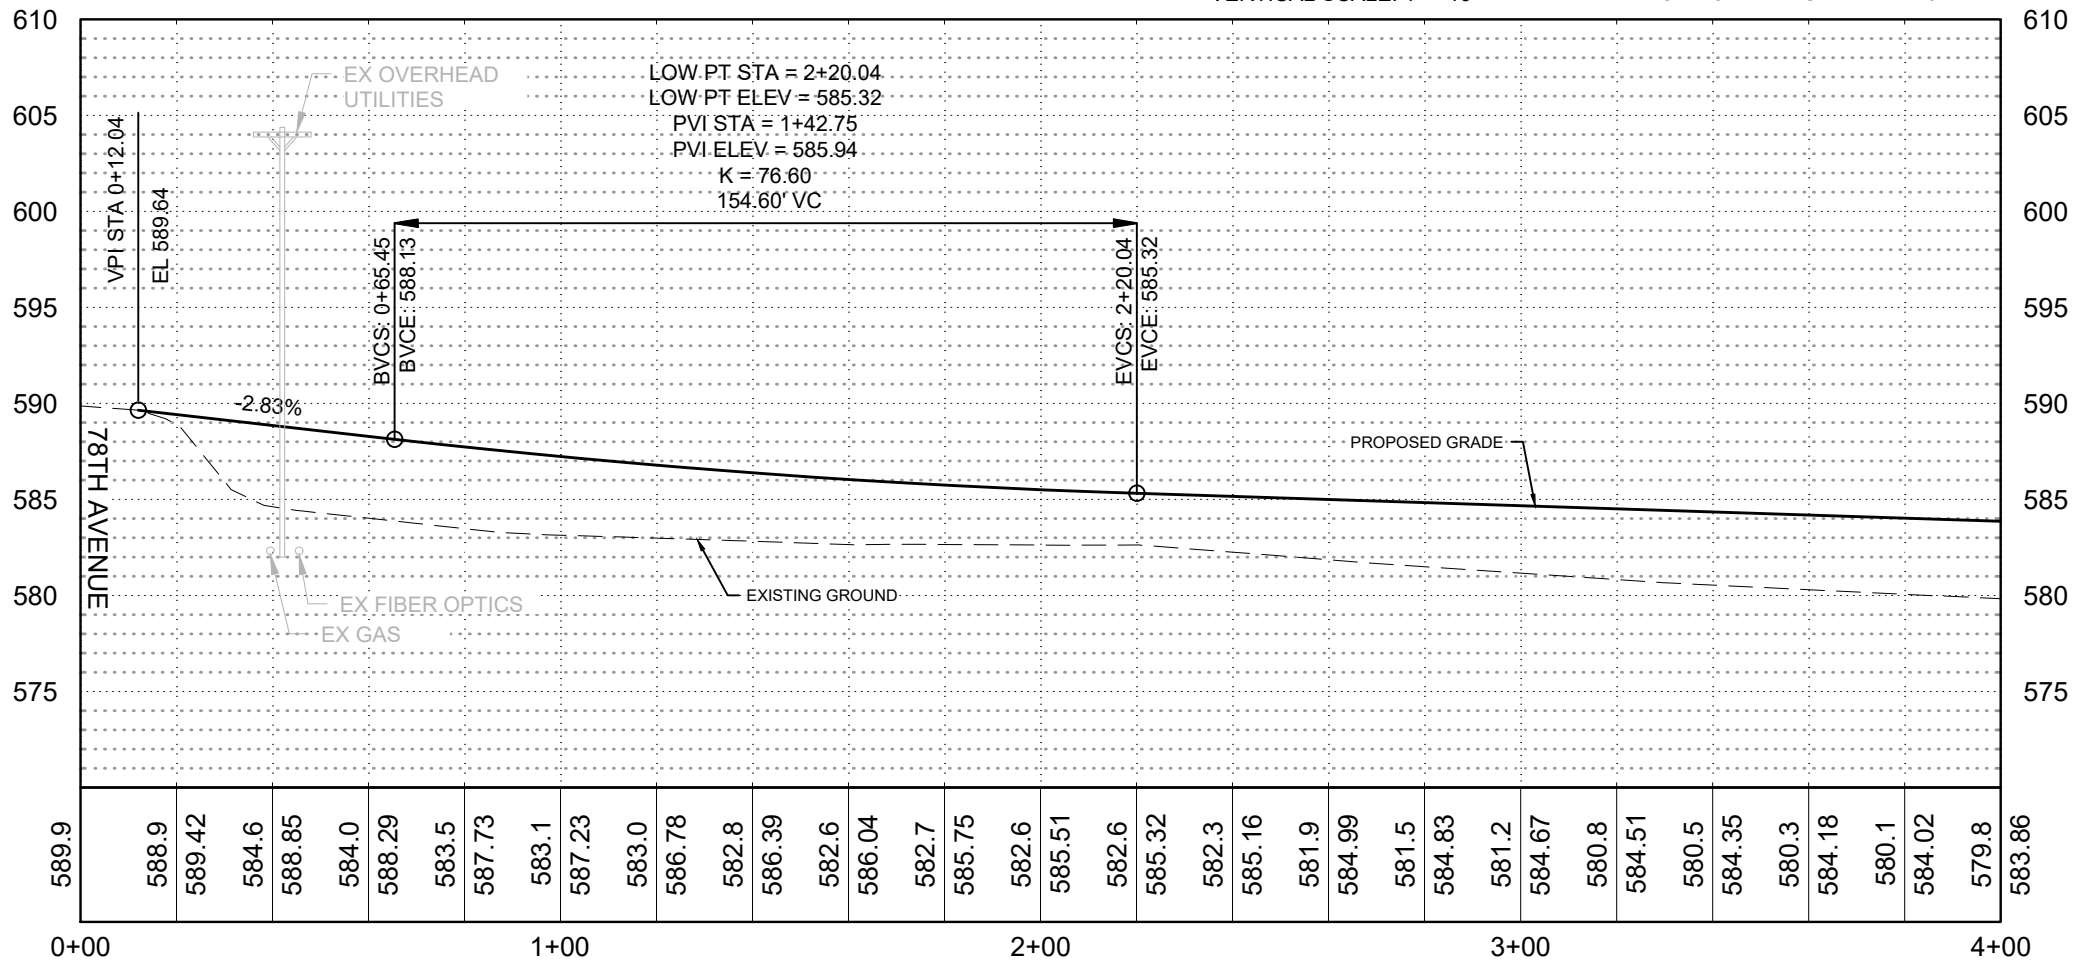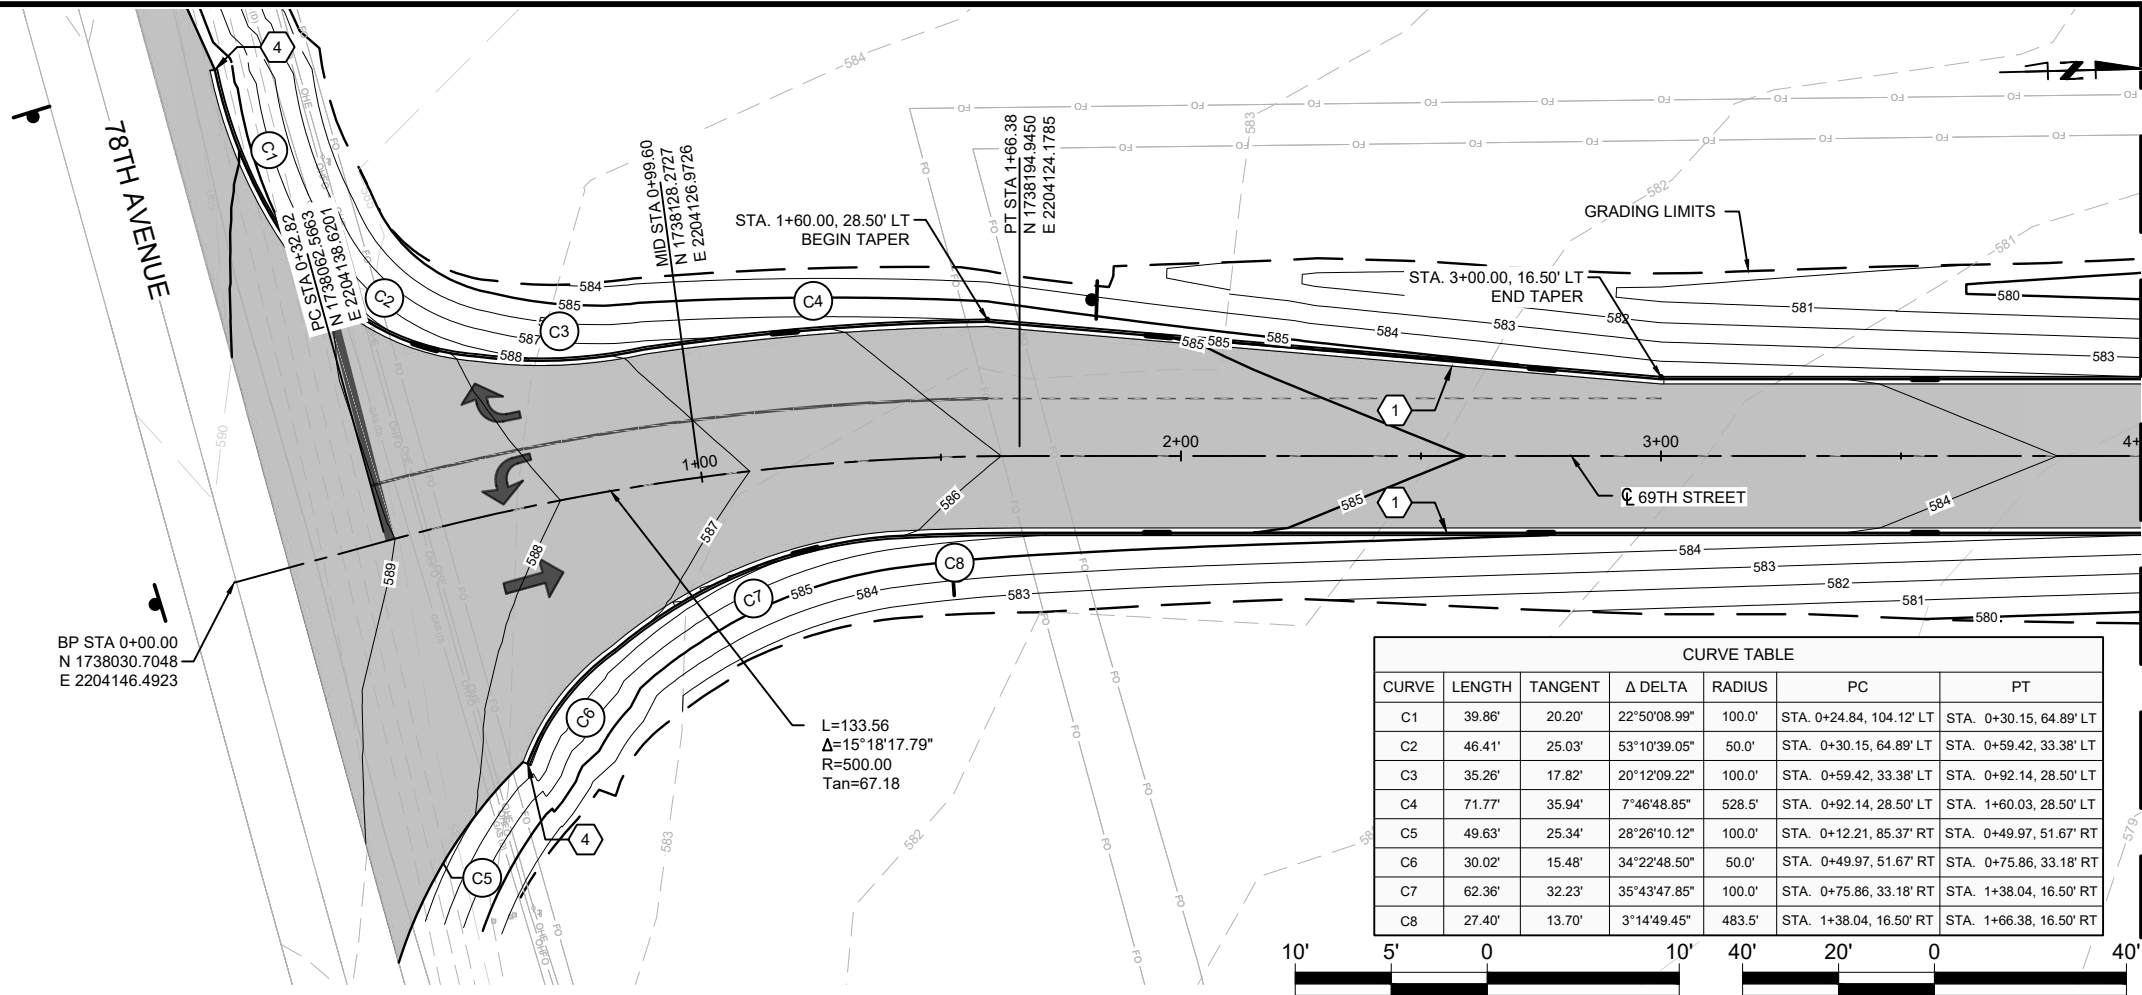

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SEE NEXT SHEET

## GENERAL NOTES

- ALL DIMENSIONS AND RADII ARE TO THE BACK OF CURBS, UNLESS OTHERWISE NOTED.
- SEE STANDARD DETAIL B.L.R. 10-8 FOR PCC PAVEMENT AND JOINTS DETAIL.

## KEYED NOTES

- INTEGRAL CURB & GUTTER. INTEGRAL CURB & GUTTER TO BE INCIDENTAL TO PAVEMENT PER ITEM 501.
- PROPOSED PAVEMENT LIMITS. SAWCUT EXISTING WITH NEAT VERTICAL LINE AND MATCH EXISTING ELEVATION.
- TRANSITION TO EXISTING CURB AND GUTTER.
- NO EXISTING CURB AND GUTTER. TRANSITION TO EXISTING GROUND.
- B6.12 CURB & GUTTER.

## LEGEND

- PROPOSED PCC PAVEMENT
- PROPOSED HMA PAVEMENT
- DIRECTION OF TRAFFIC
- GRADING LIMITS



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COUNTY (QUAD CITIES INTERNATIONAL AIRPORT)  
REALIGN THE GENERAL AVIATION  
ENTRANCE ROAD

## PROPOSED PLAN & PROFILE (1 of 4)

CLIENT APPROVAL	CLIENT APPROVAL	PROJECT NO.
		MLI-5023
		HDR PROJECT NO.
		10404260
		SHEET NO.
		11 of 61

CONSULTANTS


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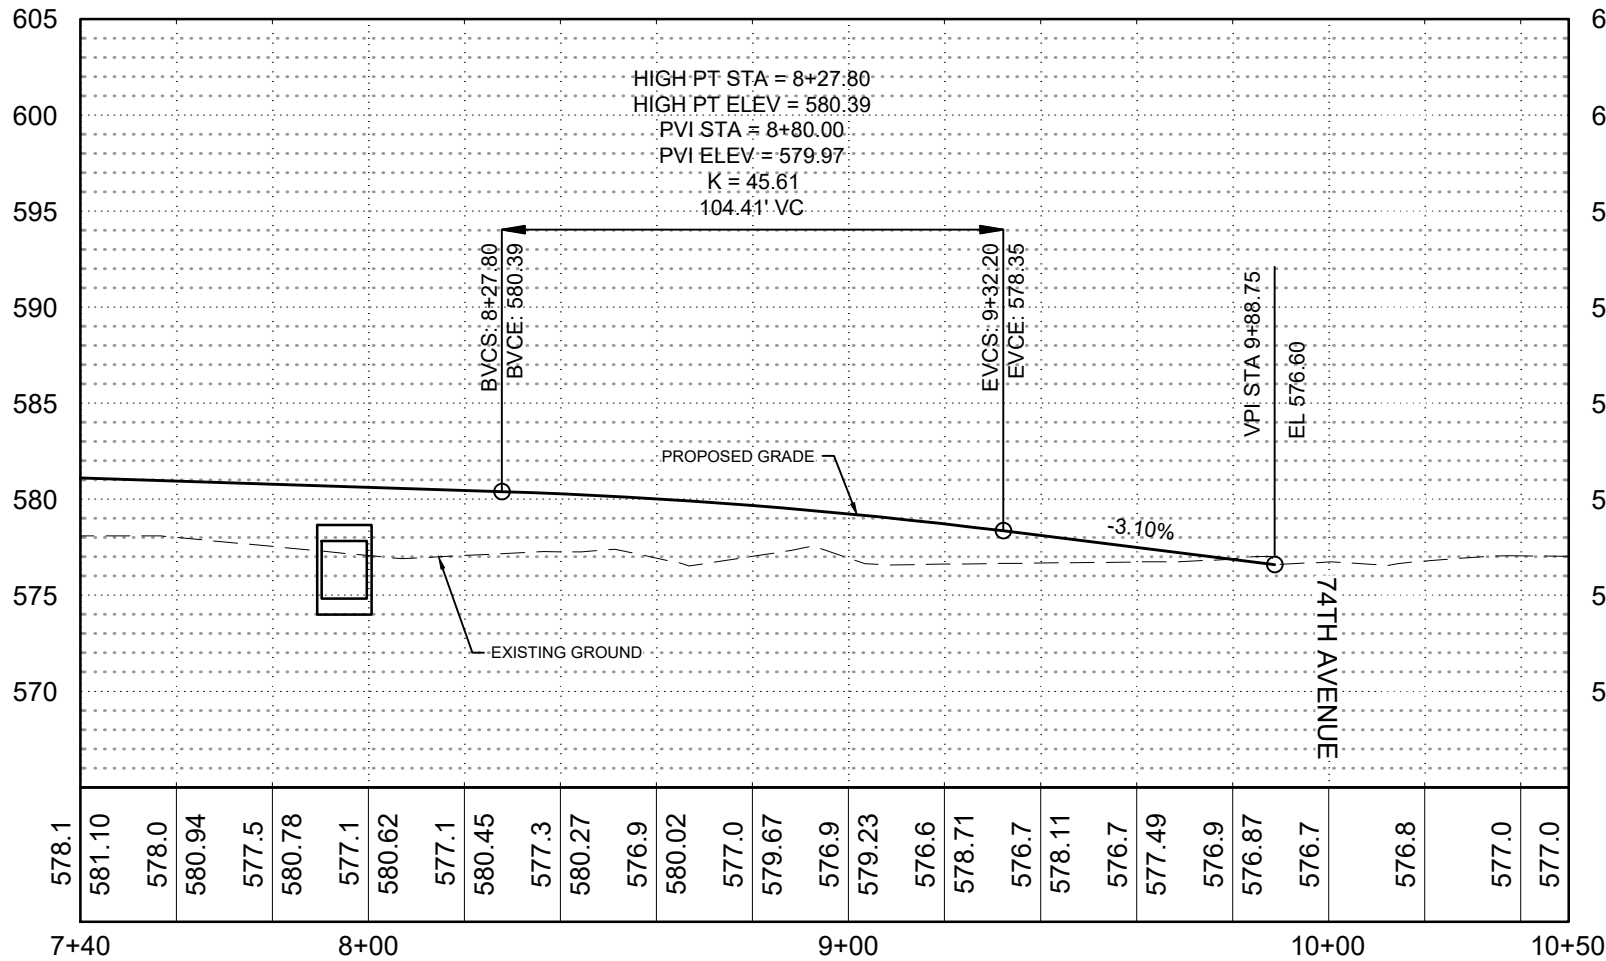
**FCR**  
4620 E 53RD STREET  
DAVENPORT, IA 52807-3620  
(563) 293-7684



SEE PREVIOUS SHEET  
MATCHLINE STA 07+40



CURVE TABLE						
CURVE	LENGTH	TANGENT	Δ DELTA	RADIUS	PC	PT
C9	125.66'	80.00'	90°00'00.00"	80.0'	STA. 7+28.27, 16.50' LT	STA. 8+08.27, 96.50' LT
C10	109.96'	70.00'	90°00'00.00"	70.0'	STA. 8+33.27, 86.50' LT	STA. 9+03.27, 16.50' LT
C11	42.62'	21.64'	24°24'54.62"	100.0'	STA. 9+08.13, 16.50' LT	STA. 9+49.53, 25.11' LT
C12	42.65'	22.72'	48°52'42.32"	50.0'	STA. 9+49.53, 25.11' LT	STA. 9+79.23, 53.92' LT
C13	44.02'	22.37'	25°13'11.51"	100.0'	STA. 9+79.23, 53.92' LT	STA. 9+88.20, 96.65' LT
C14	42.62'	21.64'	24°24'54.62"	100.0'	STA. 9+08.13, 16.50' RT	STA. 9+49.53, 25.11' RT
C15	42.65'	22.72'	48°52'42.32"	50.0'	STA. 9+49.53, 25.11' RT	STA. 9+79.23, 53.92' RT
C16	43.74'	22.22'	25°03'25.78"	100.0'	STA. 9+79.23, 53.92' RT	STA. 9+88.13, 96.39' RT

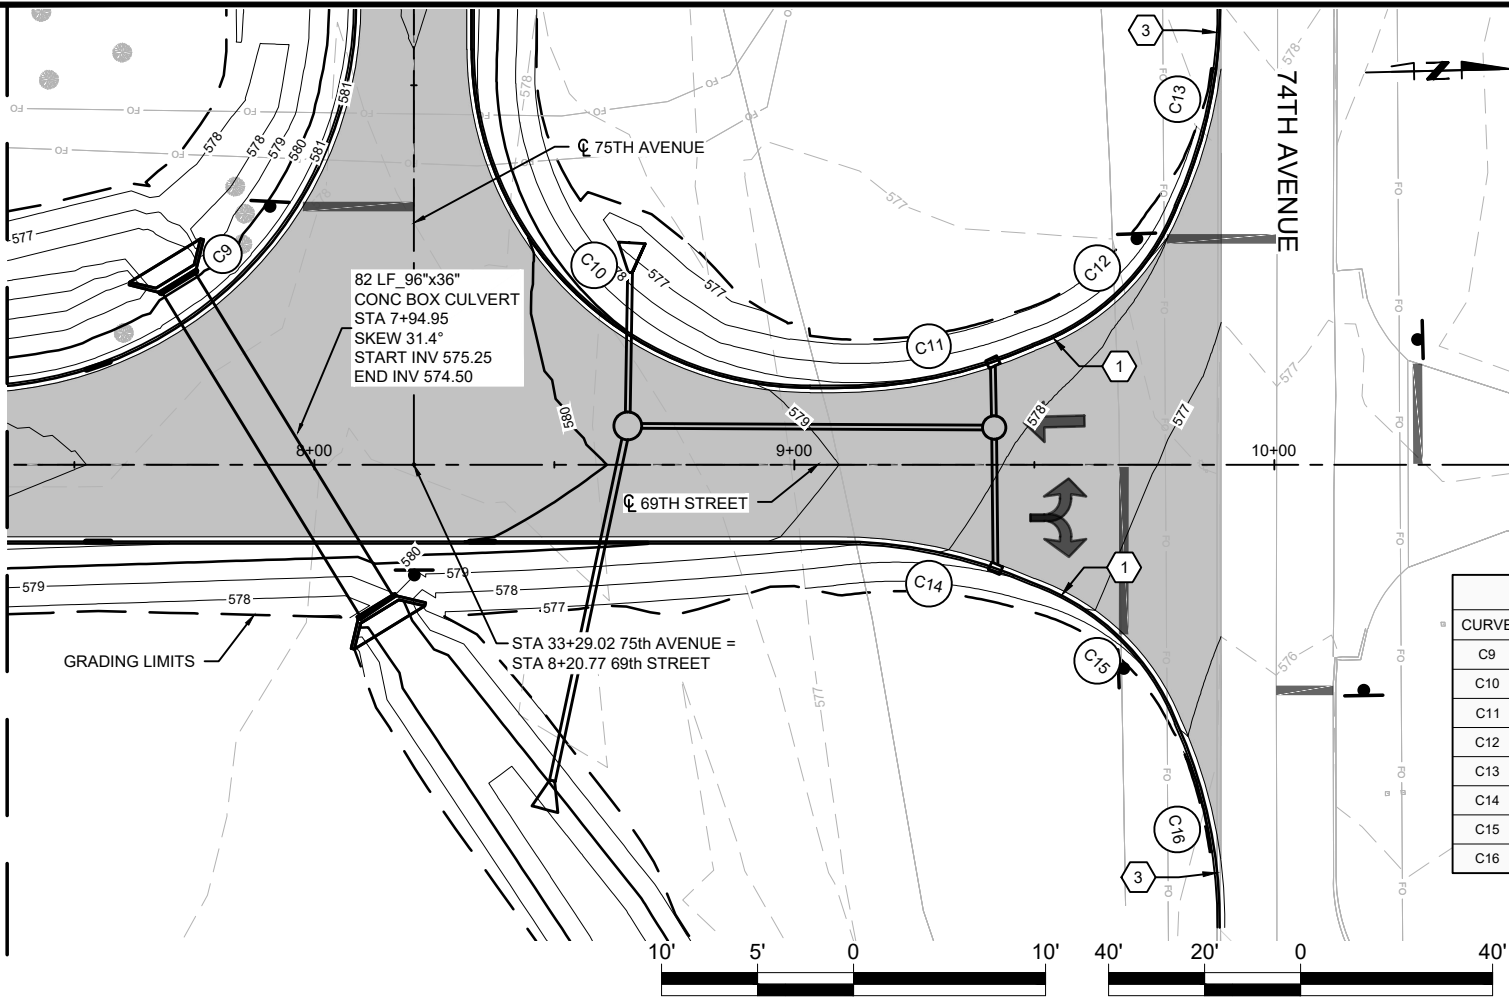

### GENERAL NOTES

- ALL DIMENSIONS AND RADII ARE TO THE BACK OF CURBS, UNLESS OTHERWISE NOTED.
- SEE STANDARD DETAIL B.L.R. 10-8 FOR PCC PAVEMENT AND JOINTS DETAIL.

### KEYED NOTES

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- PROPOSED PAVEMENT LIMITS. SAWCUT EXISTING WITH NEAT VERTICAL LINE AND MATCH EXISTING ELEVATION.
- TRANSITION TO EXISTING CURB AND GUTTER.
- NO EXISTING CURB AND GUTTER. TRANSITION TO EXISTING GROUND.
- B6.12 CURB & GUTTER.

### LEGEND

- PROPOSED PCC PAVEMENT
- PROPOSED HMA PAVEMENT
- DIRECTION OF TRAFFIC
- GRADING LIMITS



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COUNTY (QUAD CITIES INTERNATIONAL AIRPORT)  
REALIGN THE GENERAL AVIATION  
ENTRANCE ROAD

### PROPOSED PLAN & PROFILE (3 of 4)

CLIENT APPROVAL	CLIENT APPROVAL	PROJECT NO.
		MLI-5023
		HDR PROJECT NO.
		10404260
		SHEET NO.
		13 of 61

CONSULTANTS

PREPARED FOR

QUAD CITIES  
INTERNATIONAL AIRPORT




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NO.	DATE	DESCRIPTION	BY
		AS-BUILT INFORMATION	
		WORK STAKED BY:	
		INSPECTOR'S ACCEPTANCE BY:	
		FIELD VERIFICATION BY:	
		DRAWINGS CORRECTED BY:	


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DRAWN BY: AJ
CHECKED BY: SM
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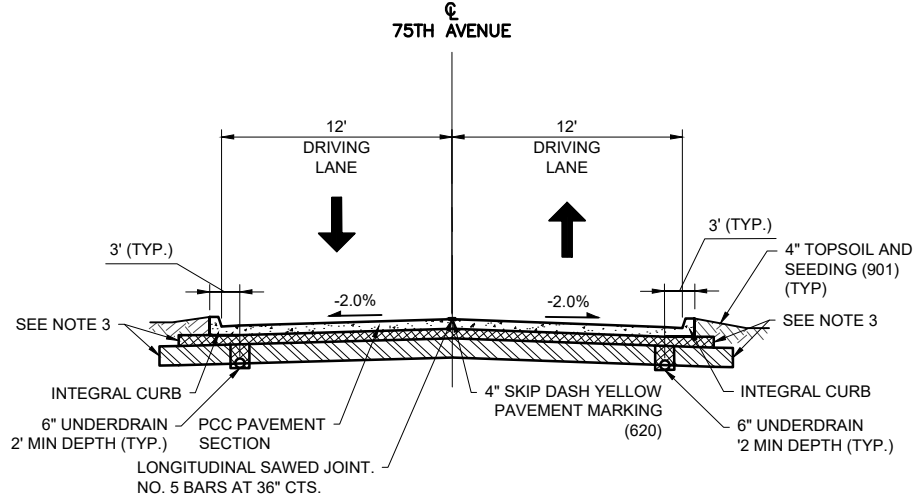


CLIENT APPROVAL	CLIENT APPROVAL	PROJECT NO. MLI-5023
		HDR PROJECT NO. 10404260
		SHEET NO. <b>15 of 61</b>


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Drawing Name: 04-TYPICAL SECTIONS.dwg

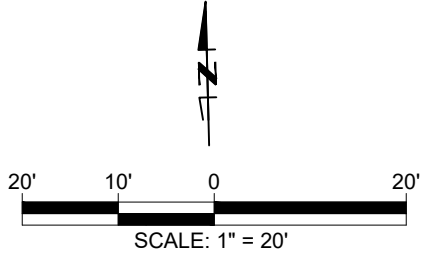


PROPOSED TYPICAL SECTION - 69TH STREET  
STA 3+00.00 TO 7+28.27 & STA 30+00 TO 32+32.52

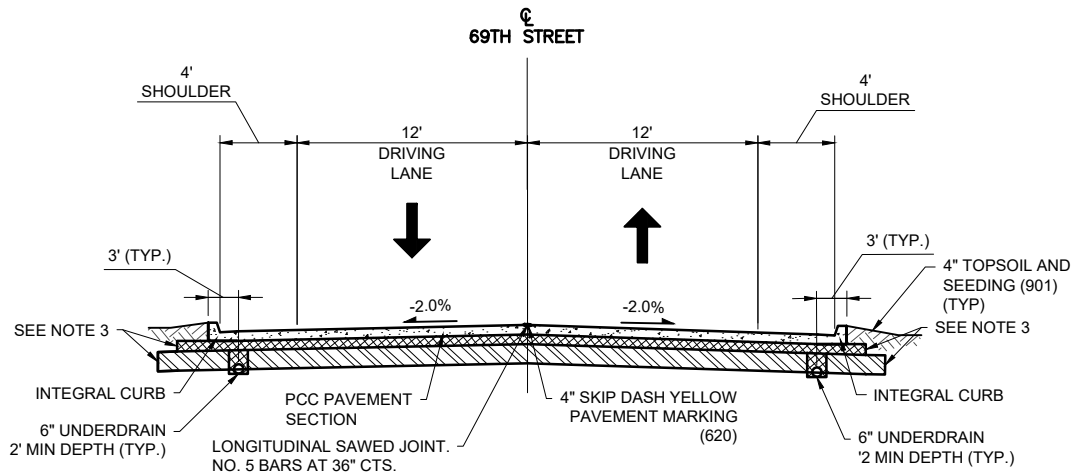


PROPOSED TYPICAL SECTION - 75TH AVENUE  
STA 30+00 TO 32+32.52

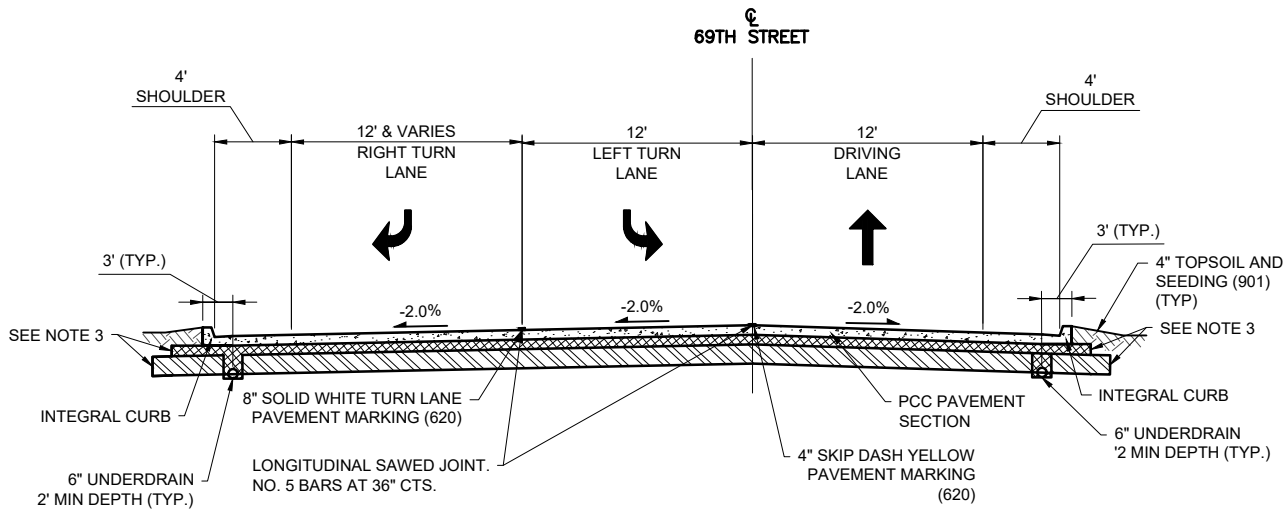


PROPOSED TYPICAL SECTION - 69TH STREET & 78TH AVENUE INTERSECTION  
STA 0+92.19 TO 3+00.00

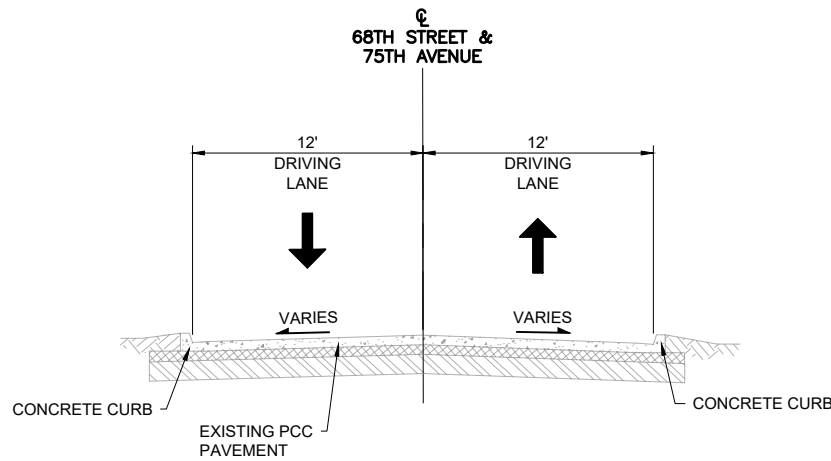


EXISTING TYPICAL SECTION - 68TH STREET & 75TH AVENUE

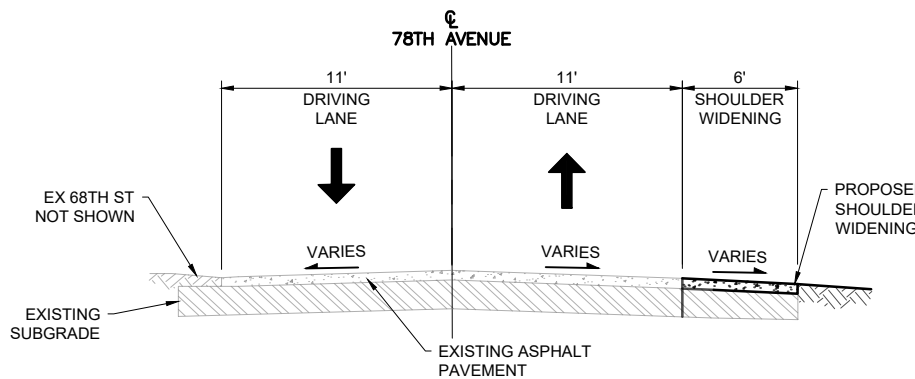


PROP TYPICAL SECTION ADD. ALT. 1 - 78TH AVENUE

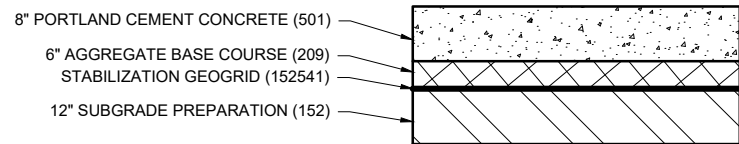

PCC PAVEMENT SECTION  
NOT TO SCALE

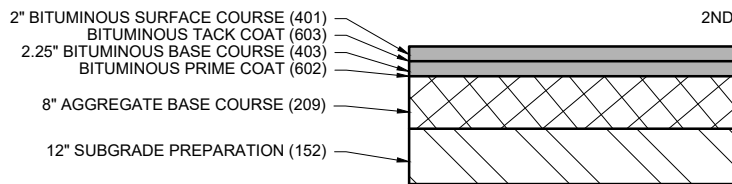

BITUMINOUS PAVEMENT SECTION  
PROPOSED PARKING ENTRANCE  
NOT TO SCALE

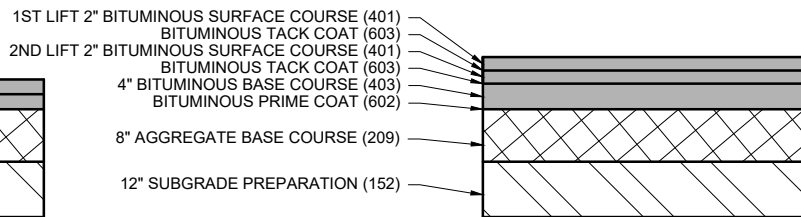

ADD. ALT. 1 - PROPOSED SHOULDER  
WIDENING - 78TH AVENUE  
NOT TO SCALE


#### NOTES:

- INTERSECTIONS BETWEEN 69TH ST AND 78TH, 75TH, AND 74TH ARE NOT REFLECTED IN THE TYPICAL SECTIONS.
- THE EXISTING PAVEMENT SECTION ON 68TH ST. IS 8" OF PCC OVER AGGREGATE BASE COURSE. BASE COURSE TO EXTEND 12" BEYOND THE BACK OF CURB. SUBGRADE TO EXTEND 12" BEYOND BASE COURSE. APPLIES TO ALL PROPOSED PCC PAVEMENT SECTIONS.
- SEE DRAINAGE DETAILS FOR UNDERDRAIN INFO.
- 6" BARRIER INTEGRAL CURB IS INCLUDED IN THE PCC PAVEMENT ITEM

#### ROADWAY STRUCTURAL TRAFFIC DESIGN INFORMATION

	MINIMUM ADT	ACTUAL ADT	ACTUAL % OF TOTAL ADT	% OF ADT IN DESIGN LANE
PV =	NO MIN	484	88%	P = 50%
SU =	NO MIN	39	7%	S = 50%
MU =	NO MIN	28	5%	M = 50%
STRUCTURAL DESIGN ADT =		550		

YEAR: 2035  
ROAD CLASS: III  
SUBGRADE SUPPORT RATING (SSR):  
POOR  
TRAFFIC FACTOR: 0.75  
ACTUAL TF: 0.75  
MIN TF: 0.5

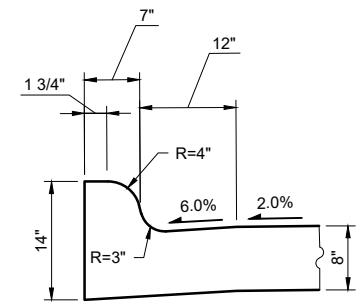

PCC INTEGRAL CURB  
NOT TO SCALE



METROPOLITAN AIRPORT AUTHORITY OF ROCK ISLAND  
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#### TYPICAL SECTIONS

CLIENT APPROVAL	CLIENT APPROVAL	PROJECT NO.
		MLI-5023
		HDR PROJECT NO.
		10404260
		SHEET NO.
		16 of 61

CONSULTANTS




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NO.	DATE	DESCRIPTION	BY
		AS-BUILT INFORMATION	
		WORK STAKED BY:	
		INSPECTOR'S ACCEPTANCE BY:	
		FIELD VERIFICATION BY:	
		DRAWINGS CORRECTED BY:	

DESIGNED BY: MM
DRAWN BY: AJ
CHECKED BY: SM
DATE:

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Date: 16 Feb 2025 - 9:42pm User: STOLJENSEN Layout: PM01-01  
Drawing Name: 12-PAVEMENT MARKING AND SIGNAGE.dwg



MATCHLINE STA 04+00  
SEE THIS SHEET

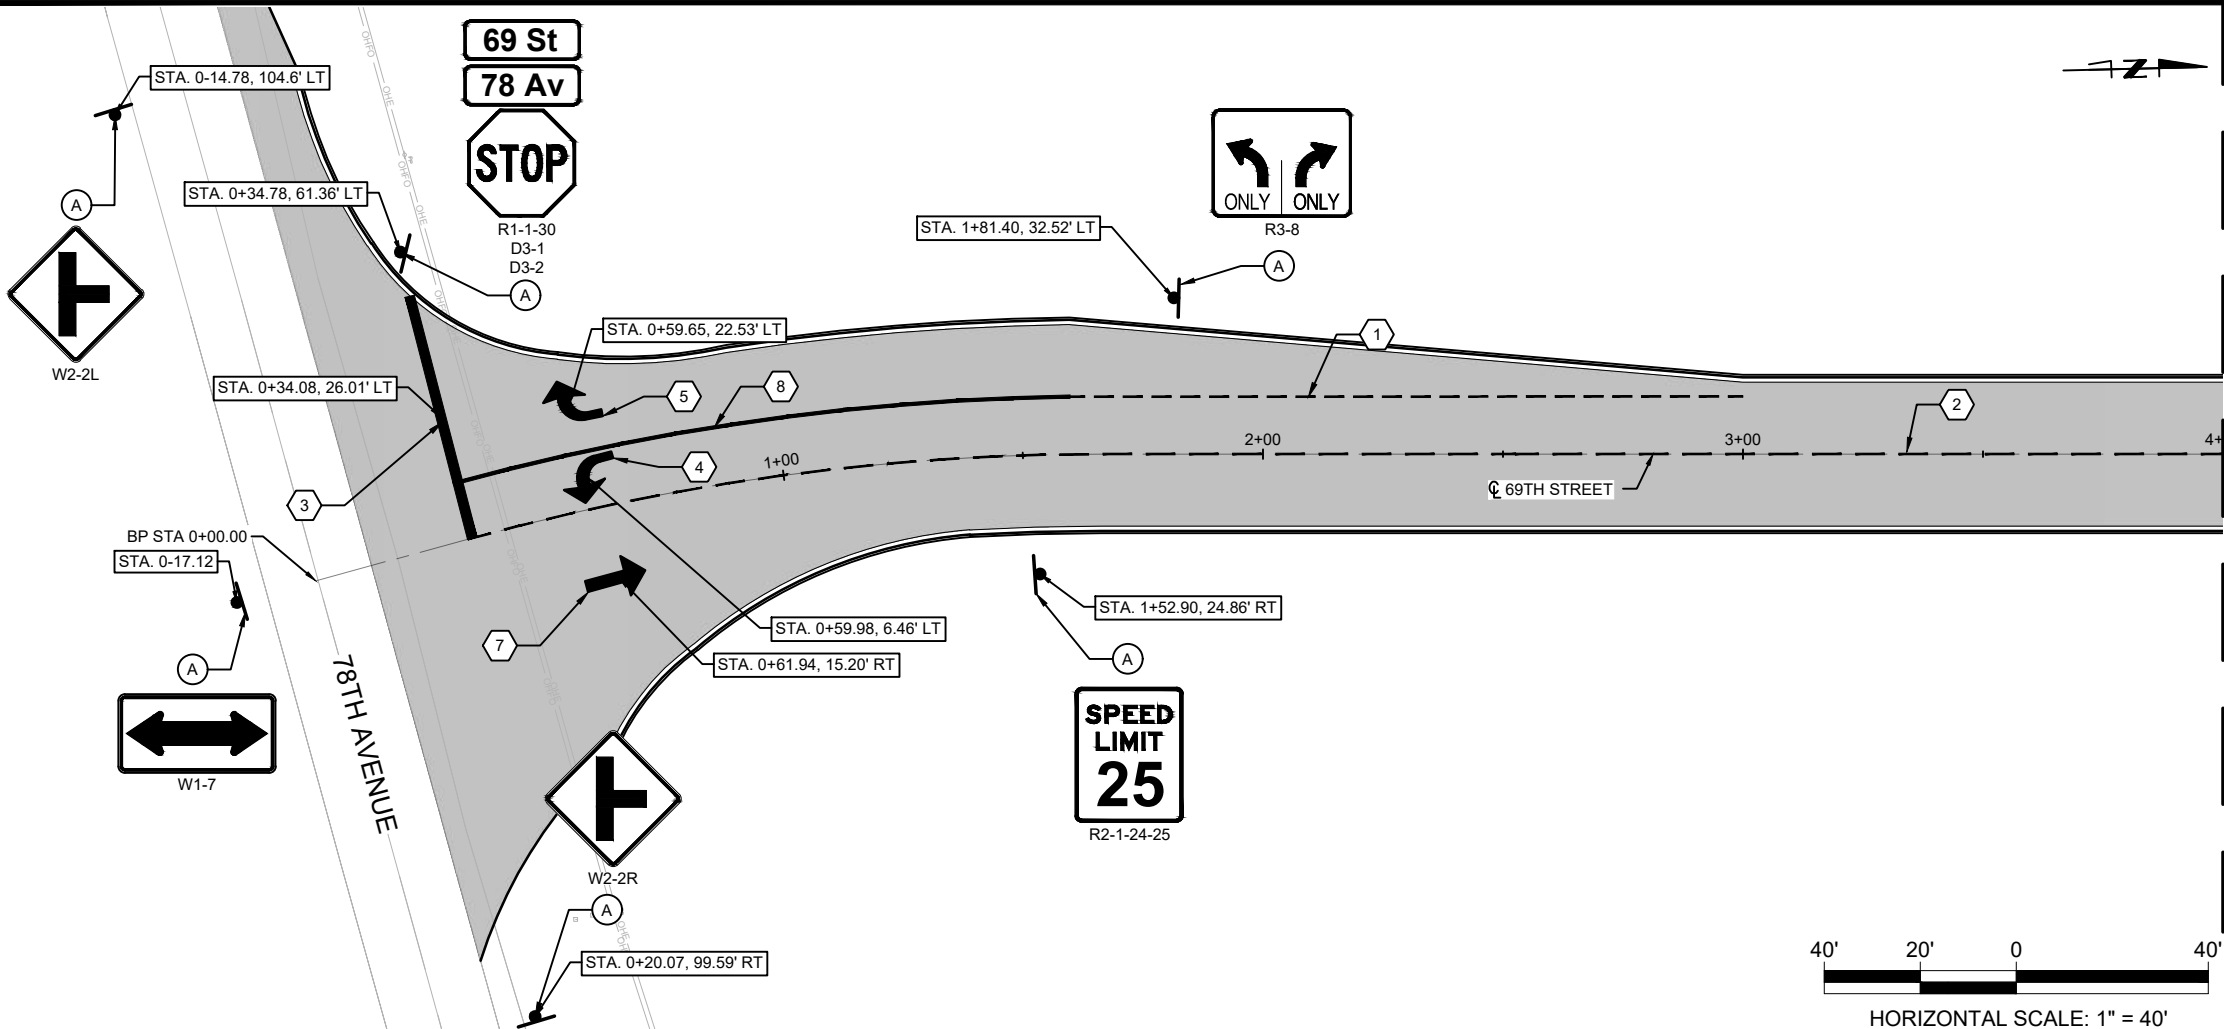**GENERAL NOTES**

1. WATERBORNE TYPE III PAINT TO BE USED ON ALL PROPOSED PAVEMENT MARKINGS IN ACCORDANCE WITH ITEM 620 "PAVEMENT MARKING" IN THE ILLINOIS STANDARD SPECIFICATIONS FOR CONSTRUCTION OF AIRPORTS, CURRENT EDITION.

- KEYED NOTES**
1. 8" WHITE 2' DASH 4' SKIP PAVEMENT MARKING.
  2. 4" SKIP DASH YELLOW PAVEMENT MARKING.
  3. 24" SOLID WHITE STOP BAR.
  4. LEFT TURN ARROW PAVEMENT MARKING.
  5. RIGHT TURN ARROW PAVEMENT MARKING.
  6. LEFT/RIGHT TURN ARROW PAVEMENT MARKING.
  7. THRU LANE ARROW PAVEMENT MARKING.
  8. 8" WHITE SOLID TURN LANE PAVEMENT MARKING.

**SIGN KEYED NOTES**

A. PROPOSED SIGN.  
B. EXISTING SIGN TO BE REMOVED.

**LEGEND**

	EXISTING SIGN POST
	PROPOSED SIGN POST



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BEFORE YOU DIG

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**PAVEMENT MARKING & SIGNING PLAN  
(1 OF 2)**

CLIENT APPROVAL	CLIENT APPROVAL	PROJECT NO. MLI-5023
		HDR PROJECT NO. 10404260
		SHEET NO. 17 of 61

CONSULTANTS




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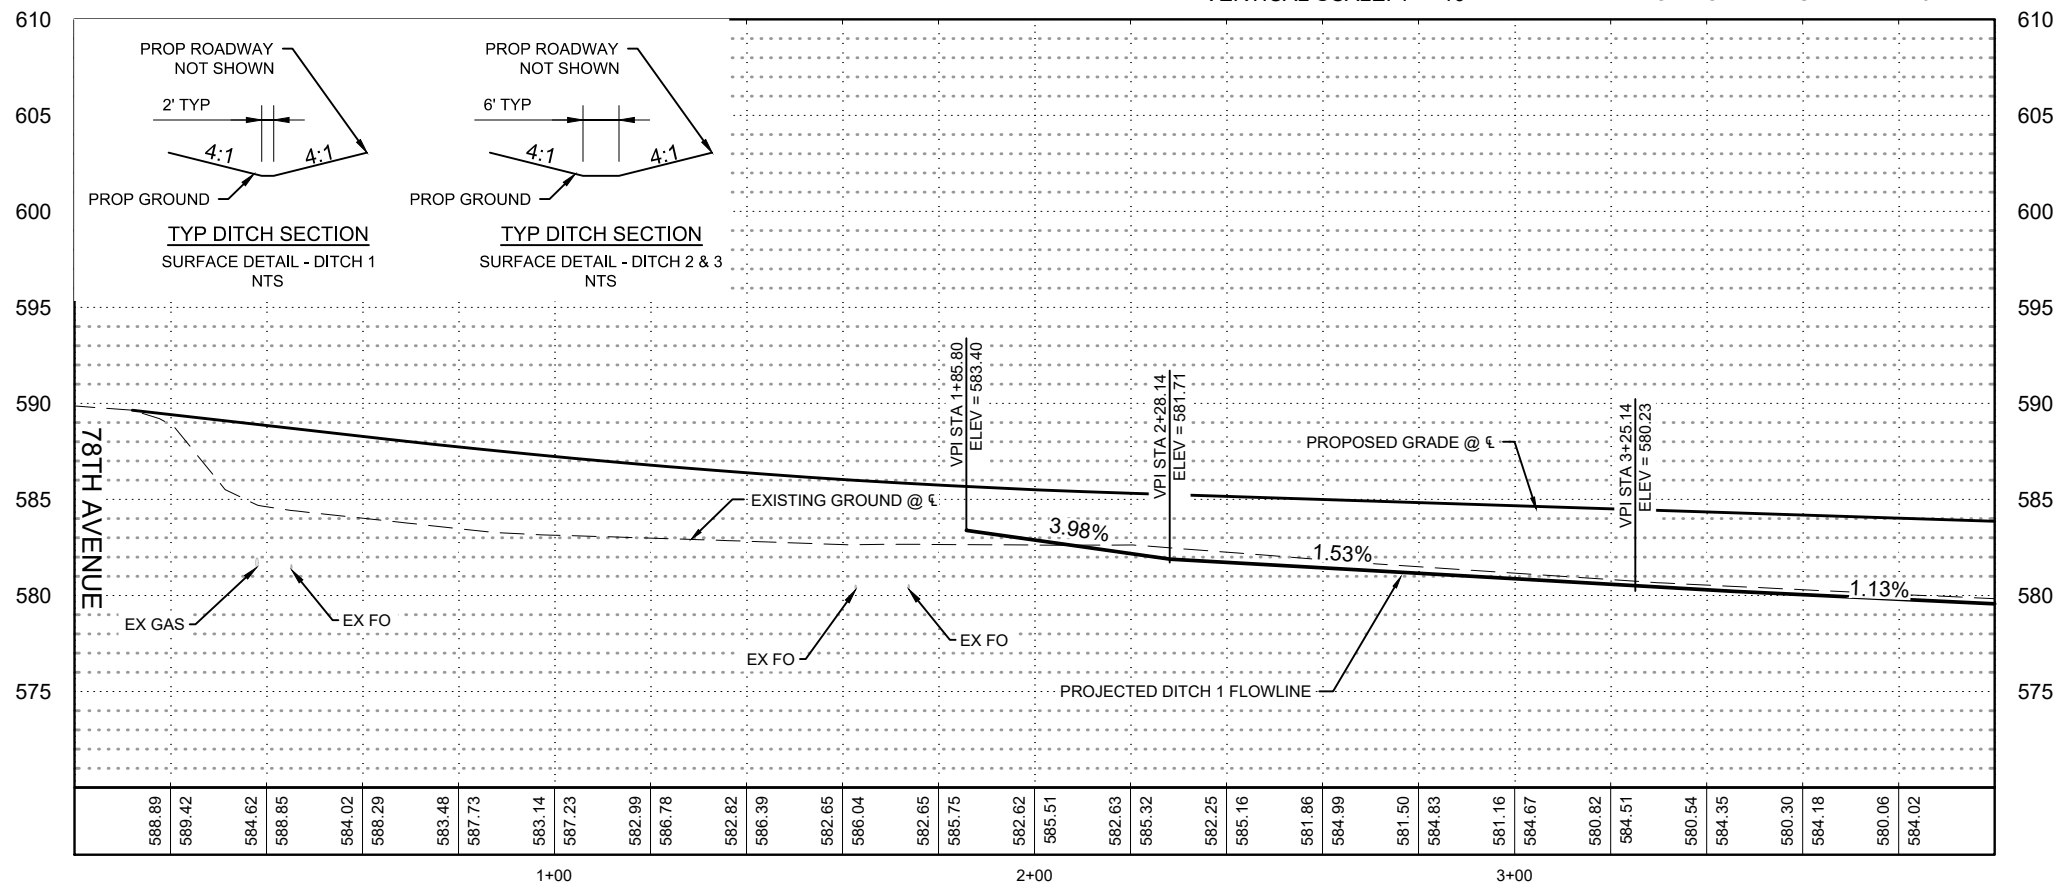
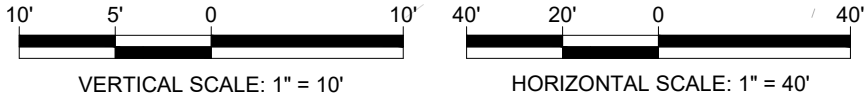
PREPARED FOR



DESIGNED BY: MM
DRAWN BY: AJ
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DATE:

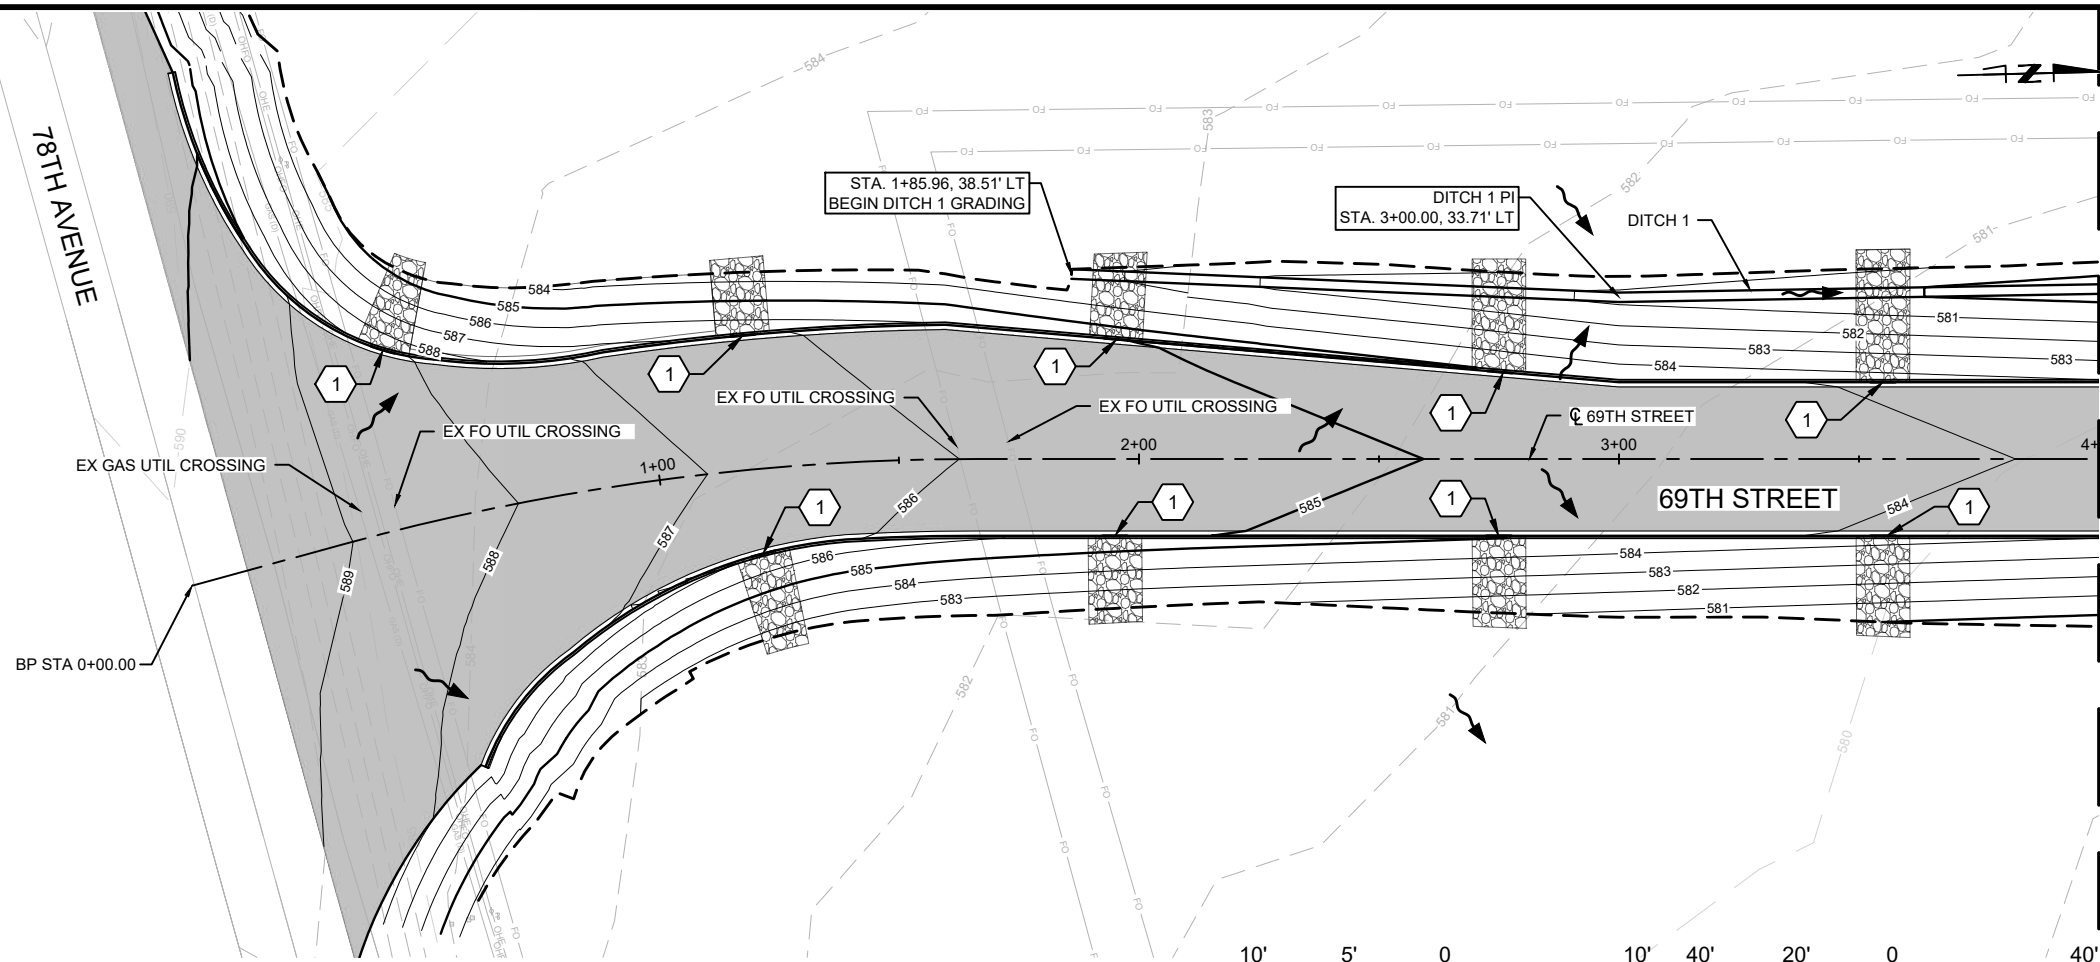

MATCHLINE STA 04+00  
SEE NEXT SHEET



#### GENERAL NOTES

- ALL DRAINAGE PIPE AND STRUCTURE STATIONS AND OFFSETS ARE BASED OFF PROPOSED CENTERLINES.
- ALL UNDERGROUND UTILITIES SHOWN IN PLANS AND PROFILES ARE APPROXIMATE LOCATIONS BASED ON AVAILABLE INFORMATION.
- REFER TO EXISTING CONDITIONS AND PROPOSED REMOVAL PLAN FOR EXISTING STORM DRAIN REMOVALS.
- SEE SWPPP SHEETS FOR FLEXAMAT DETAILS & OTHER EROSION CONTROL MEASURES.
- SEE STRUCTURAL SHEETS REGARDING 8'x3' BOX CULVERT (C-1).
- CATCH BASIN RIM ELEVATIONS ARE TO GUTTER FLOW LINE.
- SEE DETAILS SHEETS FOR CURB CUT INFORMATION.
- UNDERDRAINS NOT SHOWN HERE. SEE DRAINAGE UNDERDRAIN PLAN SHEETS.
- ALL MANHOLES (MH-1, MH-2, & MH-3) TO HAVE CLOSED LID PER IDOT STANDARD DETAIL FRAME & LID TYPE 1 6004001-05.
- ALL INLETS (CB-1 & CB-2) TO BE INLET TYPE A WITH FRAME & GRATE TYPE 3 PER STANDARD DETAILS 602301-04 & 604006-05.

#### LEGEND

- |  |                   |
|--|-------------------|
|  | INLET             |
|  | MANHOLE           |
|  | STORM DRAIN       |
|  | FLEXAMAT          |
|  | GRADING LIMITS    |
|  | DITCH GRADE BREAK |
|  | CURB CUT          |
|  | PROP CONTOUR      |
|  | EXIST CONTOUR     |
|  | FLOW ARROW        |

#### KEYED NOTES

- PROPOSED CURB CUT



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#### DRAINAGE PLAN (1 OF 4)

CLIENT APPROVAL	CLIENT APPROVAL	PROJECT NO. MLI-5023
		HDR PROJECT NO. 10404260
		SHEET NO. 19 of 61

CONSULTANTS

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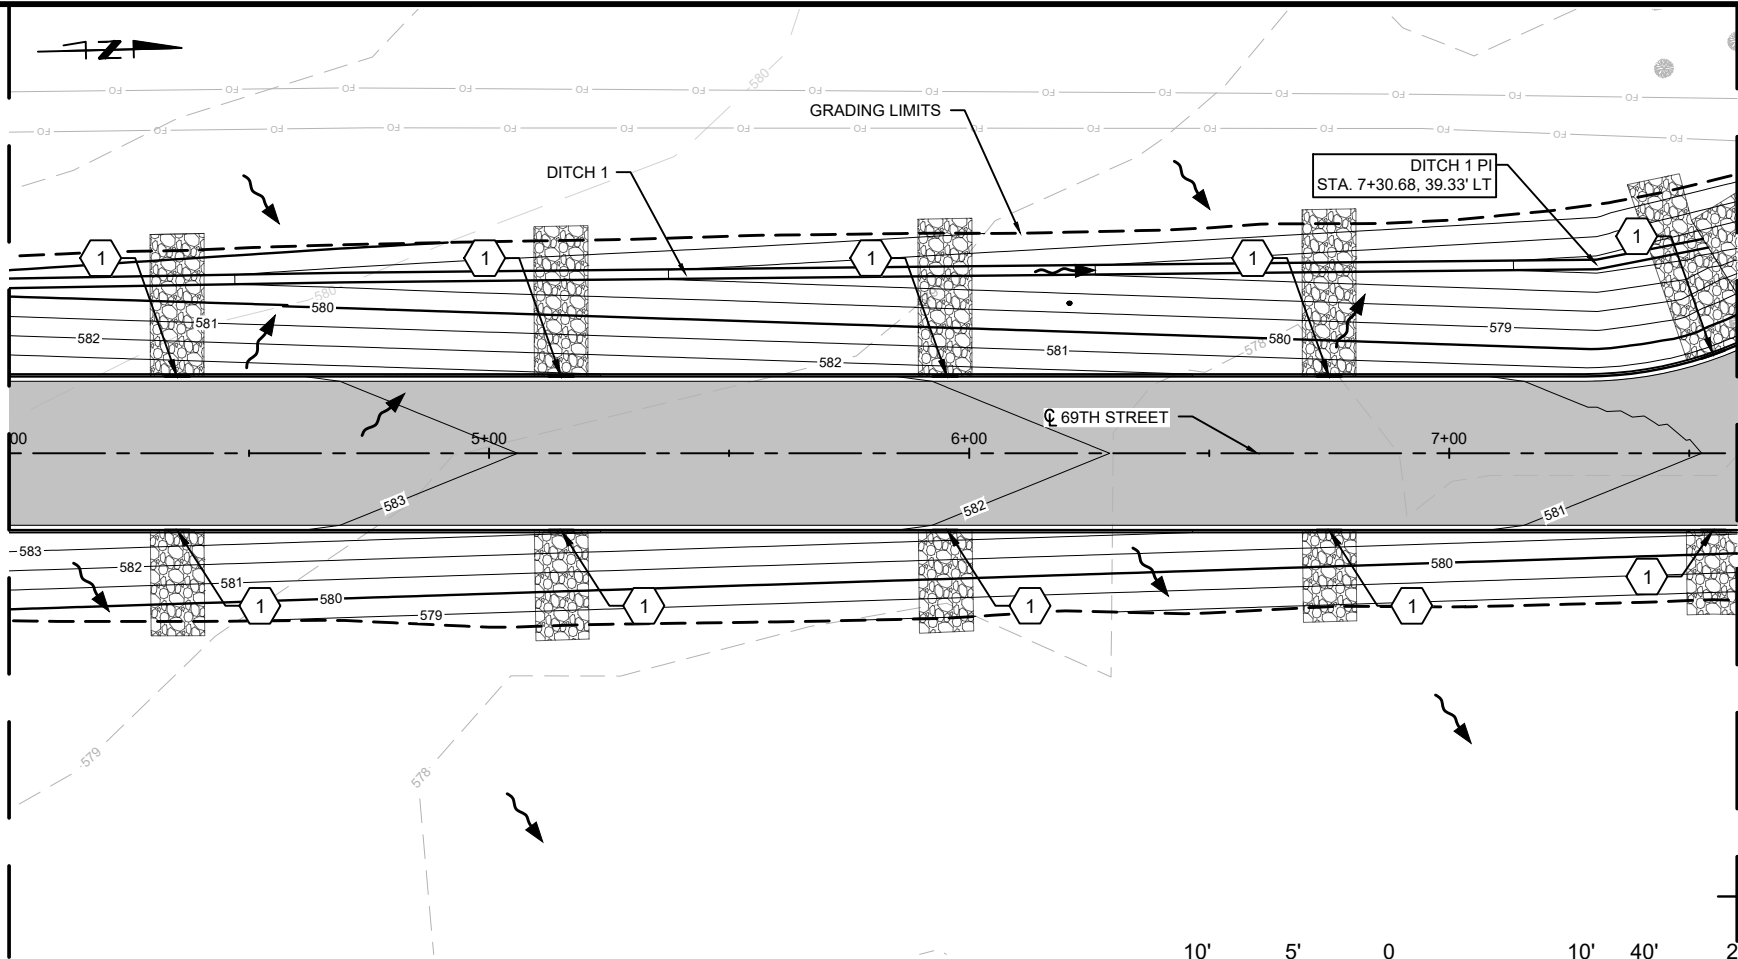
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		CONTRACTOR	
		AS-BUILT INFORMATION	
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		INSPECTOR'S ACCEPTANCE BY:	DATE:
		FIELD VERIFICATION BY:	DATE:
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DESIGNED BY: MM
DRAWN BY: AJ
CHECKED BY: SM
DATE:



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SEE PREVIOUS SHEET  
MATCHLINE STA 04+00



MATCHLINE STA 07+60  
SEE NEXT SHEET



## GENERAL NOTES

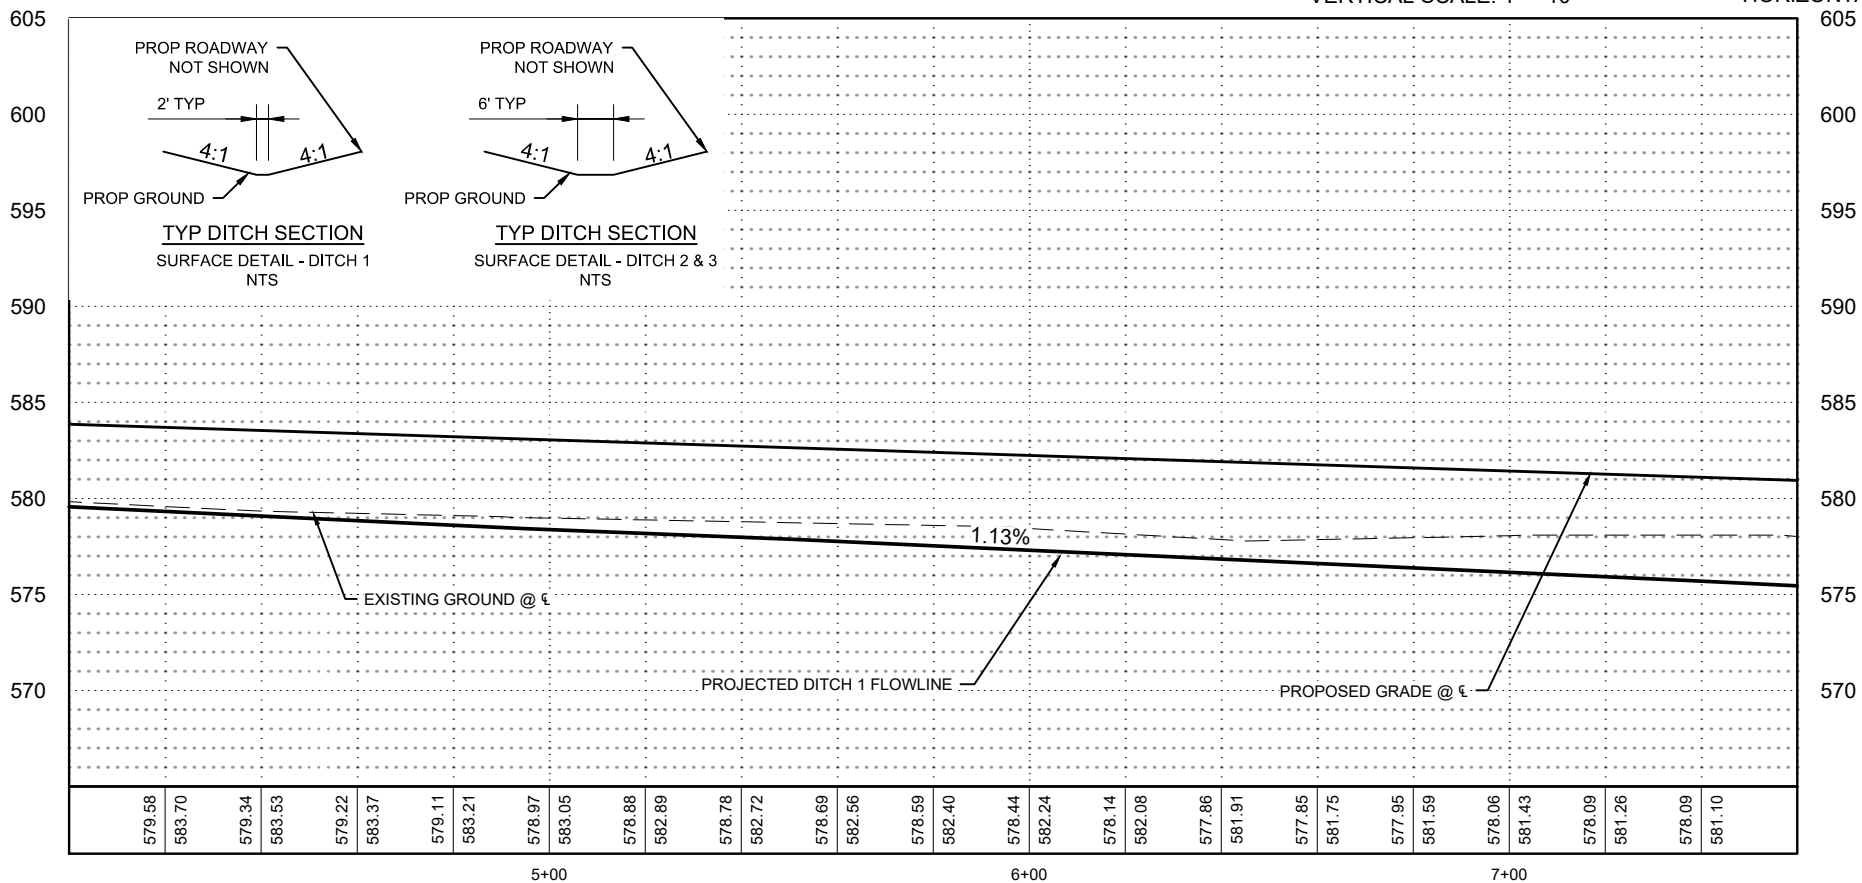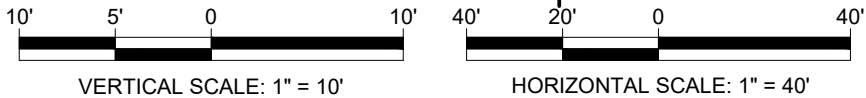- ALL DRAINAGE PIPE AND STRUCTURE STATIONS AND OFFSETS ARE BASED OFF PROPOSED CENTERLINES.
- ALL UNDERGROUND UTILITIES SHOWN IN PLANS AND PROFILES ARE APPROXIMATE LOCATIONS BASED ON AVAILABLE INFORMATION.
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- ALL INLETS (CB-1 & CB-2) TO BE INLET TYPE A WITH FRAME & GRATE TYPE 3 PER STANDARD DETAILS 602301-04 & 604006-05.

## LEGEND

- |  |                   |
|--|-------------------|
|  | INLET             |
|  | MANHOLE           |
|  | STORM DRAIN       |
|  | FLEXAMAT          |
|  | GRADING LIMITS    |
|  | DITCH GRADE BREAK |
|  | CURB CUT          |
|  | PROP CONTOUR      |
|  | EXIST CONTOUR     |
|  | FLOW ARROW        |

## KEYED NOTES

- PROPOSED CURB CUT



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## DRAINAGE PLAN (2 OF 4)

CLIENT APPROVAL	CLIENT APPROVAL	PROJECT NO.
		MLI-5023
		HDR PROJECT NO.
		10404260
		SHEET NO.
		20 of 61

CONSULTANTS

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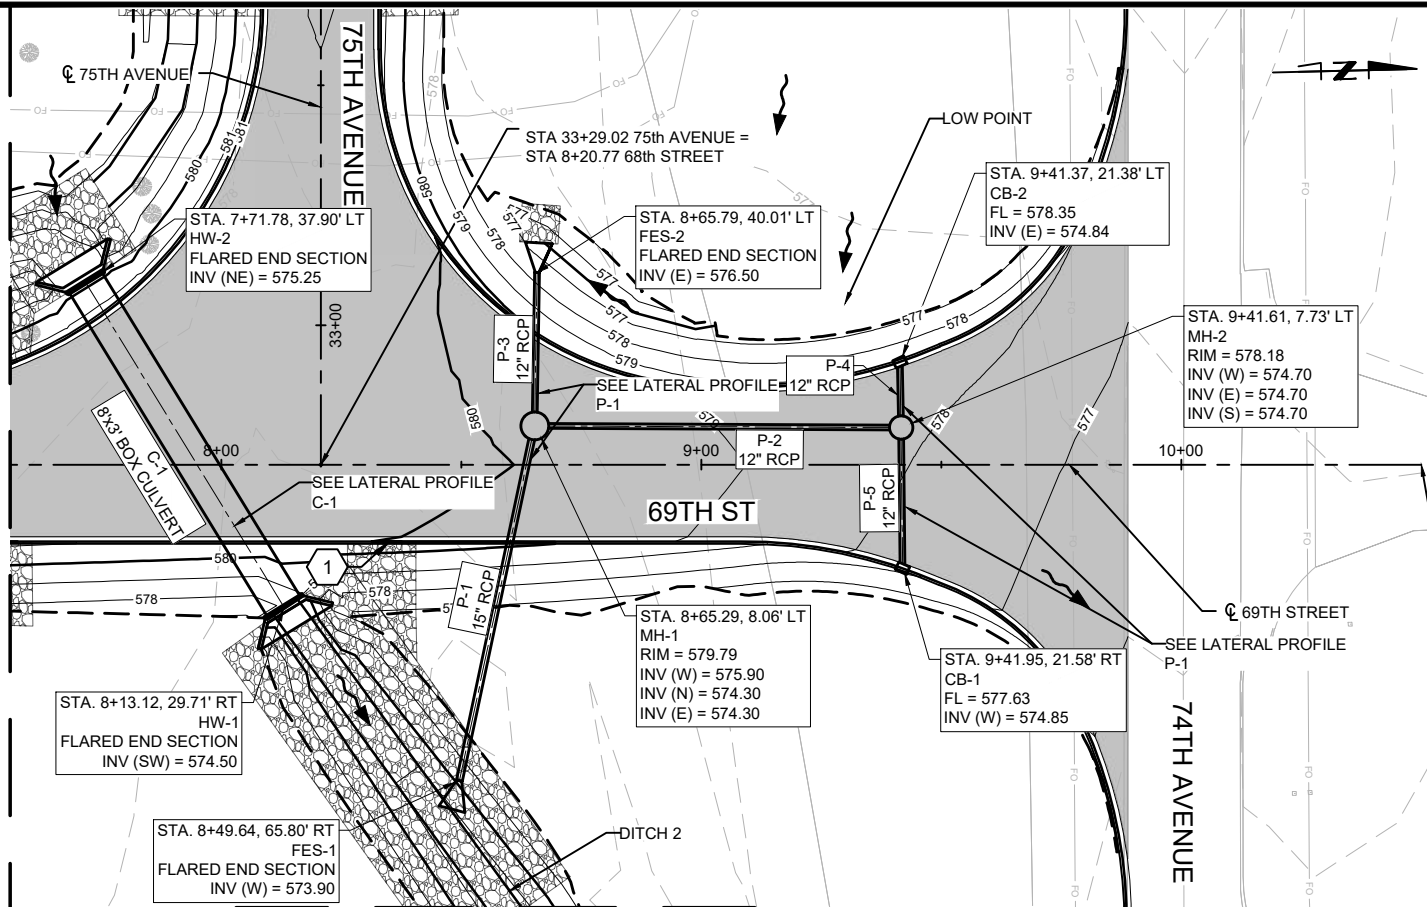
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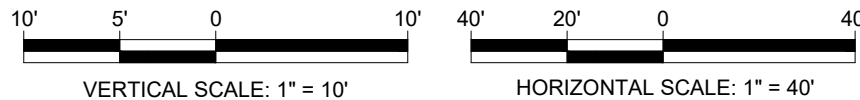
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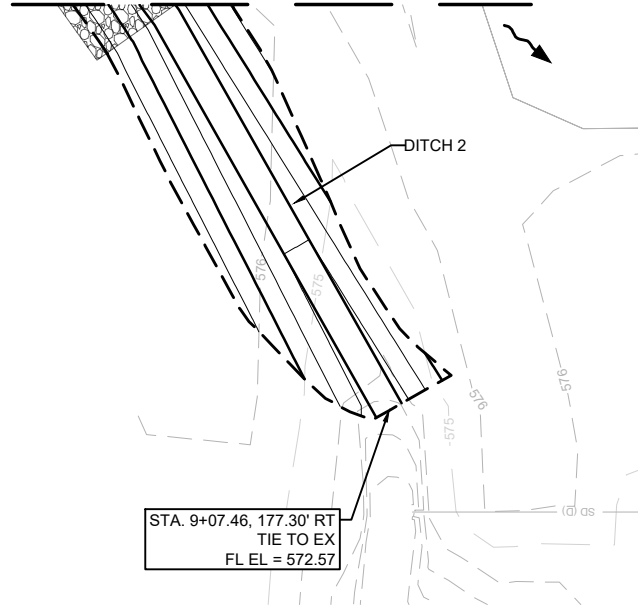
SEE PREVIOUS SHEET  
MATCHLINE STA 07+60



MATCHLINE A  
SEE THIS SHEET



MATCHLINE A  
SEE THIS SHEET



#### GENERAL NOTES

- ALL DRAINAGE PIPE AND STRUCTURE STATIONS AND OFFSETS ARE BASED OFF PROPOSED CENTERLINES.
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- REFER TO EXISTING CONDITIONS AND PROPOSED REMOVAL PLAN FOR EXISTING STORM DRAIN REMOVALS.
- SEE SWPPP SHEETS FOR FLEXAMAT DETAILS & OTHER EROSION CONTROL MEASURES.
- SEE STRUCTURAL SHEETS REGARDING 8'x3' BOX CULVERT (C-1).
- CATCH BASIN RIM ELEVATIONS ARE TO GUTTER FLOW LINE.
- SEE DETAILS SHEETS FOR CURB CUT INFORMATION.
- UNDERDRAINS NOT SHOWN HERE. SEE DRAINAGE UNDERDRAIN PLAN SHEETS.
- ALL MANHOLES (MH-1, MH-2, & MH-3) TO HAVE CLOSED LID PER IDOT STANDARD DETAIL FRAME & LID TYPE 1 6004001-05.
- ALL INLETS (CB-1 & CB-2) TO BE INLET TYPE A WITH FRAME & GRATE TYPE 3 PER STANDARD DETAILS 602301-04 & 604006-05.

#### LEGEND

- |  |                   |
|--|-------------------|
|  | INLET             |
|  | MANHOLE           |
|  | STORM DRAIN       |
|  | FLEXAMAT          |
|  | GRADING LIMITS    |
|  | DITCH GRADE BREAK |
|  | CURB CUT          |
|  | PROP CONTOUR      |
|  | EXIST CONTOUR     |
|  | FLOW ARROW        |

#### KEYED NOTES

- PROPOSED CURB CUT



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REALIGN THE GENERAL AVIATION  
ENTRANCE ROAD

#### DRAINAGE PLAN (3 OF 4)

CLIENT APPROVAL	CLIENT APPROVAL	PROJECT NO.
		MLI-5023
		HDR PROJECT NO. 10404260
		SHEET NO. 21 of 61

CONSULTANTS

**QUAD CITIES**  
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NO.	DATE	DESCRIPTION	BY
		CONTRACTOR	
		AS-BUILT INFORMATION	
		WORK STAKED BY:	DATE:
		INSPECTOR'S ACCEPTANCE BY:	DATE:
		FIELD VERIFICATION BY:	DATE:
		DRAWINGS CORRECTED BY:	DATE:





DESIGNED BY: MM

DRAWN BY: AJ

CHECKED BY: SM

DATE:



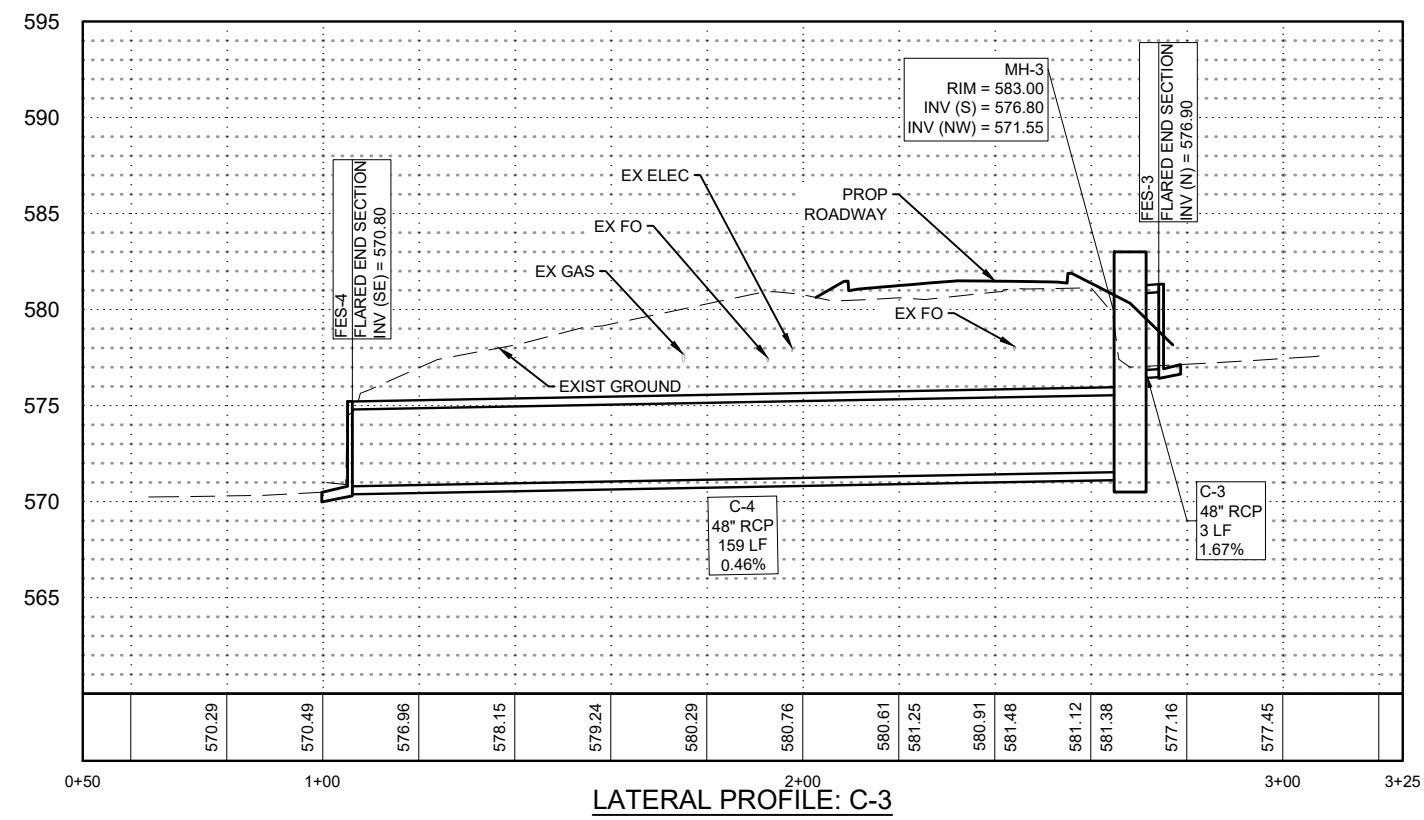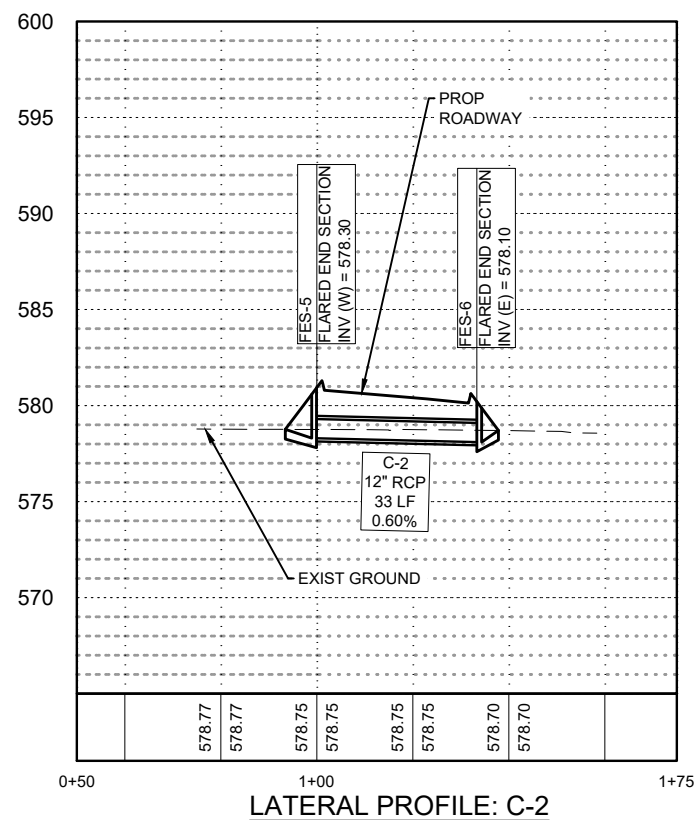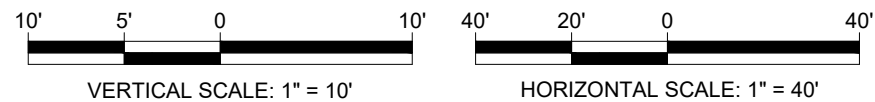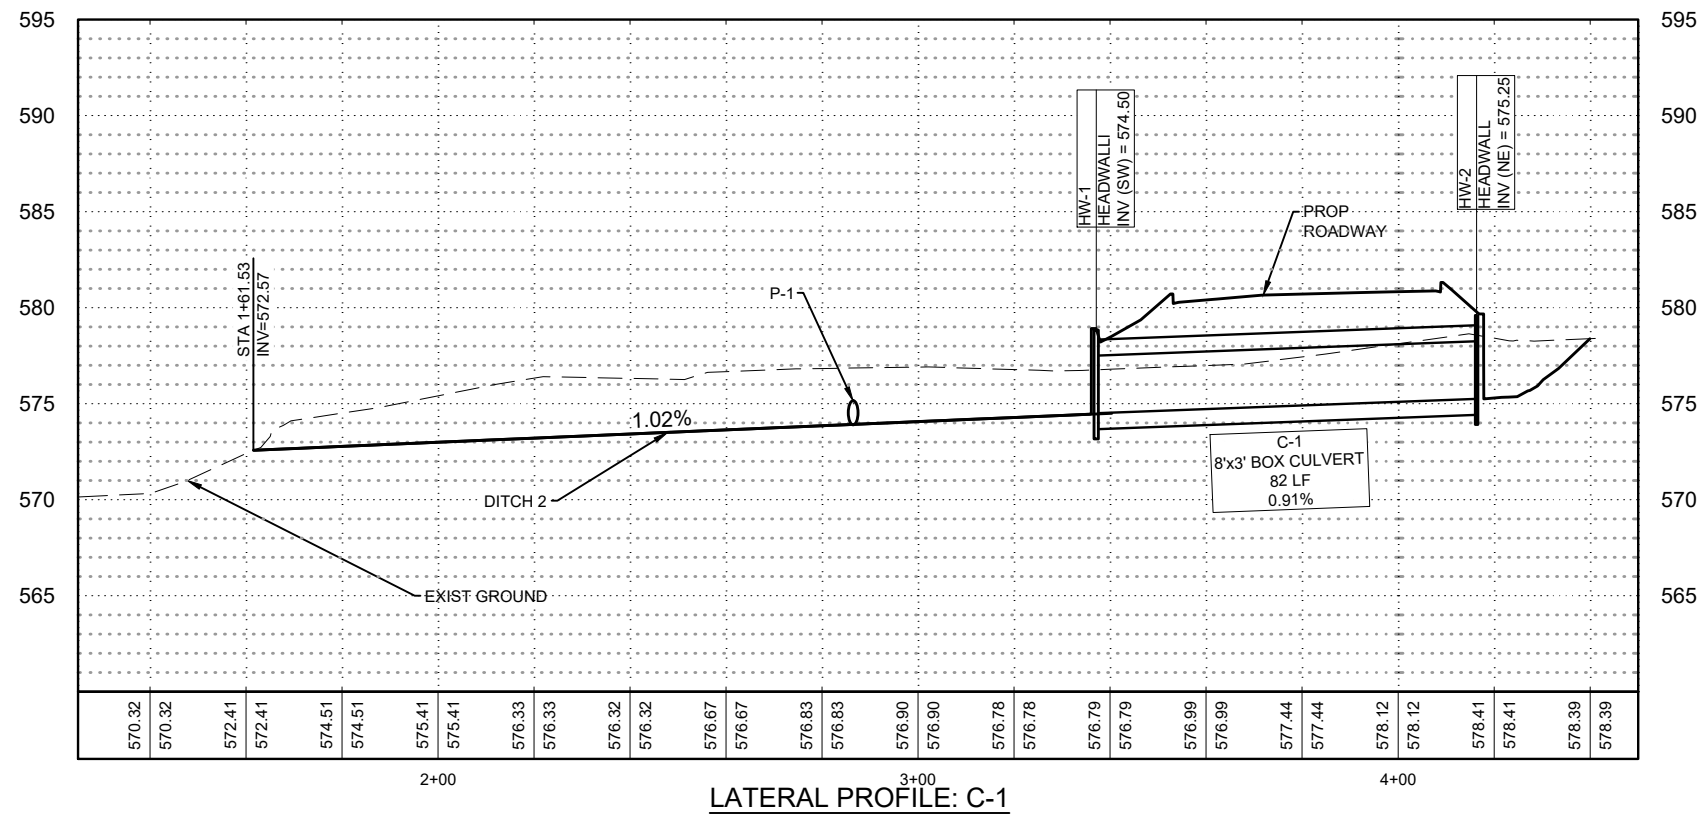










## GENERAL NOTES

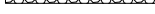- A. ALL DRAINAGE PIPE AND STRUCTURE STATIONS AND OFFSETS ARE BASED OFF PROPOSED CENTERLINES.
- B. ALL UNDERGROUND UTILITIES SHOWN IN PLANS AND PROFILES ARE APPROXIMATE LOCATIONS BASED ON AVAILABLE INFORMATION.
- C. REFER TO EXISTING CONDITIONS AND PROPOSED REMOVAL PLAN FOR EXISTING STORM DRAIN REMOVALS.
- D. SEE SWPPP SHEETS FOR FLEXEMAT DETAILS & OTHER EROSION CONTROL MEASURES.
- E. SEE STRUCTURAL SHEETS REGARDING 8'x3' BOX CULVERT (C-1).
- F. CATCH BASIN RIM ELEVATIONS ARE TO GUTTER FLOW LINE.
- G. SEE DETAILS SHEETS FOR CURB CUT INFORMATION.
- H. UNDERDRAINS NOT SHOWN HERE. SEE DRAINAGE UNDERDRAIN PLAN SHEETS.
- I. ALL MANHOLES (MH-1, MH-2, & MH-3) TO HAVE CLOSED LID PER IDOT STANDARD DETAIL FRAME & LID TYPE 1 6004001-05.
- J. ALL INLETS (CB-1 & CB-2) TO BE INLET TYPE A WITH FRAME & GRATE TYPE 3 PER STANDARD DETAILS 602301-04 & 604006-05.

### LEGEND

- |   |                   |
|---|-------------------|
|  | INLET             |
|  | MANHOLE           |
|  | STORM DRAIN       |
|  | FLEXAMAT          |
|   | IG LIMITS         |
|  | DITCH GRADE BREAK |
|  | CURB CUT          |
|  | PROP CONTOUR      |
|  | EXIST CONTOUR     |
|  | FLOW ARROW        |

## KEYED NOTES

1. PROPOSED CURB CUT




CALL J.U.L.I.E  
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METROPOLITAN AIRPORT AUTHORITY OF ROCK ISLAND  
COUNTY (QUAD CITIES INTERNATIONAL AIRPORT)  
REALIGN THE GENERAL AVIATION  
ENTRANCE ROAD



## DRAINAGE LATERAL PROFILES (1 OF 2)

CLIENT APPROVAL	CLIENT APPROVAL	PROJECT NO. MLI-5023
		HDR PROJECT NO. 10404260
		SHEET NO. <b>23 of 61</b>

Date: 11 Feb 2025 - 3:59pm User: STOLJENSEN Layout: PL01-07  
Drawing Name: 18-DRAINAGE PLAN.dwg

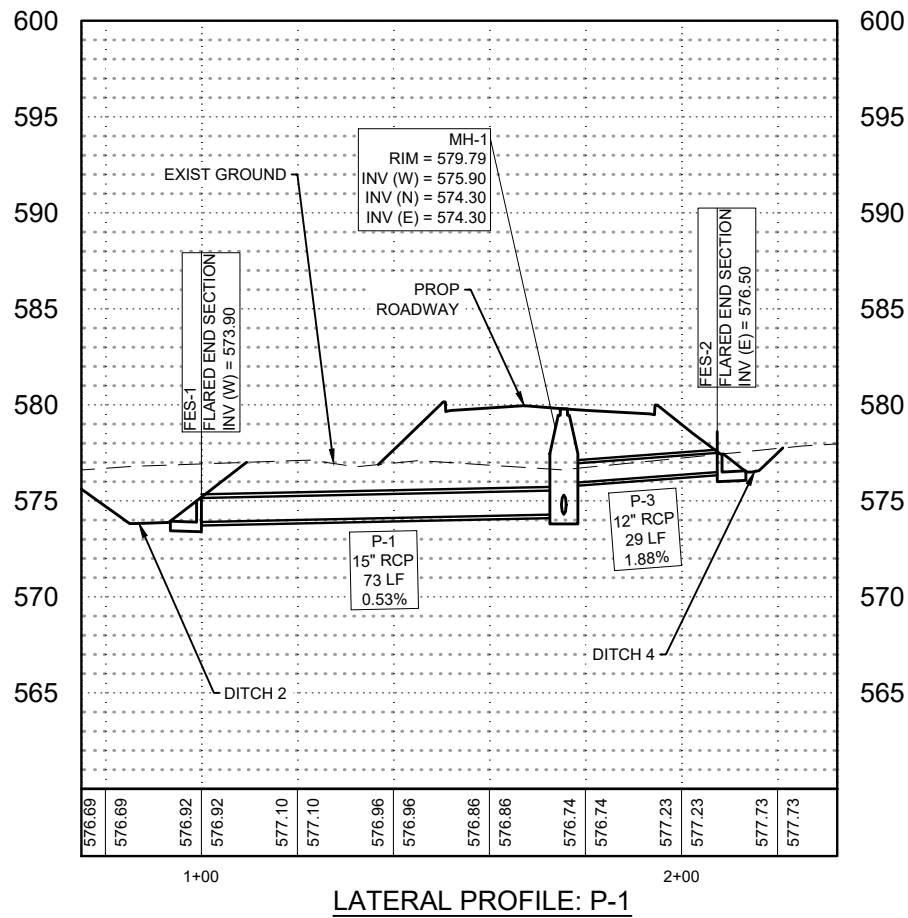

LATERAL PROFILE: P-1

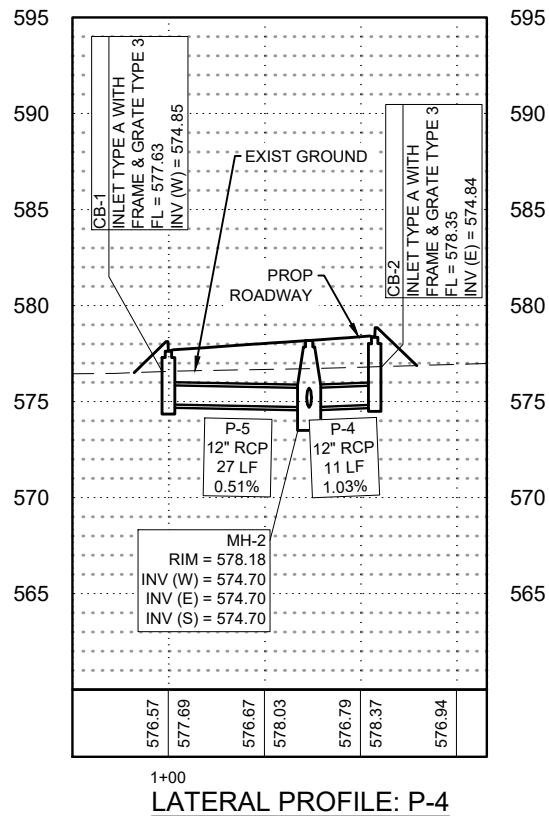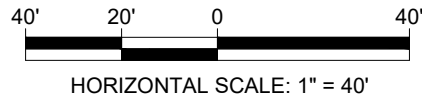

LATERAL PROFILE: P-4

## GENERAL NOTES

- ALL DRAINAGE PIPE AND STRUCTURE STATIONS AND OFFSETS ARE BASED OFF PROPOSED CENTERLINES.
- ALL UNDERGROUND UTILITIES SHOWN IN PLANS AND PROFILES ARE APPROXIMATE LOCATIONS BASED ON AVAILABLE INFORMATION.
- REFER TO EXISTING CONDITIONS AND PROPOSED REMOVAL PLAN FOR EXISTING STORM DRAIN REMOVALS.
- SEE SWPPP SHEETS FOR FLEXAMAT DETAILS & OTHER EROSION CONTROL MEASURES.
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- CATCH BASIN RIM ELEVATIONS ARE TO GUTTER FLOW LINE.
- SEE DETAILS SHEETS FOR CURB CUT INFORMATION.
- UNDERDRAINS NOT SHOWN HERE. SEE DRAINAGE UNDERDRAIN PLAN SHEETS.
- ALL MANHOLES (MH-1, MH-2, & MH-3) TO HAVE CLOSED LID PER IDOT STANDARD DETAIL FRAME & LID TYPE 1 6004001-05.
- ALL INLETS (CB-1 & CB-2) TO BE INLET TYPE A WITH FRAME & GRATE TYPE 3 PER STANDARD DETAILS 602301-04 & 604006-05.

## LEGEND

- |  |                   |
|--|-------------------|
|  | INLET             |
|  | MANHOLE           |
|  | STORM DRAIN       |
|  | FLEXAMAT          |
|  | IG LIMITS         |
|  | DITCH GRADE BREAK |
|  | CURB CUT          |
|  | PROP CONTOUR      |
|  | EXIST CONTOUR     |
|  | FLOW ARROW        |

## KEYED NOTES

- PROPOSED CURB CUT



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## DRAINAGE LATERAL PROFILES (2 OF 2)

CLIENT APPROVAL	CLIENT APPROVAL	PROJECT NO.
		MLI-5023
		HDR PROJECT NO.
		10404260
		SHEET NO.
		24 of 61

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4620 E 53RD STREET  
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QUAD CITIES  
INTERNATIONAL AIRPORT




PREPARED FOR

NO.	DATE	DESCRIPTION	BY
		CONTRACTOR	
		AS-BUILT INFORMATION	
		WORK STAKED BY:	DATE:
		INSPECTOR'S ACCEPTANCE BY:	DATE:
		FIELD VERIFICATION BY:	DATE:
		DRAWINGS CORRECTED BY:	DATE:

DESIGNED BY: MM
DRAWN BY: AJ
CHECKED BY: SM
DATE:

Date: 11 Feb 2025 - 3:55pm User: STOLJENSEN Layout: PL01-01  
Drawing Name: 24-DRAINAGE PLAN- UNDERDRAINS.dwg

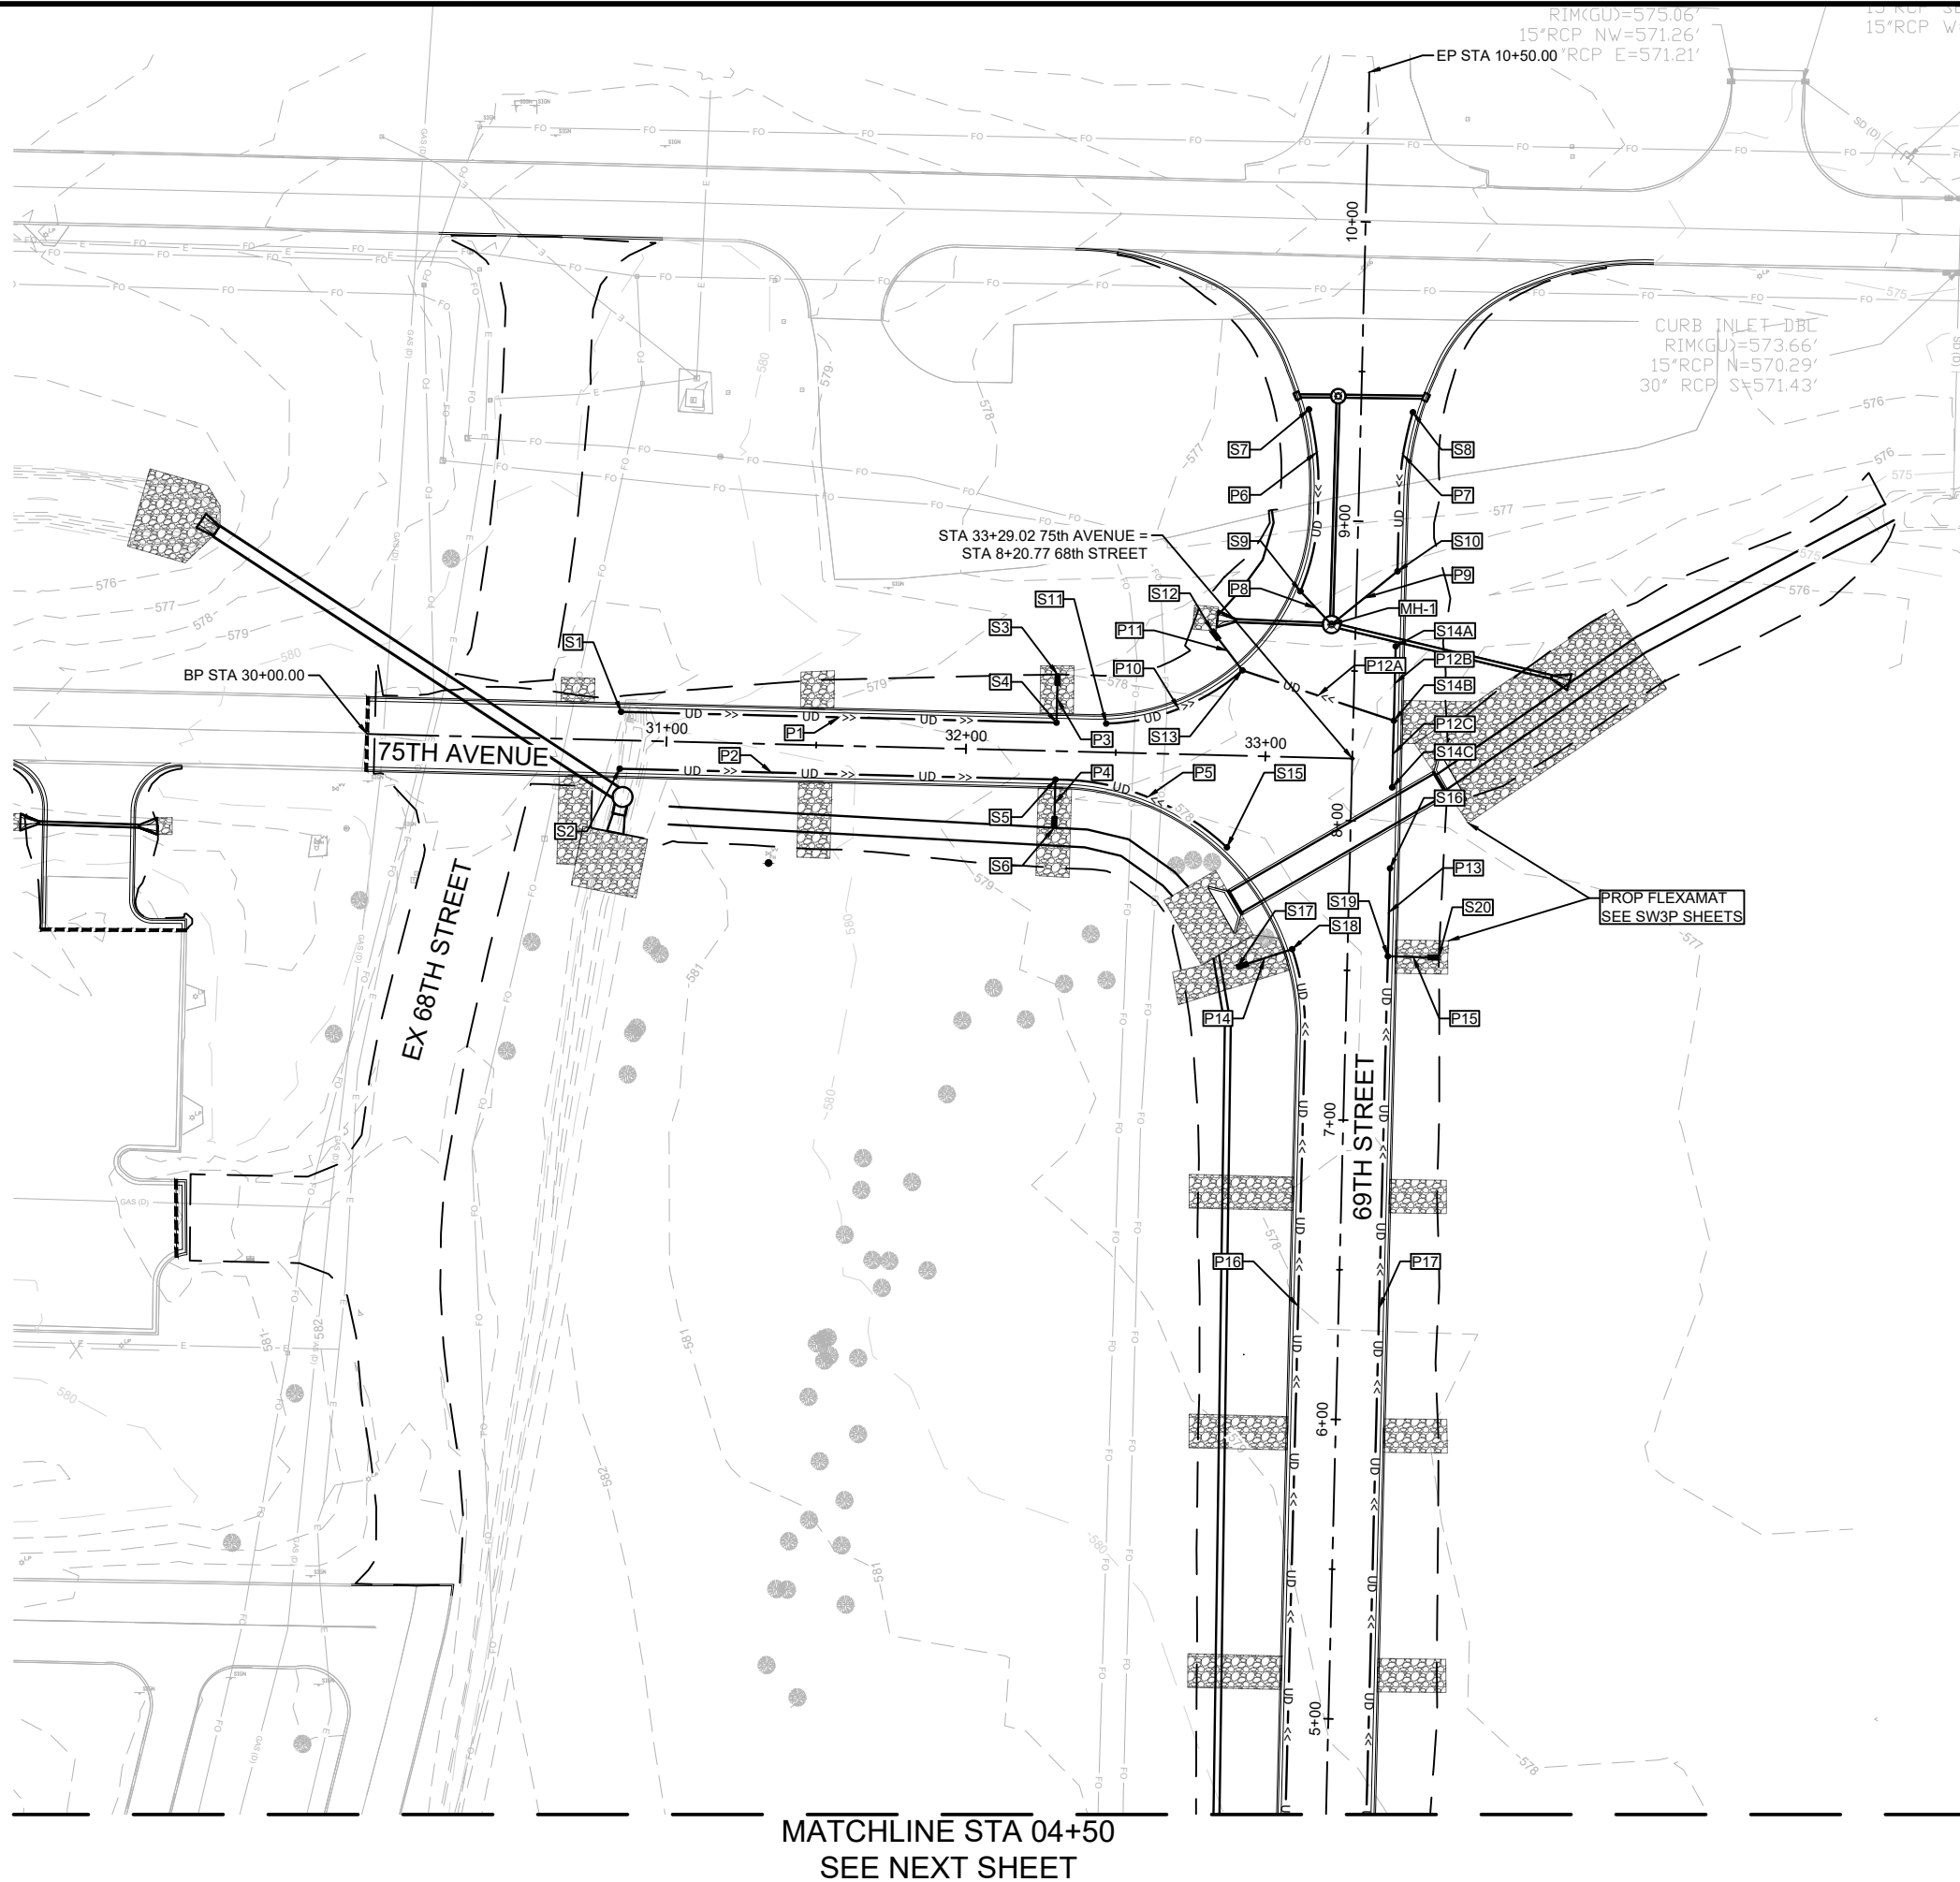

**GENERAL NOTES**

A. SEE DRAINAGE UNDERDRAIN SCHEDULE SHEET FOR UNDERDRAIN DATA.

B. ALL UNDERDRAIN TO BE 6" PVC UNLESS OTHERWISE SHOWN.

C. UNDERDRAINS TO HAVE A MINIMUM OF 0.5% SLOPE.

**LEGEND**

- UD -> UNDERDRAIN
- UNDERDRAIN HEADWALL
- UNDERDRAIN CLEANOUT
- DITCH BOTTOM WIDTH
- GRADING LIMITS

60' 30' 0 60'

SCALE: 1" = 60'

**811**

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NO.	DATE	DESCRIPTION	BY
		AS-BUILT INFORMATION	
		WORK STAKED BY:	
		INSPECTOR'S ACCEPTANCE BY:	
		FIELD VERIFICATION BY:	
		DRAWINGS CORRECTED BY:	

DESIGNED BY: MM  
DRAWN BY: AJ  
CHECKED BY: SM  
DATE:

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REALIGN THE GENERAL AVIATION  
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**DRAINAGE UNDERDRAIN PLAN (1 OF 2)**

CLIENT APPROVAL	CLIENT APPROVAL	PROJECT NO.
		MLI-5023
		HDR PROJECT NO. 10404260
		SHEET NO. 25 of 61

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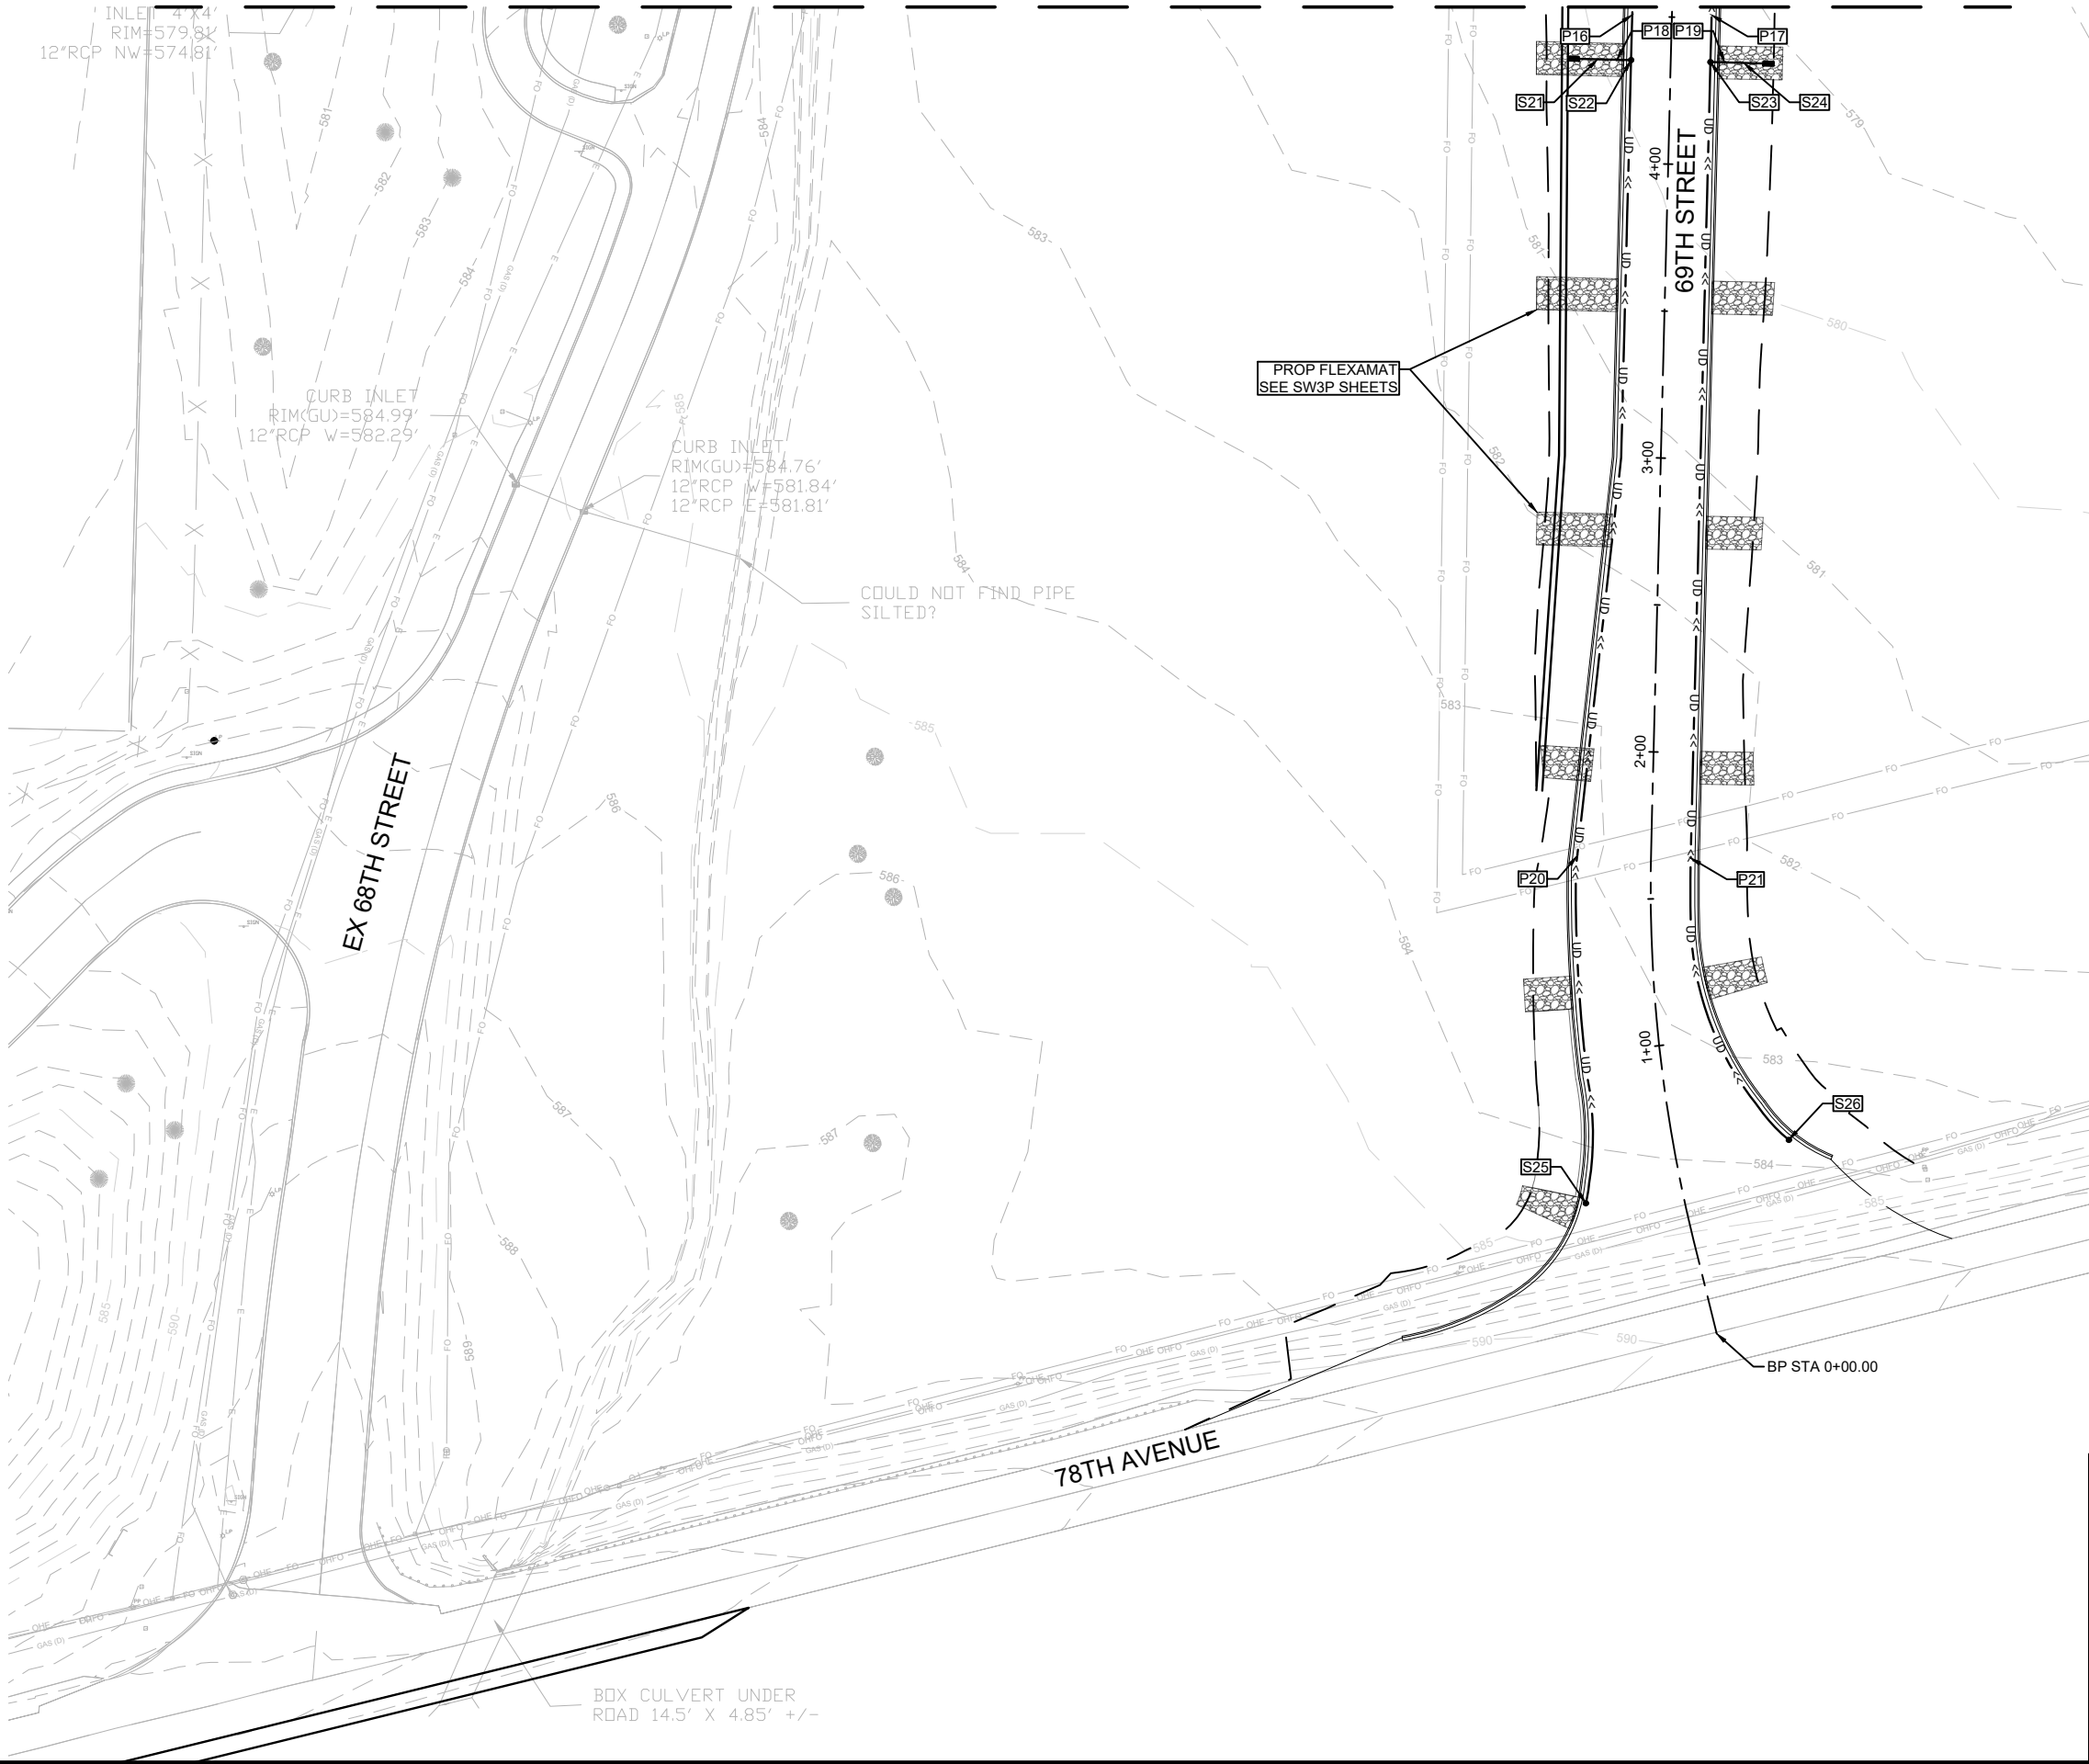
**FCR**

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PREPARED FOR

**QUAD CITIES**  
INTERNATIONAL AIRPORT

Date: 11 Feb 2025 - 3:55pm User: STOLJENSEN Layout: PL01-02  
Drawing Name: 24-DRAINAGE PLAN - UNDERDRAINS.dwg




MATCHLINE STA 04+50  
SEE PREVIOUS SHEET

GENERAL NOTES

- A. SEE DRAINAGE UNDERDRAIN SCHEDULE SHEET FOR UNDERDRAIN DATA.
- B. ALL UNDERDRAIN TO BE 6" PVC UNLESS OTHERWISE SHOWN.
- C. UNDERDRAINS TO HAVE A MINIMUM OF 0.5% SLOPE.

LEGEND

- UD ->->- UNDERDRAIN
- UNDERDRAIN HEADWALL
- UNDERDRAIN CLEANOUT
- DITCH BOTTOM WIDTH
- GRADING LIMITS

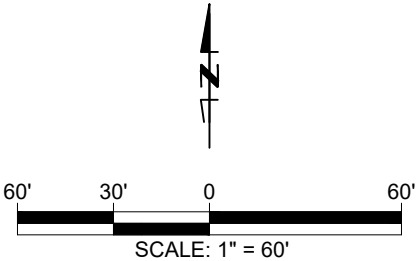

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METROPOLITAN AIRPORT AUTHORITY OF ROCK ISLAND  
COUNTY (QUAD CITIES INTERNATIONAL AIRPORT)  
REALIGN THE GENERAL AVIATION  
ENTRANCE ROAD

DRAINAGE UNDERDRAIN PLAN (2 OF 2)

CLIENT APPROVAL	CLIENT APPROVAL	PROJECT NO.
		MLI-5023
		HDR PROJECT NO.
		10404260
		SHEET NO.
		26 of 61

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INTERNATIONAL AIRPORT



NO.	DATE	DESCRIPTION	BY
		AS-BUILT INFORMATION	
		CONTRACTOR:	
		WORK STAKED BY:	
		INSPECTOR'S ACCEPTANCE BY:	
		FIELD VERIFICATION BY:	
		DRAWINGS CORRECTED BY:	

DESIGNED BY: MM
DRAWN BY: AJ
CHECKED BY: SM
DATE:



Salvage: N/A



10 year Velocity through Existing Culvert = N/A ft/s  
10 year Velocity through Proposed Culvert = 1.09 ft/s

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(563) 293-7684

[illegible]

DESIGNED BY: JM
DRAWN BY: JM
CHECKED BY: MBQ
DATE: 02/06/2025

METROPOLITAN AIRPORT AUTHORITY OF ROCK ISLAND  
COUNTY (QUAD CITIES INTERNATIONAL AIRPORT)  
REALIGN THE GENERAL AVIATION ENTRANCE ROAD

69TH STREET OVER DIVERSION CHANNEL  
GENERAL PLAN AND ELEVATION

CLIENT APPROVAL	CLIENT APPROVAL	PROJECT NO. MLI-5023
		HDR PROJECT NO. 10404260
		SHEET NO. <b>28 of 61</b>

Date: 13 Sep 2024 - 8:56am User: JNIGUS Layout: Model  
Drawing Name: BORDER.dwg


## GENERAL NOTES

The design fill height for this box is 2'-0" ft. The precast box culvert sections shall conform to the requirements of ASTM C 1577.

Drain holes shall be provided on exterior culvert walls for each precast box segment with a clear rise greater than 3 ft. The drain hole shall be located within 1/3 of the clear rise of the box culvert, shall not intercept the haunch, and shall conform to the requirements of Article 503.11 of the IDOT Standard Specifications for Road and Bridge Construction.


Nonwoven geotextile fabric shall conform to the requirements of Art. 1080.01 of the IDOT Standard Specifications for Road and Bridge Construction. The minimum weight of the fabric shall be 6 ounces per square yard.

Precast concrete box culverts and box culvert end sections shall be backfilled with Porous Granular Embankment in the required excavation areas on the sides of the box culvert from the top of the box culvert to the bottom of the box culvert. This area of PGE is included in the Porous Granular Embankment pay item. The 6-inch thick layer of porous granular material required under the precast concrete box culvert, according to Section 540.06 of the IDOT Standard Specifications for Road and Bridge Construction, shall also apply to the end sections. Cost of this porous granular material will not be paid for separately but shall be included in the unit price of the work for which it is required.

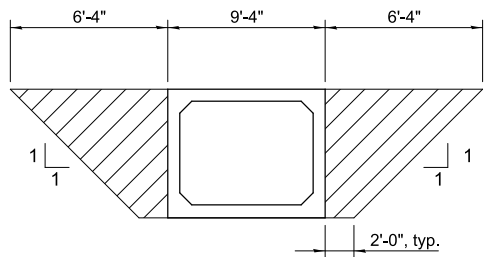

## PAY LIMITS FOR POROUS GRANULAR EMBANKMENT

(Hatched area)

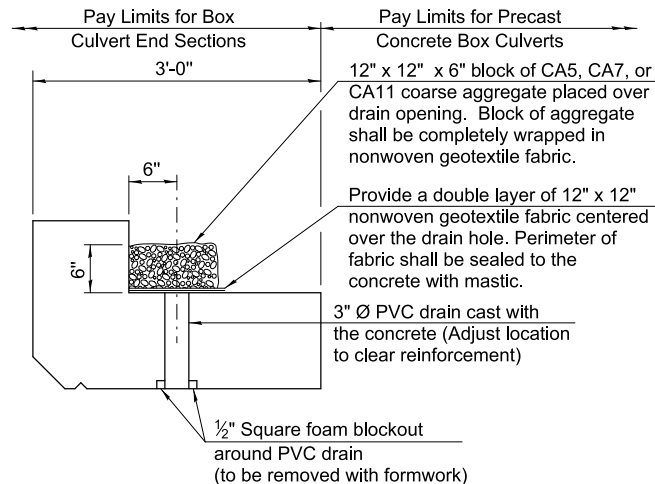

### DRAIN DETAIL

(All costs associated with furnishing and constructing the above drain detail will not be measured for payment but shall be included in the contract unit price for the associated work.)

## INDEX OF SHEETS

1. General Plan and Elevation
2. General Notes and Details
3. Culvert Details (1 of 2)
4. Culvert Details (2 of 2)
5. Soil Boring Logs

## TOTAL BILL OF MATERIAL

	ITEM	UNIT	TOTAL
	Box Culvert End Sections	Each	2
	Precast Concrete Box Culverts, 8'x3'	Foot	76.0
	Porous Granular Embankment	Cu. Yd.	111.0
	Membrane Waterproofing System for Buried Structures	Sq. Yd.	101
**	Unclassified Excavation	Cu. Yd.	180
**	Rockfill	Cu. Yd.	180

\*\* Unclassified Excavation beneath the bedding material is anticipated to a depth of approximately 4 feet. Nominal quantities are provided for both "Unclassified Excavation" and "Rockfill". Removal depth shall be determined by the Engineer after the proposed bottom of Porous Granular Material bedding is reached, and the Contractor will be paid for the actual volume excavated and filled.



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## 69TH STREET OVER DIVERSION CHANNEL GENERAL NOTES AND DETAILS

CLIENT APPROVAL	CLIENT APPROVAL	PROJECT NO.
		MLI-5023
		HDR PROJECT NO. 10404260
		SHEET NO. <b>29 of 61</b>

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**QUAD CITIES**  
INTERNATIONAL AIRPORT

4620 E 53RD STREET  
DAVENPORT, IA 52807-3620  
(563) 293-7684

[illegible]

DESIGNED BY:	JM
DRAWN BY:	JM
CHECKED BY:	MBQ
DATE:	02/06/2025



CALL J.U.L.I.E  
BEFORE YOU DIG

DESIGNED BY: JM
DRAWN BY: JM
CHECKED BY: MBQ
DATE: 02/06/2025


BAR s

BAR s1

BAR s2


## SECTION B-B

(Top slab at downstream end)

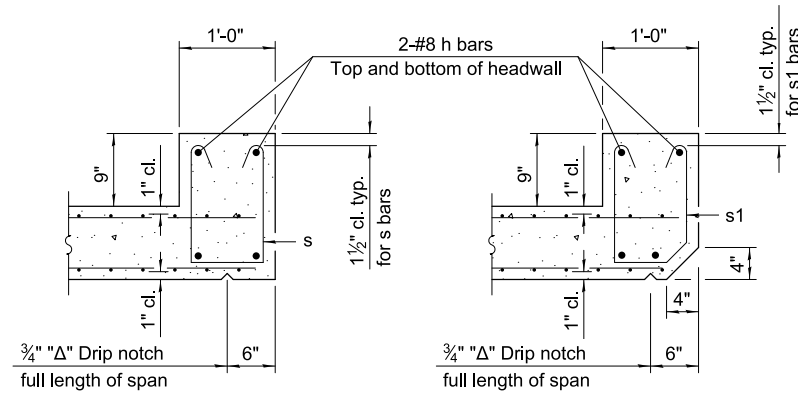

## SECTION B-B


(Top slab at upstream end)

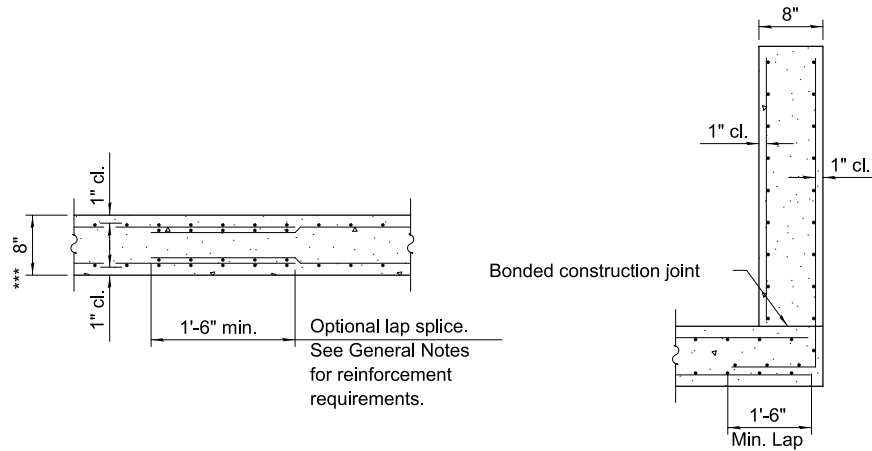

### SECTION B-B


(Bottom Slab)

\*\*\* This dimension shall be increased by 2" for CIP construction.

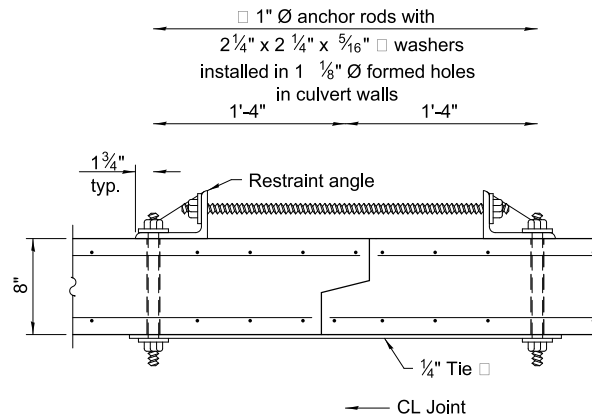


## SECTION F-F


(Showing culvert tie details)

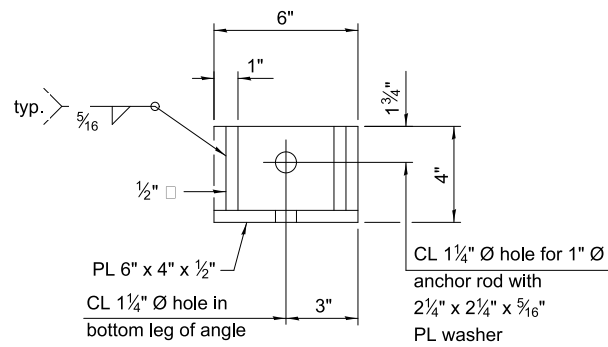

### RESTRAINT ANGLE DETAIL

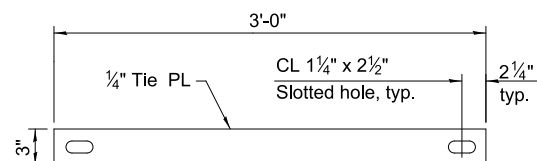

### TIE PLATE DETAIL

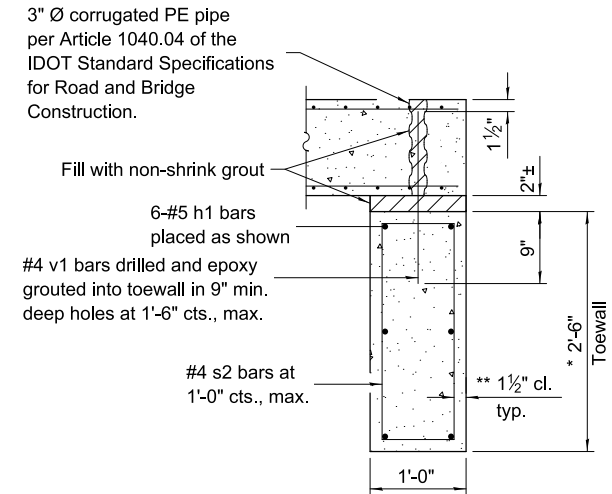

SECTION D-D

### TOEWALL CONSTRUCTION SEQUENCE

1. Perform excavation and construct toewall.
2. Backfill accordingly and place bedding for precast box culvert end sections.
3. Set precast box culvert end section.
4. Drill and epoxy grout reinforcement in toewall in accordance with Section 584 of the IDOT Standard Specifications for Road and Bridge Construction.
5. Pressure grout voids using non-shrink grout conforming to Section 1024 of the IDOT Standard Specifications for Road and Bridge Construction.

- The Contractor may furnish a precast or cast-in-place toewall. The Contractor shall be responsible for the strength and stability of the precast toewall during handling. Additional lifting points may be required depending upon the length of the toewall or the Contractor may need to modify the design of the toewall for the proposed handling method.

\*\* If soil conditions permit, the sides of the toewall may be poured directly against the soil. The clear cover on the sides of the toewall shall be increased to 3" by increasing the thickness of the toewall.



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[illegible]

METROPOLITAN AIRPORT AUTHORITY OF ROCK ISLAND  
COUNTY (QUAD CITIES INTERNATIONAL AIRPORT)  
REALIGN THE GENERAL AVIATION ENTRANCE ROAD

69TH STREET OVER DIVERSION CHANNEL  
CULVERT DETAILS (2 OF 2)

CLIENT APPROVAL	CLIENT APPROVAL	PROJECT NO. <b>MLI-5023</b>
		HDR PROJECT NO. <b>10404260</b>
		SHEET NO. <b>31 of 61</b>

Quad City Airport Aviation Entrance  
68th St. | Moline, Illinois  
Terracon Project No. 07245002



**Boring Log No. 1**

[illegible]

See Exploration and Testing Procedures for a description of field and laboratory procedures used and additional data (if any).  
See Supporting Information for explanation of symbols and abbreviations.  
Elevation Reference: Elevations were obtained from the USGS topographic survey tool.

**Water Level Observations**

	8' while drilling
	7 1/2' after drilling

**Drill Rig**  
416

**Hammer Type**  
Automatic

## Notes

#### Advancement Method

Continuous-Flight Solid-Stem Auger

**Abandonment Method**  
Boring backfilled with auger cuttings upon completion.

Facilities | Environmental | **Geotechnical** | Materials


Quad City Airport Aviation Entrance  
68th St. | Moline, Illinois  
Terracon Project No. 07245002



**Boring Log No. 2**

Model Layer	Graphic Log	Location: See Exploration Plan Latitude: 41.4401° Longitude: -90.5038°  Depth (D-1) _____ Elevation: 578 (P-1) +/- _____ TOPSOIL approx. 12"	Depth (ft.)	Water Level Observations	Sample Type	Recovery (in.)	Field Test Results	Sample Number	HP (pcf)	Unclassified Compressive Strength (psf)	Mechanical Content (%)	Dry Unit Weight (pcf)	Atterberg Limits LL-PL-Pt	Percent
1		0-1.0	577	X		12	2-3-2 N=5	1		21.5				
				X		15	2-2-2 N=4	2		23.5			43-18-25	97
2		4.0	574	X										
				X										
		6.5	571.5	X										
				X										
						16		3	2360	26.7	97			
						24		4	940	43.8	78			
3		13.5	564.5	X		12	0-0-2 N=2	5		29.4				
				X										
		19.0	559	X		15	2-4-5 N=9	6		11.9				
		20.5	557.5	X										
		Boring Terminated at 20.5 Feet												

See Exploration and Testing Procedures for a description of field and laboratory procedures used and additional data (if any).  
See Supporting Information for explanation of symbols and abbreviations.  
Elevation Reference: Elevations were obtained from the USGS topographic survey tool.

**Water Level Observation**  
 2½' while drilling  
 6½' after drilling

**Drill Rig**  
416


**Hammer Type**  
Automatic

## Notes

#### Advancement Method

Continuous-Flight Solid-Stem Auger

**Abandonment Method**  
 Boring backfilled with sugar cuttings upon completion

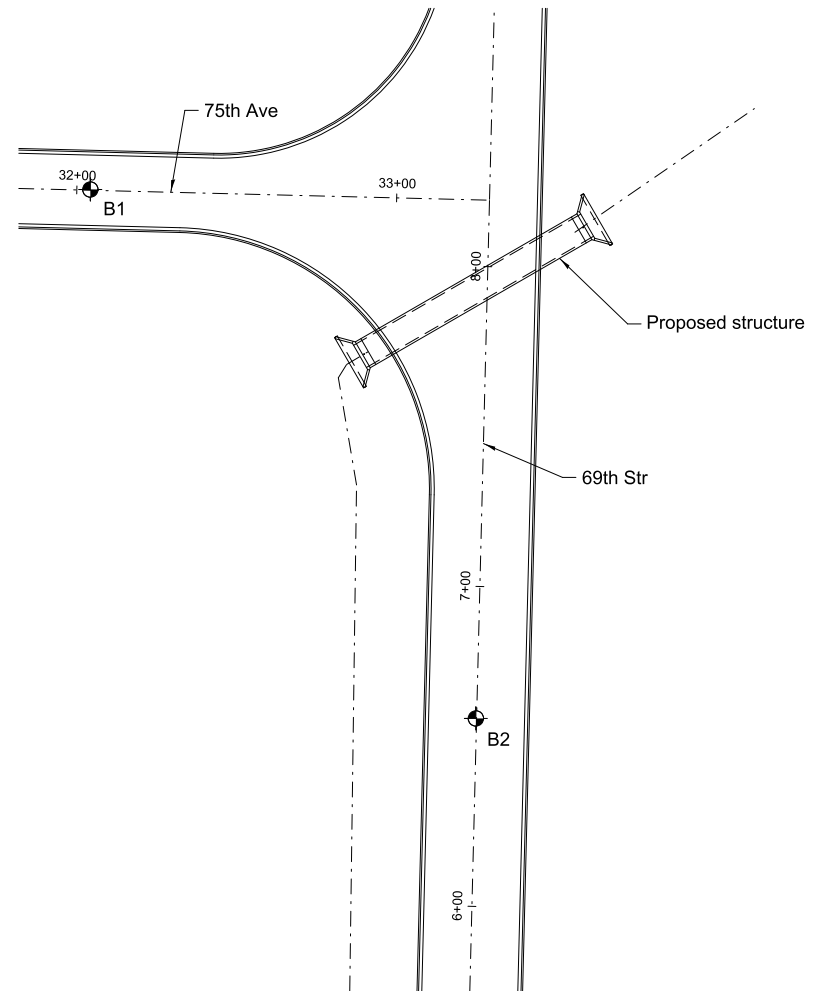Facilities | Environmental | **Geotechnical** | Materials

## BORING LOCATION PLAN



**CALL J.U.L.I.E  
BEFORE YOU DIG**

METROPOLITAN AIRPORT AUTHORITY OF ROCK ISLAND  
COUNTY (QUAD CITIES INTERNATIONAL AIRPORT)  
REALIGN THE GENERAL AVIATION ENTRANCE ROAD

69TH STREET OVER DIVERSION CHANNEL  
SOIL BORING LOGS

CLIENT APPROVAL	CLIENT APPROVAL	PROJECT NO. MLI-5023
		HDR PROJECT NO. 10404260
		SHEET NO. <b>32 of 61</b>


## CONSULTANTS

PREPARED FOR



4620 E 53RD STREET  
DAVENPORT, IA 52807-3620  
(563) 293-7684

Date: 26 Feb 2023 - 11:43am User: STOJENSEN Layout: Lighting Plan 1  
Drawing Name: XX-LIGHTING SHEETS.dwg

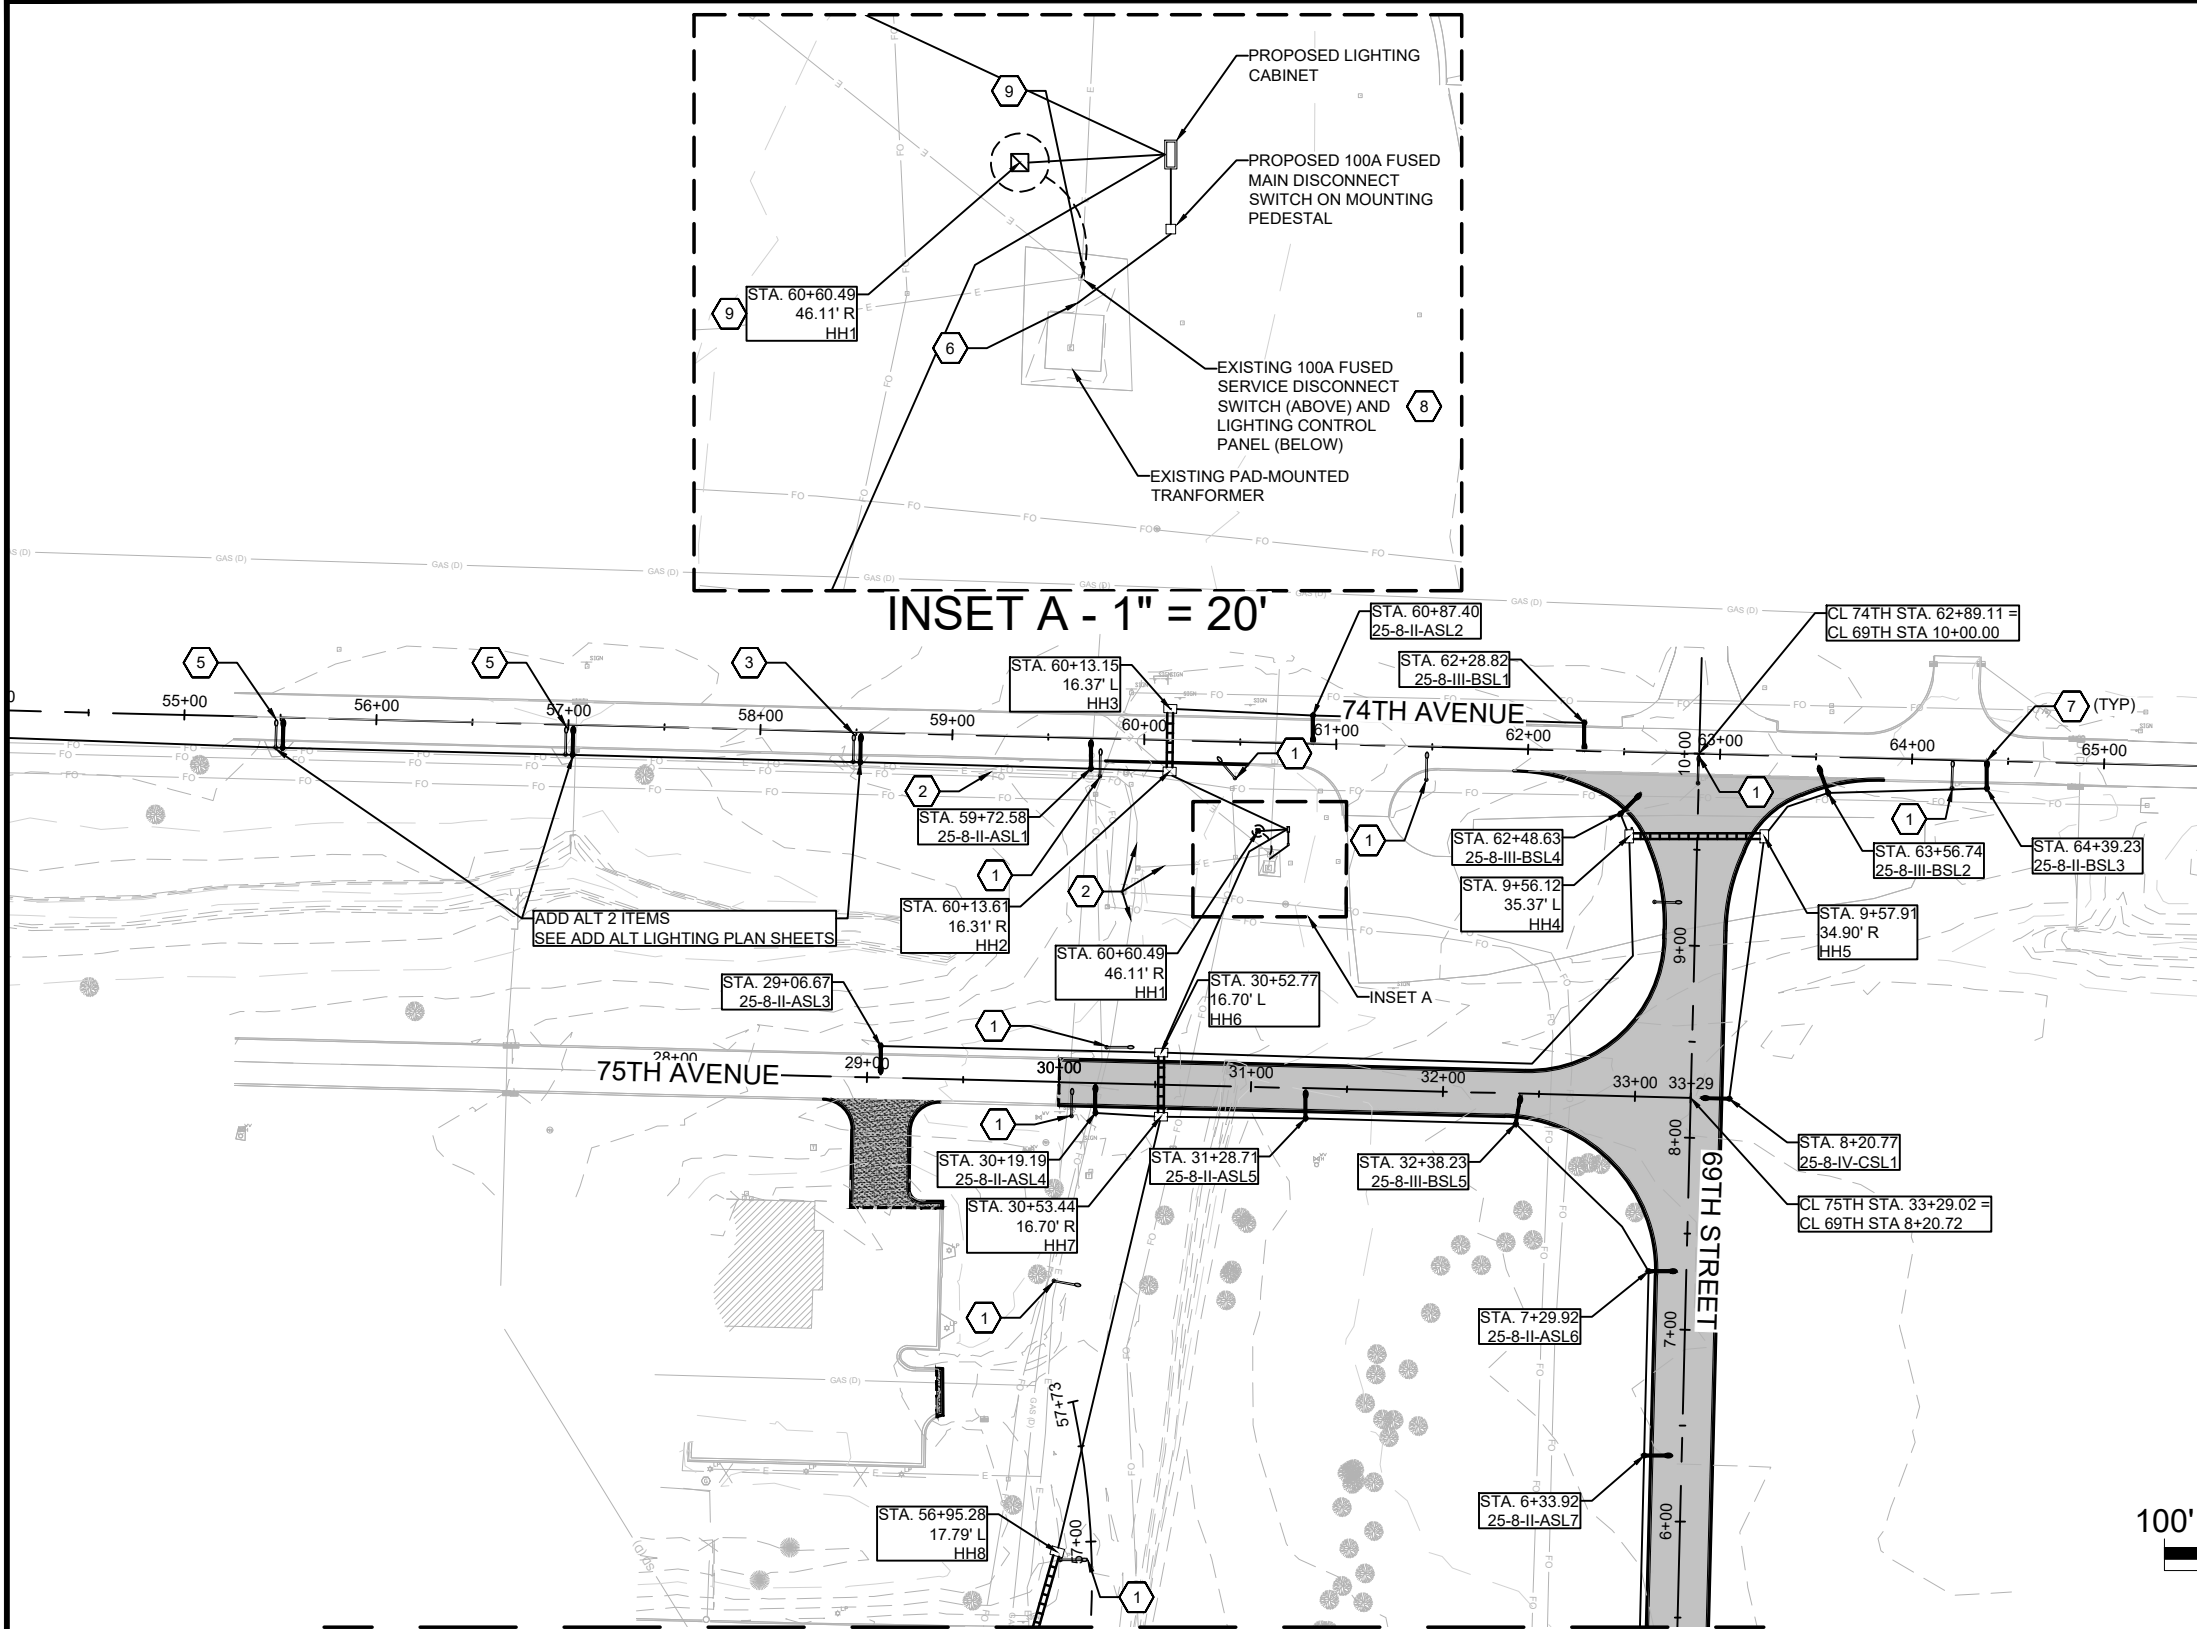

MATCHLINE A  
SEE NEXT SHEET

### KEYED NOTES


1. REMOVE EXISTING LIGHT POLE, LOCAL HANDHOLE (WHERE APPLICABLE), AND FOUNDATION DOWN TO A MINIMUM OF 24 IN BELOW GRADE.
2. REMOVE EXISTING LIGHTING CIRCUIT CONDUCTORS FEEDING LIGHT POLES SHOWN FOR REMOVAL. ABANDON THE REMAINING CONDUIT OR REMOVE AS NEEDED.
3. CONNECT NEW AND EXISTING LIGHTING CIRCUIT CONDUCTORS AT LIGHT POLE HANDHOLE.
4. INSTALL HANDHOLE HH1 TO INTECEPT EXISTING UNDERGROUND LIGHTING CONDUITS AT LOCATION OF REMOVED MAIN DISCONNECT/CONTROL CABINET PEDESTAL. SPLICE NEW AND EXISTING CONDUCTORS INSIDE HANDHOLE.
5. EXISTING LIGHT POLE TO BE PROTECTED IN PLACE.
6. UNDERGROUND EXISTING CONDUIT COMING FROM TRANSFORMER SECONDARY SHALL BE INTERCEPTED BETWEEN TRANSFORMER AND DISCONNECT SWITCH CONTROL CABINET SECONDARY AND ROUTED TO NEW MAIN FUSED DISCONNECT SWITCH.
7. THE SETBACK FOR ALL NEW LIGHT POLES SHOWN IS 7'-0" FROM BACK OF CURB TO CENTER OF POLE.
8. EXISTING PEDESTABLE WITH MOUNTED MAIN FUSED DISCONNECT AND CONTROL CABINET TO BE REMOVED.
9. AFTER REMOVING PEDESTAL AND FOUNDATION INSTALL AT THAT LOCATION HH1. DISCONNECTED BRANCH WIRING AND CONDUITS TO BE ROUTED INTO HH1.

### LEGEND

- PROP LIGHT
- EXIST LIGHT
- HANDHOLE, 11"x17" COMPOSITE CONCRETE
- HANDHOLE, 24"x24" COMPOSITE CONCRETE
- RIGID STEEL CONDUIT, JACKED OR DRILLED UNDER PAVEMENT
- HDPE DUCT (COILABLE NONMETALLIC CONDUIT) WITH CABLES

### PROPOSED LIGHT POLE DESIGNATION

BASELINE STATION NUMBER  
STA. XX+XX  
25-8-III-BSL1  
POLE NUMBER  
LUMINAIRE MOUNTING HEIGHT (FT)  
MOUNTING LENGTH (FT)  
IES DISTRIBUTION TYPE (II, III, OR IV)

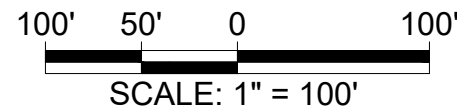

SCALE: 1" = 100'



METROPOLITAN AIRPORT AUTHORITY OF ROCK ISLAND COUNTY (QUAD CITIES INTERNATIONAL AIRPORT)  
REALIGN THE GENERAL AVIATION ENTRANCE ROAD

### LIGHTING PLAN (1 OF 2)

CLIENT APPROVAL	CLIENT APPROVAL	PROJECT NO.
		MLI-5023
		HDR PROJECT NO. 10404260
		SHEET NO. 33 of 61

CONSULTANTS



PREPARED FOR

NO.	DATE	DESCRIPTION	BY
		AS-BUILT INFORMATION	
		WORK STAKED BY:	
		INSPECTOR'S ACCEPTANCE BY:	
		FIELD VERIFICATION BY:	
		DRAWINGS CORRECTED BY:	


DESIGNED BY: MM
DRAWN BY: AJ
CHECKED BY: SM
DATE:

CONSULTANTS



4620 E 53RD STREET  
DAVENPORT, IA 52807-3620  
(563) 293-7684

Date: 11 Feb 2025 - 3:59pm User: STOLJENSEN Layout: Lighting Plan 2  
Drawing Name: XX-LIGHTING SHEETS.dwg

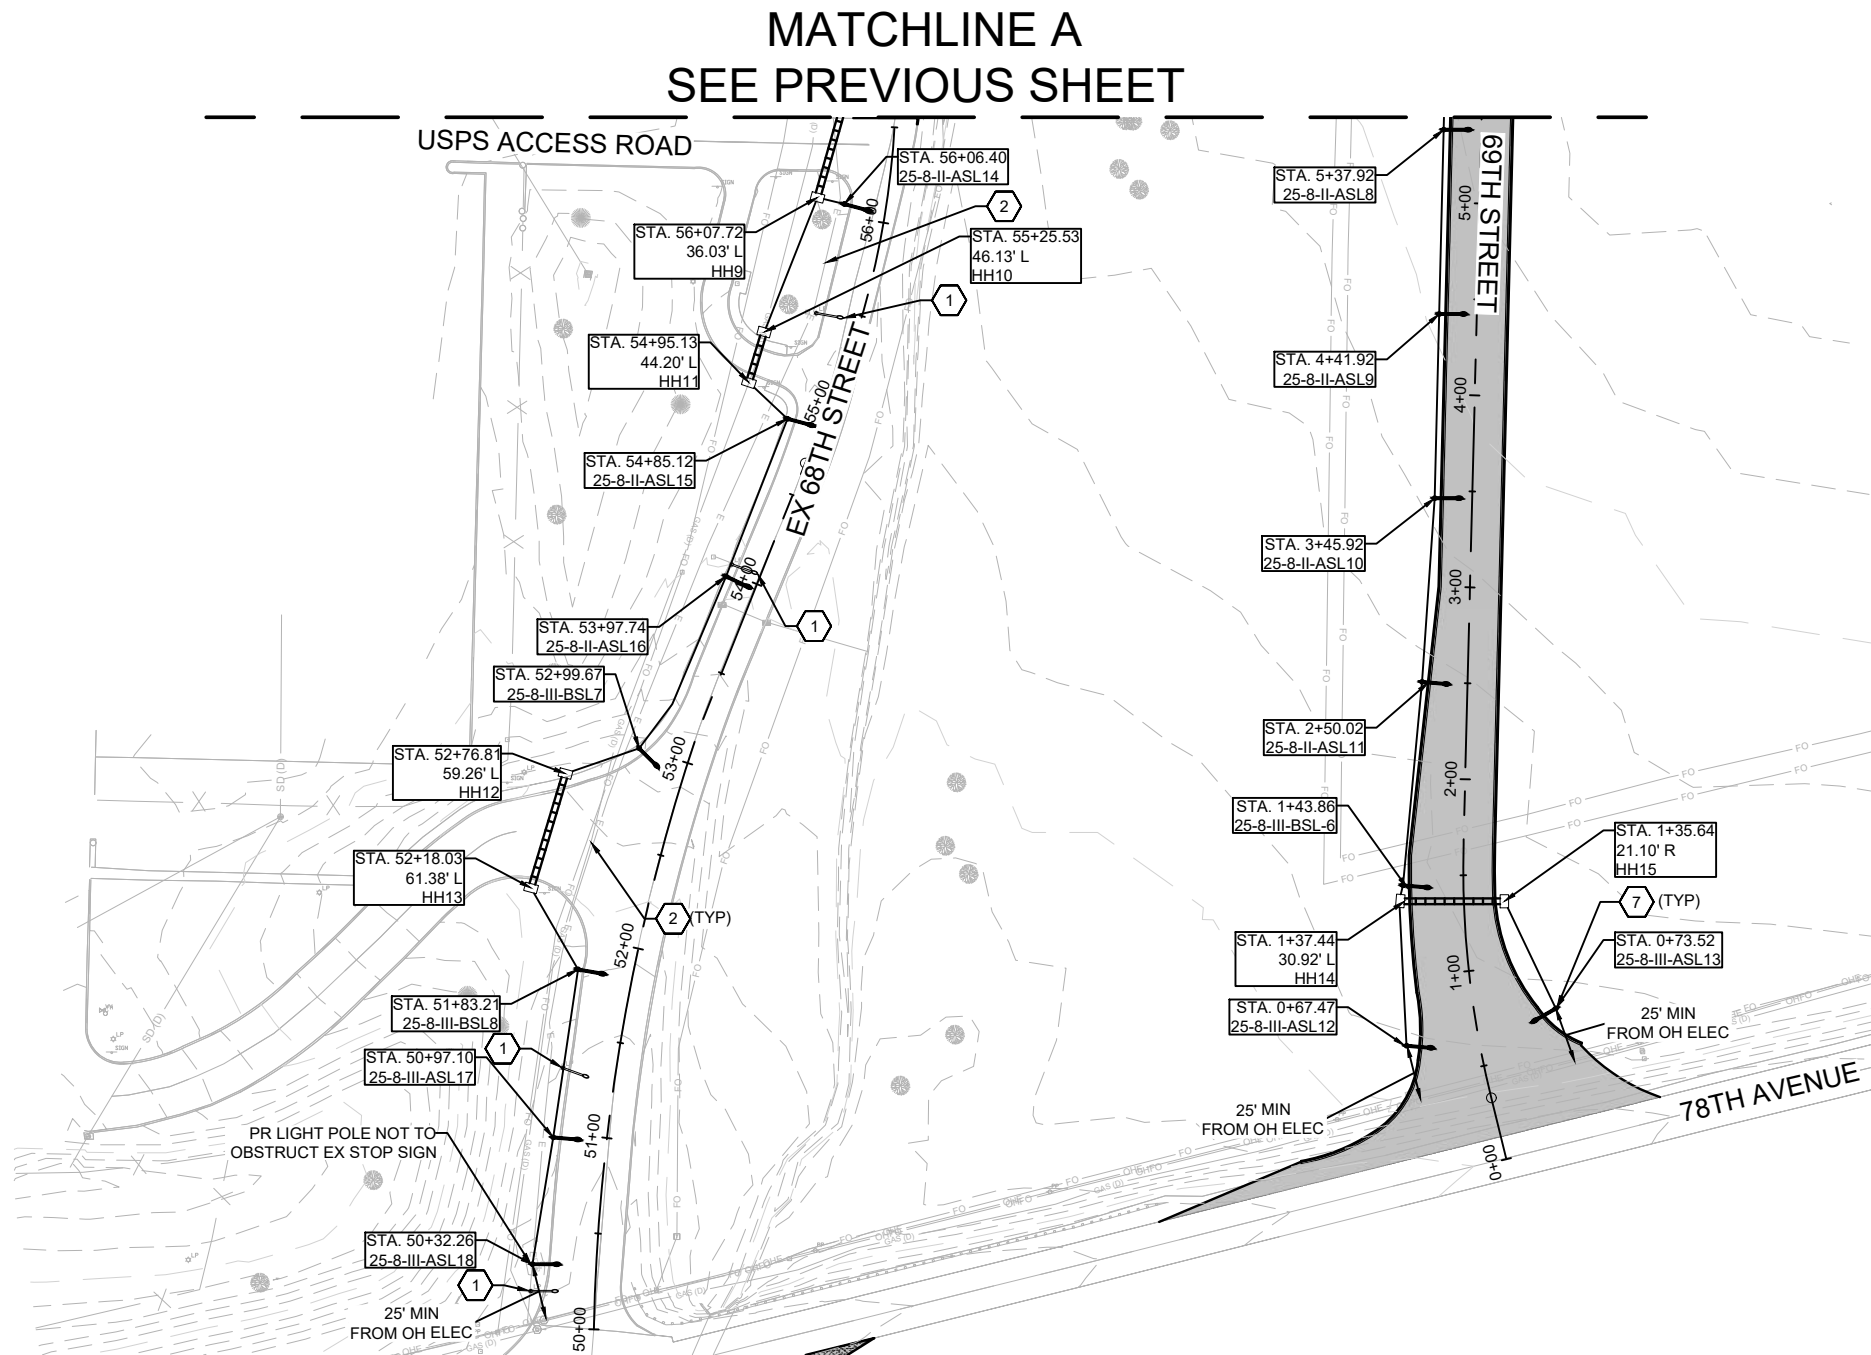

- KEYED NOTES**
1. REMOVE EXISTING LIGHT POLE, LOCAL HANDHOLE (WHERE APPLICABLE), AND FOUNDATION DOWN TO A MINIMUM OF 24 IN BELOW GRADE.
  2. REMOVE EXISTING LIGHTING CIRCUIT CONDUCTORS FEEDING LIGHT POLES SHOWN FOR REMOVAL. ABANDON THE REMAINING CONDUIT OR REMOVE AS NEEDED.
  3. CONNECT NEW AND EXISTING LIGHTING CIRCUIT CONDUCTORS AT LIGHT POLE HANDHOLE.
  4. INSTALL HANDHOLE HH1 TO INTECEPT EXISTING UNDERGROUND LIGHTING CONDUITS AT LOCATION OF REMOVED MAIN DISCONNECT/CONTROL CABINET PEDESTAL. SPLICE NEW AND EXISTING CONDUCTORS INSIDE HANDHOLE.
  5. EXISTING LIGHT POLE TO BE PROTECTED IN PLACE.
  6. UNDERGROUND EXISTING CONDUIT COMING FROM TRANSFORMER SECONDARY SHALL BE INTERCEPTED BETWEEN TRANSFORMER AND DISCONNECT SWITCH CONTROL CABINET SECONDARY AND ROUTED TO NEW MAIN FUSED DISCONNECT SWITCH.
  7. THE SETBACK FOR ALL NEW LIGHT POLES SHOWN IS 7'-0" FROM BACK OF CURB TO CENTER OF POLE.
  8. EXISTING PEDESTABLE WITH MOUNTED MAIN FUSED DISCONNECT AND CONTROL CABINET TO BE REMOVED.
  9. AFTER REMOVING PEDESTAL AND FOUNDATION INSTALL AT THAT LOCATION HH1. DISCONNECTED BRANCH WIRING AND CONDUITS TO BE ROUTED INTO HH1.

- LEGEND**
- PROP LIGHT
  - EXIST LIGHT
  - HANDHOLE, 11"x17" COMPOSITE CONCRETE
  - HANDHOLE, 24"x24" COMPOSITE CONCRETE
  - RIGID STEEL CONDUIT, JACKED OR DRILLED UNDER PAVEMENT
  - HDPE DUCT (COILABLE NONMETALLIC CONDUIT) WITH CABLES

**PROPOSED LIGHT POLE DESIGNATION**

BASELINE STATION NUMBER

LUMINAIRE MOUNTING HEIGHT (FT)  
MOUNTING LENGTH (FT)

STA. XX+XX  
25-8-III-BSL 1

POLE NUMBER

IES DISTRIBUTION TYPE (II, III, OR IV)

100' 50' 0 100'  
SCALE: 1" = 100'



METROPOLITAN AIRPORT AUTHORITY OF ROCK ISLAND COUNTY (QUAD CITIES INTERNATIONAL AIRPORT) REALIGN THE GENERAL AVIATION ENTRANCE ROAD		
LIGHTING PLAN (2 OF 2)		
CLIENT APPROVAL	CLIENT APPROVAL	PROJECT NO. MLI-5023
		HDR PROJECT NO. 10404260
		SHEET NO. 34 of 61

CONSULTANTS

PREPARED FOR



**FCR**  
4620 E 53RD STREET  
DAVENPORT, IA 52807-3620  
(563) 293-7684



[illegible]

NOTES:

1. INSTALL LIGHT POLE ON CONCRETE FOUNDATION.  
(SEE FOUNDATION DETAIL ON PLANS)



**CALL J.U.L.I.E  
BEFORE YOU DIG**

<p align="center"><b>METROPOLITAN AIRPORT AUTHORITY OF ROCK ISLAND COUNTY (QUAD CITIES INTERNATIONAL AIRPORT) REALIGN THE GENERAL AVIATION ENTRANCE ROAD</b></p>		
<p align="center"><b>LIGHTING EQUIPMENT SCHEDULE</b></p>		
CLIENT APPROVAL	CLIENT APPROVAL	PROJECT NO.  MLI-5023
		HDR PROJECT NO.  10404260
		SHEET NO.  <b>36 of 61</b>



CONSULTANTS

PREPARED FOR



4620 E 53RD STREET  
DAVENPORT, IA 52807-3620  
(563) 293-7684

Date: 11 Feb 2025 - 3:50pm User: STOLJENSEN Layout: Exist Cabinet Connection  
Drawing Name: XX-LIGHTING SHEETS.dwg

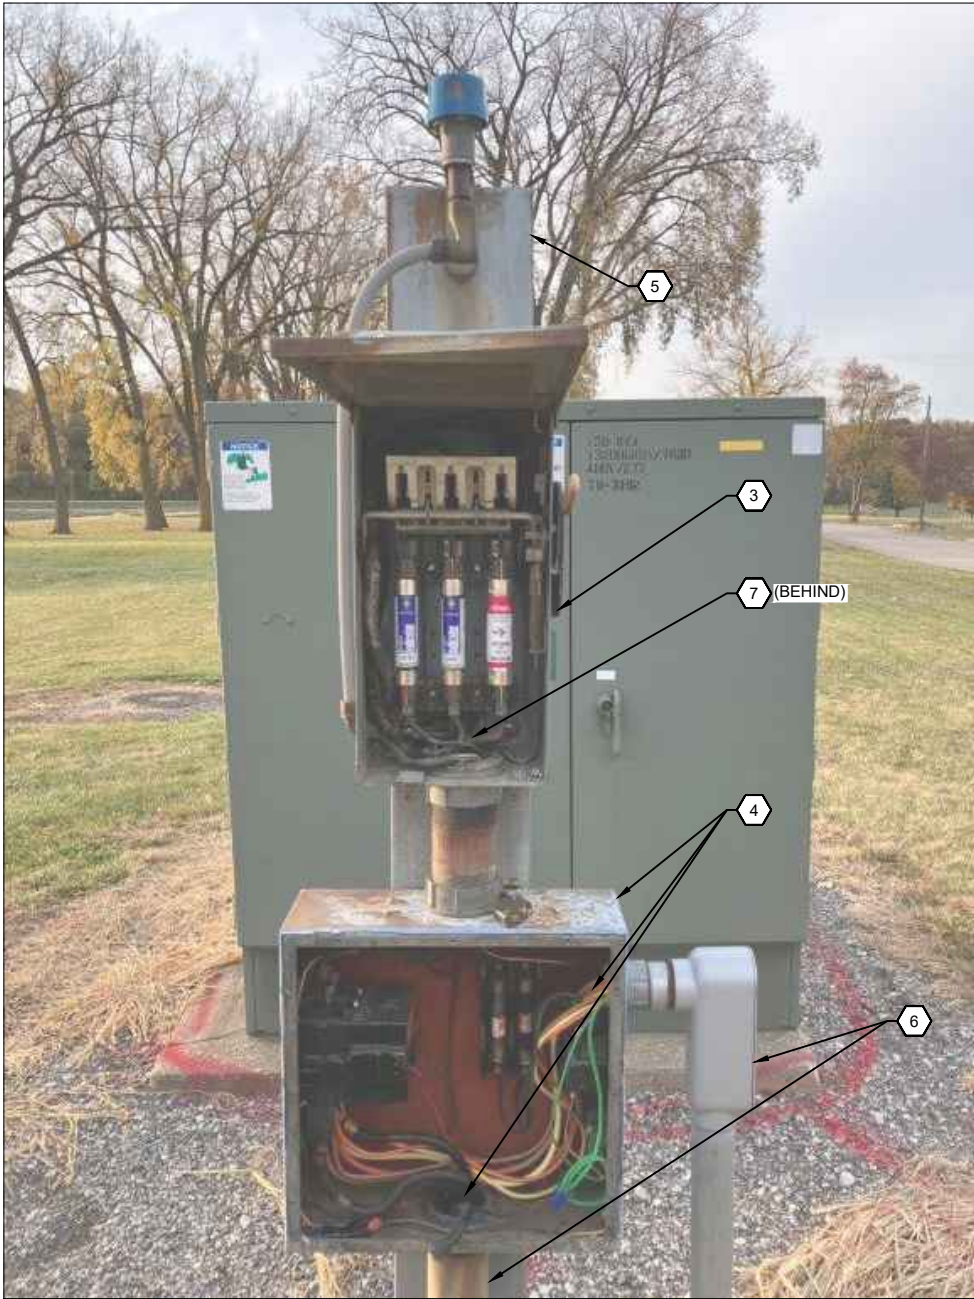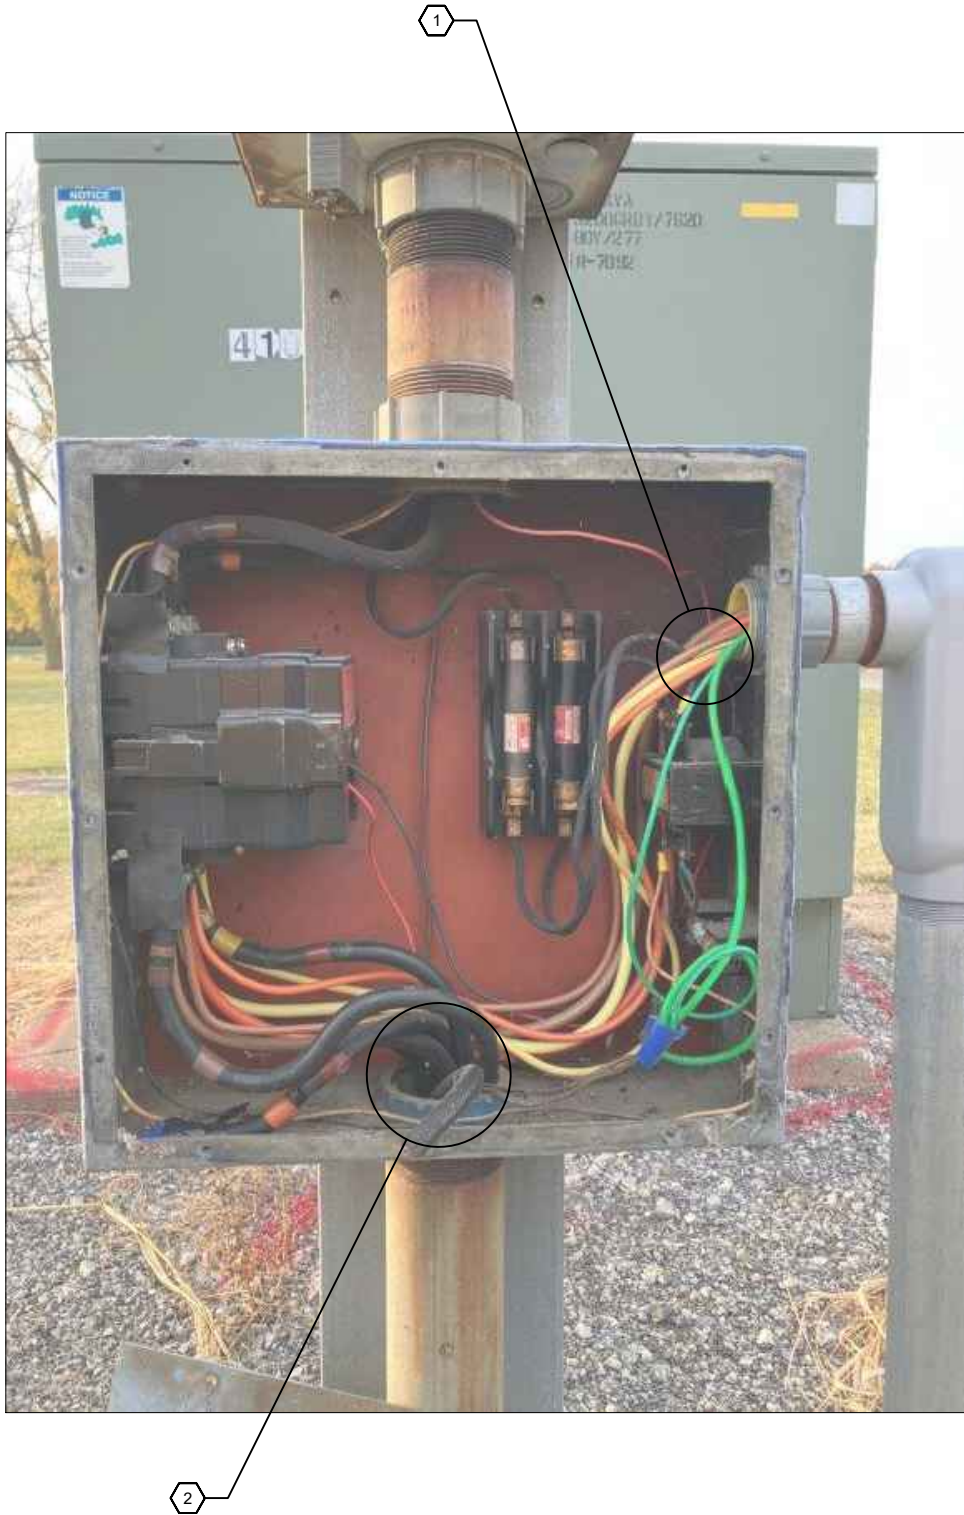

- NOTES:
- EXISTING CIRCUITS:  
-CIRCUIT NO. 1 (480V, 3PH): STREET LIGHT POLES  
(SEE PLANS FOR LIGHT POLES TO BE REMOVED FROM THIS CIRCUIT)  
-CIRCUIT NO. 2 (480V, 3 PH): SITE LIGHTING CIRCUIT.
  - EXISTING CIRCUIT:  
-CIRCUIT NO. 3 (480V, 1PH): SITE LIGHTING CIRCUIT.  
-ADDITIONAL CONDUCTORS, NOT CONNECTED.
  - DISCONNECT EXISTING MAIN FUSED DISCONNECT AND REMOVE FROM MOUNTING PEDESTAL.
  - DISCONNECT EXISTING LIGHTING CONTROL CABINET AND REMOVE FROM MOUNTING PEDESTAL.
  - REMOVE MOUNTING PEDESTAL AND ASSOCIATED FOUNDATION.
  - RE MOVE EXISTING LIGHTING BRANCH CIRCUIT CONDUCTORS TO BELOW GRADE, REROUTING TO NEW HANDHOLE HH1 TO BE INSTALLED AT BASE OF CURRENT PEDESTAL AFTER PEDESTAL AND FOUNDATION REMOVAL.
  - EXISTING CONDUIT AND CONDUCTORS FROM TRANSFORMER ARE ROUTED UNDERGROUND AND SURFACE MOUNTED UP THE BACKSIDE OF THE EXISTING MOUNTING PEDESTAL. THE CONDUCTORS SHALL BE REMOVED. THE CONDUIT SHALL BE REMOVE BACK TO A POINT BETWEEN THE TRANSFORMER AND PEDESTAL. IT SHALL BE THEN EXTENDED TO THE NEW PEDESTAL MOUNTED FUSED DISCONNECT SWITCH. NEW CONDUCTORS SHALL BE INSTALLED BETWEEN THE TRANSFORMER SECONDARY AND THE NEW FUSED DISCONNECT SWITCH.




METROPOLITAN AIRPORT AUTHORITY OF ROCK ISLAND COUNTY (QUAD CITIES INTERNATIONAL AIRPORT) REALIGN THE GENERAL AVIATION ENTRANCE ROAD		
EXISTING LC CABINET CONNETION		
CLIENT APPROVAL	CLIENT APPROVAL	PROJECT NO. MLI-5023
		HDR PROJECT NO. 10404260
		SHEET NO. 37 of 61

CONSULTANTS		PREPARED FOR	
HCR		QUAD CITIES INTERNATIONAL AIRPORT	
4620 E 53RD STREET DAVENPORT, IA 52807-3620 (563) 293-7684			
NO.	DATE	DESCRIPTION	BY
AS-BUILT INFORMATION		CONTRACTOR:	
WORK STAKED BY:		INSPECTOR'S ACCEPTANCE BY:	DATE:
FIELD VERIFICATION BY:		DRAWINGS CORRECTED BY:	DATE:
DESIGNED BY: MM			
DRAWN BY: AJ			
CHECKED BY: SM			
DATE:			



Date: 11 Feb 2025 - 3:57pm User: STOJENSEN Layout: PL01-02  
Drawing Name: 25-SWPPP & EROSION CONTROL PLAN.dwg

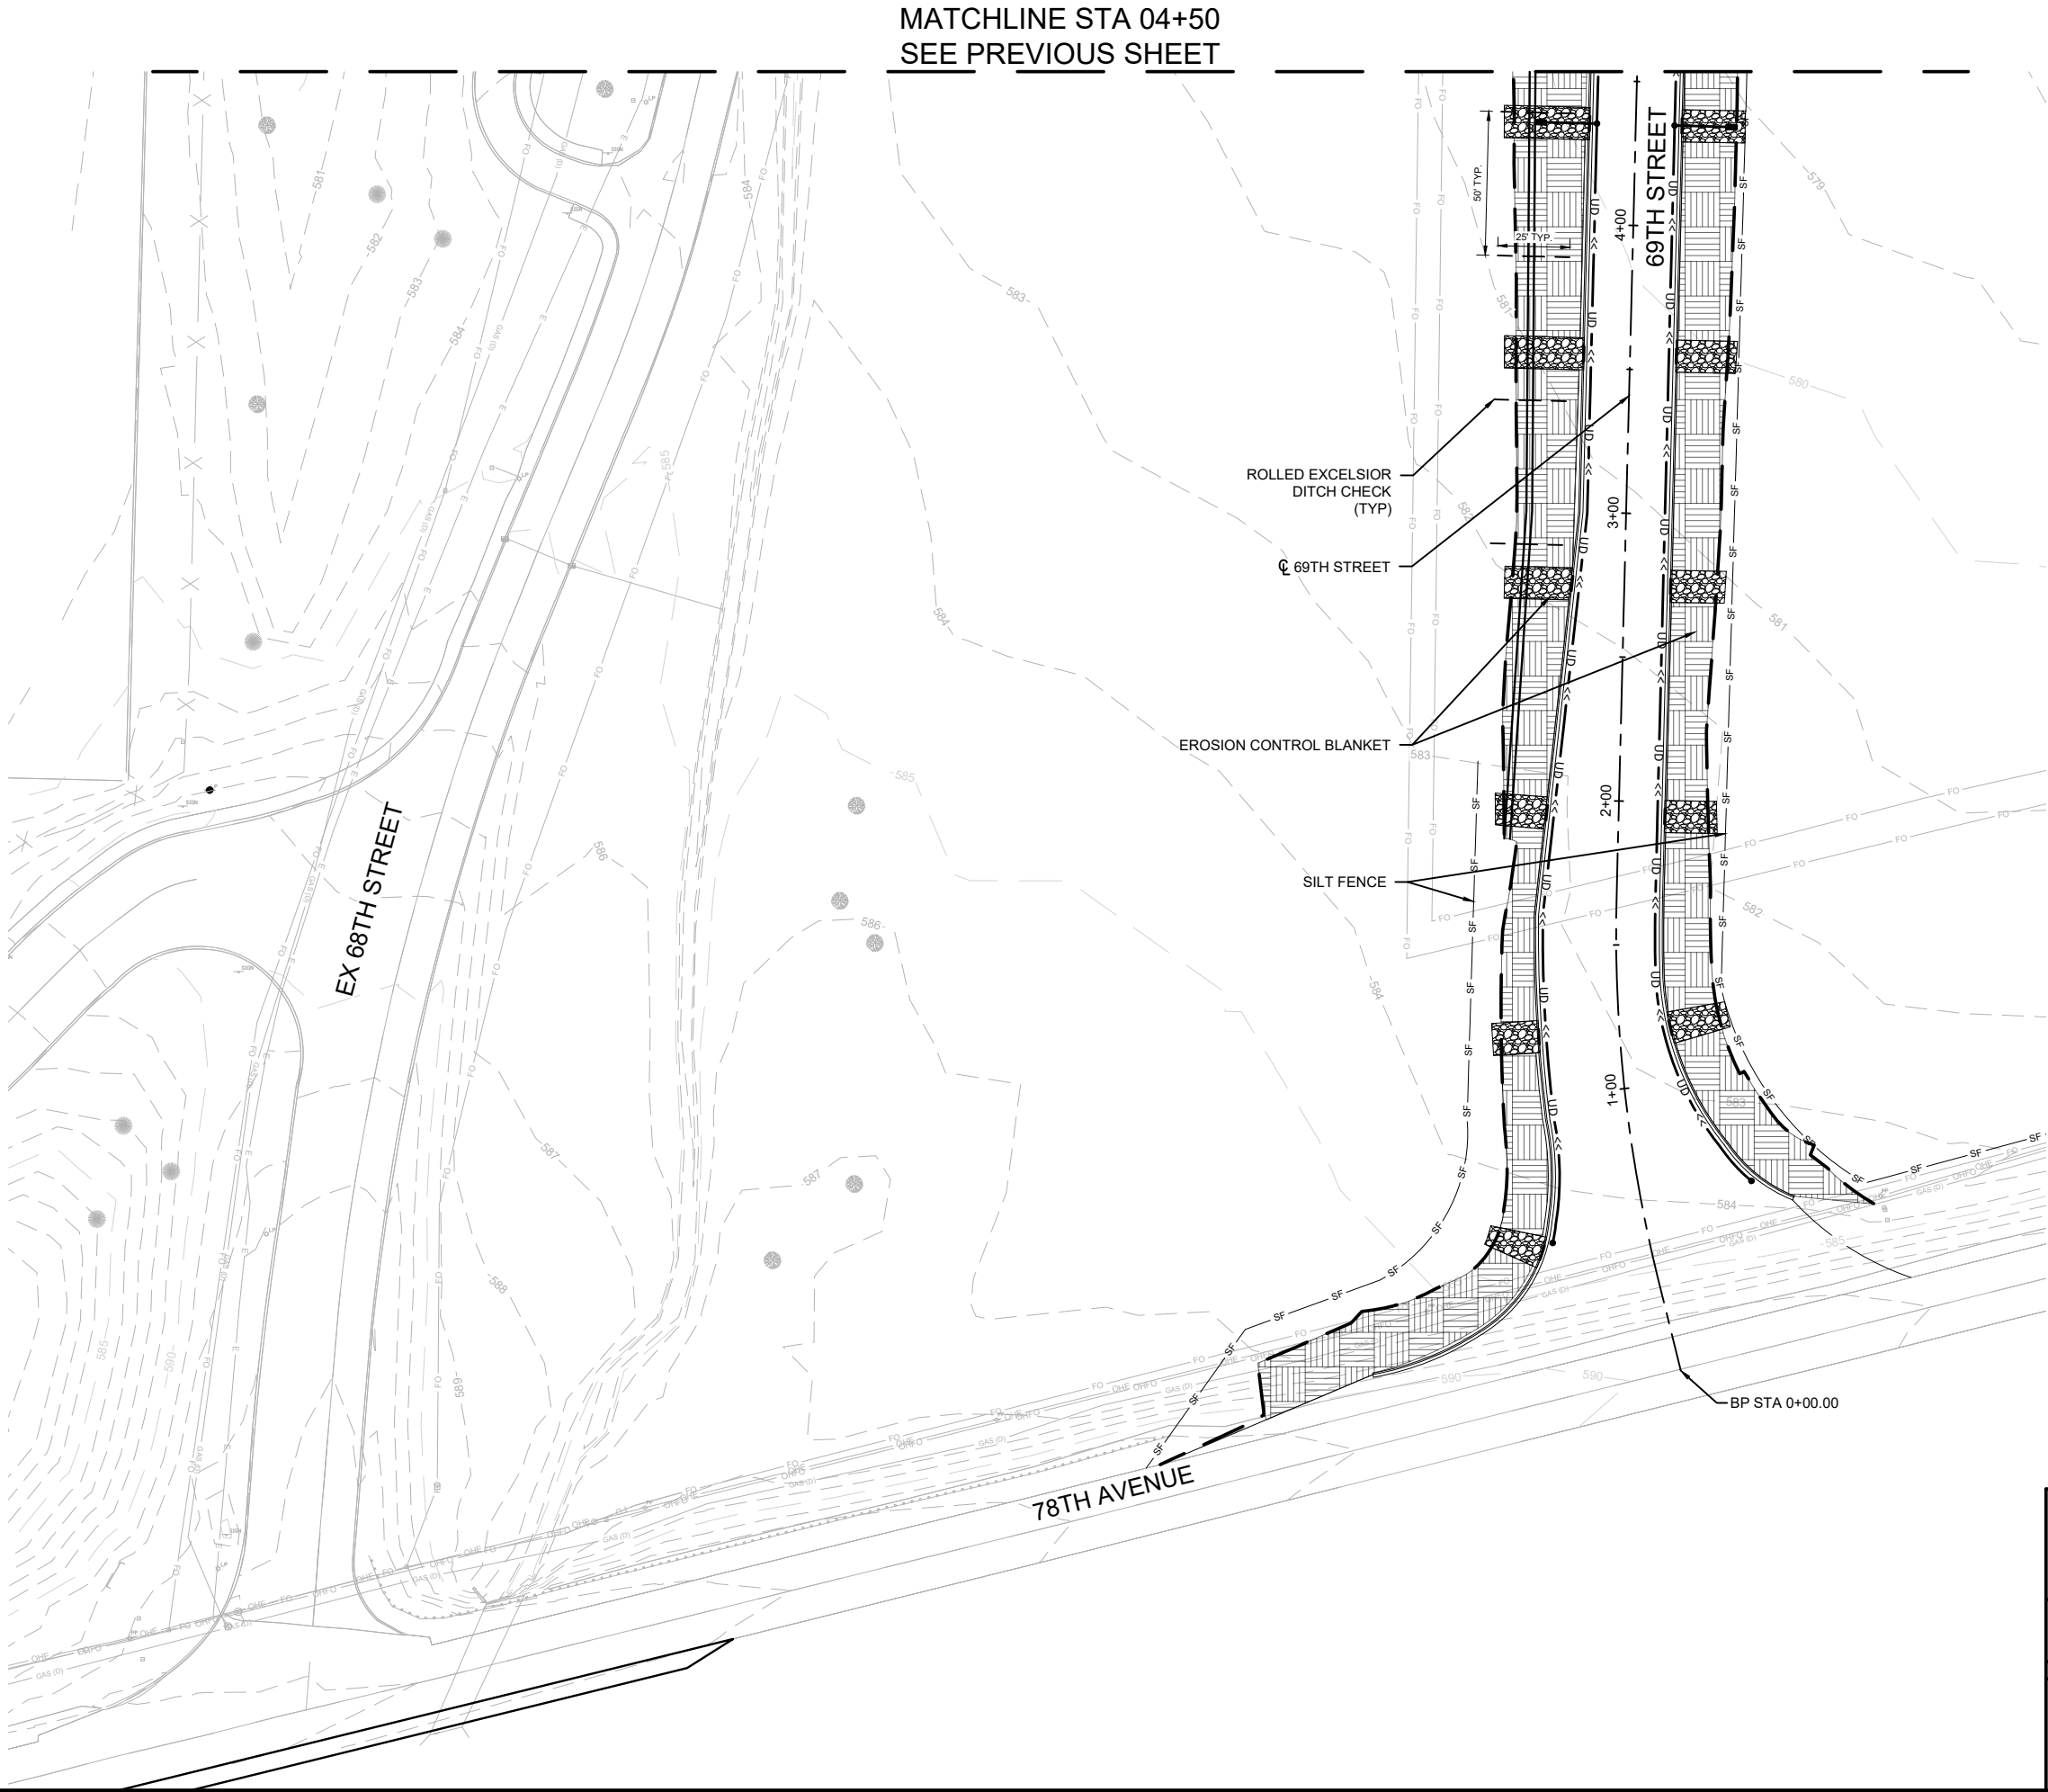


MATCHLINE STA 04+50  
SEE PREVIOUS SHEET

GENERAL NOTES

- A. SEEDING & 4" OF TOPSOIL TO BE PLACED UNDER ALL EROSION CONTROL BLANKET
- B. SEEDING & 4" OF TOPSOIL TO BE PLACED UNDER ALL FLEXAMAT.
- C. 4" OF TOPSOIL TO BE PLACED WITH ALL SEEDING.
- D. SEEDING MIXTURE TO PRODUCE TALL FESCUE TURFGRASS OR OTHER GRASS NOT ATTRACTIVE TO HAZARDOUS SPECIES OF WILDLIFE REQUIRED. SEEDING MIXTURE SUBJECT TO APPROVAL BY ENGINEER. SEE ITEM 901 SPECIAL PROVISION FOR MORE INFORMATION.
- E. FLEXAMAT TO BE FLEXAMAT PLUS OR EQUIVALENT SUBJECT TO APPROVAL BY ENGINEER.
- F. SEE CURB CUT DETAIL ON MISC DETAILS SHEET FOR FLEXAMAT DIMENSIONS & QUANTITIES NOT SHOWN ON THIS SHEET.
- G. TEMPORARY SEEDING REQUIRED PER ITEM 102.

LEGEND

- ROLLED EXCELSIOR
- FIBER ROLL DITCH CHECK
- SF SILT FENCE
- EROSION CONTROL BLANKET, SEEDING, 4" TOPSOIL
- FLEXAMAT (OR APPROVED EQUIVALENT), SEEDING, 4" TOPSOIL
- SEEDING, 4" TOPSOIL
- INLET PROTECTION (SILT FILTER BASKET)
- INLET PROTECTION (HAY BALES)

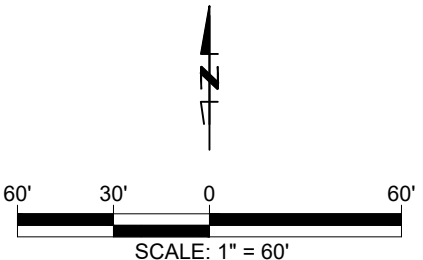

METROPOLITAN AIRPORT AUTHORITY OF ROCK ISLAND  
COUNTY (QUAD CITIES INTERNATIONAL AIRPORT)  
REALIGN THE GENERAL AVIATION  
ENTRANCE ROAD

SWPPP & EROSION CONTROL PLAN  
(2 OF 2)

CLIENT APPROVAL	CLIENT APPROVAL	PROJECT NO.
		MLI-5023
		HDR PROJECT NO.
		10404260
		SHEET NO.
		39 of 61

CONSULTANTS  
PREPARED FOR



QUAD CITIES  
INTERNATIONAL AIRPORT


4620 E 53RD STREET  
DAVENPORT, IA 52807-3620  
(563) 293-7684

NO.	DATE	DESCRIPTION	BY
		CONTRACTOR:	
		WORK STAKED BY:	DATE:
		INSPECTOR'S ACCEPTANCE BY:	DATE:
		FIELD VERIFICATION BY:	DATE:
		DRAWINGS CORRECTED BY:	DATE:

DESIGNED BY: MM  
DRAWN BY: AJ  
CHECKED BY: SM  
DATE:





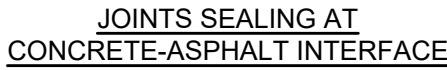

NOTE: JOINT DIMENSIONS SHALL MEET MANUFACTURER'S RECOMMENDATION.



1. UNSUITABLE MATERIAL ENCOUNTERED DURING PLACEMENT OF BEDDING SHALL BE REMOVED AND REPLACED.
2. WITHIN 3 FEET OF PAVED AREA, GRANULAR BACKFILL IS TO BE USED INSTEAD OF EARTH BACKFILL.
3. AT CONTRACTOR'S OPTION IDOT CONTROLLED LOW STRENGTH MATERIAL WITH A HIGH EARLY STRENGTH, "FLASH FILL", MAY BE USED INSTEAD OF GRANULAR TRENCH BACKFILL UNDER PAVEMENTS.

## PIPE TRENCH DETAIL

NOT TO SCALE



NOT TO SCALE

NOTE: SEE PLANS FOR LOCATIONS.

STATION	CL	SIDE	FLEXAMAT QUANTITY (SY)	
			L	R
0+50	69TH	L	19.8	—
1+20	69TH	L & R	20.0	22.8
1+95	69TH	L & R	21.0	22.6
2+75	69TH	L & R	31.9	23.8
3+55	69TH	L & R	34.4	26.0
4+35	69TH	L & R	37.0	27.3
5+15	69TH	L & R	39.0	28.3
5+95	69TH	L & R	41.0	26.6
6+75	69TH	L & R	43.3	23.6
7+55	69TH	L & R	51.1	21.8
8+35	69TH	R	—	22.6
30+70	75TH	L & R	10.0	30.9
31+50	75TH	L & R	22.7	31.1
32+30	75TH	L & R	19.8	36.3

## CONSULTANTS

**QUAD CITIES**  
INTERNATIONAL AIRPORT



NO.	DATE	DESCRIPTION	BY
AS-BUILT INFORMATION		CONTRACTOR:	
WORK STAKED BY:		DATE:	
INSPECTOR'S ACCEPTANCE BY:		DATE:	
FIELD VERIFICATION BY:		DATE:	
DRAWINGS CORRECTED BY:		DATE:	

DESIGNED BY: MM

DRAWN BY: AJ


CHECKED BY: SM

DATE:

METROPOLITAN AIRPORT AUTHORITY OF ROCK ISLAND  
COUNTY (QUAD CITIES INTERNATIONAL AIRPORT)  
REALIGN THE GENERAL AVIATION  
ENTRANCE ROAD

## ROADWAY DETAILS (1 OF 3)


CLIENT APPROVAL	CLIENT APPROVAL	PROJECT NO. MLI-5023
		HDR PROJECT NO. 10404260
		SHEET NO. <b>42 of 61</b>

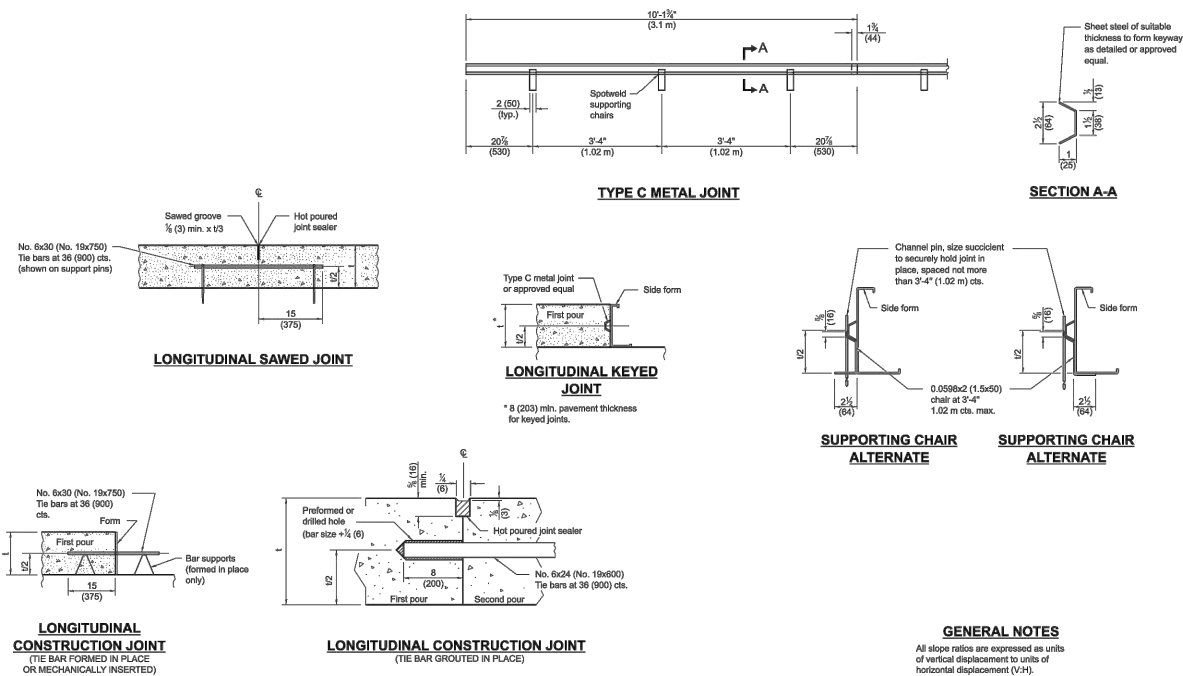

DATE	REVISIONS
1-1-22	Revised DOWEL BAR TABLE on Sheet 2.
1-1-18	Changed tie bar spacing to 36 (900) cts. Revised DOWEL BAR TABLE.

## PAVEMENT JOINTS


(Sheet 1 of 2)

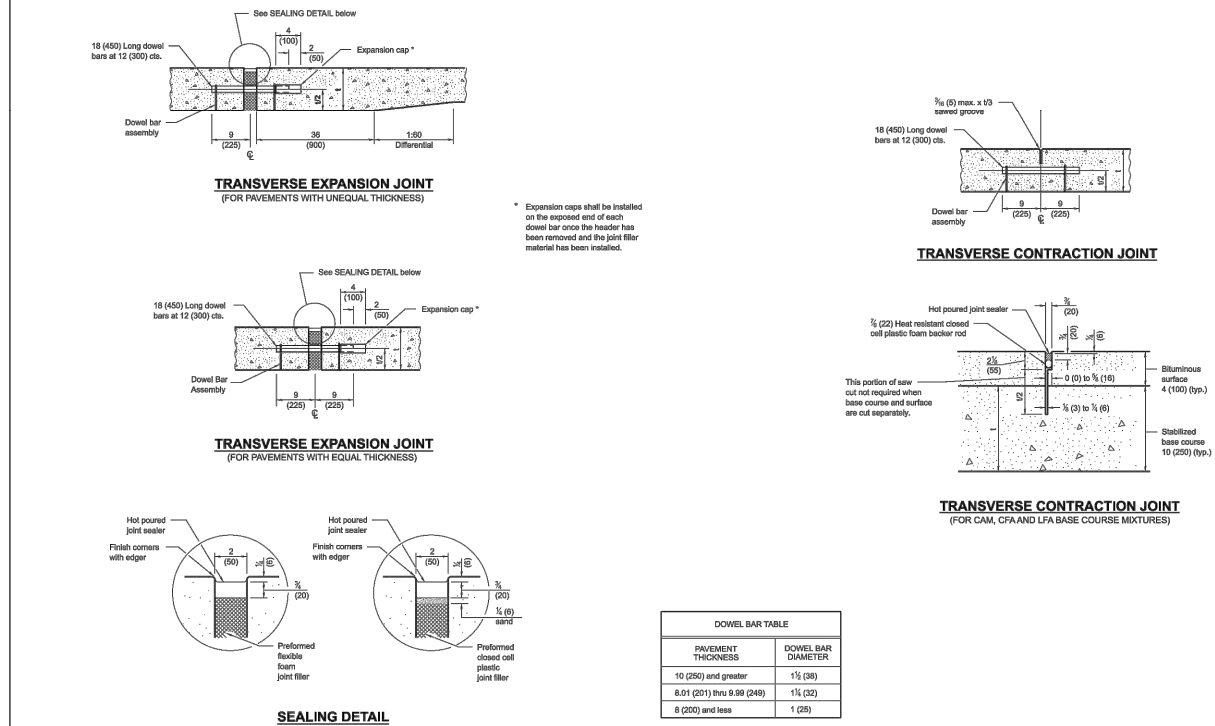**STANDARD 420001-10**

PAVEMENT THICKNESS	DOWEL BAR DIAMETER
10 (250) and greater	1½ (38)
8.01 (201) thru 9.99 (249)	1¼ (32)
6 (200) and less	1 (25)

## PAVEMENT JOINTS

(Sheet 2 of 2)

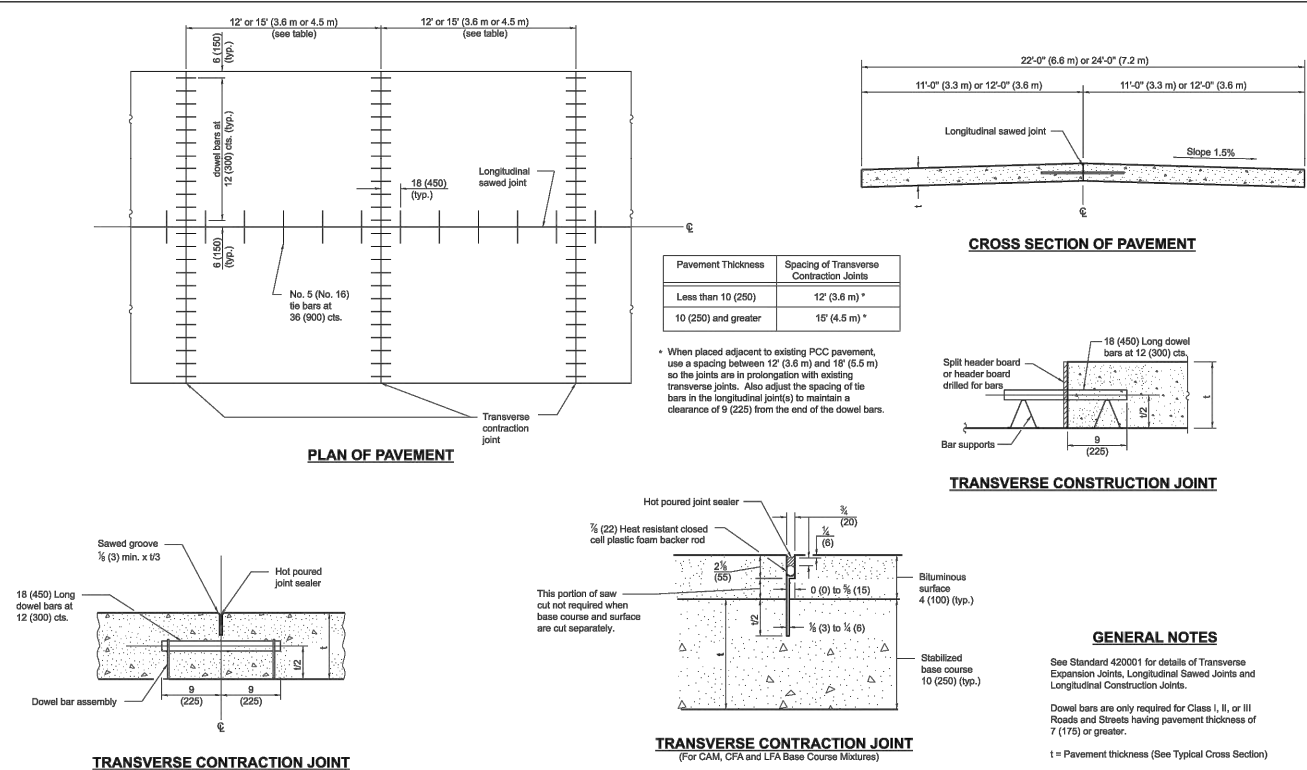**STANDARD 420001-10**

PAVEMENT THICKNESS	DOWEL BAR DIAMETER
10 (250) and greater	1½ (38)
8.01 (201) to 9.99 (249)	1¼ (32)
8 (200) and less	1 (25)

DATE	REVISIONS
1-1-22	Revised spacing of transverse contraction joints, dowel bar table and header board callout.
1-1-18	Revised dowel and tie bar sizes. Increased tie bar spacing. Eliminated skewed joint.

**PORTLAND CEMENT CONCRETE  
PAVEMENT (NONREINFORCED)**

STANDARD B.L.R. 14-13

[illegible]

DESIGNED BY: MM

DRAWN BY: A.J



CHECKED BY: SM

DATE:

METROPOLITAN AIRPORT AUTHORITY OF ROCK ISLAND  
COUNTY (QUAD CITIES INTERNATIONAL AIRPORT)  
REALIGN THE GENERAL AVIATION  
ENTRANCE ROAD

## ROADWAY DETAILS (2 OF 3)

CLIENT APPROVAL	CLIENT APPROVAL	PROJECT NO. MLI-5023
		HDR PROJECT NO. 10404260
		SHEET NO. <b>43 of 61</b>

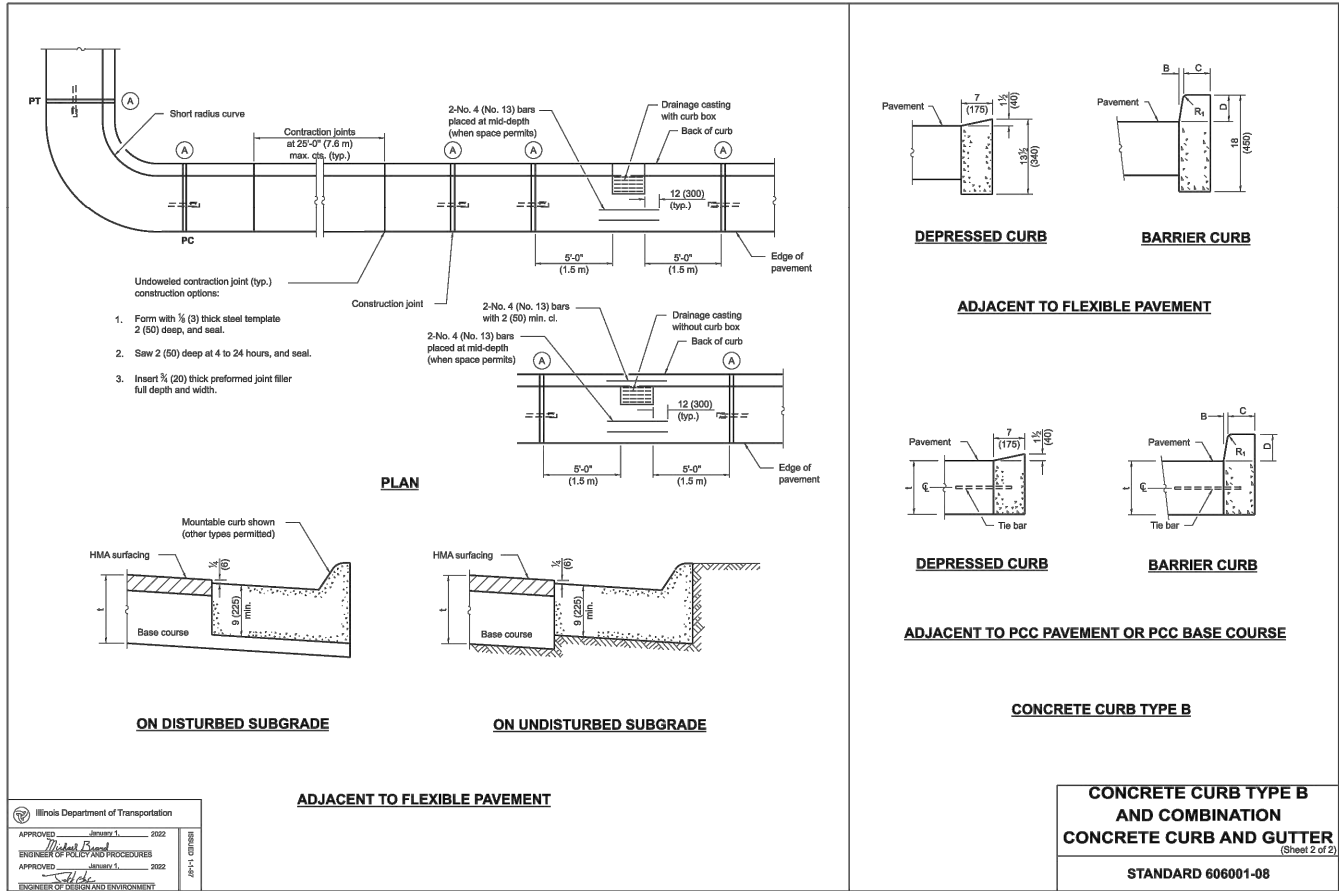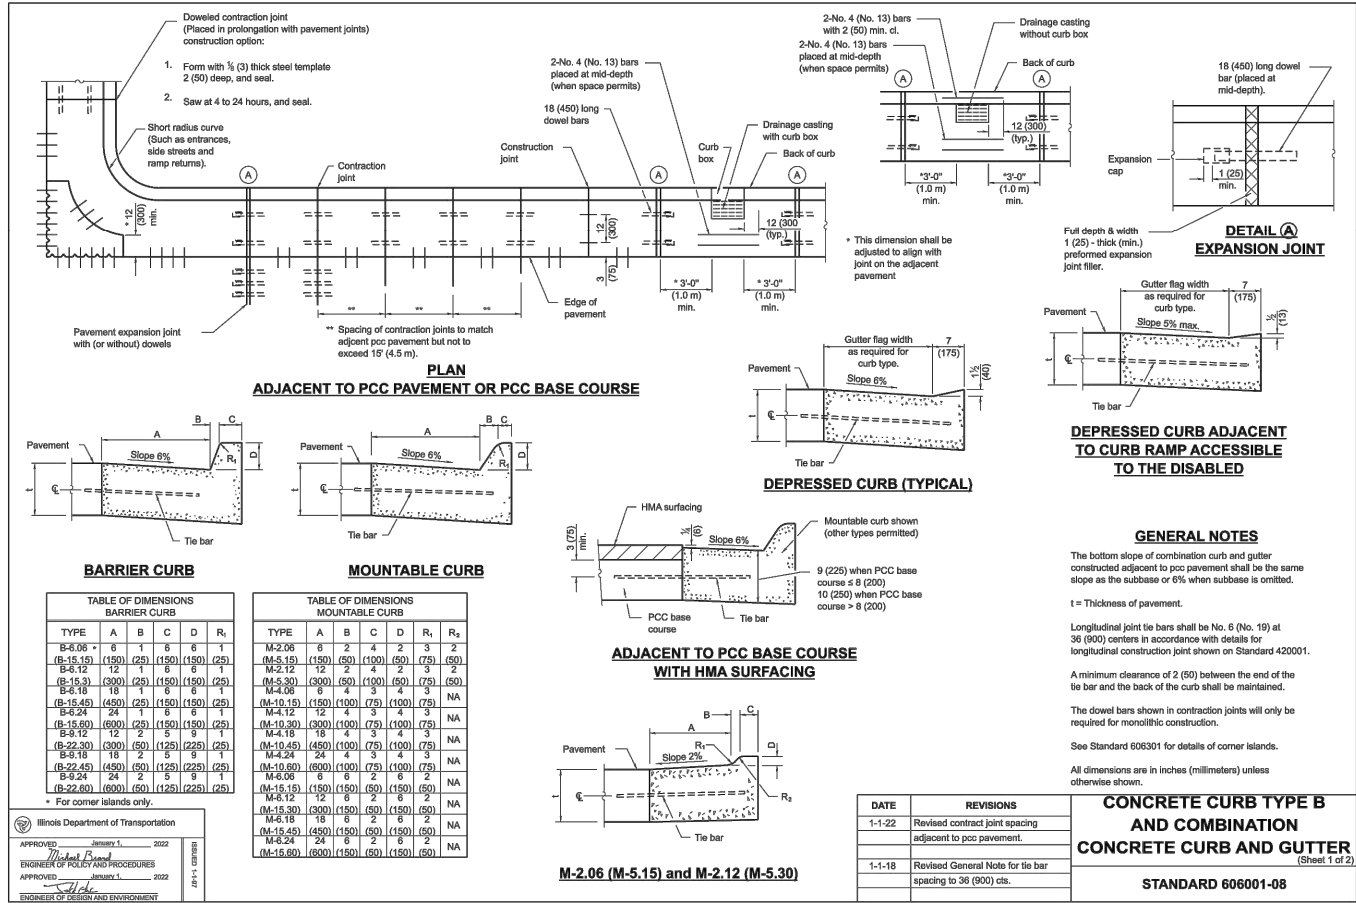

NO.	DATE	DESCRIPTION	BY
		AS-BUILT INFORMATION	
		CONTRACTOR:	
		WORK STAKED BY:	
		INSPECTOR'S ACCEPTANCE BY:	
		FIELD VERIFICATION BY:	
		DRAWINGS CORRECTED BY:	

DESIGNED BY: MM  
DRAWN BY: AJ  
CHECKED BY: SM  
DATE:

METROPOLITAN AIRPORT AUTHORITY OF ROCK ISLAND COUNTY (QUAD CITIES INTERNATIONAL AIRPORT) REALIGN THE GENERAL AVIATION ENTRANCE ROAD	
ROADWAY DETAILS (3 OF 3)	
CLIENT APPROVAL	CLIENT APPROVAL
PROJECT NO. MLI-5023	
HDR PROJECT NO. 10404260	
SHEET NO. 44 of 61	

CONSULTANTS

4620 E 53RD STREET  
DAVENPORT, IA 52807-3620  
(563) 293-7684

PREPARED FOR

[illegible]


DATE \_\_\_\_\_

METROPOLITAN AIRPORT AUTHORITY OF ROCK ISLAND  
COUNTY (QUAD CITIES INTERNATIONAL AIRPORT)  
REALIGN THE GENERAL AVIATION  
ENTRANCE ROAD


## PAVEMENT MARKING & SIGNING DETAILS

CLIENT APPROVAL	CLIENT APPROVAL	PROJECT NO.
		MLI-5023
		HDR PROJECT NO. 10404260
		SHEET NO. <b>45 of 61</b>

Illinois Department of Transportation  
PASSED *Michael Bond* 2014  
ENGINEER OF POLICY AND PROCEDURES  
APPROVED *Michael Bond* 2014  
ENGINEER OF DESIGN AND ENVIRONMENT

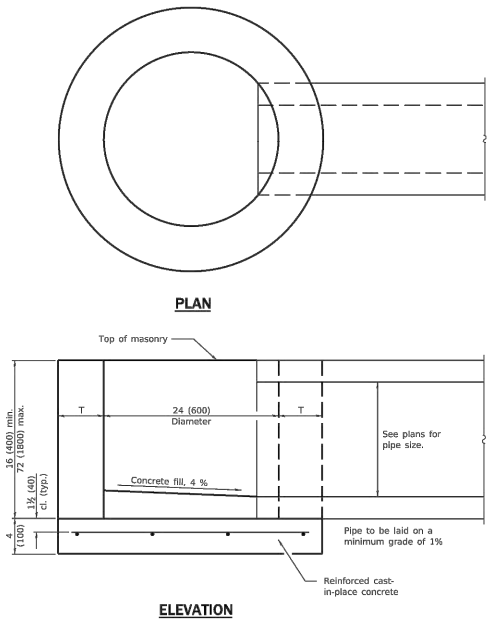

ALTERNATE MATERIALS FOR WALLS	T
BRICK MASONRY	9 (200)
CAST-IN-PLACE CONCRETE	6 (150)
CONCRETE MASONRY UNIT	5 (125)
PRECAST REINFORCED CONCRETE SECTION	3 (75)

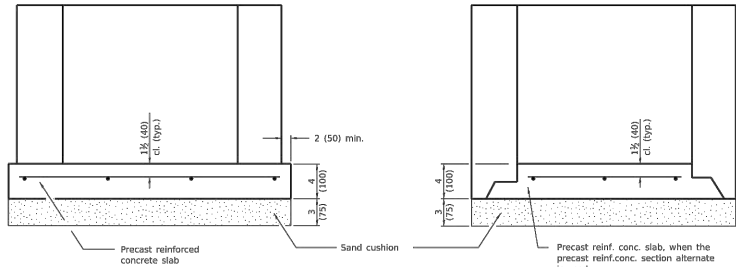

#### ALTERNATE METHODS

#### GENERAL NOTES

Bottom slabs shall be reinforced with a minimum of 0.24 sq. in./ft. (510 sq. mm/m) in both directions with a maximum spacing of 10 (250).

Bottom slabs may be connected to the riser as determined by the fabricator; however, only a single row of reinforcement around the perimeter may be utilized.


All dimensions are in inches (millimeters) unless otherwise shown.

DATE	REVISIONS
1-1-14	Increased height to 72 (1800) maximum.
1-1-11	Detailed rein. in slabs.
	Added max. limit to height.
	Added general notes.

#### INLET - TYPE A


STANDARD 602301-04

Illinois Department of Transportation  
PASSED *Michael Bond* 2021  
ENGINEER OF POLICY AND PROCEDURES  
APPROVED *Michael Bond* 2021  
ENGINEER OF DESIGN AND ENVIRONMENT

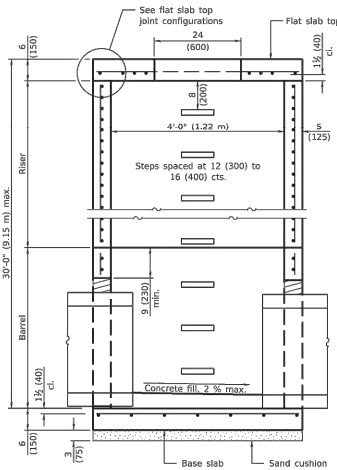


#### SECTION PARALLEL TO PIPE

(Without conical top riser)

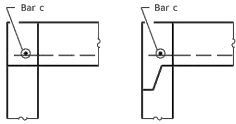

#### FLAT SLAB TOP JOINT CONFIGURATIONS

(Shown at access hole)

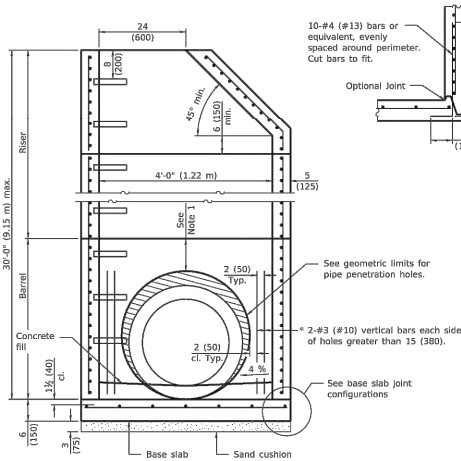

#### SECTION PERPENDICULAR TO PIPE

(With conical top riser)

\* As an alternate, the barrel wall reinforcement may be reduced to riser wall reinforcement with #3 (#10) bars placed around the pipe penetration holes as shown. This option may be utilized when the pipe penetration holes are formed as opposed to corrd.

#### GEOMETRIC LIMITS FOR PIPE PENETRATION HOLES

Note 1: A minimum of 9 (230) of monolithic reinforced concrete shall be maintained above pipe penetration holes > 24 (600).


Note 2: A minimum 12 (300) inside arc length of reinforced concrete shall be maintained between pipe penetration holes > 15 (380).

Note 3: A maximum of 60 percent of the inside perimeter of the reinforced concrete manhole walls may be removed.


Note 4: Horizontal joints that intersect pipe penetration holes > 15 (380) shall have one joint splice for every location around the perimeter of the joint where the inside arc length between pipe penetration holes is < 24 (600). See joint splice detail.

Note 5: The recommended pipe penetration hole is equal to the O.D. of the pipe plus 4 (100).

Note 6: Only pipe penetration holes ≤ 15 (380) are allowed in riser sections.

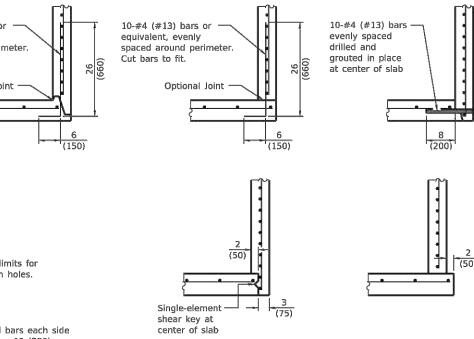

#### BASE SLAB JOINT CONFIGURATIONS

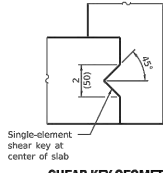

#### SHEAR KEY GEOMETRY

(Reinforcement not shown for clarity)

#### GENERAL NOTES

The manufacturer shall ensure that all precast manhole sections are additionally reinforced where required to resist damage from handling, shipping and installation stresses.

Lifting holes shall be located in the sections as per the manufacturer's recommendations.

See Standard 602701 for details of manhole steps.


All dimensions are in inches (millimeters) unless otherwise noted.

DATE	REVISIONS
1-1-21	Revised Note 1 and lifting hole general note.
3-1-19	Moved wall reinforcement from inside face to midline.


#### PRECAST MANHOLE TYPE A

4' (1.22 m) DIAMETER

(Sheet 1 of 2)  
STANDARD 602401-07

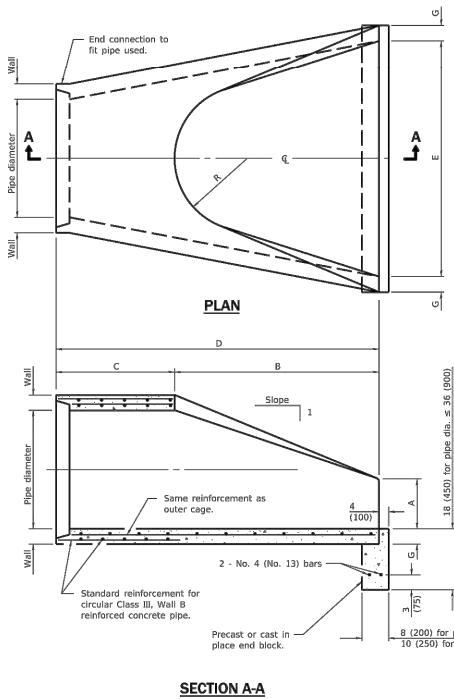

#### SECTION A-A

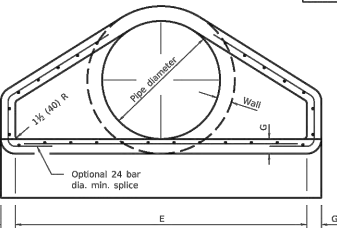

#### END VIEW

PIPE DIA.	APPROX. QTY. lbs. (kg)	WALL	A	B	C	D	E	G	R	APPROX. SLOPE
12 (300)	530 (240)	2 (51)	4 (102)	24 (610)	6'-0 3/4" (1.841 m)	6'-0 3/4" (1.851 m)	24 (610)	2 (51)	9 (229)	1:2.4
15 (375)	740 (335)	2 1/2 (57)	6 (152)	27 (686)	3'-10" (1.168 m)	6'-1" (1.854 m)	30 (762)	2 1/2 (57)	11 (280)	1:2.4
18 (450)	990 (450)	2 1/2 (64)	9 (229)	27 (686)	3'-10" (1.168 m)	6'-1" (1.854 m)	36 (914)	2 1/2 (64)	12 (305)	1:2.4
21 (525)	1280 (580)	2 1/2 (70)	9 (229)	35 (889)	6'-1" (1.854 m)	3'-6" (1.067 m)	36 (914)	2 1/2 (64)	13 (330)	1:2.4
24 (600)	1520 (690)	3 (76)	9 1/2 (241)	30 (762)	6'-1 1/2" (1.867 m)	4'-0" (1.219 m)	36 (914)	3 (76)	14 (356)	1:2.5
27 (675)	1930 (875)	3 1/2 (83)	10 1/2 (267)	30 (762)	6'-1 1/2" (1.867 m)	4'-0" (1.219 m)	36 (914)	3 1/2 (83)	14 1/2 (368)	1:2.4
30 (750)	2190 (995)	3 1/2 (89)	12 (305)	30 (762)	6'-1 1/2" (1.867 m)	5'-0" (1.524 m)	36 (914)	3 1/2 (89)	15 (381)	1:2.5
33 (825)	3200 (1450)	3 1/2 (95)	13 1/2 (343)	30 (762)	6'-1 1/2" (1.867 m)	5'-0" (1.524 m)	36 (914)	3 1/2 (95)	17 1/2 (445)	1:2.5
36 (900)	4100 (1860)	4 (102)	15 (381)	30 (762)	6'-1 1/2" (1.867 m)	6'-0" (1.829 m)	36 (914)	4 (102)	20 (508)	1:2.5
42 (1050)	5380 (2440)	4 1/2 (114)	21 (533)	35 (889)	6'-2" (1.881 m)	6'-0" (1.829 m)	36 (914)	4 1/2 (114)	22 (559)	1:2.5
48 (1200)	6550 (2970)	5 (127)	24 (610)	35 (889)	6'-2" (1.881 m)	7'-0" (2.134 m)	36 (914)	5 (127)	22 (559)	1:2.5
54 (1350)	8240 (3740)	5 1/2 (140)	27 (686)	35 (889)	6'-2" (1.881 m)	7'-0" (2.134 m)	36 (914)	5 1/2 (140)	24 (610)	1:2.0
60 (1500)	8730 (3960)	6 (152)	30 (762)	35 (889)	6'-2" (1.881 m)	7'-0" (2.134 m)	36 (914)	6 (152)	*	1:1.9
66 (1650)	10710 (4860)	6 1/2 (165)	30 (762)	35 (889)	6'-2" (1.881 m)	7'-0" (2.134 m)	36 (914)	6 1/2 (165)	*	1:1.7
72 (1800)	12520 (5680)	7 (178)	36 (914)	35 (889)	6'-2" (1.881 m)	7'-0" (2.134 m)	36 (914)	7 (178)	*	1:1.8
78 (1950)	14770 (6700)	7 1/2 (191)	36 (914)	35 (889)	6'-2" (1.881 m)	7'-0" (2.134 m)	36 (914)	7 1/2 (191)	*	1:1.8
84 (2100)	18160 (8240)	8 (203)	36 (914)	35 (889)	6'-2" (1.881 m)	7'-0" (2.134 m)	36 (914)	8 (203)	*	1:1.6

\* Radius as furnished by manufacturer

#### GENERAL NOTES

All slope ratios are expressed as units of vertical displacement to units of horizontal displacement (V:H).

All dimensions are in inches (millimeters) unless otherwise shown.

DATE	REVISIONS
1-1-11	Clarified ref. to pipe dia. on Section A-A. Changed 'inner' to 'outer' cage ref.
1-1-09	Switched units to English (metric).

#### PRECAST REINFORCED CONCRETE FLARED END SECTION

STANDARD 542301-03

Illinois Department of Transportation  
APPROVED *Michael Bond* 2011  
ENGINEER OF BRIDGES AND STRUCTURES  
APPROVED *Michael Bond* 2011  
ENGINEER OF DESIGN AND ENVIRONMENT

CONSULTANTS

PREPARED FOR



**FCR**

4620 E 53RD STREET  
DAVENPORT, IA 52807-3620  
(563) 293-7684

NO.	DATE	DESCRIPTION	BY
		CONTRACTOR	
		WORK STAKED BY:	DATE:
		INSPECTOR'S ACCEPTANCE BY:	DATE:
		FIELD VERIFICATION BY:	DATE:
		DRAWINGS CORRECTED BY:	DATE:

DESIGNED BY: MM

DRAWN BY: AJ

CHECKED BY: SM

DATE:

METROPOLITAN AIRPORT AUTHORITY OF ROCK ISLAND  
COUNTY (QUAD CITIES INTERNATIONAL AIRPORT)  
REALIGN THE GENERAL AVIATION  
ENTRANCE ROAD

#### DRAINAGE DETAILS (1 OF 5)

CLIENT APPROVAL

CLIENT APPROVAL

PROJECT NO.

MLI-5023

HDR PROJECT NO.

10404260


SHEET NO.

46 of 61

## 47 of 61


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Drawing Name: 304MISCDETAILS 1.dwg

Illinois Department of Transportation  
PASSED January 3, 2021  
ENGINEER OF POLICY AND PROCEDURES  
APPROVED January 3, 2021  
ENGINEER OF DESIGN AND ENVIRONMENT

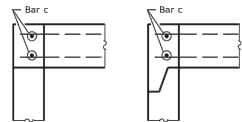


FLAT SLAB TOP JOINT CONFIGURATIONS  
(Shown at access hole)

SECTION PARALLEL TO PIPE  
(Without conical top riser)

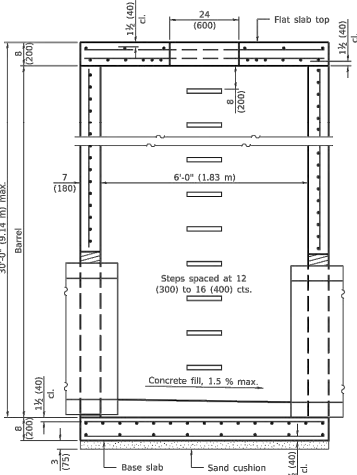


SECTION PERPENDICULAR TO PIPE  
(With conical top riser)

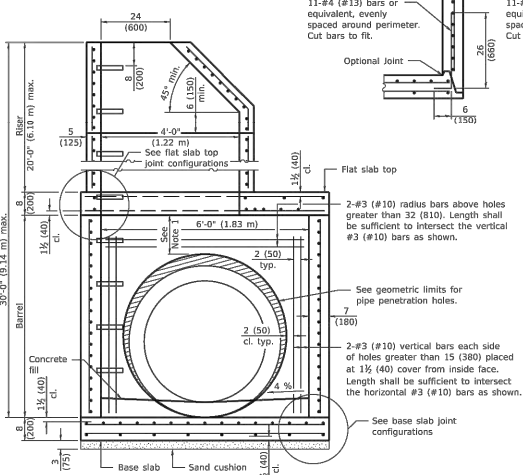

GEOMETRIC LIMITS FOR PIPE PENETRATION HOLES

- Note 1: A minimum of 9 (230) of monolithic reinforced concrete shall be maintained above pipe penetration holes > 32 (810).
- Note 2: A minimum 12 (300) inside arc length of reinforced concrete shall be maintained between pipe penetration holes > 15 (380).
- Note 3: A maximum of 60 percent of the inside perimeter of the reinforced concrete manhole walls may be removed.
- Note 4: Horizontal joints that intersect pipe penetration holes > 15 (380) shall have one joint splice for every location around the perimeter of the joint where the inside arc length between pipe penetration holes is < 24 (600). See joint splice detail.
- Note 5: The recommended pipe penetration hole is equal to the O.D. of the pipe plus 4 (100).
- Note 6: Only pipe penetration holes ≤ 15 (380) are allowed in riser sections.

SHEAR KEY GEOMETRY  
(Reinforcement not shown for clarity)

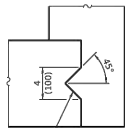

Single-element shear key at center of slab

GENERAL NOTES

Pipe holes shall be formed to facilitate proper placement of hole reinforcement.

The manufacturer shall ensure that all precast manhole sections are additionally reinforced where required to resist damage from handling, shipping and installation stresses.

Lifting holes shall be located in the sections as per the manufacturer's recommendations.

See Standard 602701 for details of manhole steps.


All dimensions are in inches (millimeters) unless otherwise noted.

DATE	REVISIONS
1-1-21	Revised Note 1, Note 2 and lifting hole general note.
3-1-19	Moved wall reinforcement from inside face to middle.


PRECAST MANHOLE TYPE A  
6' (1.83 m) DIAMETER  
(Sheet 1 of 3)

STANDARD 602406-11


Illinois Department of Transportation  
PASSED January 3, 2021  
ENGINEER OF POLICY AND PROCEDURES  
APPROVED January 3, 2021  
ENGINEER OF DESIGN AND ENVIRONMENT

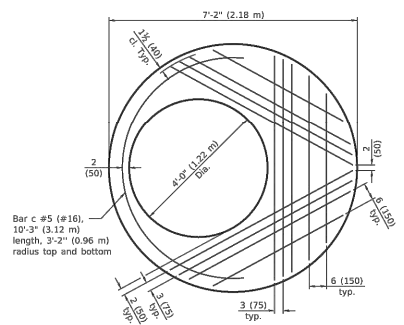

PLAN - FLAT SLAB TOP  
(Showing layout of bottom reinforcement bars and c bars)

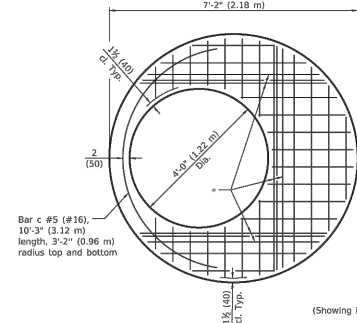


PLAN - FLAT SLAB TOP  
(Showing layout of welded wire reinforcement and c bars)

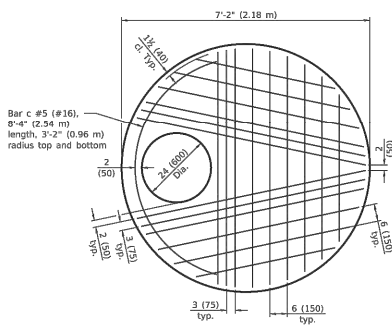


\* #5 (#16) bars for risers ≤ 10 ft. (3.05 m) tall or #6 (#19) bars for risers > 10 ft. (3.05 m) tall bottom. Bundle first bar with closest WWR bar to the opening and place second bar ±3 (75) away.

PRECAST MANHOLE TYPE A  
6' (1.83 m) DIAMETER  
(Sheet 2 of 3)


STANDARD 602406-11

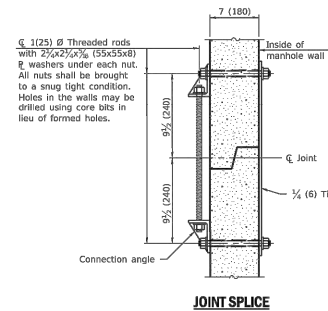

JOINT SPLICE

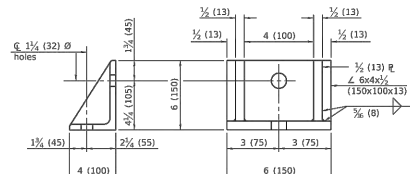

CONNECTION ANGLE

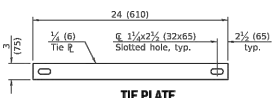

TIE PLATE

FLAT SLAB TOP REINFORCEMENT

Location	Riser Height (RH)	WWR (each direction)		Rebar (each direction except as noted)		Bar Size
		A <sub>s</sub> (min.)	Spacing (max.)	A <sub>s</sub> (min.)	Spacing (max.)	
Top Mat	All	0.11 sq. in./ft. (233 sq. mm/m)	18 (450)	0.11 sq. in./ft. (233 sq. mm/m)	18 (450)	#3 or #4 (#10) (#13)
Bottom Mat	RH ≤ 10 ft. (3.05 m)	** 0.82 sq. in./ft. (1812 sq. mm/m)	6 (150)	See plan view for rebar orientation and spacing and this table for bar size		#5 (#16)
	RH > 10 ft. (3.05 m)	** 0.88 sq. in./ft. (1963 sq. mm/m)	6 (150)			#6 (#19)

\*\* Only one layer of WWR permitted to avoid congestion.

WALL REINFORCEMENT

Location	Orientation	WWR or Rebar	
		A <sub>s</sub> (min.)	Spacing (max.)
4 ft. (1.22 m) Ø Riser	Circumferential	0.12 sq. in./ft. (254 sq. mm/m)	6 (150)
	Vertical	0.045 sq. in./ft. (95 sq. mm/m)	200
6 ft. (1.83 m) Ø Barrel	Circumferential	0.18 sq. in./ft. (381 sq. mm/m)	6 (150)
	Vertical	0.045 sq. in./ft. (95 sq. mm/m)	200

BASE SLAB REINFORCEMENT

Location	Riser Height (RH) Total Height (TH)	WWR or Rebar (each direction)	
		A <sub>s</sub> (min.)	Spacing (max.)
Top Mat	RH ≤ 10 ft. (3.05 m) 6 TH ≤ 20 ft. (6.10 m)	0.26 sq. in./ft. (593 sq. mm/m)	6 (150)
	RH > 10 ft. (3.05 m) or TH > 20 ft. (6.10 m)	0.40 sq. in./ft. (847 sq. mm/m)	6 (150)
Bottom Mat	All	0.11 sq. in./ft. (233 sq. mm/m)	18 (450)

PRECAST MANHOLE TYPE A  
6' (1.83 m) DIAMETER  
(Sheet 3 of 3)

STANDARD 602406-11

Illinois Department of Transportation  
PASSED January 3, 2021  
ENGINEER OF POLICY AND PROCEDURES  
APPROVED January 3, 2021  
ENGINEER OF DESIGN AND ENVIRONMENT

CONSULTANTS

PREPARED FOR



4620 E 53RD STREET  
DAVENPORT, IA 52807-3620  
(563) 293-7684

NO.	DATE	DESCRIPTION	BY
		CONTRACTOR:	
		WORK STAKED BY:	
		INSPECTOR'S ACCEPTANCE BY:	
		FIELD VERIFICATION BY:	
		DRAWINGS CORRECTED BY:	

DESIGNED BY: MM

DRAWN BY: AJ



CHECKED BY: SM

DATE:

METROPOLITAN AIRPORT AUTHORITY OF ROCK ISLAND  
COUNTY (QUAD CITIES INTERNATIONAL AIRPORT)  
REALIGN THE GENERAL AVIATION  
ENTRANCE ROAD

DRAINAGE DETAILS (3 OF 5)

CLIENT APPROVAL	CLIENT APPROVAL	PROJECT NO.
		MLI-5023
		HDR PROJECT NO.
		10404260
		SHEET NO.
		48 of 61

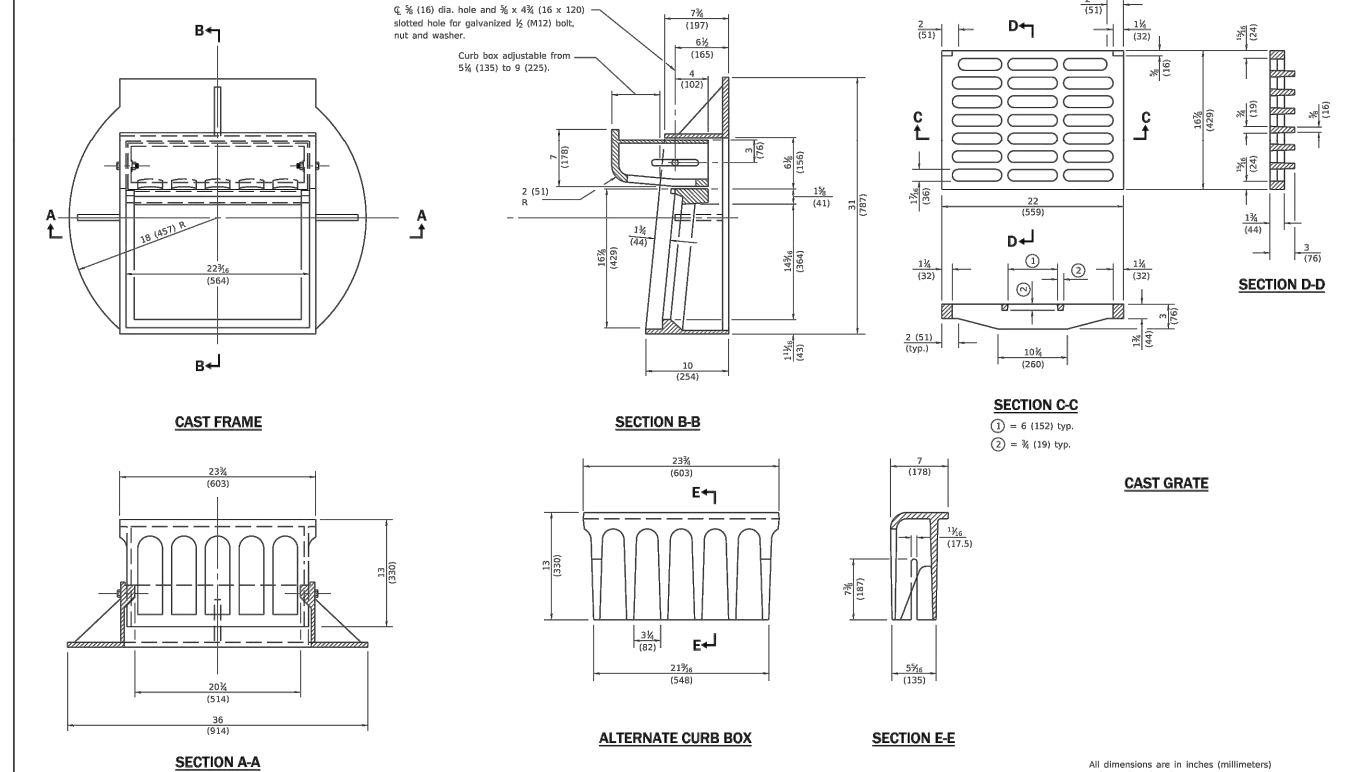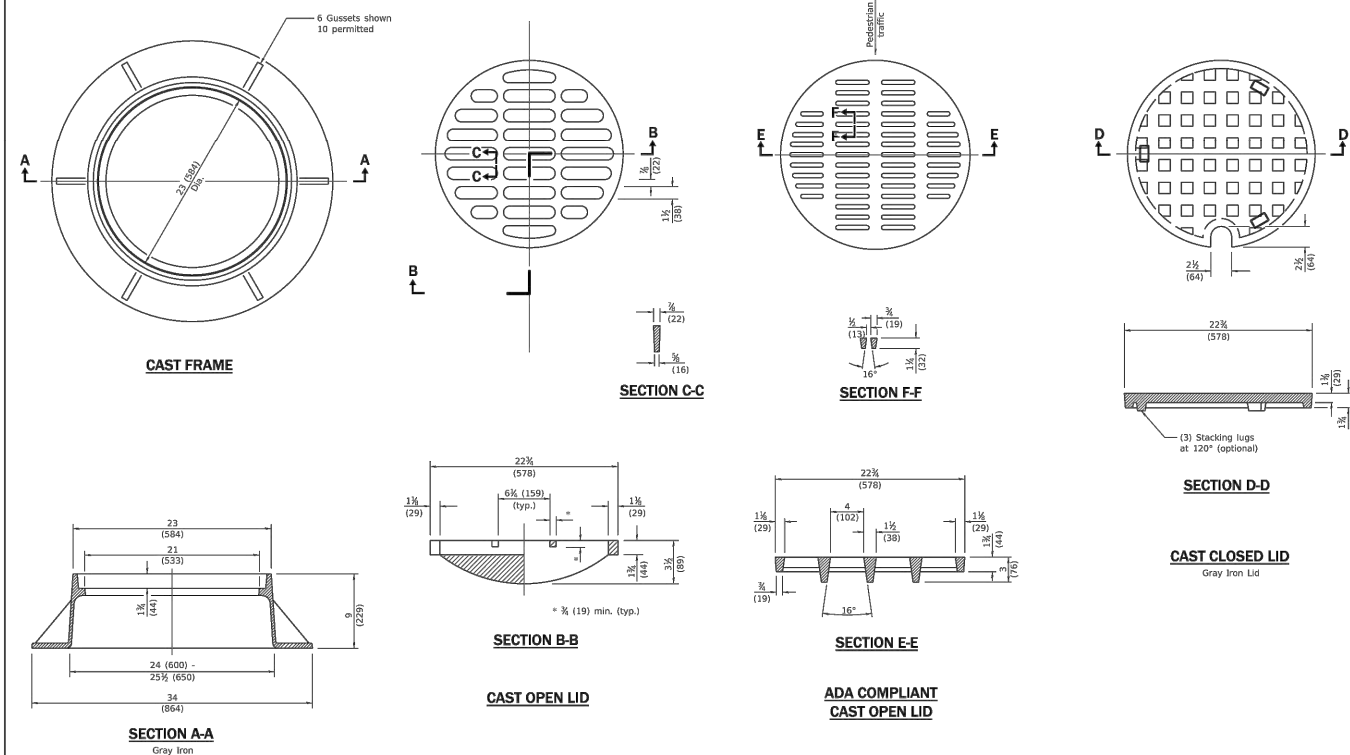

## CONSULTANTS



4620 E 53RD STREET  
DAVENPORT, IA 52807-3620  
(563) 293-7684



PREPARED FOR

[illegible]

DESIGNED BY: MM

DRAWN BY: AJ



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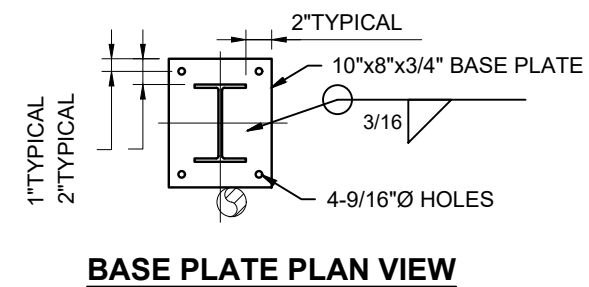
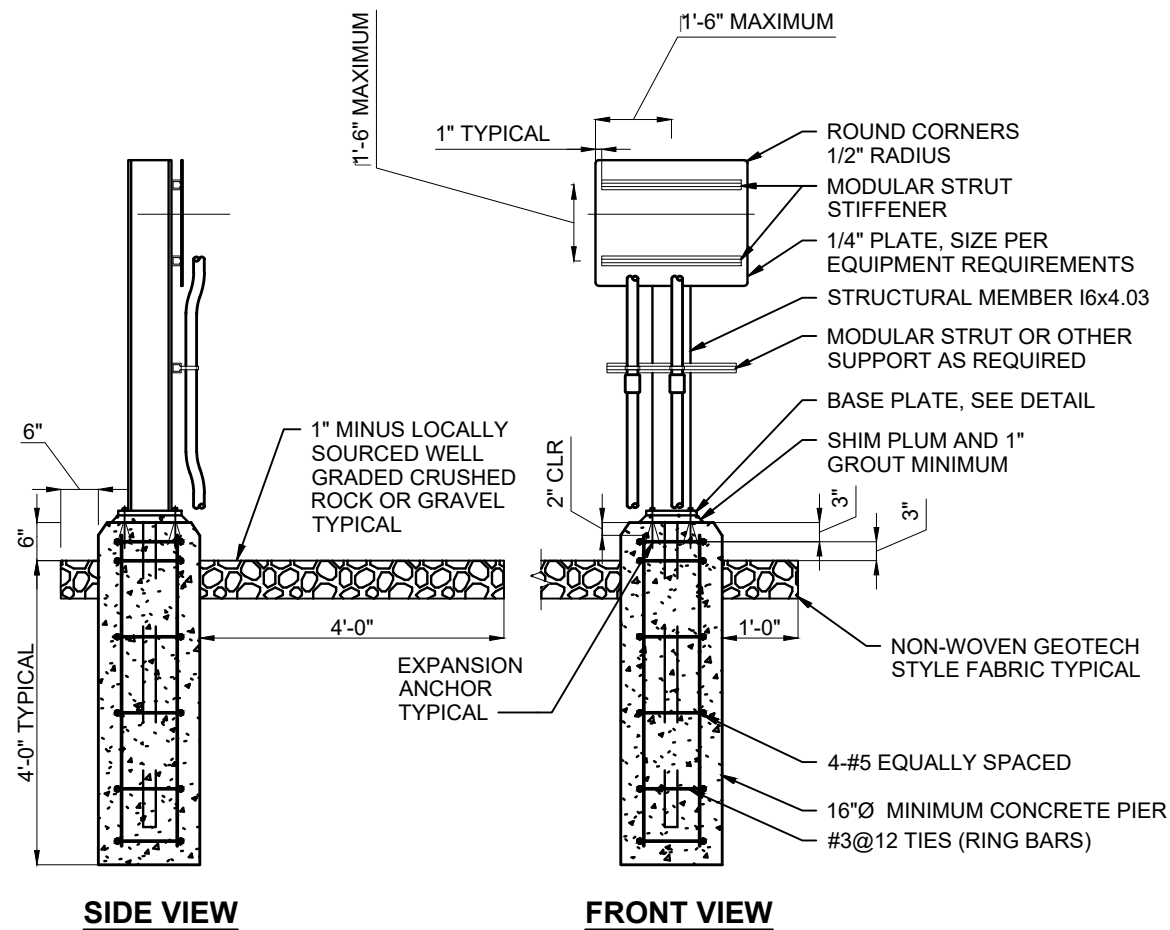
DATE:

METROPOLITAN AIRPORT AUTHORITY OF ROCK ISLAND  
COUNTY (QUAD CITIES INTERNATIONAL AIRPORT)  
REALIGN THE GENERAL AVIATION  
ENTRANCE ROAD

DRAINAGE DETAILS (4 OF 5)

CLIENT APPROVAL	CLIENT APPROVAL	PROJECT NO. MLI-5023
		HDR PROJECT NO. 10404260
		SHEET NO. <b>49 of 61</b>



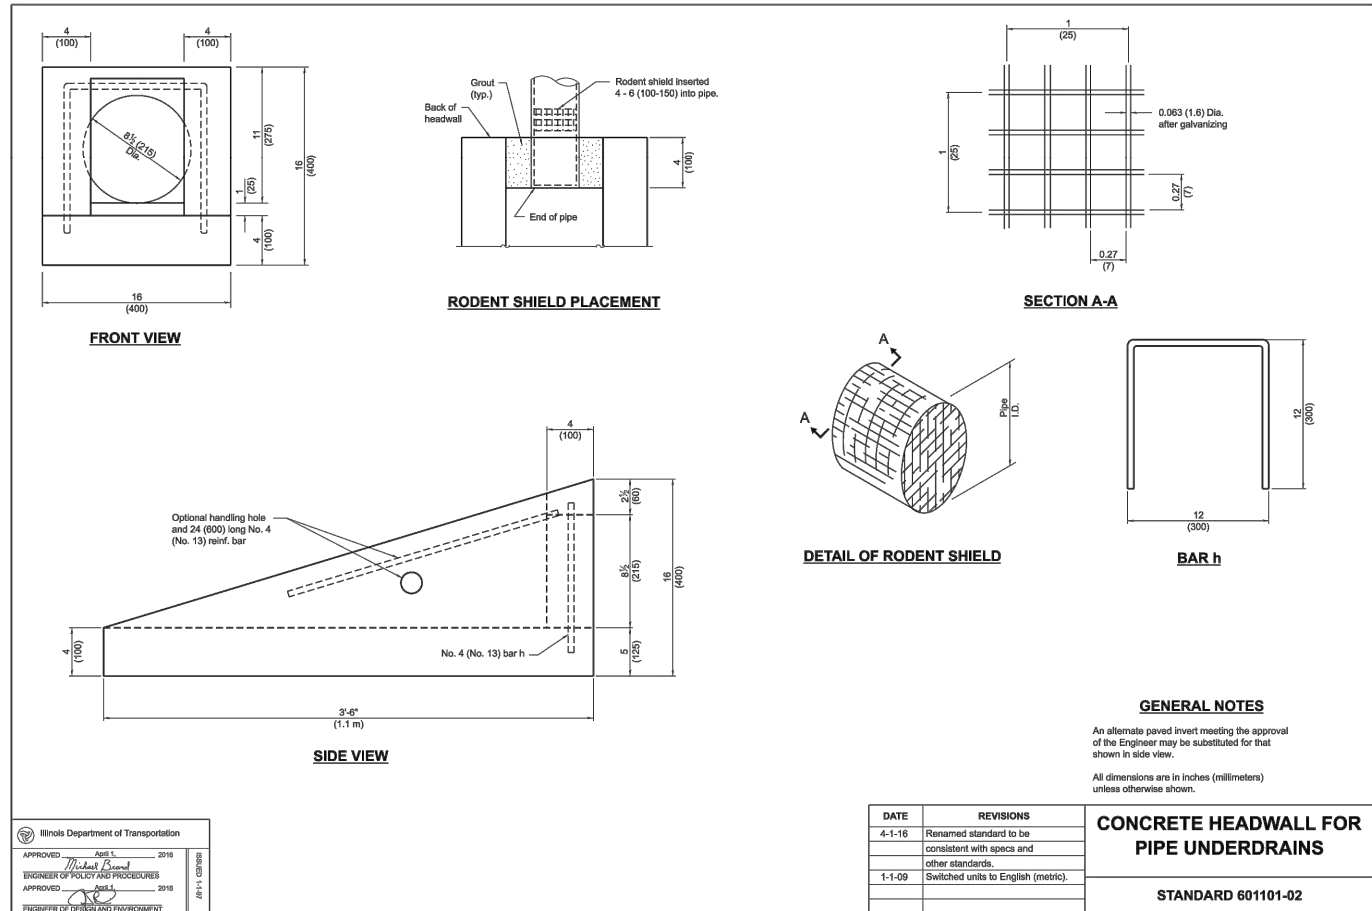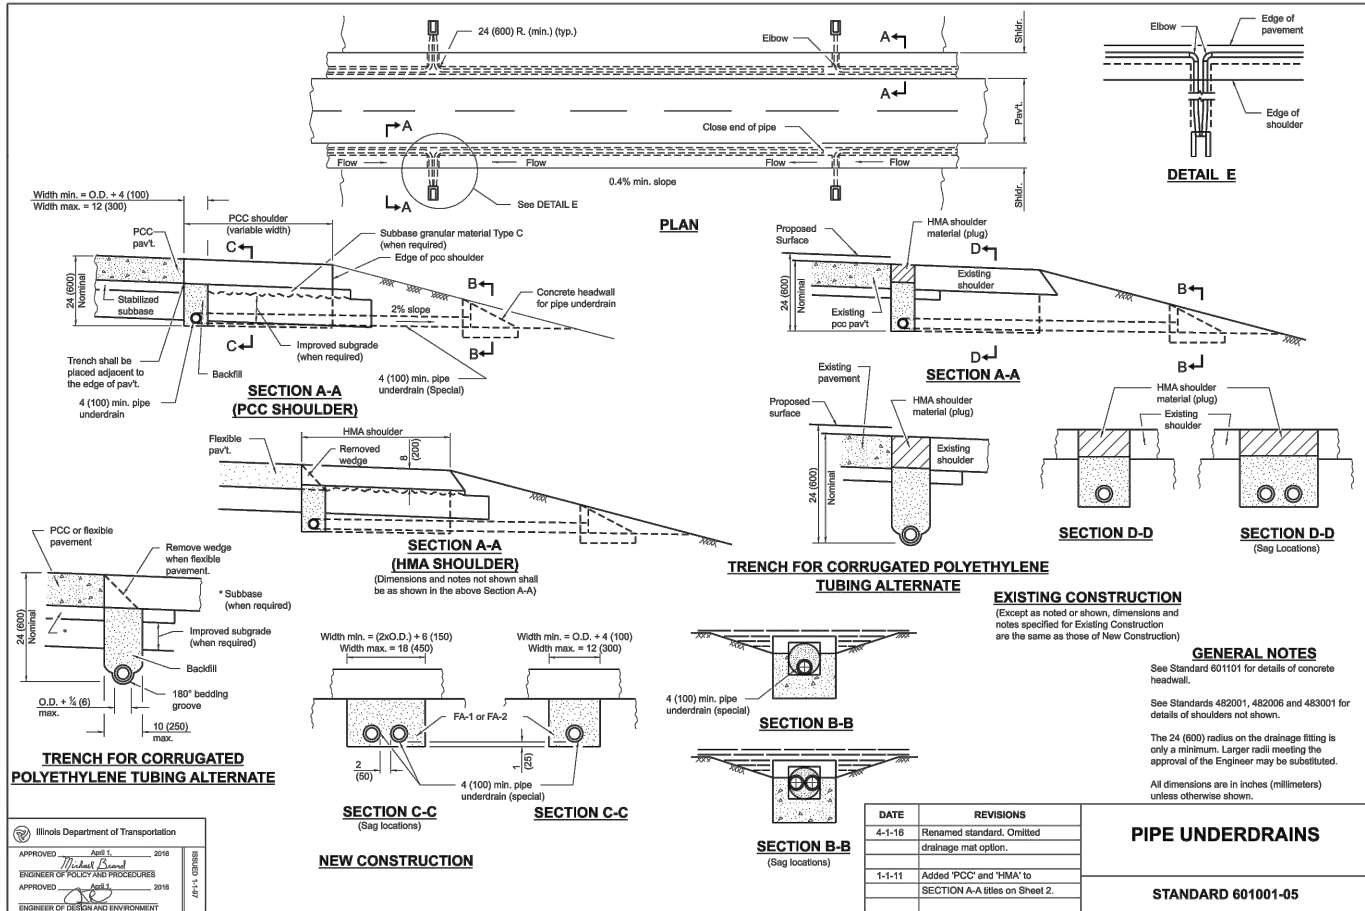

NOTES:

1. MOUNT DISCONNECT SWITCH 54 INCHES ABOVE GRADE TO CENTER OF HANDLE.
2. PEDESTAL ASSEMBLY MATERIAL: ALUMINUM, AA TYPE 6061-T6 OR 6063-T6.
3. ANCHORS: STAINLESS STEEL, 1/2" DIAMETER, 3 1/2" EMBEDMENT.
4. PROTECT SURFACES WITH DISSIMILAR MATERIALS PRIME COAT WITH A MULTI-PURPOSE EPOXY COATING, 4.5 TO 5.5 MIL.
5. ATTACH EACH MODULAR STRUT AND STIFFENER TO STRUCTURAL MEMBER WITH A MINIMUM OF TWO 3/8 INCH DIAMETER STAINLESS STEEL ROUND HEAD MACHINE SCREWS WITH LOCK WASHER AND NUT.
6. ATTACH PLATE TO EACH STIFFENER WITH A MINIMUM OF THREE 3/8 INCH DIAMETER STAINLESS STEEL FLAT HEAD (COUNTER SUNK) MACHINE SCREWS USING CHANNEL NUTS WITH SPRINGS.

## SERVICE DISCONNECT SWITCH MOUNTING PEDESTAL

NOT TO SCALE

CONSULTANTS



4620 E 53RD STREET  
DAVENPORT, IA 52807-3620  
(563) 293-7684

PREPARED FOR



NO.	DATE	DESCRIPTION	BY
		AS-BUILT INFORMATION	
		CONTRACTOR:	
		WORK STAKED BY:	DATE:
		INSPECTOR'S ACCEPTANCE BY:	DATE:
		FIELD VERIFICATION BY:	DATE:
		DRAWINGS CORRECTED BY:	DATE:

DESIGNED BY: MM
DRAWN BY: AJ
CHECKED BY: SM
DATE:

METROPOLITAN AIRPORT AUTHORITY OF ROCK ISLAND  
COUNTY (QUAD CITIES INTERNATIONAL AIRPORT)  
REALIGN THE GENERAL AVIATION  
ENTRANCE ROAD

### LIGHTING DETAILS (1 OF 4)

CLIENT APPROVAL	CLIENT APPROVAL	PROJECT NO.
		MLI-5023
		HDR PROJECT NO. 10404260
		SHEET NO. 51 of 61





**KEYNOTES:**

**1** FIELD CONFIRM IF EXISTING CIRCUIT NO. 1 FEEDS SITE LIGHTING IN ADDITION TO THE LIGHT POLES SHOWN IN THE BASE AND ALTERNATE BID FOR REMOVAL. IF THERE IS ADDITIONAL LIGHTING FED FROM THIS CIRCUIT, THEN EXTEND THE CIRCUIT TO THE NEW LIGHTING CONTROLLER AS SHOWN. IF THERE ARE NO ADDITIONAL LIGHTING FED FROM THIS CIRCUIT AFTER POLE REMOVALS, THEN EXISTING CIRCUIT NO. 1 DOES NOT HAVE TO BE EXTEND TO THE NEW LIGHTING CONTROLLER AND THE ASSOCIATED BRANCH CIRCUIT BREAKER WILL BE LABELED AS "SPARE".

**2** COORDINATE WITH ALLIANT ENERGY TO DE-ENERGIZE TRANSFORMER AS REQUIRED TO REROUTE EXISTING SECONDARY CONDUIT/CONDUCTORS AND INSTALL REPLACEMENT SERVICE DISCONNECT SWITCH.

**REMOVE:**

- MAIN SERVICE DISCONNECT
- LIGHTING CONTROL CABINET
- INDICATED CONDUIT AND CONDUCTORS

CONNECT LUMINAIRE TO INDICATED  
CIRCUIT PHASE (TYP)

EXISTING CIRCUIT TO  
ADDITIONAL EXISTING  
LIGHT POLES

## CONSULTANTS

PREPARED FOR



**QUAD CITIES**  
INTERNATIONAL AIRPORT



4620 E 53RD STREET  
DAVENPORT, IA 52807-3620  
(563) 293-7684



DESIGNED BY: MM
DRAWN BY: AJ
CHECKED BY: SM
DATE:

METROPOLITAN AIRPORT AUTHORITY OF ROCK ISLAND  
COUNTY (QUAD CITIES INTERNATIONAL AIRPORT)  
REALIGN THE GENERAL AVIATION  
ENTRANCE ROAD

## LIGHTING DETAILS (3 OF 4)


CLIENT APPROVAL	CLIENT APPROVAL	PROJECT NO. MLI-5023
		HDR PROJECT NO. 10404260
		SHEET NO. <b>53 of 61</b>

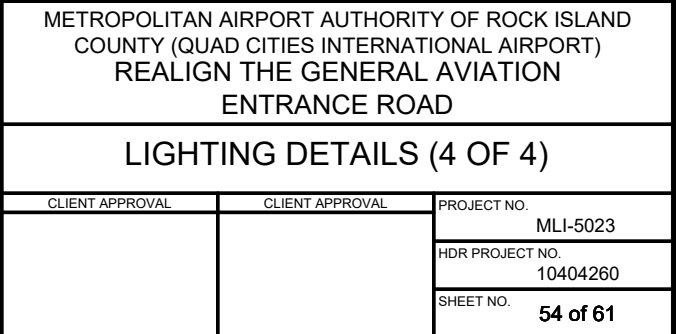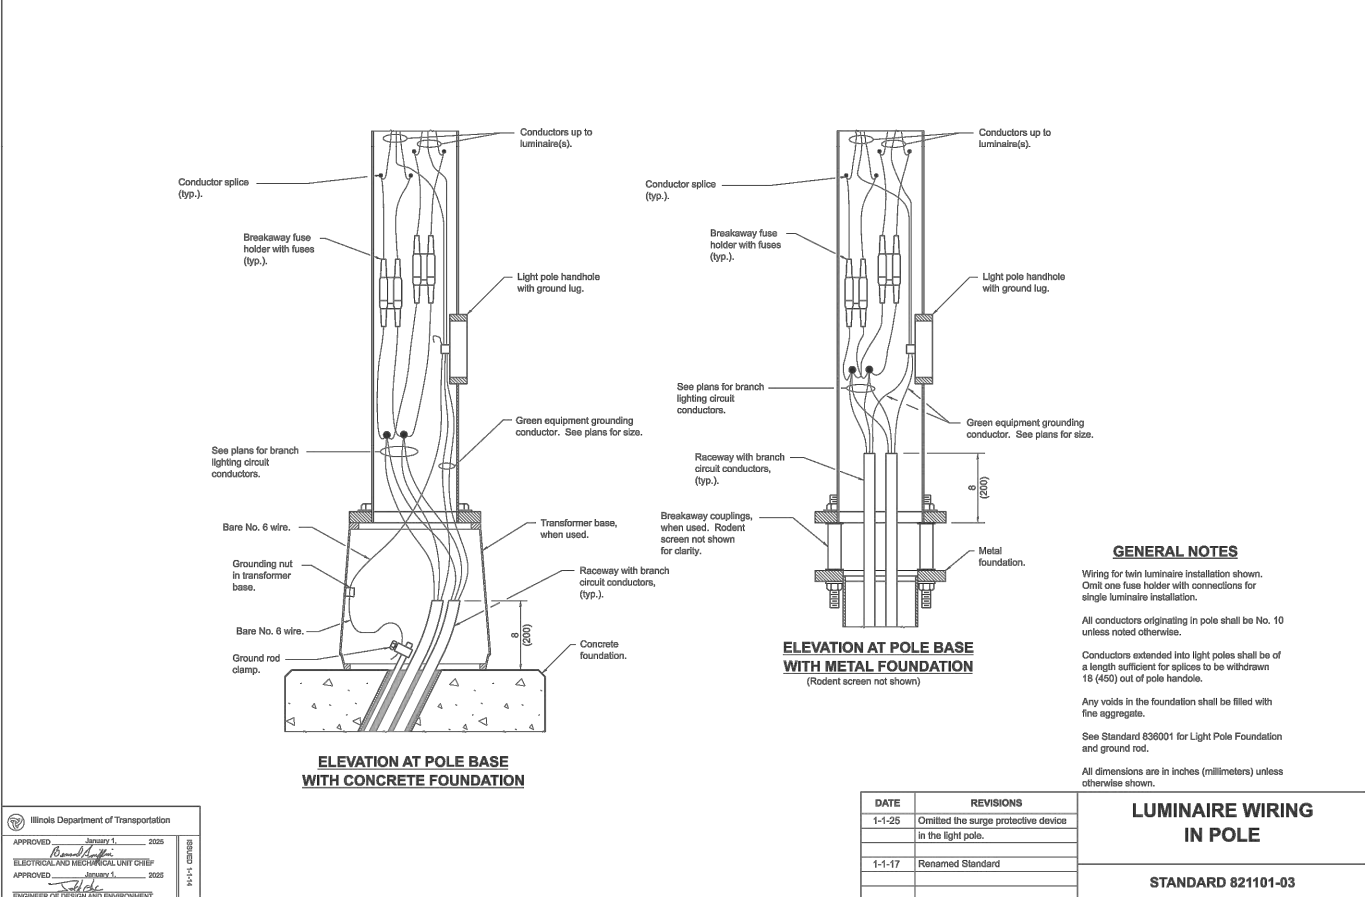

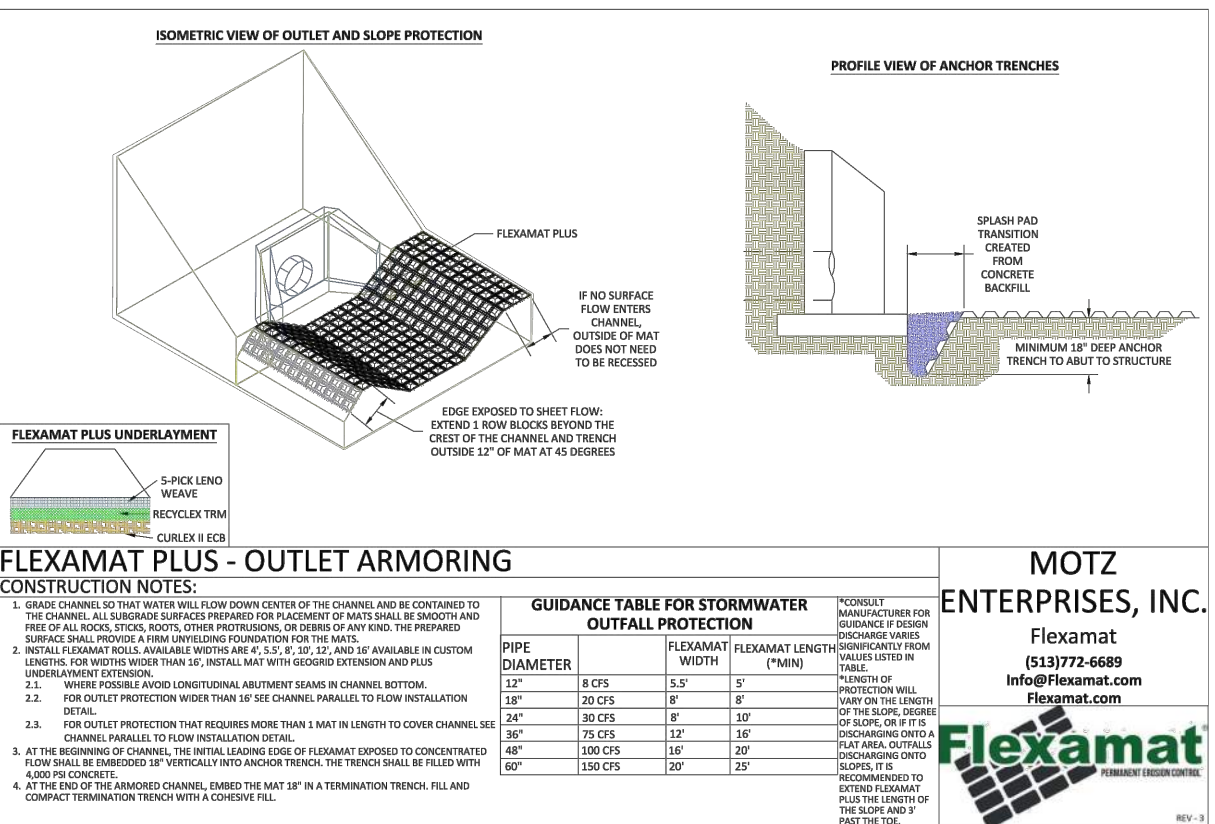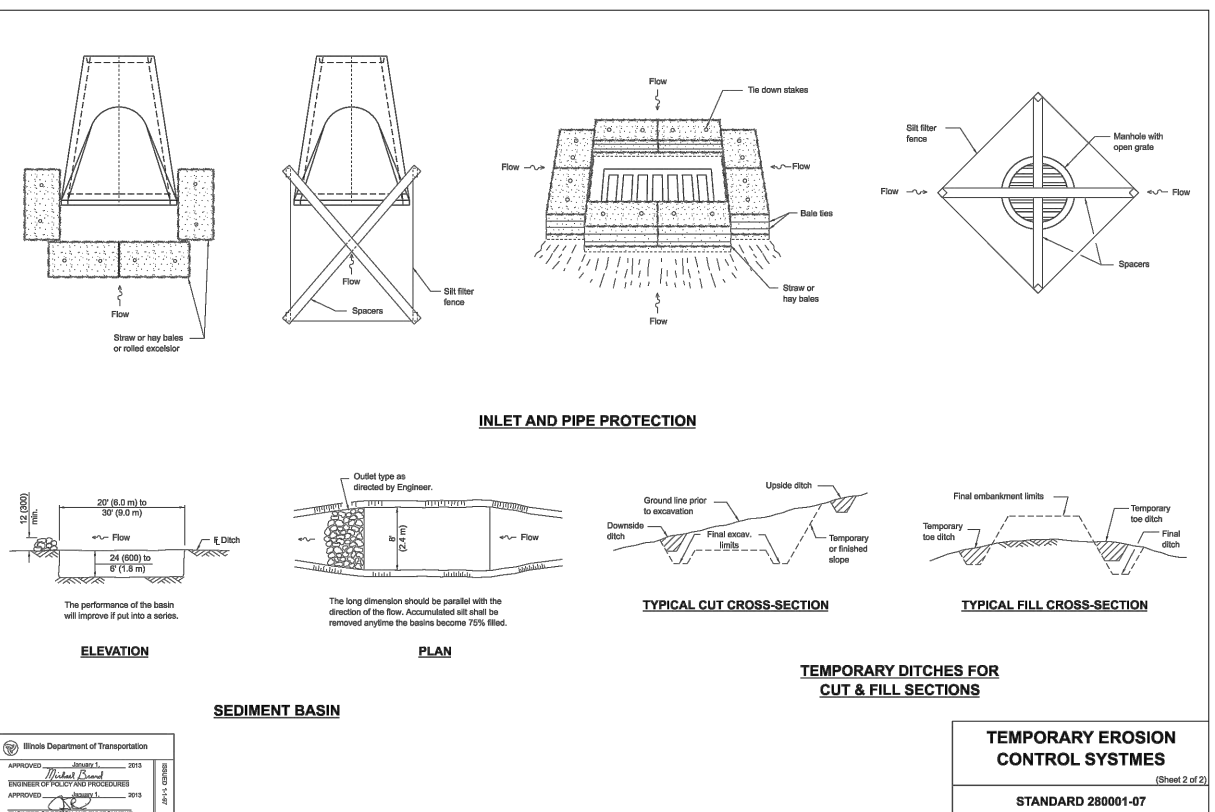

# ROLLED EROSION CONTROL PRODUCTS


## STAKING PATTERN GUIDE

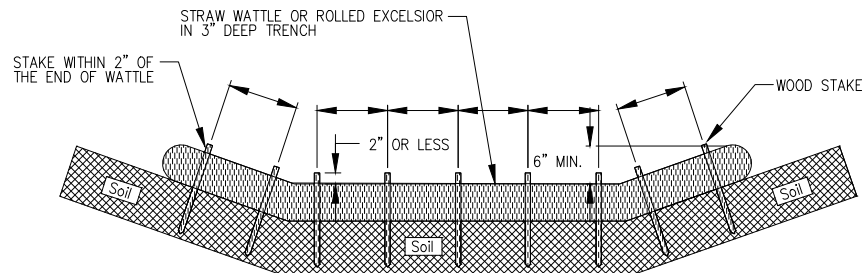


NOTES:

1. OVERLAP MINIMUM IS THE DIAMETER OF THE ROLL.
2. 4' SPACING FOR WATTLES.
3. 2' SPACING FOR ROLLED EXCELSIOR.
4. OR SPACE ACCORDING TO MANUFACTURER'S SPECIFICATIONS.

STAKE DETAIL

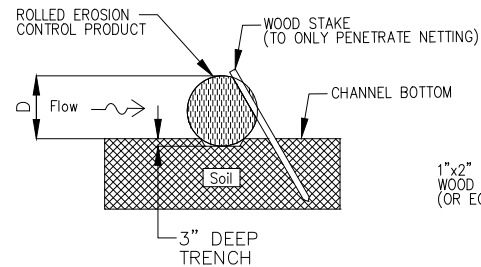

### COMPOST FILTER SOCK DETAIL

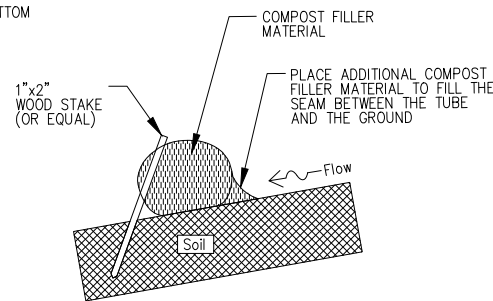

WHEN COMPOST FILTER SOCK DITCH CHECK IS USED, PLACE A COMPOST BERM UPSTREAM OF THE FILTER SOCK (SEE IUM 805). A TRENCH IS NOT REQUIRED.


NOTES:

1. DRAWINGS ARE NOT TO SCALE.
2. ENDS OF WATTLES OR ROLLED EXCELSIOR SHALL BE TURNED AT LEAST 6" UPSLOPE.
3. RECOMMENDED STAKES ARE 1 1/8" WIDE x 1 1/8" THICK x 30" LONG.
4. STAKES SHALL NOT EXTEND ABOVE THE STRAW WATTLE MORE THAN 2".
5. SPACING: THE TOE OF THE UPSTREAM DITCH CHECK SHALL CREATE A HORIZONTAL LINE WITH THE TOP OF THE DOWNSTREAM DITCH CHECK.
6. WHEN COMPOST FILTER SOCK DITCH CHECK IS USED, PLACE A COMPOST BERM UPSTREAM OF THE FILTER SOCK (SEE IUM 805). A TRENCH IS NOT REQUIRED.

REFERENCE	
Project	_____
Designed	_____ Date _____
Checked	_____ Date _____
Approved	_____ Date _____



STANDARD DWG. NO.  
IUM-514  
SHEET 1 OF 1  
DATE 08-19-2011

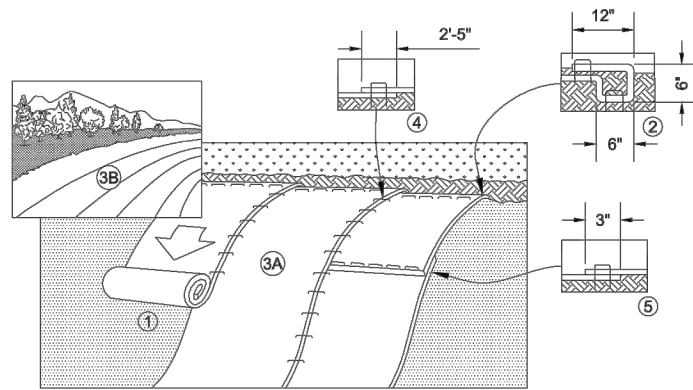


1. PREPARE SOIL BEFORE INSTALLING BLANKETS, INCLUDING ANY NECESSARY APPLICATION OF LIME, FERTILIZER, AND SEED.
2. BEGIN AT THE TOP OF THE SLOPE BY ANCHORING THE BLANKET IN A 6" (15 CM) DEEP X 6" (15 CM) WIDE TRENCH WITH APPROXIMATELY 12" (30cm) OF BLANKET EXTENDED BEYOND THE UP-SLOPE PORTION OF THE TRENCH. ANCHOR THE BLANKET WITH A ROW OF STAPLES/STAKES APPROXIMATELY 12" (30 CM) APART IN THE BOTTOM OF THE TRENCH. BACKFILL AND COMPACT THE TRENCH AFTER STAPLING. APPLY SEED TO COMPACTED SOIL AND FOLD REMAINING 12" (30 CM) PORTION OF BLANKET BACK OVER SEED AND COMPACTED SOIL. SECURE BLANKET OVER COMPACTED SOIL WITH A ROW OF STAPLES/STAKES SPACED APPROXIMATELY 12" (30 CM) APART ACROSS THE WIDTH OF THE BLANKET.
3. ROLL THE BLANKETS (A) DOWN OR (B) HORIZONTALLY ACROSS THE SLOPE. BLANKETS WILL UNROLL WITH APPROPRIATE SIDE AGAINST THE SOIL SURFACE. ALL BLANKETS MUST BE SECURELY FASTENED TO SOIL SURFACE BY PLACING STAPLES/STAKES IN APPROPRIATE LOCATIONS AS SHOWN IN THE STAPLE PATTERN GUIDE.
4. THE EDGES OF PARALLEL BLANKETS MUST BE STAPLED WITH APPROXIMATELY 2"-5" (5 CM-12.5 CM) OVERLAP DEPENDING ON BLANKET TYPE.
5. CONSECUTIVE BLANKETS SPLICED DOWN THE SLOPE MUST BE PLACED END OVER END (SHINGLE STYLE) WITH AN APPROXIMATE 3" (7.5 CM) OVERLAP. STAPLE THROUGH OVERLAPPED AREA, APPROXIMATELY 12" (30 CM) APART ACROSS ENTIRE BLANKET WIDTH.

**NOTE:**

\*IN LOOSE SOIL CONDITIONS, THE USE OF STAPLE OR STAKE LENGTHS GREATER THAN 6" (15 CM) MAY BE NECESSARY TO PROPERLY SECURE THE BLANKETS.

**EROSION CONTROL BLANKET (CITY STANDARD)**

SCALE: NONE

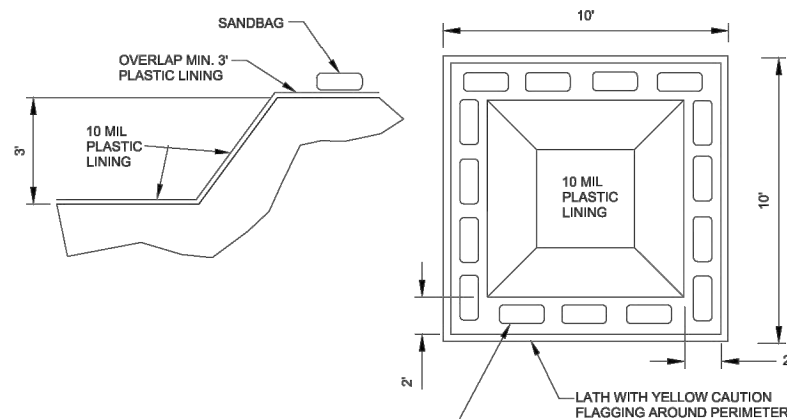

NOTES:

1. WASHOUT FACILITY SHALL NOT BE LOCATED WITHIN 50-FT UPSTREAM OF STORM DRAINS, OPEN DITCHES OR WATER BODIES.
2. WASHOUT FACILITIES MUST BE CLEANED OR NEW FACILITIES CONSTRUCTED ONCE THE FACILITY IS 75% FULL. HARDENED CONCRETE SHALL BE REMOVED AND DISPOSED OF. IF THE FACILITY IS TO BE REUSED, LINE THE STRUCTURE WITH NEW 10 MIL POLYETHYLENE SHEETING FREE OF HOLES OR TEARS.
3. A SIGN SHALL BE POSTED ADJACENT TO THE FACILITY TO INFORM CONCRETE EQUIPMENT OPERATORS OF THE FACILITY. THE JOB SITE SUPERINTENDENT SHALL ENSURE THAT CONCRETE EQUIPMENT OPERATORS USE THE WASHOUT FACILITY.
4. IF NECESSARY, A CRUSHED STONE PATH SHALL BE CONSTRUCTED TO PROVIDE EASE OF ACCESS FOR EQUIPMENT.
5. WHEN THE FACILITY IS NO LONGER REQUIRED, THE HARDENED CONCRETE SHALL BE REMOVED AND DISPOSED OF, THE MATERIALS USED TO CONSTRUCT THE FACILITY SHALL BE REMOVED, AND THE HOLE BACKFILLED AND THE SURROUNDING AREA REPAIRED.

**CONCRETE WASHOUT DETAIL (CITY STANDARD)**

SCALE: NONE

CONSULTANTS

PREPARED FOR

**QUAD CITIES**  
INTERNATIONAL AIRPORT



DAVENPORT, IA 52807-3620  
(563) 293-7684

[illegible]

DESIGNED BY: MM

DRAWN BY: AJ

CHECKED BY: SM

DATE: \_\_\_\_\_

METROPOLITAN AIRPORT AUTHORITY OF ROCK ISLAND  
COUNTY (QUAD CITIES INTERNATIONAL AIRPORT)  
REALIGN THE GENERAL AVIATION  
ENTRANCE ROAD

SWPPP DETAILS (2 OF 2)

CLIENT APPROVAL	CLIENT APPROVAL	PROJECT NO. MLI-5023
		HDR PROJECT NO. 10404260
		SHEET NO. <b>56 of 61</b>

















Date: 11 Feb 2025 - 4:00pm User: STOLJENSEN Layout: CS01-05  
Drawing Name: 26-CROSS SECTIONS.dwg

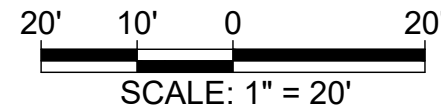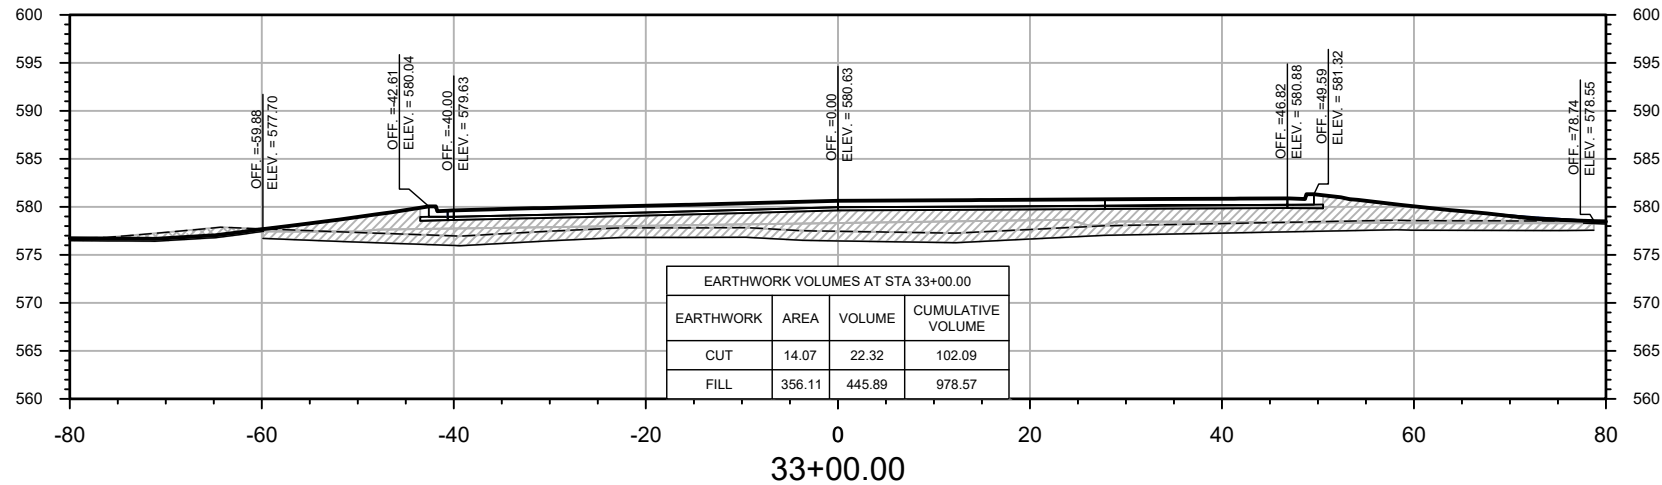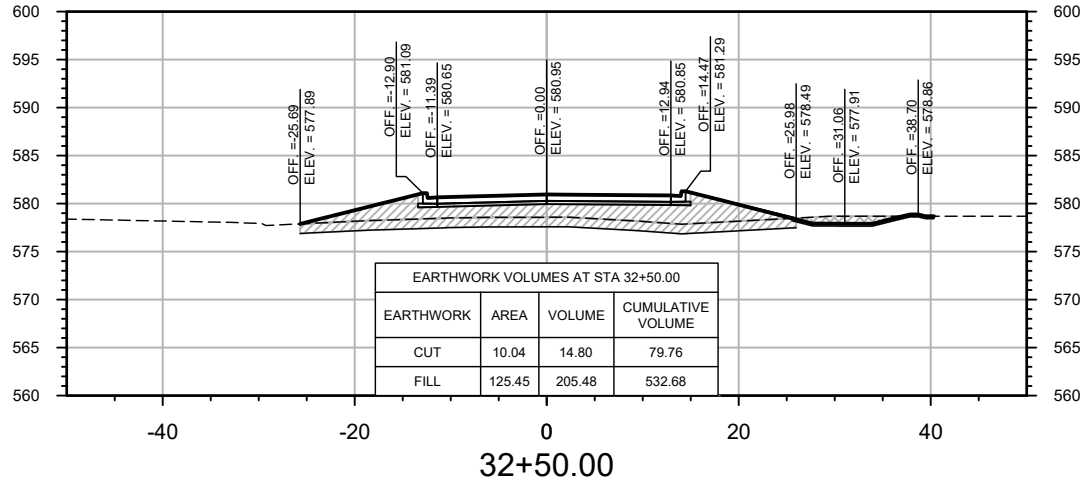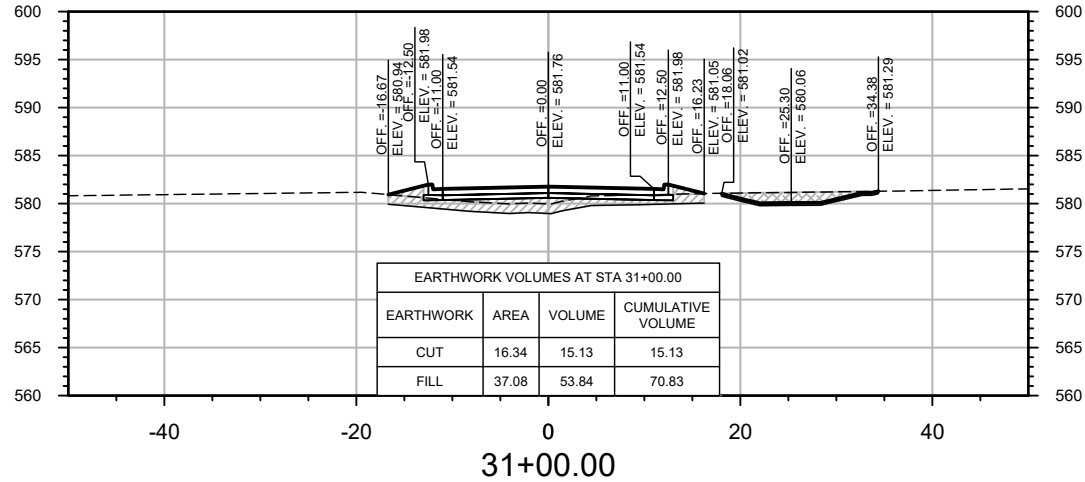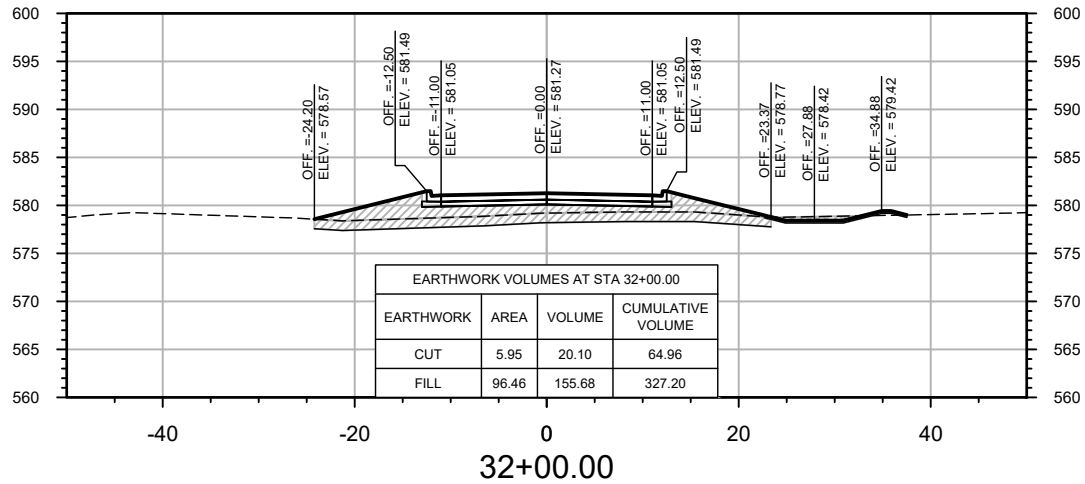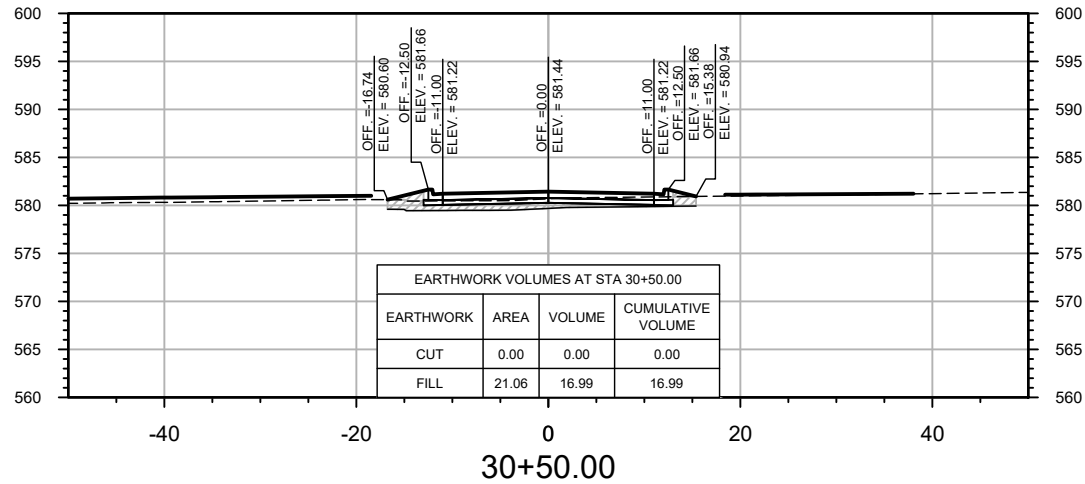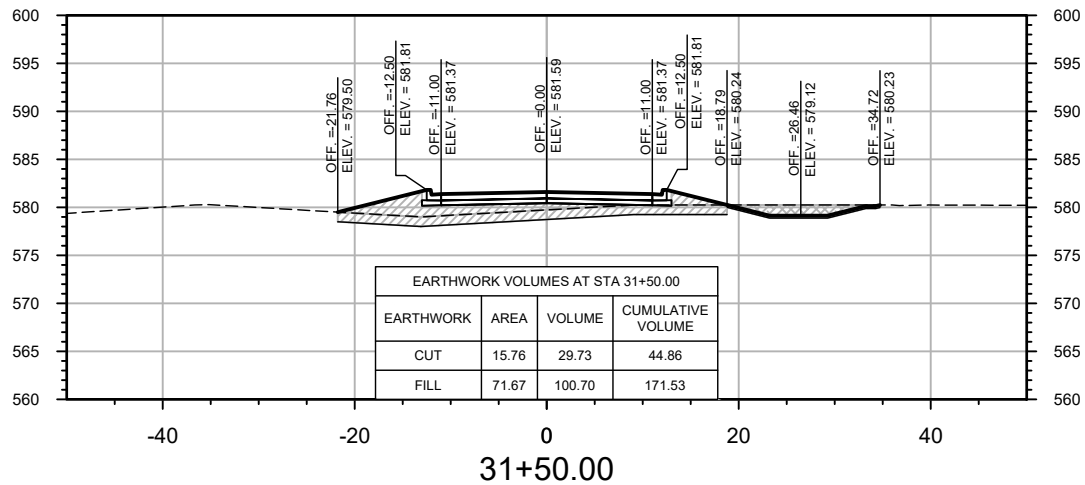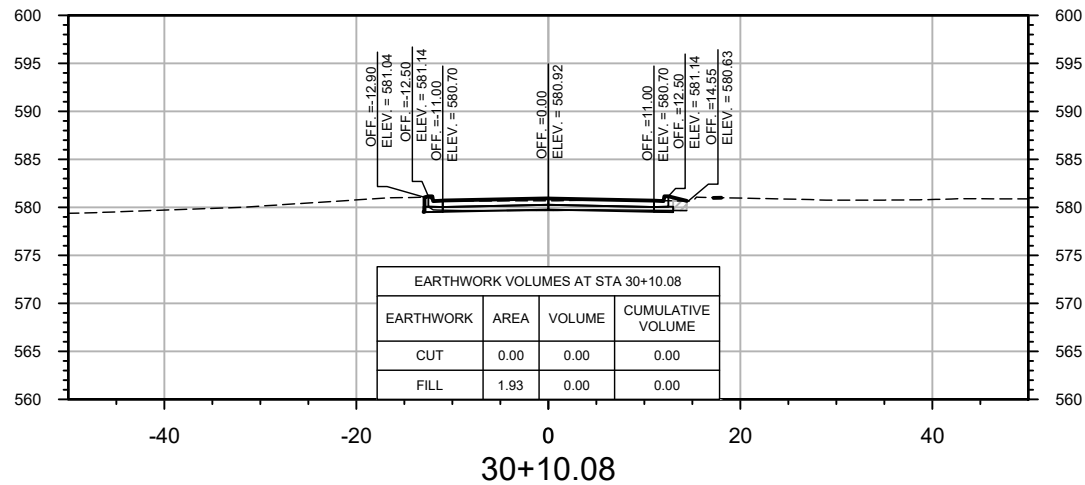

**LEGEND**

- EXISTING GROUND
- PROPOSED GROUND
- FILL AREA
- CUT AREA



METROPOLITAN AIRPORT AUTHORITY OF ROCK ISLAND  
COUNTY (QUAD CITIES INTERNATIONAL AIRPORT)  
REALIGN THE GENERAL AVIATION  
ENTRANCE ROAD

**CROSS SECTIONS (5 OF 5)**  
**75TH AVENUE**

CLIENT APPROVAL	CLIENT APPROVAL	PROJECT NO.
		MLI-5023
		HDR PROJECT NO. 10404260
		SHEET NO. 61 of 61

PREPARED FOR  
CONSULTANTS



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