

Upper Case To Lower Case Spacing Chart 8-6 Inch Series "C & D"

SECOND LETTER																	
		a c		bh	ikl	f	W	j	İ	S	†	V	У	>	<	2	Z
	SERIES	С	D	С	D	С	D	С	D	С	D	С	D	С	D	С	D
	A W X	12	1 4	14	1 ⁵	12	14	06	10	1 ¹	14	06	10	1 ¹	12	12	14
	В	14	1 ⁵	2 0	21	14	1 ⁵	1 ¹	1 ²	14	1 ⁵	1 ²	14	12	14	16	17
	CEG	14	1 ⁵	20	21	12	14	06	10	12	14	1 ²	14	14	1 ⁵	14	1 ⁵
F	D O Q R	14	1 ⁵	2 0	21	14	1 ⁵	06	10	12	14	1 ²	14	14	1 ⁵	14	1 ⁵
	F	05	06	14	1 ⁵	06	10	05	06	06	1 ⁰	06	10	06	10	1 ¹	12
I R S T	HIMN	2 0	21	2 ²	24	20	2 ¹	14	1 ⁵	1 ⁶	17	1 ⁶	17	20	21	20	21
.	JU	2 0	2 1	2 0	2 1	16	17	14	1 ⁵	1 ⁶	17	16	17	16	17	20	21
E	K L	11	12	16	17	11	12	05	06	11	1 ²	11	12	11	12	12	14
LETTER	Р	12	14	14	1 ⁵	1 ²	14	0 ⁵	06	11	12	11	12	12	14	12	14
E R	S	1 ²	14	16	1 7	1 ²	14	06	1 ⁰	1 ²	14	1 ²	14	1 ²	14	1 ²	14
	Т	11	12	16	1 7	06	10	06	10	1 ¹	1 ²	1 ¹	12	11	12	12	14
	٧	06	10	14	1 ⁵	1 ¹	12	06	10	12	14	12	14	12	14	12	14
	Υ	05	06	1 4	1 ⁵	06	10	05	06	05	07	05	06	06	10	11	12
	Z	16	17	2 ²	24	1 ⁶	17	1 ²	14	1 ⁶	17	1 ⁶	17	1 ⁶	17	20	21

Lower Case To Lower Case Spacing Chart 6 Inch Series "C & D"

		SECOND LETTER															
				b h m n р	ikl	f w		j	j	S	+	V	У	>	<	2	Z
	SERIES	С	D	С	D	С	D	С	D	С	D	С	D	С	D	С	D
FIRS	adhgij Imnqu	1 ⁶	17	22	24	1 ⁶	1 ⁷	1 ²	14	14	1 ⁵	14	1 ⁵	1 ⁶	1 ⁷	1 ⁶	17
	bfkops	12	14	16	17	11	12	05	06	11	12	11	12	12	14	12	14
T	се	12	14	16	17	12	14	06	10	12	14	12	14	12	14	12	14
L	r	06	10	12	14	06	10	03	03	05	06	05	06	06	10	06	10
Ī	† z	12	14	16	17	12	14	06	10	11	12	11	12	12	14	12	14
JETTER	v y	11	12	14	15	11	12	05	06	06	10	06	10	11	12	11	12
	W	11	12	14	15	11	12	05	06	11	12	11	12	11	12	12	14
	×	12	14	16	17	11	12	05	06	11	12	11	12	11	12	12	14

Number To Number Spacing Chart 8 Inch Series "C & D"

										SE	СО	ND	NU	IMB	ER							
			()		1	2	2	3	3	2	1	5	5	6	ò	-	7	8	3	ć	9
	SERIE	ES	С	D	С	D	С	D	С	D	С	D	С	D	С	D	С	D	С	D	С	D
F	0 9		1 ⁶	17	1 ⁶	17	14	1 ⁵	1 ²	14	14	1 ⁵	14	1 ⁵	1 ⁶	17	1 ²	14	1 ⁶	17	1 ⁶	17
R	1		2 ⁰	2 ¹	2 ⁰	2 ¹	2 ⁰	2 ¹	1 ⁶	1 ⁷	1 ⁴	1 ⁵	2 ⁰	21	2 ⁰	2 ¹	14	1 ⁵	2 ⁰	2 ¹	2 ⁰	2 !
Т	2 3	4	1 ⁴	1 ⁵	14	1 ⁵	14	1 ⁵	1 ²	14	1 ²	14	1 ⁴	1 ⁵	1 ⁴	1 ⁵	11	1 ²	1 ⁶	17	14	1 ⁵
N U	5		1 ⁴	1 ⁵	1 ⁴	1 ⁵	1 ⁴	1 ⁵	1 ¹	1 ²	1 ¹	1 ²	1 ⁴	1 ⁵	14	1 ⁵	11	1 ²	14	1 ⁵	14	15
M B	6		1 ⁶	17	14	1 ⁵	14	1 ⁵	1 ²	1 ⁵	1 ²	14	14	1 ⁵	14	1 ⁵	11	1 ²	14	1 ⁵	14	1 ⁵
E R	7		1 ²	1 ⁴	1 ²	1 ⁴	14	1 ⁵	1 ²	1 ⁵	0 ⁵	06	1 ²	1 ⁴	1 ⁴	1 ⁵	11	1 ²	14	1 ⁵	1 ²	1
	8		1 ⁶	17	1 ⁶	17	14	1 ⁵	1 ²	1 ⁵	1 ²	14	14	1 ⁵	1 ⁶	17	1 ²	14	1 ⁶	17	1 ⁴	1 ⁵

SCALE:

EXAMPLE, 2^{3} DENOTES $\frac{3''}{8}$


UPPER AND LOWER CASE LETTER WIDTHS

L E T E R S		UPPER ETTERS		H UPPER LETTERS	L E T		LOWER ETTERS
T E	SEF	RIES	SE	RIES	E R	SEI	RIES
R S	С	D	С	D	R S	С	D
А	36	5 0	5 0	6 ⁵	а	3 ⁵	4 ²
В	32	4 ⁰	4 3	5 3	Ь	3 ⁵	42
С	3 ²	40	4 3	5 3	C	3 ⁵	4 1
D	32	40	4 3	53	d	3 ⁵	4 2
E	3 0	3 ⁵	40	4 7	е	3 ⁵	4 2
F	3 ⁰	3 ⁵	40	4 7	f	2 3	26
G	3 ²	40	4 3	5 3	g	3 ⁵	42
Н	3 ²	40	4 3	53	h	3 ⁵	4 ²
I	0 7	0 7	11	12	ī	1 1	1 1
J	30	3 6	40	5 ⁰	j	20	22
K	32	41	4 3	5 4	k	35	42
L	3 ⁰	3 ⁵	4 0	4 7	1	1 1	1 1
М	3 7	45	51	6 ¹	m	6 ⁰	7 0
N	32	40	43	5 3	n	3 ⁵	42
0	34	42	4 5	5 ⁵	0	36	4 ³
Р	3 ²	40	4 ³	5 3	р	3 ⁵	4 ²
Q	3 4	4 2	4 ⁵	5 ⁵	D	3 ⁵	42
R	3 ²	40	43	5 3	r	26	32
S	3 ²	4 0	43	53	s	36	42
Т	30	3 ⁵	40	4 7	+	2 7	3 ²
U	3 ²	4 0	4 ³	5 ³	u	3 ⁵	42
٧	3 ⁵	4 4	4 7	6 ⁰	٧	42	4 7
W	4 4	5 ²	6 ⁰	7 0	w	5 ⁵	64
Х	3 4	40	4 ⁵	53	×	4 4	5 ¹
Υ	36	50	5 0	6 ⁶	У	46	5 3
Z	3 ²	4 ⁰	43	5 3	z	36	43

NUM	6 INCH	SERIES	8 INCH	SERIES
$^{N_{U_{M_{B_{E_{R}}}}}}$	С	D	С	D
1	1 2	1 4	1 ⁵	20
2	3 ²	40	4 3	5 ³
3	32	40	43	5 3
4	3 ⁵	4 3	4 ⁷	5 ⁷
5	32	40	4 3	5 ³
6	3 ²	40	4 3	5 ³
7	32	40	4 3	5 3
8	3 ²	4 0	4 3	53
9	3 ²	40	4 3	5 3
0	3 4	4 2	45	5 ⁵


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T_PLAN	PLOT DATE = 3/14/2013	DATE - 03/13/2013	REVISED -

	MAST	ARM	MOUNT	ED SIGNS	F.A.P RTE.			COUNTY	TOTAL SHEETS	SHEET NO.	
LED	INTERNALLY ILLUMINATED S				ME SIGNS	330	103	R-4	соок	877	410
									CONTRACT	NO. 6	OM61
	SHEET	OF	SHEETS	STA.	TO STA.			ILLINOIS FED. A	ID PROJECT		

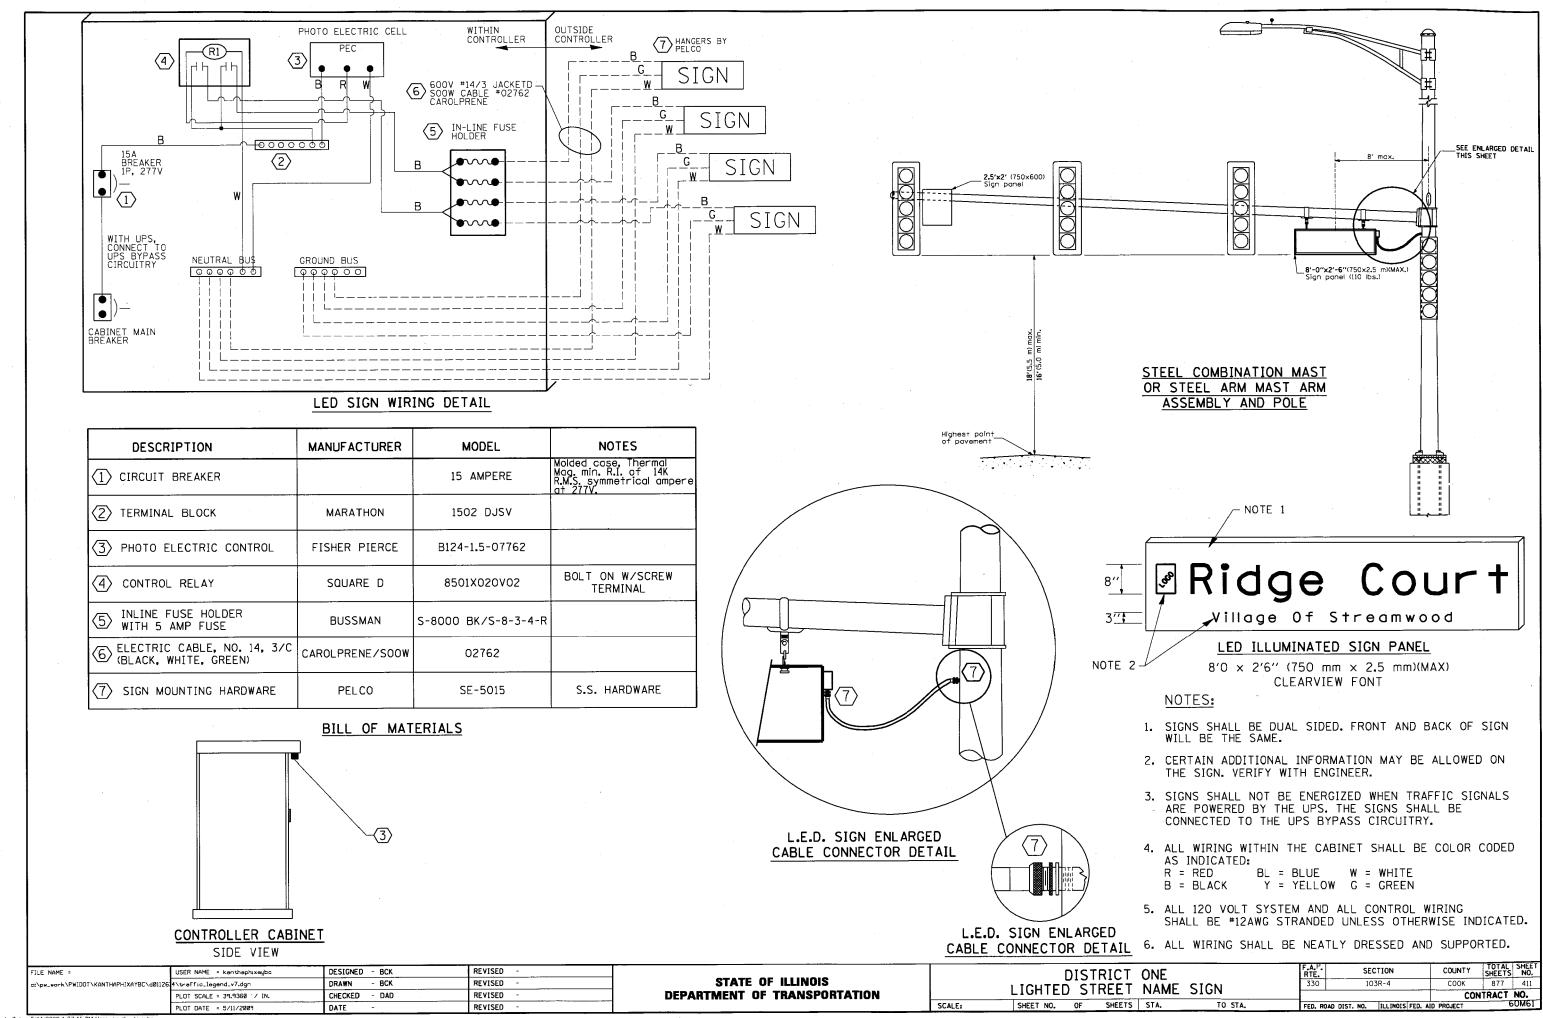

ROADWA	AY ELECTRICAL SYMBOLS
SYMBOL	DESCRIPTION
₽	PROPOSED LIGHTING UNIT: 400W, 240V PHASE TO NEUTRAL, HPS LUMINAIRE WITH TYPE III DISTRIBUTION, 45'-2" ALUMINUM POLE SHAFT ON 24" DIAMETER CONCRETE FOUNDATION, 47'-6" MOUNTING HEIGHT, 12'-0" MAST ARM, WITH 5A FUSES, T-BASE AND 20A, 120V GFCI RECEPTACLE 15'-0" ABOVE THE BASE OF POLE IF INDICATED
•===	PROPOSED COMBINATION POLE LIGHTING UNIT: 400W, 240V PHASE TO PHASE, HPS LUMINAIRE WITH TYPE III DISTRIBUTION, INSTALLED ON 12'-0" MAST ARM AT 45'-0" MOUNTING HEIGHT, ON POLE AND FOUNDATION SUPPLIED BY THE TRAFFIC SIGNAL CONTRACTOR, WITH 5A FUSES
∘-ÌR	RELOCATED LIGHTING UNIT, PROVIDE NEW 250W HPS, 240V, MC-III LUMINAIRE IN PROPOSED LOCATION
○—ŒÑA	RELOCATED LIGHTING UNIT IN PROPOSED LOCATION
o—(E)	EXISTING LIGHTING UNIT
<u> </u>	EXISTING COMBINATION POLE LIGHTING UNIT INSTALLED IN AN EARLIER STAGE
o–R	EXISTING LIGHTING UNIT TO BE REMOVED
o–RR	EXISTING LIGHTING UNIT TO BE REMOVED AND RELOCATED
⊕ ∭	TEMPORARY LIGHTING UNIT: 400W, 240V PHASE TO NEUTRAL, HPS LUMINAIRE WITH TYPE III DISTRIBUTION, 60'-0" CLASS 4 WOOD POLE, 47'-6" MOUNTING HEIGHT, 12'-0" MAST ARM, WITH 5A FUSES
○	EXISTING TEMPORARY LIGHTING UNIT TO REMAIN
○ ₩	EXISTING TEMPORARY LIGHTING UNIT TO BE REMOVED
	UNDERPASS LUMINAIRE, 100 WATT, 240V PHASE TO NEUTRAL, HPS, WITH TYPE III DISTRIBUTION, WALL MOUNTED
жα	EXISTING PEDESTRIAN LIGHTING UNIT
д	EXISTING BOLLARD LIGHTING UNIT
J	ELECTRIC JUNCTION BOX, TYPE AND SIZE AS INDICATED
Н	ELECTRIC HANDHOLE
R	GROUND RECEPTACLE

D0 4 D W 1	AV ELECTRICAL CAUSALC
ROADWA SYMBOL	AY ELECTRICAL SYMBOLS
STMBOL	DESCRIPTION EXISTING LIGHTING CONTROLLER
	EXISTING LIGHTING CONTROLLER
\boxtimes	EXISTING COMBINATION LIGHTING CONTROLLER
r-CSD	EXISTING COMBINATION SERVICE DISCONNECT CABINET, SEE TRAFFIC SIGNAL PLANS
۵	EXISTING UTILITY SERVICE CONNECTION, POLE MOUNTED TRANSFORMER
	EXISTING UTILITY SERVICE CONNECTION, PAD MOUNTED TRANSFORMER
	PROPOSED LIGHTING CONTROLLER 200A, 240/480V, 10, 3W, SINGLE DOOR, BASE MOUNTED
E ac	PROPOSED COMBINATION LIGHTING CONTROLLER ATTACHED TO TRAFFIC SIGNAL CONTROL CABINET 120/240V, 1Ø, 3W
ГCSD	PROPOSED COMBINATION LIGHTING AND TRAFFIC SIGNAL SERVICE DISCONNECT CABINET. SEE TRAFFIC SIGNAL PLANS FOR PROPOSED LOCATION
	PROPOSED UTILITY SERVICE CONNECTION, POLE MOUNTED TRANSFORMER
	PROPOSED UTILITY SERVICE CONNECTION, PAD MOUNTED TRANSFORMER
-0-	TEMPORARY WOOD POLE, 60' CLASS 4
-	ELECTRIC UTILITY POLE
4	ELECTRIC GROUND ROD
(ELECTRIC SERVICE WEATHERHEAD
	EXPOSED CONDUIT
	DIRECT BURIED CABLE, UNIT DUCT,
	OR RACEWAY EXISTING DIRECT BURIED CABLE, UNIT DUCT, OR RACEWAY TO REMAIN
	EXISTING CONDUIT EXPOSED
	EXISTING DIRECT BURIED CABLE, UNIT
	DUCT, OR RACEWAY TO BE ABANDONED (SEE GENERAL NOTE 1, DRAWING GE-2)
	AERIAL ELECTRIC CABLE
	EXISTING AERIAL ELECTRIC CABLE
	EXISTING AERIAL ELECTRIC CABLE TO BE REMOVED
	CONCEALED CONDUIT IN STRUCTURE
	UNDERGROUND CONDUIT SLEEVE
	CONDUIT TURNED UP
	CONDUIT TURNED DOWN
×	LIQUID TIGHT FLEXIBLE METAL CONDUIT

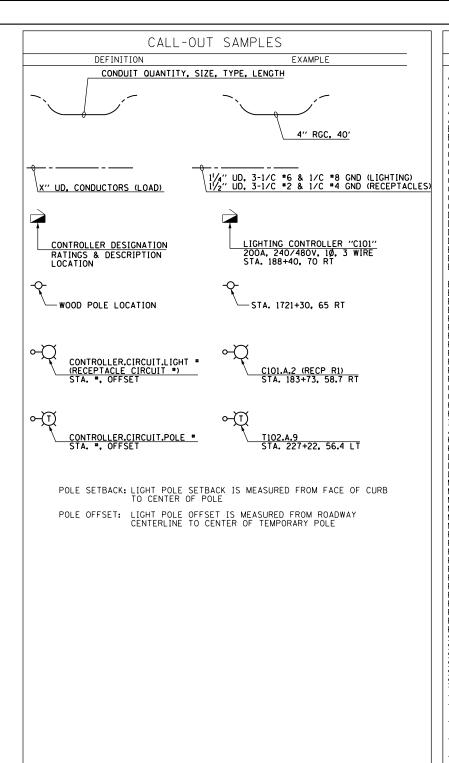

SCALE: NONE

	APPDEVIATIONS
ABBREVIATION	ABBREVIATIONS DESCRIPTION
AC A/C.A. AFG A/C.A. AFG A/R A/R A/R A/R A/S BOE CKT CLC CNC CCP CDA CDDP ECA EM EOP ETT FNDD BOON FNDD D ECA EOP ETT FNDD BOON FNDD D ECA EOP ETT FNDD BOON FNDD D ECA EOP ETT FNDD BOON FND D ECA EOP ETT FNDD BOON FNDD D ECA EOP ETT FNDD BOON FNDD D ECA EOP ETT FNDD BOON FNDD CO ETT FNDD BOON FNDD CO ETT FNDD BOON FND CO ETT FND FND CO ET	ALTERNATING CURRENT AERIAL CABLE AMERICANS WITH DISABILITIES ACT ABOVE FINISHED GRADE AERIAL CABLE TO BE REMOVED ATTACHED TO STRUCTURE BASELINE IDOT BUREAU OF ELECTRICITY CIRCUIT BREAKER COLLABLE TO BE REMOVED ATTACHED TO STRUCTURE BASELINE IDOT BUREAU OF ELECTRICITY CIRCUIT BREAKER COLLABLE NOMETALLIC CONDUIT CONTROL PANEL CONTROL PANEL CURRENT TRANSFORMER DAVIT ARM DIRECT CURRENT DIAMERY DIAMERY DIAMERY DIAMERY DIAMERY DIAMERY DIAMERY DIAMERY EXISTING UNIT TO REMAIN ELECTRIC CABLE ASSEMBLY EXISTING GENEABLY EXISTING TEMPORARY UNIT TO REMAIN EXISTING TEMPORARY UNIT TO REMAIN EXISTING TEMPORARY MELCOATED UNIT FOUNDATION BARRIER WALL FUNDATION BARRIER WALL FUNDATION DEATHER FOUNDATION DEATHER FOUNDATION METAL FOUNDATION METAL FOUNDATION METAL FUNDATION PARAPET WALL FUSE GROUND FAULT CIRCUIT INTERRUPTER GROUND FAULT LIGHTING METAL GROUND FAULT CIRCUIT INTERRUPTER GROUND FAULT GROUND

JUSS S. WACKER DR. SUITE 500 CHICKOGO FAX (312)-939-1000 FAX (312)-939-1000

FILE NAME = D160M61-SHT-E01.dgn

USER NAME = michal_bartusiewicz	DESIGNED	-	MAE	REVISED	-
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PLOT SCALE = 2.0000000 '/ in.	CHECKED	-	DAD	REVISED	=
PLOT DATE = 3/15/2013	DATE	-	03/13/2013	REVISED	=

STATE OF ILLINOIS
DEPARTMENT OF TRANSPORTATION

	US 45 (Lagrange road)							SECTION	COUNTY	TOTAL SHEETS	SHEET NO.
FLE	ELECTRICAL SYMBOL LIST AND ABBREVIATIONS						330	103R-4	соок	877	412
								E-1	CONTRACT	NO. (60M61
	SHEET 1	1 OF	2 SHF	TS ST	TA 7	TO STA		THE INDIC EED	ID DDO IECT		

GENERAL NOTES:

- 1. UNLESS NOTED OTHERWISE, ALL LIGHTING EOUIPMENT REMOVED AS PART OF THIS CONTRACT SHALL REMAIN THE PROPERTY OF THE VILLAGE OF ORLAND PARK AND SHALL BE DELIVERED TO THE VILLAGE OF ORLAND PARK MAINTENANCE FACILITY. THE CONTRACTOR SHALL TURN OVER TO THE VILLAGE OF ORLAND PARK ALL REMOVED POLES, MAST ARMS, FIXTURES, AND CONTROLLERS.
- 2. THE CONTRACTOR SHALL COORDINATE ALL WORK AND MATERIALS WITH SPECIAL ATTENTION TO ALL OTHER CONSTRUCTION CONTRACTS. THIS WORK SHALL BE INCLUDED IN THE COST OF THIS CONTRACT. SEPARATE PAYMENT WILL NOT BE MADE.
- 3. THE CONTRACTOR SHALL CALL J.U.L.I.E. (1-800-892-0123) 72 HOURS BEFORE EXCAVATION FOR UNDERGROUND UTILITY LOCATIONS. UTILITY LOCATIONS SHOWN ON PLANS ARE APPROXIMATE.
- 4. THE CONTRACTOR SHALL PROTECT AND CAREFULLY PRESERVE ALL PROPERTY MARKS AND MONUMENTS UNTIL THE OWNER, AN AUTHORIZED SURVEYOR OR AGENT HAS WITNESSED OR OTHERWISE REFERENCED THEIR LOCATION.
- 5. THE CONTRACTOR SHALL OBTAIN ALL NECESSARY PERMITS PRIOR TO COMMENCING WORK AND COMPLY WITH STATE REGULATIONS REGARDING AIR, WATER, AND NOISE POLLUTION.
- 6. THE CONTRACTOR SHALL COORDINATE CONSTRUCTION ACTIVITIES WITH ALL UTILITY COMPANIES.
- 7. WHEN ELECTRIC LIGHTING IS UTILIZED IN NIGHT OPERATIONS THE CONTRACTOR SHALL EXERCISE THE UTMOST PRECAUTIONS IN PREVENTING ADVERSE VISIBILITY TO THE MOTORING PUBLIC.
- 8. QUANTITIES OF RIGID GALVANIZED STEEL CONDUIT AND PVC CONDUIT WHERE INDICATED ON THE PLANS ARE APPROXIMATIONS ONLY. THE CONTRACTOR SHALL FIELD VERIFY ALL LENGTHS AND SHALL INSTALL RACEWAYS IN COMPLETE CONFORMANCE WITH SPECIFIED REQUIREMENTS.
- 9. GROUNDING CONNECTIONS AT ALL EQUIPMENT FOUNDATIONS SHALL BE EXOTHERMICALLY WELDED, UNLESS NOTED OTHERWISE, AS SPECIFIED, AND SHALL BE INSPECTED AND APPROVED BY THE ENGINEER PRIOR TO POURING CONCRETE OR BACKFILLING, AS APPLICABLE.
- 10. NO EQUIPMENT OR MATERIAL SHALL BE DELIVERED TO THE JOB SITE PRIOR TO THE APPROVAL AND INSPECTION OF THE ENGINEER. ANY EQUIPMENT OR MATERIAL DELIVERED TO THE JOB SITE PRIOR TO APPROVAL AND INSPECTION SHALL BE REMOVED FROM THE JOB SITE AT THE CONTRACTOR'S EXPENSE.
- 11. THE PROPOSED LIGHTING CONTROL CABINETS SHALL BE INSTALLED WITHIN THE RIGHT OF WAY WITH THE EXACT LOCATION TO BE CONFIRMED BY THE CONTRACTOR IN THE FIELD.
- 12. THE CONTRACTOR SHALL PREPARE A PRELIMINARY SCHEDULE WHEN THE CONTRACT COMMENCES WHICH ESTABLISHES THE DATE WHEN THE ELECTRICAL SERVICES WILL BE REQUIRED. THIS SCHEDULE SHALL BE FORWARDED IN WRITING TO COMMONWEALTH EDISON COMPANY (Comed). SUBSEQUENT UPDATING OF THE SCHEDULE SHALL BE FORWARDED TO COMED AS CHANGES MAY OCCUR IN THE DATE OF SERVICE REQUIREMENTS. TEN (10) DAYS BEFORE THE ELECTRICAL SERVICES ARE REQUIRED, THE CONTRACTOR SHALL NOTIFY COMED BY PHONE AND CONFIRM THE REQUEST IN WRITING. COMED SERVICE CONTRACT AND AGREEMENT SHALL BE FORWARDED TO THE VILLAGE OF ORLAND PARK FOR REVIEW AND SIGNATURE.
- 13. ALL PITS USED FOR ACCESSING CONDUITS UNDER ROADWAYS SHALL BE LOCATED 5'-O" (MINIMUM) CLEAR FROM THE EDGE OF SHOULDER, LOCATIONS OF THE CONDUIT CROSSINGS SHOWN ARE APPROXIMATE AND MAY BE SHIFTED AS NECESSARY TO MEET THE MINIMUM CLEARANCE REQUIRED. THE CONTRACTOR SHALL SUBMIT PLANS FOR THE LOCATION AND SIZE OF EACH PIT AND MAINTENANCE AND PROTECTION OF TRAFFIC AT THE SITE OF EACH PIT FOR THE APPROVAL OF THE ENGINEER BEFORE THE EXCAVATION OF ANY PIT MAY BEGIN.
- 14. EXISTING LIGHTING CONTROLLERS ARE OWNED AND MAINTAINED BY THE VILLAGE OF ORLAND PARK. PROPOSED LIGHTING CONTROLLERS C101, C103, AND C105 WILL BE OWNED AND MAINTAINED BY THE VILLAGE OF ORLAND PARK.
- 15. UNDERGROUND CONDUIT SHALL EXTEND (2') BEYOND THE SHOULDER, CURB, BARRIER WALL AND/OR GUARDRAIL, AS APPLICABLE.
- 16. THE INSTALLATION OF COMBINATION TRAFFIC SIGNAL AND STREET LIGHT POLES IS A COORDINATED EFFORT OF THE TRAFFIC SIGNAL CONTRACTOR AND ELECTRICAL CONTRACTOR. THE COMBINATION LIGHTING CONTROLLER AND STANDARD COMBINATION LIGHTING DISCONNECT DETAILS ARE INCLUDED IN THE TRAFFIC SIGNAL DRAWINGS. THE TRAFFIC SIGNAL CONTRACTOR WILL PROVIDE AND INSTALL THE COMBINATION LIGHTING CONTROLLER, THE COMBINATION POLE, THE LUMINAIRE MAST ARM, AND THE COMBINATION SERVICE DISCONNECT. THE ELECTRICAL CONTRACTOR WILL PROVIDE AND INSTALL THE COMBINATION POLE LUMINAIRE, ALL WIRING INSIDE THE COMBINATION POLE ASSOCIATED WITH THE LUMINAIRE, LIGHTING CONDUCTORS BETWEEN ALL COMBINATION POLES AND THE COMBINATION LIGHTING CONTROLLER, AND THE LIGHTING POWER CONDUCTORS BETWEEN THE COMBINATION LIGHTING CONTROLLER AND THE COMBINATION SERVICE DISCONNECT. THE TRAFFIC SIGNAL CONTRACTOR AND THE ELECTRICAL CONTRACTOR MUST COORDINATE THE INSTALLATION OF TRAFFIC SIGNAL AND LIGHTING CONDUITS IN THE BASE OF THE COMBINATION SERVICE DISCONNECT, THE BASE OF THE TRAFFIC SIGNAL CONTROL CABINET AND COMBINATION LIGHTING CONTROLLER, THE BASE OF ALL COMBINATION POLES, AND THE INSTALLATION OF CONDUIT AND WIRING BETWEEN THE COMBINATION POLE AND THE TRAFFIC SIGNAL CONTROLLER. THE BASES OF ALL COMBINATION POLES, AND THE INSTALLATION OF CONDUIT AND WIRING BETWEEN THE COMBINATION POLE AND THE TRAFFIC SIGNAL CONTROLLER CABINET AND THE COMBINATION LIGHTING CONTROLLER. THE ELECTRICAL CONTRACTOR'S WORK ASSOCIATED WITH THE COMBINATION POLES IS SHOWN ON THE ELECTRICAL SHEETS.
- 17. COMBINATION LIGHTING WILL BE OWNED AND MAINTAINED BY IDOT, THEREFORE THE COMBINATION POLE UNIT IDENTIFICATION SHALL BE BLACK LETTERS AND NUMERALS ON A SILVER-WHITE REFLECTIVE BACKGROUND. ALL OTHER LIGHTING UNITS AND SYSTEMS ARE NOT MAINTAINED BY IDOT, AND SHALL HAVE AN ALTERNATE COLOR SCHEME IDENTIFICATION OF BLACK ON YELLOW.
- 18. THE TRAFFIC SIGNAL SHEETS DO NOT SHOW THE TRAFFIC SIGNAL MAST ARM POLES BEING INSTALLED IN ANY PARTICULAR STAGE OF CONSTRUCTION. THE TIMING OF THE INSTALLATION IS LEFT UP TO THE TRAFFIC SIGNAL CONTRACTOR, THE GENERAL CONTRACTOR SHALL INSURE THAT THE COMBINATION TRAFFIC SIGNAL/STREET LIGHTING MAST ARM POLES ARE INSTALLED IN THE STAGE SHOWN ON THE ELECTRICAL SHEETS.
- 19. THE COORDINATION OF THE SIDE STREET WORK WITH LOGRANGE ROAD WORK IS LEFT UP TO THE CONTRACTOR. IT IS THE CONTRACTOR'S RESPONSIBILITY TO MAINTAIN THE OPERATING STATUS OF LOGRANGE ROAD STREET LIGHTS REGARDLESS OF THE SIDE STREET STAGING. THIS MEANS THE CONTRACTOR MAY HAVE TO INSTALL TEMPORARY OVERHEAD WIRING FOR LOGRANGE ROAD STREET LIGHTS TO BYPASS STREET LIGHTS NOT YET INSTALLED. NOT ALL POSSIBILITIES FOR TEMPORARY OVERHEAD WIRING NEEDS ARE SHOWN ON THE PLANS, SINCE THIS DEPENDS UPON COORDINATION AS DETERMINED BY THE CONTRACTOR.
- 20. ALL LIGHT POLE SETBACKS SHOWN ARE MEASURED FROM THE FACE OF CURB TO THE CENTER OF LIGHT POLE, UNLESS STATED OTHERWISE. IF THERE IS NO CURB, THE SETBACK WILL BE MEASURED FROM THE EDGE OF TRAVELLED PAVEMENT.

GENERAL NOTES (CONTINUED):

- 21. FURNISH AND INSTALL A COMBINATION POLE LIGHTING CONTROLLER TO OPERATE THE LIGHT FIXTURES ON THE PROPOSED LIGHTING/TRAFFIC SIGNALS COMBINATION POLES AS SHOWN ON THESE PLANS. THE COMBINATION LIGHTING CONTROLLER (CLC) SHALL BE ATTACHED TO THE SIDE OF THE TRAFFIC SIGNAL CONTROLLER CABINET AS SHOWN ON THE ATTACHED DETAILS. COMBINATION LIGHTING CONTROLLERS ARE POWERED FROM THE PROPOSED LIGHTING/TRAFFIC SIGNALS COMBINATION SERVICE DISCONNECT CABINET, AND PAID FOR UNDER PAY ITEM NO. X8250090 "COMBINATION POLE LIGHTING CONTROLLER".
- 22. FURNISH AND INSTALL A 1" UNIT DUCT WITH 3-1/C "8, 1/C "10 G, IN a 2" RGC CONDUIT FROM EACH PROPOSED COMBINATION LIGHTING/TRAFFIC SIGNALS SERVICE DISCONNECT CABINET TO EACH PROPOSED COMBINATION LIGHTING CONTROLLER LOCATION. INSTALL THE UNIT DUCT IN A SEPARATE CONDUIT FOR THE ENTIRE RUN. SEE TRAFFIC SIGNAL PLANS FOR LOCATION OF COMED POWER SOURCE FEEDING COMBINATION LIGHTING CONTROLLERS AND LOCATION OF EACH COMBINATION SERVICE DISCONNECT.
- 23. PROPOSED LIGHT POLE SET BACKS ARE MEASURED FROM THE FACE OF CURB TO THE CENTER OF THE LIGHT POLE. MINIMUM SET BACK SHALL BE 3 FEET. OFFSETS FOR TEMPORARY LIGHTING WOOD POLES ARE MEASURED FROM THE ROADWAY CENTERLINE TO THE CENTER OF THE WOOD POLE.

SUGGESTED LIGHTING PHASING NOTES:

PRE-STAGE (PRIOR TO THE START OF STAGE 1 CONSTRUCTION)

- A. FURNISH AND INSTALL TEMPORARY LIGHTING CONTROLLERS "T101", "T102", AND "T103" AS SHOWN ON DRAWINGS E-11 THROUGH E-13.
- B. COORDINATE WITH COMED TO GET POWER TO LIGHTING CONTROLLERS "T101", "T102", AND "T103". FURNISH AND INSTALL ALL ITEMS NECESSARY AS COORDINATED WITH COMED TO GET POWER TO LIGHTING CONTROLLERS "T101", "T102", AND "T103".
- C. FURNISH, INSTALL, AND ENERGIZE ALL TEMPORARY LIGHTING UNITS AS INDICATED ON DRAWINGS E-10 THROUGH E-16 PRIOR TO THE REMOVAL OF EXISTING LIGHTING UNITS.
- D. REMOVE EXISTING LIGHTING UNITS AND FOUNDATIONS ON THE WEST SIDE OF US-45 (Lagrange ROAD) AND ALONG ALL SIDE ROADS IMPACTED BY THIS PROJECT AS INDICATED ON DRAWINGS E-10 THROUGH E-16 IN ACCORDANCE WITH THE SPECIAL PROVISIONS.
- E. TRANSPORT ALL REMOVED LIGHTING UNITS TO THE OWNER'S ELECTRICAL MAINTENANCE FACILITY FOR PROCESSING AS DETERMINED BY THE ENGINEER, UNLESS NOTED OTHERWISE.

STAGE 1

- A. REMOVE EXISTING LIGHTING UNITS AND FOUNDATIONS ON THE EAST SIDE OF US-45 (LGGRANGE ROAD) AS INDICATED ON DRAWINGS E-10 THROUGH E-13 IN ACCORDANCE WITH THE SPECIAL PROVISIONS.
- B. TRANSPORT ALL REMOVED LIGHTING UNITS TO THE OWNER'S ELECTRICAL MAINTENANCE FACILITY FOR PROCESSING AS DETERMINED BY THE ENGINEER, UNLESS NOTED OTHERWISE.
- C. COORDINATE WITH COMED FOR THE REMOVAL OF POWER TO LIGHTING CONTROLLERS FOR LIGHT SYSTEMS 3 AND 4 LOCATED ON DRAWINGS E-10 AND E-11. REMOVE THE LIGHTING CONTROLLERS AND FOUNDATIONS. TRANSPORT THE REMOVED LIGHTING CONTROLLERS TO THE OWNER'S ELECTRICAL MAINTENANCE FACILITY FOR PROCESSING PER THE SPECIAL PROVISIONS.
- D. CONSTRUCT NEW LIGHTING UNIT FOUNDATIONS FOR PROPOSED AND EXISTING TO BE RELOCATED LIGHTING UNITS AS SHOWN ON DRAWING E-20 BETWEEN 144+h PLACE AND 143rd STREET ALONG NORTHBOUND (EAST) SIDE OF US-45 (LOGRANCE ROAD), INSTALL LIGHTING UNITS ON PROPOSED FOUNDATIONS. CONNECT LUMINAIRES TO EXISTING LIGHTING CONTROLLER "RWP-1". CONNECT THE RECEPTACLES ON LIGHTING UNITS TO EXISTING RECEPTACLES ON LIGHTING UNITS TO EXISTING RECEPTACLES ON LIGHTING UNITS TO EXISTING RECEPTACLES.
- E. FURNISH AND INSTALL PROPOSED LIGHTING CONTROLLERS "C101", "C103", AND "C105" AND ASSOCIATED UTILITY SERVICES. COORDINATE WORK WITH COMED.
- F. FURNISH, INSTALL, AND ENERGIZE PROPOSED LIGHTING UNITS ON THE EAST SIDE OF US-45 (Lagrange ROAD) AS INDICATED ON DRAWINGS E-17 THROUGH E-20, FURNISH AND INSTALL TEMPORARY CONNECTION FOR LIGHTING CONTROLLER "C103" CIRCUITS G AND H BETWEEN CONTROLLER "C103" AND LIGHTING UNIT "C103,G,3" TO ENERGIZE LUMINAIRES AS SHOWN ON DRAWING E-18.

STAGE 2

A. REMOVE ALL TEMPORARY LIGHTING UNITS, TEMPORARY LIGHTING CONTROLLERS "T101", "T102", AND "T103", ASSOCIATED UTILITY SERVICES, AND WIRING ONCE TRAFFIC IS SHIFTED TO PROPOSED NORTHBOUND LANES CONSTRUCTED IN STAGE 1.

STAGE 3

- A. CONSTRUCT NEW LIGHTING UNIT FOUNDATIONS FOR PROPOSED AND EXISTING TO BE RELOCATED LIGHTING UNITS AS SHOWN ON DRAWING E-34 BETWEEN 144+h PLACE AND 143rd STREET ALONG SOUTHBOUND (WEST) SIDE OF US-45 (LOGRANGE ROAD), INSTALL LIGHTING UNITS ON PROPOSED FOUNDATIONS. CONNECT LUMINAIRES TO EXISTING LIGHTING CONTROLLER "RWP-1". CONNECT THE RECEPTACLES ON LIGHTING UNITS TO EXISTING RECEPTACLE CONTROLLER "H-2".
- B. CONSTRUCT NEW LIGHTING UNIT FOUNDATION FOR EXISTING TO BE RELOCATED LIGHTING UNIT "C6H4" AT LOCATION SHOWN ON DRAWING E-31. REMOVE, REINSTALL, AND ENERGIZE LIGHTING UNIT AT PROPOSED LOCATION.
- C. FURNISH, INSTALL, AND ENERGIZE PROPOSED LIGHTING UNITS ON THE WEST SIDE OF US-45 (Lagrange ROAD) AS INDICATED ON DRAWINGS E-31 THROUGH E-34.


SIDE ROAD CONSTRUCTION STAGE A

A. CONSTRUCT NEW LIGHTING UNIT FOUNDATIONS FOR PROPOSED AND EXISTING TO BE RELOCATED LIGHTING UNITS ALONG SOUTH SIDES (EASTBOUND LANES) OF SIDE ROADS AS SHOWN ON DRAWINGS E-21 THROUGH E-23. INSTALL AND ENERGIZE LIGHTING UNITS ON PROPOSED FOUNDATIONS. COORDINATE INSTALLATION AND CONNECTION OF LIGHTING UNITS WITH CONSTRUCTION STAGES FOR US-45 (LOGRANGE ROAD) AND ALL SIDE ROADS IMPACTED BY THIS PROJECT.

SIDE ROAD CONSTRUCTION STAGE B

A. CONSTRUCT NEW LIGHTING UNIT FOUNDATIONS FOR PROPOSED AND EXISTING TO BE RELOCATED LIGHTING UNITS ALONG NORTH SIDES (WESTBOUND LANES) OF SIDE ROADS AS SHOWN ON DRAWINGS E-28 THROUGH E-30. INSTALL AND ENERGIZE LIGHTING UNITS ON PROPOSED FOUNDATIONS. CONSTRUCT PERMANENT CONNECTION OF PROPOSED LIGHTING CONTROLLER "C103" CIRCUITS G, H, R2, AND R4, AND REMOVE TEMPORARY AERIAL CONNECTION TO CONTROLLER FROM LIGHTING UNIT "C103.G.3". COORDINATE INSTALLATION AND CONNECTION OF LIGHTING UNITS WITH CONSTRUCTION STAGES FOR US-45 (Lagrange ROAD) AND ALL SIDE ROADS IMPACTED BY THIS PROJECT.

LE NAME =	USER NAME = michal_bartusiewicz	DESIGNED - MAE	REVISED -
60M61-SHT-E02.dgn		DRAWN - MAE	REVISED -
	PLOT SCALE = 2.0000 '/ in.	CHECKED - DAD	REVISED -
HT_PLAN	PLOT DATE = 3/15/2013	DATE - 03/13/2013	PEVISED -

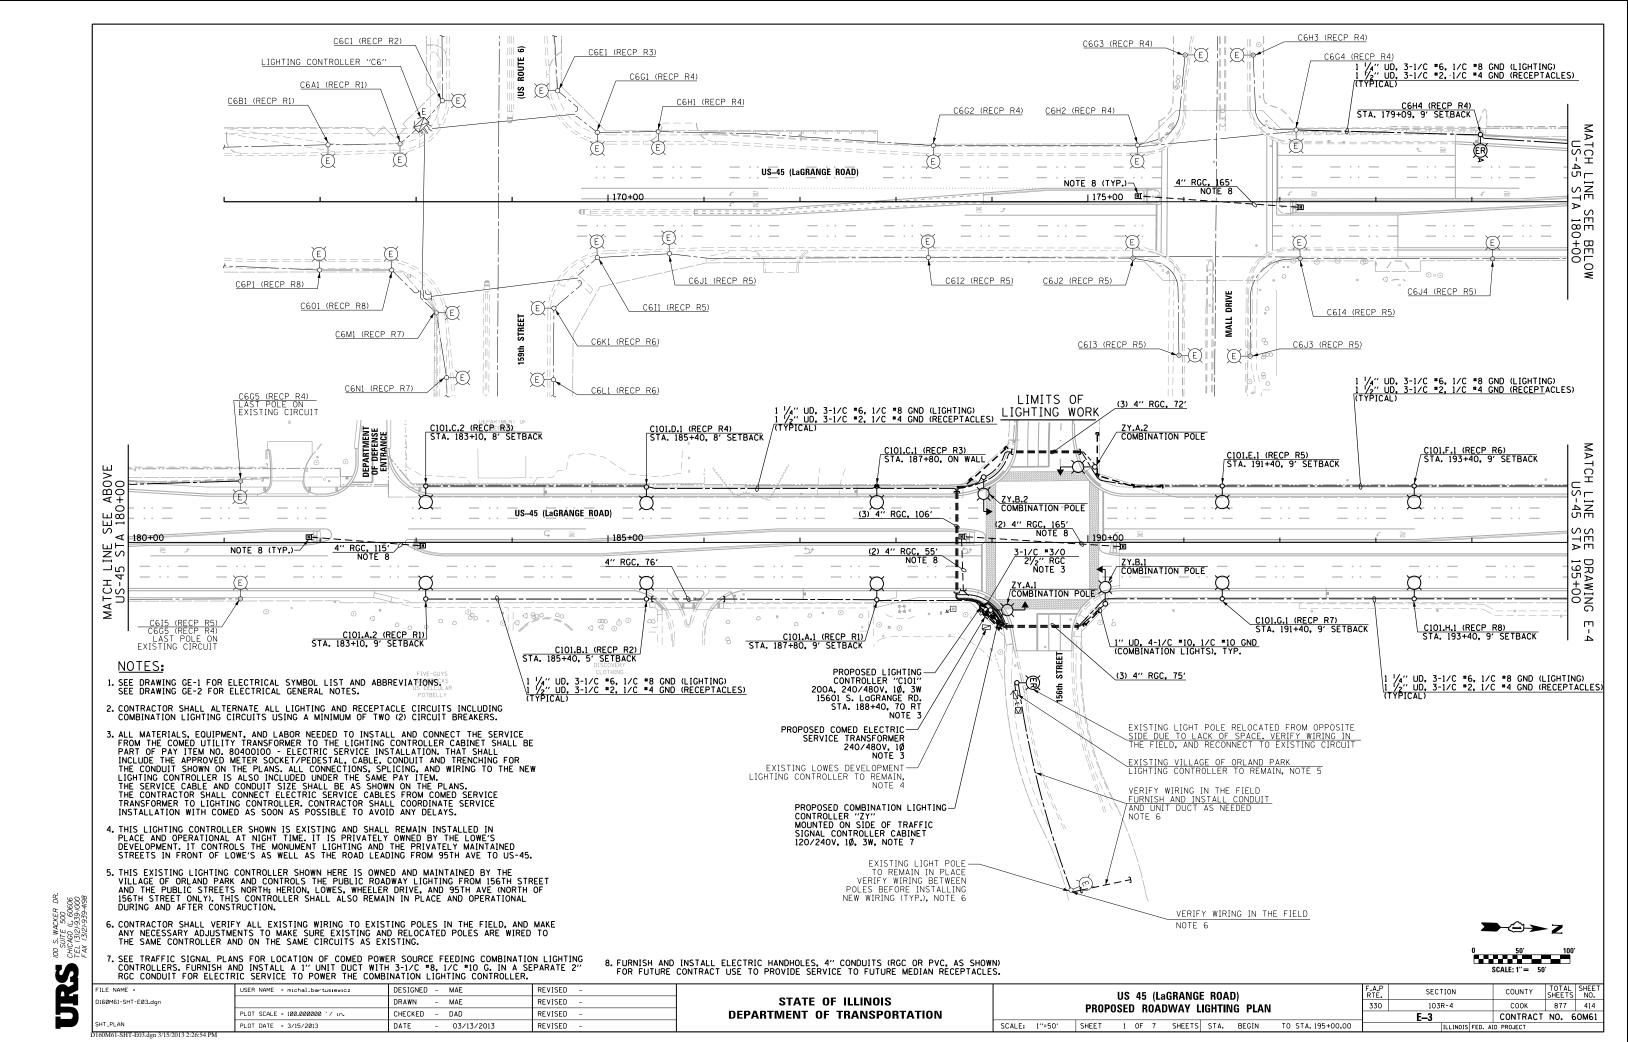

1/4" UD, 3-1/C =6, 1/C =8 GND (LIGHTING)
2" UD, 3-1/C =2, 1/C =4 GND (RECEPTACLES)
TYPICAL)

ZX.B.2
COMBINATION POLE

COMBINATION POLE

120/240V, 10, 3W NOTE 5

PROPOSED COMBINATION LIGHTING CONTROLLER "ZX" MOUNTED ON SIDE OF TRAFFIC SIGNAL CONTROLLER CABINET

C101.F.2 (RECP R6) STA. 198+00, ON WALL

C101.E.2 (RECP R5) STA. 195+70, 9' SETBACK

C101.G.2 (RECP R7) STA. 195+70, 9' SETBACK

C103.C.3 (RECP R3)
STA. 210+55, 6' SETBACK, NOTE 4

4" RGC. 33"

C101.H.2 (RECP R8)
STA. 198+00, ON WALL

ш

SE

- $\frac{1}{2}$

MATCH

95+00

LIMITS OF

LIGHTING WORK

(2) 4" RGC, 110"

LIMITS OF

LIGHTING WORK

1 '/4" UD, 3-1/C "6, 1/C "8 GND (LIGHTING) -1 '/2" UD, 3-1/C "2, 1/C "4 GND (RECEPTACLES) (TYPICAL)/

C103.C.2 (RECP R3) STA, 215+35, NOTE 4

4" RGC, 156' NOTE 6

(3) 4" RGC, 67'

ZX.A.2 COMBINATION POLE

4" RGC, 33"

ZX.B.1 COMBINATION POLE

(2) 4" RGC, 62'

US-45 (LaGRANGE ROAD)

54TH PLAC

C101.E.3 (RECP R5) STA. 202+60. 6' SETBACK

C101.G.3 (RECP R7) STA. 202+60, 9' SETBACK

C103.D.1 (RECP R4) STA. 217+60, 9' SETBACK

C103.C.1 (RECP R3)
STA. 220+00, 9' SETBACK

PROPOSED COMBINATION LIGHTING— CONTROLLER "ZW" MOUNTED ON SIDE OF TRAFFIC SIGNAL CONTROLLER CABINET 120/240V, 10, 3W NOTE 5

4" RGC, 71

C101.G.4 (RECP R7) STA. 207+20, 9' SETBACK

4" RGC, 85' NOTE 6

(3) 4" RGC, 84"

ZV.B.2 COMBINATION POLE

ZV.A.1 COMBINATION POLE

120/240V, 10, 3W NOTE 5

C103.G.1 (RECP R7)
STA. 224+36, 9' SETBACK

- PROPOSED COMBINATION LIGHTING CONTROLLER "ZV" MOUNTED ON SIDE OF TRAFFIC SIGNAL CONTROLLER CABINET

4" PVC, 200 NOTE 6

1" UD, 4-1/C *10, 1/C *10 GND (COMBINATION LIGHTS), TYP.

SEE DRAWING E-8 FOR CONTINUATION

ZV.A.2 COMBINATION POLE

SEE DRAWING E-8

FOR CONTINUATION

C101.E.4 (RECP R5)

C101.F.3 (RECP R6)
STA. 204+90, 9' SETBACK

| 205+00

1 1/4" UD, 3-1/C *6, 1/C *8 GND (LIGHTING) 1 1/2" UD, 3-1/C *2, 1/C *4 GND (RECEPTACLES) (TYPICAL)

PROPOSED COMED ELECTRIC SERVICE TRANSFORMER 240/480V, 10, 3W NOTE 3

4" RGC, 35"

C101.H.3 (RECP R8) STA. 204+90. 9' SETBACK

3-1/C *3/0 2¹/₂" RGC NOTE 3

SEE DRAWING E-7

FOR CONTINUATION

ZW.B.1 COMBINATION POLE

(2) 4" RGC. 106'

ZW.A.2 COMBINATION POLE

LIMITS OF LIGHTING WORK

ZW.A.1 COMBINATION POLE

MATCH US-2

15 ST LINE

SEE A 210

BELOW 0+00

MATCH

LINE JS-45

SEE

DRAWING 225+00

Ш

<u>ZW.B.2</u> COMBINATION POLE

4" RGC, 74

C103.E.1 (RECP R5) STA, 224+36, NOTE 4

2	6. FURNISH AND INSTALL EL CONTRACT USE TO PROVI	LECTRIC HANDHOLES, 4" CONDUITS IDE SERVICE TO FUTURE MEDIAN	S (RGC OR PVC, AS SHOWN) FOR RECEPTACLES.	FUTURE										SCALE: 1"= 5		
•	FILE NAME =	USER NAME = michal_bartusiewicz	DESIGNED - MAE	REVISED -				116 45 (1	~CD A NIC	GE ROAD)		F.A.P	SECTION	COUNTY	TOTAL	AL SHEET
	D160M61-SHT-E04.dgn		DRAWN - MAE	REVISED -	STATE OF ILLINOIS			•		LIGHTING PLAN	1	330	103R-4	соок	877	7 415
3		PLOT SCALE = 100.0000000 '/ 10.	CHECKED - DAD	REVISED -	DEPARTMENT OF TRANSPORTATION		FNUFU	SED NUA	UVVAI	LIGHTING FLAN	1		E-4	CONTRAC	T NO.	60M61
	SHT_PLAN	PLOT DATE = 3/15/2013	DATE - 03/13/2013	REVISED -		SCALE: 1"=50"	SHEET	2 OF 7	SHEETS	STA. 195+00.00	TO STA. 225+00.00		ILLINOIS '	FED. AID PROJECT		





DESIGNED - MAE REVISED DRAWN - MAE REVISED LOT SCALE = 100.000000 '/ in-CHECKED - DAD REVISED DATE - 03/13/2013 PLOT DATE = 3/15/2013 REVISED


STATE OF ILLINOIS **DEPARTMENT OF TRANSPORTATION**

US 45 (LaGRANGE ROAD) PROPOSED ROADWAY LIGHTING PLAN SCALE: 1"=50" SHEET 3 OF 7 SHEETS STA. 225+00.00 TO STA.255+00.00

SECTION 330 103R-4 E-5

COUNTY COOK 877 416 CONTRACT NO. 60M61

ILE NAME 160M61-SHT-E05.dar

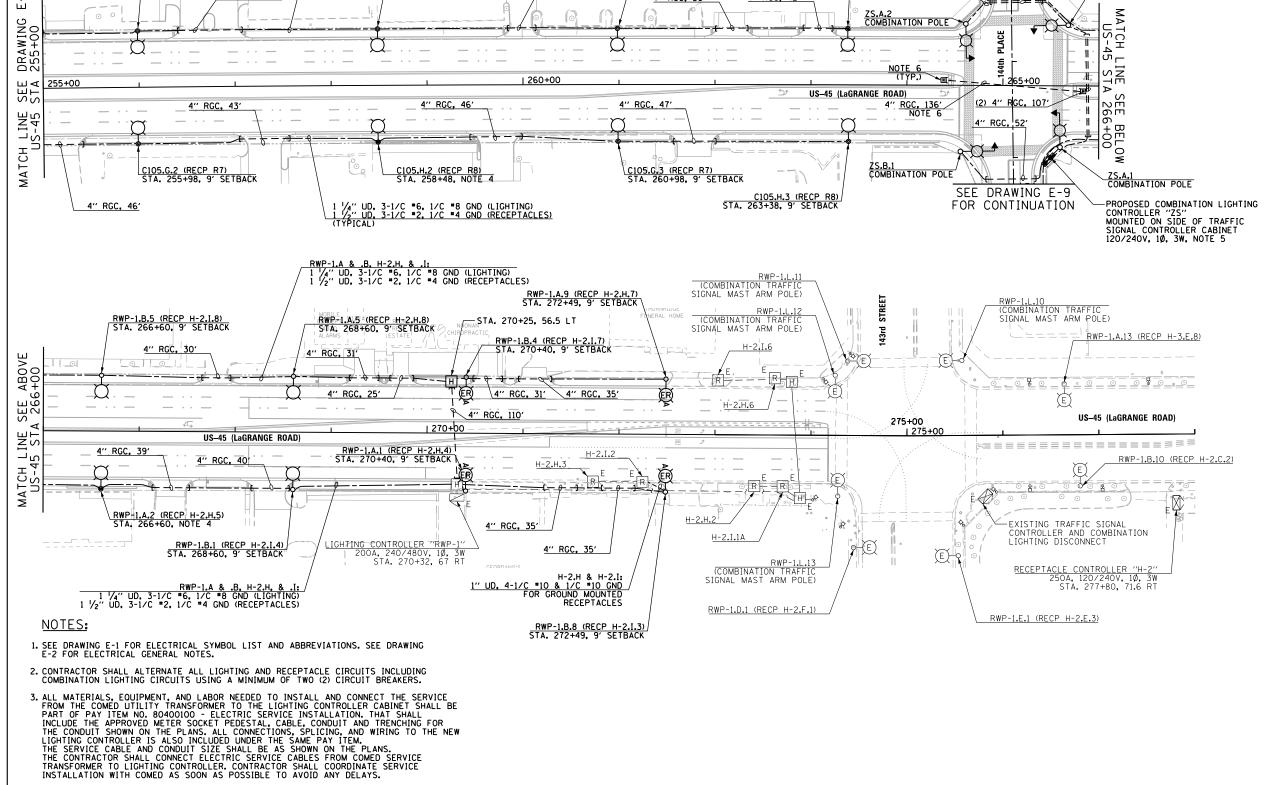

C105.E.3 (RECP R5) STA. 260+98. 9' SETBACK

4" RGC. 36'

4" RGC, 42'

1 1/4" UD, 3-1/C #6, 1/C #8 GND (LIGHTING)
1 1/2" UD, 3-1/C #2, 1/C #4 GND (RECEPTACLES)
(TYPICAL)

C105.F.2 (RECP R6) STA. 258+48, 9' SETBACK

4" RGC. 31'

C105.E.2 (RECP R5)

4" RGC, 69"

4. CONTRACTOR SHALL INSTALL GROUND MOUNTED LIGHT POLE FOUNDATIONS AS CLOSE TO RIGHT OF WAY AS POSSIBLE AT THIS LOCATION. AT LOCATIONS WHERE A RETAINING WALL IS PROPOSED, CONTRACTOR SHALL ROUTE RETAINING WALL AROUND LIGHT POLES.

5. SEE TRAFFIC SIGNAL PLANS FOR LOCATION OF COMED POWER SOURCE FEEDING COMBINATION LIGHTING CONTROLLERS. FURNISH AND INSTALL A 1" UNIT DUCT WITH 3-1/C *8, 1/C *10 G. IN A SEPARATE 2" RGC CONDUIT FOR ELECTRIC SERVICE TO POWER THE COMBINATION LIGHTING CONTROLLER.

2



SEE DRAWING E-9


FOR CONTINUATION

(2) 4" RGC, 55'


ZS.B.2 COMBINATION POLE

1" UD, 4-1/C *10, 1/C *10 GND (COMBINATION LIGHTS), TYP,


C105.F.3 (RECP R6) STA. 263+38, 9' SETBACK

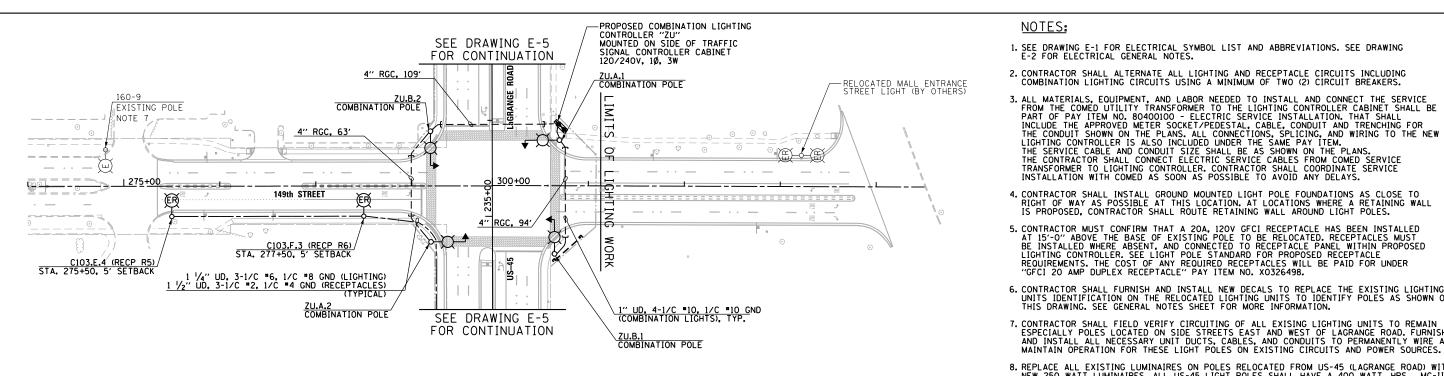

149TH STREET

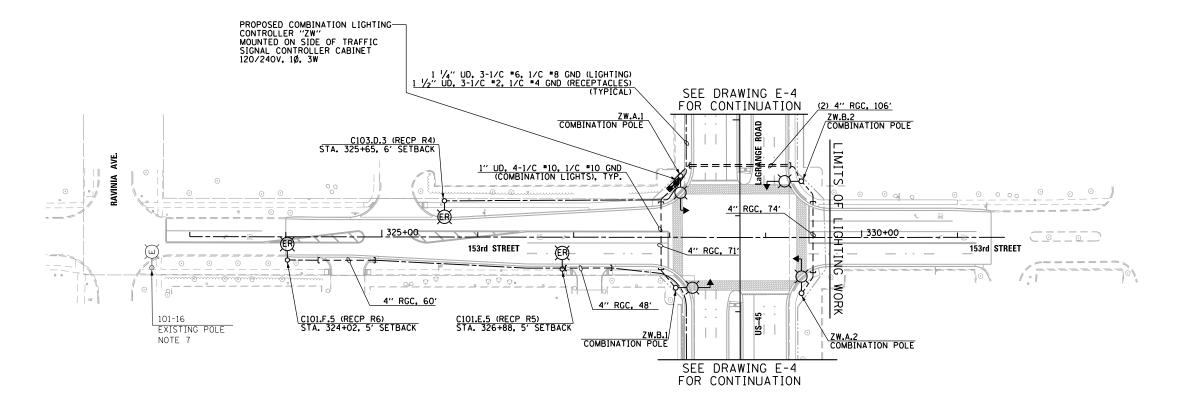

153RD STREET

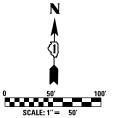

FILE NAME =	USER NAME = michal_bartusiewicz	DESIGNED - MAE	REVISED -
D160M61-SHT-E07.dgn		DRAWN - MAE	REVISED -
	PLOT SCALE = 100.0000000 '/ in.	CHECKED - DAD	REVISED -
SHT_PLAN	PLOT DATE = 3/15/2013	DATE - 03/13/2013	REVISED -

STATE OF ILLINOIS **DEPARTMENT OF TRANSPORTATION**

153rd STREET & 149th STREET PROPOSED ROADWAY LIGHTING PLAN SCALE: 1"=50' SHEET 5 OF 7 SHEETS STA. VARIES TO STA. VARIES

NOTES:

1. SEE DRAWING E-1 FOR ELECTRICAL SYMBOL LIST AND ABBREVIATIONS. SEE DRAWING E-2 FOR ELECTRICAL GENERAL NOTES.

2. CONTRACTOR SHALL ALTERNATE ALL LIGHTING AND RECEPTACLE CIRCUITS INCLUDING COMBINATION LIGHTING CIRCUITS USING A MINIMUM OF TWO (2) CIRCUIT BREAKERS.

INSTALLATION WITH COMED AS SOON AS POSSIBLE TO AVOID ANY DELAYS.

4. CONTRACTOR SHALL INSTALL GROUND MOUNTED LIGHT POLE FOUNDATIONS AS CLOSE TO RICHT OF WAY AS POSSIBLE AT THIS LOCATION. AT LOCATIONS WHERE A RETAINING WALL IS PROPOSED, CONTRACTOR SHALL ROUTE RETAINING WALL AROUND LIGHT POLES.


5. CONTRACTOR MUST CONFIRM THAT A 20A, 120V GFC1 RECEPTACLE HAS BEEN INSTALLED AT 15'-O" ABOVE THE BASE OF EXISTING POLE TO BE RELOCATED. RECEPTACLES MUST BE INSTALLED WHERE ABSENT, AND CONNECTED TO RECEPTACLE PANEL WITHIN PROPOSED LIGHTING CONTROLLER. SEE LIGHT POLE STANDARD FOR PROPOSED RECEPTACLE REQUIREMENTS. THE COST OF ANY REQUIRED RECEPTACLES WILL BE PAID FOR UNDER "GFC1 20 AMP DUPLEX RECEPTACLE" PAY ITEM NO. X0326498.

6. CONTRACTOR SHALL FURNISH AND INSTALL NEW DECALS TO REPLACE THE EXISTING LIGHTING UNITS IDENTIFICATION ON THE RELOCATED LIGHTING UNITS TO IDENTIFY POLES AS SHOWN ON THIS DRAWING. SEE GENERAL NOTES SHEET FOR MORE INFORMATION.


7. CONTRACTOR SHALL FIELD VERIFY CIRCUITING OF ALL EXISING LIGHTING UNITS TO REMAIN ESPECIALLY POLES LOCATED ON SIDE STREETS EAST AND WEST OF LAGRANGE ROAD. FURNISH AND INSTALL ALL NECESSARY UNIT DUCTS, CABLES, AND CONDUITS TO PERMANENTLY WIRE AND MAINTAIN OPERATION FOR THESE LIGHT POLES ON EXISTING CIRCUITS AND POWER SOURCES.

8. REPLACE ALL EXISTING LUMINAIRES ON POLES RELOCATED FROM US-45 (LAGRANGE ROAD) WITH NEW 250 WATT LUMINAIRES. ALL US-45 LIGHT POLES SHALL HAVE A 400 WATT, HPS, MC-III LUMINAIRES. ALL SIDE STREET RELOCATED POLES SHALL HAVE 250 WATT, HPS, MC-III LUMINAIRES, EXCEPT WHERE NOTED OTHERWISE ON THE PLANS, NEW 250 WATT LUMINAIRES SHALL HAVE THE SAME CATALOG NUMBER AS THE PROPOSED 400 WATT LUMINAIRES EXCEPT THAT THE BALLAST AND LAMP ARE DESIGNED FOR 250 WATT OPERATION.


SECTION COUNTY 330 103R-4 COOK 877 418 E-7 CONTRACT NO. 60M61

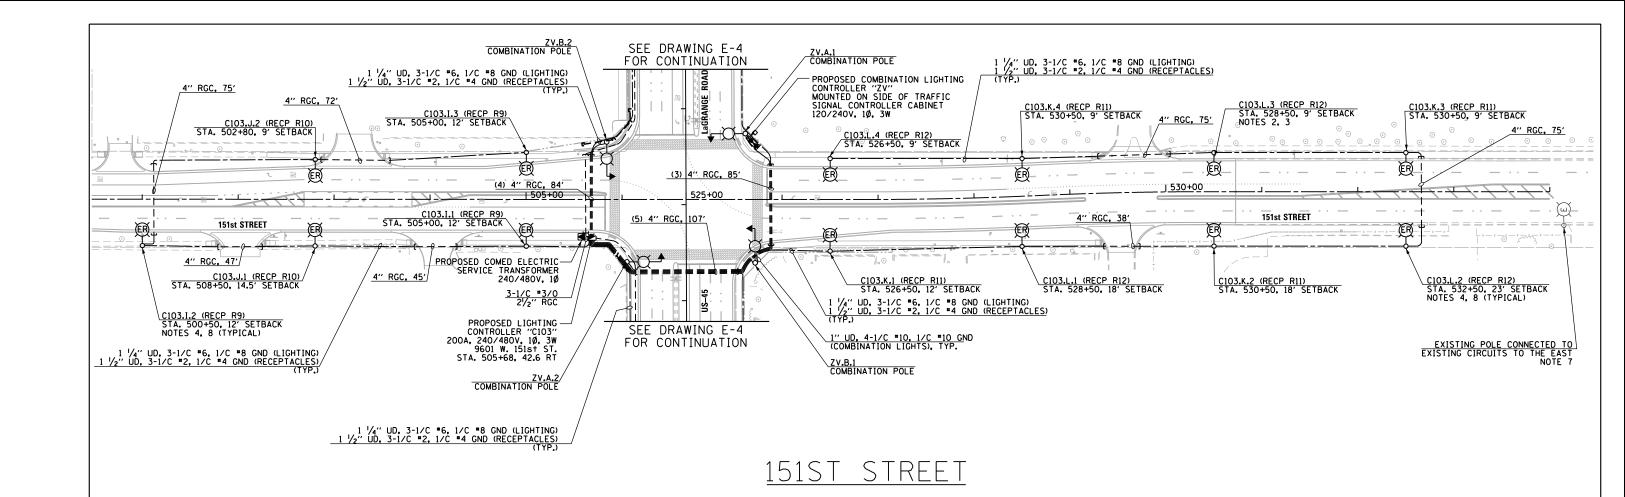

- SEE DRAWING E-1 FOR ELECTRICAL SYMBOL LIST AND ABBREVIATIONS. SEE DRAWING E-2 FOR ELECTRICAL GENERAL NOTES.
- 2. CONTRACTOR SHALL ALTERNATE ALL LIGHTING AND RECEPTACLE CIRCUITS INCLUDING COMBINATION LIGHTING CIRCUITS USING A MINIMUM OF TWO (2) CIRCUIT BREAKERS.
- 3. ALL MATERIALS, EQUIPMENT, AND LABOR NEEDED TO INSTALL AND CONNECT THE SERVICE FROM THE COMED UTILITY TRANSFORMER TO THE LIGHTING CONTROLLER CABINET SHALL BE PART OF PAY ITEM NO. 80400100 ELECTRIC SERVICE INSTALLATION. THAT SHALL INCLUDE THE APPROVED METER SOCKET/PEDESTAL, CABLE, CONDUIT AND TRENCHING FOR THE CONDUIT SHOWN ON THE PLANS. ALL CONNECTIONS, SPLICING, AND WIRING TO THE NEW LIGHTING CONTROLLER IS ALSO INCLUDED UNDER THE SAME PAY ITEM. THE SERVICE CABLE AND CONDUIT SIZE SHALL BE AS SHOWN ON THE PLANS. THE CONTRACTOR SHALL CONNECT ELECTRIC SERVICE CABLES FROM COMED SERVICE TRANSFORMER TO LIGHTING CONTROLLER. CONTRACTOR SHALL COORDINATE SERVICE INSTALLATION WITH COMED AS SOON AS POSSIBLE TO AVOID ANY DELAYS.
- 4. CONTRACTOR SHALL INSTALL GROUND MOUNTED LIGHT POLE FOUNDATIONS AS CLOSE TO RIGHT OF WAY AS POSSIBLE WHEN POLE IS SHOWN TO BE INSTALLED CLOSE TO RIGHT OF WAY LINE. AT LOCATIONS WHERE A RETAINING WALL IS PROPOSED, CONTRACTOR SHALL ROUTE RETAINING WALL AROUND LIGHT POLES.
- 5. CONTRACTOR SHALL CONFIRM THAT A 20A, 120V GFCI RECEPTACLE HAS BEEN INSTALLED AT 15'-0" ABOVE THE BASE OF EXISTING POLE TO BE RELOCATED. RECEPTACLES MUST BE INSTALLED WHERE ABSENT, AND CONNECTED TO RECEPTACLE PANEL WITHIN PROPOSED LIGHTING CONTROLLER. SEE LIGHT POLE STANDARD FOR PROPOSED RECEPTACLE REQUIREMENTS. THE COST OF ANY REQUIRED RECEPTACLES WILL BE PAID FOR UNDER "GFCI 20 AMP DUPLEX RECEPTACLE" PAY ITEM NO. X0326498.
- 6. CONTRACTOR SHALL FURNISH AND INSTALL NEW DECALS TO REPLACE THE EXISTING LIGHTING UNITS IDENTIFICATION ON THE RELOCATED LIGHTING UNITS TO IDENTIFY POLES AS SHOWN ON THIS DRAWING. SEE GENERAL NOTES SHEET FOR MORE INFORMATION.
- 7. CONTRACTOR SHALL FIELD VERIFY CIRCUITING OF ALL EXISING LIGHTING UNITS TO REMAIN ESPECIALLY POLES LOCATED ON SIDE STREETS EAST AND WEST OF LAGRANGE ROAD. FURNISH AND INSTALL ALL NECESSARY UNIT DUCTS, CABLES, AND CONDUITS TO PERMANENTLY WIRE AND MAINTAIN OPERATION FOR THESE LIGHT POLES ON EXISTING CIRCUITS AND POWER SOURCES.
- 8. REPLACE ALL EXISTING LUMINAIRES ON POLES RELOCATED FROM US-45 (LAGRANGE ROAD) WITH NEW 250 WATT LUMINAIRES, ALL US-45 LIGHT POLES SHALL HAVE A 400 WATT, HPS, MC-III LUMINAIRES, ALL SIDE STREET RELOCATED POLES SHALL HAVE 250 WATT, HPS, MC-III LUMINAIRES, EXCEPT WHERE NOTED OTHERWISE ON THE PLANS. NEW 250 WATT LUMINAIRES SHALL HAVE THE SAME CATALOG NUMBER AS THE PROPOSED 400 WATT LUMINAIRES EXCEPT THAT THE BALLAST AND LAMP ARE DESIGNED FOR 250 WATT OPERATION.

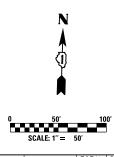

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	FILE NAME =	USER NAME = michal_bartusiewicz	DESIGNED - MAE	REVISED -			F.A.P SE	ECTION	COUNTY T	TOTAL SHEET
	D160M61-SHT-E08.dgn		DRAWN - MAE	REVISED -	STATE OF ILLINOIS	151st STREET PROPOSED ROADWAY LIGHTING PLAN	330 10	03R-4		877 419
3		PLOT SCALE = 100.0000000 '/ in.	CHECKED - DAD	REVISED -	DEPARTMENT OF TRANSPORTATION		E-8		CONTRACT N	NO. 60M61
	SHT_PLAN	PLOT DATE = 3/15/2013	DATE - 03/13/2013	REVISED -		SCALE: 1"=50" SHEET 6 OF 7 SHEETS STA. 498+50.00 TO STA. 531+50.00		ILLINOIS FED. AID	PROJECT	

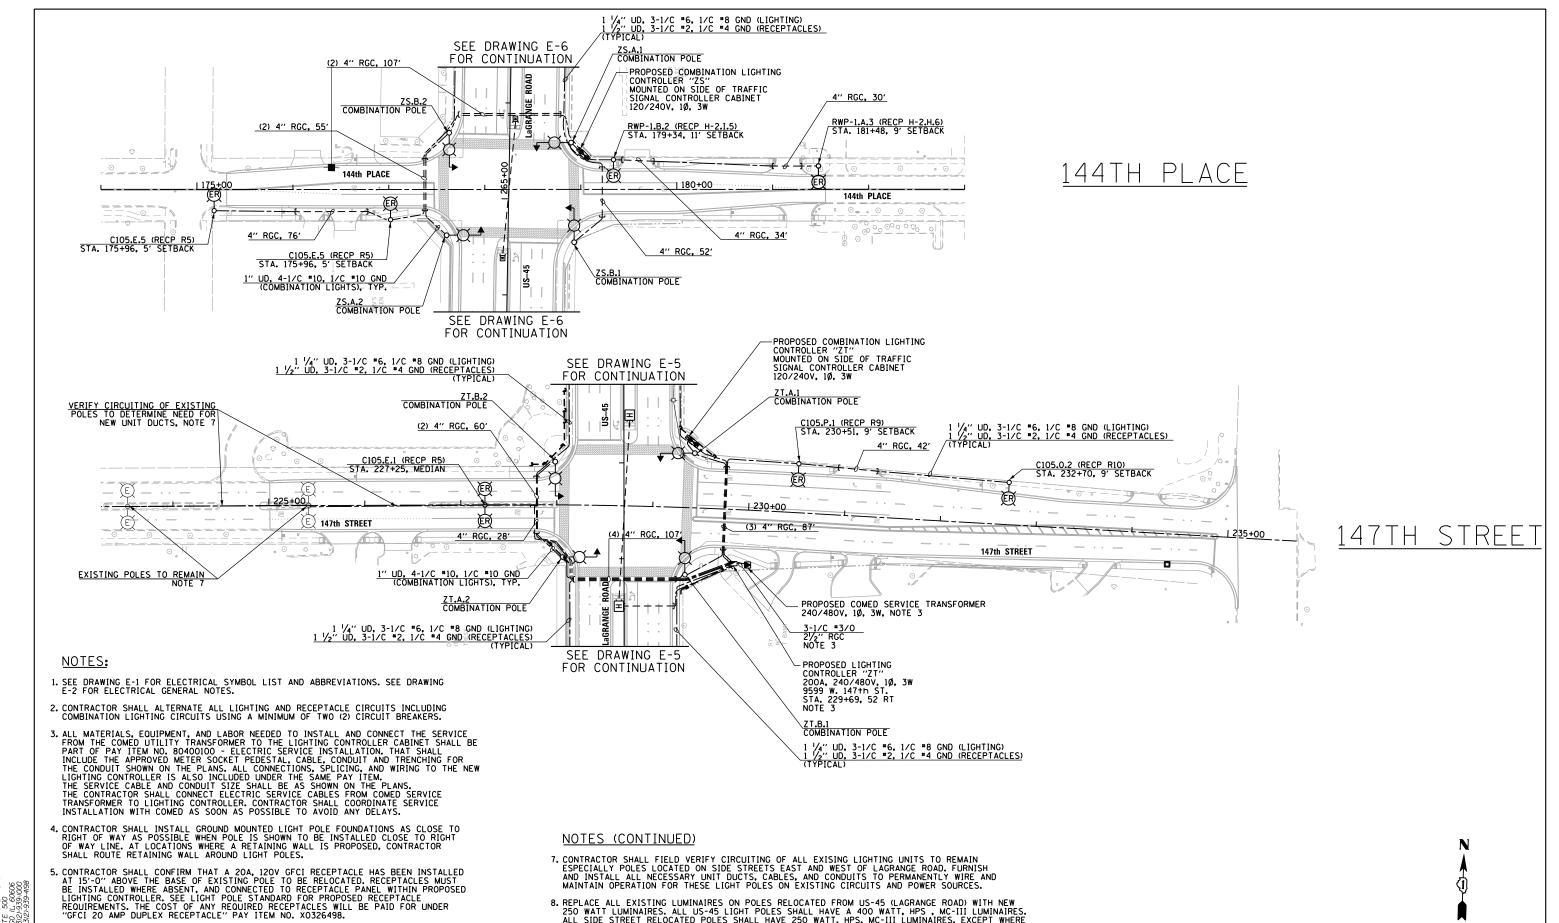

FILE NAME = DESIGNED - MAE REVISED USER NAME = michal_bartusiewicz 160M61-SHT-E09.dgr ORAWN - MAF REVISED CHECKED - DAD REVISED 03/13/2013 PLOT DATE = 3/15/2013 DATE REVISED


6. CONTRACTOR SHALL FURNISH AND INSTALL NEW DECALS TO REPLACE THE EXISTING LIGHTING UNITS IDENTIFICATION ON THE RELOCATED LIGHTING UNITS TO IDENTIFY POLES AS SHOWN ON THIS DRAWING. SEE GENERAL NOTES SHEET FOR MORE INFORMATION.

STATE OF ILLINOIS **DEPARTMENT OF TRANSPORTATION**

8. REPLACE ALL EXISTING LUMINAIRES ON POLES RELOCATED FROM US-45 (LAGRANGE ROAD) WITH NEW 250 WATT LUMINAIRES, ALL US-45 LIGHT POLES SHALL HAVE A 400 WATT, HPS, MC-III LUMINAIRES, ALL SIDE STREET RELOCATED POLES SHALL HAVE 250 WATT, HPS, MC-III LUMINAIRES, EXCEPT WHERE NOTED OTHERWISE ON THE PLANS. NEW 250 WATT LUMINAIRES SHALL HAVE THE SAME CATALOG NUMBER AS THE PROPOSED 400 WATT LUMINAIRES EXCEPT THAT THE BALLAST AND LAMP ARE DESIGNED FOR 250 WATT OPERATION.

147th STREET & 144th PLACE PROPOSED ROADWAY LIGHTING PLAN SCALE: 1"=50' SHEET 7 OF 7 SHEETS STA. VARIES TO STA. VARIES

SECTION COUNTY 330 103R-4 COOK 877 420 E-9 CONTRACT NO. 60M61

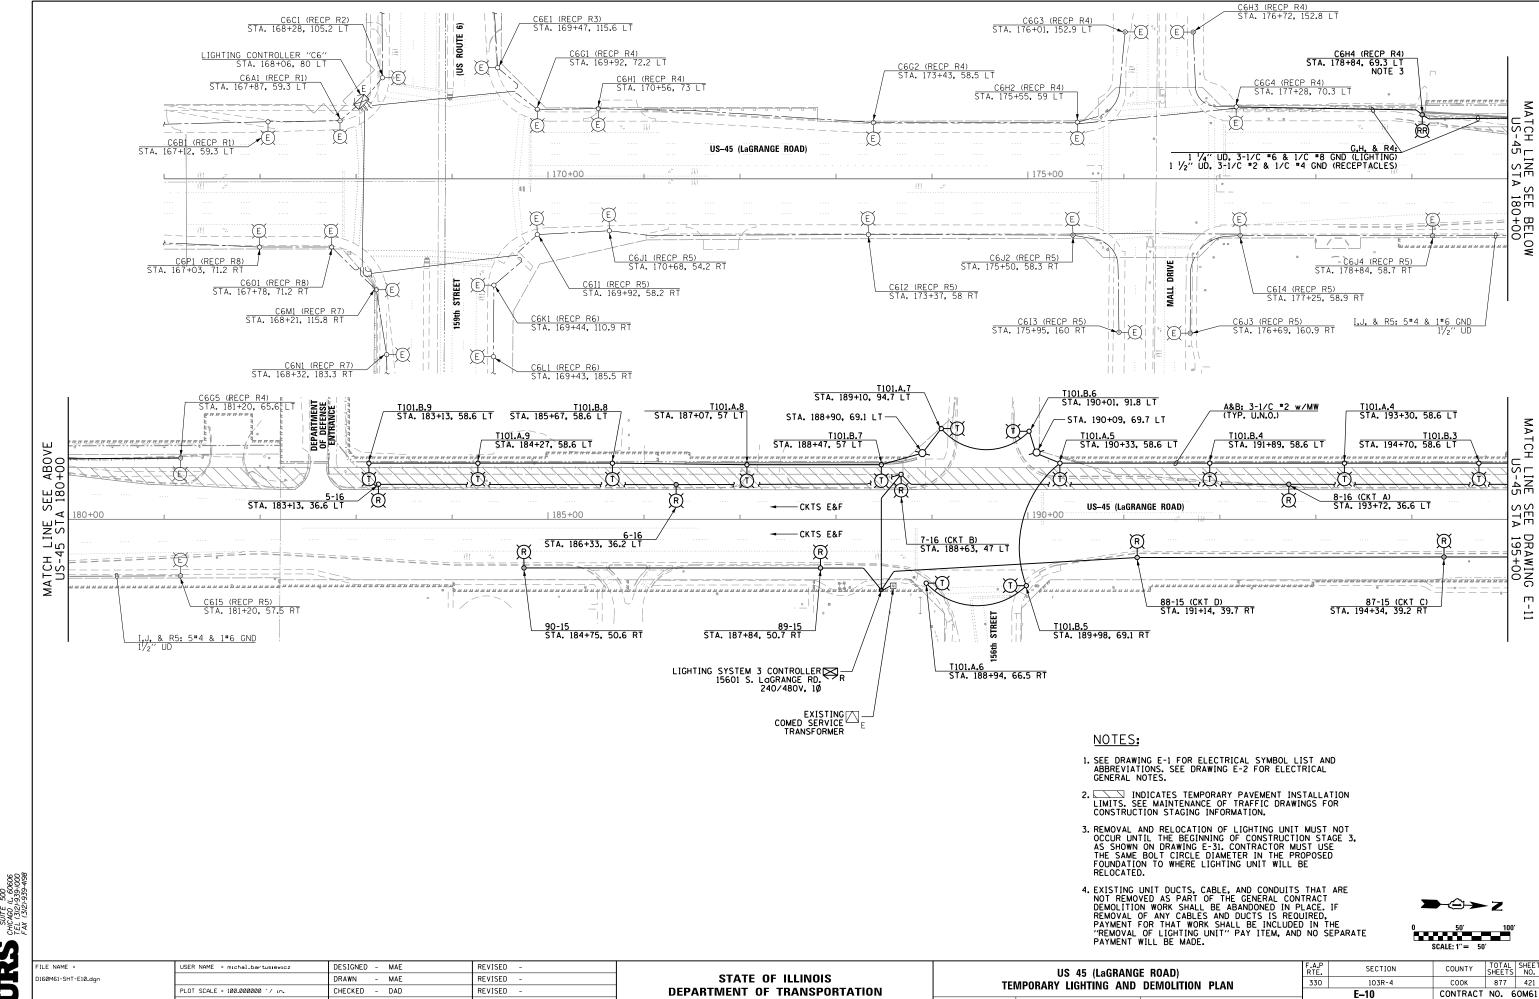

SCALE: 1"=50" SHEET

1 OF 7 SHEETS STA. BEGIN TO STA. 195+00.00





PLOT DATE = 3/15/2013

DATE

- 03/13/2013

REVISED

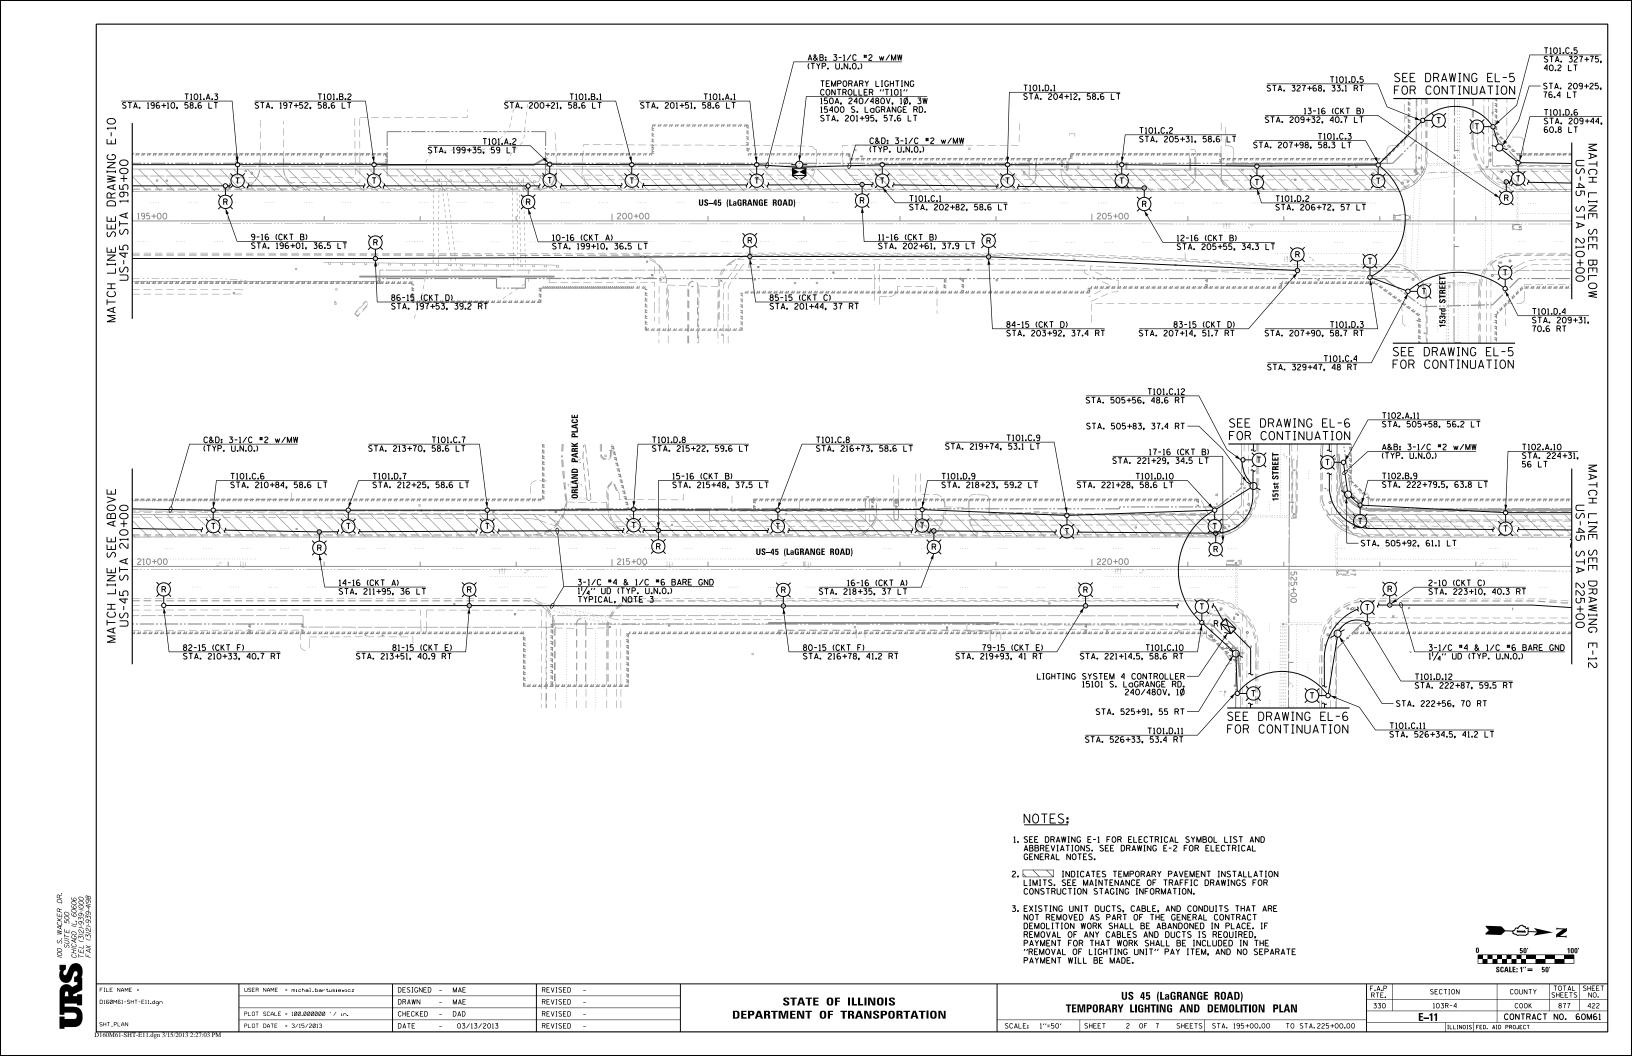

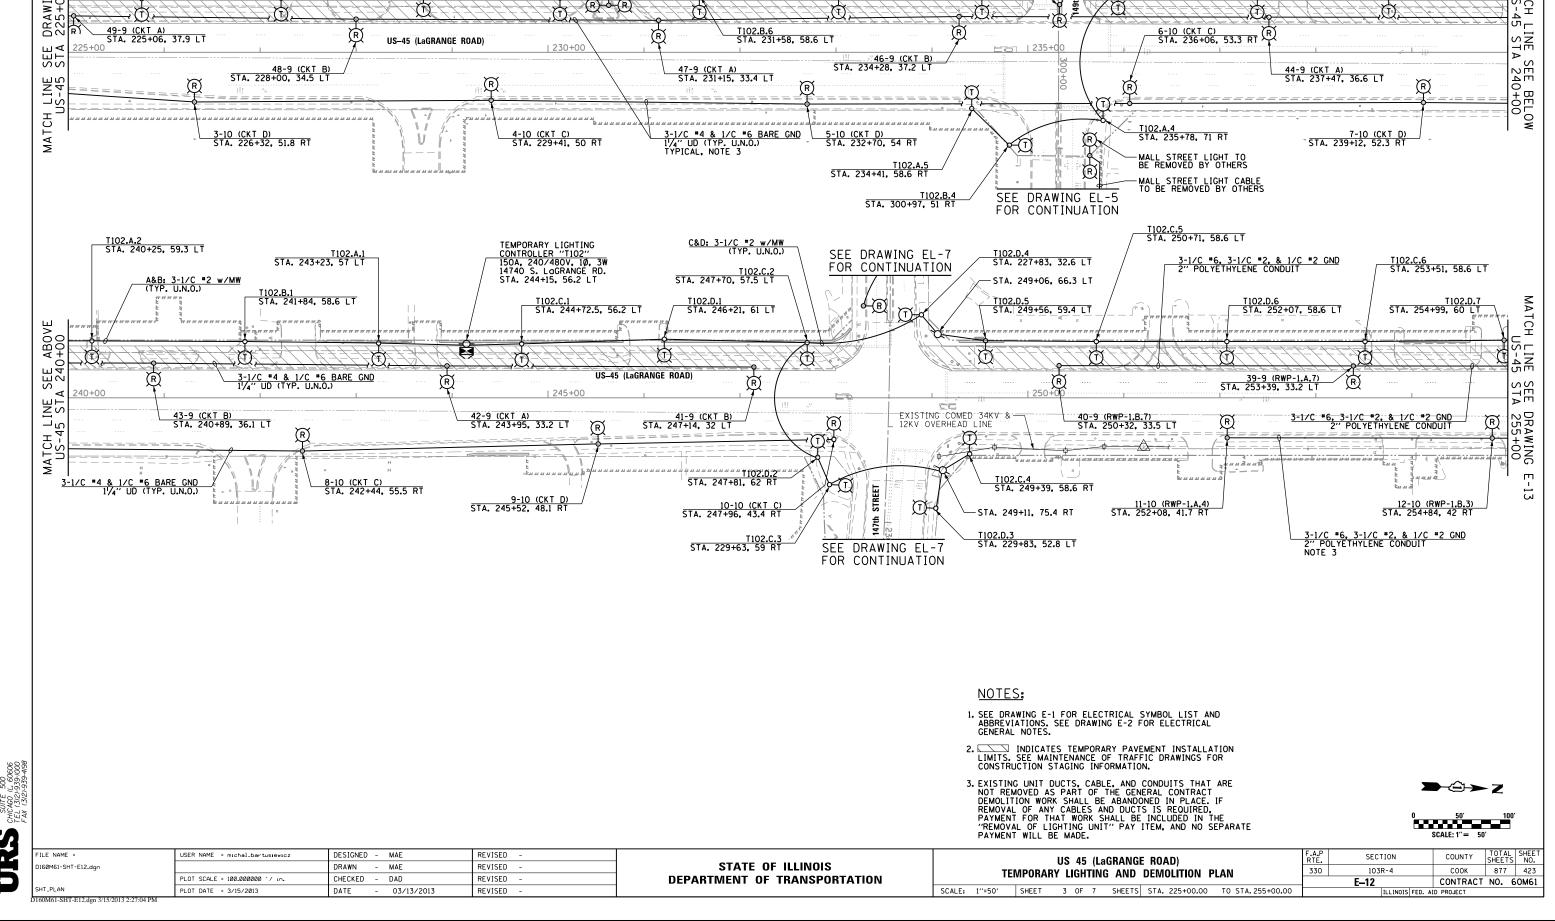

-PARKING LOT LIGHT TO BE REMOVED BY OTHERS

R-R

T102.A.7 STA. 233+08. 58.6 LT

TO NEXT STREET LIGHT-CONTROLLER LOCATION UNKNOWN COORDINATE REMOVAL WITH OWNER

STA. 278+34. 1 LT

T102.B.5 STA. 234+52. 58.6 LT

T102.B.7 STA. 228+70. 61 LT

T102.A.8 STA. 230+12. 56.5 LT

T102.A.9 STA. 227+22, 56.4 LT

T102.B.8 STA. 225+77, 55.9 LT

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SEE DRAWING EL-5

FOR CONTINUATION

T102.A.6 STA, 277+71, 31.8 LT


STA. 277+98.5, 31.8 LT

T102.B.3 STA, 235+94, 62.8 LT

T102.A.3 STA. 237+33, 58.6 LT

T102.B.2 STA, 238+76, 59.3 LT

A&B: 3-1/C *2 w/MW (TYP. U.N.O.)

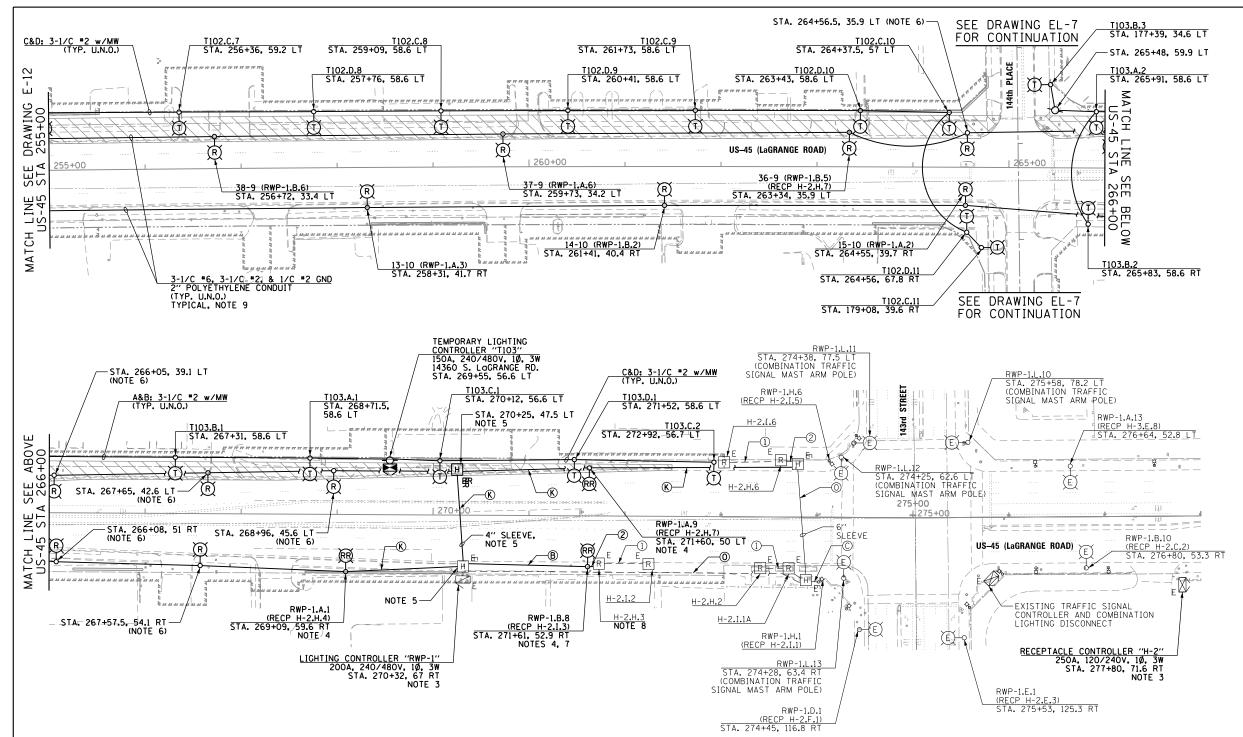

EXISTING CONDUIT AND WIRE LEGEND


- (B) 2-1/C *6, 2-1/C *10, & 1-1/C *6 GND WIRE 600V (XLP-TYPE-USE) 1/2" POLYETHYLENE CONDUIT
- © 3-1/C *6, 3-1/C *10, & 1-1/C *6 GND WIRE 600V (XLP-TYPE-USE) 11/2" POLYETHYLENE CONDUIT
- (K) 3-1/C *6, 3-1/C *2, & 1-1/C *2 GND WIRE 600V (XLP-TYPE-USE) 2" POLYETHYLENE CONDUIT
- ① 13-1/C *6, 3-1/C *2, & 1-1/C *2 GND WIRE 600V (XLP-TYPE-USE) 3" POLYETHYLENE CONDUIT
- 1 2-1/C *10 & 1-1/C *10 GND WIRE 600V (XLP-TYPE-USE) 34" POLYETHYLENE CONDUIT
- ② 3-1/C *10 & 1-1/C *10 GND WIRE 600V (XLP-TYPE-USE) ¾" POLYETHYLENE CONDUIT




- 1. SEE DRAWING E-1 FOR ELECTRICAL SYMBOL LIST AND ABBREVIATIONS. SEE DRAWING E-2 FOR ELECTRICAL GENERAL NOTES.
- . INDICATES TEMPORARY PAVEMENT INSTALLATION LIMITS. SEE MAINTENANCE OF TRAFFIC DRAWINGS FOR CONSTRUCTION STAGING INFORMATION.
- 3. CONTRACTOR MUST DEENERGIZE THE SERVICE FEED TO BOTH CONTROLLERS RWP-1 AND H-2 DURING THE SAME TIME BEFORE COMMENCING WITH DEMOLITION WORK PER OSHA REQUIREMENTS. CONTRACTOR MUST REENERGIZE BOTH CONTROLLERS ONCE THE ELECTRICAL ITEMS TO BE REMOVED ARE DISCONNECTED.
- 4. CONTRACTOR MUST CONFIRM THE DIAMETER OF BOLT CIRCLE FOR ALL EXISTING LIGHTING UNITS TO BE REMOVED AND RELOCATED.
- 5. THERE SHOULD BE ADDITIONAL COILED WIRE FOR FUTURE WORK (THIS PROJECT) IN THE WEST HANDHOLE (TO BE RELOCATED) NEAR STATION 270+00. IF THERE IS NOT, THE CONTRACTOR MUST REMOVE EXISTING WIRES FROM THE CONTRACTOR MUST REMOVE EXISTING WIRES FROM CONDUIT BACK TO EXISTING HANDHOLE TO REMAIN (EAST HANDHOLE NEAR STATION 270+00). CONDUIT SHALL REMAIN FOR EXTENSION TO RELOCATED HANDHOLE AS SHOWN ON DRAWING E-34.
- 6. CONTRACTOR SHALL REMOVE TEMPORARY POLES AND ALL ATTACHED LIGHT FIXTURES AND ARMS. THESE ITEMS ARE TO BE TURNED OVER TO THE VILLAGE OF ORLAND PARK PUBLIC WORKS DEPARTMENT.
- 7. CONTRACTOR MUST DISCONNECT CONDUCTORS FOR HOLIDAY TREE LIGHTING RECEPTACLE CIRCUITS FROM LOAD SIDE OF FUSES WITHIN EXISTING LIGHT POLE TO BE RELOCATED, FUSES MUST REMAIN WITHIN EXISTING POLE FOR RECONNECTION TO HOLIDAY TREE LIGHTING RECEPTACLES AS SHOWN ON DRAWING E-20.
- 8. DISCONNECT CONDUIT FROM EXISTING HOLIDAY TREE . DISCONNECT CONDUIT FROM EXISTING HOLDAY THEE LIGHTING RECEPTACLE AND SEAL OFF ALL OPENINGS. THIS WORK WILL BE PAID UNDER THE "REMOVE AND RELOCATE EXISTING LIGHT STANDARD" PAY ITEM. SEPARATE PAYMENT WILL NOT BE MADE.
- 9. EXISTING UNIT DUCTS, CABLE, AND CONDUITS THAT ARE NOT REMOVED AS PART OF THE GENERAL CONTRACT DEMOLITION WORK SHALL BE ABANDONED IN PLACE. IF REMOVAL OF CABLES AND DUCTS IS REQUIRED, PAYMENT FOR THAT WORK SHALL BE INCLUDED IN THE "REMOVAL OF LIGHTING UNIT" PAY ITEM, AND NO SEPARATE PAYMENT WILL BE MADE PAYMENT WILL BE MADE.




CKER DR 500 11, 60606 -939-1000	① 2-1/C #10	0 & 1-1/C *10 GND WIRE 600V (XLP-	TYPE-USE) 3/4" POLYETHYLENE (CONDUIT				
WACKE TE 500 30 /L, 6 312)-939	② 3-1/C *10	0 & 1-1/C *10 GND WIRE 600V (XLP-	TYPE-USE) ¾" POLYETHYLENE (CONDUIT				→
SUN	£ .						0	50' 100' SCALE: 1" = 50'
7	FILE NAME =	USER NAME = michal_bartusiewicz	DESIGNED - MAE	REVISED -		HE AF (L-CDANCE DOAD)	F.A.P SECTION	COUNTY TOTAL SHEET SHEETS NO.
	D160M61-SHT-E13.dgn		DRAWN - MAE	REVISED -	STATE OF ILLINOIS	US 45 (Lagrange Road) Temporary Lighting and Demolition Plan	330 103R-4	COOK 877 424
		PLOT SCALE = 100.000000 '/ in.	CHECKED - DAD	REVISED -	DEPARTMENT OF TRANSPORTATION	TEMPORARY LIGHTING AND DEMOLITION PLAN	E-13	CONTRACT NO. 60M61
	SHT_PLAN						E-13	

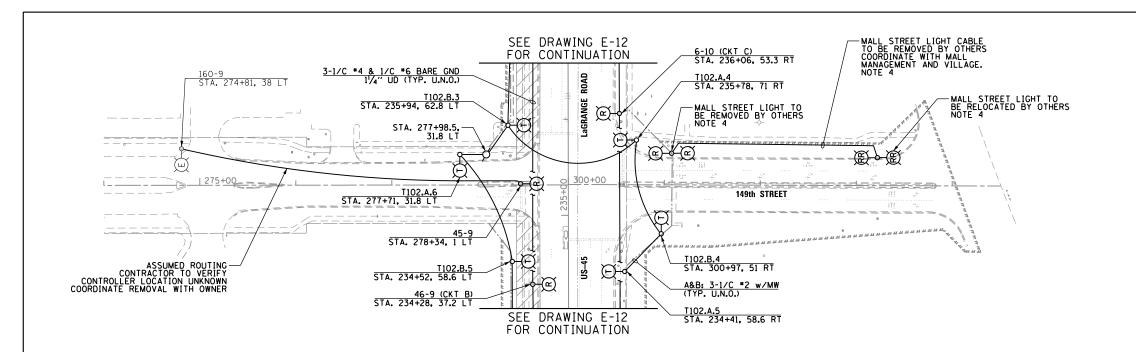


- SEE DRAWING E-1 FOR ELECTRICAL SYMBOL LIST AND ABBREVIATIONS. SEE DRAWING E-2 FOR ELECTRICAL GENERAL NOTES.
- 2. INDICATES TEMPORARY PAVEMENT INSTALLATION LIMITS. SEE MAINTENANCE OF TRAFFIC DRAWINGS FOR CONSTRUCTION STAGING INFORMATION.
- 3. EXISTING UNIT DUCTS, CABLE, AND CONDUITS THAT ARE NOT REMOVED AS PART OF THE GENERAL CONTRACT DEMOLITION WORK SHALL BE ABANDONED IN PLACE. IF REMOVAL OF ANY CABLES AND DUCTS IS REQUIRED, PAYMENT FOR THAT WORK SHALL BE INCLUDED IN THE "REMOVAL OF LIGHTING UNIT" PAY ITEM, AND NO SEPARATE PAYMENT WILL BE MADE.
- 4. CONTRACTOR SHALL COORDINATE WITH MALL MANAGEMENT AND THE VILLAGE OF ORLAND PARK. MAKE SURE REMOVAL OF POLES IS COORDINATED WITH CONSTRUCTION STAGING FOR US45 AND 149TH STREET TO MINIMIZE DOWN TIME FOR THE LIGHT POLES IN CONFLICT WITH CONSTRUCTION.
- 5. CONTRACTOR SHALL REMOVE 40' POLES FROM LOGRANGE AND RELOCATE THEM TO THE SIDE STREETS. AFTER EXISTING STOCK OF 40' POLES IS DEPLETED, THEN SHORTER POLES CAN BE RELOCATED TO SIDE STREETS AWAY FROM LOGRANGE ROAD, IF NEEDED, AS SHOWN ON THE PLANS.

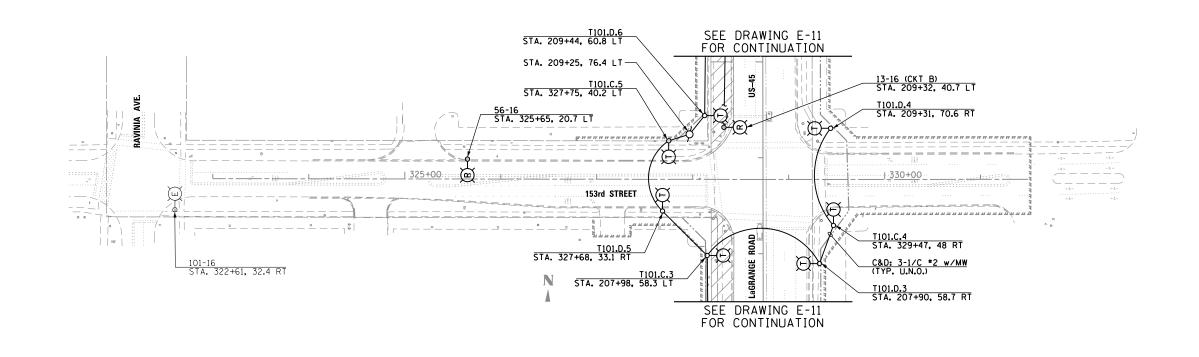


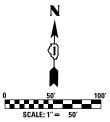


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	SHT_PLAN	PLOT DATE = 3/15/2013	DATE -	- 03/13/2013	REVISED -		SCALE: 1"=50"	SHEET	5 OF	7 SI	HEETS STA.	TO STA.		ILLINOIS FED.	AID PROJECT		
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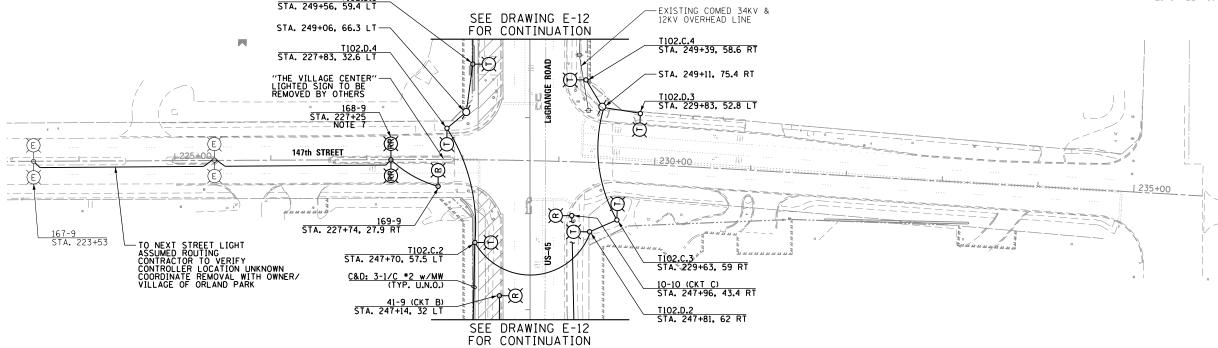
- 1. SEE DRAWING E-1 FOR ELECTRICAL SYMBOL LIST AND ABBREVIATIONS. SEE DRAWING E-2 FOR ELECTRICAL GENERAL NOTES.
- 2. INDICATES TEMPORARY PAVEMENT INSTALLATION LIMITS. SEE MAINTENANCE OF TRAFFIC DRAWINGS FOR CONSTRUCTION STAGING INFORMATION.
- 3. CONTRACTOR MUST CONFIRM THE BOLT CIRCLE DIAMETER FOR ALL EXISTING LIGHTING UNITS TO BE REMOVED AND RELOCATED PRIOR TO REMOVAL OF EXISTING POLE AND CONCRETE FOUNDATION.
- 4. CONTRACTOR MUST COORDINATE THE REMOVAL AND REINSTALLATION OF LIGHT POLE WITH THE PROPOSED RECONSTRUCTION OF 151st STREET AND WITH THE OWNER. SEE MAINTENANCE OF TRAFFIC DRAWINGS FOR LOGRANGE ROAD CONSTRUCTION AND 151st STREET STAGING PLANS. CONTRACTOR TO DISCONNECT POWER SOURCE AT NEXT LIGHT POLE EAST OF POLE TO BE RELOCATED. THIS WORK SHALL BE PAID FOR UNDER THE "REMOVE AND RELOCATE EXISTING LIGHT STANDARD" AND THE "REMOVAL OF POLE FOUNDATION" PAY ITEMS. SEPARATE PAYMENT WILL NOT BE MADE.
- 5. EXISTING UNIT DUCTS, CABLE, AND CONDUITS THAT ARE NOT REMOVED AS PART OF THE GENERAL CONTRACT DEMOLITION WORK SHALL BE ABANDONED IN PLACE. IF REMOVAL OF ANY CABLES AND DUCTS IS REOUIRED, PAYMENT FOR THAT WORK SHALL BE INCLUDED IN THE "REMOVAL OF LIGHTING UNIT" PAY ITEM, AND NO SEPARATE PAYMENT WILL BE MADE.
- 6. CONTRACTOR SHALL REMOVE 40' POLES FROM LOGRANGE AND RELOCATE THEM TO THE SIDE STREETS. AFTER EXISTING STOCK OF 40' POLES IS DEPLETED, THEN SHORTER POLES CAN BE RELOCATED TO SIDE STREETS AWAY FROM LOGRANGE ROAD, IF NEEDED, AS SHOWN ON THE PLANS.

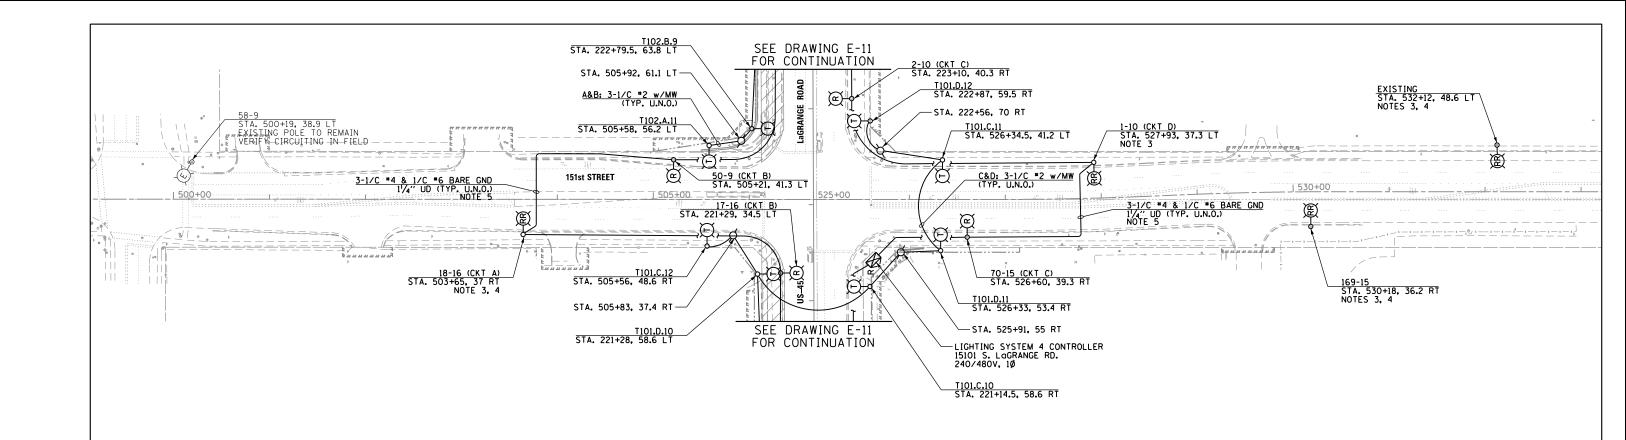


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3		PLOT SCALE = 100.0000000 '/ in.	CHECKED - DAD	REVISED -	DEPARTMENT OF TRANSPORTATION		-	E-15	CONTRACT NO. 60M61
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- 1. SEE DRAWING E-1 FOR ELECTRICAL SYMBOL LIST AND ABBREVIATIONS. SEE DRAWING E-2 FOR ELECTRICAL GENERAL NOTES.
- 2. INDICATES TEMPORARY PAVEMENT INSTALLATION LIMITS. SEE MAINTENANCE OF TRAFFIC DRAWINGS FOR CONSTRUCTION STAGING INFORMATION.
- 3. CONTRACTOR TO COORDINATE WITH COMED AS TO WHO IS RESPONSIBLE FOR DISCONNECTING AND REMOVING THE EXISTING STREET LIGHT FROM COMED POLE. THIS WORK SHALL BE PAID FOR UNDER THE "REMOVE AND RELOCATE EXISTING LIGHT STANDARD" PAY ITEM. SEPARATE PAYMENT WILL NOT BE MADE.
- 4. CONTRACTOR SHALL REMOVE TEMPORARY POLES AND ALL ATTACHED LIGHT FIXTURES AND ARMS. THESE ITEMS ARE TO BE TURNED OVER TO THE VILLAGE OF ORLAND PARK.
- 5. EXISTING UNIT DUCTS, CABLE, AND CONDUITS THAT ARE NOT REMOVED AS PART OF THE GENERAL CONTRACT DEMOLITION WORK SHALL BE ABANDONED IN PLACE, IF REMOVAL OF ANY CABLES AND DUCTS IS REQUIRED, PAYMENT FOR THAT WORK SHALL BE INCLUDED IN THE "REMOVAL OF LIGHTING UNIT" PAY ITEM, AND NO SEPARATE PAYMENT WILL BE MADE.
- 6. CONTRACTOR SHALL REMOVE 40' POLES FROM LaGRANGE AND RELOCATE THEM TO THE SIDE STREETS. AFTER EXISTING STOCK OF 40' POLES IS DEPLETED, THEN SHORTER POLES CAN BE RELOCATED TO SIDE STREETS AWAY FROM LaGRANGE ROAD, IF NEEDED, AS SHOWN ON THE PLANS.
- 7. CONTRACTOR SHALL REMOVE THIS TWIN ARM POLE DUE TO CONFLICT WITH CONSTRUCTION ACTIVITIES, AND SHALL BE REINSTALLED IN THE SAME LOCATION, ON A NEW FOUNDATION, AS SOON AS THE CONFLICT HAS BEEN ELIMINATED. KEEP ALL EXISTING PARTS INCLUDING LUMINAIRES WITH POLE FOR REINSTALLATION.

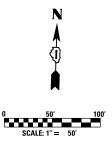

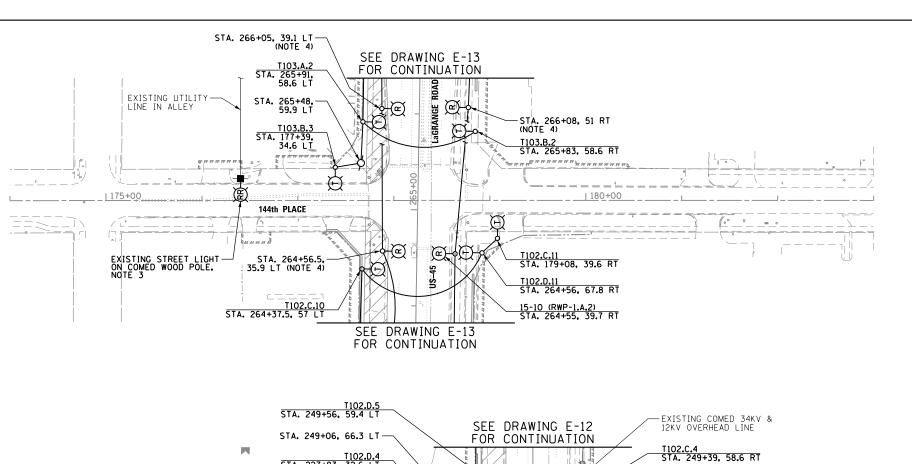


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	E-16			CONTRACT	NO. 6	ОМ61
		ILLINOIS	FED. A	D PROJECT		
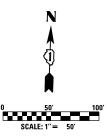
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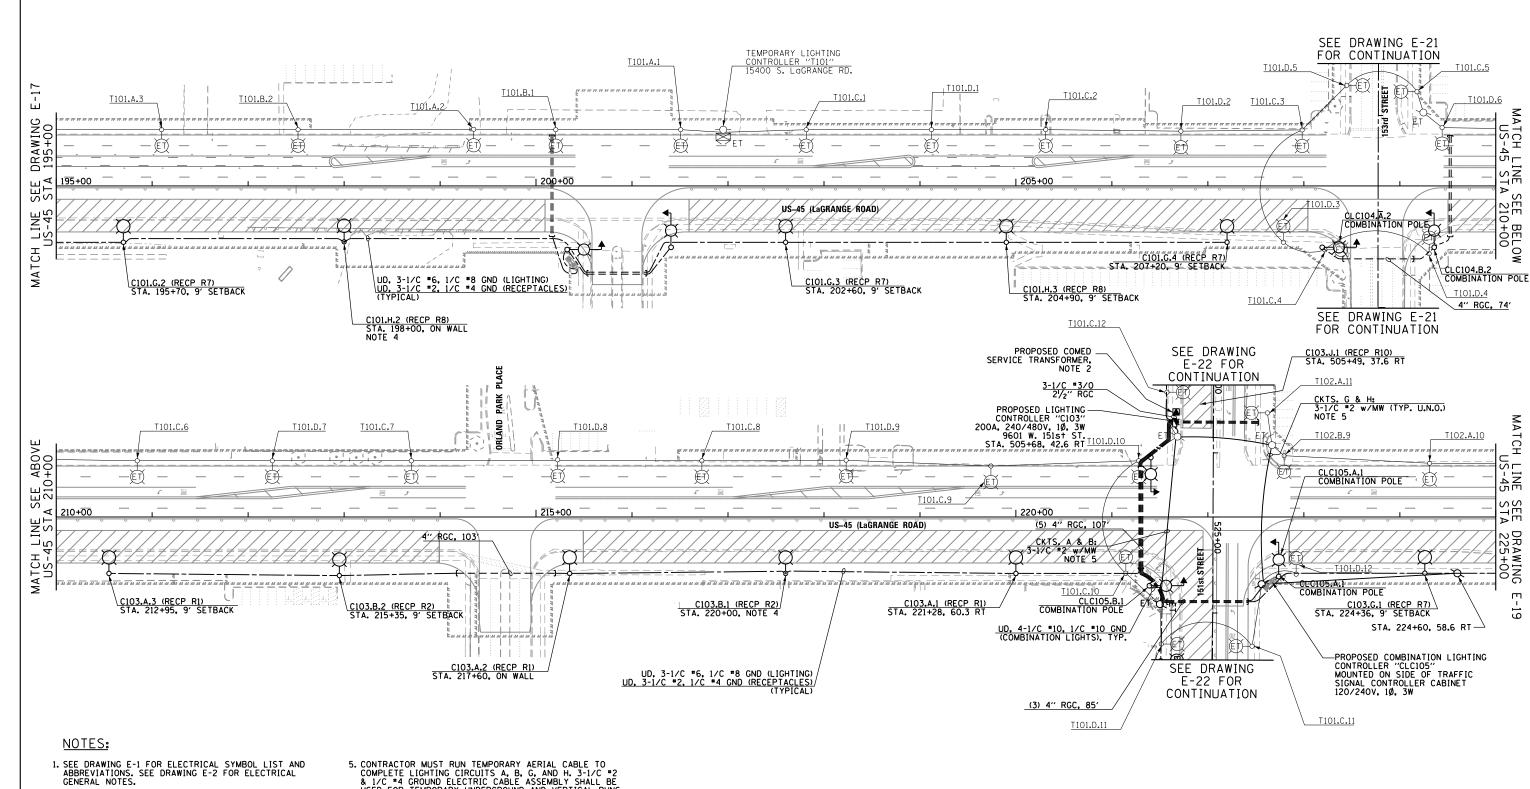
USER NAME = michal_bartusiewicz

DEPARTMENT OF TRANSPORTATION


US 45 (LaGRANGE ROAD) TEMPORARY ROADWAY LIGHTING PLAN - STAGE 1A

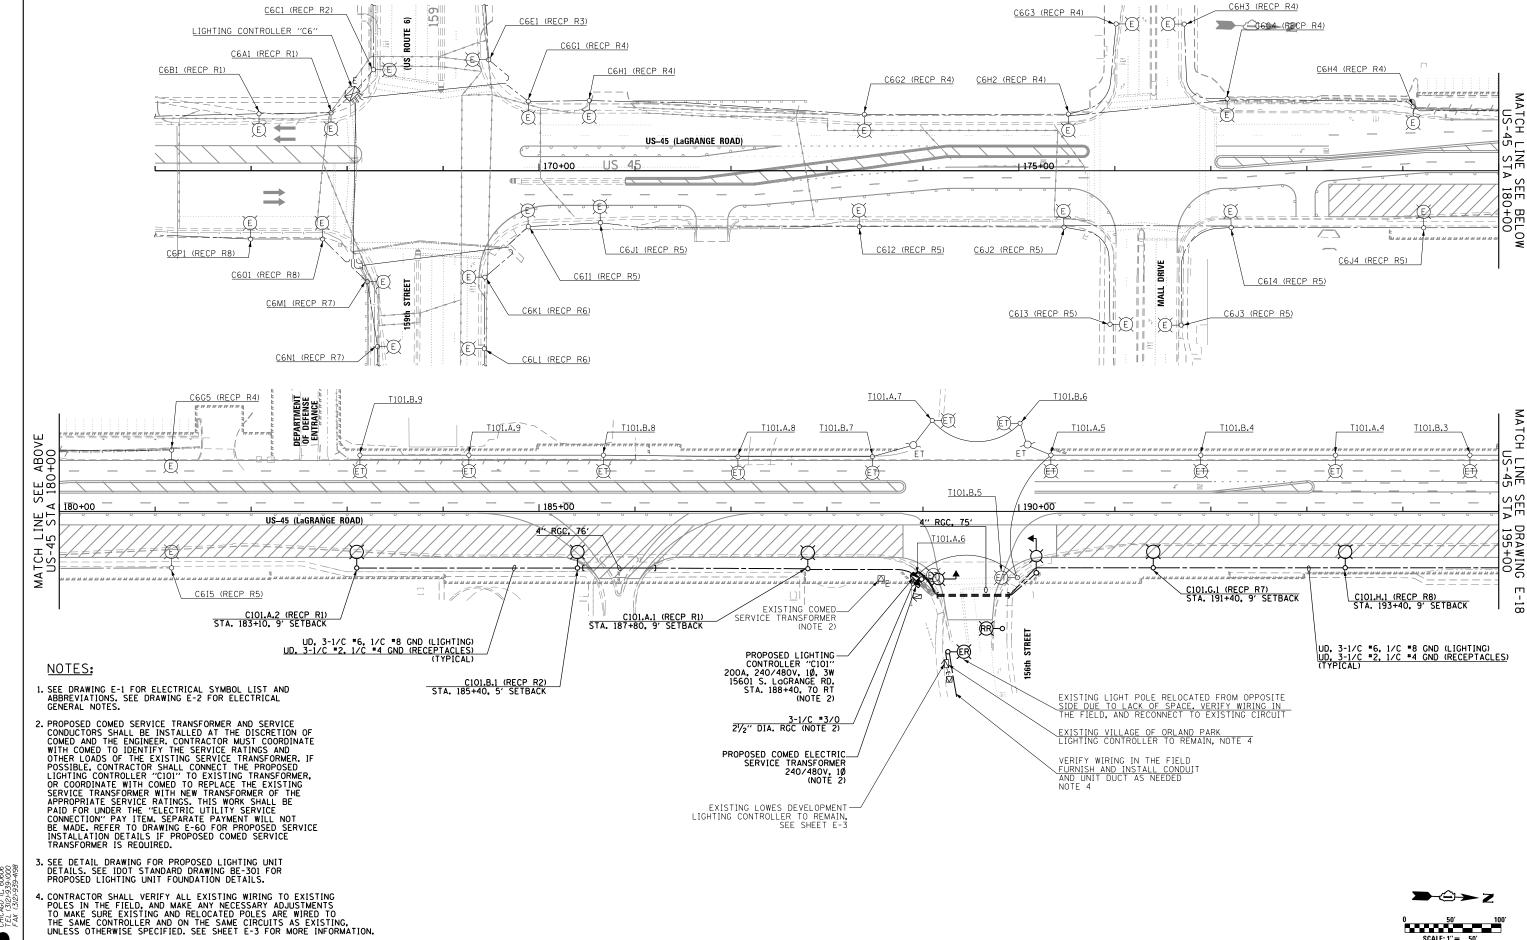SECTION COUNTY 330 103R-4 COOK E-17

STATE OF ILLINOIS 877 428 CONTRACT NO. 60M61 SCALE: 1"=50" SHEET 1 OF 7 SHEETS STA. BEGIN TO STA.195+00.00



- 2. CONTRACTOR MUST ROUTE CONDUIT FROM A LOCATION SPECIFIED BY COMED TO THE PRIMARY SIDE OF THE PROPOSED SERVICE TRANSFORMER. CONDUIT MATERIAL AND SIZE TO BE DETERMINED BY COMED, AND PAID FOR UNDER THE "ELECTRIC UTILITY SERVICE CONNECTION" PAY ITEM. SEPARATE PAYMENT WILL NOT BE MADE.
- 3. SEE DETAIL DRAWING FOR PROPOSED LIGHTING UNIT DETAILS. SEE IDOT STANDARD DRAWING BE-301 FOR PROPOSED LIGHTING UNIT FOUNDATION DETAILS, UNLESS NOTED OTHERWISE.
- 4. SEE DRAWING E-59 FOR PROPOSED RETAINING WALL MOUNTED LIGHTING UNIT INSTALLATION DETAILS.
- 5. CONTRACTOR MUST RUN TEMPORARY AERIAL CABLE TO COMPLETE LIGHTING CIRCUITS A, B, G, AND H, 3-1/C *2 & 1/C *4 GROUND ELECTRIC CABLE ASSEMBLY SHALL BE USED FOR TEMPORARY UNDERGROUND AND VERTICAL RUNS ALONG WOOD POLES AS SHOWN ON DRAWING E-67. THE COST OF THIS WORK SHALL BE INCLUDED IN THE "ELECTRIC CABLE ASSEMBLY IN TRENCH, 600V (EPR-TYPE TC) 3-1/C NO. 2 AND NO. 4 GROUND" AND THE "AERIAL CABLE, 3-1/C NO. 2 WITH MESSENGER WIRE" PAY ITEMS. SEPARATE PAYMENT WILL NOT BE MADE. RECEPTACLE CIRCUITS SHALL NOT BE ENERGIZED BY TEMPORARY MEANS.

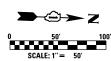

100 S. WACKER DR. SUITE 500 CHICAGO (312)-9339-1000	DETAILS. SEE II BE-301 FOR PRO DETAILS, UNLES 4. SEE DRAWING E	AWING FOR PROPOSED LIGHTING UNIT DOT STANDARD DRAWING DPOSED LIGHTING UNIT FOUNDATION S NOTED OTHERWISE. -59 FOR PROPOSED RETAINING WALLING UNIT INSTALLATION DETAILS.	RADIUS PVC COND	FURNISH AND INSTALL (3) 3½" × 36" DUIT RACEWAY ELBOWS IN FOUNDATION RD DRAWING BE-301.				0 50' 100' SCALE: 1'= 50'
3 5	FILE NAME =	USER NAME = michal_bartusiewicz	DESIGNED - MAE	REVISED -		US 45 (Lagrange ROAD)	F.A.P SECTION	COUNTY TOTAL SHEET
	D160M61-SHT-E18.dgn		DRAWN - MAE	REVISED -	STATE OF ILLINOIS	TEMPORARY ROADWAY LIGHTING PLAN - STAGE 1A	330 103R-4	COOK 877 429
\Box) 	PLOT SCALE = 100.0000000 '/ in.	CHECKED - DAD	REVISED -	DEPARTMENT OF TRANSPORTATION		E-18	CONTRACT NO. 60M61
	SHT_PLAN	PLOT DATE = 3/15/2013	DATE - 03/13/2013	REVISED -		SCALE: 1''=50' SHEET 2 OF 7 SHEETS STA. 195+00.00 TO STA. 225+00.00	ILLINOIS	FED. AID PROJECT
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100 S. WACKER DR. SUITE 500 CHCAGO IL, 66606 TEL (312)-3334-000 FAX (312)-3334-000

E-18

SEE

T102.B.8

T102.A.9


T102.B.7

4" RGC, 74

T102.A.8

<u>| 23</u>0+00

US-45 (Lagrange ROAD)

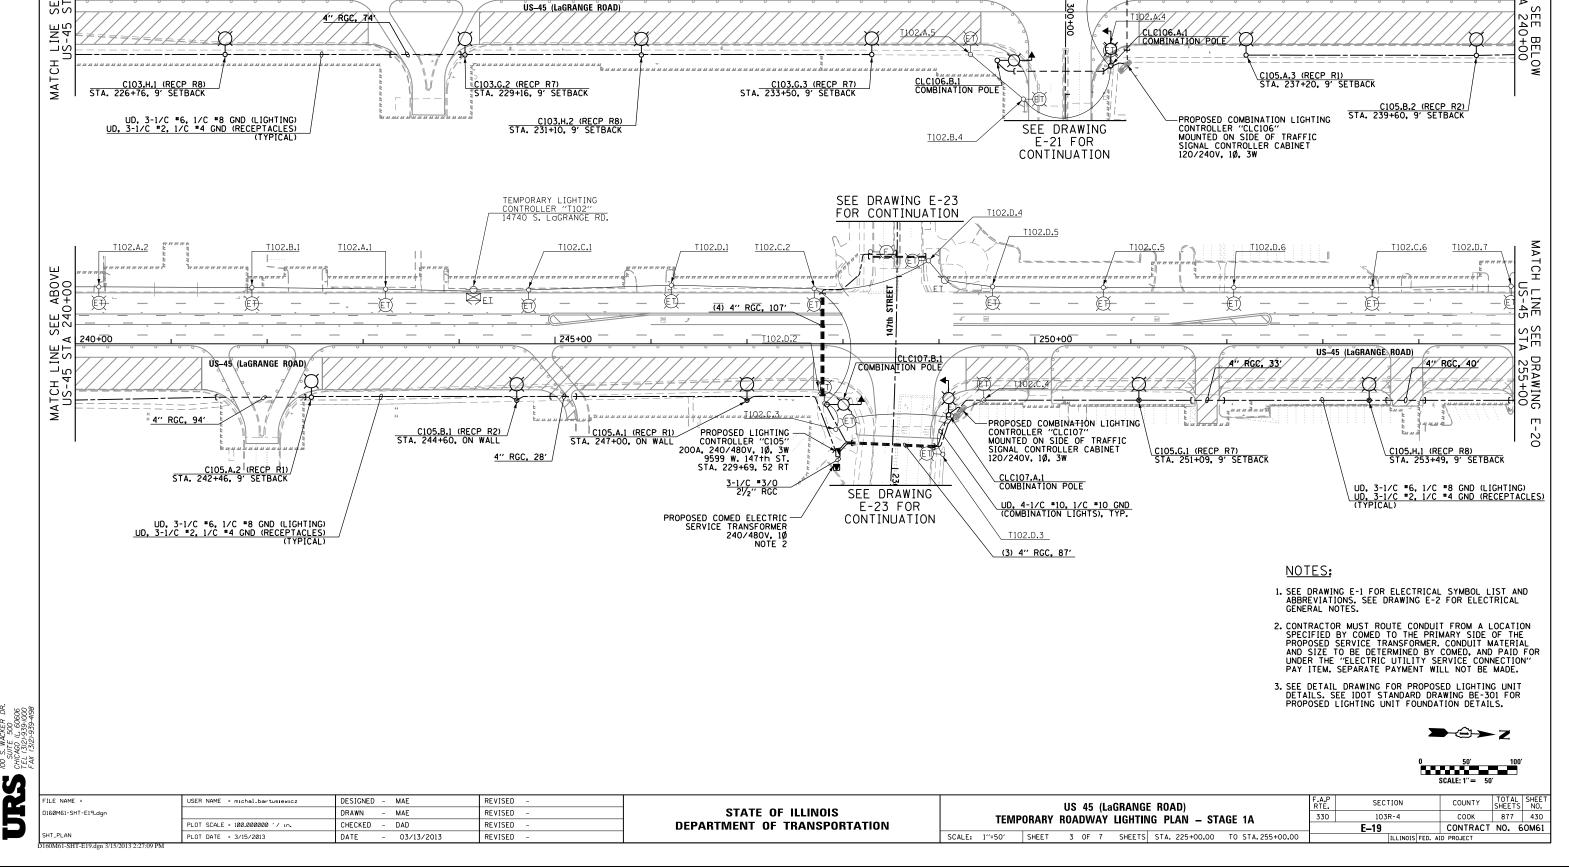

T102.B.6

T102.A.7

SEE DRAWING E-21 FOR CONTINUATION

T102.B.5


T102.A.6

T102.B.3

T102.A.3

T102.B.2


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100 S. WACKER DR. SUITE 500 CHICAGO IL, 60606 TEL (312)939-0000 FAX (312)-339-000

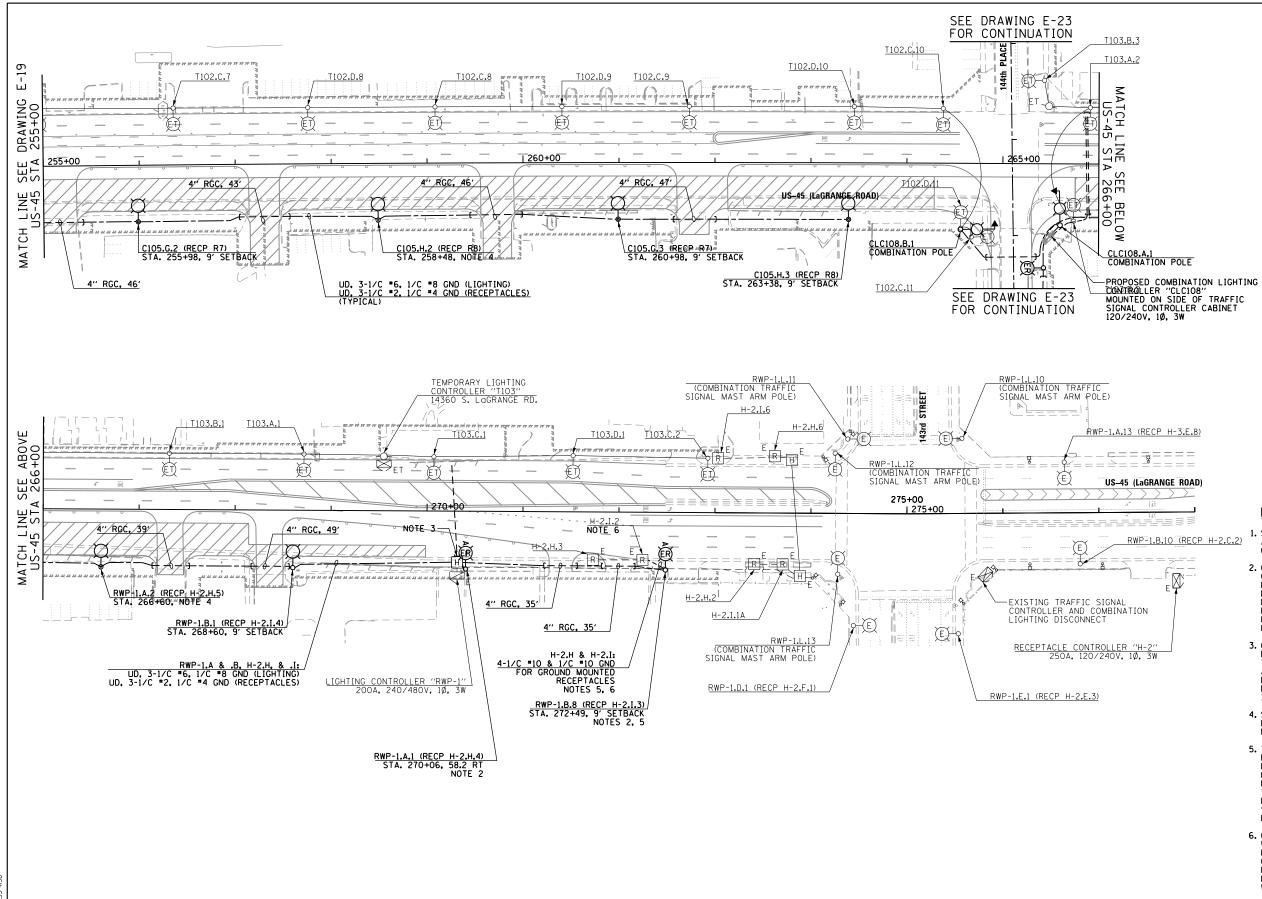
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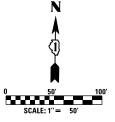
- SEE DRAWING E-1 FOR ELECTRICAL SYMBOL LIST AND ABBREVIATIONS. SEE DRAWING E-2 FOR ELECTRICAL GENERAL NOTES.
- 2. CONTRACTOR MUST REINSTALL EXISTING LIGHTING UNIT ON NEW POLE FOUNDATION WITH THE SAME BOLT CIRCLE DIAMETER AS WAS DETERMINED PER NOTE 4 ON DRAWING E-13, SEE IDOT STANDARD DRAWING BE-301 FOR PROPOSED LIGHTING UNIT FOUNDATION DETAILS. FOUNDATION WILL BE PAID FOR UNDER THE "LIGHT POLE FOUNDATION, 24" DIAMETER" PAY ITEM. SEPARATE PAYMENT WILL NOT BE MADE.
- 3. CONTRACTOR MUST DEENERGIZE THE SERVICE FEED TO BOTH CONTROLLERS RWP-1 AND H-2 DURING THE SAME TIME BEFORE SPLICING UD CONDUCTORS TO APPROPRIATE EXISTING CIRCUIT CABLES WITHIN THE EXISTING HANDHOLE. CONTRACTOR MUST REENERGIZE BOTH CONTROLLERS AS SOON AS THE ELECTRICAL ITEMS ARE INSTALLED AND CONNECTED.
- 4. SEE DETAIL DRAWING FOR PROPOSED LIGHTING UNIT DETAILS. SEE IDOT STANDARD DRAWING BE-301 FOR PROPOSED LIGHTING UNIT FOUNDATION DETAILS.
- 5. TRANSITION FROM 31/2" PVC CONDUIT ELBOW TO 3/4"
 POLYETHYLENE CONDUIT TO ROUTE CONDUCTORS FROM
 RELOCATED LIGHT POLE FOUNDATION TO EXISTING
 HOLIDAY TREE LIGHTING RECEPTACLE. PROPOSED
 RECEPTACLE CIRCUIT CONDUCTORS MUST BE CONNECTED
 TO EXISTING FUSES WITHIN LIGHT POLE TO BE
 RELOCATED. THIS WORK WILL BE PAID UNDER THE
 "REMOVE AND RELOCATE EXISTING LIGHT STANDARD"
 PAY ITEM. SEPARATE PAYMENT WILL NOT BE MADE.
- 6. CONTRACTOR TO CONNECT PROPOSED CONDUIT AND WIRING TO EXISTING HOLIDAY TREE LIGHTING RECEPTACLE IN THE SAME MANNER AS EXISTING CONNECTIONS WERE MADE. THIS WORK WILL BE PAID UNDER THE "REMOVE AND RELOCATE EXISTING LIGHT STANDARD" PAY ITEM. SEPARATE PAYMENT WILL NOT BE MADE.




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SHT_PLAN	PLOT DATE = 3/15/2013	DATE - 03/13/2013	REVISED -		SCALE: 1"=50" SHEET 4 OF 7 SHEETS STA. 255+00.00 TO STA. 278+00.00		ILLINOIS FF	ED. AID PROJECT

1. SEE DRAWING E-1 FOR ELECTRICAL SYMBOL LIST AND ABBREVIATIONS. SEE DRAWING E-2 FOR ELECTRICAL GENERAL NOTES.

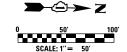

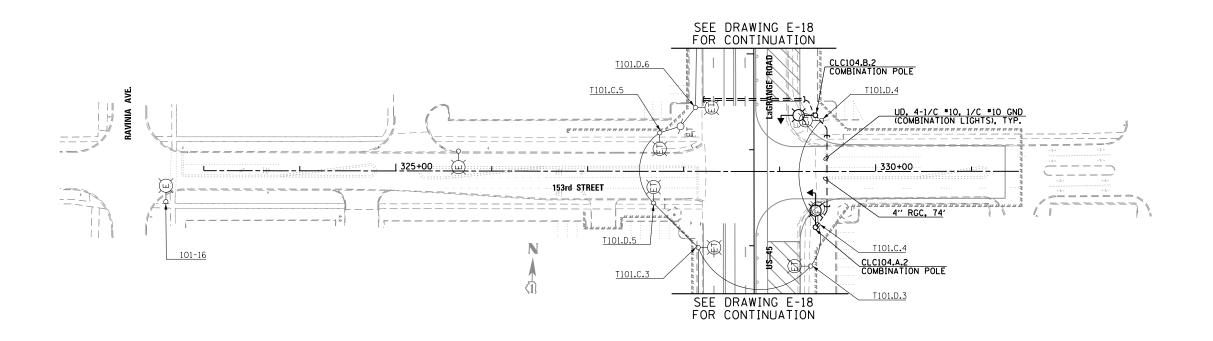


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3		PLOT SCALE = 100.0000000 ' / in.	CHECKED - DAD	REVISED -		TEIVIFUNANT NUADVVAT LIGHTING FLAN - STAGE IA	E-21	CONTRACT	NO. 60M61	
	SHT_PLAN	PLOT DATE = 3/15/2013	DATE - 03/13/2013	REVISED -		SCALE: 1"=50" SHEET 5 OF 7 SHEETS STA. VARIES TO STA. VARIES			AID PROJECT	
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- 1. SEE DRAWING E-1 FOR ELECTRICAL SYMBOL LIST AND ABBREVIATIONS. SEE DRAWING E-2 FOR ELECTRICAL GENERAL NOTES.
- 2. CONTRACTOR MUST ROUTE CONDUIT FROM A LOCATION SPECIFIED BY COMED TO THE PRIMARY SIDE OF THE PROPOSED SERVICE TRANSFORMER. CONDUIT MATERIAL AND SIZE TO BE DETERMINED BY COMED, AND PAID FOR UNDER THE "ELECTRIC UTILITY SERVICE CONNECTION" PAY ITEM. SEPARATE PAYMENT WILL NOT BE MADE.
- 3. CONTRACTOR MUST REINSTALL EXISTING LIGHTING UNIT ON NEW POLE FOUNDATION WITH THE SAME BOLT CIRCLE DIAMETER AS WAS DETERMINED PER NOTE 3 ON DRAWING EL-6. SEE IDOT STANDARD DRAWING BE-301 FOR PROPOSED LIGHTING UNIT FOUNDATION DETAILS. FOUNDATION WILL BE PAID FOR UNDER THE "LIGHT POLE FOUNDATION, 24" DIAMETER" PAY ITEM. SEPARATE PAYMENT WILL NOT BE MADE.
- 4. CONTRACTOR MUST CONFIRM THAT A 20A, 120V GFCI RECEPTACLE HAS BEEN INSTALLED AT 15'-0" ABOVE THE BASE OF EXISTING POLE TO BE RELOCATED. RECEPTACLES MUST BE INSTALLED WHERE ABSENT, AND CONNECTED TO RECEPTACLE PANEL WITHIN THE PROPOSED LIGHTING CONTROLLER "C103". SEE IDOT STANDARD BE-400 FOR PROPOSED RECEPTACLE REQUIREMENTS. THE COST OF ALL REQUIRED RECEPTACLES WILL BE INCLUDED IN THE "LIGHT POLE, ALUMINUM, 47.5 FT. M.H., 12 FT. MAST ARM" PAY ITEM. SEPARATE PAYMENT WILL NOT BE MADE.
- 5. CONTRACTOR MUST CHANGE THE LIGHTING UNIT IDENTIFICATION ON THE REINSTALLED LIGHTING UNIT TO THE NEW NAME SHOWN ON THIS DRAWING.
- 6. SEE DETAIL DRAWING FOR PROPOSED LIGHTING UNIT DETAILS. SEE IDOT STANDARD DRAWING BE-301 FOR PROPOSED LIGHTING UNIT FOUNDATION DETAILS.
- CONTRACTOR MUST RUN TEMPORARY AERIAL CABLE TO
 7. COMPLETE LIGHTING CIRCUITS A, B, G, AND H, 3-1/C *2
 & 1/C *4 GROUND ELECTRIC CABLE ASSEMBLY SHALL BE
 USED FOR TEMPORARY UNDERGROUND AND VERTICAL RUNS
 ALONG WOOD POLES AS SHOWN ON DRAWING ED-8. THE
 COST OF THIS WORK SHALL BE INCLUDED IN THE
 "ELECTRIC CABLE ASSEMBLY IN TRENCH, 600V (EPR-TYPE
 TC) 3-1/C NO. 2 AND NO. 4 GROUND" AND THE "AERIAL
 CABLE, 3-1/C NO. 2 WITH MESSENGER WIRE" PAY ITEMS.
 SEPARATE PAYMENT WILL NOT BE MADE. RECEPTACLE
 CIRCUITS SHALL NOT BE ENERGIZED BY TEMPORARY MEANS.

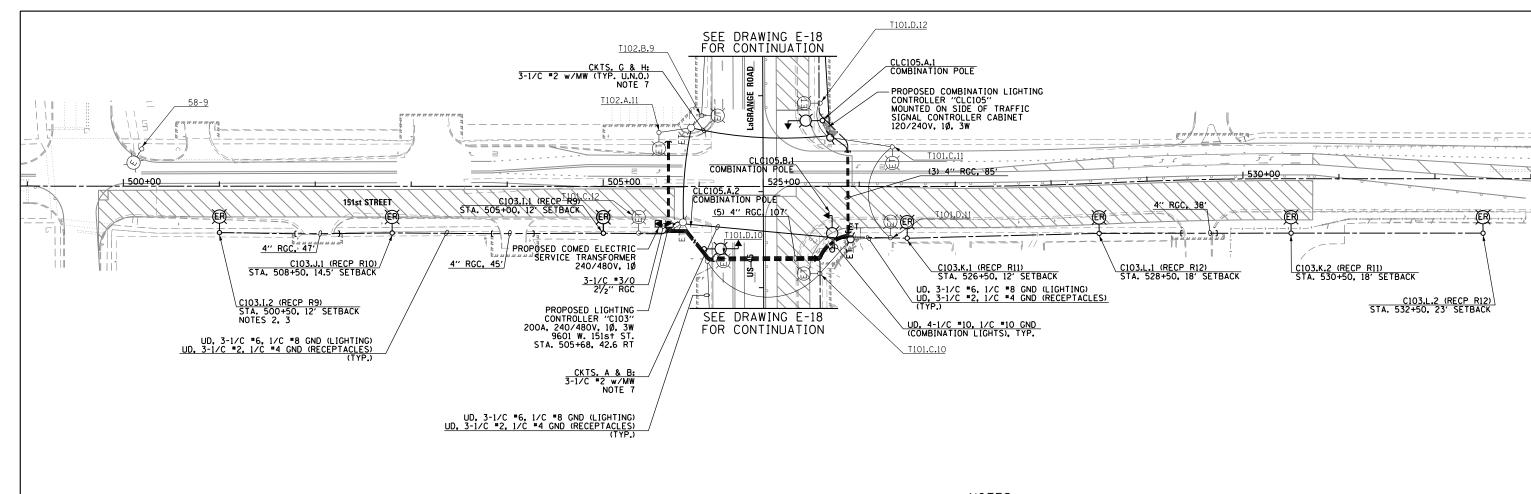8. CONTRACTOR TO FURNISH AND INSTALL (3) $31/2^{\prime\prime} \times 36^{\prime\prime}$ RADIUS PVC CONDUIT RACEWAY ELBOWS IN FOUNDATION PER IDOT STANDARD DRAWING BE-301.




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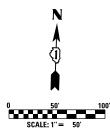
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STATE OF ILLINOIS **DEPARTMENT OF TRANSPORTATION**

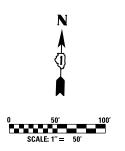15	1st STREET	Г ТЕМРО	ORAR	Y F	RO/	ADWAY	LIGHT	ING PLAN	– STAGE 1A
SCALE:	1''=50'	SHEET	6	0F	7	SHEETS	STA.	498+50.00	TO STA. 531+50.00

F.A.P RTE.	SEC.	TION		COUNTY	TOTAL SHEETS	SHEET NO.
330	103R-4			COOK	877	433
E-22				CONTRACT	NO. 6	OM61
		ILLINOIS	FED. A	D PROJECT		



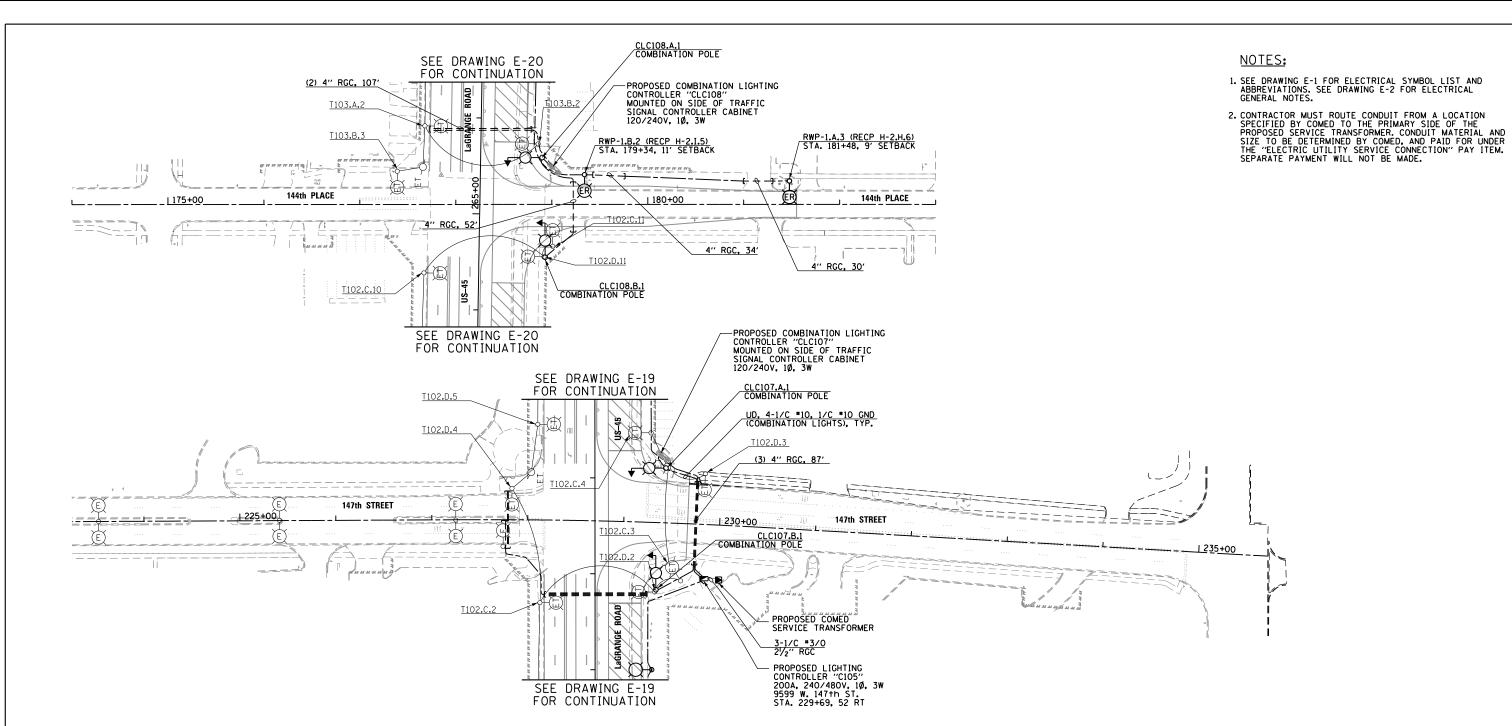

								COMERT
7						-		
2	FILE NAME =	USER NAME = michal_bartusiewicz	DESIGNED - MAE	REVISED -	STATE OF ILLINOIS DEPARTMENT OF TRANSPORTATION	147th STREET & 144th PLACE	F.A.P SECTIO	N COUNTY TOTAL SHEET
4	D160M61-SHT-E23.dgn		DRAWN - MAE	REVISED -			330 103R-4	COOK 877 434
•		PLOT SCALE = 100.0000000 ' / in.	CHECKED - DAD	REVISED -		TEMPORARY ROADWAY LIGHTING PLAN - STAGE 1A	E-23	CONTRACT NO. 60M61
	SHT_PLAN	PLOT DATE = 3/15/2013	DATE - 03/13/2013	REVISED -	1	SCALE: 1"=50" SHEET 7 OF 7 SHEETS STA. VARIES TO STA. VARIES		INOIS FED. AID PROJECT
	D160M61-SHT-E23.dgn 3/15/2013 2:27:12 PM	•	•	·	•			

100 S. WACKER DR. SUITE 500 CHICAGO 12, 60606 TEL (312)-939-1000 FAX (312)-939-4198	
Y 4	
	FILE NAME =
	D160M61-SHT-E24.dgn
P	SHT_PLAN D160M61-SHT-E24.dgn 3/15/2013 2:27:13 PM
	<u> </u>

C6C1 (RECP R2)

DATE


PLOT DATE = 3/15/2013

- 03/13/2013

REVISED

LIGHTING CONTROLLER "C6

C6E1 (RECP R3)

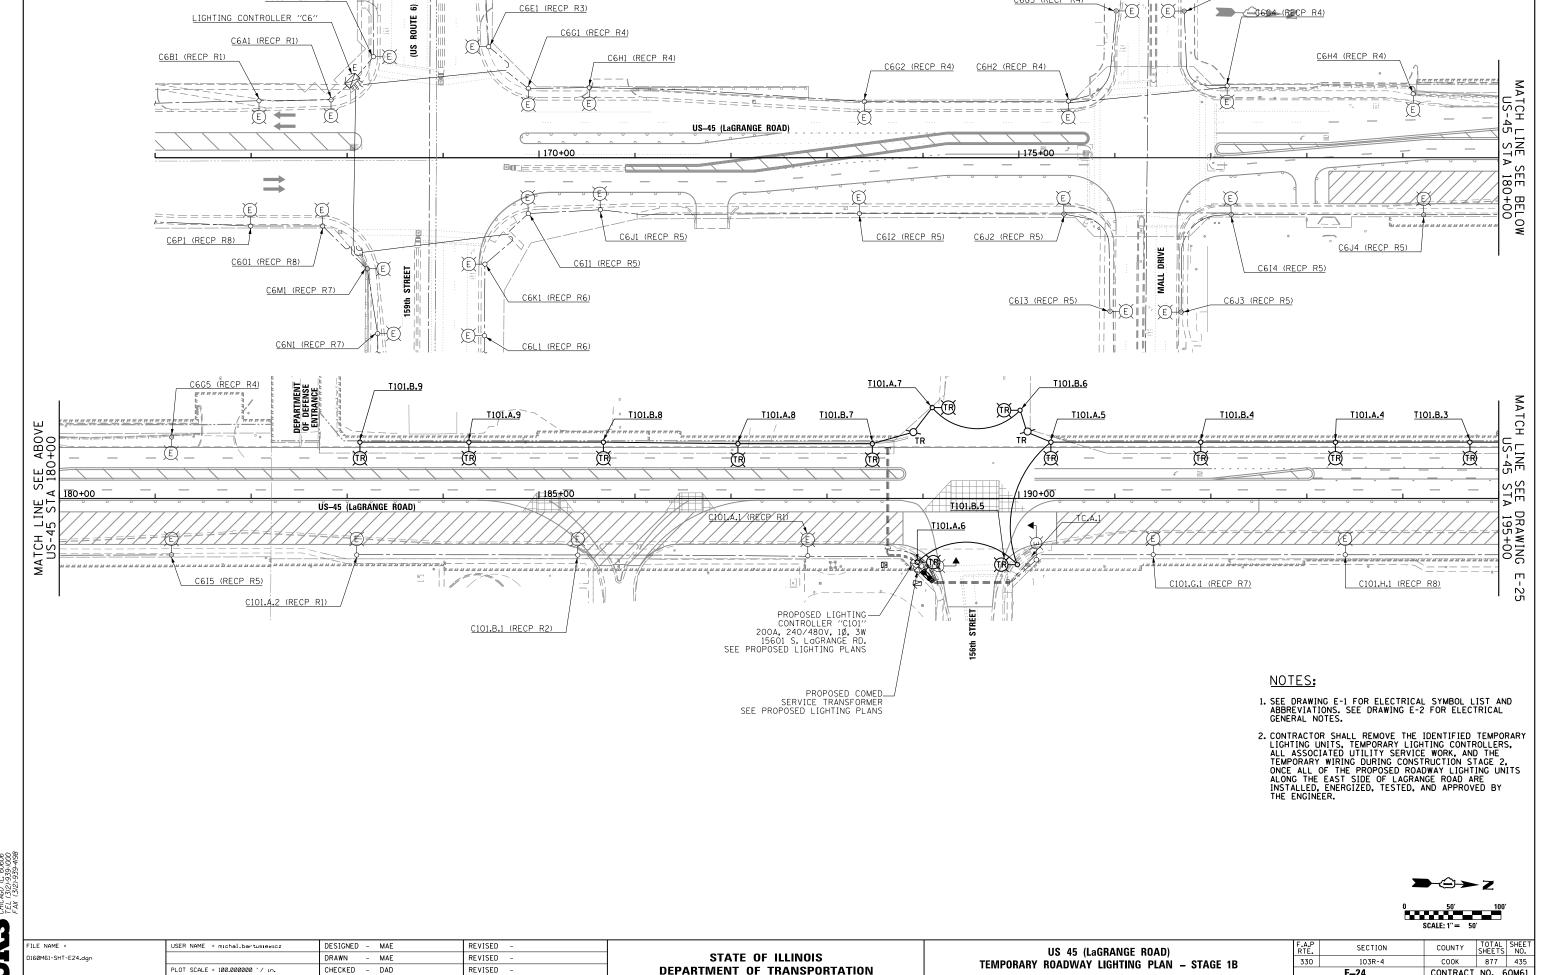

C6H3 (RECP R4)


2664 (RECP_R4)

E-24

SCALE: 1"=50" SHEET 1 OF 7 SHEETS STA. BEGIN TO STA. 195+00.00

CONTRACT NO. 60M61


C6G3 (RECP R4)

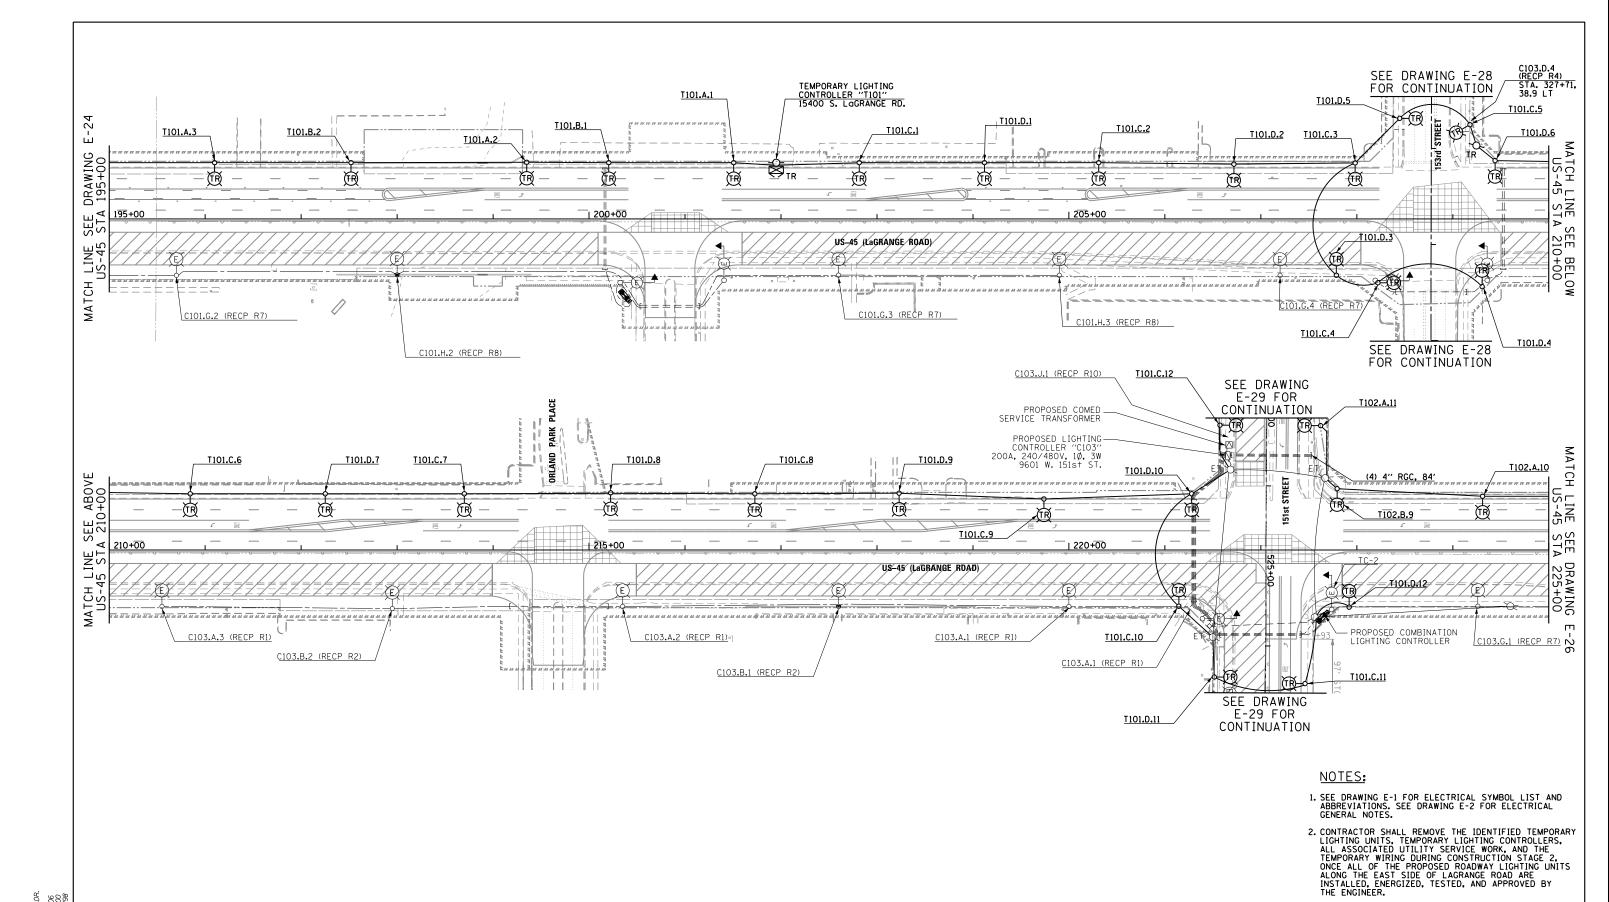




4										
2	FILE NAME =	USER NAME = michal_bartusiewicz	DESIGNED - MAE	REVISED -		US 45 (Lagrange Road)	F.A.P	SECTION	COUNTY TO	TAL SHEET
	D160M61-SHT-E25.dgn		DRAWN - MAE	REVISED -	STATE OF ILLINOIS DEPARTMENT OF TRANSPORTATION	TEMPORARY ROADWAY LIGHTING PLAN - STAGE 1B	330	103R-4	COOK 8	877 436
3		PLOT SCALE = 100.0000000 '/ in.	CHECKED - DAD	REVISED -		TEWPORARY RUADWAY LIGHTING PLAN - STAGE IB	555	E-25	CONTRACT NO	O. 60M61
	SHT_PLAN	PLOT DATE = 3/15/2013	DATE - 03/13/2013	REVISED -		SCALE: 1"=50" SHEET 2 OF 7 SHEETS STA. 195+00.00 TO STA. 225+00.00		ILLINOIS FED. A		
	D160M61-SHT-E25.dgn 3/15/2013 2:27:14 PM	•	•							



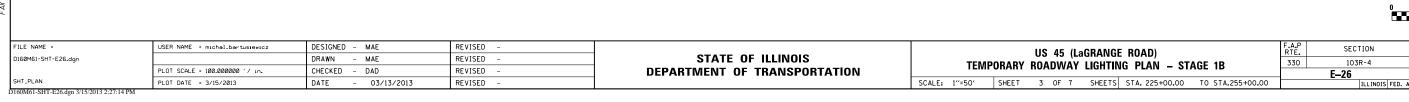

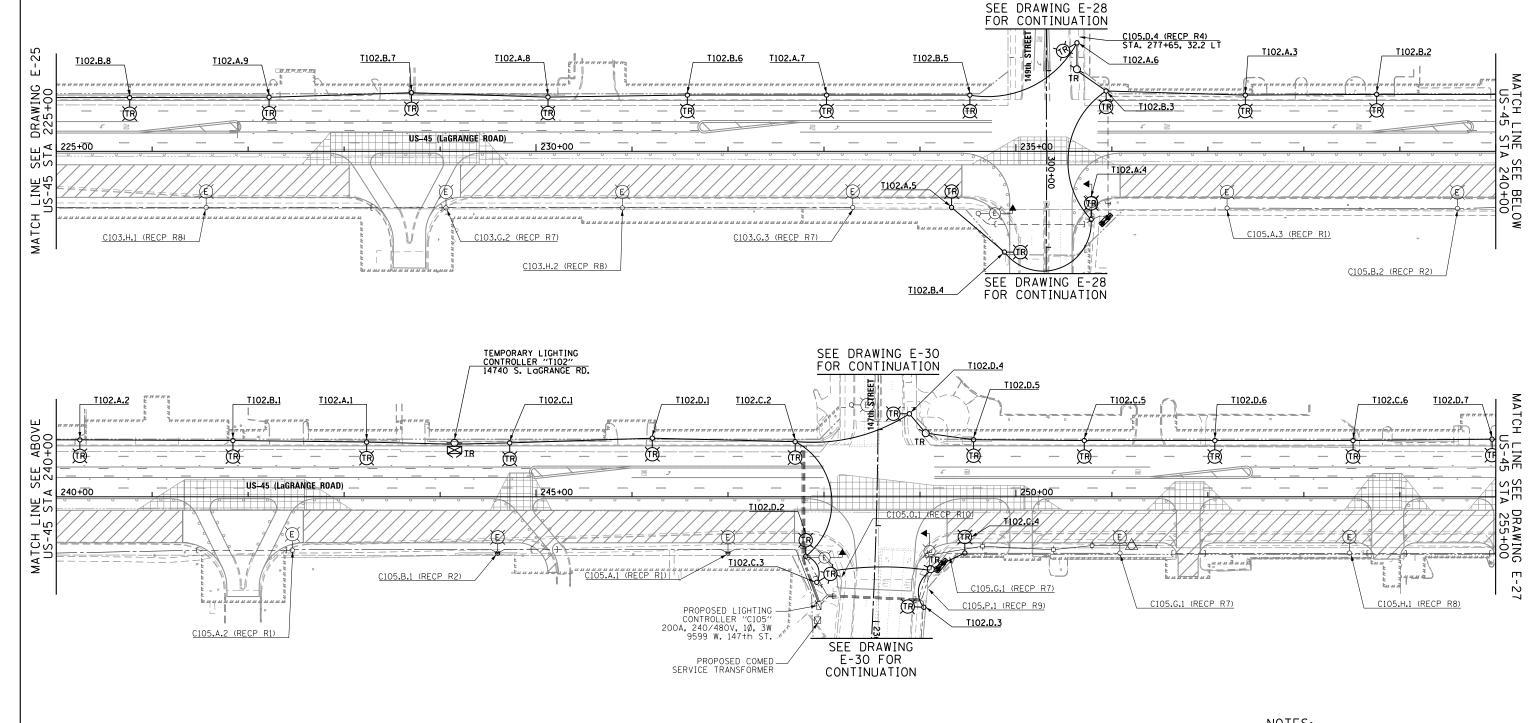

- 1. SEE DRAWING E-1 FOR ELECTRICAL SYMBOL LIST AND ABBREVIATIONS. SEE DRAWING E-2 FOR ELECTRICAL GENERAL NOTES.
- 2. CONTRACTOR SHALL REMOVE THE IDENTIFIED TEMPORARY LIGHTING UNITS, TEMPORARY LIGHTING CONTROLLERS, ALL ASSOCIATED UTILITY SERVICE WORK, AND THE TEMPORARY WIRING DURING CONSTRUCTION STAGE 2, ONCE ALL OF THE PROPOSED ROADWAY LIGHTING UNITS ALONG THE EAST SIDE OF LAGRANGE ROAD ARE INSTALLED, ENERGIZED, TESTED, AND APPROVED BY THE ENGINEER.




COUNTY


COOK

877 437

CONTRACT NO. 60M61

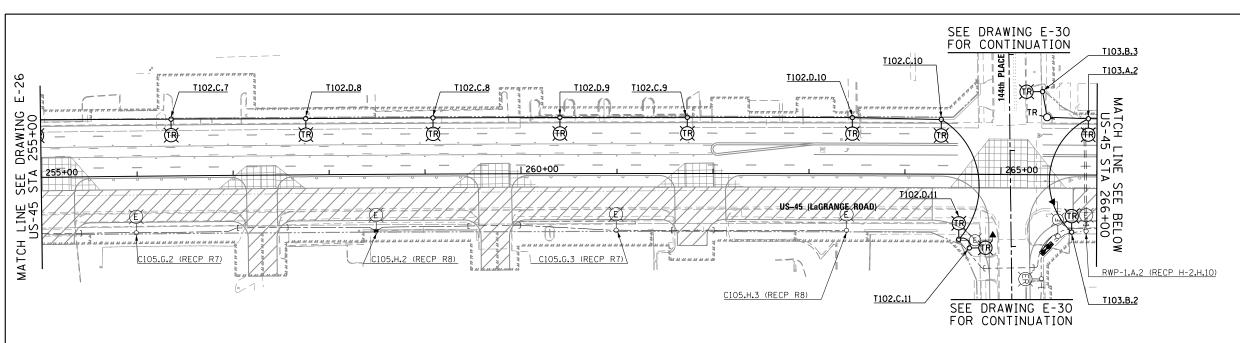


- SEE DRAWING E-1 FOR ELECTRICAL SYMBOL LIST AND ABBREVIATIONS. SEE DRAWING E-2 FOR ELECTRICAL GENERAL NOTES.
- 2. CONTRACTOR SHALL REMOVE THE IDENTIFIED TEMPORARY LIGHTING UNITS, TEMPORARY LIGHTING CONTROLLERS, ALL ASSOCIATED UTILITY SERVICE WORK, AND THE TEMPORARY WIRING DURING CONSTRUCTION STAGE 2, ONCE ALL OF THE PROPOSED ROADWAY LIGHTING UNITS ALONG THE EAST SIDE OF LAGRANGE ROAD ARE INSTALLED, ENERGIZED, TESTED, AND APPROVED BY THE ENGINEER.

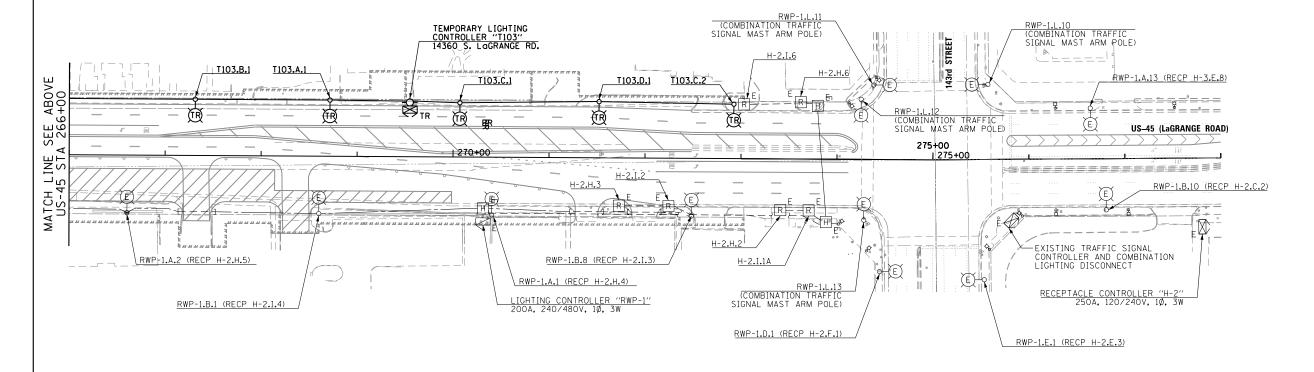





4											
	FILE NAME =	USER NAME = michal_bartusiewicz	DESIGNED - MAE	REVISED -		US 45 (Lagrange road)		F.A.P RTF	SECTION	COUNTY TOTAL SHE	EET
=	D160M61-SHT-E27.dgn		DRAWN - MAE	REVISED -	STATE OF ILLINOIS	TEMPORARY ROADWAY LIGHTING PLAN - STAGE 1B			103R-4	COOK 877 43	38
3		PLOT SCALE = 100.0000000 '/ in.	CHECKED - DAD	REVISED -	DEPARTMENT OF TRANSPORTATION	TEIVIPUN	TEMPUKAKY KUADWAY LIGHTING PLAN - STAGE IB			CONTRACT NO. 60M	161
	SHT_PLAN	PLOT DATE = 3/15/2013	DATE - 03/13/2013	REVISED -		SCALE: 1"=50" SF	HEET 4 OF 7 SHEETS STA. 255+00.00 TO STA. 278+00.00		ILLINOIS FEI	D. AID PROJECT	
	D160M61-SHT-E27.dgn 3/15/2013 2:27:15 PM										

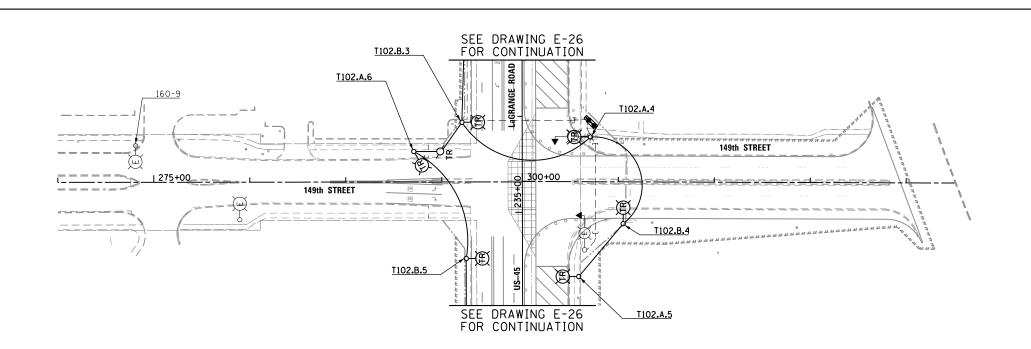


- 1. SEE DRAWING E-1 FOR ELECTRICAL SYMBOL LIST AND ABBREVIATIONS. SEE DRAWING E-2 FOR ELECTRICAL GENERAL NOTES.
- 2. CONTRACTOR SHALL REMOVE THE IDENTIFIED TEMPORARY LIGHTING UNITS, TEMPORARY LIGHTING CONTROLLERS, ALL ASSOCIATED UTILITY SERVICE WORK, AND THE TEMPORARY WIRING DURING CONSTRUCTION STAGE 2, ONCE ALL OF THE PROPOSED ROADWAY LIGHTING UNITS ALONG THE EAST SIDE OF LAGRANGE ROAD ARE INSTALLED, ENERGIZED, TESTED, AND APPROVED BY THE ENGINEER.

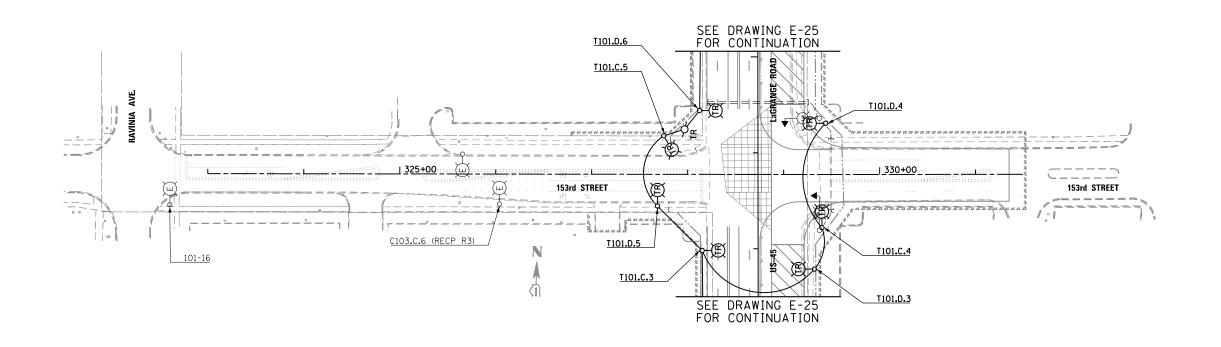


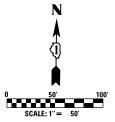


4											
•	FILE NAME =	USER NAME = michal_bartusiewicz	DESIGNED - MAE	REVISED -		153rd STREET & 149th STREET	F.A.P	SECTION	COUNTY	TOTAL SH	HEET
•	DI60M61-SHT-E28.dgn		DRAWN - MAE	REVISED -	STATE OF ILLINOIS	TEMPORARY ROADWAY LIGHTING PLAN - STAGE 1B	330	103R-4	соок	877	439
3		PLOT SCALE = 100.0000000 '/ in.	CHECKED - DAD	REVISED -	DEPARTMENT OF TRANSPORTATION	TENTONANT NUADVVAT LIGHTING PLAN - STAGE ID		E-28	CONTRACT	NO. 60M	м61
	SHT_PLAN	PLOT DATE = 3/15/2013	DATE - 03/13/2013	REVISED -		SCALE: 1"=50" SHEET 5 OF 7 SHEETS STA. VARIES TO STA. VARIES		ILLINOIS FEE	D. AID PROJECT		
	D160M61-SHT-E28.dgn 3/15/2013 2:27:16 PM										

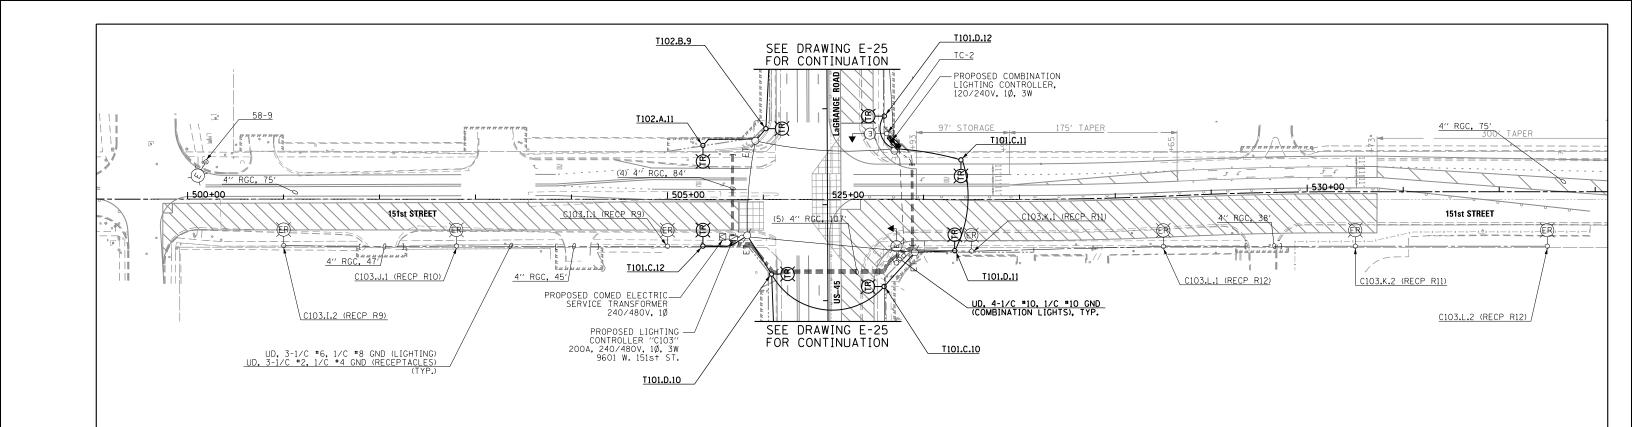


- 1. SEE DRAWING E-1 FOR ELECTRICAL SYMBOL LIST AND ABBREVIATIONS. SEE DRAWING E-2 FOR ELECTRICAL GENERAL NOTES.
- 2. CONTRACTOR SHALL REMOVE THE IDENTIFIED TEMPORARY LIGHTING UNITS, TEMPORARY LIGHTING CONTROLLERS, ALL ASSOCIATED UTILITY SERVICE WORK, AND THE TEMPORARY WIRING DURING CONSTRUCTION STAGE 2, ONCE ALL OF THE PROPOSED ROADWAY LIGHTING UNITS ALONG THE EAST SIDE OF LAGRANGE ROAD ARE INSTALLED, ENERGIZED, TESTED, AND APPROVED BY THE ENGINEER.
- 3. CONTRACTOR MUST REINSTALL EXISTING LIGHTING UNIT ON NEW POLE FOUNDATION WITH THE SAME BOLT CIRCLE DIAMETER AS WAS DETERMINED PER NOTE 3 ON DRAWING EL-6. SEE IDOT STANDARD DRAWING BE-301 FOR PROPOSED LIGHTING UNIT FOUNDATION DETAILS. FOUNDATION WILL BE PAID FOR UNDER THE "LIGHT POLE FOUNDATION, 24" DIAMETER" PAY ITEM. SEPARATE PAYMENT WILL NOT BE MADE.
- 4. CONTRACTOR MUST CONFIRM THAT A 20A, 120V GFCI RECEPTACLE HAS BEEN INSTALLED AT 15'-0" ABOVE THE BASE OF EXISTING POLE TO BE RELOCATED. RECEPTACLES MUST BE INSTALLED WHERE ABSENT, AND CONNECTED TO RECEPTACLE PANEL WITHIN THE PROPOSED LIGHTING CONTROLLER "C103". SEE IDOT STANDARD BE-400 FOR PROPOSED RECEPTACLE REOUIREMENTS. THE COST OF ALL REOUIRED RECEPTACLE SWILL BE INCLUDED IN THE "LIGHT POLE, ALUMINUM, 47.5 FT. M.H., 12 FT. MAST ARM" PAY ITEM. SEPARATE PAYMENT WILL NOT BE MADE.
- 5. CONTRACTOR MUST CHANGE THE LIGHTING UNIT IDENTIFICATION ON THE REINSTALLED LIGHTING UNIT TO THE NEW NAME SHOWN ON THIS DRAWING.

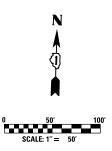


74									
	FILE NAME =	USER NAME = michal_bartusiewicz	DESIGNED - MAE	REVISED -			F.A.P SECTION	COUNTY TOTAL	SHEET
	D160M61-SHT-E29.dgn		DRAWN - MAE	REVISED -	STATE OF ILLINOIS	151st Street Temporary Roadway Lighting Plan – Stage 1B	330 103R-4	COOK 877	440
		PLOT SCALE = 100.0000000 '/ 10.	CHECKED - DAD	REVISED -	DEPARTMENT OF TRANSPORTATION		E-29	CONTRACT NO.	60M61
	SHT_PLAN	PLOT DATE = 3/15/2013	DATE - 03/13/2013	REVISED -		SCALE: 1''=50' SHEET 6 OF 7 SHEETS STA. 498+50.00 TO STA. 531+50.00	ILLINOIS FED.	. AID PROJECT	

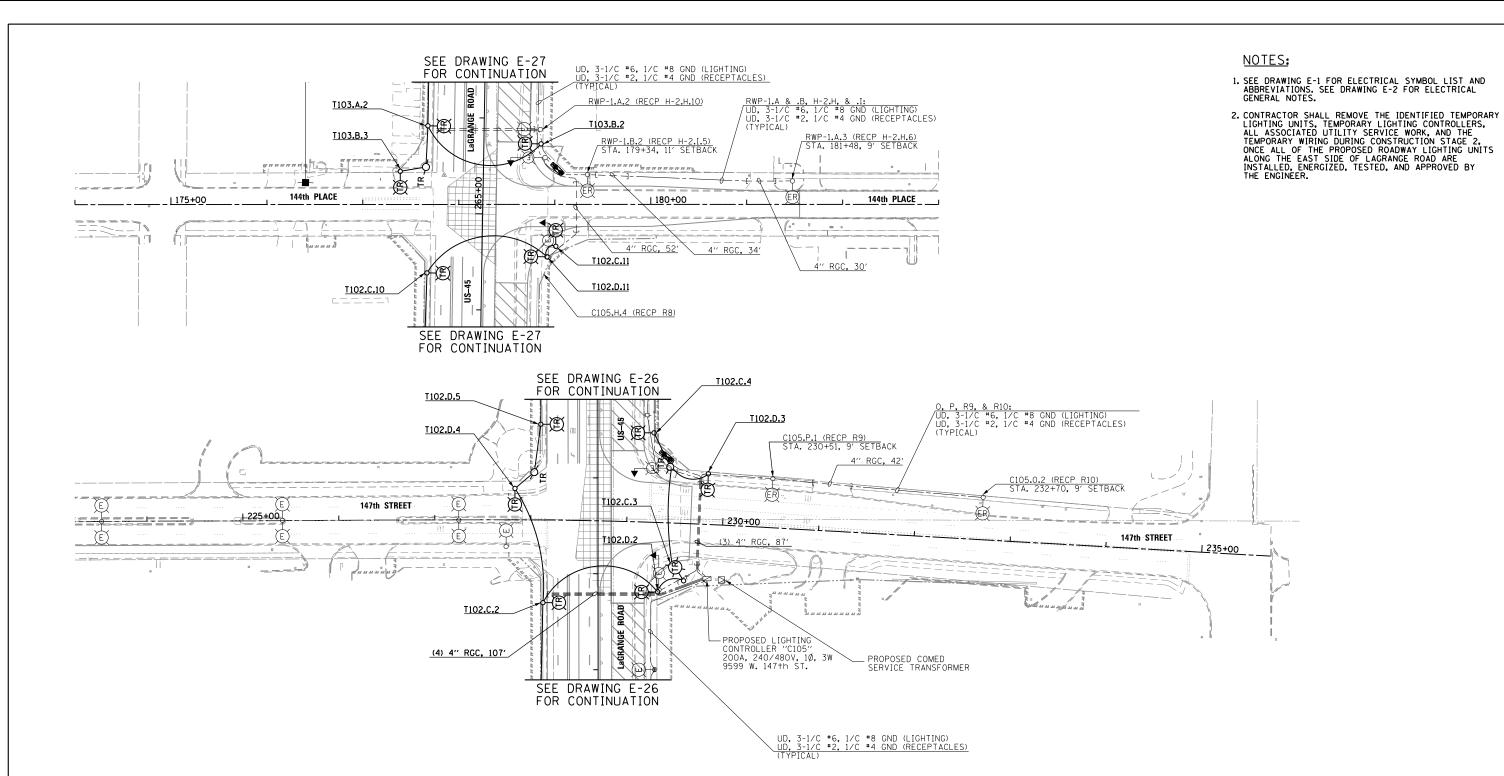

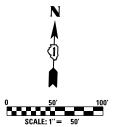

2											•
	FILE NAME =	USER NAME = michal_bartusiewicz	DESIGNED -	MAE	REVISED -		147th STREET & 144th PLACE	F.A.P RTF	SECTION	COUNTY	TOTAL SHEET SHEETS NO.
•	D160M61-SHT-E30.dgn		DRAWN -	MAE	REVISED -	STATE OF ILLINOIS	TEMPORARY ROADWAY LIGHTING PLAN - STAGE 1B	330	103R-4	соок	877 441
3		PLOT SCALE = 100.0000000 '/ in.	CHECKED -	DAD	REVISED -	DEPARTMENT OF TRANSPORTATION	IEWPURAKT KUADWAT LIGHTING PLAN - STAGE IB		E-30	CONTRACT	T NO. 60M61
	SHT_PLAN	PLOT DATE = 3/15/2013	DATE -	03/13/2013	REVISED -		SCALE: 1"=50" SHEET 7 OF 7 SHEETS STA. VARIES TO STA. VARIES			AID PROJECT	
	D160M61-SHT-E30.dgn 3/15/2013 2:27:17 PM										

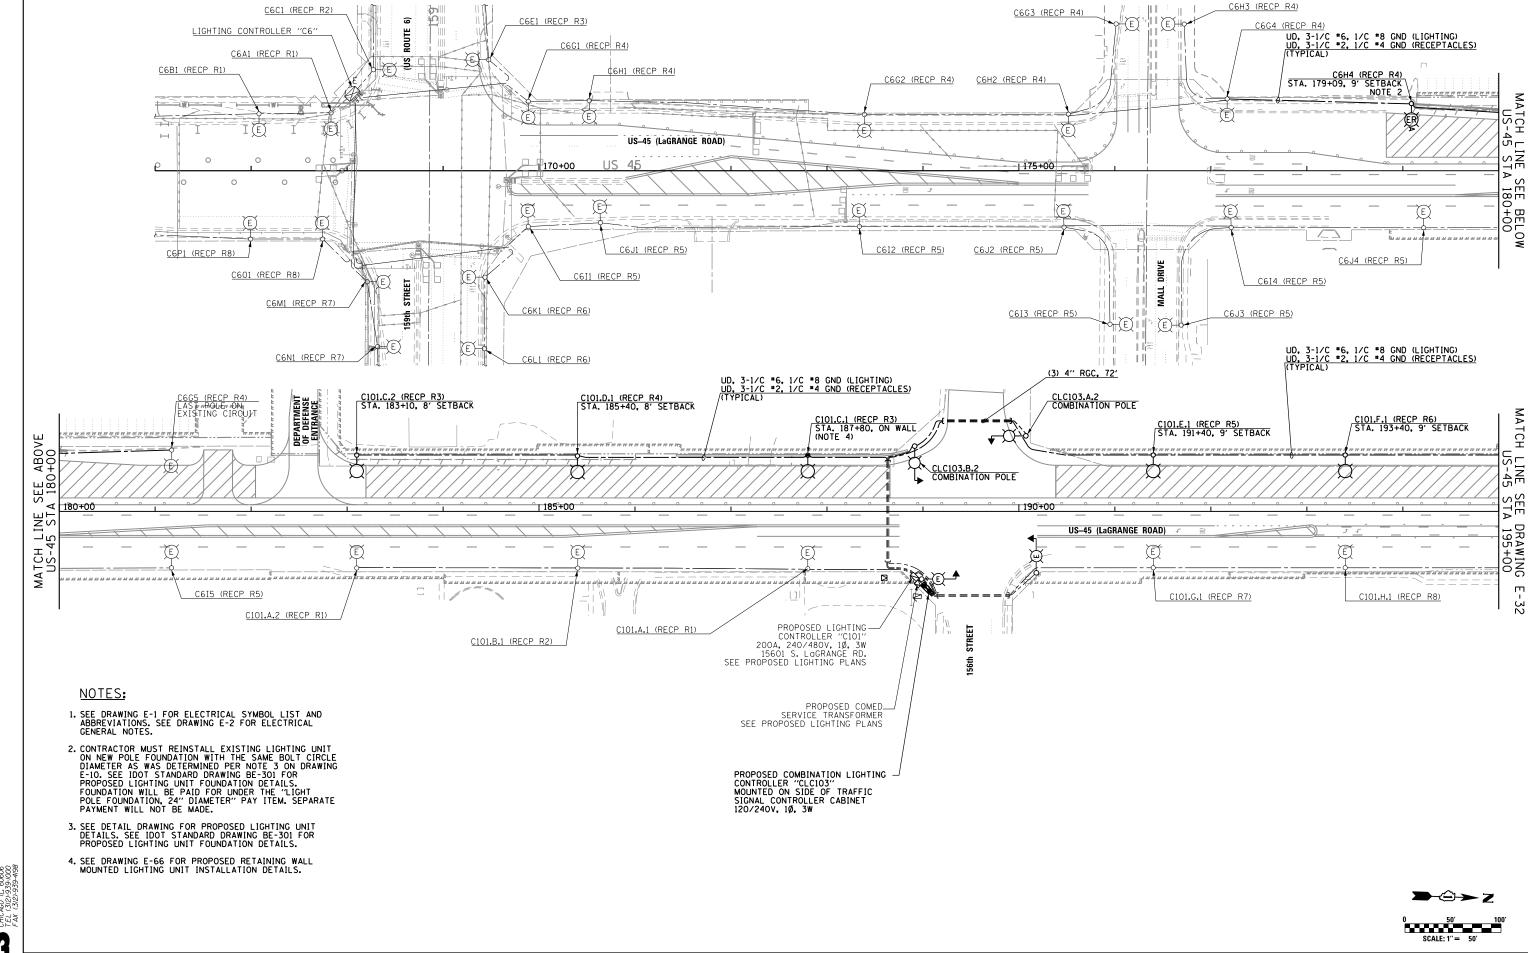




STATE OF ILLINOIS
DEPARTMENT OF TRANSPORTATION

US 45 (Lagrange Road)
TEMPORARY ROADWAY LIGHTING PLAN - STAGE 3

SCALE: 1"=50' SHEET 1 OF 7 SHEETS STA. BEGIN TO STA. 195+00.00

60M61-SHT-E31.den 3/15/2013 2:27:18 P

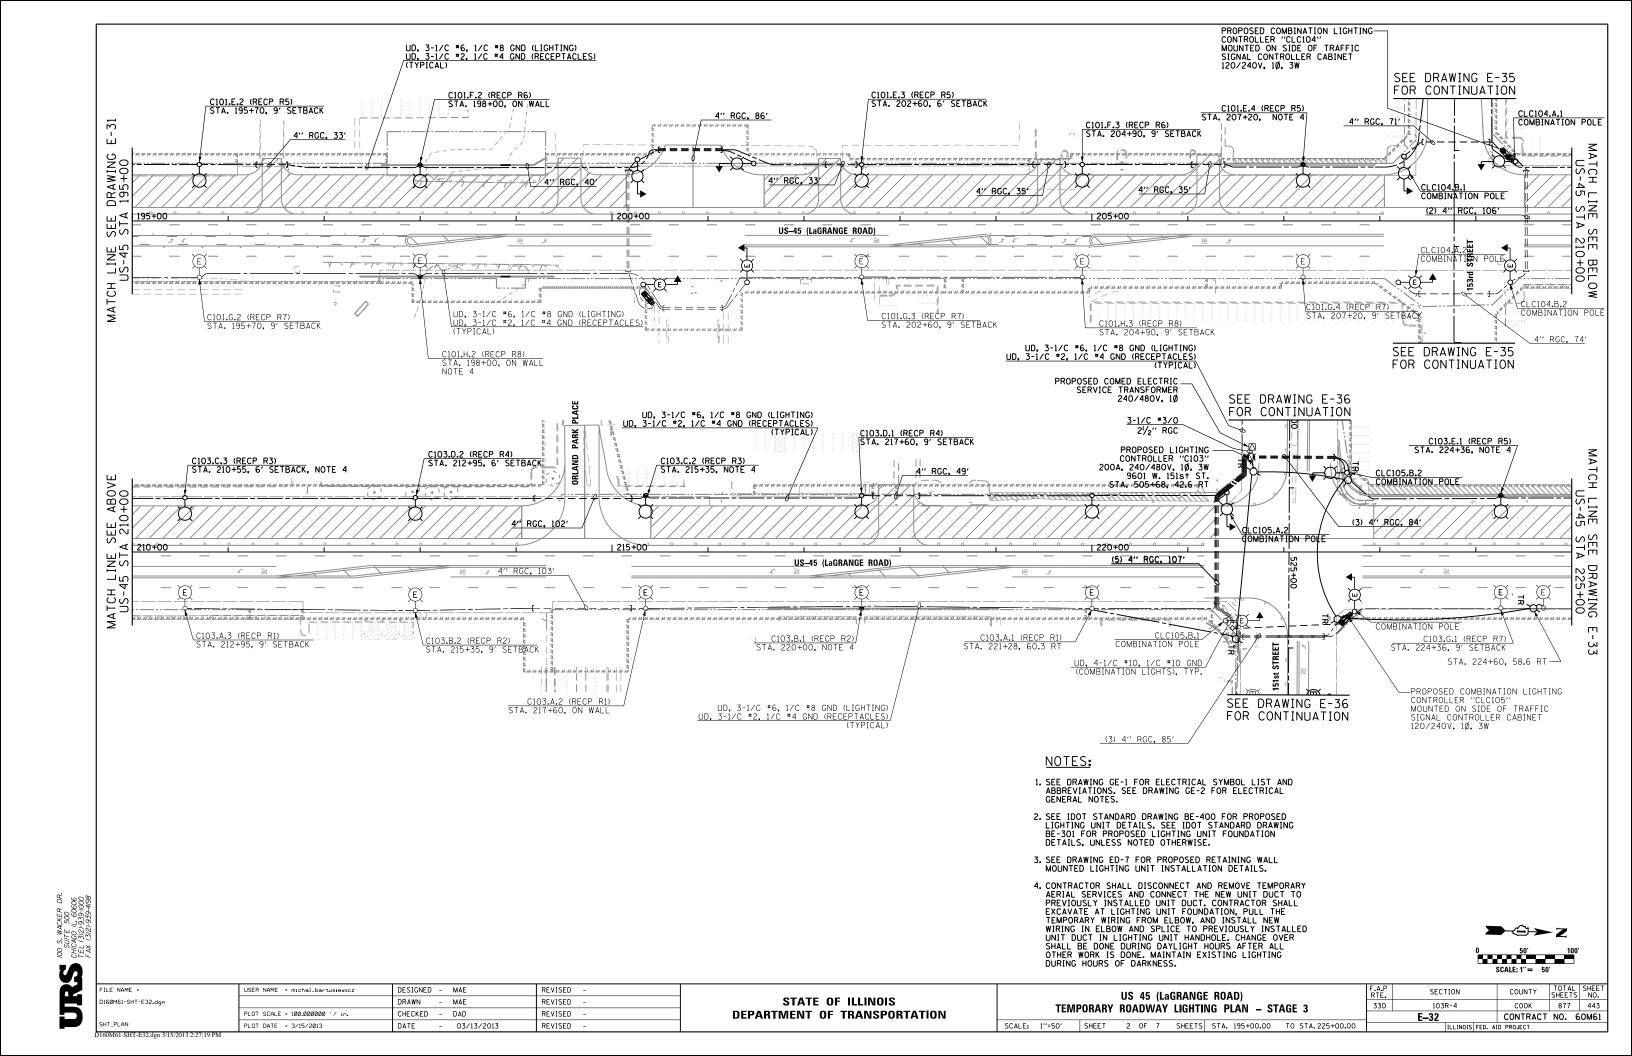

100 S. WACKER DR. SUITE 500 CHICAGO 11, 60606 TEL (312)-939-1000 FAX (312)-939-408

3. SEE DRAWING E-66 FOR PROPOSED RETAINING WALL MOUNTED LIGHTING UNIT INSTALLATION DETAILS. FILE NAME = DESIGNED - MAE REVISED USER NAME = michal_bartusiewicz SECTION COUNTY US 45 (LaGRANGE ROAD) STATE OF ILLINOIS 160M61-SHT-E33.dar DRAWN - MAE REVISED 103R-4 877 444 330 COOK TEMPORARY ROADWAY LIGHTING PLAN - STAGE 3 PLOT SCALE = 100.000000 '/ in. CHECKED - DAD REVISED **DEPARTMENT OF TRANSPORTATION** E-33 CONTRACT NO. 60M61 - 03/13/2013 SCALE: 1"=50" SHEET 3 OF 7 SHEETS STA. 225+00.00 TO STA. 255+00.00 PLOT DATE = 3/15/2013 DATE REVISED

NOTES:

SEE DRAWING E-35
FOR CONTINUATION

C, D, R3, & R4:
3-1/C *6, 3-1/C *2, & 1/C *2 GND
1/2" UD (TYP. U.N.O.)

C105.D.4 (RECP R4)

C105.A.4 (RECP R1)

4" RGC, 39"

C105.E.2 (RECP R5) STA, 251+69, 58.6 LT

C105.H.1 (RECP R8)

FOR CONTINUATION

| 235+0

SEE DRAWING E-35 FOR CONTINUATION

C105.E.1 (RECP R5) STA. 227+77, 32.4 LT

C105.F.1 (RECP R6) STA. 249+35, ON WALL NOTE 3

1250+00

C105.G.1 (RECP R7)

C105.P.1 (RECP R9)

C103.E.4 (RECP R5) STA. 232+75, 58.6 LT

C103.F.4 (RECP R6) STA. 234+52, 58.6 LT

C103.G.4 (RECP R7)

C103.H.4 (RECP R8)

C105.0.1 (RECP/R10

SEE DRAWING E-37

FOR CONTINUATION

SEE DRAWING E-37 FOR CONTINUATION

C103.F.3 (RECP R6) STA. 231+01, 58.6 LT

4" RGC, 42"

C105.B.1 (RECP R2) (E)

PROPOSED COMED SERVICE TRANSFORMER

PROPOSED LIGHTING E CONTROLLER "C105" 200A, 240/480V, 1Ø, 3W 9599 W. 147+h ST.

C103.H.3 (RECP R8)

4" RGC, 63"

(3) 4"/ RGC, 118°

1 230+00

C103.G.3 (RECP R7)

1245+00

US-45 (Lagrange ROAD)

C103.H.2 (RECP R8)

C, D, R3, & R4: 3-1/C *6, 3-1/C *2, & 1/C *2 GND 1½" UD (TYP, U.N.O.)

C105.C.2 (RECP R3) STA. 244+02, 56.6 LT

E

4" RGC. 35'

E, F, R5, & R6: 3-1/C *6, 3-1/C *2, & 1/C *2 GND 11/2" UD (TYP. U.N.O.)

4" RGC, 46'

<u>4" RGC, 41</u>

C103.F.2 (RECP R6) STA. 226+69, 57 LT

C103.G.2 (RECP R7)

4" RGC, 33'

US-45 (LaGRANGE ROAD)

C105.B.2 (RECP R3)

240+00

MATCH LI

4" RGC, 38'

C105.D.2 (RECP R4) STA. 241+84, 58.6 LT

4" RGC, 41"

C105.A.2 (RECP R1)

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DRAWING

 Σ

MATCH

1. SEE DRAWING E-1 FOR ELECTRICAL SYMBOL LIST AND ABBREVIATIONS. SEE DRAWING E-2 FOR ELECTRICAL GENERAL NOTES.

C105.C.3 (RECP R3) STA. 239+77, 58.6 LT

LINE 45 ST

SEE BELOW A 240+00

MATCH

DRAWING 255+00

E-34

C105.D.3 (RECP R4) STA, 238+09, 58,6 LT

C105.B.3 (RECP R2)


C105.A.3 (RECP R1)

E, F, R5, & R6: 3-1/C *6, 3-1/C *2, & 1/C *2 GND 11/2" UD (TYP. U.N.O.)

C105.F.2 (RECP R6) STA. 253+51, 58.6 LT


C105.G.2 (RECP R7)

2. SEE DETAIL DRAWING FOR PROPOSED LIGHTING UNIT DETAILS. SEE IDOT STANDARD DRAWING BE-301 FOR PROPOSED LIGHTING UNIT FOUNDATION DETAILS.

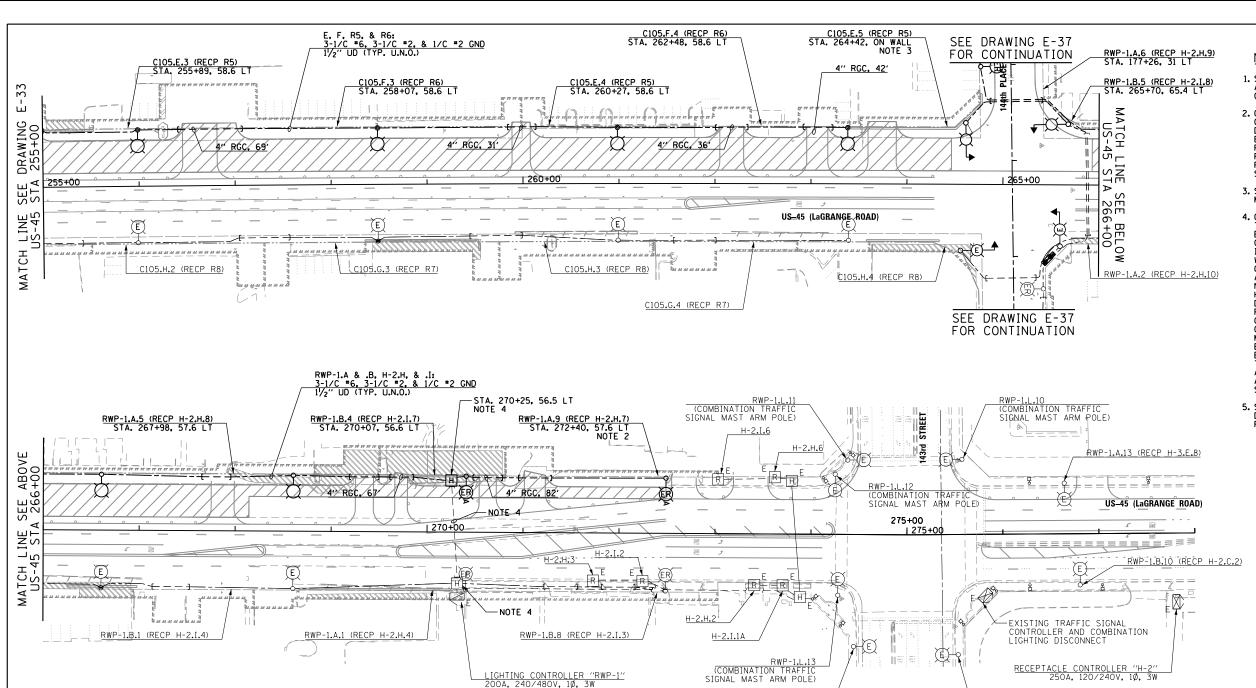

- 1. SEE DRAWING E-1 FOR ELECTRICAL SYMBOL LIST AND ABBREVIATIONS. SEE DRAWING E-2 FOR ELECTRICAL GENERAL NOTES.
- 2. CONTRACTOR MUST REINSTALL EXISTING LIGHTING UNIT ON NEW POLE FOUNDATION WITH THE SAME BOLT CIRCLE DIAMETER AS WAS DETERMINED PER NOTE 4 ON DRAWING E-13. SEE IDOT STANDARD DRAWING BE-301 FOR PROPOSED LIGHTING UNIT FOUNDATION DETAILS. FOUNDATION WILL BE PAID FOR UNDER THE "LIGHT POLE FOUNDATION, 24" DIAMETER" PAY ITEM. SEPARATE PAYMENT WILL NOT BE MADE.
- 3. SEE DRAWING E-66 FOR PROPOSED RETAINING WALL MOUNTED LIGHTING UNIT INSTALLATION DETAILS.
- MOUNTED LIGHTING UNIT INSTALLATION DETAILS.


 4. CONTRACTOR MUST EXTEND EXISTING CONDUIT TO REACH THE RELOCATED HANDHOLE, AND ROUTE THE EXISTING EXCESS COILED 3-1/C "6, 3-1/C "2, AND 1/C "2 GROUND WIRING THROUGH TO THE RELOCATED HANDHOLE. IF THERE IS NOT SUFFICIENT EXISTING EXCESS COILED WIRE TO REACH THE RELOCATED HANDHOLE, THE CONTRACTOR SHALL INSTALL NEW 3-1/C "6, 3-1/C "2, AND 1/C "2 GROUND WIRING FROM THE EAST HANDHOLE NEAR STATION 270+00, CONTRACTOR MUST DEENERGIZE THE SERVICE FEED TO BOTH CONTROLLERS RWP-1 AND H-2 DURING THE SAME TIME BEFORE SPLICING CONDUCTORS TO THE APPROPRIATE EXISTING CIRCUIT CABLES WITHIN THE EXISTING HANDHOLE. CONTRACTOR MUST REENERGIZE BOTH CONTROLLERS AS SOON AS THE ELECTRICAL ITEMS ARE INSTALLED AND CONNECTED. EXTENSION OF EXISTING CONDUIT WILL BE PAID UNDER THE "RELOCATE EXISTING HANDHOLE" PAY ITEM, AND ALL REQUIRED NEW CABLES SHALL BE PAID UNDER THE APPROPRIATE "ELECTRIC CABLE IN CONDUIT" PAY ITEMS. SEPARATE PAYMENTS WILL NOT BE MADE.
- 5. SEE DETAIL DRAWING FOR PROPOSED LIGHTING UNIT DETAILS. SEE IDOT STANDARD DRAWING BE-301 FOR PROPOSED LIGHTING UNIT FOUNDATION DETAILS.

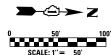


4											
2	FILE NAME =	USER NAME = michal_bartusiewicz	DESIGNED - MAE	REVISED -		US 45 (Lagrange road)	F.A.P RTF	SECTION	COUNTY	TOTAL S	HEET NO.
	D160M61-SHT-E34.dgn		DRAWN - MAE	REVISED -	STATE OF ILLINOIS	TEMPORARY ROADWAY LIGHTING PLAN - STAGE 3	330	103R-4	соок	877	445
3		PLOT SCALE = 100.000000 '/ in.	CHECKED - DAD	REVISED -	DEPARTMENT OF TRANSPORTATION	SCALE: 1"=50" SHEET 4 OF 7 SHEETS STA. 255+00.00 TO STA. 278+00.00		E-34	CONTRACT	NO. 60	M61
	SHT_PLAN	PLOT DATE = 3/15/2013	DATE - 03/13/2013	REVISED -				ILLINOIS FED.	AID PROJECT		
	D160M61-SHT-E34.dgn 3/15/2013 2:27:20 PM				·						


RWP-1.D.1 (RECP H-2.F.1)

RWP-1.E.1 (RECP H-2.E.3)

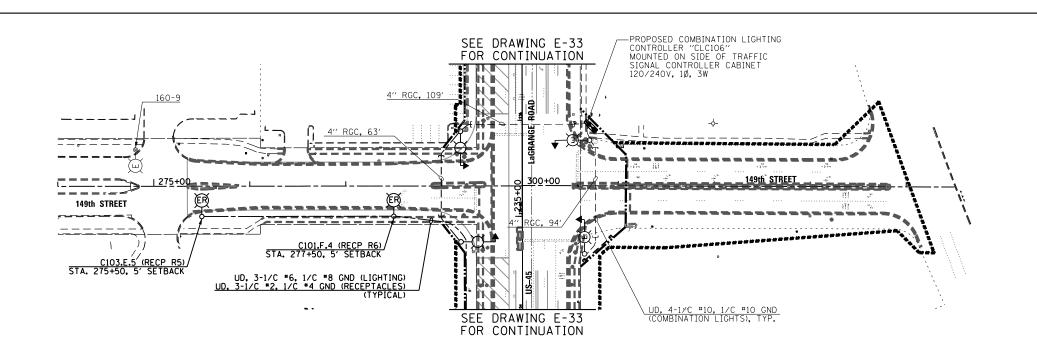


- 1. SEE DRAWING E-1 FOR ELECTRICAL SYMBOL LIST AND ABBREVIATIONS. SEE DRAWING E-2 FOR ELECTRICAL GENERAL NOTES.
- 2. SEE DETAIL DRAWING FOR PROPOSED LIGHTING UNIT DETAILS. SEE IDOT STANDARD DRAWING BE-301 FOR PROPOSED LIGHTING UNIT FOUNDATION DETAILS.

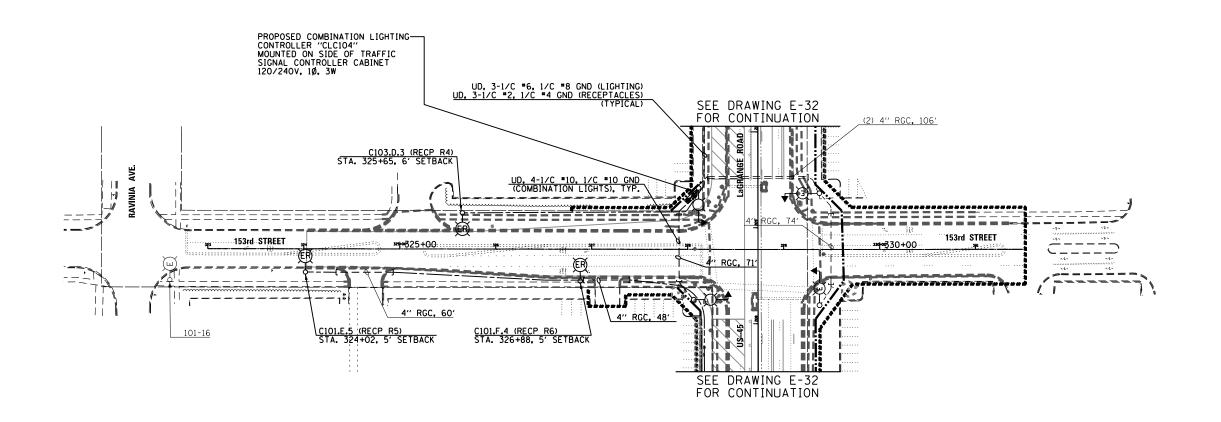


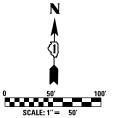

4											
•	FILE NAME =	USER NAME = michal_bartusiewicz	DESIGNED - MAE	REVISED -		153rd STREET & 149th STREET		SECTION	COUNTY	TOTAL S	HEET
	D160M61-SHT-E35.dgn		DRAWN - MAE	REVISED -	STATE OF ILLINOIS	TEMPORARY ROADWAY LIGHTING PLAN - STAGE 3	330	103R-4	соок	877	446
3		PLOT SCALE = 100.0000000 ' / in.	CHECKED - DAD	REVISED -	DEPARTMENT OF TRANSPORTATION	TEMPURARY RUADWAY LIGHTING PLAN - STAGE 3		E-35	CONTRACT	NO. 601	M61
	SHT_PLAN	PLOT DATE = 3/15/2013	DATE - 03/13/2013	REVISED -		SCALE: 1"=50" SHEET 5 OF 7 SHEETS STA. VARIES TO STA. VARIES			. AID PROJECT		
ľ	D160M61-SHT-E35.dgn 3/15/2013 2:27:22 PM										

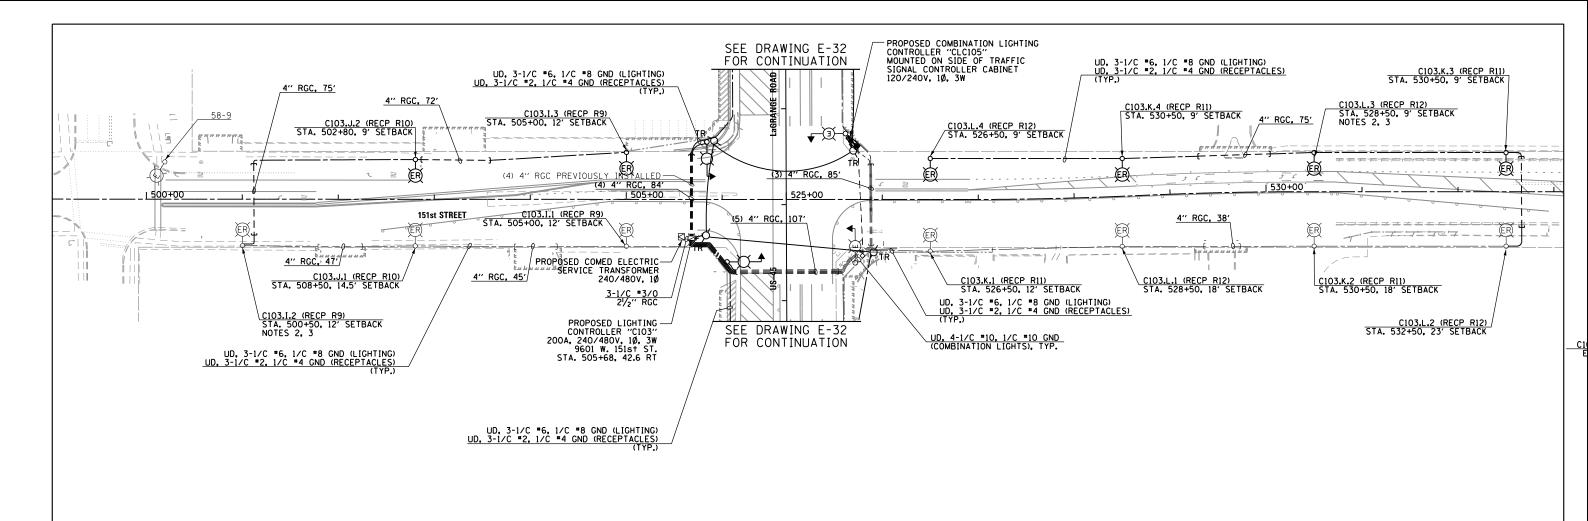


- 1. SEE DRAWING E-1 FOR ELECTRICAL SYMBOL LIST AND ABBREVIATIONS. SEE DRAWING E-2 FOR ELECTRICAL GENERAL NOTES.
- 2. SEE DETAIL DRAWING FOR PROPOSED LIGHTING UNIT DETAILS. SEE IDOT STANDARD DRAWING BE-301 FOR PROPOSED LIGHTING UNIT FOUNDATION DETAILS.
- 3. CONTRACTOR SHALL DISCONNECT AND REMOVE TEMPORARY AERIAL SERVICES AND CONNECT THE NEW UNIT DUCT TO PREVIOUSLY INSTALLED UNIT DUCT. CONTRACTOR SHALL EXCAVATE AT LIGHTING UNIT FOUNDATION, PULL THE TEMPORARY WIRING FROM ELBOW, AND INSTALL NEW WIRING IN ELBOW AND SPLICE TO PREVIOUSLY INSTALLED UNIT DUCT IN LIGHTING UNIT HANDHOLE. CHANGE OVER SHALL BE DONE DURING DAYLIGHT HOURS AFTER ALL OTHER WORK IS DONE. MAINTAIN EXISTING LIGHTING DURING HOURS OF DARKNESS.

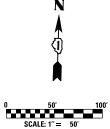


900							Ϋ
: 500 2)-939-4198 2)-939-4198							Á
SUITE CHICAGO CHICAGO TEL (312) FAX (312)							0 50' 100'
A							SCALE: 1" = 50"
FILE NAME =	USER NAME = michal_bartusiewicz	DESIGNED - MAE	REVISED -			F.A.P SECTION	COUNTY TOTAL SH
D160M61-SHT-E36.dgn		DRAWN - MAE	REVISED -	STATE OF ILLINOIS	151st STREET TEMPORARY ROADWAY LIGHTING PLAN - STAGE 3	330 103R-4	COOK 877 44
5	PLOT SCALE = 100.000000 ' / 10.	CHECKED - DAD	REVISED -	DEPARTMENT OF TRANSPORTATION		E-36	CONTRACT NO. 60M
SHT_PLAN	PLOT DATE = 3/15/2013	DATE - 03/13/2013	REVISED -		SCALE: 1"=50' SHEET 6 OF 7 SHEETS STA. 498+50.00 TO STA. 531+50.00		FED. AID PROJECT

N (i)	
0 50' SCALE: 1"=	100' 50'

2									SUALL. I — JU	
7	FILE NAME =	USER NAME = michal_bartusiewicz	DESIGNED - MAE	REVISED -		147th STREET & 144th PLACE	F.A.P	SECTION	COUNTY TO	TAL SHEET
	D160M61-SHT-E37.dgn		DRAWN - MAE	REVISED -	SIATE OF ILLINOIS		330	103R-4	COOK 8	877 448
3		PLOT SCALE = 100.0000000 '/ in.	CHECKED - DAD	REVISED -	DEPARTMENT OF TRANSPORTATION	TEMPORARY ROADWAY LIGHTING PLAN - STAGE 3		E-37	CONTRACT N	0. 60M61
	SHT_PLAN	PLOT DATE = 3/15/2013	DATE - 03/13/2013	REVISED -		SCALE: 1"=50' SHEET 7 OF 7 SHEETS STA. VARIES TO STA. VARIES		ILLINOIS FED. A	ID PROJECT	
	D160M61-SHT-E37.dgn 3/15/2013 2:27:23 PM									

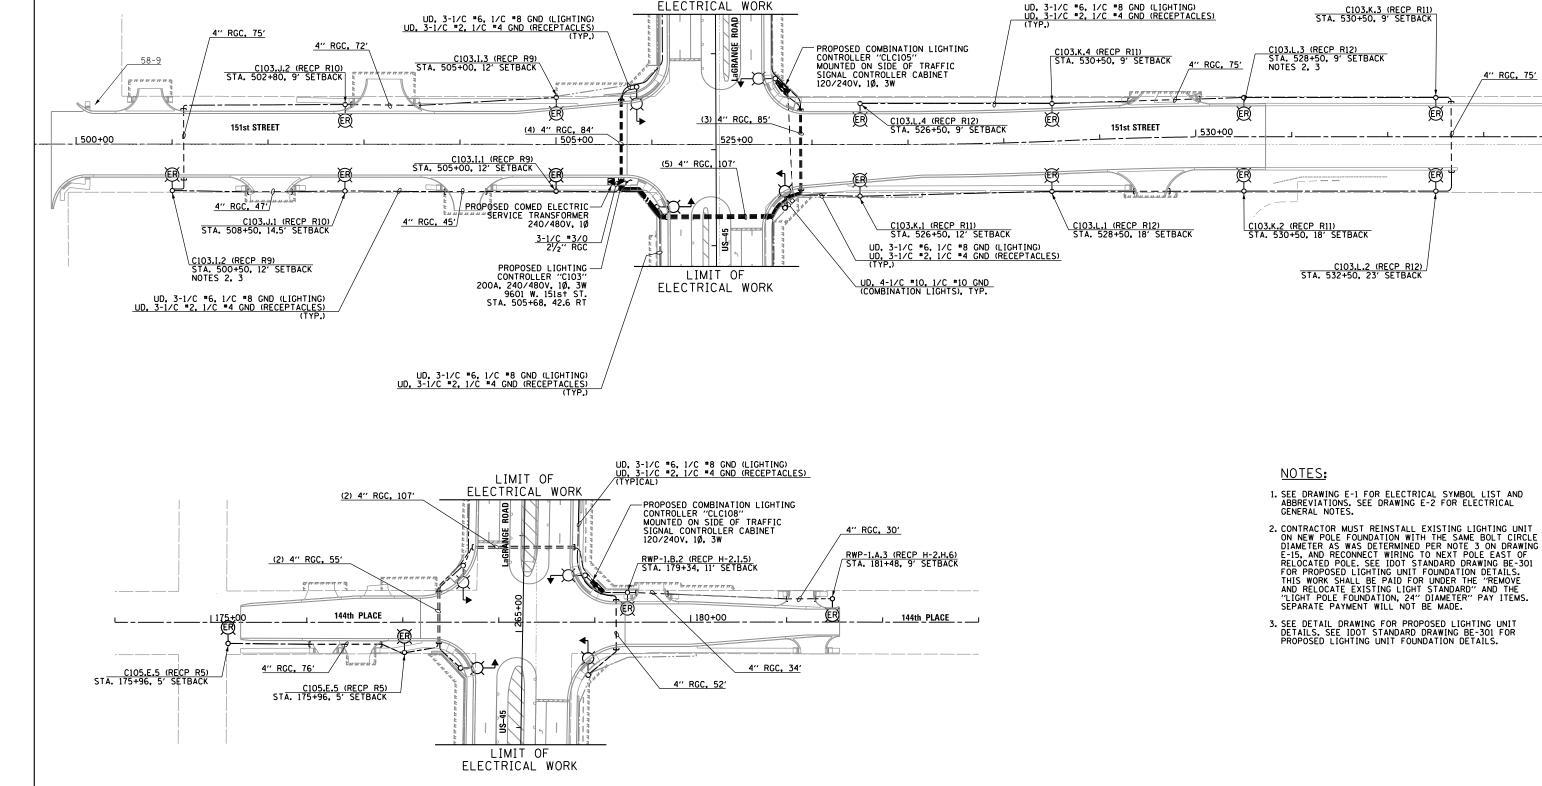

LIMIT OF ELECTRICAL WORK

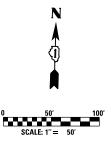

C103.K.3 (RECP R11)
STA. 530+50, 9' SETBACK

4" RGC, 75"

Ø

FILE NAME = DESIGNED - MAE REVISED USER NAME = michal_bartusiewicz SECTION COUNTY 151st STREET & 144th PLACE STATE OF ILLINOIS 160M61-SHT-E38.dar ORAWN MAE REVISED 330 103R-4 COOK 877 449 TEMPORARY ROADWAY LIGHTING PLANS - STAGE 4 PLOT SCALE = 100.0000000 '/ in. CHECKED -DAD REVISED **DEPARTMENT OF TRANSPORTATION** E-38 CONTRACT NO. 60M61 SCALE: 1"=50" SHEET 1 OF 1 SHEETS STA. 498+50.00 TO STA. 531+50.00 DATE 03/13/2013 REVISED PLOT DATE = 3/15/2013

URS



STATE OF ILLINOIS

US 45 (LaGRANGE ROAD) LIGHTING CONTROLLER "C101" WIRING DIAGRAM SCALE: NONE SHEET 1 OF 1 SHEETS STA.

TOTAL

330 103R-4 COOK E-39

TOTAL

16.5

1980

400W HPS LUMINAIRE: 2.0A AT 240V 250W HPS LUMINAIRE: 1.1A AT 240V COUNTY 877 450 CONTRACT NO. 60M61

TOTAL

480 480 920 920 ----٧

LIGHTING CONTROLLER "C101" ROADWAY LIGHTING PANEL LOAD TABLE

CIRCUIT

BLACK PHASE

WATTS

1980

6864

AMPS

7.5

28.6

	7	300			_
С	4	960	D	2	4
Ε	9.1	1920	F	9.1	19
G	8	1920	Н	8	19
I			J		
К			L		
М			N		
0			Р		
0			R		

2340

8364

LOAD TABULATION IS BASED ON THE FOLLOWING:

WATTS

960

RED PHASE

AMPS

9.75

34.85

CIRCUIT

→©→ Z

ROADWAY LIGHTING PANEL LOAD TABLE

CIRCUIT			CIRCUIT		
CIRCUIT	AMPS	WATTS	CIRCUIT	AMPS	WATTS
Α	4	960	В	4	960
С			D		
TOTAL	4.0	960	TOTAL	4.0	960

400W HPS LUMINAIRE: 2.0A AT 240V

1 1/4" UD, 3-1/C =6, 1-1/C =8 GND (LIGHTING) 1 1/2" UD, 3-1/C =2, 1-1/C =4 GND (RECEPTACLE) TYPICAL DEPARTMENT OF DEFENSE ENTRANCE DARVIN ENTRANCE 156th ST 153rd ST C.1 R3 E.1 R5 E.3 R5 C.2 R3 E.2 R5 LaGRANGE ROAD 1 1/4" UD, 3-1/C =6, 1-1/C =8 GND (LIGHTING) 1 1/2" UD, 3-1/C =2, 1-1/C =4 GND (RECEPTACLE) TYPICAL

-EXISTING COMED SERVICE TRANSFORMER, NOTE 4

STA. 188+40, 73 RT

ZZ.B.2

ZZ.A.1

PROPOSED LIGHTING CONTROLLER "C101" 200A, 240/480V, 10, 3W 15601 S. Lagrange RD.

→⊕→ Z

PROPOSED COMBINATION TRAFFIC SIGNALS/LIGHTING CONTROLLER "ZZ" (TYP.)

-PROPOSED COMBINATION SERVICE DISCONNECT, EXACT LOCATION BY TRAFFIC SIGNAL CONTRACTOR

' UD, 3-1/C *8 & 1/C *10 GND.
" RGC (SEPARATE CONDUIT)

LaGRANGE ROAD

1" UD, 4-1/C *10 & 1/C *10 GND.
WIRING FOR LIGHTS ON COMBINATION POLES

LIGHTING CONTROLLER "C101" WIRING DIAGRAM
N.T.S.

PROPOSED COMBINATION POLE LIGHTING UNIT: 400W, 2.0A AT 240V PHASE TO PHASE, HPS LUMINAIRE WITH TYPE MC-III DISTRIBUTION

PROPOSED COMBINATION LIGHTING CONTROLLER ATTACHED TO SIDE OF TRAFFIC SIGNAL CABINET 120/240V, 10, 3W

COMBINATION SERVICE DISCONNECT CABINET GROUND OR POLE MOUNTED, SEE TRAFFIC SIGNAL PLANS FOR LOCATION AT EACH INTERSECTION

COMBINATION TRAFFIC/LIGHTING CONTROLLER (TYPICAL FOR ALL INTERSECTIONS IN THIS CONTRACT)

LOAD TABULATION IS BASED ON THE FOLLOWING:

LEGEND:

PROPOSED LIGHTING UNIT: 400W, 240V PHASE TO NEUTRAL, HPS LUMINAIRE WITH TYPE MC-III DISTRIBUTION, 45'-2" ALUMINUM POLE SHAFT ON 24" DIAMETER CONCRETE FOUNDATION, 47'-6" MOUNTING HEIGHT, 12'-0" MAST ARM, WITH 5A FUSES AND T-BASE (RED PHASE-DADED SYMPO) OPEN SYMBOL, BLACK PHASE-SHADED SYMBOL

PROPOSED 120V, 20A, GFCI RECEPTACLE ON PROPOSED LIGHTING UNIT (ORANGE PHASE-OPEN SYMBOL, BROWN PHASE-SHADED SYMBOL)

EXISTING LIGHTING POLE RELOCATED WITH NEW 250 HPS AND GFCI RECEPTACLE, 5A FUSES (LIGHTING UNIT ON RED PHASE- OPEN SYMBOL, BLACK PHASE-SHADED SYMBOL)

PROPOSED ROADWAY LIGHTING CONTROLLER 200A, 240/480V, 10, 3W, SPECIAL SINGLE DOOR, BASE MOUNTED

EXISTING COMED PAD-MOUNTED TRANSFORMER FOR UTILITY SERVICE CONNECTION

PROPOSED COMED PAD-MOUNTED TRANSFORMER FOR UTILITY SERVICE CONNECTION PROPOSED CONDUIT AND CABLE AS INDICATED TO SECONDARY SIDE OF UTILITY SERVICE

PROPOSED UNIT DUCT: SIZE AND QUANTITY OF CONDUCTORS AS INDICATED

NOTES:

1. SEE DRAWING E-1 FOR ELECTRICAL ABBREVIATIONS. SEE DRAWING E-2 FOR ELECTRICAL GENERAL NOTES.

2. COLOR CODING OF CONDUCTORS FOR 240/480V, 10, 3W LIGHTING SYSTEM IS AS FOLLOWS:

"A" PHASE - RED
"B" PHASE - BLACK
NEUTRAL - WHITE NEUTRAL GROUND

3. COLOR CODING OF CONDUCTORS FOR 120/240V, 10, 3W RECEPTACLE SYSTEM IS AS FOLLOWS:

"A" PHASE - ORANGE
"B" PHASE - BROWN
NEUTRAL - GRAY
GROUND - GREEN

4. CONTRACTOR TO CONNECT PROPOSED ROADWAY LIGHTING CONTROLLER "CIOI" TO THE EXISTING COMED SERVICE TRANSFORMER AT DISCRETION OF COMED AND THE ENGINEER. FURNISH AND INSTALL NEW CABLE IN CONDUIT BETWEEN COMED TRANSFORMER AND CONTROLLER AS SHOWN. REFER TO NOTE 2 ON DRAWING E-17 FOR FURTHER INFORMATION.

LIGHTING CONTROLLER "C101" RECEPTACLE PANEL LOAD TABLE

ORANGE PHASE BROWN PHASE CIRCUI1 CIRCUIT AMPS WATTS AMPS WATTS 360 1.5 180 R4 R3 360 1.5 180 R5 7.5 900 R6 7.5 900 R7 720 R8 720 R9 R10 R11 R12 ----R13 --R14 --R15 R16 --R17 R18

2340

LOAD TABULATION IS BASED ON THE FOLLOWING:

19.5

180W RECEPTACLE: 1.5A AT 120V
• FOR FUTURE MEDIAN RECEPTACLE LOADS

FILE NAME =	USER NAME = michal_bartusiewicz	DESIGNED -	DAD	REVISED -
D160M61-SHT-E39.dgn		DRAWN -	DAD	REVISED -
	PLOT SCALE = 2.0000000 '/ in.	CHECKED -	DAD	REVISED -
SHT PLAN	DLOT DATE - 3/15/2013	DATE	07/17/2017	DEVICED

TYPICAL COMBINATION LIGHTING CONTROLLER WIRING DIAGRAM
TYPICAL FOR ALL INTERSECTIONS

N.T.S.

3-1/C *3/0 2¹/₂'' RGC

ZZ.A.2

ZZ.B.1

156th STREET to 144th PLACE (7 INTERSECTIONS TOTAL)

DEPARTMENT OF TRANSPORTATION

1" UD, 4-1/C #10, 1/C #10 GND (TYPICAL)

D160M61-SHT-E39.dgn 3/15/2013 2:27:26 PM



	FILE NAME =	USER NAME = michal_bartusiewicz	DESIGNED - DAD	REVISED -
	D160M61-SHT-E40.dgn		DRAWN - DAD	REVISED -
		PLOT SCALE = 2.0000000 '/ in.	CHECKED - DAD	REVISED -
	SHT_PLAN	PLOT DATE = 3/15/2013	DATE - 03/13/2013	REVISED -
Í	0160M61-SHT-E40.dgn 3/15/2013 2:27:26 PM			

STATE OF ILLINOIS

US 45 (LaGRANGE ROAD) LIGHTING CONTROLLER "C103" WIRING DIAGRAM SCALE: NONE SHEET 1 OF 1 SHEETS STA.

SECTION COUNTY 330 103R-4 COOK

400W HPS LUMINAIRE: 2.0A AT 240V 250W HPS LUMINAIRE: 1.1A AT 240V

1 $\frac{1}{4}$ " UD, 3-1/C *6, 1-1/C *8 GND (LIGHTING) 1 $\frac{1}{2}$ " UD, 3-1/C *2, 1-1/C *4 GND (RECEPTACLE) TYPICAL

C.2 R3

1 1/4" UD, 3-1/C =6, 1-1/C =8 GND (LIGHTING) 1 1/2" UD, 3-1/C =2, 1-1/C =4 GND (RECEPTACLE) TYPICAL

PROPOSED LIGHTING CONTROLLER "C103" 200A, 240/480V, 1Ø, 3W 9601 W. 151s† ST. STA. 505+68, 42.6 RT

LOAD TABULATION IS BASED ON THE FOLLOWING:

E	
PHASE	
WATTS	
480	
1224	
1224	
480	
528	
1056	
480	
2880	

151s† ST

LOAD	TABULATION	IS	BASED	ON	THE	FOLLOWING

1 1/4" UD, 3-1/C =6, 1-1/C =8 GND (LIGHTING) 1 1/2" UD, 3-1/C =2, 1-1/C =4 GND (RECEPTACLE) TYPICAL

1 ¼" UD, 3-1/C "6, 1-1/C "8 GND (LIGHTING) 1 ½" UD, 3-1/C "2, 1-1/C "4 GND (RECEPTACLE) TYPICAL

LIGHTING CONTROLLER "C103" RECEPTACLE PANEL LOAD TABLE

CIRCUIT

R2

R4

R6

R8

R10

R12

R14

R16

R18

TOTAL

BROWN PHASE

WATTS

360

540

540

360

360

720

--

--

2880

AMPS

4.5

4.5

24

180W RECEPTACLE: 1.5A AT 120V
• FOR FUTURE MEDIAN RECEPTACLE LOADS

ORANGE PHASE

WATTS

540

540

720

540

540

720

--

3600

AMPS

4.5

4.5

4.5

--

30

LEGEND:

149th ST

l ¼" UD, 3-1/C #6, 1-1/C #8 GND (LIGHTING) l ½" UD, 3-1/C #2, 1-1/C #4 GND (RECEPTACLE) TYPICAL

LaGRANGE ROAD

- PROPOSED LIGHTING UNIT: 400W, 240V PHASE TO NEUTRAL, HPS LUMINAIRE WITH TYPE III DISTRIBUTION, 45'-2" ALUMINUM POLE SHAFT ON 24" DIAMETER CONCRETE FOUNDATION, 47'-6" MOUNTING HEIGHT, 12'-0" MAST ARM, WITH 5A FUSES AND T-BASE (RED PHASE-CSUADED SYMPOL)
- EXISTING LIGHTING POLE RELOCATED WITH NEW 250 HPS AND GFCI RECEPTACLE, 5A FUSES (LIGHTING UNIT ON RED PHASE- OPEN SYMBOL, BLACK PHASE-SHADED SYMBOL)
- PROPOSED 120V, 20A, GFCI RECEPTACLE ON PROPOSED LIGHTING UNIT (ORANGE PHASE-OPEN SYMBOL, BROWN PHASE-SHADED SYMBOL)



PROPOSED ROADWAY LIGHTING CONTROLLER 200A, 240/480V, 1Ø, 3W, SPECIAL SINGLE DOOR, BASE MOUNTED



PROPOSED COMED PAD-MOUNTED TRANSFORMER FOR UTILITY SERVICE CONNECTION

- PROPOSED CONDUIT AND CABLE AS INDICATED TO SECONDARY SIDE OF UTILITY SERVICE CONNECTION
- PROPOSED UNIT DUCT: SIZE AND QUANTITY OF CONDUCTORS AS INDICATED

NOTES:

- 1. SEE DRAWING E-1 FOR ELECTRICAL ABBREVIATIONS. SEE DRAWING E-2 FOR ELECTRICAL GENERAL NOTES.
- 2. COLOR CODING OF CONDUCTORS FOR 240/480V, 10, 3W LIGHTING SYSTEM IS AS FOLLOWS:
- "A" PHASE RED
 "B" PHASE BLACK
 NEUTRAL WHITE
 GROUND GREEN
- 3. COLOR CODING OF CONDUCTORS FOR 120/240V, 10, 3W RECEPTACLE SYSTEM IS AS FOLLOWS:

"A" PHASE - ORANGE
"B" PHASE - BROWN
NEUTRAL - GRAY
GROUND - GREEN

LIGHTING CONTROLLER "C103" ROADWAY LIGHTING PANEL LOAD TABLE									
CIRCUIT	RED F	PHASE	CIRCUIT	BLACK	PHASE				
CIRCUIT	AMPS	WATTS	CIRCUIT	AMPS	WATTS				
Α	6	1440	В	4	480				
С	6	1440	D	5.1	1224				
Ε	7.1	1704	F	5.1	1224				
G	6	1440	Н	4	480				
I	3.3	792	J	2.2	528				
K	4.4	1056	L	4.4	1056				
М			N						
0			Р		480				
0			R						
S			T						
U			٧						
W	15	3600	х	12	2880				
TOTAL	47.8	11472	TOTAL	52.625	8832				

LIGHTING CONTROLLER "C103" WIRING DIAGRAM
N.T.S.

AME =	USER NAME = michal_bartusiewicz	DESIGNED -	-	DAD	REVISED	=
I-SHT-E40.dgn		DRAWN -	-	DAD	REVISED	=
	PLOT SCALE = 2.0000000 '/ in.	CHECKED -	-	DAD	REVISED	=
AN	PLOT DATE = 3/15/2013	DATE -	-	03/13/2013	REVISED	_

DEPARTMENT OF TRANSPORTATION

CIRCUIT

R3

R5

R7

R9

R11

R13

R15

R17

TOTAL


E-40

CONTRACT NO. 60M61

877 451

1 1/4" UD, 3-1/C "6, 1-1/C "8 GND (LIGHTING) 1 1/2" UD, 3-1/C "2, 1-1/C "4 GND (RECEPTACLE) TYPICAL



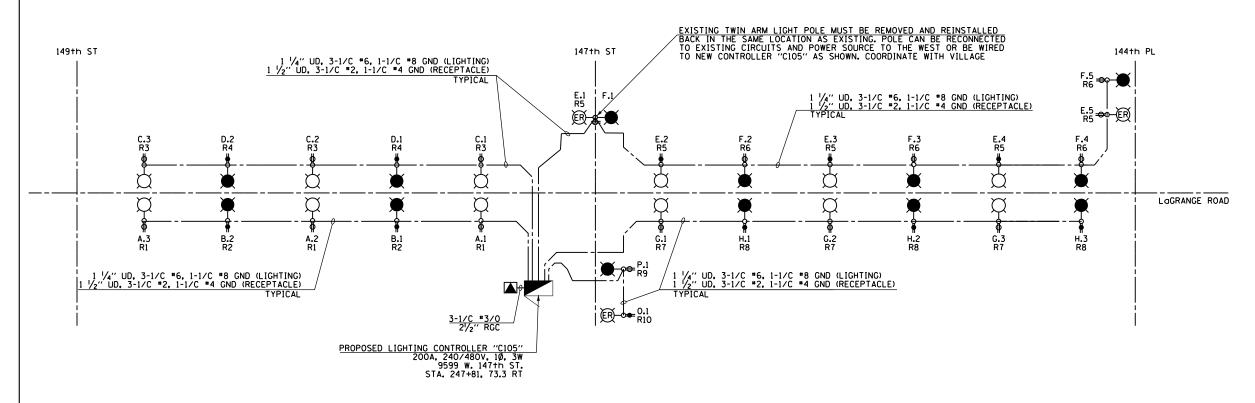

LIGHTING CONTROLLER "C105" WIRING DIAGRAM N.T.S.

F	LIGHTING CONTROLLER "C105" ROADWAY LIGHTING PANEL LOAD TABLE								
CIRCUIT	RED F	PHASE	CIRCUIT	BLACK	PHASE				
CIRCUIT	AMPS	WATTS	CIRCUIT	AMPS	WATTS				
Α	6	1440	В	4	960				
С	6	1440	D	4	960				
E	8.2	1968	F	8.2	1968				
G	6	1440	Н	6	1440				
I			J						
К				L					
М			N						
0	1.1	250	Р	1.1	250				
a			R						
S			Т						
U			٧						
w	10.5	2520	х	9	2160				
TOTAL	37.8	9072	TOTAL	32.3	7752				

LOAD TABULATION IS BASED ON THE FOLLOWING:

400W HPS LUMINAIRE: 2.0A AT 240V 250W HPS LUMINAIRE: 1.1A AT 240V

	LIGHTING CONTROLLER "C105" RECEPTACLE PANEL LOAD TABLE									
	CIRCUIT	ORANGE	PHASE	CIDCUIT	BROWN	PHASE	1			
	CIRCUIT	AMPS	WATTS	CIRCUIT	AMPS	WATTS	1			
	Rl	4.5	540	R2	3	360	1			
	R3	4.5	540	R4	3	360	1			
	R5	7.5	900	R6	7.5	900	1			
	R7	3	360	R8	3	360	1			
	R9	1.5	180	R10	1.5	180	1			
•	R11			R12			1			
•	R13			R14						
•	R15			R16			1			
•	R17			R18			1.			
	TOTAL	21	2520	TOTAL	18	2160	1			

LOAD TABULATION IS BASED ON THE FOLLOWING:

180W RECEPTACLE: 1.5A AT 120V
• FOR FUTURE MEDIAN RECEPTACLE LOADS

LEGEND:

PROPOSED LIGHTING UNIT: 400W, 240V PHASE TO NEUTRAL, HPS LUMINAIRE WITH TYPE III DISTRIBUTION, 45'-2" ALUMINUM POLE SHAFT ON 24" DIAMETER CONCRETE FOUNDATION, 47'-6" MOUNTING HEIGHT, 12'-0" MAST ARM, WITH 5A FUSES AND T-BASE (RED PHASE-OPEN SYMBOL, BLACK PHASE-SHADED SYMBOL)

EXISTING LIGHTING POLE RELOCATED WITH NEW 250 HPS AND GFCI RECEPTACLE, 5A FUSES (LIGHTING UNIT ON RED PHASE- OPEN SYMBOL, BLACK PHASE-SHADED SYMBOL)


PROPOSED 120V, 20A, GFCI RECEPTACLE ON PROPOSED LIGHTING UNIT (ORANGE PHASE-OPEN SYMBOL, BROWN PHASE-SHADED SYMBOL)



PROPOSED ROADWAY LIGHTING CONTROLLER 200A, 240/480V, 10, 3W, SPECIAL SINGLE DOOR, BASE MOUNTED



PROPOSED COMED PAD-MOUNTED TRANSFORMER FOR UTILITY SERVICE CONNECTION

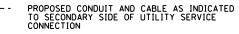

--- PROPOSED UNIT DUCT: SIZE AND QUANTITY OF CONDUCTORS AS INDICATED

NOTES:

- 1. SEE DRAWING E-1 FOR ELECTRICAL ABBREVIATIONS. SEE DRAWING E-2 FOR ELECTRICAL GENERAL NOTES.
- 2. COLOR CODING OF CONDUCTORS FOR 240/480V, 10, 3W LIGHTING SYSTEM IS AS FOLLOWS:

"A" PHASE - RED
"B" PHASE - BLACK
NEUTRAL - WHITE
GROUND - GREEN


3. COLOR CODING OF CONDUCTORS FOR 120/240V, 10, 3W RECEPTACLE SYSTEM IS AS FOLLOWS:

"A" PHASE - ORANGE
"B" PHASE - BROWN
NEUTRAL - GRAY
GROUND - GREEN

100 S. WACKER DR. SUITE 500 CHICAGO IL. 60606 F. (\$120.939.9000)

DESIGNED - JLW REVISED TOTAL SHEET SHEETS NO. FILE NAME = USER NAME = michal_bartusiewicz SECTION COUNTY US 45 (LaGRANGE ROAD) STATE OF ILLINOIS 160M61-SHT-E41.dgr DRAWN - CJM REVISED 330 103R-4 COOK 877 452 LIGHTING CONTROLLER "C105" WIRING DIAGRAM CHECKED -KMY REVISED **DEPARTMENT OF TRANSPORTATION** E-41 CONTRACT NO. 60M61 SCALE: NONE SHEET 1 OF 1 SHEETS STA. 03/13/2013 PLOT DATE = 3/15/2013 DATE REVISED D160M61-SHT-E41.dgn 3/15/2013 2:27:27 PM



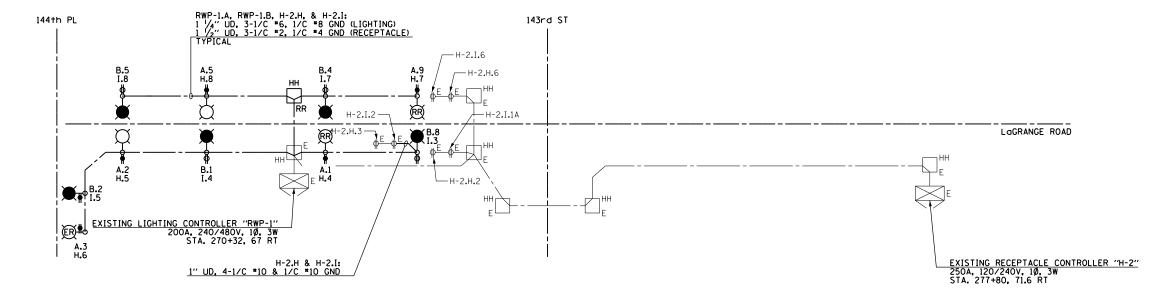

EXISTING LIGHTING CONTROLLERS "RWP-1" & "H-2" WIRING MODIFICATION DIAGRAM
N.T.S. (NOTES 2, 3, 4)

100 S. WACKER DR. SAUTE 500 SILTE 500 CHCAGO IL. 60606 TEL (312)-939-1000 FAX (312)-939-4098

FILE NAME =	USER NAME = michal_bartusiewicz	DESIGNED -	JLW	REVISED -	Γ
0160M61-SHT-E42.dgn		DRAWN -	CJM	REVISED -	ĺ
	PLOT SCALE = 2.0000000 '/ in.	CHECKED -	KMY	REVISED -	ĺ
SHT_PLAN	PLOT DATE = 3/15/2013	DATE -	03/13/2013	REVISED -	ĺ

STATE OF ILLINOIS
DEPARTMENT OF TRANSPORTATION

US 45 (Lagrange Road)

EXISTING LIGHTING CONTROLLERS "RWP-1" & "H-2"

WIRING MODIFICATION DIAGRAM

SCALE: NONE SHEET 1 OF 1 SHEETS STA. TO STA.

LEGEND:

PROPOSED LIGHTING UNIT: 400W, 240V PHASE TO NEUTRAL, HPS LUMINAIRE WITH TYPE III DISTRIBUTION, 45'-2" ALUMINUM POLE SHAFT ON 24" DIAMETER CONCRETE FOUNDATION, 47'-6" MOUNTING HEIGHT, 12'-0" MAST ARM, WITH 5A FUSES AND T-BASE (RED PHASE-OPEN SYMBOL, BLACK PHASE-SHADED SYMBOL)

EXISTING LIGHTING UNIT WITH RECEPTACLE TO BE RELOCATED (LIGHTING UNIT ON RED PHASE-OPEN SYMBOL, BLACK PHASE-SHADED SYMBOL) (RECEPTACLE ON ORANGE PHASE-OPEN SYMBOL, BROWN PHASE-SHADED SYMBOL)

EXISTING LIGHTING POLE TO BE RELOCATED WITH NEW 250 W HPS FIXTURE AND GFCI RECEPTACLE (LIGHTING UNIT ON RED PHASE-OPEN SYMBOL, BACK PHASE-SHADED SYMBOL) (RECEPTACLE ON ORANGE PHASE-OPEN SYMBOL, BROWN PHASE-SHADED SYMBOL)

⇒ PROPOSED 120V, 20A, GFCI RECEPTACLE ON PROPOSED LIGHTING UNIT (ORANGE PHASE-OPEN SYMBOL, BROWN PHASE-SHADED SYMBOL)

⇒E EXISTING RECEPTACLE INSTALLED BY OTHERS (ORANGE PHASE-OPEN SYMBOL, BROWN PHASE-SHADED SYMBOL)

E EXISTING ROADWAY LIGHTING OR RECEPTACLE CONTROLLER AS INDICATED

RR BE RELOCATED HANDHOLE TO

HH EXISTING ROADWAY LIGHTING HANDHOLE

--- PROPOSED ELECTRICAL CONDUCTORS: SIZE AND QUANTITY AS INDICATED

 ELECTRICAL CONDUCTORS: EXISTING OR INSTALLED IN EARLIER CONSTRUCTION STAGE

NOTES:

1. SEE DRAWING E-1 FOR ELECTRICAL ABBREVIATIONS. SEE DRAWING E-2 FOR ELECTRICAL GENERAL NOTES.


2. WIRING DIAGRAM ONLY SHOWS THE CHANGES BEING MADE TO THE CONTROLLERS. EXISTING LOADS ON THE CONTROLLERS ARE NOT SHOWN FOR CLARITY.

3. COLOR CODING OF PROPOSED CONDUCTORS FOR 240/480V, 10, 3W LIGHTING SYSTEM IS AS FOLLOWS:

"A" PHASE - RED
"B" PHASE - BLACK
NEUTRAL - WHITE
GROUND - GREEN

4. COLOR CODING OF PROPOSED CONDUCTORS FOR 120/240V, 10, 3W RECEPTACLE SYSTEM IS AS FOLLOWS:

"A" PHASE - ORANGE
"B" PHASE - BROWN
NEUTRAL - GRAY
GROUND - GREEN

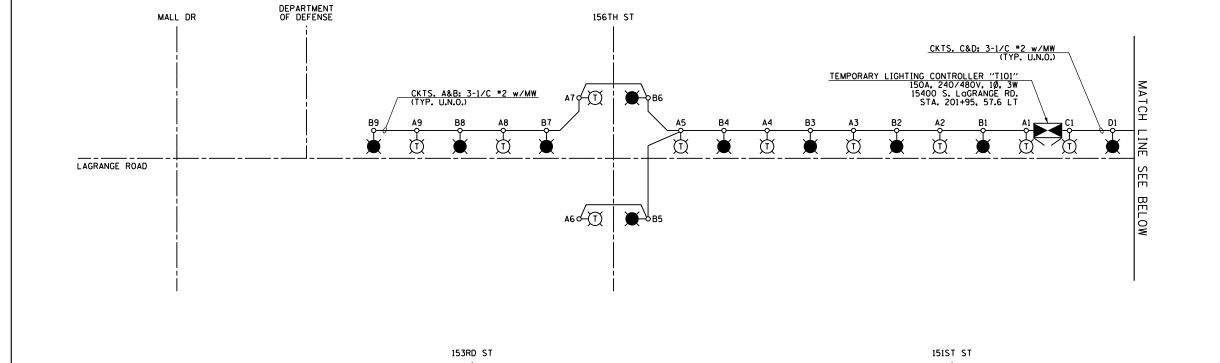

TEMPORARY LIGHTING CONTROLLER T101 WIRING DIAGRAM N.T.S.

CKTS. C&D: 3-1/C *2 w/MW (TYP. U.N.O.)

C12 9-T

LAGRANGE ROAD

ABOVE

MATCH

LEGEND:

TEMPORARY LIGHTING UNIT: 400W, 240V PHASE TO NEUTRAL, HPS LUMINAIRE WITH TYPE III DISTRIBUTION, 60'-0" CLASS 4 WOOD POLE, 47'-6" MOUNTING HEIGHT, 12'-0" MAST ARM, WITH 5A FUSES (RED PHASE-OPEN SYMBOL, BLACK PHASE-SHADED SYMBOL)



TEMPORARY ROADWAY LIGHTING CONTROLLER 150A, 240/480V, 10, 3W



TEMPORARY AERIAL CABLE AND MESSENGER WIRE AS IDENTIFIED

NOTES:

- 1. SEE DRAWING E-1 FOR ELECTRICAL ABBREVIATIONS. SEE DRAWING E-2 FOR ELECTRICAL GENERAL NOTES.
- 2. COLOR CODING OF CONDUCTORS FOR 240/480V, 10, 3W LIGHTING SYSTEM IS AS FOLLOWS:

"A" PHASE - RED
"B" PHASE - BLACK
NEUTRAL - WHITE
GROUND - GREEN



F	LIGHTING CONTROLLER "T101" ROADWAY LIGHTING PANEL LOAD TABLE										
CIRCUIT	RED F	PHASE	CIRCUIT	BLACK	PHASE						
CIRCUIT	AMPS	WATTS	CIRCUIT	AMPS	WATTS						
Α	18	4320	В	18	4320						
С	24	5760	D	24	5760						
E			F								
G			Н								
I			J								
К			L								
TOTAL	42	10080	TOTAL	42	10080						


LOAD TABULATION IS BASED ON THE FOLLOWING:


400W HPS LUMINAIRE: 2.0A AT 240V

100 S. WACKER SUITE 500 CHICAGO 1L, 60 TEL (312)-939-1 FAX (312)-939
JRS

2 DR. 1000 1000 198

i																
!	FILE NAME =	USER NAME = michal_bartusiewicz	DESIGNED - JLW	REVISED -						IIC	45 (LaGRANGE ROA	וח	F.A.P	SECTION	COUNTY	TOTAL SHEET
1	D160M61-SHT-E43.dgn		DRAWN - CJM	REVISED -	STATE OF ILLINOIS		т	EMDOD	ADV LIC		•	" WIRING DIAGRAM	330	103R-4	соок	877 454
		PLOT SCALE = 2.0000000 ' / in.	CHECKED - KMY	REVISED -	DEPARTMENT OF TRANSPORTATION			EIVIPUN	ANT LIU	GHIING	3 CONTROLLER TIO	WINING DIAGNAM		E-43	CONTRAC	T NO. 60M61
'	SHT_PLAN	PLOT DATE = 3/15/2013	DATE - 03/13/2013	REVISED -		S	SCALE:	NONE	SHEET	1	OF 1 SHEETS STA.	TO STA.		ILLINOIS FI	D. AID PROJECT	
ľ	0160M61-SHT-E43.dgn 3/15/2013 2:27:28 PM															

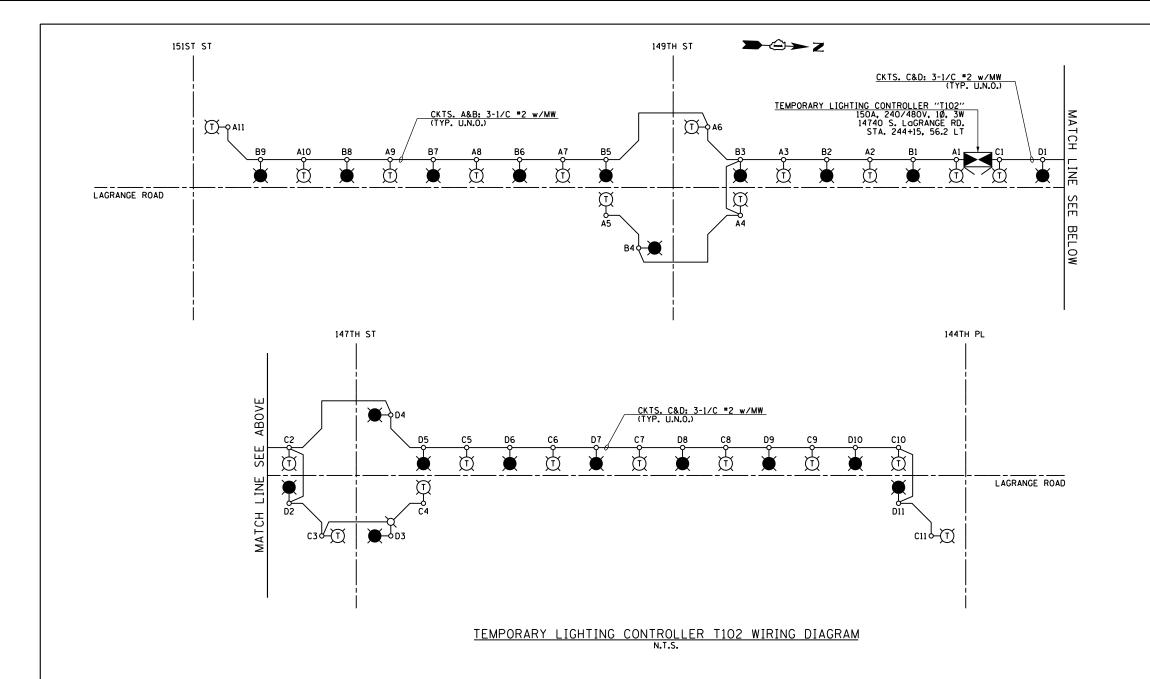

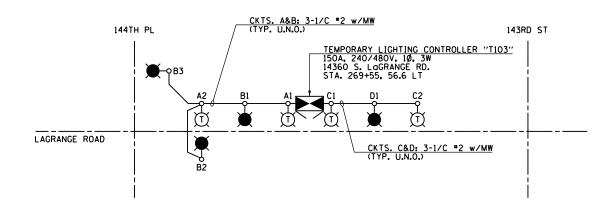

TEMPORARY LIGHTING CONTROLLER T103 WIRING DIAGRAM N.T.S.

LIGHTING CONTROLLER "T102" ROADWAY LIGHTING PANEL LOAD TABLE								
CIRCUIT	RED F	PHASE	CIRCUIT	BLACK	PHASE			
CIRCUIT	AMPS	WATTS	CIRCUIT	AMPS	WATTS			
Α	22	2 5280 B		18	4320			
С	22	5280	D	22	5280			
Ε			F					
G			н					
I			J					
K			L					
TOTAL	44	10560	TOTAL	40	9600			

LOAD TABULATION IS BASED ON THE FOLLOWING:

400W HPS LUMINAIRE: 2.0A AT 240V

LIGHTING CONTROLLER "T103" ROADWAY LIGHTING PANEL LOAD TABLE									
CIRCUIT	RED F	PHASE		BLACK	PHASE				
CIRCUIT	AMPS	WATTS	CIRCUIT	AMPS	WATTS				
Α	4	960	В	6	1440				
С	4	960	D	2	480				
Ε			F						
G			Н						
I			J						
K			L						
TOTAL	8	1920	TOTAL	8	1920				

LOAD TABULATION IS BASED ON THE FOLLOWING:

LEGEND:

NOTES:

"A" PHASE - RED
"B" PHASE - BLACK
NEUTRAL - WHITE
GROUND - GREEN

TEMPORARY LIGHTING UNIT: 400W, 240V PHASE TO NEUTRAL, HPS LUMINAIRE WITH TYPE III DISTRIBUTION, 60'-0" CLASS 4 WOOD POLE, 47'-6" MOUNTING HEIGHT, 12'-0" MAST ARM, WITH 5A FUSES (RED PHASE-OPEN SYMBOL, BLACK PHASE-SHADED SYMBOL)

TEMPORARY ROADWAY LIGHTING CONTROLLER 150A, 240/480V, 10, 3W

PROPOSED TEMPORARY WOOD POLE (NOTE 3)

TEMPORARY AERIAL CABLE AND MESSENGER WIRE AS IDENTIFIED

1. SEE DRAWING E-1 FOR ELECTRICAL ABBREVIATIONS. SEE DRAWING E-2 FOR ELECTRICAL GENERAL NOTES. 2. COLOR CODING OF CONDUCTORS FOR 240/480V, 10, 3W LIGHTING SYSTEM IS AS FOLLOWS:

3. TEMPORARY POLES SHOWN ONLY AT LOCATIONS WHERE THREE OR MORE AERIAL CABLE RUNS MEET. REFER TO DRAWINGS E-10 THROUGH E-16 FOR ALL TEMPORARY POLE LOCATIONS.

EXISTING PERMANENT LIGHTING UNIT


400W HPS LUMINAIRE: 2.0A AT 240V

FILE NAME =	USER NAME = michal_bartusiewicz	DESIGNED -	JLW	REVISED -	Τ
D160M61-SHT-E44.dgn		DRAWN -	CJM	REVISED -	
	PLOT SCALE = 2.0000000 ' / in.	CHECKED -	KMY	REVISED -	
SHT_PLAN	PLOT DATE = 3/15/2013	DATE -	03/13/2013	REVISED -	

				US 45 (L
STATE OF ILLINOIS		TEMPO	RARY	LIGHTING (
DEPARTMENT OF TRANSPORTATION				WIRIN
	CCALE	NONE	CHEET	1 05 1

	US 45 (LaGRANGE ROAD)						F.A.P SECTION COUNTY TOTAL SHEETS					SHEE'	
/IPORARY LIGHTING CONTROLLER "T102" AND "T103"				102" AND "T103"	330	103R-4		соок	877	455			
			W	RING	DIAGE	<u>RAMS</u>			E-44		CONTRACT	NO. (50M61
	SHEET		1 OF	1	SHEETS	STA.	TO STA.		ILLINOIS FE	D. AIC	PROJECT		

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LIGHTING CONTROLLER "C101" STAGE 1 WIRING DIAGRAM N.T.S.

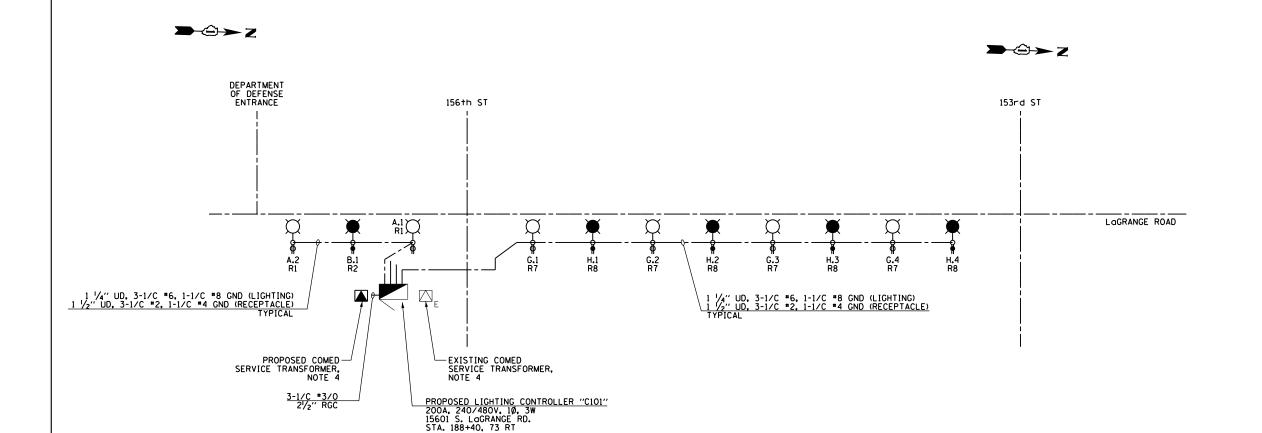F	LIGHTING CONTROLLER "C101" ROADWAY LIGHTING PANEL LOAD TABLE								
CIRCUIT	RED I	PHASE	CIRCUIT	BLACK PHASE					
CIRCUIT	AMPS	WATTS	CIRCUIT	AMPS	WATTS				
Α	4	960	В	2	480				
С			D						
E			F						
G	8	1920	Н	8	1920				
I			J						
K			L						
М			N						
0			Р						
0			R						
S			Т						
U			٧						
W	4.5	1080	х	3.8	900				
TOTAL	16.5	3960	TOTAL	13.8	3312				

LOAD TABULATION IS BASED ON THE FOLLOWING:

400W HPS LUMINAIRE: 2.0A AT 240V 250W HPS LUMINAIRE: 1.1A AT 240V

		LIGHTING CONTROLLER "C101" RECEPTACLE PANEL LOAD TABLE							
	CIRCUIT	ORANGE	ORANGE PHASE		BROWN PHASE				
	CINCUIT	AMPS	WATTS	CIRCUIT	AMPS	WATTS			
	R1	3	360	R2	1.5	180			
	R3			R4					
	R5			R6					
	R7	6	720	R8	6	720			
•	R9			R10					
•	R11			R12					
•	R13			R14					
•	R15			R16					
•	R17			R18					
	TOTAL	9	1080	TOTAL	7.5	900			

LOAD TABULATION IS BASED ON THE FOLLOWING:

180W RECEPTACLE: 1.5A AT 120V
• FOR FUTURE MEDIAN RECEPTACLE LOADS

NOTES:

1. SEE DRAWING E-1 FOR ELECTRICAL ABBREVIATIONS. SEE DRAWING E-2 FOR ELECTRICAL GENERAL NOTES.

LEGEND:

PROPOSED LIGHTING UNIT: 400W, 240V PHASE TO NEUTRAL, HPS LUMINAIRE WITH TYPE III DISTRIBUTION, 45'-2" ALUMINUM POLE SHAFT ON 24" DIAMETER CONCRETE FOUNDATION, 47'-6" MOUNTING HEIGHT, 12'-0" MAST ARM, WITH 5A FUSES AND T-BASE (RED PHASE-OPEN SYMBOL, BLACK PHASE-SHADED SYMBOL)

PROPOSED 120V, 20A, GFCI RECEPTACLE ON PROPOSED LIGHTING UNIT (ORANGE PHASE-OPEN SYMBOL, BROWN PHASE-SHADED SYMBOL)

EXISTING LIGHTING POLE RELOCATED WITH NEW 250 HPS AND GFCI RECEPTACLE, 5A FUSES (LIGHTING UNIT ON RED PHASE- OPEN SYMBOL, BLACK PHASE-SHADED SYMBOL)

PROPOSED ROADWAY LIGHTING CONTROLLER 200A, 240/480V, 10, 3W, SPECIAL SINGLE DOOR, BASE MOUNTED

EXISTING COMED PAD-MOUNTED TRANSFORMER FOR UTILITY SERVICE CONNECTION

PROPOSED COMED PAD-MOUNTED TRANSFORMER FOR UTILITY SERVICE CONNECTION

PROPOSED CONDUIT AND CABLE AS INDICATED TO SECONDARY SIDE OF UTILITY SERVICE CONNECTION

PROPOSED UNIT DUCT: SIZE AND QUANTITY OF CONDUCTORS AS INDICATED

2. COLOR CODING OF CONDUCTORS FOR 240/480V, 10. 3W LIGHTING SYSTEM IS AS FOLLOWS:

"A" PHASE - RED
"B" PHASE - BLACK
NEUTRAL - WHITE
GROUND - GREEN

3. COLOR CODING OF CONDUCTORS FOR 120/240v, 10. 3W RECEPTACLE SYSTEM IS AS FOLLOWS:

"A" PHASE - ORANGE
"B" PHASE - BROWN
NEUTRAL - GRAY
GROUND - GREEN

4. CONTRACTOR TO CONNECT PROPOSED ROADWAY LIGHTING CONTROLLER "C101" TO THE EXISTING COMED SERVICE TRANSFORMER AT DISCRETION OF COMED AND THE ENGINEER. REFER TO NOTE 2 ON DRAWING E-17 FOR FURTHER INFORMATION.


FILE NAME =	USER NAME = michal_bartusiewicz	DESIGNED -	-	JLW	REVISED -
D160M61-SHT-E45.dgn		DRAWN -	-	CJM	REVISED -
	PLOT SCALE = 2.0000000 '/ in.	CHECKED -	-	KMY	REVISED -
SHT_PLAN	PLOT DATE = 3/15/2013	DATE -	-	03/13/2013	REVISED -

STATE OF ILLINOIS DEPARTMENT OF TRANSPORTATION


US 45 (Lagrange road)	F.A.P RTE.	SECTION	COUNTY	TOTAL SHEETS	SHEET NO.
LIGHTING CONTROLLER "C101" STAGE 1 WIRING DIAGRAM	330	103R-4	COOK	877	456
Eldiffied Colorideren Civi Civide i William Dividii/iiii		E-45	CONTRACT	NO. 6	OM61
SCALE: NONE SHEET 1 OF 1 SHEETS STA. TO STA.		ILLINOIS FED. A	D PROJECT		

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LIGHTING CONTROLLER "C103" STAGE 1 WIRING DIAGRAM N.T.S.

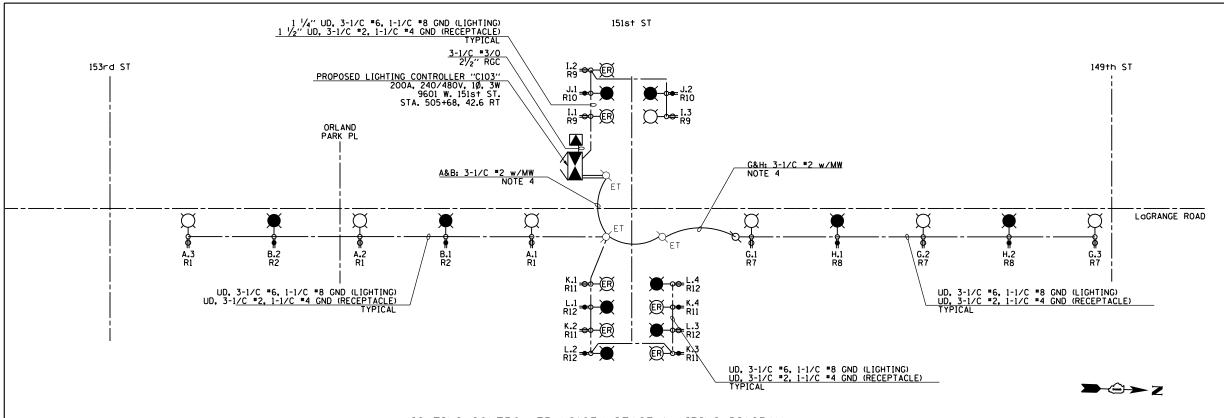

COMBINATION LIGHTING CONTROLLER "ZV" STAGE 1 WIRING DIAGRAM

NOTES:

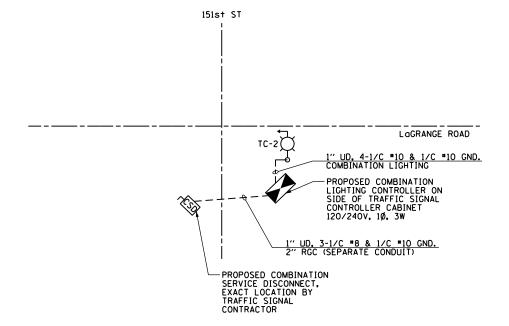ILE NAME =

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D160M61-SHT-E46.dgn 3/15/2013 2:27:29 PM

- 1. CONTRACTOR SHALL COORDINATE INSTALLATION OF ALL COMBINATION LIGHTING EQUIPMENT WITH THE TRAFFIC SIGNAL CONTRACTOR. STAGING OF THE INSTALLATION OF THE COMBINATION LIGHTING EQUIPMENT MUST FOLLOW THE STAGING OF THE PERMANENT TRAFFIC SIGNAL EQUIPMENT INSTALLATION.
- 2. NOT ALL COMBINATION LIGHTING EQUIPMENT STAGING IS SHOWN SINCE CONSTRUCTION STAGING WILL VARY BETWEEN INETRSECTIONS.
- 3. REFER TO TRAFFIC SIGNAL PLANS FOR EXACT LOCATIONS OF TRAFFIC SIGNAL CONTROLLER CABINET, COMED SERVICE TRANSFORMER FEEDING THE COMBINATION LIGHTING, AND LOCATION OF THE COMBINATION SERVICE DISCONNECT CABINET.

	LIGHTING CONTROLLER "C103" ROADWAY LIGHTING PANEL LOAD TABLE							
Ī	CIRCUIT	RED I	PHASE	CIRCUIT	BLACK	BLACK PHASE		
	CIRCUIT	AMPS	WATTS	CINCOIT	AMPS	WATTS		
	Α	6	1440	В	4	480		
	С					1224		
	Ε			F				
	G	6	1440	Н	4	480		
	I	3.3	792	J	2.2	528		
	K	4.4	1056	L	4.4	1056		
	М			N				
	0			Р		480		
	Q			R				
	S			Т				
	U			٧				
	W	15	3600	х	12	2880		
	TOTAL	47.8	11472	TOTAL	52.625	8832		

LOAD TABULATION IS BASED ON THE FOLLOWING:

400W HPS LUMINAIRE: 2.0A AT 240V 250W HPS LUMINAIRE: 1.1A AT 240V

LIGHTING CONTROLLER "C103" RECEPTACLE PANEL LOAD TABLE

	HEOLITAGEE TANKE EOAD TADEE							
	CIRCUIT	ORANGE PHASE		CIRCUIT	BROWN PHASE			
	CINCUIT	AMPS	WATTS	CIRCUIT	AMPS	WATTS		
	R1	4.5	540	R2	3	360	1	
	R3			R4			1	
	R5			R6			1	
	R7	4.5	540	R8	3	360	1	
	R9	4.5	540	R10	3	360	1	
	R11	6	720	R12	6	720		
•	R13			R14			•	
•	R15			R16			•	
•	R17			R18			•	
	TOTAL	30	3600	TOTAL	24	2880	1	

LOAD TABULATION IS BASED ON THE FOLLOWING:

180W RECEPTACLE: 1.5A AT 120V
• FOR FUTURE MEDIAN RECEPTACLE LOADS

LEGEND:

- PROPOSED LIGHTING UNIT: 400W, 240V PHASE TO NEUTRAL, HPS LUMINAIRE WITH TYPE III DISTRIBUTION, 45'-2" ALUMINUM POLE SHAFT ON 24" DIAMETER CONCRETE FOUNDATION, 47'-6" MOUNTING HEIGHT, 12'-0" MAST ARM, WITH 5A FUSES AND T-BASE (RED PHASE-OPEN SYMBOL, BLACK PHASE-SHADED SYMBOL)
- EXISTING LIGHTING UNIT WITH RECEPTACLE TO BE RELOCATED (LIGHTING UNIT ON RED PHASE-OPEN SYMBOL), BLACK PHASE-SHADED SYMBOL), (RECEPTACLE ON ORANGE PHASE-OPEN SYMBOL, BROWN PHASE-SHADED SYMBOL)
- EXISTING LIGHTING POLE RELOCATED WITH NEW 250 HPS AND RECEPTACLE, 5A FUSES (LIGHTING UNIT ON RED PHASE- OPEN SYMBOL, BLACK PHASE-SHADED SYMBOL)
- PROPOSED 120V, 20A, GFCI RECEPTACLE ON PROPOSED LIGHTING UNIT (ORANGE PHASE-OPEN SYMBOL, BROWN PHASE-SHADED SYMBOL)
- -O- PROPOSED TEMPORARY WOOD POLE
 - PROPOSED COMBINATION POLE LIGHTING UNIT: 400W, 2.0A AT 240V PHASE TO PHASE, HPS LUMINAIRE WITH TYPE III DISTRIBUTION
 - PROPOSED TEMPORARY WOOD POLE INSTALLED IN EARLIER CONSTRUCTION STAGE



PROPOSED ROADWAY LIGHTING CONTROLLER



PROPOSED COMBINATION LIGHTING CONTROLLER



PROPOSED COMED PAD-MOUNTED TRANSFORMER FOR UTILITY SERVICE CONNECTION

--- PROPOSED CONDUIT AND CABLE AS INDICATED TO SECONDARY SIDE OF UTILITY SERVICE

COMBINATION SERVICE DISCONNECT

- --- PROPOSED UNIT DUCT: SIZE AND QUANTITY OF CONDUCTORS AS INDICATED
- TEMPORARY AERIAL CABLE AND MESSENGER
 WIRE AS INDICATED

NOTES:

- SEE DRAWING E-1 FOR ELECTRICAL ABBREVIATIONS. SEE DRAWING E-2 FOR ELECTRICAL GENERAL NOTES.
- 2. COLOR CODING OF CONDUCTORS FOR 240/480V, 10. 3W LIGHTING SYSTEM IS AS FOLLOWS:
 - "A" PHASE RED
 "B" PHASE BLACK
 NEUTRAL WHITE
 GROUND GREEN
- 3. COLOR CODING OF CONDUCTORS FOR 120/240V, 10, 3W RECEPTACLE SYSTEM IS AS FOLLOWS:
- "A" PHASE ORANGE
 "B" PHASE BROWN
 NEUTRAL GRAY
- 4. AERIAL CABLES ARE ONLY PROVIDED TO COMPLETE THE ROADWAY LIGHTING CIRCUITS C103.A, C103.B, C103.G, AND C103.H. RECEPTACLE CIRCUITS C103.RI, C103.R2, C103.R3, AND C103.R4 WILL NOT BE CONNECTED AND ENERGIZED UNTIL THE PERMANENT WIRING CONNECTION IS COMPLETED AS SHOWN ON DRAWING EW3-2.




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STATE OF ILLINOIS
DEPARTMENT OF TRANSPORTATION

US 45 (LaGRANGE ROAD)
LIGHTING CONTROLLER "C103" STAGE 1 WIRING DIAGRAM

SCALE: NONE SHEET 1 OF 1 SHEETS STA. TO STA.

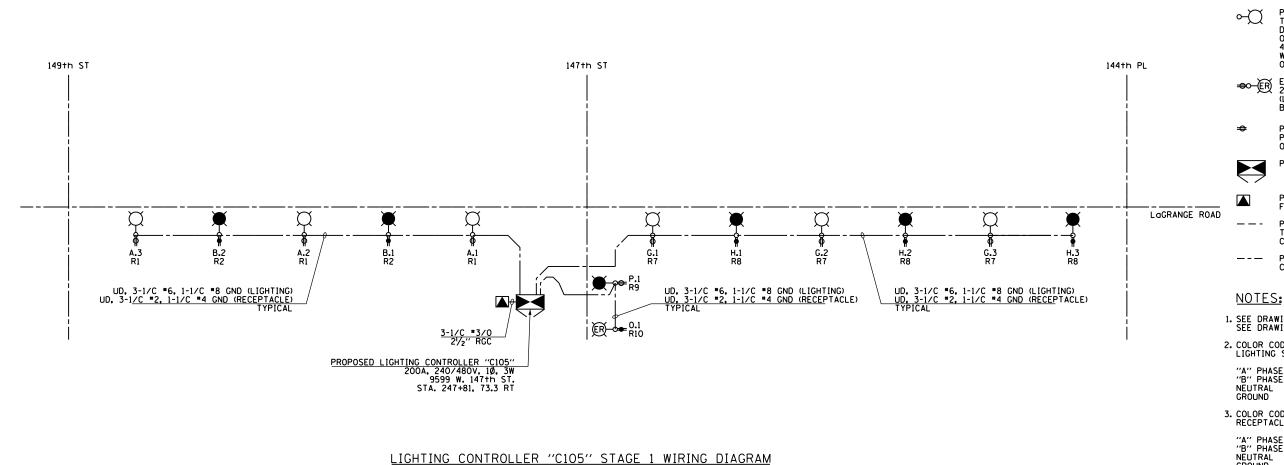

LEGEND:

PROPOSED LIGHTING UNIT: 400W, 240V PHASE TO NEUTRAL, HPS LUMINAIRE WITH TYPE III DISTRIBUTION, 45'-2" ALUMINUM POLE SHAFT ON 24" DIAMETER CONCRETE FOUNDATION, 47'-6" MOUNTING HEIGHT, 12'-0" MAST ARM, WITH 5A FUSES AND T-BASE (RED PHASE-OPEN SYMBOL, BLACK PHASE-SHADED SYMBOL)

EXISTING LIGHTING POLE RELOCATED WITH NEW 250 HPS AND RECEPTACLE, 5A FUSES (LIGHTING UNIT ON RED PHASE- OPEN SYMBOL, BLACK PHASE-SHADED SYMBOL)

PROPOSED 120V, 20A, GFCI RECEPTACLE ON PROPOSED LIGHTING UNIT (ORANGE PHASE-OPEN SYMBOL, BROWN PHASE-SHADED SYMBOL)

PROPOSED ROADWAY LIGHTING CONTROLLER

PROPOSED COMED PAD-MOUNTED TRANSFORMER FOR UTILITY SERVICE CONNECTION

PROPOSED CONDUIT AND CABLE AS INDICATED TO SECONDARY SIDE OF UTILITY SERVICE CONNECTION

PROPOSED UNIT DUCT: SIZE AND QUANTITY OF CONDUCTORS AS INDICATED

- SEE DRAWING E-1 FOR ELECTRICAL ABBREVIATIONS.
 SEE DRAWING E-2 FOR ELECTRICAL GENERAL NOTES.
- 2. COLOR CODING OF CONDUCTORS FOR 240/480V, 10. 3W LIGHTING SYSTEM IS AS FOLLOWS:

"A" PHASE - RED
"B" PHASE - BLACK
NEUTRAL - WHITE
GROUND - GREEN

3. COLOR CODING OF CONDUCTORS FOR 120/240V, 10, 3W RECEPTACLE SYSTEM IS AS FOLLOWS:

"A" PHASE - ORANGE
"B" PHASE - BROWN
NEUTRAL - GRAY
GROUND - GREEN

F			PANEL LO		E
CIRCUIT	RED F	PHASE	CIRCUIT	BLACK	PHASI
CIRCUIT	AMPS	WATTS	CIRCUIT	AMPS	WAT

-	CIRCUIT	RED PHASE		CIRCUIT	BLACK PHASE		
	CIRCUIT	AMPS	WATTS	CIRCUIT	AMPS	WATTS	
	Α	6	1440	В	4	960	
	С			D			
	Ε			F			
	G	6	1440	Н	6	1440	
	I			J			
	K			L	-		
	М			N			
	0	1.1	250	Р	1.1	250	
	0			R			
	S			T			
	U			٧			
	W	4.5	1080	х	3.8	900	
	TOTAL	17.6	4224	TOTAL	14.9	3576	

LOAD TABULATION IS BASED ON THE FOLLOWING:

400W HPS LUMINAIRE: 2.0A AT 240V 250W HPS LUMINAIRE: 1.1A AT 240V

LIGHTING CONTROLLER "C105" RECEPTACLE PANEL LOAD TABLE									
CIRCUIT	ORANGE	PHASE	CIRCUIT	BROWN	PHASE				
CIRCUIT	AMPS	WATTS	CIRCUIT	AMPS	WATTS				
R1	4.5	540	R2	3	360				
R3			R4						
R5			R6						
R7	3	360	R8	3	360				
R9	1.5	180	R10	1.5	180				
R11			R12						
R13			R14						
R15			R16						
R17			R18						
TOTAL	9	9 1080		7.5	900				

LOAD TABULATION IS BASED ON THE FOLLOWING:

180W RECEPTACLE: 1.5A AT 120V
• FOR FUTURE MEDIAN RECEPTACLE LOADS






FILE NAME =	USER NAME = michal_bartusiewicz	DESIGNED -	DAD	REVISED -
0160M61-SHT-E47.dgn		DRAWN -	DAD	REVISED -
	PLOT SCALE = 2.0000000 '/ in.	CHECKED -	DAD	REVISED -
SHT_PLAN	PLOT DATE = 3/15/2013	DATE -	03/13/2013	REVISED -

	LIGHTIN	G CONT	US 45 Roller	•			D) WIRING DIAGRAM
SCALE:	NONE	SHEET	1 OF	1	SHEETS	STA.	TO STA.

	ILLINOIS FED. AI	D PROJECT		
	E-47	CONTRACT	NO. 6	ОМ61
330	103R-4	COOK	877	458
F.A.P RTE.	SECTION	COUNTY	TOTAL SHEETS	SHEET NO.




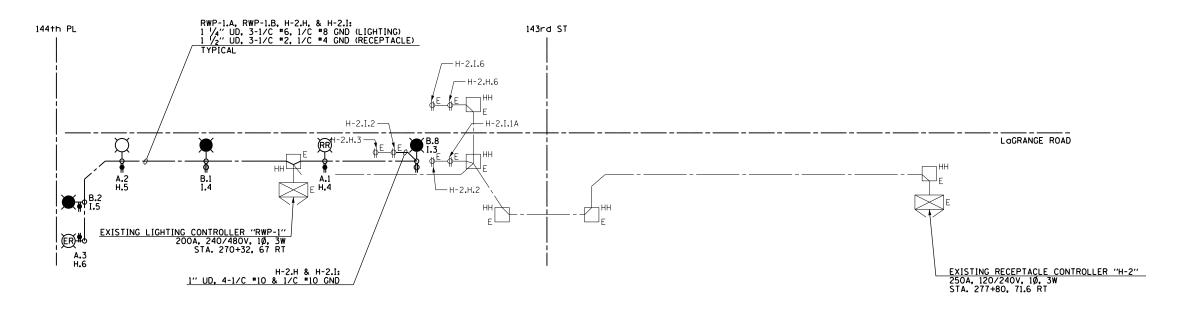


EXISTING LIGHTING CONTROLLERS "RWP-1" & "H-2" STAGE 1 WIRING MODIFICATION DIAGRAM
N.T.S. (NOTES 2, 3, 4)

LEGEND:

- PROPOSED LIGHTING UNIT: 400W, 240V PHASE
 TO NEUTRAL, HPS LUMINAIRE WITH TYPE III
 DISTRIBUTION, 45'-2" ALUMINUM POLE SHAFT
 ON 24" DIAMETER CONCRETE FOUNDATION,
 47'-6" MOUNTING HEIGHT, 12'-0" MAST ARM,
 WITH 5A FUSES AND T-BASE (RED PHASEOPEN SYMBOL, BLACK PHASE-SHADED SYMBOL)
- EXISTING LIGHTING UNIT WITH RECEPTACLE TO BE RELOCATED (LIGHTING UNIT ON RED PHASE-OPEN SYMBOL) (RECEPTACLE ON ORANGE PHASE-OPEN SYMBOL, BROWN PHASE-SHADED SYMBOL)
- EXISTING LIGHTING POLE RELOCATED WITH NEW 250 HPS AND GFCI RECEPTACLE, 5A FUSES (LIGHTING UNIT ON RED PHASE- OPEN SYMBOL, BLACK PHASE-SHADED SYMBOL)
 - PROPOSED 120V, 20A, GFCI RECEPTACLE ON PROPOSED LIGHTING UNIT (ORANGE PHASE-OPEN SYMBOL, BROWN PHASE-SHADED SYMBOL)
 - EXISTING RECEPTACLE INSTALLED BY OTHERS (ORANGE PHASE-OPEN SYMBOL, BROWN PHASE-SHADED SYMBOL)

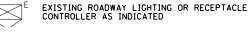

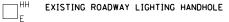

--- PROPOSED ELECTRICAL CONDUCTORS: SIZE AND OUANTITY AS INDICATED

--- ELECTRICAL CONDUCTORS: EXISTING OR INSTALLED IN EARLIER CONSTRUCTION STAGE

NOTES:

- 1. SEE DRAWING E-1 FOR ELECTRICAL ABBREVIATIONS. SEE DRAWING E-2 FOR ELECTRICAL GENERAL NOTES.
- 2. WIRING DIAGRAM ONLY SHOWS THE CHANGES BEING MADE TO THE CONTROLLERS. EXISTING LOADS ON THE CONTROLLERS ARE NOT SHOWN FOR CLARITY.
- 3. COLOR CODING OF PROPOSED CONDUCTORS FOR 240/480V, 10. 3W LIGHTING SYSTEM IS AS FOLLOWS:

"A" PHASE - RED
"B" PHASE - BLACK
NEUTRAL - WHITE
GROUND - GREEN

4. COLOR CODING OF PROPOSED CONDUCTORS FOR 120/240V, 10, 3W RECEPTACLE SYSTEM IS AS FOLLOWS:

"A" PHASE - ORANGE
"B" PHASE - BROWN
NEUTRAL - GRAY
GROUND - GREEN



STATE OF ILLINOIS
DEPARTMENT OF TRANSPORTATION


US 45 (Lagrange Road)

EXISTING LIGHTING CONTROLLERS "RWP-1" & "H-2"

STAGE 1 WIRING MODIFICATION DIAGRAM

NONE | SHEET 1 OF 1 SHEETS | STA. TO STA.



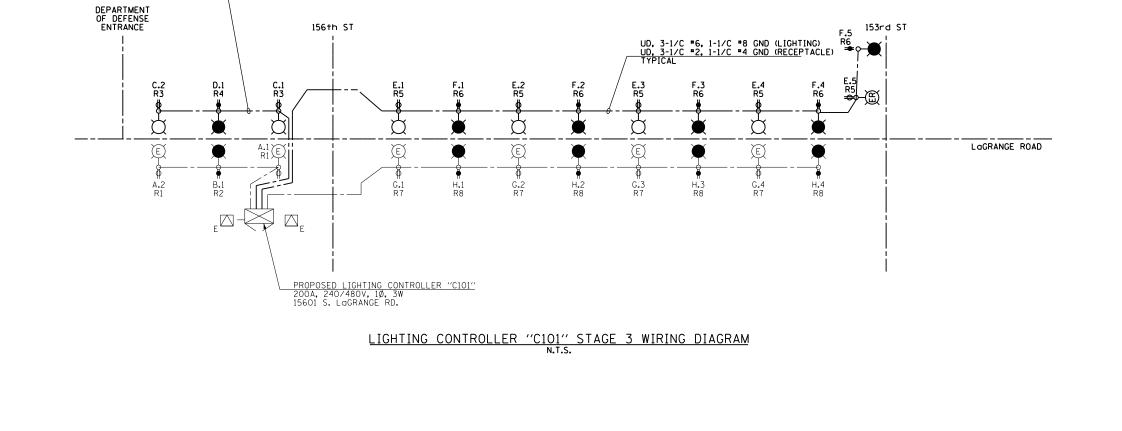

LIGHTING CONTROLLER "C101" ROADWAY LIGHTING PANEL LOAD TABLE										
CIRCUIT	RED F	PHASE	CIRCUIT	BLACK	PHASE					
CIRCUIT	AMPS	WATTS	CIRCUIT	AMPS	WATTS					
Α	4	960	В	2	480					
С	4	960	D	2	480					
E	9.1	1920	F	9.1	1920					
G	8	1920	Н	8	1920					
I			J							
К			L							
М			N							
0			Р							
Q			R							
S			Т							
U			٧							
W	9.75	2340	х	7.5	1980					
TOTAL	34.85	8364	TOTAL	28.6	6864					

LOAD TABULATION IS BASED ON THE FOLLOWING:

400W HPS LUMINAIRE: 2.0A AT 240V 250W HPS LUMINAIRE: 1.1A AT 240V

	LIGHTING CONTROLLER "C101" RECEPTACLE PANEL LOAD TABLE										
	CIRCUIT	ORANGE	PHASE	CIDCUIT	BROWN	PHASE	1				
	CIRCUIT	AMPS	WATTS	CIRCUIT	AMPS	WATTS	1				
	R1	3	360	R2	1.5	180	1				
	R3	3	360	R4	1.5	180	1				
	R5	7.5	900 R6		7.5	900	1				
	R7	6	720	R8	6	720	1				
	R9			R10			1				
	R11			R12			1				
,	R13			R14			1				
,	R15			R16			1				
,	R17			R18			1				
	TOTAL	OTAL 19.5 2340		TOTAL	16.5	1980	1				

LOAD TABULATION IS BASED ON THE FOLLOWING:

180W RECEPTACLE: 1.5A AT 120V • FOR FUTURE MEDIAN RECEPTACLE LOADS LEGEND:

-

CSD

PROPOSED LIGHTING UNIT: 400W, 240V PHASE TO NEUTRAL, HPS LUMINAIRE WITH TYPE III DISTRIBUTION, 45'-2" ALUMINUM POLE SHAFT ON 24" DIAMETER CONCRETE FOUNDATION, 47'-6" MOUNTING HEIGHT, 12'-0" MAST ARM, WITH 5A FUSES AND T-BASE (RED PHASE-OPEN SYMBOL, BLACK PHASE-SHADED SYMBOL)

EXISTING LIGHTING POLE RELOCATED WITH NEW 250 HPS AND RECEPTACLE, 5A FUSES (LIGHTING UNIT ON RED PHASE- OPEN SYMBOL, BLACK PHASE-SHADED SYMBOL)

EXISTING LIGHTING POLE RELOCATED WITH NEW 250 HPS AND RECEPTACLE, 5A FUSES (LIGHTING UNIT ON RED PHASE- OPEN SYMBOL, BLACK PHASE-SHADED SYMBOL)

PROPOSED 120V, 20A, GFCI RECEPTACLE ON PROPOSED LIGHTING UNIT (ORANGE PHASE-OPEN SYMBOL, BROWN PHASE-SHADED SYMBOL)

PROPOSED ROADWAY LIGHTING UNIT INSTALLED IN EARLIER CONSTRUCTION STAGE

PROPOSED 120V, 20A, GFCI RECEPTACLE INSTALLED IN EARLIER CONSTRUCTION STAGE

PROPOSED COMBINATION POLE LIGHTING UNIT INSTALLED IN EARLIER CONSTRUCTION STAGE

PROPOSED ROADWAY LIGHTING CONTROLLER INSTALLED IN EARLIER CONSTRUCTION STAGE

PROPOSED COMBINATION LIGHTING CONTROLLER INSTALLED IN EARLIER CONSTRUCTION STAGE

COMBINATION SERVICE DISCONNECT INSTALLED IN EARLIER CONSTRUCTION STAGE

EXISTING COMED PAD-MOUNTED TRANSFORMER FOR UTILITY SERVICE CONNECTION

---- PROPOSED CONDUIT AND CABLE TO SECONDARY SIDE OF UTILITY SERVICE CONNECTION INSTALLED IN EARLIER CONSTRUCTION STAGE

--- PROPOSED UNIT DUCT: SIZE AND QUANTITY OF CONDUCTORS AS INDICATED

--- PROPOSED UNIT DUCT INSTALLED IN EARLIER CONSTRUCTION STAGE

NOTES:

1. SEE DRAWING E-1 FOR ELECTRICAL ABBREVIATIONS. SEE DRAWING E-2 FOR ELECTRICAL GENERAL NOTES.

2. COLOR CODING OF CONDUCTORS FOR 240/480V, 10, 3W LIGHTING SYSTEM IS AS FOLLOWS:

"A" PHASE - RED
"B" PHASE - BLACK
NEUTRAL - WHITE
GROUND - GREEN

3. COLOR CODING OF CONDUCTORS FOR 120/240V, 10, 3W RECEPTACLE SYSTEM IS AS FOLLOWS:

"A" PHASE - ORANGE
"B" PHASE - BROWN
NEUTRAL - GRAY
GROUND - GREEN

REVISED FILE NAME : DESIGNED - JLW USER NAME = michal_bartusiewicz 160M61-SHT-E49.dgr DRAWN CJM REVISED PLOT SCALE = 2.0000000 '/ in. CHECKED -KMY REVISED DATE 03/13/2013 REVISED PLOT DATE = 3/15/2013 D160M61-SHT-E49.dgn 3/15/2013 2:27:31 PM

UD, 3-1/C =6, 1-1/C =8 GND (LIGHTING)
UD, 3-1/C =2, 1-1/C =4 GND (RECEPTACLE)
TYPICAL

STATE OF ILLINOIS
DEPARTMENT OF TRANSPORTATION

SCALE: NONE SHEET 1 OF 1 SHEETS STA. TO STA.



DESIGNED -REVISED JLW USER NAME = michal_bartusiewicz 160M61-SHT-E50.dgr DRAWN CJM REVISED PLOT SCALE = 2.000000 '/ in. CHECKED KMY REVISED 03/13/2013 REVISED PLOT DATE = 3/15/2013 DATE D160M61-SHT-E50.dgn 3/15/2013 2:27:31 PM

<u>UD. 4-1/C *10 & 1/C *10</u> GND. 74" UD

-PROPOSED COMBINATION LIGHTING CONTROLLER 120/240V, 1Ø, 3W

-PROPOSED COMBINATION SERVICE DISCONNECT

COMBINATION LIGHTING CONTROLLER " "

STAGE 3 WIRING DIAGRAM

LaGRANGE ROAD

UD, 3-1/C "6, 1-1/C "8 GND (LIGHTING) UD, 3-1/C "2, 1-1/C "4 GND (RECEPTACLE) TYPICAL

PROPOSED LIGHTING CONTROLLER "C103"
ORLAND 200A, 240/480V, 10, 3W

9601 W. 151st ST. STA. 505+68, 42.6 RT

→ <u>ER</u>

LIGHTING CONTROLLER "C103" STAGE 3 WIRING DIAGRAM
N.T.S.

EXISTING A & B TO

LIGHTING UNIT C103.B.1

EXISTING CIRCUITS A & B TO

CONTROLLER C103

E.1 R5

₩ PO R12

151st ST

B.5 R2 → ■

LIGHTING CONTROLLER "C103"

STAGE 4 PARTIAL WIRING DIAGRAM

EXISTING CIRCUITS 0 & P TO

CONTROLLER C103

LaGRANGE ROAD

C.1 R3

ORLAND PARK PL

UD, 3-1/C *6, 1-1/C *8 GND (LIGHTING)
UD, 3-1/C *2, 1-1/C *4 GND (RECEPTACLE)
TYPICAL

151st ST

TC-1

STATE OF ILLINOIS **DEPARTMENT OF TRANSPORTATION**

US 45 (LaGRANGE ROAD) LIGHTING CONTROLLER "C103" STAGE 3 & 4 WIRING DIAGRAMS SCALE: NONE SHEET 1 OF 1 SHEETS STA.

SECTION COUNTY 330 103R-4 COOK 877 461 E-50 CONTRACT NO. 60M61

LEGEND: PROPOSED LIGHTING UNIT: 400W, 240V PHASE TO NEUTRAL, HPS LUMINAIRE WITH TYPE III DISTRIBUTION, 45'-2" ALUMINUM POLE SHAFT ON 24" DIAMETER CONCRETE FOUNDATION, 47'-6" MOUNTING HEIGHT, 12'-0" MAST ARM, WITH 5A FUSES AND T-BASE (RED PHASE-OPEN SYMBOL, BLACK PHASE-SHADED SYMBOL) PROPOSED 120V, 20A, GFCI RECEPTACLE ON PROPOSED LIGHTING UNIT (ORANGE PHASE-OPEN SYMBOL, BROWN PHASE-SHADED SYMBOL)

PROPOSED COMBINATION POLE LIGHTING UNIT: 400W, 2.0A AT 240V PHASE TO PHASE, HPS LUMINAIRE WITH TYPE III DISTRIBUTION

PROPOSED ROADWAY LIGHTING UNIT INSTALLED IN EARLIER CONSTRUCTION STAGE

PROPOSED 120V, 20A, GFCI RECEPTACLE INSTALLED IN EARLIER CONSTRUCTION STAGE

PROPOSED COMBINATION POLE LIGHTING UNIT INSTALLED IN EARLIER CONSTRUCTION STAGE

PROPOSED ROADWAY LIGHTING CONTROLLER INSTALLED IN EARLIER CONSTRUCTION STAGE

PROPOSED COMBINATION LIGHTING CONTROLLER INSTALLED IN EARLIER CONSTRUCTION STAGE

COMBINATION SERVICE DISCONNECT INSTALLED IN EARLIER CONSTRUCTION STAGE ⊢CSD EXISTING COMED PAD-MOUNTED TRANSFORMER FOR UTILITY SERVICE CONNECTION

PROPOSED CONDUIT AND CABLE TO SECONDARY SIDE OF UTILITY SERVICE CONNECTION INSTALLED IN EARLIER CONSTRUCTION STAGE

PROPOSED UNIT DUCT: SIZE AND QUANTITY OF CONDUCTORS AS INDICATED

PROPOSED UNIT DUCT INSTALLED IN EARLIER CONSTRUCTION STAGE

NOTES:

1. SEE DRAWING E-1 FOR ELECTRICAL ABBREVIATIONS. SEE DRAWING E-2 FOR ELECTRICAL GENERAL NOTES.

2. COLOR CODING OF CONDUCTORS FOR 240/480V, 10, 3W LIGHTING SYSTEM IS AS FOLLOWS:

"A" PHASE - RED
"B" PHASE - BLACK
NEUTRAL - WHITE
GROUND - GREEN

3. COLOR CODING OF CONDUCTORS FOR 120/240V, 10, 3W RECEPTACLE SYSTEM IS AS FOLLOWS:

"A" PHASE - ORANGE
"B" PHASE - BROWN
NEUTRAL - GRAY



LIGHTING CONTROLLER "C103" ROADWAY LIGHTING PANEL LOAD TABLE RED PHASE BLACK PHASE CIRCUIT CIRCUIT WATTS AMPS WATTS 1440 В 480 С 1440 D 5.1 1224 7.1 1704 5.1 1224 G 1440 480 Н 3.3 792 2.2 528 1056 4.4 1056 4.4 М 480 ۵

TOTAL

12

52.625

2880

8832

F.3 R6 E.3 R5

149th ST

LaGRANGE ROAD

11472 LOAD TABULATION IS BASED ON THE FOLLOWING:

3600

400W HPS LUMINAIRE: 2.0A AT 240V 250W HPS LUMINAIRE: 1.1A AT 240V

15

47.8

TOTAL

UD, 3-1/C *6, 1-1/C *8 GND (LIGHTING)
UD, 3-1/C *2, 1-1/C *4 GND (RECEPTACLE)
TYPICAL


UD, 3-1/C *6, 1-1/C *8 GND (LIGHTING)
UD, 3-1/C *2, 1-1/C *4 GND (RECEPTACLE)
TYPICAL

	LIGHTING CONTROLLER "C103" RECEPTACLE PANEL LOAD TABLE								
	CIRCUIT	ORANGE	PHASE	CIRCUIT	BROWN	PHASE			
	CIRCUIT	AMPS	WATTS	CIRCUIT	AMPS	WATTS			
	R1	4.5	540	R2	3	360			
	R3	4.5	540	R4	4.5	540			
	R5	6	720	R6	4.5	540			
	R7	4.5	540	R8	3	360			
	R9	4.5	540	R10	3	360			
	R11	6	720	R12	6	720			
	R13			R14					
	R15			R16					
٠	R17			R18					
	TOTAL	30	3600	TOTAL	24	2880			

LOAD TABULATION IS BASED ON THE FOLLOWING:

180W RECEPTACLE: 1.5A AT 120V
• FOR FUTURE MEDIAN RECEPTACLE LOADS



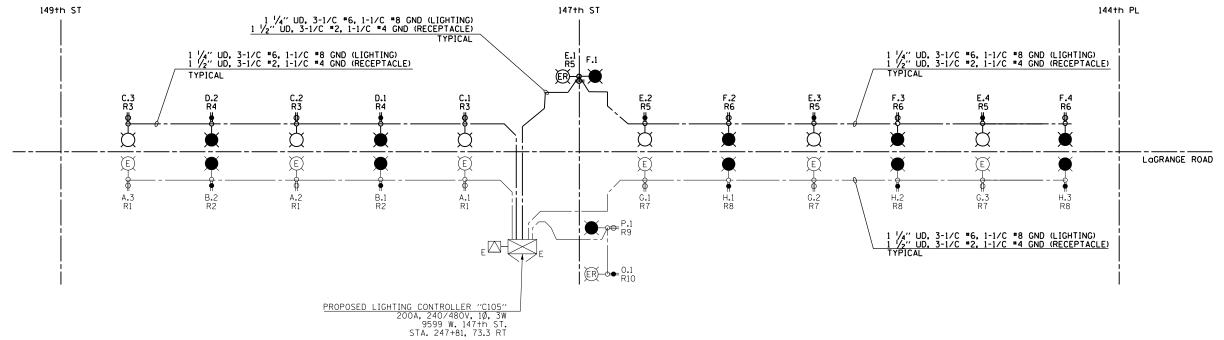

LIGHTING CONTROLLER "C105" STAGE 3 WIRING DIAGRAM
N.T.S.

LIGHTING CONTROLLER "C105" ROADWAY LIGHTING PANEL LOAD TABLE								
CIRCUIT	RED F	PHASE	CIRCUIT	BLACK	PHASE			
CIRCUIT	AMPS	WATTS	CIRCUIT	AMPS	WATTS			
Α	6	1440	В	4	960			
С	6	1440	D	4	960			
Ε	8.2	1968	F	8.2	1968			
G	6	1440	Н	6	1440			
I			J					
K			L					
М			N					
0	1.1	250	Р	1.1	250			
0			R					
S			T					
U			٧					
w	10.5	2520	х	9	2160			
TOTAL	37.8	9072	TOTAL	32.3	7752			

LOAD TABULATION IS BASED ON THE FOLLOWING:

400W HPS LUMINAIRE: 2.0A AT 240V 250W HPS LUMINAIRE: 1.1A AT 240V

LEGEND:

-

PROPOSED LIGHTING UNIT: 400W, 240V PHASE TO NEUTRAL, HPS LUMINAIRE WITH TYPE III DISTRIBUTION, 45'-2" ALUMINUM POLE SHAFT ON 24" DIAMETER CONCRETE FOUNDATION, 47'-6" MOUNTING HEIGHT, 12'-0" MAST ARM, WITH 5A FUSES AND T-BASE (RED PHASE-OPEN SYMBOL, BLACK PHASE-SHADED SYMBOL)

PROPOSED 120V, 20A, GFCI RECEPTACLE ON PROPOSED LIGHTING UNIT (ORANGE PHASE-OPEN SYMBOL, BROWN PHASE-SHADED SYMBOL)

PROPOSED ROADWAY LIGHTING UNIT INSTALLED IN EARLIER CONSTRUCTION STAGE

PROPOSED 120V, 20A, GFCI RECEPTACLE INSTALLED IN EARLIER CONSTRUCTION STAGE

PROPOSED ROADWAY LIGHTING CONTROLLER INSTALLED IN EARLIER CONSTRUCTION STAGE

PROPOSED COMED PAD-MOUNTED TRANSFORMER FOR UTILITY SERVICE CONNECTION INSTALLED IN EARLIER CONSTRUCTION STAGE

 PROPOSED CONDUIT AND CABLE TO SECONDARY SIDE OF UTILITY SERVICE CONNECTION INSTALLED IN EARLIER CONSTRUCTION STAGE

--- PROPOSED UNIT DUCT: SIZE AND QUANTITY OF CONDUCTORS AS INDICATED

— PROPOSED UNIT DUCT INSTALLED IN EARLIER CONSTRUCTION STAGE

NOTES:

1. SEE DRAWING E-1 FOR ELECTRICAL ABBREVIATIONS. SEE DRAWING E-2 FOR ELECTRICAL GENERAL NOTES.

2. COLOR CODING OF CONDUCTORS FOR 240/480V, 10. 3W LIGHTING SYSTEM IS AS FOLLOWS:

"A" PHASE - RED
"B" PHASE - BLACK
NEUTRAL - WHITE
GROUND - GREEN

3. COLOR CODING OF CONDUCTORS FOR 120/240V, 10. 3W RECEPTACLE SYSTEM IS AS FOLLOWS:

"A" PHASE - ORANGE
"B" PHASE - BROWN
NEUTRAL - GRAY
GROUND - GREEN

LIGHTING CONTROLLER "C105" RECEPTACLE PANEL LOAD TABLE										
CIRCUIT	ORANGE	PHASE	CIRCUIT	BROWN	PHASE]				
CIRCUIT	AMPS	WATTS	CIRCUIT	AMPS	WATTS	1				
R1	4.5	540	R2	3	360]				
R3	4.5	540	R4	3	360	1				
R5	7.5	900	R6	7.5	900	1				
R7	3 360		R8	3	360	1				
R9	1.5	180	R10	1.5	180	1				
R11			R12			١.				
R13			R14			١.				
R15			R16			۱.				
R17			R18			1.				

TOTAL

18

2160

LOAD TABULATION IS BASED ON THE FOLLOWING:

2520

180W RECEPTACLE: 1.5A AT 120V
• FOR FUTURE MEDIAN RECEPTACLE LOADS

21

TOTAL

100 S. WACKER DR. SUITE 500	CHICAGO 11, 60606 TEL (312)-939-1000 FAX (312)-939-4198
7	A


ILE NAME =	USER NAME = michal_bartusiewicz	DESIGNED - JLW	REVISED -	
160M61-SHT-E51.dgn		DRAWN - CJM	REVISED -	
	PLOT SCALE = 2.0000000 '/ in.	CHECKED - KMY	REVISED -	
HT_PLAN	PLOT DATE = 3/15/2013	DATE - 03/13/201	REVISED -	

STATE OF ILLINOIS
DEPARTMENT OF TRANSPORTATION

		US	\$ 4	5 (La	GRANGE	ROA	.D)
LIG	HTING	CONTROLLER	₹ ″	C105"	STAGE	3 &	4 WIRING DIAGRAMS
SCALE:	NONE	SHEET	1 OF	F 1	SHEETS	STA.	TO STA.

F.A.P RTE.	SECTION	COUNTY	TOTAL SHEETS	SHEET NO.
330	103R-4	COOK	877	462
	E-51	CONTRACT	NO. 6	ОМ61
	ILLINOIS FED. A	ID PROJECT		



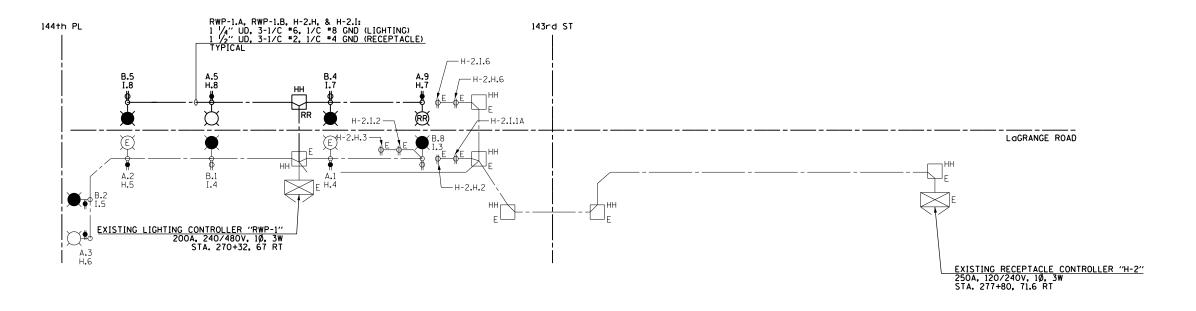

EXISTING LIGHTING CONTROLLERS "RWP-1" & "H-2" STAGE 3 WIRING MODIFICATION DIAGRAM
N.T.S. (NOTES 2, 3, 4)

LEGEND:

PROPOSED LIGHTING UNIT: 400W, 240V PHASE TO NEUTRAL, HPS LUMINAIRE WITH TYPE III DISTRIBUTION, 45'-2" ALUMINUM POLE SHAFT ON 24" DIAMETER CONCRETE FOUNDATION, 47'-6" MOUNTING HEIGHT, 12'-0" MAST ARM, WITH 5A FUSES AND T-BASE (RED PHASE-OPEN SYMBOL, BLACK PHASE-SHADED SYMBOL)

EXISTING LIGHTING UNIT WITH RECEPTACLE TO BE RELOCATED (LIGHTING UNIT ON RED PHASE-OPEN SYMBOL) (RECEPTACLE ON ORANGE PHASE-OPEN SYMBOL, BROWN PHASE-SHADED SYMBOL)

EXISTING LIGHTING UNIT OR LIGHTING UNIT INSTALLED IN EARLIER CONSTRUCTION STAGE (RED PHASE-OPEN SYMBOL, BLACK PHASE-SHADED SYMBOL)

PROPOSED 120V, 20A, GFCI RECEPTACLE ON PROPOSED LIGHTING UNIT (ORANGE PHASE-OPEN SYMBOL, BROWN PHASE-SHADED SYMBOL)

⇒E EXISTING RECEPTACLE INSTALLED BY OTHERS (ORANGE PHASE-OPEN SYMBOL, BROWN PHASE-SHADED SYMBOL)

E EXISTING ROADWAY LIGHTING OR RECEPTACLE CONTROLLER AS INDICATED

HH EXISTING ROADWAY LIGHTING HANDHOLE TO BE RELOCATED

HH EXISTING ROADWAY LIGHTING HANDHOLE

--- PROPOSED ELECTRICAL CONDUCTORS: SIZE AND QUANTITY AS INDICATED

--- ELECTRICAL CONDUCTORS: EXISTING OR INSTALLED IN EARLIER CONSTRUCTION STAGE

NOTES:

1. SEE DRAWING E-1 FOR ELECTRICAL ABBREVIATIONS. SEE DRAWING E-2 FOR ELECTRICAL GENERAL NOTES.

2. WIRING DIAGRAM ONLY SHOWS THE CHANGES BEING MADE TO THE CONTROLLERS. EXISTING LOADS ON THE CONTROLLERS ARE NOT SHOWN FOR CLARITY.

3. COLOR CODING OF PROPOSED CONDUCTORS FOR 240/480V, 10, 3W LIGHTING SYSTEM IS AS FOLLOWS:


"A" PHASE - RED
"B" PHASE - BLACK
NEUTRAL - WHITE
GROUND - GREEN

4. COLOR CODING OF PROPOSED CONDUCTORS FOR 120/240V. 10. 3W RECEPTACLE SYSTEM IS AS FOLLOWS:


"A" PHASE - ORANGE
"B" PHASE - BROWN
NEUTRAL - GRAY
GROUND - GREEN

| 100 S. WACKER DR. SUITE 500 CHICAGO IL, 60606 TEL (312)-939-1000 FAX (312)-939-4198


DESIGNED - DAD REVISED US 45 (LaGRANGE ROAD) FILE NAME = USER NAME = michal_bartusiewicz SECTION COUNTY STATE OF ILLINOIS 160M61-SHT-E52.dgr DRAWN DAD REVISED EXISTING LIGHTING CONTROLLERS "RWP-1" & "H-2" 330 103R-4 COOK 877 463 STAGE 3 WIRING MODIFICATION DIAGRAM CHECKED -DAD REVISED **DEPARTMENT OF TRANSPORTATION** E-52 CONTRACT NO. 60M61 SCALE: NONE SHEET - 03/13/2013 PLOT DATE = 3/15/2013 DATE REVISED 1 OF 1 SHEETS STA. D160M61-SHT-E52.dgn 3/15/2013 2:27:32 PM

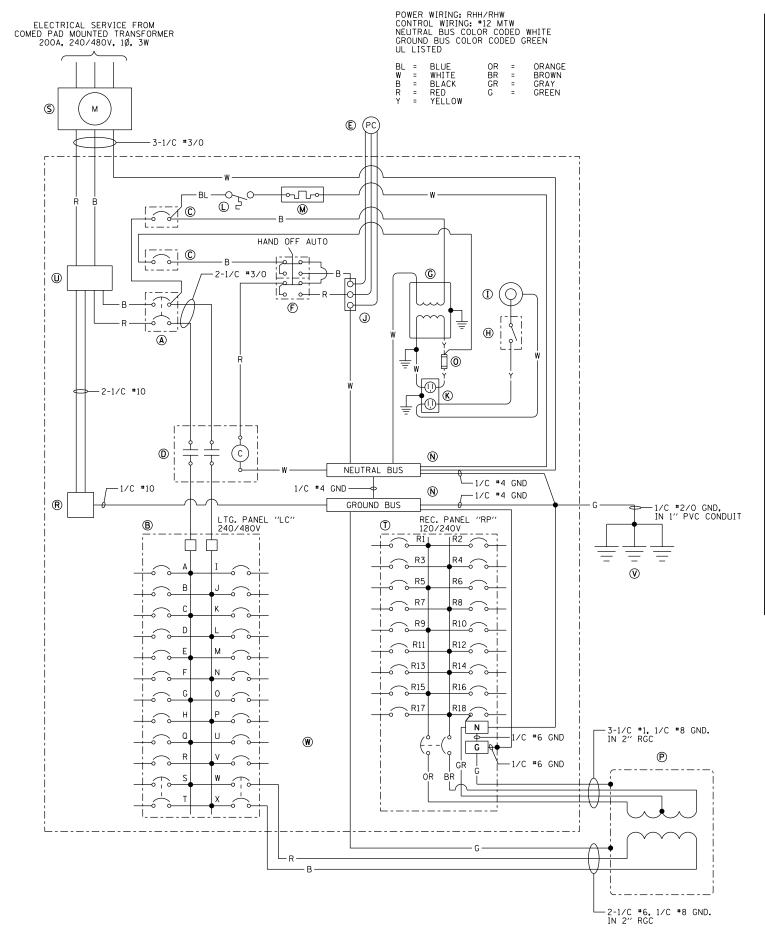

TEM	QTY.	DESCRIPTION				
A	1	MAIN CIRCUIT BREAKER, MOLDED CASE, THERMAL MAGNETIC, 200 AMP, 480V, 2-POLE, NON-INTERCHANGEABLE TRIP, INTERRUPTING RATING 65,000 AMPERES AT 480 VOLTS				
₿	1	EATON, POW-R-LINE C PANELBOARD, 480/240 VOLT, 1-PHASE, 3-WIRE, 30 BRANCH CIRCUITS, 225 AMPERE MAIN LUGS, WITH (20) 1-POLE 30 AMPERE, 240 VOLT, BOLT-ON BRANCH CIRCUIT BREAKERS, INTERRUPTING RATING 65,000 AMPERES AT 277 VOLTS (4 SPARE) AND (2) 2-POLE 50 AMPERE, 480 VOLT, BOLT-ON BRANCH CIRCUIT BREAKERS, INTERRUPTING RATING 65,000 AMPERES AT 480 VOLTS (1 SPARE)				
©	2	EATON, HFD1015, 1-POLE, 15 AMPERE, 240 VOLT CIRCUIT BREAKER, INTERRUPTING RATING 65,000 AMPERES AT 277 VOLTS				
0	1	EATON, A202K4BA, 2-POLE, 200 AMPERE CONTACTOR, 240 VOLT COIL				
(E)	1	PHOTOCELL (MOUNTED ON THE FRONT OF THE CABINET UNDER THE DRIP EDGE AND TO THE SIDE OF THE ACCESS DOOR)				
(Ē)	1	SOUARE D. 9001KYK111, HAND-OFF-AUTO SELECTOR SWITCH				
©	1	JEFFERSON, 21-0071-055, 1 KILOVOLT-AMPERE TRANSFORMER				
H	1	OMRON, A20G07BK, DOOR SWITCH				
(I)	1	GENERAL ELECTRIC, H7-12OV-15F-3W-DD, 60 WATT ENCLOSED AND GASKETED INCANDESCENT FIXTURE				
(J)	1	3 POINT TERMINAL BLOCK				
<u>(K)</u>	1	HUBBELL, HBL5362ISA, 20 AMPERE GROUND FAULT CIRCUIT INTERRUPTOR RECEPTACLE, WITH WEATHERPROOF BOX & COVER				
©_	1	WHITE-RODGERS, #2E552, 0-50 DEGREE THERMOSTAT				
M	1	VULCAN *0S1408-250B 250 WATT STAINLESS STEEL HEATER				
N _	2	COPPER GROUND AND NEUTRAL BUS, MINIMUM 1/4"×1"×12"				
0	1	BUSSMANN, KTK15, FUSE				
P	1	OLSUN ELECTRIC CORPORATION, *GSISLE-6, 25 KILOVOLT- AMPERE, 1-PHASE, 480-120/240 VOLT TRANSFORMER IN NEMA 3R ENCLOSURE				
®	1	BRACKET MOUNTED SURGE ARRESTER FOR 480/240 VOLT, 3 WIRE SERVICE				
<u>S</u>	1	METER SOCKET/PEDESTAL FOR ELECTRIC UTILITY CO. METER				
①	1	EATON, POW-R-LINE C PANELBOARD, 240/120 VOLT, 1-PHASE, 3-WIRE, 18 BRANCH CIRCUITS, 100 AMPERE, 2-POLE, 240 VOLT MAIN BREAKER, INTERRUPTING RATING 14,000 AMPERES AT 277 VOLTS, WITH (18) 1-POLE 30 AMPERE, 120 VOLT, BOLT-ON GROUND FAULT CIRCUIT INTERRUPTING BRANCH CIRCUIT BREAKERS, CATALOG NUMBER GHBGFEP1030, INTERRUPTING RATING 14,000 AMPERES AT 120 VOLTS (2 SPARE)				
(1	MARATHON, *1402401, 175A, 2-POLE, 600 VOLT POWER DISTRIBUTION BLOCK				
(V)	3	COPPER GROUND ROD, 5/8"×10"				
W	18	POWER DIST SPLICE BLOCKS *2 AWG TO *14 AWG SINGLE POLE. (NOT SHOWN ON BACKPLATE)				

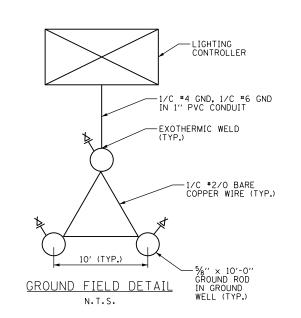

- 1. SEE DRAWING E-1 FOR ELECTRICAL SYMBOL LIST AND ABBREVIATIONS. SEE DRAWING E-2 FOR ELECTRICAL GENERAL NOTES.
- 2. SEE DRAWING E-20 FOR CONTROLLER CABINET DETAILS.
- 3. THE CONTROLLER SHALL BE SUITABLE FOR USE AS SERVICE EQUIPMENT PER NEC 230.66 AND U.L. LISTED.
- 4. BOND PANELBOARD ENCLOSURES "LC" AND "RP" TO THE CONTROLLER ENCLOSURE WITH "6 GND.
- 5. IF THERE IS NOT ENOUGH RIGHT OF WAY TO INSTALL THE GROUNDING TRIAD AS SHOWN, REDUCE SPACING TO 6'.
- 6. ALL EQUIPMENT, MATERIALS AND COMPONENTS MUST BE SPECIFICATION GRADE OR BETTER. COMPLETE CABINET CONSTRUCTION SHALL FOLLOW ALL APPLICABLE IDOT SPECIFICATIONS, STANDARDS, AND DETAILS.
- 7. MANUFACTURER MODEL AND PART NUMBERS SHOWN ARE MINIMUM ACCEPTABLE COMPONENTS AND CAN BE SUBSTITUTED WITH EQUAL OR BETTER MATERIALS FROM OTHER MANUFACTURERS WITH THE WRITTEN APPROVAL FROM THE ENGINEER OF RECORD.

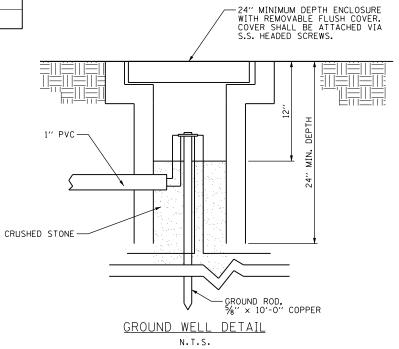

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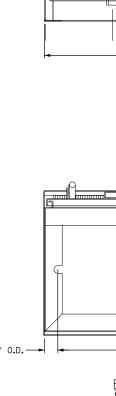
STATE OF ILLINOIS
DEPARTMENT OF TRANSPORTATION


US 45 (Lagrange Road)

Lighting Controller Wiring Diagram & Grounding Details


Scale: None | Sheet | 1 Of | 1 Sheets | Sta. | To Sta.

F.A.P RTE.	SECTION		COUNTY	TOTAL SHEETS	SHEET NO.
330	103R-4		COOK	877	464
	E-53	CONTRACT	NO. 6	ОМ61	
	ILLINOIS	D PROJECT			




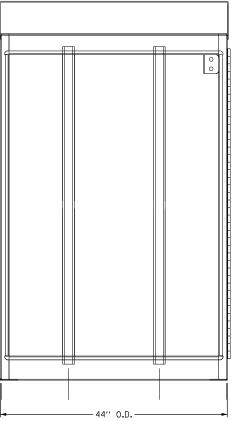


FRONT VIEW DOOR REMOVED

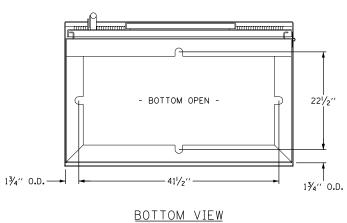

ALUMINUM TYPE IV CONTROL CABINET 3R 59"×44"×26" SCALE: NOT TO SCALE

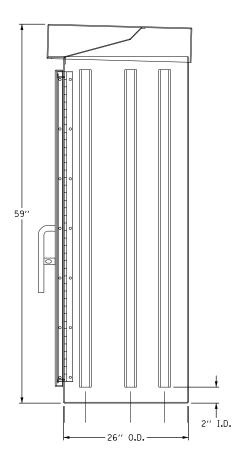

RIGHT SIDE VIEW

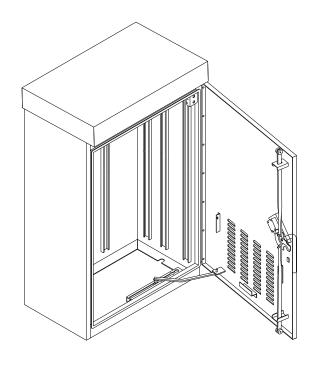

SPECIFICATIONS:

PERFORMANCE - THE ENCLOSURE WILL MEET OR EXCEED THE REQUIREMENTS OF A NEMA 3R RATING AND SHALL BE U.L. LISTED PER U.L. 508.

MATERIAL - SHEET ALUMINUM 1/8" THICKNESS, ALLOY 5052 H32. SURFACE SHALL HAVE A SMOOTH, NATURAL ALUMINUM MILL FINISH. ALL WELDS TO BE HELIARC AND SHALL BE NEATLY FORMED AND FREE OF CRACKS, BLOW HOLES, AND OTHER DEFECTS. ALL EDGES TO BE FREE OF BURRS.

CABINET FEATURES - CABINET TOP SLOPED 1/2" TO THE REAR, WITH 1/8" X 1" VENT SLOTS UNDER FRONT OVERHANG.

DOORS AND LOCKS - THE MAIN DOOR IS OF NEMA TYPE 3R CONSTRUCTION WITH CELLULAR NEOPRENE GASKET, WHICH IS RAIN TIGHT. HINGE IS 2" OPEN AND IS CONTINUOUS 14 GAUGE STAINLESS STEEL WITH A 1/4 " DIA, PIN AND IS CAPPED AT THE TOP TO RENDER IT TAMPER PROOF. THE HINGE IS SECURED WITH 1/4-20 STAINLESS STEEL CARRIAGE BOLTS AND ESNA LOCK NUTS. STANDARD EQUIPMENT INCLUDES A THREE POINT LOCKING SYSTEM, WHICH SECURES THE DOOR AT THE TOP, BOTTOM, AND CENTER. A CORBIN LOCK WITH TWO KEYS IS ALSO FURNISHED. THE MAIN DOOR IS ALSO EQUIPPED WITH A THREE POSITION DOOR STOP, ONE AT 90°, ONE AT 120°, AND ONE AT 180°, DOOR LOCKING RODS ARE 1/4" X 3/4" A LUMINUM TURNED EDGEWAYS WITH I" NYLON ROLLERS. MAIN DOOR HANDLE IS 3/4" DIAMETER STAINLESS STEEL. THE CABINET DOOR SHALL BE HINGED ON THE RIGHT SIDE WHEN FACING THE FRONT OF THE CABINET.

EQUIPMENT MOUNTING - THE CABINET SHALL BE EQUIPPED WITH TWO ADJUSTABLE "L" MOUNTING CHANNELS WELDED TO EACH SIDE WALL AND THE BACK WALL ALLOWING FULL ADJUSTMENT OF SHELVES OR PANELS.

VENTILATION - VENT SLOTS (1/8" X 1") ARE PROVIDED ON THE UNDERSIDE OF THE COVER OVERHANG AND LOUVER SLOTS ARE FORMED IN THE LOWER PORTION OF THE MAIN DOOR. THIS CREATES A NATURAL MOVEMENT OF AIR AND HAS A COOLING EFFECT ON THE ELECTRICAL EQUIPMENT.

CABINET TYPE FOR PERMANENT CONTROLLERS "C101", "C103", AND "C105" ARE BASE MOUNTED AND EQUIPPED WITH INSIDE FLANGES AT THE FRONT, BACK, AND SIDES FOR ANCHORING TO A BASE (SEE INSTALLATION DETAILS ON DRAWING E-55).

CABINET TYPE FOR TEMPORARY CONTROLLERS "T101", "T102", AND "T103" ARE POLE MOUNTED (SEE INSTALLATION DETAILS ON DRAWING E-56).

THIS SPECIFICATION IS PER IDOT STANDARD SPECIFICATIONS.

INDICATED DIMENSIONS REPRESENT THE MINIMUM REQUIREMENTS. DIMENSIONS SHALL BE INCREASED AS REQUIRED TO COMPLY WITH THE CODE AND TO ADEQUATELY HOUSE ALL REQUIRED COMPONENTS WITH AMPLE ROOM FOR ARRANGEMENT AND TERMINATION OF WIRING.

THE SERVICE EQUIPMENT SHALL BE MARKED TO IDENTIFY AS BEING SUITABLE AS SERVICE EQUIPMENT IN ACCORDANCE WITH NEC ARTICLE 230.66.

FILE NAME =

DESIGNED - DAD REVISED USER NAME = michal_bartusiewicz 160M61-SHT-E54.dgr DRAWN -DAD REVISED CHECKED -DAD REVISED 03/13/2013 PLOT DATE = 3/15/2013 DATE REVISED D160M61-SHT-E54.dgn 3/15/2013 2:27:33 PM

STATE OF ILLINOIS **DEPARTMENT OF TRANSPORTATION**

	JS 45 (LaGRANG	E ROAD)		F.A.P RTE.	SECTION	COUNTY	TOTAL	SHEET NO.
LIGHTING CONTROLLER DETAILS				330	103R-4	COOK	877	465
LIGHTING CONTROLLER DETAILS					E-54	CONTRACT	NO. (50M61
SCALE: NONE SHEET	1 OF 1 SHEETS	STA.	TO STA.		TILINOIS FED A	D PROJECT		

-(2) 2" RGC. SEE DRAWING ED-4 FOR NUMBER AND SIZE OF WIRES CONTROLLER CABINET NOTE 4 -25KVA, 480-120/240V TRANSFORMER IN NEMA 3R ENCLOSURE NOTE 19 SOCKET 3" (TYP.) 3" (TYP.) --3" (TYP.) BEVELLED EDGES EXPANSION JOINT BOLT TRANSFORMER BASE TO CONCRETE FOUNDATION (TYP.) 4' WIDE X 4" THICK CONCRETE SLAB GRADE -NOTE 18 GRADE -30" MIN. (TYP.) 30" MIN. (TYP.) -1" PVC TO GROUND FIELD OF (3) GROUND RODS IN A 10 FT. TRIANGLE. SEE DRAWING ED-4 FOR WIRE SIZES. VERIFY EXACT LOCATION OF GROUND FIELD WITH THE ENGINEER. NO GROUND WELL SHALL BE PLACED IN CONCRETE PAD IN FRONT OF CONTROLLER. 4" DIA. × 36"-PVC ELBOW (TYP.) PROVIDE BUSHING AND DUCT SEAL (TYP.) CONDUIT TO COMED TRANSFORMER -CONCRETE FOUNDATION NOTE 17 4" PVC RACEWAYS, (10) MINIMUM PLUS 2 SPARES. COORDINATE WITH CIRCUIT REQUIREMENTS TYPICAL-ACTUAL DIRECTION AS REQUIRED PER PLANS LEFT SIDE ELEVATION FRONT ELEVATION

LIGHTING CONTROLLER FOUNDATION DETAILS

REVISED

NOTES:

- 1. COORDINATE PLACEMENT OF RACEWAYS WITH CONTROLLER MANUFACTURER TO ASSURE DOOR LATCH DOES NOT INTEFERE WITH CABLES OR OTHER DEVICES.
- 2. THE CONTRACTOR SHALL PROVIDE A GROUND FIELD AT EACH CABINET LOCATION. THE GROUND RODS, ANCHOR BOLTS AND REINFORCEMENT STEEL SHALL ALL BE INTERCONNECTED.
- 3. THE CONTRACTOR SHALL VERIFY EXACT LOCATION OF CONTROLLER FOUNDATION AND GROUND FIELD WITH THE ENGINEER.
- 4. SEE DRAWING E-54 FOR CONTROL CABINET DETAILS.
- 5. ALL SCREWS AND HARDWARE SHALL BE PLATED, GALVANIZED, OR MADE OF BRASS, ALUMINUM OR STAINLESS STEEL.
- 6. NAME PLATE SHALL HAVE ENGRAVED 0.75 INCH HIGH LETTERS FILLED IN BLACK: "ROADWAY LIGHTING CONTROLLER, VILLAGE OF ORLAND PARK".
- 7. ONE INCH THICK POLYISOCYANURATE INSULATION SHALL BE INSTALLED AND PERMANENTLY CEMENTED ON ALL SIDES OF THE CABINET AND DOORS.
- 8. ALL DEVICES SHALL BE FRONT REMOVABLE.
- 9. ALL LUGS SHALL BE OF COPPER SCREWS AND CONNECTORS, SPRING HELD.
- 10. ALL CONTROL WIRING SHALL BE 600V MACHINE TOOL WIRE TYPE MTW.
- 11. ALL POWER WIRING SHALL BE 600V TYPE RHH/RHW.
- 12. CIRCUIT BREAKERS, CONTACTORS AND OTHER COMPONENTS SHALL BE PANEL MOUNTED ON 0.125 INCH THICK GLASTIC INSULATION BACK PANEL.
- 13. THE COMPLETED CONTROLLER SHALL BE U.L. LISTED AS AN INDUSTRIAL CONTROL PANEL UNDER UL508.
- 14. ALL 120 VOLT SYSTEM AND ALL CONTROL WIRING SHALL BE *12AWG STRANDED UNLESS OTHERWISE INDICATED.
- 15. ALL WIRING SHALL BE NEATLY DRESSED AND SUPPORTED.
- 16. FOR LIGHTING CONTROLLER WIRING DIAGRAM, SEE DRAWING E-53.
- 17. CONCRETE FOUNDATION SHALL BE CONSTRUCTED AS REQUIRED TO SUPPORT CONTROL CABINET AND TRANSFORMER. CONTRACTOR TO INSURE THE CONTROLLER CABINET AND METER SOCKET ARE LOCATED ON THE FOUNDATION END CLOSEST TO THE UTILITY SERVICE, WITH THE METER SOCKET FACING THE DIRECTION OF THE UTILITY SERVICE. CONCRETE FOUNDATION SHALL BE INCLUDED IN THE COST OF "LIGHTING CONTROLLER, SPECIAL" PAY ITEM.
- 18. LENGTH OF CONCRETE SLAB SHOULD MATCH LENGTH OF CONCRETE FOUNDATION.
- 19. THE COST OF THE TRANSFORMER AND THE RELATED WORK SHALL BE INCLUDED IN THE COST OF "LIGHTING CONTROLLER, SPECIAL" ITEM.

TOTAL SHEE SHEETS NO. SECTION COUNTY US 45 (LaGRANGE ROAD) 330 103R-4 COOK 877 466 LIGHTING CONTROLLER FOUNDATION DETAILS CONTRACT NO. 60M61 E-55 1 OF 1 SHEETS STA. SCALE: NONE SHEET

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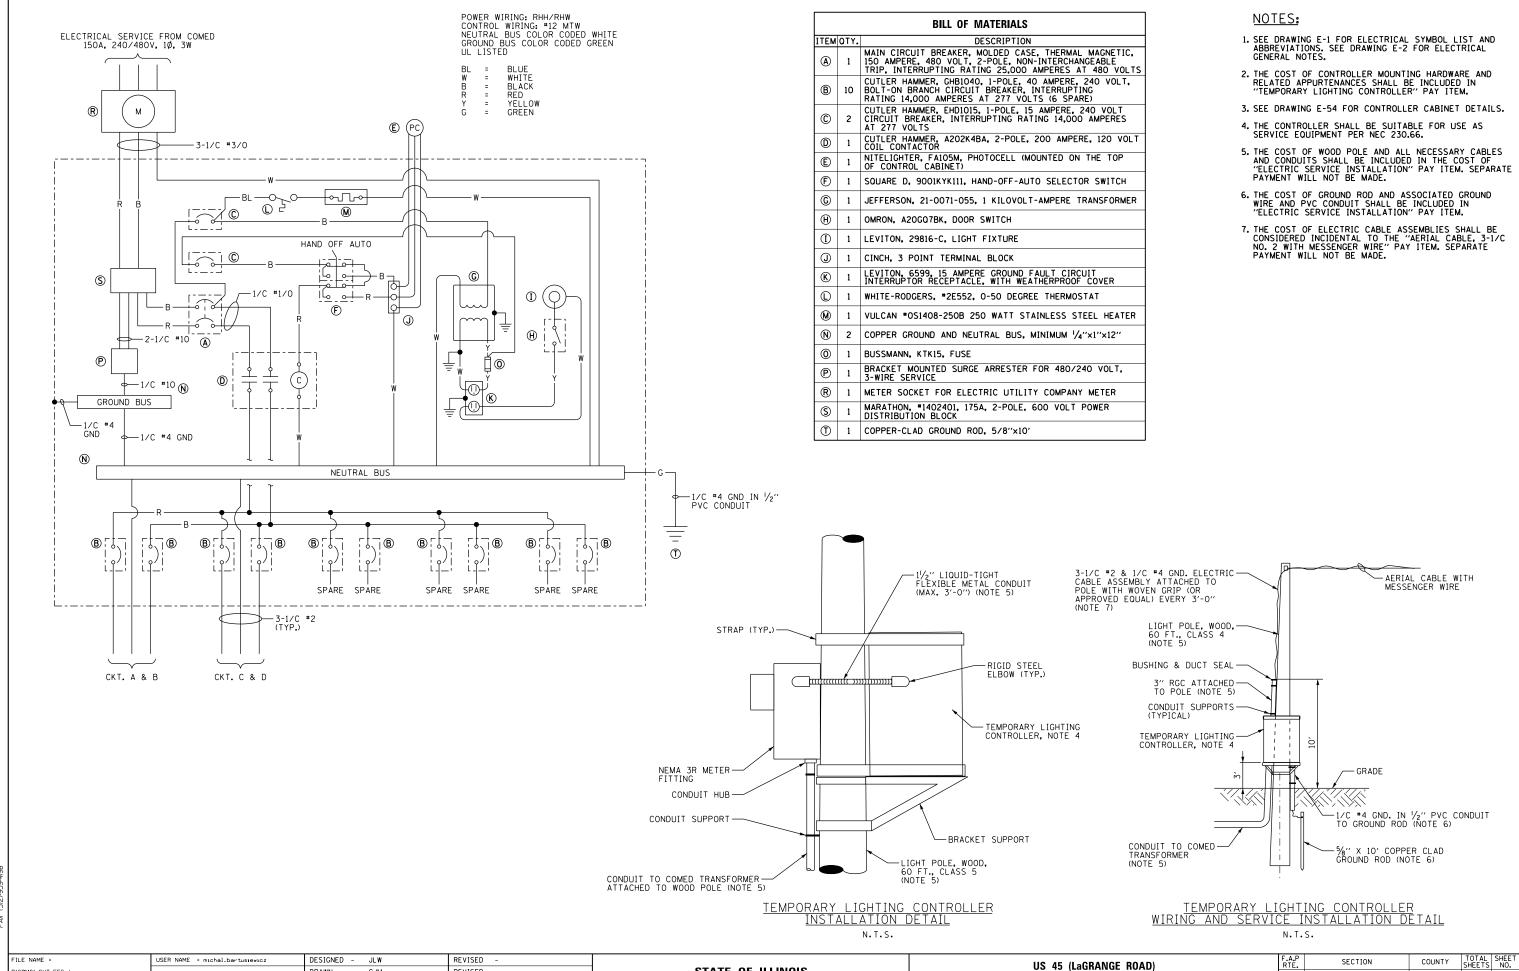
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DESIGNED - JLW

USER NAME = michal_bartusiewicz

STATE OF ILLINOIS **DEPARTMENT OF TRANSPORTATION**



STATE OF ILLINOIS

DEPARTMENT OF TRANSPORTATION

330

TEMPORARY LIGHTING CONTROLLER DETAILS & DIAGRAMS

1 OF 1 SHEETS STA.

SCALE: NONE SHEET

103R-4

E-56

COOK

877 467

CONTRACT NO. 60M61

160M61-SHT-E56.dgr

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FILE NAME = DESIGNED - DAD REVISED USER NAME = michal_bartusiewicz 160M61-SHT-E57.dgr DRAWN -DAD REVISED CHECKED -DAD REVISED 03/13/2013 PLOT DATE = 3/15/2013 DATE REVISED D160M61-SHT-E57.dgn 3/15/2013 2:27:35 PM

STATE OF ILLINOIS **DEPARTMENT OF TRANSPORTATION**

US 45 (LaGRANGE ROAD) **ELECTRICAL WIRING DIAGRAMS AND DETAILS** 1 OF 1 SHEETS STA.

TOTAL SHEET SHEETS NO. SECTION COUNTY 330 103R-4 COOK 877 468 E-57 CONTRACT NO. 60M61

SCALE: NONE SHEET

-2-1/C #10 & 1/C #10 GND, 600V, TYPE RHW TO FESTOON RECEPTACLE

-FUSE HOLDER WITH 5 AMP FUSE (TYP.)

-SOLID COPPER SLUG

-CABLE SPLICE (TYP.), SEE TYPICAL DETAIL ON THIS DRAWING (SPLICES FOR CONDUCTORS THAT ONLY PASS THROUGH POLE NOT SHOWN FOR CLARITY)

-600V INSULATED COLOR-CODED COPPER CONDUCTOR (TYP.)

-LIGHT POLE FOUNDATION

1.1.1.1

LTG IN

L RECP IN

-1 +1 +1

 -1.1 ± 1.1

TYPICAL POLE BASE WIRING DETAIL

LTG OUT

RECP OUT

-12" MAXIMUM WIDTH EXCEPT AS APPROVED BY THE ENGINEER 12"/ -DETECTABLE WARNING TAPE AS SPECIFIED -UNIT DUCT WITH COLOR-CODED WIRING PER PLANS (OPEN CONDUCTORS REPRESENT RECEPTACLE CIRCUIT CONDUCTORS)

400W HPS LUMINAIRE

FESTOON RECEPTACLE

5 AMP FUSE (TYP.)

1/C #6 RED

/C #6 WHITE

/C #8 GREEN

/C #2 ORANGE

1/C #2 BROWN

/C #2 GRAY

/C #4 GREEN

LAØ LBØ

LN

RBØ

LIGHTING (

RECEPTACLE CIRCUIT

LIGHTING CONTROLLER

-GROUND LUG (TYP.)

—1/C #2 GND

-SOLID COPPER SLUG (TYP.)

CABLE SPLICE (TYP.)


TYPICAL LIGHTING UNIT AND RECEPTACLE WIRING DIAGRAM

•

CONTINUED TO NEXT

(TYP.)

TYPICAL UNIT DUCT IN TRENCH DETAIL

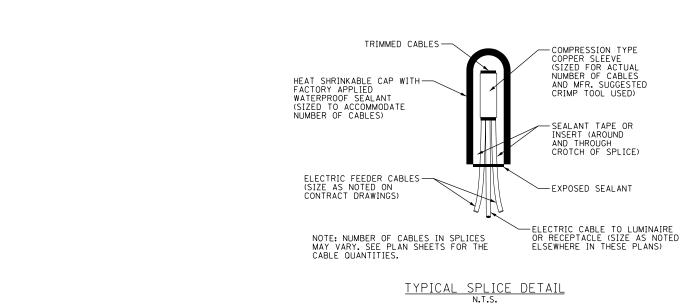

2-1/C #10 & 1/C #10 GND,-600V, TYPE RHW TO LIGHT FIXTURE

GROUND LUG-

1/C #2 INSULATED GREEN GROUND WIRE (TYP.)

POLE SHAFT

LA = LTG A PHASE LB = LTG B PHASE LN = LTG NEUTRAL RA = RECP A PHASE RB = RECP B PHASE RN = RECP NEUTRAL

G = GROUND

1-PH COMPT TR PAD - ESS/RSS

167kVA MAXIMUM CAPACITY

	ITEM	MATERIAL DESCRIPTION (BY ComEd)	MIG	SI	UNIT	QTY .A
Ì	A	GROUNDING INSTALLATION (1) C8550, _CO	G			î
-		Wire, Capper; #1/0-19 Strand, Soft Drawn, Tin Coaled, Bare,	G	355082	FT	35
1	D	Connector, Compression; 1/0 Or 2/0 Strd Cu. Run & Top,	U	368545	EΑ	1

NOTES:

APPLICATION

 THIS STANDARD SHALL BE USED FOR THE INSTALLATION OF AN ELECTRIC OR RESIDENTIAL SERVICE STATION FOUNDATION AS DESCRIBED IN THE "INFORMATION AND REQUIREMENTS FOR THE SUPPLY OF ELECTRIC SERVICE BOOK", SECTIONS 2.02 AND 2.07.

SUPPLEMENTARY MATERIAL

- WHEN BARE LEAD COVERED CABLES ARE LOCATED OR PLANNED WITHIN 200 FEET, OMIT ITEM "C" AND REPLACE WITH 1/0 LEAD CLAD COPPER CONDUCTOR (SI 360809). SPECIFY STANLESS SITEL GROUNDS PER C8550.CGO.
- 2 PRECAST ALTERNATIVES TO THIS POURED DESIGN MAY BE AVAILABLE. CONTACT CONSTRUCTION STANDARDS GROUP.


INFORMATION

- THE CUSTOMER TO INSTALL THE TRANSFORMER FOUNDATION,
 INCH CONDUITS, AND TRENCH FOR COMEG GROUND WIRE.
- © Comed TO PROVIDE AND INSTALL THE GROUND WIRE AND GRID.
- (1) AFTER PRIMARY AND SECONDARY CONDUITS ARE IN PLACE, BACKFILL WITH SCREENINGS, SAND, OR FINE EXCAVATED MATERIAL. COMPACT THOROUGHLY BEFORE POURING FOUNDATION.
- (14) CONCRETE TO BE IN ACCORDANCE WITH THE LATEST EDITION OF THE APPLICABLE ACI CODE AND AIR ENTRAINED. IT SHALL HAVE A MINIMUM COMPRESSIVE STRENGTH OF 3000 PSI AT 28 DAYS. AIR ENTRAINMENT SHALL BE 4 TO 7 PERCENT OF THE VOLUME OF CONCRETE.

- 15 TOP OF FOUNDATION TO BE SMOOTH AND LEVEL.
- (F) GRADE AWAY FROM FOUNDATION, FINAL GRADE SHALL BE WELL DRAINED AT ALL TIMES.
- PRIMARY AND SECONDARY CONDUIT MUST COME THROUGH FOUNDATION IN DESIGNATED AREAS.
- (18) SEE C7723 FOR BURNDY-HUSKY DIE SET CROSS REFERENCE.
- 19 DO NOT PLACE CONDUITS UNDER THIS SECTION OF FOUNDATION
- 20 DO NOT DISTURB EARTH IN FOUNDATION AREA MORE THAN
- NECESSARY WHEN INSTALLING CONDUIT.

 (2) TERMINATE PRIMARY AND SECONDARY CONDUITS FLUSH WITH TOP OF FOUNDATION.
- (2) BOX OUT CONDUIT OPENING.
- (2) SECONDARY CONDUIT LOCATION.
- 24) PRIMARY CONDUIT LOCATION.
- 25 PLEASE CONSULT GP 346 (SPCC) OR ENVIRONMENTAL SERVICES IF EITHER OF THE FOLLOWING EXISTS:
 - A SINGLE ABOVE GROUND TANK WITH A CAPACITY OF 660 GALLONS OR MORE.
 - MORE THAN ONE ABOVE GROUND TANK WITH TOTAL CAPACITY EQUAL TO OR EXCEEDING 1320 GALLONS.

F	PRESSING TABLE (18)						
1777.4	TOOL & DIE	NO. OF					
ITEM	Y-35	CRIMPS					
	U-0	1					
D	U-E	3					

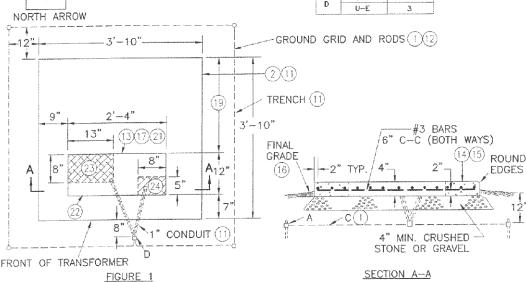

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ComEd SYSTEM STANDARD

NOTES:


- THIS WORK SHALL BE INSTALLED UNDER THE "ELECTRIC SERVICE INSTALLATION" PAY ITEM, UNLESS NOTED OTHERWISE.
- 2. COMMONWEALTH EDISON COMPANY (COMED) SHALL FURNISH AND INSTALL THE PAD MOUNTED TRANSFORMER COMPLETE WITH GROUNDING SYSTEM INCLUDING GROUND RODS, GROUNDING CONDUCTOR, PRIMARY CABLE, CUT-OUT SWITCH, LIGHTNING ARRESTOR, CONNECTORS, AND ANY OTHER EQUIPMENT AND LABOR DEEMED NECESSARY. SEE COMED SYSTEM STANDARD C5288 FOR INSTALLATION REQUIREMENTS.
- 3. ELECTRIC SERVICE CONDUCTORS FROM THE INSIDE OF THE CABINET TO THE TRANSFORMER, PROVIDE 10 FT OF SLACK FOR CONNECTION TO TRANSFORMER BY COMED, CABLE SHALL CONFORM TO THE REQUIREMENTS SPECIFIED FOR ELECTRIC CABLE IN CONDUIT. LABEL CABLE ON BOTH ENDS. SEE PLAN DRAWINGS FOR CABLE TYPE AND SIZE.
- 4. UNDERGROUND CONDUIT. SEE PLAN DRAWINGS FOR CONDUIT MATERIAL AND SIZE.
- 5. RGC 90 DEGREES LONG SWEEP ELBOW IN TRENCH, SEE PLAN DRAWINGS FOR CONDUIT, TYPE, SIZE, AND QUANTITY. THIS WORK SHALL BE INSTALLED UNDER THE "ELECTRIC SERVICE INSTALLATION" PAY ITEM.
- 6. UNDER THE "ELECTRIC UTILITY SERVICE CONNECTION" PAY ITEM, COMED SHALL FURNISH AND INSTALL METER ON CONTROLLER CABINET.
- 7. SEE DRAWING E-55 FOR LIGHTING CONTROLLER AND FOUNDATION DETAILS.
- 8. SUBMIT A PLAN DRAWING SHOWING THE PROPOSED PRIMARY CONDUIT INSTALLATION TO COMED FOR THEIR APPROVAL. THIS WORK SHALL BE COVERED UNDER THE "ELECTRIC UTILITY SERVICE CONNECTION" PAY ITEM. SEPARATE PAYMENT WILL NOT BE MADE.
- COORDINATE DETAILS WITH COMED. FOR BID, ASSUME 200 FEET OF 4" DIA. UNDERGROUND RGC WITH 3-1/C *2/O 12KV CABLES.

COUNTY

COOK

877 469

CONTRACT NO. 60M61

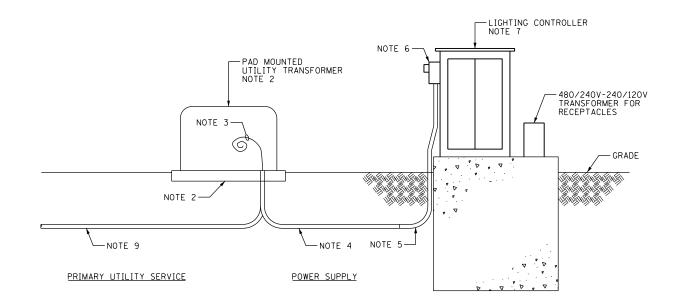

ELECTRIC SERVICE INSTALLATION DETAIL
N.T.S.


100 S. WACKE SUITE 50 SUITE 60 CHICAGO 1L. 1 TEL (312)-93 FAX (312)-93

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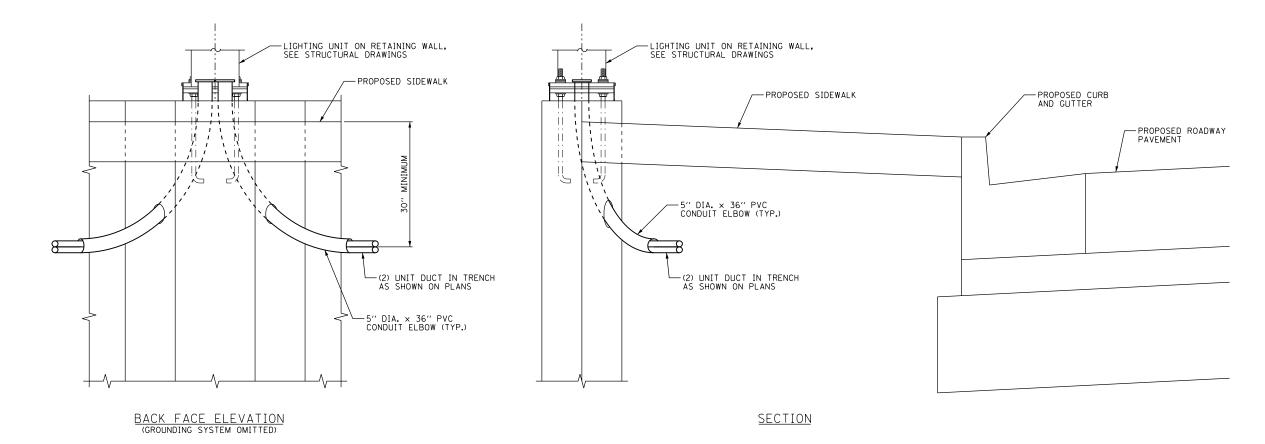
STATE OF ILLINOIS
DEPARTMENT OF TRANSPORTATION

				110 45	,, ,	0048101			F.A.P RTE.	SECTION
	FLFC	US 45 (Lagrange Road) ELECTRIC SERVICE INSTALLATION PAD MOUNTED TRANSFORMER					330	103R-4		
		,,,,,,								E-58
ı	SCALE:	NONE	SHEET	1 OF	1	SHEETS	STA.	TO STA.		ILLINOIS FED. A

 SEE DRAWING E-1 FOR ELECTRICAL SYMBOL LIST AND ABBREVIATIONS. SEE DRAWING E-2 FOR ELECTRICAL GENERAL NOTES.

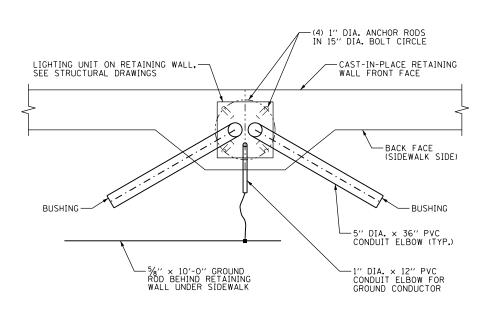

<u>PLAN VIEW</u>



LIGHT POLE ON CAST-IN-PLACE RETAINING WALL N.T.S.


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STATE OF ILLINOIS				
DEPARTMENT	0F	TRANSPORTATION		


US 45 (Lagrange Road)								F.A.P RTE.	SECTION	COUNTY	TOTAL SHEETS	SHEET NO.	
RF1	RETAINING WALL MOUNTED LIGHT POLE INSTALLATION DETAILS							330	103R-4	соок	877	470	
	TETAINING WATER INCOMED EIGHT FORE INCOMEDITION DETAILS								E-59		CONTRACT NO. 60M61		
SCALE:	NONE	SHEET	1 OF	1 5	SHEETS	STA.	TO STA.		ILLINOIS FED. AID PROJECT				

- 1. SEE DRAWING E-1 FOR ELECTRICAL SYMBOL LIST AND ABBREVIATIONS. SEE DRAWING E-2 FOR ELECTRICAL GENERAL NOTES.
- 2. AERIAL CABLE MUST HAVE A MINIMUM CLEARANCE OF 20'-0" TO GRADE AT ALL LOCATIONS.
- 3. CONTRACTOR HAS THE OPTION TO SUBSTITUTE THE UNIT DUCT WITH ELECTRIC CABLE IN CONDUIT. NO ADDITIONAL PAYMENT WILL BE ALLOWED FOR ANY ADDITIONAL MATERIALS AS A RESULT OF THIS SUBSTITUTION.



NOTE: DETAIL FOR WOOD POLE TO ROADWAY LIGHTING CONTROLLER WIRING CONNECTION IS SIMILAR.

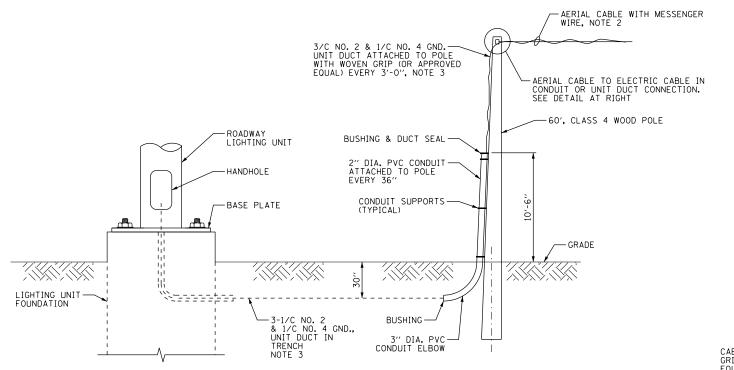WOOD POLE TO ROADWAY LIGHTING UNIT WIRING CONNECTION DETAIL N.T.S.

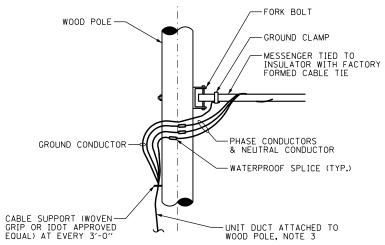

AERIAL CABLE TO ELECTRIC

CABLE ASSEMBLY CONNECTION DETAIL

N.T.S.

| 100 S. WACKER DR. SUITE 500 CHICAGO TEL (312)-939-1000 FAX (312)-939-4198

FILE

STATE OF ILLINOIS
DEPARTMENT OF TRANSPORTATION

CENTER RACEWAYS LIGHT POLE FOUNDATION DEPTH TABLE 40 FT. (12.192 m) TO 47.5 FT. (14.478 m) MOUNTING HEIGHT DESIGN DEPTH "D" OF FOUNDATION SOIL CONDITIONS SINGLE ARM POLE TWIN ARM POLE RACEWAYS PARALLEI TO EDGE OF PAVEMENT 15'-0" (4.57 m) Qu = 0.375 TON/SQ. FT. (3.96 m) RACEWAYS PARALLEL MEDIUM CLAY TO EDGE OF PAVEMENT Ou = 0.75 TON/SO.FT (2.09 m) (3.23 m) TOP VIEW STIFF CLAY 8'-0" Qu = 1.50 TON/SQ. FT. (2.13 m) (2.44 m) LOOSE SAND Ø = 34° 10'-0" (2.74 m) (3.05 m) 4-1" Dia, X 5'-0" (4-25.4 Dia. X 1.524 m) 9'-0'' (2.74 m) Ø = 37.5° (2.52 m) DENSE SAND (2.36 m) (2.74 m) 3/4" (19) CHAMFER #2/0 BARE COPPER EXOTHERMIC WELD CONNECTION TO GND ROD. EXOTHERMIC WELD CONNECTION 1-2" PVC RACEWAY (LITE) 1-2 1/2" PVC RACEWAY (RECP) 1-2" PVC RACEWAY (LITE) (36" RADIUS) 1-2 1/2" PVC RACEWAY (RECP) (36" RADIUS) 6" (152.4) THREADED GROUND CLAMP UL LISTED 8-#6 VERTICAL BARS GROUND ROD (WHEN SPECIFIED) 5%" Dia. X 10' (15.875 Dia. X 3.048 m) RADIUS NOT LESS THAN 5" (127.0) 4 TIMES NOMINAL ROD DIA. 3 LOOPS MIN. AT TOP & BOTTOM ANCHOR ROD DETAIL - 2" (50.8) 3" (76.2) 24" (609.6) Dia. FOUNDATION DETAIL TOP OF ANCHOR ROD 1" (100) MAX. GROUND I INF



CENTER RACEWAYS
IN FOUNDATION

TOP VIEW

- 1. ALL DIMENSIONS ARE IN INCHES (MILLIMETERS) UNLESS OTHERWISE SHOWN.
- THE ANCHOR RODS AND RACEWAYS SHALL BE PROPERLY SECURED IN PLACE BEFORE THE CONCRETE IN PLACED.
- THE FOUNDATION SHALL NOT PROTRUDE MORE THAN 100MM (4 IN.) ABOVE THE FINISHED GRADE WITHIN A 60 IN. (1.5 m) CHORD ACROSS THE FOUNDATION, WITH ANCHOR RODS INCLUDED, IN ACCORDANCE WITH AASHTO GUIDELINES. IF THE FOUNDATION HEIGHT, INCLUDING ANCHOR RODS, EXTENDS BEYOND THESE SPECIFIED LIMITS, THE FOUNDATION SHALL BE REPLACED AT THE CONTRACTOR'S EXPENSE. SEE FOUNDATION EXTENSION DETAIL.
- THE HOLE FOR THE FOUNDATION SHALL BE MADE BY DRILLING WITH AN AUGER, OF THE SAME DIAMETER AS THE FOUNDATION. IF SOIL CONDITIONS REQUIRE THE USE OF A LINER TO FORM THE HOLE, THE LINER SHALL BE WITHDRAWN AS THE CONCRETE IS DEPOSITED.
- THE TOP OF THE FOUNDATION SHALL BE CONSTRUCTED LEVEL. A LINER OR FORM SHALL BE USED TO PRODUCE A UNIFORM SMOOTH SIDE TO THE TOP OF THE FOUNDATION. FOUNDATION TOP
- 6. THE CONCRETE SHALL BE CLASS SI. CONCRETE SHALL CURE ACCORDING TO ARTICLE 1020.13 BEFORE LIGHT POLES ARE INSTALLED.
- THE ANCHOR ROD SHALL BE A HOOK ROD TYPE. COLD BENDING OF THE ANCHOR ROD WILL NOT BE ALLOWED. THE RADIUS OF THE HOOK BEND SHALL NOT BE LESS THAN 4 TIMES THE NOMINAL DIAMETER OF THE ANCHOR ROD. A TACK WELDED ANCHOR ROD MAY BE SUBSTITUTED WITH THE
- THE ANCHOR RODS SHALL BE ACCORDING TO ASTM F1554 GRADE 725 (GRADE 105). NUTS SHALL BE HEXAGON NUTS ACCORDING TO ASTM A 194 2H OR ASTM A 563 DH, AND WASHERS SHALL BE
- ANCHOR RODS, NUTS AND WASHERS SHALL BE COMPLETELY GALVANIZED BY EITHER THE HOT-DIPPED PROCESS CONFORMING WITH AASHTO M 232, THE MECHANICAL PLATING METHOD CONFORMING TO AASHTO M 298, CLASS 50 WITH A MAXIMUM COATING THICKNESS OF 150 UM(6 MILS) OR THE ELECTROLYTIC PROCESS ACCORDING TO ASTM F 1136.
- 10. THE ANCHOR RODS SHALL BE THREADED A MINIMUM OF 6 INCHES (150 mm) WITH A MINIMUM OF 3 INCHES (75 mm) OF THREADED ANCHOR ROD EMBEDDED IN THE FOUNDATION.
- 11. ANCHOR RODS SHALL PROJECT $2\frac{\gamma}{4}$ " (69.9 mm) above the top of the foundation. If Breakaway couplings are specified, the contractor shall carefully coordinate the anchor rod PROJECTION WITH THE INSTALLATION REQUIREMENTS OF THE BREAKAWAY COUPLINGS.
- 12. THE CONTRACTOR SHALL USE A *3 SPIRAL AT 6" (152.4 mm) PITCH OR MAY SUBSTITUTE *3 TIES AT 12" (304.8 mm) O.C. WITH THE APPROVAL OF THE ENGINEER.
- 13. THE CABLE TRENCHES AND FOUNDATION SHALL BE BACK FILLED AND COMPACTED AS SPECIFIED BEFORE THE LIGHT POLE IS ERECTED.
- 14. THE RACEWAYS SHALL PROJECT 1" (25.4 mm) ABOVE THE TOP OF THE FOUNDATION.
- 15. CONTRACTOR MUST INSURE THAT THE SETBACK FROM THE BACK OF CURB TO CENTERLINE OF ALL FOUNDATIONS IS KEPT AT A MINIMUM OF 3'-0". CONTRACTOR MUST ALSO INSURE THAT 4'-0" OF MINIMUM SIDEWALK PAVEMENT WIDTH IS GIVEN WHEREVER A FOUNDATION IS WITHIN THE SIDEWALK OR PATH LIMITS PER A.D.A. REQUIREMENTS.

FILE NAME =	USER NAME = michal_bartusiewicz	DESIGNED - JLW	REVISED -
D160M61-SHT-E61.dgn		DRAWN - CJM	REVISED -
	PLOT SCALE = 2.0000000 '/ in.	CHECKED - KMY	REVISED -
SHT_PLAN	PLOT DATE = 3/15/2013	DATE - 03/13/2013	REVISED -

60" (1500)

FOUNDATION EXTENSION DETAIL

STATE OF ILLINOIS **DEPARTMENT OF TRANSPORTATION**

8-#6 VERT.

SECTION A-A


8-6# VERT.


SECTION A-A


US-45 (LaGRANGE ROAD) LIGHT POLE FOUNDATION 40' (12.192 m) TO 47 1/2" (14.478 m) M.H., 15" (381mm) BOLT CIRCLE
SCALE: NONE | SHEET | 1 OF | 1 SHEETS | STA. TO STA.

SECTION COUNTY 330 103R-4 COOK 877 472 CONTRACT NO. 60M61 E-61

D160M61-SHT-E61.dgn 3/15/2013 2:27:41 PM

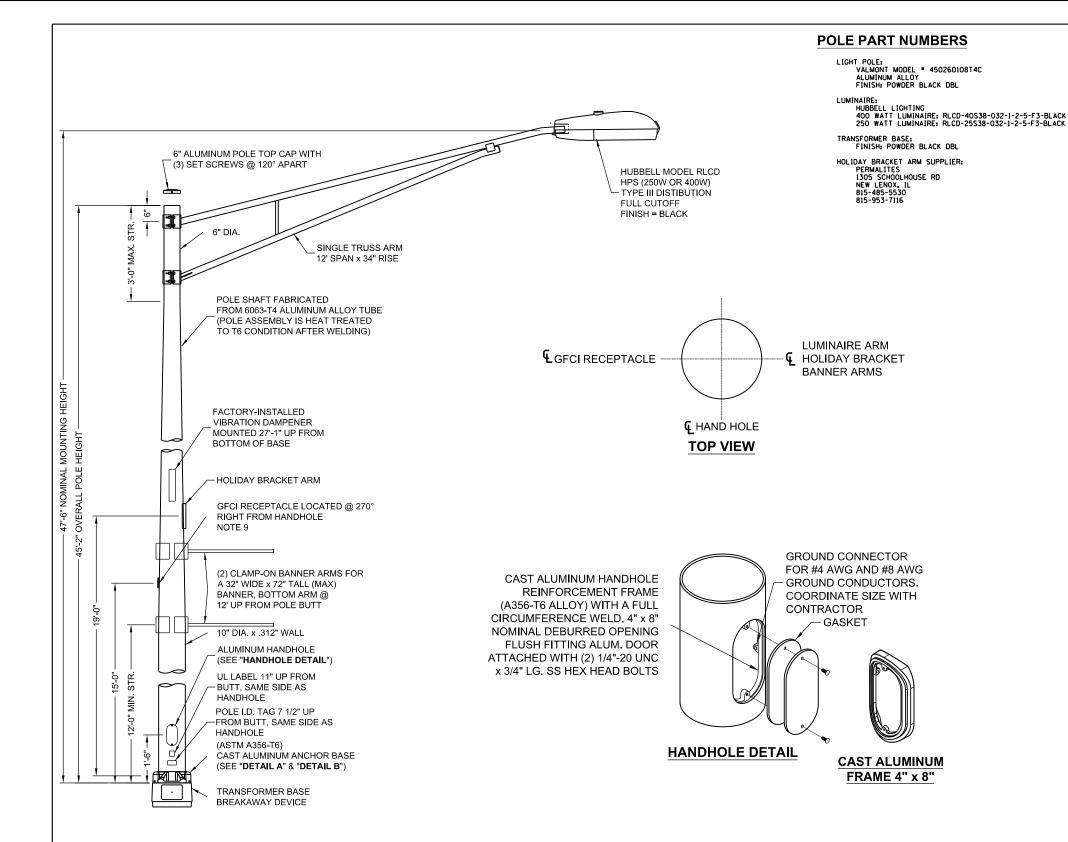

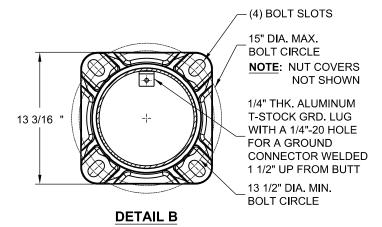

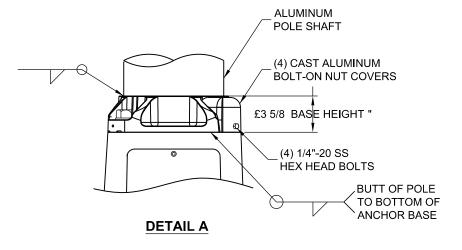

NOTES:


- 1. ALL IDMENSIONS ARE IN INCHES UNLESS OTHERWISE SHOWN.
- 2. MOUNTING HEIGHT IS DEFINED AS THE DISTANCE FROM THE CENTERLINE OF THE TENON TO THE BOTTOM OF THE ANCHOR BASE.
- 3. TWO PIECE SHAFT WILL BE MATCHED, MARKED AND INTERCHANGEABLE BETWEEN DIFFERENT UNITS. FIELD DRILLING OF THE HOLES WILL NOT BE ALLOWED.
- 4. THE LIGHT POLE WILL MEET AASHTO DESING CRITERIA AS SPECIFIED.
- 5. THE INSTALLING CONTRACTOR WILL PROVIDE A UL LISTED GROUNDING CONNECTOR. CONTRACTOR SHALL COORDINATE LUGS WITH POLE MANUFACTURER FOR BONDING LUGS.
- 6. LIGHT POLES WILL NOT BE INSTALLED WITHOUT MAST ARMS AND LUMINAIRES.
- 7. LIGHT POLES WILL BE SET PLUMB ON THE FOUNDATION WITHOUT THE USE OF LEVELING NUTS, WASHERS OR SHIMS.
- 8. LIGHTING UNIT IDENTIFICATION NUMBERS SHALL BE INSTALLED BEFORE THE LIGHTING UNIT IS ENERGIZED.
- 9. ALL PROPOSED LIGHTING UNITS SHALL HAVE A 20A, 12OV, GFC1 RECEPTACLE WITH IN-USE WEATHERPROOF RUGGED U.V. RESISTANT POLYCARBONATE COVER INSTALLED ON BACK OF POLE AT 15'-0" ABOVE THE BASE OF POLE. RECEPTACLE AND BOX SHALL BE BLACK.
- 10. CONTRACTOR MUST PROVIDE A BREAKAWAY DEVICE, TRANSFORMER BASE WITH 15" DIA. BOLT CIRCLE, FOR ALL PROPOSED LIGHTING UNITS. TRANSFORMER BASE SHALL BE INCLUDED IN PAY ITEM "LIGHT POLE SPECIAL".
- 11. LIGHT POLE SHALL BE LISTED OR CLASSIFIED BY A NATIONALLY RECOGNIZED TESTING LABORATORY SUCH AS UL, ETL, OR EOUIVALENT.
- 12. CONTRACTOR MUST VERIFY ALL INFORMATION, PART NUMBERS, DIMENTIONS, MEASUREMENTS, AND COMPONENTS SHOWN ON THIS SHEET WITH THE VILLAGE OF ORLAND PARK PUBLIC WORKS DEPARTMENT AND THE EQUIPMENT MANUFACTURERS BEFORE ODDIED




FILE NAME =	USER NAME = michal_bartusiewicz	DESIGNED - JLW	REVISED -
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SHT_PLAN	PLOT DATE = 3/15/2013	DATE - 03/13/201	REVISED -
D160M61-SHT-E62.dgn 3/15/2013 2:27:43 PM			

STATE OF ILLINOIS **DEPARTMENT OF TRANSPORTATION**

			US-45	(La(GRANGE	ROAL))	F.A.P RTE.	SECTION	COUNTY TOTAL SHEE		
Δ	ALUMINUM LIGHT POLE, 47 1/2" (14.478 m) MOUNTING HEIGHT				330	103R-4	соок	877	473			
^	ALDIVINOUN LIGHT FOLL, 47 V2 (14.470 III) INCONTING HEIGHT				E-62	CONTRACT	NO. (60M61				
SCALE:	NONE	SHEET	1 OF	1	SHEETS	STA.	TO STA.		TILLINOIS FED. AT	D PROJECT		

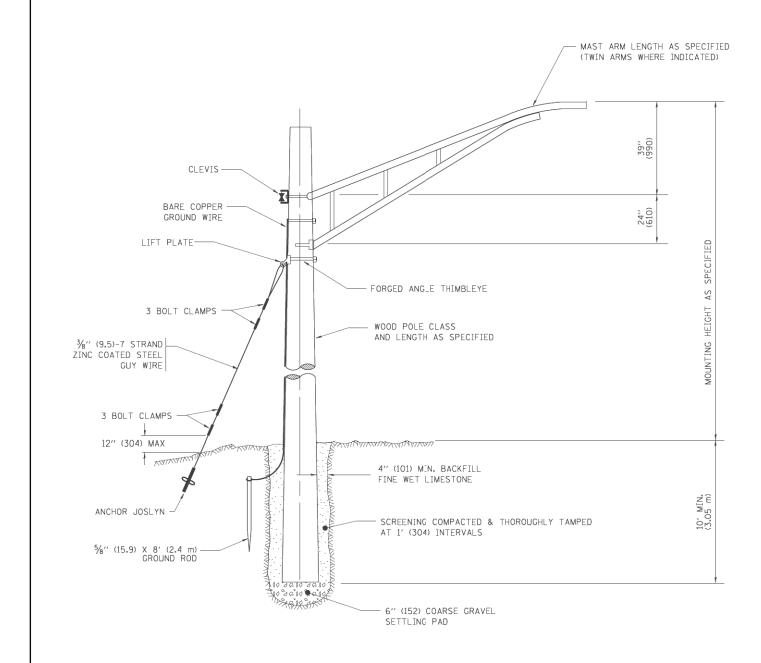

TEMPORARY LIGHT POLE DETAIL

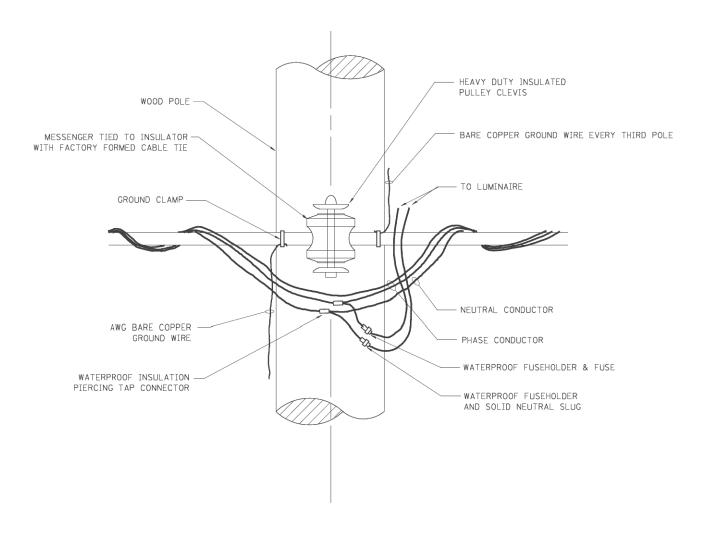


TEMPORARY LIGHT POLE ATTACHMENT DETAIL

NOTES:

1. ALL DIMENSIONS IN INCHES (MILLIMETERS) UNLESS OTHERWISE INDICATED

4													
•	FILE NAME =	USER NAME = michal_bartusiewicz	DESIGNED - JLW	REVISED -	CTATE OF HAINOIC	US-45 (Lagrange Road) Temporary light pole details				F.A.P	SECTION	COUNTY	TOTAL SHEET
	D160M61-SHT-E63.dgn		DRAWN - CJM	REVISED -	STATE OF ILLINOIS				330	103R-4	соок	877 474	
3		PLOT SCALE = 2.0000000 ' / in.	CHECKED - KMY	REVISED -	DEPARTMENT OF TRANSPORTATION	TEMPUKAKY LIGHT PULE DETAILS			E-63	CONTRACT	NO. 60M61		
	SHT_PLAN	PLOT DATE = 3/15/2013	DATE - 03/13/2013	REVISED -		SCALE: NONE	SHEET 1 OF	1 SHEETS STA.	TO STA.		ILLINOIS FED.	ID PROJECT	
	D160M61-SHT-E63.dgn 3/15/2013 2:27:46 PM												

PANEL EQUIPMENT

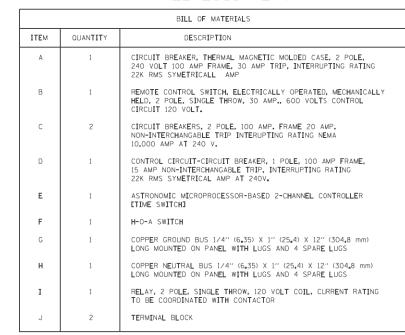

TYPICAL LIGHTING LAYOUT

(NOT TO SCALE)

SEE IDOT COMBINATION POLE DETAIL

POLE WIRING DETAIL


STANDARD-TYPE SMALL DIMENSION DOUBLE POLE FUSEHOLDER WITH INSULATED BOOTS, FUSING AND (SEE SPECS)

CABLE SPLICE (TYP.)

PHASE CONDUCTORS, 600 V TYPE RHW, SOLID COLOR, SIZE AS SPECIFIED (TYP.)

(NOT TO SCALE)

IDOT TRAFFIC SIGNAL/LIGHTING CONTROL CABINET

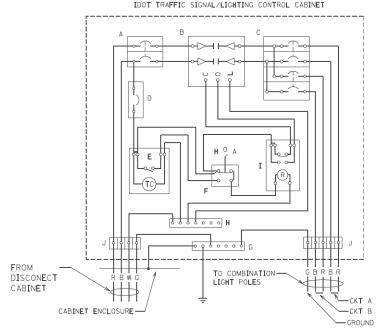

2-1/C -10 AWG, 600 V TYPE RHW, SOLID COLOR CODED CABLES

SPLICE GROUND WIRE AND PIGTAIL SAME SIZE -EXTENSION TO POLE GROUNDING LUG

INSULATED GROUND WIRE, 600 V TYPE RHW, SOLID COLOR GREEN, SIZE AS SPECIFIED


GROUNDING LUG -

UNIT DUCT (TYP)

COMBINATION LIGHTING CONTROLLER WIRING DIAGRAM (NOT TO SCALE)



- 1. ALL WIRING RELATED TO THE LIGHTIGN CONTROLS SHALL BE *10 AWG, 600V, TYPE SWITCH BOARD WIRE, STRANDED COPPER.
- 2. PROVIDE SEALING GROMMETS FOR ALL OPEN WIRING EXTENDED FROM DEVICES IN BOXES OR CABINETS WITHIN THE ENCLOSURE.
- 3. ALL WIRING SHALL BE NEATLY DRESSED, IDENTIFIED BY TAGS, AND SUPPORTED.
- 4. ALL SPLICES AND CONNECTIONS FOR ROADWAY LIGHTING SHALL BE AT POLE BASE ONLY. UNDERGROUND SPLICING OF LIGHTING CONDUCTORS IS NOT PERMITTED.
- 5. THE COMBINATION POLE LIGHTING CABLING DETAIL IS INTENDED TO SHOW CONNECTIONS ONLY. FOR FURTHER INFORMATION ON THE COMBINATION LIGHT POLE, THE TRAFFIC SIGNAL CONTROL CABINET, AND THE SERVICE DISCONNECT BOX REFER TO THE RESPECTIVE DETAIL DRAWINGS.
- 6. COMBINATION LIGHTING SHALL BE TIMED TO ENERGIZE 20 MINUTES PRIOR TO DUSK AND SHALL BE TIMED TO DE-ENERGIZE 20 MINUTES AFTER TO DAWN.
- 7. COMBINATION LIGHTING CONTROLLER AND ALL COMBINATION POLES SHALL HAVE IDOT DESIGNATIONS AND IDOT LABELS, LIGHTING CONTROLER DESIGNATIONS SHALL BE COORDINATED WITH THE BUREAU OF TRAFFIC LIGHTING SECTION.

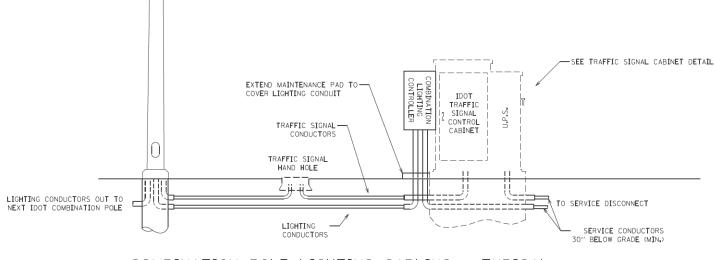

COMBINATION PCLE LIGHTING CABLING - TYPICAL

(NOT TO SCALE)


74										
~	FILE NAME =	USER NAME = michal_bartusiewicz	DESIGNED -	DOT	REVISED -		US-45 (Lagrange road)	F.A.P	SECTION	COUNTY TOTAL SHEET
	D160M61-SHT-E64.dgn		DRAWN -	DOT	REVISED -	STATE OF ILLINOIS	COMBINATION POLE LIGHTING CONTROLLER		103R-4	COOK 877 475
3		PLOT SCALE = 2.0000000 '/ in.	CHECKED -	DAD	REVISED -	DEPARTMENT OF TRANSPORTATION			E-64	CONTRACT NO. 60M61
	SHT_PLAN	PLOT DATE = 3/15/2013	DATE -	03/13/2013	REVISED -		SCALE: NONE SHEET 1 OF 1 SHEETS STA. TO STA.		ILLINOIS FE	D. AID PROJECT


FOUNDATION DESIGN TABLE

	DESIGN DEPTH (OF FOUNDATION		REINFORCEMENT	IN FOUNDATION					
TYPE OF SOIL	SINGLE ARM	TWIN ARM	SINGLE	ARM	TWIN ARM					
	D	D	VERT BARS	SPIRAL	VERT BARS	SPIRAL				
SOFT CLAY	13'-0''	15'-0''	8-#6X12'-6''	#3X122′	8-#6X14'-3''	#3X141′				
	(3.962 m)	(4.572 m)	(3.810 m)	(37.186 m)	(4.343 m)	(42.977 m)				
MEDIUM CLAY	9'-6''	10′-9′′	8-#6X9'-0''	#3X90′	8-#6X10'-0''	#3X100′				
	(2.896 m)	(3.277 m)	(2.743 m)	(27.432 m)	(3.048 m)	(30.480 m)				
STIFF CLAY	7'-0''	8'-0''	8-#6X6′-6′′	#3X66′	8-#6X7'-6''	#3X76′				
	(2.134 m)	(2.438 m)	(1.981 m)	(20.112 m)	(2.286 m)	(23.165 m)				
LOOSE SAND	9'-0''	10'-0''	8-#6X8'-6''	#3X85′	8-#6X9'-6''	#3X94′				
	(2.743 m)	(3.048 m)	(2.591 m)	(25.908 m)	(2.896 m)	(28.651 m)				
MEDIUM SAND	8′-3′′	9'-0''	8-#6X8'-0''	#3X78′	8-#6X8'-6''	#3X85′				
	(2.515 m)	(2.743 m)	(2.438 m)	(23.774 m)	(2.591 m)	(25.908 m)				
DENSE SAND	7′-9′′	9'-0''	8-#6X7'-6''	#3X73′	8-#6X8'-6''	#3X85′				
	(2.362 m)	(2.743 m)	(2.286 m)	(22.250 m)	(2.591 m)	(25.908 m)				
ROCK OR SOLIDIFIED SLAG	5′-0′′ (1.524 m)	5′-0′′ (1.524 m)	NONE	NONE	NONE	NONE				

NOTES

- 1. ALL DIMENSIONS ARE IN INCHES (MILLIMETERS) UNLESS OTHERWISE SHOWN.
- 2. THE ENGINEER SHALL DETERMINE THE CLASS OF SOIL DURING EXCAVATION AND SELECT THE DESIGN DEPTH OF FOUNDATION FROM THE DESIGN TABLE.
- 3. EXCAVATION OF THE POLE FOUNDATION SHALL BE MADE WITH AN AUGER, 24" (609.6 mm) OR 30" (762.0 mm) IN DIAMETER.
- 4. THE ANCHOR ROD SHALL BE A HOOK ROD TYPE, COLD BENDING OF THE ANCHOR ROD WILL NOT BE ALLOWED. THE RADIUS OF THE HOOK BEND SHALL NOT BE LESS THAN 4 TIMES THE NOMINAL DIAMETER OF THE ANCHOR ROD. A TACK WELDED ANCHOR ROD WAY BE SUBSTITUTED WITH THE APPROVAL OF THE ENGINEER.
- 5. THE ANCHOR BOLTS AND RACEWAYS SHALL BE PROPERLY SECURED IN PLACE BEFORE THE CONCRETE IS PLACED IN THE FORM.
- 6. THE ANCHOR RODS SHALL BE ACCORDING TO ASTM F1554 GRADE 725 (GRADE 105). NUTS SHALL BE HEXAGON NUTS ACCORDING TO ASTM A 194 2H OR ASTM A 563 DH, AND WASHERS SHALL BE ACCORDING TO ASTM F 436.
- 7. THE CONTRACTOR SHALL COORDINATE EXTENSION OF ANCHOR BOLTS ABOVE TOP OF FOUNDATION WITH THE BREAKAWAY DEVICE MANUFACTURER'S REQUIREMENTS. IF LIGHT POLE IS MOUNTED WITHOUT BREAKAWAY DEVICE, ANCHOR BOLTS SHALL PROJECT 23/4" (69.9 mm) ABOVE TOP OF THE FOUNDATION. THE CONTRACTOR SHALL CONFIRM ANCHOR BOLT EXTENTION WITH ENGINEER.
- 8. RACEWAYS SHALL PROJECT 1" (25.4 mm) ABOVE THE TOP OF THE FOUNDATION.
- 9. THE CABLE TRENCH SHALL BE BACKFILLED AND FIRMLY COMPACTED BEFORE THE LIGHT IS ERECTED.

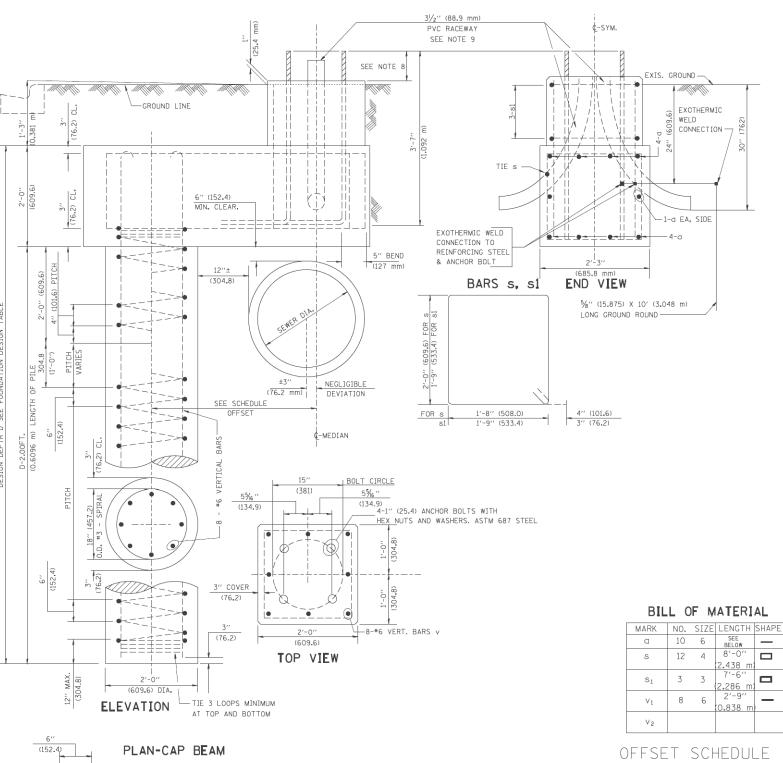

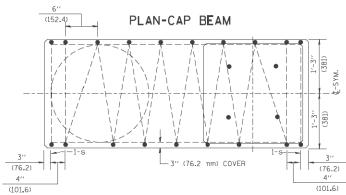

SEWER	PILE OFFSET	LENGIH
DIAM. d -	from¢-MED′N	of BAR a
IN.	=_T.	FT.
UP TO 24"	3'-3''	#6 × 5′-3′′
(609.6 mm)	(0.991 m)	(1.600 m)
27" (685.8 m)TO	3'-9''	5'-9''
36" (914.4 mm)	(1.143 m)	(1.753 m)
42" (1066.8 mm) TO	4'-6''	6′-6′′
48" (1219.2 mm)	(1.372 m)	(1.981 m)
54" (1371.6 mm) TO	5′-0′′	7′-0′′
60" (1524.0 mm)	(1.524 m)	(2.134 m)
66" (1676.4 mm) TO	5'-6''	7′-6′′
72" (1828,8 mm)	(1.676 m)	(2.286 m)

COUNTY


COOK 877 476
CONTRACT NO. 60M61




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	PLOT SCALE = 2.0000000 '/ in.	CHECKED -	DAD	REVISED -
HT_PLAN	PLOT DATE = 3/15/2013	DATE -	03/13/2013	REVISED -

STATE OF	ILLINOIS
DEPARTMENT OF	TRANSPORTATION

	LIGHT POLE FOUNDATION OFFSET						F.A.P RTE.	SECTION		
	40' (12.192 m) TO 47 1/2' (14.478m) M.H.					330	103R-4			
			15" (3	<u>381 r</u>	<u>nm) BOL1</u>	T CIRCLE				E-65
SCALE	: NONE	SHEET	1 0	F 1	SHEETS	STA.	TO STA.			ILLINO

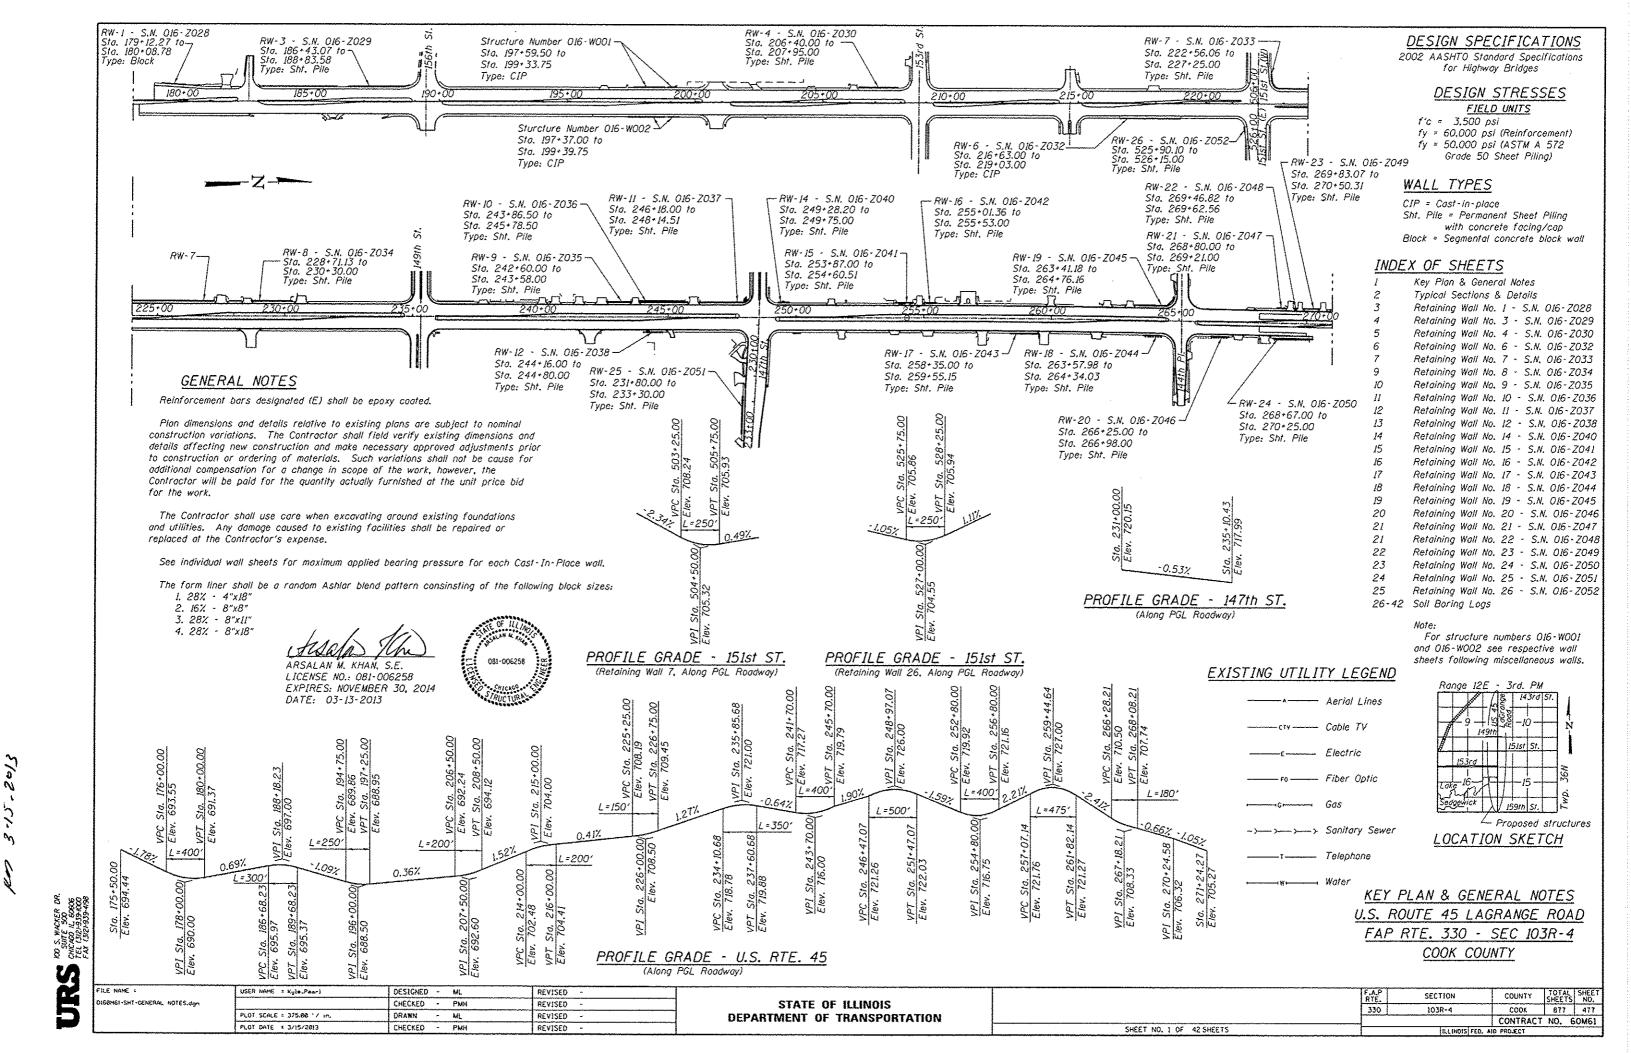

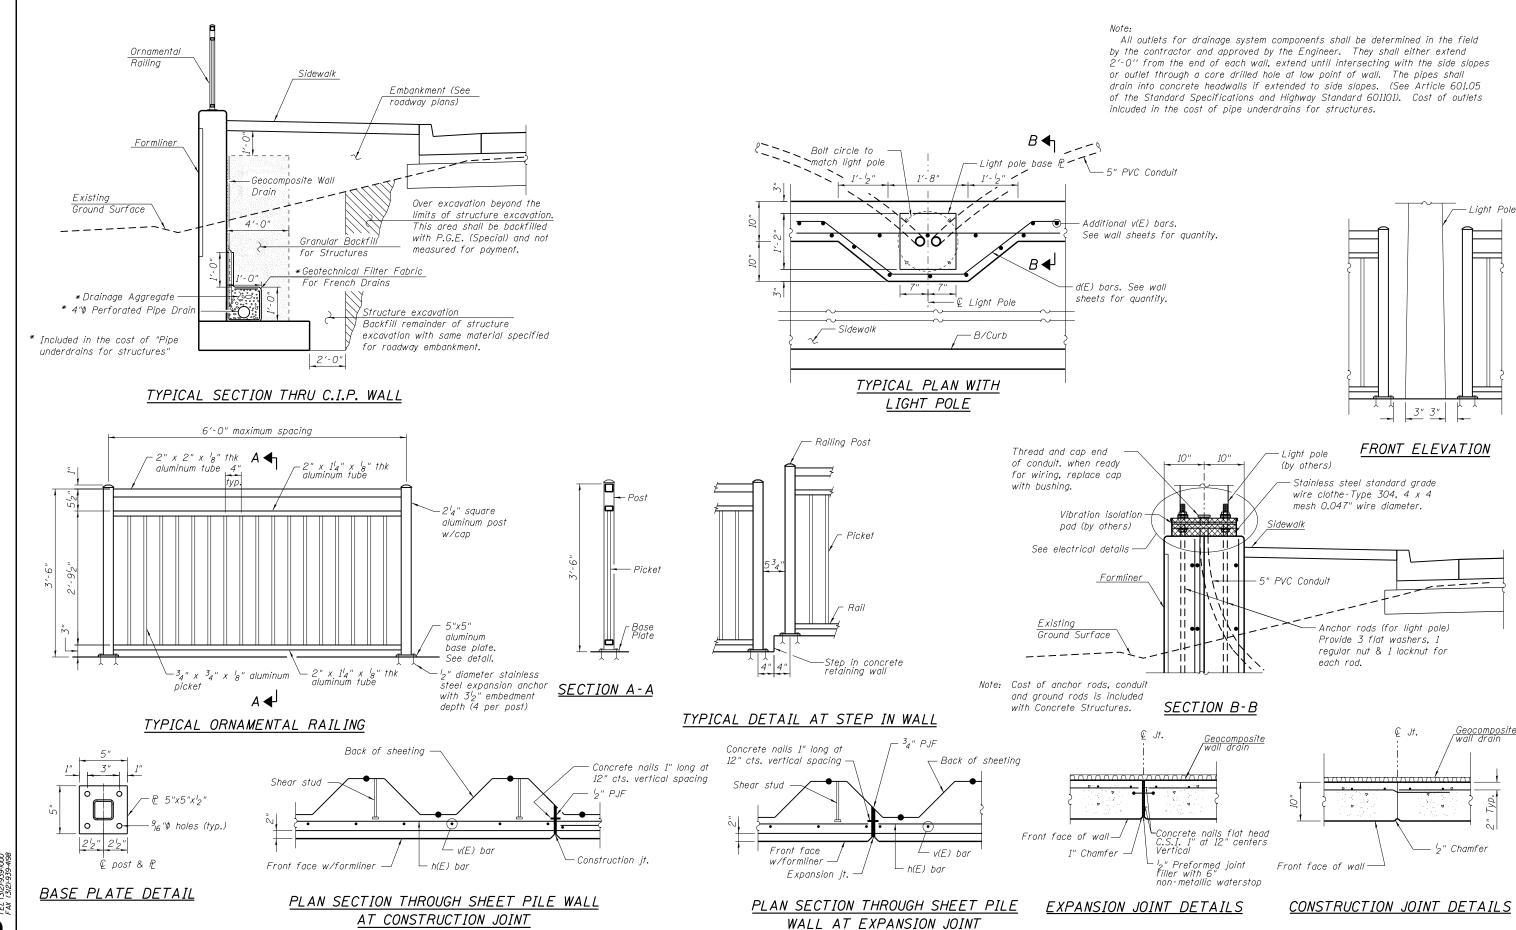


100 S. WACKER DR. SUITE 500 CHICAGO IL. 60606 TEL (312)-939-4000 FAX (312)-939-4198

STATE OF ILLINOIS DEPARTMENT OF TRANSPORTATION RETAINING WALL
TYPICAL SECTIONS & DETAILS

SHEET NO. 2 OF 42 SHEETS


F.A.P RTE. SECTION COUNTY TOTAL SHEETS NO. 330 103R-4 COOK 877 478

CONTRACT NO. 60M61

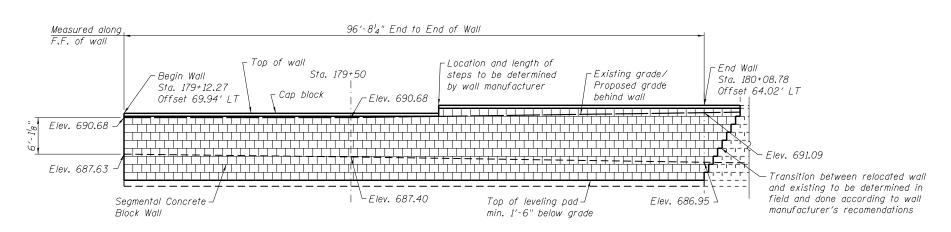

EXISTING WAL SECTION

<u>ELEVATION</u> (Looking east at F.F. wall)

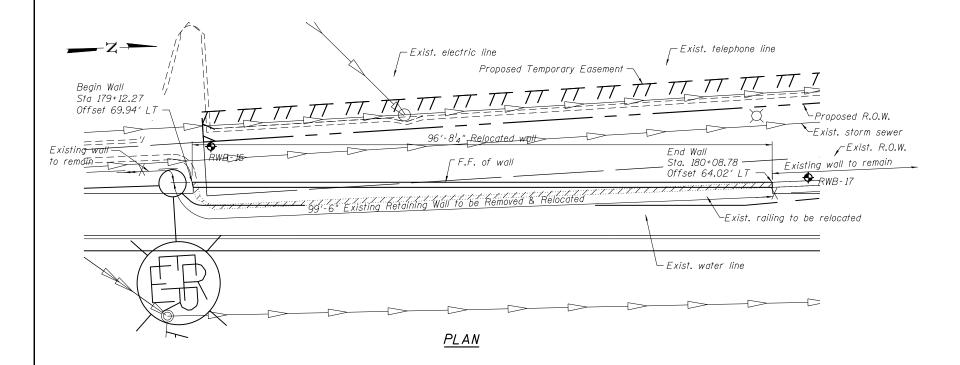

EXISTING RAILING

Existing wall and railing details are taken from existing plans and may not reflect actual field conditions.

BILL OF MATERIAL

ITEM	UNIT	QUANTITY
Remove and Re-Erect Segmental Block Retaining Wall	Sq. Ft.	633


<u>LEGEND</u>

Soil Boring
F.F. Front Face
B.F. Back Face
E.F. Each Face

100 S. WACKEY SUITE 500 CHICAGO 11, 6C

ILE NAME =	USER NAME = Anthony_Plutz	DESIGNED - PMH	REVISED -	
160M61-SHT-Wall_01-1.dgn		CHECKED - JCE	REVISED -	İ
	PLOT SCALE = 16.0000 ' / in.	DRAWN - PMH	REVISED -	İ
	PLOT DATE = 3/14/2013	CHECKED - JCE	REVISED -	ı

RETAINING WALL NO. 1 - S.N. 016-Z028	F.A.P RTE. SECTION		COUNTY	TOTAL SHEETS	SHEET NO.
STA. 179 + 12.27 TO 180 + 08.78	330	103R-4	COOK	877	479
31A. 1/3 + 12.27 10 100 + 00.70			CONTRACT	NO. 6	60M61
SHEET NO. 3 OF 42 SHEETS		ILLINOIS FED. AI	D PROJECT		

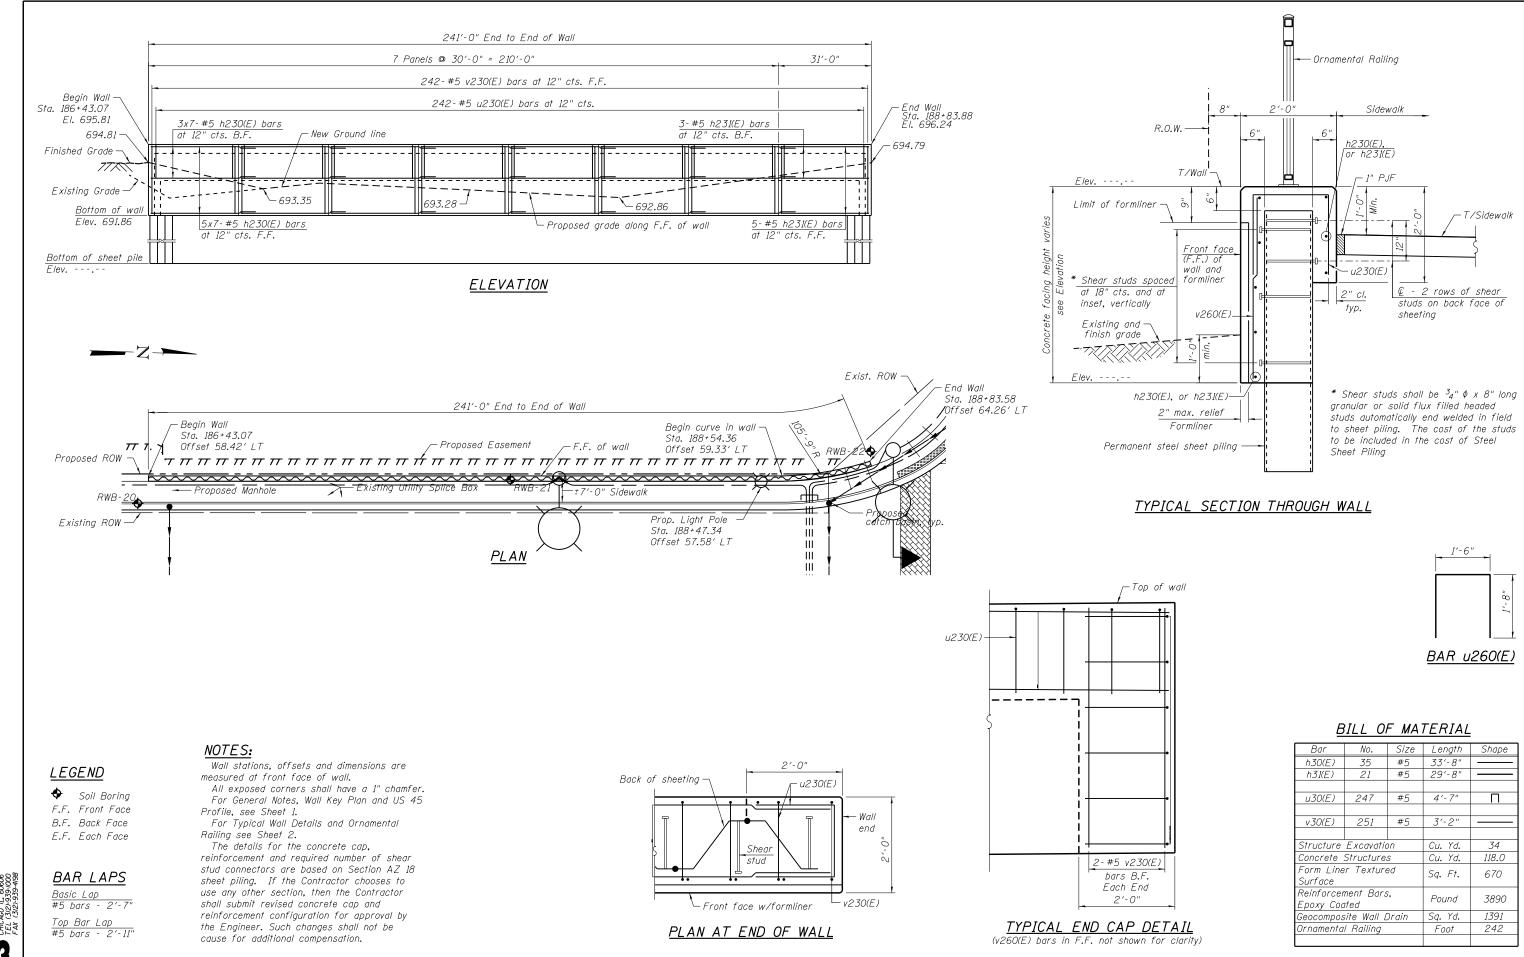

STATE OF ILLINOIS

DEPARTMENT OF TRANSPORTATION

SECTION

103R-4

330

RETAINING WALL NO. 3 - S.N. 016-Z029

STA. 186 + 43.07 TO 188 + 83.58

SHEET NO. 4 OF 42 SHEETS

COUNTY

COOK

877 480

CONTRACT NO. 60M61

160M61-SHT-Wall_03-1.dgn

USER NAME = Anthony_Plutz

PLOT DATE = 3/14/2013

DESIGNED - MJL

CHECKED


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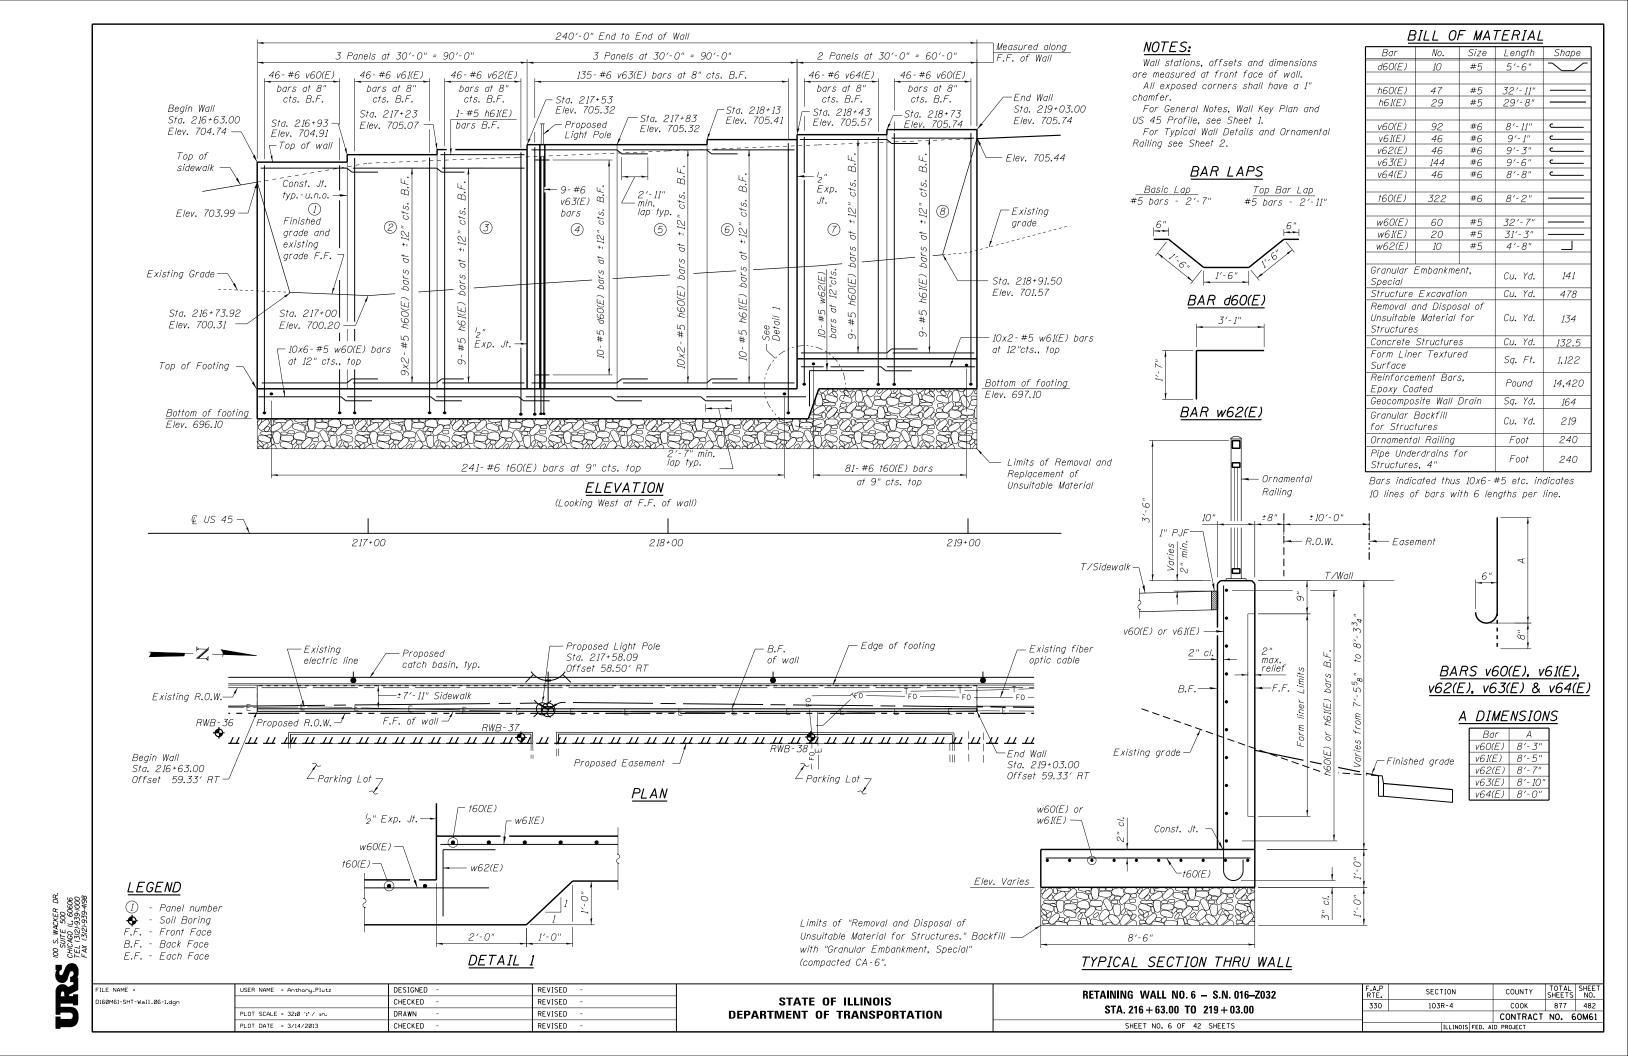
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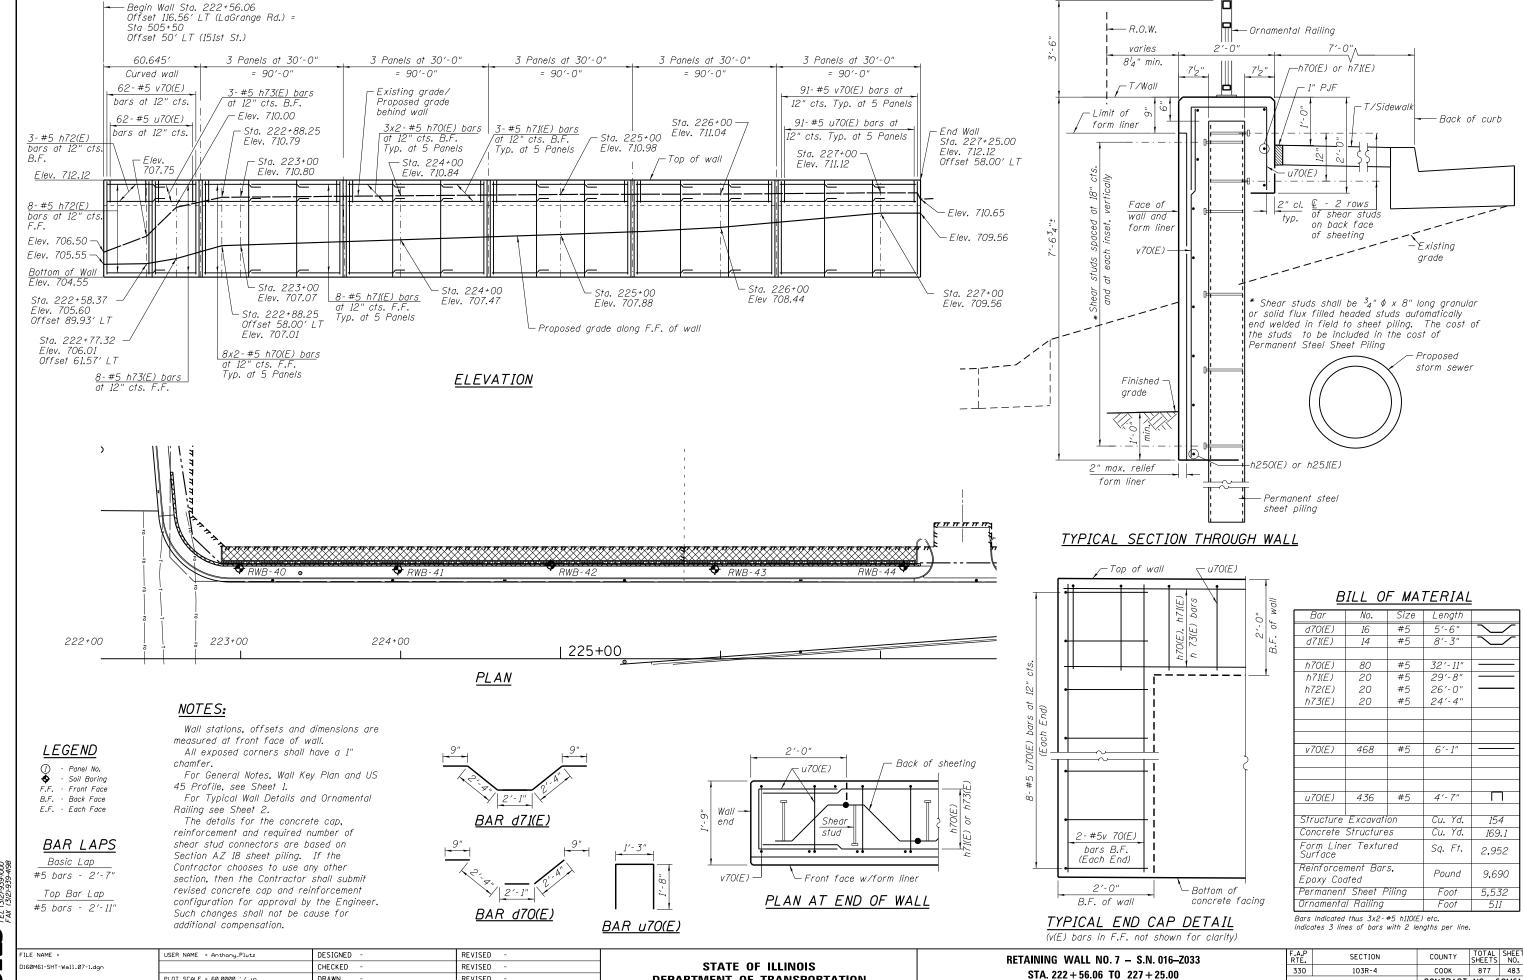
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DEPARTMENT OF TRANSPORTATION

SHEET NO. 7 OF 42 SHEETS


CONTRACT NO. 60M61

DRAWN

CHECKED

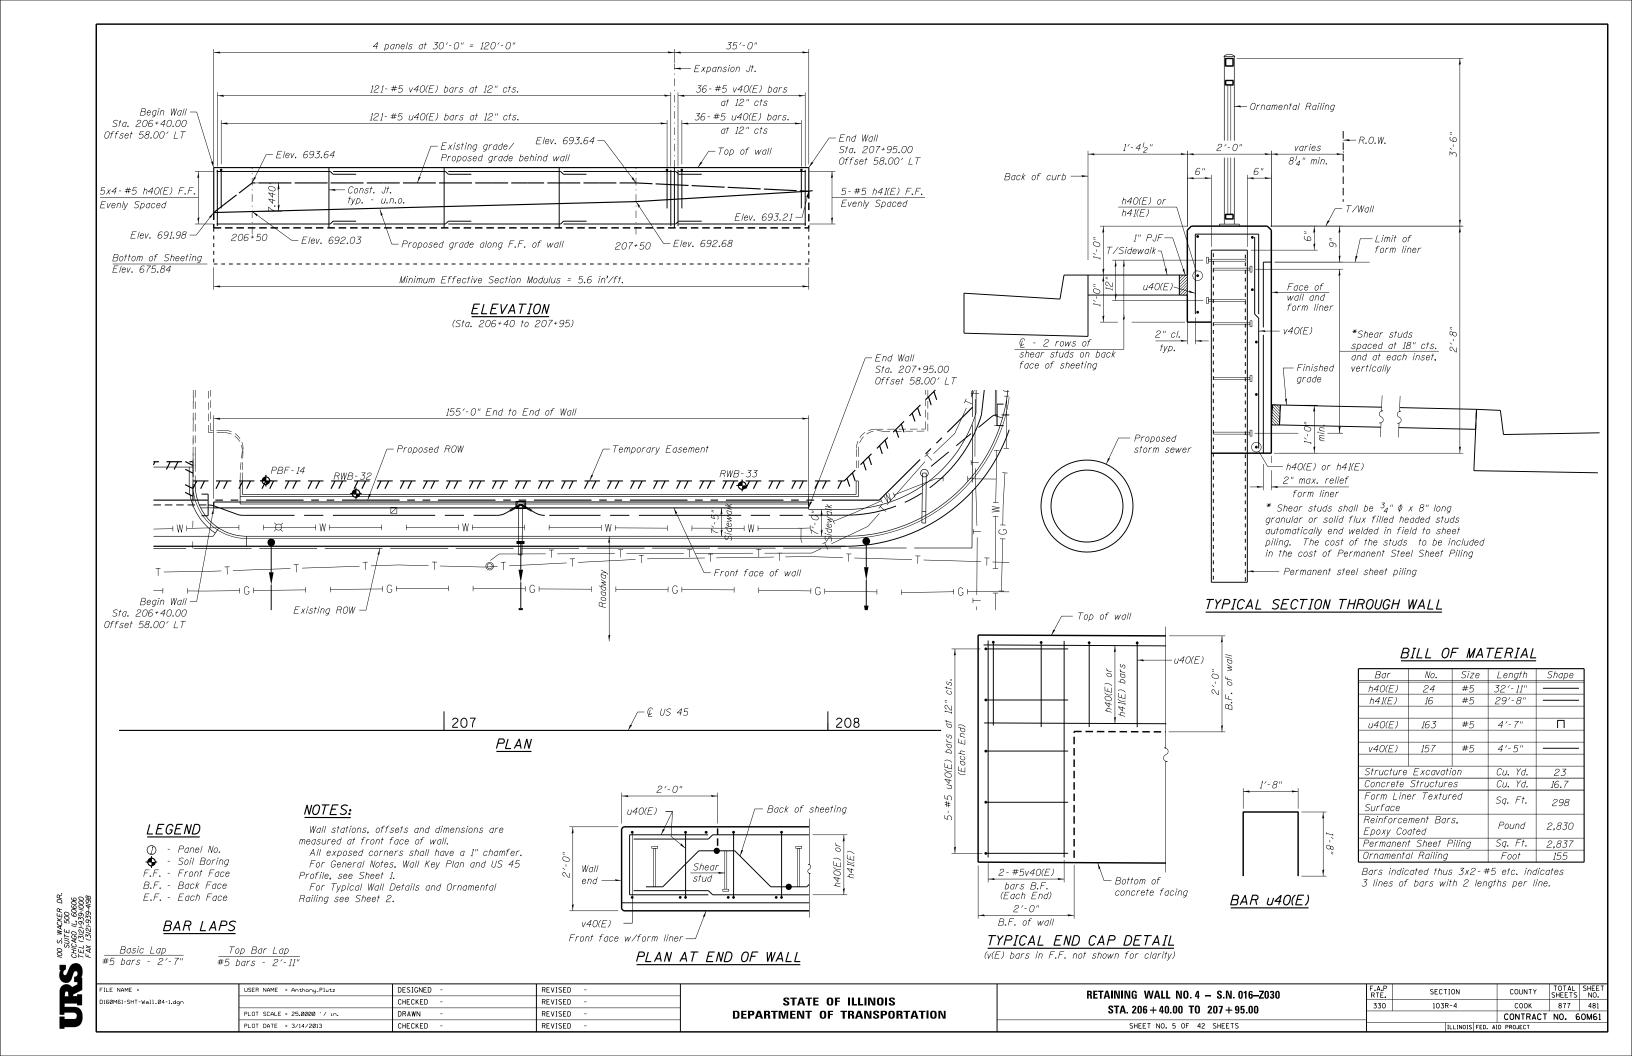PLOT DATE = 3/14/2013

REVISED

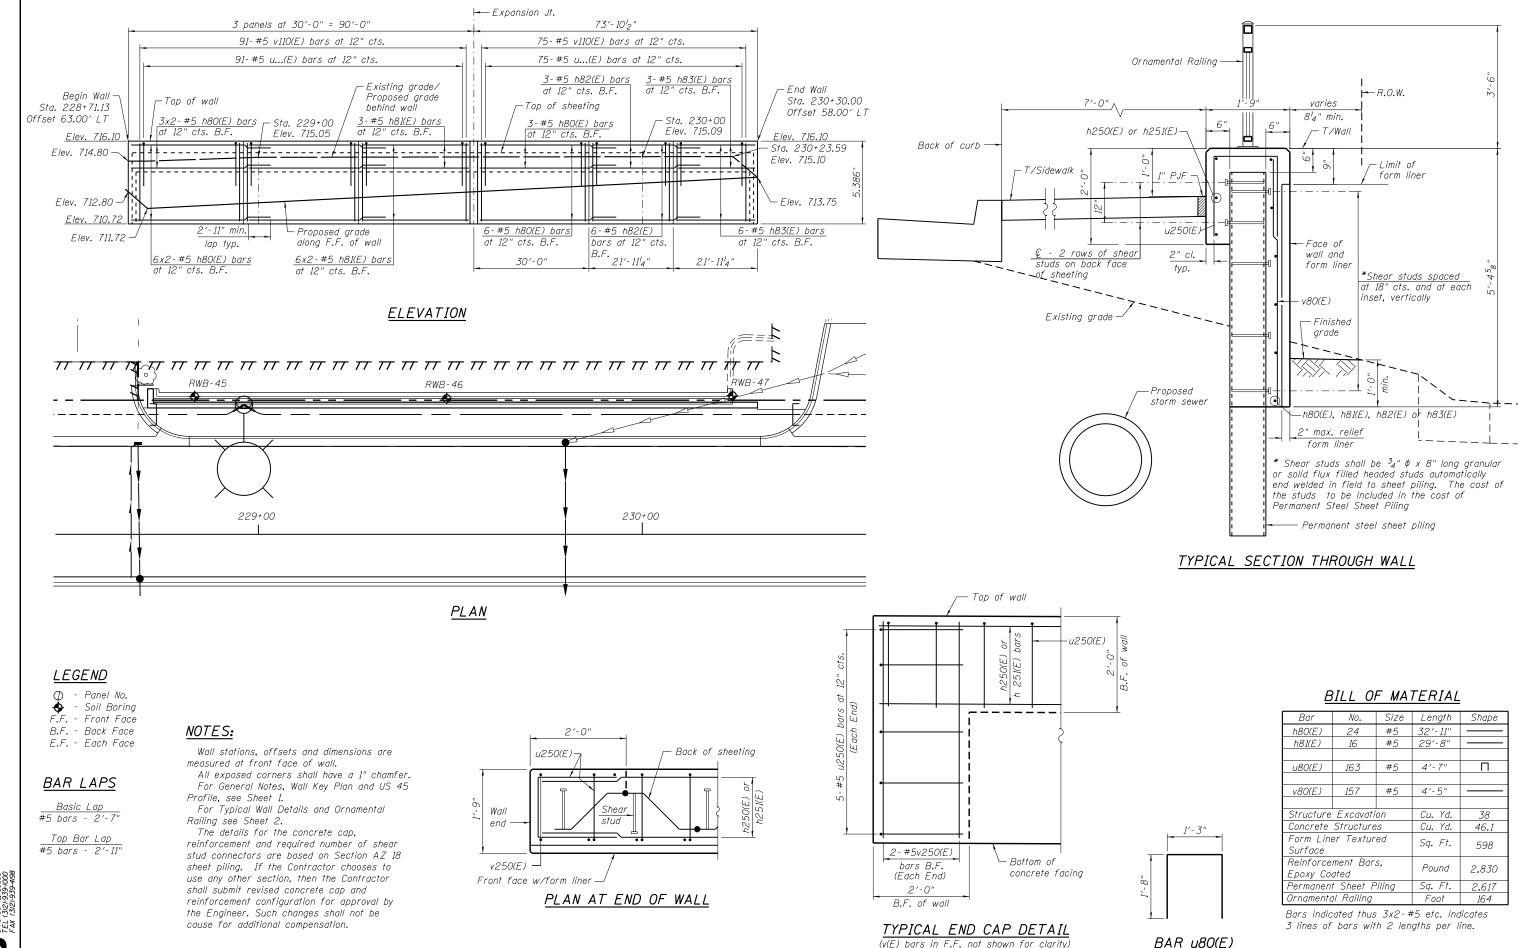

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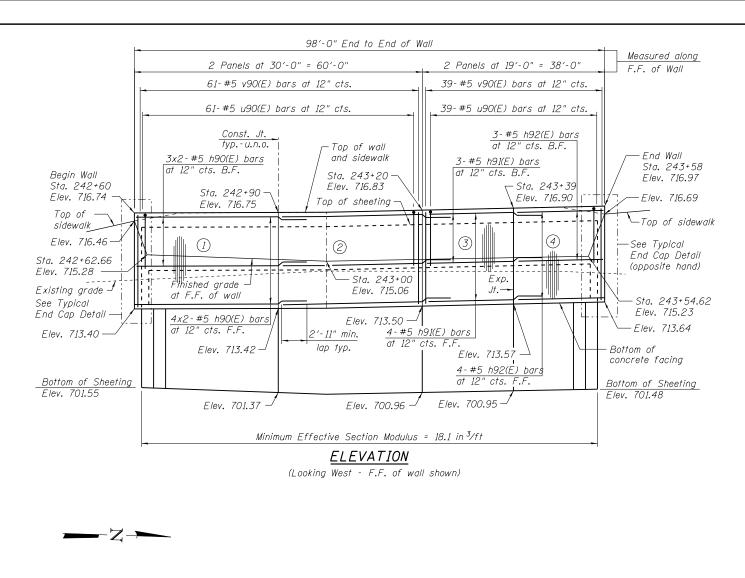
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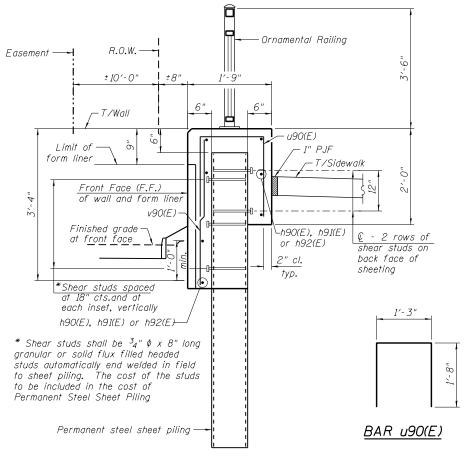
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STATE OF ILLINOIS **DEPARTMENT OF TRANSPORTATION** RETAINING WALL NO. 8 - S.N. 016-Z034 STA. 228 + 71.13 TO 230 + 30.00 SHEET NO. 8 OF 42 SHEETS

(v(E) bars in F.F. not shown for clarity)

SECTION COUNTY 330 103R-4 COOK 877 484 CONTRACT NO. 60M61





TYPICAL SECTION THROUGH WALL

BILL OF MATERIAL

Bar	No.	Size	Length	Shape
h90(E)	14	#5	32′-11"	
h91(E)	14	#5	18′-8"	
u90(E)	108	#5	4'-7"	
v90(E)	104	#5	3'-0"	
Structure Excavation		Cu. Yd.	20	
Concrete .	Structure	S	Cu. Yd.	21.2
Form Line	r Texture	ed	Sa. Ft.	241
Surface			04. / /.	
Reinforcement Bars,			Pound	1.600
Epoxy Coated			i odila	1,000
Permanent Sheet Piling		Sq. Ft.	1,480	
Ornamenta	I Railing		Foot	98


Bars indicated thus 4x2-#5 etc. indicates 4 lines of bars with 2 lengths per line.


NOTES:


Wall stations, offsets and dimensions are measured at front face of wall. All exposed corners shall have a 1" chamfer.

For General Notes, Wall Key Plan and US 45 Profile, see Sheet 1. For Typical Wall Details and O rnamental Railing see Sheet 2.

The details for the concrete cap, reinforcement and required number of shear stud connectors are based on Section AZ 18 sheet piling. If the Contractor chooses to use any other section, then the Contractor shall submit revised concrete cap and reinforcement configuration for approval by the Engineer. Such changes shall not be cause for additional compensation.

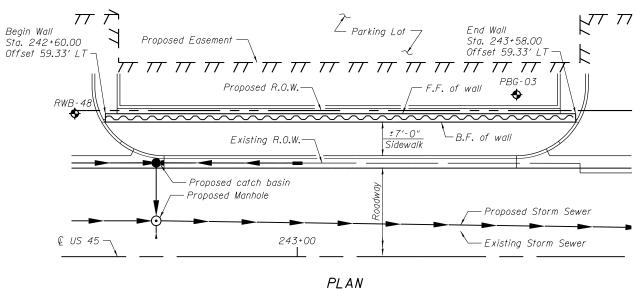

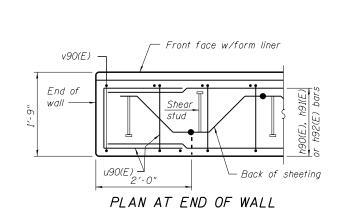

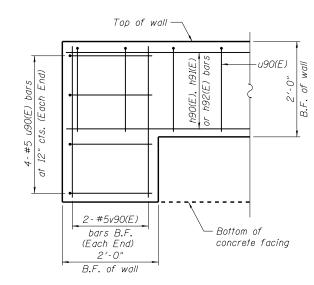

TYPICAL END CAP DETAIL

(v90(E) bars at F.F. not shown for clarity)

LEGEND

- Panel No. - Soil Boring F.F. - Front Face

B.F. - Back Face E.F. - Each Face

	Basic Lap
#5	bars - 2'-7"

Top Bar Lap #5 bars - 2'-11"

BAR LAPS


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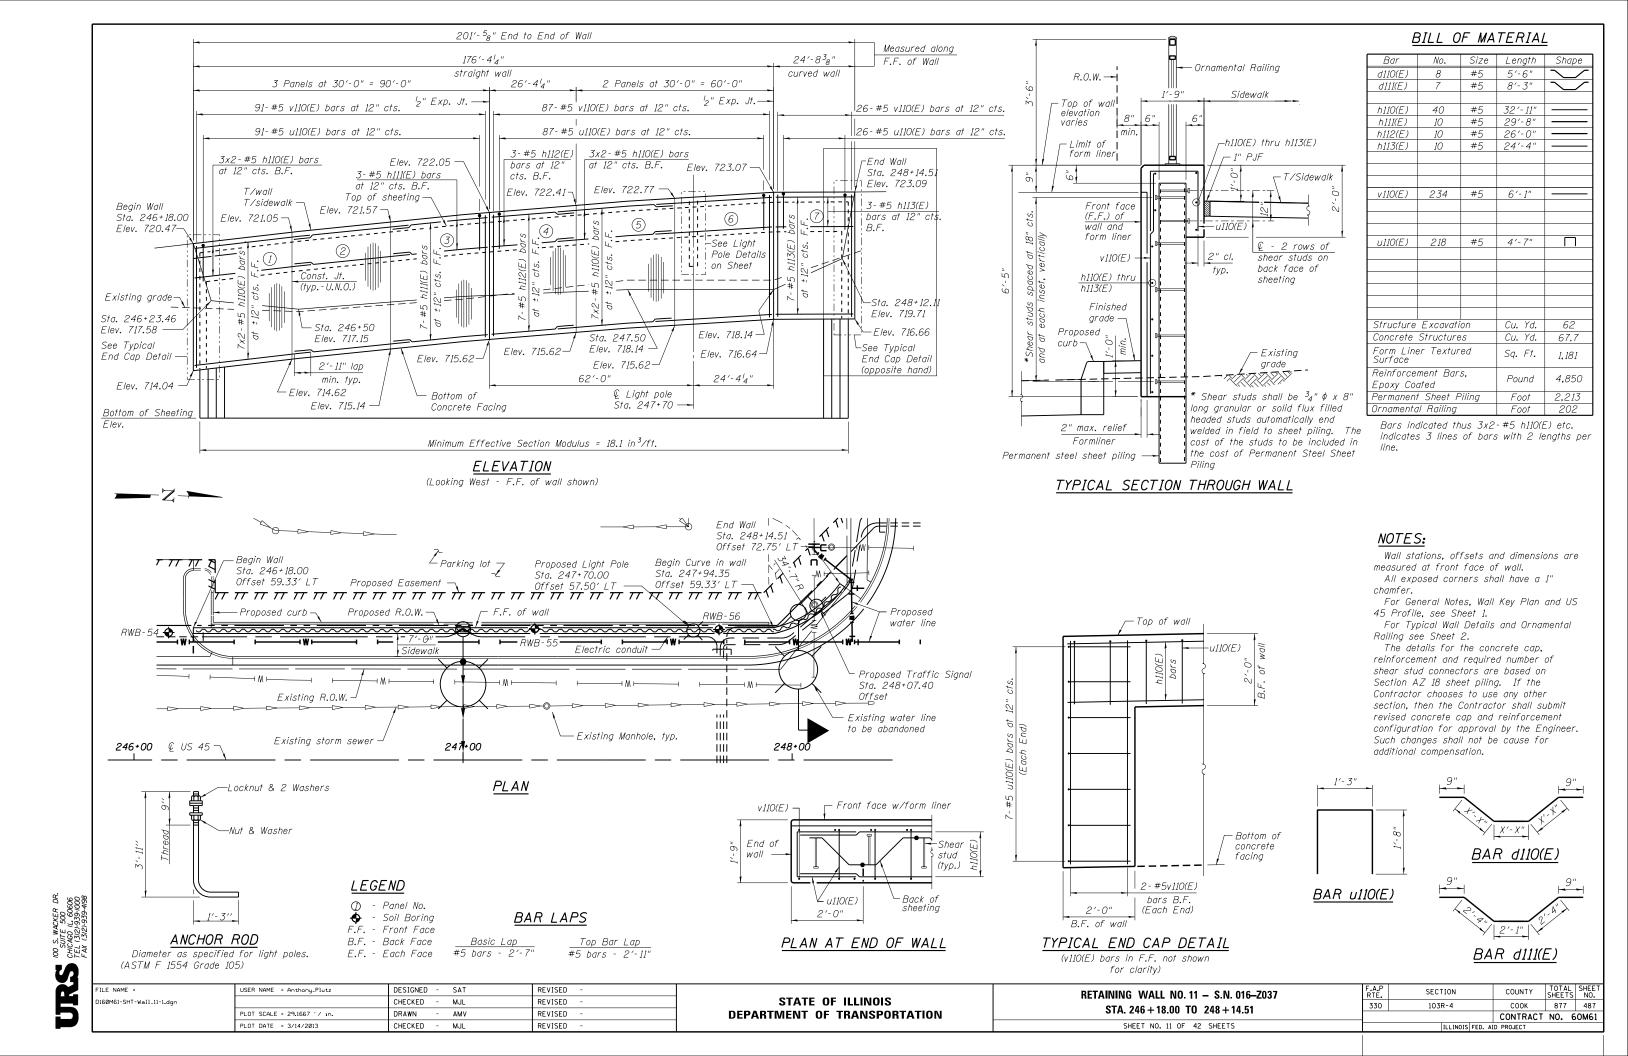
USER NAME = Anthony_Plutz	DESIGNED	-	SAT	REVISED -
	CHECKED	-		REVISED -
PLOT SCALE = 20.0000 '/ in.	DRAWN	-	SAT	REVISED -
PLOT DATE = 3/14/2013	CHECKED	-	MJL	REVISED -


STATE OF ILLINOIS **DEPARTMENT OF TRANSPORTATION**

RETAINING WALL NO. 9 - S.N. 016-Z035 STA. 242+60.00 TO 243+58.00	
SHEET NO. 9 OF 42 SHEETS	

F.A.P RTE.	SECTION		COUNTY	TOTAL SHEETS	SHEET NO.
330	103R-4		COOK	877	485
			CONTRACT	NO. 6	ом61
	ILLINOIS	FED. A	ID PROJECT		



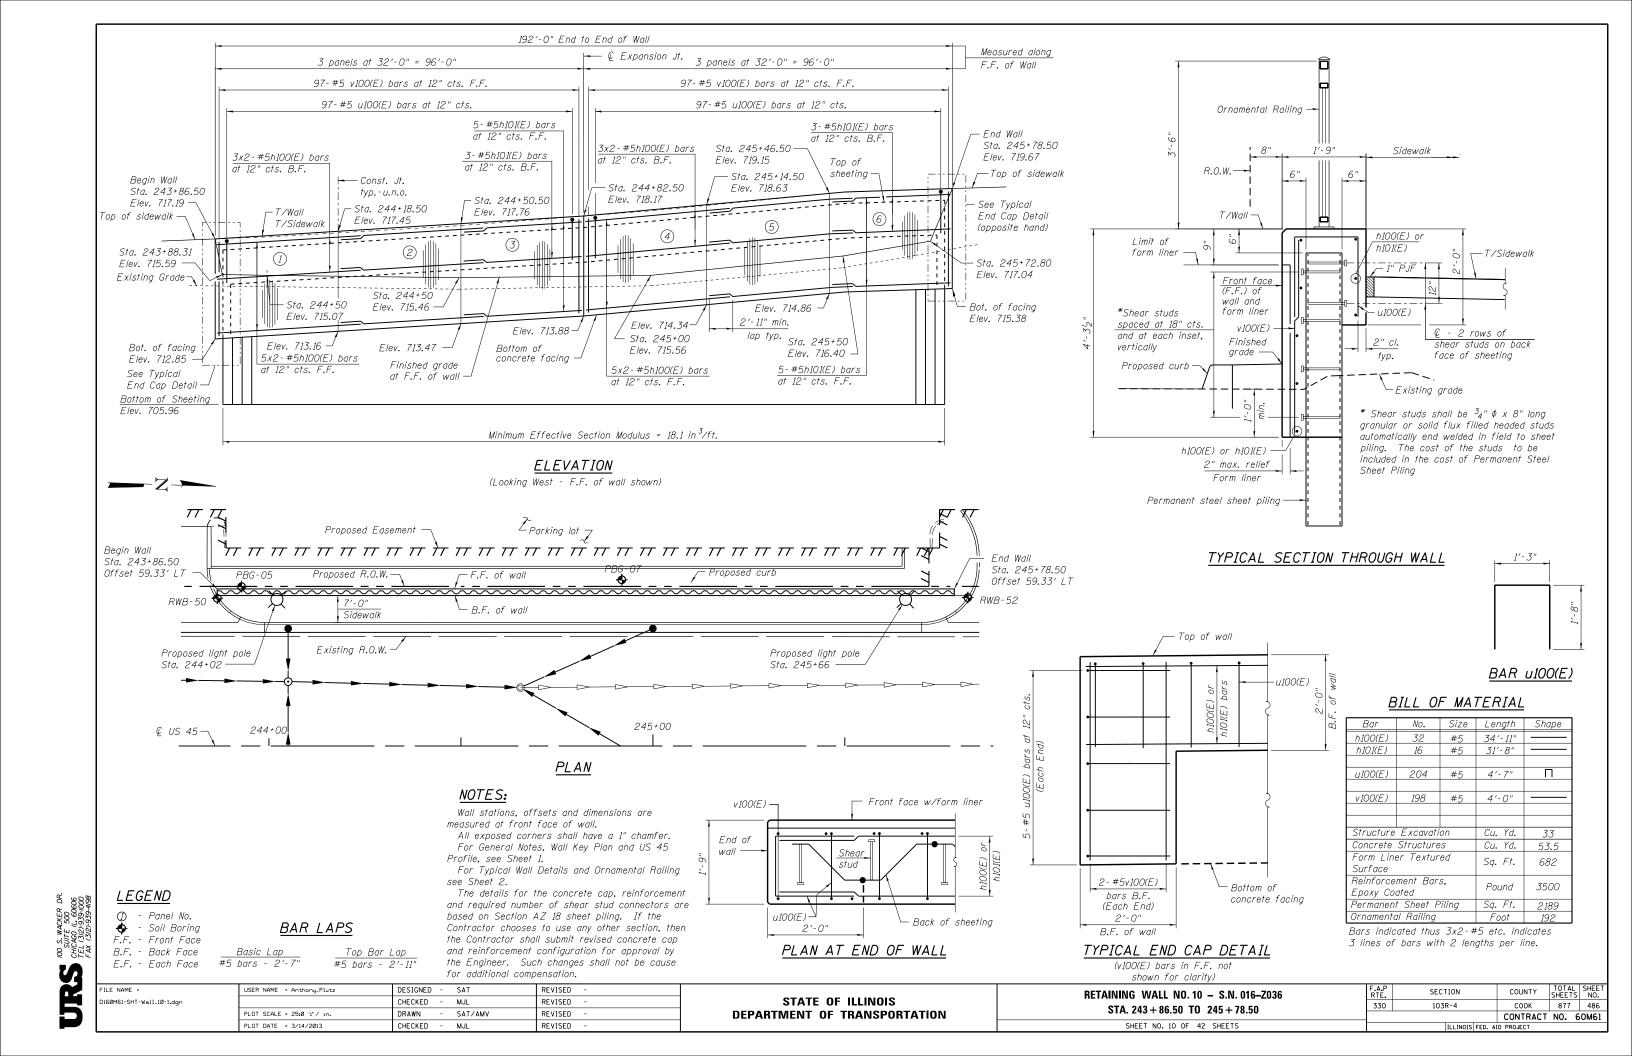

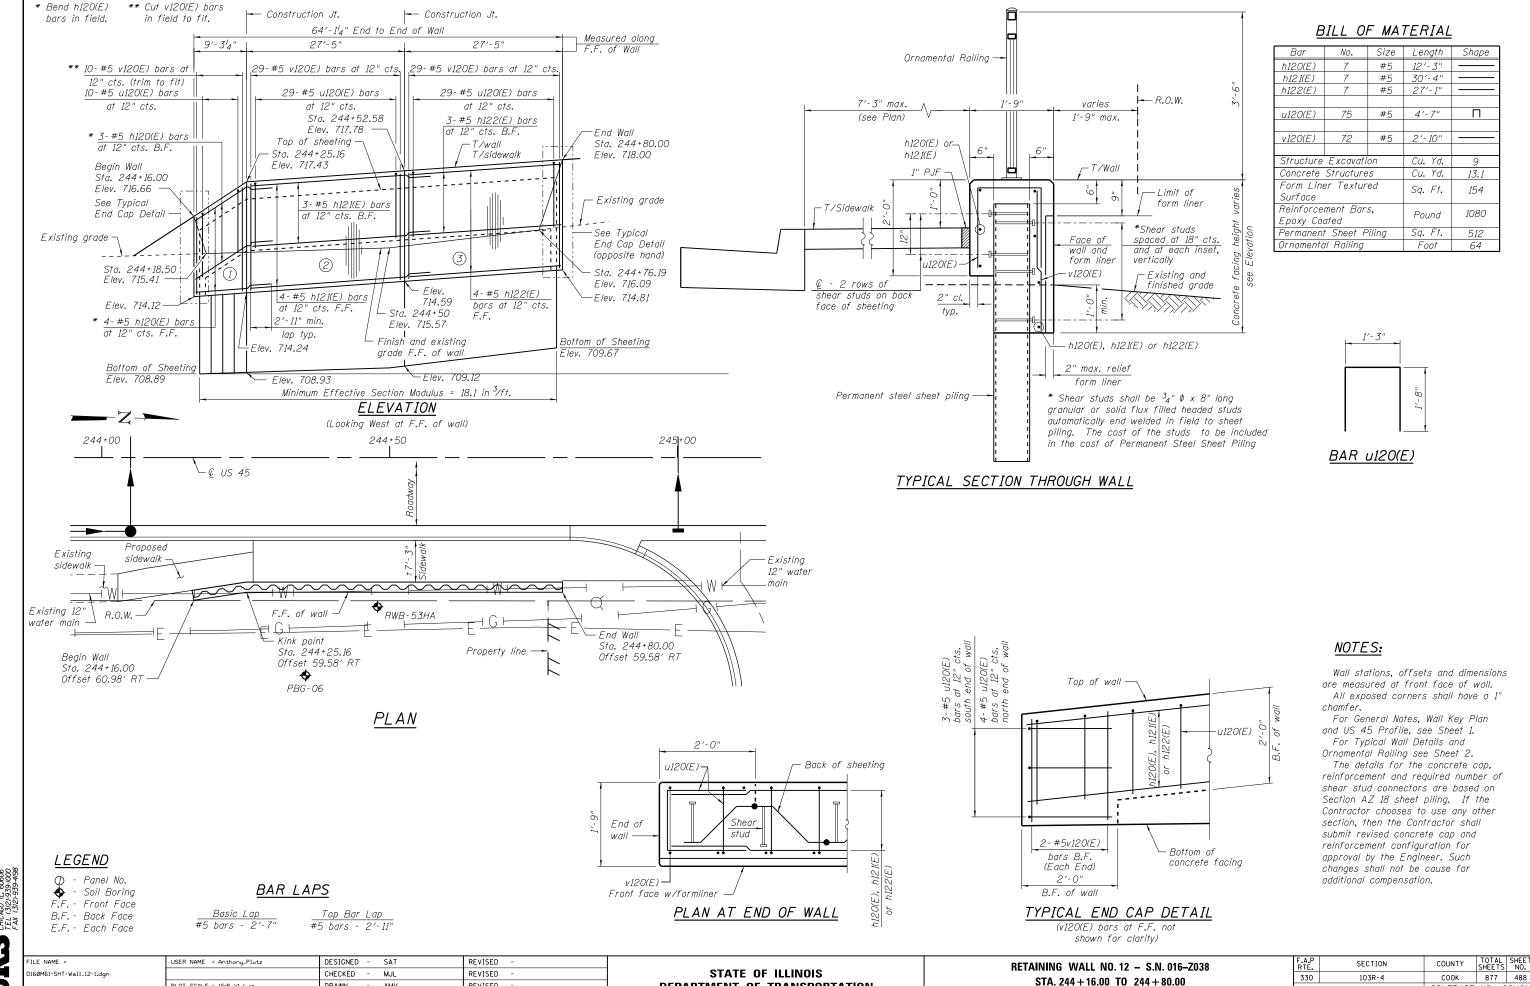

DEPARTMENT OF TRANSPORTATION

SHEET NO. 12 OF 42 SHEETS

CONTRACT NO. 60M61

PLOT SCALE = 16:8 ':" / in.

PLOT DATE = 3/14/2013


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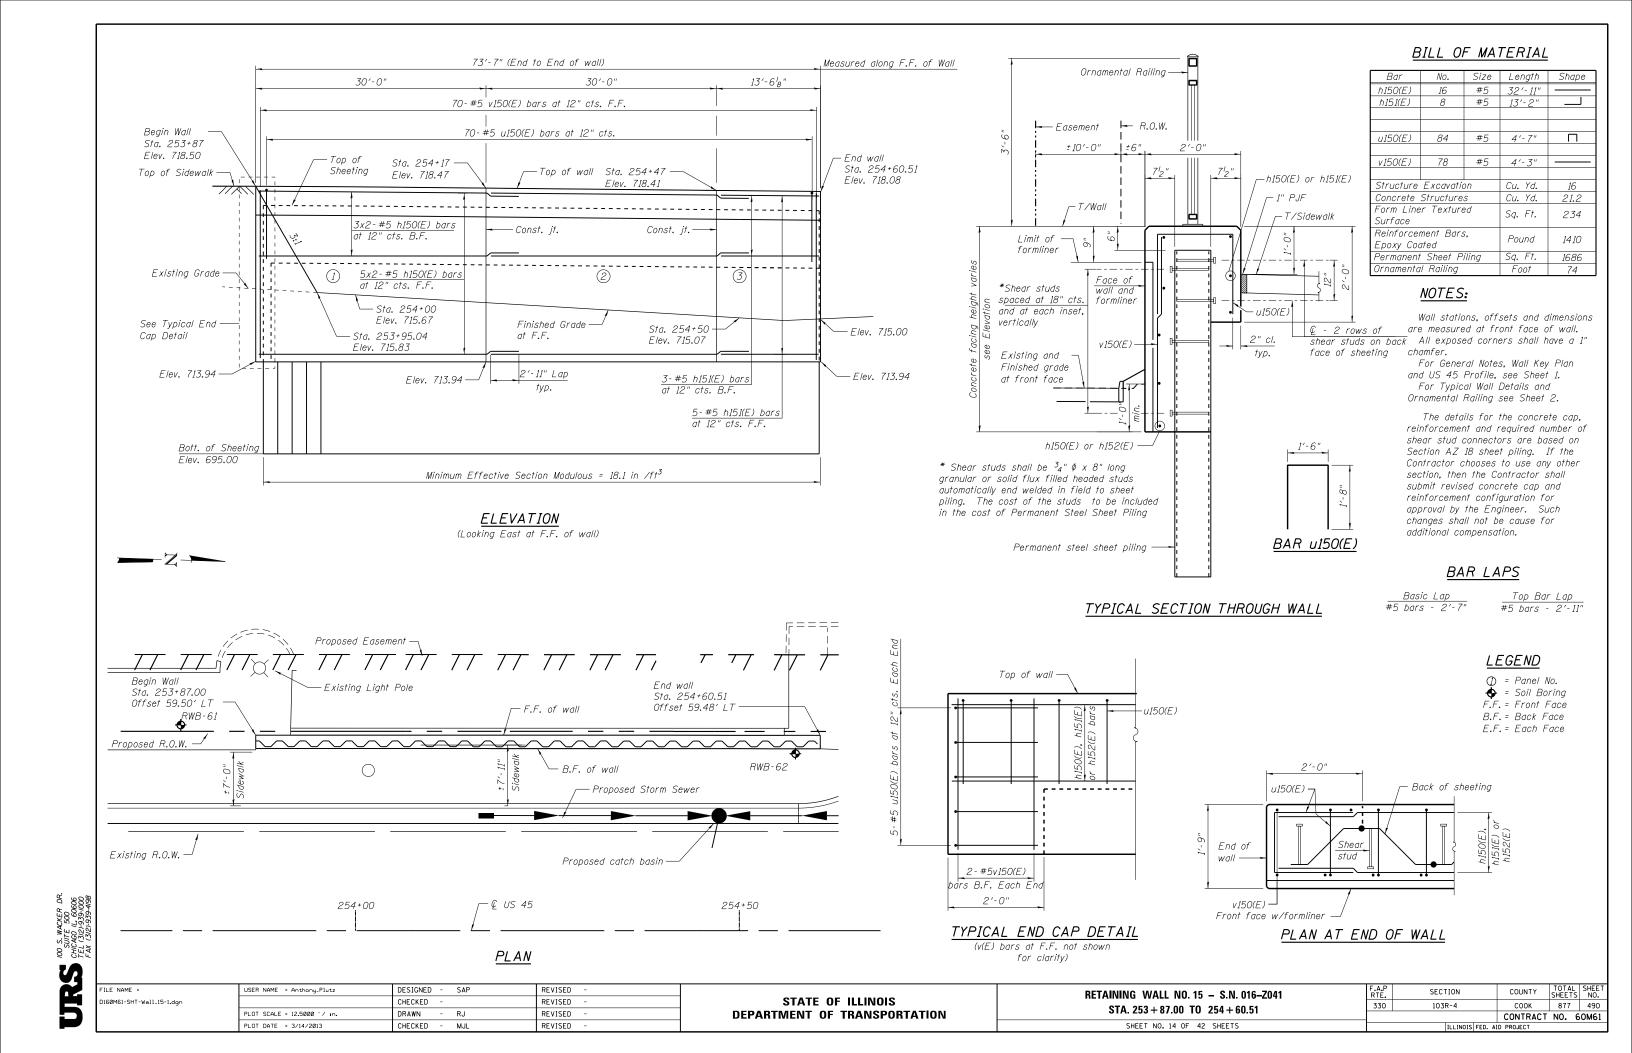
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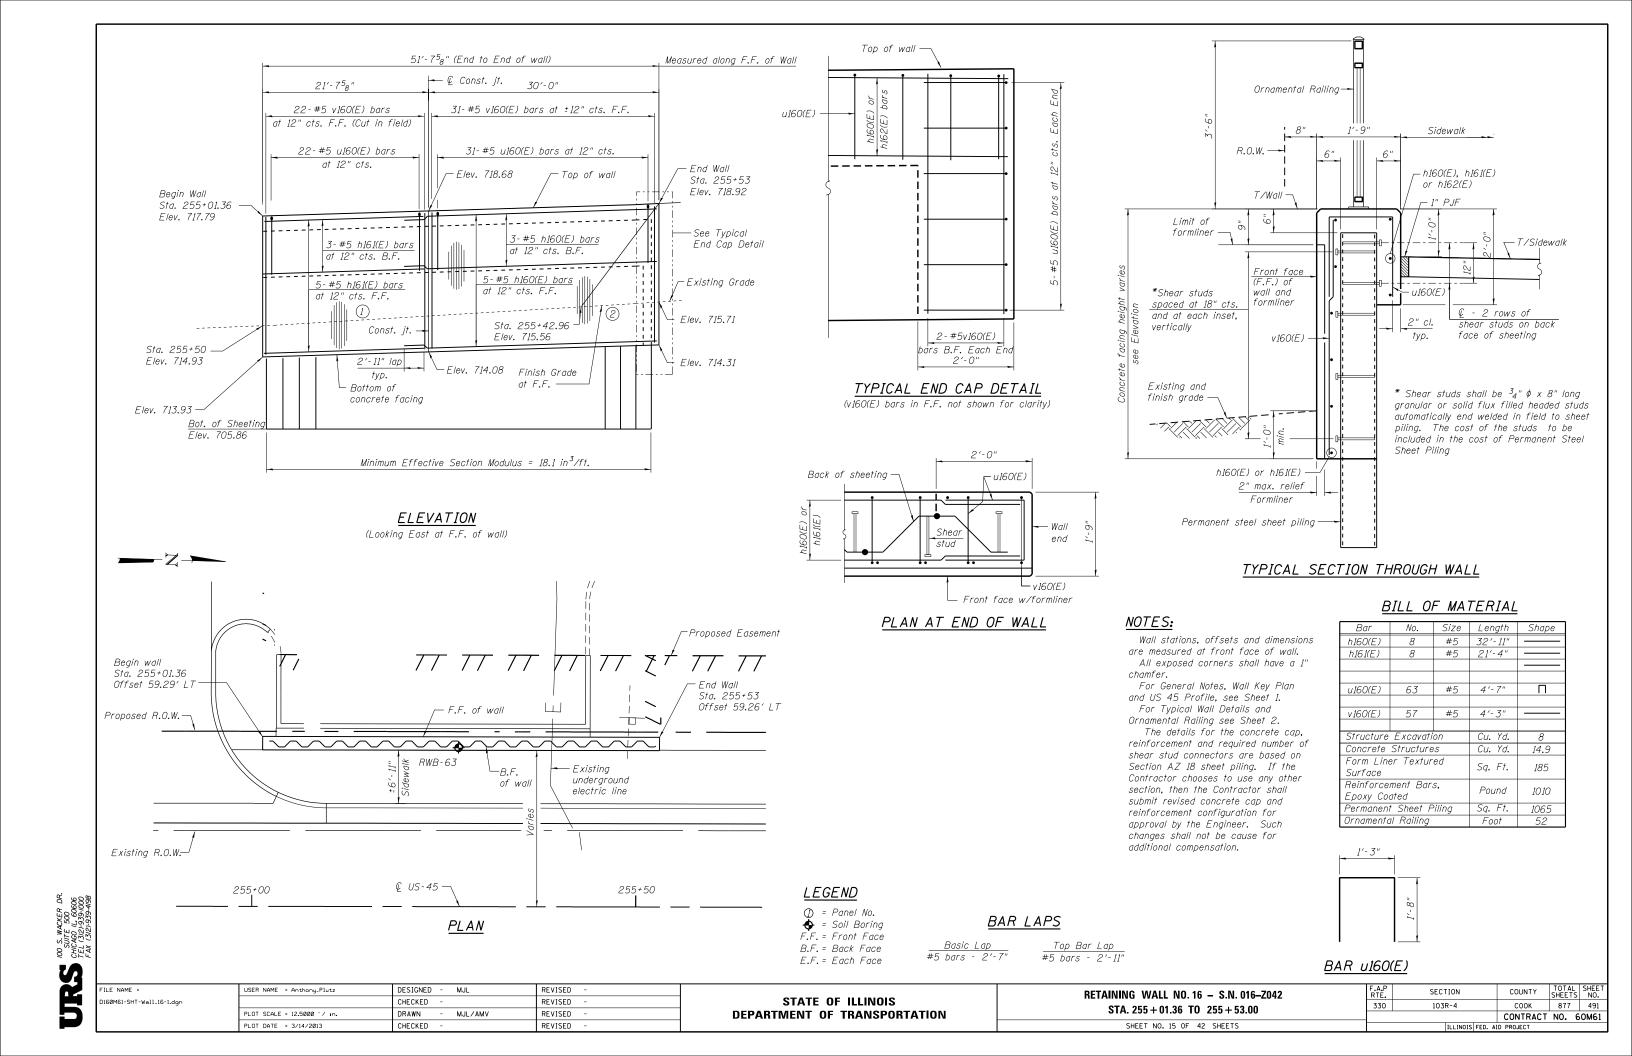
AMV


MJL


REVISED







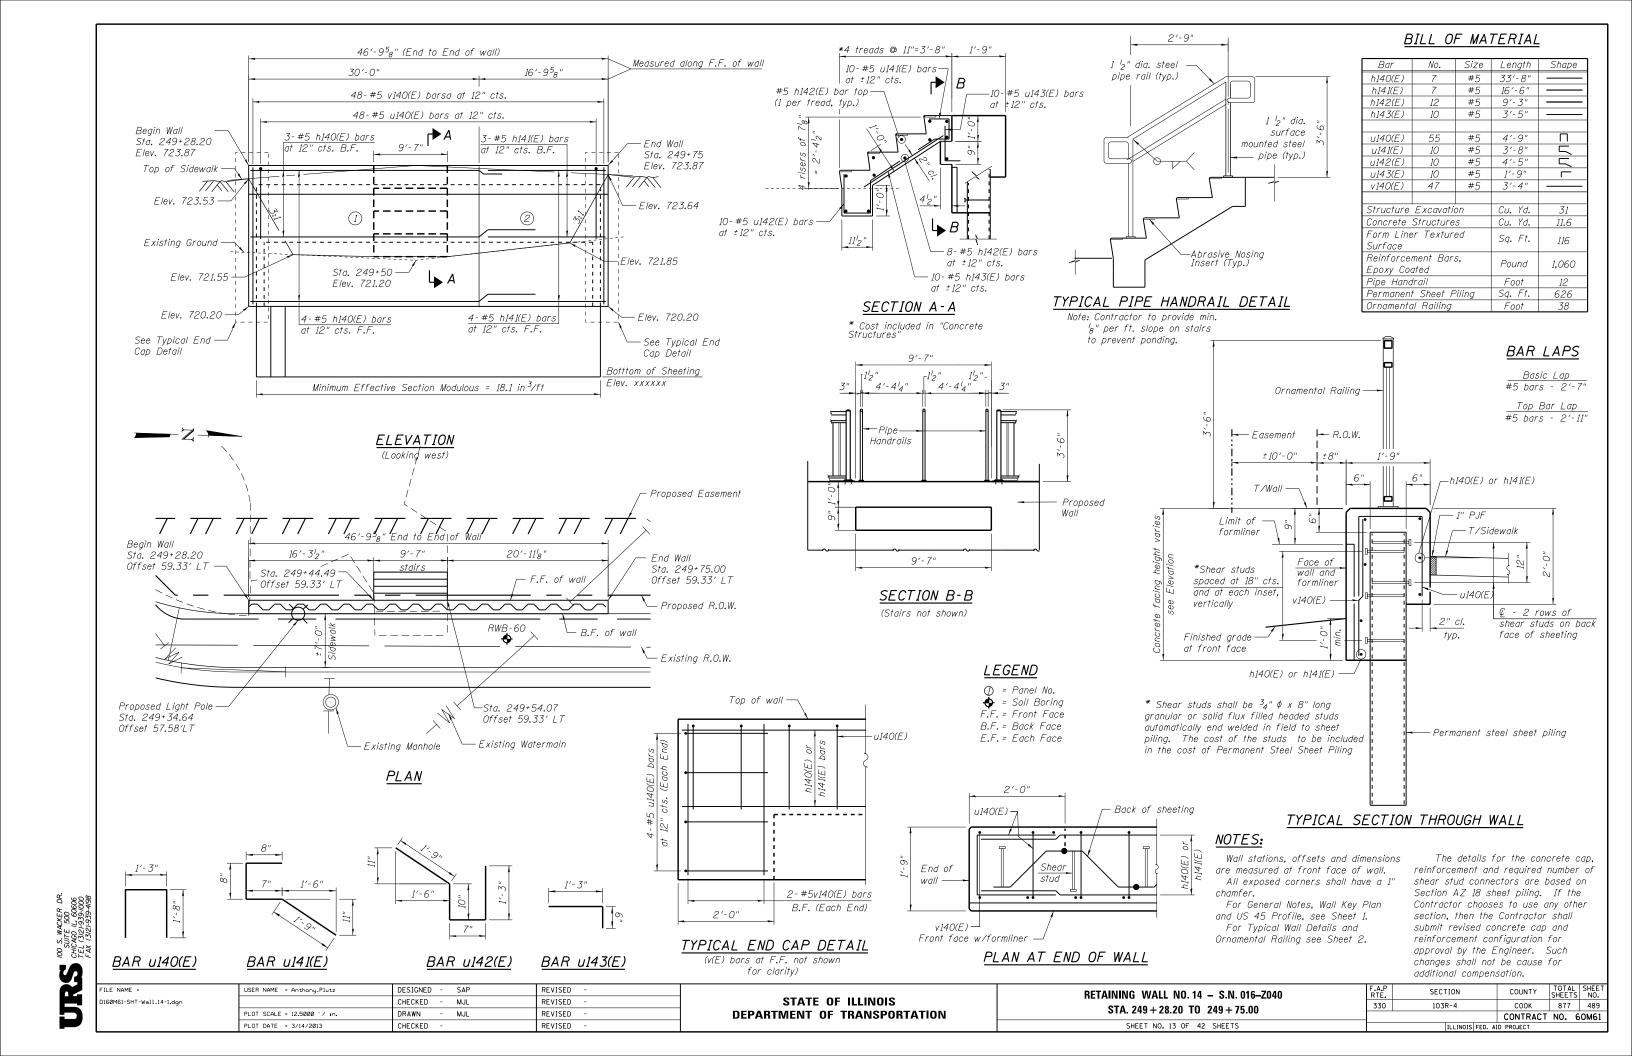

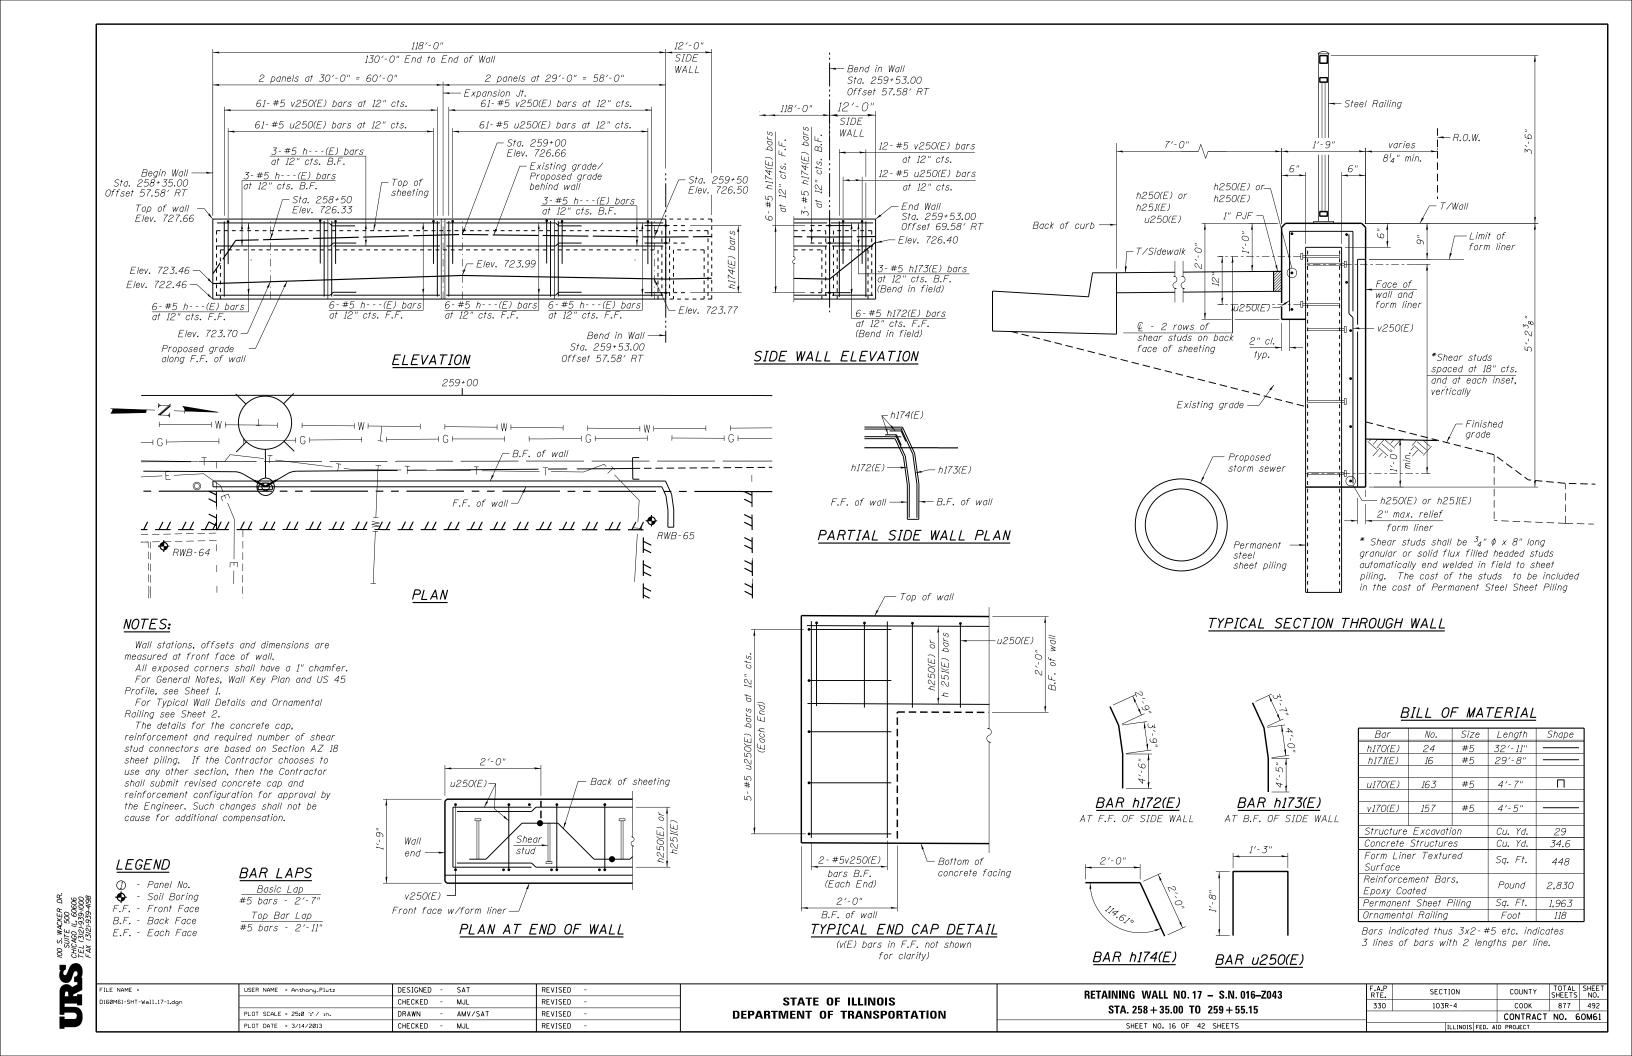


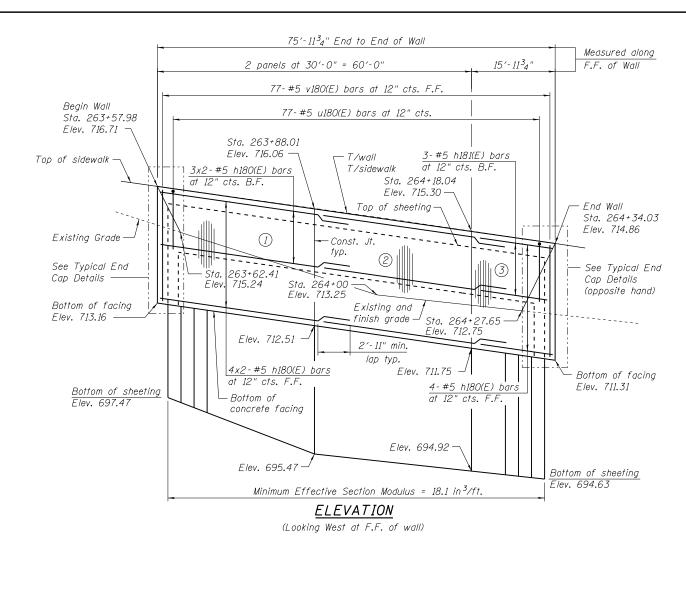

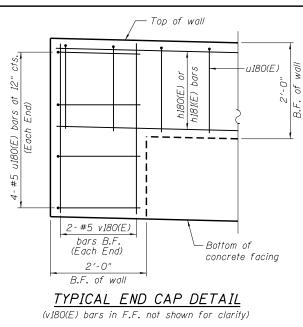


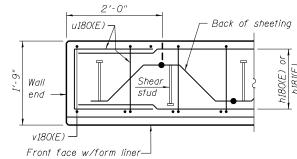

PLAN AT END OF WALL

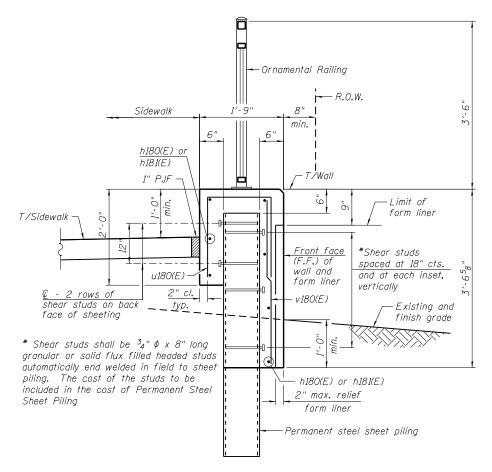

TYPICAL SECTION THROUGH WALL

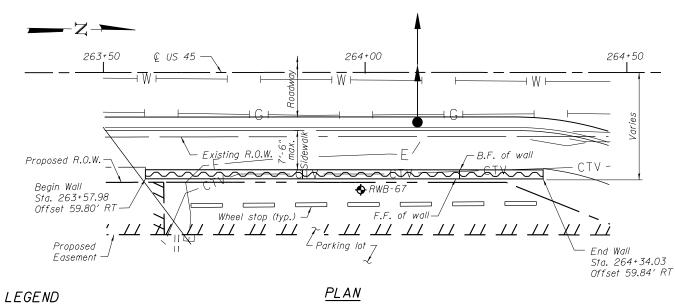


NOTES:

Wall stations, offsets and dimensions are measured at front face of wall. All exposed corners shall have a 1" chamfer.

For General Notes, Wall Key Plan and US 45 Profile, see Sheet 1. For Typical Wall Details and Ornamental Railing see Sheet 2.

The details for the concrete cap, reinforcement and required number of shear stud connectors are based on Section AZ 18 sheet piling. If the Contractor chooses to use any other section, then the Contractor shall submit revised concrete cap and reinforcement configuration for approval by the Engineer. Such changes shall not be cause for additional compensation.

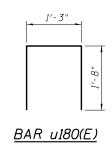

BAR LAPS

Basic Lap #5 bars - 2'-7"

Top Bar Lap #5 bars - 2'-11"

BILL OF MATERIAL

_				
Bar	No.	Size	Length	Shape
h180(E)	14	#5	32'-11"	
h181(E)	7	#5	15′-6"	
u180(E)	85	#5	4'-7"	П
v180(E)	81	#5	3'-4"	
Structure Excavation		Cu. Yd.	24	
Concrete Structures		Cu. Yd.	17.5	
Form Liner Textured		Sq. Ft.	213	
Surface		- 4		
Reinforcement Bars,		Pound	1290	
poxy Coated				
Permanent Sheet Piling		Sq. Ft.	1499	
Ornamento	al Railing		Foot	76

Bars indicated thus 4x2-#5 etc. indicates 4 lines of bars with 2 lengths per line.




- Panel No.


- Soil Boring F.F. - Front Face B.F. - Back Face E.F. - Each Face

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		1		
		-	5	

FILE NAME =	USER NAME = Anthony_Plutz	DESIGNED - SAT	REVISED -
D160M61-SHT-Wall_18-1.dgn		CHECKED - MJL	REVISED -
	PLOT SCALE = 18.33 ' / in.	DRAWN - AMV	REVISED -
	PLOT DATE = 3/14/2013	CHECKED - MJL	REVISED -

A.P RTE.	SECTION		COUNTY	TOTAL SHEETS	SHEET NO.		
330	103R-4		соок	877	493		
			CONTRACT	NO. 6	OM61		
ILLINOIS FED. AID PROJECT							

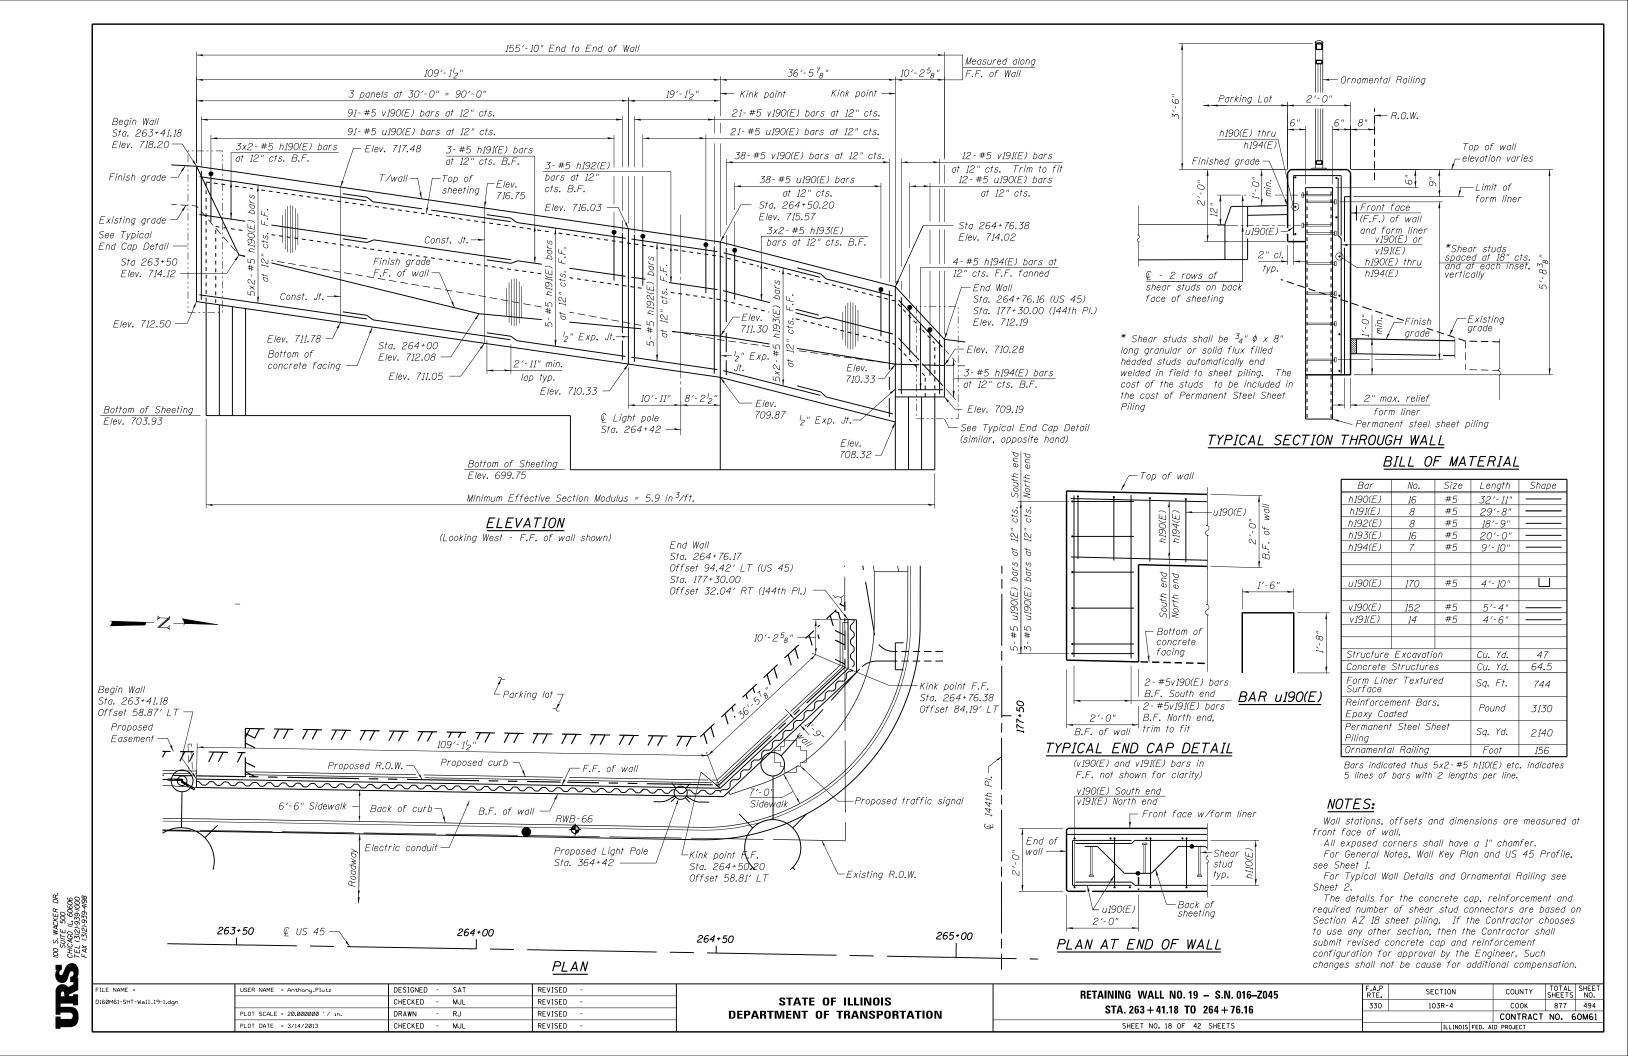

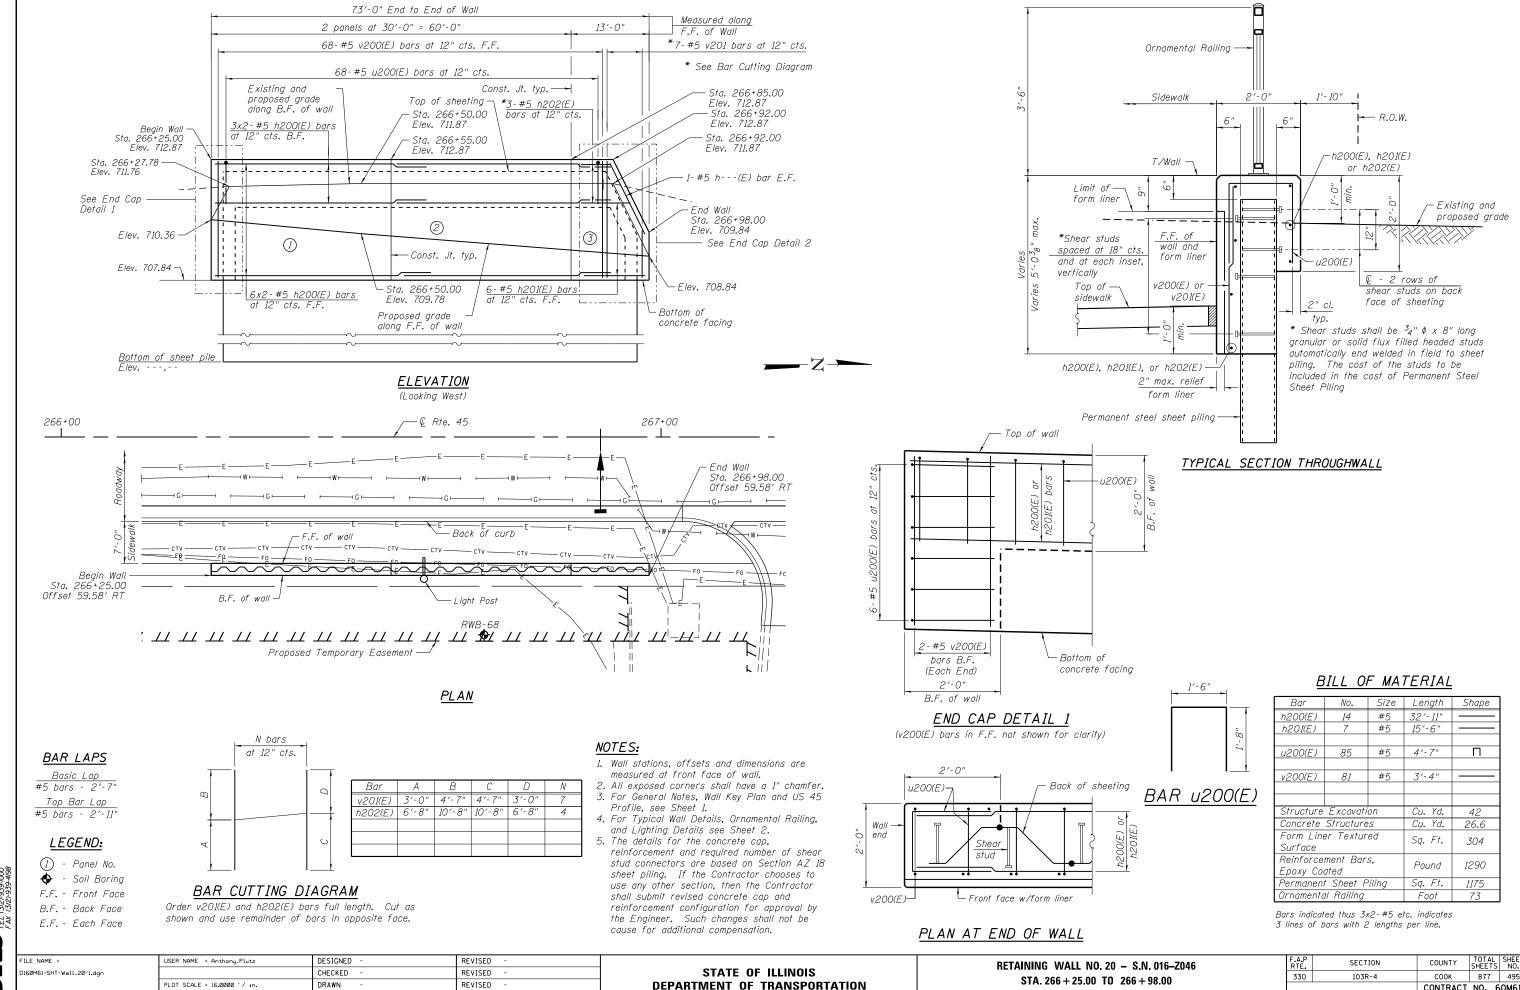



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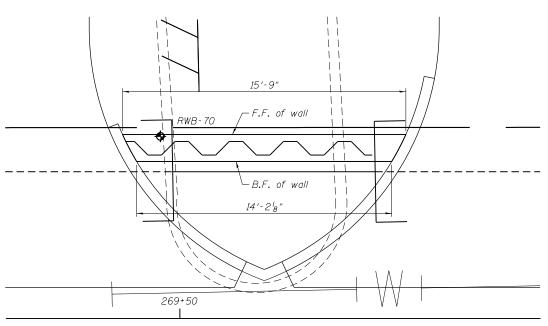
SHEET NO. 19 OF 42 SHEETS

PLOT DATE = 3/14/2013


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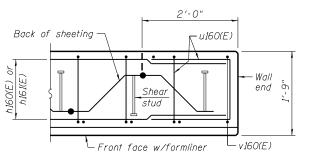


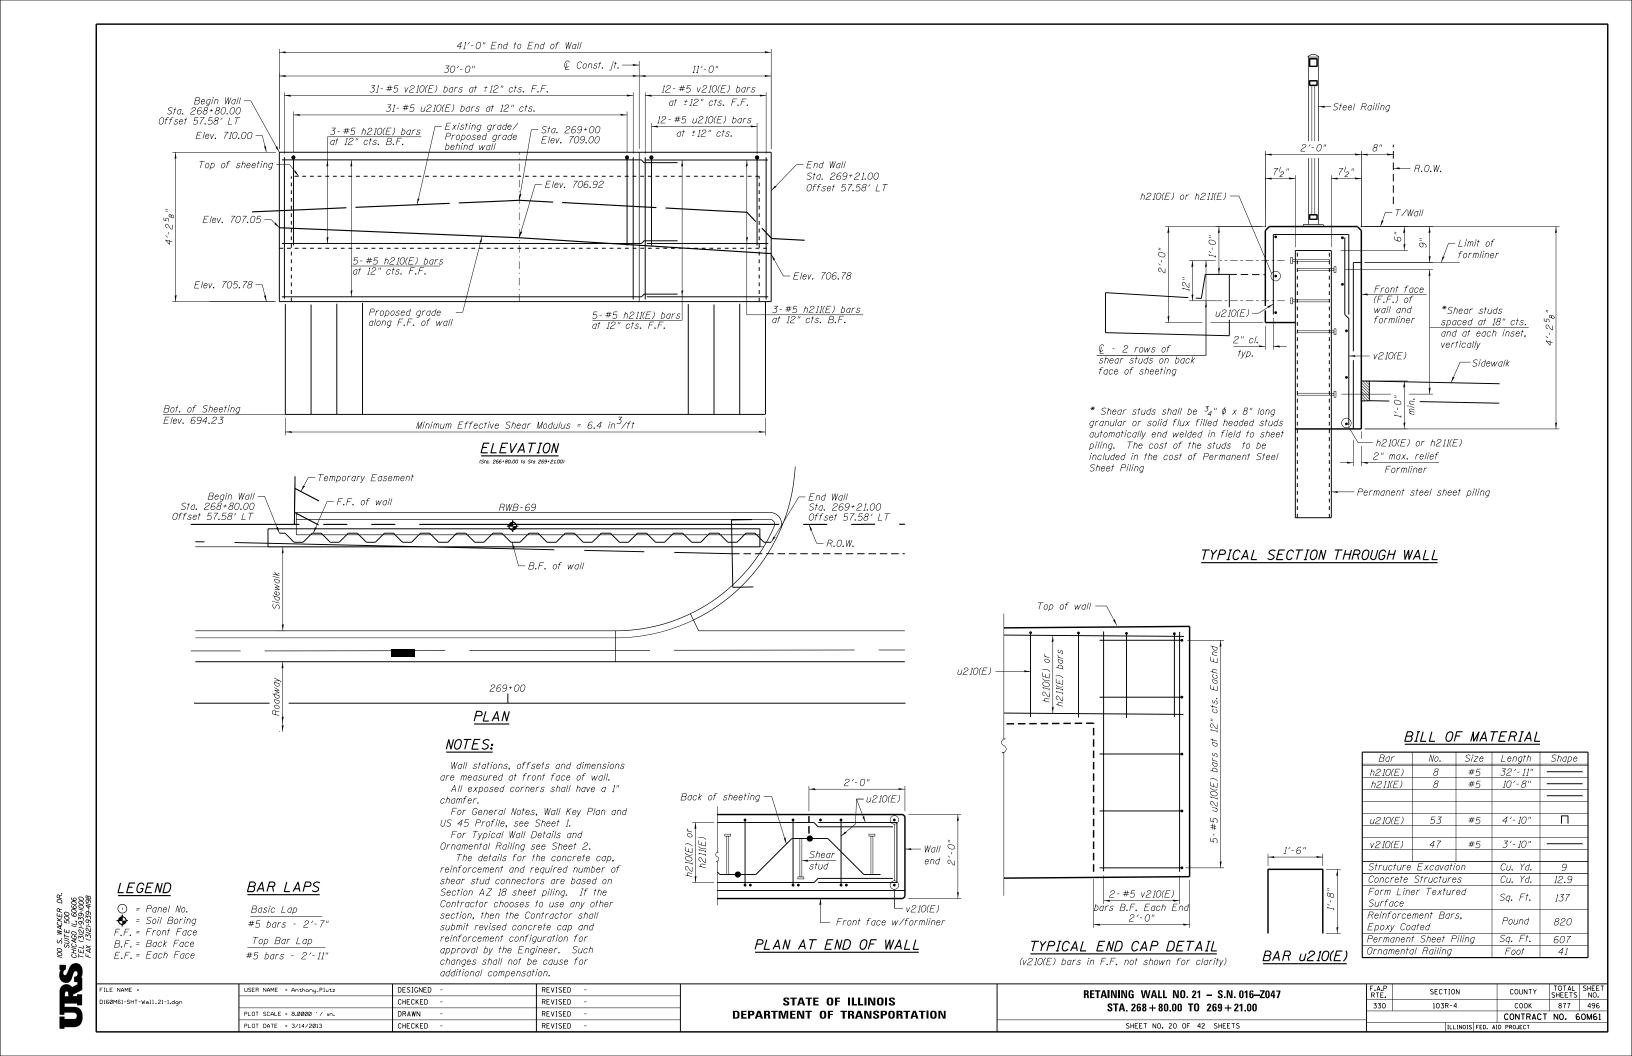


PLAN

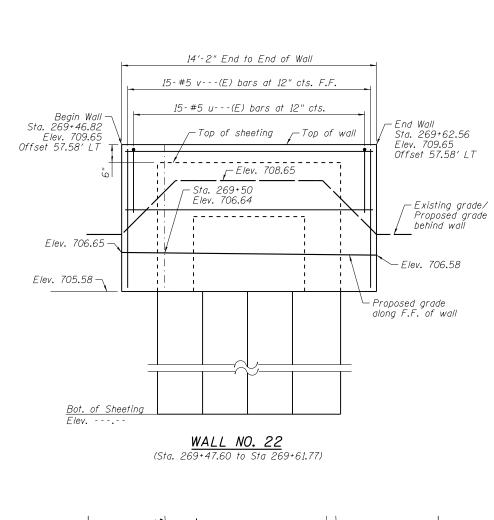

TYPICAL END CAP DETAIL (v160(E) bars in F.F. not shown for clarity)

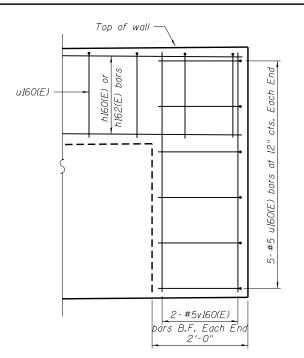

PLAN AT END OF WALL

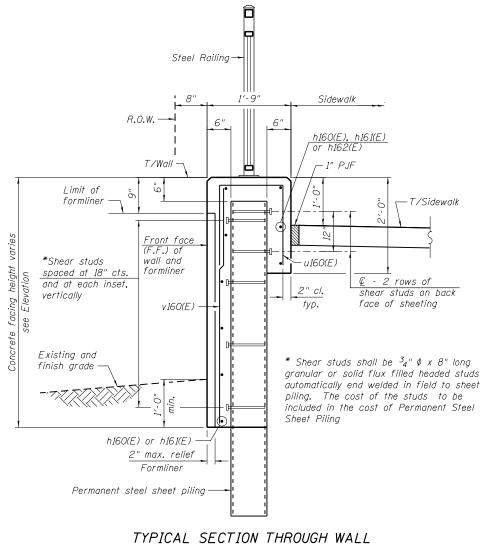


NOTES:

Wall stations, offsets and dimensions are measured at front face of wall. All exposed corners shall have a 1" chamfer.

For General Notes, Wall Key Plan and US 45 Profile, see Sheet 1. For Typical Wall Details and Ornamental Railing see Sheet 2.

The details for the concrete cap, reinforcement and required number of shear stud connectors are based on Section AZ 18 sheet piling. If the Contractor chooses to use any other section, then the Contractor shall submit revised concrete cap and reinforcement configuration for approval by the Engineer. Such changes shall not be cause for additional compensation.

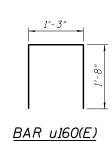

BILL OF MATERIAL

Bar	No.	Size	Length	Shape
			32'-11"	Отпарт
h220(E)	6	#5		-
h221(E)	6	#5	21'-4"	
				-
u220(E)	21	#5	4'-7"	
v220(E)	19	#5	4'-3"	
			_	
Structure Excavation		Cu. Yd.	3	
Concrete Structures		Cu. Yd.	5.0	
Form Liner Textured Surface		Sq. Ft.	62	
Reinforcement Bars, Epoxy Coated		Pound	530	
Permanent Sheet Piling		Sq. Ft.	355	
Ornamental Railing		Foot	15	

LEGEND



Basic Lap #5 bars - 2'-7" E.F. = Each Face

BAR LAPS

Top Bar Lap #5 bars - 2'-11"


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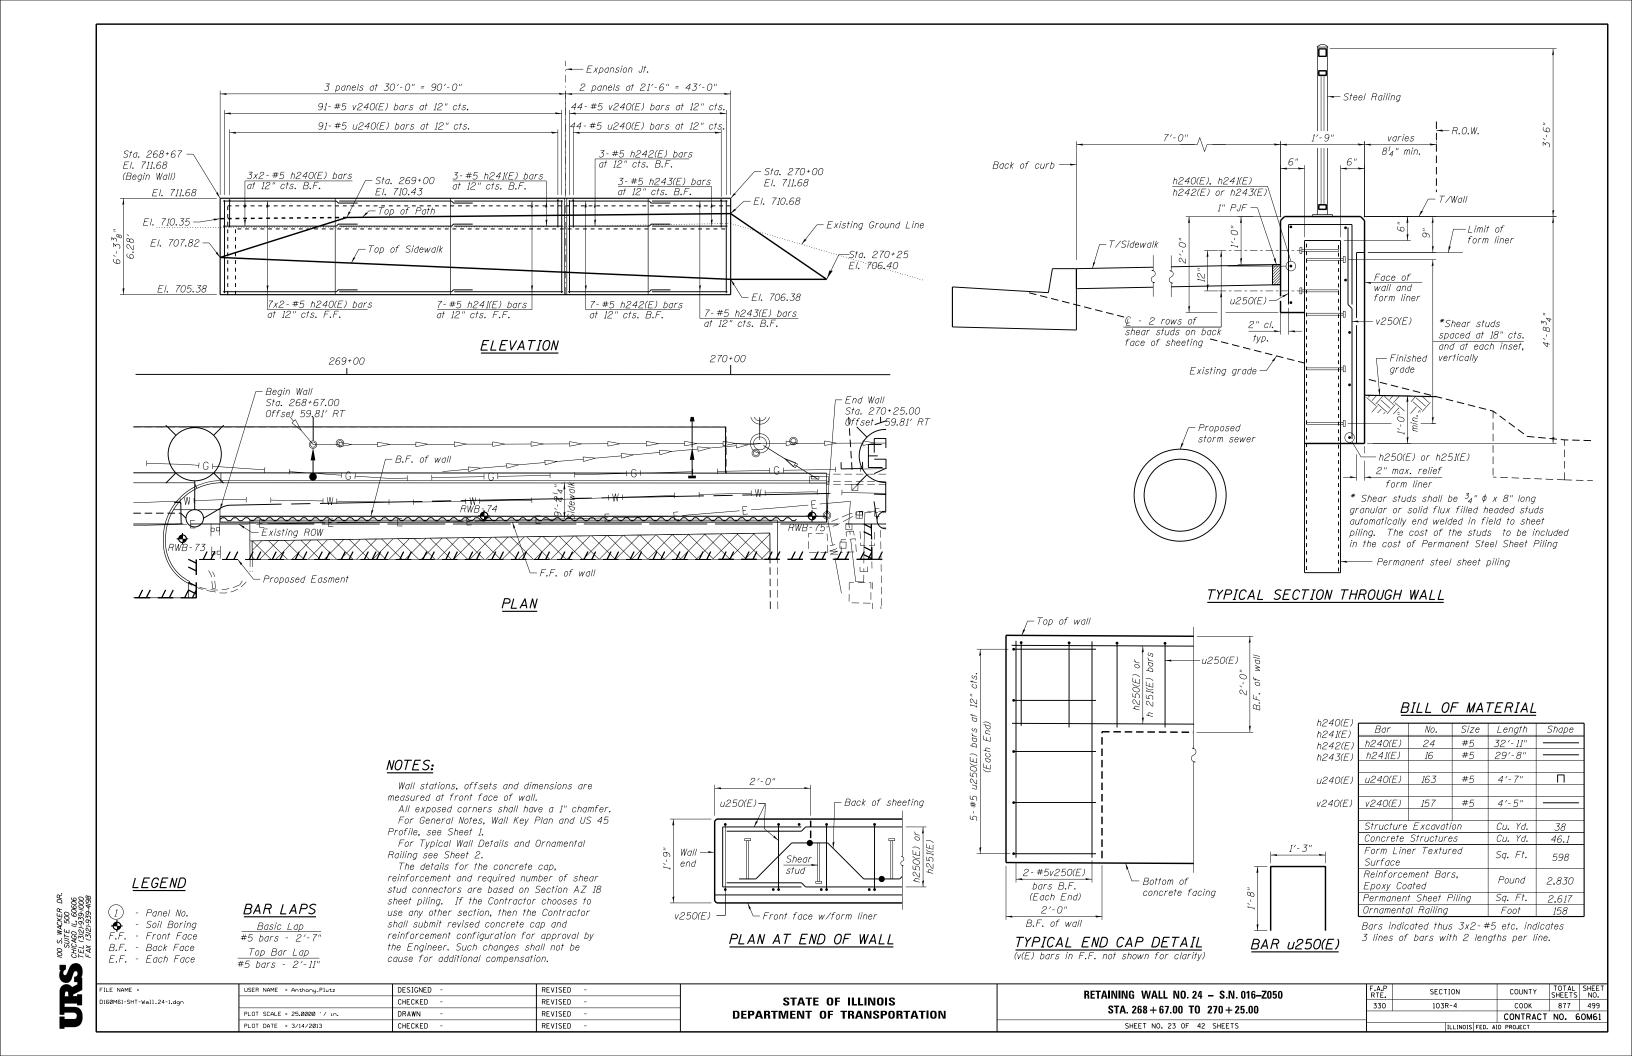
USER NAME = Anthony_Plutz	DESIGNED -	REVISED -	
	CHECKED -	REVISED -	
PLOT SCALE = 5.333 ' / in.	DRAWN -	REVISED -	
PLOT DATE = 3/14/2013	CHECKED -	REVISED -	


RETAINING WALL NO. 22 - S.N. 016-Z048 STA. 269 + 46.82 TO 269 + 62.56 SHEET NO. 21 OF 42 SHEETS

F.A.P RTE.	SECTION	COUNTY	TOTAL SHEETS	SHEET NO.
330	103R-4	COOK	877	497
CONTRACT NO. 60M				
ILLINOIS FED. AID PROJECT				

STATE OF ILLINOIS				
DEPARTMENT OF	TRANSPORTATION			



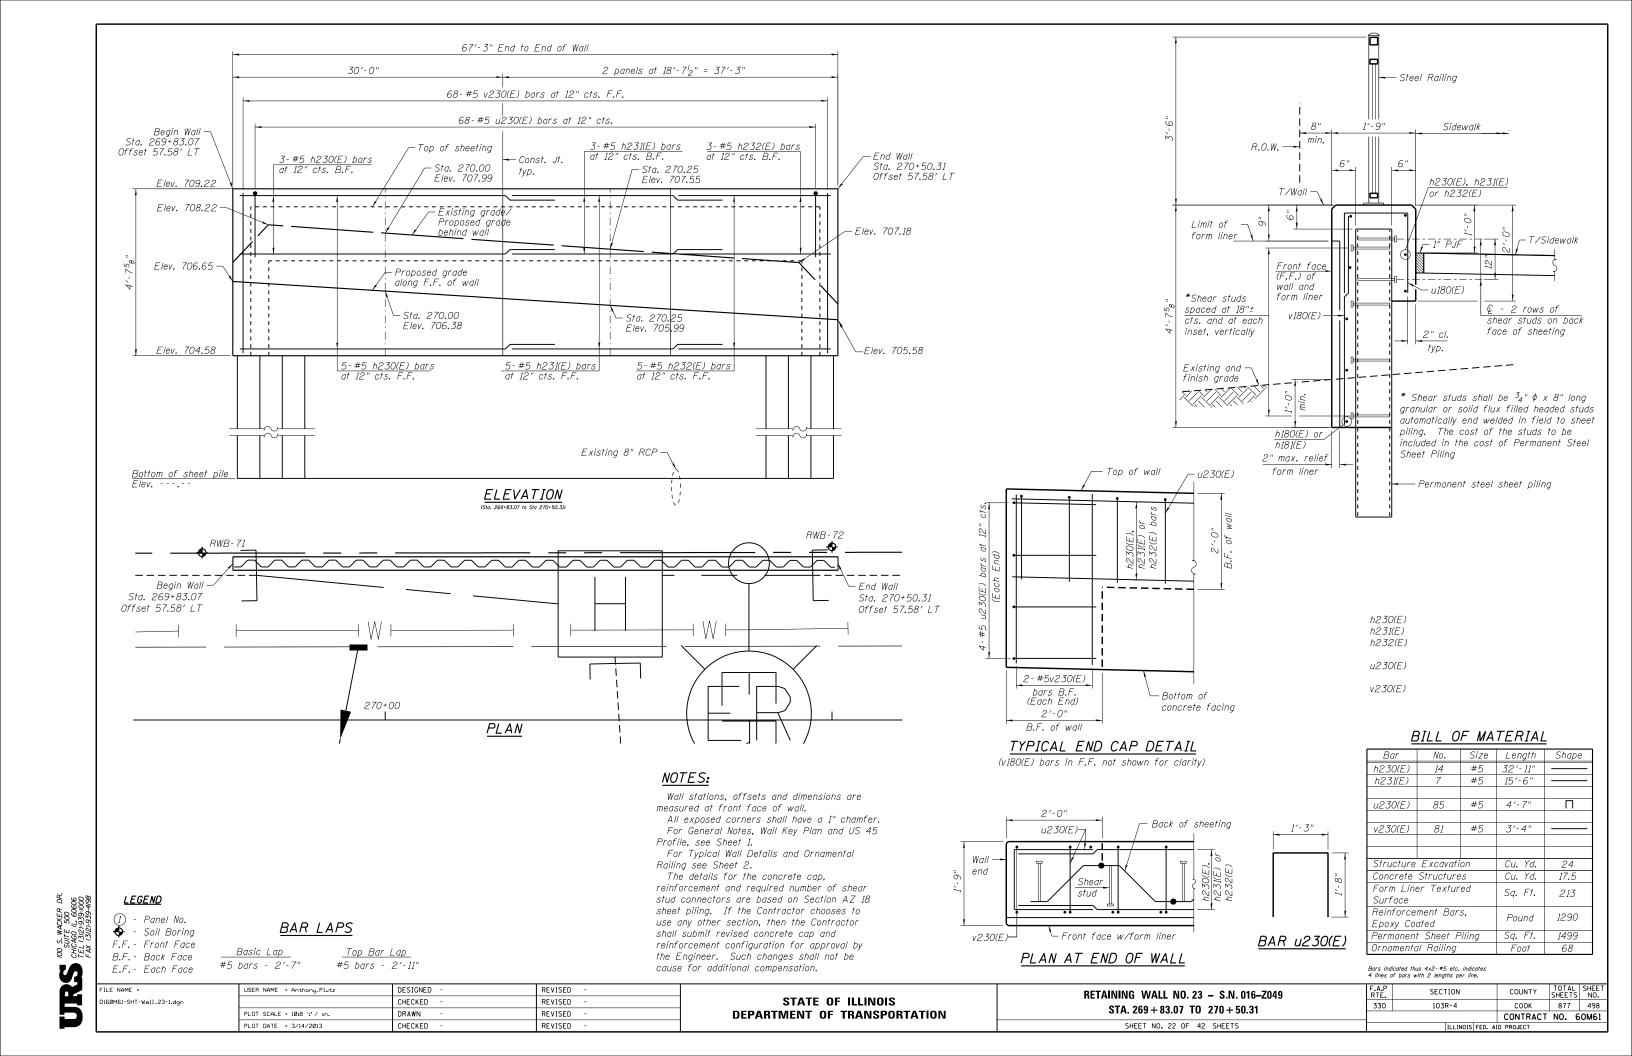

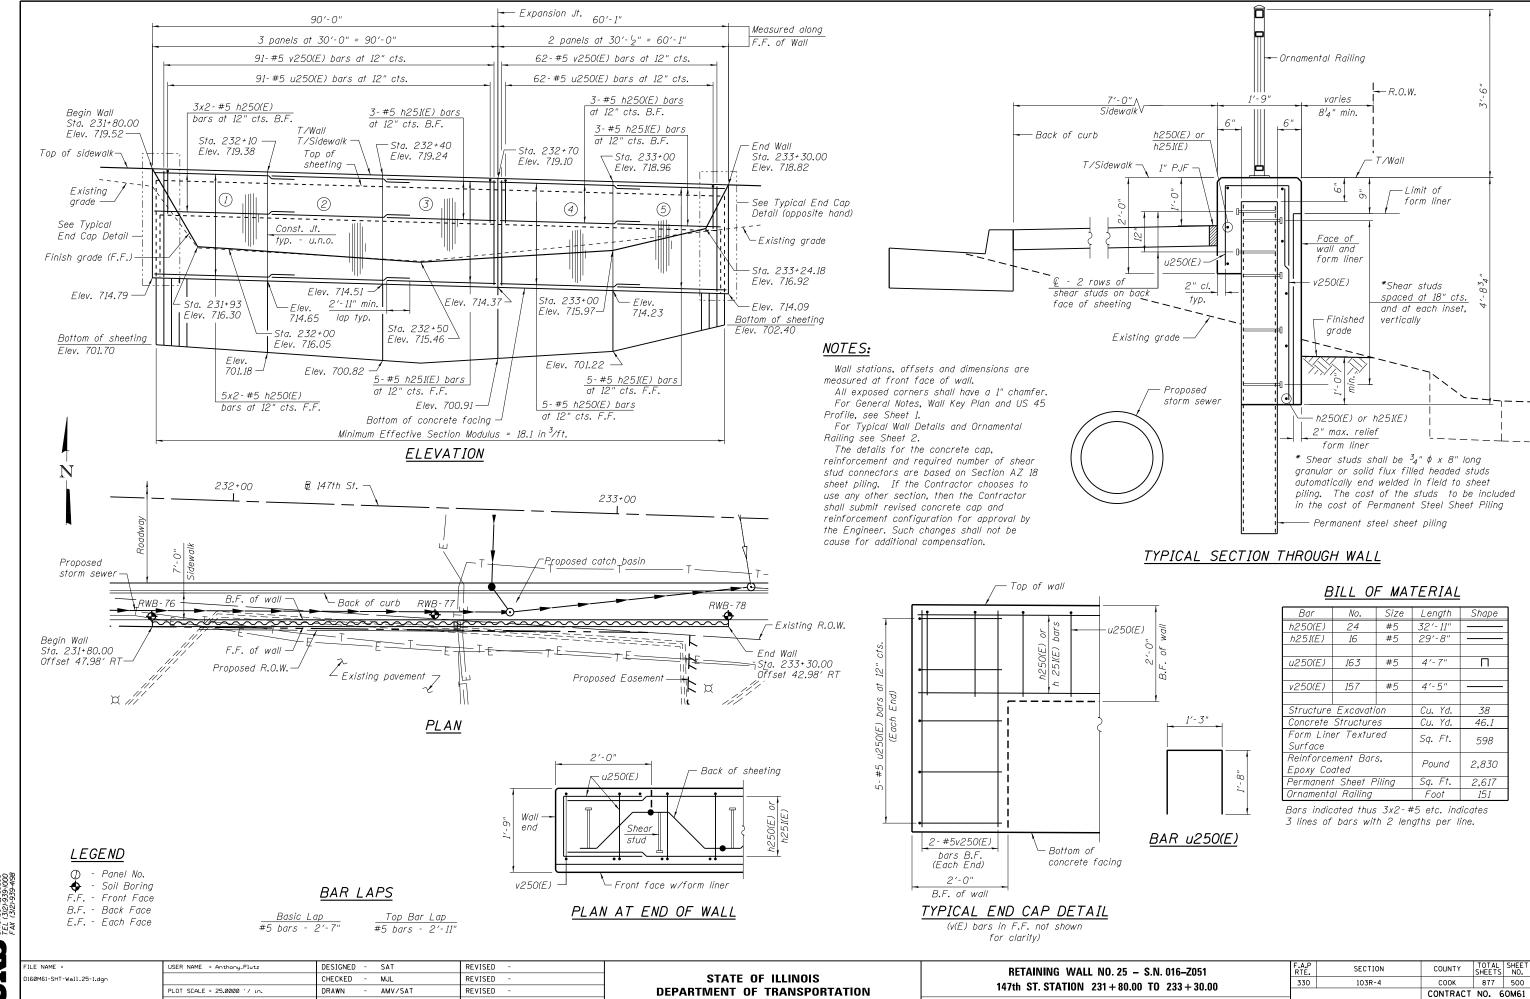

REVISED

SHEET NO. 24 OF 42 SHEETS

100 S. WACKER DR. SUITE 500 CHICAGO IL 66606 TEL (312)-939-1000 FAX (312)-939-4198

PLOT DATE = 3/14/2013

CHECKED

MJL