


USER NAME = Anthony_Plutz	DESIGNED	-	MRF	REVISED -
	DRAWN	-	MRF	REVISED -
PLOT SCALE = 40.0000000 '/ in.	CHECKED	-	MJL	REVISED -
PLOT DATE = 3/13/2013	DATE	-	03/13/13	REVISED -

STATE	OF	ILLINOIS
DEPARTMENT (OF '	TRANSPORTATION

SCALE: 1"=20"

	TRAFFIC SIGNAL INSTALLATION PLAN						F.A.P RTE.	F.A.P RTE. SECTION		TOTAL SHEETS	SHEET NO.
US 45 (LAGRANGE ROAD) AND 131ST STREET					330	103R-5	соок	778	303		
	,							TD-32	CONTRACT	NO. 6	OM62
	SHEET	2 OF	2	SHEETS	STA.	TO STA.		ILLINOIS FED. A	ID PROJECT		

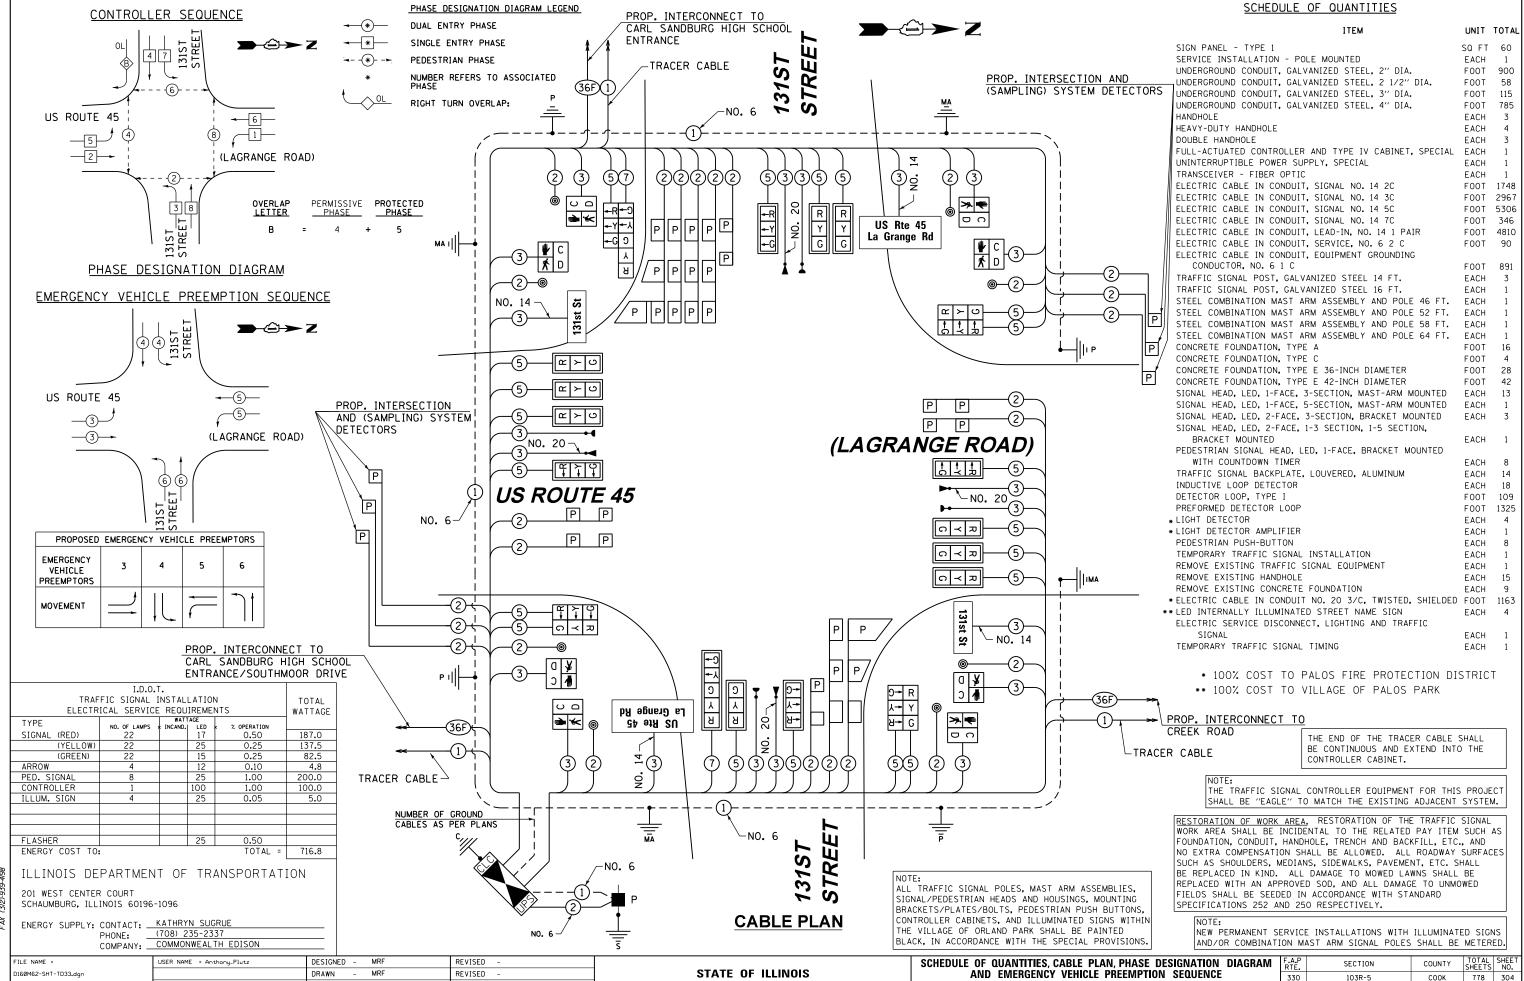

DEPARTMENT OF TRANSPORTATION

US 45 (LAGRANGE ROAD) AND 131ST STREET

SCALE: N.T.S. SHEET 1 OF 1 SHEETS STA.

TD-33

CONTRACT NO. 60M62

| 100 S. WACKER DR. SUITE 500 CHICAGO 1L, 60606 TEL (312)-939-1000


CHECKED

PLOT DATE = 3/13/2013

MJL

03/13/13

REVISED

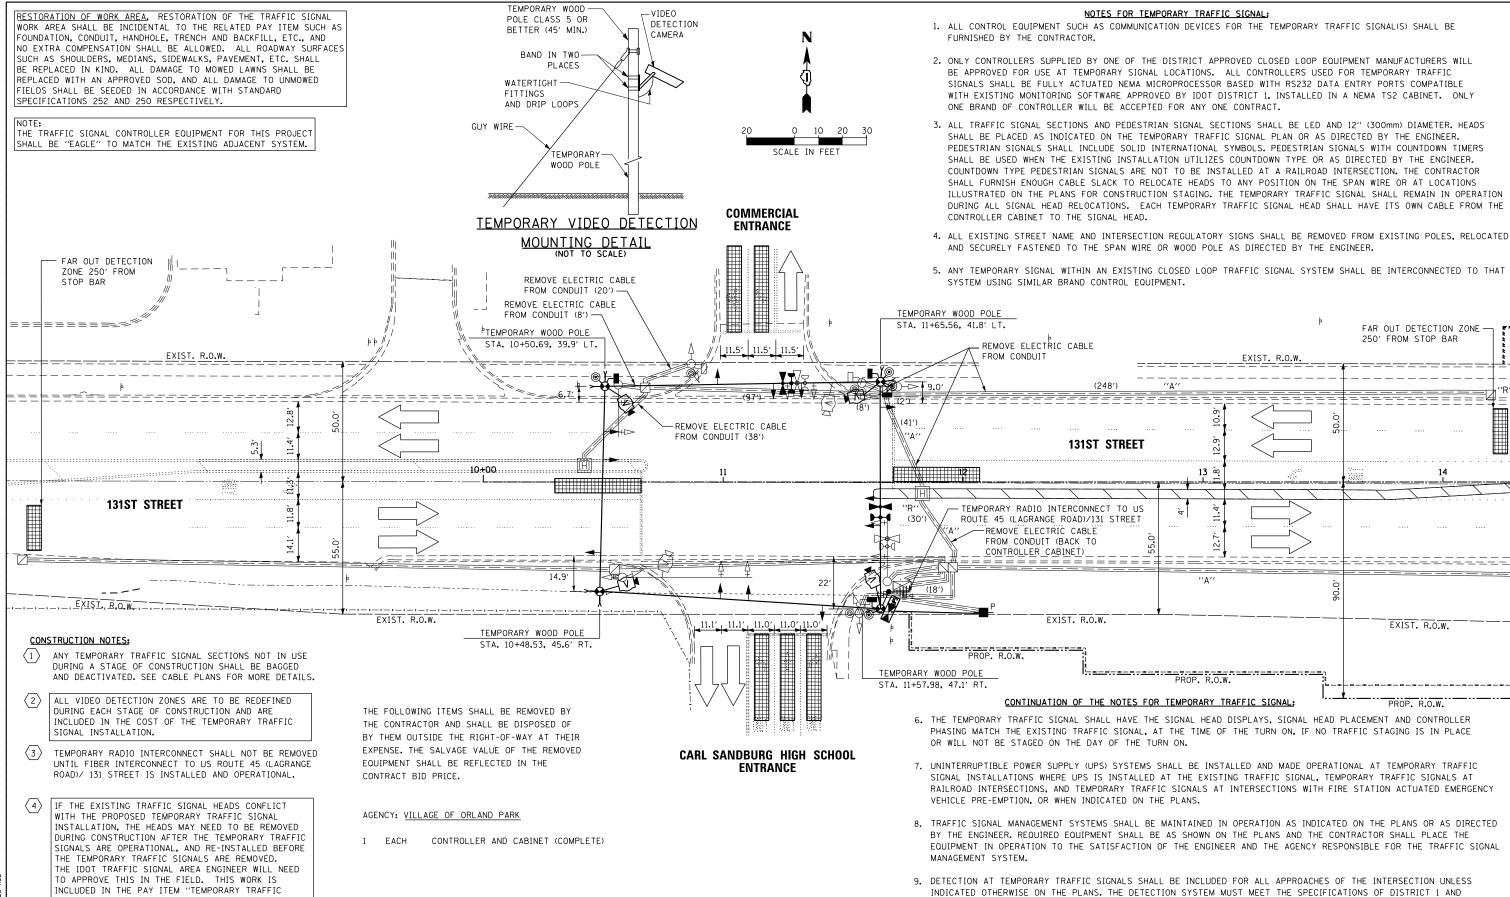

SIGNAL INSTALLATION".

FILE NAME =	USER NAME = Anthony_Plutz	DESIGNED -	MRF	REVISED -
0160M62-SHT-TD34.dgn		DRAWN -	MRF	REVISED -
	PLOT SCALE = 40.0000 '/ in.	CHECKED -	MJL	REVISED -
SHT_PLAN	PLOT DATE = 3/13/2013	DATE -	03/13/13	REVISED -

STATE OF ILLINOIS **DEPARTMENT OF TRANSPORTATION**

SCALE: 1"=20' SHEET

THE CONTRACTOR SHALL BE RESPONSIBLE FOR INSTALLING AND MAINTAINING THE CAMERAS TO THE SATISFACTION OF THE ENGINEER AND THE AGENCY RESPONSIBLE FOR THE CAMERAS. TEMPORARY TRAFFIC SIGNAL INSTALLATION AND REMOVE EXISTING SECTION COUNTY TRAFFIC SIGNAL EQUIPMENT PLAN - PRE-STAGE 330 103R-5 COOK 778 305 131ST STREET AND HS ENTRANCE/COMMERCIAL ENTRANCE

TD-34

CONTRACT NO. 60M62

10. WHEN PAN, TILT, ZOOM CAMERAS ARE INSTALLED AT THE EXISTING INTERSECTION OR ARE CALLED FOR IN THE PLANS,

THE CONTRACTOR SHALL PLACE THE DETECTORS INTO OPERATION TO THE SATISFACTION OF THE ENGINEER.

1 OF 4 SHEETS STA.

RESTORATION OF WORK AREA, RESTORATION OF THE TRAFFIC SIGNAL WORK AREA SHALL BE INCIDENTAL TO THE RELATED PAY ITEM SUCH AS FOUNDATION, CONDUIT, HANDHOLE, TRENCH AND BACKFILL, ETC., AND NO EXTRA COMPENSATION SHALL BE ALLOWED. ALL ROADWAY SURFACES SUCH AS SHOULDERS, MEDIANS, SIDEWALKS, PAVEMENT, ETC. SHALL BE REPLACED IN KIND. ALL DAMAGE TO MOWED LAWNS SHALL BE REPLACED WITH AN APPROVED SOD, AND ALL DAMAGE TO UNMOWED FIELDS SHALL BE SEEDED IN ACCORDANCE WITH STANDARD SPECIFICATIONS 252 AND 250 RESPECTIVELY. THE TRAFFIC SIGNAL CONTROLLER EQUIPMENT FOR THIS PROJECT SHALL BE "EAGLE" TO MATCH THE EXISTING ADJACENT SYSTEM. 10 20 30 SCALE IN FEET COMMERCIAL **ENTRANCE** TEMPORARY RADIO INTERCONNECT FAR OUT DETECTION ZONE — 77 250' FROM STOP BAR TO US ROUTE 45 (LAGRANGE ROAD)/131 STREET // 11.5′ 11.5′ 11.5′ \\ EXIST. R.O.W. **131ST STREET** • \geq 10+00 1 **131ST STREET** EXIST. R.O.W. EXIST. R.O.W. EXIST. R.O.W. 11.1′ 11.1′ 11.0′ 11.0′ 11 EXIST. R.O.W. PROP. R.O.W. FAR OUT DETECTION ZONE 123' FROM CONSTRUCTION NOTES: STOP BAR PROP. R.O.W. ANY TEMPORARY TRAFFIC SIGNAL SECTIONS NOT IN USE DURING A STAGE OF CONSTRUCTION SHALL BE BAGGED AND DEACTIVATED. SEE CABLE PLANS FOR MORE DETAILS. PROP. R.O.W. ALL VIDEO DETECTION ZONES ARE TO BE REDEFINED DURING EACH STAGE OF CONSTRUCTION AND ARE INCLUDED IN THE COST OF THE TEMPORARY TRAFFIC CARL SANDBURG HIGH SCHOOL SIGNAL INSTALLATION. **ENTRANCE** (3) TEMPORARY RADIO INTERCONNECT SHALL NOT BE REMOVED UNTIL FIBER INTERCONNECT TO US ROUTE 45 (LAGRANGE ROAD)/ 131 STREET IS INSTALLED AND OPERATIONAL. IF THE EXISTING TRAFFIC SIGNAL HEADS CONFLICT WITH THE PROPOSED TEMPORARY TRAFFIC SIGNAL INSTALLATION, THE HEADS MAY NEED TO BE REMOVED DURING CONSTRUCTION AFTER THE TEMPORARY TRAFFIC SIGNALS ARE OPERATIONAL, AND RE-INSTALLED BEFORE THE TEMPORARY TRAFFIC SIGNALS ARE REMOVED. THE IDOT TRAFFIC SIGNAL AREA ENGINEER WILL NEED TO APPROVE THIS IN THE FIELD. THIS WORK IS INCLUDED IN THE PAY ITEM "TEMPORARY TRAFFIC." INCLUDED IN THE PAY ITEM "TEMPORARY TRAFFIC SIGNAL INSTALLATION". TEMPORARY TRAFFIC SIGNAL INSTALLATION - STAGE 1A 131ST STREET AND CARL SANDBURG HIGH SCHOOL ENTRANCE / DESIGNED - MRF REVISED USER NAME = Anthony_Plutz SECTION COUNTY STATE OF ILLINOIS 160M62-SHT-TD35.dgr DRAWN MRF REVISED 330 103R-5 COOK 778 306 PLOT SCALE = 40.0000 '/ in. CHECKED -MJL REVISED **DEPARTMENT OF TRANSPORTATION** COMMERCIAL ENTRANCE TD-35 CONTRACT NO. 60M62

SCALE: 1"=20' SHEET

2 OF 4 SHEETS STA.



PLOT DATE = 3/13/2013

DATE

03/13/13

RESTORATION OF WORK AREA, RESTORATION OF THE TRAFFIC SIGNAL WORK AREA SHALL BE INCIDENTAL TO THE RELATED PAY ITEM SUCH AS FOUNDATION, CONDUIT, HANDHOLE, TRENCH AND BACKFILL, ETC., AND NO EXTRA COMPENSATION SHALL BE ALLOWED. ALL ROADWAY SURFACES SUCH AS SHOULDERS, MEDIANS, SIDEWALKS, PAVEMENT, ETC. SHALL BE REPLACED IN KIND. ALL DAMAGE TO MOWED LAWNS SHALL BE REPLACED WITH AN APPROVED SOD, AND ALL DAMAGE TO UNMOWED FIELDS SHALL BE SEEDED IN ACCORDANCE WITH STANDARD SPECIFICATIONS 252 AND 250 RESPECTIVELY. THE TRAFFIC SIGNAL CONTROLLER EQUIPMENT FOR THIS PROJECT SHALL BE "EAGLE" TO MATCH THE EXISTING ADJACENT SYSTEM. 0 10 20 30 SCALE IN FEET COMMERCIAL **ENTRANCE** FAR OUT DETECTION ZONE 250' FROM STOP BAR TEMPORARY RADIO INTERCONNECT FAR OUT DETECTION ZONE — 250' FROM STOP BAR TO US ROUTE 45 (LAGRANGE ROAD)/131 STREET 11.5′ 11.5′ 11.5′ 131ST STREET 10+00 **ナ** • 131ST STREET EXIST. R.O.W. EXIST. R.O.W. EXIST. R.O.W. 11.1′, 11.1′, 11.0′, 11.0′,11. EXIST. R.O.W. **CONSTRUCTION NOTES:** ANY TEMPORARY TRAFFIC SIGNAL SECTIONS NOT IN USE DURING A STAGE OF CONSTRUCTION SHALL BE BAGGED AND DEACTIVATED. SEE CABLE PLANS FOR MORE DETAILS. PROP. R.O.W. PROP. R.O.W. ALL VIDEO DETECTION ZONES ARE TO BE REDEFINED PROP. R.O.W. DURING EACH STAGE OF CONSTRUCTION AND ARE INCLUDED IN THE COST OF THE TEMPORARY TRAFFIC SIGNAL INSTALLATION. TEMPORARY RADIO INTERCONNECT SHALL NOT BE REMOVED UNTIL FIBER INTERCONNECT TO US ROUTE 45 (LAGRANGE CARL SANDBURG HIGH SCHOOL **ENTRANCE** ROAD)/ 131 STREET IS INSTALLED AND OPERATIONAL. IF THE EXISTING TRAFFIC SIGNAL HEADS CONFLICT WITH THE PROPOSED TEMPORARY TRAFFIC SIGNAL INSTALLATION, THE HEADS MAY NEED TO BE REMOVED DURING CONSTRUCTION AFTER THE TEMPORARY TRAFFIC SIGNALS ARE OPERATIONAL, AND RE-INSTALLED BEFORE THE TEMPORARY TRAFFIC SIGNALS ARE REMOVED. THE IDOT TRAFFIC SIGNAL AREA ENGINEER WILL NEED TO APPROVE THIS IN THE FIELD. THIS WORK IS INCLUDED IN THE PAY ITEM "TEMPORARY TRAFFIC SIGNAL INSTALLATION". DESIGNED - MRF REVISED USER NAME = Anthony_Plutz SECTION COUNTY 160M62-SHT-TD36.dgr DRAWN MRF REVISED



TEMPORARY TRAFFIC SIGNAL INSTALLATION STAGE 1B 131ST STREET AND CARL SANDBURG HIGH SCHOOL ENTRANCE / STATE OF ILLINOIS 330 103R-5 COOK 778 307 PLOT SCALE = 40.0000 '/ in. CHECKED -REVISED **DEPARTMENT OF TRANSPORTATION** COMMERCIAL ENTRANCE TD-36 CONTRACT NO. 60M62 SCALE: 1"=20" SHEET 3 OF 4 SHEETS STA. PLOT DATE = 3/13/2013 DATE 03/13/13 REVISED

RESTORATION OF WORK AREA. RESTORATION OF THE TRAFFIC SIGNAL WORK AREA SHALL BE INCIDENTAL TO THE RELATED PAY ITEM SUCH AS FOUNDATION, CONDUIT, HANDHOLE, TRENCH AND BACKFILL, ETC., AND NO EXTRA COMPENSATION SHALL BE ALLOWED. ALL ROADWAY SURFACES SUCH AS SHOULDERS, MEDIANS, SIDEWALKS, PAVEMENT, ETC. SHALL BE REPLACED IN KIND. ALL DAMAGE TO MOWED LAWNS SHALL BE REPLACED WITH AN APPROVED SOD, AND ALL DAMAGE TO UNMOWED FIELDS SHALL BE SEEDED IN ACCORDANCE WITH STANDARD SPECIFICATIONS 252 AND 250 RESPECTIVELY. THE TRAFFIC SIGNAL CONTROLLER EQUIPMENT FOR THIS PROJECT SHALL BE "EAGLE" TO MATCH THE EXISTING ADJACENT SYSTEM. COMMERCIAL **ENTRANCE** - FAR OUT DETECTION ZONE 250' FROM STOP BAR LIC, FINAL GEOMETRICS - TEMPORARY RADIO INTERCONNECT TO US ROUTE 45 (LAGRANGE ROAD)/131 STREET 1C, FINAL GEOMETRICS-1C, FINAL GEOMETRICS -1C, FINAL GEOMETRICS **131ST STREET** • - FINAL GEOMETRICS 13 1C, FINAL GEOMETRICS 1C, FINAL GEOMETRICS 1C, FINAL GEOMETRICS-**131ST STREET** 1C, FINAL GEOMETRICS-EXIST. B.O.W. EXIST. R.O.W. EXIST. R.O.W. PROP. R.O.W. CONSTRUCTION NOTES: -1C, FINAL GEOMETRICS **L** I PROP. R.O.W.

- $\langle 1 \rangle$ any temporary traffic signal sections not in use DURING A STAGE OF CONSTRUCTION SHALL BE BAGGED AND DEACTIVATED. SEE CABLE PLANS FOR MORE DETAILS.
- 2 ALL VIDEO DETECTION ZONES ARE TO BE REDEFINED DURING EACH STAGE OF CONSTRUCTION AND ARE INCLUDED IN THE COST OF THE TEMPORARY TRAFFIC SIGNAL INSTALLATION.
- TEMPORARY RADIO INTERCONNECT SHALL NOT BE REMOVED UNTIL FIBER INTERCONNECT TO US ROUTE 45 (LAGRANGE ROAD)/ 131 STREET IS INSTALLED AND OPERATIONAL.
- IF THE EXISTING TRAFFIC SIGNAL HEADS CONFLICT WITH THE PROPOSED TEMPORARY TRAFFIC SIGNAL

WITH THE FROITSED TEMPORART TRAFFIC SIGNAL
INSTALLATION, THE HEADS MAY NEED TO BE REMOVED
DURING CONSTRUCTION AFTER THE TEMPORARY TRAFFIC
SIGNALS ARF OPFRATIONAL. AND RE-INSTALLED BEFORF
THE TEMPORARY TRAFFIC SIGNALS ARE REMOVED.
ITHE IDOT TRAFFIC SIGNAL AREA ENGINEER WILL NEED.
TO APPROVE THIS IN THE FIELD. THIS WORK IS
INCLUDED IN THE PAY ITEM "TEMPORARY TRAFFIC
SIGNAL INSTALLATION".

FILE NAME =
D160M62-SHT-TD37.dgn
0.17 0.41

USER NAME = Anthony_Plutz	DESIGNED	-	MRF	REVISED -
	DRAWN	-	MRF	REVISED -
PLOT SCALE = 40.0000 '/ in.	CHECKED	-	MJL	REVISED -
PLOT DATE = 3/13/2013	DATE	-	03/13/13	REVISED -

STATE OF ILLINOIS
DEPARTMENT OF TRANSPORTATION

CARL SANDBURG HIGH SCHOOL

ENTRANCE

1	TEMPO							E 1C & FINAL GEOMETRICS	F.A.P RTE.	SECTION	COUNTY	TOTAL SHEETS	SHEET NO.
ı	131ST STREET AND CARL SANDBURG HIGH SCHOOL ENTRANCE /								330	103R-5	соок	778	308
ı	COMMERCIAL ENTRANCE								TD-37	CONTRACT	NO. 6	0м62	
ı	SCALE:	1''=20'	SHEET	4 OF	4	SHEETS	STA.	TO STA.	ILLINOIS FED. AID PROJECT				

10 20 30


FAR OUT DETECTION ZONE -

EXIST. R.O.W.


PROP. R.O.W.


250' FROM STOP BAR

SCALE IN FEET

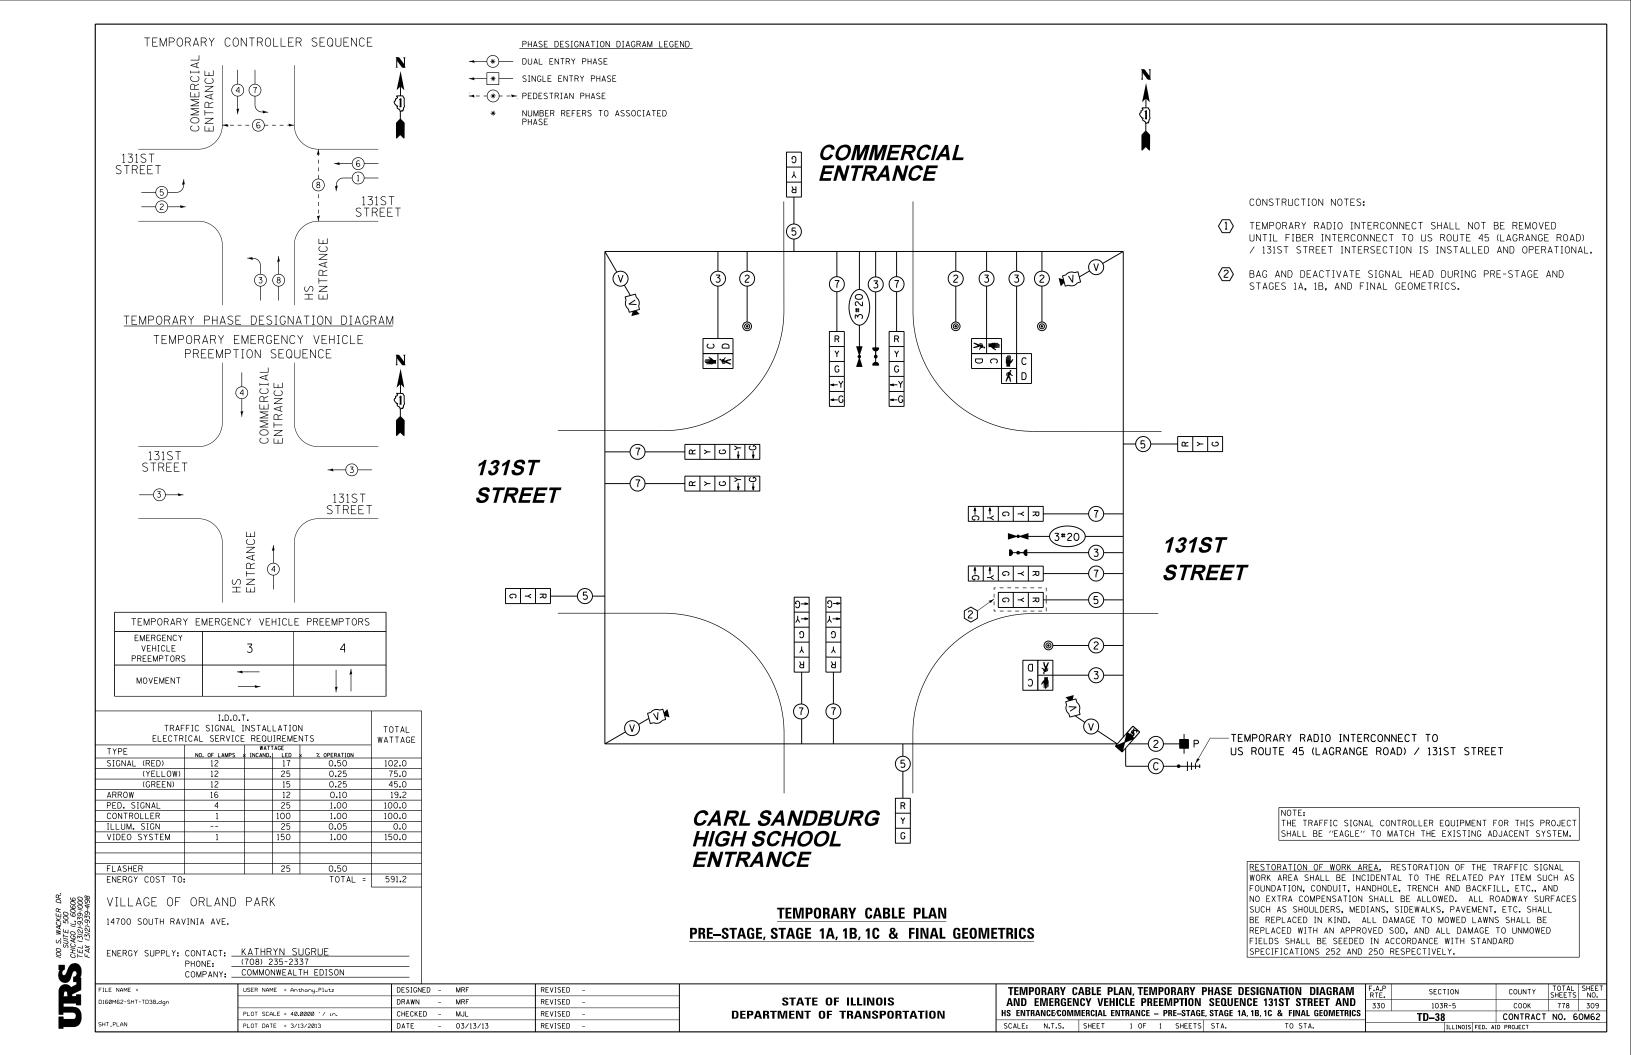

RESTORATION OF WORK AREA. RESTORATION OF THE TRAFFIC SIGNAL WORK AREA SHALL BE INCIDENTAL TO THE RELATED PAY ITEM SUCH AS FOUNDATION, CONDUIT, HANDHOLE, TRENCH AND BACKFILL, ETC., AND NO EXTRA COMPENSATION SHALL BE ALLOWED. ALL ROADWAY SURFACES SUCH AS SHOULDERS, MEDIANS, SIDEWALKS, PAVEMENT, ETC. SHALL BE REPLACED IN KIND. ALL DAMAGE TO MOWED LAWNS SHALL BE REPLACED WITH AN APPROVED SOD, AND ALL DAMAGE TO UNMOWED FIELDS SHALL BE SEEDED IN ACCORDANCE WITH STANDARD SPECIFICATIONS 252 AND 250 RESPECTIVELY. THE TRAFFIC SIGNAL CONTROLLER EQUIPMENT FOR THIS PROJECT SHALL BE "EAGLE" TO MATCH THE EXISTING ADJACENT SYSTEM.

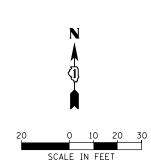

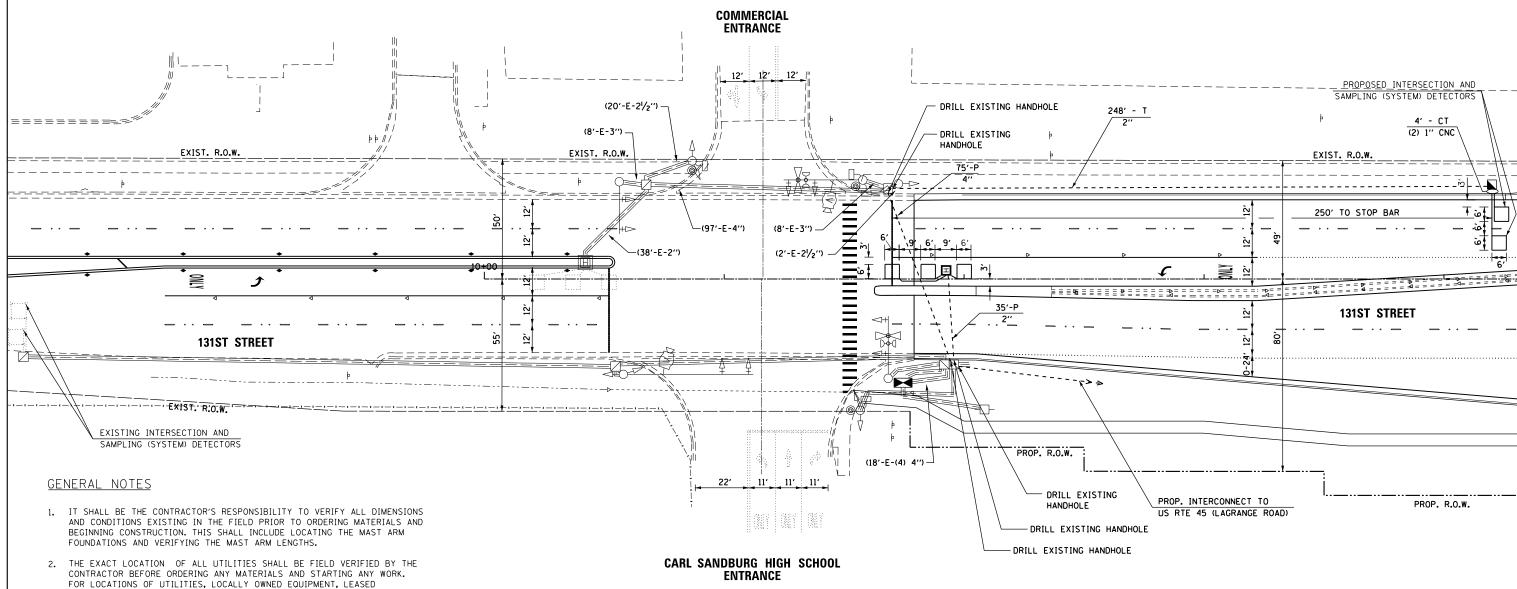

ENFORCEMENT CAMERA SYSTEM FACILITIES AND IDOT UNDERGROUND FACILITIES, CONTACT THE LOCAL COUNTIES, MUNICIPALITIES AND IDOT FOR LOCATES. THE CONTRACTOR SHALL CALL 'JULIE' AT (800) 892-0123 OR 811, IN THE CITY OF CHICAGO CONTACT DIGGER AT (312) 744-7000 FOR FIELD LOCATIONS OF BURIED UTILITIES (48 HOUR NOTIFICATION REQUIRED).

3. THE CONTRACTOR SHALL CHECK THE PROPOSED TRAFFIC SIGNAL EQUIPMENT LOCATIONS FOR OVERHEAD UTILITY CONFLICTS. THE CONTRACTOR SHALL COORDINATE ANY CONFLICTS WITH THE UTILITY COMPANIES AND THE RESIDENT ENGINEER BEFORE ORDERING MATERIALS.

4. THE CONTRACTOR SHALL COORDINATE CONSTRUCTION ACTIVITIES WITH UTILITY

GALVANIZED STEEL CONDUIT IDENTIFIED AS IN TRENCH (T) OR PUSHED (P) IS SHOWN FOR INFORMATION ONLY. ALL UNDERGROUND CONDUIT SHALL BE PAID FOR AT THE CONTRACT UNIT PRICE PER FOOT FOR UNDERGROUND CONDUIT, OF THE TYPE AND SIZE SPECIFIED, REGARDLESS OF THE METHOD OF INSTALLATION.


COMPANIES, LOCAL GOVERNMENT AGENCIES AND IDOT.

FILE NAME =
D160M62-SHT-TD39.dgn
CUT DI ANI

ILE NAME =	USER NAME = Anthony_Plutz	DESIGNED -	MRF	REVISED -
160M62-SHT-TD39.dgn		DRAWN -	MRF	REVISED -
	PLOT SCALE = 40.0000 '/ in.	CHECKED -	MJL	REVISED -
HT_PLAN	PLOT DATE = 3/13/2013	DATE -	03/13/13	REVISED -

STATI	E OF	: ILLINOIS
DEPARTMENT	OF	TRANSPORTATION

I								PLAN	F.A.P RTE.	SECTION	COUNTY	TOTAL SHEETS	SHEET NO.
I	131S	T STRE	ET AND					SCHOOL ENTRANCE /	330	103R-5	соок	778	310
ļ				COMIN	/IEK(IAL EN				TD-39	CONTRACT	NO. 6	50M62
l	SCALE:	1''=20'	SHEET	1 OF	1	SHEETS	STA.	TO STA.		ILLINOIS FED. A	ID PROJECT		

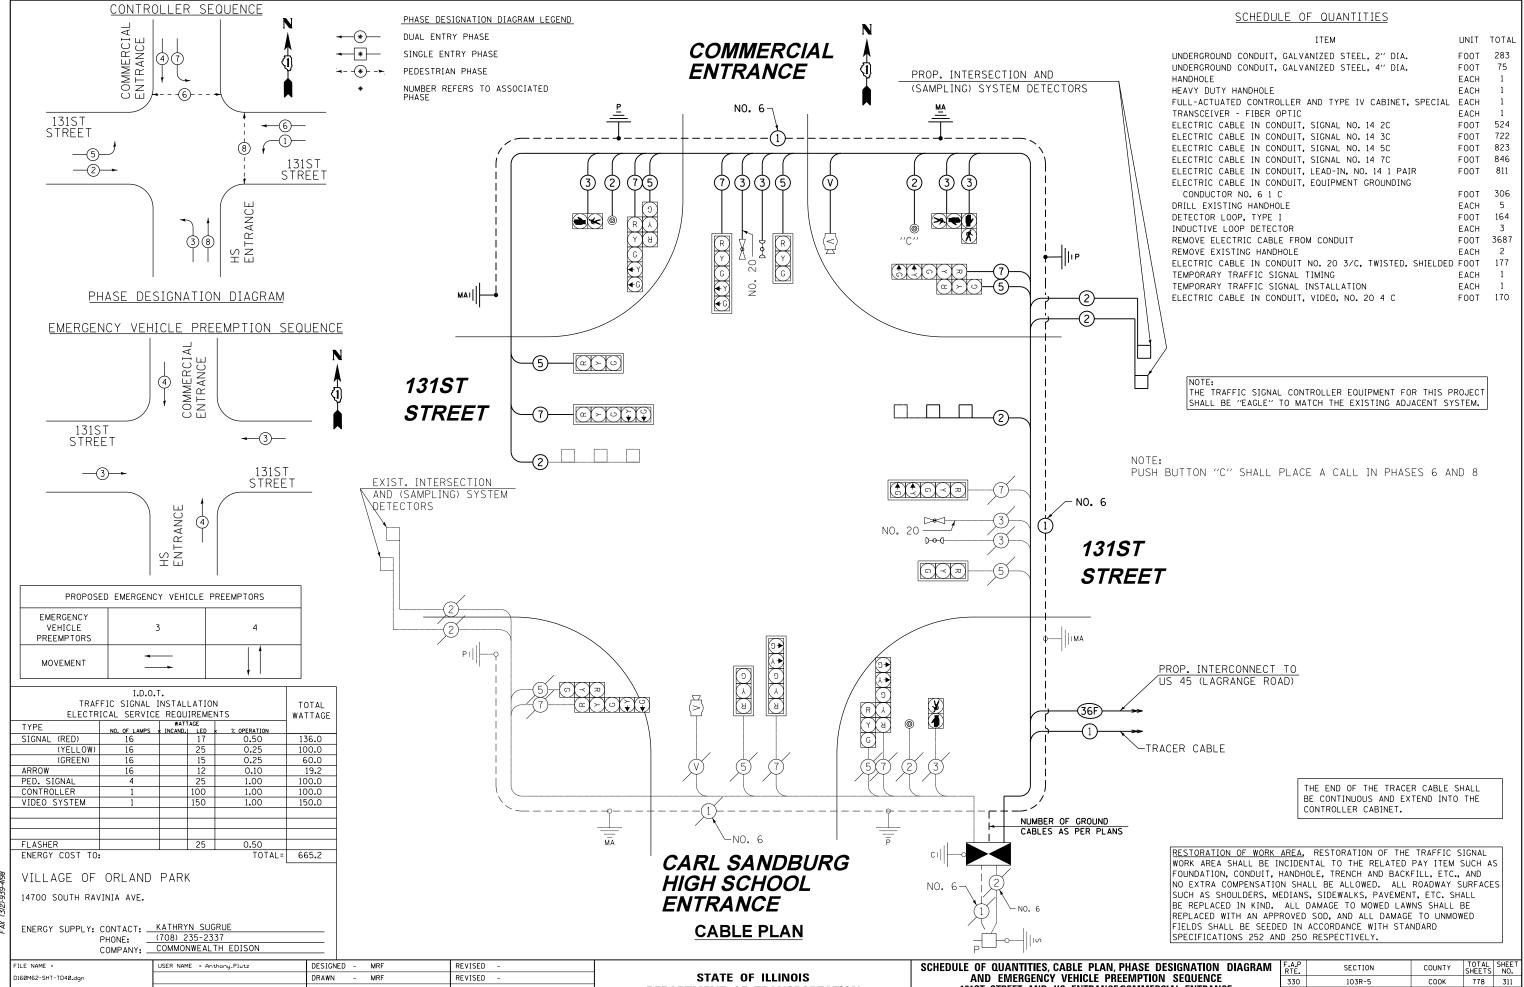

DEPARTMENT OF TRANSPORTATION

131ST STREET AND HS ENTRANCE/COMMERCIAL ENTRANCE

SCALE: N.T.S. SHEET 1 OF 1 SHEETS STA.

TD-40

CONTRACT NO. 60M62

CHICAGO 12, WACKEN DR. SUITE 500

CHICAGO 11, 60606

TEL (312)-939-1000

CHECKED


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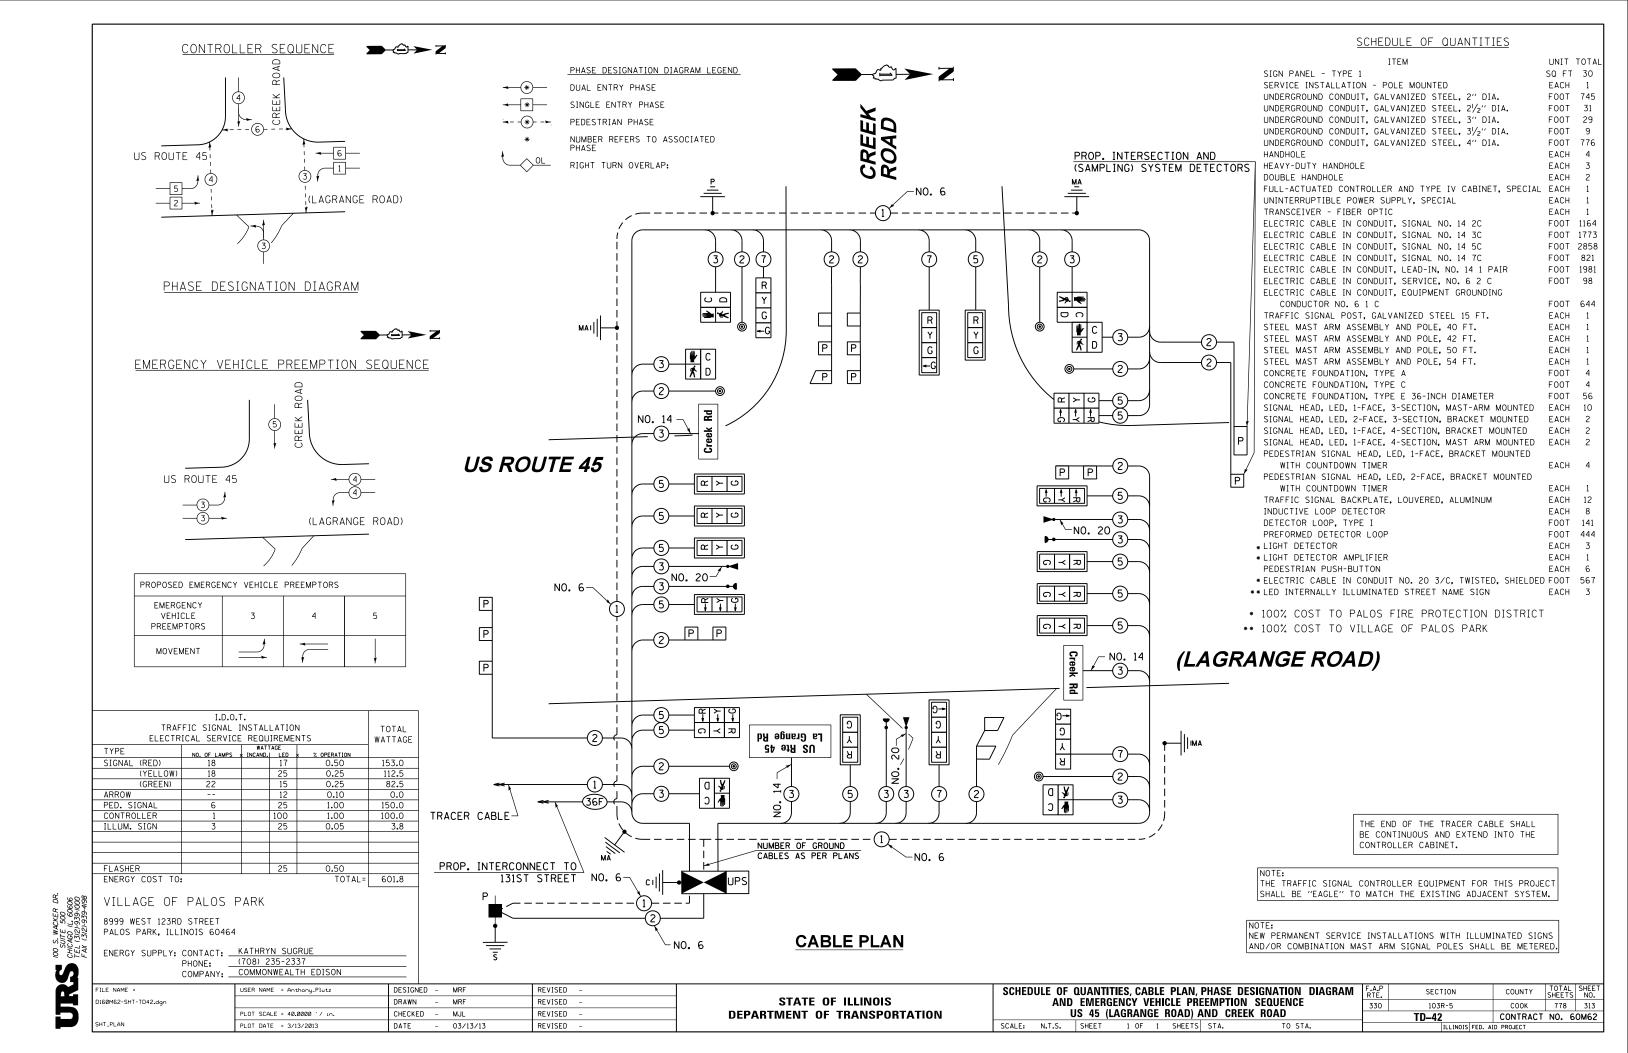
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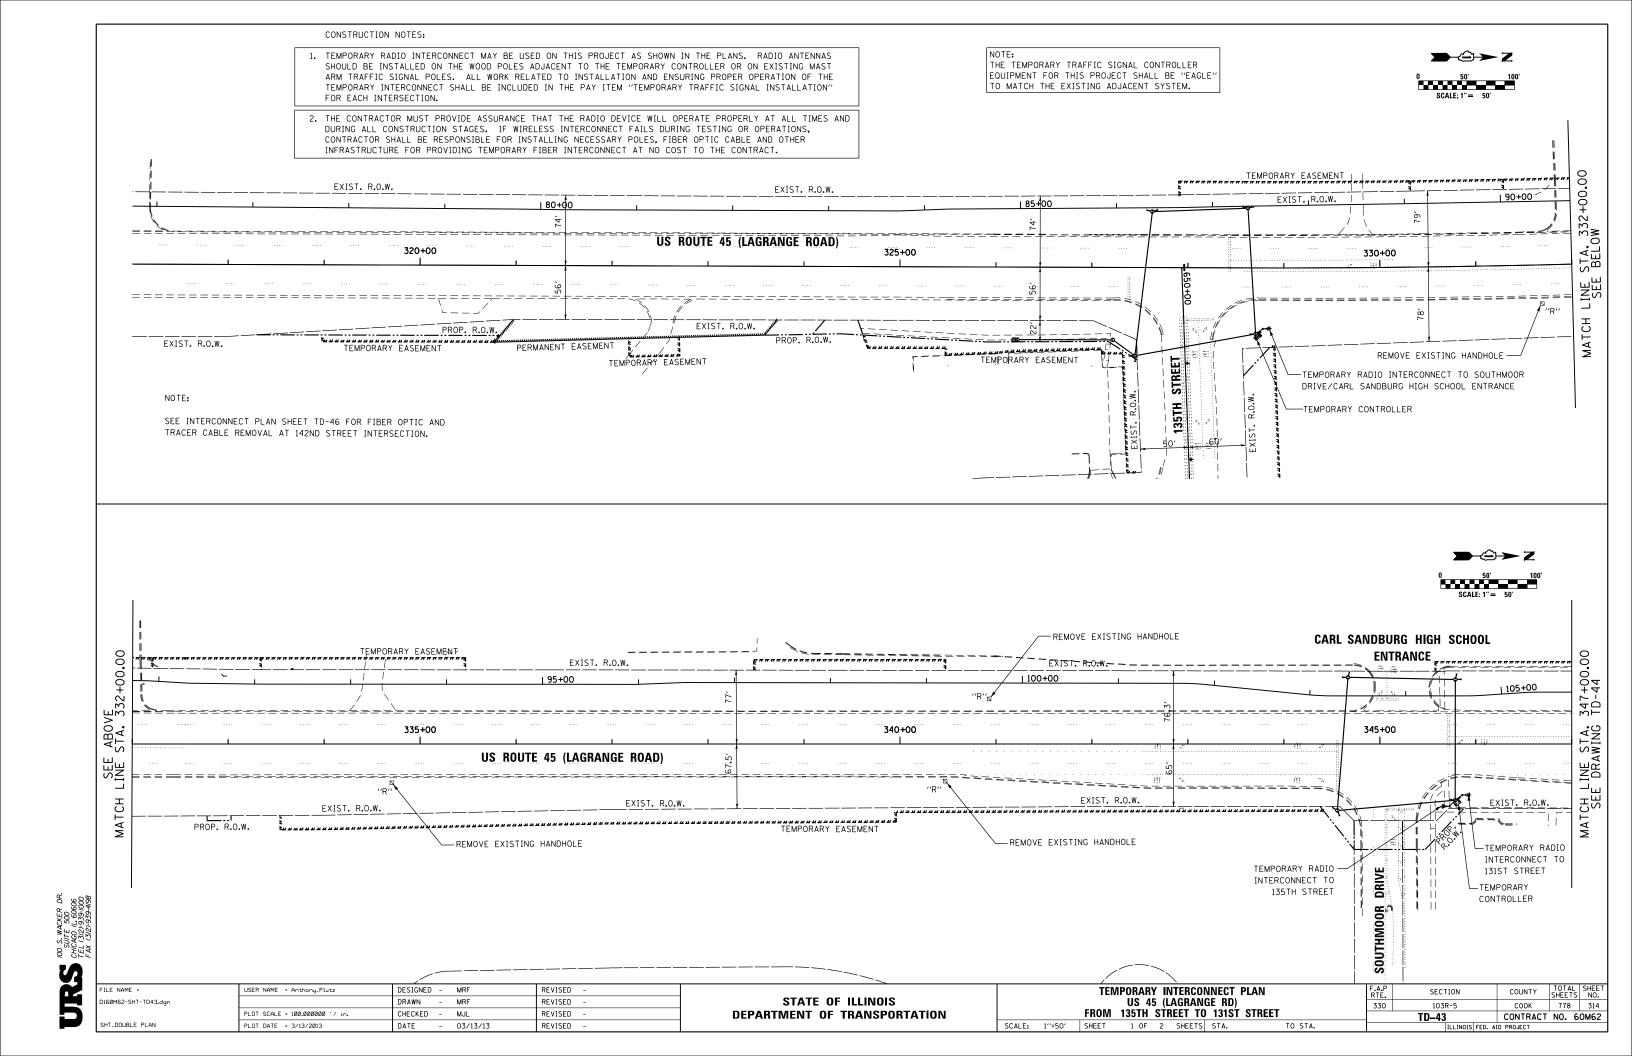
MJL


03/13/13

REVISED





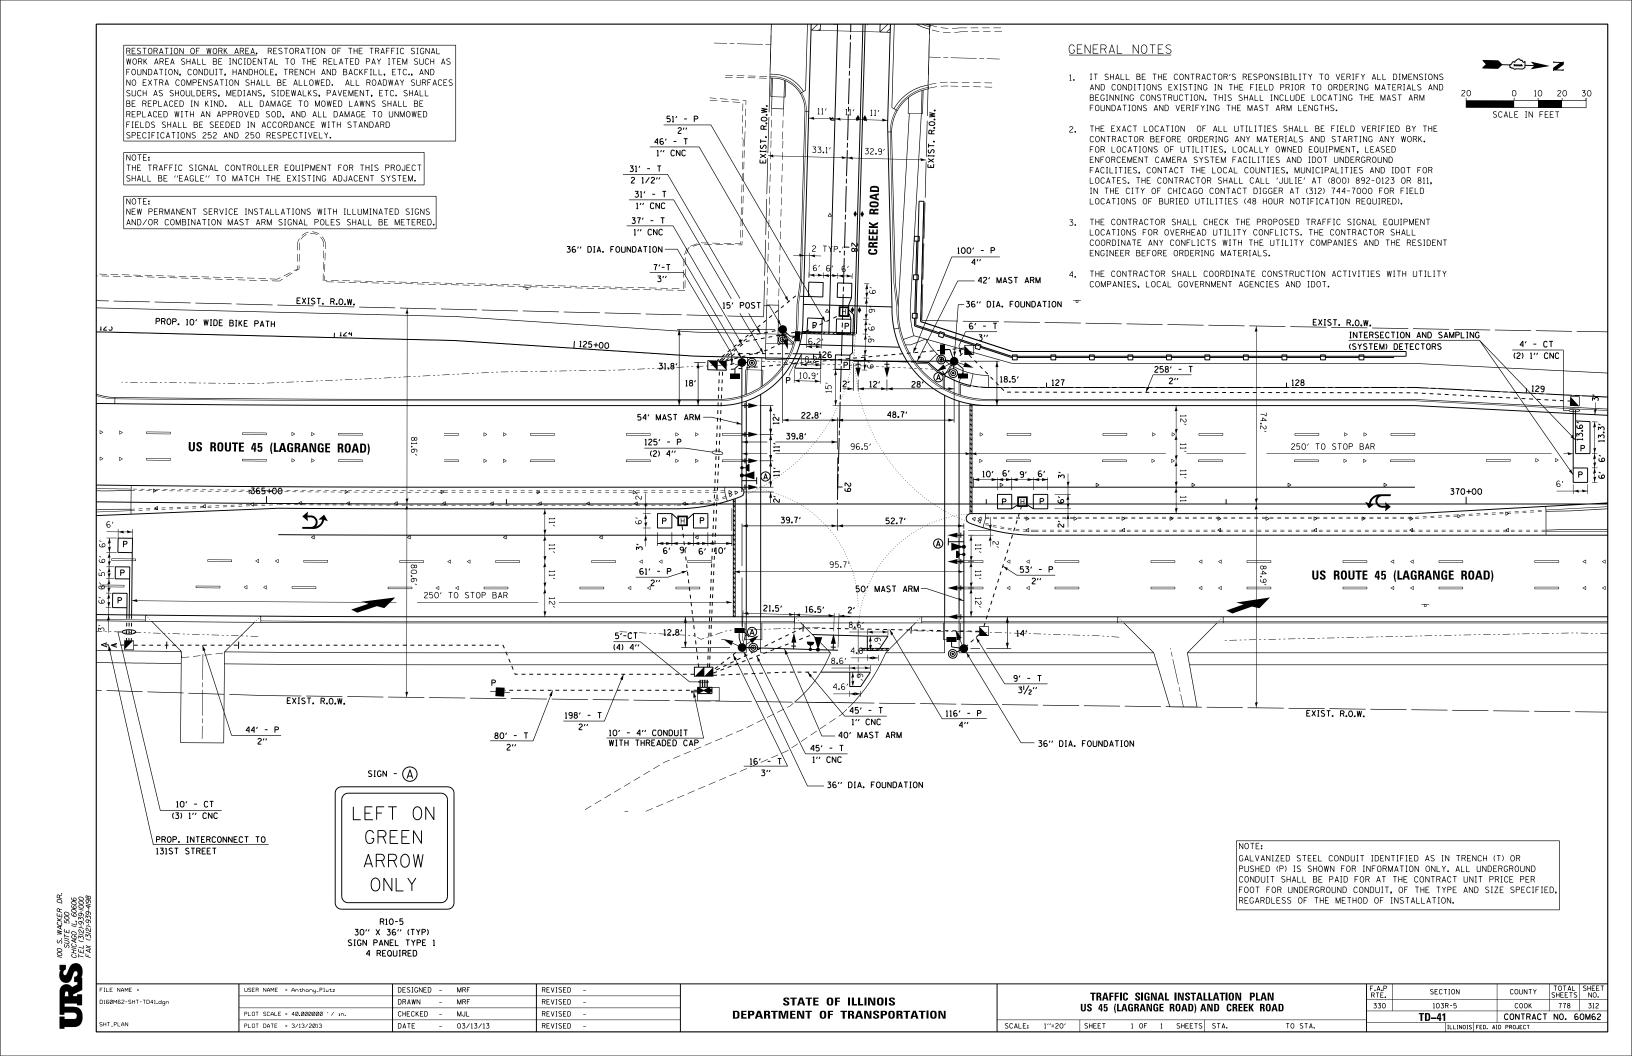

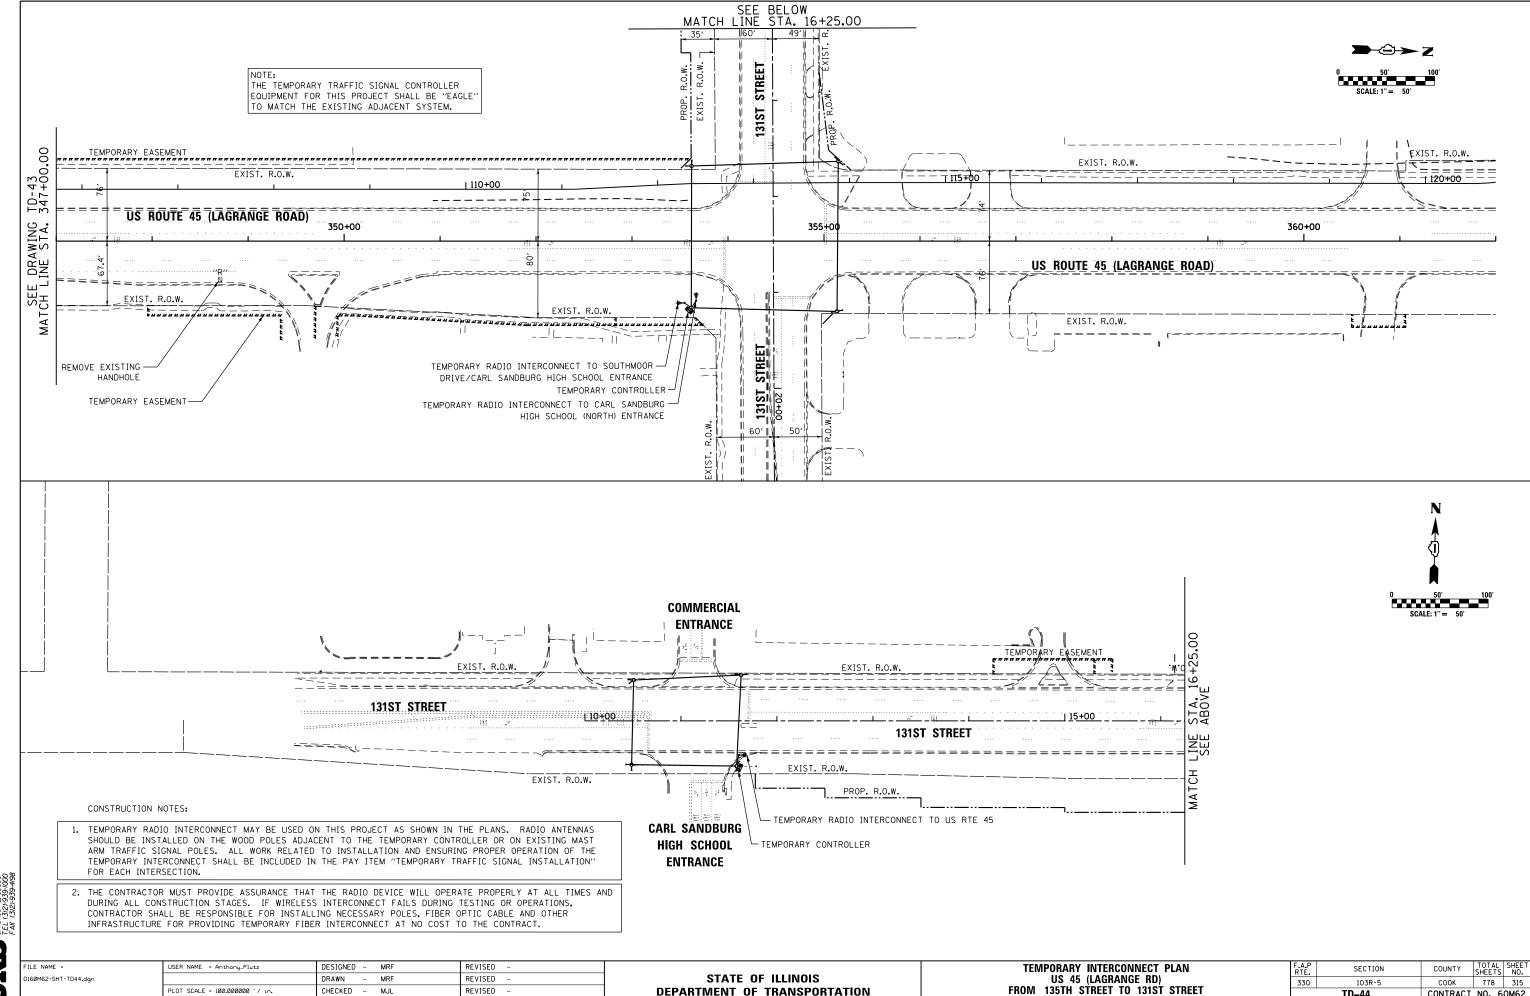

SCALE: 1"=50' SHEET

2 OF 2 SHEETS STA.

TD-44

CONTRACT NO. 60M62



SHT_DOUBLE PLAN

PLOT DATE = 3/13/2013

03/13/13

REVISED

DATE

FILE NAME =	USER NAME = Anthony_Plutz	DESIGNED -	MRF	REVISED -
D160M62-SHT-TD45.dgn		DRAWN -	MRF	REVISED -
	PLOT SCALE = 100.0000 '/ in.	CHECKED -	MJL	REVISED -
SHT_PLAN	PLOT DATE = 3/13/2013	DATE -	03/13/13	REVISED -

STATE OF ILLINOIS **DEPARTMENT OF TRANSPORTATION**


TEMPORARY INTERCONNECT SCHEMATIC
US 45 (LAGRANGE RD) FROM 135TH STREET TO 131ST STREET SCALE: N.T.S. SHEET 1 OF 1 SHEETS STA.

330 103R-5 TD-45


 COUNTY
 TOTAL SHEETS NO.


 COOK
 778
 316

 CONTRACT NO. 60M62
 SECTION

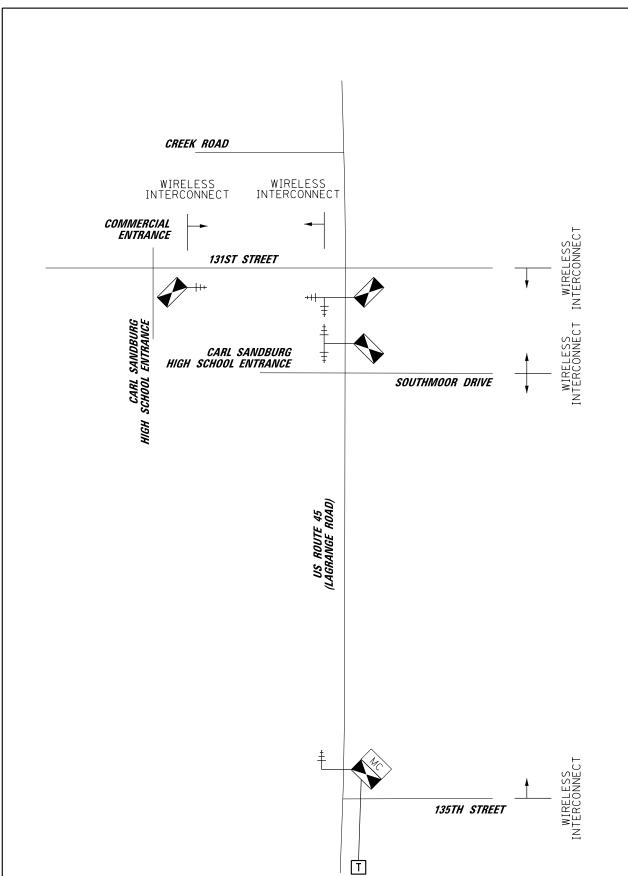


THE TEMPORARY TRAFFIC SIGNAL CONTROLLER EQUIPMENT FOR THIS PROJECT SHALL BE "EAGLE" TO MATCH THE EXISTING ADJACENT SYSTEM.

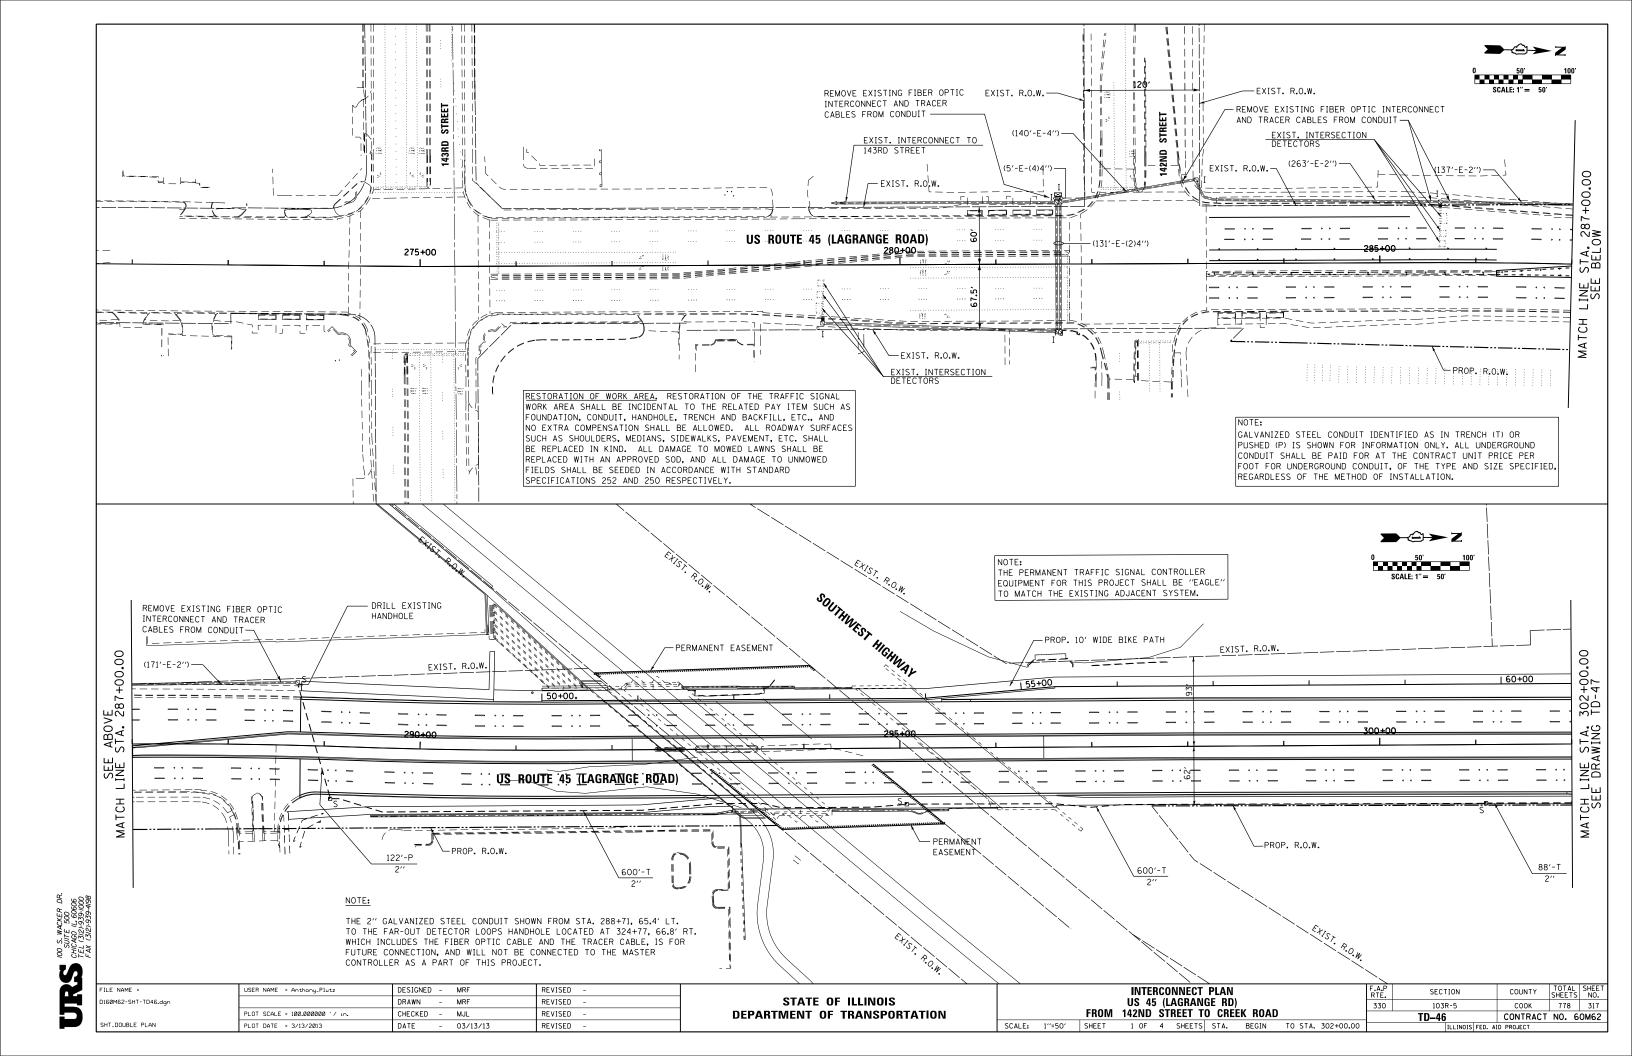

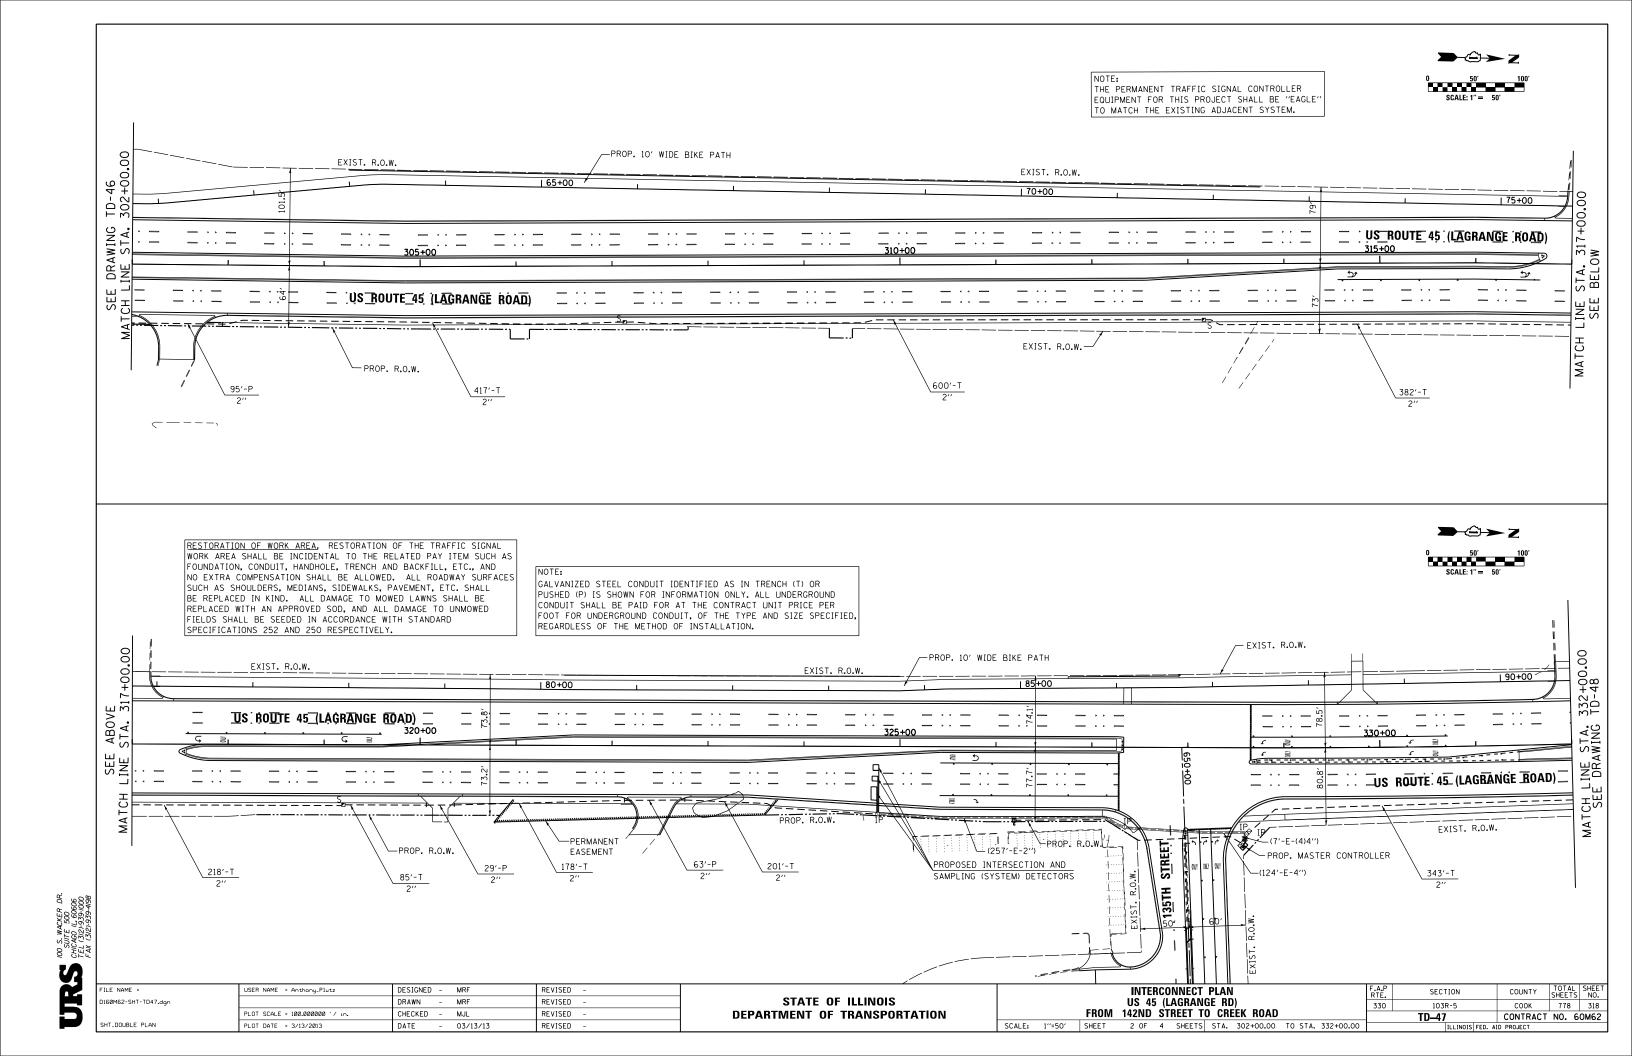

RESTORATION OF WORK AREA, RESTORATION OF THE TRAFFIC SIGNAL WORK AREA SHALL BE INCIDENTAL TO THE RELATED PAY ITEM SUCH AS FOUNDATION, CONDUIT, HANDHOLE, TRENCH AND BACKFILL, ETC., AND NOTE: NO EXTRA COMPENSATION SHALL BE ALLOWED. ALL ROADWAY SURFACES GALVANIZED STEEL CONDUIT IDENTIFIED AS IN TRENCH (T) OR SUCH AS SHOULDERS, MEDIANS, SIDEWALKS, PAVEMENT, ETC. SHALL PUSHED (P) IS SHOWN FOR INFORMATION ONLY. ALL UNDERGROUND BE REPLACED IN KIND. ALL DAMAGE TO MOWED LAWNS SHALL BE CONDUIT SHALL BE PAID FOR AT THE CONTRACT UNIT PRICE PER REPLACED WITH AN APPROVED SOD, AND ALL DAMAGE TO UNMOWED FOOT FOR UNDERGROUND CONDUIT, OF THE TYPE AND SIZE SPECIFIED, FIELDS SHALL BE SEEDED IN ACCORDANCE WITH STANDARD REGARDLESS OF THE METHOD OF INSTALLATION. SPECIFICATIONS 252 AND 250 RESPECTIVELY. CARL SANDBURG HIGH SCHOOL - PROP. 10' WIDE BIKE PATH **ENTRANCE** STA, 347+00.00 BELOW EXIST. R.O.W. EXIST. R.O.W. 47+00. US ROUTE 45 (LAGRANGE ROAD) 345+00 ≥V DRA INE _ .. _ 몽핑 MATCH MAT EXIST. R.O.W. PROP. R.O.W. (247'-E-2") DRIVE 440'-T 109'-T 441'-T NOTE: - (5'-E-(4)4'') THE PERMANENT TRAFFIC SIGNAL CONTROLLER EOUIPMENT FOR THIS PROJECT SHALL BE "EAGLE" SOUTHMOOR TO MATCH THE EXISTING ADJACENT SYSTEM. 50.5 SEE DRAWING TD-49 MATCH LINE STA. 16+25.00 STREET 125'-T 131ST -PROP. 10' WIDE BIKE PATH PROPOSED INTERSECTION AND SAMPLING (SYSTEM) DETECTORS PROP. 10' WIDE BIKE PATH (158'-E-(2)4'') — 362+00.00 TD-49 EXIST. R.O.W. EXIST. R.O.W ÷00+ | 110+00 VE 347 — · US—ROUTE—45 · (LAGRANGE ·ROAD) INE STA. DRAWING 360+00 355+00 SEE _US ROUTE 45 (LAGRANGE_ROAD)— MATCH LI SEE MATCH EXIST. \ R.O.W. EXIST. R.O.W. - EXIST. R.O.W. - (238'-E-2") STREET (7'-E-(4)4'') 122'-P 158'-T 81'-T PROPOSED INTERSECTION AND SAMPLING (SYSTEM) DETECTORS 131ST (144'-E-(2)4'') -DESIGNED - MRF REVISED INTERCONNECT PLAN US 45 (LAGRANGE RD) USER NAME = Anthony_Plutz SECTION COUNTY STATE OF ILLINOIS 160M62-SHT-TD48.dgn DRAWN MRF REVISED 330 103R-5 COOK 778 319 FROM 142ND STREET TO CREEK ROAD PLOT SCALE = 100.000000 '/ in. CHECKED -MJL REVISED **DEPARTMENT OF TRANSPORTATION** TD-48 CONTRACT NO. 60M62 SHT_DOUBLE PLAN SCALE: 1"=50' SHEET 3 OF 4 SHEETS STA. 332+00.00 TO STA. 362+00.00 PLOT DATE = 3/13/2013 DATE 03/13/13 REVISED

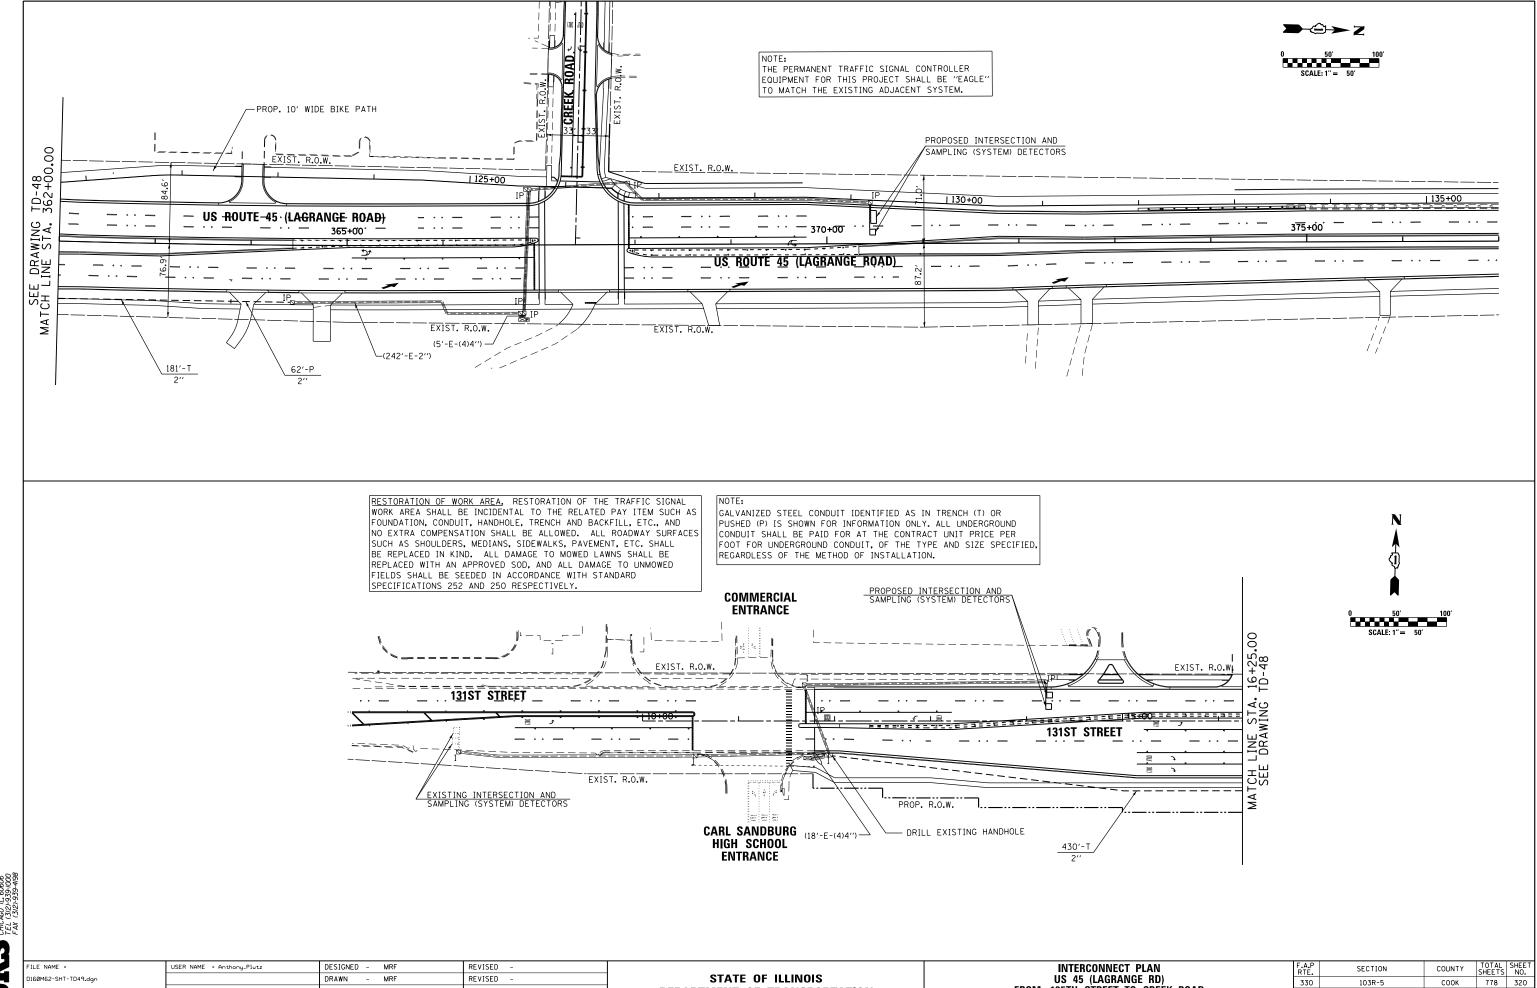

DEPARTMENT OF TRANSPORTATION

FROM 135TH STREET TO CREEK ROAD

4 OF 4 SHEETS STA. 362+00.00 TO STA. END

SCALE: 1"=50' SHEET

CONTRACT NO. 60M62

TD-49

100 S. WACKEI SUITE 500 SUITE 500 CHICAGO 11, 60 FAX (12):-939 FAX (12):-939

SHT_DOUBLE PLAN

PLOT SCALE = 100.0000000 '/ in.

PLOT DATE = 3/13/2013

CHECKED -

DATE

MJL

03/13/13

REVISED



160M62-SHT-TD50.dgn

USER NAME = Anthony_Plutz

PLOT SCALE = 100.0000 '/ in.

PLOT DATE = 3/13/2013

DESIGNED - MRF

CHECKED - MJL

MRF

- 03/13/13

DRAWN -


DATE

REVISED

REVISED

REVISED

REVISED

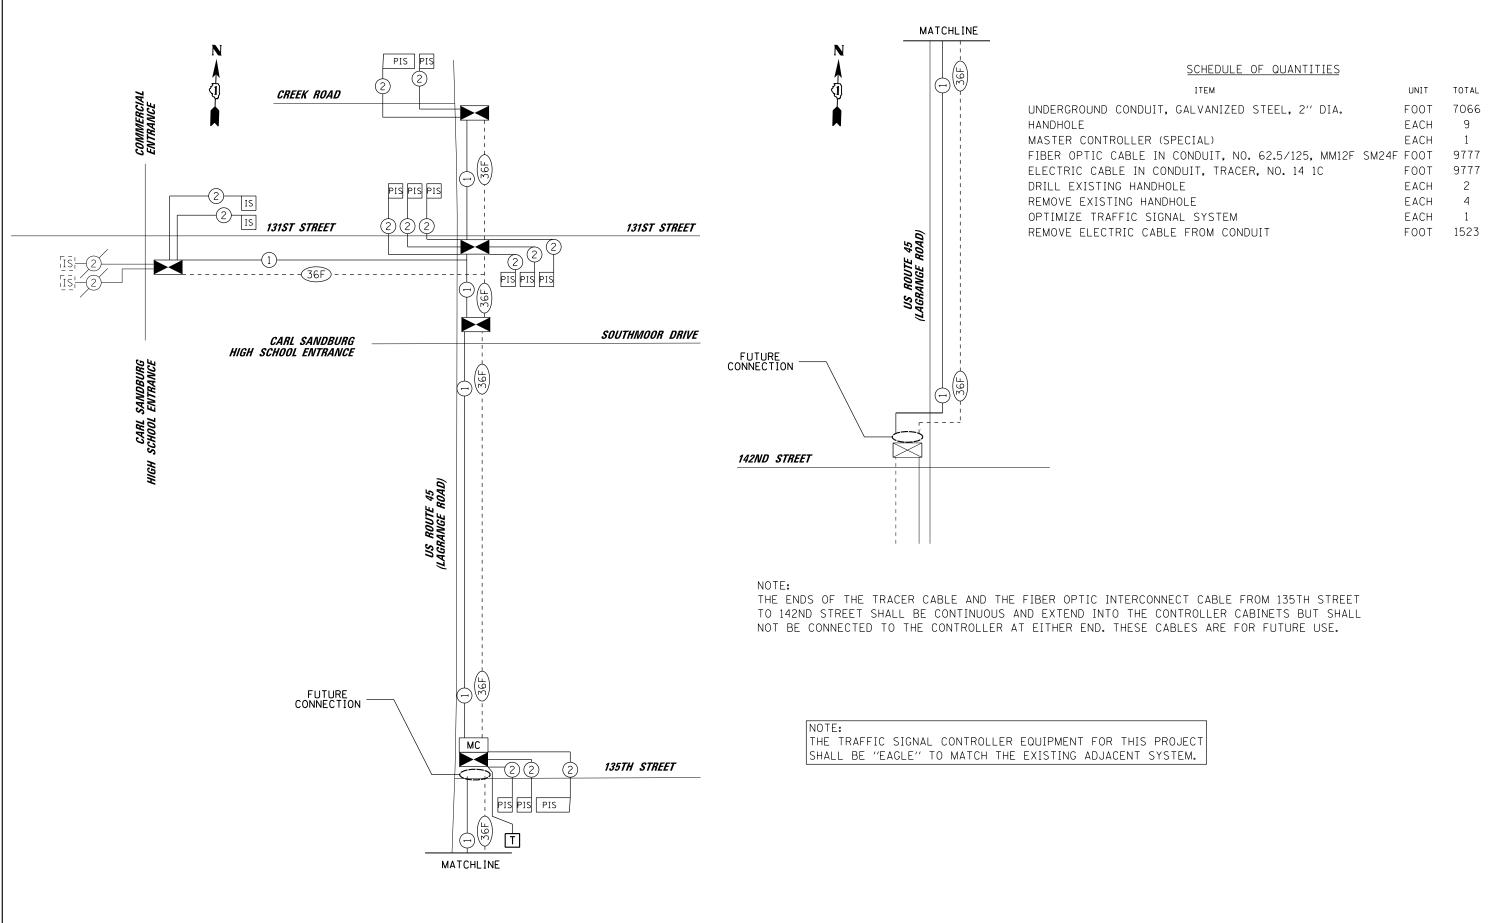

STATE OF ILLINOIS

DEPARTMENT OF TRANSPORTATION

INTERCONNECT SCHEMATIC US 45 (LAGRANGE RD)

FROM 142ND STREET TO CREEK ROAD

SCALE: N.T.S. SHEET 1 OF 1 SHEETS STA.

SECTION

103R-5

TD-50


330


COUNTY


соок


778 321


CONTRACT NO. 60M62

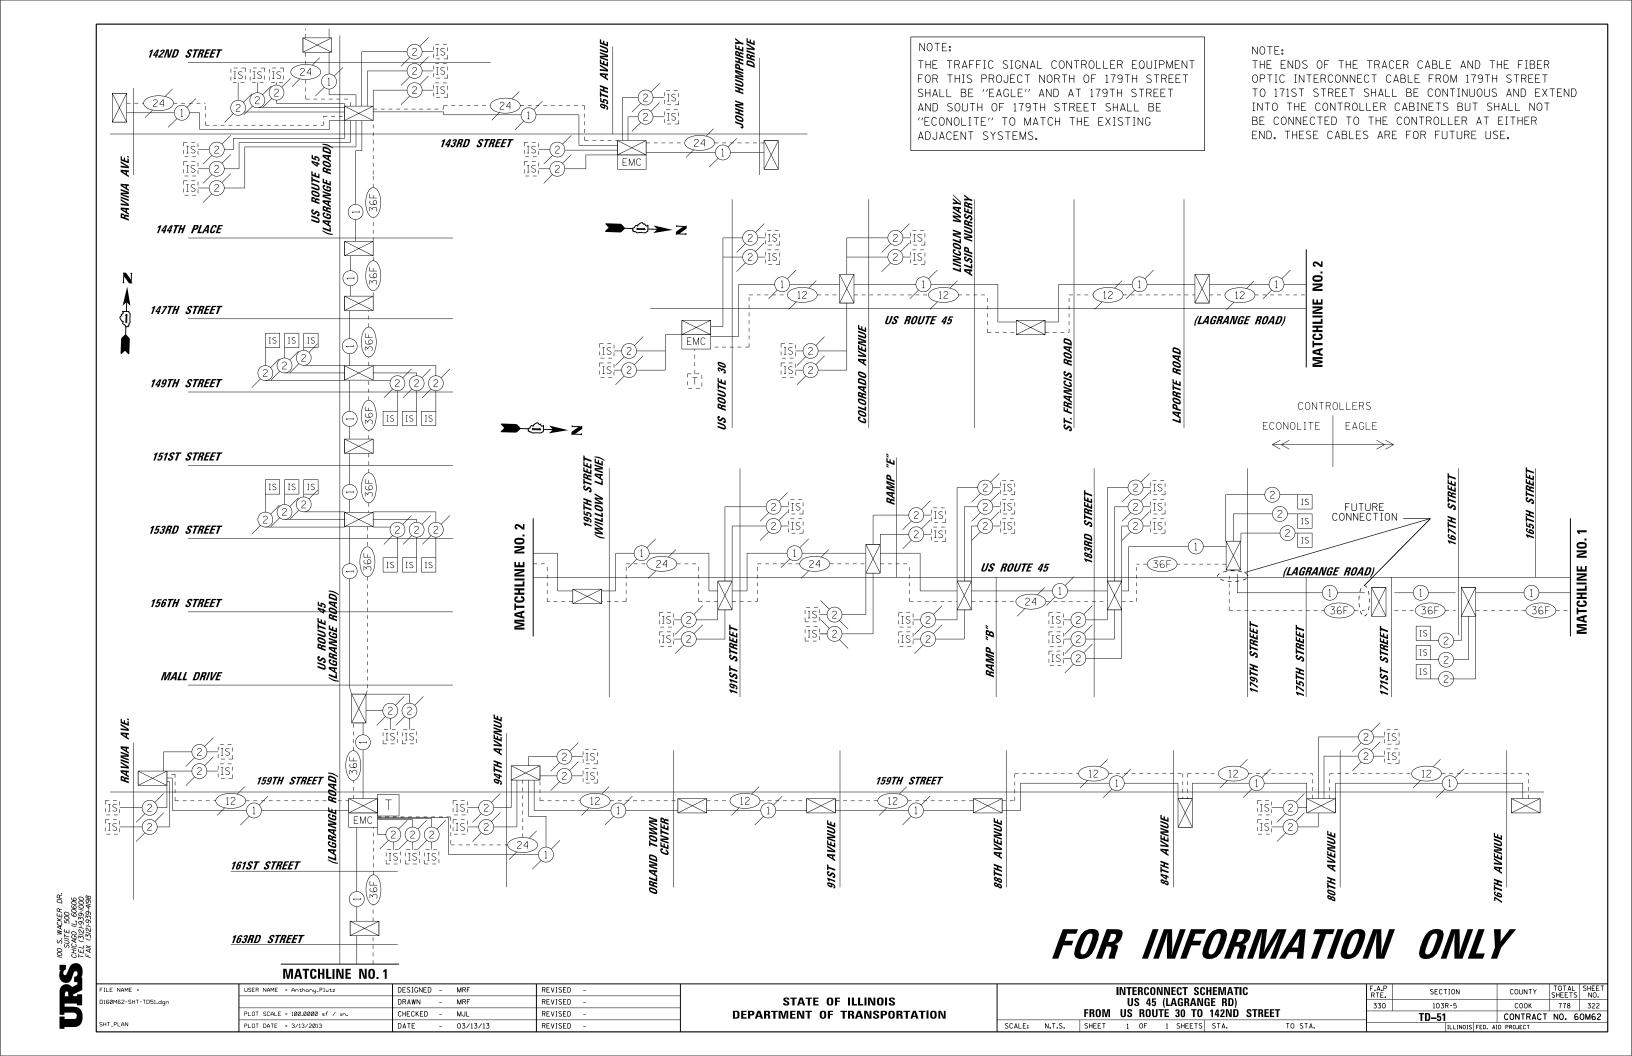

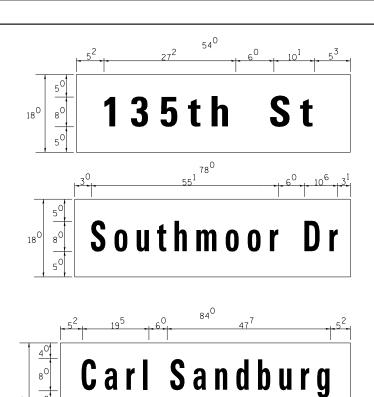

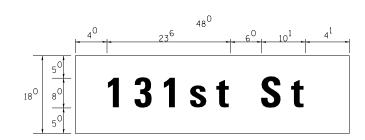

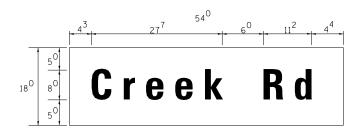

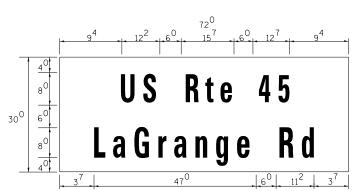

Upper Case To Lower Case Spacing Chart 8-6 Inch Series "C & D"

							SEC	ONI) L	ETT	ER						
			de oq	b h m n ı		f	W		j	S	+	V	У	>	<	2	Z
	SERIES	С	D	С	D	С	D	С	D	С	D	С	D	С	D	С	D
	A W X	12	14	14	1 ⁵	12	14	06	10	11	14	06	10	1 ¹	12	12	14
	В	14	1 ⁵	20	21	14	1 ⁵	1 ¹	1 ²	14	1 ⁵	1 ²	14	12	14	1 ⁶	17
	CEG	14	1 ⁵	20	21	1 ²	14	06	10	1 ²	14	1 ²	14	14	1 ⁵	14	1 ⁵
F	DOQR	14	1 ⁵	20	21	14	1 ⁵	06	10	12	14	12	14	14	1 ⁵	14	1 ⁵
F I R	F	05	06	14	1 ⁵	06	10	05	06	06	10	06	10	06	10	1 ¹	12
S	HIMN	20	21	22	24	20	21	14	1 ⁵	16	17	16	17	20	21	20	21
'	JU	2 0	2 1	20	21	1 ⁶	17	14	1 ⁵	16	17	16	17	1 ⁶	17	20	21
Ē	K L	11	12	16	17	11	1 ²	05	06	11	12	11	12	11	1 ²	12	14
E T T	Р	12	14	14	1 ⁵	12	14	05	06	11	12	11	12	12	14	12	14
Ē	S	1 ²	14	16	1 7	1 ²	14	06	10	1 ²	14	1 ²	14	1 ²	14	1 ²	14
	Т	11	12	16	1 7	06	10	06	10	11	12	11	12	1 ¹	12	12	14
	٧	06	10	14	1 ⁵	11	12	06	10	1 ²	14	1 ²	14	1 ²	14	12	14
	Υ	05	06	14	1 ⁵	06	10	05	06	05	07	05	06	06	10	11	12
	Z	16	17	22	24	16	17	12	14	16	17	16	17	16	17	20	21

Lower Case To Lower Case Spacing Chart 6 Inch Series "C & D"

							SE	.CO1	1D	LET	TEF	?					
		a c g (d e	рh	ikl	f	W		İ	S	+	V	У	>	<	- 2	7_
	SERIES	С	D	С	D	С	D	С	D	С	D	С	D	С	D	С	D
F	adhgij Imnqu	16	17	22	24	16	1 ⁷	12	14	14	1 ⁵	14	1 ⁵	1 ⁶	1 ⁷	16	1 ⁷
I R S	bfkops	12	14	16	17	11	12	05	06	11	12	11	12	12	14	12	14
T	се	12	14	16	17	12	14	06	10	12	14	12	14	12	14	12	14
L	r	06	10	12	14	06	10	03	03	05	06	05	06	06	10	06	10
Ë T T	† z	12	14	16	17	12	14	06	10	11	12	11	12	12	14	12	14
ĖR	v у	11	12	14	15	11	12	05	06	06	10	06	10	11	12	11	12
'	W	11	12	14	15	11	12	05	06	11	12	11	12	11	12	12	14
	×	12	14	16	17	11	12	05	06	11	12	11	12	11	12	12	14

Number To Number Spacing Chart 8 Inch Series "C & D"

										SE	СО	ND	NL	ΙМВ	ER							
)		1	2	2	1.7	3	2	4	Ę	5	6	ò	-	7	8	3	(9
	SE	RIES	С	D	С	D	С	D	С	D	С	D	С	D	С	D	С	D	С	D	С	D
F I	0	9	1 ⁶	17	1 ⁶	17	14	1 ⁵	1 ²	14	14	1 ⁵	14	1 ⁵	1 ⁶	17	1 ²	14	1 ⁶	17	1 ⁶	17
R S	1		2 ⁰	2 ¹	2 ⁰	21	2 ⁰	2 ¹	1 ⁶	1 ⁷	1 ⁴	1 ⁵	2 ⁰	2 ¹	2 ⁰	2 ¹	14	1 ⁵	2 ⁰	2 ¹	2 ⁰	2 ¹
T	2	3 4	14	1 ⁵	14	1 ⁵	14	1 ⁵	1 ²	14	1 ²	14	14	1 ⁵	1 ⁴	1 ⁵	1 ¹	1 ²	1 ⁶	1 ⁷	14	15
N	5		14	1 ⁵	14	1 ⁵	14	1 ⁵	11	1 ²	1 ¹	1 ²	14	1 ⁵	14	1 ⁵	1 ¹	1 ²	14	1 ⁵	14	1 ⁵
M B	6		1 ⁶	1 ⁷	14	1 ⁵	14	1 ⁵	1 ²	1 ⁵	1 ²	14	14	1 ⁵	14	1 ⁵	1 ¹	1 ²	14	1 ⁵	14	15
E R	7		1 ²	14	1 ²	14	14	1 ⁵	1 ²	1 ⁵	0 ⁵	06	1 ²	14	14	1 ⁵	11	1 ²	14	1 ⁵	1 ²	14
	8		1 ⁶	17	1 ⁶	17	14	1 ⁵	1 ²	1 ⁵	1 ²	14	14	1 ⁵	1 ⁶	17	1 ²	14	1 ⁶	17	14	15

SCALE:

EXAMPLE, 2^{3} DENOTES $\frac{3''}{8}$

UPPER AND LOWER CASE LETTER WIDTHS

E T E R S	6 INCH UPPER CASE LETTERS			H UPPER LETTERS	L E T		LOWER ETTERS
T E	SEF	RIES	SE	RIES	T T E	SEI	RIES
R S	С	D	С	D	T E R S	С	D
А	36	5 ⁰	5 ⁰	6 ⁵	а	35	42
В	32	40	4 3	5 ³	Ь	3 ⁵	42
С	32	40	4 3	5 ³	С	3 5	4 1
D	32	40	4 3	53	d	35	42
E	3 0	35	40	4 7	е	3 ⁵	42
F	3 0	35	40	4 7	f	2 3	26
G	32	40	4 3	5 ³	g	3 5	42
Н	3 2	40	4 3	53	h	3 ⁵	42
I	0 7	0 7	11	12	i	1 1	1 1
J	30	36	40	5 ⁰	j	20	22
К	32	41	4 3	5 4	k	3 ⁵	42
L	3 0	35	40	4 7	I	1 1	1 1
М	3 7	45	51	6 ¹	m	6 ⁰	7 0
N	32	40	43	5 ³	n	35	42
0	34	42	4 5	5 ⁵	0	36	43
Р	32	40	4 3	5 3	Р	35	42
Q	3 4	42	45	5 ⁵	q	35	42
R	32	40	43	5 ³	r	26	32
S	32	40	43	53	S	36	42
Т	30	35	40	4 7	+	2 7	32
U	32	40	4 3	5 ³	u	35	42
V	35	44	4 7	60	٧	42	4 7
W	44	5 ²	60	70	w	5 ⁵	64
X	3 4	40	45	5 ³	×	4 4	5 1
Y	3 6	50	5 0	66	У	46	5 3
Z	3 2	40	43	5 ³	z	36	43


NUM	6 INCH	SERIES	8 INCH	SERIES
N _{UMBER}	С	D	С	D
1	12	1 4	1 ⁵	20
2	3 ²	40	4 ³	5 3
3	3 ²	40	43	5 3
4	3 ⁵	4 3	4 ⁷	5 7
5	32	40	4 3	5 3
6	3 ²	40	4 ³	5 3
7	3 ²	40	4 3	5 ³
8	32	4 0	4 3	5 3
9	3 ²	40	4 3	5 3
0	3 4	42	4 ⁵	5 ⁵

100 S. WACKER DR. SUITE 500 CHICAGO IL, 6606 FEL (312)-333-1020 FAX (312)-339-408

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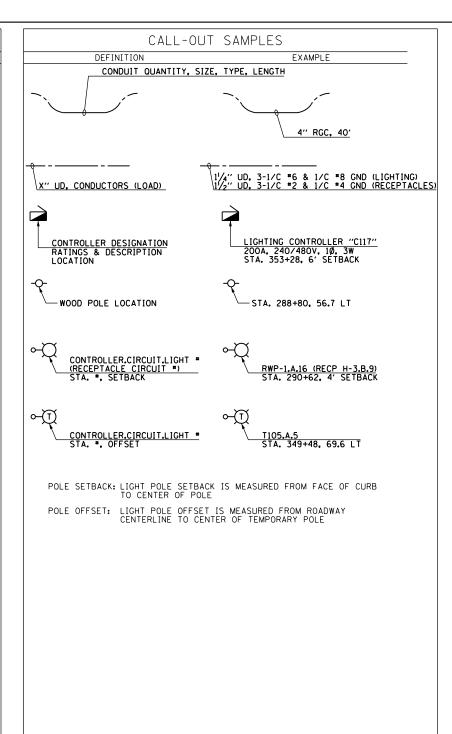
USER NAME = Anthony_Plutz	DESIGNED	-		REVISED	=
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PLOT SCALE = 40.0000000 '/ in.	CHECKED	-		REVISED	=
PLOT DATE = 3/13/2013	DATE	-	03/13/13	REVISED	=

	MAST	ARM	MOUNT	ED SIGNS		F.A.P RTE.	SEC ⁻	ΓΙΟΝ	COUNTY	TOTAL SHEETS	SHEET NO.
LED				STREET NAME	SIGNS	330	103	R-5	COOK	778	323
									CONTRACT	NO. 6	ОМ62
	SHEET	OF	SHEETS	STA.	TO STA.			ILLINOIS FED. A	D PROJECT		

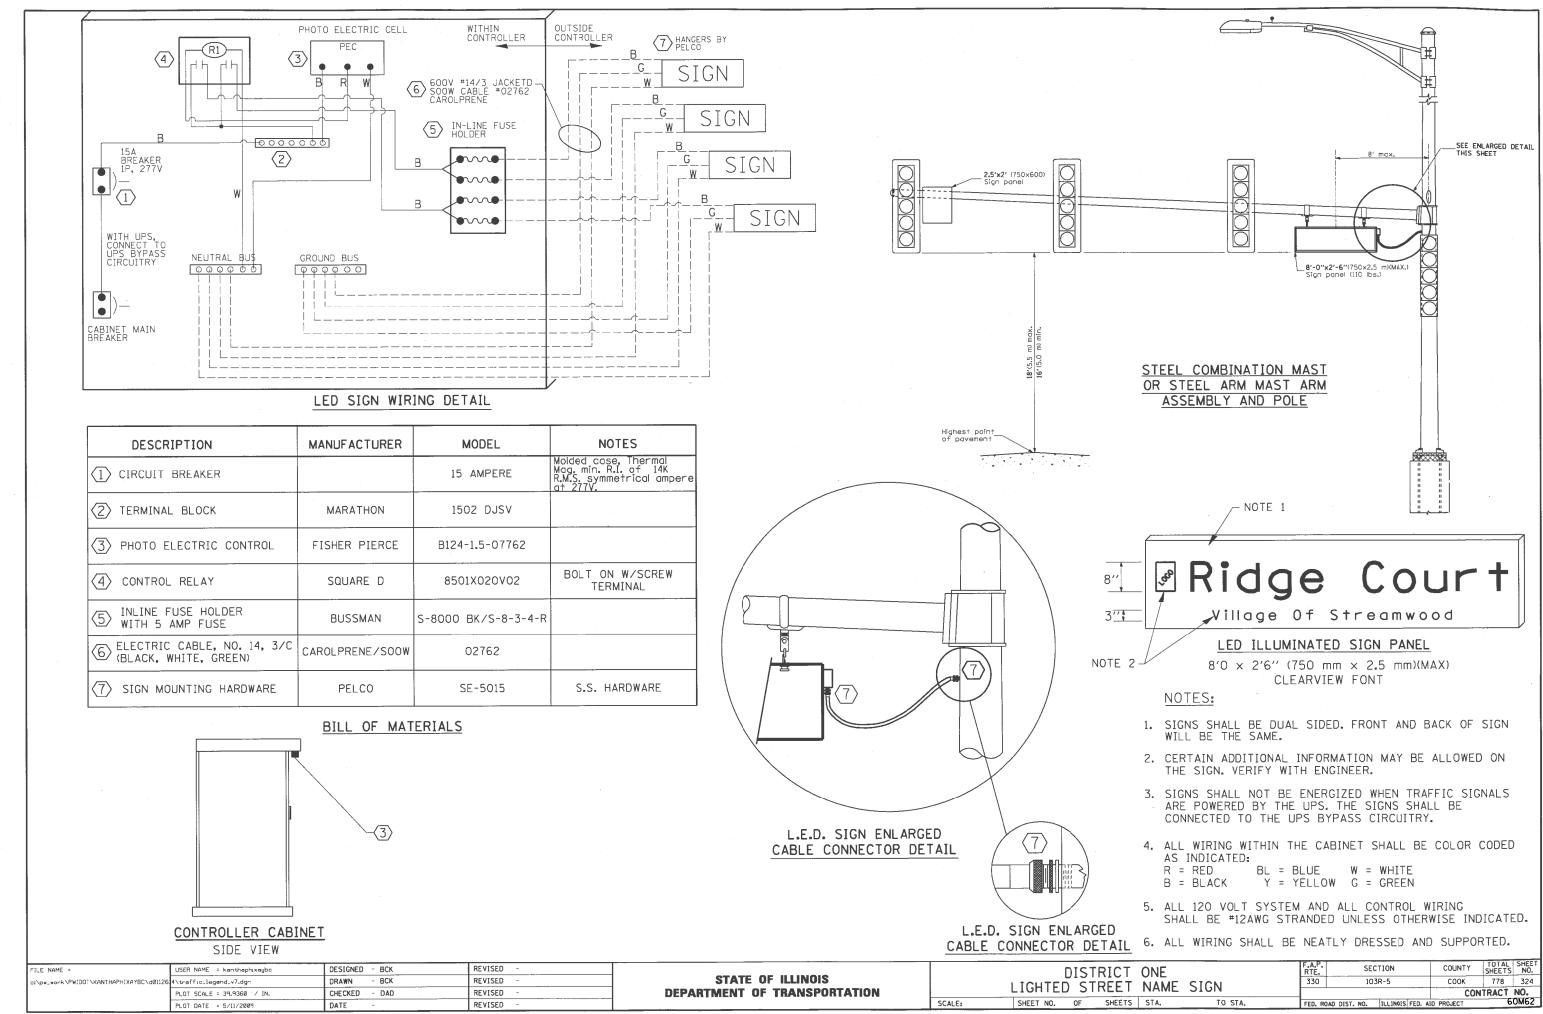

ROADWA	AY ELECTRICAL SYMBOLS
SYMBOL COMPANY	DESCRIPTION PROPOSED LIGHTING UNIT: 400W, 240V PHASE TO NEUTRAL, HPS LUMINAIRE WITH TYPE III DISTRIBUTION, 45'-2" ALUMINUM POLE SHAFT ON 24" DIAMETER CONCRETE FOUNDATION, 47'-6" MOUNTING HEIGHT, 12'-0" MAST ARM, WITH 5A FUSES, T-BASE AND 20A, 120V GFCI RECEPTACLE 15'-0" ABOVE THE BASE OF POLE. BLACK W/BANNER ARM AND ORNAMENTAL BRACKET.
⊶ ®	RELOCATED LIGHTING UNIT, PROVIDE NEW 250W HPS, 240V, MC-III LUMINAIRE ON A RELOCATED POLE PROPOSED LOCATION
o—ŒÑA	RELOCATED LIGHTING UNIT IN PROPOSED LOCATION
- □	PROPOSED COMBINATION POLE LIGHTING UNIT: 400W, 240V PHASE TO PHASE, HPS LUMINAIRE WITH TYPE III DISTRIBUTION, INSTALLED ON 12'-0" MAST ARM AT 45'-0" MOUNTING HEIGHT, ON POLE AND FOUNDATION SUPPLIED BY THE TRAFFIC SIGNAL CONTRACTOR, WITH 5A FUSES
- (E)	EXISTING LIGHTING UNIT
0-E)	EXISTING COMBINATION POLE LIGHTING UNIT INSTALLED IN AN EARLIER STAGE
-®	EXISTING LIGHTING UNIT TO BE REMOVED
- ₩	EXISTING LIGHTING UNIT TO BE REMOVED AND RELOCATED
~ <u>U</u>	TEMPORARY LIGHTING UNIT: 400W, 240V PHASE TO NEUTRAL, HPS LUMINAIRE WITH TYPE III DISTRIBUTION, 60'-0" CLASS 4 WOOD POLE, 47'-6" MOUNTING HEIGHT, 12'-0" MAST ARM, WITH 5A FUSES
⊶ €	EXISTING TEMPORARY LIGHTING UNIT TO REMAIN
- ®	EXISTING TEMPORARY LIGHTING UNIT TO BE REMOVED
	UNDERPASS LUMINAIRE, 100 WATT, 240V PHASE TO NEUTRAL, HPS, WITH TYPE III DISTRIBUTION, WALL MOUNTED
₩ ¤	EXISTING PEDESTRIAN LIGHTING UNIT
ı ı	EXISTING BOLLARD LIGHTING UNIT
J	ELECTRIC JUNCTION BOX, TYPE AND SIZE AS INDICATED
H	ELECTRIC HANDHOLE
R	GROUND RECEPTACLE

ROADWA	AY ELECTRICAL SYMBOLS
SYMBOL	DESCRIPTION
	EXISTING LIGHTING CONTROLLER
\bowtie	EXISTING COMBINATION LIGHTING CONTROLLER
⊢CSD	EXISTING COMBINATION SERVICE DISCONNECT CABINET, SEE TRAFFIC SIGNAL PLANS
۵	EXISTING UTILITY SERVICE CONNECTION, POLE MOUNTED TRANSFORMER
	EXISTING UTILITY SERVICE CONNECTION, PAD MOUNTED TRANSFORMER
	PROPOSED LIGHTING CONTROLLER 200A, 240/480V, 10, 3W, SINGLE DOOR, BASE MOUNTED
ατ	PROPOSED COMBINATION LIGHTING CONTROLLER ATTACHED TO TRAFFIC SIGNAL CONTROL CABINET 120/240v, 10, 3W
ЦCSD	PROPOSED COMBINATION SERVICE DISCONNECT, SEE TRAFFIC SIGNAL PLANS
	PROPOSED UTILITY SERVICE CONNECTION, POLE MOUNTED TRANSFORMER
	PROPOSED UTILITY SERVICE CONNECTION, PAD MOUNTED TRANSFORMER
-0-	TEMPORARY WOOD POLE, 60' CLASS 4
-	ELECTRIC UTILITY POLE
4	ELECTRIC GROUND ROD
<u>"</u>	ELECTRIC SERVICE WEATHERHEAD
	EXPOSED CONDUIT
	DIRECT BURIED CABLE, UNIT DUCT,
	EXISTING DIRECT BURIED CABLE, UNIT DUCT, OR RACEWAY TO REMAIN
	EXISTING CONDUIT EXPOSED
	EXISTING DIRECT BURIED CABLE, UNIT DUCT, OR RACEWAY TO BE ABANDONED (SEE GENERAL NOTE 1, DRAWING GE-2)
	AERIAL ELECTRIC CABLE
	EXISTING AERIAL ELECTRIC CABLE
	EXISTING AERIAL ELECTRIC CABLE TO BE REMOVED
	CONCEALED CONDUIT IN STRUCTURE
	UNDERGROUND CONDUIT SLEEVE
o	CONDUIT TURNED UP
	CONDUIT TURNED DOWN
×	LIQUID TIGHT FLEXIBLE METAL CONDUIT
3(TITLE TO THE TOTAL OUT OF THE TOTAL OUT OUT OF THE TOTAL OUT OUT OUT OUT OF THE TOTAL OUT



SCALE: NONE

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FILE NAME =

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USER NAME = Anthony_Plutz	DESIGNED	-	MAE	REVISED -
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PLOT SCALE = 2.0000000 '/ in.	CHECKED	-	DAD	REVISED -
PLOT DATE = 3/13/2013	DATE	-	03/13/13	REVISED -

STATE OF ILLINOIS DEPARTMENT OF TRANSPORTATION

		US	45	(La	GRANGE	ROAD)	F.A.P RTE.	F.A.P RTE. SECTION		TOTAL SHEETS	SHEET NO.	
ELECTRICAL SYMBOL LIST AND ABBREVIATIONS						,	REVIATIONS	330	103R-5	соок	778	325
ELECTRICAL STRIBOL LIST AND ADDITEVIATIONS							E-1 CONTRACT NO.			NO. 6	OM62	
١E	SHEET	1	OF	1	SHEETS	STA.	TO STA.		ILLINOIS FED. A	ID PROJECT		

GENERAL NOTES:

- 1. UNLESS NOTED OTHERWISE, ALL LIGHTING EQUIPMENT REMOVED AS PART OF THIS CONTRACT SHALL REMAIN THE PROPERTY OF THE VILLAGE OF ORLAND PARK AND SHALL BE DELIVERED TO THE VILLAGE OF ORLAND PARK WILL REMOVE ALL ROADWAY LIGHTING WIRING FROM CONDUIT PRIOR TO POLE REMOVAL. THE CONTRACTOR SHALL TURN OVER TO THE VILLAGE OF ORLAND PARK ALL REMOVED POLES, MAST ARMS, FIXTURES, AND CONTROLLERS.
- 2. THE CONTRACTOR SHALL COORDINATE ALL WORK AND MATERIALS WITH SPECIAL ATTENTION TO ALL OTHER CONSTRUCTION CONTRACTS. THIS WORK SHALL BE INCLUDED IN THE COST OF THIS CONTRACT. SEPARATE PAYMENT WILL NOT BE MADE.
- 3. THE CONTRACTOR SHALL CALL J.U.L.I.E. (1-800-892-0123) 72 HOURS BEFORE EXCAVATION FOR UNDERGROUND UTILITY LOCATIONS. UTILITY LOCATIONS SHOWN ON PLANS ARE APPROXIMATE.
- 4. THE CONTRACTOR SHALL PROTECT AND CAREFULLY PRESERVE ALL PROPERTY MARKS AND MONUMENTS UNTIL THE OWNER, AN AUTHORIZED SURVEYOR OR AGENT HAS WITNESSED OR OTHERWISE REFERENCED THEIR LOCATION.
- 5. THE CONTRACTOR SHALL OBTAIN ALL NECESSARY PERMITS PRIOR TO COMMENCING WORK AND COMPLY WITH STATE REGULATIONS REGARDING AIR, WATER, AND NOISE POLLUTION.
- 6. THE CONTRACTOR SHALL COORDINATE CONSTRUCTION ACTIVITIES WITH ALL UTILITY COMPANIES.
- 7. WHEN ELECTRIC LIGHTING IS UTILIZED IN NIGHT OPERATIONS THE CONTRACTOR SHALL EXERCISE THE UTMOST PRECAUTIONS IN PREVENTING ADVERSE VISIBILITY TO THE MOTORING PUBLIC.
- 8. QUANTITIES OF RIGID GALVANIZED STEEL CONDUIT AND PVC CONDUIT WHERE INDICATED ON THE PLANS ARE APPROXIMATIONS ONLY. THE CONTRACTOR SHALL FIELD VERIFY ALL LENGTHS AND SHALL INSTALL RACEWAYS IN COMPLETE CONFORMANCE WITH SPECIFIED REQUIREMENTS.
- 9. GROUNDING CONNECTIONS AT ALL EQUIPMENT FOUNDATIONS SHALL BE EXOTHERMICALLY WELDED, UNLESS NOTED OTHERWISE, AS SPECIFIED, AND SHALL BE INSPECTED AND APPROVED BY THE ENGINEER PRIOR TO POURING CONCRETE OR BACKFILLING, AS APPLICABLE.
- 10. NO EQUIPMENT OR MATERIAL SHALL BE DELIVERED TO THE JOB SITE PRIOR TO THE APPROVAL AND INSPECTION OF THE ENGINEER. ANY EQUIPMENT OR MATERIAL DELIVERED TO THE JOB SITE PRIOR TO APPROVAL AND INSPECTION SHALL BE REMOVED FROM THE JOB SITE AT THE CONTRACTOR'S EXPENSE.
- 11. THE PROPOSED LIGHTING CONTROL CABINET SHALL BE INSTALLED WITHIN THE RIGHT OF WAY WITH THE EXACT LOCATION TO BE CONFIRMED BY THE CONTRACTOR IN THE FIELD.
- 12. THE CONTRACTOR SHALL PREPARE A PRELIMINARY SCHEDULE WHEN THE CONTRACT COMMENCES WHICH ESTABLISHES THE DATE WHEN THE ELECTRICAL SERVICES WILL BE REQUIRED. THIS SCHEDULE SHALL BE FORWARDED IN WRITING TO COMMONWEALTH EDISON COMPANY (COMED). SUBSEQUENT UPDATING OF THE SCHEDULE SHALL BE FORWARDED TO COMED AS CHANGES MAY OCCUR IN THE DATE OF SERVICE REQUIREMENTS. TEN (10) DAYS BEFORE THE ELECTRICAL SERVICES ARE REQUIRED, THE CONTRACTOR SHALL NOTIFY COMED BY PHONE AND CONFIRM THE REQUEST IN WRITING. COMED SERVICE CONTRACT AND AGREEMENT SHALL BE FORWARDED TO THE VILLAGE OF ORLAND PARK FOR REVIEW AND SIGNATURE.
- 13. ALL PITS USED FOR ACCESSING CONDUITS UNDER ROADWAYS SHALL BE LOCATED 5'-O" (MINIMUM) CLEAR FROM THE EDGE OF SHOULDER, LOCATIONS OF THE CONDUIT CROSSINGS SHOWN ARE APPROXIMATE AND MAY BE SHIFTED AS NECESSARY TO MEET THE MINIMUM CLEARANCE REQUIRED. THE CONTRACTOR SHALL SUBMIT PLANS FOR THE LOCATION AND SIZE OF EACH PIT AND MAINTENANCE AND PROTECTION OF TRAFFIC AT THE SITE OF EACH PIT FOR THE APPROVAL OF THE ENGINEER BEFORE THE EXCAVATION OF ANY PIT MAY BEGIN.
- 14. EXISTING LIGHTING CONTROLLERS ARE OWNED AND MAINTAINED BY THE VILLAGE OF ORLAND PARK. PROPOSED LIGHTING CONTROLLERS C115 AND C117 WILL BE OWNED AND MAINTAINED BY THE VILLAGE OF ORLAND PARK.
- 15. UNDERGROUND CONDUIT SHALL EXTEND (2') BEYOND THE SHOULDER, CURB, BARRIER WALL, AND/OR GUARDRAIL, AS APPLICABLE.
- 16. THE INSTALLATION OF COMBINATION TRAFFIC SIGNAL AND STREET LIGHT POLES IS A COORDINATED EFFORT OF THE TRAFFIC SIGNAL CONTRACTOR AND ELECTRICAL CONTRACTOR. THE COMBINATION LIGHTING CONTROLLER AND STANDARD COMBINATION LIGHTING DISCONNECT DETAILS ARE INCLUDED IN THE TRAFFIC SIGNAL DRAWINGS. THE TRAFFIC SIGNAL CONTRACTOR WILL PROVIDE AND INSTALL THE COMBINATION LIGHTING CONTROLLER, THE COMBINATION POLE, THE LUMINAIRE MAST ARM, AND THE COMBINATION POLE AND INSTALL THE COMBINATION POLE LUMINAIRE, ALL WIRING INSIDE THE COMBINATION POLE ASSOCIATED WITH THE LUMINAIRE, LIGHTING CONDUCTORS BETWEEN ALL COMBINATION POLE ASSOCIATED WITH THE LUMINAIRE, LIGHTING CONDUCTORS BETWEEN ALL COMBINATION POLE ASSOCIATED WITH THE LUMINAIRE, AND THE LIGHTING POWER CONDUCTORS BETWEEN THE COMBINATION LIGHTING CONTROLLER, AND THE LIGHTING POWER CONDUCTORS BETWEEN THE COMBINATION LIGHTING CONTROLLER AND THE SELECTRICAL CONTRACTOR MUST COORDINATE THE INSTALLATION OF TRAFFIC SIGNAL AND LIGHTING CONDUITS IN THE BASE OF THE COMBINATION SERVICE DISCONNECT, THE BASE OF THE TRAFFIC SIGNAL CONTROL CABINET AND COMBINATION LIGHTING CONTROLLER, THE BASE OF THE TRAFFIC SIGNAL CONTROL CABINET AND COMBINATION DOLES, AND THE INSTALLATION OF CONDUIT AND WIRING BETWEEN THE COMBINATION POLES AND THE INSTALLATION OF CONDUIT AND WIRING BETWEEN THE COMBINATION POLES AND THE INSTALLATION OF CONDUIT AND WIRING BETWEEN THE COMBINATION POLES AND THE INSTALLATION OF CONDUIT AND WIRING BETWEEN THE COMBINATION POLES AND THE INSTALLATION OF CONDUIT AND WIRING BETWEEN THE COMBINATION POLES AND THE INSTALLATION OF CONDUIT AND WIRING BETWEEN THE COMBINATION POLES AND THE INSTALLATION OF CONDUIT AND WIRING BETWEEN THE COMBINATION POLES AND THE STAFFIC SIGNAL CONTROLLER CABINET AND THE COMBINATION POLES IS SHOWN ON THE ELECTRICAL CONTRACTOR'S WORK ASSOCIATED WITH THE COMBINATION POLES IS SHOWN ON THE ELECTRICAL SHEETS.
- 17. COMBINATION LIGHTING WILL BE OWNED AND MAINTAINED BY IDOT, THEREFORE THE COMBINATION POLE UNIT IDENTIFICATION SHALL BE BLACK LETTERS AND NUMERALS ON A SILVER-WHITE REFLECTIVE BACKGROUND. ALL OTHER LIGHTING UNITS AND SYSTEMS ARE NOT MAINTAINED BY IDOT, AND SHALL HAVE AN ALTERNATE COLOR SCHEME IDENTIFICATION OF BLACK ON YELLOW.
- 18. THE TRAFFIC SIGNAL SHEETS DO NOT SHOW THE TRAFFIC SIGNAL MAST ARM POLES BEING INSTALLED IN ANY PARTICULAR STAGE OF CONSTRUCTION. THE TIMING OF THE INSTALLATION IS LEFT UP TO THE TRAFFIC SIGNAL CONTRACTOR. THE GENERAL CONTRACTOR SHALL INSURE THAT THE COMBINATION TRAFFIC SIGNAL/STREET LIGHTING MAST ARM POLES ARE INSTALLED IN THE STAGE SHOWN ON THE ELECTRICAL SHEETS.
- 19. THE COORDINATION OF THE SIDE STREET WORK WITH LAGRANGE ROAD WORK IS LEFT UP TO THE CONTRACTOR. IT IS THE CONTRACTOR'S RESPONSIBILITY TO MAINTAIN THE OPERATING STATUS OF LAGRANGE ROAD STREET LIGHTS REGARDLESS OF THE SIDE STREET STAGING. THIS MEANS THE CONTRACTOR MAY HAVE TO INSTALL TEMPORARY OVERHEAD WIRING FOR LAGRANGE ROAD STREET LIGHTS TO BYPASS STREET LIGHTS NOT YET INSTALLED. NOT ALL POSSIBILITIES FOR TEMPORARY OVERHEAD WIRING NEEDS ARE SHOWN ON THE PLANS, SINCE THIS DEPENDS UPON COORDINATION AS DETERMINED BY THE CONTRACTOR.

GENERAL NOTES (CONTINUED):

- 20. FURNISH AND INSTALL A COMBINATION POLE LIGHTING CONTROLLER TO OPERATE THE LIGHT FIXTURES ON THE PROPOSED LIGHTING/TRAFFIC SIGNALS COMBINATION POLES AS SHOWN ON THESE PLANS. THE COMBINATION LIGHTING CONTROLLER (CLC) SHALL BE ATTACHED TO THE SIDE OF THE TRAFFIC SIGNAL CONTROLLER CABINET AS SHOWN ON THE ATTACHED DETAILS. COMBINATION LIGHTING CONTROLLERS ARE POWERED FROM THE PROPOSED LIGHTING/TRAFFIC SIGNALS COMBINATION SERVICE DISCONNECT CABINET, AND PAID FOR UNDER PAY ITEM NO. X8250090 "COMBINATION POLE LIGHTING CONTROLLERS"
- 21. FURNISH AND INSTALL A 1" UNIT DUCT WITH 3-1/C "8, 1/C "10 G. IN CONDUIT FROM EACH PROPOSED COMBINATION LIGHTING/TRAFFIC SIGNALS SERVICE DISCONNECT CABINET TO EACH PROPOSED COMBINATION LIGHTING CONTROLLER LOCATION. INSTALL THE UNIT DUCT IN A SEPARATE CONDUIT FOR THE ENTIRE RUN. SEE TRAFFIC SIGNAL PLANS FOR LOCATION OF COMED POWER SOURCE FEEDING COMBINATION LIGHTING CONTROLLERS.
- 22. PROPOSED LIGHT POLE SET BACKS ARE MEASURED FROM THE FACE OF CURB TO THE CENTER OF THE LIGHT POLE. MINIMUM SET BACK SHALL BE 3 FEET. OFFSETS FOR TEMPORARY LIGHTING WOOD POLES ARE MEASURED FROM THE ROADWAY CENTERLINE TO THE CENTER OF THE WOOD POLE.

SUGGESTED LIGHTING PHASING NOTES:

PRE-STAGE (PRIOR TO THE START OF STAGE 1 CONSTRUCTION)

- A. FURNISH AND INSTALL TEMPORARY LIGHTING CONTROLLERS "TIO4" AND "TIO5" AS SHOWN ON DRAWINGS E-12 AND E-13.
- B. COORDINATE WITH COMED TO GET POWER TO LIGHTING CONTROLLERS "T104" AND "T105". FURNISH AND INSTALL ALL ITEMS NECESSARY AS COORDINATED WITH COMED TO GET POWER TO LIGHTING CONTROLLERS "T104" AND "T105".
- C. FURNISH, INSTALL, AND ENERGIZE ALL TEMPORARY LIGHTING UNITS AS INDICATED ON DRAWINGS E-11 THROUGH E-13 PRIOR TO THE REMOVAL OF EXISTING LIGHTING UNITS.
- D. REMOVE EXISTING LIGHTING UNITS AND FOUNDATIONS ON THE WEST SIDE OF US-45 (Lagrange Road) AS INDICATED ON DRAWINGS E-11 THROUGH E-13 IN ACCORDANCE WITH THE SPECIAL PROVISIONS.
- E. TRANSPORT ALL REMOVED LIGHTING UNITS TO THE OWNER'S ELECTRICAL MAINTENANCE FACILITY FOR PROCESSING AS DETERMINED BY THE ENGINEER, UNLESS NOTED OTHERWISE.

STAGE 1A

- A. REMOVE EXISTING LIGHTING UNITS AND FOUNDATIONS ON THE EAST SIDE OF US-45 (LOGRANGE ROAD) AS INDICATED ON DRAWINGS E-11 THROUGH E-13 IN ACCORDANCE WITH THE SPECIAL PROVISIONS.
- B. TRANSPORT ALL REMOVED LIGHTING UNITS TO THE OWNER'S ELECTRICAL MAINTENANCE FACILITY FOR PROCESSING AS DETERMINED BY THE ENGINEER, UNLESS NOTED OTHERWISE.
- C. COORDINATE WITH COMED FOR THE REMOVAL OF POWER TO UNIDENTIFIED LIGHTING CONTROLLER LOCATED ON DRAWING E-12. REMOVE THE UNIDENTIFIED LIGHTING CONTROLLER AND FOUNDATION. TRANSPORT THE REMOVED LIGHTING CONTROLLER TO THE OWNER'S ELECTRICAL MAINTENANCE FACILITY FOR PROCESSING PER THE SPECIAL PROVISIONS.
- D. FURNISH AND INSTALL PROPOSED LIGHTING CONTROLLERS "C115" AND "C117" AND ASSOCIATED UTILITY SERVICES. COORDINATE WORK WITH COMED.
- E. COORDINATE WITH THE GENERAL CONTRACTOR, THE TRAFFIC SIGNAL CONTRACTOR, AND COMED TO INSURE INSTALLATION OF COMBINATION LIGHTING CONTROLLERS, THE COMBINATION SERVICE DISCONNECT, AND MAST ARM POLES FOR COMBINATION LIGHTING UNITS AS SHOWN IN PLANS.
- F. FURNISH AND INSTALL PROPOSED LIGHTING UNITS AND PROPOSED SOUTHWEST HIGHWAY BRIDGE UNDERPASS LIGHTING UNITS ON THE EAST SIDE OF US-45 (LOGRANGE ROAD) AS INDICATED ON DRAWINGS E-14 THROUGH E-16 AND E-10.
- G. FURNISH AND INSTALL PROPOSED LIGHTING UNITS ON THE NORTH SIDE OF 135+h STREET AS INDICATED ON DRAWING E-17.
- H. FURNISH AND INSTALL PROPOSED LIGHTING UNITS ON THE SOUTH SIDE OF 131st STREET AS INDICATED ON DRAWING E-18.
- I. DISCONNECT EXISTING UNDERPASS LIGHTING UNITS ON EASTERN ENDS OF EXISTING MULTI-USE PATH BRIDGE AND RAILROAD BRIDGE FROM ORLAND PARK CONTROLLER "3 (SHOWN ON DRAWING E-14), CONNECT UNDERPASS LIGHTING UNITS TO PROPOSED LIGHTING CONTROLLER "C115" CIRCUITS A AND B AS INSTRUCTED ON DRAWING E-9.

STAGE 1E


- A. FURNISH AND INSTALL PROPOSED LIGHTING UNITS ON THE EAST SIDE OF US-45 (Lagrange ROAD) AND ON THE SOUTH SIDE OF 135+h STREET AS INDICATED ON DRAWINGS E-19 THROUGH E-21.
- B. ENERGIZE PROPOSED LIGHTING CONTROLLERS "C115" AND "C117" ONCE ALL OF THE CIRCUIT RUNS FOR THE EAST SIDE OF LOGRANGE ROAD AND SIDE STREETS EAST OF LOGRANGE ROAD ARE INSTALLED AS SHOWN ON DRAWINGS E-14 THROUGH E-22, E-9, AND E-10.
- C. PROVIDE PERMANENT UNIT DUCT CONNECTION TO COMBINATION LIGHTING UNITS FROM THEIR RESPECTIVE COMBINATION CONTROLLERS.

STAGE 2

A. REMOVE ALL TEMPORARY LIGHTING UNITS, TEMPORARY LIGHTING CONTROLLERS "T104" AND "T105", ASSOCIATED UTILITY SERVICES, AND WIRING ONCE PROPOSED LIGHTING CONTROLLERS "C115", "C117", AND "TC131" ARE ENERGIZED AND TRAFFIC IS SHIFTED TO PROPOSED NORTHBOUND LANES CONSTRUCTED IN STAGES 1A AND 1B.

STAGE 3

- A. FURNISH, INSTALL, AND ENERGIZE PROPOSED LIGHTING UNITS AND PROPOSED SOUTHWEST HIGHWAY BRIDGE UNDERPASS LIGHTING UNITS ON THE WEST SIDE OF US-45 (LOGRANGE ROAD) AS INDICATED ON DRAWINGS E-23 THROUGH E-25 AND E-10.
- B. FURNISH AND INSTALL PROPOSED LIGHTING UNIT ON 131s+ STREET AS INDICATED ON DRAWING E-26. INSTALL PERMANENT UNIT DUCT CONNECTIONS AS INDICATED ON DRAWINGS E-25 AND E-26 TO ENERGIZE PROPOSED ROADWAY LIGHTING UNITS.
- C. DISCONNECT EXISTING UNDERPASS LIGHTING UNITS ON WESTERN ENDS OF EXISTING MULTI-USE PATH BRIDGE AND RAILROAD BRIDGE FROM ORLAND PARK CONTROLLER *3 (SHOWN ON DRAWING E-23), CONNECT UNDERPASS LIGHTING UNITS TO PROPOSED LIGHTING CONTROLLER "C115" AS INSTRUCTED ON DRAWING E-9.
- D. COORDINATE WITH THE GENERAL CONTRACTOR AND THE TRAFFIC SIGNAL CONTRACTOR TO INSURE INSTALLATION OF MAST ARM POLES FOR COMBINATION LIGHTING UNITS.
- E. DISCONNECT ELECTRICAL FEED TO LIGHTING UNIT ON NORTHWEST CORNER OF CREEK ROAD, AND REMOVE LIGHTING UNIT AND FOUNDATION. FURNISH AND INSTALL PROPOSED FOUNDATION TO RELOCATE EXISTING LIGHTING UNIT. RECONNECT AND ENERGIZE EXISTING LIGHTING UNIT IN PROPOSED LOCATION. SEE DRAWING E-8 FOR DETAILS.

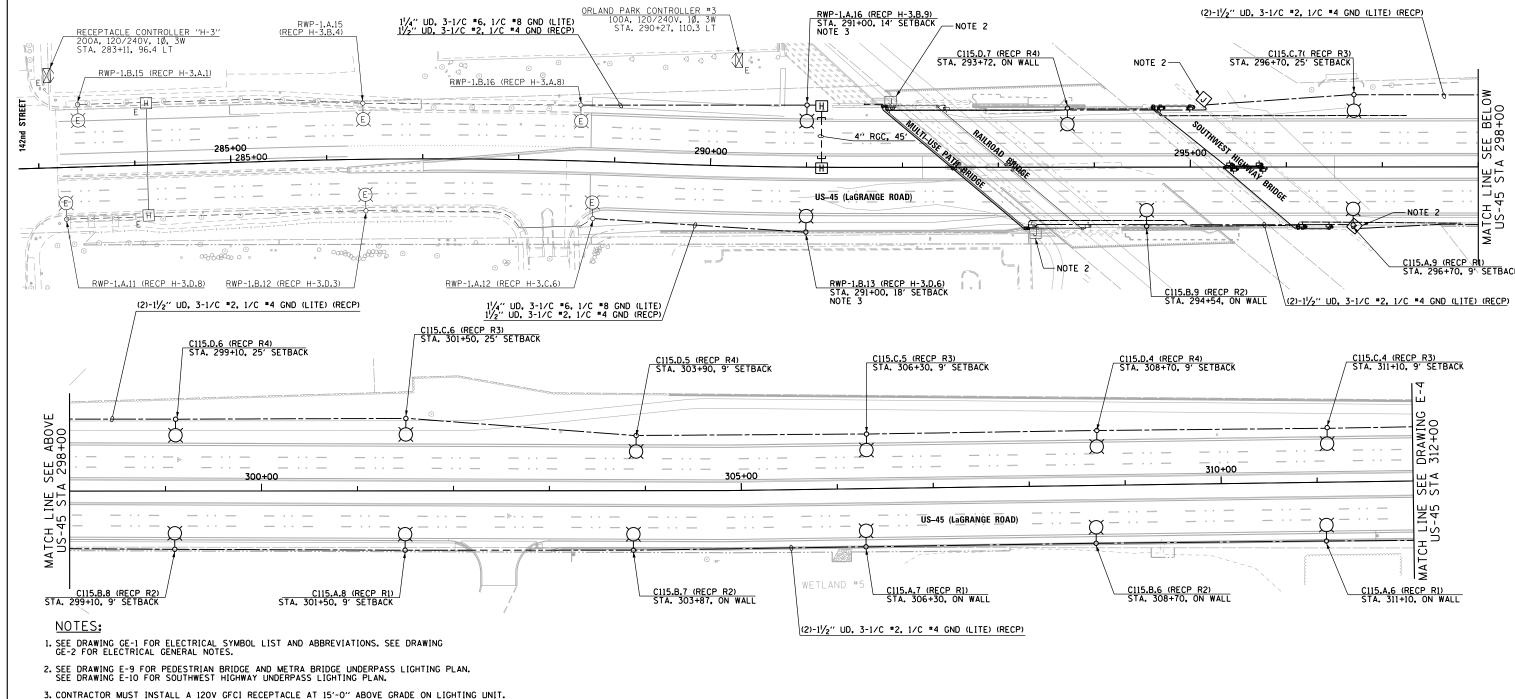

- 3. CONTRACTOR MUST INSTALL A 120V GFCI RECEPTACLE AT 15'-0" ABOVE GRADE ON LIGHTING UNIT. CONNECT RECEPTACLE TO CONTROLLER H-3.
- 4. STREET LIGHTING CONTROLLER RWP-1 IS LOCATED SOUTH OF 143rd STREET ON THE EAST SIDE OF THE ROAD AT APPROXIMATE STATION 270+00.
- 5. CONTRACTOR SHALL ALTERNATE ALL LIGHTING AND RECEPTACLE CIRCUITS INCLUDING COMBINATION LIGHTING CIRCUITS USING A MINIMUM OF TWO (2) CIRCUIT BREAKERS.
- 6. ALL MATERIALS, EQUIPMENT, AND LABOR NEEDED TO INSTALL AND CONNECT THE SERVICE FROM THE COMED UTILITY TRANSFORMER TO THE LIGHTING CONTROLLER CABINET SHALL BE PART OF PAY ITEM NO. 80400100 ELECTRIC SERVICE INSTALLATION. THAT SHALL INCLUDE THE APPROVED METER SOCKET PEDESTAL, CABLE, CONDUIT AND TRENCHING FOR THE CONDUIT SHOWN ON THE PLANS. ALL CONNECTIONS, SPLICING, AND WIRING TO THE NEW LIGHTING CONTROLLER IS ALSO INCLUDED UNDER THE SAME PAY ITEM. THE SERVICE CABLE AND CONDUIT SIZE SHALL BE AS SHOWN ON THE PLANS. THE CONTRACTOR SHALL CONNECT ELECTRIC SERVICE CABLES FROM COMED SERVICE TRANSFORMER TO LIGHTING CONTROLLER. CONTRACTOR SHALL CONDUIT SIZE SHALL BE AS SHOWN ON THE PLANS.
- 7. CONTRACTOR SHALL INSTALL GROUND MOUNTED LIGHT POLE FOUNDATIONS AS CLOSE TO RIGHT OF WAY AS POSSIBLE WHERE SHOWN. AT LOCATIONS WHERE A LIGHT POLE IS PROPOSED ON TOP OF RETAINING WALL, CONTRACTOR SHALL ROUTE RETAINING WALL AROUND LIGHT POLES IF FOUNDATIONS CANNOT BE INSTALLED INTEGRAL TO RETAINING WALL.
- 8. SEE TRAFFIC SIGNAL PLANS FOR LOCATION OF COMED POWER SOURCE FEEDING COMBINATION LIGHTING CONTROLLERS. FURNISH AND INSTALL A 1" UNIT DUCT WITH 3-1/C *8, 1/C *10 G. IN CONDUIT FOR ELECTRIC SERVICE TO POWER THE COMBINATION LIGHTING CONTROLLER.
- 9. FURNISH AND INSTALL ELECTRIC HANDHOLES, 4" CONDUITS (RGS OR PVC, AS SHOWN) FOR FUTURE CONTRACT

	USE TO PROVIDE SERVICE TO FUTURE MEDIAN RECEPTACLES.									
FILE NAME =	USER NAME = Anthony_Plutz	DESIGNED - MAE	REVISED -							
D160M62-SHT-E03.dgn		DRAWN - WM	REVISED -							
	PLOT SCALE = 100.0000000 '/ in.	CHECKED - DAD	REVISED -							
SHT_PLAN	PLOT DATE = 3/13/2013	DATE - 03/13/13	REVISED -							

STATE OF ILLINOIS	
DEPARTMENT OF TRANSPORTATION	J


SCALE: 1"=50"

	US-	-45	(La	GRANGE	ROA	D)			F.A.P RTE.	
PROPO	GEL) R	ŃΛΓ	WAY H	CHTIN	IG PLAN			330	
SHEET	1	OF	3	SHEETS	STA.	284+00	TO STA.	312+00		

;	SCALE: 1" = 50	,	
SECTION	COUNTY	TOTAL SHEETS	SHEET NO.
103R-5	соок	778	327
E-3	CONTRACT	NO. 6	0м62

103R-E-3

0 50′ 100

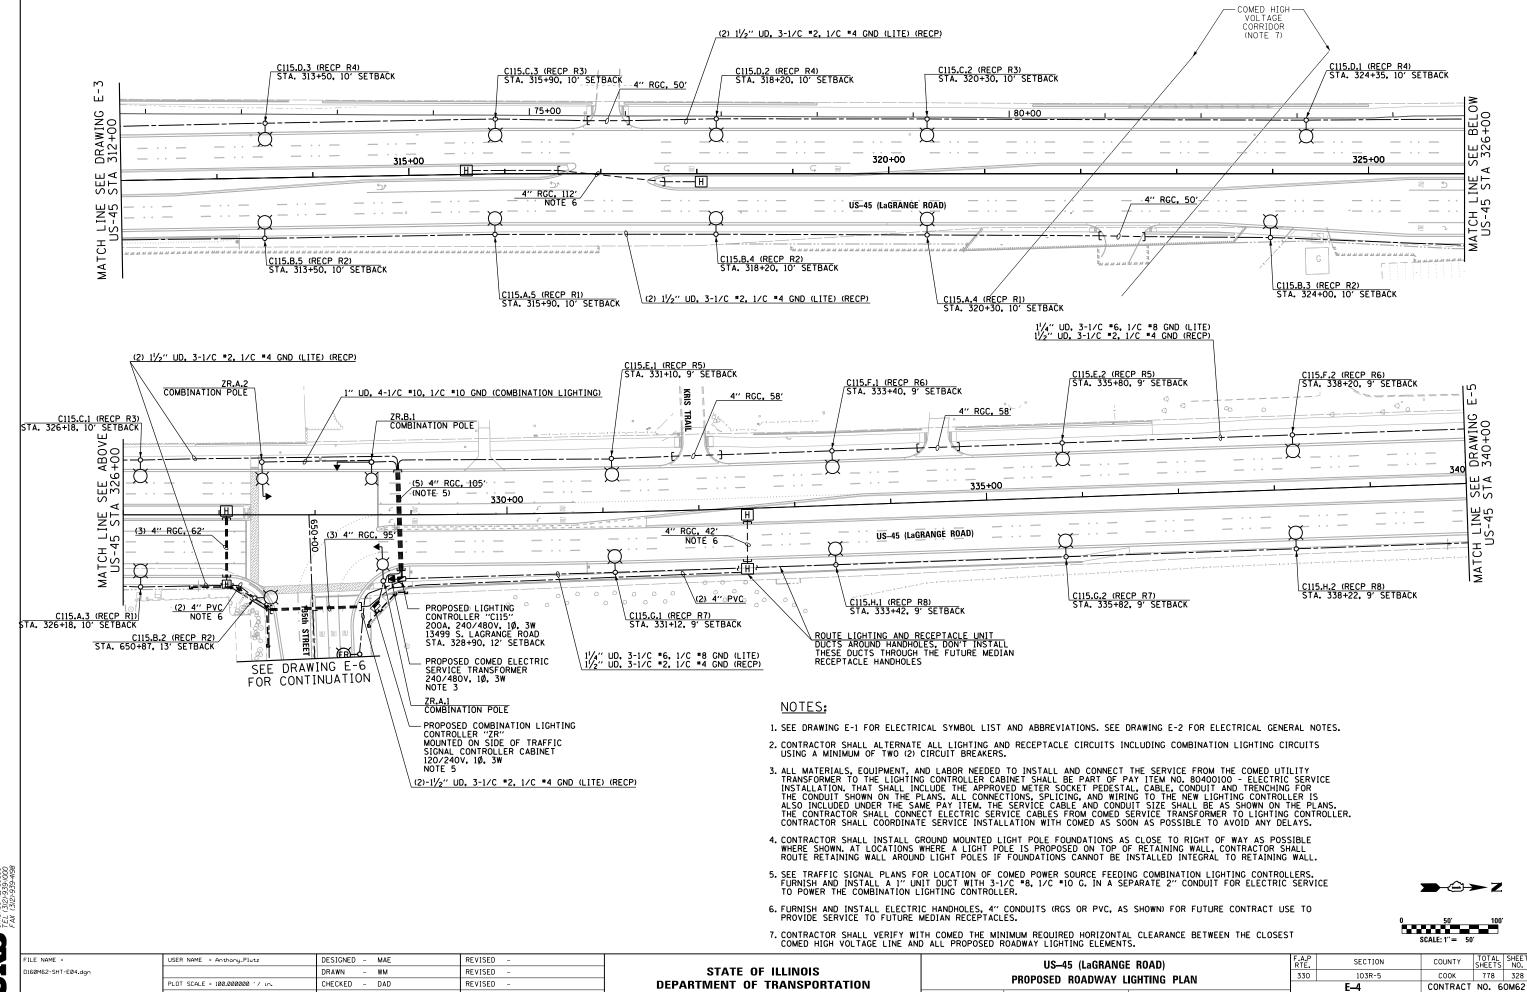

SCALE: 1"=50" SHEET 2 OF 3 SHEETS STA. 312+00 TO STA. 340+00


100 S. WACK SUITE 50 CHICAGO 11, TEL (312)-93


03/13/13

REVISED

DATE

PLOT DATE = 3/13/2013

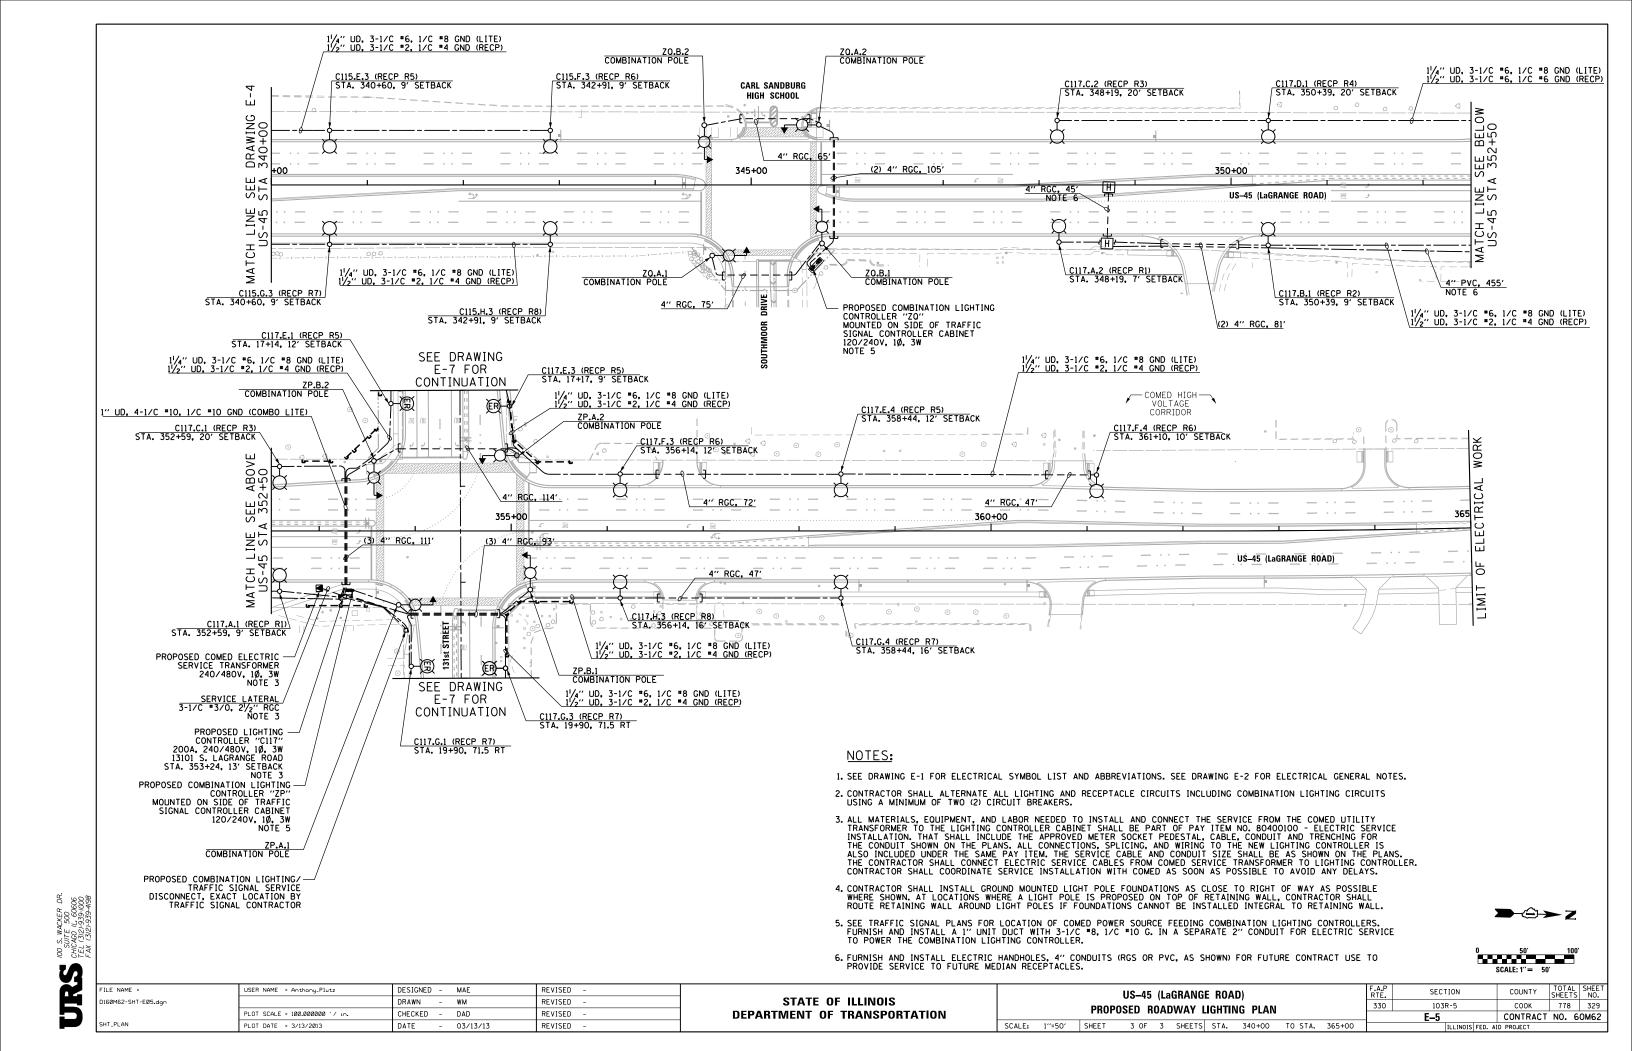


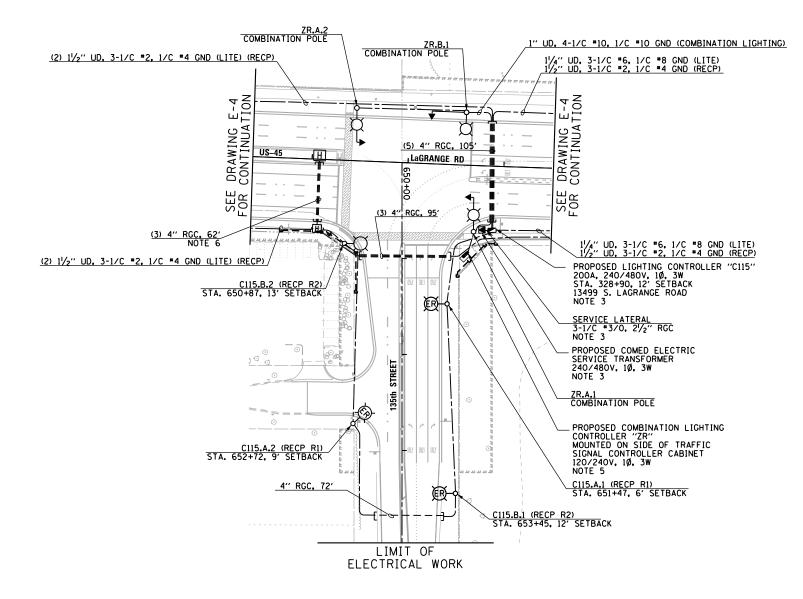


135th ST INERSECTION


NOTES:

- 1. SEE DRAWING E-1 FOR ELECTRICAL SYMBOL LIST AND ABBREVIATIONS. SEE DRAWING E-2 FOR ELECTRICAL GENERAL NOTES.
- 2. CONTRACTOR SHALL ALTERNATE ALL LIGHTING AND RECEPTACLE CIRCUITS INCLUDING COMBINATION LIGHTING CIRCUITS USING A MINIMUM OF TWO (2) CIRCUIT BREAKERS.
- 3. ALL MATERIALS, EQUIPMENT, AND LABOR NEEDED TO INSTALL AND CONNECT THE SERVICE FROM THE COMED UTILITY
 TRANSFORMER TO THE LIGHTING CONTROLLER CABINET SHALL BE PART OF PAY ITEM NO. 80400100 ELECTRIC SERVICE
 INSTALLATION. THAT SHALL INCLUDE THE APPROVED METER SOCKET PEDESTAL, CABLE, CONDUIT AND TRENCHING FOR
 THE CONDUIT SHOWN ON THE PLANS. ALL CONNECTIONS, SPLICING, AND WIRING TO THE NEW LIGHTING CONTROLLER IS
 ALSO INCLUDED UNDER THE SAME PAY ITEM. THE SERVICE CABLE AND CONDUIT SIZE SHALL BE AS SHOWN ON THE PLANS.
 THE CONTRACTOR SHALL CONNECT ELECTRIC SERVICE CABLES FROM COMED SERVICE TRANSFORMER TO LIGHTING CONTROLLER.
 CONTRACTOR SHALL CONDUINATE SERVICE INSTALLATION WITH COMED AS SOON AS POSSIBLE TO AVOID ANY DELAYS.
- 4. CONTRACTOR SHALL INSTALL GROUND MOUNTED LIGHT POLE FOUNDATIONS AS CLOSE TO RIGHT OF WAY AS POSSIBLE WHERE SHOWN. AT LOCATIONS WHERE A LIGHT POLE IS PROPOSED ON TOP OF RETAINING WALL, CONTRACTOR SHALL ROUTE RETAINING WALL AROUND LIGHT POLES IF FOUNDATIONS CANNOT BE INSTALLED INTEGRAL TO RETAINING WALL.
- 5. SEE TRAFFIC SIGNAL PLANS FOR LOCATION OF COMED POWER SOURCE FEEDING COMBINATION LIGHTING CONTROLLERS. FURNISH AND INSTALL A 1" UNIT DUCT WITH 3-1/C *8, 1/C *10 G. IN A SEPARATE 2" CONDUIT FOR ELECTRIC SERVICE TO POWER THE COMBINATION LIGHTING CONTROLLER.
- 6. FURNISH AND INSTALL ELECTRIC HANDHOLES, 4" CONDUITS (RGS OR PVC, AS SHOWN) FOR FUTURE CONTRACT USE TO PROVIDE SERVICE TO FUTURE MEDIAN RECEPTACLES.

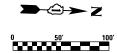


FILE NAME =	USER NAME = Anthony_Plutz	DESIGNED - MAE	REVISED -			F.A.P SECTION	N COUNTY SHEET
D160M62-SHT-E06.dgn		DRAWN - WM	REVISED -	STATE OF ILLINOIS	135th STREET PROPOSED ROADWAY LIGHTING PLAN	330 103R-5	COOK 778 330
	PLOT SCALE = 100.0000000 '/ in.	CHECKED - DAD	REVISED -	DEPARTMENT OF TRANSPORTATION		E_6	CONTRACT NO. 60M62
SHT_PLAN	PLOT DATE = 3/13/2013	DATE - 03/13/13	REVISED -		SCALE: 1"=50" SHEET	In r	INOIS FED. AID PROJECT

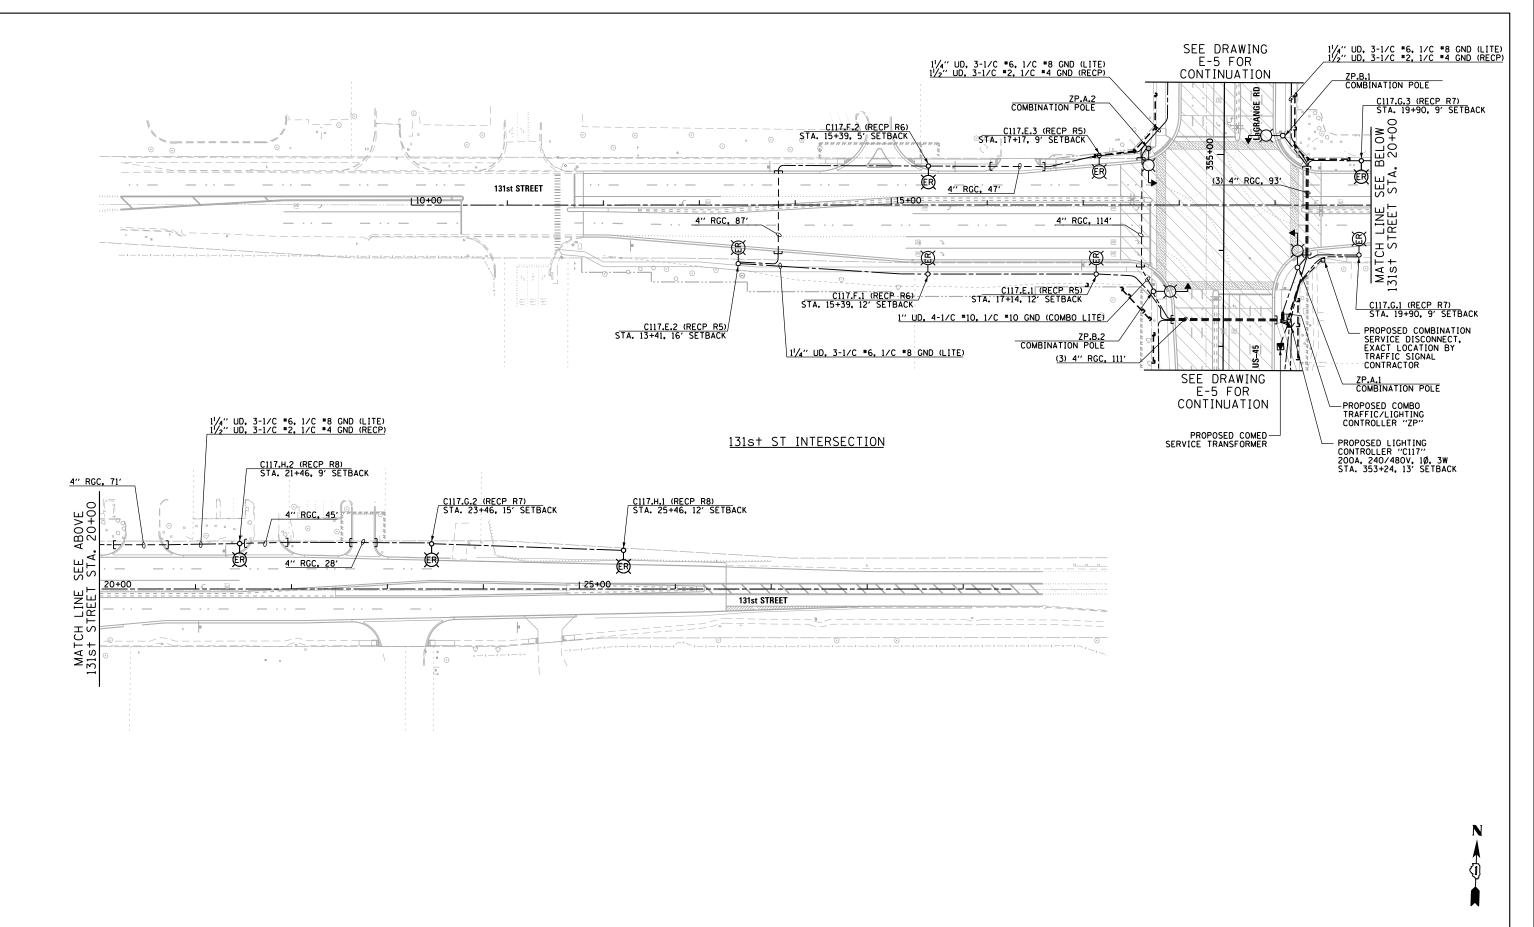

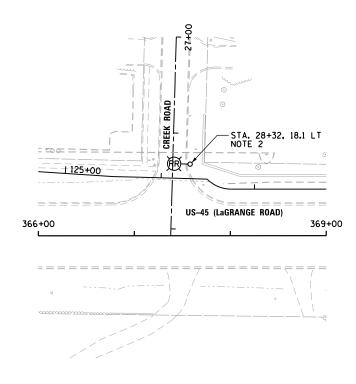

CREEK ROAD ELECTRICAL DEMOLITION PLAN

SCALE: 1" = 50'-0"

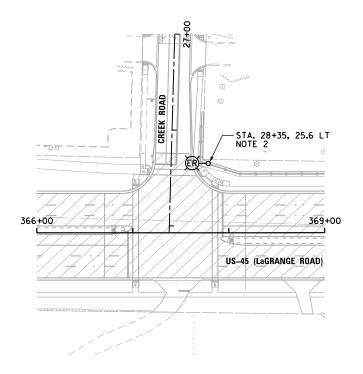

CREEK ROAD PROPOSED ROADWAY LIGHTING PLAN

SCALE: 1" = 50'-0"



- 1. SEE DRAWING E-1 FOR ELECTRICAL SYMBOL LIST AND ABBREVIATIONS. SEE DRAWING E-2 FOR ELECTRICAL GENERAL NOTES.
- GENERAL NOTES.

 2. CONTRACTOR MUST COORDINATE THE REMOVAL AND REINSTALLATION OF LIGHT POLE WITH THE PROPOSED RECONSTRUCTION OF CREEK ROAD AND WITH THE OWNER. SEE MAINTENANCE OF TRAFFIC DRAWINGS FOR LGGRANGE ROAD CONSTRUCTION STAGE 3 AND CREEK ROAD STAGING PLANS. CONTRACTOR TO DISCONNECT POWER SOURCE AT NEXT LIGHT POLE WEST OF POLE TO BE RELOCATED. THE CONTRACTOR MUST CONFIRM THE DIAMETER OF EXISTING BOLT CIRCLE FOR POLE TO BE RELOCATED PRIOR TO REMOVAL OF EXISTING POLE AND CONCRETE FOUNDATION. CONTRACTOR TO REINSTALL EXISTING POLE ON PROPOSED CONCRETE FOUNDATION, AND RECONNECT WIRING TO NEXT POLE WEST OF RELOCATED POLE. SEE IDOT STANDARD DRAWING E-45 FOR PROPOSED LIGHTING UNIT FOUNDATION DETAILS. THIS WORK SHALL BE PAID FOR UNDER THE "REMOVE AND RELOCATE EXISTING LIGHT STANDARD", THE "REMOVE AND RELOCATE EXISTING LIGHT STANDARD", THE "REMOVE AND RELOCATE EXISTING LIGHT STANDARD", THE "REMOVEA OF POLE FOUNDATION", AND THE "LIGHT POLE FOUNDATION, 24" DIAMETER" PAY ITEMS, SEPARATE PAYMENT WILL NOT BE MADE.






FILE NAME =	USER NAME = Anthony_Plutz	DESIGNED -	MAE	REVISED -
D160M62-SHT-E08.dgn		DRAWN -	WM	REVISED -
	PLOT SCALE = 100.0000000 '/ in.	CHECKED -	DAD	REVISED -
SHT_PLAN	PLOT DATE = 3/13/2013	DATE -	03/13/13	REVISED -



									F.A.P RTE.	SECTION	COUNTY
CREEK ROAD ROADWAY LIGHTING PLANS									330	103R-5	COOK
										E-8	CONTRAC
SCALE:	1''=50'	SHEET	1 OF	1 SHE	TS STA.	366+00	TO STA.	369+00		ILLINOIS FED. A	ID PROJECT

;	SCALE: 1" = 50	,	
	COUNTY	TOTAL SHEETS	SHEET NO.
	соок	778	332
	CONTRACT	NO. 6	0м62

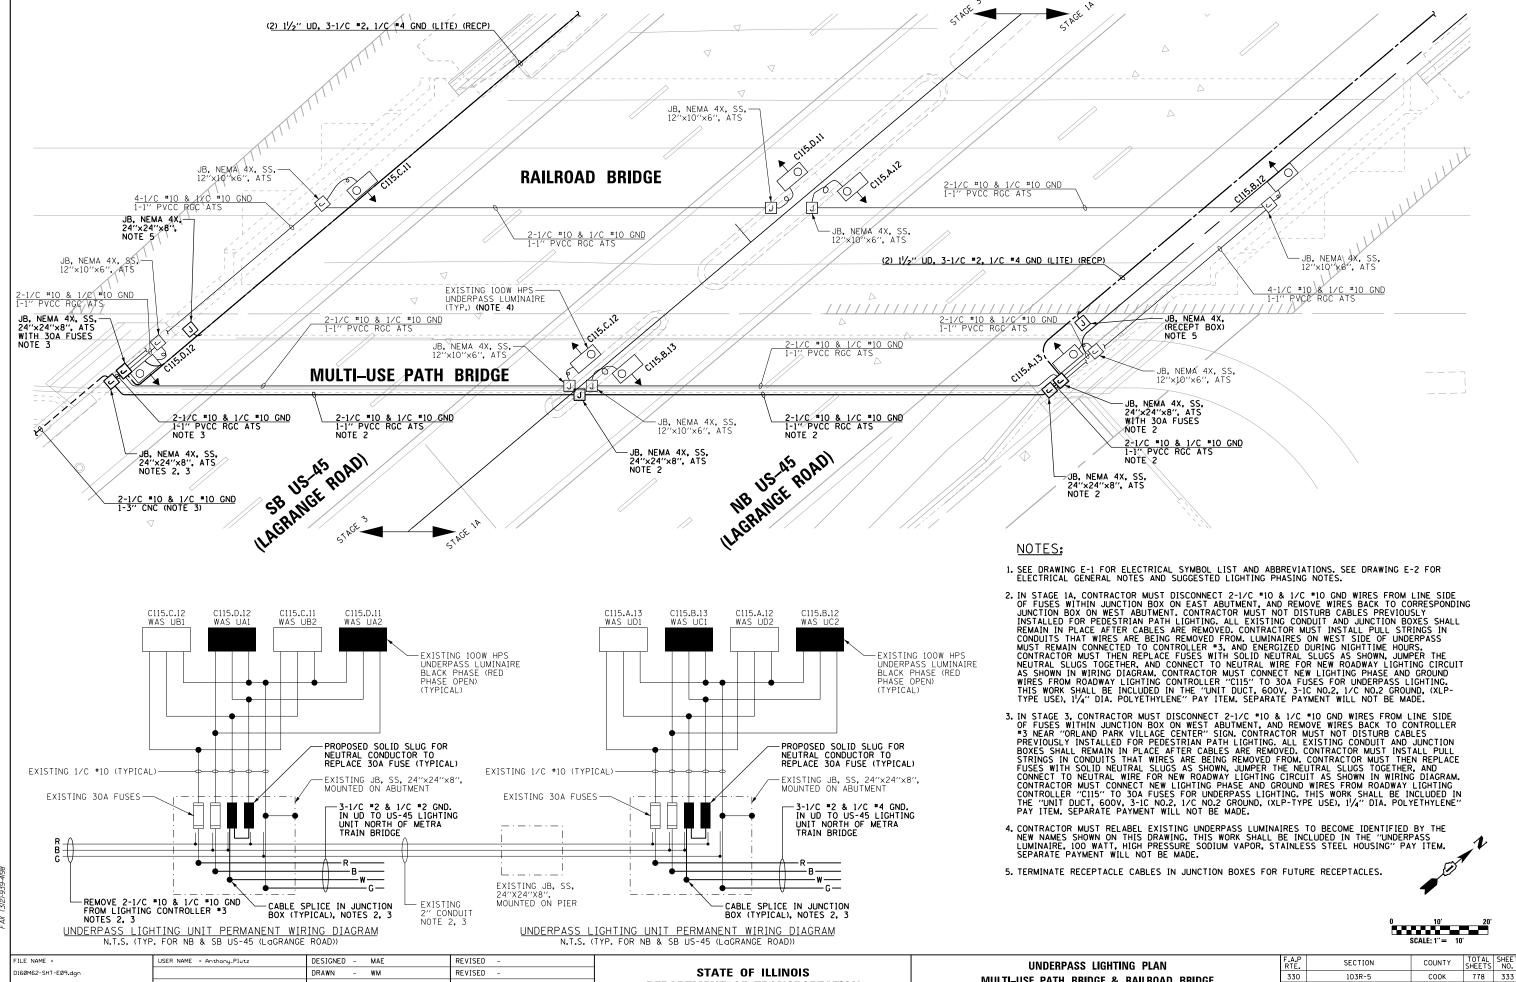

DEPARTMENT OF TRANSPORTATION

MULTI-USE PATH BRIDGE & RAILROAD BRIDGE

SCALE: 1" = 10' SHEET 1 OF 1 SHEETS STA. 164+23 TO STA. 167+50

E-9

CONTRACT NO. 60M62

PLOT SCALE = 20.0000000 '/ in.

PLOT DATE = 3/13/2013


CHECKED -

DATE

DAD

03/13/13

REVISED

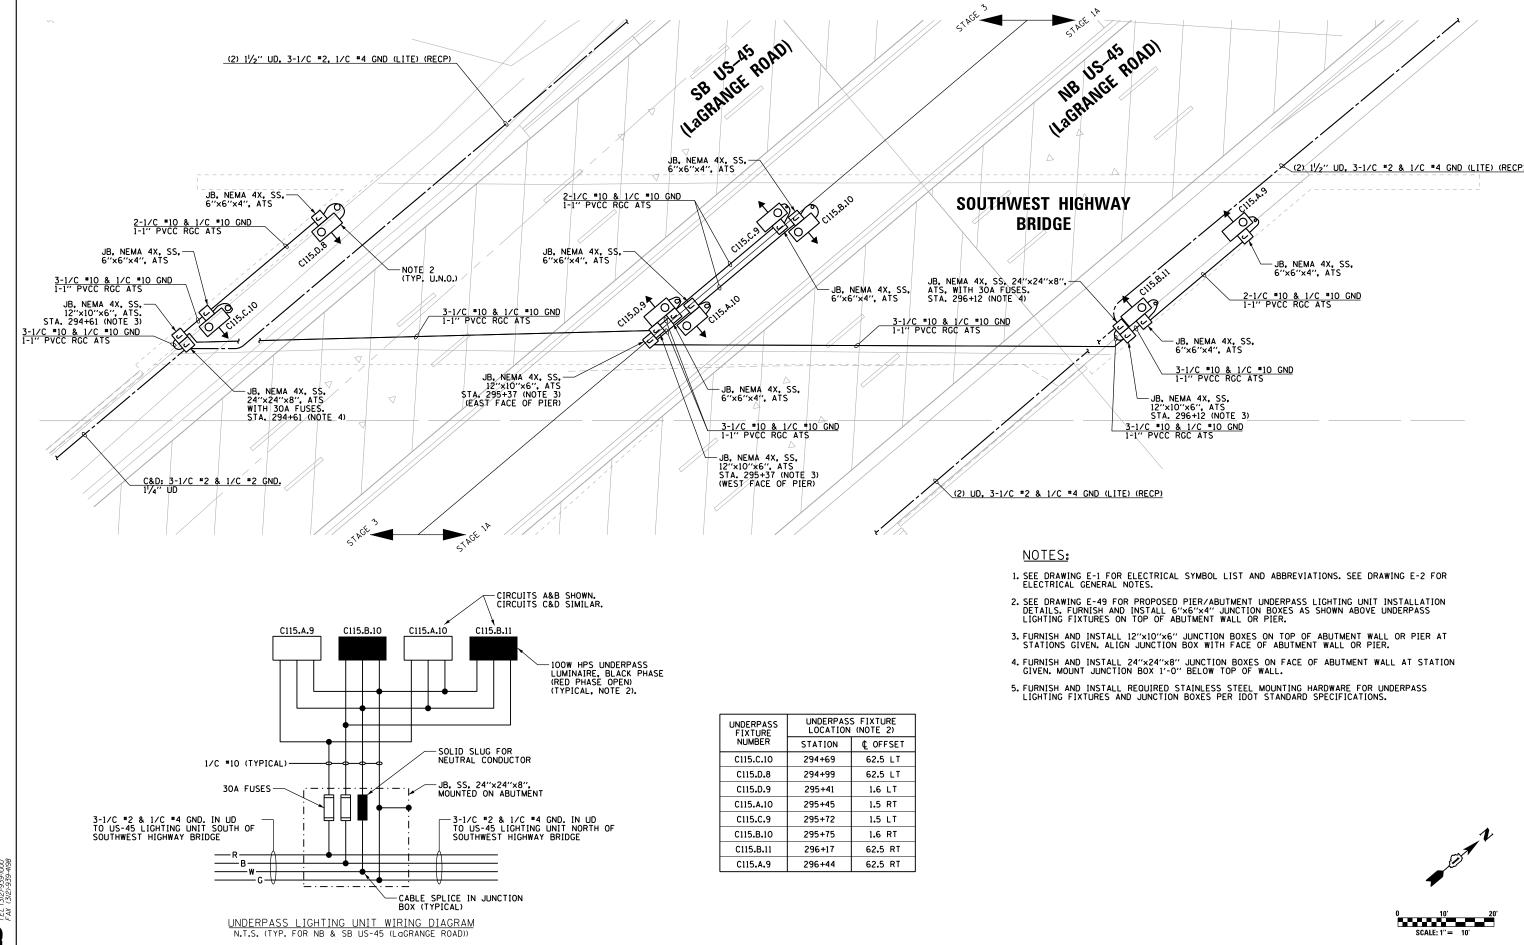

STATE OF ILLINOIS

DEPARTMENT OF TRANSPORTATION

SECTION

103R-5

E-10

330

UNDERPASS LIGHTING PLAN

SOUTHWEST HIGHWAY BRIDGE

1 OF 1 SHEETS STA. 164+23 TO STA. 167+50

SCALE: 1" = 10' SHEET

COUNTY

COOK

778 334

CONTRACT NO. 60M62

ILE NAME :

160M62-SHT-E10.dgr

DESIGNED - MAE

WM

DAD

03/13/13

ORAWN

DATE

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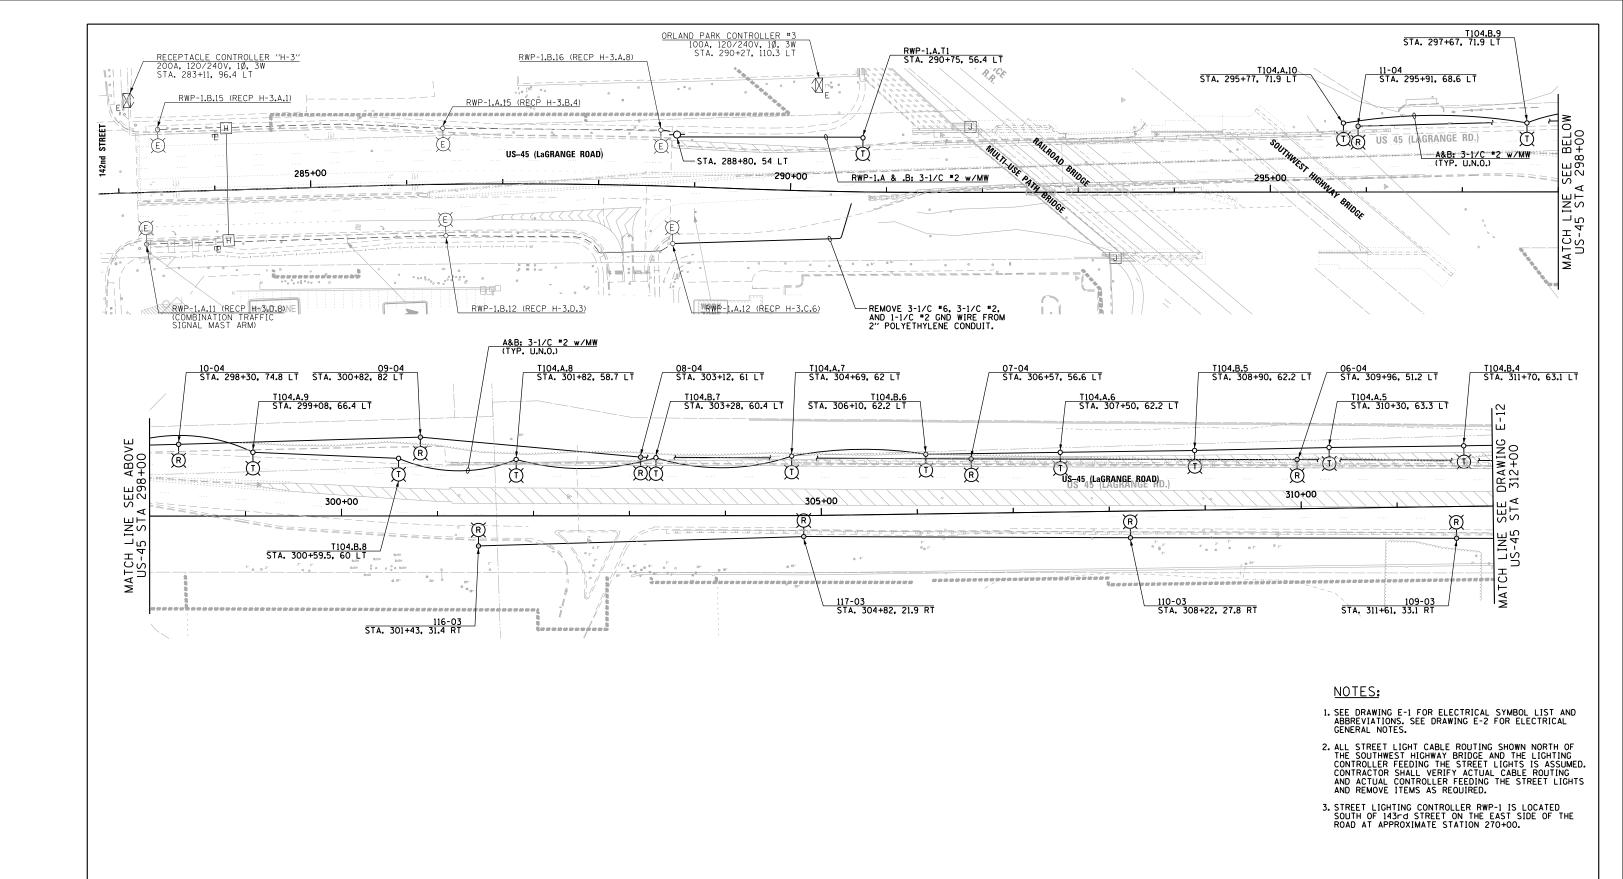
USER NAME = Anthony_Plutz

PLOT DATE = 3/13/2013


REVISED

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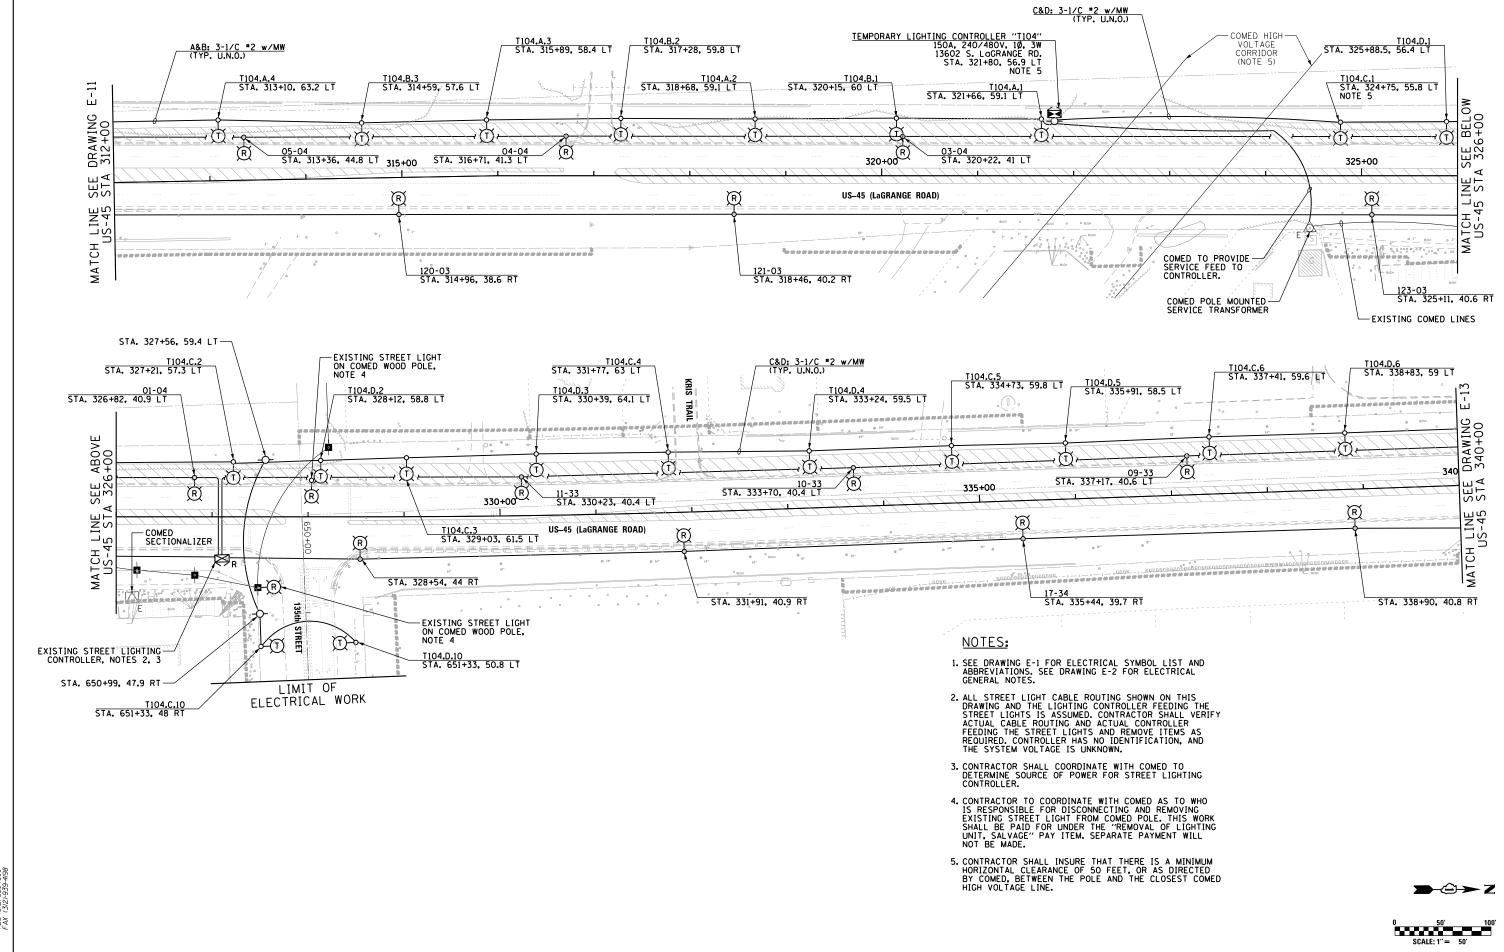
REVISED





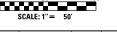

FILE NAME =	USER NAME = Anthony_Plutz	DESIGNED - MAE	REVISED -		US-45 (Lagrange Road)	F.A.P SECTI	ION COUNTY TOTAL SHEET
D160M62-SHT-E11.dgn		DRAWN - WM	REVISED -	STATE OF ILLINOIS		330 103R	-5 COOK 778 335
	PLOT SCALE = 100.0000000 '/ in.	CHECKED - DAD	REVISED -	DEPARTMENT OF TRANSPORTATION	TEMPORARY LIGHTING AND DEMOLITION PLAN	E-11	CONTRACT NO. 60M62
SHT_PLAN	PLOT DATE = 3/13/2013	DATE - 03/13/13	REVISED -		SCALE: 1"=50" SHEET 1 OF 3 SHEETS STA. 284+00 TO STA. 312+00		LLINOIS FED. AID PROJECT





FILE NAME :

160M62-SHT-E12.dar

USER NAME = Anthony_Plutz


PLOT DATE = 3/13/2013


PLOT SCALE = 100.0000000 '/ in.

ORAWN


DATE

DESIGNED - MAE REVISED SECTION COUNTY US-45 (LaGRANGE ROAD) STATE OF ILLINOIS WM REVISED 330 103R-5 COOK 778 336 TEMPORARY LIGHTING AND DEMOLITION PLAN CHECKED -DAD REVISED **DEPARTMENT OF TRANSPORTATION** E-12 CONTRACT NO. 60M62 SCALE: 1"=50' SHEET 2 OF 3 SHEETS STA. 312+00 TO STA. 340+00 03/13/13 REVISED

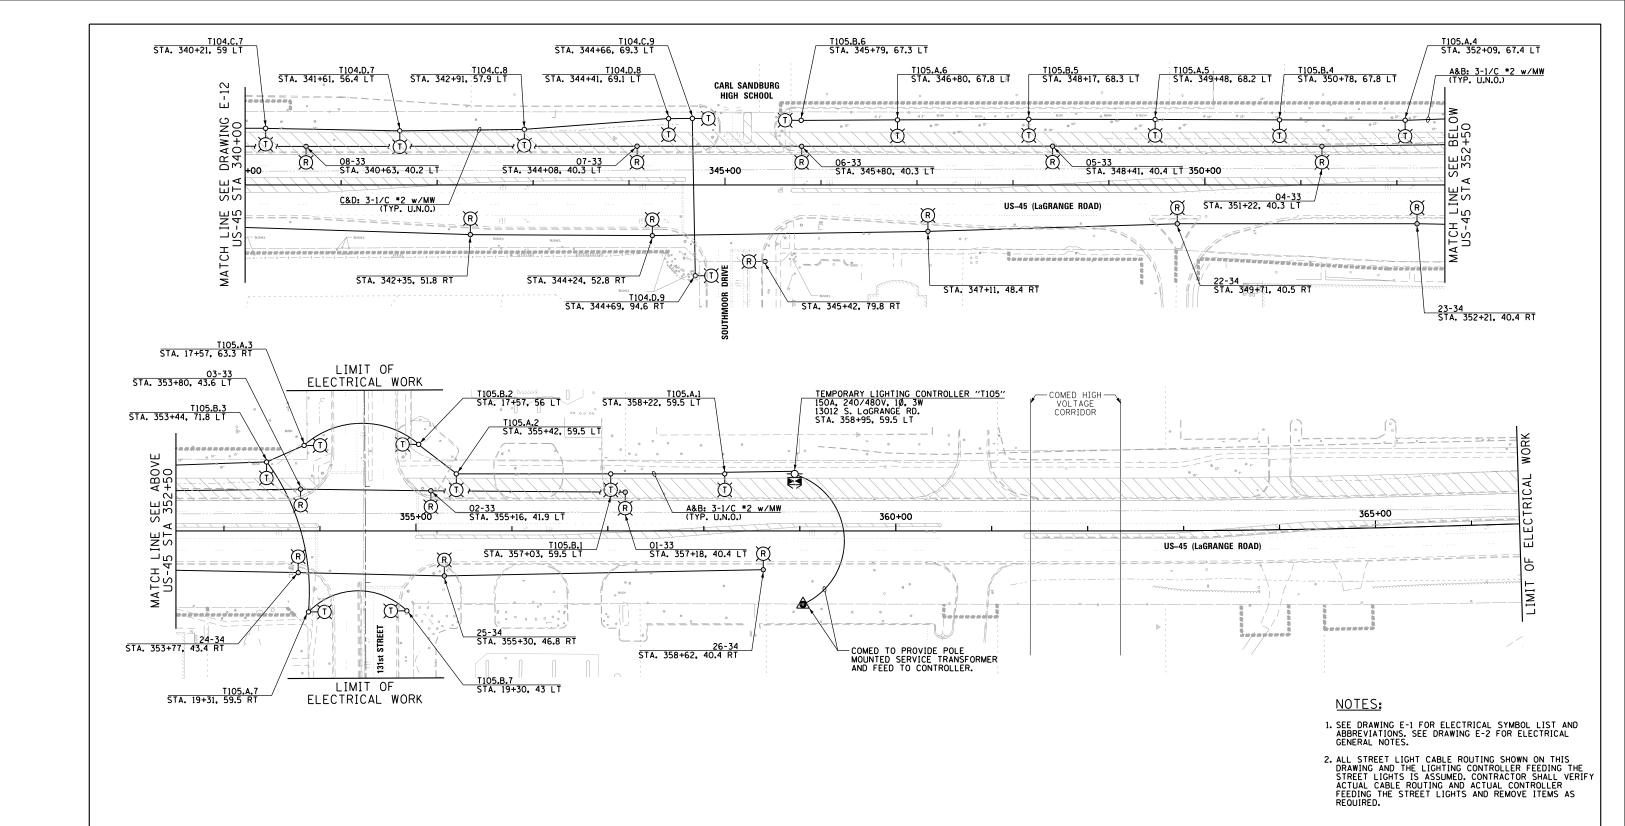

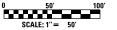

WACKER DR. TE 500 50 II. 60606 312)-939-1000 312)-939-4198								>
100 S. W SUITE CHICAGO TEL (312 FAX (312							0	50' 100' SCALE: 1" = 50'
	FILE NAME =	USER NAME = Anthony_Plutz	DESIGNED - MAE	REVISED -	OTATE OF HUMBIO	US-45 (Lagrange Road)	F.A.P RTE. SECTION	COUNTY TOTAL SHEET SHEETS NO.
	D160M62-SHT-E13.dgn		DRAWN - WM	REVISED -	STATE OF ILLINOIS	TEMPORARY LIGHTING AND DEMOLITION PLAN	330 103R-5	COOK 778 337
		PLOT SCALE = 100.0000000 '/ in.	CHECKED - DAD	REVISED -	DEPARTMENT OF TRANSPORTATION		E-13	CONTRACT NO. 60M62
	SHT_PLAN	PLOT DATE = 3/13/2013	DATE - 03/13/13	REVISED -		SCALE: 1"=50" SHEET 3 OF 3 SHEETS STA. 340+00 TO STA. 366+50	ILLINOIS FF	ED. AID PROJECT

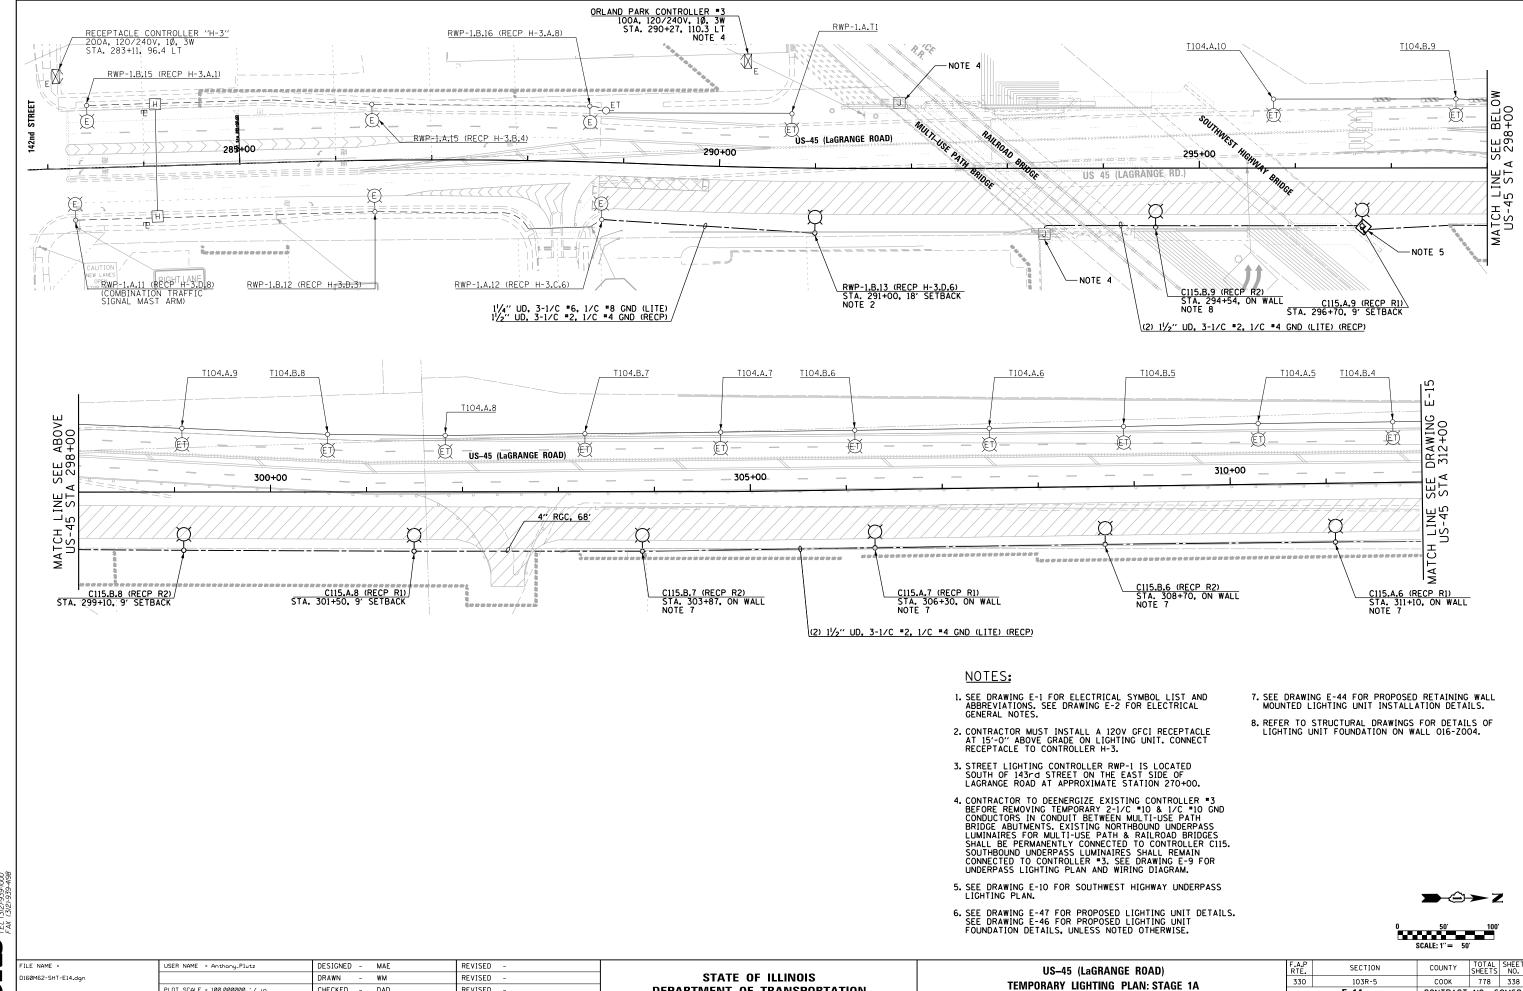

DEPARTMENT OF TRANSPORTATION

SCALE: 1"=50' SHEET

1 OF 3 SHEETS STA. 284+00 TO STA. 312+00

E-14

CONTRACT NO. 60M62

PLOT SCALE = 100.0000000 '/ in.

PLOT DATE = 3/13/2013

CHECKED


DATE

DAD

03/13/13

REVISED

REVISED

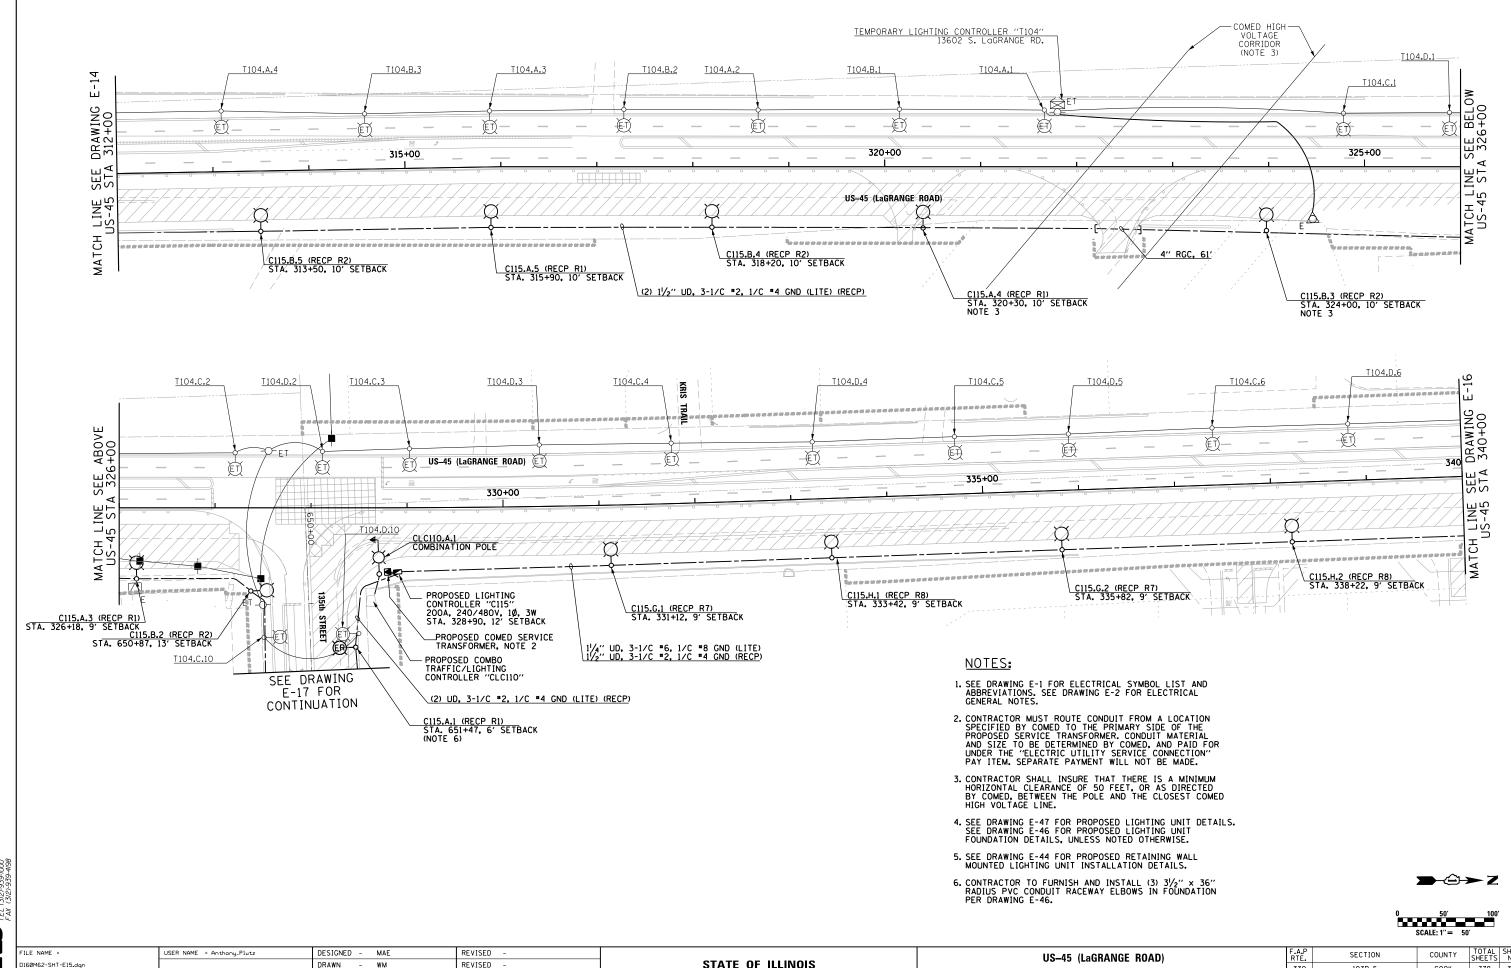


100 S. WACKER DR. SUITE 500 CHICAGO II, 60606 FEL (3I2)-939-1000 FAX (3I2)-939-4198

u	USER NAME = Anthony_Plutz	DESIGNED	-	MAE	REVISED	-
		DRAWN	-	WM	REVISED	=
Р	PLOT SCALE = 100.0000000 '/ in.	CHECKED	-	DAD	REVISED	=
Р	PLOT DATE = 3/13/2013	DATE	_	03/13/13	REVISED	_


STATI	E OI	FILLINOIS
DEPARTMENT	0F	TRANSPORTATION

									F.A.P RTE.	SECTION	COUNTY	TOTAL SHEETS	SHEE1
TEMPORARY LIGHTING PLAN: STAGE 1A								330	103R-5	соок	778	339	
TEMPORANT EIGHTING PEAN. STAGE IA									E-15	CONTRACT	NO. 6	OM62	
SCALE:	1′′=50′	SHEET	2 OF	3 SHEET	S STA.	312+00	TO STA.	340+00		ILLINOIS FED. A	ID PROJECT		

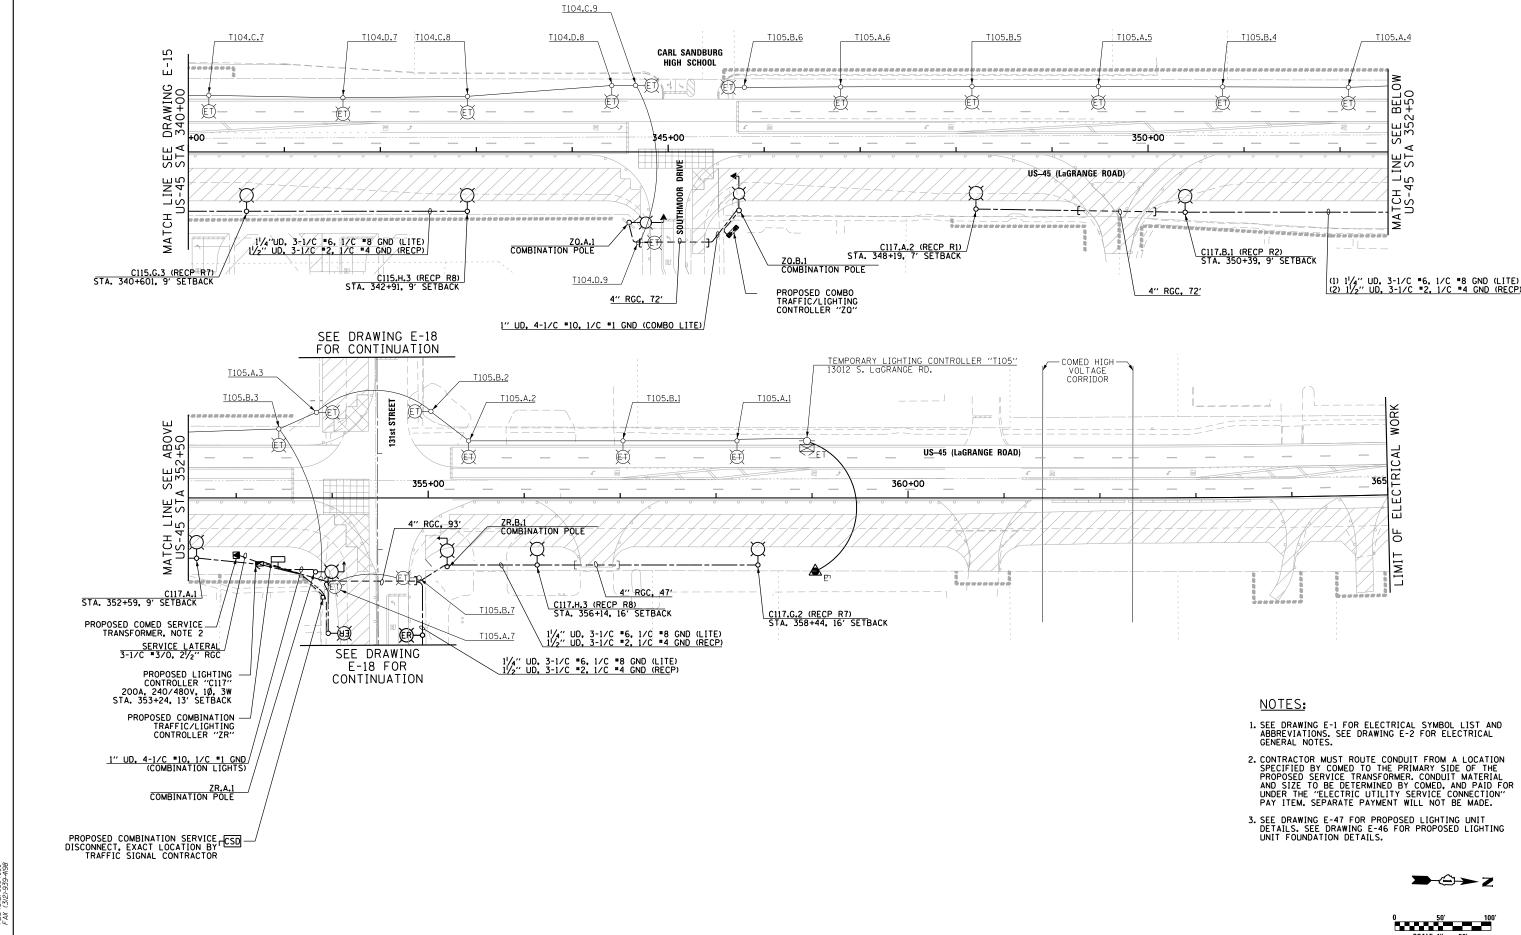



FILE NAME =	USER NAME = Anthony_Plutz	DESIGNED - MAE	REVISED -		US-45 (LaGRANGE ROAD)	F.A.P	SECTION	COUNTY	TOTAL '	HEET
D16@M62-SHT-E16.dgn		DRAWN - WM	REVISED -	STATE OF ILLINOIS	TEMPORARY LIGHTING PLAN: STAGE 1A	330	103R-5	соок	778	340
	PLOT SCALE = 100.0000000 '/ in.	CHECKED - DAD	REVISED -	DEPARTMENT OF TRANSPORTATION			E-16	CONTRACT	NO. 60	M62
SHT_PLAN	PLOT DATE = 3/13/2013	DATE - 03/13/13	REVISED -		SCALE: 1"=50" SHEET 3 OF 3 SHEETS STA. 340+00 TO STA. 365+00			AID PROJECT		

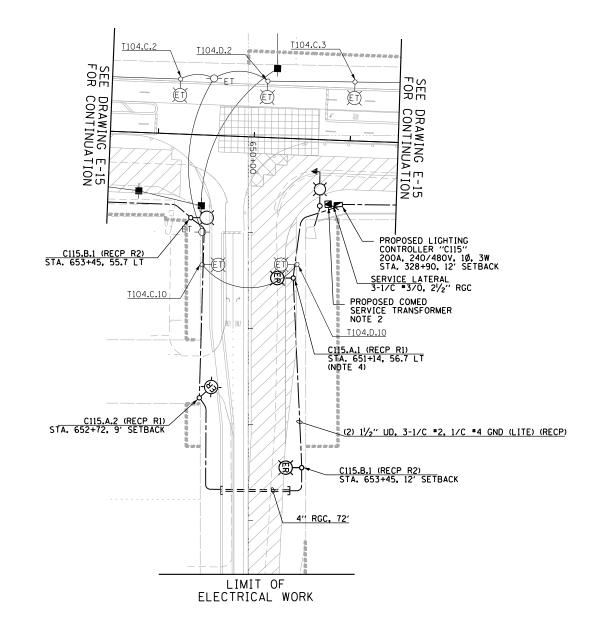


135th ST INTERSECTION


NOTES:

- SEE DRAWING E-1 FOR ELECTRICAL SYMBOL LIST AND ABBREVIATIONS. SEE DRAWING E-2 FOR ELECTRICAL GENERAL NOTES.
- 2. SEE DRAWING E-15 FOR FURTHER WORK CONCERNING THE PROPOSED COMED SERVICE TRANSFORMER.
- SEE DRAWING E-47 FOR PROPOSED LIGHTING UNIT DETAILS. SEE DRAWING E-46 FOR PROPOSED LIGHTING UNIT FOUNDATION DETAILS, UNLESS NOTED OTHERWISE.
- 4. CONTRACTOR TO FURNISH AND INSTALL (3) 3½" × 36" RADIUS PVC CONDUIT RACEWAY ELBOWS IN FOUNDATION PER IDOT STANDARD DRAWING E-46.



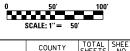


F	FILE NAME =	USER NAME = Anthony_Plutz	DESIGNED - MAE	REVISED -			F.A.P RTE.	SECTION	COUNTY	TOTAL	SHEE NO.
D	0160M62-SHT-E17.dgn		DRAWN - WM	REVISED -	STATE OF ILLINOIS	135th Street Temporary Lighting Plan: Stage 1A	330	103R-5	соок	778	341
١ ١		PLOT SCALE = 100.0000000 '/ in.	CHECKED - DAD	REVISED -	DEPARTMENT OF TRANSPORTATION			F_17	CONTRACT	NO. 6	ОМ62
S	SHT_PLAN	PLOT DATE = 3/13/2013	DATE - 03/13/13	REVISED -		SCALE: 1"=50" SHEET 1 OF 1 SHEETS STA. 650+00 TO STA. 663+00		ILLINOIS FED.	AID PROJECT		

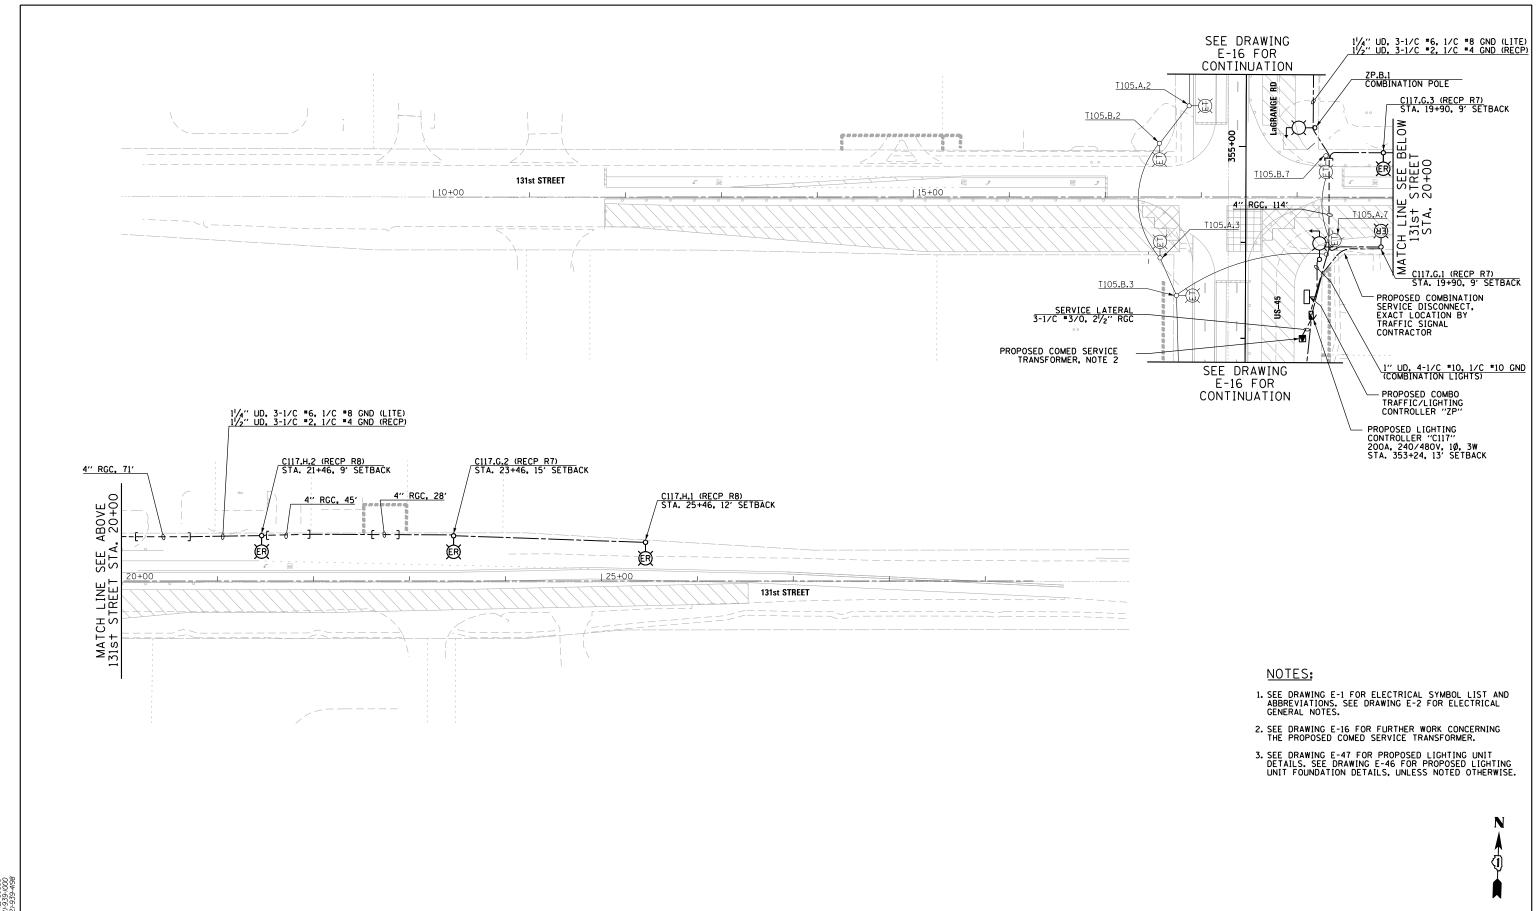


0	50′		100'
	SCALE: 1"=	50′	

FILE NAME = USER NAME = Anthony_Plutz DESIGNED - MAE REVISED SECTION COUNTY STATE OF ILLINOIS 131st STREET PROPOSED ROADWAY LIGHTING PLAN - STAGE 1A 0160M62-SHT-E18.dgr DRAWN - WM REVISED 103R-5 COOK 778 342 330 PLOT SCALE = 100.0000000 '/ in. CHECKED - DAD REVISED **DEPARTMENT OF TRANSPORTATION** CONTRACT NO. 60M62 E-18 - 03/13/13 SCALE: 1"=50" SHEET 1 OF 1 SHEETS STA. 10+00 TO STA. 28+00 PLOT DATE = 3/13/2013 DATE REVISED

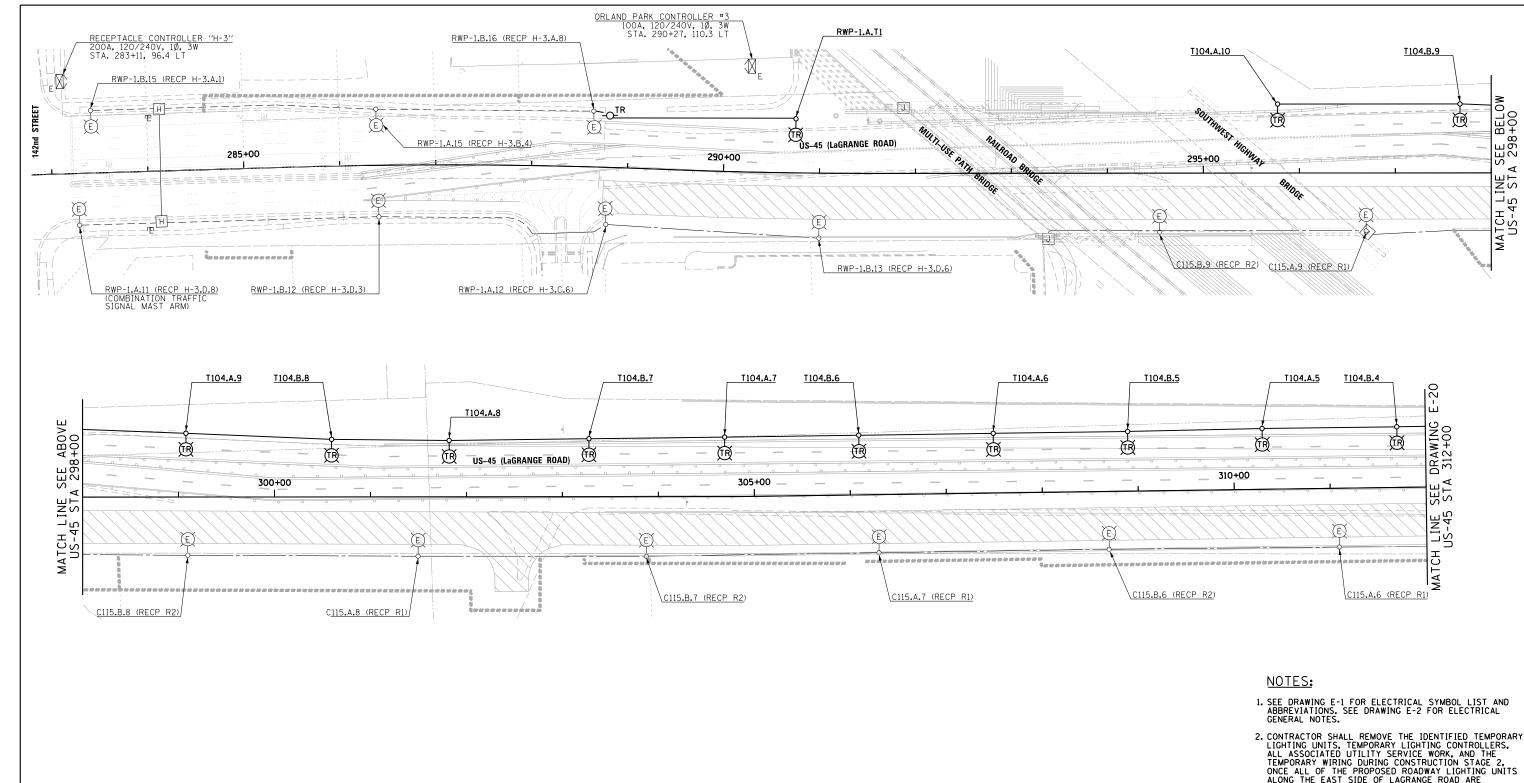

2. CONTRACTOR SHALL REMOVE THE IDENTIFIED TEMPORARY LIGHTING UNITS, TEMPORARY LIGHTING CONTROLLERS, ALL ASSOCIATED UTILITY SERVICE WORK, AND THE TEMPORARY WIRING DURING CONSTRUCTION STAGE 2, ONCE ALL OF THE PROPOSED ROADWAY LIGHTING UNITS ALONG THE EAST SIDE OF LAGRANGE ROAD ARE INSTALLED, ENERGIZED, TESTED, AND APPROVED BY THE ENGINEER.

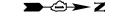

COUNTY COOK


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D16@M62-SHT-E19.dgn		DRAWN -	WM	REVISED -	ı
	PLOT SCALE = 100.0000000 '/ in.	CHECKED -	DAD	REVISED -	ı
SHT_PLAN	PLOT DATE = 3/13/2013	DATE -	03/13/13	REVISED -	i

100 S. WACKER DR. SUITE 500 CHICAGO IL, 66066 FEL (312)-939-4080 FAX (312)-939-408

STATE OF ILLINOIS **DEPARTMENT OF TRANSPORTATION**

US-45 (Lagrange Road)	.A.P	SECTIO
PROPOSED ROADWAY LIGHTING PLAN - STAGE 1B	330	103R-5
PROPOSED ROADWAT LIGHTING FEAR - STAGE ID		E-19
SCALE: 1"=50" SHEET		ILI


778 343 CONTRACT NO. 60M62 ILLINOIS FED. AID PROJECT

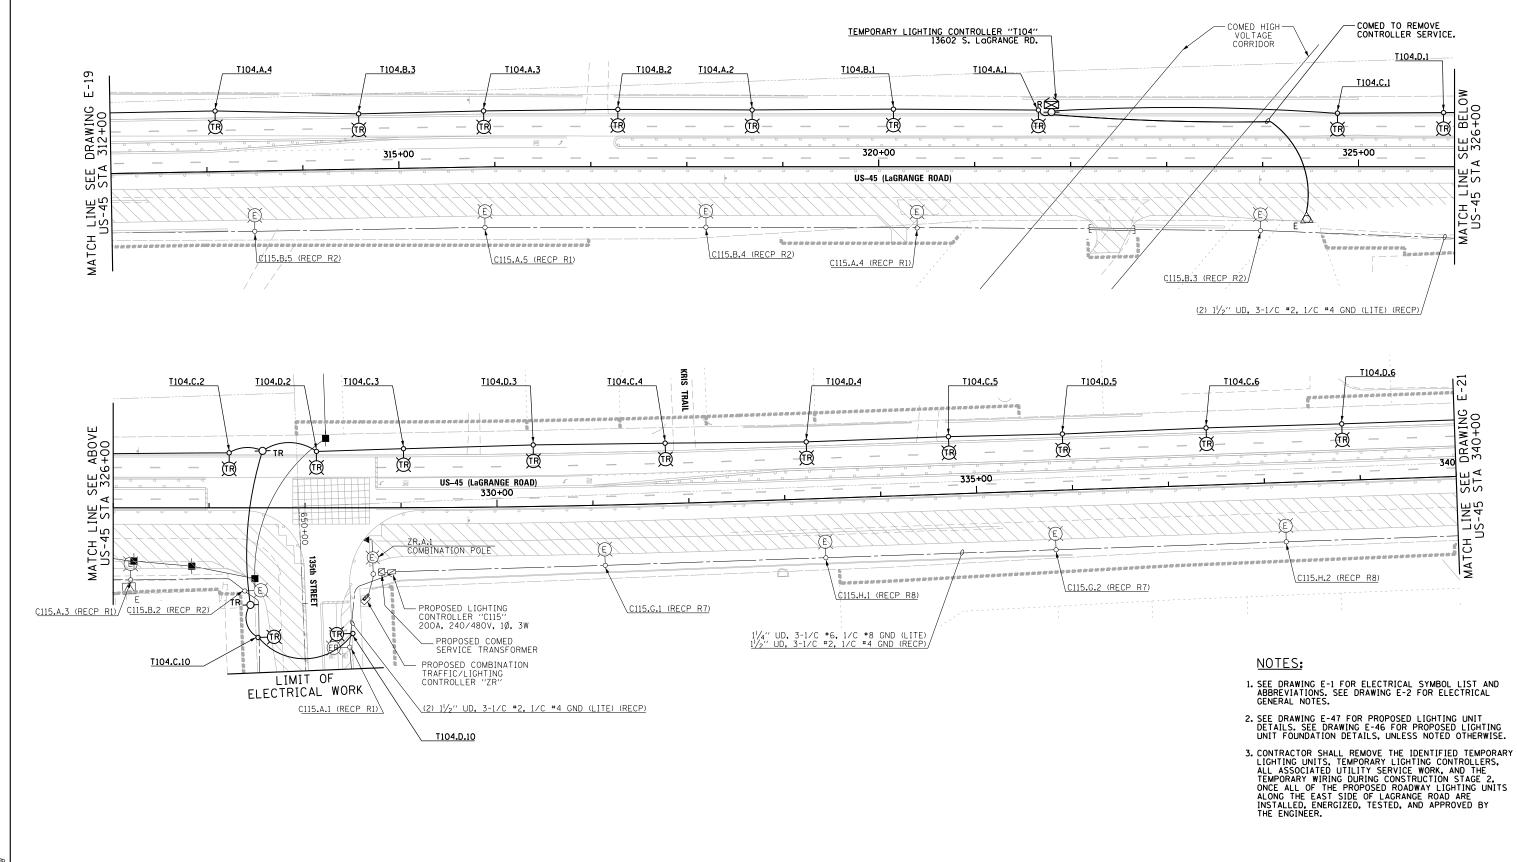

50'	100'

>-Ĝ→Z

DESIGNED - MAE REVISED USER NAME = Anthony_Plutz SECTION COUNTY US-45 (Lagrange Road) STATE OF ILLINOIS 160M62-SHT-E20.dg DRAWN WM REVISED 330 103R-5 COOK 778 344 PROPOSED ROADWAY LIGHTING PLAN - STAGE 1B PLOT SCALE = 100.0000000 '/ in. CHECKED DAD REVISED **DEPARTMENT OF TRANSPORTATION** E-20 CONTRACT NO. 60M62 SCALE: 1"=50' SHEET 2 OF 3 SHEETS STA. 312+00 TO STA. 340+00 PLOT DATE = 3/13/2013 DATE 03/13/13 REVISED

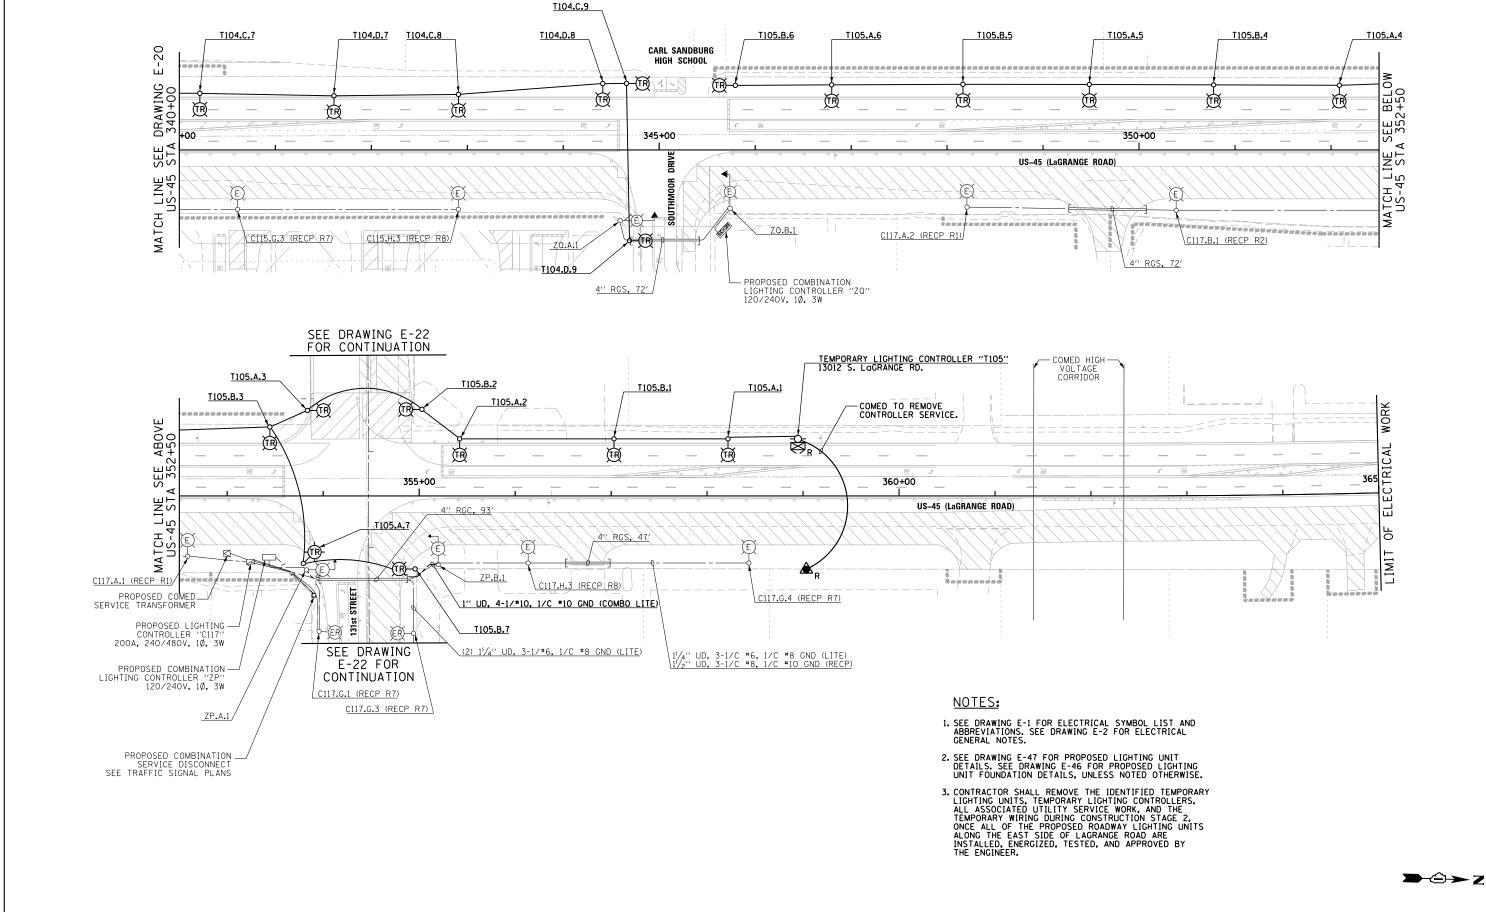




160M62-SHT-E21.dgn

STATE OF ILLINOIS
DEPARTMENT OF TRANSPORTATION

50" 100

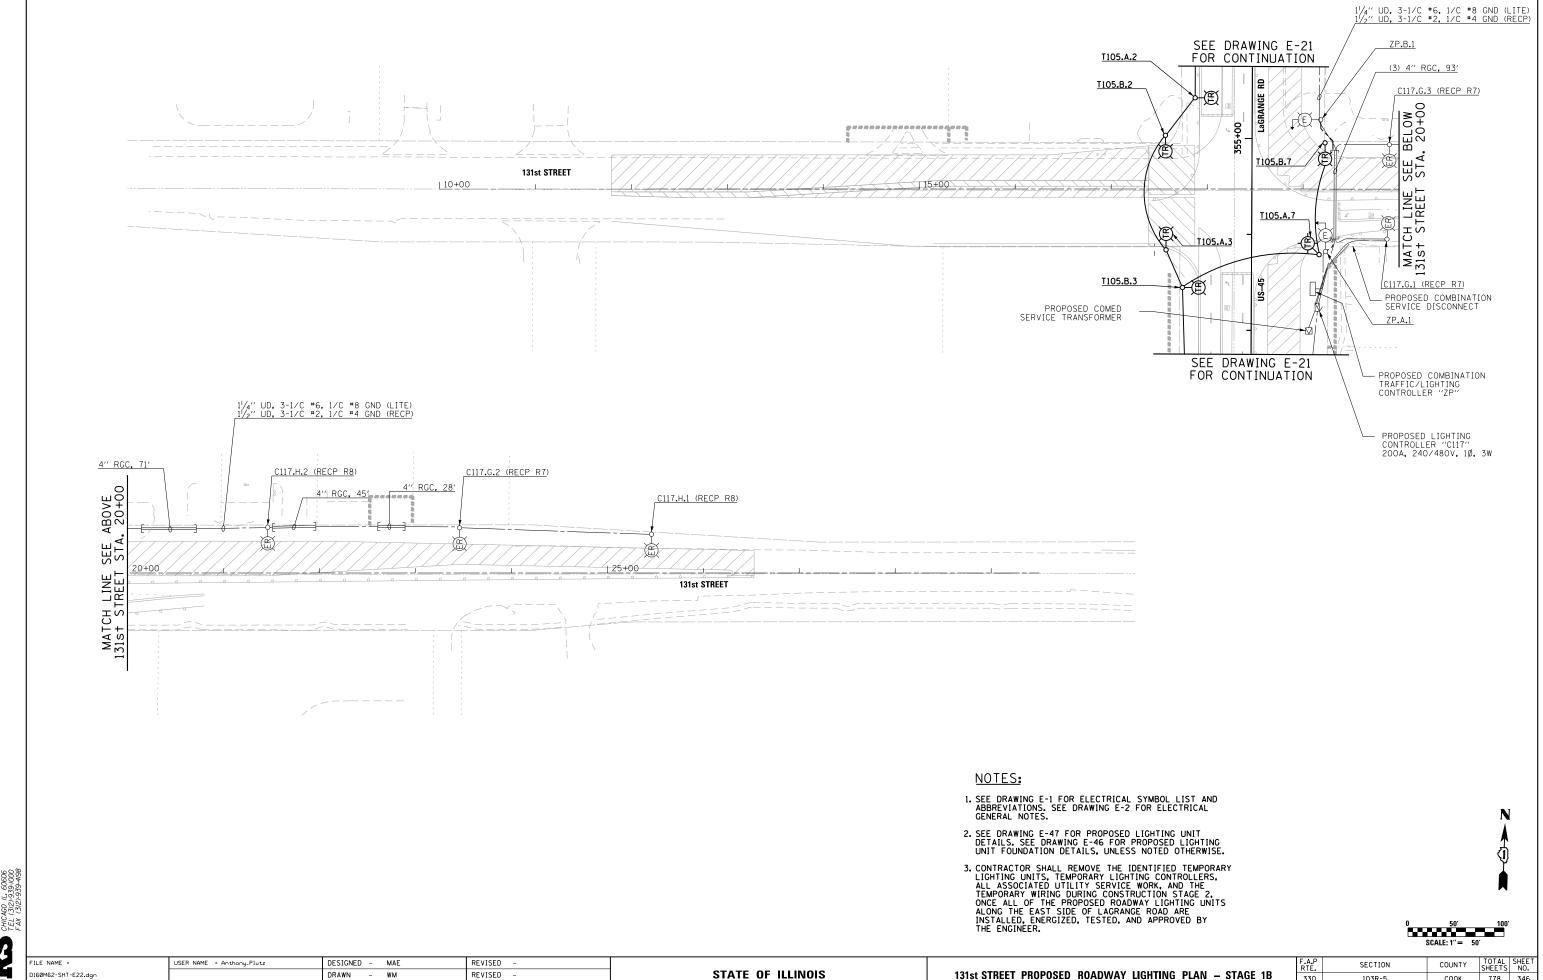


REVISED PLOT SCALE = 100.0000000 '/ in. CHECKED -DAD REVISED 03/13/13 REVISED PLOT DATE = 3/13/2013 DATE

STATE OF ILLINOIS **DEPARTMENT OF TRANSPORTATION**

131st STREET PROPOSED ROADWAY LIGHTING PLAN - STAGE 1B SCALE: 1"=50" SHEET 1 OF 1 SHEETS STA. 10+00 TO STA. 28+00

103R-5 330 COOK 778 346 E-22 CONTRACT NO. 60M62

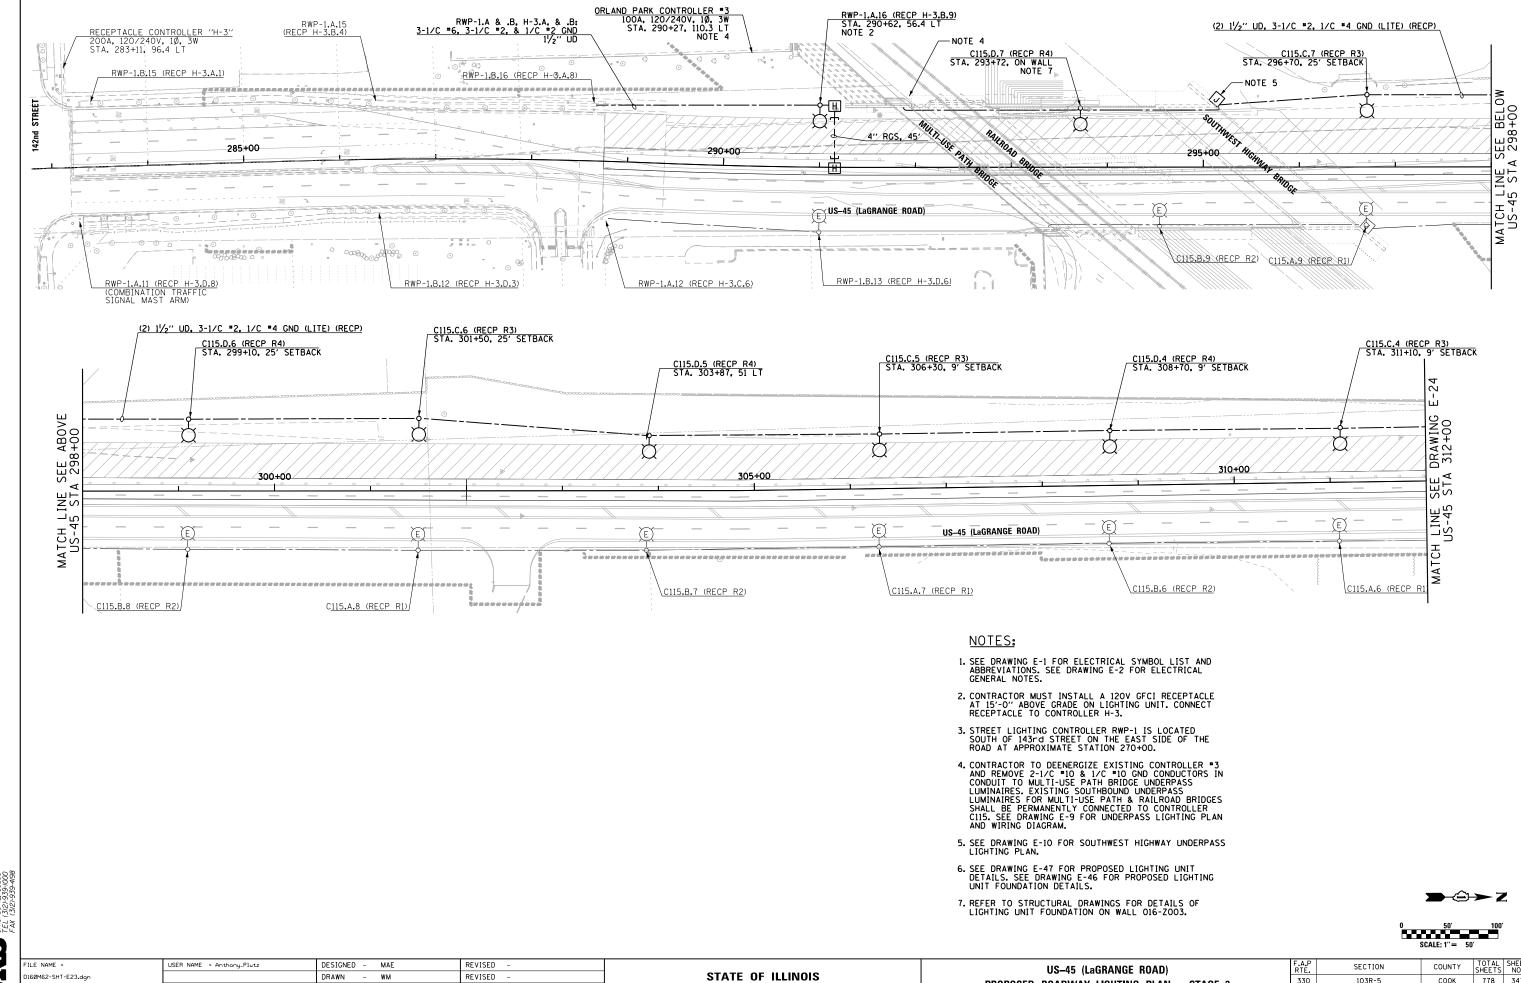

DEPARTMENT OF TRANSPORTATION

330

PROPOSED ROADWAY LIGHTING PLAN - STAGE 3

1 OF 3 SHEETS STA. 284+00 TO STA. 312+00

SCALE: 1"=50' SHEET

103R-5

E-23

COOK

778 347

CONTRACT NO. 60M62

PLOT SCALE = 100.000000 '/ in.

PLOT DATE = 3/13/2013

CHECKED -


DATE

DAD

03/13/13

REVISED

REVISED

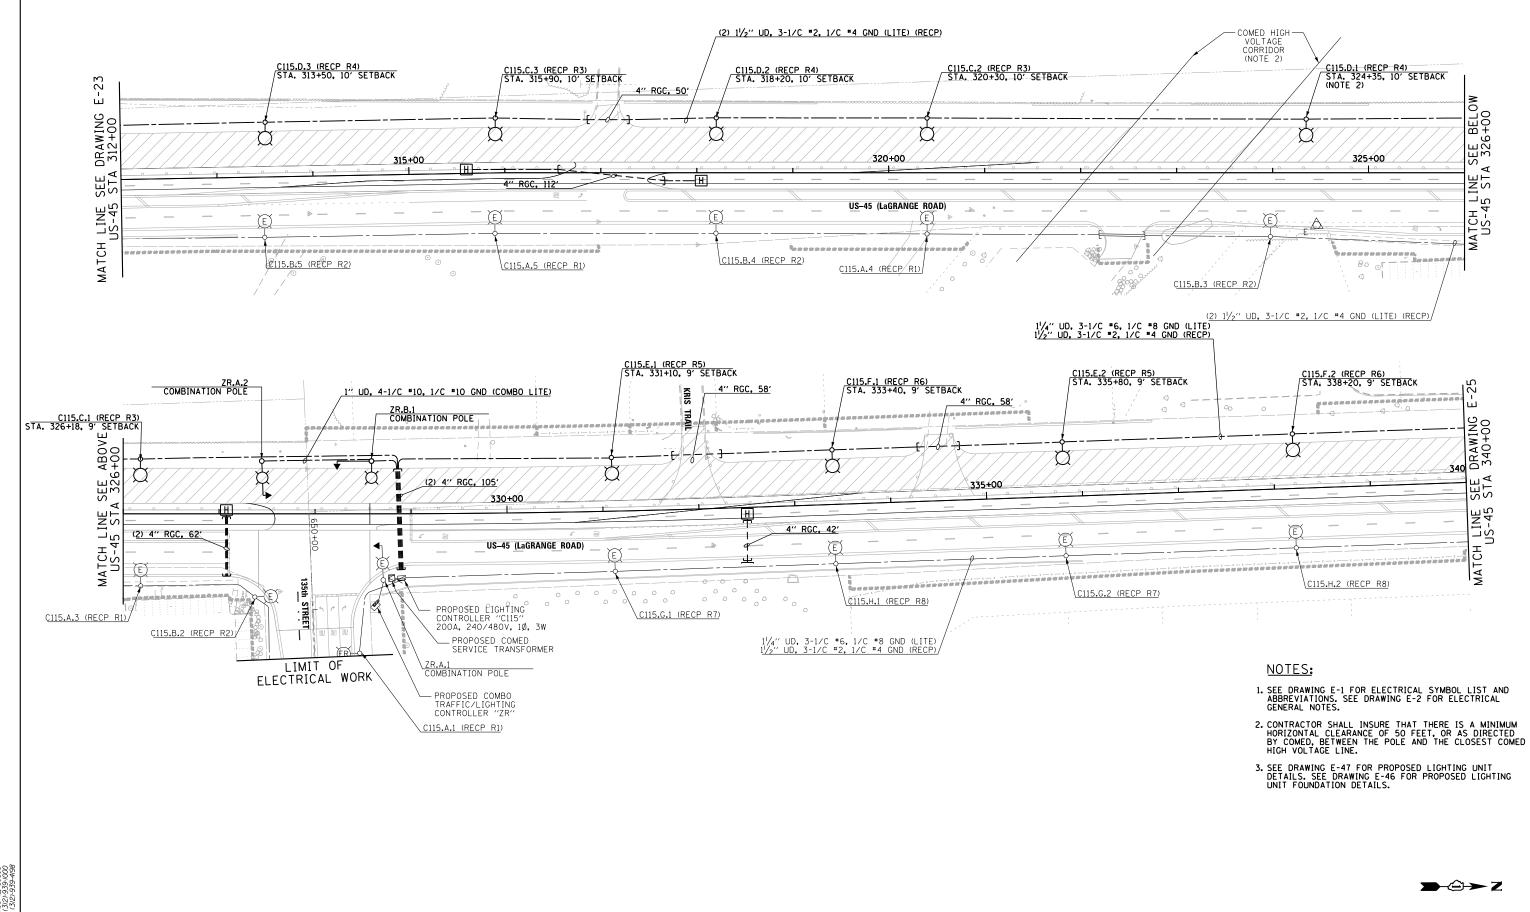




E NAME =	USER NAME = Anthony_Plutz	DESIGNED -	MAE	REVISED -
60M62-SHT-E24.dgn		DRAWN -	WM	REVISED -
	PLOT SCALE = 100.0000000 '/ in.	CHECKED -	DAD	REVISED -
T_PLAN	PLOT DATE = 3/13/2013	DATE -	03/13/13	REVISED -


STATI	E OI	FILLINOIS
DEPARTMENT	0F	TRANSPORTATION

	US-45 (Lagrange road)							F.A.P RTE.	SECTION	ION COUNTY TOTAL SHEETS				
	PROPOSED ROADWAY LIGHTING PLAN - STAGE 3								330	103R-5	соок	778	348	
	PROPOSED ROADWAY LIGHTING PLAN - STAGE 3									E-24	CONTRACT	NO. 6	OM62	
SCALE:	1′′=50′	SHEET	2 OF	3	SHEETS	STA.	312+00	TO STA.	340+00	ILLINOIS FED. AID PROJECT				

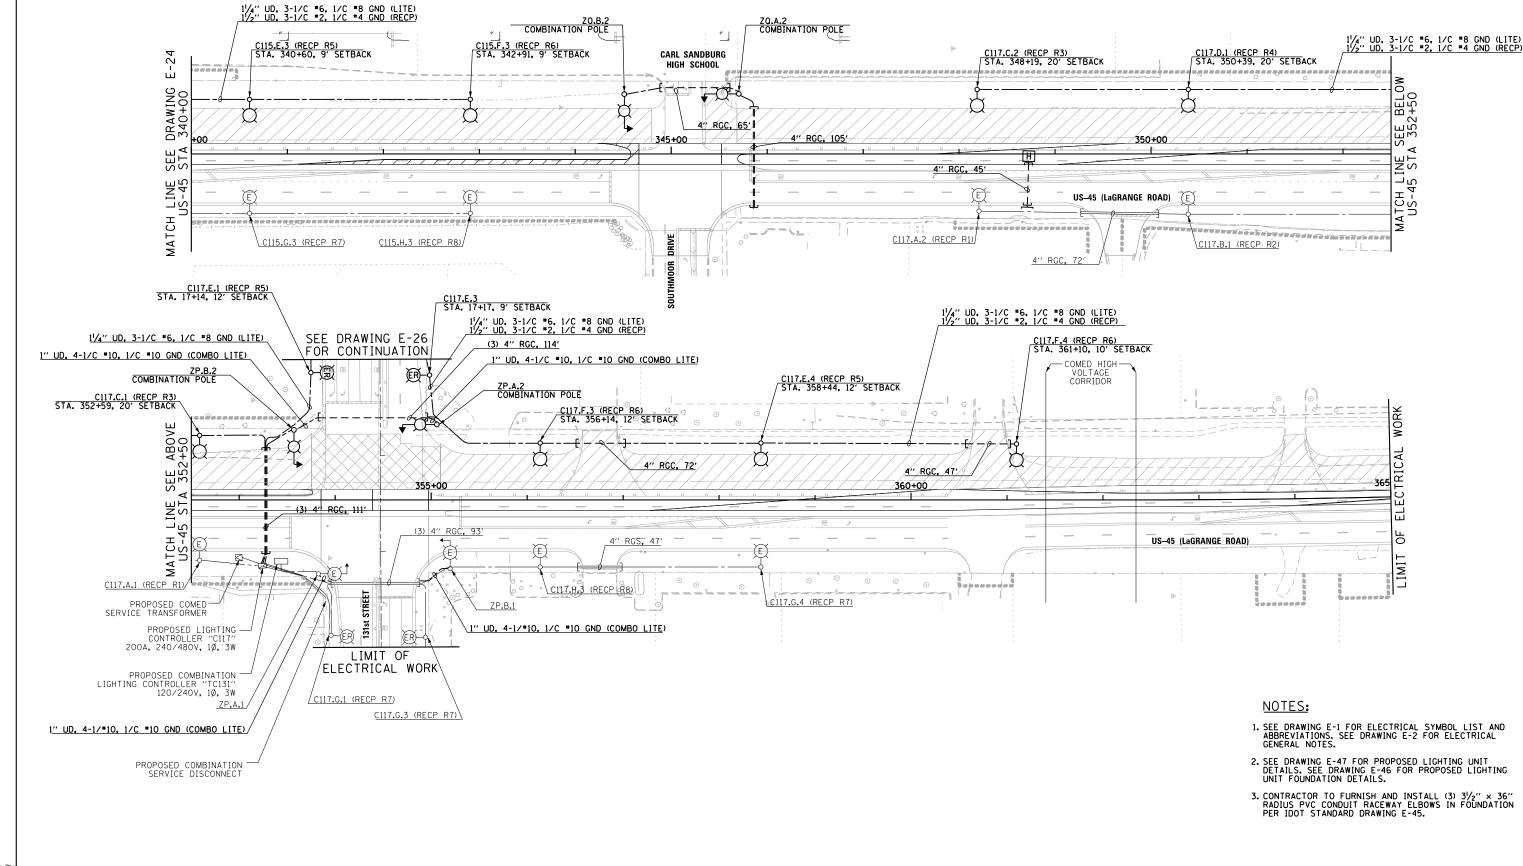

50°	100'	
CCALE, 4"	EO'	

FILE NAME = DESIGNED - MAE REVISED USER NAME = Anthony_Plutz SECTION COUNTY US-45 (LaGRANGE ROAD) STATE OF ILLINOIS 160M62-SHT-E25.dg ORAWN WM REVISED 330 103R-5 COOK 778 349 PROPOSED ROADWAY LIGHTING PLAN - STAGE 3 PLOT SCALE = 100.000000 '/ in. CHECKED -DAD REVISED **DEPARTMENT OF TRANSPORTATION** E-25 CONTRACT NO. 60M62 3 OF 3 SHEETS STA. 340+00 TO STA. 365+00 03/13/13 REVISED PLOT DATE = 3/13/2013 DATE

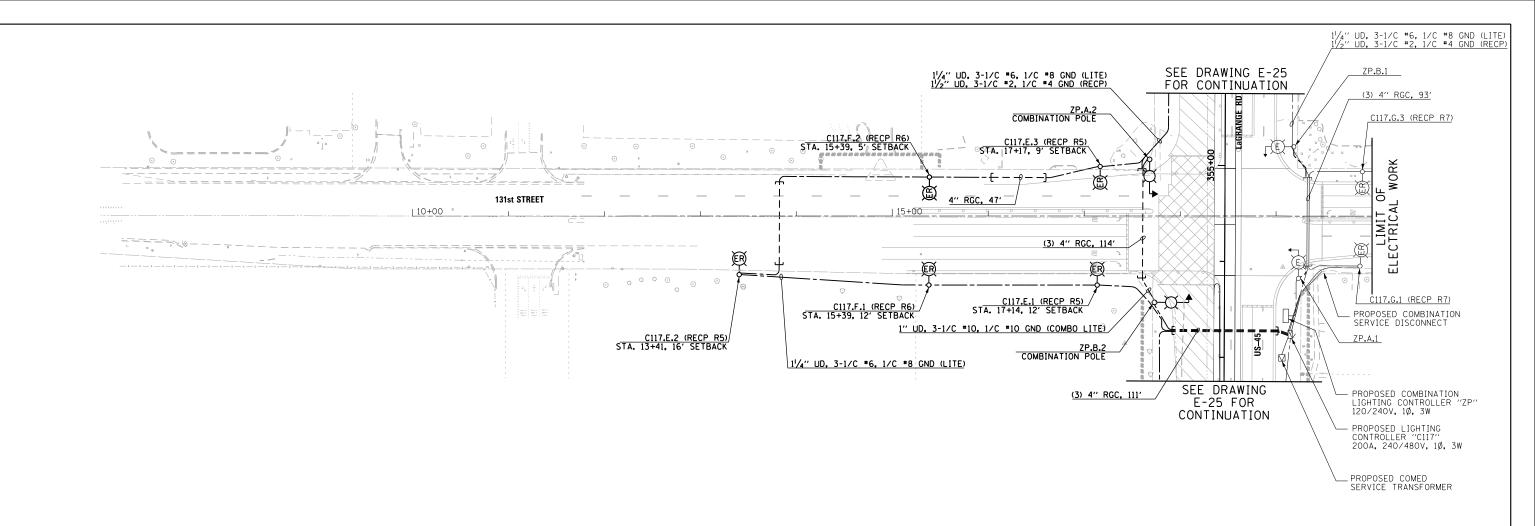


NOTES:


- SEE DRAWING E-1 FOR ELECTRICAL SYMBOL LIST AND ABBREVIATIONS. SEE DRAWING E-2 FOR ELECTRICAL GENERAL NOTES.
- 2. SEE DRAWING E-47 FOR PROPOSED LIGHTING UNIT DETAILS. SEE DRAWING E-46 FOR PROPOSED LIGHTING UNIT FOUNDATION DETAILS, UNLESS NOTED OTHERWISE.
- 3. CONTRACTOR TO FURNISH AND INSTALL (3) $3^1\!/_2$ " \times 36" RADIUS PVC CONDUIT RACEWAY ELBOWS IN FOUNDATION PER DRAWING E-46.



N

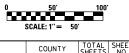

S. WACKER DR. SUITE 500 ICAGO IL, 60606 L (312)-939-1098 X (312)-939-4198								Á
OO CHIS							(0 50' 100' SCALE: 1" = 50'
62	FILE NAME :	USER NAME = Anthony_Plutz	DESIGNED - MAE	REVISED -			F.A.P SECTION	COUNTY TOTAL SHEET
	D160M62-SHT-E26.dgn		DRAWN - WM	REVISED -	STATE OF ILLINOIS	131st STREET PROPOSED ROADWAY LIGHTING PLAN - STAGE 3	330 103R-5	COOK 778 350
\Box		PLOT SCALE = 100.0000000 '/ in.	CHECKED - DAD	REVISED -	DEPARTMENT OF TRANSPORTATION		E-26	CONTRACT NO. 60M62
	SHT_PLAN	PLOT DATE = 3/13/2013	DATE - 03/13/13	REVISED -		SCALE: 1"=50" SHEET 1 OF 1 SHEETS STA. 10+00 TO STA. 20+00		FED. AID PROJECT

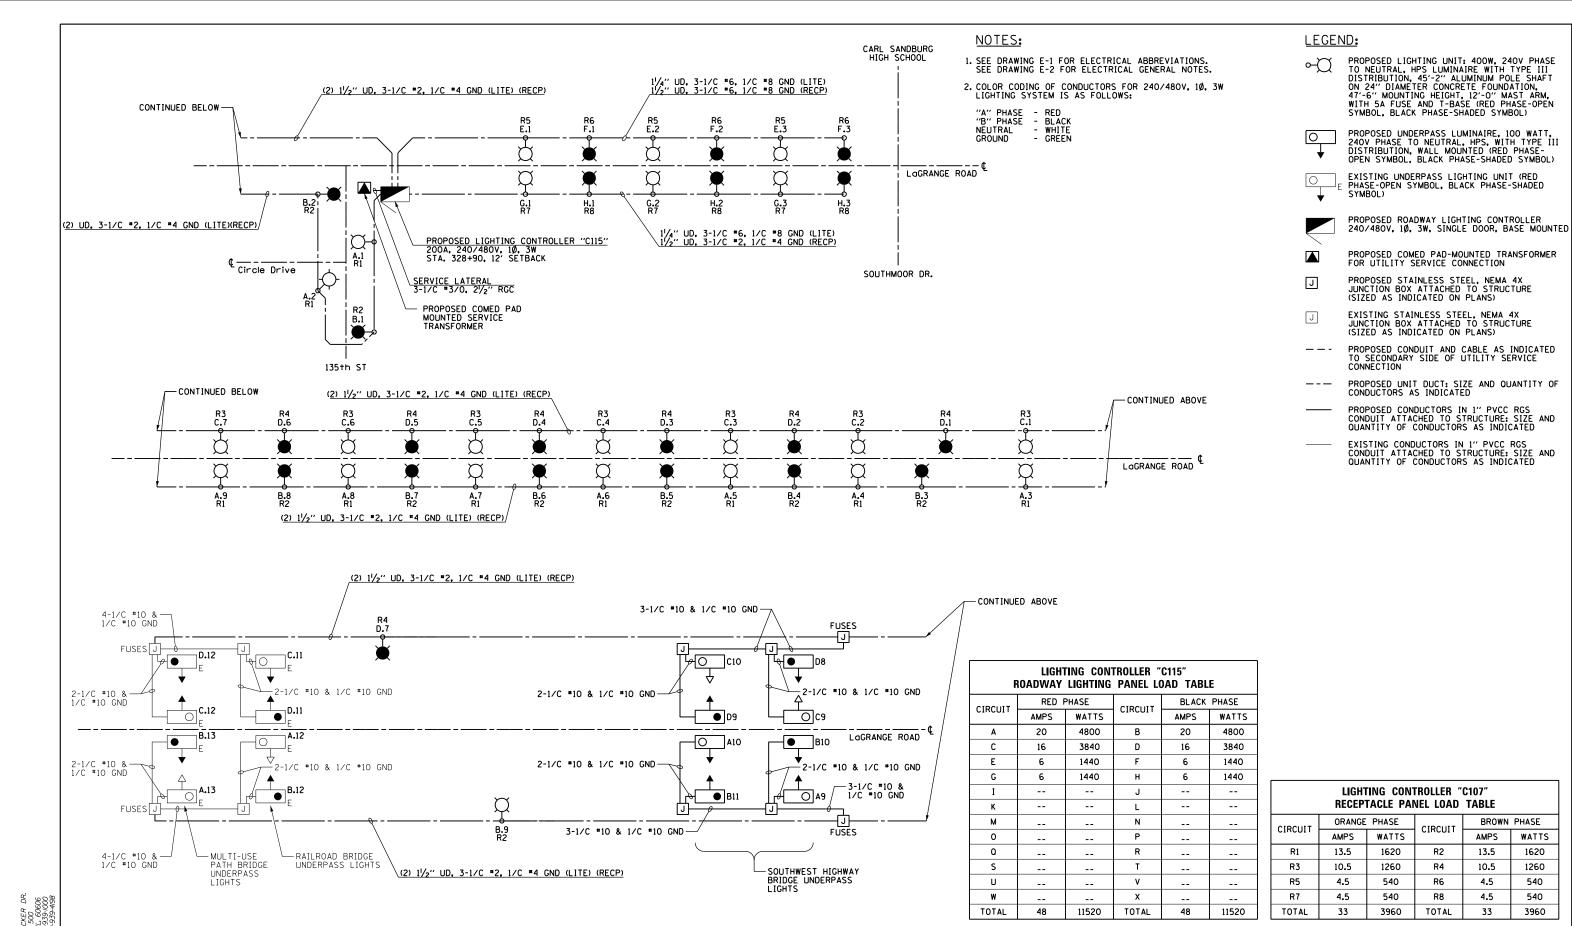

LOAD TABULATION IS BASED ON THE FOLLOWING:

180W RECEPTACLE: 1.5A AT 120V

STATE OF ILLINOIS
DEPARTMENT OF TRANSPORTATION

LIGHTING CONTROLLER "C115" WIRING DIAGRAM

REVISED

REVISED

REVISED

REVISED

DESIGNED - MAE

WM

DAD

03/13/13

DRAWN

DATE

CHECKED

USER NAME = Anthony_Plutz

PLOT DATE = 3/13/2013

PLOT SCALE = 2.0000000 '/ in.

160M62-SHT-E27.dg

US 45 (Lagrange Road)
LIGHTING CONTROLLER "C115" WIRING DIAGRAM

SCALE: NONE SHEET 1 OF 1 SHEETS STA. TO STA.


LOAD TABULATION IS BASED ON THE FOLLOWING:

100W HPS UNDERPASS LUMINAIRE: 0.5A AT 240V

400W HPS LUMINAIRE: 2.0A AT 240V

	ILLINOIS FED. A	ID PROJECT		
	E-27	CONTRACT	NO. 6	0м6
330	103R-5	соок	778	35:
RTE.	SECTION	COUNTY	SHEETS	NO.



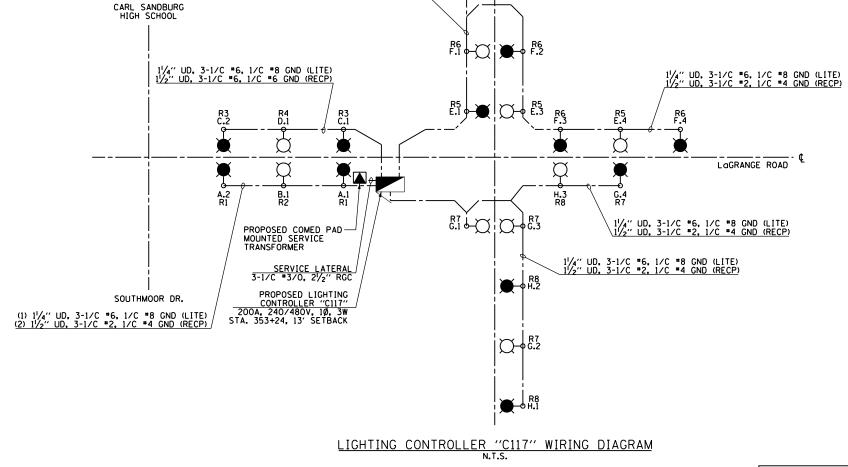

1¹/₄" UD, 3-1/C *6, 1/C *8 GND (LITE) 1¹/₂" UD, 3-1/C *2, 1/C *4 GND (RECP) 131st ST

F	LIGHTING CONTROLLER "C117" ROADWAY LIGHTING PANEL LOAD TABLE										
CIRCUIT	RED F	PHASE	CIRCUIT	BLACK	PHASE						
CIRCUIT	AMPS	WATTS	CIRCUIT	AMPS	WATTS						
Α	4	960	В	2	480						
С	4	960	D	2	480						
E	8	1920	F	8	1920						
G	8	1920	Н	6	1440						
I			J								
К			L								
М			N								
0			Р								
0			R								
S			T								
U			٧								
w			х								
TOTAL	20	4800	TOTAL	18	4320						

LOAD TABULATION IS BASED ON THE FOLLOWING:

400W HPS LUMINAIRE: 2.0A AT 240V (PHASE TO NEUTRAL)

LEGEND:

 \sim

PROPOSED LIGHTING UNIT: 400W, 240V PHASE TO NEUTRAL, HPS LUMINAIRE WITH TYPE III DISTRIBUTION, 45'-2" ALUMINUM POLE SHAFT ON 24" DIAMETER CONCRETE FOUNDATION, 47'-6" MOUNTING HEIGHT, 12'-0" MAST ARM, WITH 5A FUSES AND T-BASE (RED PHASE-OPEN SYMBOL, BLACK PHASE-SHADED SYMBOL)



PROPOSED ROADWAY LIGHTING CONTROLLER SINGLE DOOR, BASE MOUNTED, SPECIAL 200A, 240/480V, 10, 3W



PROPOSED COMED PAD-MOUNTED TRANSFORMER FOR UTILITY SERVICE CONNECTION

-- PROPOSED CONDUIT AND CABLE AS INDICATED TO SECONDARY SIDE OF UTILITY SERVICE CONNECTION

--- PROPOSED UNIT DUCT: SIZE AND QUANTITY OF CONDUCTORS AS INDICATED

NOTES:

- 1. SEE DRAWING E-1 FOR ELECTRICAL ABBREVIATIONS. SEE DRAWING E-2 FOR ELECTRICAL GENERAL NOTES.
- 2. COLOR CODING OF CONDUCTORS FOR 240/480V, 10. 3W LIGHTING SYSTEM IS AS FOLLOWS:

"A" PHASE - RED
"B" PHASE - BLACK
NEUTRAL - WHITE
GROUND - GREEN




LIGHTING CONTROLLER "C107" RECEPTACLE PANEL LOAD TABLE										
CIRCUIT	ORANGE	PHASE	CIRCUIT	BROWN	PHASE					
	AMPS	WATTS	CIRCUIT	AMPS	WATTS					
R1	3 1620		R2	1.5	1620					
R3	3	1260	R4	1.5	1260					
R5	6	720	R6	6	720					
R7	6	720	R8	4.5	540					
TOTAL	TOTAL 18.0		TOTAL	13.5	1620					

LOAD TABULATION IS BASED ON THE FOLLOWING:

180W RECEPTACLE: 1.5A AT 120V (PHASE TO NEUTRAL)

	FILE NAME =	USER NAME = Anthony_Plutz	DESIGNED - MAE	REVISED -		US 45 (Lagrange Road)	F.A.P	SECTION	COUNTY	TOTAL SHEET
	D160M62-SHT-E28.dgn		DRAWN - WM	REVISED -	STATE OF ILLINOIS		330	103R-5	соок	778 352
1		PLOT SCALE = 2.0000000 '/ in.	CHECKED - DAD	REVISED -	DEPARTMENT OF TRANSPORTATION	LIGHTING CONTROLLER "C117" WIRING DIAGRAM		E-28	CONTRACT	NO. 60M62
	SHT_PLAN	PLOT DATE = 3/13/2013	DATE - 03/13/13	REVISED -		SCALE: NONE SHEET 1 OF 1 SHEETS STA. TO STA.		ILL INDIS FE	ED. AID PROJECT	

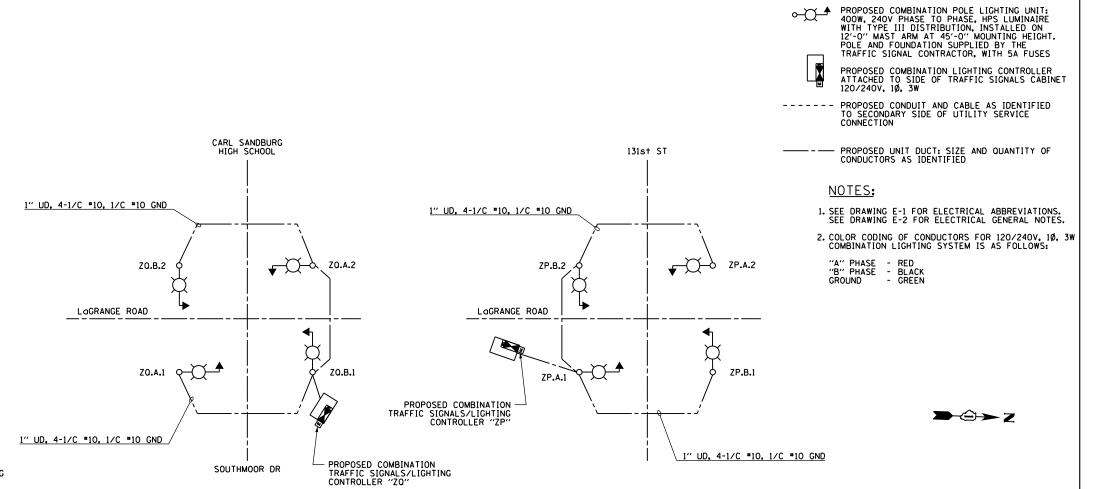

ZR.B.1

ZR.A.1

PROPOSED COMBINATION
TRAFFIC SIGNALS/LIGHTING
CONTROLLER "ZR"

1" UD, 4-1/C *10, 1/C *10 GND

ZR.A.2

PROPOSED COMBINATION TRAFFIC/LIGHTING CONTROLLER 'ZR'' WIRING DIAGRAM N.T.S.

1	COMBO TRAFFIC/LIGHTING CONTROLLER "ZR" ROADWAY LIGHTING PANEL LOAD TABLE								
CIRCUIT			CIRCUIT						
CIRCUIT	AMPS	WATTS	CIRCUIT	AMPS	WATTS				
Α	4	960	В	2	480				
С			D						
TOTAL	4.0	960	TOTAL	2.0	480				

LOAD TABULATION IS BASED ON THE FOLLOWING:

400W HPS LUMINAIRE: 2.0A AT 240V (PHASE TO PHASE)

PROPOSED COMBINATION TRAFFIC/LIGHTING CONTROLLER "ZQ" WIRING DIAGRAM N.T.S.

COMBO TRAFFIC/LIGHTING CONTROLLER "ZQ" ROADWAY LIGHTING PANEL LOAD TABLE										
CIRCUIT			CIRCUIT							
CIRCUIT	AMPS	WATTS	CIRCUIT	AMPS	WATTS					
Α	4	960	В	4	960					
С			D	-						
TOTAL	4.0	960	TOTAL	4.0	960					

LOAD TABULATION IS BASED ON THE FOLLOWING:

400W HPS LUMINAIRE: 2.0A AT 240V (PHASE TO PHASE)

PROPOSED COMBINATION TRAFFIC/LIGHTING CONTROLLER "ZP" WIRING DIAGRAM N.T.S.

LEGEND:

COMBO TRAFFIC/LIGHTING CONTROLLER "ZP" ROADWAY LIGHTING PANEL LOAD TABLE										
CIRCUIT			CIRCUIT							
CIRCUIT	AMPS WATTS		CIRCUIT	AMPS	WATTS					
Α	4	960	В	4	960					
С			D							
TOTAL	4.0	960	TOTAL	4.0	960					

LOAD TABULATION IS BASED ON THE FOLLOWING:


400W HPS LUMINAIRE: 2.0A AT 240V (PHASE TO PHASE)

100 S. WACKER DR. SUITE 500 CHICAGO IL, 60606 TEL (3(2)-939-1000 FAX (3(2)-939-4198

E NAME =	USER NAME = Anthony_Plutz	DESIGNED -	MAE	REVISED -
60M62-SHT-E29.dgn		DRAWN -	WM	REVISED -
	PLOT SCALE = 2.0000000 '/ in.	CHECKED -	DAD	REVISED -
T_PLAN	PLOT DATE = 3/13/2013	DATE -	03/13/13	REVISED -

STATE OF ILLINOIS
DEPARTMENT OF TRANSPORTATION

	US 45 (Lagrange ROAD)								
	PROPOSED COMBINATION TRAFFIC / LIGHTING CONTROLLERS								
	"CLC110", "CLC111", & "CLC112" WIRING DIAGRAM								
SCALE:	NONE	SHEET	1 OF	1	SHEETS	STA.	TO STA.		

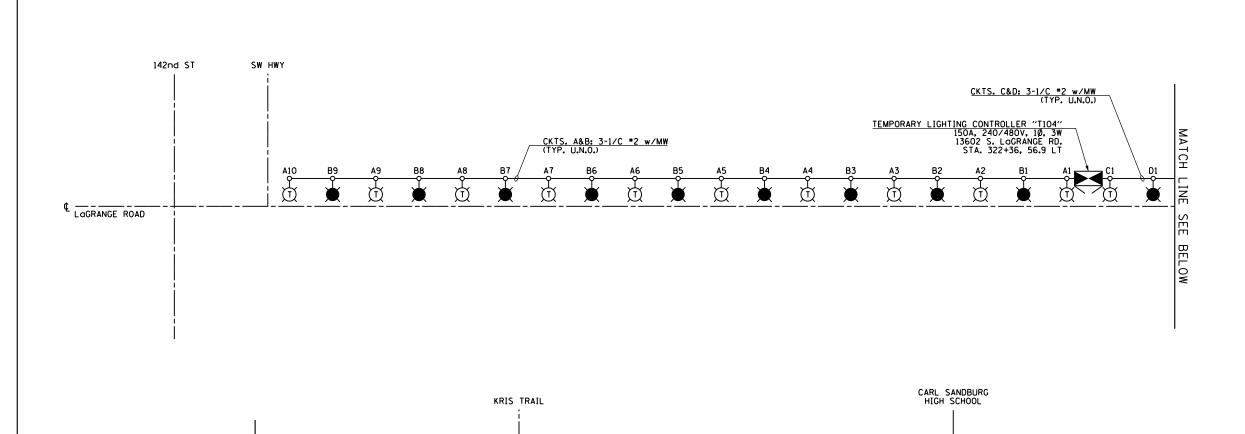

TEMPORARY LIGHTING CONTROLLER T104 WIRING DIAGRAM N.T.S.

CKTS. C&D: 3-1/C *2 w/MW (TYP. U.N.O.)

LEGEND:

TEMPORARY LIGHTING UNIT: 400W, 240V PHASE TO NEUTRAL, HPS LUMINAIRE WITH TYPE III DISTRIBUTION, 60'-0" CLASS 4 WOOD POLE, 47'-6" MOUNTING HEIGHT, 12'-0" MAST ARM, WITH 5A FUSES (RED PHASE-OPEN SYMBOL, BLACK PHASE-SHADED SYMBOL)



TEMPORARY ROADWAY LIGHTING CONTROLLER



TEMPORARY AERIAL CABLE AND MESSENGER WIRE AS INDICATED

NOTES:

- 1. SEE DRAWING E-1 FOR ELECTRICAL ABBREVIATIONS. SEE DRAWING E-2 FOR ELECTRICAL GENERAL NOTES.
- 2. COLOR CODING OF CONDUCTORS FOR 240/480V, 10, 3W LIGHTING SYSTEM IS AS FOLLOWS:

"A" PHASE - RED
"B" PHASE - BLACK
NEUTRAL - WHITE
GROUND - GREEN



LIGHTING CONTROLLER "T104" ROADWAY LIGHTING PANEL LOAD TABLE								
CIRCUIT -	RED	PHASE	CIRCUIT	BLACK	PHASE			
	AMPS	WATTS	CIRCUIT	AMPS	WATTS			
Α	20	4800	В	18	4320			
С	20	4800	D	20	4800			
E			F					
G			Н					
I			J					
К			L					
TOTAL	40	9600	TOTAL	38	9120			

LOAD TABULATION IS BASED ON THE FOLLOWING:

400W HPS LUMINAIRE: 2.0A AT 240V

FILE NAME =	USER NAME = Anthony_Plutz	DESIGNED - MAE	REVISED -	
D160M62-SHT-E30.dgn		DRAWN - WM	REVISED -	
	PLOT SCALE = 2.0000000 '/ in.	CHECKED - DAD	REVISED -	
SHT_PLAN	PLOT DATE = 3/13/2013	DATE - 03/13/13	REVISED -	

C10

135th ST

STATE OF ILLINOIS **DEPARTMENT OF TRANSPORTATION**

т	EMPORA	RY LIGH		•	GRANGE FROLLER)) " Wiring Diagram	
SCALE:	NONE	SHEET	1 OF	1	SHEETS	STA.	TO STA.	

Lagrange ROAD

D9 0-

SOUTHMOOR DR

F.A.P RTE.	SEC	TION		COUNTY	TOTAL SHEETS	SHEET NO.
330	103R-5			соок	778	354
E-30				CONTRACT	NO. 6	0м62
		ILLINOIS	FED. A	D PROJECT		

TEMPORARY LIGHTING CONTROLLER T105 WIRING DIAGRAM N.T.S.

LEGEND:

TEMPORARY LIGHTING UNIT: 400W, 240V PHASE TO NEUTRAL, HPS LUMINAIRE WITH TYPE III DISTRIBUTION, 60'-0" CLASS 4 WOOD POLE, 47'-6" MOUNTING HEIGHT, 12'-0" MAST ARM, WITH 5A FUSES (RED PHASE-OPEN SYMBOL, BLACK PHASE-SHADED SYMBOL)



TEMPORARY ROADWAY LIGHTING CONTROLLER



TEMPORARY AERIAL CABLE AND MESSENGER WIRE AS INDICATED

NOTES:

- 1. SEE DRAWING E-1 FOR ELECTRICAL ABBREVIATIONS. SEE DRAWING E-2 FOR ELECTRICAL GENERAL NOTES.
- 2. COLOR CODING OF CONDUCTORS FOR 240/480V, 10, 3W LIGHTING SYSTEM IS AS FOLLOWS:

"A" PHASE - RED
"B" PHASE - BLACK
NEUTRAL - WHITE
GROUND - GREEN



LIGHTING CONTROLLER "T105" ROADWAY LIGHTING PANEL LOAD TABLE							
CIRCUIT	RED PHASE	PHASE	CIRCUIT	BLACK	PHASE		
CIRCUIT	AMPS	WATTS		AMPS	WATTS		
Α	14	3360	В	14	3360		
С			D				
Ε			F				
G			Н				
I			J				
K			L				
TOTAL	14	3360	TOTAL	14	3360		

LOAD TABULATION IS BASED ON THE FOLLOWING:

400W HPS LUMINAIRE: 2.0A AT 240V

100 S. WACKER DR. SUITE 500	CHICAGO 1L, 60606 TEL (312)-939-1000 FAX (312)-939-4198
70	3

FILE NAME =	USER NAME = Anthony_Plutz	DESIGNED -	MAE	REVISED -
D160M62-SHT-E31.dgn		DRAWN -	WM	REVISED -
	PLOT SCALE = 2.0000000 '/ in.	CHECKED -	DAD	REVISED -
SHT_PLAN	PLOT DATE = 3/13/2013	DATE -	03/13/13	REVISED -



т	EMPORA	RY LIGH		•	GRANGE FROLLER) Wiring Diagram	
SCALE:	NONE	SHEET	1 OF	1	SHEETS	STA.	TO STA.	

	ILLINOIS	FED. AI	D PROJECT		
E-31			CONTRACT	NO. 6	OM62
330	103R-5		COOK	778	355
F.A.P RTE.	SECTION		COUNTY	TOTAL SHEETS	SHEET NO.



PLOT SCALE = 2.0000000 '/ in.

PLOT DATE = 3/13/2013

CHECKED


DATE

DAD

03/13/13

REVISED

REVISED

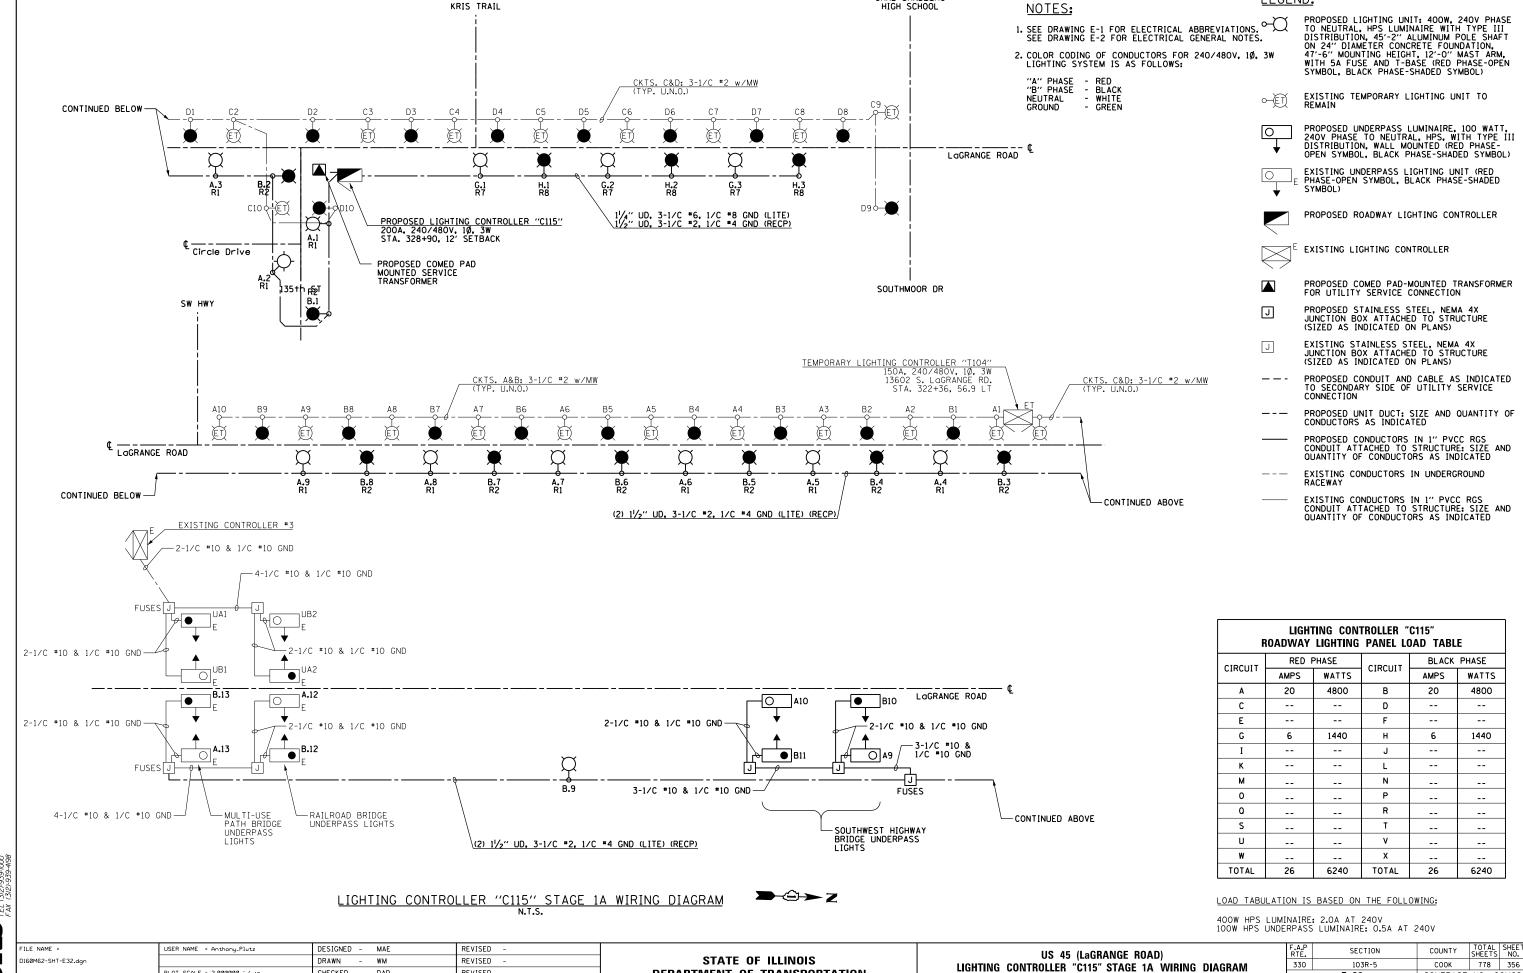

DEPARTMENT OF TRANSPORTATION

SCALE: NONE SHEET 1 OF 1 SHEETS STA.


KRIS TRAIL

CARL SANDBURG HIGH SCHOOL

LEGEND:

CONTRACT NO. 60M62

E-32

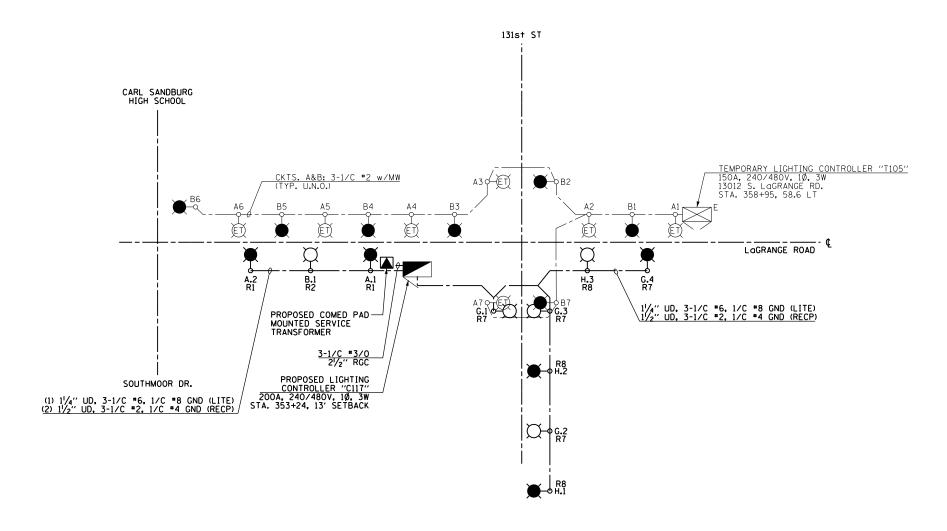

LIGHTING CONTROLLER "C117" STAGE 1A WIRING DIAGRAM N.T.S.

F	LIGHTING CONTROLLER "T105" ROADWAY LIGHTING PANEL LOAD TABLE									
CIRCUIT	RED F	PHASE	CIDCUIT	BLACK	PHASE					
CIRCUIT	AMPS	WATTS	CIRCUIT	AMPS	WATTS					
Α	14	3360	В	14	3360					
С			D							
E			F							
G			Н							
I			J							
K			L							
TOTAL	14	3360	TOTAL	14	3360					

LOAD TABULATION IS BASED ON THE FOLLOWING:

400W HPS LUMINAIRE: 2.0A AT 240V

SCALE:

LEGEND:

PROPOSED LIGHTING UNIT: 400W, 240V PHASE TO NEUTRAL, HPS LUMINAIRE WITH TYPE III DISTRIBUTION, 45'-2" ALUMINUM POLE SHAFT ON 24" DIAMETER CONCRETE FOUNDATION, 47'-6" MOUNTING HEIGHT, 12'-0" MAST ARM, WITH 5A FUSES AND T-BASE (RED PHASE-OPEN SYMBOL, BLACK PHASE-SHADED SYMBOL)

EXISTING TEMPORARY LIGHTING UNIT TO REMAIN



PROPOSED ROADWAY LIGHTING CONTROLLER SINGLE DOOR, BASE MOUNTED, SPECIAL 200A, 240/480V, 10, 3W



PROPOSED COMED PAD-MOUNTED TRANSFORMER FOR UTILITY SERVICE CONNECTION

 PROPOSED CONDUIT AND CABLE AS INDICATED TO SECONDARY SIDE OF UTILITY SERVICE CONNECTION

--- PROPOSED UNIT DUCT: SIZE AND QUANTITY OF CONDUCTORS AS INDICATED

NOTES:

- 1. SEE DRAWING E-1 FOR ELECTRICAL ABBREVIATIONS. SEE DRAWING E-2 FOR ELECTRICAL GENERAL NOTES.
- 2. COLOR CODING OF CONDUCTORS FOR 240/480V, 10, 3W LIGHTING SYSTEM IS AS FOLLOWS:

"A" PHASE - RED
"B" PHASE - BLACK
NEUTRAL - WHITE
GROUND - GREEN



F	LIGHTING CONTROLLER "C117" ROADWAY LIGHTING PANEL LOAD TABLE								
CIDCUIT	RED I	PHASE	CIDCUIT	BLACK	PHASE				
CIRCUIT	AMPS	WATTS	CIRCUIT	AMPS	WATTS				
Α	4	960	В	2	480				
С			D						
Ε			F						
G	8	1920	Н	6	1440				
I			J						
K			L						
М			N						
0			Р						
0			R						
S			Т						
U			٧						
w			х						
TOTAL	12	2880	TOTAL	8	1920				

LOAD TABULATION IS BASED ON THE FOLLOWING:

400W HPS LUMINAIRE: 2.0A AT 240V

100 S. WACKER DR. SUITE 500 CHICAGO IL, 60606 TEL (312)-939-1000 FAX (312)-939-4198

FILE NAME =	USER NAME = Anthony_Plutz	DESIGNED -	MAE	REVISED -	Ξ
D160M62-SHT-E33.dgn		DRAWN -	WM	REVISED -	
	PLOT SCALE = 2.0000000 '/ in.	CHECKED -	DAD	REVISED -	
SHT_PLAN	PLOT DATE = 3/13/2013	DATE -	03/13/13	REVISED -	
					_

	US 45 (Lagrange Road) Lighting Controller "C117" Stage 1A Wiring Diagram						F.A.P RTE.	SECTION
LIGHTING							330	103R-5
Licitino							E-33	
NONE	SHEET	1 OF	1	SHEETS	STA.	TO STA.		ILLINOIS FED.




PLOT DATE = 3/13/2013

DATE

03/13/13

REVISED

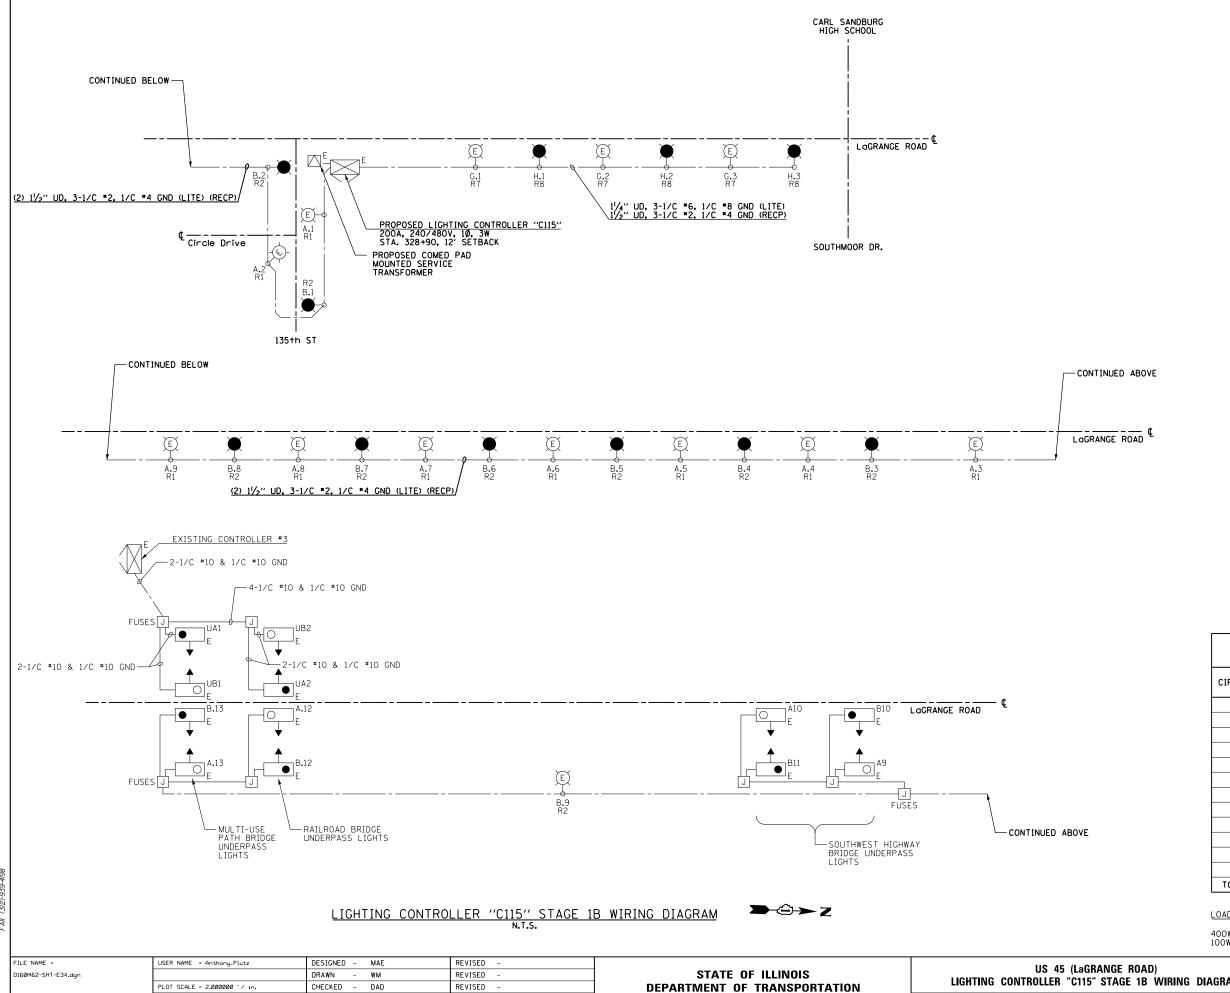

LEGEND:

- PROPOSED LIGHTING UNIT: 400W, 240V PHASE TO NEUTRAL, HPS LUMINAIRE WITH TYPE III DISTRIBUTION, 45'-2" ALUMINUM POLE SHAFT ON 24" DIAMETER CONCRETE FOUNDATION, 47'-6" MOUNTING HEIGHT, 12'-0" MAST ARM, WITH 5A FUSE AND T-BASE (RED PHASE-OPEN SYMBOL, BLACK PHASE-SHADED SYMBOL)
- PROPOSED LIGHTING UNIT INSTALLED IN EARLIER CONSTRUCTION STAGE (RED PHASE-OPEN SYMBOL, BLACK PHASE-SHADED SYMBOL)
- EXISTING UNDERPASS LIGHTING UNIT (RED PHASE-OPEN SYMBOL, BLACK PHASE-SHADED SYMBOL)
 - ROADWAY LIGHTING CONTROLLER (EXISTING OR INSTALLED IN EARLIER CONSTRUCTION STAGE)
 - PROPOSED COMED PAD-MOUNTED TRANSFORMER FOR UTILITY SERVICE CONNECTION AS INSTALLED IN EARLIER CONSTRUCTION STAGE
- EXISTING STAINLESS STEEL, NEMA 4X
 JUNCTION BOX ATTACHED TO STRUCTURE
 (SIZED AS INDICATED ON PLANS)
- PROPOSED CONDUIT AND CABLE TO SECONDARY SIDE OF UTILITY SERVICE CONNECTION AS INSTALLED IN EARLIER CONSTRUCTION STAGE
- PROPOSED UNIT DUCT: SIZE AND QUANTITY OF CONDUCTORS AS INDICATED
- -- UNDERGROUND CONDUCTORS (EXISTING OR INSTALLED IN EARLIER CONSTRUCTION STAGE)
- CONDUCTORS IN 1" PVCC RGC CONDUIT
 ATTACHED TO STRUCTURE (EXISTING OR
 INSTALLED IN EARLIER CONSTRUCTION STAGE)

NOTES:

- 1. SEE DRAWING E-1 FOR ELECTRICAL ABBREVIATIONS. SEE DRAWING E-2 FOR ELECTRICAL GENERAL NOTES.
- 2. COLOR CODING OF CONDUCTORS FOR 240/480V, 10, 3W LIGHTING SYSTEM IS AS FOLLOWS:

"A" PHASE - RED
"B" PHASE - BLACK
NEUTRAL - WHITE
GROUND - GREEN

LIGHTING CONTROLLER "C115" ROADWAY LIGHTING PANEL LOAD TABLE										
CIRCUIT	RED F	PHASE	CIRCUIT	BLACK PHASE						
CIRCUIT	AMPS	WATTS	CIRCUIT	AMPS	WATTS					
Α	20	4800	В	20	4800					
С			D							
Ε			F							
G	6	1440	Н	6	1440					
I			J							
K			L							
М			N							
0			Р							
0			R							
S			T							
U			٧							
W			Х							
TOTAL	26	6240	TOTAL	26	6240					

LOAD TABULATION IS BASED ON THE FOLLOWING:

400W HPS LUMINAIRE: 2.0A AT 240V 100W HPS UNDERPASS LUMINAIRE: 0.5A AT 240V

SCALE: NONE SHEET 1 OF 1 SHEETS STA.

	F.A.P RTE.	SECTION	COUNTY	TOTAL SHEETS	SHEET NO.
G DIAGRAM	330	103R-5	соок	778	358
o Diritaniriii		E-34	CONTRACT	NO. 6	OM62
TO STA		THE THOTO CODE	ID DDO IECT		

FILE NAME =	USER NAME = Anthony_Plutz	DESIGNED -	MAE	REVISED -	Τ
D160M62-SHT-E35.dgn		DRAWN -	WM	REVISED -	
	PLOT SCALE = 2.0000000 '/ in.	CHECKED -	DAD	REVISED -	
SHT_PLAN	PLOT DATE = 3/13/2013	DATE -	03/13/13	REVISED -	

STATE OF ILLINOIS
DEPARTMENT OF TRANSPORTATION

	LIGHTING	CONT		•	GRANGI 17" STA		D) WIRING DIAGRAM
SCALE:	NONE	SHEET	1 OF	1	SHEETS	STA.	TO STA.

PROPOSED LIGHTING UNIT: 400W, 240V PHASE
TO NEUTRAL, HPS LUMINAIRE WITH TYPE III
DISTRIBUTION, 45'-2" ALUMINUM POLE SHAFT
ON 24" DIAMETER CONCRETE FOUNDATION,
47'-6" MOUNTING HEIGHT, 12'-0" MAST ARM,
WITH 5A FUSES AND T-BASE (RED PHASEOPEN SYMBOL, BLACK PHASE-SHADED SYMBOL)

PROPOSED ROADWAY LIGHTING UNIT INSTALLED
IN EARLIER CONSTRUCTION STAGE

PROPOSED COMBINATION POLE LIGHTING UNIT
INSTALLED IN EARLIER CONSTRUCTION STAGE

PROPOSED ROADWAY LIGHTING CONTROLLER INSTALLED IN EARLIER CONSTRUCTION STAGE

PROPOSED COMBINATION LIGHTING CONTROLLER INSTALLED IN EARLIER CONSTRUCTION STAGE

COMBINATION SERVICE DISCONNECT INSTALLED IN EARLIER CONSTRUCTION STAGE

EXISTING COMED PAD-MOUNTED TRANSFORMER FOR UTILITY SERVICE CONNECTION

PROPOSED CONDUIT AND CABLE TO SECONDARY
SIDE OF UTILITY SERVICE CONNECTION
INSTALLED IN EARLIER CONSTRUCTION STAGE

INSTALLED IN EARLIER CONSTRUCTION STAGE
--- PROPOSED UNIT DUCT: SIZE AND QUANTITY OF CONDUCTORS AS INDICATED

-- PROPOSED UNIT DUCT INSTALLED IN EARLIER CONSTRUCTION STAGE

NOTES:

⊢CSD ^E

LEGEND:

- 1. SEE DRAWING E-1 FOR ELECTRICAL ABBREVIATIONS. SEE DRAWING E-2 FOR ELECTRICAL GENERAL NOTES.
- 2. COLOR CODING OF CONDUCTORS FOR 240/480V, 10, 3W LIGHTING SYSTEM IS AS FOLLOWS:

"A" PHASE - RED
"B" PHASE - BLACK
NEUTRAL - WHITE
GROUND - GREEN



LIGHTING CONTROLLER "C117" ROADWAY LIGHTING PANEL LOAD TABLE									
CIRCUIT	RED I	PHASE	CIRCUIT	BLACK PHASE					
CIRCUIT	AMPS	WATTS	CIRCUIT	AMPS	WATTS				
A	4	960	В	4	960				
С			D						
Ε			F						
G	4	960	Н	2	480				
I			J						
K			L						
М	2	480	N	2	480				
0	2	480	Р	2	480				
0			R						
S			Т						
U			٧						
W			х						
TOTAL	12	2880	TOTAL	10	2400				


LOAD TABULATION IS BASED ON THE FOLLOWING:

400W HPS LUMINAIRE: 2.0A AT 240V

CARL SANDBURG HIGH SCHOOL	
SOUTHMOOR DR. SOUTHMOOR DR. 11/4" UD, 3-1/C #6, 1/C #8 GND (LITE) 11/2" UD, 3-1/C #2, 1/C #4 GND (RECP) SERVICE LATERAL SERVICE LATERAL 3-1/C #3/0, 2//2" RGC PROPOSED LIGHTING CONTROLLER "C117" 200A, 240/480V, 10, 3W STA. 353+24, 13' SETBACK	Lagrange ROAD R7 G.1 E R7 G.3 R8 R8 R7 R8 R8 R7 R8 R7 R8 R8

LIGHTING CONTROLLER "C117" STAGE 1B WIRING DIAGRAM
N.T.S.

131st ST

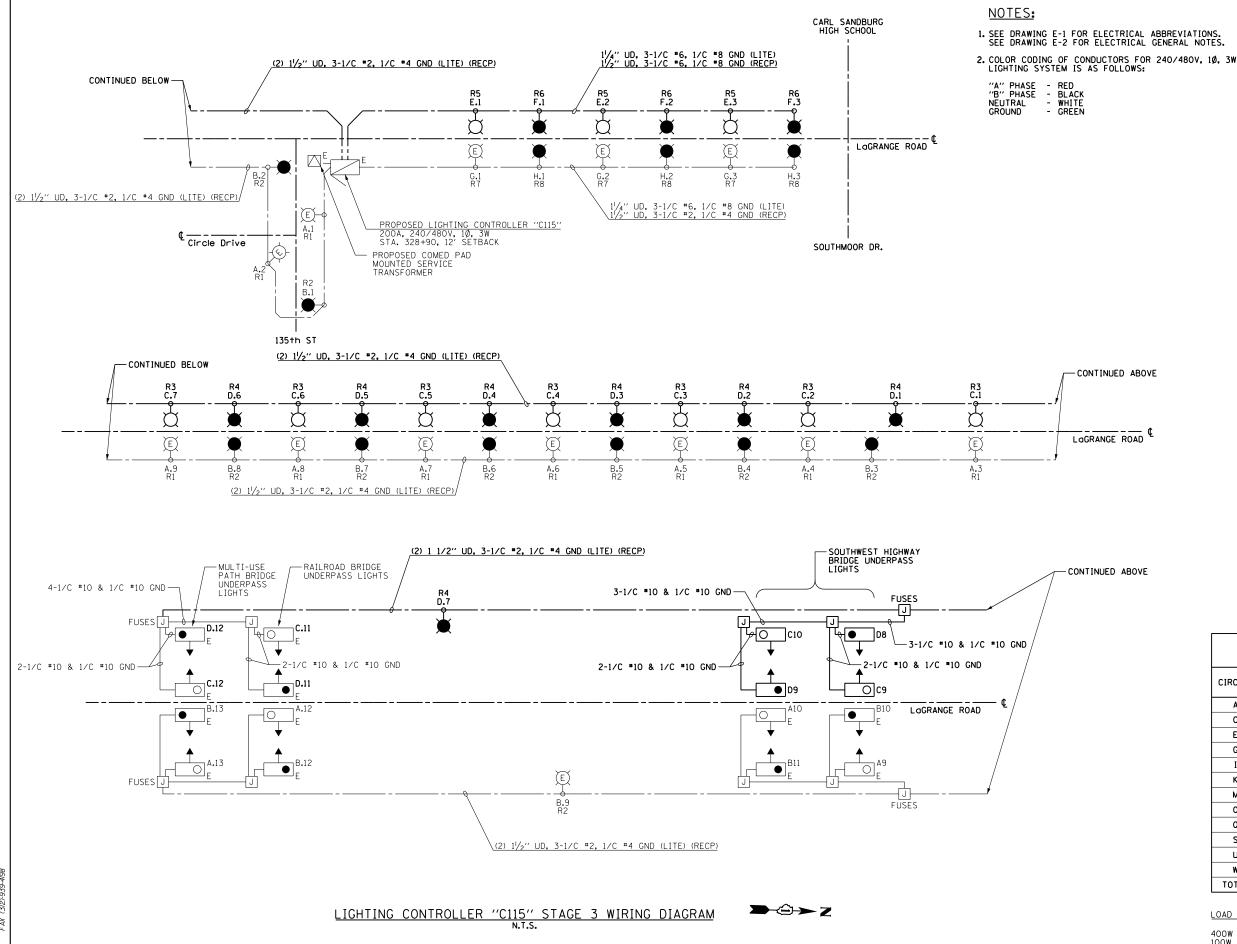

S

ILE NAME 160M62-SHT-E36.dar LEGEND:

J

PROPOSED LIGHTING UNIT: 400W, 240V PHASE TO NEUTRAL, HPS LUMINAIRE WITH TYPE III DISTRIBUTION, 45'-2" ALUMINUM POLE SHAFT ON 24" DIAMETER CONCRETE FOUNDATION, 47'-6" MOUNTING HEIGHT, 12'-0" MAST ARM, WITH 5A FUSE AND T-BASE (RED PHASE-OPEN CAMPON DIACE CONTROL SYMBOL, BLACK PHASE-SHADED SYMBOL)

PROPOSED UNDERPASS LUMINAIRE, 100 WATT, 240V PHASE TO NEUTRAL, HPS, WITH TYPE III DISTRIBUTION, WALL MOUNTED (RED PHASE-OPEN SYMBOL, BLACK PHASE-SHADED SYMBOL)

PROPOSED LIGHTING UNIT INSTALLED IN EARLIER CONSTRUCTION STAGE (RED PHASE-OPEN SYMBOL, BLACK PHASE-SHADED SYMBOL)

PROPOSED TWIN-LUMINAIRE LIGHTING UNIT INSTALLED IN EARLIER CONSTRUCTION STAGE (RED PHASE-OPEN SYMBOL, BLACK PHASE-SHADED SYMBOL)

EXISTING UNDERPASS LIGHTING UNIT (RED PHASE-OPEN SYMBOL, BLACK PHASE-SHADED SYMBOL)

PROPOSED ROADWAY LIGHTING CONTROLLER AS INSTALLED IN EARLIER CONSTRUCTION STAGE

PROPOSED COMED PAD-MOUNTED TRANSFORMER FOR UTILITY SERVICE CONNECTION AS INSTALLED IN EARLIER CONSTRUCTION STAGE

PROPOSED STAINLESS STEEL, NEMA 4X JUNCTION BOX ATTACHED TO STRUCTURE (SIZED AS INDICATED ON PLANS)

EXISTING STAINLESS STEEL, NEMA 4X JUNCTION BOX ATTACHED TO STRUCTURE (SIZED AS INDICATED ON PLANS)

PROPOSED CONDUIT AND CABLE TO SECONDARY SIDE OF UTILITY SERVICE CONNECTION AS INSTALLED IN EARLIER CONSTRUCTION STAGE

PROPOSED UNIT DUCT: SIZE AND QUANTITY OF CONDUCTORS AS INDICATED

PROPOSED CONDUCTORS IN 1" PVCC RGS CONDUIT ATTACHED TO STRUCTURE: SIZE AND QUANTITY OF CONDUCTORS AS INDICATED

PROPOSED UNIT DUCT INSTALLED IN EARLIER CONSTRUCTION STAGE

CONDUCTORS IN 1" PVCC RGC CONDUIT ATTACHED TO STRUCTURE (EXISTING OR INSTALLED IN EARLIER CONSTRUCTION STAGE)


LIGHTING CONTROLLER "C115" ROADWAY LIGHTING PANEL LOAD TABLE


-					_
CIRCUIT	RED F	PHASE	CIRCUIT	BLACK	PHASE
CIRCUIT	AMPS	WATTS	CIRCUIT	AMPS	WATTS
Α	20	4800	В	20	4800
С	16	3840	D	16	3840
Ε	6	1440	F	6	1440
G	6	1440	Н	6	1440
I			J		
К			L		
М			N		
0			Р		
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S			Т		
U			٧		
W			X		
TOTAL	48	11520	TOTAL	48	11520

LOAD TABULATION IS BASED ON THE FOLLOWING:

400W HPS LUMINAIRE: 2.0A AT 240V 100W HPS UNDERPASS LUMINAIRE: 0.5A AT 240V

USER NAME = Anthony_Plutz	DESIGNED - MAE	REVISED -		US 45 (Lagrange Road)					F.A.P RTE.	SECTION	COUNTY	TOTAL SHE	┑	
	DRAWN - WM	REVISED -	STATE OF ILLINOIS	LICUTIA	IC CONT	(IC DIACDAM	330	103R-5	соок	778 36	
PLOT SCALE = 2.000000 '/ in.	CHECKED - DAD	REVISED -	DEPARTMENT OF TRANSPORTATION	LIGHTING CONTROLLER "C115" STAGE 3 WIRING DIAGRAM				E-36		NO. 60M6				
PLOT DATE = 3/13/2013	DATE - 03/13/13	REVISED -		SCALE: NONE SHEET 1 OF 1 SHEETS STA. TO STA.						ID PROJECT				

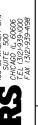

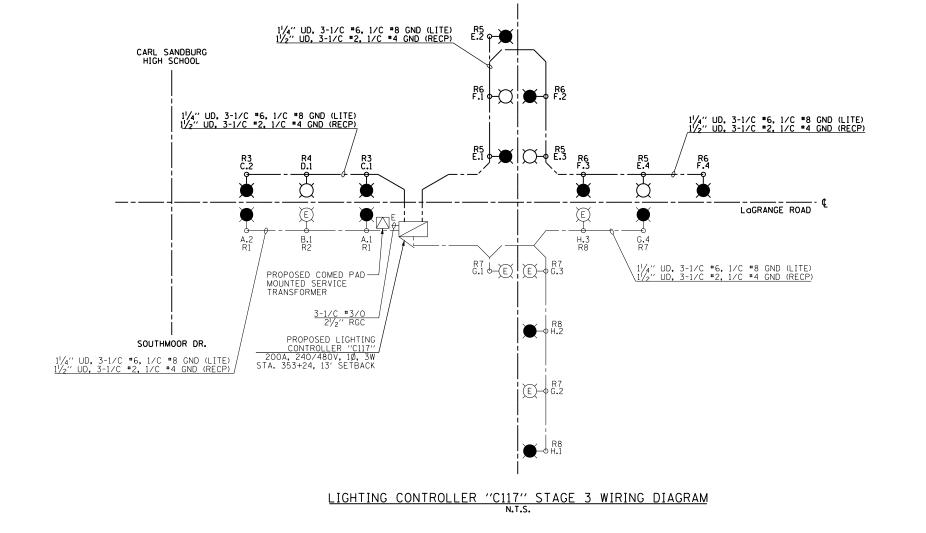

131st ST

LEGEND:

PROPOSED LIGHTING UNIT: 400W, 240V PHASE TO NEUTRAL, HPS LUMINAIRE WITH TYPE III DISTRIBUTION, 45'-2" ALUMINUM POLE SHAFT ON 24" DIAMETER CONCRETE FOUNDATION, 47'-6" MOUNTING HEIGHT, 12'-0" MAST ARM, WITH 5A FUSES AND T-BASE (RED PHASE-OPEN SYMBOL, BLACK PHASE-SHADED SYMBOL)

PROPOSED COMBINATION POLE LIGHTING UNIT:
400W, 2.0A AT 240V PHASE TO PHASE, HPS
LUMINAIRE WITH TYPE III DISTRIBUTION

PROPOSED ROADWAY LIGHTING UNIT INSTALLED IN EARLIER CONSTRUCTION STAGE

PROPOSED COMBINATION POLE LIGHTING UNIT INSTALLED IN EARLIER CONSTRUCTION STAGE

PROPOSED ROADWAY LIGHTING CONTROLLER INSTALLED IN EARLIER CONSTRUCTION STAGE

PROPOSED COMBINATION LIGHTING CONTROLLER INSTALLED IN EARLIER CONSTRUCTION STAGE

COMBINATION SERVICE DISCONNECT INSTALLED IN EARLIER CONSTRUCTION STAGE

EXISTING COMED PAD-MOUNTED TRANSFORMER FOR UTILITY SERVICE CONNECTION

PROPOSED CONDUIT AND CABLE TO SECONDARY
SIDE OF UTILITY SERVICE CONNECTION
INSTALLED IN EARLIER CONSTRUCTION STAGE

--- PROPOSED UNIT DUCT: SIZE AND QUANTITY OF CONDUCTORS AS INDICATED

--- PROPOSED UNIT DUCT INSTALLED IN EARLIER CONSTRUCTION STAGE

NOTES:

1. SEE DRAWING E-1 FOR ELECTRICAL ABBREVIATIONS. SEE DRAWING E-2 FOR ELECTRICAL GENERAL NOTES.

2. COLOR CODING OF CONDUCTORS FOR 240/480V, 10, 3W LIGHTING SYSTEM IS AS FOLLOWS:

"A" PHASE - RED
"B" PHASE - BLACK
NEUTRAL - WHITE
GROUND - GREEN




LIGHTING CONTROLLER "C117" ROADWAY LIGHTING PANEL LOAD TABLE									
CIRCUIT	RED F	PHASE	CIRCUIT	BLACK PHASE					
CIRCUIT	AMPS	WATTS	CIRCUIT	AMPS	WATTS				
Α	4	960	В	2	480				
С	4	960	D	2	480				
Ε	8	1920	F	8	1920				
G	4	960	Н	6	1440				
I			J						
К			L						
М			N						
0			Р						
0			R						
S			Т						
U			٧						
w			х						
TOTAL	20	4800	TOTAL	18	4320				

LOAD TABULATION IS BASED ON THE FOLLOWING:

400W HPS LUMINAIRE: 2.0A AT 240V

FILE NAME =	USER NAME = Anthony_Plutz	DESIGNED - MAE	REVISED -		US 45 (Lagrange road)	F.A.P RTF	SECTION	COUNTY	TOTAL SHEET SHEETS NO.
D160M62-SHT-E37.dgn		DRAWN - WM	REVISED -	STATE OF ILLINOIS	LIGHTING CONTROLLER "C117" STAGE 3 WIRING DIAGRAM	330	103R-5	соок	778 361
	PLOT SCALE = 2.0000000 '/ in.	CHECKED - DAD	REVISED -	DEPARTMENT OF TRANSPORTATION	LIGHTING CONTROLLER CITY STAGE 3 WINING DIAGNAM		E-37	CONTRACT	NO. 60M62
SHT_PLAN	PLOT DATE = 3/13/2013	DATE - 03/13/13	REVISED -		SCALE: NONE SHEET 1 OF 1 SHEETS STA. TO STA.		ILLINOIS FED.	AID PROJECT	

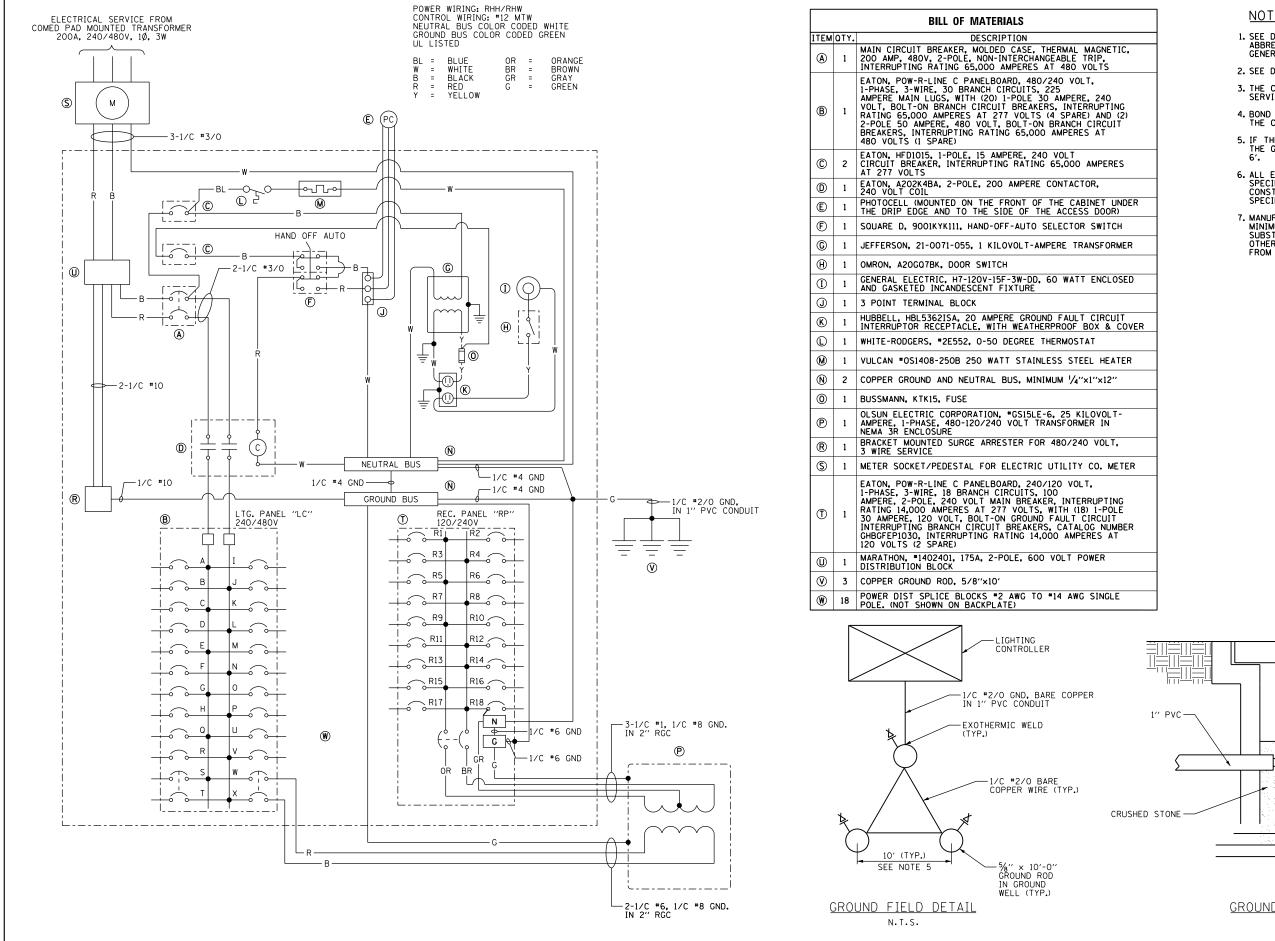

NOTES:

- 1. SEE DRAWING E-1 FOR ELECTRICAL SYMBOL LIST AND ABBREVIATIONS. SEE DRAWING E-2 FOR ELECTRICAL GENERAL NOTES.
- 2. SEE DRAWING E-20 FOR CONTROLLER CABINET DETAILS.
- 3. THE CONTROLLER SHALL BE SUITABLE FOR USE AS SERVICE EQUIPMENT PER NEC 230.66 AND U.L. LISTED.
- 4. BOND PANELBOARD ENCLOSURES "LC" AND "RP" TO THE CONTROLLER ENCLOSURE WITH *6 GND.
- 5. IF THERE IS NOT ENOUGH RIGHT OF WAY TO INSTALL THE GROUNDING TRIAD AS SHOWN, REDUCE SPACING TO
- 6. ALL EOUIPMENT, MATERIALS AND COMPONENTS MUST BE SPECIFICATION GRADE OR BETTER. COMPLETE CABINET CONSTRUCTION SHALL FOLLOW ALL APPLICABLE IDOT SPECIFICATIONS, STANDARDS, AND DETAILS.
- 7. MANUFACTURER MODEL AND PART NUMBERS SHOWN ARE MINIMUM ACCEPTABLE COMPONENTS AND CAN BE SUBSTITUTED WITH EQUAL OR BETTER MATERIALS FROM OTHER MANUFACTURERS WITH THE WRITTEN APPROVAL FROM THE ENGINEER OF RECORD.

STONE STONE

GROUND WELL DETAIL

STATE OF ILLINOIS
DEPARTMENT OF TRANSPORTATION

US 45 (Lagrange road)

Lighting Controller Wiring Diagram & Grounding Details

Scale: None Sheet 1 of 1 sheets Sta. To Sta.

-GROUND ROD, 5/8" × 10'-0" COPPER

WITH REMOVABLE FLUSH COVER. COVER SHALL BE ATTACHED VIA S.S. HEADED SCREWS.

160M62-SHT-E38.dgr

DESIGNED -

ORAWN

CHECKED

USER NAME = Anthony_Plutz

PLOT SCALE = 2.0000000 '/ in.

MAE

WM

DAD

03/13/13


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REVISED


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REVISED





FRONT VIEW DOOR REMOVED

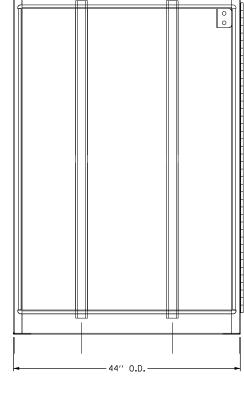

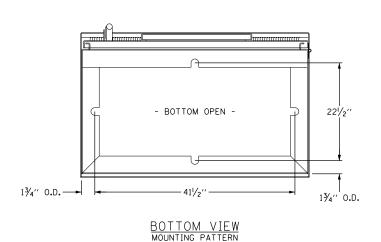DESIGNED - MAE

WM

DAD

- 03/13/13

DRAWN -

CHECKED -

DATE

USER NAME = Anthony_Plutz

PLOT DATE = 3/13/2013


ALUMINUM TYPE IV CONTROL CABINET 3R 59"x44"x26" SCALE: NOT TO SCALE

REVISED


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REVISED



<u>RIGHT SIDE VIEW</u>

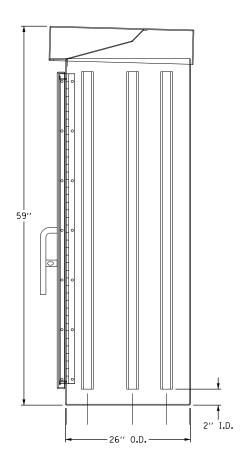

SPECIFICATIONS:

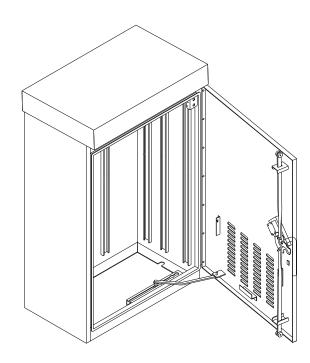PERFORMANCE - THE ENCLOSURE WILL MEET OR EXCEED THE REQUIREMENTS OF A NEMA 3R RATING AND SHALL BE U.L. LISTED PER U.L. 508.

MATERIAL - SHEET ALUMINUM 1/8" THICKNESS, ALLOY 5052 H32. SURFACE SHALL HAVE A SMOOTH, NATURAL ALUMINUM MILL FINISH. ALL WELDS TO BE HELIARC AND SHALL BE NEATLY FORMED AND FREE OF CRACKS, BLOW HOLES, AND OTHER DEFECTS. ALL EDGES TO BE FREE OF BURRS.

CABINET FEATURES - CABINET TOP SLOPED 1/2" TO THE REAR, WITH 1/8" X 1" VENT SLOTS UNDER FRONT OVERHANG.

DOORS AND LOCKS - THE MAIN DOOR IS OF NEMA TYPE 3R CONSTRUCTION WITH CELLULAR NEOPRENE GASKET, WHICH IS RAIN TIGHT. HINGE IS 2" OPEN AND IS CONTINUOUS 14 GAUGE STAINLESS STEEL WITH A 1/4" DIA. PIN AND IS CAPPED AT THE TOP TO RENDER IT TAMPER PROOF. THE HINGE IS SECURED WITH 1/4-20 STAINLESS STEEL CARRIAGE BOLTS AND ESNA LOCK NUTS. STANDARD EOUIPMENT INCLUDES A THREE POINT LOCKING SYSTEM, WHICH SECURES THE DOOR AT THE TOP, BOTTOM, AND CENTER, A CORBIN LOCK WITH TWO KEYS IS ALSO FURNISHED. THE MAIN DOOR IS ALSO EOUIPPED WITH A THREE POSITION DOOR STOP, ONE AT 90°, ONE AT 120°, AND ONE AT 180°, DOOR LOCKING RODS ARE 1/4" X 3/4" ALUMINUM TURNED EDGEWAYS WITH I" NYLON ROLLERS. MAIN DOOR HANDLE IS 3/4" DIAMETER STAINLESS STEEL. THE CABINET DOOR SHALL BE HINGED ON THE RIGHT SIDE WHEN FACING THE FRONT OF THE CABINET.

EQUIPMENT MOUNTING - THE CABINET SHALL BE EQUIPPED WITH TWO ADJUSTABLE "L" MOUNTING CHANNELS WELDED TO EACH SIDE WALL AND THE BACK WALL ALLOWING FULL ADJUSTMENT OF SHELVES OR PANELS.

VENTILATION - VENT SLOTS (1/8" X 1") ARE PROVIDED ON THE UNDERSIDE OF THE COVER OVERHANG AND LOUVER SLOTS ARE FORMED IN THE LOWER PORTION OF THE MAIN DOOR. THIS CREATES A NATURAL MOVEMENT OF AIR AND HAS A COOLING EFFECT ON THE ELECTRICAL EQUIPMENT.

CABINET TYPE FOR PERMANENT CONTROLLERS "C115" AND "C117" ARE BASE MOUNTED AND EQUIPPED WITH INSIDE FLANGES AT THE FRONT, BACK, AND SIDES FOR ANCHORING TO A BASE (SEE INSTALLATION DETAILS ON DRAWING E-40).

CABINET TYPE FOR TEMPORARY CONTROLLERS "T104" AND "T105" ARE POLE MOUNTED (SEE INSTALLATION DETAILS ON DRAWING E-41).

THIS SPECIFICATION IS PER IDOT STANDARD SPECIFICATIONS.

INDICATED DIMENSIONS REPRESENT THE MINIMUM REQUIREMENTS. DIMENSIONS SHALL BE INCREASED AS REQUIRED TO COMPLY WITH THE CODE AND TO ADEQUATELY HOUSE ALL REQUIRED COMPONENTS WITH AMPLE ROOM FOR ARRANGEMENT AND TERMINATION OF WIRING.

THE SERVICE EQUIPMENT SHALL BE MARKED TO IDENTIFY AS BEING SUITABLE AS SERVICE EQUIPMENT IN ACCORDANCE WITH NEC ARTICLE 230.66.

STATE OF ILLINOIS DEPARTMENT OF TRANSPORTATION			L
	SCALE:	NONE	SHEET

	US 45 (LaGRANGE ROAD)						F.A.P RTE.	SEC.	TION		COUNTY	TOTAL	SHEET NO.
LIGHTING CONTROLLER DETAILS				330	103R-5			COOK	778	363			
		-	-	TT TT TT				E-39			CONTRACT	NO. 6	50M62
T	1	OF	1	SHEETS	STA.	TO STA.			ILLINOIS	FED. AI	D PROJECT		


(2) 2" RGC, SEE DRAWING E-37 FOR CONTROLLER CABINET NOTE 4 NUMBER AND SIZE OF WIRES -25KVA, 480-120/240V TRANSFORMER IN NEMA 3R ENCLOSURE NOTE 19 SOCKET 3" (TYP.) 3" (TYP.)--3" (TYP.) BEVELLED EDGES EXPANSION JOINT BOLT TRANSFORMER BASE TO CONCRETE FOUNDATION (TYP.) 4' WIDE X 4" THICK CONCRETE SLAB GRADE -NOTE 18 GRADE -30" MIN. (TYP.) 30" MIN. (TYP.) -1" PVC TO GROUND FIELD OF (3) GROUND RODS IN A 10 FT. TRIANGLE. SEE DRAWING E-37 FOR WIRE SIZES. VERIFY EXACT LOCATION OF GROUND FIELD WITH THE ENGINEER. NO GROUND WELL SHALL BE PLACED IN CONCRETE PAD IN FRONT OF CONTROLLER. 4" DIA. × 36"-PVC ELBOW (TYP.) PROVIDE BUSHING AND DUCT SEAL (TYP.) CONDUIT TO COMED TRANSFORMER -CONCRETE FOUNDATION NOTE 17 4" PVC RACEWAYS, (10) MINIMUM PLUS 2 SPARES. COORDINATE WITH CIRCUIT REQUIREMENTS TYPICAL-ACTUAL DIRECTION AS REQUIRED PER PLANS LEFT SIDE ELEVATION FRONT ELEVATION

LIGHTING CONTROLLER FOUNDATION DETAILS

NOTES:

- 1. COORDINATE PLACEMENT OF RACEWAYS WITH CONTROLLER MANUFACTURER TO ASSURE DOOR LATCH DOES NOT INTEFERE WITH CABLES OR OTHER DEVICES.
- 2. THE CONTRACTOR SHALL PROVIDE A GROUND FIELD AT EACH CABINET LOCATION. THE GROUND RODS, ANCHOR BOLTS AND REINFORCEMENT STEEL SHALL ALL BE INTERCONNECTED.
- 3. THE CONTRACTOR SHALL VERIFY EXACT LOCATION OF CONTROLLER FOUNDATION AND GROUND FIELD WITH THE ENGINEER.
- 4. SEE DRAWING E-39 FOR CONTROL CABINET DETAILS.
- 5. ALL SCREWS AND HARDWARE SHALL BE PLATED, GALVANIZED, OR MADE OF BRASS, ALUMINUM OR STAINLESS STEEL.
- 6. NAME PLATE SHALL HAVE ENGRAVED 0.75 INCH HIGH LETTERS FILLED IN BLACK: "ROADWAY LIGHTING CONTROLLER, VILLAGE OF ORLAND PARK".
- 7. ONE INCH THICK POLYISOCYANURATE INSULATION SHALL BE INSTALLED AND PERMANENTLY CEMENTED ON ALL SIDES OF THE CABINET AND DOORS.
- 8. ALL DEVICES SHALL BE FRONT REMOVABLE.
- 9. ALL LUGS SHALL BE OF COPPER SCREWS AND CONNECTORS, SPRING HELD.
- 10. ALL CONTROL WIRING SHALL BE 600V MACHINE TOOL WIRE TYPE MTW.
- 11. ALL POWER WIRING SHALL BE 600V TYPE RHH/RHW.
- 12. CIRCUIT BREAKERS, CONTACTORS AND OTHER COMPONENTS SHALL BE PANEL MOUNTED ON 0.125 INCH THICK GLASTIC INSULATION BACK PANEL.
- 13. THE COMPLETED CONTROLLER SHALL BE U.L. LISTED AS AN INDUSTRIAL CONTROL PANEL UNDER UL508.
- 14. ALL 120 VOLT SYSTEM AND ALL CONTROL WIRING SHALL BE *12AWG STRANDED UNLESS OTHERWISE INDICATED.
- 15. ALL WIRING SHALL BE NEATLY DRESSED AND SUPPORTED.
- 16. FOR LIGHTING CONTROLLER WIRING DIAGRAM, SEE DRAWING E-38.
- 17. CONCRETE FOUNDATION SHALL BE CONSTRUCTED AS REQUIRED TO SUPPORT CONTROL CABINET AND TRANSFORMER. CONTRACTOR TO INSURE THE CONTROLLER CABINET AND METER SOCKET ARE LOCATED ON THE FOUNDATION END CLOSEST TO THE UTILITY SERVICE, WITH THE METER SOCKET FACING THE DIRECTION OF THE UTILITY SERVICE. CONCRETE FOUNDATION SHALL BE INCLUDED IN THE COST OF "LIGHTING CONTROLLER, SPECIAL" PAY ITEM.
- 18. LENGTH OF CONCRETE SLAB SHOULD MATCH LENGTH OF CONCRETE FOUNDATION.
- 19. THE COST OF THE TRANSFORMER AND THE RELATED WORK SHALL BE INCLUDED IN THE COST OF "LIGHTING CONTROLLER, SPECIAL" ITEM.

TOTAL SHEE SHEETS NO. DESIGNED - MAE REVISED USER NAME = Anthony_Plutz SECTION COUNTY US 45 (LaGRANGE ROAD) 160M62-SHT-E40.dgr DRAWN WM REVISED STATE OF ILLINOIS 330 103R-5 COOK 778 364 LIGHTING CONTROLLER FOUNDATION DETAILS PLOT SCALE = 2.0000000 '/ in. CHECKED DAD REVISED **DEPARTMENT OF TRANSPORTATION** E-40 CONTRACT NO. 60M62 1 OF 1 SHEETS STA. SCALE: NONE SHEET 03/13/13 PLOT DATE = 3/13/2013 DATE REVISED

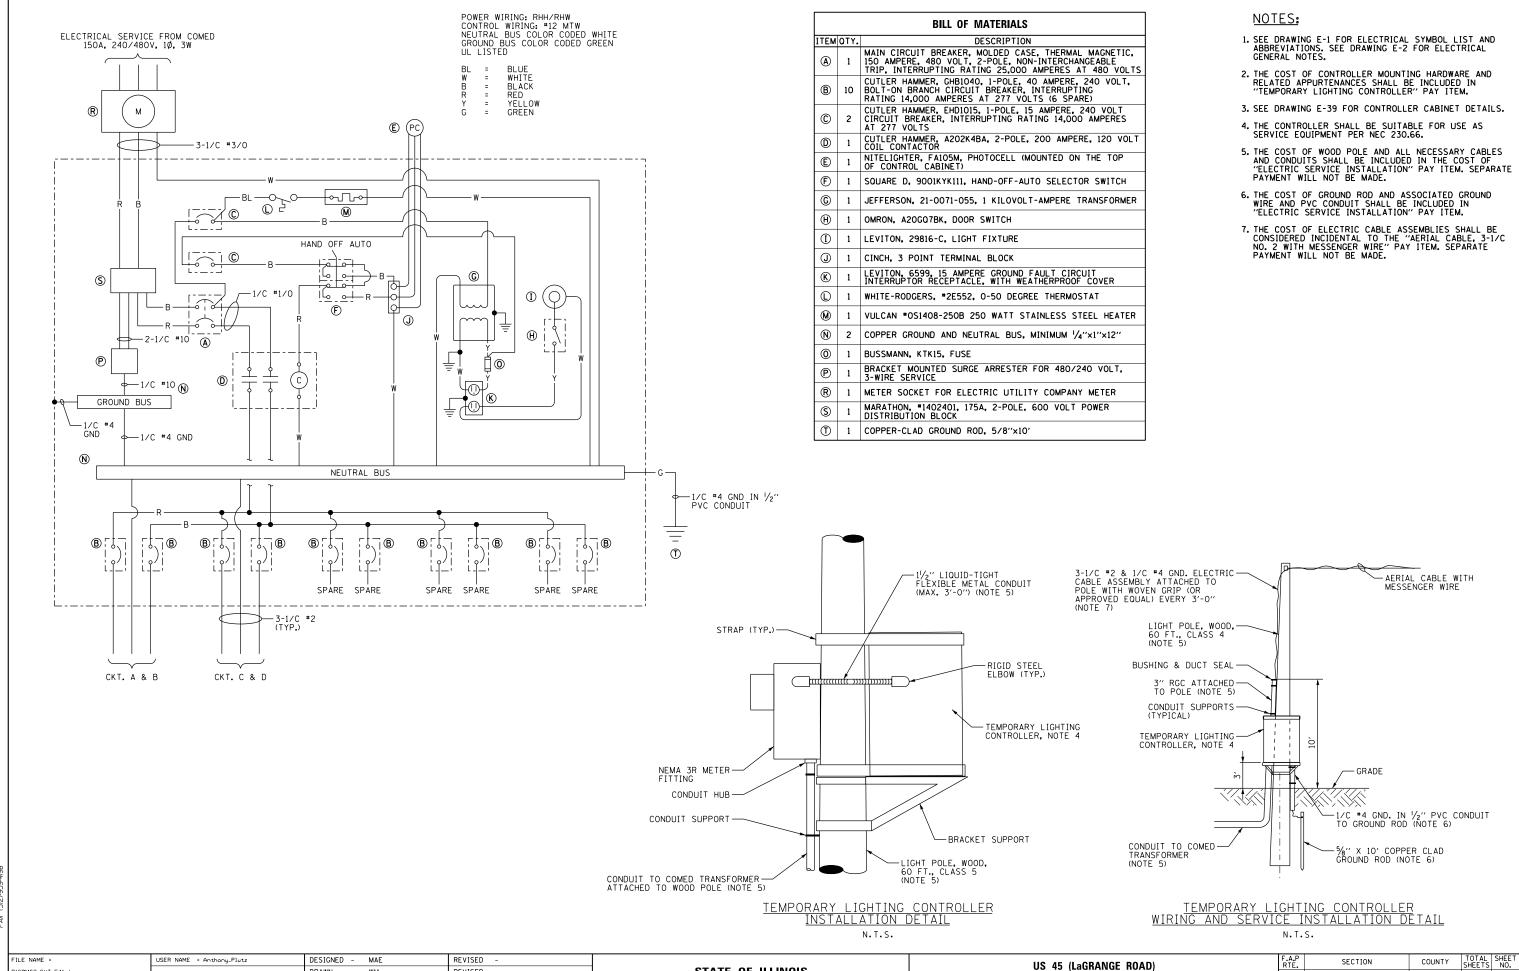

STATE OF ILLINOIS

DEPARTMENT OF TRANSPORTATION

330

TEMPORARY LIGHTING CONTROLLER DETAILS & DIAGRAMS

1 OF 1 SHEETS STA.

SCALE: NONE SHEET

103R-5

E-41

COOK

778 365

CONTRACT NO. 60M62

160M62-SHT-E41.dgr

ORAWN

DATE

CHECKED

PLOT SCALE = 2.0000 '/ in.

PLOT DATE = 3/13/2013

WM


DAD

03/13/13

REVISED

REVISED


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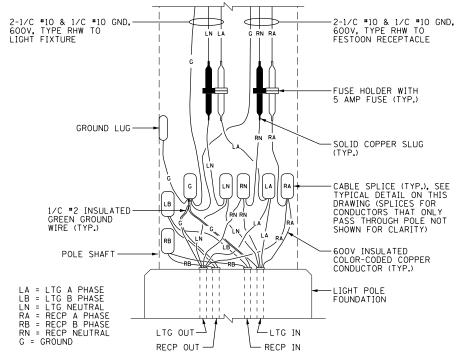
TYPICAL LIGHTING UNIT AND RECEPTACLE WIRING DIAGRAM N.T.S.

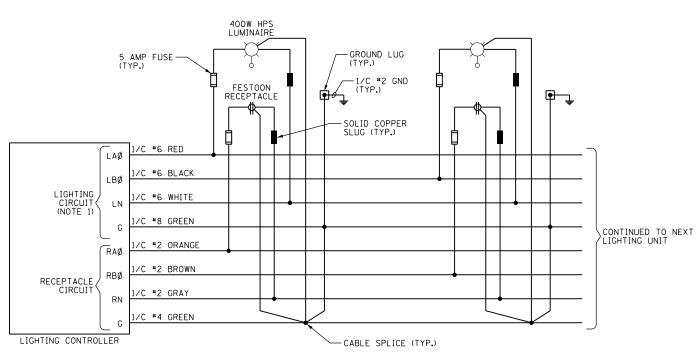NOTES:


1. SOME LIGHTING CIRCUITS ARE REQUIRED TO USE 3-1/C #2, 1/C #4 GND.



TYPICAL UNIT DUCT IN TRENCH DETAIL N.T.S.

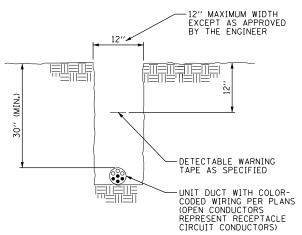

TYPICAL POLE BASE WIRING DETAIL

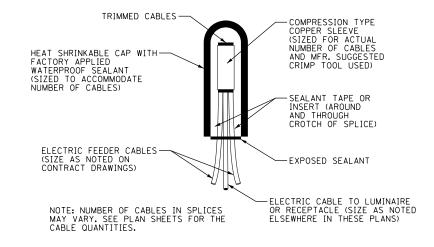

TYPICAL SPLICE DETAIL N.T.S.

FILE NAME =	USER NAME = Anthony_Plutz	DESIGNED -	MAE	REVISED -	
D160M62-SHT-E42.dgn		DRAWN -	WM	REVISED -	
	PLOT SCALE = 2.0000000 '/ in.	CHECKED -	DAD	REVISED -	
SHT_PLAN	PLOT DATE = 3/13/2013	DATE -	03/13/13	REVISED -	

STATE OI	F ILLINOIS
DEPARTMENT OF	TRANSPORTATION

	U	IS 45	(Lat	GRANGI	ROAD)		F.A.P RTE.	SECTION	COUNTY	TOTAL SHEETS	SHEE NO.
Fi	ELECTRICAL WIRING DIAGRAMS AND DETAILS							103R-5	соок	778	366
								E-42 CONTRACT NO.			0м62
SCALE: NONE	SHEET	1 OF	1	SHEETS	STA.	TO STA.		ILLINOIS FED. A	ID PROJECT		

- 1 THE CUSTOMER TO INSTALL THE TRANSFORMER FOUNDATION, 1 INCH CONDUITS, AND TRENCH FOR COMED GROUND WIRE.
- (2) Comed to provide and install the ground wire and GRID.
- (13) AFTER PRIMARY AND SECONDARY CONDUITS ARE IN PLACE, BACKFILL WITH SCREENINGS, SAND, OR FINE EXCAVATED MATERIAL. COMPACT THOROUGHLY BEFORE POURING FOUNDATION.
- (4) CONCRETE TO BE IN ACCORDANCE WITH THE LATEST EDITION OF THE APPLICABLE ACI CODE AND AIR ENTRAINED. IT SHALL HAVE A MINIMUM COMPRESSIVE STRENGTH OF 3000 PSI AT 28 DAYS AIR ENTRAINMENT SHALL BE 4 TO 7 PERCENT OF THE VOLUME OF CONCRETE.

PRESSING TABLE (18) TOOL & DIE NO. OF CRIMPS ITEM U-0

25 PLEASE CONSULT GP 346 (SPCC) OR ENVIRONMENTAL SERVICES IF EITHER OF THE FOLLOWING EXISTS:


- A SINGLE ABOVE GROUND TANK WITH A CAPACITY OF 660

MORE THAN ONE ABOVE GROUND TANK WITH TOTAL CAPACITY EQUAL TO OR EXCEEDING 1320 GALLONS.

2 BOX OUT CONDUIT OPENING.

23 SECONDARY CONDUIT LOCATION. 24) PRIMARY CONDUIT LOCATION.

GALLONS OR MORE.

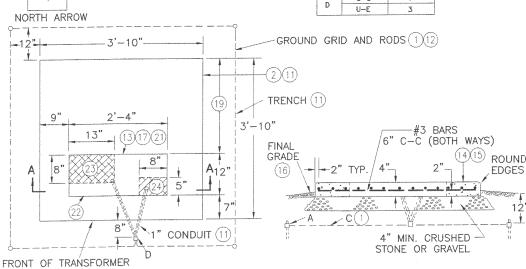

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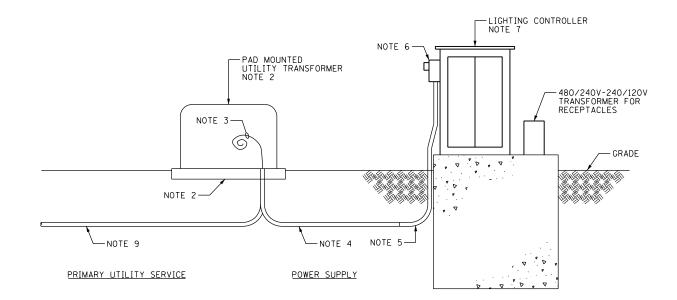
FIGURE 1

ComEd SYSTEM STANDARD

SECTION A-A

NOTES:

- THIS WORK SHALL BE INSTALLED UNDER THE "ELECTRIC SERVICE INSTALLATION" PAY ITEM, UNLESS NOTED OTHERWISE.
- 2. COMMONWEALTH EDISON COMPANY (COMED) SHALL FURNISH AND INSTALL THE PAD MOUNTED TRANSFORMER COMPLETE WITH GROUNDING SYSTEM INCLUDING GROUND RODS, GROUNDING CONDUCTOR, PRIMARY CABLE, CUT-OUT SWITCH, LIGHTNING ARRESTOR, CONNECTORS, AND ANY OTHER EQUIPMENT AND LABOR DEEMED NECESSARY. SEE COMED SYSTEM STANDARD C5288 FOR INSTALLATION REQUIREMENTS.
- 3. ELECTRIC SERVICE CONDUCTORS FROM THE INSIDE OF THE CABINET TO THE TRANSFORMER, PROVIDE 10 FT OF SLACK FOR CONNECTION TO TRANSFORMER BY COMED. CABLE SHALL CONFORM TO THE REQUIREMENTS SPECIFIED FOR ELECTRIC CABLE IN CONDUIT, LABEL CABLE ON BOTH ENDS. SEE PLAN DRAWINGS FOR CABLE TYPE AND SLIZE. DRAWINGS FOR CABLE TYPE AND SIZE.
- 4. UNDERGROUND CONDUIT. SEE PLAN DRAWINGS FOR CONDUIT MATERIAL AND
- 5. RGC 90 DEGREES LONG SWEEP ELBOW IN TRENCH, SEE PLAN DRAWINGS FOR CONDUIT, TYPE, SIZE, AND QUANTITY. THIS WORK SHALL BE INSTALLED UNDER THE "ELECTRIC SERVICE INSTALLATION" PAY ITEM.
- 6. UNDER THE "ELECTRIC UTILITY SERVICE CONNECTION" PAY ITEM, COMED SHALL FURNISH AND INSTALL METER ON CONTROLLER CABINET.
- 7. SEE DRAWING E-40 FOR LIGHTING CONTROLLER FOUNDATION DETAILS.
- 8. SUBMIT A PLAN DRAWING SHOWING THE PROPOSED PRIMARY CONDUIT INSTALLATION TO COMED FOR THEIR APPROVAL. THIS WORK SHALL BE COVERED UNDER THE "ELECTRIC UTILITY SERVICE CONNECTION" PAY ITEM. SEPARATE PAYMENT WILL NOT BE MADE.
- COORDINATE DETAILS WITH COMED. FOR BID, ASSUME 200 FEET OF 4" DIA. UNDERGROUND RGC WITH 3-1/C *2/O 12KV CABLES.




INSTALLATION DETAIL

ILE NAME =	USER NAME = Anthony_Plutz	DESIGNED -	MAE	REVISED -	Π
0160M62-SHT-E43.dgn		DRAWN -	WM	REVISED -	
	PLOT SCALE = 2:0.0000000 ':' / in.	CHECKED -	DAD	REVISED -	
SHT_PLAN	PLOT DATE = 3/13/2013	DATE -	03/13/13	REVISED -	
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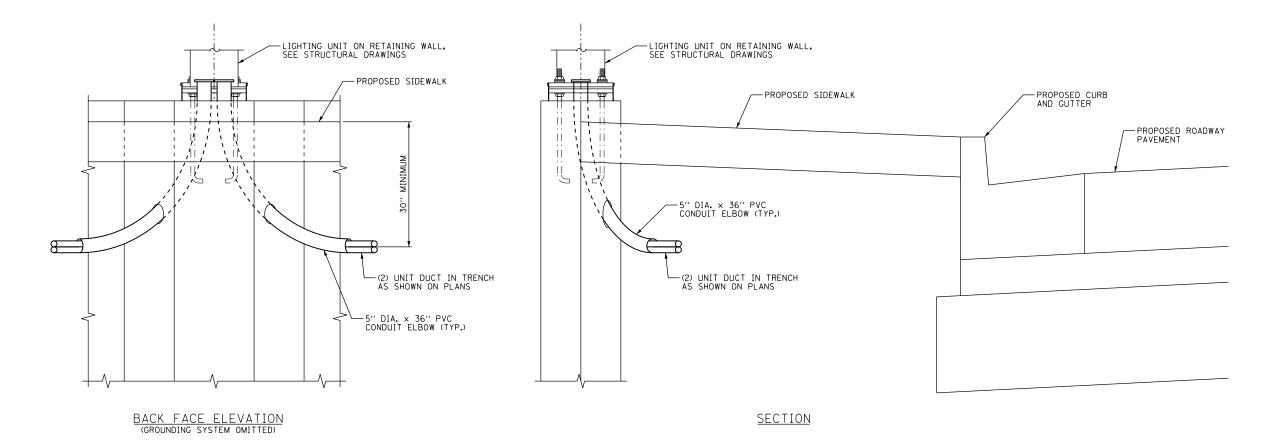
US 45 (Lagrange road)	F.A.P RTE.	SECTION	COUNTY	TOTAL SHEETS	SHEET NO.
ELECTRIC SERVICE INSTALLATION PAD MOUNTED TRANSFORMER	330	103R-5	COOK	778	367
		E-43	CONTRACT	NO. 6	OM62
SCALE: NONE SHEET 1 OF 1 SHEETS STA. TO STA.		ILLINOIS FED. A	D PROJECT		

NOTES:

 SEE DRAWING E-1 FOR ELECTRICAL SYMBOL LIST AND ABBREVIATIONS. SEE DRAWING E-2 FOR ELECTRICAL GENERAL NOTES.

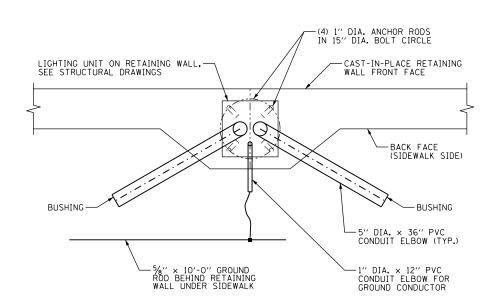

<u>PLAN VIEW</u>



LIGHT POLE ON CAST-IN-PLACE RETAINING WALL N.T.S.

100 S. WAC SUITE 5	CHICAGO IL TEL (312)-9 FAX (312)-9
	3


FILE NAME =	USER NAME = Anthony_Plutz	DESIGNED -	MAE	REVISED -	Ī
D160M62-SHT-E44.dgn		DRAWN -	WM	REVISED -	ı
	PLOT SCALE = 2.0000 '/ in.	CHECKED -	DAD	REVISED -	ı
SHT_PLAN	PLOT DATE = 3/13/2013	DATE -	03/13/13	REVISED -	


STATE	OF ILLINOIS
DEPARTMENT O	F TRANSPORTATION

Ī	US 45 (Lagrange road)									SECTION	COUNTY	TOTAL SHEETS	
١	RF1	RETAINING WALL MOUNTED LIGHT POLE INSTALLATION DETAILS							330	103R-5	соок	778	368
ļ		METAINING WALL MODIVIED LIGHT FOLL INSTALLATION DETAILS								E-44 CONTRACT NO. 601			
	SCALE:	NONE	SHEET	1 OF	1	SHEETS	STA.	TO STA.	ILLINOIS FED. AID PROJECT				

NOTES:

- SEE DRAWING E-1 FOR ELECTRICAL SYMBOL LIST AND ABBREVIATIONS. SEE DRAWING E-2 FOR ELECTRICAL GENERAL NOTES.
- 2. AERIAL CABLE MUST HAVE A MINIMUM CLEARANCE OF 20'-0" TO GRADE AT ALL LOCATIONS.
- 3. CONTRACTOR HAS THE OPTION TO SUBSTITUTE THE UNIT DUCT WITH ELECTRIC CABLE IN CONDUIT. NO ADDITIONAL PAYMENT WILL BE ALLOWED FOR ANY ADDITIONAL MATERIALS AS A RESULT OF THIS SUBSTITUTION.

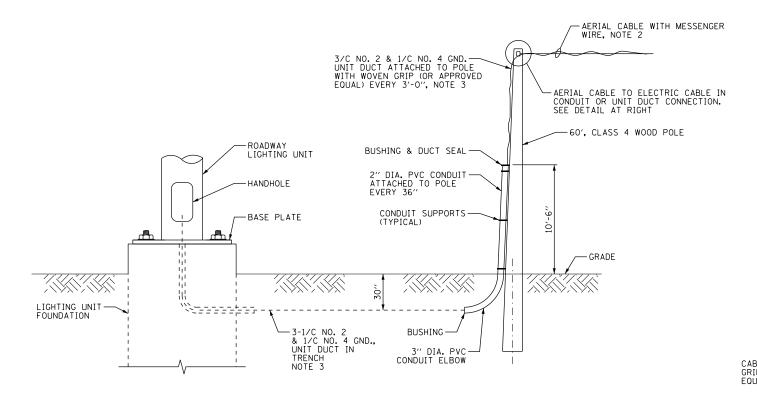

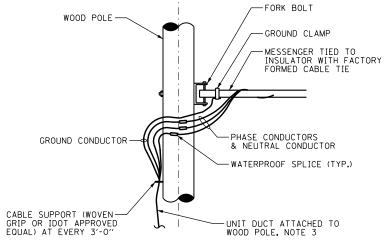

WOOD POLE TO ROADWAY LIGHTING UNIT WIRING CONNECTION DETAIL N.T.S.

REVISED

REVISED REVISED

REVISED

AERIAL CABLE TO ELECTRIC

CABLE ASSEMBLY CONNECTION DETAIL


N.T.S.

SCALE: NONE

| 100 S. WACKER DR. SUITE 500 | CHICAGO IL, 60606 | TEL (312)-939-4198 | FAX (312)-939-4198

E NAME =	USER NAME = Anthony_Plutz	DESIGNED	-	MAE
0M62-SHT-E45.dgn		DRAWN	-	WM
	PLOT SCALE = 2.0000 '/ in.	CHECKED	-	DAD
_PLAN	PLOT DATE = 3/13/2013	DATE	-	03/13/13

	US 45 (Lagrange Road) Temporary lighting details							F.A.P RTE.	SECTION	COUNTY	TOTAL	SHEE'
							:	330	103R-5	соок	778	369
_									E-45	CONTRACT	NO. (60M62
	SHEET	1	OF	1	SHEETS	STA.	TO STA.		ILLINOIS FED. A	ID PROJECT		

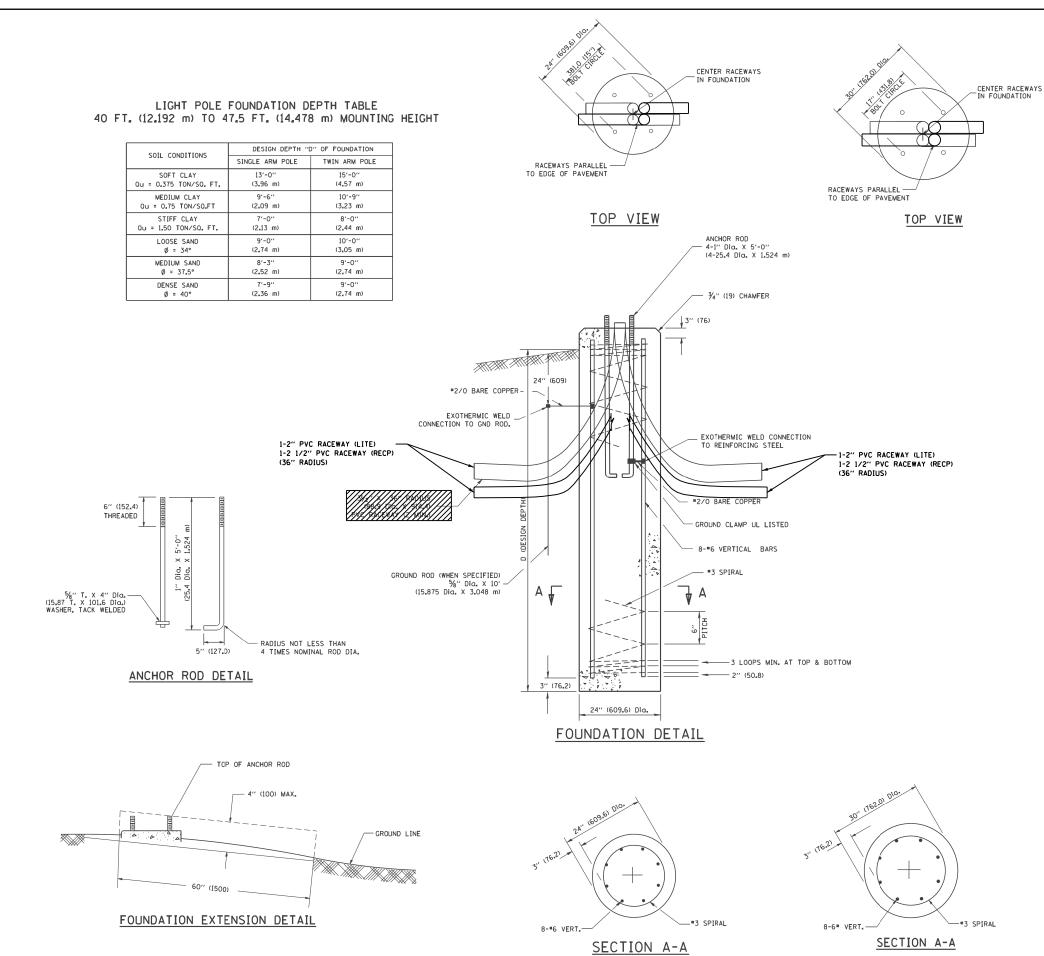



- 1. ALL DIMENSIONS ARE IN INCHES (MILLIMETERS) UNLESS OTHERWISE SHOWN.
- THE ANCHOR RODS AND RACEWAYS SHALL BE PROPERLY SECURED IN PLACE BEFORE THE CONCRETE IN PLACED.
- 3. THE FOUNDATION SHALL NOT PROTRUDE MORE THAN 100MM (4 IN.) ABOVE THE FINISHED GRADE WITHIN A 60 IN. (1.5 m) CHORD ACROSS THE FOUNDATION, WITH ANCHOR RODS INCLUDED. IN ACCORDANCE WITH AASHTO GUIDELINES. IF THE FOUNDATION HEIGHT, INCLUDING ANCHOR RODS, EXTENDS BEYOND THESE SPECIFIED LIMITS, THE FOUNDATION SHALL BE REPLACED AT THE CONTRACTOR'S EXPENSE. SEE FOUNDATION EXTENSION DETAIL.
- 4. THE HOLE FOR THE FOUNDATION SHALL BE MADE BY DRILLING WITH AN AUGER, OF THE SAME DIAMETER AS THE FOUNDATION. IF SOIL CONDITIONS REQUIRE THE USE OF A LINER TO FORM THE HOLE, THE LINER SHALL BE WITHDRAWN AS THE CONCRETE IS DEPOSITED.
- THE TOP OF THE FOUNDATION SHALL BE CONSTRUCTED LEVEL. A LINER OR FORM SHALL BE USED TO PRODUCE A UNIFORM SMOOTH SIDE TO THE TOP OF THE FOUNDATION. FOUNDATION TOP SHALL BE CHAMPERED 3/2-IN. (20 mm).
- 6. THE CONCRETE SHALL BE CLASS SI. CONCRETE SHALL CURE ACCORDING TO ARTICLE 1020,13 BEFORE LIGHT POLES ARE INSTALLED.
- 7. THE ANCHOR ROD SHALL BE A HOOK ROD TYPE. COLD BENDING OF THE ANCHOR ROD WILL NOT BE ALLOWED. THE RADIUS OF THE HOOK BEND SHALL NOT BE LESS THAN 4 TIMES THE NOMINAL DIAMETER OF THE ANCHOR ROD. A TACK WELDED ANCHOR ROD MAY BE SUBSTITUTED WITH THE APPROVAL OF THE ENGINEER.
- THE ANCHOR RODS SHALL BE ACCORDING TO ASTM F1554 GRADE 725 (GRADE 105). NUTS SHALL BE HEXAGON NUTS ACCORDING TO ASTM A 194 2H OR ASTM A 563 DH, AND WASHERS SHALL BE ACCORDING TO ASTM E 436
- ANCHOR RODS, NUTS AND WASHERS SHALL BE COMPLETELY GALVANIZED BY EITHER THE HOT-DIPPED PROCESS CONFORMING WITH AASHTO M 232, THE MECHANICAL PLATING METHOD CONFORMING TO AASHTO M 298, CLASS 50 WITH A MAXIMUM COATING THICKNESS OF 150 UM(6 MILS) OR THE ELECTROLYTIC PROCESS ACCORDING TO ASTM F 1136.
- 10. THE ANCHOR RODS SHALL BE THREADED A MINIMUM OF 6 INCHES (150 mm) WITH A MINIMUM OF 3 INCHES (75 mm) OF THREADED ANCHOR ROD EMBEDDED IN THE FOUNDATION.
- 11. ANCHOR RODS SHALL PROJECT $2\frac{\pi}{4}$ " (69.9 mm) ABOVE THE TOP OF THE FOUNDATION, IF BREAKAWAY COUPLINGS ARE SPECIFIED, THE CONTRACTOR SHALL CAREFULLY COORDINATE THE ANCHOR ROD PROJECTION WITH THE INSTALLATION REQUIREMENTS OF THE BREAKAWAY COUPLINGS.
- 12. THE CONTRACTOR SHALL USE A *3 SPIRAL AT 6" (152.4 mm) PITCH OR MAY SUBSTITUTE *3 TIES AT 12" (304.8 mm) O.C. WITH THE APPROVAL OF THE ENGINEER.
- 13. THE CABLE TRENCHES AND FOUNDATION SHALL BE BACK FILLED AND COMPACTED AS SPECIFIED BEFORE THE LIGHT POLE IS ERECTED.
- 14. THE RACEWAYS SHALL PROJECT I" (25.4 mm) ABOVE THE TOP OF THE FOUNDATION.
- 15. CONTRACTOR MUST INSURE THAT THE SETBACK FROM THE BACK OF CURB TO CENTERLINE OF ALL FOUNDATIONS IS KEPT AT A MINIMUM OF 3"-0". CONTRACTOR MUST ALSO INSURE THAT 4"-0" OF MINIMUM SIDEWALK PAVEMENT WIDTH IS GIVEN WHEREVER A FOUNDATION IS WITHIN THE SIDEWALK OR PATH LIMITS PER A.D.A. REQUIREMENTS.


COUNTY


COOK


778 370

CONTRACT NO. 60M62

USER NAME = Anthony_Plutz	DESIGNED -	MAE	REVISED -	
	DRAWN -	WM	REVISED -	
PLOT SCALE = 2.0000000 '/ in.	CHECKED -	DAD	REVISED -	
PLOT DATE = 3/13/2013	DATE -	03/13/13	REVISED -	
	PLOT SCALE = 2.000000 '/ in.	DRAWN - PLOT SCALE = 2.0000000 '/ in. CHECKED -	DRAWN - WM PLOT SCALE = 2.000000 '/ in. CHECKED - DAD	DRAWN - WM REVISED - PLOT SCALE = 2.0000000 ' / In. CHECKED - DAD REVISED -

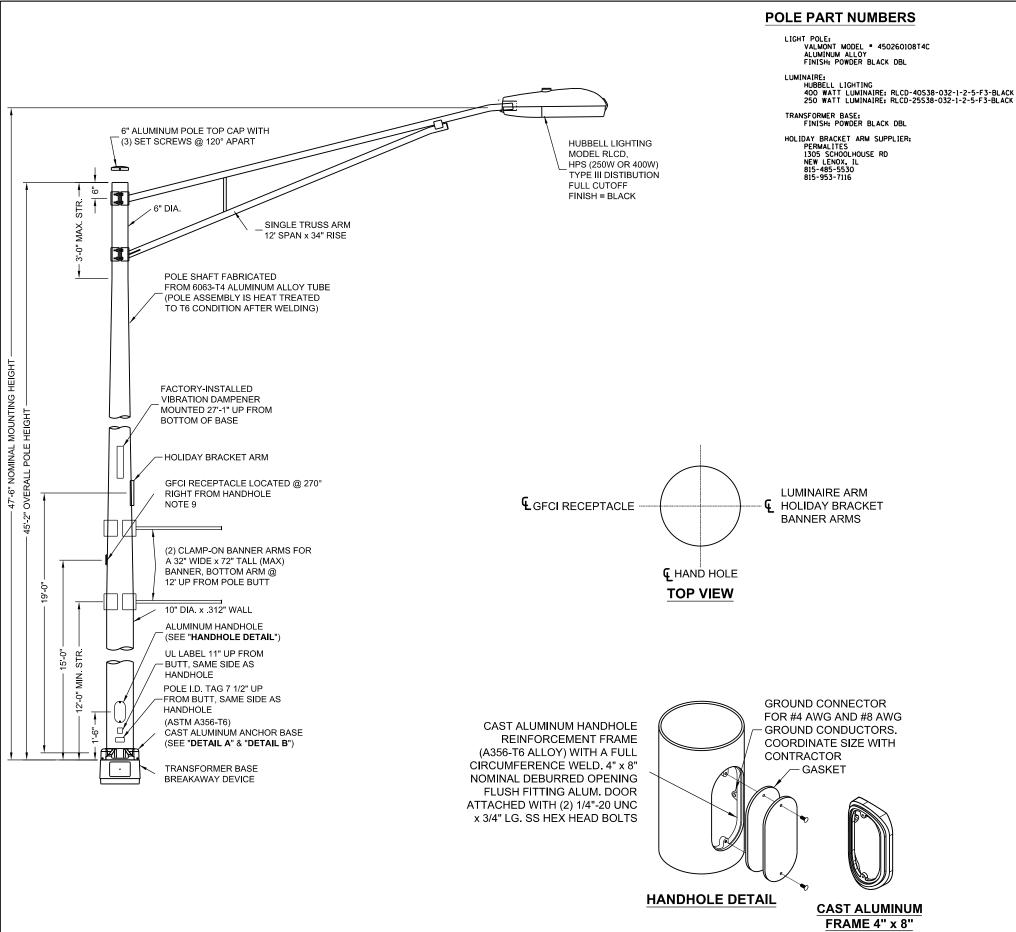

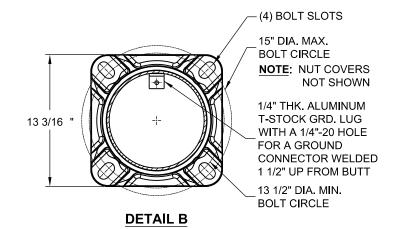

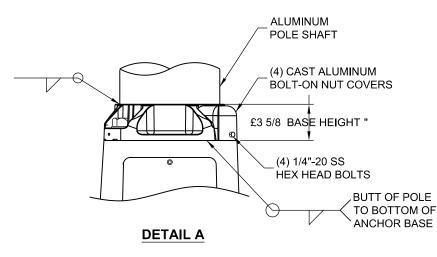


NOTES:

- 1. ALL IDMENSIONS ARE IN INCHES UNLESS OTHERWISE SHOWN.
- 2. MOUNTING HEIGHT IS DEFINED AS THE DISTANCE FROM THE CENTERLINE OF THE TENON TO THE BOTTOM OF THE ANCHOR BASE.
- 3. TWO PIECE SHAFT WILL BE MATCHED, MARKED AND INTERCHANGEABLE BETWEEN DIFFERENT UNITS. FIELD DRILLING OF THE HOLES WILL NOT BE ALLOWED.
- 4. THE LIGHT POLE WILL MEET AASHTO DESING CRITERIA AS SPECIFIED.
- 5. THE INSTALLING CONTRACTOR WILL PROVIDE A UL LISTED GROUNDING CONNECTOR. CONTRACTOR SHALL COORDINATE LUGS WITH POLE MANUFACTURER FOR BONDING LUGS.
- 6. LICHT POLES WILL NOT BE INSTALLED WITHOUT MAST ARMS AND LUMINAIRES.
- LIGHT POLES WILL BE SET PLUMB ON THE FOUNDATION WITHOUT THE USE OF LEVELING NUTS, WASHERS OR SHIMS.
- 8. LIGHTING UNIT IDENTIFICATION NUMBERS SHALL BE INSTALLED BEFORE THE LIGHTING UNIT IS ENERGIZED.
- 9. ALL PROPOSED LIGHTING UNITS SHALL HAVE A 20A, 12OV, GFCI RECEPTACLE WITH IN-USE WEATHERPROOF RUGGED U.V. RESISTANT POLYCARBONATE COVER INSTALLED ON BACK OF POLE AT 15'-0" ABOVE THE BASE OF POLE. RECEPTACLE AND BOX SHALL BE BLACK.
- IO. CONTRACTOR MUST PROVIDE A BREAKAWAY DEVICE, TRANSFORMER BASE WITH 15" DIA. BOLT CIRCLE, FOR ALL PROPOSED LIGHTING UNITS. TRANSFORMER BASE SHALL BE INCLUDED IN PAY ITEM "LIGHT POLE SPECIAL".
- 11. LIGHT POLE SHALL BE LISTED OR CLASSIFIED BY A NATIONALLY RECOGNIZED TESTING LABORATORY SUCH AS UL, ETL. OR EQUIVALENT.
- 12. CONTRACTOR MUST VERIFY ALL INFORMATION, PART NUMBERS, DIMENTIONS, MEASUREMENTS, AND COMPONENTS SHOWN ON THIS SHEET WITH THE VILLAGE OF ORLAND PARK PUBLIC WORKS DEPARTMENT AND THE EQUIPMENT MANUFACTURERS BEFORE ORDERING.


FILE NAME =	USER NAME = Anthony_Plutz	DESIGNED -	MAE	REVISED -
D160M62-SHT-E47.dgn		DRAWN -	WM	REVISED -
	PLOT SCALE = 2.0000000 ' / in.	CHECKED -	DAD	REVISED -
SHT_PLAN	PLOT DATE = 3/13/2013	DATE -	03/13/13	REVISED -

US-45 (Lagrange road)								
Α	LUMINUN	/ LIGHT	POLE,	47	1/2" (14.	478	m) MOUNTING HEIGHT	
SCALE:	NONE	SHEET	1 OF	1	SHEETS	STA.	TO STA.	

	ILLINOIS FE	ED. AI	D PROJECT		
	E-47		CONTRACT	NO. 6	0м62
330	103R-5		COOK	778	371
F.A.P RTE.	SECTION	COUNTY	TOTAL SHEETS	SHEET NO.	

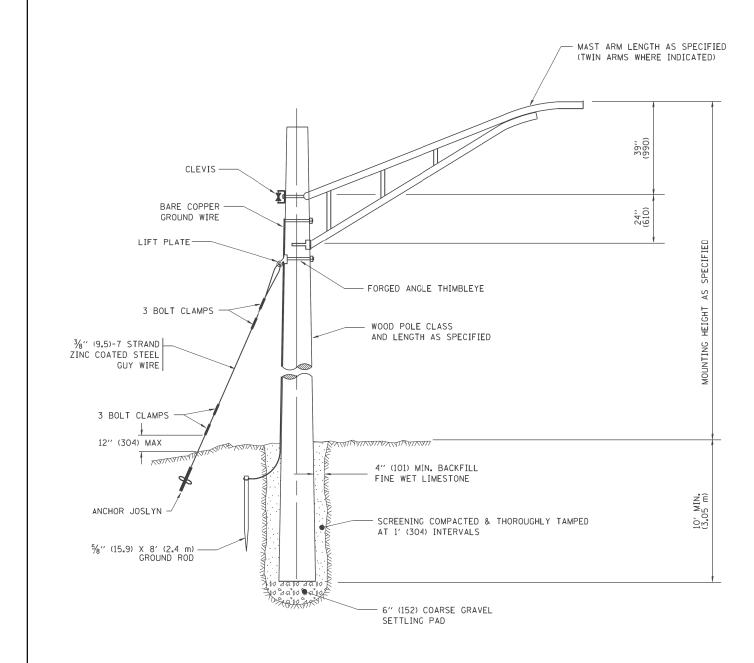

TEMPORARY LIGHT POLE DETAIL

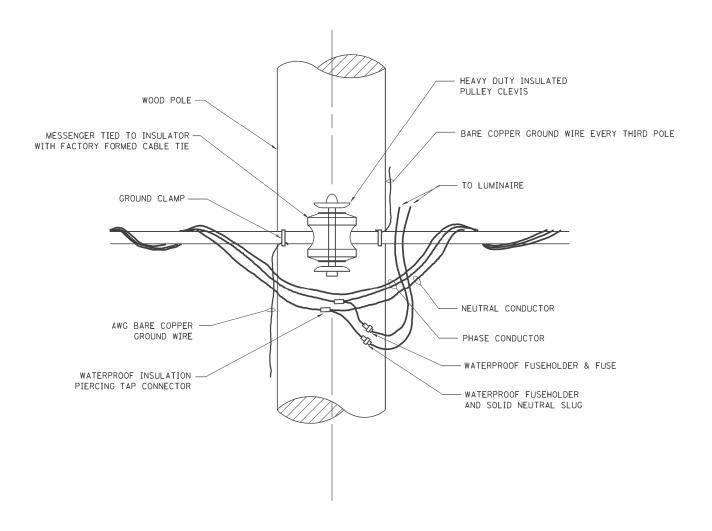

TEMPORARY LIGHT POLE ATTACHMENT DETAIL

NOTES:

1. ALL DIMENSIONS IN INCHES (MILLIMETERS) UNLESS OTHERWISE INDICATED


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	D160M62-SHT-E48.dgn		DRAWN - WM	REVISED -	STATE OF ILLINOIS
		PLOT SCALE = 2.0000000 '/ in.	CHECKED - DAD	REVISED -	DEPARTMENT OF TRANSPORTA
	SHT_PLAN	PLOT DATE = 3/13/2013	DATE - 03/13/13	REVISED -	

ATION		
	SCALE.	NONE

US-45 (Lagrange road) Temporary light pole details					F.A.P RTE.	SECTION	COUNTY	TOTAL SHEETS	SHEET NO.	
					330 103R-5		COOK	778	372	
					E-48 CONTRACT NO. 6				0м62	
SHEET	1 OF	1	SHEETS	STA.	TO STA.	ILLINOIS FED. AID PROJECT				



1/8"

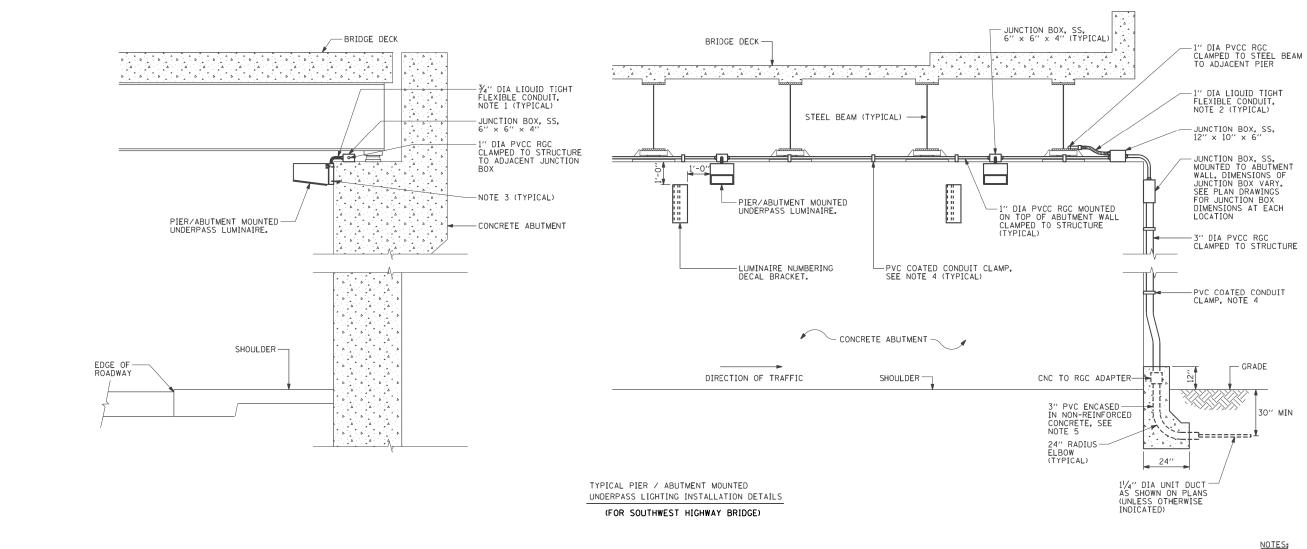

- 1. LIQUID TIGHT FLEXIBLE METAL
 CONDUIT, MAXIMUM LENGTH 6'-0", TYPICAL
 FOR EACH INSTANCE AS SHOWN, PROVIDE PVC
 COATED RIGID GALVANIZED STEEL CONDUIT AS
 REQUIRED NOT TO EXCEED 6'-0" OF FLEXIBLE
 LIQUID TIGHT METAL CONDUIT, LIQUID TIGHT
 FLEXIBLE METAL CONDUIT WILL BE INCLUDED
 IN THE COST OF THE CONDUIT ATTACHED TO
 STRUCTURE, OF THE CORRESPONDING DIA.,
 GALVANIZED STEEL, PVC COATED PAY ITEM
 EXCEPT THAT THE COST OF THE 3'4" DIA.
 RIGID STEEL CONDUIT AND 3'4" DIA. FLEXIBLE
 CONDUIT SHALL BE INCLUDED IN THE LUMINAIRE
 INSTALLATION.
- 2. UNDERPASS LUMINAIRE MOUNTED TO FACE OF PIER OR ABUTMENT WALL. MOUNTING HEIGHT OF 1" BELOW THE TOP OF PIER OR ABUTMENT WALL TYPICAL FOR ALL PIER/ABUTMENT MOUNTED UNDERPASS LUMINAIRES UNLESS OTHERWISE NOTED.
- 3. EXPANSION ANCHOR, POWDER ACTUATED FASTENERS WILL NOT BE ALLOWED. EXPANSION ANCHOR MUST BE SIZED IN ACCORDANCE WITH MANUFACTURERS REQUIREMENTS.
- 4. SECURE THE CONDUIT WITH PVC COATED CONDUIT CLAMPS OR CONDUIT BEAM CLAMPS AS SHOWN AT 5'-O" INTERVALS FOR LATERALS AND WITHIN 2'-O" MAXIMUM FROM ANY JUNCTION BOX, FLEXIBLE CONDUIT, OR CHANGE IN DIRECTION, ALL PVC COATED CONDUIT CLAMPS OR BEAM CLAMPS SHALL BE INCLUDED WITH THE COST OF THE "CONDUIT ATTACHED TO STRUCTURE, OF THE CORRESPONDING DIA., GALVANIZED STEEL, PVC COATED" PAY ITEM.
- 5. THE CONCRETE ENCASED CONDUIT TRANSITION SHALL BE INCLUDED IN THE COST OF THE GALVANIZED RIGID STEEL CONDUIT PAY ITEMS.
- 6. ALL CONDUIT ATTACHED TO STRUCTURE SHALL BE PVC COATED RIGID STEEL CONDUIT (PVCC RGC) TYPICAL.





NOT TO SCALE

NOT TO SCALE

STATE OF ILLINOIS

DEPARTMENT OF TRANSPORTATION

			US-45 (LAGRANGE ROAD)							
		PIER /P	BUTME	NT	MOUNT	ED (JNDERPA:			
		LUM	INAIRE	INS	TALLAT	ION	DETAILS			
SCALE:	NONE	SHEET	1 OF	1	SHEETS	STA.				

F.A.P RTE.	SECTION	COUNTY	TOTAL SHEETS	SHEET NO.
330	103R-5	COOK	778	373
	E-49	CONTRACT	NO. 6	OM62

ILLINOIS FED. AID PROJECT

USER NAME = Anthony_Plutz	DESIGNED -	MAL	REVISED -	
	DRAWN -	WM	REVISED -	
PLOT SCALE = 2.0000 '/ in.	CHECKED -	DAD	REVISED -	
PLOT DATE = 3/13/2013	DATE -	03/13/13	REVISED -	

ELEVATION

L1" (TYPICAL)

HEXAGON HEAD BOLT 1/4" DIA (3-REQUIRED)

ANCHOR AS APPROVED BY ENGINEER

ALUMINUM BUSHING 1/2" LONG ALUMINUM BRACKET


LUMINAIRE NUMBERING DECAL BRACKET

NOT TO SCALE

ASS TO STA.

160M62-SHT-E49.dgr

PANEL EQUIPMENT

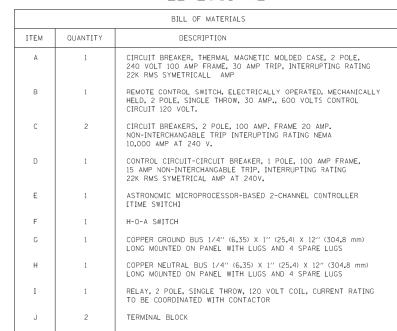

CKT TYPICAL LIGHTING LAYOUT

(NOT TO SCALE)

POLE WIRING DETAIL

(NOT TO SCALE)

STANDARD-TYPE SMALL DIMENSION DOUBLE POLE


(SEE SPECS)


- CABLE SPLICE (TYP.)

PHASE CONDUCTORS, 600 V TYPE RHW

SOLID COLOR, SIZE AS SPECIFIED (TYP.)

FUSEHOLDER WITH INSULATED BOOTS, FUSING AND

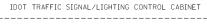

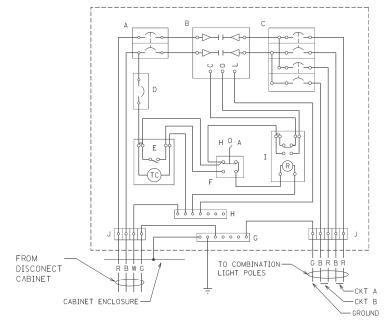

2-1/C #10 AWG, 600 V TYPE RHW, SOLID COLOR CODED CABLES

SPLICE GROUND WIRE AND PIGTAIL SAME SIZE -EXTENSION TO POLE GROUNDING LUG

INSULATED GROUND WIRE, 600 V TYPE RHW, SOLID COLOR GREEN, SIZE AS SPECIFIED


GROUNDING LUG -

UNIT DUCT (TYP)



NOTES:

- ALL WIRING RELATED TO THE LIGHTIGN CONTROLS SHALL BE *10 AWG, 600V, TYPE SWITCH BOARD WIRE, STRANDED COPPER.
- 2. PROVIDE SEALING GROMMETS FOR ALL OPEN WIRING EXTENDED FROM DEVICES IN BOXES OR CABINETS WITHIN THE ENCLOSURE.
- 3. ALL WIRING SHALL BE NEATLY DRESSED, IDENTIFIED BY TAGS, AND SUPPORTED.
- 4. ALL SPLICES AND CONNECTIONS FOR ROADWAY LIGHTING SHALL BE AT POLE BASE ONLY. UNDERGROUND SPLICING OF LIGHTING CONDUCTORS IS NOT PERMITTED.
- THE COMBINATION POLE LIGHTING CABLING DETAIL IS INTENDED TO SHOW CONNECTIONS ONLY, FOR FURTHER INFORMATION ON THE COMBINATION LIGHT POLE, THE TRAFFIC SIGNAL CONTROL CABINET, AND THE SERVICE DISCONNECT BOX REFER TO THE RESPECTIVE DETAIL DRAWINGS.
- 6. COMBINATION LIGHTING SHALL BE TIMED TO ENERGIZE 20 MINUTES PRIOR TO DUSK AND SHALL BE TIMED TO DE-ENERGIZE 20 MINUTES AFTER TO DAWN.
- 7. COMBINATION LIGHTING CONTROLLER AND ALL COMBINATION POLES SHALL HAVE IDOT DESIGNATIONS AND IDOT LABELS. LIGHTING CONTROLER DESIGNATIONS SHALL BE COORDINATED WITH THE BUREAU OF TRAFFIC LIGHTING SECTION.

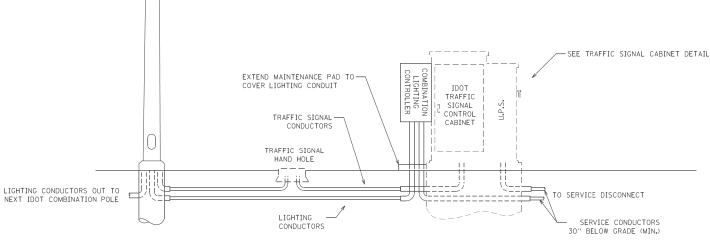

COMBINATION POLE LIGHTING CABLING - TYPICAL

(NOT TO SCALE)

FILE NAME =	USER NAME = Anthony_Plutz	DESIGNED - MAE	REVISED -
D160M62-SHT-E50.dgn		DRAWN - WM	REVISED -
	PLOT SCALE = 2.0000000 '/ in.	CHECKED - DAD	REVISED -
SHT_PLAN	PLOT DATE = 3/13/2013	DATE - 03/13/13	REVISED -

COMBINATION LIGHTING CONTROLLER WIRING DIAGRAM

(NOT TO SCALE)

STATE OF ILLINOIS **DEPARTMENT OF TRANSPORTATION**


US-45 (LaGRANGE ROAD)	F.A.P RTE.	SECTION	COUNTY	TOTAL SHEETS	SHEET NO.
COMBINATION LIGHTING CONTROLLER	330	103R-5	соок	778	374
		E-50	CONTRACT	NO. 6	OM62
SCALE: NONE SHEET 1 OF 1 SHEETS STA. TO STA.		ILLINOIS FED. A	ID PROJECT		

FOUNDATION DESIGN TABLE

			DESIGN 1						
	DESIGN DEPTH (F FOUNDATION	REINFORCEMENT IN FOUNDATION						
TYPE OF SOIL	SINGLE ARM	TWIN ARM	SINGLE	ARM	TWIN ARM				
	D	D	VERT BARS	SPIRAL	VERT BARS	SPIRAL			
SOFT CLAY	13'-0'' (3 . 962 m)	15'-0'' (4 . 572 m)	8-#6X12'-6'' (3.810 m)	#3X122′ (37.186 m)	8-#6X14'-3'' (4.343 m)	#3X141′ (42.977 m)			
MEDIUM CLAY	9'-6'' (2.896 m)	10′-9′′ (3 . 277 m)	8-#6X9'-0'' (2.743 m)	#3X90′ (27.432 m)	8-#6X10'-0'' (3.048 m)	#3X100′ (30.480 m)			
STIFF CLAY	7'-0'' (2 . 134 m)	8'-0'' (2.438 m)	8-#6X6'-6'' (1.981 m)	#3X66′ (20 . 112 m)	8-#6X7'-6'' (2.286 m)	#3X76′ (23 . 165 m)			
LOOSE SAND	9'-0'' (2.743 m)	10'-0'' (3.048 m)	8-#6X8'-6'' (2.591 m)	#3X85′ (25.908 m)	8-#6X9'-6'' (2.896 m)	#3X94 ⁴ (28.651 m)			
MEDIUM SAND	8′-3′′ (2 . 515 m)	9'-0'' (2.743 m)	8-#6X8'-0'' (2.438 m)	#3X78′ (23.774 m)	8-#6X8'-6'' (2.591 m)	#3X85′ (25.908 m)			
DENSE SAND	SAND 7'-9" 9'-0" (2.743 m)		8-#6X7'-6'' (2.286 m)	#3X73′ (22.250 m)	8-#6X8'-6'' (2.591 m)	#3X85′ (25.908 m)			
ROCK OR SOLIDIFIED SLAG	5′-0′′ (1.524 m)	5′-0′′ (1.524 m)	NONE	NONE	NONE	NONE			

NOTES

- 1. ALL DIMENSIONS ARE IN INCHES (MILLIMETERS) UNLESS OTHERWISE SHOWN.
- 2. THE ENGINEER SHALL DETERMINE THE CLASS OF SOIL DURING EXCAVATION AND SELECT THE DESIGN DEPTH OF FOUNDATION FROM THE DESIGN TABLE.
- 3. EXCAVATION OF THE POLE FOUNDATION SHALL BE MADE WITH AN AUGER, 24" (609.6 mm) OR 30" (762.0 mm) IN DIAMETER.
- 4. THE ANCHOR ROD SHALL BE A HOOK ROD TYPE. COLD BENDING OF THE ANCHOR ROD WILL NOT BE ALLOWED. THE RADIUS OF THE HOOK BEND SHALL NOT BE LESS THAN 4 TIMES THE NOMINAL DIAMETER OF THE ANCHOR ROD. A TACK WELDED ANCHOR ROD MAY BE SUBSTITUTED WITH THE APPROVAL OF THE ENGINEER.
- 5. THE ANCHOR BOLTS AND RACEWAYS SHALL BE PROPERLY SECURED IN PLACE BEFORE THE CONCRETE IS PLACED IN THE FORM.
- 6. THE ANCHOR RODS SHALL BE ACCORDING TO ASTM F1554 GRADE 725 (GRADE 105). NUTS SHALL BE HEXAGON NUTS ACCORDING TO ASTM A 194 2H OR ASTM A 563 DH, AND WASHERS SHALL BE ACCORDING TO ASTM F 436.
- 7. THE CONTRACTOR SHALL COORDINATE EXTENSION OF ANCHOR BOLTS ABOVE TOP OF FOUNDATION WITH THE BREAKAWAY DEVICE MANUFACTURER'S REQUIREMENTS. IF LIGHT POLE IS MOUNTED WITHOUT BREAKAWAY DEVICE, ANCHOR BOLTS SHALL PROJECT 2¾4" (69.9 mm) ABOVE TOP OF THE FOUNDATION. THE CONTRACTOR SHALL CONFIRM ANCHOR BOLT EXTENTION WITH ENGINEER.
- 8. RACEWAYS SHALL PROJECT 1" (25.4 mm) ABOVE THE TOP OF THE FOUNDATION.
- 9. THE CABLE TRENCH SHALL BE BACKFILLED AND FIRMLY COMPACTED BEFORE THE LIGHT IS ERECTED.

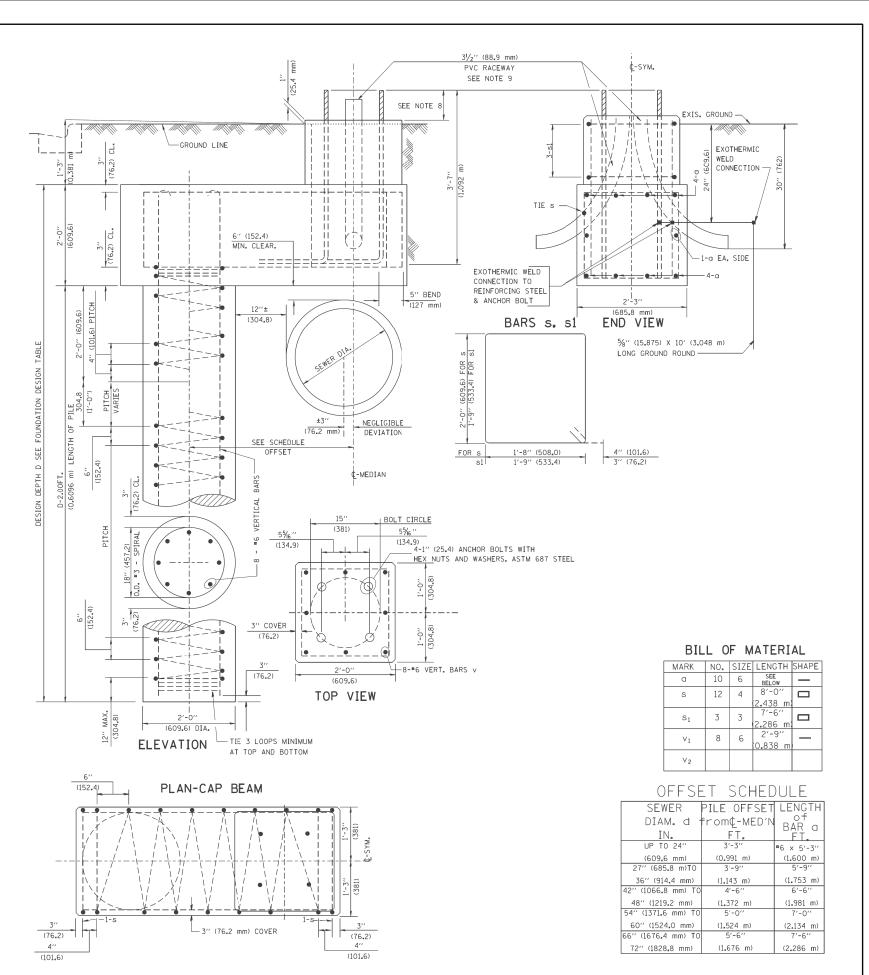




LE NAME =	USER NAME = Anthony_Plutz	DESIGNED -	MAE	REVISED -
60M62-SHT-E51.dgn		DRAWN -	WM	REVISED -
	PLOT SCALE = 2.0000000 '/ in.	CHECKED -	DAD	REVISED -
HT_PLAN	PLOT DATE = 3/13/2013	DATE -	03/13/13	REVISED -

STATE OF ILLINOIS
DEPARTMENT OF TRANSPORTATION

									F.A.P RTE.		
	LIGHT POLE FOUNDATION OFFSET										
	40' (12.192 m) TO 47 1/2' (14.478m) M.H.										
	15" (381 mm) BOLT CIRCLE									E.	
SCALE:	NONE	SHEET	1	OF.	1	SHEETS	STA.	TO STA.			

F.A.P RTE.	SECT		COUNTY	TOTAL SHEET	- S	SHEE		
330	1038		COOK	778		375		
	E-51	Т	CONTRACT	NO.	6	ом62		
		ILLINOIS	FED.	ΑI	D PROJECT			

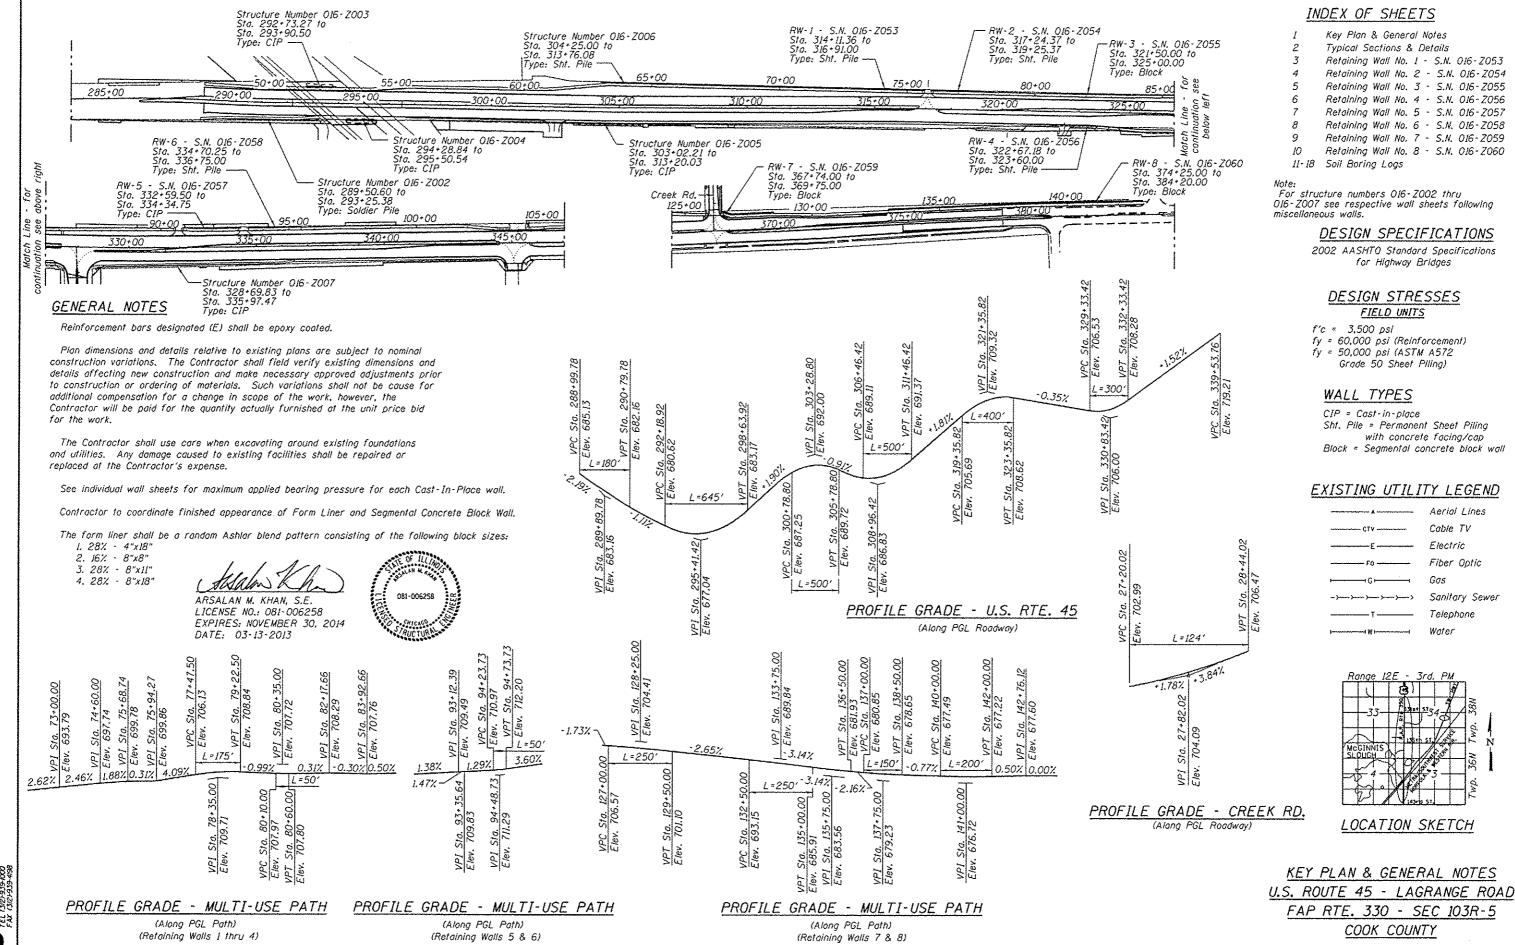

8 255 S


160M62-SHT-WALLS CENERAL NOTES.dgn

DESIGNED - MJL USER NAME = Kyle.Pearl REVISED CHECKED - PMH REVISED -PLOT SCALE = 375,00 1/ 10. DRAWN MJL REVISED 91 DT DATE : 3/15/2013 CHECKED - PMH REVISED


STATE OF ILLINOIS DEPARTMENT OF TRANSPORTATION

COUNTY TOTAL SHEE SHEETS NO. RTE. SECTION 330 103R-5 COOK 778 376 CONTRACT NO. 60M62 ILLINOIS FFD. AID PROJECT

SHEET NO. 1 OF 18 SHEETS

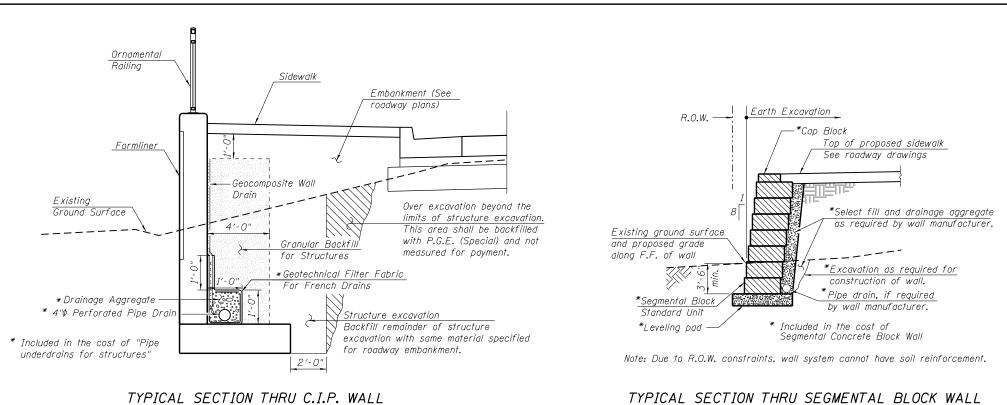

TYPICAL SECTION THRU SEGMENTAL BLOCK WALL

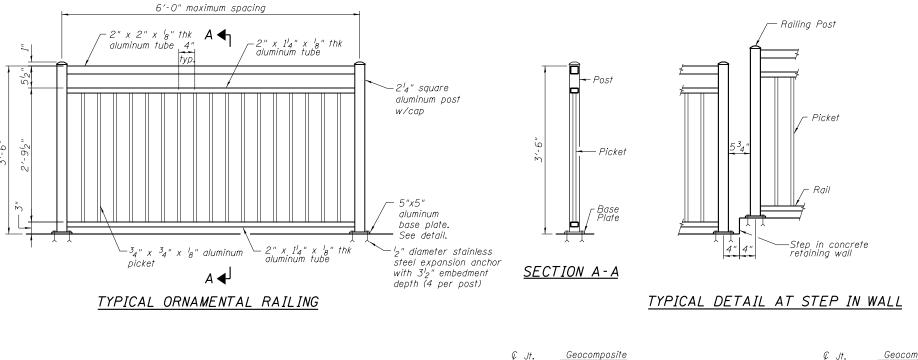

Front face of wall-

REVISED

REVISED

REVISED


REVISED

1" Chamfer

9₁₆ "Ø holes (tvp.,

€ post & P

BASE PLATE DETAIL

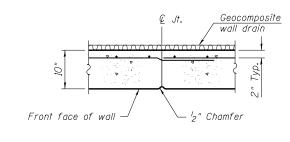

EXPANSION JOINT DETAILS

Vertical

wall drain


-Concrete nails flat head

C.S.I. 1" at 12" centers


^l₂" Preformed joint filler with 6"

non-metallic waterstop

CONSTRUCTION JOINT DETAILS

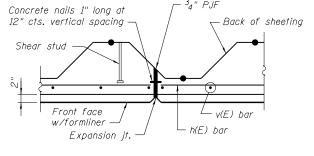

PLAN SECTION THROUGH SHEET PILE WALL AT EXPANSION JOINT

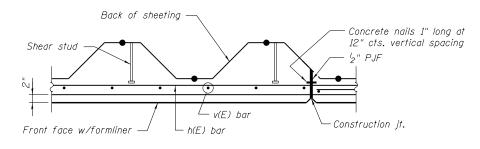

All outlets for drainage system components shall be determined in the field

2'-0" from the end of each wall, extend until intersecting with the side slopes

by the contractor and approved by the Engineer. They shall either extend

or outlet through a core drilled hole at low point of wall. The pipes shall drain into concrete headwalls if extended to side slopes. (See Article 601.05 of the Standard Specifications and Highway Standard 601101). Cost of outlets


inlcuded in the cost of pipe underdrains for structures.


PLAN SECTION THROUGH SHEET PILE WALL AT CONSTRUCTION JOINT

FILE NAME =	USER NAME = Anthony_Plutz	DESIGNED -
D160M62-SHT-Wall_Details.dgn		CHECKED -
	PLOT SCALE = 2:0.0000 ':' / in.	DRAWN -
	PLOT DATE = 3/13/2013	CHECKED -

STATE OF ILLINOIS **DEPARTMENT OF TRANSPORTATION**

SECTION COUNTY **RETAINING WALL** 330 103R-5 COOK 778 377 **TYPICAL SECTIONS & DETAILS** CONTRACT NO. 60M62 SHEET NO. 2 OF 18 SHEETS

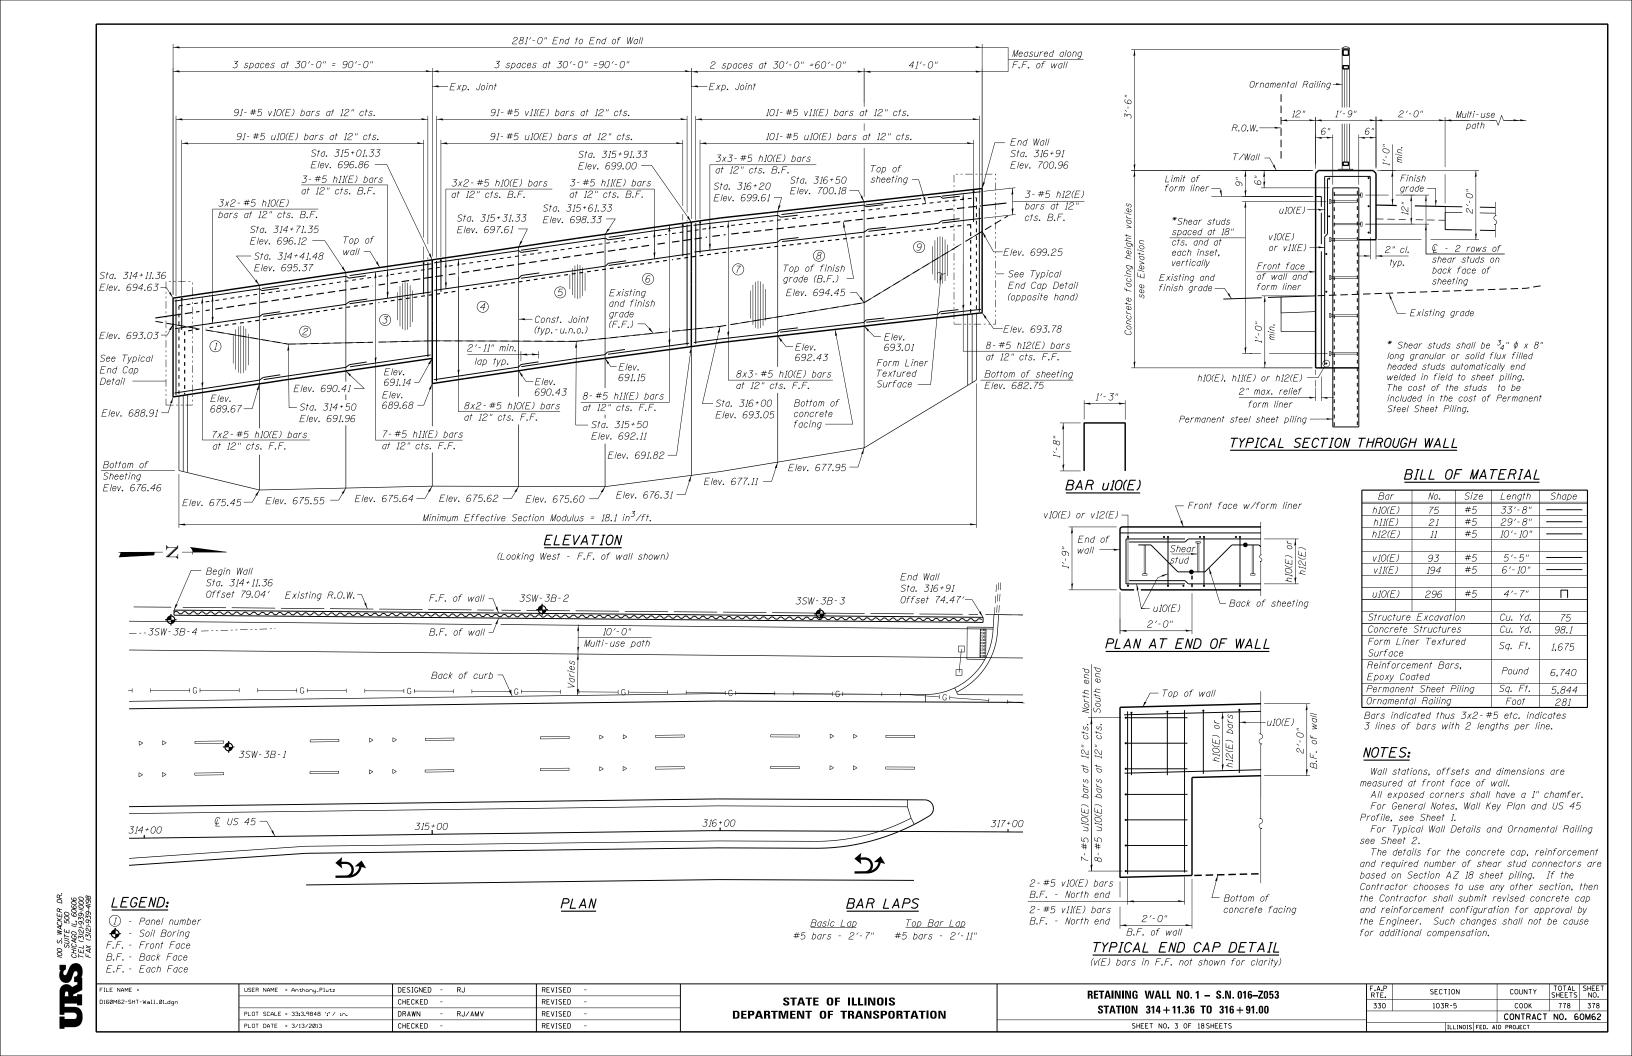

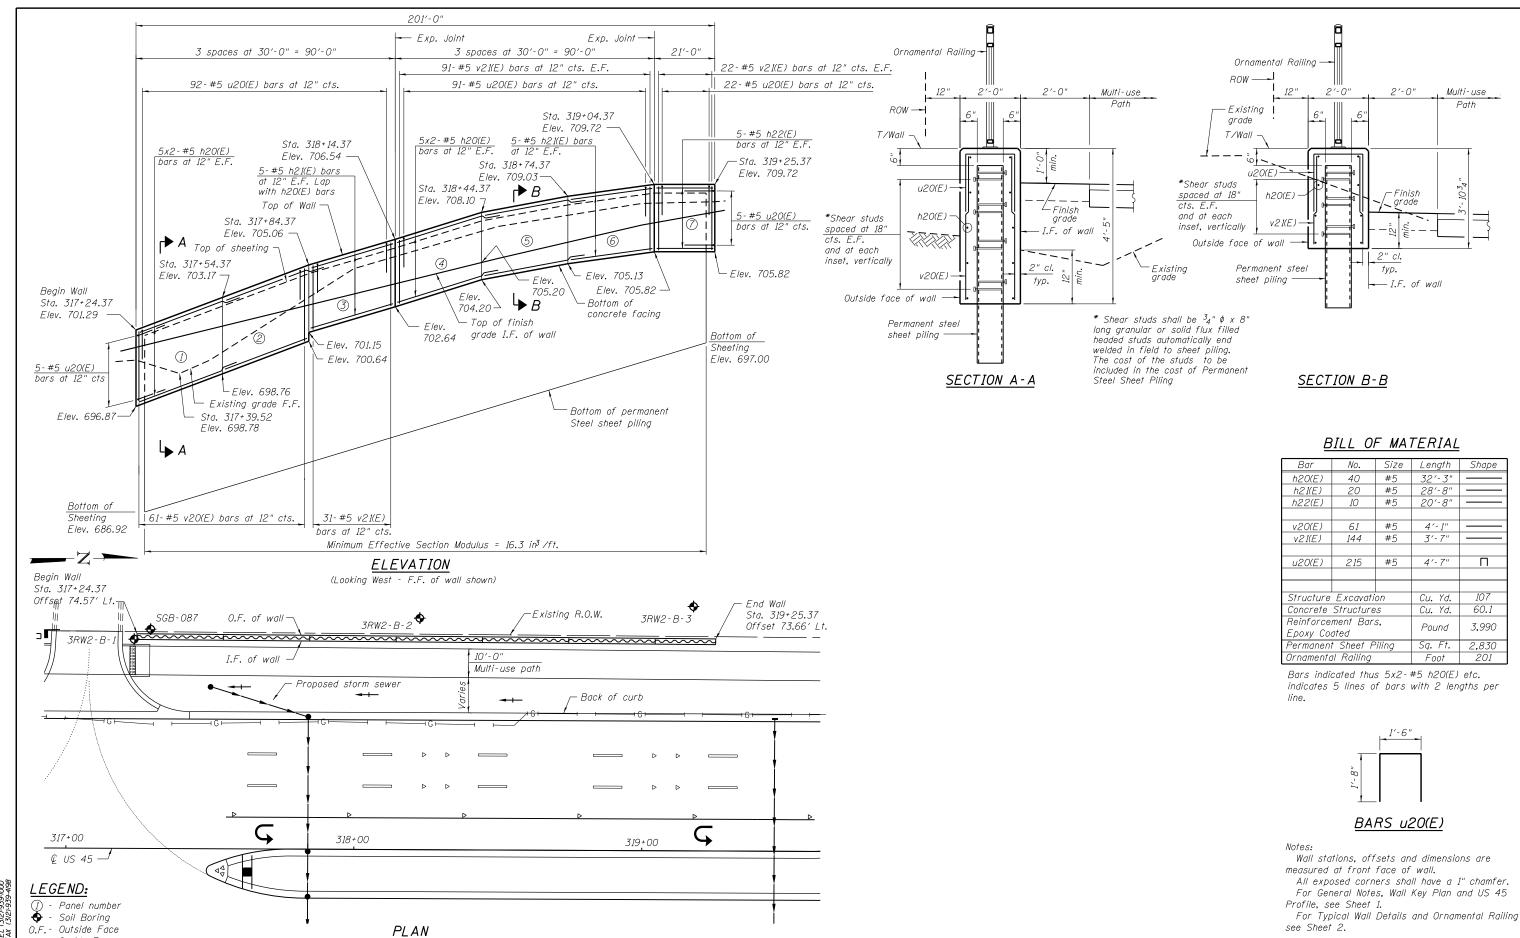

I.F. - Inside Face E.F.- Each Face

160M62-SHT-Wall_02.dan

USER NAME = Anthony_Plutz

PLOT SCALE = 33.3321 ' / in.

PLOT DATE = 3/13/2013

DESIGNED - RJ

CHECKED

DRAWN

CHECKED

REVISED

REVISED

REVISED

REVISED

ILE NAME =

STATE OF ILLINOIS **DEPARTMENT OF TRANSPORTATION** RETAINING WALL NO. 2 - S.N. 016-Z054 STATION 317 + 24.37 TO 319 + 25.37 SHEET NO. 4 OF 18 SHEETS

SECTION COUNTY 330 103R-5 COOK 778 379 CONTRACT NO. 60M62

Multi-use_

Path

32′-3"

20′-8"

3′-7"

4'-7"


Cu. Yd.


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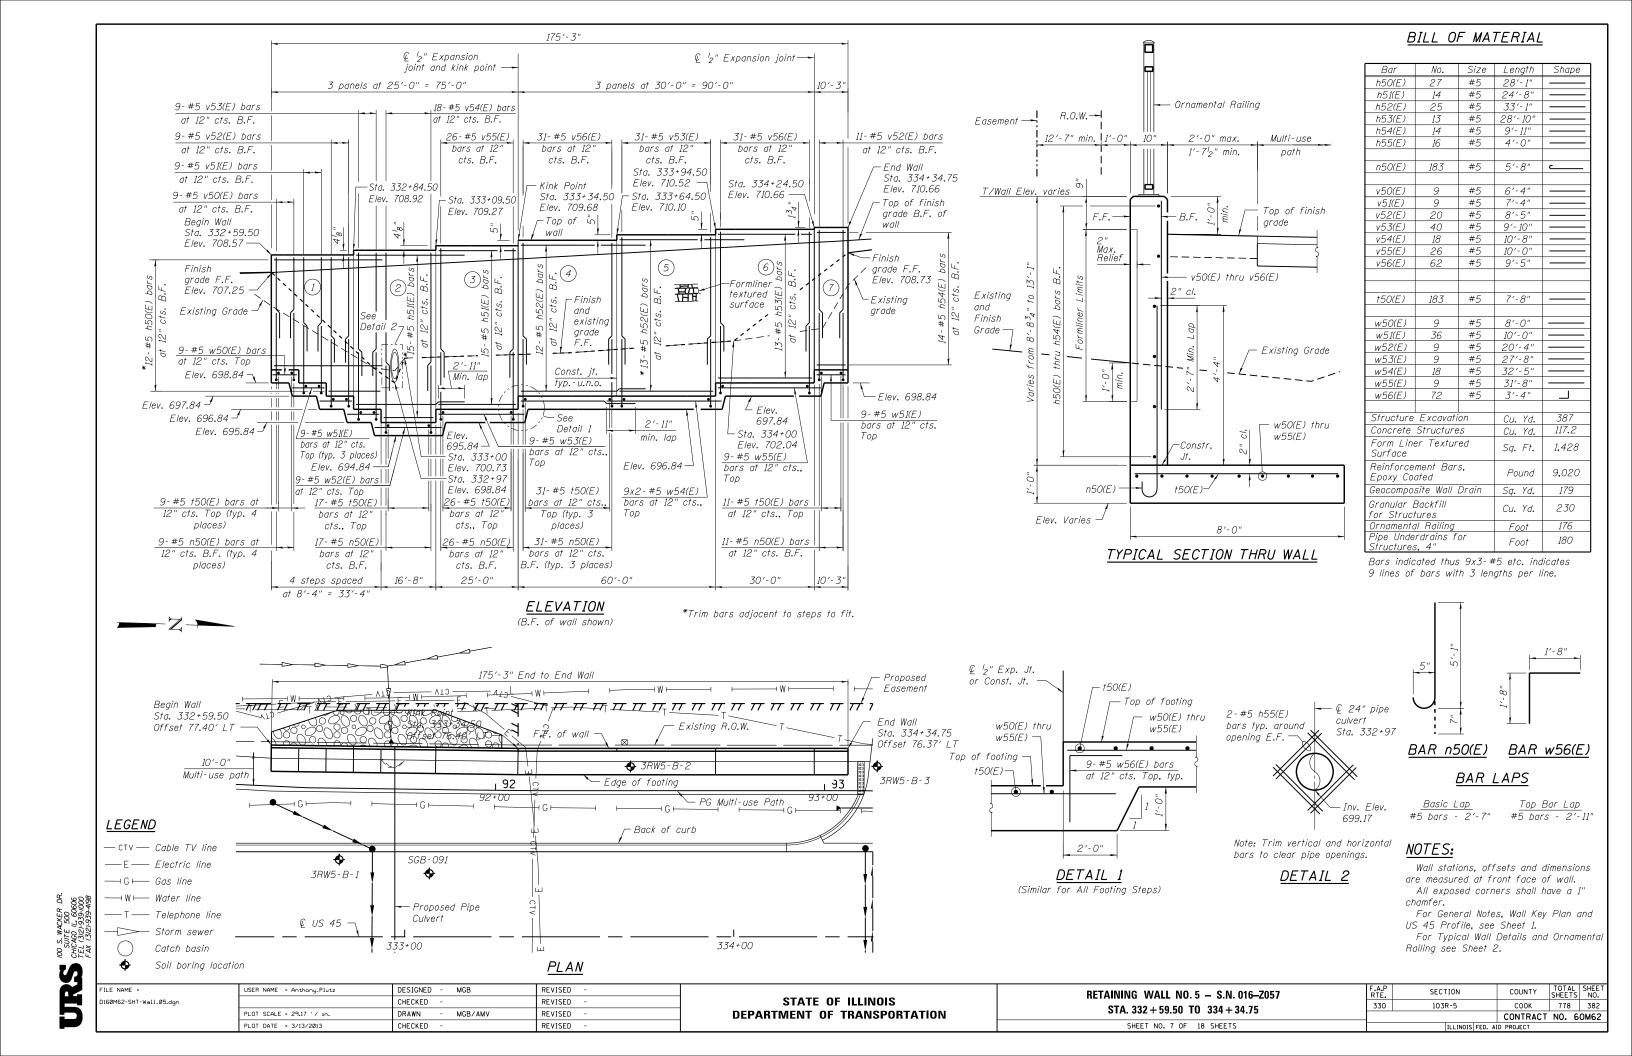
Pound


60.1


3,990



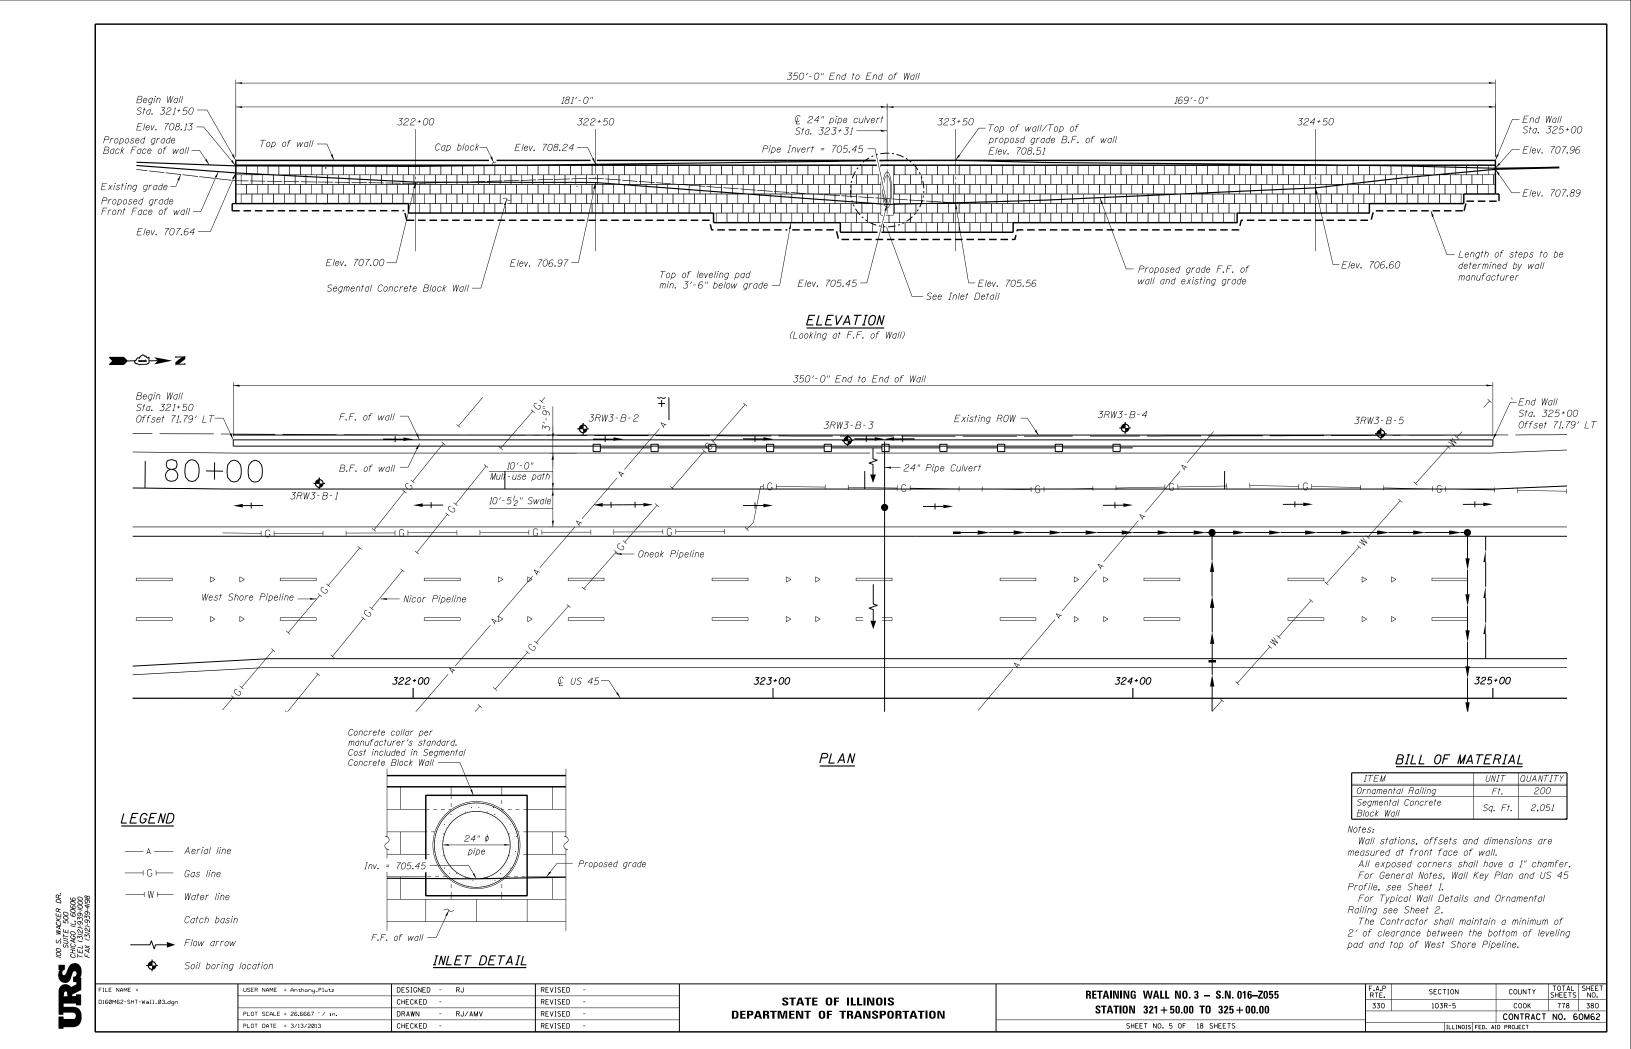

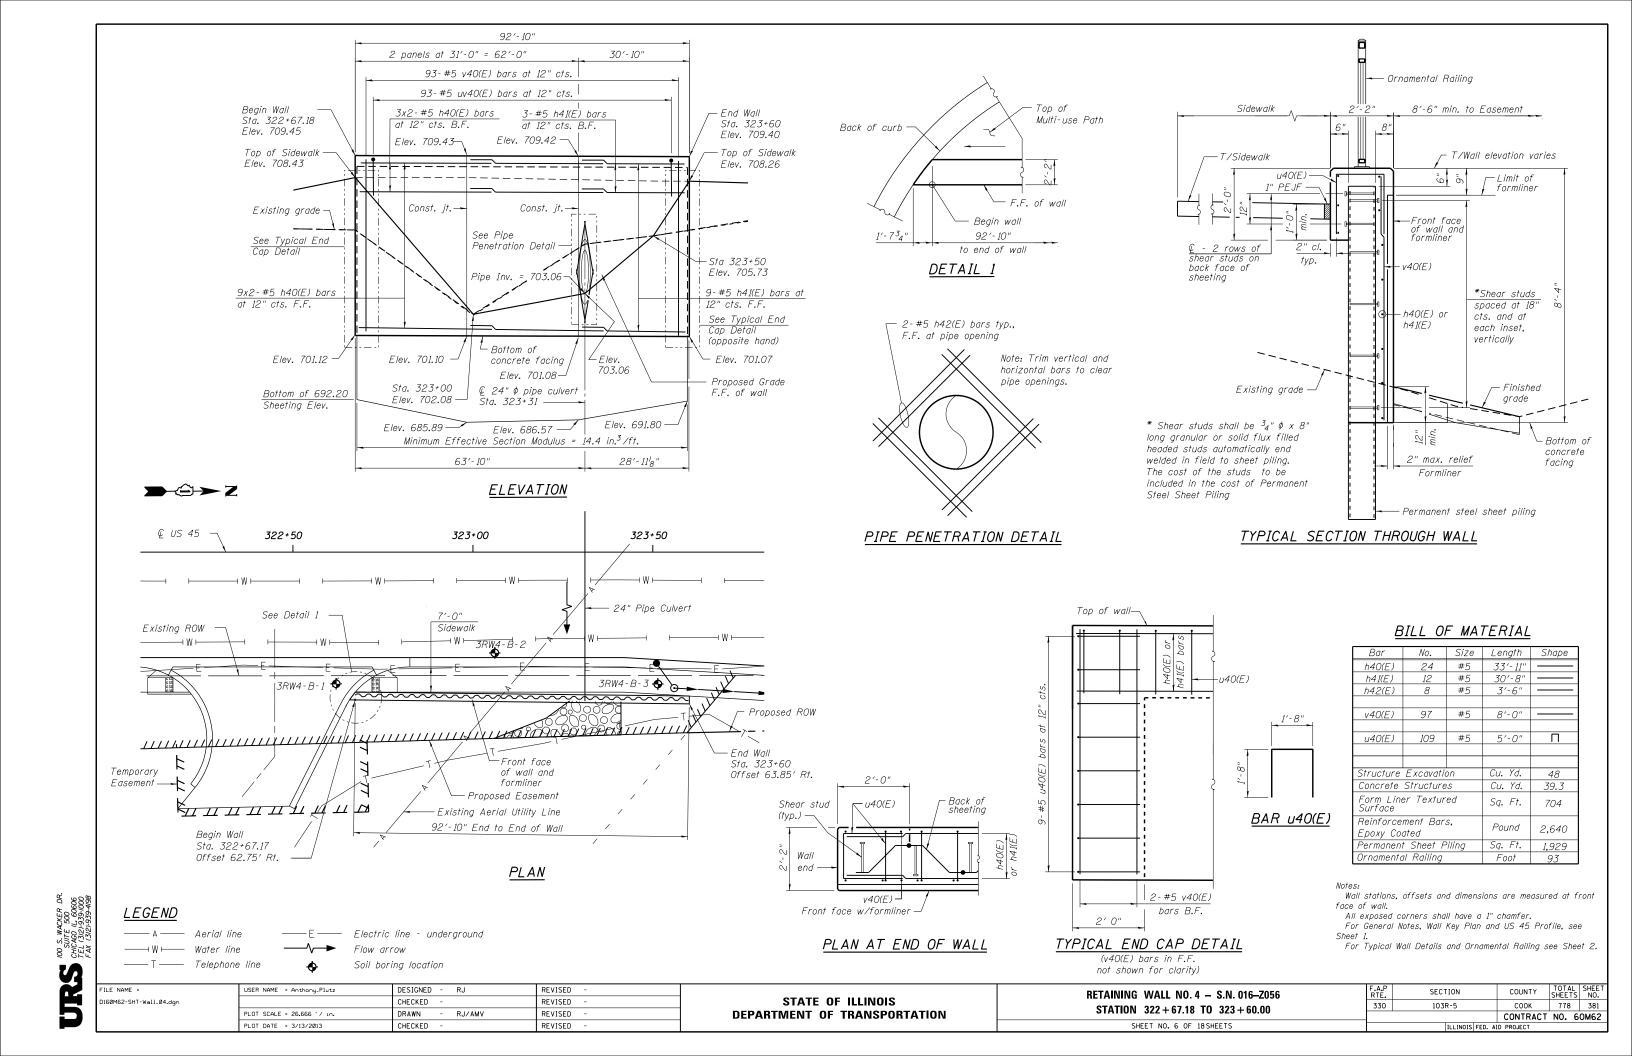

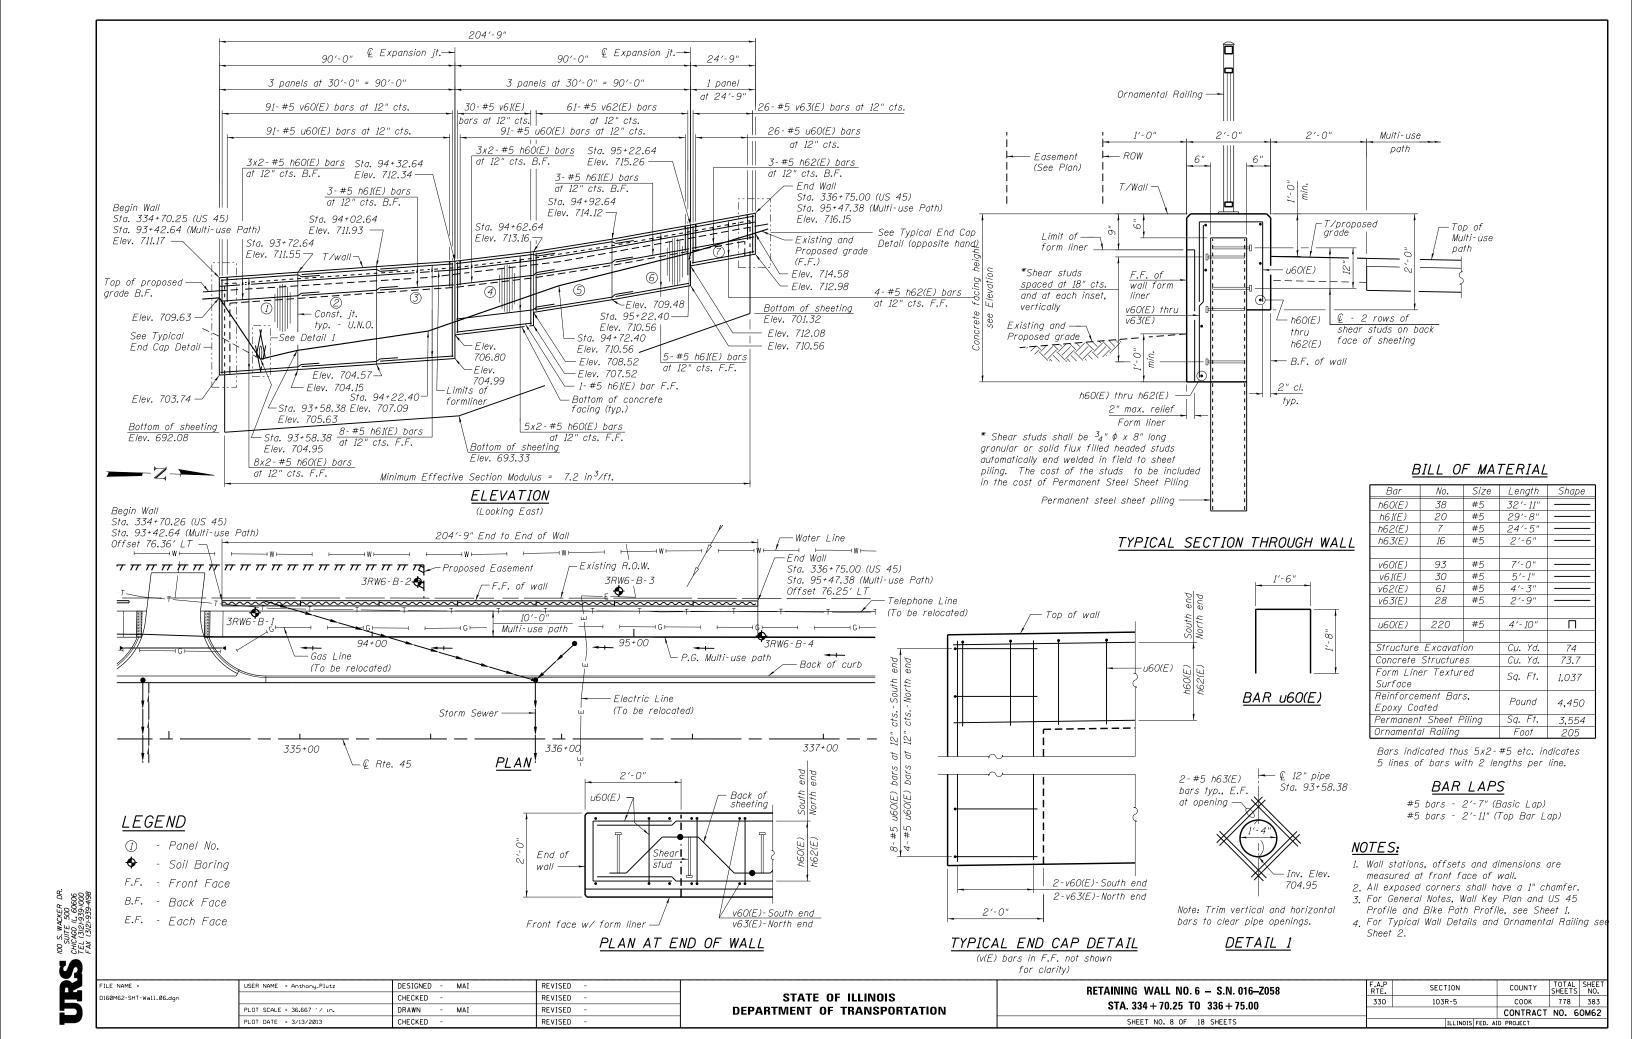

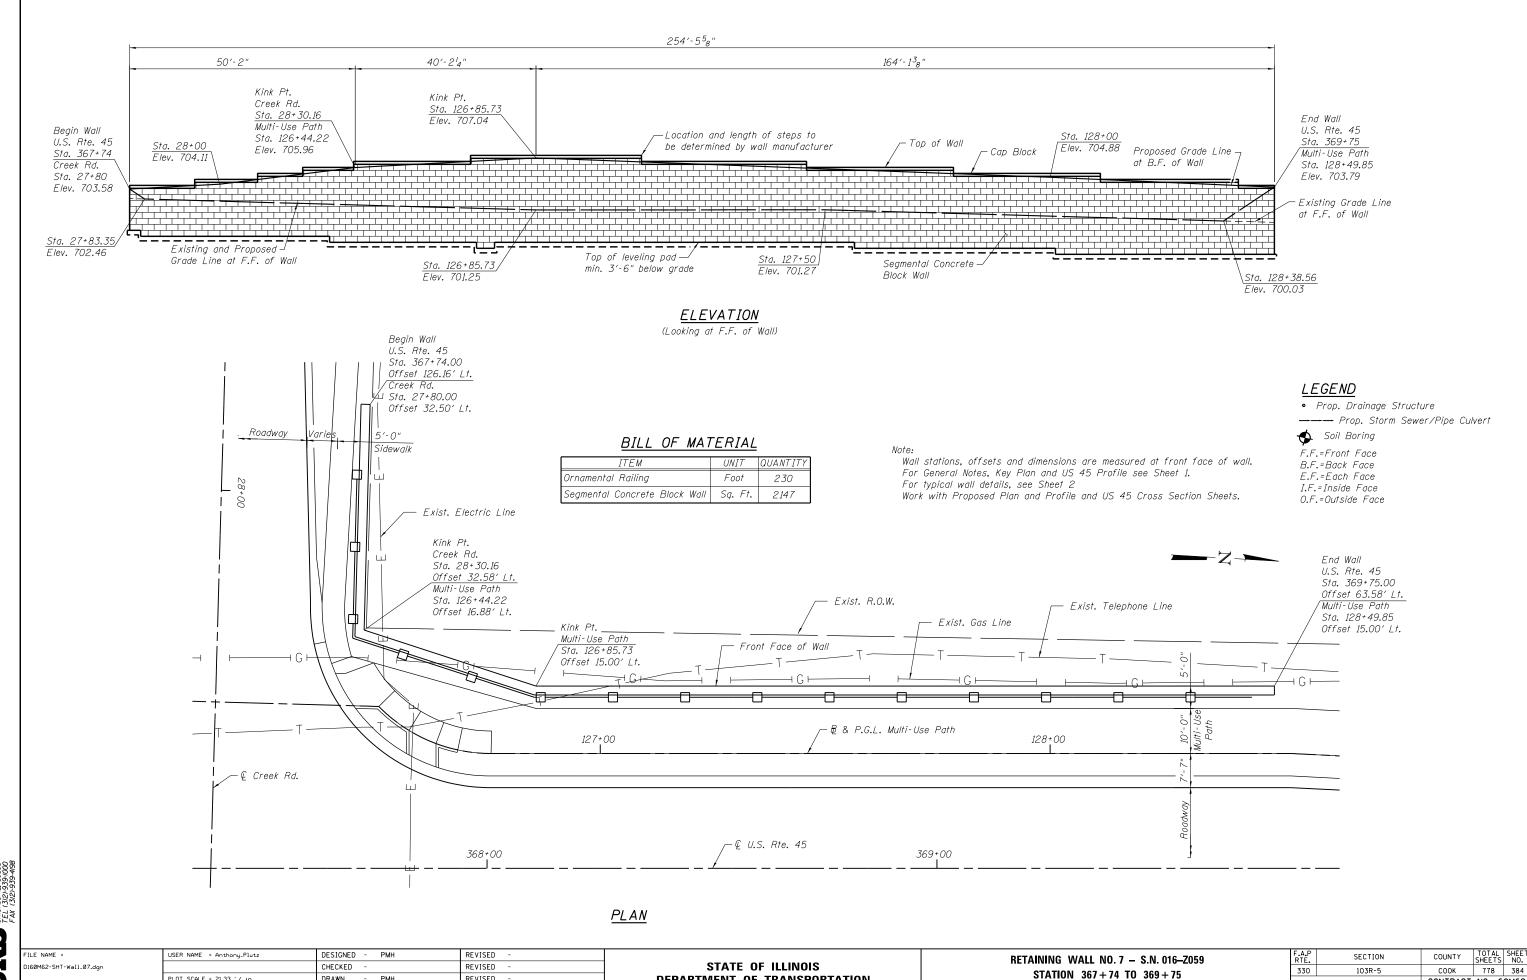

DEPARTMENT OF TRANSPORTATION

SHEET NO. 9 OF 18 SHEETS


CONTRACT NO. 60M62

REVISED

REVISED

PLOT DATE = 3/13/2013

CHECKED

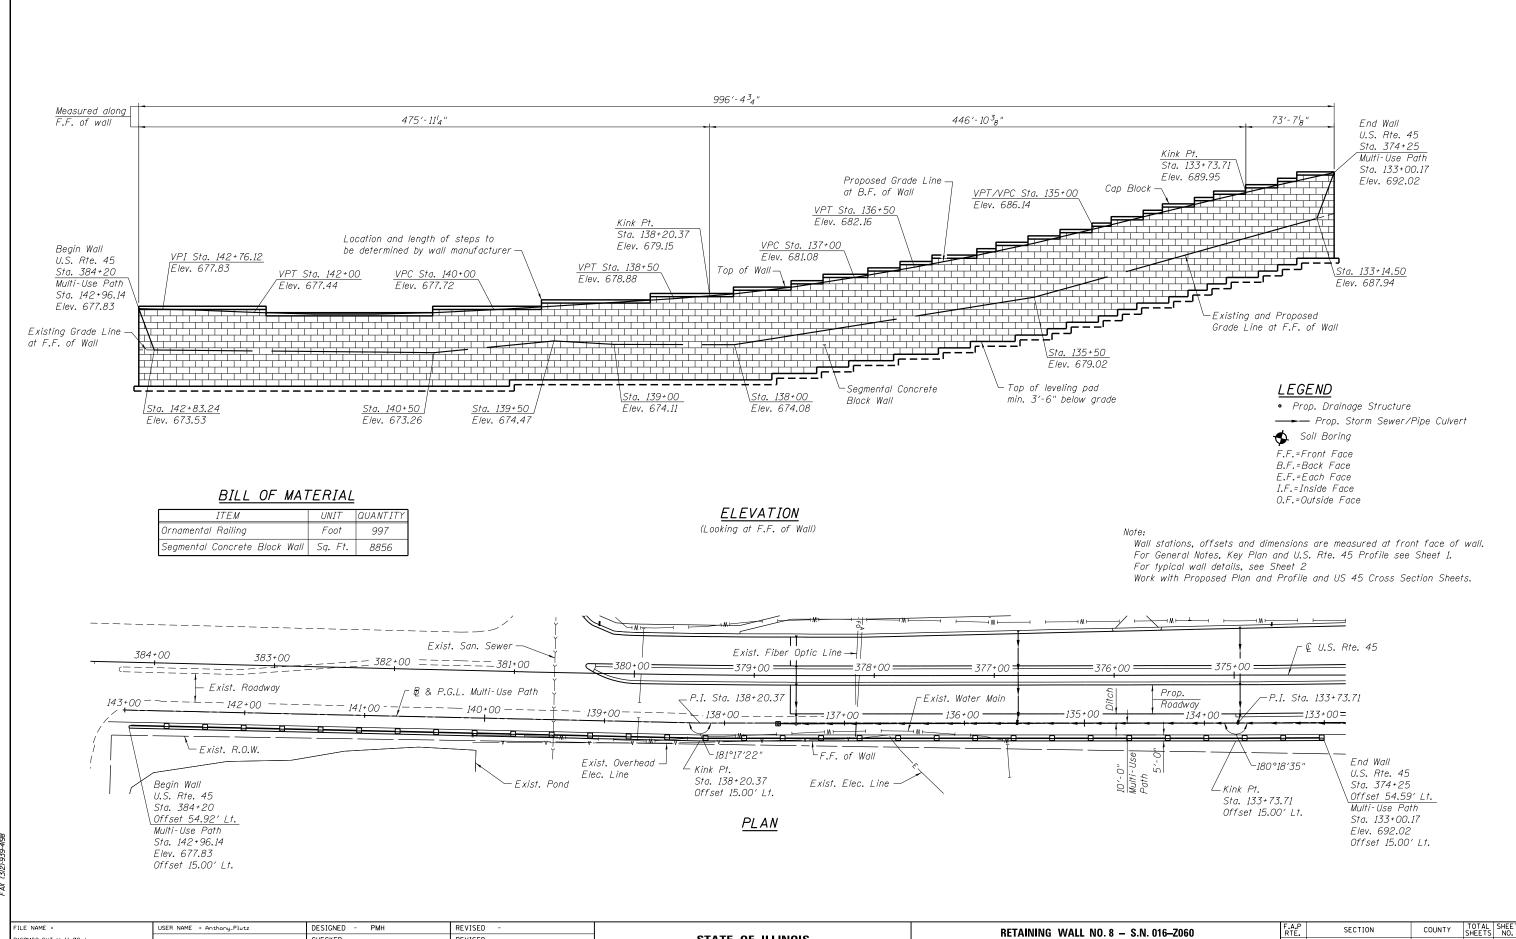

STATE OF ILLINOIS

DEPARTMENT OF TRANSPORTATION

SECTION

103R-5

330

RETAINING WALL NO. 8 - S.N. 016-Z060

STATION 374+25 TO 384+20

SHEET NO. 10 OF 18 SHEETS

COUNTY

COOK 778 385

CONTRACT NO. 60M62

160M62-SHT-Wall_08.dgn

CHECKED


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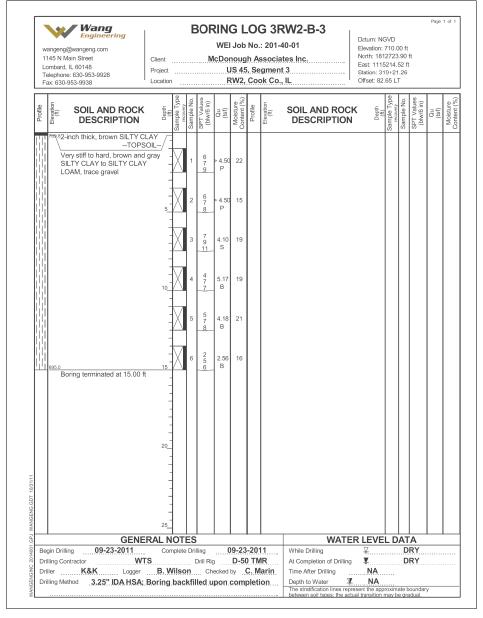
REVISED

REVISED

REVISED

1 Li	Wang Engineering vangang@wangeng.com 145 N Main Street combard, IL. 60148 elepnone: 630-953-9928 ax: 630-953-9938	Client Project Location		M	WEI lcDoi	Job noug	No. h As	: 201-4 ssocia gment	RW2-B-1 40-01 tes Inc. t 3	Datum: N Elevation North: 18 East: 111 Station: 3 Offset: 72	599. 12526 5223 17+2	39 ft 3.42	ft	Page	1 of
Profile	SOIL AND ROCE DESCRIPTION		Sample No.	SPT Values (blw/6 in)	Qu (tsf)	Moisture Content (%)	Profile	Elevation (ft)	SOIL AND ROC DESCRIPTION	K Depth	Sample Type	Sample No.	SPT Values (blw/6 in)	Qu (tsf)	Moisture
	699,23-inch thick, brown SILTYTOF Stiff to hard, brown and gr SILTY CLAY to SILTY CL/ LOAM, trace gravel	CLAY SOIL	1	5 6 8	3.77 B	20									
	207 till, 8400 grafo	5	2	3 7 7	> 4.50 P	17									
			3	5 6 7	3.94 B	22									
		10	4	4 6 7	3.44 B	19									
			5	4 5 6	2.74 B	18									
	9844 Boring terminated at 15.00	15 ft _	6	2 3 5	1.64 B	17									
		-													
1000111		20													
NAMOGENOSOS	051	25_							MATE	R LEVE					
Be Dr Dr	egin Drilling 09-23-2011 illing Contractor V iller K&K Logge illing Method 3.25" IDA HSA	/TS B. Wilso	Drill D	rill Rig Ch	 ecked	D-5 0	D TN	IR arin	While Drilling At Completion of Drilling	<u>⊽</u> NA		D D	RY RY		



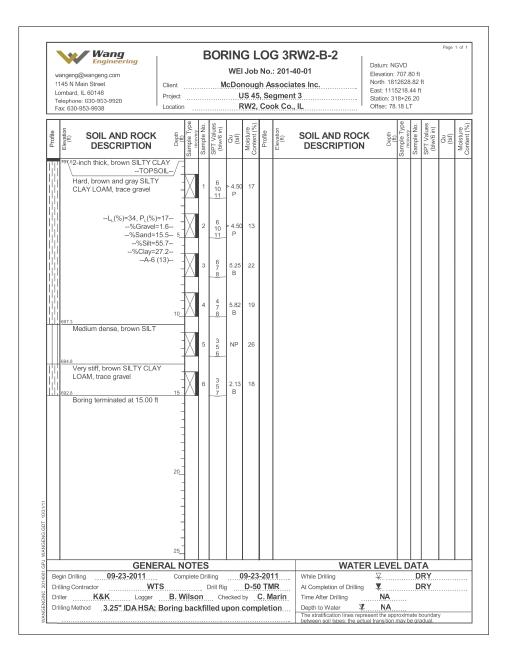

For retaining wall key plan see sheet 1.
For typical wall details see sheet 2.


See individual wall sheets for boring locations.


D160M62-SHT-Boring01.dgn


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	CHECKED - JCE	REVISED -
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PLOT DATE = 3/13/2013	CHECKED -	REVISED -

STATE OF ILLINOIS	
DEPARTMENT OF TRANSPORTATION	

RETAINING WALL		SECTION	COUNTY	TOTAL SHEETS	SHEET NO.
SUI BUBING LUCS	330	103R-5	COOK	778	386
2011 BORING TOR2			CONTRACT	NO. 6	OM62
HEET NO. 11 OF 18 SHEETS		ILLINOIS FED. A	D PROJECT		
SOIL BORING LOGS HEET NO. 11 OF 18 SHEETS		ILLINOIS FED. A		NO. 6	ОМ62

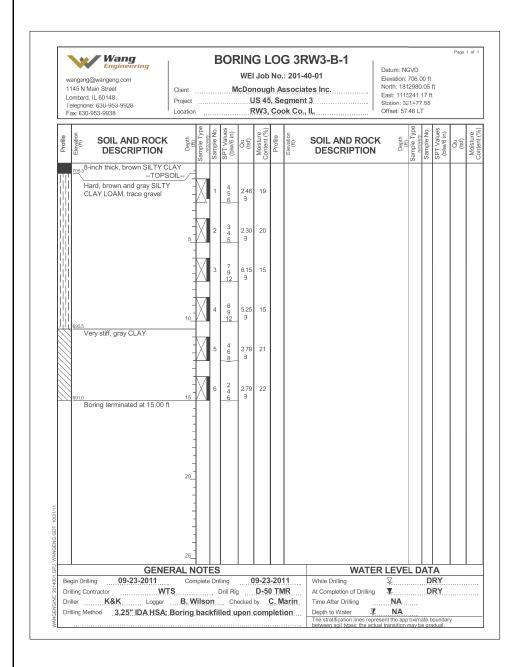

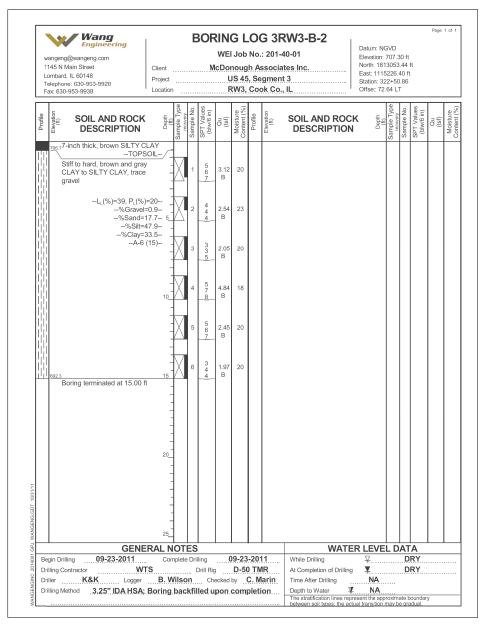

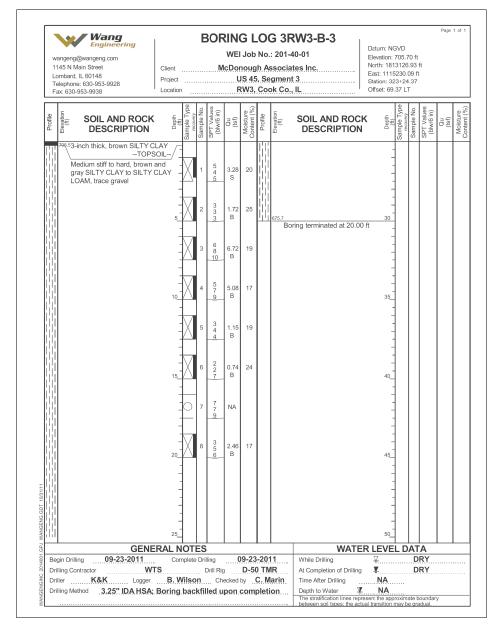

Note:

For retaining wall key plan see sheet 1. For typical wall details see sheet 2.


See individual wall sheets for boring locations.


100 S. WACKER I SUITE 500 CHICAGO IL, 606G TEL (312)-939-100 FAX (312)-939-410


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PLOT DATE = 3/13/2013	CHECKED -	REVISED -

RETAINING WALL SOIL BORING LOGS		SECTION	COUNTY	TOTAL SHEETS	SHEET NO.
		103R-5	COOK	778	387
			CONTRACT	NO. 6	0м62
SHEET NO. 12 OF 18 SHEETS	ILLINOIS FED. AID PROJECT				



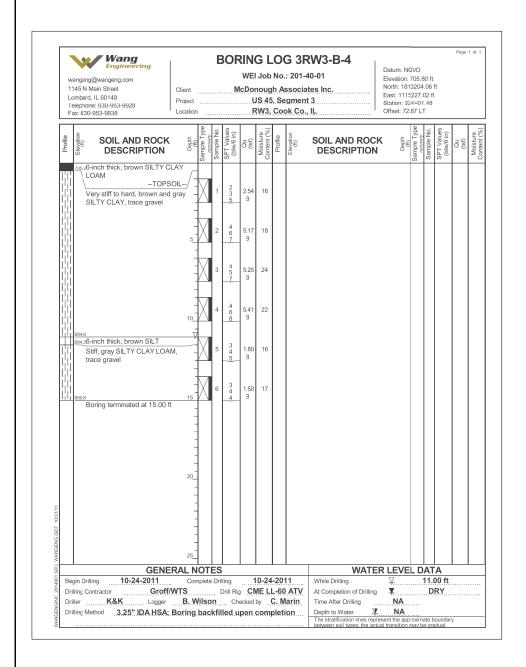

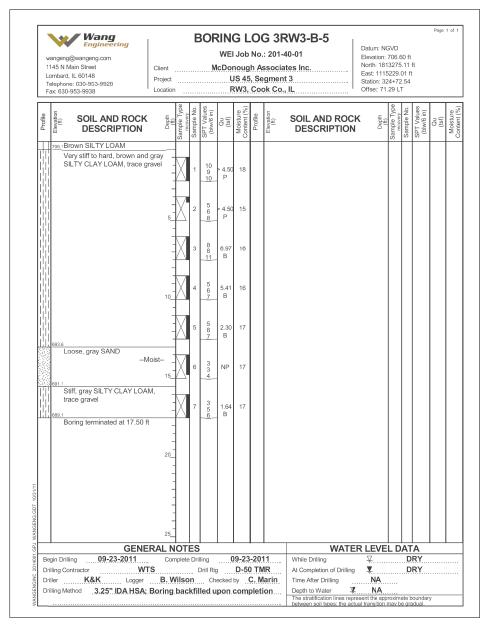

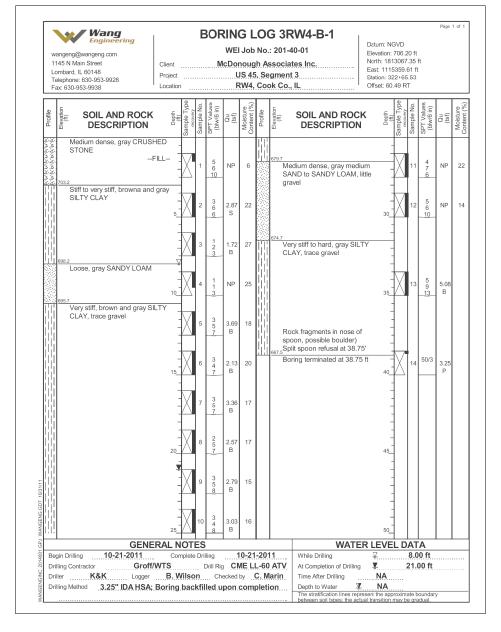
For retaining wall key plan see sheet 1. For typical wall details see sheet 2.


See individual wall sheets for boring locations.


100 S. WACKER DR.
100 S. WACKE

160M62-SHT-Boring03.dgn

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	CHECKED - JCE	REVISED -
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PLOT DATE = 3/13/2013	CHECKED - JCE	REVISED -

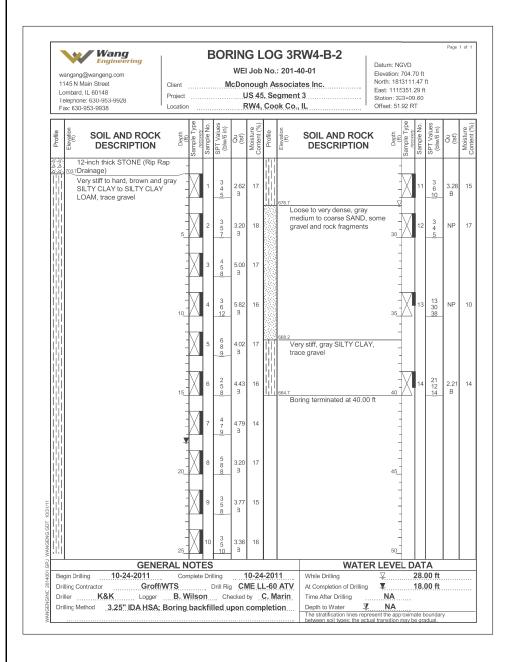

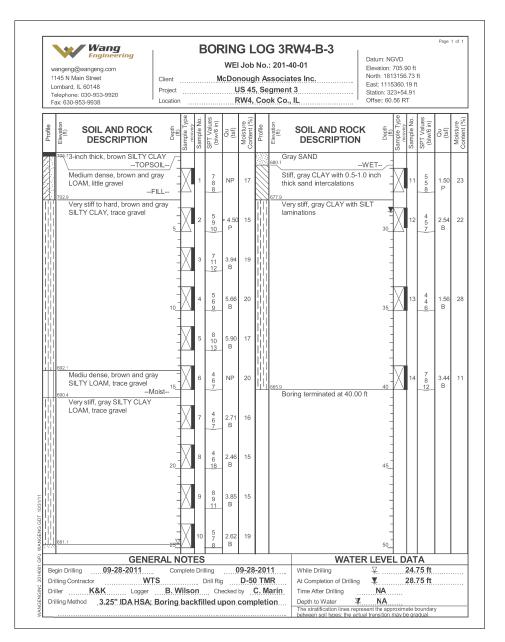

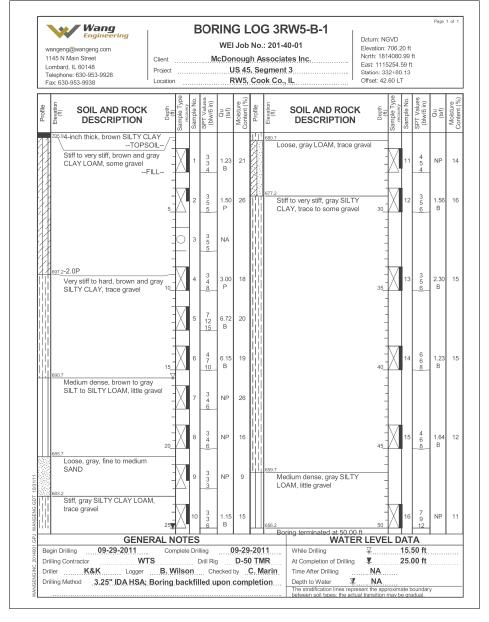

For retaining wall key plan see sheet 1.


For typical wall details see sheet 2.


See individual wall sheets for boring locations.


100 S. WACKER D SUITE 500 CHICAGO 1L. 60600 TEL (312)-9339-100 FAX (312)-939-419

160M62-SHT-Boring04.dgn

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	CHECKED - JCE	REVISED -
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PLOT DATE = 3/13/2013	CHECKED - JCE	REVISED -

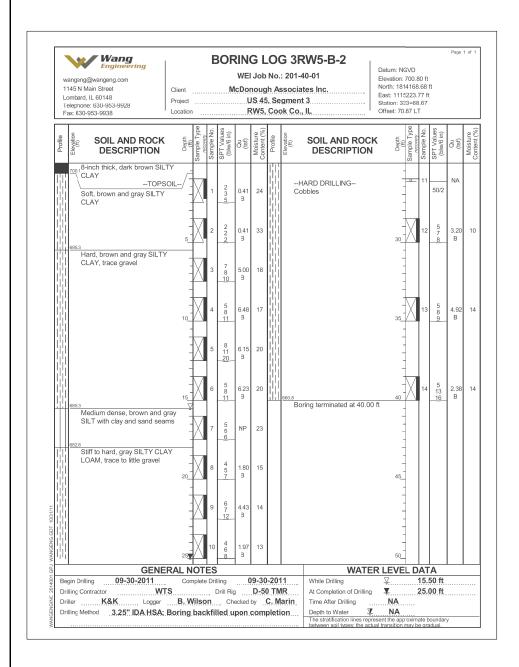

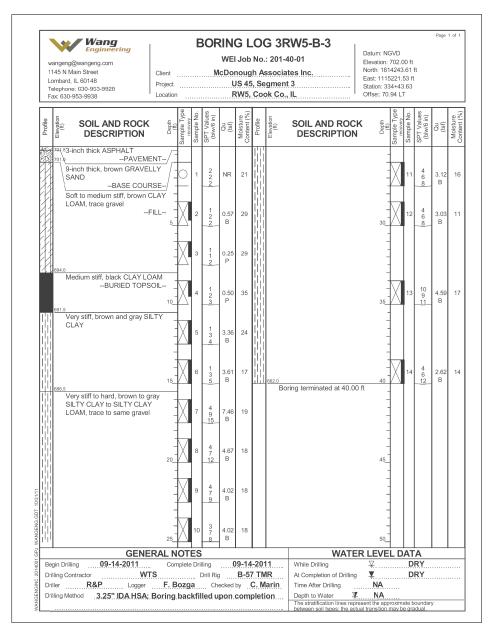

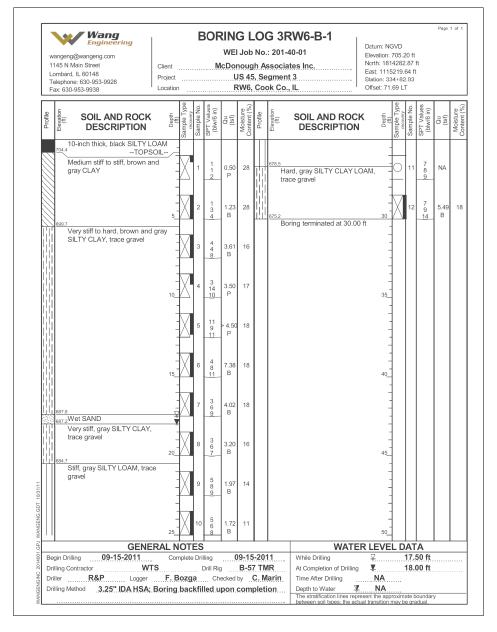

For retaining wall key plan see sheet 1.

For typical wall details see sheet 2.

See individual wall sheets for boring locations.


100 S. WACKER DR. 100 S. WACKE


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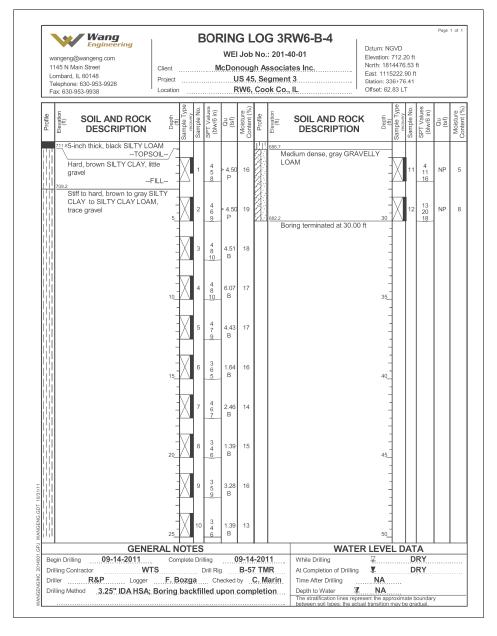
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PLOT DATE = 3/13/2013	CHECKED	-	JCE	REVISED -	

STATI	E OF	ILLINOIS
DEPARTMENT	OF	TRANSPORTATION

RETAINING WALL SOIL BORING LOGS		SECTION	COUNTY	TOTAL SHEETS	SHEET NO.
		103R-5	соок	778	390
			CONTRACT	NO. 6	OM62
SHEET NO. 15 OF 18 SHEETS		ILLINOIS FED. A	D PROJECT		



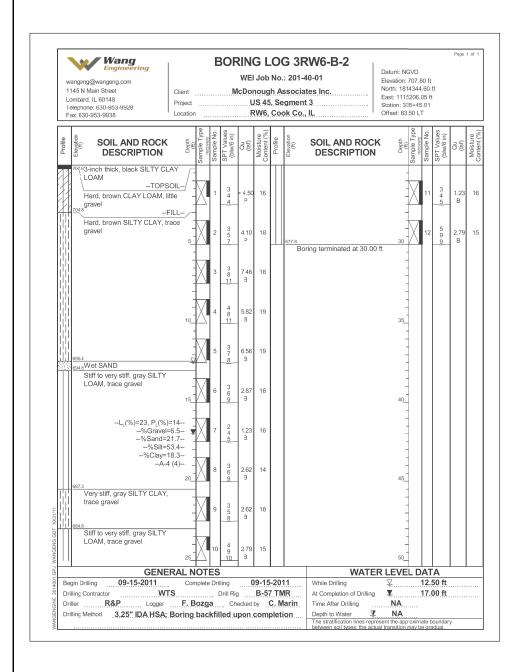

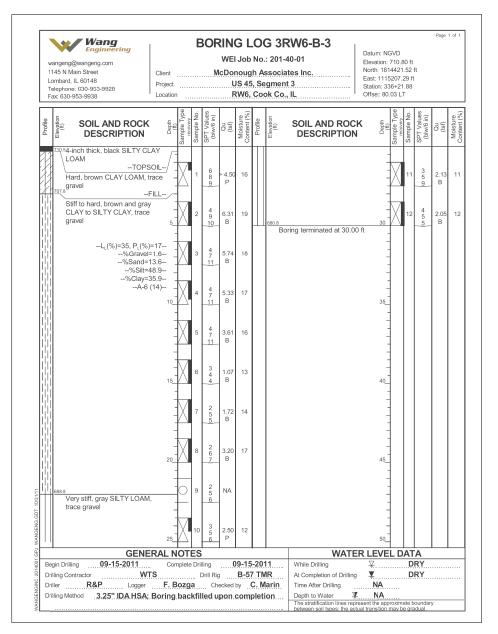

For retaining wall key plan see sheet 1. For typical wall details see sheet 2,


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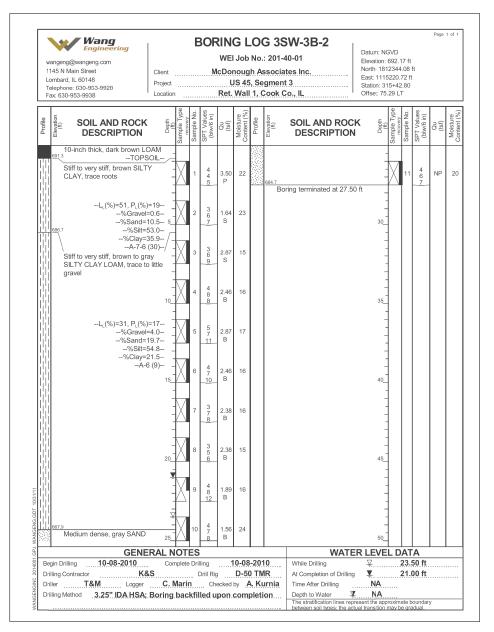
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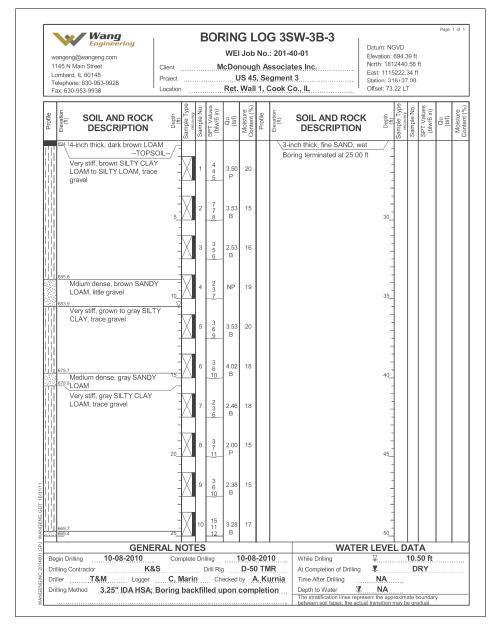
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PLOT SCALE = 0:2.00 ':' / in.	DRAWN - JDK	REVISED -
PLOT DATE = 3/13/2013	CHECKED - JCE	REVISED -

STATE	OF	ILLINOIS
DEPARTMENT	OF	TRANSPORTATION

RETAINING WALL		SECTION	COUNTY	TOTAL	SHEET NO.
SOIL BORING LOGS	330	103R-5	соок	778	391
SUIL BURING LUGS			CONTRACT	NO. 6	50M62
SHEET NO. 16 OF 18 SHEETS		ILLINOIS FED.	AID PROJECT		





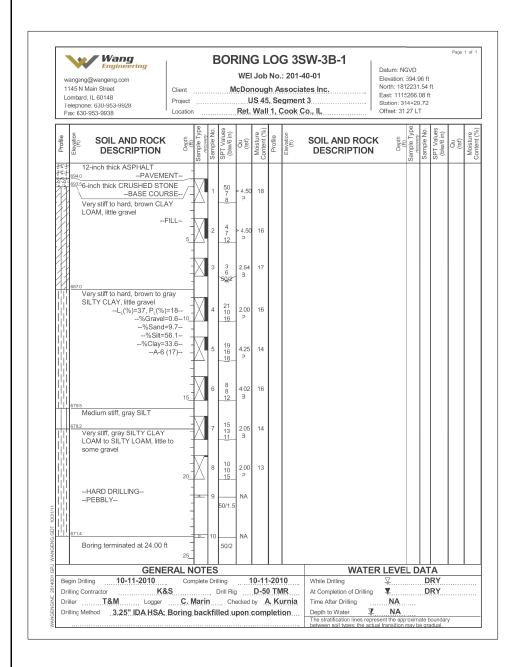


For retaining wall key plan see sheet 1. For typical wall details see sheet 2.


See individual wall sheets for boring locations.


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PLOT DATE = 3/13/2013	CHECKED - JCE	REVI	ISED -

RETAINING WALL		SECTION	COUNTY	TOTAL SHEETS	SHEET NO.	
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SOIL BORING LOGS			CONTRACT	NO. 6	ОМ62	
	ILLINOIS FED. AID PROJECT					



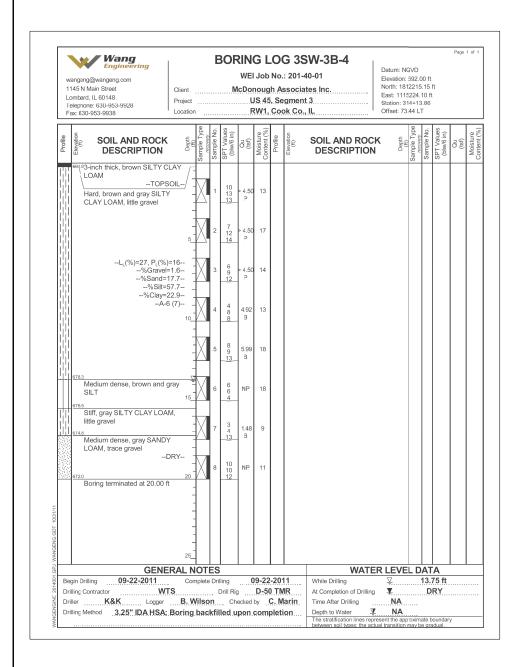

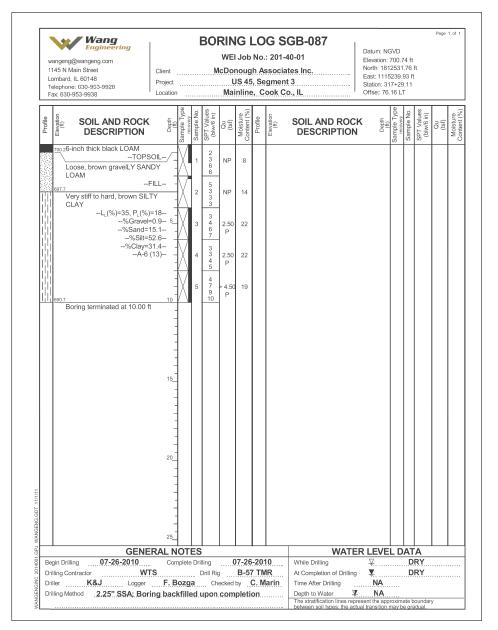


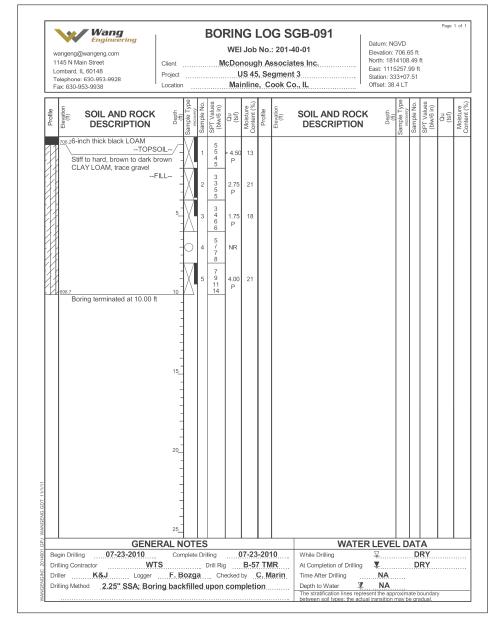For retaining wall key plan see sheet 1. For typical wall details see sheet 2. See individual wall sheets for boring locations.



160M62-SHT-Boring08.dgn

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PLOT DATE = 3/13/2013	CHECKED - JCE	REVISED -

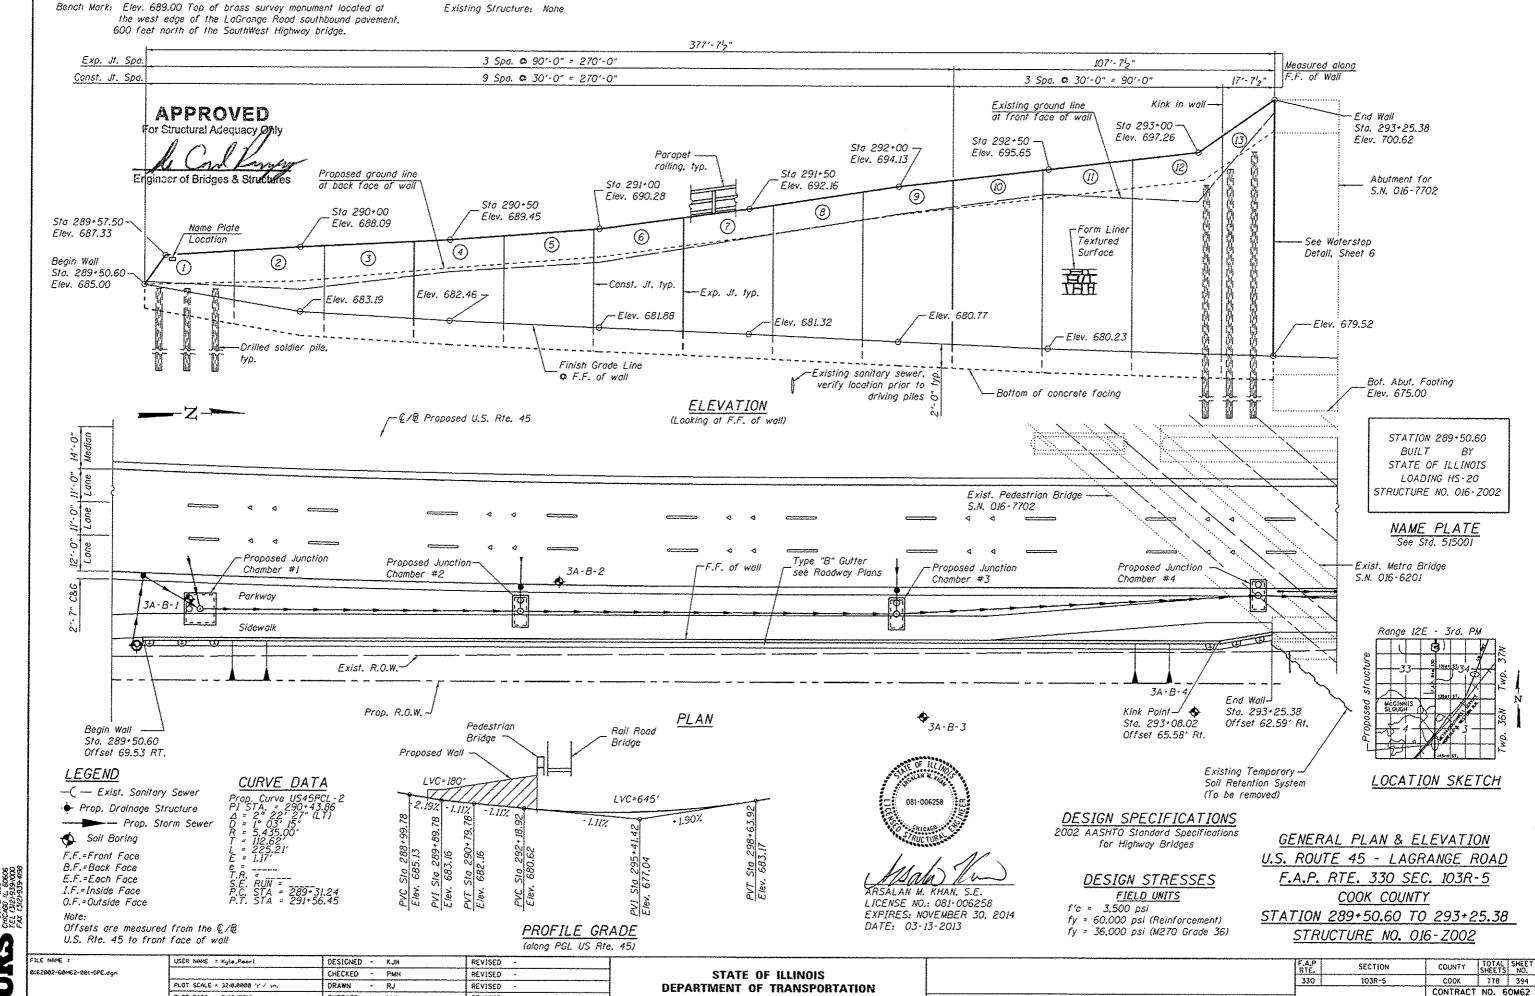

SHEET NO. 1 OF 9 SHEETS


ILLINOIS FED. AID PROJECT

Y

PLOT DATE = 3/15/2013

CHECKED - MJL

REVISED

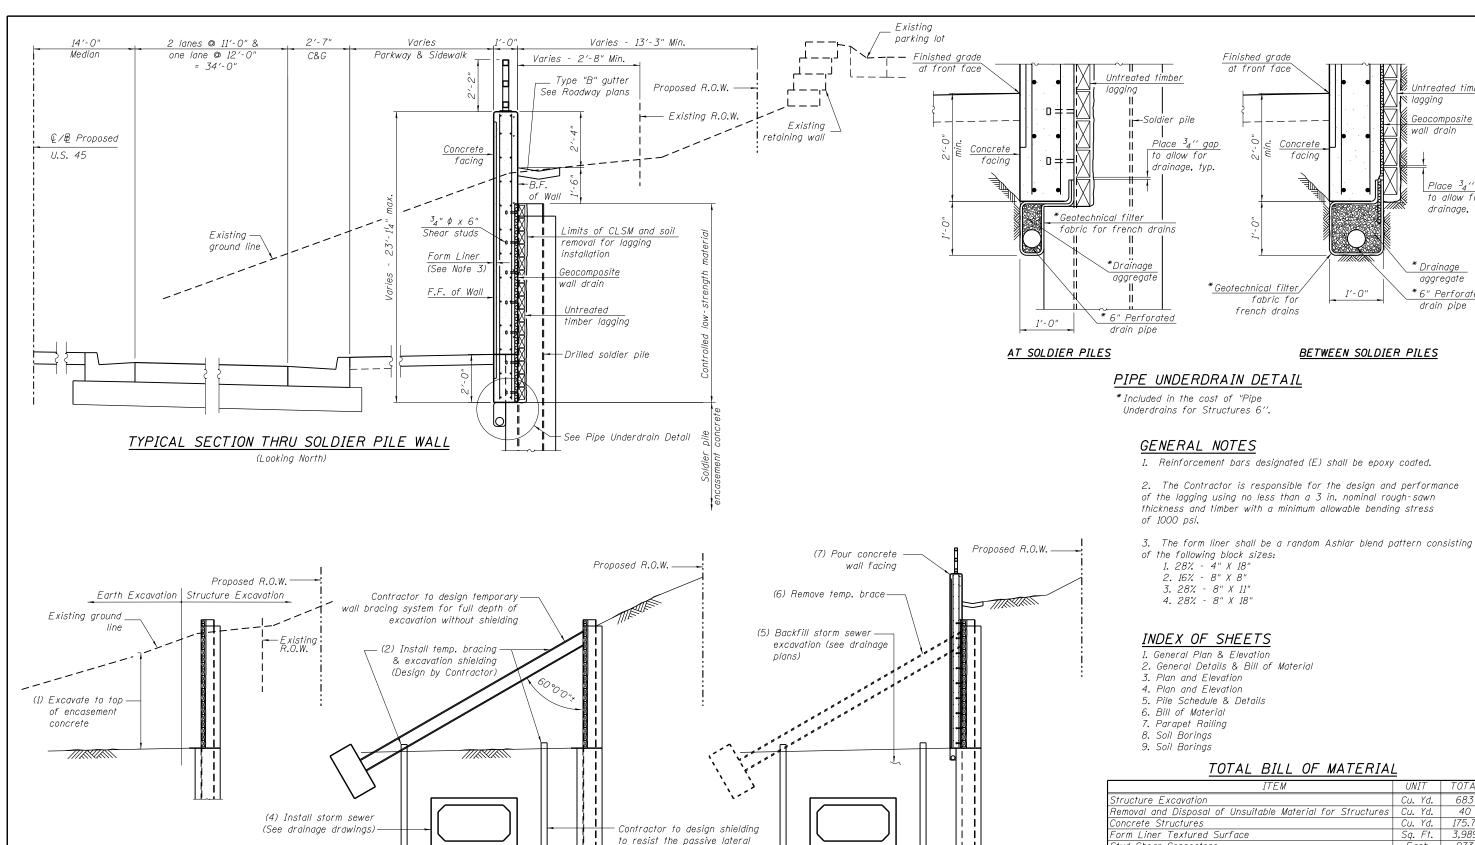

TOTAL BILL OF MATERIAL	=	
ITEM	UNIT	TOTAL
Structure Excavation	Cu. Yd.	683
Removal and Disposal of Unsuitable Material for Structures	Cu. Yd.	40
Concrete Structures	Cu. Yd.	175.7
Form Liner Textured Surface	Sq. Ft.	3,989
Stud Shear Connectors	Each	973
Reinforcement Bars, Epoxy Coated	Pound	20,100
Parapet Railling	Foot	378
Name Plates	Each	1
Geocomposite Wall Drain	Sq. Yd.	375
Drilling and Setting Soldier Piles (In Soil)	Cu. Ft.	12,474
Removal of Temporary Soil Retention System	Sq. Ft.	962
Untreated Timber Lagging	Sq. Ft.	3,303
Furnishing Soldier Piles (W Section)	Foot	1,514
Pipe Underdrains for Structures 6"	Foot	435
Temporary Wall Bracing System	L. Sum	1
I E A D		TOTAL

FILE NAME =	USER NAME = Anthony_Plutz	DESIGNED	-	KJH	REVISED	-	_
016Z002-60M62-002-GNO.dgn		CHECKED	-	PMH	REVISED	-	
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	PLOT DATE = 3/13/2013	CHECKED	-	M.II	REVISED	_	

STEP 1 - CONSTRUCT SOLDIER

PILE WALL W/O FACING

(3) Excavate

STEP 2 - INSTALL TEMPORARY WALL BRACING

SYSTEM AND STORM SEWER

SOLDIER PILE WALL STAGE CONSTRUCTION

STATE OF ILLINOIS **DEPARTMENT OF TRANSPORTATION**

STEP 3 - FINISH WALL CONSTRUCTION

earth pressure applied to the soil from the wall as if

sheilding weren't there (use Kp=3.0)

GENERAL	DETA	ILS	&	BILL	0F	MATERIAL	
STRUCTURE NO. 016-Z002							
	SHEET	NO.	2 OF	9 SH	FFTS		

RTE.	SECTION		COUNTY	TOTAL SHEETS	SHEE NO.
330	103R-5		COOK	778	395
			CONTRACT	NO. 6	ОМ62
	ILLINOIS	FED. Al	D PROJECT		

Untre<u>ated timber</u>

Place 3₄ '' gap to allow for drainage, typ.

∭ Geo<u>composite</u>

Drainage


aggregate


drain pipe

* 6" Perforated

k wall drain


🏿 lagging

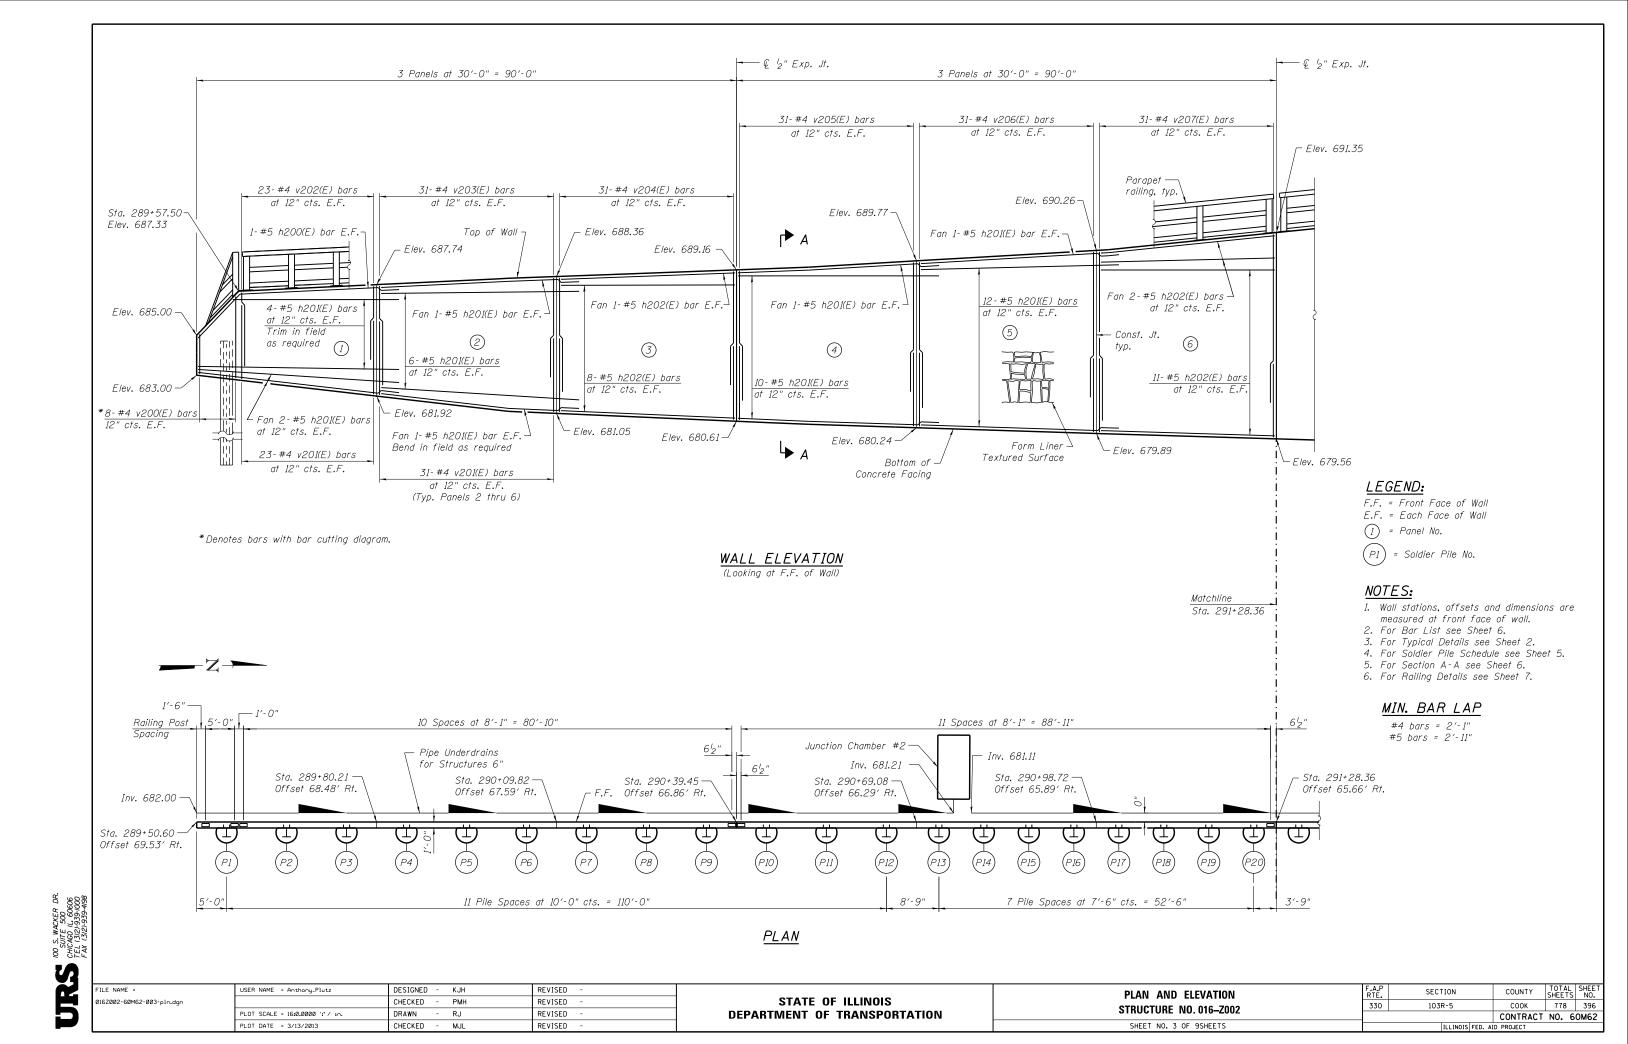

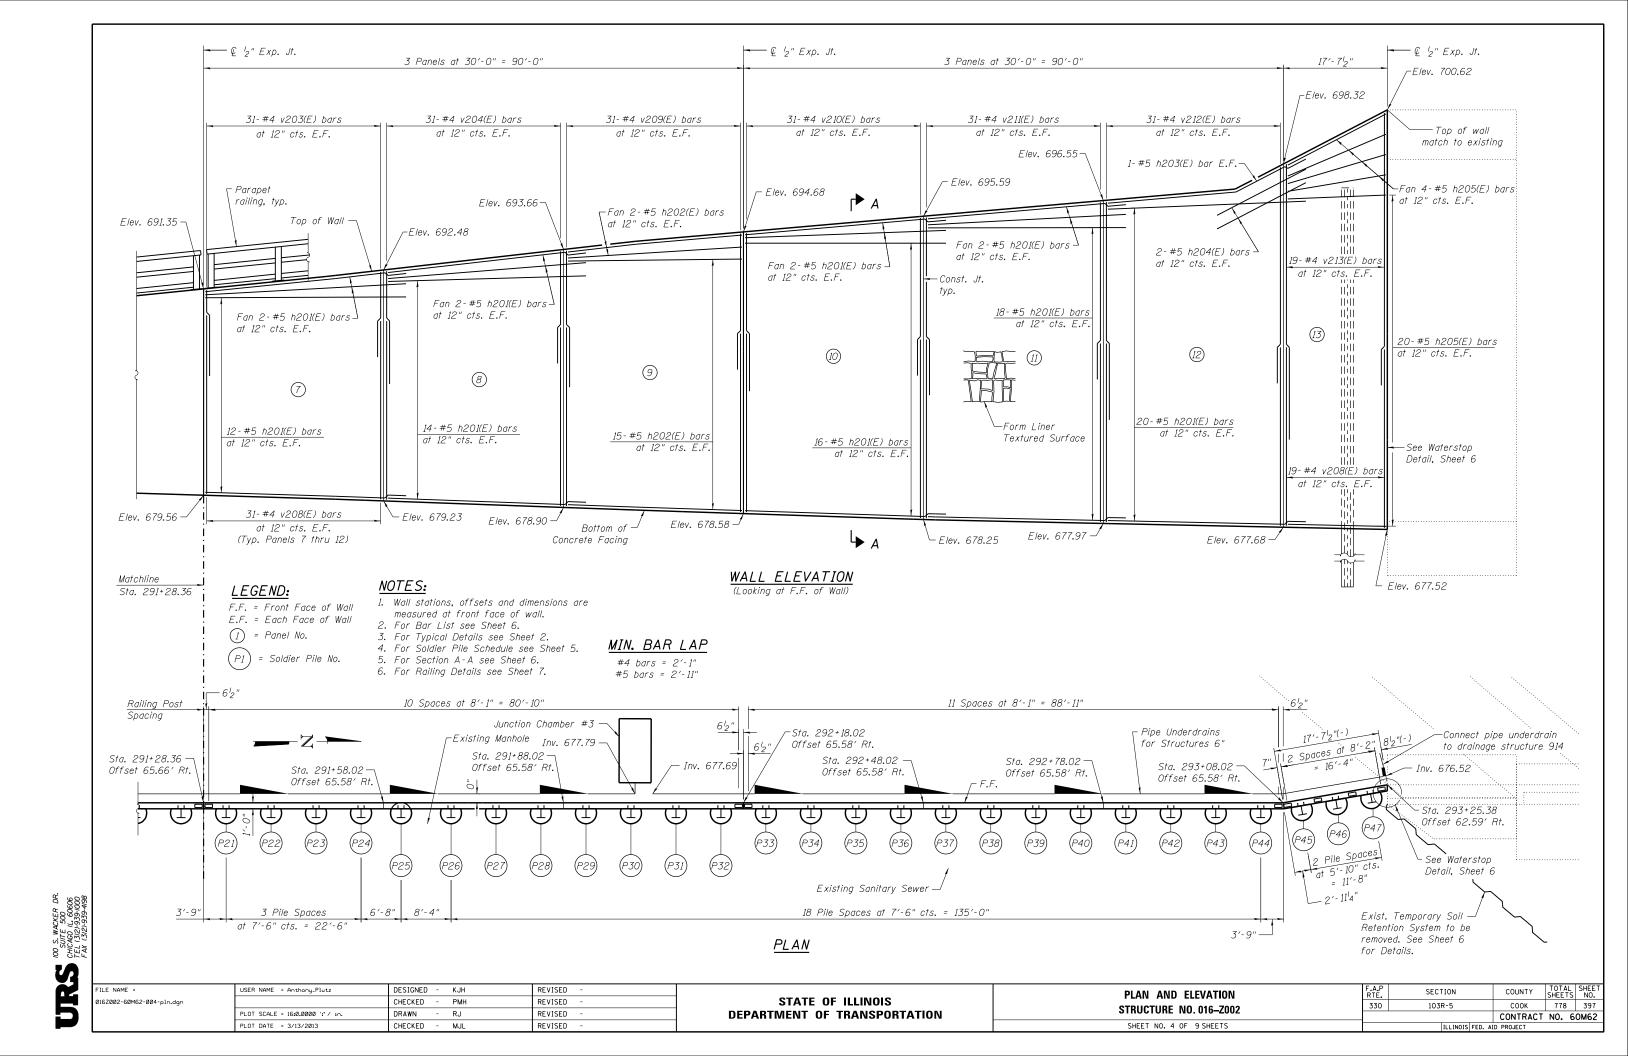


SOLDIER PILE SCHEDULE

		Soldier Pi	le Data		ı	Concr	ete Encasem	ent Data
Pile No.	Pile Size	Top of Pile Elevation	Pile Tip Elevation	Pile Length (Ft.)	No. of Studs	Diameter (In.)	Top of Encasement Elevation	Encasement Length
P1	W18x46	682.84	667.07	15,77	2	24	682.82	15.75
P2	W18x46	683.64	666.71	16.93	4	24	682.46	15.75
P3	W18x46	683.82	666.35	17.47	4	24	682.10	15.75
P4	W18x46	684.01	666.02	17.99	6	24	681.77	15.75
P5	W18x46	684.22	665.73	18.49	6	24	681.48	15.75
P6	W18x46	684,42	665.44	18.98	8	24	681.19	15.75
P7	W18x76	684.66	663.47	21.19	8	30	680.97	17.50
P8	W18x76	684.93	663.33	21.60	10	30	680.83	17.50
P9	W18x76	685.20	663.19	22.01	10	30	680.69	17.50
P10	W21x93	685.43	661.55	23.88	10	30	680.55	19.00
P11	W21x93	685.63	661.43	24.21	12	30	680.43	19.00
P12	W21x93	685,84	661.30	24.53	12	30	680.30	19.00
P13	W21x93	686.00	661.20	24.80	12	30	680.20	19.00
P14	W21x93	686.12	661.11	25.01	14	30	680.11	19.00
P15	W21x93	686.24	661.02	25.22	14	30	680.02	19.00
P16	W21x93	686.37	660.94	25.43	14	30	679.94	19.00
P17	W24x104	686.56	659.60	26.96	14	36	679.85	20.25
P18	W24x104	686.84	659.52	27.32	16	36	679,77	20,25
P19	W24x104	687.11	659.44	27.67	16	36	679.69	20.25
P20	W24x104	687.38	659.35	28.03	16	36	679.60	20.25
P21	W24x131	687.66	657.52	30.14	18	36	679.52	22.00
P22	W24x131	687.94	657.44	30.50	18	36	679.44	22.00
P23	W24x131	688,22	657.36	30.87	18	36	679,36	22.00
P24	W24x131	688.50	657.27	31.23	20	36	679.27	22.00
P25	W27x146	688.76	656.95	31.81	20	36	679.20	22.25
P26	W27x146	689.09	656.86	32.23	20	36	679.11	22.25
P27	W27x146	689.38	656.78	32.61	22	36	679.03	22.25
P28	W27x146	689.68	656.69	32.99	22	36	678.94	22.25
P29	W27x146	689,96	654.86	35.09	24	36	678.86	24.00
P30	W27x146	690.21	654.78	35.43	24	36	678.78	24.00
P31	W27x146	690.47	654,70	35.77	24	36	678.70	24.00
P32	W27x146	690.72	654.62	36.10	26	36	678.62	24.00
P.3.3	W30x173	690.96	652.78	38.18	26	42	678.53	25.75
P34	W30x173	691.19	652.70	38.49	26	42	678.45	25.75
P35	W30x173	691.42	652.62	38.79	28	42	678.37	25.75
P36	W30x173	691.65	652.54	39.10	28	42	678.29	25.75
P37	W33x201	691.88	649.72	42.16	28	42	678.22	28.50
P38	W33x201	692.12	649.64	42.48	28	42	678.14	28.50
P39	W33x201	692.36	649.57	42.79	30	42	678.07	28.50
P40	W33x201	692.60	649.50	43.10	30	42	678.00	28.50
P41	W36x262	692.84	647.10	45,74	30	48	677.93	30.83
P42	W36x262	693.08	647.03	46.05	32	48	677.86	30.83
P43	W36x262	693.33	646.96	46.37	32	48	677.79	30.83
P44	W36x262	693.57	646.89	46.68	32	48	677.72	30.83
P45	W36x262	694.87	643.83	51.05	36	48	677.66	33.83
P45 P46	W36x262	695.64	643.77	51.86	38	48	677.60	33.83
P46 P47	W36x262	696.40	643.72	52.68	38	48	677.55	33.83

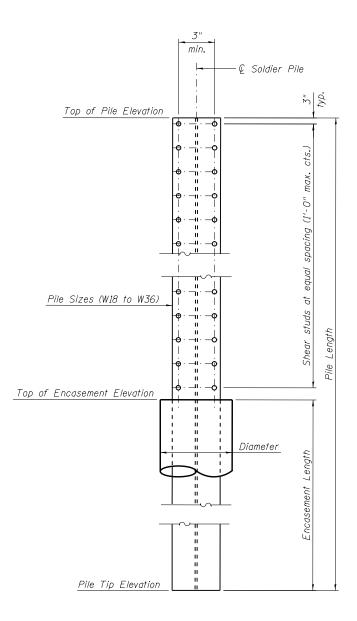

SOLDIER PILE ELEVATION AND SHEAR STUD CONNECTION DETAILS

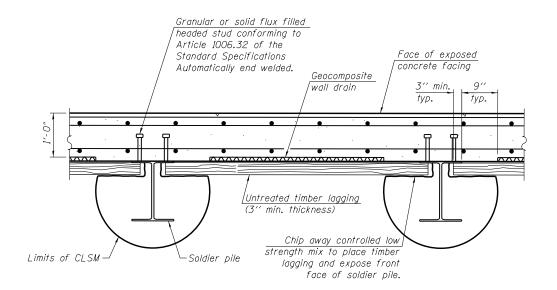


DETAIL PLAN

100 S. W. SUITE	CHICAGO TEL (312, FAX (312
Z	3

LE NAME =	USER NAME = Anthony_Plutz	DESIGNED - KJH	REVISED -
6Z002-60M62-005-det.dgn		CHECKED - PMH	REVISED -
	PLOT SCALE = 5:4.0000 ':' / in.	DRAWN - RJ	REVISED -
	PLOT DATE = 3/13/2013	CHECKED - MJL	REVISED -

STATE OF ILLINOIS	
DEPARTMENT OF TRANSPORTATION	

PILE SCHEDULE & DETAILS STRUCTURE NO. 016-Z002	F.A.P RTE.	SECTION	COUNTY	TOTAL SHEETS	SHEET NO.
	330	103R-5	COOK	778	398
31NUCTURE NO. 010-2002			CONTRACT	NO. 6	ОМ62
SHEET NO. 5 OF 9 SHEETS		TILINOIS EED A	n ppn iect		

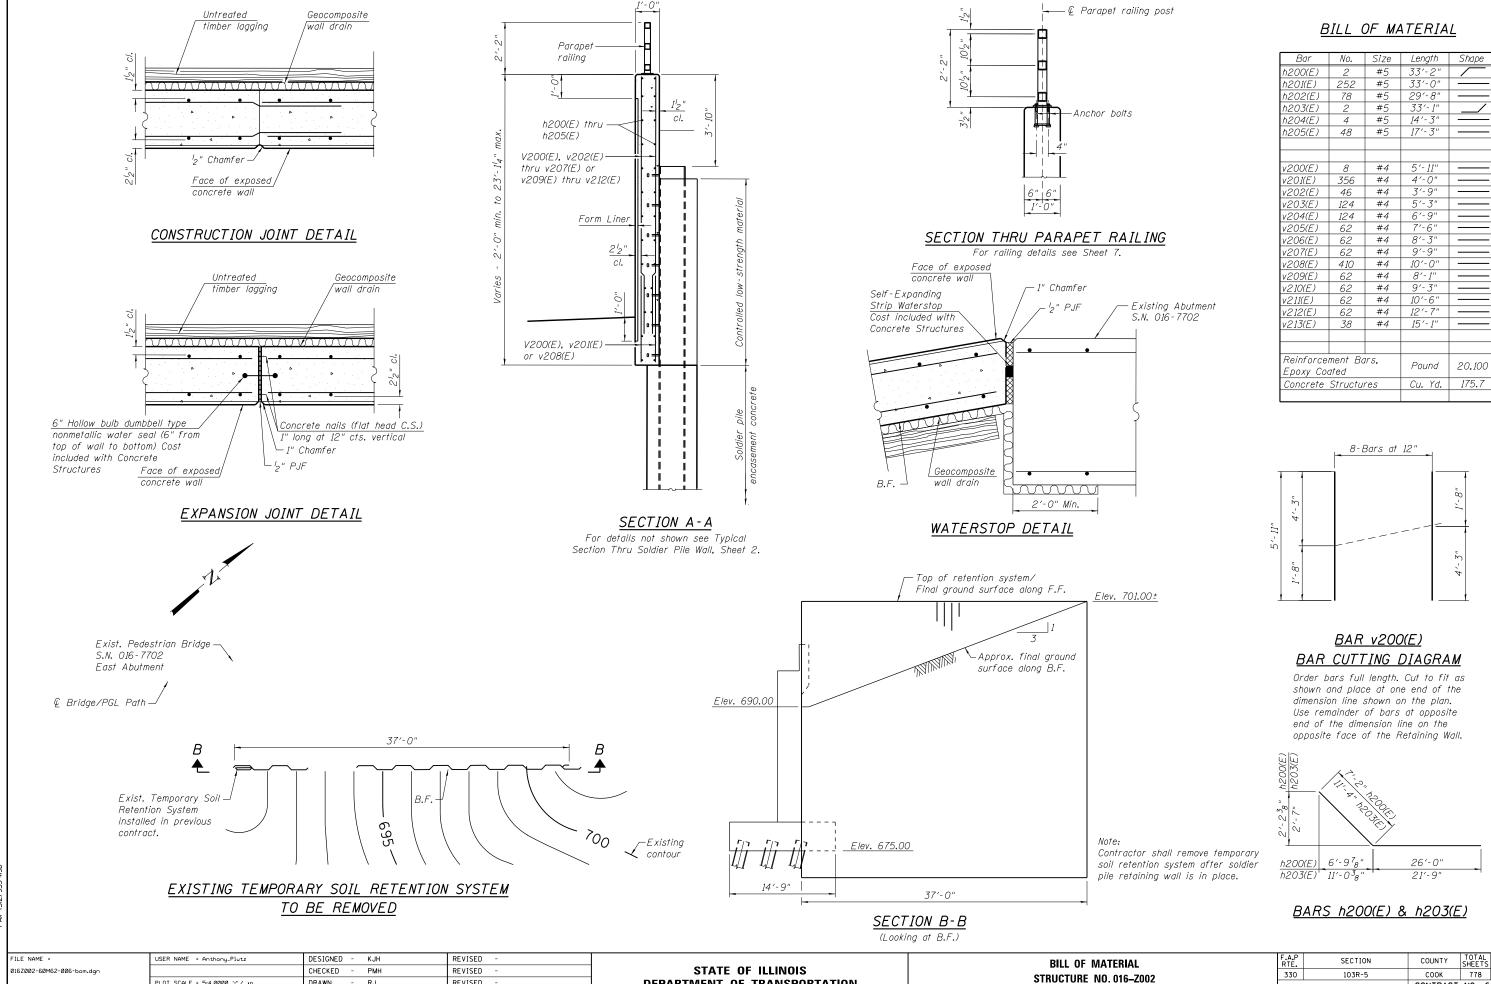

DEPARTMENT OF TRANSPORTATION

SHEET NO. 6 OF 9SHEETS

33′-1"

15′-1"

Pound

Cu. Yd.

21'-9"

COUNTY

COOK 778 399

CONTRACT NO. 60M62

20,100

PLOT SCALE = 5:4.0000 ':" / in.

PLOT DATE = 3/13/2013

DRAWN


CHECKED -

RJ

MJL

REVISED

REVISED

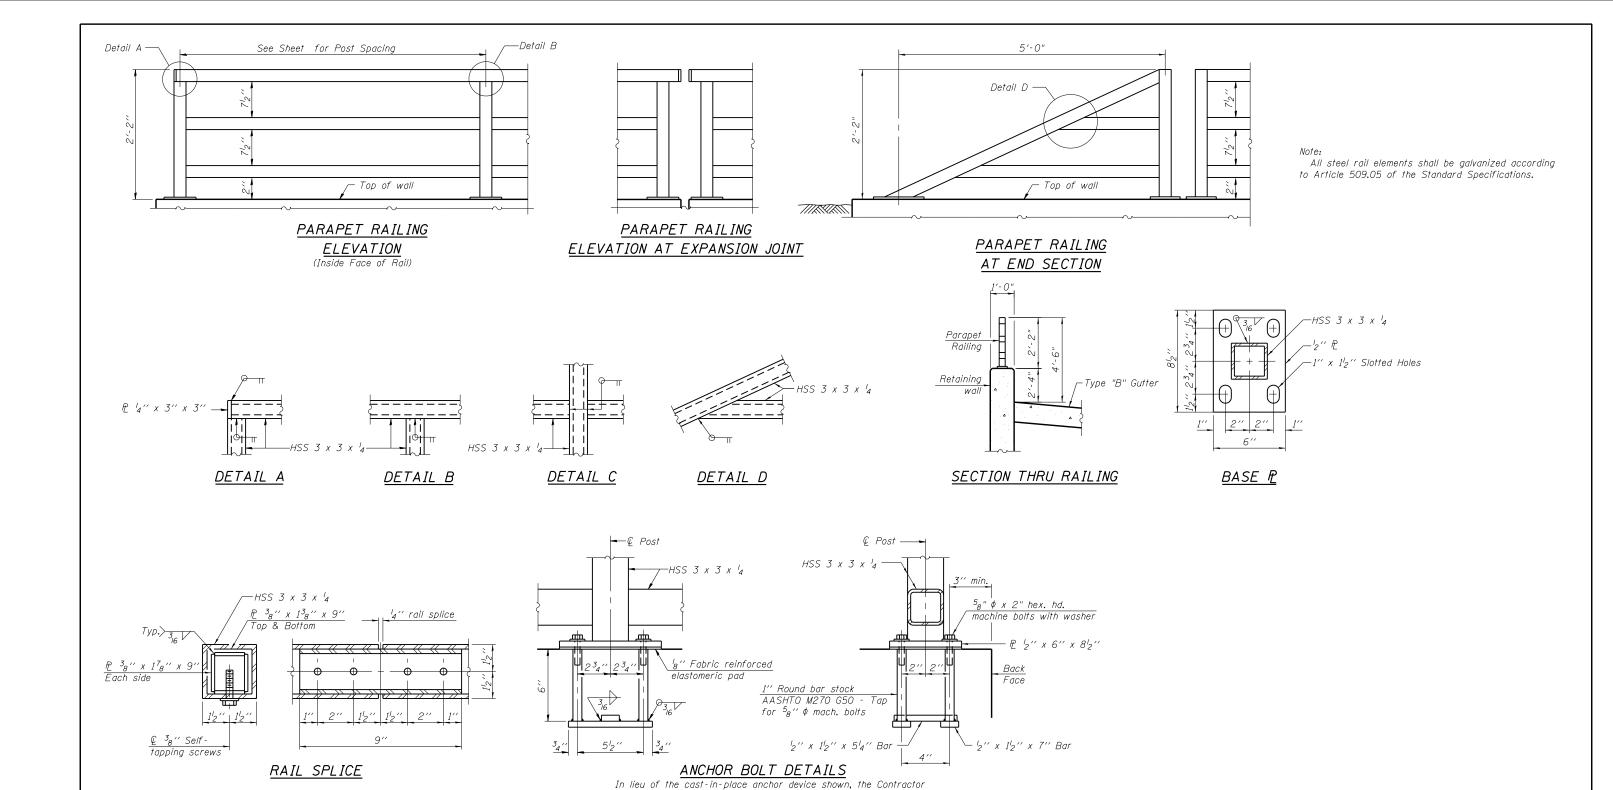

BILL OF MATERIAL

Item	Unit	Quantity
Parapet Railing	Foot	378

FILE NAME =	USER NAME = Anthony_Plutz	DESIGNED - PMH	REVISED -		PARAPET RAILING	F.A.P RTF	SECTION	COUNTY TOTAL SHEET
016Z002-60M62-007-Rail.dgn		CHECKED - MJL	REVISED -	STATE OF ILLINOIS		330	103R-5	COOK 778 400
	PLOT SCALE = 0:2.00000 ':' / in.	DRAWN - RJ	REVISED -	DEPARTMENT OF TRANSPORTATION	STRUCTURE NO. 016–Z002			CONTRACT NO. 60M62
	PLOT DATE = 3/13/2013	CHECKED - MJL	REVISED -		SHEET NO. 7 OF 9 SHEETS		ILLINOIS FED	. AID PROJECT

has the option of drilling and setting $^58''$ ϕ anchor rods according to Article 509.06 of the Standard Specifications. Embedment shall

be according to the manufacturer's specifications.