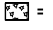
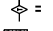

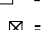
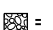
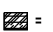
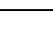
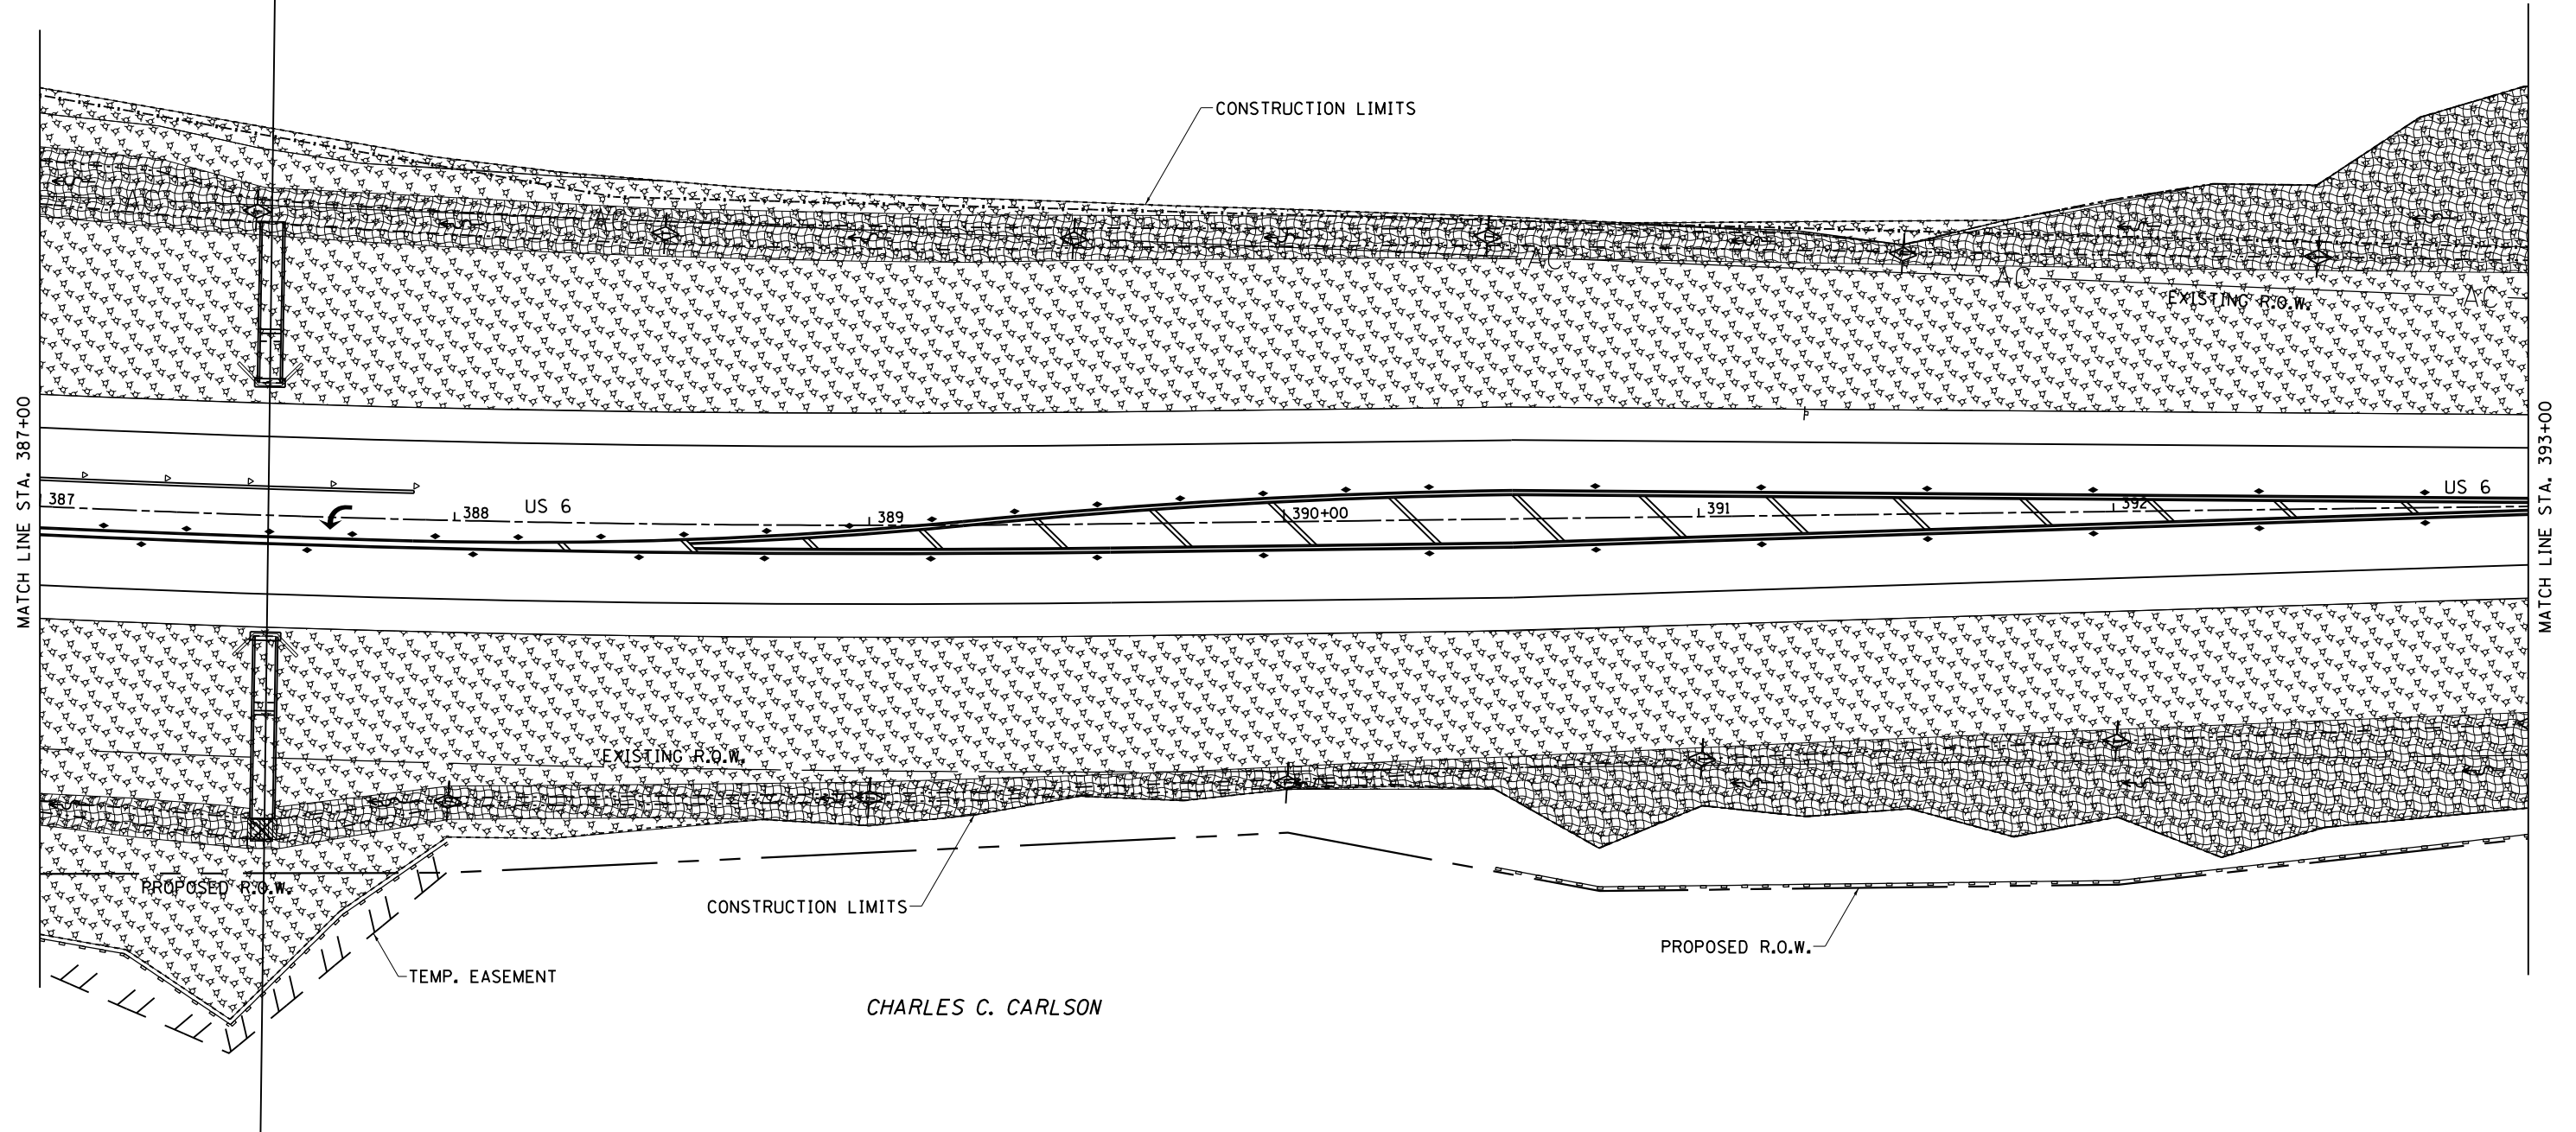
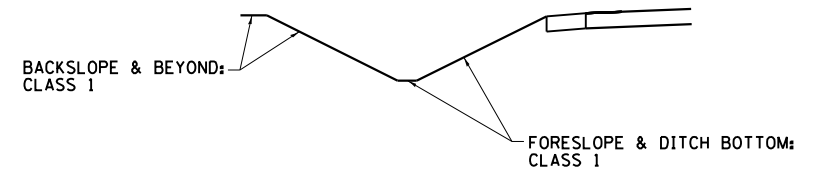


EROSION CONTROL

-  = MULCH METHOD 3
-  = TEMPORARY DITCH CHECKS
-  = EROSION CONTROL BLANKET
-  = PERIMETER EROSION BARRIER
-  = INLET PIPE PROTECTION
-  = RIP RAP
-  = TURF REINFORCEMENT MAT

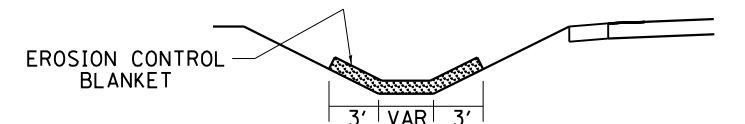


SEEDING DETAIL
(IN FRONT OF HOMES)



CHARLES C. CARLSON

EROSION CONTROL
BLANKET DETAIL



0 50' 100' — 1" = 20'

FILE NAME =	USER NAME = renkesw	DESIGNED -	REVISED -
ct:\pw\work\p\dot\renkesw\dms36691\0205584-sht-eros.dgn		DRAWN -	REVISED -
Default	PLOT SCALE = 40.0000' / in.	CHECKED -	REVISED -
	PLOT DATE = Tue Dec 18 16:31:33 2012	DATE -	REVISED -

STATE OF ILLINOIS
DEPARTMENT OF TRANSPORTATION

US 6
EROSION CONTROL DETAILS

SCALE: SHEET OF SHEETS STA. TO STA.

F.A.U. RTÉ.	SECTION	COUNTY	TOTAL SHEETS	SHEET NO.
5789	40BR	ROCK ISLAND	225	108
				CONTRACT NO. 64341

ILLINOIS FED. AID PROJECT