04-27-12 LETTING ITEM 014

STATE OF ILLINOIS
DEPARTMENT OF TRANSPORTATION
DIVISION OF HIGHWAYS

PROPOSED HIGHWAY PLANS

FOR INDEX OF SHEETS, SEE SHEET NO. 2 FOR TRAFFIC DATA, SEE SHEET NO. 4

IMPROVEMENT LOCATED IN THE CITY OF ELMHURST

MS 99/FAP 347 (IL 38 N. FRONTAGE RD — BRUSH HILL ROAD)/(IL 38)
OVER SALT CREEK
SECTION: JB-1 (11)
SCOUR COUNTERMEASURES AND STRUCTURAL REPAIR
DUPAGE COUNTY

C-91- 233-12

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420 NORTH FRONT STREET, SUITE 100 | McHENRY, ILLINOIS 60050
Phone: 815.385,1778 | Toll Freez: 800.728.7508 | Face 315.385,1781 | HRGreen.com
ILLINOIS PROFESSIONAL DESIGN FIRM #184-001322

100' 200' 300' — 1" = 100'
0 50' 100' — 1" = 50'
0 50' 100' — 1" = 40'
0 100' — 1" = 30'
0 50' — 100' — 1" = 30'
0 50' — 100' — 1" = 30'
0 50' — 100' — 1" = 20'

FULL SIZE PLANS HAVE BEEN PREPARED USING STANDARD

FULL SIZE PLANS HAVE BEEN PREPARED USING STANDARD ENGINEERING SCALES. REDUCED SIZED PLANS WILL NOT CONFORM TO STANDARD SCALES. IN MAKING MEASUREMENTS ON REDUCED PLANS, THE ABOVE SCALES MAY BE USED.


J.U.L.I.E. JOINT UTILITY LOCATION INFORMATION FOR EXCAVATION 1–800–892–0123 OR 811 R. 11 E.

Reminent Coolege

Re

PROJECT LOCATION: S.N. 022-0028, BRUSH HILL ROAD (NORTH FRONTAGE ROAD) S.N. 022-0026, FAP 347, IL RTE 38 (ROOSEVELT ROAD) OVER SALT CREEK

D-91-575-10

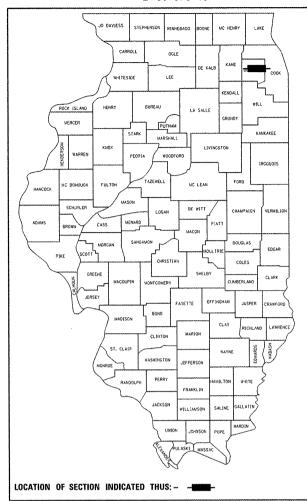

STATE OF ILLINOIS
DEPARTMENT OF TRANSPORTATION
DIVISION OF HIGHWAYS

SUBMITTED FEBRUARY 14, 20 12

Diane M. O'Heefe

DEPUTY DIRECTOR OF HIGHWAYS, REGION ENGINE

March 23 20 12

John D. Bouranzell: PE 12

Octube Engineer of Design and Environment

William R. Frey Bracker DIRECTOR OF HIGHWAYS, CHOR ENGINE

PROFESSIONAL ENGINEER'S SIGN & SEAL

Christophe M. Houths

EXPIRES: 11-30-13

PRINTED BY THE AUTHORITY
OF THE STATE OF ILLINOIS

JOINT UTILITY L
1-800-892-0123
OR 811

CONTRAC

(847) 705-4247

CONTRACT NO. 60R88

INDEX OF SHEETS

- COVER SHEET
- 2 INDEX OF SHEETS, LIST OF STATE STANDARDS, AND GENERAL NOTES
- 3 SUMMARY OF QUANTITIES
- LOCATION MAP
- SCOUR COUNTERMEASURES BRUSH HILL ROAD OVER SALT CREEK
- SUBSTRUCTURE REPAIR PLANS ILLINOIS ROUTE 38 OVER SALT CREEK
- CROSS SECTIONS SCOUR COUNTERMEASURES BRUSH HILL ROAD
- TRAFFIC CONTROL AND PROTECTION FOR SIDE ROADS, INTERSECTIONS, q
- ARTERIAL ROAD INFORMATION SIGN 10
- 11-13 DEWATERING SYSTEM DETAILS SCOUR COUNTERMEASURES

LIST OF STATE STANDARDS

STANDARD NO. DESCRIPTION

701101-02

OFF-RD OPERATIONS, MULTILANE, 4.5 m (15') TO 600 mm (24") FROM PAVEMENT EDGE

701106-02 OFF-RD OPERATIONS, MULTILANE, MORE THAN 4.5 m (15') AWAY

701601-07 URBAN LANE CLOSURE, MULTILANE, 1W OR 2W WITH NONTRAVERSABLE MEDIAN

701901-02 TRAFFIC CONTROL DEVICES

COMMITMENTS

GENERAL NOTES

- 1. BEFORE STARTING ANY EXCAVATION, THE CONTRACTOR SHALL CALL "JULIE" (JOINT UTILITY LOCATION INFORMATION FOR EXCAVATION) AT 8-1-1 OR (800) 892-0123 FOR FIELD LOCATIONS OF BURIED ELECTRIC. TELEPHONE, AND GAS FACILITIES (48 HOUR NOTIFICATION IS REQUIRED).
- 2. THE CONTRACTOR WILL NOT BE ALLOWED TO SET UP A YARD OR FIELD OFFICE ON STATE PROPERTY WITHOUT WRITTEN PERMISSION FROM THE DEPARTMENT.
- 3. EXCAVATION INTO THE STREAM BED FOR STONE RIPRAP INSTALLATION SHALL NOT BE DEEPER THAN THE BOTTOM OF THE FOOTING ON THE PIER OR ABUTMENT TO BE PROTECTED.
- 4. DEBRIS REMOVAL, IF ENCOUNTERED, SHALL BE INCLUDED IN THE COST OF THE STONE RIPRAP.
- 5. IT SHALL BE THE CONTRACTORS RESPONSIBILITY TO VERIFY ALL DIMENSIONS & CONDITIONS EXISTING IN THE FIELD PRIOR TO CONSTRUCTION ORDERING OF MATERIAL.
- 6. THE CONTRACTOR SHALL CONTACT THE DISTRICT ONE ARTERIAL TRAFFIC CONTROL SUPERVISOR AT (847) 705~4470 A MINIMUM OF 72 HOURS IN ADVANCE OF BEGINNING WORK
- 7. ALL AREAS (INCLUDING WETLAND AREAS) OUTSIDE THE LIMITS OF RIPRAP PLACEMENT AND/OR EXCAVATION WHICH ARE DISTURBED (WHERE EXISTING SOIL CONTOURS HAVE BEEN ALTERED AND/OR EXISTING VEGETATION HAD BEEN DESTROYED BY THE CONTRACTORS OPERATIONS) SHALL BE RESTORED BY REGRADING TO THE ORIGINAL CONTOURS AND/OR SEEDING WITH SEEDING, CLASS 4, AND MULCHING WITH EROSION CONTROL BLANKETS. PLACE TEMPORARY SEEDING AND TEMPORARY EROSION CONTROL BLANKETS AS NEEDED. THIS WORK WILL NOT BE PAID FOR SEPERATELY, BUT THE COSTS SHALL BE CONSIDERED INCLUDED IN THE CONTRACT UNIT PRICES FOR THE CONSTRUCTION ITEMS INVOLVED, AND NO ADDITIONAL COMPENSATION WILL BE ALLOWED.
- 8. THE CONTRACTOR IS ADVISED TO AVOID OR MINIMIZE ANY DISTURBANCE TO EXISTING VEGETATION OUTSIDE THE LIMITS OF RIPRAP PLACEMENT AND CHANNEL EXCAVATION.
- 9. THE CONTRACTOR MUST PROTECT PAVEMENT WHEN DUMPING RIPRAP ONTO PAVEMENT AND WILL BE RESPONSIBLE FOR RESTORING PAVEMENT MARKINGS.
- 10. ANY GUARDRAIL OR SIGNS DAMAGED BY THE CONTRACTORS OPERATIONS SHALL BE REPLACED IN KIND AT THE CONTRACTORS EXPENSE.
- 11. THE CONTRACTOR SHALL BE REQUIRED TO PROVIDE ACCESS TO ABUTTING PROPERTY AT ALL TIMES DURING THE CONSTURCTION OF THIS PROJECT.
- 12. DO NOT SCALE PLANS FOR CONSTRUCTION DIMENSIONS.
- 13. THE CONTRACTOR SHALL SUBMIT DEWATERING AND SEDIMENT CONTROL PLANS FOR EACH SITE TO THE ENGINEER FOR APPROVAL.
- 14. THE CONTRACTOR SHALL CONTACT THE ENGINEER AFTER DEWATERING FOR FINAL RIPRAP OR SLOPE MATTRESS PLACEMENT.
- 15. NIGHT TIME CLOSURES WILL NOT BE REQUIRED FOR THIS PROJECT.
- 16. UNLESS OTHERWISE NOTED, EXCAVATION OF MATERIAL REQUIRED TO INSTALL STONE RIPRAP OR SLOPE MATTRESS SHALL BE INCLUDED IN THE ITEM BEING INSTALLED.
- 17. THIS PROJECT REQUIRES US ARMY CORPS OF ENGINEERS 404 PERMITS. THE PERMITS ISSUED TO THE DEPARTMENT DOES NOT COVER THE IN STREAM WORK BY THE CONTRACTOR. THEREFORE AFTER AWARD, THE CONTRACTOR WILL NEED TO SUBMIT THE WORK PLAN TO THE CORPS. THE CORPS WILL NOT BE PROVIDING AN APPROVAL UNLESS STATED OTHERWISE IN THE PERMIT AND IN STREAM WORK CAN COMMENCE AT THE CONTRACTOR'S DISCRETION, GUIDELINES ON ACCEPTABLE IN STREAM WORK TECHNIQUES CAN BE FOUND ON THE CORPS WEBSITE: HTTP:WWW.LRC.USACE.ARMY.MIL/

DUPAGE 13 2

CONTRACT NO. 60R88

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STATE OF ILLINOIS **DEPARTMENT OF TRANSPORTATION**

INDEX OF	SHEETS, LIST	OF STAT	E STAI	NDARDS, A	ND GENERAL	NOTES RI	Ė.	SEC	TI
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SCALE:	SHEET NO.	1 OF 1	SHEETS	STA.	TO STA.	FEI	D. ROAD (DIST. NO.	Ti

				OTAUK	OTAOL
	SUMMARY OF QUANTITIES		URBAN 100% STATE	MS O	014 FAP
CODE NO.	ITEM	TINU	TOTAL OUANTITY	BRUSH HILL DUPAGE CO	ILL RTE 38 DUPAGE CO
28100107	STONE RIPRAP, CLASS A4	SQ YD	261	261	
28200200	FILTER FABRIC	SQ YD	419	419	
67000400	ENGINEER'S FIELD OFFICE, TYPE A	CAL MO	3	2	1
67100100	MOBILIZATION	L SUM	1	0.5	0.5
70102630	TRAFFIC CONTROL AND PROTECTION, STANDARD 701601	L SUM	1	0.5	0,5
X0301852	DEWATERING STRUCTURE NO. 1	EACH	1	1	
X0301853	DEWATERING STRUCTURE NO. 2	EACH	1		1
Z0012755	STRUCTURAL REPAIR OF CONCRETE (DEPTH GREATER THAN 5 INCHES)	SQ FT	280		280
Z0030850	TEMPORARY INFORMATION SIGNING	SQFT	51.4	51.4	1

11. SIPROJECT_CONTACT)
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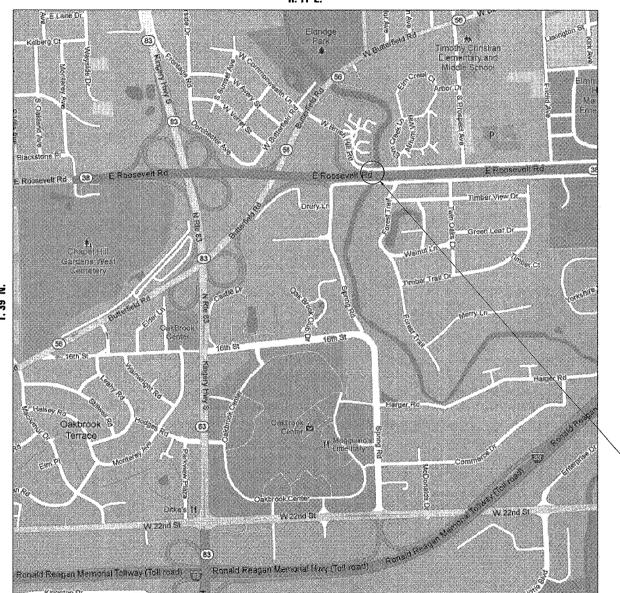
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STATE OF ILLINOIS
DEPARTMENT OF TRANSPORTATION

TRAFFIC DATA
BRUSH HILL ROAD
SPEED LIMIT = 30 MPH
2009 ADT = ~500

IL 38 (ROOSEVELT ROAD) SPEED LIMIT = 45 MPH 2009 ADT = 60,500

R. 11 E.



- PROJECT LOCATION: S.N. 022-0028, BRUSH HILL ROAD (NORTH FRONTAGE ROAD) S.N. 022-0026, FAP 347, IL RTE 38 (ROOSEVELT ROAD) OVER SALT CREEK


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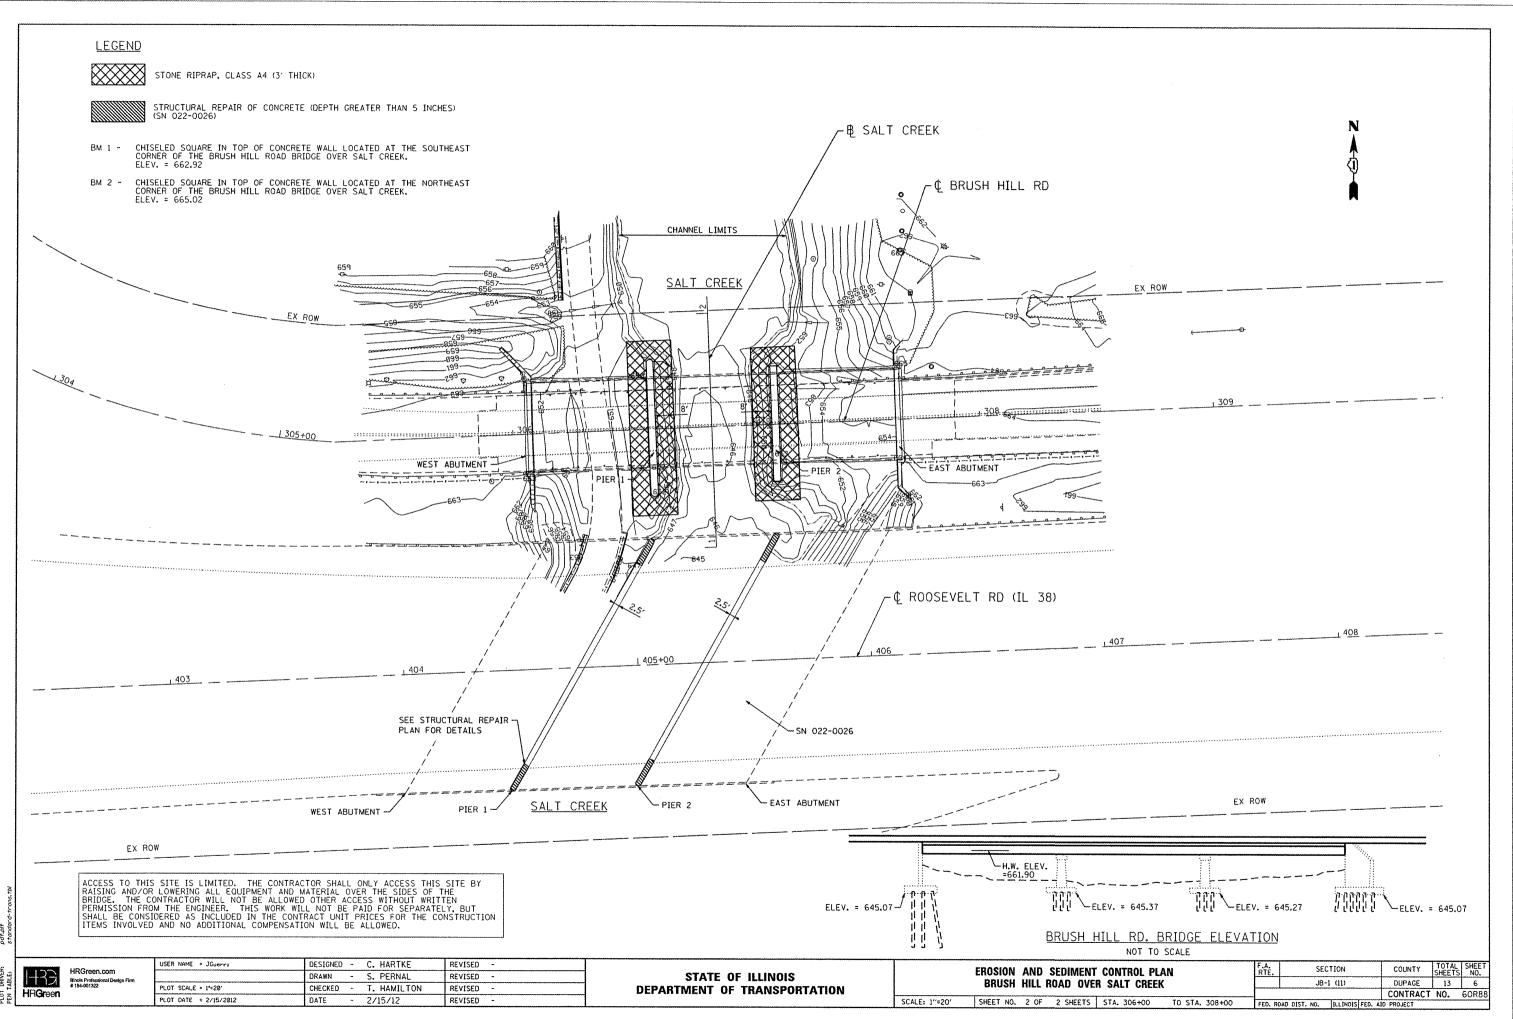
STATE OF ILLINOIS DEPARTMENT OF TRANSPORTATION

LOCATION MAP SCOUR COUNTERMEASURES AND STRUCTURAL REPAIR SHEET NO. 1 OF 1 SHEETS STA.


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STRUCTURAL REPAIR OF CONCRETE (DEPTH GREATER THAN 5 INCHES)

		AREA (SF)							
PIER	FACE	SOUTH END	NORTH END	TOTALS					
PIER *1	EAST FACE	35	35	70.0					
PIER #1	WEST FACE	35	35	70.0					
PIER #2	EAST FACE	35	35	70.0					
PIER #2	WEST FACE	35	35	70.0					
			TOTAL	280.0					

SCALE: 1"=20"

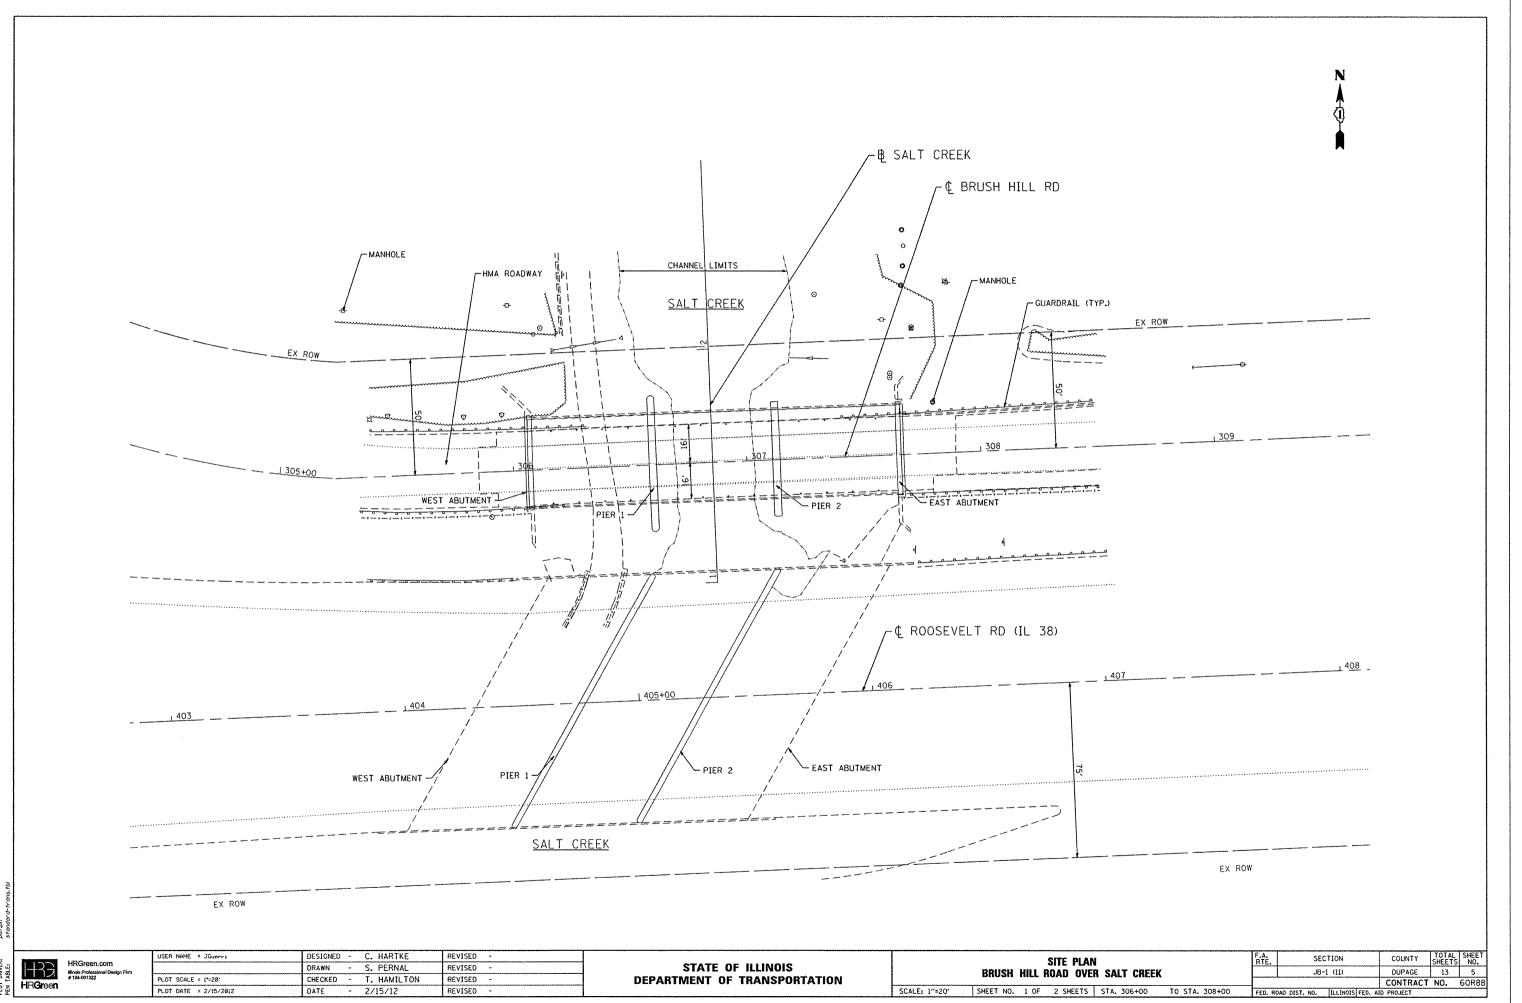ACCESS TO THIS SITE IS LIMITED. THE CONTRACTOR SHALL ONLY ACCESS THIS SITE BY RAISING AND/OR LOWERING ALL EQUIPMENT AND MATERIAL OVER THE SIDES OF THE BRIDGE. THE CONTRACTOR WILL NOT BE ALLOWED OTHER ACCESS WITHOUT WRITTEN PERMISSION FROM THE ENGINEER. THIS WORK WILL NOT BE PAID FOR SEPARATELY, BUT SHALL BE CONSIDERED AS INCLUDED IN THE CONTRACT UNIT PRICES FOR THE CONSTRUCTION ITEMS INVOLVED AND NO ADDITIONAL COMPENSATION WILL BE ALLOWED.


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	PLOT	SCALE	=	1*=20
	PLOT	DATE	=	2/15

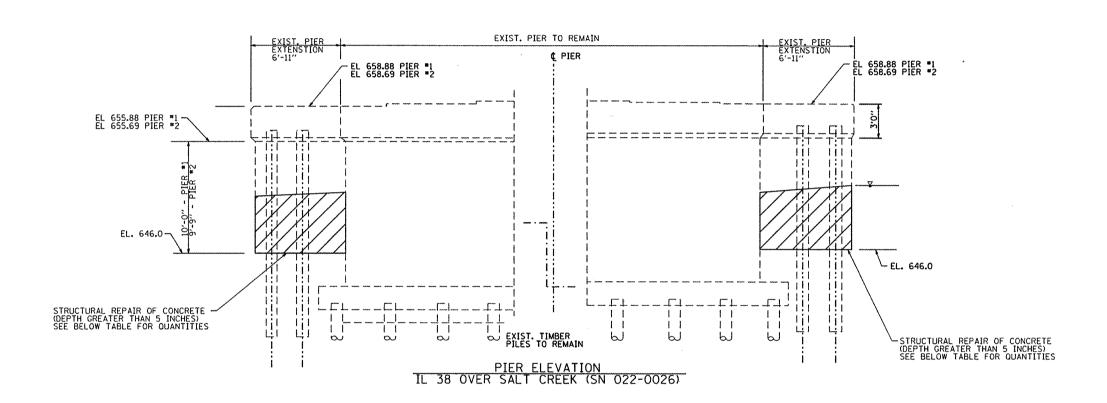USER NAME = JGuerri	DESIGNED		C. HARTKE	REVISED	-
	DRAWN	-	S. PERNAL	REVISED	•
PLOT SCALE = 1°=20'	CHECKED	-	T. HAMILTON	REVISED	-
PLOT DATE = 2/15/2012	DATE	-	2/15/12	REVISED	-

STATE	OF	ILLINOIS
DEPARTMENT (0F 1	TRANSPORTATION

SUBSTRUCTURE REPAIR PLANS	F.A. RTE.	SECTION	COUNTY	TOTAL SHEETS	SHEET NO.
ILLINOIS ROUTE 38 OVER SALT CREEK		JB-1 (11)	DUPAGE	13	7
			CONTRACT	NO.	60R88
SHEET NO. 2 OF 2 SHEETS STA. TO STA.	FED. RO	DAD DIST. NO. ILLINOIS FED. AT	D PROJECT	~~~~~	

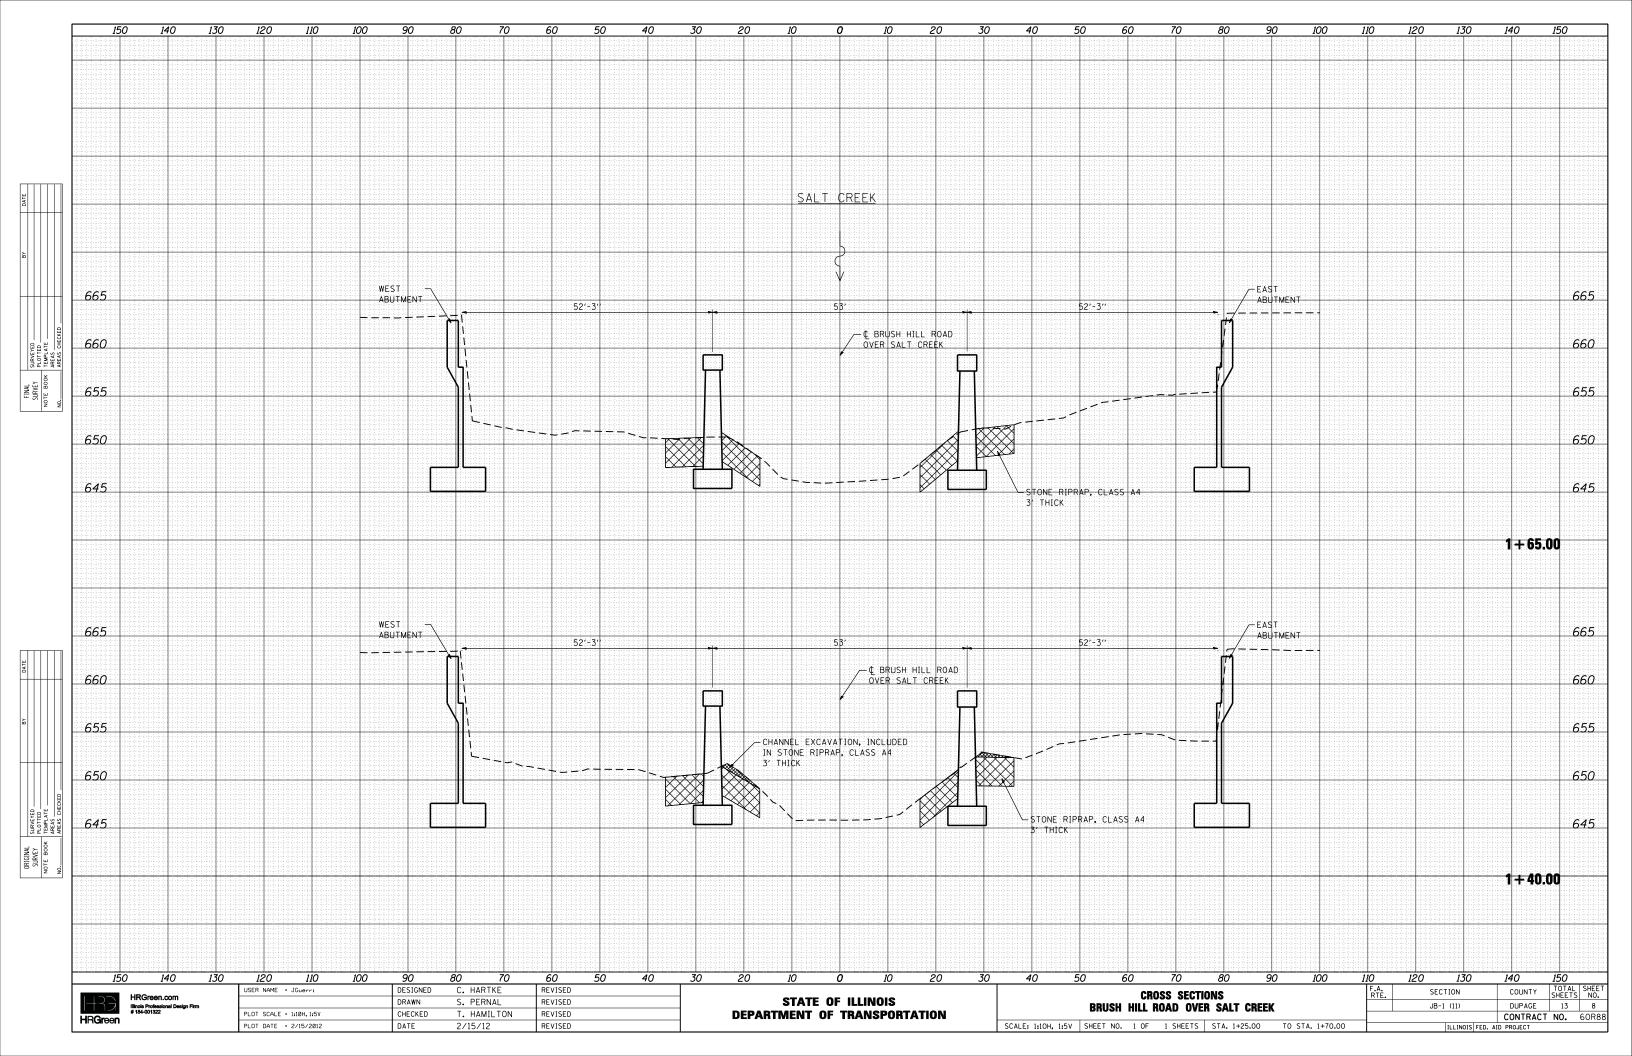

ROAD CONSTRUCTIO AHEAD ROAD TYPE III BARRICADES WITH TWO FLASHING AMBER LIGHTS ON EACH. AHEAD TYPE I OR TYPE II BARRICADES WITH ONE FLASHING AMBER LIGHT ON EACH, OR TYPE III BARRICADES WITH TWO FLASHING 200'± (60 m±)-AMBER LIGHTS ON EACH. 21 (530) DRIVEWAY STREET: SPEED 40 MPH OR LESS km/h) 200'± (60 m±) (60 500°± (150 COLLECTOR LIMIT> 40 MPH (LOCAL LIMIT , W20-1(0) SPEED CONSTRUCTION M6-4(0)-2115 CONSTRUCTION M6-1(0)-2115 AHEAD

TRAFFIC CONTROL AND PROTECTION FOR SIDE ROADS, INTERSECTIONS, AND DRIVEWAYS

NOTES:

- A. FOR NO LANE RESTRICTION ON THE SIDE ROAD OR DRIVEWAYS
- 1. SIDE ROAD WITH A SPEED LIMIT OF 40 MPH (60 km/b) OR LESS AS SHOWN ON THE DRAWING AND AS DIRECTED BY THE ENGINEER:
- OF THE MAIN ROLLTE.
- b) THE CLOSED PORTION OF THE MAIN ROUTE SHALL BE PROTECTED BY BLOCKING WITH TYPE I, TYPE II OR TYPE III BARRICADES, 1/3 OF THE CROSS SECTION OF THE CLOSED PORTION.
- 2. SIDE ROAD WITH A SPEED LIMIT GREATER THAN 40 MPH (60 km/h)
 AS SHOWN ON THE DRAWING AND AS DIRECTED BY THE ENGINEER:
- a) ONE ROAD CONSTRUCTION AHEAD SIGN 48 x 48 (1.2 m x 1.2 m) WITH A FI ASHER MOUNTED ON IT APPROXIMATELY 500' (150 m) IN ADVANCE OF THE MAIN ROUTE.
- b) THE CLOSED PORTION OF THE MAIN ROUTE SHALL BE PROTECTED BY BLOCKING WITH TYPE III BARRICADES, 1/2 OF THE CROSS SECTION OF THE CLOSED PORTION.
- 3. WHEN THE SIDE ROAD LIES BETWEEN THE BEGINNING OF THE MAINLINE SIGNING AND THE WORK ZONE, A SINGLE HEADED ARROW (MG-1) SHALL BE USED IN LIEU OF THE DOUBLE HEADED ARROW (MG-4).

SCALE: NONE

- B. FOR A LANE CLOSURE ON A SIDE ROAD OR DRIVEWAY:
- USE APPLICABLE PORTIONS OF THE TYPICAL APPLICATION OF TRAFFIC CONTROL DEVICES (STD. 701501, STD. 701606 OR THE APPROPRIATE STANDARD). THE SPACING OF SIGNS AND BARRICADES SHALL BE ADJUSTED FOR FIELD CONDITIONS AS DIRECTED BY THE ENGINEER. THE DIRECTIONAL ARROW SHALL BE COVERED OR REMOVED WHEN NO LONGER CONSISTENT WITH THE SIDE ROAD LANE CLOSURE.
- C. ADVANCE WARNING SIGNS ARE TO BE OMITTED ON DRIVEWAY LINLESS OTHERWISE NOTED.
- D. THE TRAFFIC CONTROL AND PROTECTION FOR SIDE ROADS, INTERSECTIONS, AND DRIVEWAYS SHALL BE INCIDENTAL TO THE COST OF SPECIFIED TRAFFIC CONTROL STANDARDS OR ITEMS.

All dimensions are in millimeters (inches) unless otherwise shown.



USER NAME = gaglianobt	DESIGNED - LHA	REVISED - J. OBERLE 10-18-95
	DRAWN -	REVISED - A. HOUSEH 03-06-96
PLOT SCALE = 50.000 '/ IN.	CHECKED -	REVISED - A. HOUSEH 10-15-96
PLOT DATE = 1/4/2008	DATE - 06-89	REVISED -T. RAMMACHER 01-06-0

STATE	OF	ILLINOIS
DEPARTMENT	OF	TRANSPORTATION


TRAFFIC CONTROL AND PROTECTION FOR			F.A RTE.	SECTION	COUNTY	TOTAL SHEETS	SHEET NO.		
SIDE ROADS, INTERSECTIONS, AND DRIVEWAYS			JB-1 (11)	DUPAGE	13	9			
SIDE NUADS, INTERSECTIONS, AND DRIVERVATS					TC-10	CONTRACT	NO.	60R88	
SHEET NO. 1	1 OF	5 SHEETS	STA.	TO STA.	FEO. R	DAD DIST. NO. 1 JULINOIS FED. A	D PROJECT		

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USER NAME = gaglianobt DESIGNED REVISED - R. MIRS 09-15-97 DRAWN REVISED - R. MIRS 12-11-97 LOT SCALE = 50.000 '/ IN. CHECKED REVISED -T. RAMMACHER 02-02-9 LOT DATE = 1/4/2008 DATE REVISED - C. JUCIUS 01-31-07



SECTION ARTERIAL ROAD JB-1 (11) INFORMATION SIGN CONTRACT NO. 60R88 TC-22 SHEET NO. 2 OF 5 SHEETS STA. TO STA. FED. ROAD DIST. NO. 1 | ILLINOIS FED. AID PROJECT

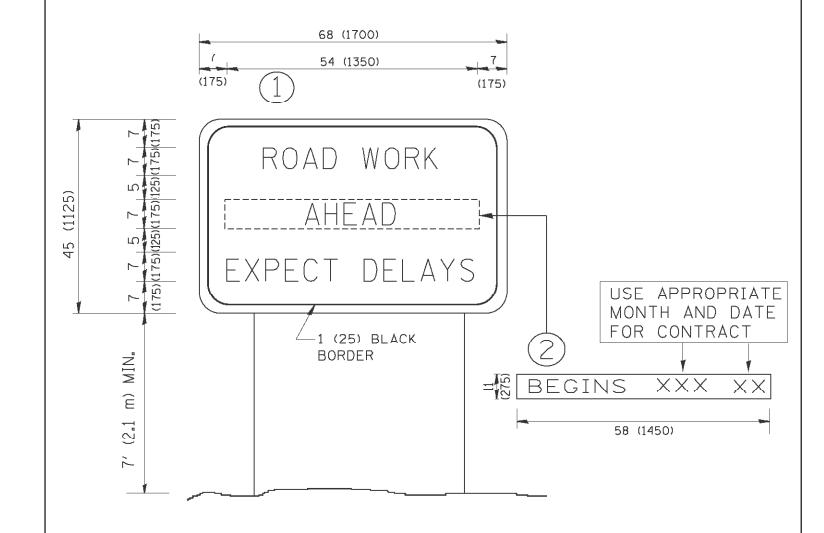

NOTES:

1. USE BLACK LETTERING ON ORANGE BACKGROUND.

SCALE: NONE

- 2. ERECT SIGNS IN ADVANCE OF THE LOCATION FOR THE "ROAD CONSTRUCTION AHEAD" SIGN AT LOCATIONS AS DIRECTED BY THE ENGINEER.
- 3. ERECT SIGN (1) WITH INSTALLED PANEL (2) ONE WEEK PRIOR TO THE START OF CONSTRUCTION.
- 4. REMOVE PANEL (2) SOON AFTER THE START OF CONSTRUCTION.
- 5. SEE SPECIAL PROVISION FOR "TEMPORARY INFORMATION SIGNING" FOR ADDITIONAL INFORMATION.
- 6. ONE SIGN ASSEMBLY EQUALS 25.70 SQ. FT. (2.3 SQ. M.)
- 7. SHALL BE PAID FOR AS TEMPORARY INFORMATION SIGNING.

ALL DIMENSIONS ARE IN INCHES (MILLIMETERS) UNLESS OTHERWISE SHOWN.

DUPAGE

13 10

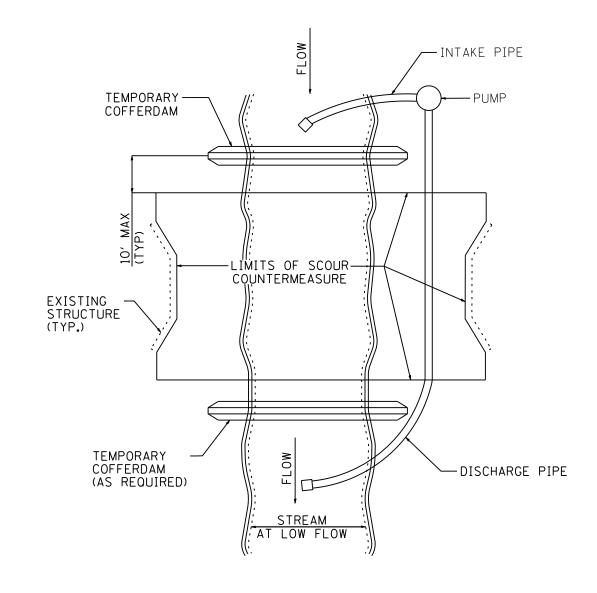


FIGURE D1. TEMPORARY COFFERDAM WITH PUMP BYPASS

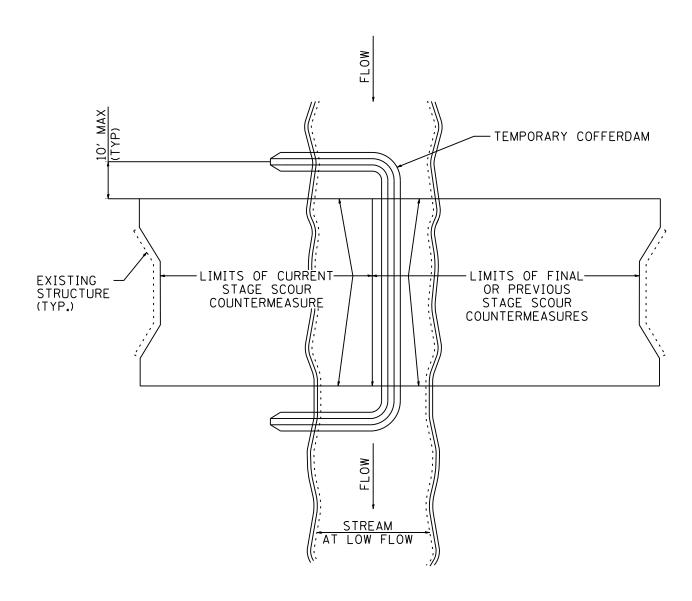


FIGURE D2. STAGED IN-STREAM COFFERDAM DIVISION

NOTE: DEWATERING SYSTEM DETAILS SHALL BE USED IN CONJUCTION WITH THE PROJECT SPECIAL PROVISIONS.

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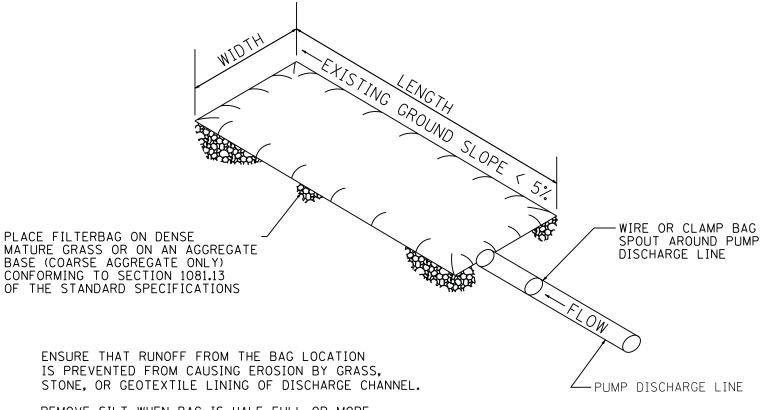
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PLOT SCAL	LE = N/A	CHECKED	-		REVISED	-	
PLOT DATE	E = 2/15/2012	DATE	-	2/15/12	REVISED	-	

STATE OF ILLINOIS
DEPARTMENT OF TRANSPORTATION

DEWATERING SYSTEM DETAILS					F.A. RTE.	SEC	COUNTY	TOTAL SHEETS	SHEE NO.		
	SCOUR COUNTERMEASURES – VARIOUS LOCATION						JB-1 (11)		DUPAGE	13	11
									CONTRACT	NO.	60R
	SCALE: N/A	SHEET NO. 3 OF	5 SHEETS	STA.	TO STA.	FED. RO	FED. ROAD DIST. NO. ILLINOIS FED. AID PROJEC				



REMOVE SILT WHEN BAG IS HALF FULL OR MORE OFTEN IF RECOMMENDED BY THE MAUNFACUTURER. DISPOSE OF SILT BY TRANSPORTING THE FILLED BAG TO DISPOSAL AREA. SLIT THE BAG, BLEND SILT INTO EXISTING TOPOGRAPHY, SEED AND MULCH

MAINTAIN EXTRA FILTER BAGS ON SITE. REPLACE DAMAGED BAGS PROMPTLY.

TYPICAL FLOW RATE: 10 GPM x W x L

FIGURE S1. SEDIMENT FILTER BAG

NOTE: DEWATERING SYSTEM DETAILS SHALL BE USED IN CONJUCTION WITH THE PROJECT SPECIAL PROVISIONS.

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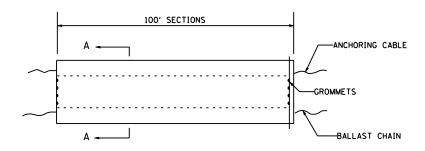
DEWATERING SYSTEM DETAILS
SCOUR COUNTERMEASURES - VARIOUS LOCATION

A SHEET NO. 4 OF 5 SHEETS STA. TO STA.


F.A. RTE. SECTION COUNTY TOTAL SHEETS NO.

JB-1 (11) DUPAGE 13 12

CONTRACT NO. 60R88



ELEVATION

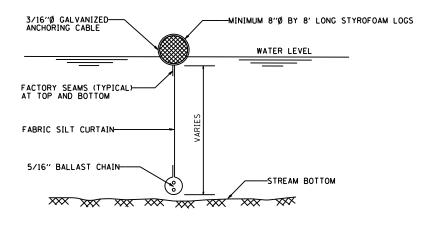


SECTION A-A

FLOTATION BOOM

NOTES:

- FLOTATION BOOM SHALL BE ANCHORED TO PREVENT DRIFT SHOREWARD OR DOWNSTREAM. ANCHORAGES SHALL BE INSTALLED ON BOTH SHORE AND STREAM SIDE.
- SHORE ANCHORS SHALL CONSIST OF A POST WITH DEADMAN OR APPROVED EQUAL. STREAM ANCHORS SHALL BE SUFFICIENT SIZE TO STABILIZE THE BARRIER WITH NUMBER AND SPACING DEPENDENT ON WATERWAY VELOCITIES.
- 3. FABRIC SECTIONS SHALL BE CONNECTED END TO END WITH MINIMUM 5/8" DIAMETER POLYPROPYLENE ROPE
- 4. DESIGN OF BOOM AND ANCHORAGE SHALL BE IN ACCORDANCE WITH MANUFACTURER'S RECOMMENDATIONS. BOTTOM OF BOOM SHALL REACH BOTTOM OF WATERWAY USING ONE OR TWO VERTICAL SECTIONS AS REQUIRED.
- 5. MAINTENANCE SHALL BE PERFORMED AS NEEDED. CONTRACTOR SHALL REMOVE THE BOOM AT COMPLETION OF WORK IN A MANNER THAT WILL PREVENT SILTATION OF THE WATERWAY.

APPLICATION: FLOTATION BOOMS TO BE USED TO CONTROL EROSION, TURBIDITY AND DEBRIS WHEN WORKING IN WATERWAYS.

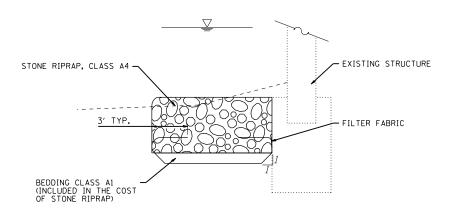

FILTER FABRIC/ RIPRAP DETAIL

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STATE OF ILLINOIS
DEPARTMENT OF TRANSPORTATION

_	DEWATERING SYSTEM DETAILS SCOUR COUNTERMEASURES – VARIOUS LOCATION					F.A. RTE.	F.A. SECTION		COUNTY	TOTAL	SHEET NO.
							JB-1 (11)		DUPAGE	13	13
									CONTRACT	NO.	60R88
	SCALE: N/A	SHEET NO. 5 OF	5 SHEETS	STA.	TO STA.	FED. R	, ROAD DIST, NO. ILLINOIS FED. AID PROJECT				