
04-27-12 LETTING ITEM 078

NDEX OF SHEETS

- 1. COVER SHEET, INDEX OF SHEETS
- 2. GENERAL NOTES & LIST OF STATE STANDARDS
- 3. SUMMARY OF QUANTITIES & TYPICAL SECTIONS
- 4. SIDEWALK AND SIGNAGE PLAN
- 5. SITE PLAN PRATT AVENUE AND EAST PRAIRIE AVENUE TRAFFIC CALMING
- 6. SITE PLAN EAST PRAIRIE AVENUE AND MORSE AVENUE TRAFFIC CALMING
- 7-8. DETAILS

FULL SIZE PLANS HAVE BEEN PREPARED USING STANDARD ENGINEERING SCALES. REDUCED SIZED PLANS WILL NOT CONFORM TO STANDARD SCALES. IN MAKING MEASUREMENTS ON REDUCED PLANS, THE BELOW SCALES MAY BE USED.

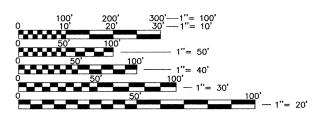



CONTRACTOR IS RESPONSIBLE FOR CONTACTING J.U.L.I.E. AT 1-800-892-0123
AND MUST ACQUIRE A DIG NUMBER A MINIMUM OF 72 HOURS PRIOR TO ANY
WORK BEING DONE

CONTRACT NO. 63685

FILE NAME 9232.386 DT-1

JGRAM


STATE OF ILLINOIS DEPARTMENT OF TRANSPORTATION DIVISION OF HIGHWAYS

PLANS FOR PROPOSED SAFETY IMPROVEMENTS

VARIOUS LOCATIONS
SAFE ROUTE TO SCHOOLS

SECTION: 10-00055-00-SP JOB NO. C-40-013-10 PROJECT NO. SRTS-4009(065)

VILLAGE OF LINCOLNWOOD COOK COUNTY

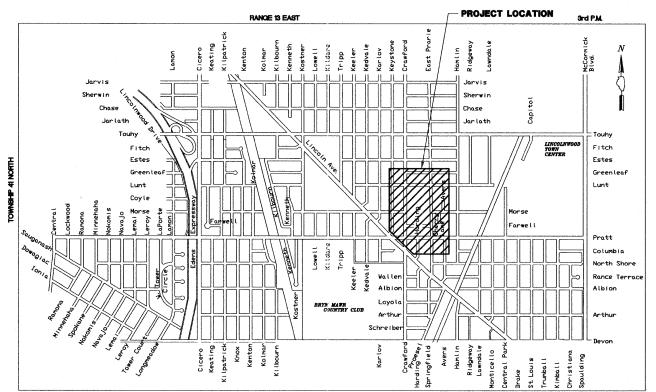

NILES TOWNSHIP

LOCATION MAP

(NOT TO SCALE)

PROJECT INFORMATION

GROSS AND NET LENGTH = N/A

ADT = VARIES FROM 6,300 TO 13,000 VPD

POSTED SPEED LIMIT = VARIES FROM 25 TO 35 MPH

ROAD CLASSIFICATION = URBAN COLLECTOR

GEWALT HAMILTON

PROJECT LOCATED IN THE


VILLAGE OF LINCOLNWOOD


850 Forest Edge Drive Vernon Hills, IL. 60061

ALU. SECTION COUNTY TOTAL SHEET NO.

/A 10-00055-00-SP COOK 8 I

CONTRACT NO. 63685

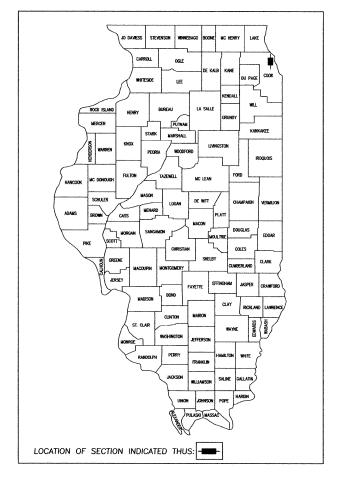

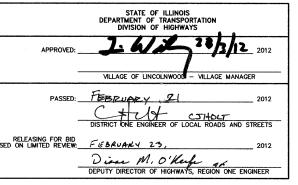



PRINTED BY THE AUTHORITY
OF THE STATE OF ILLINOIS

GENERAL NOTES

A-1 THE ILLINOIS DEPARTMENT OF TRANSPORTATION "STANDARD SPECIFICATIONS FOR ROAD AND BRIDGE CONSTRUCTION" LATEST EDITION, THE "STANDARD SPECIFICATIONS FOR WATER AND SEWER MAIN CONSTRUCTION IN ILLINOIS" LATEST EDITION, PROJECT SPECIFICATIONS, ALL APPLICABLE REQUIREMENTS OF THE ILLINOIS ENVIRONMENTAL PROTECTION AGENCY MUNICIPALITY ORDINANCES OF AUTHORITIES HAVING JURISDICTION AND ALL ADDENDA THERE SHALL GOVERN THIS WORK.

A-2 ALL REFERENCES TO "ENGINEER" SHALL BE INTERPRETED TO MEAN THE RESIDENT ENGINEER.

A-3 NO CONSTRUCTION PLANS SHALL BE USED FOR CONSTRUCTION UNLESS SPECIFICALLY MARKED A—3 NO CONSTRUCTION PLANS SHALL BE USED FOR CONSTRUCTION UNLESS SPECIFICALLY MARKED FOR CONSTRUCTION. PRIOR TO COMMENCEMENT OF CONSTRUCTION, THE CONTRACTOR SHALL VERIFY ALL DIMENSIONS, AND CONDITIONS AFFECTING THEIR WORK WITH THE ACTUAL CONDITIONS AT THE JOB SITE. IN ADDITION, THE CONTRACTOR MUST VERIFY THE ENGINEERS LINE AND GRADES. IF THERE ARE ANY DISCREPANCIES FROM WHAT IS SHOWN ON THE CONSTRUCTION PLANS, STANDARD SPECIFICATIONS AND/OR SPECIAL DETAILS, THE CONTRACTOR SHALL SECURE WRITTEN INSTRUCTION FROM THE ENGINEER PRIOR TO PROCEEDING WITH ANY PART OF THE WORK AFFECTED BY OMISSION OR DISCREPANCIES. FAILING TO SECURE SUCH INSTRUCTION, THE CONTRACTOR WILL BE CONSIDERED TO HAVE PROCEEDED AT HIS OWN RISK AND EXPENSE. IN THE EVENT OF ANY DOUBT OR QUESTION ARISING WITH RESPECT TO THE TRUE MEANING OF THE CONSTRUCTION PLANS OR SPECIFICATIONS. THE DECISION OF THE FINGLE REP SHALL BE FINAL AND CONCLUSIVE. OR SPECIFICATIONS, THE DECISION OF THE ENGINEER SHALL BE FINAL AND CONCLUSIVE.

A-4 IT IS THE CONTRACTOR'S RESPONSIBILITY TO ASCERTAIN EXISTING FIELD CONDITIONS PRIOR

A-5 EASEMENTS FOR THE EXISTING UTILITIES, BOTH PUBLIC AND PRIVATE, AND UTILITIES WITHIN PUBLIC RIGHTS-OF-WAY ARE SHOWN ON THE PLANS ACCORDING TO AVAILABLE RECORDS. THE CONTRACTOR SHALL BE RESPONSIBLE FOR DETERMINING THE EXACT LOCATION IN THE FIELD OF THESE UTILITY LINES AND THEIR PROTECTION FROM DAMAGE DUE TO CONSTRUCTION OPERATIONS. IF EXISTING UTILITY LINES OF ANY NATURE ARE ENCOUNTERED WHICH CONFLICT IN LOCATION WITH NEW CONSTRUCTION, THE CONTRACTOR SHALL NOTIFY THE ENGINEER SO THAT THE CONFLICT MAY BE RESOLVED

A-6 SAW CUTTING OF PAVEMENTS, SIDEWALK, ETC. SHALL BE TO FULL DEPTH AND SHALL RESULT IN A CLEAN STRAIGHT EDGE ON THE PORTION REMAINING. ALL SAW CUTTING SHALL BE CONSIDERED INCLUDED IN THE COST OF THE ITEM REMOVED.

A-7 THE CONTRACTOR SHALL PROTECT AND CAREFULLY PRESERVE ALL SECTION OR SUBSECTION MONUMENTS, PROPERTY CORNERS, AND REFERENCE MARKERS UNTIL THE ENGINEER, OR AN AUTHORIZED SURVEYOR HAS WITNESSED OR OTHERWISE REFERENCED THEIR LOCATIONS.

A-8 WHENEVER, DURING CONSTRUCTION OPERATIONS, LOOSE MATERIAL IS DEPOSTIED IN THE FLOW LINE OF GUTTERS, DRAINAGE STRUCTURES, DITCHES, ETC. SUCH THAT THE NATURAL FLOW LINE OF WATER IS OBSTRUCTED, THE LOOSE MATERIAL WILL BE REMOVED AT THE CLOSE OF EACH WORKING DAY, AT THE CONCLUSION OF CONSTRUCTION OPERATION, ALL DRAINAGE STRUCTURES AND FLOW LINES SHALL BE FREE FROM DIRT AND DEBRIS. THIS WORK SHALL BE CONSIDERED INCLUDED IN THE COST OF THE CONTRACT. THE CONTRACTOR'S FAILURE TO PROVIDE THE ABOVE WILL PRECLUDE ANY POSSIBLE ADDED COMPENSATION REQUESTED DUE TO DELAYS OR UNSUITABLE MATERIALS CREATED AS A RESULT THEREOF

-9 ALL CURB SHALL BE TIED TO THE EXISTING CONCRETE PAVEMENT. THE TIE BAR SHALL BE DRILLED A MINIMUM 6" INTO THE EXISTING CONCRETE BASE COURSE AND PROTRUDE A MINIMUM 6" IN THE NEW CONCRETE CURB AND GUTTER. TIE BARS SHALL BE #6 EPOXY COATED BARS AND PLACED 24" O.C.

STORM SEWERS, WATER MAINS, AND UTILITIES

B-1 THE CONTRACTOR IS RESPONSIBLE FOR CONTACTING JULIE PRIOR TO THE START OF

B-2 THE CONTRACTOR SHALL BE RESPONSIBLE FOR THE PROTECTION OF ALL UNDERGROUND AND SURFACE UTILITIES EVEN THOUGH THEY MIGHT NOT BE SHOWN ON THE PLANS. ANY UTILITY PROPERTY DAMAGED DURING CONSTRUCTION SHALL BE REPAIRED OR REPLACED TO THE SATISFACTION OF THE ENGINEER AT THE CONTRACTOR'S EXPENSE.

 $B\!-\!3$ THE VILLAGE OF LINCOLNWOOD SHALL BE NOTIFIED A MINIMUM 3 DAYS PRIOR TO THE START OF CONSTRUCTION AT $847\!-\!673\!-\!1540.$

B-4 THE CONTRACTOR SHALL ENSURE THAT ALL WATER SYSTEM VALVE VAULTS, AND SANITARY SEWER MANHOLES REMAIN READILY ACCESSIBLE TO THE VILLAGE FOR EMERGENCY OPERATIONS. THE LOCATIONS OF ALL WATER AND SANITARY FACILITIES SHALL BE MARKED AND READILY VISIBLE

TRAFFIC CONTROL

D-1 SEE TRAFFIC CONTROL HIGHWAY STANDARDS CONCERNING TRAFFIC CONTROL AND

<u>DEBRIS REMOVAL</u>
MATERIALS RESULTING FROM THE REMOVAL OF ASPHALT SURFACES, UTILITY ADJUSTMENTS, RESTORATION WORK,
ETC. SHALL BE REMOVED AT THE END OF EACH DAY TO AN APPROVED SITE. IN THE JUDGEMENT OF THE VILLAGE, SHOULD IT BE NECESSARY TO REMOVE SUCH MATERIALS, THE VILLAGE WILL HAVE THE MATERIAL REMOVED AND THE CONTRACTOR SHALL BE BILLED (CHARGED) ACCORDINGLY.

HE INDISCRIMINATE USE OF FIRE HYDRANTS, EXISTING STREAMS, CREEKS, WETLANDS OR PONDS IS STRICTLY THE INDISCRIBINATE USE OF FIRE HIDRANIS, EASING STREAMS, CREERS, WELFANDS OF FUNDS IS STREAM PROHIBITED. THE CONTRACTOR SHALL PROVIDE A WATER TRUCK AND DRIVER AS REQUIRED TO OBTAIN AND TRANSPORT THIS WATER. THE CONTRACTOR SHALL BE RESPONSIBLE FOR OBTAINING WATER FROM AN APPROVED SOURCE OTHER THAN HIS YARD, WRITTEN APPROVAL FROM THE AGENCY HAVING JURISDICTION FOR THE SOURCE OF THE WATER MUST BE RECEIVED BY THE CONTRACTOR PRIOR TO USE OF THE WATER.

IT WILL BE THE CONTRACTOR'S RESPONSIBILITY TO NOTIFY RESIDENTS AND THE VILLAGE WHEN ACCESS TO THEIR DRIVEWAYS WILL BE TEMPORARILY CLOSED DUE TO SIDEWALK REPLACEMENT, AND/OR DRIVEWAY REPLACEMENT. AT LOCATIONS WHERE THE DRIVEWAY IS SCHEDULED TO BE REMOVED, THE CONTRACTOR SHALL CONTACT THE BUSINESS/HOMEOWNER 24 HOURS PRIOR TO REMOVING THE CURB, SIDEWALK, OR DRIVE APPROACH. EVERY EFFORT SHALL BE MADE TO ACCOMMODATE ACCESS TO THESE PROPERTIES. THE CONTRACTOR SHALL NOT BE ALLOWED TO CLOSE A DRIVEWAY FOR MORE THAN 1 DAY UNDER UNLESS THE DRIVEWAY IS CLOSED FOR THE PURPOSE OF CURING CONCRETE PLACED AS A PART OF THIS CONTRACT. THE CONTRACTOR SHALL BE RESPONSIBLE FOR MAINTAINING THE BARRICADES TO PREVENT TRAFFIC FROM USING THE DRIVEWAYS DURING THIS PERIOD.

STREET SWEEPING AND PREPARATION
THE CONTRACTOR SHALL BE RESPONSIBLE FOR SWEEPING AND CLEANING STREETS OF ANY DEBRIS AND MATERIAL
THAT HAS ACCUMULATED AS A RESULT OF THE CONSTRUCTION ACTIVITY. A MECHANICAL SWEEPER, MECHANICALLY
DRIVEN AIR AND HANDWORK WITH SHOVEL AND BROOM SHALL BE UTILIZED TO PROVIDE A CLEAN STREET FOR THE
MOTORING PUBLIC, WITHIN 24 HOURS OF PLACING PRIME COAT AND THE LAYING OF HMA, THE CONTRACTOR SHALL SWEEP THE PAVEMENT AND REMOVE STANDING WATER, EARTH, WEEDS, LEAVES, DIRT, CONSTRUCTION DEBRIS AND ALL LOOSE MATERIAL.

HIGHWAY STANDARDS:

000001-06	STANDARD	SYMBOLS.	ABBREVIATIONS,	AND	PATTERNS

424001-06 PERPENDICULAR CURB RAMPS				
	424001-06	PERPENDICULAR	CURB	RAMPS

602001-02 CATCH BASIN TYPE A 604001-03 FRAME AND LIDS TYPE 1

606001-04 CONCRETE CURB TYPE B AND COMBINATION CONC CURB AND GUTTER

701301-04 LANE CLOSURE, 2L, 2W, SHORT TIME OPERATIONS

701311-03 LANE CLOSURE, 2L, 2W, MOVING OPERATIONS-DAY ONLY

701501-06 LANE CLOSURE, 2L, 2W, UNDIVIDED

701601-07 URBAN LANE CLOSURE, MULTILANE, 1W OR 2W WITH NONTRAVERSABLE MEDIAN 701602-05 URBAN LANE CLOSURE, MULTILANE, 2W WITH BIDIRECTIONAL LEFT TURN LANE

URBAN LANE CLOSURE, MULTILANE, 2W WITH MOUNTABLE MEDIAN 701606-08

URBAN LANE CLOSURE, MULTILANE INTERSECTION 701701-08

701801-05 SIDEWALK, CORNER OR CROSSWALK CLOSURE

701901-02 TRAFFIC CONTROL DEVICES

720001-01 SIGN PANEL MOUNT DETAILS 720006-03 SIGN PANEL ERECT DETAILS

METAL POST FOR SIGNS MARKERS AND DELINEATORS 720011-01

729001-01 APPLICATIONS OF TYPES A AND B POSTS

TYPICAL PAVEMENT MARKINGS 780001-03

DISTRICT 1 STANDARDS

DAVENENT DECUDE

TRAFFIC CONTROL AND PROTECTION PLAN FOR SIDE ROADS, INTERSECTIONS AND DRIVEWAYS

TC-13 TYPICAL PAVEMENT MARKINGS

HOT-MIX ASPHALT MIXTURE REQUIREMENTS

MI.	XIUKE IT	PE				AI	K V	70105	
ACING									_
CHDEVOE	COLIBEE	MIX 'D'	NEO	/IL 0.5	\ n"	197	a 5	O CVP	_

	ASPHALT	SURFACE	COURSE,	MIX	'D',	N50,	(IL	9.5	mm)	2"	4%	0	50	GYR
DRIVEWAY	r'S													
HOT-MIX	ASPHALT	SURFACE	COURSE,	MIX	'n,	N50,	(IL	9.5	mm)	3"	4%	0	50	GYR

THE UNIT WEIGHT TO CALCULATE ALL HMA SURFACE MIXTURE QUANTITIES IS 112 LBS/SQ YD/IN. HMA THE "AC TYPE" SHALL BE "PG 64-22" UNLESS MODIFIED BY DISTRICT ONE SPECIAL PROVISIONS. FOR "PERCENT OF RAP" SEE DISTRICT ONE SPECIAL PROVISIONS.

FILE NAME =	USER NAME = BJW	DESIGNED -	BJW	REVISED -	1/10/2012
9232.386 DT-1.dwg		DRAWN -	BJW	REVISED -	2/20/2012
	PLOT SCALE = 1:1	CHECKED -	SDB	REVISED -	
	PLOT DATE = 1/10/2012	DATE -	12/9/2011	REVISED -	

•	STAT	E OF	ILLINOIS	
DEPARTI	MENT	OF T	RANSPOR	TATION

VILLAGE OF	LINCOLNWOD - SA	FE ROUTE TO SCHOOLS	F.A.U RTE.	SECTION	COUNTY	TOTAL SHEETS	SHEET NO.
GENERA	I NOTES & LIST OF	STATE STANDARDS	N/A	10-00055-00-SP	COOK	8	2
GLITLIA	L NOTES & LIST OF	OTATE OTANDANDO			CONTRACT ;	#: 63	685
SCALE: N.T.S.	SHEET NO. 2 OF 8 SHEETS	STA. TO STA.		ILLINOIS FED. AI	D PROJECT		

SUMMARY OF QUANTITIES

Code#	Item	Unit	Quantity		Code#	
	EARTH EXCAVATION	CUYD	45			TRAFFIC CONT
20800150	TRENCH BACKFILL	CUYD	11		70102625	TRAFFIC CONT
28000500	INLET AND PIPE PROTECTION	EACH	16		70102630	TRAFFIC CONT
35101600	AGGREGATE BASE COURSE, TYPE B, 4"	SQ YD	310		70102632	TRAFFIC CONT
35300500	PORTLAND CEMENT CONCRETE BASE COURSE, 10"	SQ YD	125		70102635	TRAFFIC CONT
40600100	BITUMINOUS MATERIALS (PRIME COAT)	GALLON	65		70102640	TRAFFIC CONT
40603335	HOT-MIX ASPHALT SURFACE COURSE, MIX "D", N50	TON	95	*	72000100	SIGN PANEL -
42400200	PORTLAND CEMENT CONCRETE SIDEWALK 5"	SQFT	5,300		72400100	REMOVE SIGN
42400800	DETECTABLE WARNINGS	SQFT	400		72400200	REMOVE SIGN
44000100	PAVEMENT REMOVAL	SQ YD	400		72400310	REMOVE SIGN
44000157	HOT-MIX ASPHALT SURFACE REMOVAL, 2"	SQ YD	775	*	72900100	METAL POST -
44000200	DRIVEWAY PAVEMENT REMOVAL	SQ YD	22	*	72900200	METAL POST -
44000500	COMBINATION CURB AND GUTTER REMOVAL	FOOT	890	*	78000100	THERMOPLAS
44000600	SIDEWALK REMOVAL	SQFT	5,150	*	78000200	THERMOPLAS
44213204	TIE BARS 3/4"	EACH	540	*	78000600	THERMOPLAS
550B2500	STORM SEWERS, RUBBER GASKET, CLASS B, TYPE 2 8"	FOOT	20	*	78000650	THERMOPLAS
55100300	STORM SEWER REMOVAL 8"	FOOT	10		78300100	PAVEMENT MA
60200105	CATCH BASIN, TYPE A, 4' DIAMETER, TYPE 1 FRAME, OPEN LID	EACH	4	*	84200600	REMOVAL OF
60234200	INLETS, TYPE A, TYPE 1 FRAME, OPEN LID	EACH	5	*	84200804	REMOVAL OF
60250200	CATCH BASINS TO BE ADJUSTED	EACH	2		X0325225	BRICK PAVEM
60265700	VALVE VAULTS TO BE ADJUSTED	EACH	5		X2110104	TOPSOIL AND
60500050	REMOVING CATCH BASINS	EACH	7		X4240430	PORTLAND CE
60500060	REMOVING INLETS	EACH	1	*	X7200105	SIGN PANEL -
60603800	COMBINATION CONCRETE CURB AND GUTTER, TYPE B-6.12	FOOT	1,225		Z0004510	HOT-MIX ASPH
67400400	MOBILIZATION	L SUM	1			

	1				
ity		Code#	Item	Unit	Quantity
45		70102620	TRAFFIC CONTROL AND PROTECTION, STANDARD 701501	LSUM	1
11		70102625	TRAFFIC CONTROL AND PROTECTION, STANDARD 701606	L SUM	1
16		70102630	TRAFFIC CONTROL AND PROTECTION, STANDARD 701601	LSUM	1
10		70102632	TRAFFIC CONTROL AND PROTECTION, STANDARD 701602	LSUM	1
25		70102635	TRAFFIC CONTROL AND PROTECTION, STANDARD 701701	L SUM	1
65		70102640	TRAFFIC CONTROL AND PROTECTION, STANDARD 701801	L SUM	1
95		72000100	SIGN PANEL - TYPE 1	SQFT	150
00		72400100	REMOVE SIGN PANEL ASSEMBLY - TYPE A	EACH	10
00		72400200	REMOVE SIGN PANEL ASSEMBLY - TYPE B	EACH	5
00		72400310	REMOVE SIGN PANEL - TYPE 1	SQFT	150
					100
75	*	72900100	METAL POST - TYPE A	FOOT	100
22	*	72900200	METAL POST - TYPE B	FOOT	50
90	*	78000100	THERMOPLASTIC PAVEMENT MARKING - LETTERS AND SYMBOLS	SQFT	415
50	*	78000200	THERMOPLASTIC PAVEMENT MARKING - LINE 4"	FOOT	1,000
40	*	78000600	THERMOPLASTIC PAVEMENT MARKING - LINE 12"	FOOT	1,800
20	*	78000650	THERMOPLASTIC PAVEMENT MARKING - LINE 24"	FOOT	475
10		78300100	PAVEMENT MARKING REMOVAL	SQFT	2,000
4	*	84200600	REMOVAL OF LIGHTING UNIT, NO SALVAGE	EACH	1
5	*	84200804	REMOVAL OF POLE FOUNDATION	EACH	1
		V0005005	REDOVE DAVIENCE DE MOVAL AND DEED ACCAMENT		
2		XU325225	BRICK PAVEMENT REMOVAL AND REPLACEMENT	SQFT	115
5		X2110104	TOPSOIL AND SOD FURNISH AND PLACE, 4" (SPECIAL)	SQ YD	350
7		X4240430	PORTLAND CEMENT CONRETE SIDEWALK 5 INCH, (SPECIAL)	SQFT	380
1	*	X7200105	SIGN PANEL - TYPE 1 (SPECIAL)	SQ FT	38
25		70004510	HOT-MIX ASPHALT DRIVEWAY PAVEMENT, 3"	SQ YD	40
L)		20004010	DIOTHIN AUTHALI DINVEYVATEAVENIENT, 3	שני וט	40

R.O.W.

40'

21.5' (VARIES)

11' (VARIES)

VARIES


VARIES

F

(F)

EXISTING TYPICAL CROSS SECTION

PRATT AVENUE

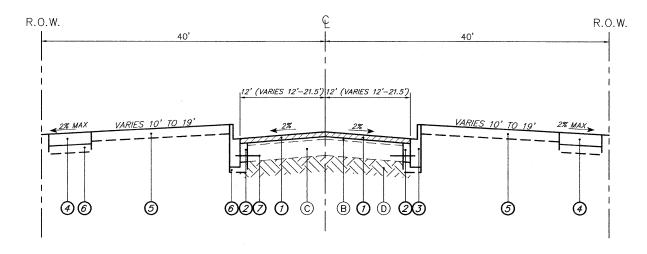

PROPOSED TYPICAL CROSS SECTION

PRATT AVENUE BUMPOUT LOCATION

EXISTING LEGEND

- (A) HMA SURFACE REMOVAL, 2"
- B EXISTING HMA PAVEMENT 2" & VARIES
- © EXISTING PCC PAVEMENT 8" & VARIES
- D EXISTING SUBGRADE
- E EXISTING B6.12 CC&G REMOVAL
- (F) EXISTING SIDEWALK
- © PROPOSED FULL DEPTH SAWCUT
- FULL DEPTH PAVEMENT REMOVAL

PROPOSED LEGEND


- 1 HOT-MIX ASPHALT SURFACE COURSE, 2"
- (2) PCC BASE COURSE, 10"
- (3) COMBINATION CONCRETE CURB & GUTTER, B6.12
- 4 PORTLAND CEMENT CONCRETE SIDEWALK, 5"
- TOPSOIL AND SOD RESTORATION
- 6 AGGREGATE BASE COURSE, 4"
- NO. 6 EPOXY COATED TIE BAR


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	PLOT SCALE = 1:1	CHECKED	-	SDB	REVISED	-	
	PLOT DATE = 1/10/2012	DATE	_	12/9/2011	REVISED	_	


STATE OF ILLINOIS
DEPARTMENT OF TRANSPORTATION


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	SUMM	IARY	OF	QUA	NT	TIES	& -	TYPICA	L SECTION	IS	N//
CALE	N.T.S.	SHE	ET NO.	3 OF	8 :	SHEETS	5	TA.	TO STA		

	FAU RTE	SECT	ION		T	COUNTY	TOTAL SHEETS	SHEET NO.
	N/A	10-00055	5-00-S	P	T	COOK	8	3
					1	CONTRACT	# 63	685
1			ILLINOIS	FED.	AID	PROJECT		

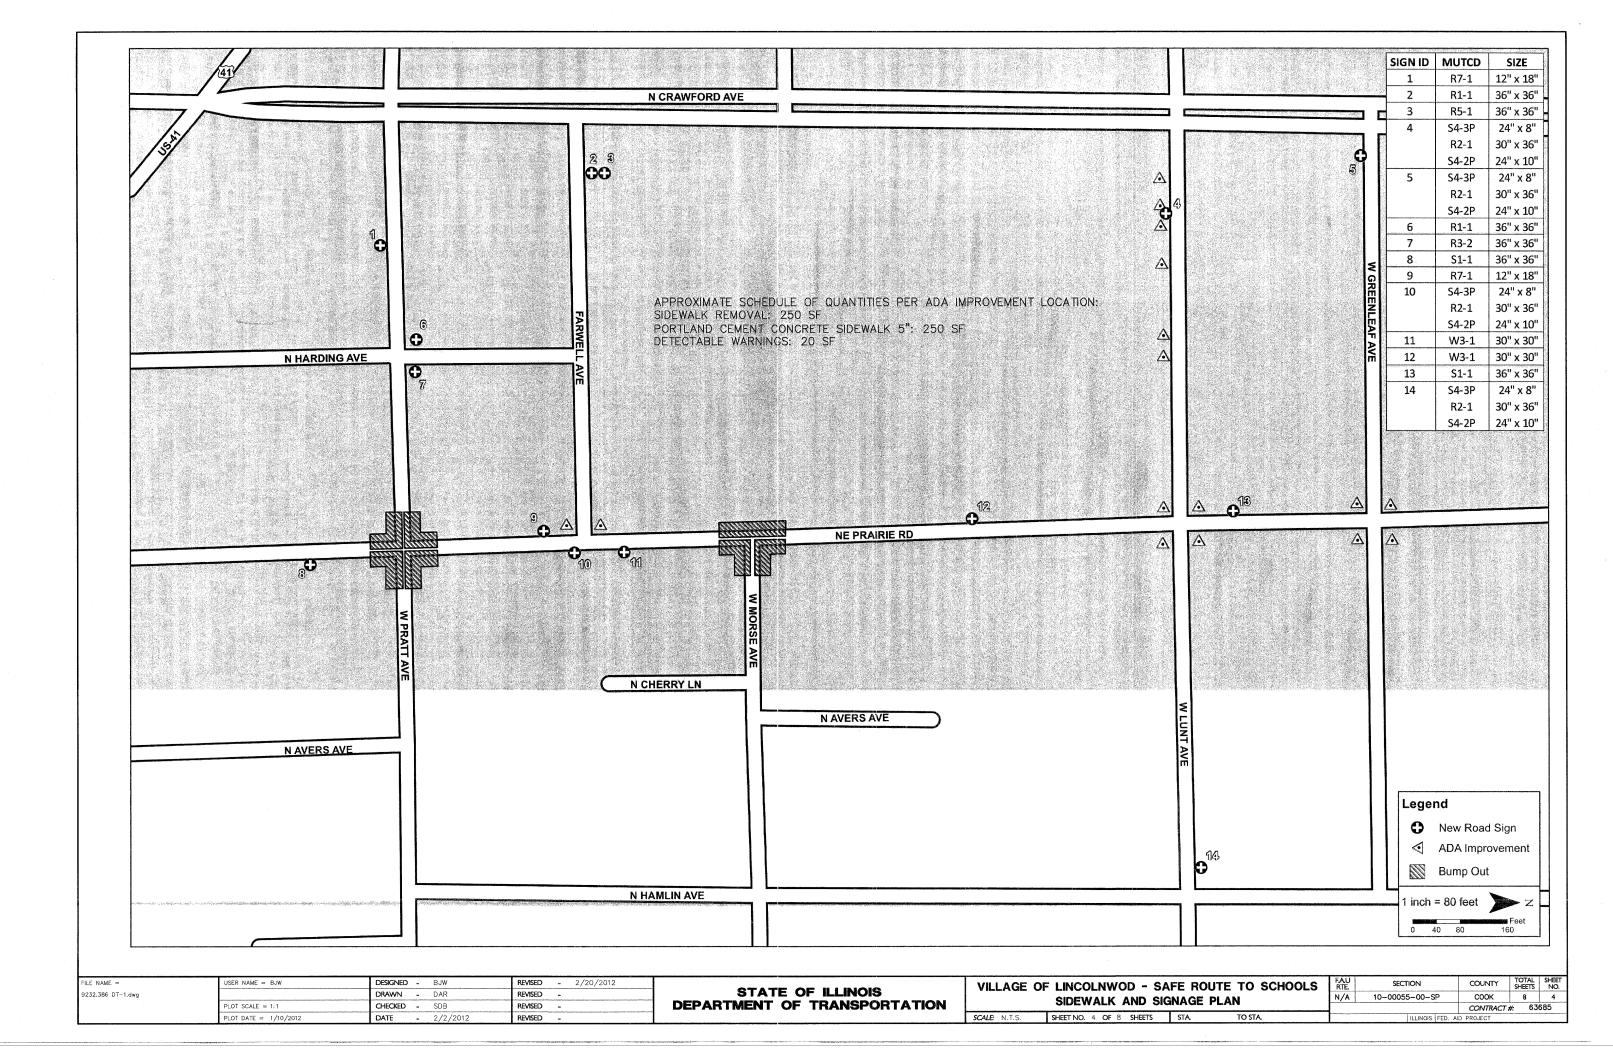

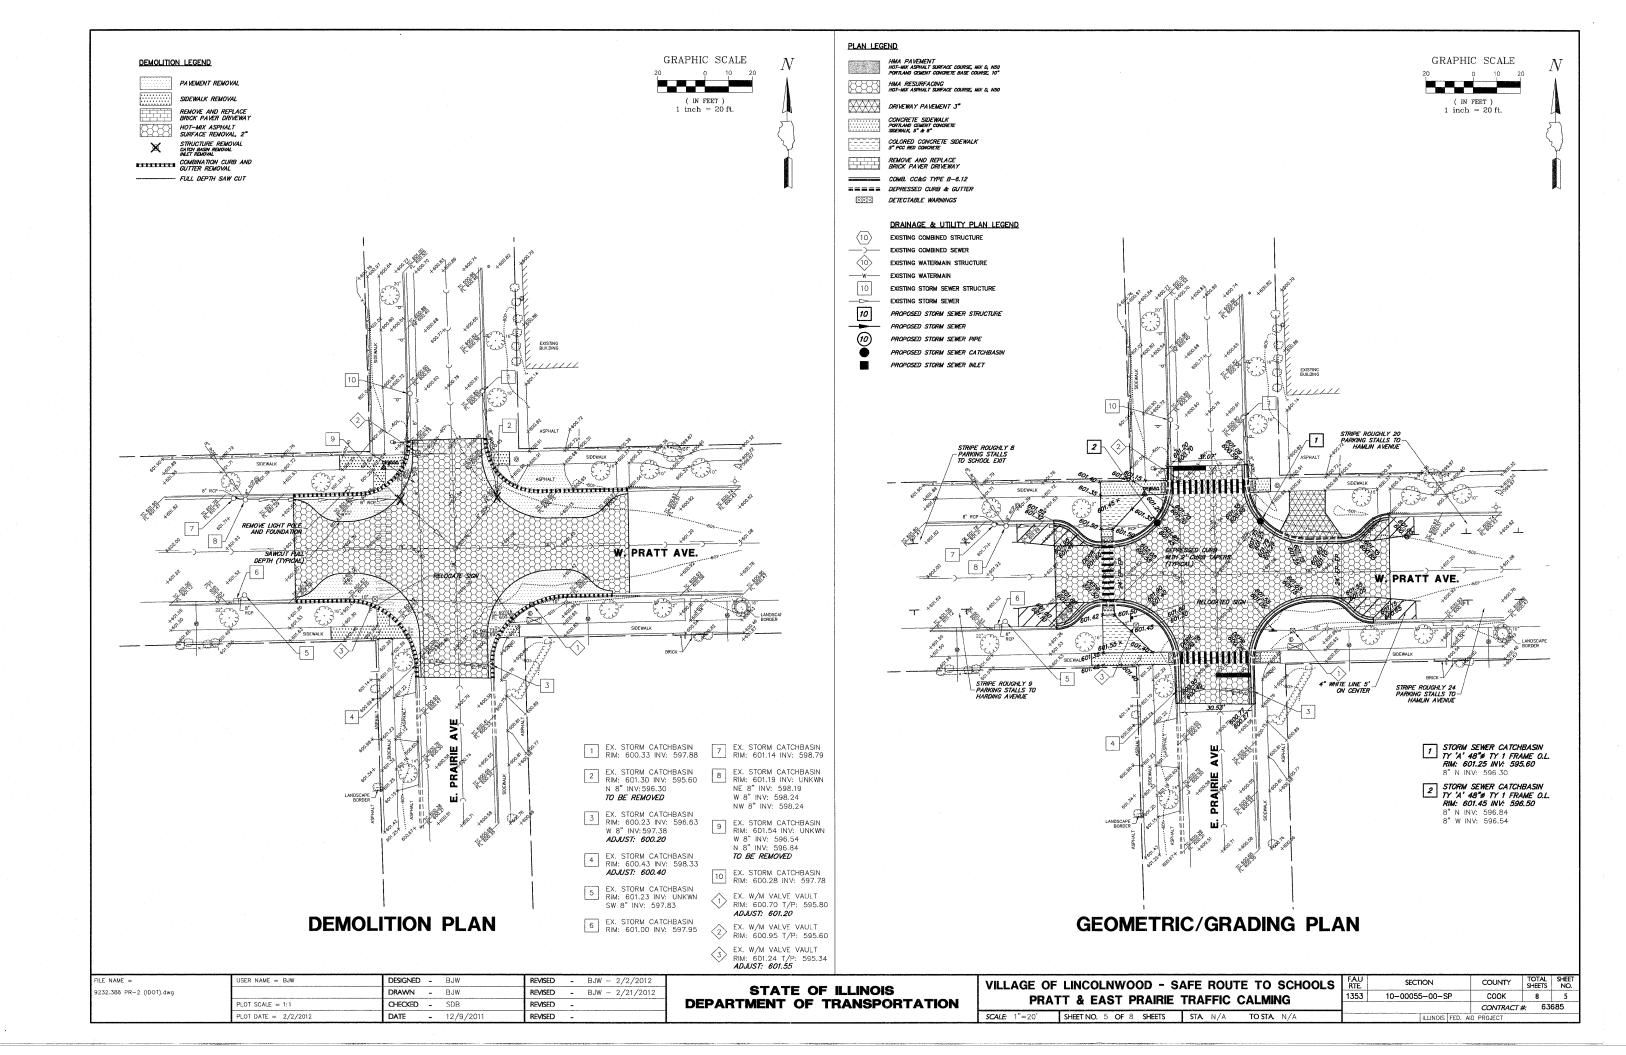

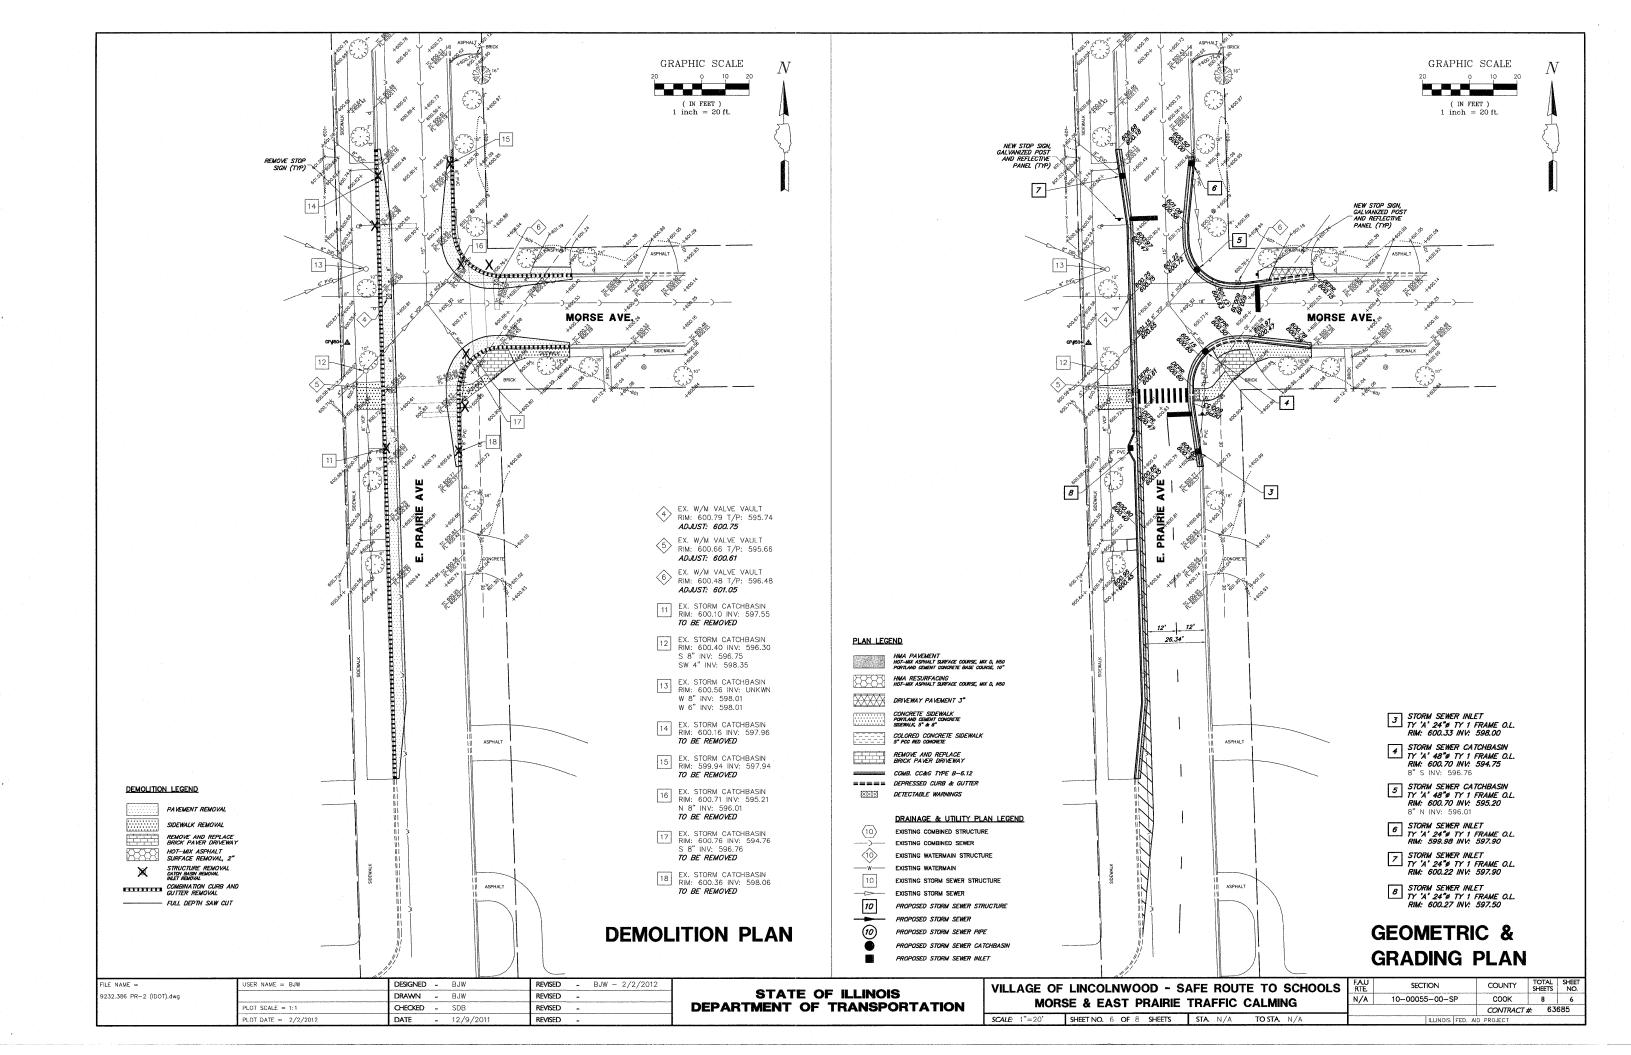

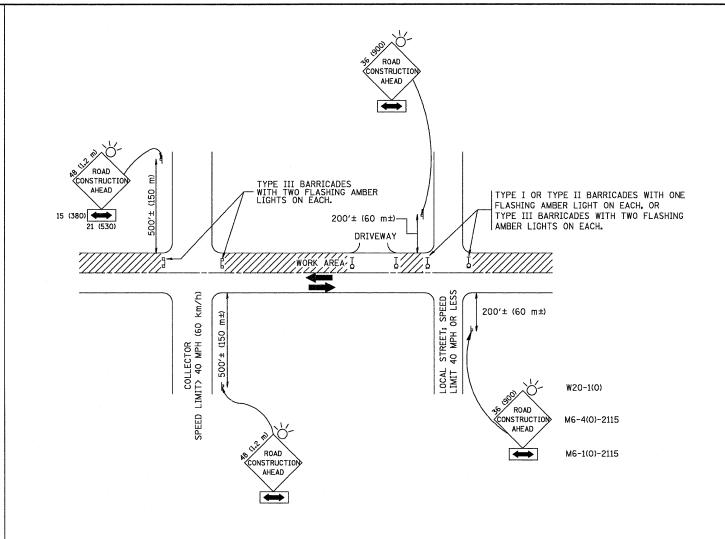

NOTES:

- A. FOR NO LANE RESTRICTION ON THE SIDE ROAD OR DRIVEWAYS
- 1. SIDE ROAD WITH A SPEED LIMIT OF 40 MPH (60 km/h) OR LESS AS SHOWN ON THE DRAWING AND AS DIRECTED BY THE ENGINEER:
- d) ONE **ROAD CONSTRUCTION AMEAD** SIGN 36 × 36 (900×900) WITH A FLASHER AND FLAG MOUNTED ON IT APPROXIMATELY 200' (60 m) IN ADVANCE
- b) THE CLOSED PORTION OF THE MAIN ROUTE SHALL BE PROTECTED BY BLOCKING WITH TYPE I, TYPE II OR TYPE III BARRICADES, 1/3 OF THE CROSS SECTION OF THE CLOSED PORTION.
- 2. SIDE ROAD WITH A SPEED LIMIT GREATER THAN 40 MPH (60 km/h) AS SHOWN ON THE DRAWING AND AS DIRECTED BY THE ENGINEER:
- a) ONE ROAD CONSTRUCTION AHEAD SIGN 48 x 48 (1.2 m x 1.2 m) WITH A FLASHER MOUNTED ON IT APPROXIMATELY 500' (150 m) IN ADVANCE OF THE MAIN ROUTE.
- b) THE CLOSED PORTION OF THE MAIN ROUTE SHALL BE PROTECTED BY BLOCKING WITH TYPE III BARRICADES, 1/2 OF THE CROSS SECTION
- 3. WHEN THE SIDE ROAD LIES BETWEEN THE BEGINNING OF THE MAINLINE SIGNING AND THE WORK ZONE, A SINGLE HEADED ARROW (MG-1) SHALL BE USED IN LIEU OF THE DOUBLE HEADED ARROW (M6-4).

- B. FOR A LANE CLOSURE ON A SIDE ROAD OR DRIVEWAY:
- USE APPLICABLE PORTIONS OF THE TYPICAL APPLICATION OF TRAFFIC CONTROL DEVICES (STD. 701501, STD. 701606 OR THE APPROPRIATE STANDARD). THE SPACING OF SIGNS AND BARRICADES SHALL BE ADJUSTED FOR FIELD CONDITIONS AS DIRECTED BY THE ENGINEER. THE DIRECTIONAL ARROW SHALL BE COVERED OR REMOVED WHEN NO LONGER CONSISTENT WITH THE SIDE ROAD LANE CLOSURE.
- C. ADVANCE WARNING SIGNS ARE TO BE OMITTED ON DRIVEWAY UNLESS OTHERWISE NOTED.
- D. THE TRAFFIC CONTROL AND PROTECTION FOR SIDE ROADS, INTERSECTIONS, AND DRIVEWAYS SHALL BE INCIDENTAL TO THE COST OF SPECIFIED TRAFFIC CONTROL STANDARDS OR ITEMS.


All dimensions are in millimeters (inches)


unless otherwise shown.

FILE NAME = JSER NAME == BJW DESIGNED - LHA REVISED - J. OBERLE 10-18-95 STATE OF ILLINOIS 9232.386 DT-1.dwg DRAWN **REVISED** - A. HOUSEH 03-06-96 **DEPARTMENT OF TRANSPORTATION** PLOT SCALE = CHECKED -**REVISED** - A. HOUSEH 10-15-96 PLOT DATE = 1/10/2012 DATE REVISED - T. RAMMACHER 01-06-0


TRAFFIC CONTROL AND PROTECTION FOR SIDE ROADS, INTERSECTIONS, AND DRIVEWAYS SCALE: NONE SHEET NO. 7 OF 8 SHEETS STA.

GHA #9232,386
TOTAL SHEET
SHEETS NO. SECTION COUNTY N/A 10-00055-00-SP COOK 8 7 TC-10 CONTRACT #: 63685

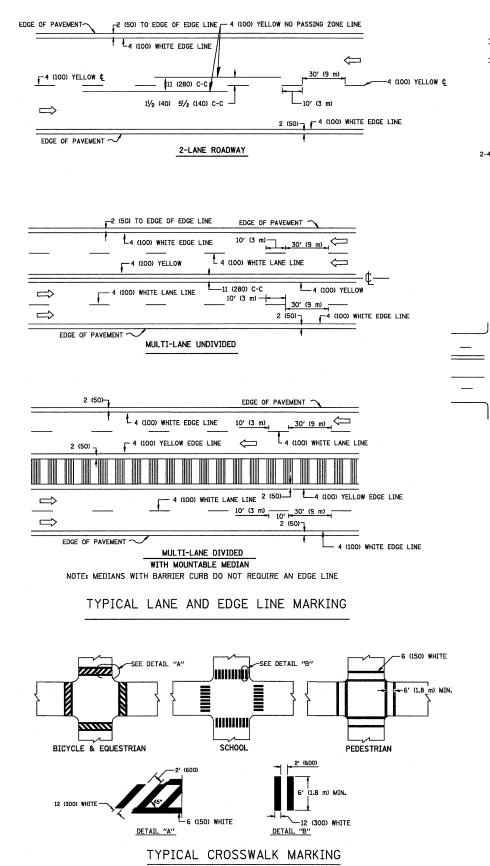

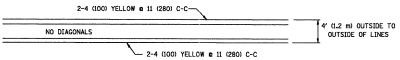


4' (1.2 m) WIDE MEDIANS ONLY

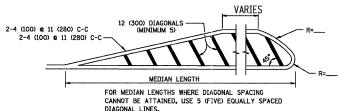


DIAGONAL LINE SPACING: 50' (15 m) C-C (LESS THAN 30MPH (50 km/h)) 75' (25 m) C-C 30MPH (50 km/h) T0 45MPH (70 km/h)) 150' (45 m) C-C (MORE THAN 45MPH (70 km/h))

MEDIANS OVER 4' (1.2 m) WIDE

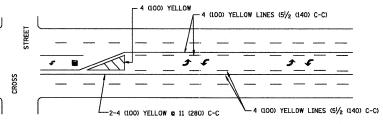


A MINIMUM OF TWO PAIRS OF TURN ARROWS SHALL BE USED, WHITE IN COLOR. ADDITIONAL PAIRS SHALL BE PLACED AT 200' (60 m) TO 300' (90 m) INTERVALS.

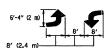

MEDIAN WITH TWO-WAY LEFT TURN LANE

TYPICAL PAINTED MEDIAN MARKING

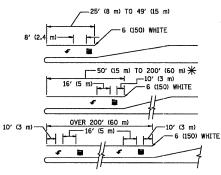


FULL SIZE LETTERS 8' (2.4 m) AND ARROWS SHALL BE USED. \P AREA = 15.6 SQ. FT. (1.5 m²) MLY AREA = 20.8 SQ. FT. (1.9 m²)

* TURN LANES IN EXCESS OF 400' (120 m) IN LENGTH MAY HAVE AN ADDITIONAL SET OF ARROW - "ONLY" INSTALLED MIDWAY BETWEEN THE OTHER TWO SETS OF ARROW - "ONLY".

TYPICAL LEFT (OR RIGHT) TURN LANE

TYPICAL TURN LANE MARKING

8 (200) WHITE 12 (300) WHITE DIAGONALS 1 10' (3 m) OR LESS SPACING ISLAND OFFSET FROM PAVEMENT EDGE

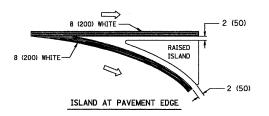

TYPICAL ISLAND MARKING

TYPE OF MARKING	WIDTH OF LINE	PATTERN	COLOR	SPACING / REMARKS	
CENTERLINE ON 2 LANE PAVEMENT	4 (100)	SKIP-DASH	YELLOW	10' (3 m) LINE WITH 30' (9 m) SPACE	
CENTERLINE ON MULTI-LANE UNDIVIDED PAVEMENT	2 2 4 (100)	SOLID	YELLOW	11 (280) C-C	
NO PASSING ZONE LINES: FOR ONE DIRECTION FOR BOTH DIRECTIONS	4 (100) 2 @ 4 (100)	SOLID SOLID	YELLOW	5½ (140) C-C FROM SKIP-DASH CENTERLINE 11 (280) C-C OMIT SKIP-DASH CENTERLINE BETWEEN	
LANE LINES	4 (100) 5 (125) ON FREEWAYS	SKIP-DASH SKIP-DASH	WHITE WHITE	10' (3 m) LINE WITH 30' (9 m) SPACE	
DOTTED LINES (EXTENSIONS OF CENTER, LANE OR TURN LANE MARKINGS)	SAME AS LINE BEING EXTENDED	SKIP-DASH	SAME AS LINE BEING EXTENDED	2' (600) LINE WITH 6' (1.8 m) SPACE	
EDGE LINES	4 (100)	SOLID	YELLOW-LEFT WHITE-RIGHT	OUTLINE MOUNTABLE MEDIANS IN YELLOW: EDGE LINES ARE NOT USED NEXT TO BARRIER CURB	
TURN LANE MARKINGS	6 (150) LINE; FULL SIZE LETTERS & SYMBOLS (8' (2.4m))	SOLID	WHITE	SEE TYPICAL TURN LANE MARKING DETAIL	
TWO WAY LEFT TURN MARKING	2 @ 4 (100) EACH DIRECTION	SKIP-DASH AND SOLID	YELLOW	10' (3 m) LINE WITH 30' (9 m) SPACE FOR SKIP-DASH; 5½ (140) C-C BETWEEN SOLID LINE AND SKIP-DASH LINE	
	8' (2.4m) LEFT ARROW	IN PAIRS	WHITE	SEE TYPICAL TWO-WAY LEFT TURN MARKING DETAIL	
CROSSWALK LINES (PEDESTRIAN) A. DIAGONALS (BIKE & EQUESTRIAN) B. LONGITUDINAL BARS (SCHOOL)	2 @ 6 (150) 12 (300) @ 45° 12 (300) @ 90°	SOLID SOLID SOLID	WHITE WHITE WHITE	NOT LESS THAN 6' (1.8 m) APART 2' (600) APART 2' (600) APART SEE TYPICAL CROSSWALK MARKING DETAILS.	
STOP LINES	24 (600)	SOLID	WHITE	PLACE 4' (1.2 m) IN ADVANCE OF AND PARALLEL TO CROSSWALK, IF PRESENT. OTHERWISE, PLACE AT DESIRED STOPPING POINT. PARALLEL TO CROSSROAD CENTERLINE, WHERE POSSIBLE	
PAINTED MEDIANS	2 @ 4 (100) WITH 12 (300) DIAGONALS @ 45° NO DIAGONALS USED FOR 4' (1.2 m) WIDE MEDIANS	SOLID	YELLOW: TWO WAY TRAFFIC WHITE: ONE WAY TRAFFIC	11 (280) C-C FOR THE DOUBLE LINE SEE TYPICAL PAINTED MEDIAN MARKING.	
GORE MARKING AND CHANNELIZING LINES	8 (200) WITH 12 (300) DIAGONALS @ 45°	SOLID	WHITE	DIAGONALS: 15' (4.5 m) C-C (LESS THAN 30MPH (50 km/h)) 20' (6 m) C-C 30MPH (50 km/h) TO 45MPH (70 km/h)) 30' (9 m) C-C (OVER 45MPH (70 km/h))	
RAILROAD CROSSING	24 (600) TRANSVERSE LINES; "RR" IS 6' (1.8 ml LETTERS; 16 (400) LINE FOR "X"	SOLID	WHITE	SEE STATE STANDARD 780001 AREA OF: "R"=3.6 SQ. FT. (0.33 m ²) EACH "X"=54.0 SQ. FT. (5.0 m ²)	
SHOULDER DIAGONALS	12 (300) @ 45°	SOLID	WHITE - RIGHT YELLOW - LEFT	50' (15 m) C-C (LESS THAN 30MPH (50 km/h)) 75' (25 m) C-C (30 MPH (50 km/h) TO 45MPH (70 km/h)) 150' (45 m) C-C (OVER 45MPH (70 km/h))	

FOR FURTHER DETAILS ON PAVEMENT MARKING REFER TO STANDARD SPECIFICATIONS FOR ROAD AND BRIDGE CONSTRUCTION AND STATE STANDARD 780001.

All dimensions are in inches (millimeters) unless otherwise shown.

TYPICAL PAVEMENT MARKINGS

FILE NAME =	USER NAME = BJW	DESIGNED - EVERS	REVISED - T. RAMMACHER 10-27-
9232.386 DT-1.dwg		DRAWN -	REVISED - C. JUCIUS 09-09-0
	PLOT SCALE =	CHECKED -	REVISED -
	PLOT DATE = 1/10/2012	DATE - 03-19-90	REVISED -

STATE OF ILLINOIS DEPARTMENT OF TRANSPORTATION

								GHA #9:	232.386
DISTRICT ONE			FAU. RTE. SECTION		COUNTY	TOTAL SHEETS	SHEET NO.		
	TYPICAL PAVEMENT MARKINGS			N/A 10-00055-00-SP		LAKE	8	8	
Ì				TC-13		CONTRACT #:		63685	
	SCALE: NONE S	HEET NO. 8 OF 8 SHEETS	STA.	TO STA.	FED. ROAD DIST. NO. 1 ILLUNOIS FED. AID PROJECT				