PITTSFIELD PENSTONE MUNICIPAL CONSTRUCTION PLANS FOR

PITTSFIELD, PIKE COUNTY, ILLINOIS

EXPAND THE APRON

AIP PROJECT NO. 3-17-0081-B14

MARCH 23, 2012

	SUMMARY OF QUANTITIES	TITIES		
ITEM NO.	DESCRIPTION	UNIT	AS BID QUANTITY	AS BUILT QUANTITY
AR152410	UNCLASSIFIED EXCAVATION	CN. YD	2,513	
AR156512	BALES	EACH	14	
AR401613	BIT. SURF. CSE.—METHOD I, SUPERPAVE	NOT	842	
AR401655	BUTT JOINT CONSTRUCTION	SQ. YD.	145	
AR401901	REMOVE BITUMINOIS SURFACE COURSE	SQ. YD.	426	
AR403613	BIT. BASE CSE.—METHOD I, SUPERPAVE	TON	1,609	
AR510510	TIE DOWN	EACH	33	
AR603510	BITUMINOUS TACK COAT	GAL.	446	
AR620520	PAVEMENT MARKING-WATERBORNE	SQ. FT.	511	
AR620900	PAVEMENT MARKING REMOVAL	SQ. FT.	56	
AR901510	SEEDING	ACRE	0.6	
AR908510	MULCHING	ACRE	0.6	

YICINITY MAP	U.S. R.E. SA	PITTSFIELD PENSTONE MUNICIPAL AIRPORT

8	6-7	5	4	3	2	1	NO.	
EROSION CONTROL PLAN	APRON CROSS SECTIONS	TIEDOWN AND MARKING LAYOUT AND DETAILS	APRON LAYOUT AND STAKING PLAN	TYPICAL SECTION AND SPECIAL DETAILS	IMPROVEMENT AND SAFETY PLAN	COVER SHEET	DESCRIPTION	INDEX TO SHEETS

/30/2013	Se Constant		W. C. B.	
SUBMITTED _ X		JACKSONVILLE, ILLINO	HUTCHISON ENGINEERIN	TLANS TRETARED BY :


EXPIRES 11,

JOB NO. 3081 3081Y001 1=1

ENGINEER'S SEAL DATE ______ NG, INC. APPROVED Literative ___ CITY CLERK APPROVED

CITY OF PITTSFIELD, ILLINOIS

SH. 1 OF 8 SHTS.

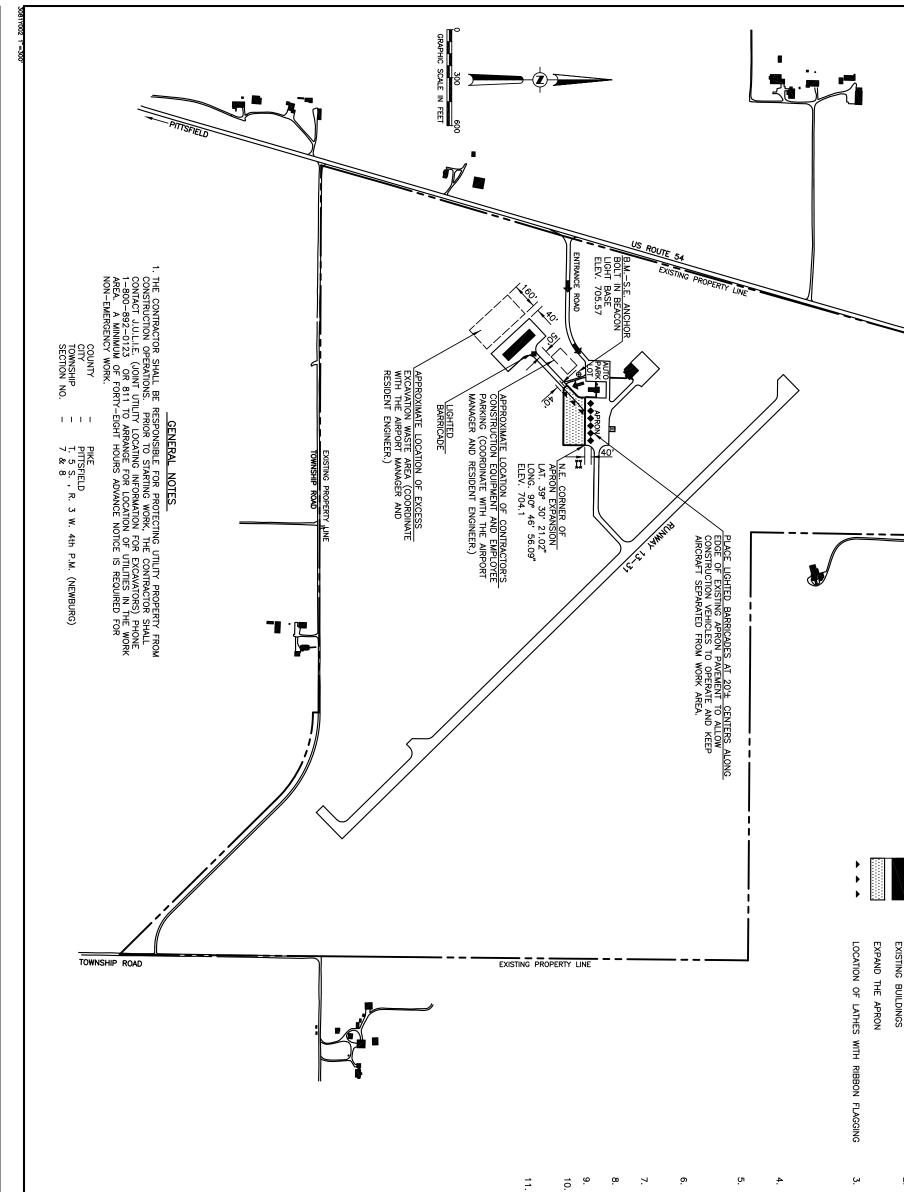

CONSTRUCTION PROCEDURE NOTES

ALL CONTRACTOR EMPLOYEES WILL PARK THEIR PERSONAL VEHICLES IN THE AREA DESIGNATED IN THESE PLANS FOR USE AS A VEHICLE PARKING AREA. ONLY AUTHORIZED CONTRACTOR VEHICLES WILL BE ALLOWED ON THE AIR OPERATIONS AREA OF THE AIRPORT AND ON THE CONSTRUCTION SITE.

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CONTRACTOR'S ACCESS/HAUL ROUTE

LEGEND

LOCATION OF LIGHTED BARRICADES


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- FLAGS WILL BE REQUIRED ON ALL CONTRACTOR'S VEHICLES AND EQUIPMENT. THE FLAGS SHALL BE THREE (3) FOOT SQUARE CHECKERED FLAGS (INTERNATIONAL ORANGE AND WHITE) DISPLAYED IN FULL VIEW ABOVE THE VEHICLE.
- THE CONTRACTOR WILL USE THE DESIGNATED HAUL ROUTE AND EQUIPMENT STORAGE AREA SHOWN ON THIS SHEET. IT WILL BE THE CONTRACTOR'S RESPONSIBILITY TO MAINTAIN THE DESIGNATED HAUL ROUTE AND EQUIPMENT STORAGE AREA FOR THE DURATION OF THE PROJECT. ANY DAMAGE TO EXISTING PAVEMENTS USED TO HAUL MATERIAL TO THE CONSTRUCTION SITE WILL BE REPAIRED BY THE CONTRACTOR AT HIS OWN EXPENSE TO THE SATISFACTION OF THE AIRPORT MANAGER AND RESIDENT ENGINEER.
- LIGHTED BARRICADES WILL BE PLACED NEXT TO ANY OPEN EXCAVATION THAT IS ADJACENT TO A PAVEMENT BEING UTILIZED BY AIRCRAFT OR GROUND VEHICLES. BARRICADES WILL BE EQUIPPED WITH RED FLASHING LIGHTS.
- THE CONTRACTOR SHALL FURNISH, MAINTAIN, AND REMOVE ALL BARRICADES REQUIRED TO DELINEATE THE WORK AREA AND KEEP ARCRAFT OR GROUND VEHICLES FROM ENGROACHING INTO SAID WORK AREA. THIS REQUIREMENT SHALL BE CONSIDERED INCIDENTAL TO THE CONTRACT AND NO ADDITIONAL COMPENSATION WILL BE ALLOWED.
- CONSTRUCTION ACTIVITY CONTROL AND OPERATION AREA PROTECTION SHALL BE ACCOMPLISHED IN ACCORDANCE WITH FAA ADVISORY CIRCULAR NO. 150/5370-2F.
- THE MAXIMUM CONSTRUCTION EQUIPMENT HEIGHT UTILIZED ON THE AIRPORT FOR THIS PROJECT SHALL BE 25° .
- THIS PROJECT CONSISTS OF WORK TO EXPAND THE APRON PAVEMENT TO THE SOUTH OF THE EXISTING APRON.
- THIS PROJECT WILL DISTURB MORE THAN 1 ACRE OF LAND.
- LATHES WITH RIBBON FLAGGING SPACED AT 50' CENTERS SHALL BE PLACED 40' FROM THE T-HANGAR ACCESS TAXIWAY (2 TO DELINEATE THE LIMITS OF CONSTRUCTION OPERATIONS WHILE THE TAXIWAY IS ACTIVE/OPEN.
- NO WORK SHALL BE PERFORMED WITHIN 40' OF THE $\mathbb Q$ OF THE ACTIVE TAXIWAY . AT SUCH TIME AS WORK IS PERFORMED WITHIN THIS AREA, THE TAXIWAY SHALL BE CLOSED TO AIRCRAFT USAGE.


IMPROVEMENT AND SAFETY PLAN

HUTCHISON ENGINEERING,
JACKSONVILLE, ILLINOIS PROJ. NO. PPQ-4082 PROJ. NO. 3-17-0081-B14 ₹ ?

SH. 2 OF 8 SHTS.

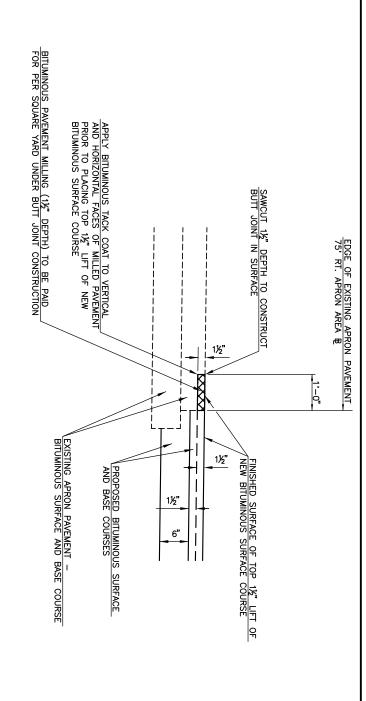

DETAIL A
NOT TO SCALE

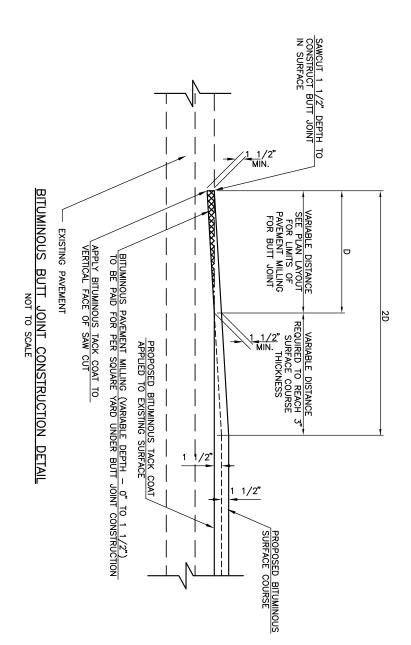

EXISTING APRON PAVEMENT
5"± BITUMINOUS SURFACE OVER
6" BITUMINOUS BASE APRON AREA 75' æ 1'-O" WIDE X 1½" DEEP AREA ALONG THE EDGE OF THE EXISTING PAVEMENT TO BE MILLED OUT TO CONSTRUCT BUTT JOINT IN THE TOP LIFT OF BITUMINOUS SURFACE COURSE. SEE DETAIL A. 0.8% & VAR. PROPOSED 6" BITUMINOUS BASE COURSE - SUPERPAVE (ITEM 403) CONSTRUCTED IN MIN. OF TWO 3" LIFTS 135' PROPOSED 3" BITUMINOUS SURFACE COURSE - SUPERPAVE (ITEM 401) CONSTRUCTED IN TWO 1½" LIFTS j0; 1.5% & & AR. 20' 100 B AN PI015

- NOTES: 1. THE SUBGRADE BENEATH NEW PAVEMENT SHALL BE COMPACTED TO 95% OF MAXIMUM DENSITY OBTAINED BY STANDARD PROCTOR TO A 6" DEPTH IN CUT AREAS AND TO A 9" DEPTH IN EMBANKMENT AREAS. EMBANKMENTS BELOW THE TOP 9" SHALL BE COMPACTED TO 95% OF MAXIMUM DENSITY.
- A BITUMINOUS TACK COAT-ITEM 603 (0.03 GALLONS PER SQUARE YARD) SHALL BE APPLIED BETWEEN THE LIFTS OF NEW BITUMINOUS PAVEMENT.

APRON TYPICAL SECTION NOT TO SCALE

EARTHWORK SUMMARY RT. STA. 19+79 TO STA. 24+20 (APRON AREA B)

UNCLASSIFIED EXCAVATION = 2,513 CU. YD.

EMBANKMENT +30% SHRINKAGE = TOTAL TO BE WASTED = 2,457 CU. YD. 56 CU. YD.

EARTHWORK NOTE : 1. EXCESS EXCAVATION NOTED ABOVE TO BE WASTED SHALL BE HAULED TO THE WASTE AREA SHOWN ON SHEET NO. 2 AND BE PLACED, GRADED AND SHAPED TO DRAIN BY THE CONTRACTOR.

SEEDING NOTES

ALL AREAS DISTURBED BY THIS CONSTRUCTION PROJECT WITHIN THE GRADING LIMITS SHOWN IN THESE CONSTRUCTION PLANS AND THE SEEDING LIMITS SHOWN OUTSIDE THE GRADING LIMITS SHALL BE LIMED, FERTILIZED, SEEDED AND MULCHED. THESE AREAS SHALL CONSTITUTE THE SEEDING AND MULCHING AREAS DESIGNATED FOR PAYMENT.

ALL OTHER AREAS DISTURBED BY THE CONTRACTOR INCLUDING THE CONTRACTOR'S PARKING AREA, WASTE AREA, HAUL ROUTES, ETC. SHALL BE REGRADED, RESEEDED AND MULCHED AS REQUIRED BY THE RESIDENT ENGINEER AND/OR RESTORED TO THEIR ORIGINAL CONDITION BY THE CONTRACTOR AT HIS OWN EXPENSE UPON COMPLETION OF THE IMPROVEMENTS.

A QUANTITY OF 0.6 AC. CONSTITUTES THE AREA FOR PAYMENT.


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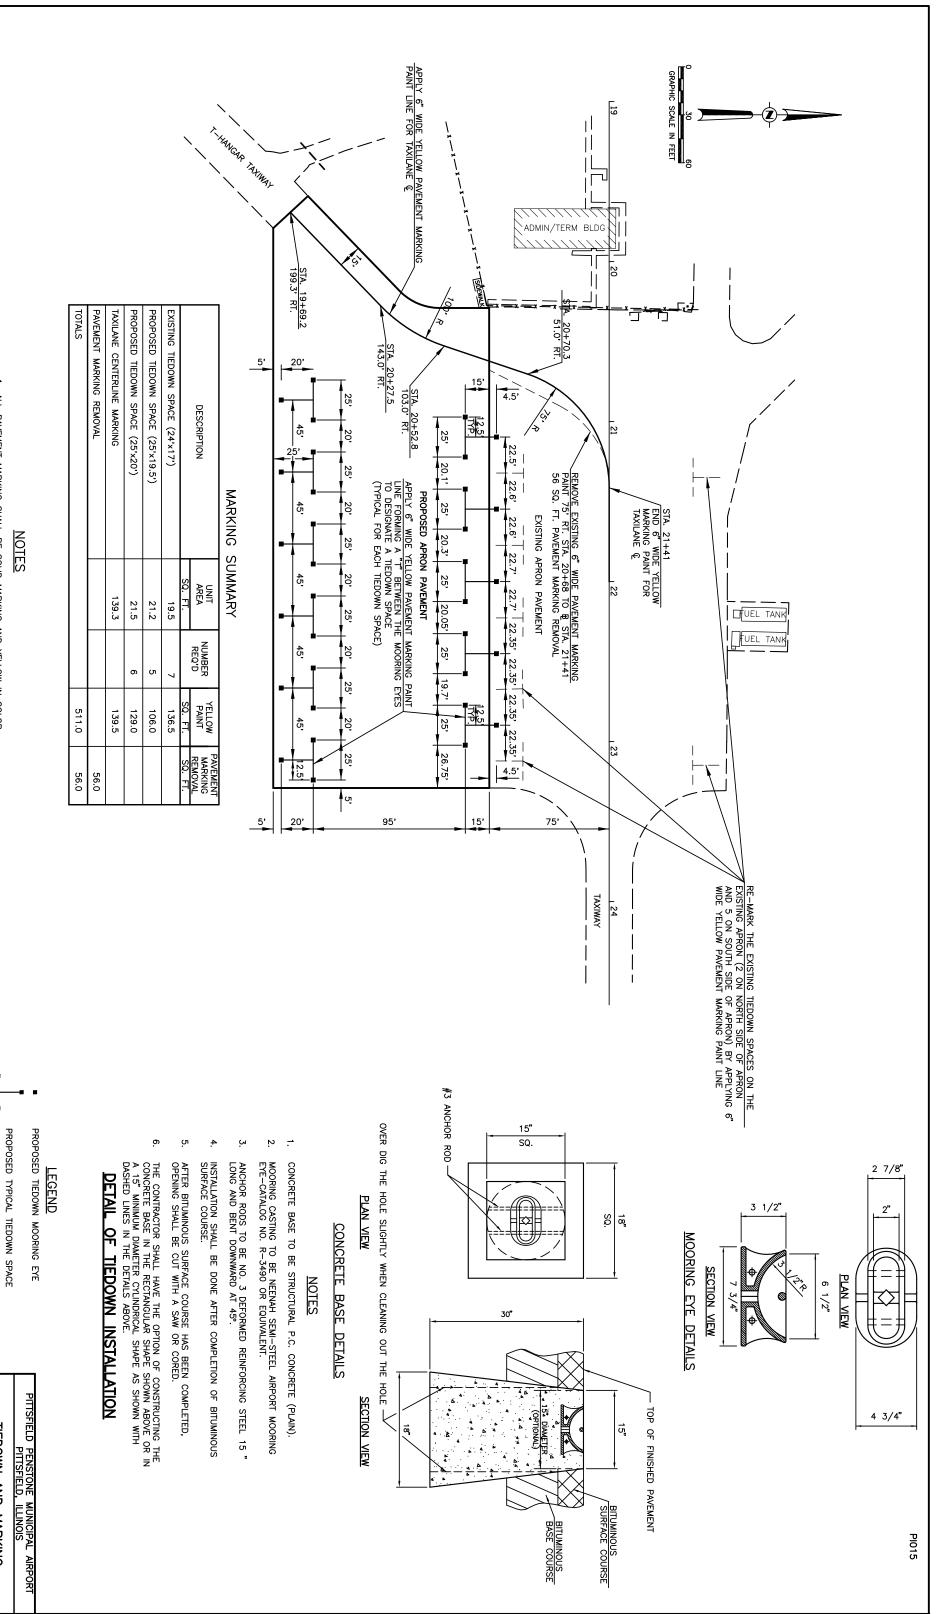
PITTSFIELD PENSTONE MUNICIPAL AIRPORT
PITTSFIELD, ILLINOIS TYPICAL SECTION AND SPECIAL DETAILS

JACKSONVILLE, ILLINOIS

SHT. 3 OF 8 SHTS.

ILL. PROJ. NO. PPQ-4082
AIP PROJECT NO. 3-17-0081-B14



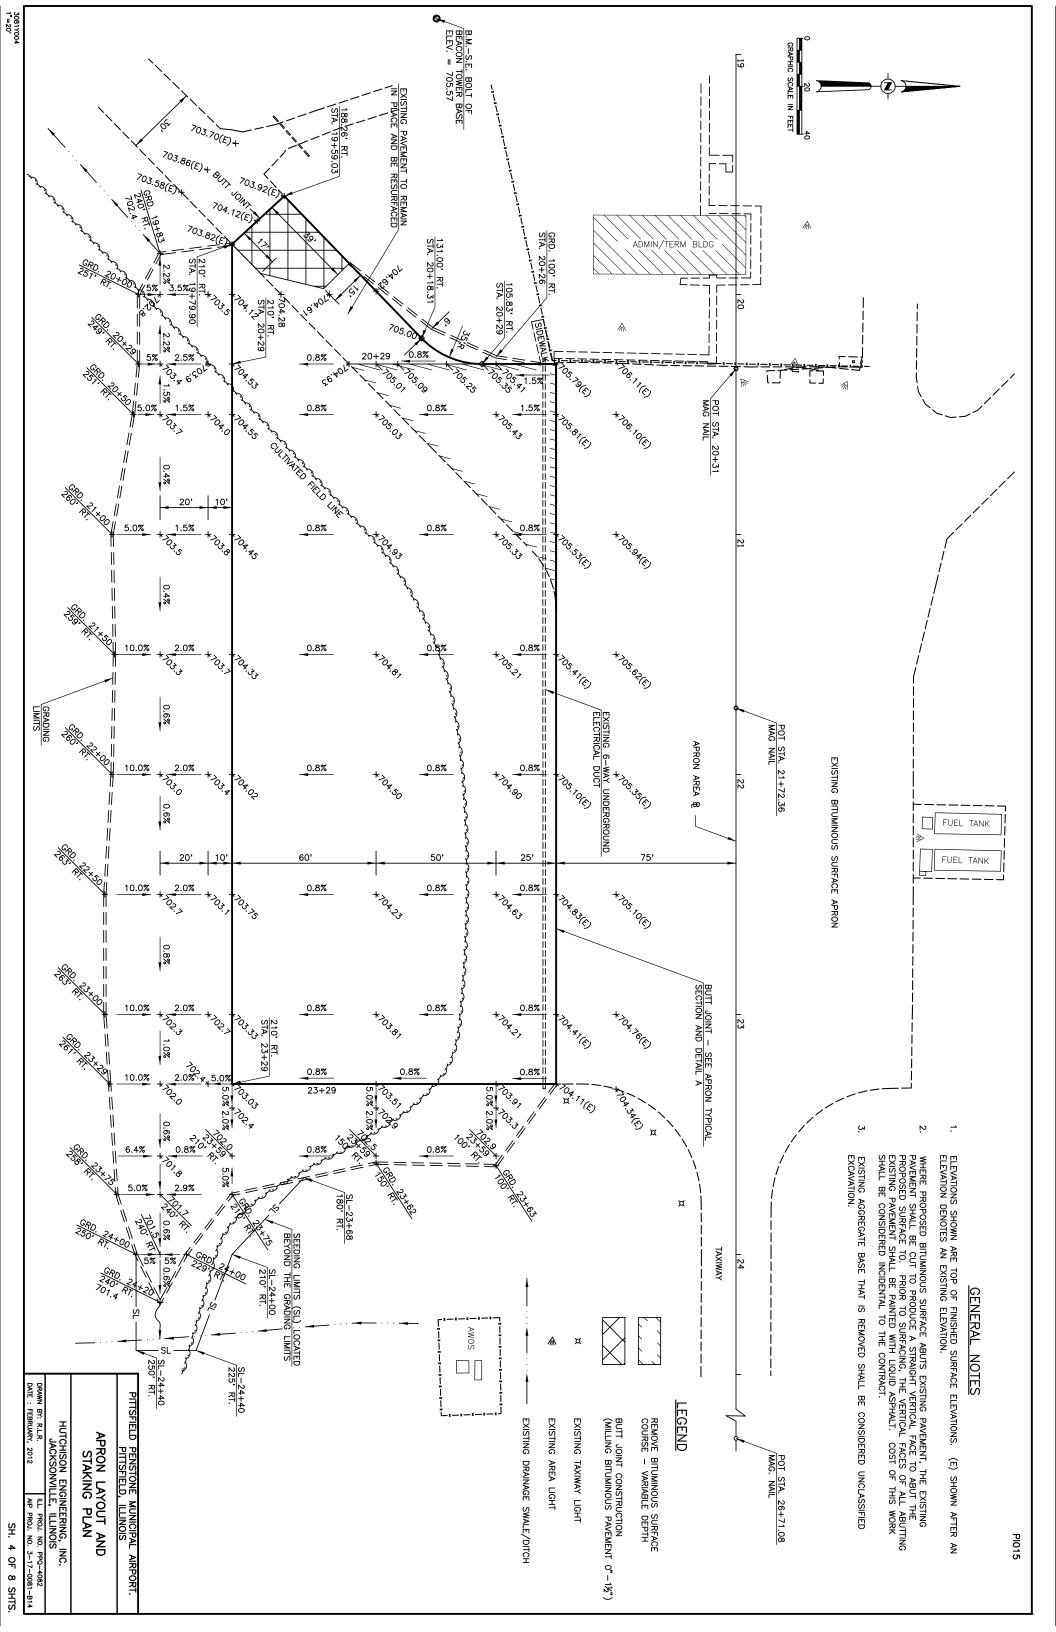

JACKSONVILLE, ILLINOIS

TIEDOWN AND MARKING LAYOUT AND DETAILS


3081Y005 1=30

3. PAINT SHALL BE APPLIED AT THE RATE OF 115 SQ. FT. PER GALLON PER APPLICATION. GLASS BEADS SHALL BE APPLIED AT THE RATE OF 7 POUNDS PER GALLON OF PAINT (APPLIED TO SECOND COAT ONLY).

1. ALL PAVEMENT MARKING SHALL BE SOLID MARKING AND YELLOW IN COLOR.

ALL PAVEMENT MARKING SHALL CONSIST OF TWO APPLICATIONS OF PAINT AND ONE APPLICATION OF GLASS BEADS (REFLECTIVE MEDIA).

EXISTING TIEDOWN SPACE

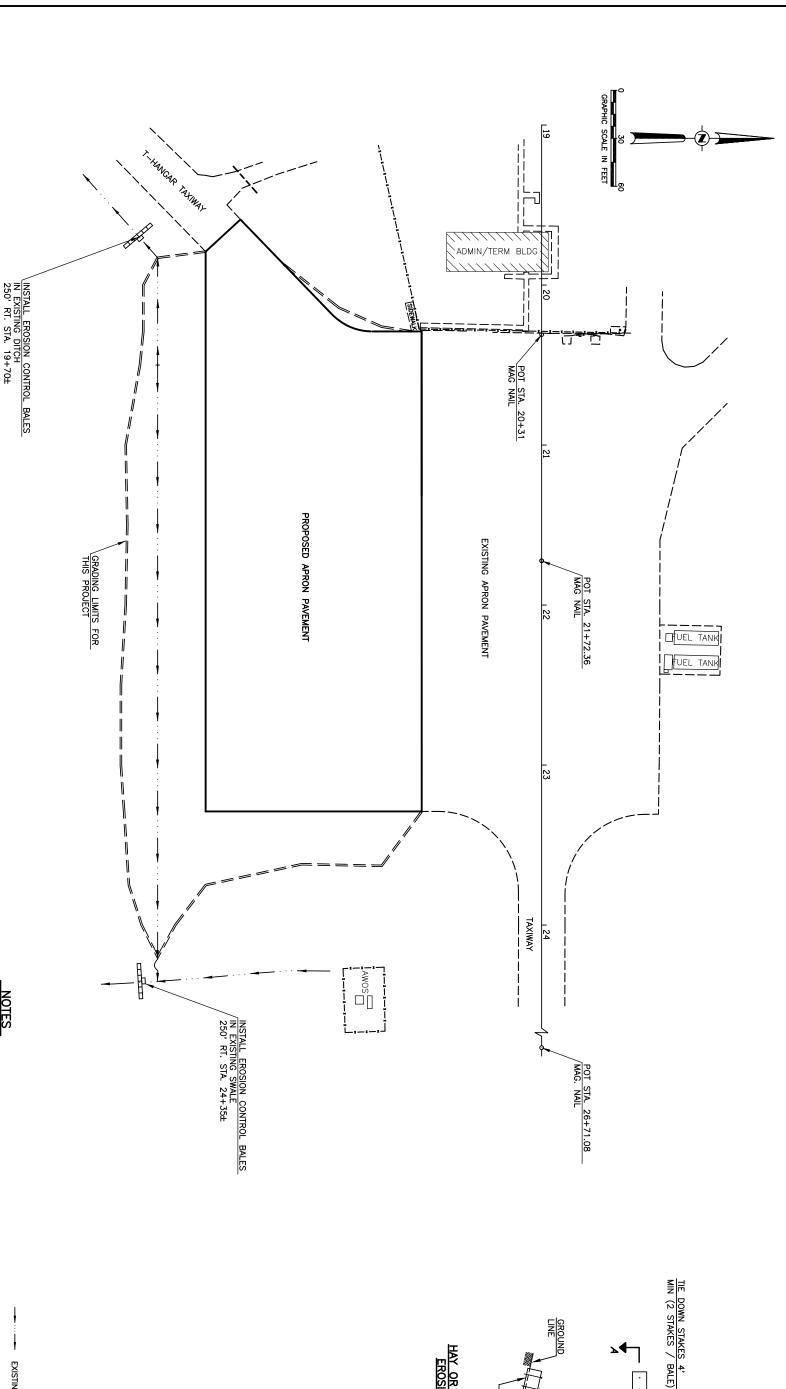

HAY OR STRAW BALES DITCH CHECK EROSION CONTROL INSTALLATION

2" TO 3" EMBEDMENT

NOT MORE THAN 6" EXPOSURE

- FLOW

PI015

BALE PLACED ACROSS
JOINTS IN DITCH BOTTOM

SECTION A-A

LEGEND

PROPOSED EROSION CONTROL BALES INSTALLATION EXISTING DRAINAGE CHANNEL/SWALE/DITCH

PITTSFIELD PENSTONE MUNICIPAL AIRPORT

EROSION CONTROL PLAN

HUTCHISON ENGINEERING, INC.
JACKSONVILLE, ILLINOIS

ILL. PROJ. NO. 3-17-0081-B14

5. ADDITIONAL TEMPORARY EROSION CONTROL SYSTEM (HAY OR STRAW BALES) SHALL BE LOCATED AND CONFIGURED AS DIRECTED BY THE RESIDENT ENGINEER SHOULD THEIR USE BE REQUIRED TO CONTROL SILTATION.

THIS CONSTRUCTION PROJECT WILL RESULT IN THE DISTURBANCE OF MORE THAN 1 ACRE OF LAND.

3. EROSION CONTROL DEVICES SHALL CONFORM TO THE ILLINOIS ENVIRONMENTAL PROTECTION AGENCY STANDARDS AND SPECIFICATIONS FOR SOIL EROSION AND SEDIMENT CONTROL — CURRENT EDITION.

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THE AREAS DISTURBED BY THE INSTALLATION AND THE REMOVAL OF THE TEMPORARY EROSION CONTROL SYSTEMS SHALL ALSO BE SEEDED AND MULCHED UPON THEIR REMOVAL.

1. THE AREAS DISTURBED BY THE CONSTRUCTION SHOWN IN THESE PLANS SHALL BE SEEDED AND MULCHED IN ADDITION TO THE EROSION CONTROL METHODS SHOWN ON THIS SHEET.

3081Y008 1"=30'

SH. 8 OF 8 SHTS.