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STATE OF ILLINOIS

DEPARTMENT OF TRANSPORTATION

D-91-436-16

FOR INDEX OF SHEETS, SEE SHEET NO. 2

THE PROJECT IS LOCATED IN THE CITIES OF PARK RIDGE AND CHICAGO

PROPOSED HIGHWAY PLANS

F.A.U. ROUTE 1349: DEVON AVE.
EAST OF DES PLAINES RIVER RD. TO CANFIELD AVE.

SECTION: (3197A&B) RS-1 PROJECT: STP- 9A65(879)

RESURFACING (3P), PEDESTRIAN RAMPS

COOK COUNTY


C-91-436-16

RESURFACING OMISSION: STA. 96 + 86.8 TO STA. 99 + 07

PROJECT BEGINS

STA. 16+00

TRAFFIC DATA:
2014 ADT = 19,300
POSTED SPEED LIMIT = 30-40 MPH

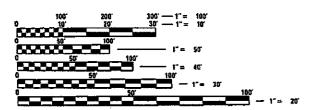


FULL SIZE PLANS HAVE BEEN PREPARED USING STANDARD ENGINEERING SCALES. REDUCED SIZED PLANS WILL NOT CONFORM TO STANDARD SCALES. IN MAKING MEASUREMENTS ON REDUCED PLANS, THE ABOVE SCALES MAY BE USED.

J.U.L.I.E.
JOINT UTILITY LOCATION INFORMATION FOR EXCAVATION
1-809-892-0123
OR 811
C.U.A.N.
CRICAGO UTILITY ALERT NETWORK
(312) 744-7000

CONTRACT NO. 62D18

PROJECT ENGINEER KARI SMITH (847) 705-4437
PROJECT MANAGER FAWAD AQUEEL (847) 705-4247

PROJECT MANAGER FAWAD AQUEEL (847) 705-4

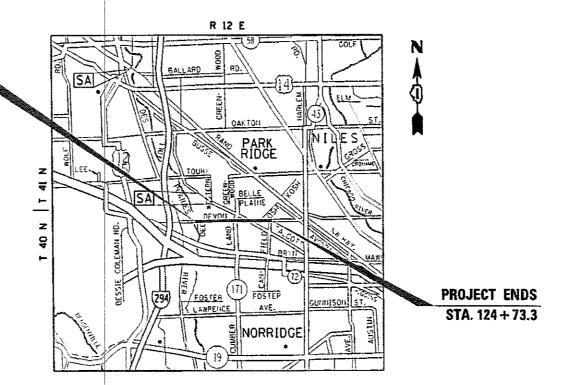

LEYDEN, JEFFERSON, AND MAINE TOWNSHIP

GROSS LENGTH = 10,873.3 FT. = 2.06 MILES

NET LENGTH = 10,061.3 FT. = 1.91 MILES

STATE OF ILLINOIS
DEPARTMENT OF TRANSPORTATION

SUBMITTED TANKAR-1 24 20 18

Outhor Color of Price of Design and Environment

Color Color of Design and Environment

DOG 23 20 18

DIRECTOR OF MIGHWAYS PROJECT IMPLEMENTATION

LOCATION OF SECTION INDICATED THUS:

PRINTED BY THE AUTHORITY OF THE STATE OF ILLINOIS

INDEX OF SHEETS

SHEET NO. DESCRIPTION

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- 55 58 DETECTOR LOOP REPLACEMENT PLANS
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 - O PAVEMENT PATCHING FOR HMA SURFACED PAVEMENT (BD-22)
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 - 68 ARTERIAL ROAD INFORMATION SIGN (TC-22)
 - 9 DISTRICT ONE STANDARD TRAFFIC SIGNAL DESIGN DETAIL, SHEET 2 OF 7 (TS-05)
 - 70 DISTRICT ONE DETECTOR LOOP INSTALLATION DETAILS FOR ROADWAY RESURFACING (TS-07)

STATE HIGHWAY STANDARDS

STANDARD NO.	DESCRIPTION
000001-06	STANDARD SYMBOLS, ABBREVIATIONS AND PATTERNS
424001-10	PERPENDICULAR CURB RAMPS FOR SIDEWALKS
424006-03	DIAGONAL CURB RAMPS FOR SIDEWALKS
424011-03	CORNER PARALLEL CURB RAMPS FOR SIDEWALKS
424031-01	MEDIAN PEDESTRIAN CROSSINGS
442201-03	CLASS C AND PATCHES
604001-04	FRAMES AND LIDS TYPE 1
604086-03	FRAME AND GRATE TYPE 23
604091-03	FRAME AND GRATE TYPE 24
606001-07	CONCRETE CURB TYPE B AND COMBINATION CONCRETE CURB AND GUTTER
701101-05	OFF-RD OPERATIONS, MULTILANE, 15' (4.5 m) TO 24" (600 mm) FROM PAVEMENT EDGE
701427-05	LANE CLOSURE, MULTILANE, INTERMITTENT OR MOVING OPER., FOR SPEEDS < 40 MPH
701601-09	URBAN LANE CLOSURE, MULTILANE, 1W OR 2W WITH NONTRAVERSABLE MEDIAN
701606-10	URBAN SINGLE LANE CLOSURE, MULTILANE, 2W WITH MOUNTABLE MEDIAN
701701-10	URBAN LANE CLOSURE, MULTILANE INTERSECTION
701801-06	SIDEWALK, CORNER OR CROSSWALK CLOSURE
701901-07	TRAFFIC CONTROL DEVICES
814001-03	HANDHOLES

GENERAL NOTES

- BEFORE STARTING ANY EXCAVATION, THE CONTRACTOR SHALL CALL "JULIE" AT (800) 892-0123 OR 811 AND CUAN AT (312) 744-7000 FOR FIELD LOCATIONS OF BURIED ELECTRIC, TELEPHONE, AND GAS FACILITIES. (48 HOUR NOTIFICATION DEGULIEF.)
- THE CONTRACTOR SHALL COORDINATE CONSTRUCTION ACTIVITIES WITH UTILITY COMPANIES, THE CITIES OF PARK RIDGE AND CHICAGO.
- 3. FRAMES AND GRATES ADJUSTMENT OF PRIVATE UTILITIES WITHIN THE LIMITS OF THE IMPROVEMENTS SHALL BE DONE BY CONTRACT.
- 4. THE CONTRACTOR SHALL CONTACT DISTRICT ONE ARTERIAL TRAFFIC CONTROL SUPERVISOR AT (847) 705-4470 A MINIMUM OF 72 HOURS IN ADVANCE OF BEGINNING WORK.
- THE CONTRACTOR WILL NOT BE ALLOWED TO SET UP A YARD OR FIELD OFFICE ON STATE PROPERTY WITHOUT THE WRITTEN PERMISSION OF THE DEPARTMENT.
- 6. UNLESS OTHER CONDITIONS WARRANT EXTENDED LANE CLOSURE AS DETERMINED AND APPROVED IN WRITING BY THE ENGINEER OR AS PROVIDED FOR IN THE CONTRACT SPECIFICATIONS, OVERNIGHT CLOSURES SHALL NOT BE ALLOWED FOR REHABILITATION PROJECTS INVOLVING DAYTIME MILLING AND RESURFACING OPERATIONS AND CLASS D PATCHING.
- 7. IT SHALL BE THE CONTRACTOR'S RESPONSIBILITY TO VERIFY ALL DIMENSIONS AND CONDITIONS EXISTING IN THE FIELD PRIOR TO CONSTRUCTION AND ORDERING OF MATERIALS.
- 8. DO NOT SCALE PLANS FOR CONSTRUCTION DIMENSIONS.

GENERAL NOTES (CONTINUED..)

- THE CONTRACTOR SHALL BE REQUIRED TO PROVIDE ACCESS TO ABUTTING PROPERTY AT ALL TIMES DURING THE CONSTRUCTION OF THIS PROJECT.
- ALL PAVEMENT PATCHING LOCATIONS WILL BE DETERMINED IN THE FIELD BY THE ENGINEER.
- 11. DRAINAGE ADJUSTMENT OR RECONSTRUCTION LOCATIONS WILL BE DETERMINED IN THE FIELD BY THE ENGINEER.
- 12. FOR FRAMES AND LIDS ADJUSTMENT WITHOUT MILLING, REUSE EXISTING FRAME AND LID UNLESS OTHERWISE SPECIFIED IN THE PLANS.
- 13. WHEN MILLED PAVEMENT IS OPEN TO TRAFFIC, THE MAXIMUM GRADE DIFFERENTIAL BETWEEN PASSES OF THE MILLING MACHINE SHALL NOT EXCEED 1½ INCHES WHERE THE SPEED LIMIT IS 45 MPH OR LESS, AND I INCH WHERE THE SPEED LIMIT IS 0°CR 45 MPH. WITH WRITTEN APPROVAL FROM THE ENGINEER, A MAXIMUM GRADE DIFFERENTIAL OF 3 INCHES MAY BE ALLOWED IF THE EDGE OF THE MILLING IS SLOPED A MINIMUM OF 1½3H.
- 14. BUTT JOINTS WILL BE INSTALLED AT THE ENDS OF RESURFACING (WHERE RESURFACING MEETS EXISTING PAVEMENT) IN ACCORDANCE WITH THE "BUTT JOINT AND HMA TAPER DETAILS" SHEET INCLUDED IN THE PLANS, UNLESS OTHERWISE SPECIFIED.
- 15. THE ENGINEER SHALL CONTACT CORY JUCIUS, ARTERIAL TRAFFIC FIELD ENGINEER VIA E-MAIL AT CORY.JUCIUS@ILLINOIS.GOV, A MINIMUM OF 2 WEEKS PRIOR TO PLACEMENT OF PERMANENT PAVEMENT MARKINGS.
- 16. BEFORE BEGINNING ANY WORK, THE CONTRACTOR SHALL RETAIN AND RECORD FOR FUTURE REFERENCE, ALL EXISTING PAVEMENT MARKING LINES (AND RAISED REFLECTIVE PAVEMENT MARKERS) IN ORDER THAT THESE LOCATIONS CAN BE RE-ESTABLISHED FOR STRIPING. EXACT LOCATIONS OF ALL PAVEMENT MARKINGS SHALL BE AS DIRECTED BY THE ENGINEER.
- 17. ANY PAVEMENT MARKINGS AND RAISED REFLECTIVE PAVEMENT MARKERS OBLITERATED BY MILLING AND RESURFACING OPERATIONS ON SIDE STREETS AND ENTRANCES SHALL BE REPLACED AND PAID FOR IN KIND.
- PAVEMENT MARKING TAPE, TYPE III SHALL BE USED FOR SHORT TERM PAVEMENT MARKINGS ON ALL FINAL SURFACES.
- 19. THE CONTRACTOR SHALL BE RESPONSIBLE FOR THE REPLACEMENT OF ANY DETECTOR LOOPS DAMAGED DURING CONSTRUCTION.
- THE CONTRACTOR SHALL MAINTAIN PEDESTRIAN ACCESS AT ALL TIMES DURING CONSTRUCTION.
- 21. LOCATION OF COMBINATION CONCRETE CURB AND GUTTER REMOVAL AND REPLACEMENT FOR COMBINATION CURB AND GUTTER (THE TYPE SPECIFIED IN THE PLANS) WILL BE DETERMINED IN THE FIELD BY THE ENGINEER.
- 22. CONTACT THE IDOT ROADSIDE DEVELOPMENT UNIT AT 847-705-4171 AT LEAST 2 WEEKS PRIOR TO BEGINNING WORK FOR LAYOUT.
- 23. BEFORE BEGINNING ANY WORK, THE CONTRACTOR SHALL RETAIN AND RECORD FOR FUTURE REFERENCE, ALL EXISTING PAVEMENT MARKING LINES (AND RAISED REFLECTIVE PAVEMENT MARKERS) IN ORDER THAT THESE LOCATIONS CAN BE RE-ESTABLISHED FOR STRIPING. EXACT LOCATIONS OF ALL PAVEMENT MARKINGS SHALL BE AS DIRECTED BY THE ENGINEER.

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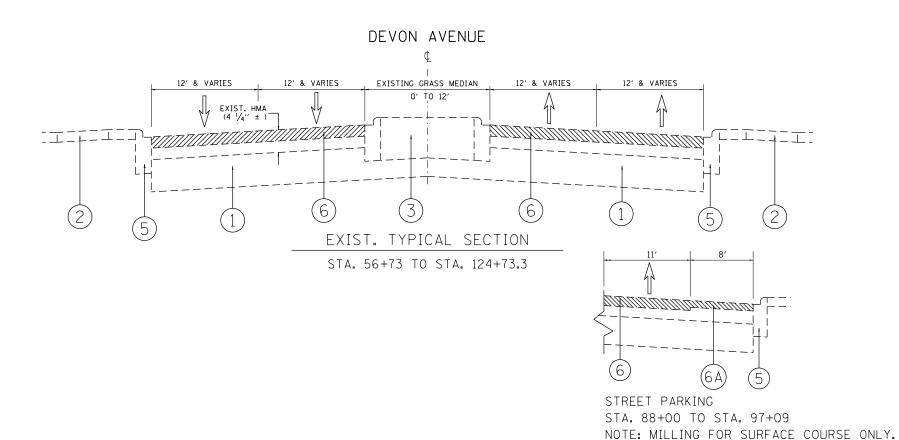
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20100110	TREE REMOVAL (6 TO 15 UNITS DIAMETER)	UNIT	15	15				40600827	POLYMERIZED LEVELING BINDER (MACHINE	TON	2551	2551			
				-					METHOD), IL-4.75, N50						
20100210	TREE REMOVAL (OVER 15 UNITS DIAMETER)	UNIT	30	30											
			**************************************					40600982	HOT-MIX ASPHALT SURFACE REMOVAL - BUTT	SO YD	745	745			
20200100	EARTH EXCAVATION	CU YD	145	145					JOINT						
21101615	TOPSOIL FURNISH AND PLACE, 4"	SO YD	988	988				40603335	HOT-MIX ASPHALT SURFACE COURSE, MIX	TON	2	2		+	
				1					"D", N50						
25000400	NITROGEN FERTILIZER NUTRIENT	POUND	12	12											
								40603340	HOT-MIX ASPHALT SURFACE COURSE, MIX	TON	5244	5244			
25000500	PHOSPHORUS FERTILIZER NUTRIENT	POUND	12	12					"D". N70						
25000600	POTASSIUM FERTILIZER NUTRIENT	POUND	12	12				42001300	PROTECTIVE COAT	SO YD	2145	2145			
		Found	1 '2	12					1107207732 0047	30.15	2193	2173		+	
25100630	EROSION CONTROL BLANKET	SO YD	745	745				42300200	PORTLAND CEMENT CONCRETE DRIVEWAY	SO YD	125	125			
									PAVEMENT, 6 INCH						
25200110	SODDING, SALT TOLERANT	SQ YD	1002	1002		 				-					
25200200	SUPPLEMENTAL WATERING	UNIT	3 /	3.5				42300400	PORTLAND CEMENT CONCRETE DRIVEWAY PAVEMENT, 8 INCH	SO YD	7	7			
23230230	JOHN ELIZATIVE HAVENING	J	3.5	3, 3					· ·	-					
35501308	HOT-MIX ASPHALT BASE COURSE, 6"	SO YD	5	5				42400200	PORTLAND CEMENT CONCRETE SIDEWALK 5 INCH	SQ FT	14907	14907			
35501316	HOT-MIX ASPHALT BASE COURSE, 8"	SQ YD	12	12				42400800	DETECTABLE WARNINGS	SO FT	1188	1188			
40600290	BITUMINOUS MATERIALS (TACK COAT)	POUND	41751	41751				44000155	HOT-MIX ASPHALT SURFACE REMOVAL. 1 1/2"	SO YD	1702	1702			1
	·								-	- Control of the Cont					
40600400	MIXTURE FOR CRACKS, JOINTS, AND	TON	188	188				44000158	HOT-MIX ASPHALT SURFACE REMOVAL. 2 1/4"	SO YD	60718	60718			
	FLANGEWAYS														
								44000200	DRIVEWAY PAVEMENT REMOVAL	SQ YD	135	135			
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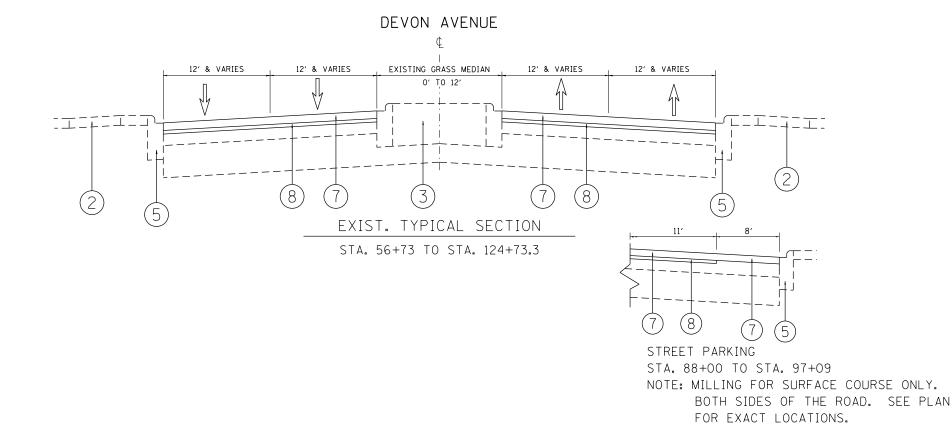
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44000600	SIDEWALK REMOVAL	SO FT	14208	14208					60406100	FRAMES AND L	IDS, TYPE 1, CLOSED LID	EACH	15	15					
44201777	CLASS D PATCHES, TYPE II, 11 INCH	SQ YD	319	319	1				¥ 66900200	NON-SPECIAL	WASTE DISPOSAL	CU YD	145	145					
44201781	CLASS D PATCHES, TYPE III, 11 INCH	SO YD	90	90					★ 66900450	SPECIAL WAST	E PLANS AND REPORTS	LSUM	A A A A A A A A A A A A A A A A A A A	1					
44201783	CLASS D PATCHES, TYPE IV, 11 INCH	SQ YD	1049	1049					66900530	SOIL DISPOSA	L ANALYSIS	EACH	4	4					
48102100	AGGREGATE WEDGE SHOULDER, TYPE B	TON	64	64					67000400	ENGINEER'S F	IELD OFFICĘ, TYPE A	CAL MO	6	6					
60250400	CATCH BASINS TO BE ADJUSTED WITH NEW	EACH	1	1					67100100	MOBILIZATION		LSUM		1					
	TYPE 1 FRAME, OPEN LID								70102625	TRACE IC CONT	DOL AND DESTRUCTION	, con							
60252800	CATCH BASINS TO BE RECONSTRUCTED	EACH	2	2					70102625	STANDARD 701	ROL AND PROTECTION.	LSUM		1					
60255800	MANHOLES TO BE ADJUSTED WITH NEW TYPE 1	EACH	1	1					70102630	TRAFFIC CONT	ROL AND PROTECTION,	LSUM	1	1					
	FRAME, CLOSED LID			20 million 10 million						STANDARD 701	601								
60257900	MANHOLES TO BE RECONSTRUCTED	EACH	2	2					70102635	TRAFFIC CONT	ROL AND PROTECTION,	LSUM	1	1	-				
60266600	VALVE BOXES TO BE ADJUSTED	EACH	9	9	-														
60300105	FRAMES AND GRATES TO BE ADJUSTED	EACH	2	2					70102640	STANDARD 701	ROL AND PROTECTION.	LSUM	garage and a second and a secon	1					
60300305	FRAMES AND LIDS TO BE ADJUSTED	EACH	44	44					70300100	SHORT TERM P	AVEMENT MARKING	F00T	30809	30809	-				
60404940	FRAMES AND GRATES, TYPE 23	EACH	2	2					70300150	SHORT TERM P	AVEMENT MARKING REMOVAL	SO FT	10270	10270					
60406000	FRAMES AND LIDS, TYPE 1, OPEN LID	EACH	15	15					70300210	TEMPORARY PA	VEMENT MARKING LETTERS AND	SO FT	219	219	117				
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Transport Tran	70300240	TEMPORARY PAVEMENT MARKING - LINE 6"	FOOT	3405	3405			78300200	RAISED REFLE	CTIVE PAVEMENT MARKER	EACH	565	565					
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TOURS TEMPORAL STIC PARENT MARING - LINE 2* FOOT 1545 1								∦ 85000200	MA INTENANCE	OF EXISTING TRAFFIC SIGNAL	EACH	5	5	<u>-</u>				
TO TO THE MADE AND EAST AND ENTRELS ASSEMBLY - TIPE B EACH 2 2 2 2 2 2 2 2 2 2 2 2 2 2 2 2 2 2 2	70300260	TEMPORARY PAVEMENT MARKING - LINE 12"	FOOT	336	336				INSTALLATION	v								<u> </u>
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72400200 RELOCALE SION PAREL ASSEMBLY - TYPE B	70300280	TEMPORARY PAVEMENT MARKING - LINE 24"	F001	652	652			* 88600600	DETECTOR LOG	JP REPLACEMEN!	F001	1612	1612					
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7 7240060 REJOCATE SION PAREL ASSENDEY - TYPE B EACH 2 2 2		•																
# 7800100 THERMOPLASTIC PAYEMENT MARKING - S0 FT 219 219	72400200	REMOVE SIGN PANEL ASSEMBLY - TYPE B	EACH	1	1			★ 89502376	REBUILD EXIS	STING HANDHOLE	EACH	6	6					
# 7800100 THERMOPLASTIC PAVEMENT MARKING - S0 FT 219 219 219	/- 73400500	DELOCATE CION DANEL ACCEMBLY TYPE B	FACU		2			V0320050	CONSTRUCTION	N I AVOIT (SPECIAL)	I CIM	,						
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# 78000200 THERMOPLASTIC PAVEMENT MARKING - LINE 4" FOOT 16545 16545 16545	* 78000100	THERMOPLASTIC PAVEMENT MARKING -	SQ FT	219	219			X0327611	REMOVE AND I	REÎNSTALL BRICK PAVER	SQ FT	32	32					
* 78000200 THERMOPLASTIC PAVEMENT MARKING - LINE 4" FOOT 16545 16545		LETTERS AND SYMBOLS																
* 78000400 THERMOPLASTIC PAVEMENT MARKING - LINE 6" FOOT 3405 3405 X2501800 SEEDING, CLASS 4 (MODIFIED) ACRE 0, 15 0, 15 X2501800 STORM SEWERS TO BE CLEANED 12" FOOT 280 280 X6000500 THERMOPLASTIC PAVEMENT MARKING - LINE 12" FOOT 336 336 X6000500 THERMOPLASTIC PAVEMENT MARKING - LINE 12" FOOT 336 336 X6000500 THERMOPLASTIC PAVEMENT MARKING - LINE 12" FOOT 336 336 X6000500 THERMOPLASTIC PAVEMENT MARKING - LINE 12" FOOT 336 336 X6000500 THERMOPLASTIC PAVEMENT MARKING - LINE 12" FOOT 652 652 X6000500 THERMOPLASTIC PAVEMENT MARKING - LINE 24" FOOT 652 652 X7000050 THERMOPLASTIC PAVEMENT MARKING - LINE 24" FOOT 652 652 X7000050 TEMPORARY PAVEMENT MARKING REMOVAL SO FT 11665 11665 X7000050 TEMPORARY PAVEMENT MARKING REMOVAL SO FT 11665 11665 X7000050 TEMPORARY PAVEMENT MARKING REMOVAL SO FT 11665 11665 X7000050 TEMPORARY PAVEMENT MARKING REMOVAL SO FT 11665 11665 X7000050 TEMPORARY PAVEMENT MARKING REMOVAL SO FT 11665 X7000050 TEMPORARY PAVEMENT MARKING REMOVAL SO								X2010350	TREE REMOVA	L. ACRES (SPECIAL)	ACRE	0.15	0. 15					
* 7800400 THERMOPLASTIC PAVEMENT MARKING - LINE 6" FOOT 3405 3405	* 78000200	THERMOPLASTIC PAVEMENT MARKING - LINE 4"	FOOT	16545	16545					CHARLES CHARLES CONTROL OF THE CONTR								
* 78000500 THERMOPLASTIC PAVEMENT MARKING - LINE 8" FOOT 624 624	* 78000400	THERMOPIASTIC PAVEMENT MARKING - LINE 6"	FOOT	3405	3405			X2020110	GRADING AND	SHAPING SHOULDERS	UNII	24	24					
* 78000600 THERMOPLASTIC PAVEMENT MARKING - LINE 12" FOOT 336 336								x2501800	SEEDING, CL	ASS 4 (MODIFIED)	ACRE	0, 15	0.15					
* 78000600 THERMOPLASTIC PAVEMENT MARKING - LINE 12" FOOT 336 336	* 78000500	THERMOPLASTIC PAVEMENT MARKING - LINE 8"	FOOT	624	624													
* 78000650 THERMOPLASTIC PAVEMENT MARKING - LINE 24" FOOT 652 652								X5537800	STORM SEWERS	S TO BE CLEANED 12"	FOOT	280	280					
* 78000650 THERMOPLASTIC PAVEMENT MARKING - LINE 24" FOOT 652 652	* 78000600	THERMOPLASTIC PAVEMENT MARKING - LINE 12"	FOOT	336	336													
X7030005 TEMPORARY PAVEMENT MARKING REMOVAL SO FT 11665 11665	* 78000650	THERMOPLASTIC PAVEMENT MARKING - LINE 24"	FOOT	652	652			x6030310	FRAMES AND	LIDS TO BE ADJUSTED (SPECIAL)	EACH	80	80					
		The second secon		1				x7030005	TEMPORARY P.	AVEMENT MARKING REMOVAL	SQ FT	11665	11665					
	14																	
								12										
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			URBAN																
[SUMMARY OF QUANTITIES			0005	co	NSTRUCTION	ON TYPE	CODE		SUM	MARY OF QUANTITIES			2005	COI	VSTRUCTIO	N TYPE CO	DDE	
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X7240500	RELOCATE EXISTING SIGNS	EACH	5	5															
X8950205	REBUILD EXISTING HANDHOLE, SPECIAL	EACH	Į.	1															
Z0004562	COMBINATION CONCRETE CURB AND GUTTER	FOOT	5120	5120															
	REMOVAL AND REPLACEMENT									11									
Z0018500	D DRAINAGE STRUCTURES TO BE CLEANED	EACH	28	28															
Z0030850	TEMPORARY INFORMATION SIGNING	SO FT	102.8	102.8															
π 7 m⊃i√	Ø TRAINKES	Hour-	500	500		-													
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Z007660	TRAINSES - TRAINING PROGRAM GRADUATE	HOUR	500	500					and the state of t										
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						The state of the s											:		
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		HECKED -	***	REVISED REVISED				DEPARTMI	ENT OF T	RANSPORTATION		OF SHEETS STA		O STA.	FED. ROA	D DIST. NO. 1 IL	LINOIS FED. AID	CONTRACT PROJECT	10. 62

I Revised 00042





LEGEND

- (1) EXISTING P.C.C. PAVEMENT, ±9"
- (2) EXISTING P.C.C. SIDEWALK, 5" (TYP.)
- (3) EXISTING MEDIAN
- (4) EXISTING AGGREGATE SHOULDER
- (5) EXISTING COMB. CONCRETE CURB AND GUTTER
- (6) PROPOSED HMA SURFACE REMOVAL, 2 1/4"
- (6A) PROPOSED HMA SURFACE REMOVAL, 1 1/2" (SEE PLAN FOR EXACT LOCATIONS)
- 7 PROPOSED HMA SURFACE COURSE, MIX "D", N70, 1 1/2"
- 8 PROPOSED POLY. LEVELING BINDER (MACHINE METHOD), IL-4.75, N50, $\frac{3}{4}$ "
- (9) PROPOSED AGGREGATE WEDGE SHOULDER, TYPE B
- (10) PROPOSED GRADING AND SHAPING SHOULDERS
- 11) PROPOSED PAVEMENT MARKING

HOT-MIX ASPHALT MIXTURE REQUIREMENTS

MIXTURE TYPE	AIR VOIDS @ NDES	QMP

ROADWAY RESURFACING:

HOT-MIX ASPHALT SURFACE COURSE, MIX "D", N70 (IL 9.5 mm)	4% AT 70 GYR.	QCP
POLY. LEVELING BINDER (MACHINE METHOD), IL-4.75, N50	3.5% AT 50 GYR.	QCP

HOT-MIX ASPHALT PATCHING:

CLASS D PATCHES (HMA BINDER IL-19 mm)	4% AT 70 GYR.	QC / QA
		l

HMA DRIVEWAY RESTORATION FOR CURB AND GUTTER REMOVE AN REPLACEMENT:

HOT-MIX ASPHALT SURFACE COURSE, MIX "D", N50 (IL 9.5 mm), 2"	4% AT 50 GYR.	QC / QA
HOT-MIX ASPHALT BASE COURSE, 6" (HMA BINDER IL 19.0)	4% AT 50 GYR.	QC / QA
HOT-MIX ASPHALT BASE COURSE, 8" (HMA BINDER IL 19.0)	4% AT 50 GYR.	QC / QA

OMP Designation: Quality Control/Quality Assurance (QC/QA); Quality Control for Performance (QCP); Pay for Performance (PFP)

NOTES:

THE UNIT WEIGHT USED TO CALCULATE ALL HMA SURFACE MIXTURE QUANTITIES IS 112 LBS/SQ YD/IN.

THE "AC TYPE" FOR POLYMERIZED HMA MIXES SHALL BE "SBS/SBR PG 76-22" AND FOR NON-POLYMERIZED HMA THE "AC TYPE" SHALL BE "PG 64-22" UNLESS MODIFIED BY DISTRICT ONE SPECIAL PROVISIONS.

FOR USE OF RECYCLED MATERIALS SEE SPECIAL PROVISIONS.

QUALITY MANAGEMENT PROGRAM (QMP) IDENTIFIES THE PARTICULAR QUALITY CONTROL SPECIFICATION THAT APPLIES TO THE HMA MIXTURE.

NOTE:


THE CONTRACTOR SHALL MILL THE ROADWAY FIRST, THEN DO PAVEMENT PATCHING PER BD-22 DETAIL.

FILE NAME =	USER NAME = paraynoal	DESIGNED -	REVISED -		DEVO	N AVE. (DES PLAINES RIVER	RD TO CANFIELD AVE !	F.A.U. RTE.	SECTION	COUNTY	TOTAL SHEET SHEETS NO.
pw:\\ILØ84EBIDINTEG.:ll:nois.gov:PWIDOT\Do	cuments\IDOT Offices\District 1\Projects\D14	361 BR/AMDN ata\Design\D143616-sht-plan.dgn	REVISED -	STATE OF ILLINOIS		EXISTING AND PROPOSED	•	1349	(3197A&B) RS-1	соок	70 7
	PLOT SCALE = 100.0000 '/ in.	CHECKED -	REVISED -	DEPARTMENT OF TRANSPORTATION		EXISTING AND PROPUSED	ITPICAL SECTIONS			CONTRAC	CT NO. 62D18
	PLOT DATE = 2/1/2018	DATE -	REVISED -		SCALE:	SHEET NO. OF SHEETS	STA. TO STA.	FED. ROA	AD DIST. NO. 1 ILLINOIS FED.		

BOTH SIDES OF THE ROAD. SEE PLAN

FOR EXACT LOCATIONS.


DEVON AVENUE Liz' & VARIES Liz' &

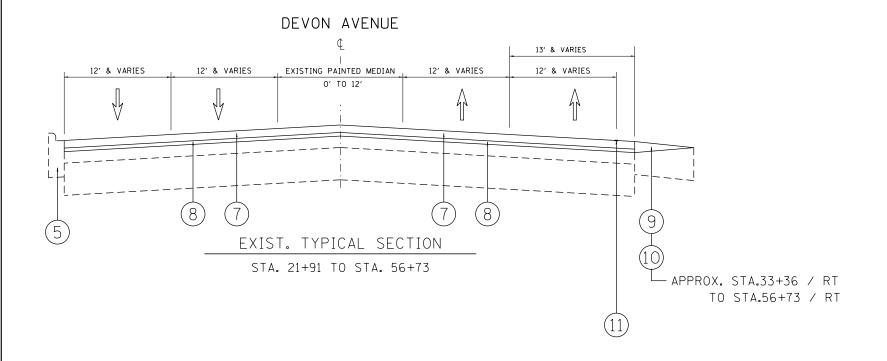



LEGEND


- 1) EXISTING P.C.C. PAVEMENT, ±9"
- 2 EXISTING P.C.C. SIDEWALK, 5" (TYP.)
- (3) EXISTING MEDIAN
- 4) EXISTING AGGREGATE SHOULDER
- (5) EXISTING COMB. CONCRETE CURB AND GUTTER
- (6) PROPOSED HMA SURFACE REMOVAL, 2 1/4"
- (SEE PLAN FOR EXACT LOCATIONS)
- 7 PROPOSED HMA SURFACE COURSE, MIX "D", N70, 1 1/2"
- 8 PROPOSED POLY. LEVELING BINDER (MACHINE METHOD), IL-4.75, N50, $\frac{3}{4}$ "
- (9) PROPOSED AGGREGATE WEDGE SHOULDER, TYPE B
- (10) PROPOSED GRADING AND SHAPING SHOULDERS
- (11) PROPOSED PAVEMENT MARKING


FILE NAME =	USER NAME = paraynoal	DESIGNED -	REVISED -		DEVO	ON AVE. (DES PLAINES RIVEI	R BU TU C	ANEIELD AVE)	F.A.U. RTF	SECTION	COUNTY	TOTAL SHEET SHEETS NO.
pw:\\IL084EBIDINTEG.:ll:nois.gov:PWIDOT\Do	cuments\IDOT Offices\District 1\Projects\D143	61 BRANDN ata\Design\D143616-sht-plan.dgn	REVISED -	STATE OF ILLINOIS		•		,	1349	(3197A&B) RS-1	соок	70 8
	PLOT SCALE = 100.0000 ' / in.	CHECKED -	REVISED -	DEPARTMENT OF TRANSPORTATION		EXISTING AND PROPOSED	I YPICAL S	SECTIONS			CONTRAC	CT NO. 62D18
	PLOT DATE = 2/1/2018	DATE -	REVISED -		SCALE:	SHEET NO. OF SHEETS	STA.	TO STA.	FED. ROAD	DIST. NO. 1 ILLINOIS FE	D. AID PROJECT	

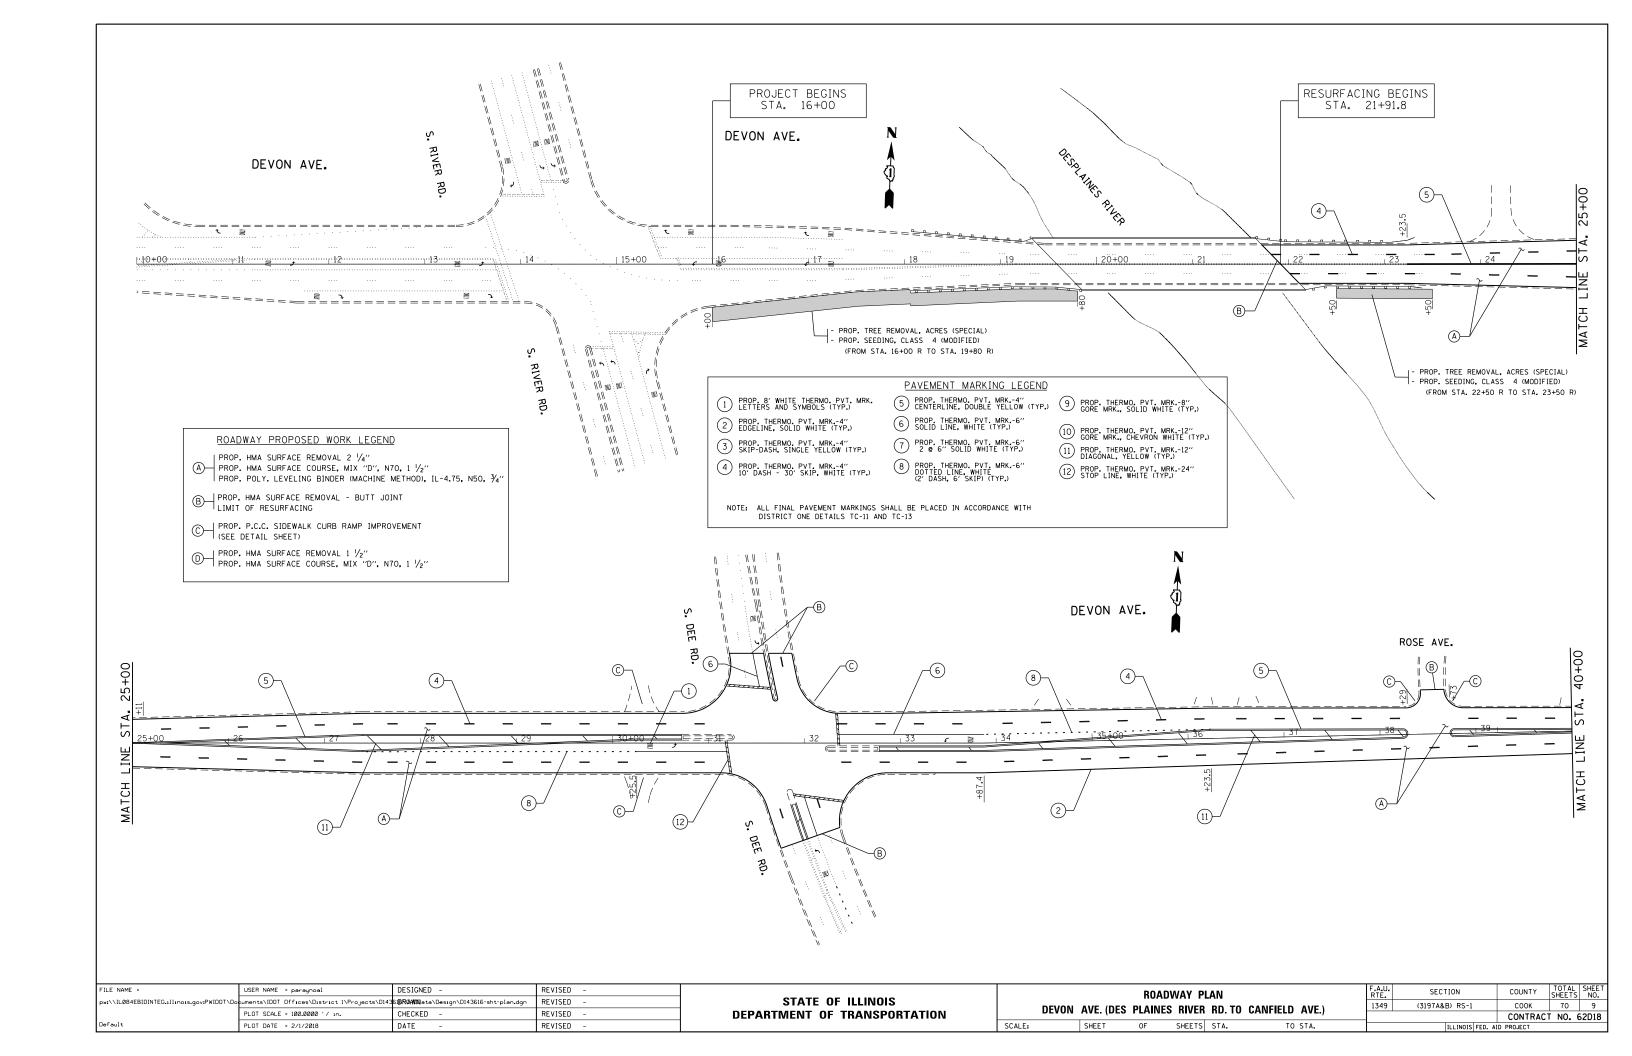

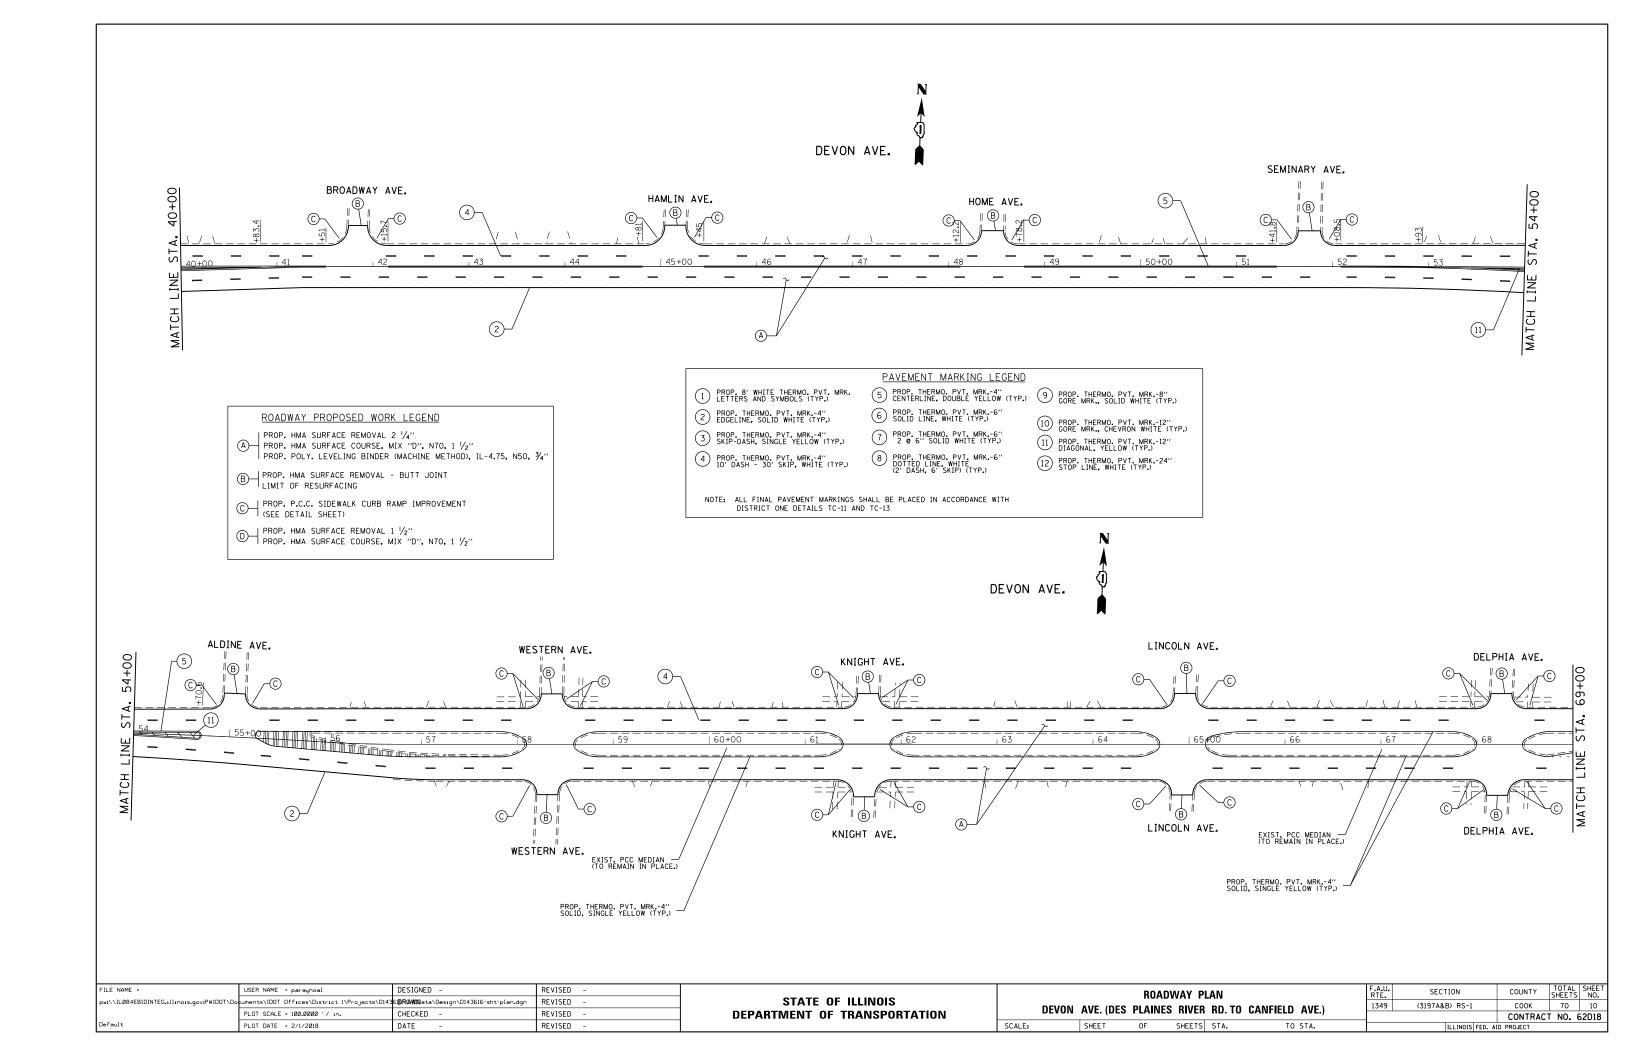

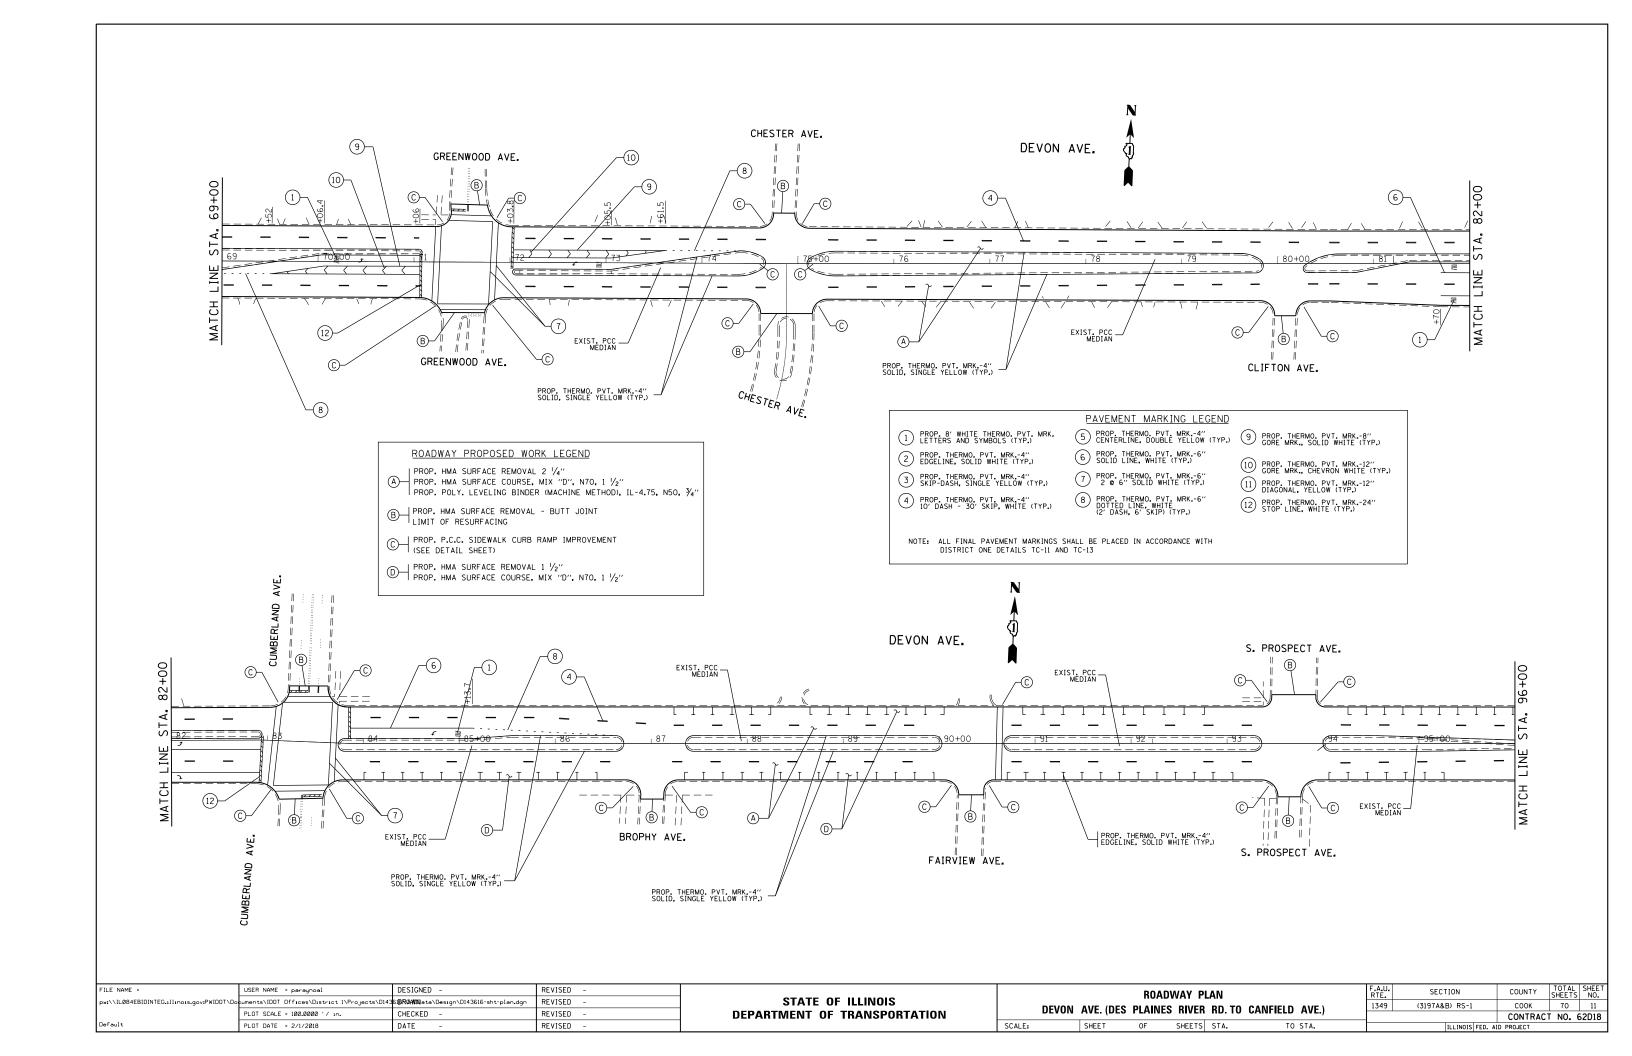

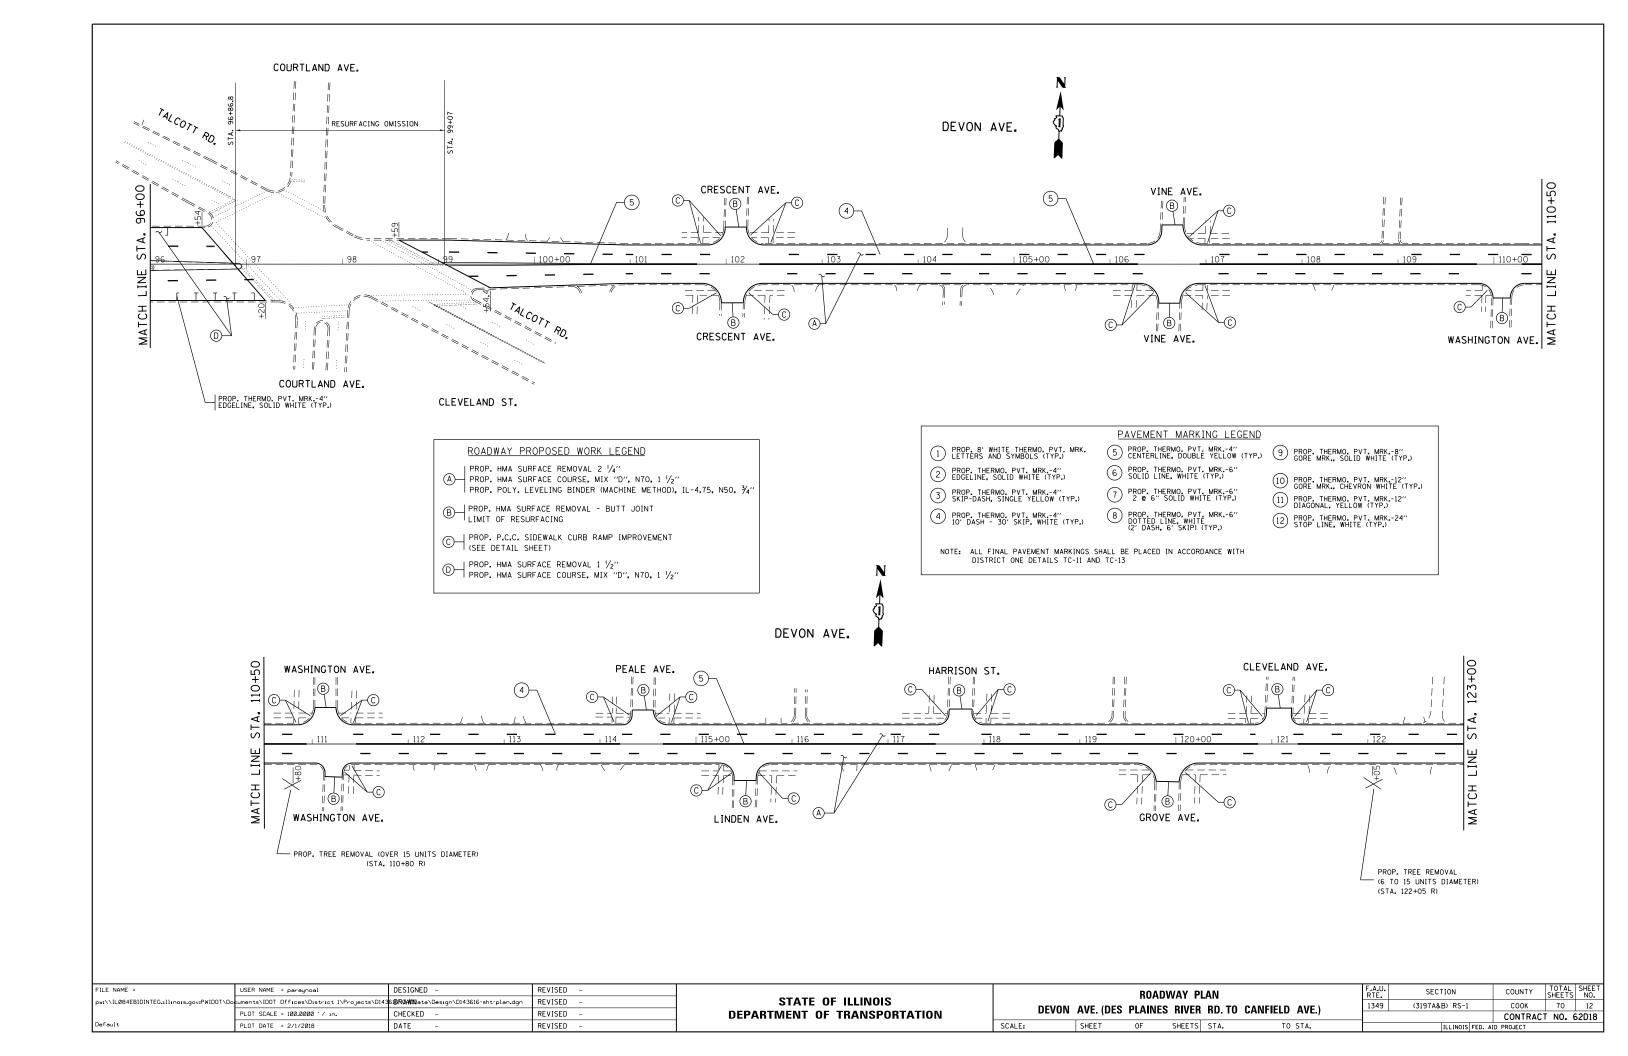

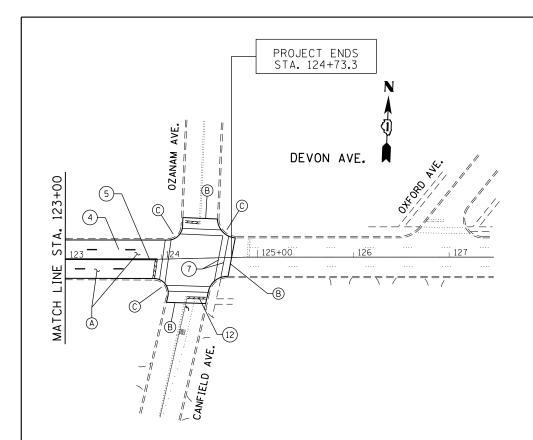

ROADWAY PROPOSED WORK LEGEND

- PROP. HMA SURFACE REMOVAL 2 1/4"

 PROP. HMA SURFACE COURSE, MIX "D", N70, 1 1/2"

 PROP. POLY. LEVELING BINDER (MACHINE METHOD), IL-4.75, N50, 3/4"
- B-PROP. HMA SURFACE REMOVAL BUTT JOINT LIMIT OF RESURFACING
- ©—| PROP. P.C.C. SIDEWALK CURB RAMP IMPROVEMENT (SEE DETAIL SHEET)
- $\bigcirc \longrightarrow | \begin{array}{c} \text{PROP. HMA SURFACE REMOVAL 1 $1/2''$} \\ \text{PROP. HMA SURFACE COURSE, MIX "D", N70, 1 $1/2''$} \\ \end{array}$

PAVEMENT MARKING LEGEND

- 1 PROP. 8' WHITE THERMO. PVT. MRK. 5 PROP. CENTE
- 2 PROP. THERMO. PVT. MRK.-4" EDGELINE, SOLID WHITE (TYP.)
- 6 PROP. THERMO. PVT. MRK.-6"
 SOLID LINE, WHITE (TYP.)
- 3 PROP. THERMO. PVT. MRK.-4" SKIP-DASH, SINGLE YELLOW (TYP.)
 - (P.) 2
- 7 PROP. THERMO. PVT. MRK.-6" 2 @ 6" SOLID WHITE (TYP.)

SCALE:

- PROP. THERMO. PVT. MRK.-4"
 10' DASH 30' SKIP, WHITE (TYP.)


 8 PROP. THERMO. PVT. MRK.-6"
 DOTTED LINE, WHITE
 (2' DASH, 6' SKIP) (TYP.)
- 5 PROP. THERMO. PVT. MRK.-4"
 (SORE MRK., SOLID WHITE (TYP.)
 - PROP. THERMO. PVT. MRK.-12"
 GORE MRK., CHEVRON WHITE (TYP.)
 - 11) PROP. THERMO. PVT. MRK.-12" DIAGONAL, YELLOW (TYP.)
 - PROP. THERMO. PVT. MRK.-24" STOP LINE, WHITE (TYP.)


NOTE: ALL FINAL PAVEMENT MARKINGS SHALL BE PLACED IN ACCORDANCE WITH DISTRICT ONE DETAILS TC-11 AND TC-13


FILE NAME =	USER NAME = paraynoal	DESIGNED -	REVISED -
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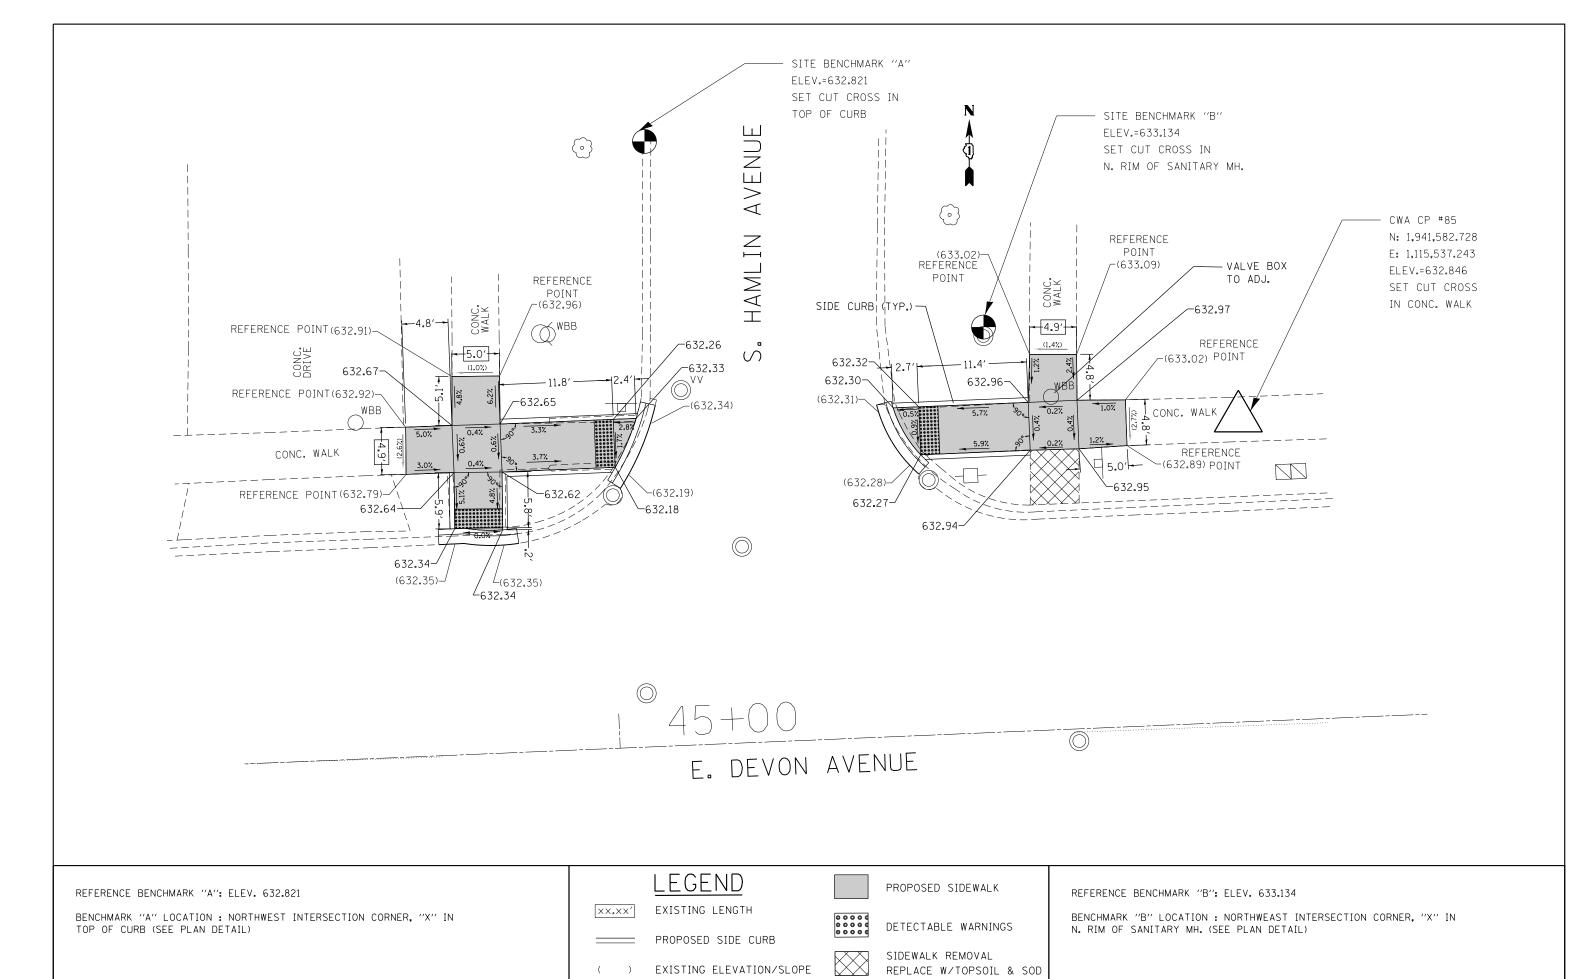
STATE OF ILLINOIS
DEPARTMENT OF TRANSPORTATION

ROADWAY PLAN	F.A.U. RTE.	SECTION	COUNTY	TOTAL SHEETS	SHEET NO.
DEVON AVE. (DES PLAINES RIVER RD. TO CANFIELD /	NF \ 1349	(3197A&B) RS-1	COOK	70	13
DEVOIT AVE. (DES TEARINES HIVER HD. TO CANTILLED A	\VL./		CONTRACT	T NO. 6	S2D18
SHEET OF SHEETS STA. TO S	TA.	TILINOIS FED AT	D PROJECT		




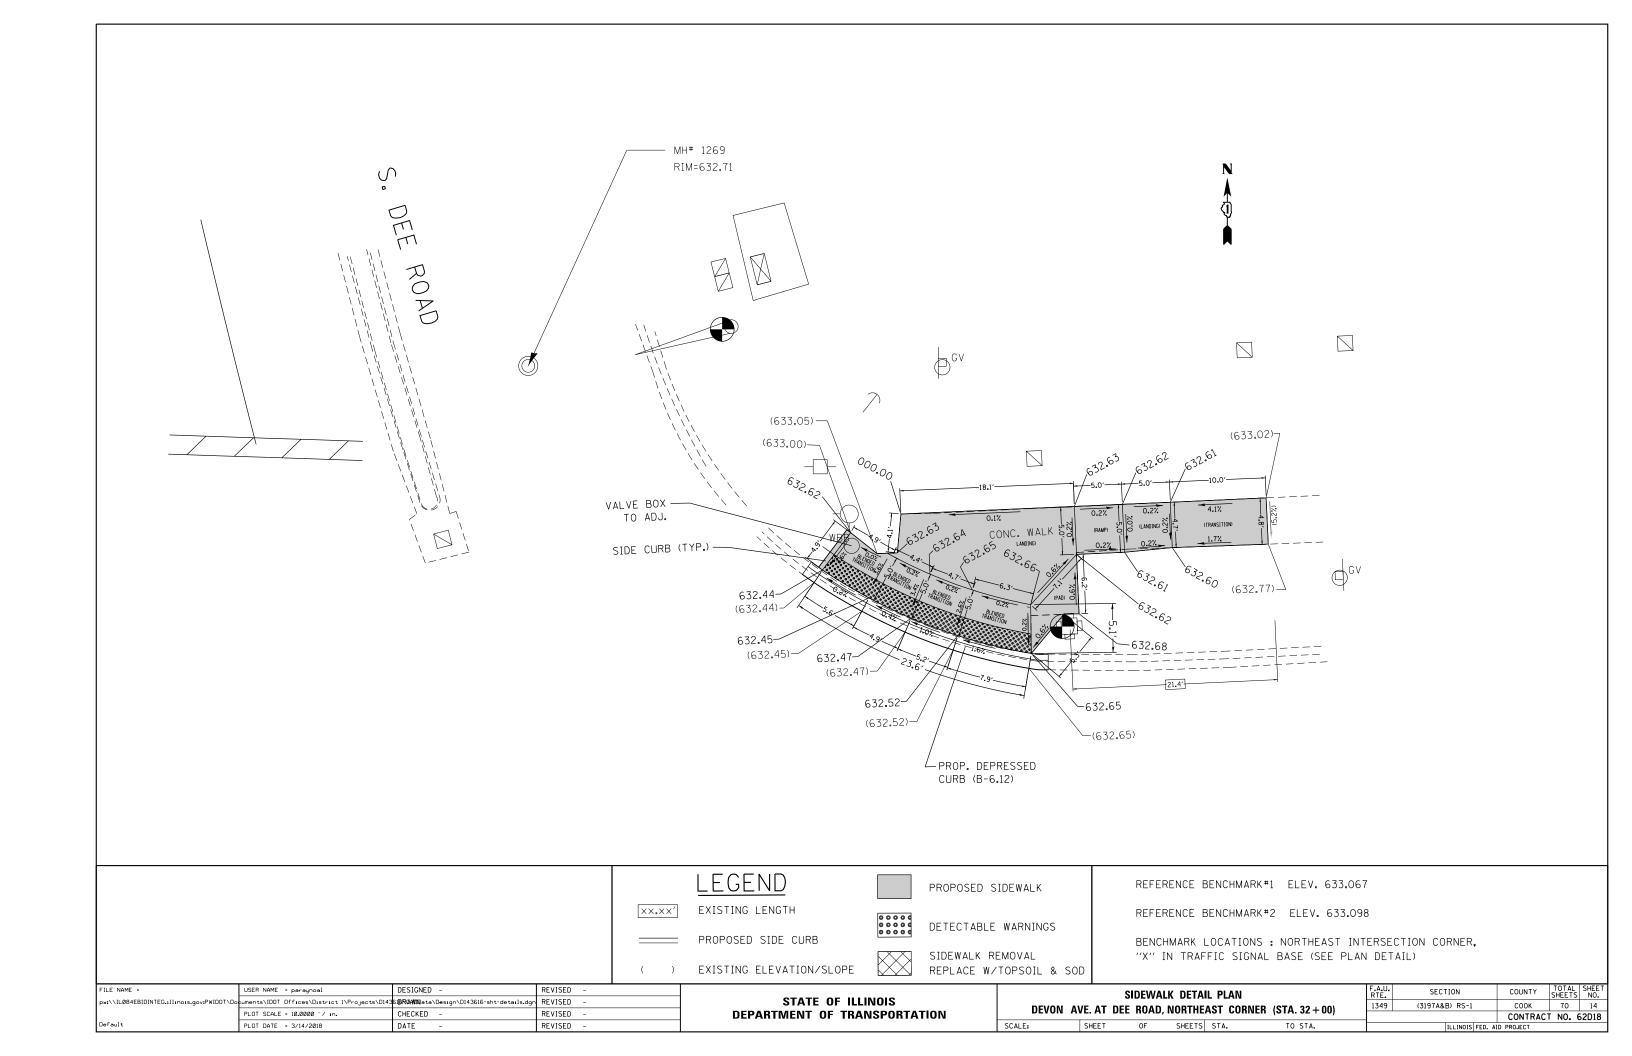

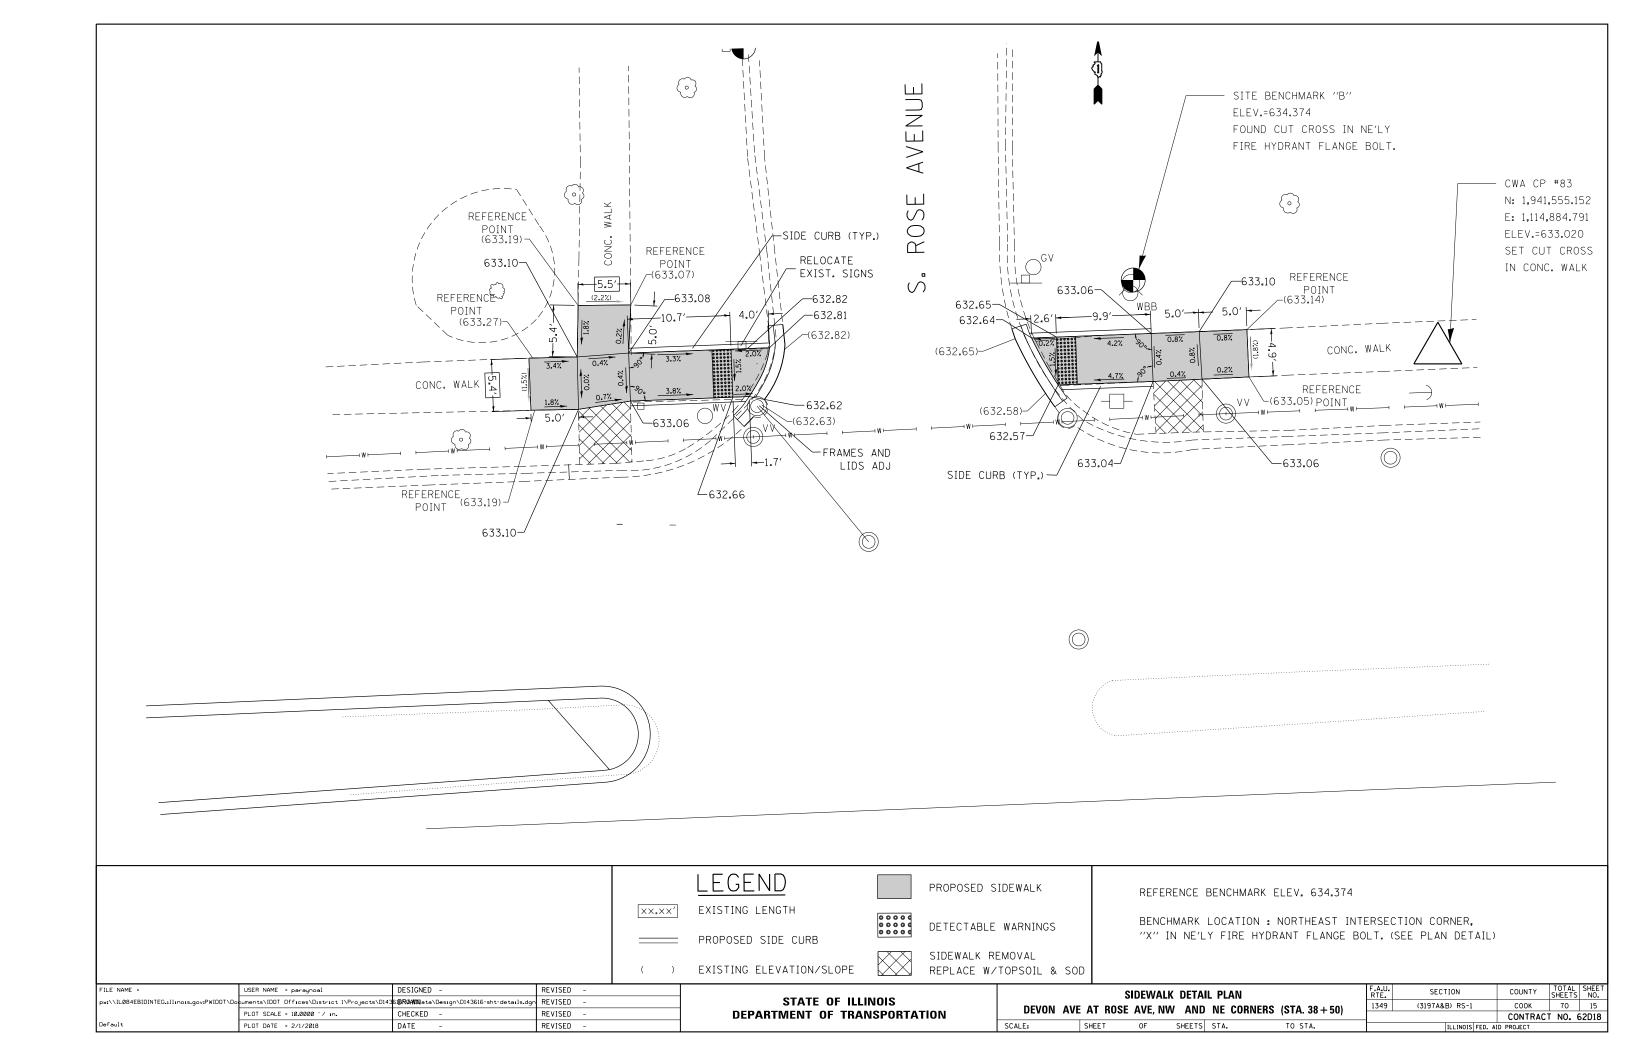


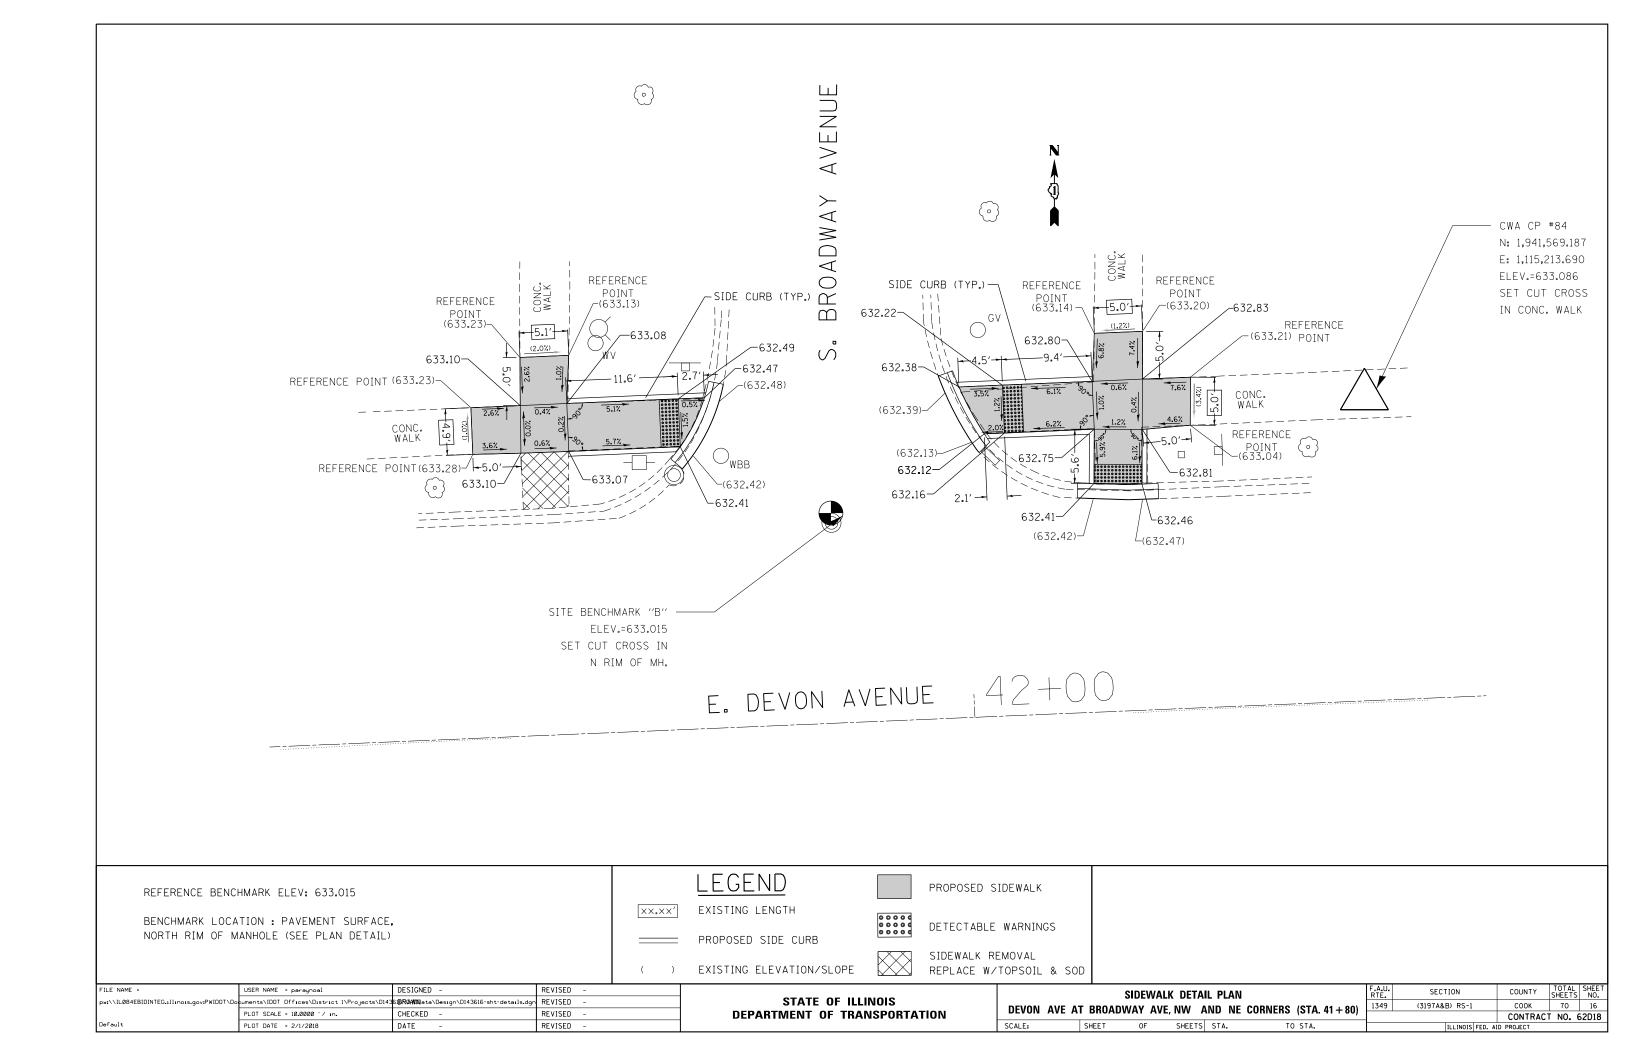

FILE NAME = DESIGNED -REVISED USER NAME = paraynoal SECTION COUNTY SIDEWALK DETAIL PLAN STATE OF ILLINOIS ow:\\ILØ84EBIDINTEG.:111:no: uments\IDOT Offices\District 1\Projects\D143<mark>616R(AMUN</mark>ata\Design\D143616-sht-details.dg REVISED 1349 (3197A&B) RS-1 COOK 70 17 DEVON AVE AT HAMLIN AVE, NW AND NE CORNERS (STA. 45 + 20) CHECKED -REVISED **DEPARTMENT OF TRANSPORTATION** CONTRACT NO. 62D18 OF SHEETS STA. PLOT DATE = 2/1/2018 REVISED DATE

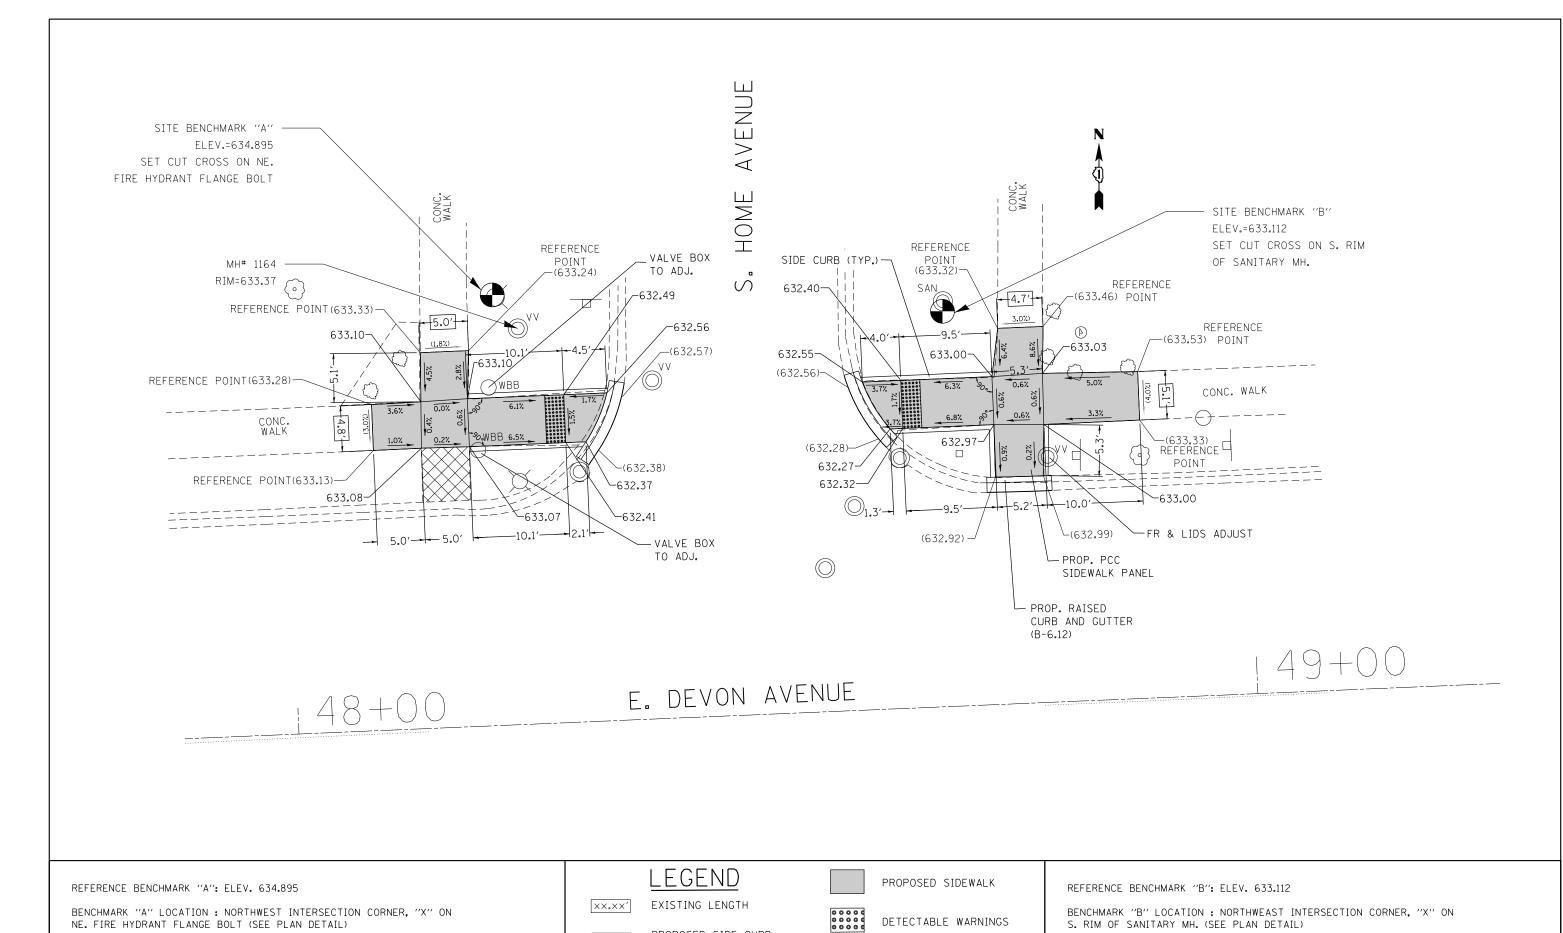

PROPOSED SIDE CURB SIDEWALK REMOVAL REPLACE W/TOPSOIL & SOD EXISTING ELEVATION/SLOPE TOTAL SHEET NO. 70 18 FILE NAME = DESIGNED -REVISED USER NAME = paraynoal SECTION SIDEWALK DETAIL PLAN STATE OF ILLINOIS ow:\\ILØ84EBIDINTEG.:111:no uments\IDOT Offices\District 1\Projects\D143<mark>61BR(ANN)</mark>ata\Design\D143616-sht-details.dg REVISED 1349 (3197A&B) RS-1 COOK DEVON AVE AT HOME AVE, NW AND NE CORNERS (STA. 48 + 40) CHECKED -REVISED **DEPARTMENT OF TRANSPORTATION** CONTRACT NO. 62D18 OF SHEETS STA. REVISED PLOT DATE = 2/1/2018

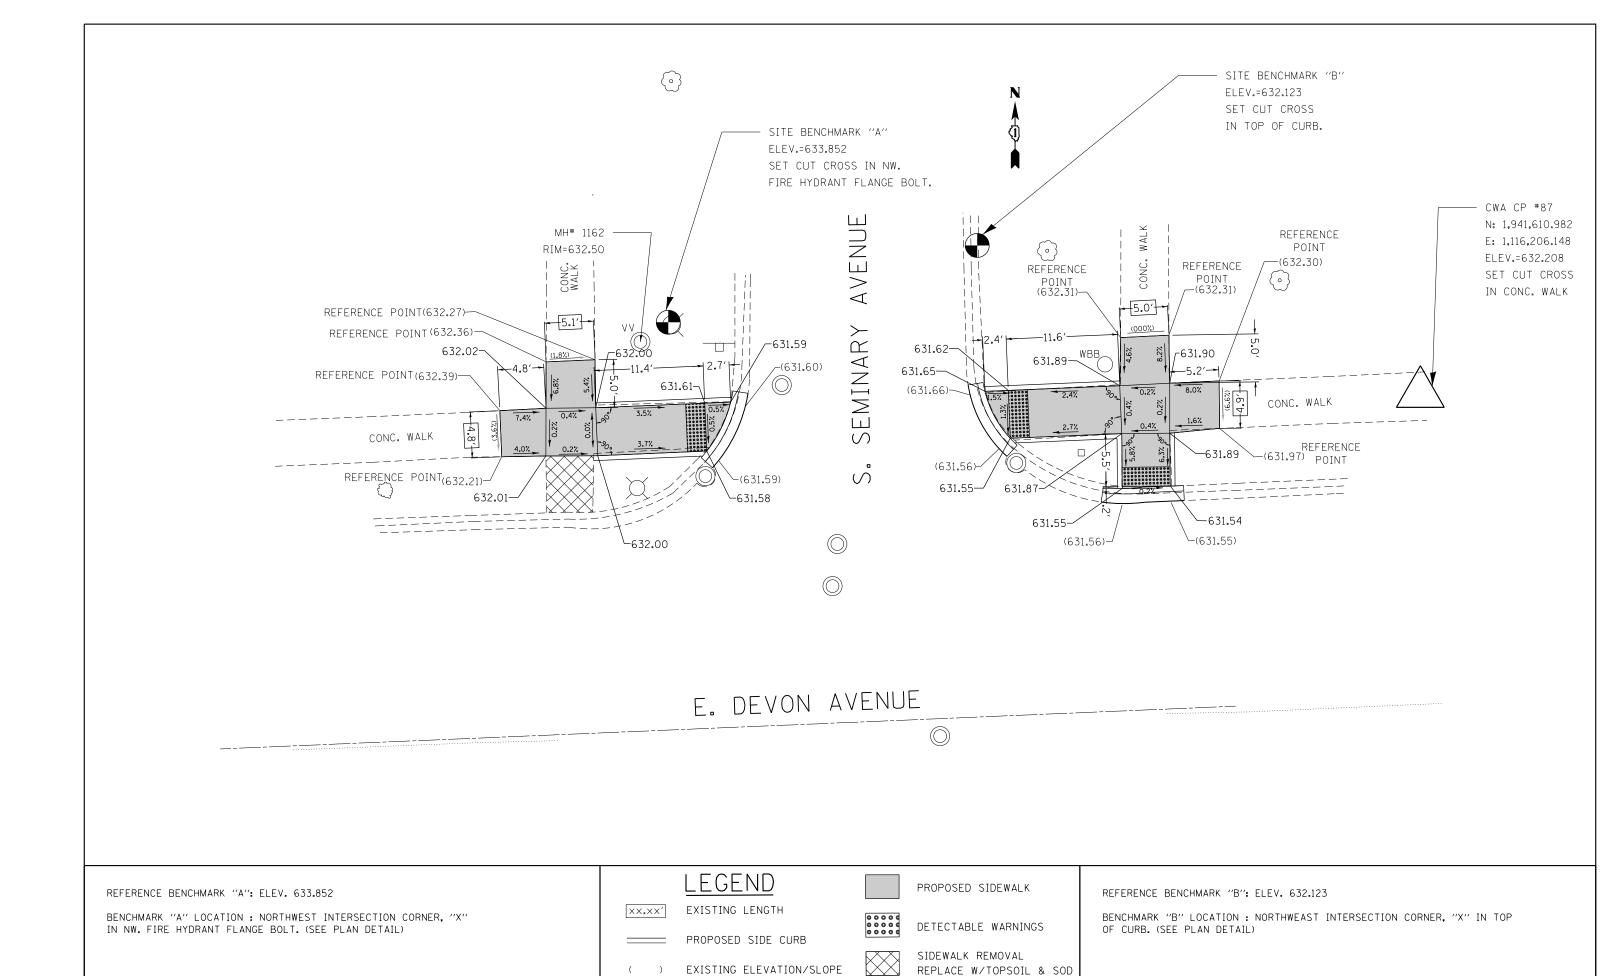


STATE OF ILLINOIS DEPARTMENT OF TRANSPORTATION


SIDEWALK DETAIL PLAN

DEVON AVE AT SEMINARY AVE, NW AND NE CORNERS (STA. 51 + 70)

SCALE: SHEET OF SHEETS STA. TO STA.

| F.A.U. | SECTION | COUNTY | TOTAL SHEET | NO. |
| 1349 | (3197A&B) RS-1 | COOK | 70 | 19 |
| CONTRACT NO. 62D18

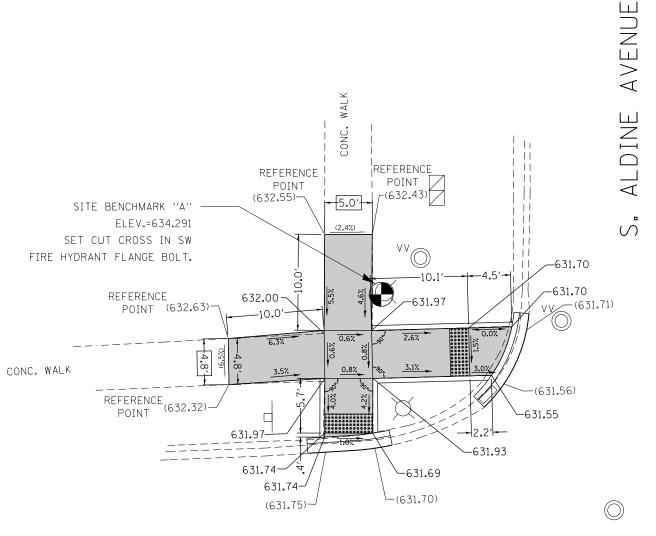

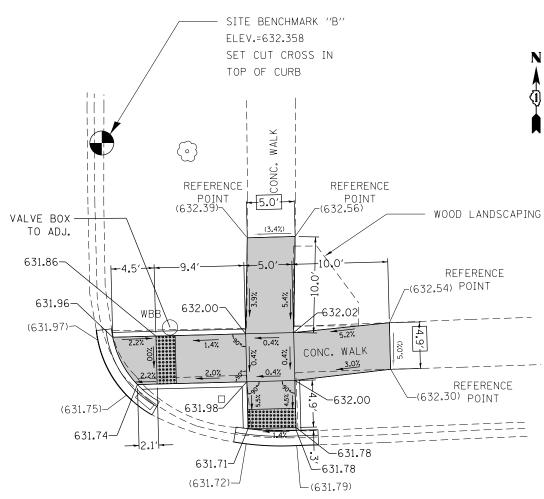

REFERENCE BENCHMARK "A": ELEV. 634.291

BENCHMARK "A" LOCATION : NORTHWEST INTERSECTION CORNER, "X" IN SW. FIRE HYDRANT FLANGE BOLT. (SEE PLAN DETAIL)

LEGEND

PROPOSED SIDE CURB

EXISTING ELEVATION/SLOPE

PROPOSED SIDEWALK

REPLACE W/TOPSOIL & SOD

REFERENCE BENCHMARK "B": ELEV. 632.358

EXISTING LENGTH

DETECTABLE WARNINGS

── SIDEWALK REMOVAL BENCHMARK "B" LOCATION: NORTHWEAST INTERSECTION CORNER, "X" IN TOP OF CURB. (SEE PLAN DETAIL)

TOTAL SHEET NO. 70 20


CONTRACT NO. 62D18

COUNTY

COOK


STATE OF ILLINOIS
DEPARTMENT OF TRANSPORTATION


	F.A.U. RTE.	SECTION				
DEVON AVE AT	ALDINE AVE NV	V AND NE CO	RNERS (STA. 55 + 00)	1349	(3197A&B) RS-1	Γ
DEVOIT AVE AT	ALDINE AVE, INV	V AND NE CO	111VE113 (31A. 33 + 00)			Γ
SCALE: SHEE	ET OF	SHEETS STA.	TO STA.		ILLINOIS FED. A	īD

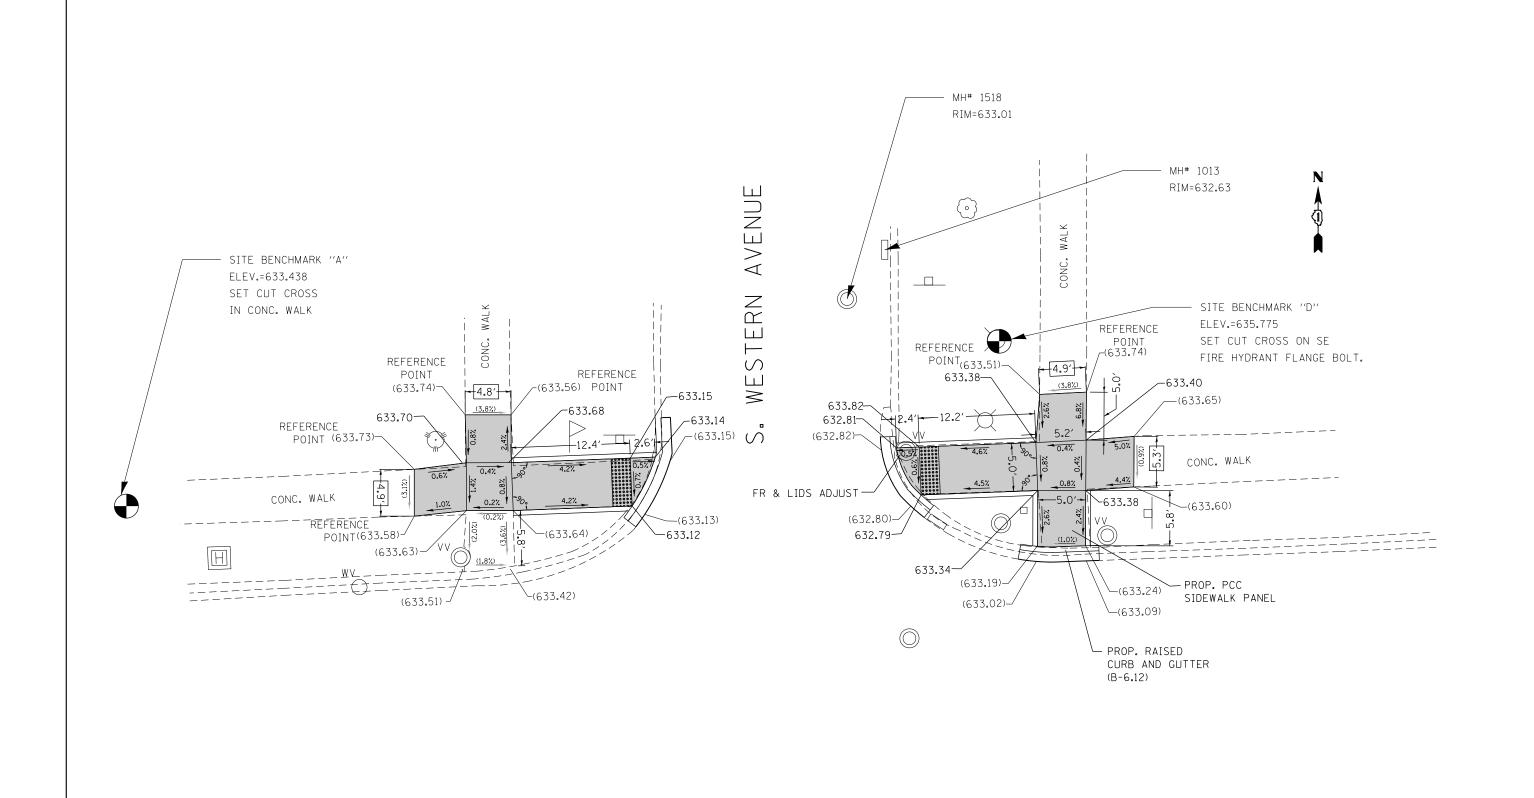



LEGEND PROPOSED SIDEWALK REFERENCE BENCHMARK "A": ELEV. 633.438 REFERENCE BENCHMARK "D": ELEV. 635.775 EXISTING LENGTH XX.XX' BENCHMARK "A" LOCATION: NORTHWEST INTERSECTION CORNER, "X" BENCHMARK "D" LOCATION: NORTHEAST INTERSECTION CORNER, "X" DETECTABLE WARNINGS IN CONC. WALK (SEE PLAN DETAIL) ON SEFIRE HYDRANT FLANGE BOLT. (SEE PLAN DETAIL) PROPOSED SIDE CURB SIDEWALK REMOVAL EXISTING ELEVATION/SLOPE REPLACE W/TOPSOIL & SOD


	ILE NAME =	USER NAME = paraynoal		REVISED -	CTATE OF HUMOIC	SIDEWALK DETAIL PLAN					F.A.U. RTE.	SECTION	COUNTY	TOTAL SHEET SHEETS NO.	
	w:\\ILØ84EBIDINTEG.:llinois.gov:PWIDOT\Do	cuments\IDOT Offices\District I\Projects\D143		REVISED -	STATE OF ILLINOIS	DEVON A	WE AT WEST	FRN AVE	NIM A	NID NE CO	BNERS (STA 58 ± 20)	1349	(3197A&B) RS-1	соок	70 21
		PLOT SCALE = 10.0000 '/ in.	CHECKED -	REVISED -	DEPARTMENT OF TRANSPORTATION	DEVOIN P	DEVON AVE AT WESTERN AVE, NW AND NE CORNERS		1111E113 (31A. 30 + 20)			CONTRA	CT NO. 62D18		
	efault	PLOT DATE = 2/1/2018	DATE -	REVISED -		SCALE:	SHEET	OF	SHEETS	S STA.	TO STA.		ILLINOIS FED.	AID PROJECT	
_															

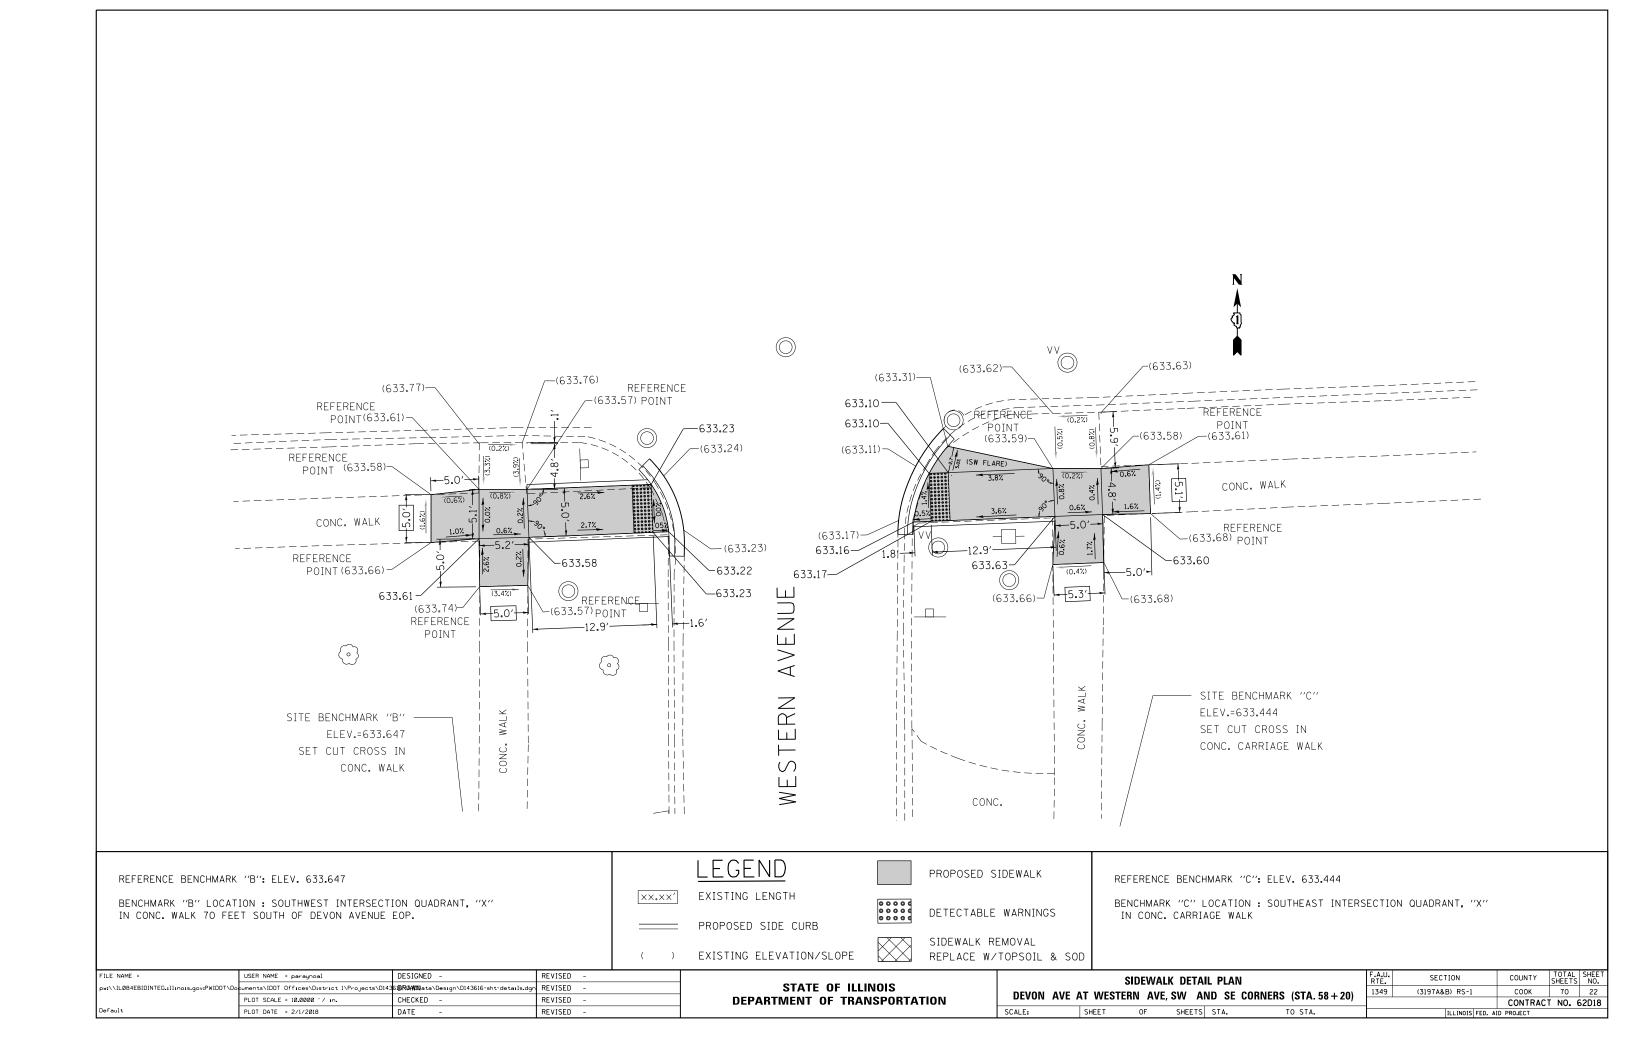

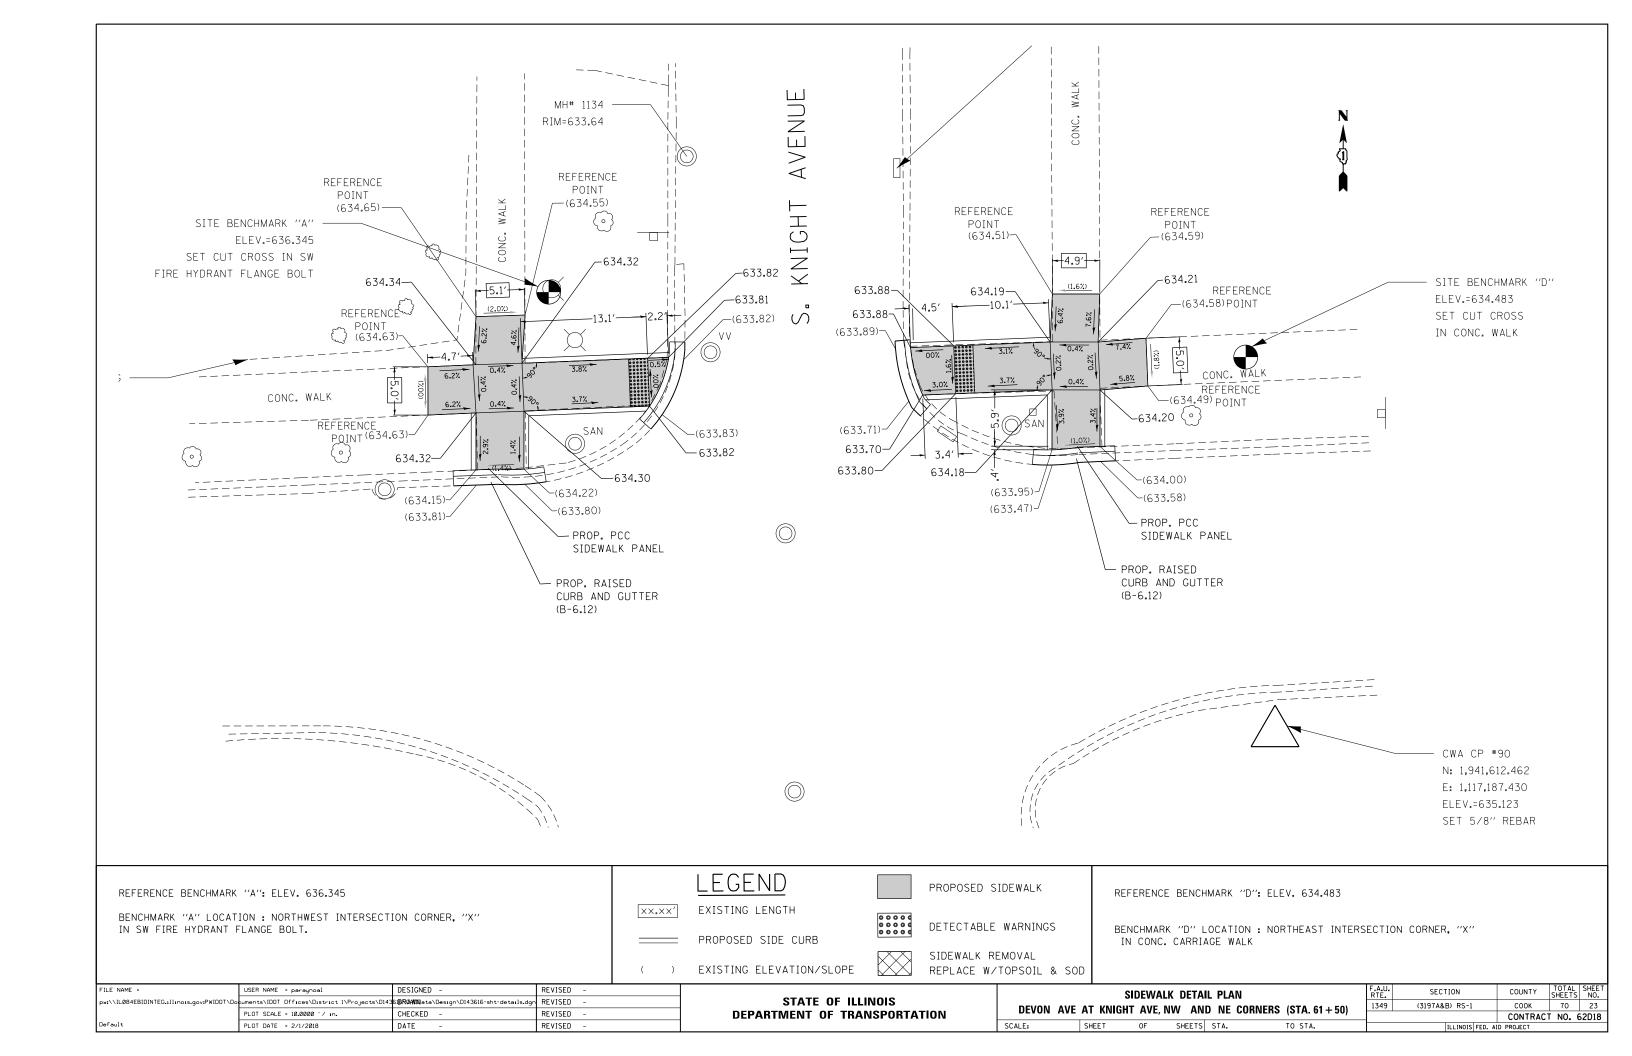

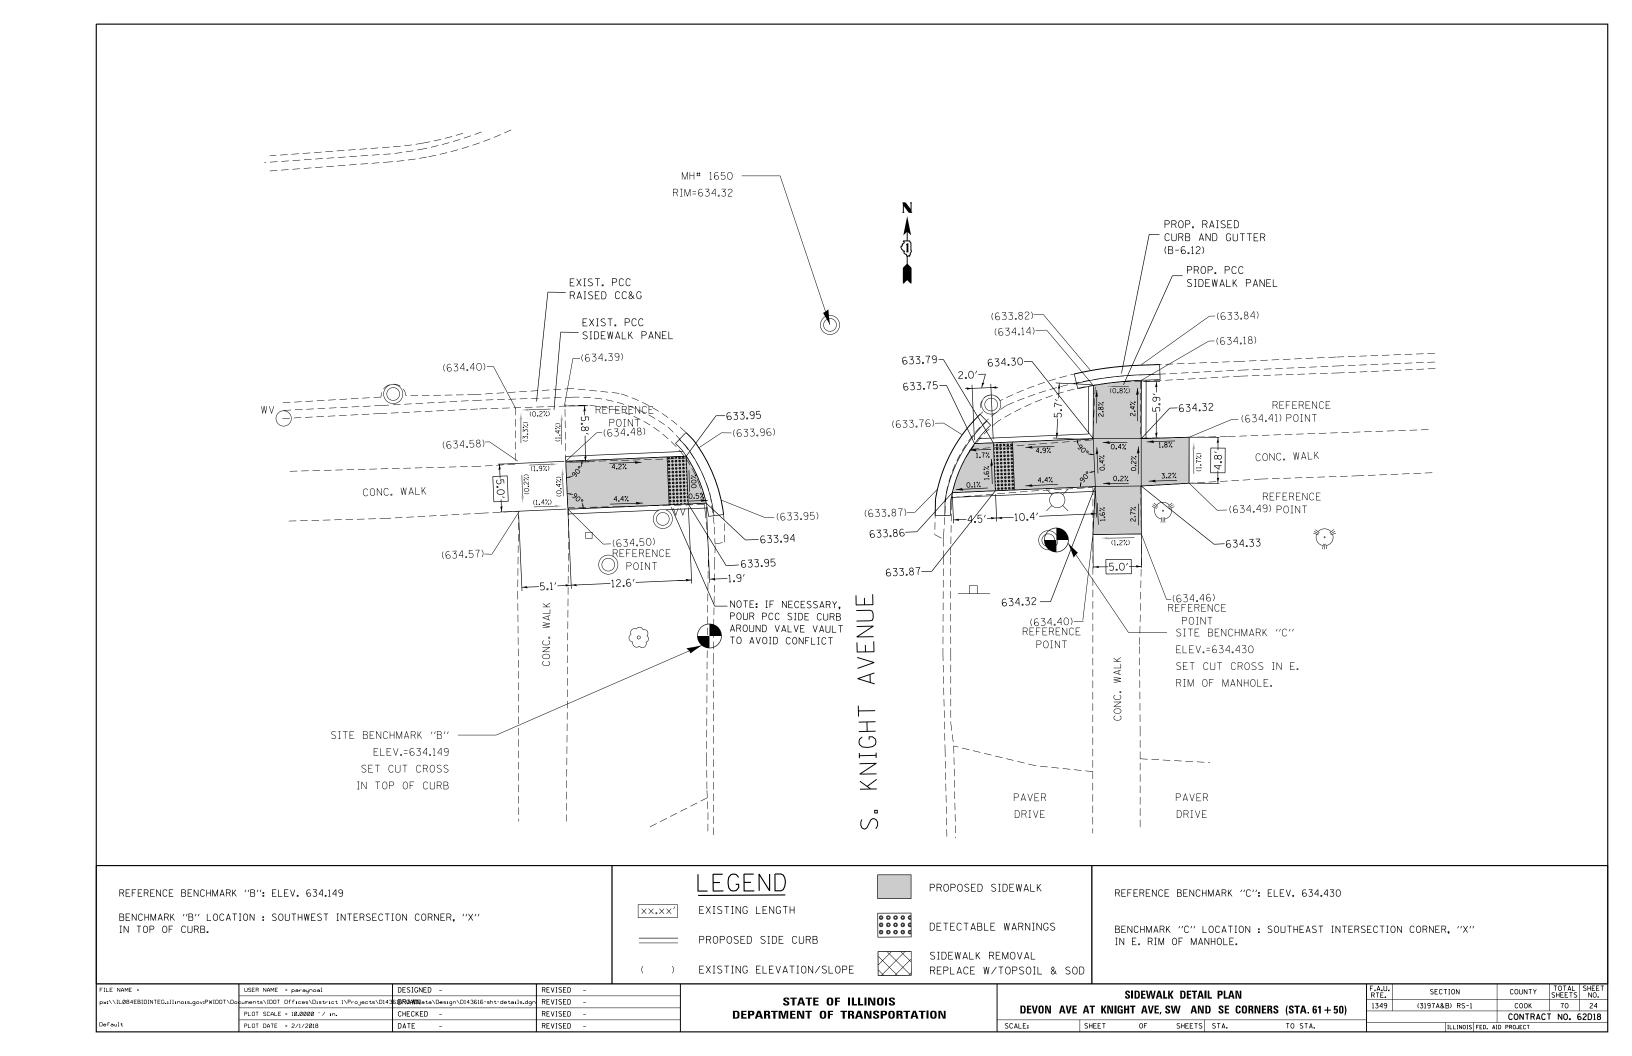

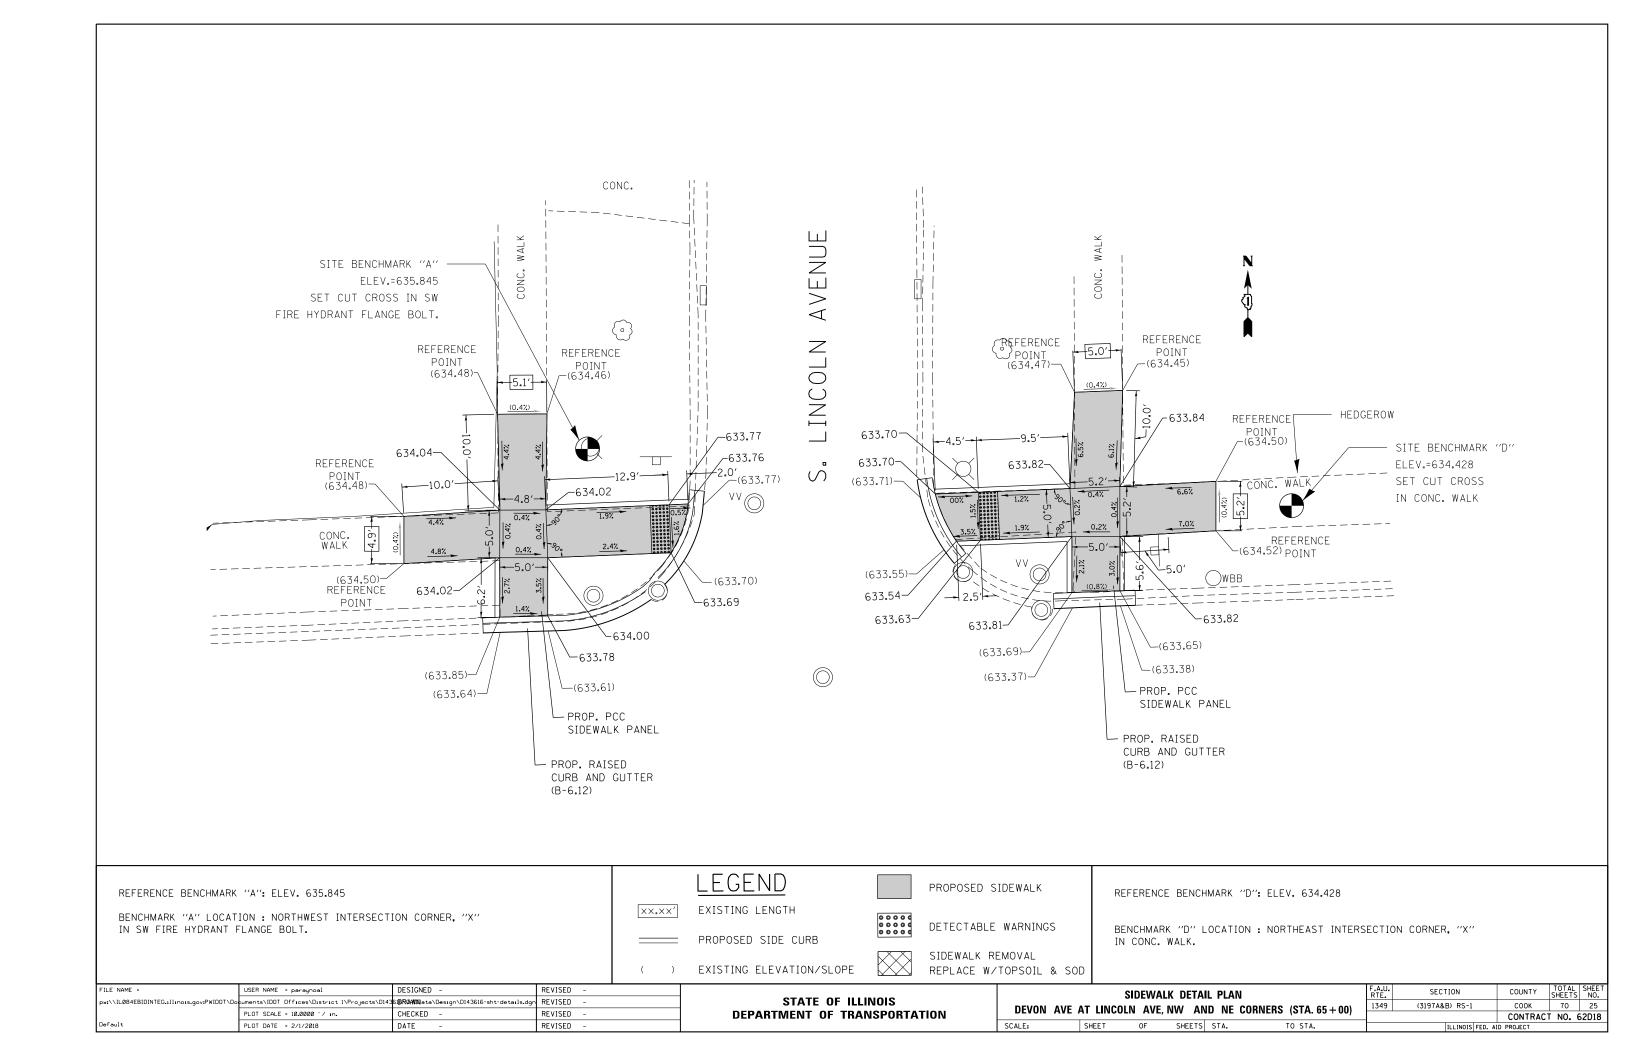

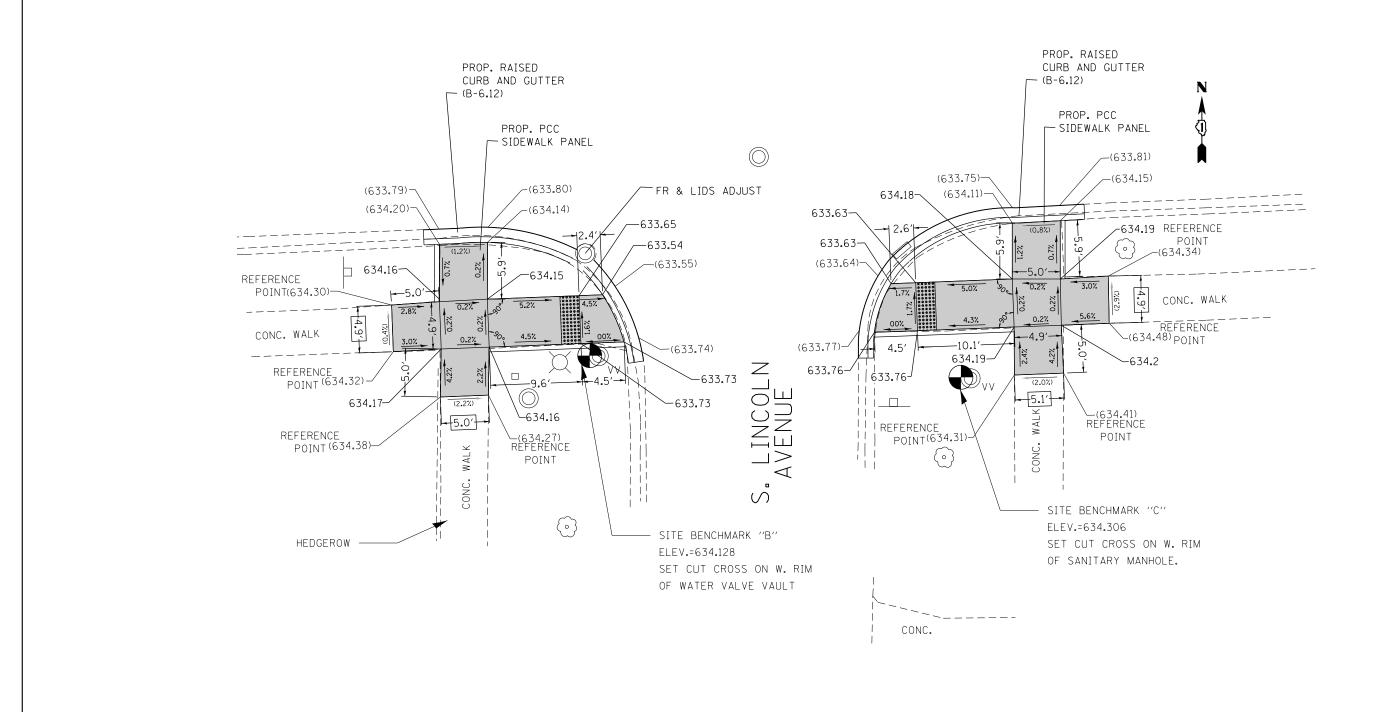

BENCHMARK "B" LOCATION : SOUTHWEST INTERSECTION CORNER, "X" ON W. RIM OF WATER VALVE VAULT.

REFERENCE BENCHMARK "B": ELEV. 634.128

LEGEND

EXISTING ELEVATION/SLOPE

PROPOSED SIDEWALK

REPLACE W/TOPSOIL & SOD

REFERENCE BENCHMARK "C": ELEV. 634.306

XX.XX' EXISTING LENGTH

PROPOSED SIDE CURB

DETECTABLE WARNINGS


ON W. RIM OF SAN'S SIDEWALK REMOVAL

BENCHMARK "C" LOCATION: SOUTHEAST INTERSECTION CORNER, "X" ON W. RIM OF SANITARY MANHOLE.

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	PLOT SCALE = 10.0000 '/ in.	CHECKED -	REVISED -	ı
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STATE OF ILLINOIS
DEPARTMENT OF TRANSPORTATION


		SIDEWA	F.A.U. RTE.	SECTION	COUNTY	TOT			
DEVON AVE AT LINCOLN AVE, SW AND SE CORNERS (STA. 65 + 00)							(3197A&B) RS-1	соок	70
								CONTRAC	T NO
SCALE:	SHEET	OF	SHEETS	STA.	TO STA.		ILLINOIS FED. A	ID PROJECT	

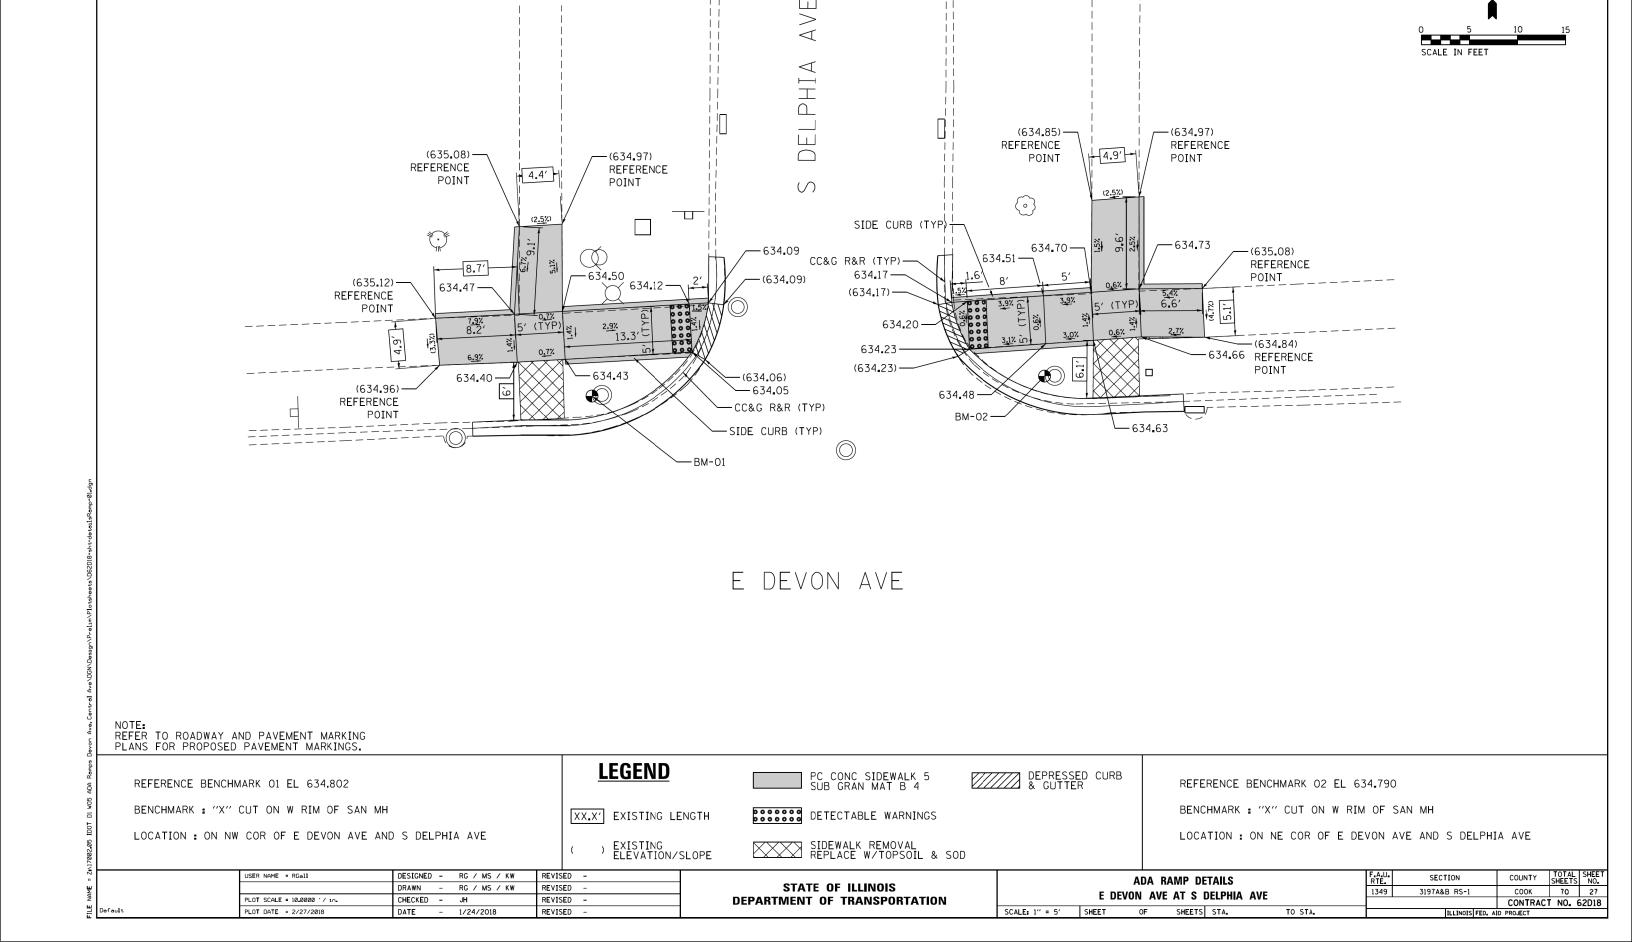


E DEVON AVE (634.87) REFERENCE POINT — (634**.**44) (634.47) — 634.63 -**−**634**.**63 SIDE CURB (TYP)-634.69--CC&G R&R (TYP) CC&G R&R (TYP)--SIDE CURB (TYP) (634,49) -634.56 634.48 -(635.01) REFERENCE POINT -634.57 6.9% 5.2′ (634.53)--(634,67) -634.67 634.52 £634<u>.6</u>7— -634.76 -634.66 634.53 634.76 --BM-03 -(634.78) REFERENCE POINT ++FR & LIDS ADJUST (634.76) -REFERENCE POINT -(634.82) REFERENCE POINT 5' (TYP) (634.93) REFERENCE POINT -(634.89) REFERENCE POINT -5**.**2′ ELPHIA \bigcirc NOTE: REFER TO ROADWAY AND PAVEMENT MARKING PLANS FOR PROPOSED PAVEMENT MARKINGS. **LEGEND** PC CONC SIDEWALK 5 SUB GRAN MAT B 4 REFERENCE BENCHMARK 03 EL 634.919 REFERENCE BENCHMARK 04 EL 634.806 BENCHMARK : "X" ON N RIM OF CB BENCHMARK : "X" ON NE COR TS HH DETECTABLE WARNINGS XX.X' EXISTING LENGTH LOCATION: ON SW COR OF E DEVON AVE AND S DELPHIA AVE LOCATION: ON SE COR OF E DEVON AVE AND S DELPHIA AVE SIDEWALK REMOVAL REPLACE W/TOPSOIL & SOD) EXISTING ELEVATION/SLOPE COUNTY SHEETS NO.

COOK 70 28


CONTRACT NO. 62D18 USER NAME = RGall DESIGNED - RG / MS / KW REVISED -SECTION ADA RAMP DETAILS STATE OF ILLINOIS DRAWN - RG / MS / KW REVISED -3197A&B RS-1 1349 E DEVON AVE AT S DELPHIA AVE PLOT SCALE = 10.0000 '/ in. CHECKED - JH REVISED -**DEPARTMENT OF TRANSPORTATION** SCALE: 1" = 5' SHEET SHEETS STA. PLOT DATE = 2/27/2018 DATE - 1/24/2018

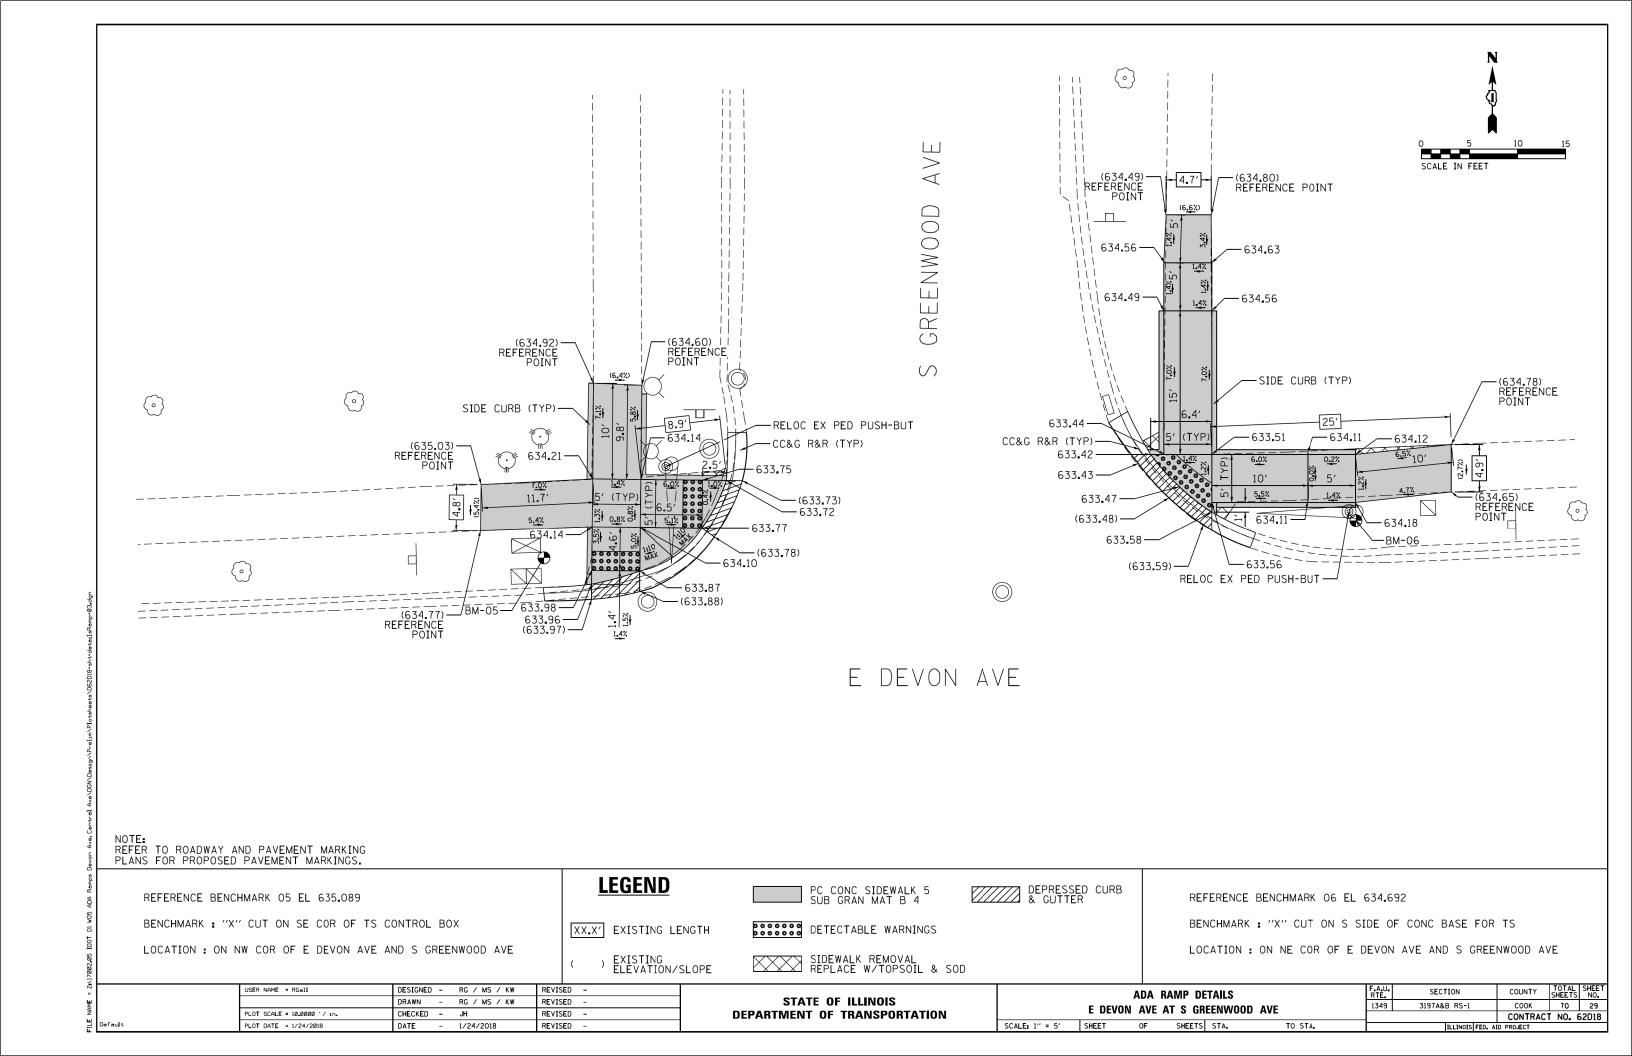

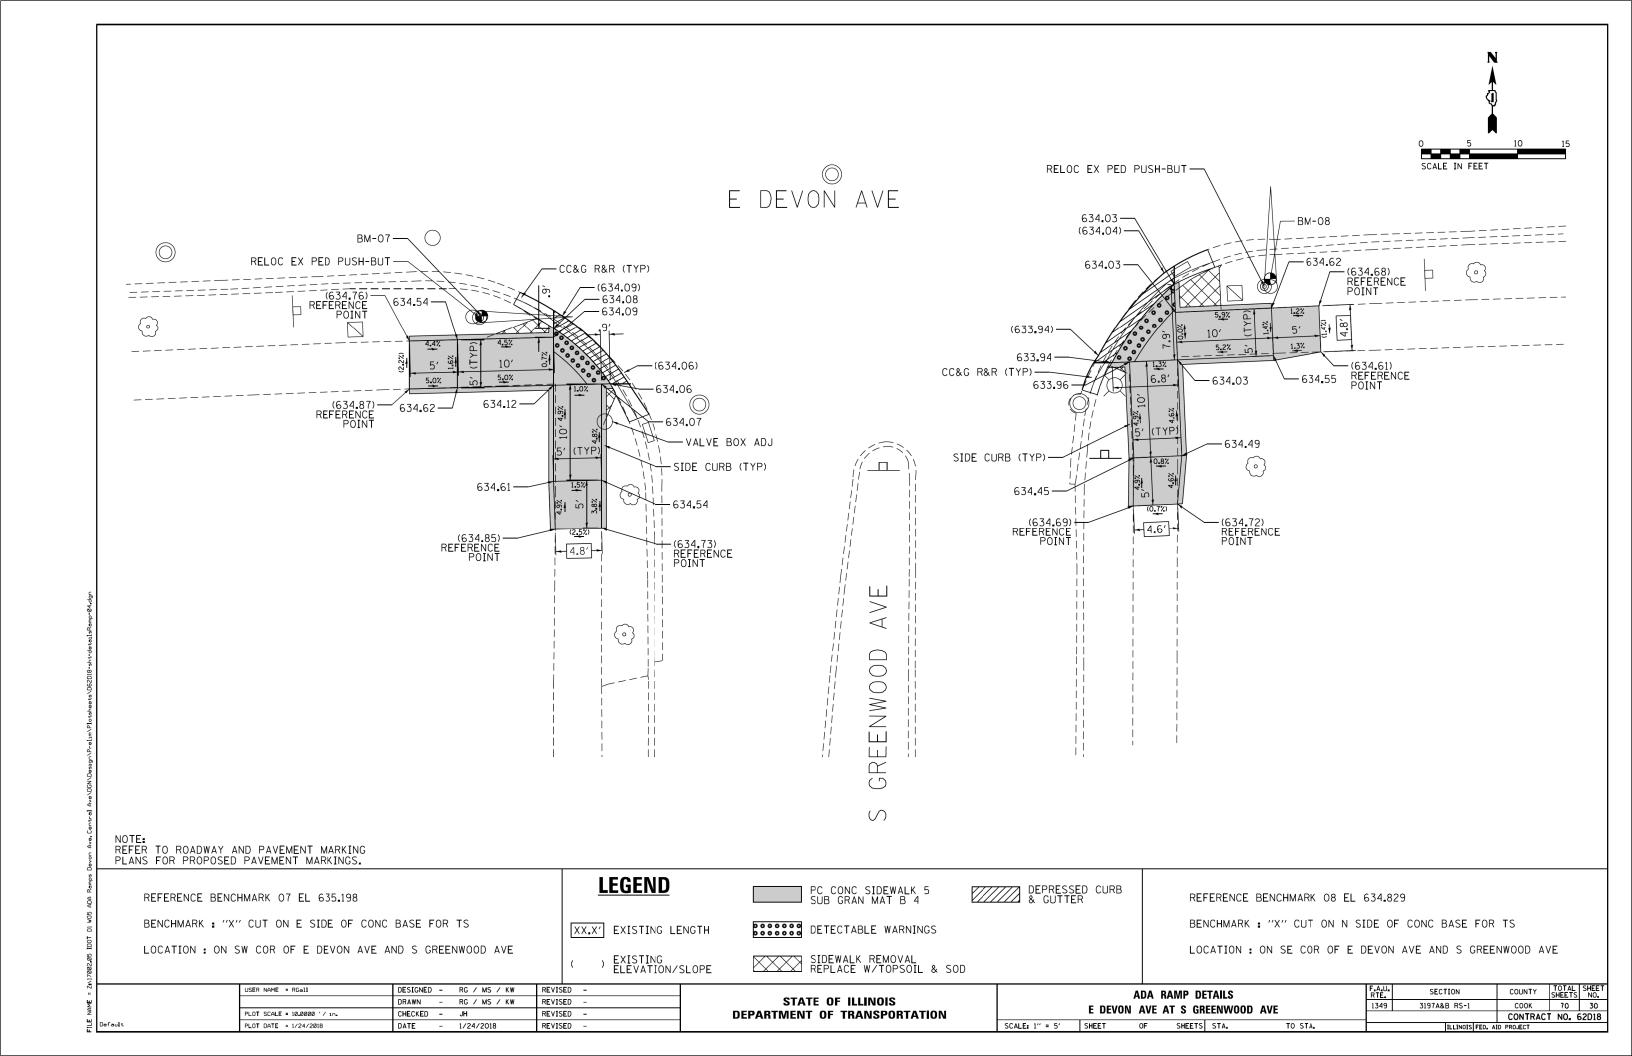

AVE (e) (635.45) --(635**.**53) REFERENCE REFERENCE POINT POINT CHES 5' (TYP), (635.58) (635.51) 5' (TYP) (1.6%) REFERENCE REFERENCE POINT POINT (1.4%) -SIDE CURB (TYP) \bigcirc - 634**.**93 - 635**.**05 -**/** ← 634**.**79 -(635**.**49) -635.02 REFERENCE SIDE CURB (TYP) 3.9% −BM-09 634.92-(635.54)-POINT REFERENCE (634.93) -635.10 -POINT **-** (634**.**76) 5<u>.3%</u> 8**.**9′ 6.78^{\(\)} 8.7′ 2<u>.2%</u> 11**.**6′ FR & LIDS ADJUST -(635.43) 3.4% REFERENCE (634.87)-POINT 634.86 634.83 CC&G R&R (TYP)-·CC&G R&R (TYP) -634.98 FR & LIDS ADJUST FR & LIDS ADJUST (635.40) (634,86) REFERENCE POINT -635.15 E DEVON AVE NOTE: REFER TO ROADWAY AND PAVEMENT MARKING PLANS FOR PROPOSED PAVEMENT MARKINGS. **LEGEND** PC CONC SIDEWALK 5 SUB GRAN MAT B 4 REFERENCE BENHCMARK 09 EL 636.631 BENCHMARK : "X" CUT IN SW FH FLANGE BOLT DETECTABLE WARNINGS XX.X' EXISTING LENGTH LOCATION: ON NW COR OF E DEVON AVE AND S CHESTER AVE SIDEWALK REMOVAL REPLACE W/TOPSOIL & SOD) EXISTING ELEVATION/SLOPE COUNTY TOTAL SHEETS NO.

COOK 70 31 USER NAME = RGall DESIGNED - RG / MS / KW REVISED -SECTION ADA RAMP DETAILS STATE OF ILLINOIS DRAWN - RG / MS / KW REVISED -1349 3197A&B RS-1 E DEVON AVE AT S CHESTER AVE PLOT SCALE = 10.00000 '/ in. CHECKED - JH REVISED -**DEPARTMENT OF TRANSPORTATION** CONTRACT NO. 62D18 SCALE: 1" = 5' SHEET OF SHEETS STA. TO STA. PLOT DATE = 2/27/2018 DATE - 1/24/2018 REVISED

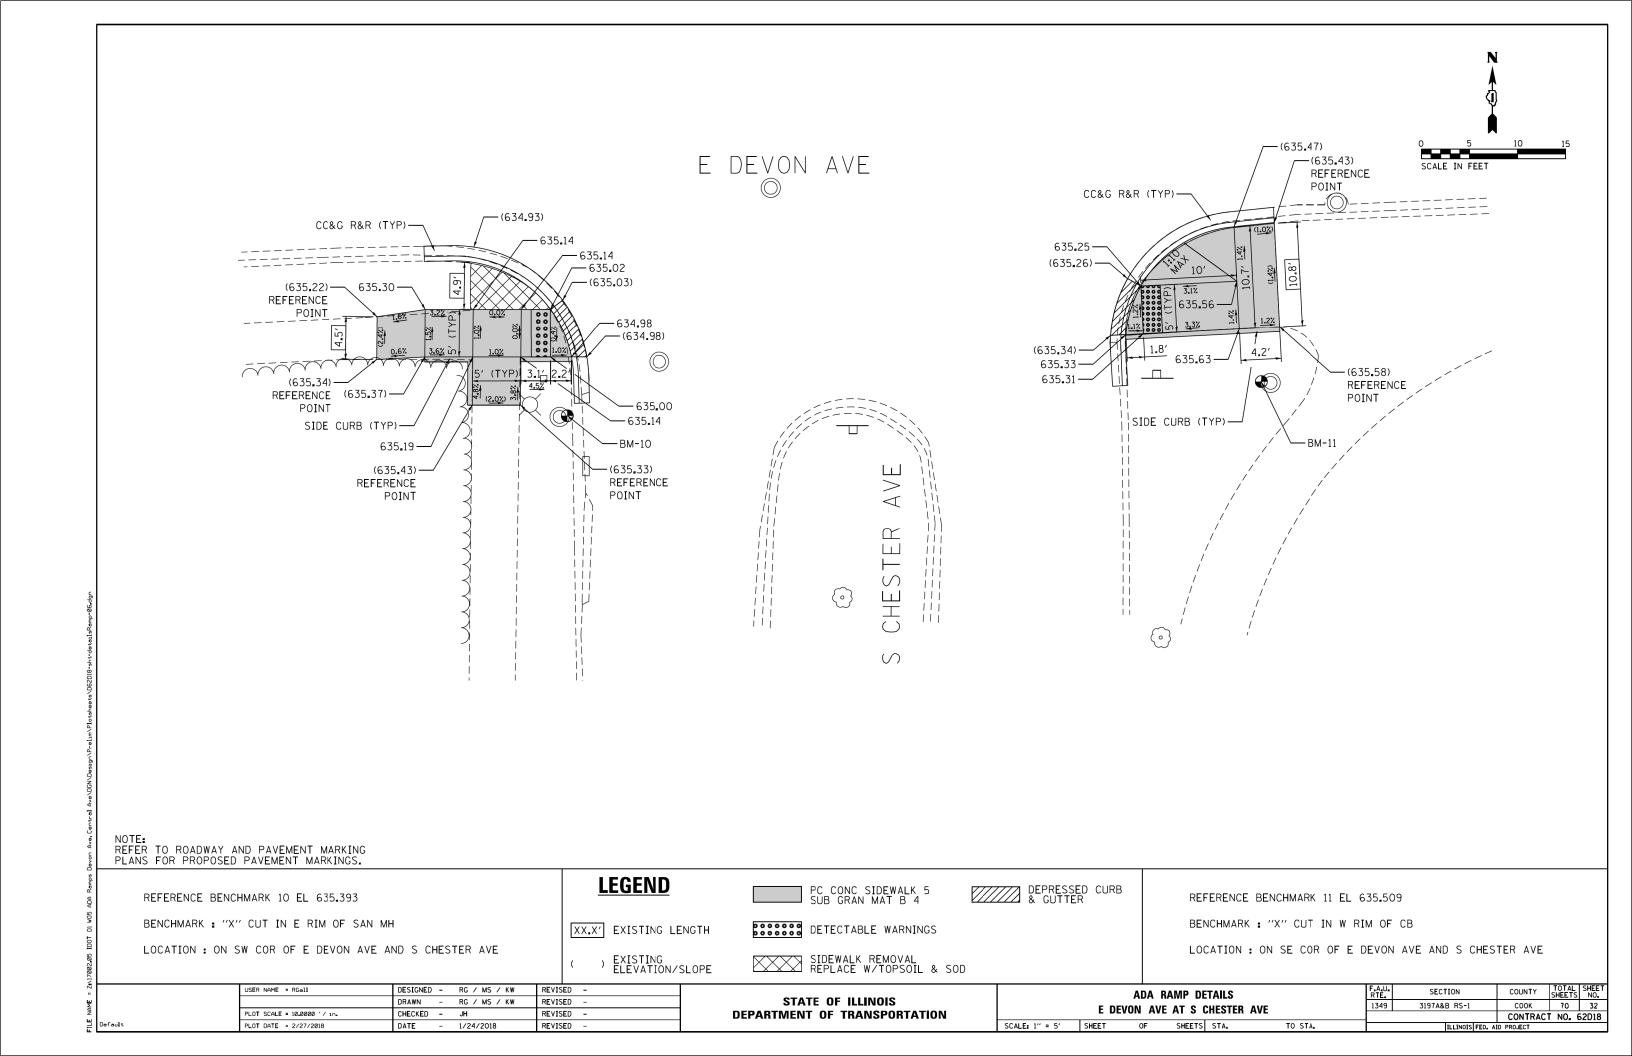

CC&G R&R (TYP)

CC&G R&R (TYP)

CC&G R&R (TYP)

CC&G R&R (TYP)

G37.25

G37.25

G37.20

10.0' 5′ — (637**.**46) (0.0%) 637.39 (637.08)--(637**.**48)/ -(636.98) REFERENCE 637.07-(637.32)— --- 637**.**27 POINT 637.10 -REFERENCE SIDE CURB (TYP)-POINT (637.30)-REFERENCE -(637.44) POINT (637.39) **-**(637**.**29) REFERENCE REFERENCE POINT REFERENCE POINT POINT > \triangleleft (e) Z \bigcirc

NOTE:
REFER TO ROADWAY AND PAVEMENT MARKING
PLANS FOR PROPOSED PAVEMENT MARKINGS.

REFERENCE BENCHMARK 12 EL 637.241

BENCHMARK : "X" CUT IN W RIM OF WV VLT

LOCATION : ON SW COR OF E DEVON AVE AND S CLIFTON AVE

() EXISTING ELEVATION/SLOPE

LEGEND

XX.X' EXISTING LENGTH

PC CONC SIDEWALK 5 SUB GRAN MAT B 4

DETECTABLE WARNINGS

DEPRESSED CURB & GUTTER

REFERENCE BENCHMARK 13 EL 637.457

BENCHMARK : "X" CUT IN SE COR OF TS HH

LOCATION : ON SE COR OF DEVON AVE AND S CLIFTON AVE


SECTION 3197A&B RS-1 COUNTY SHEETS NO.


COOK 70 33


CONTRACT NO. 62D18


SIDEWALK REMOVAL
REPLACE W/TOPSOIL & SOD


USER NAME = RGall	DESIGNED -	RG / MS / KW	REVISED	-		ADA RAMP DETAILS E DEVON AVE AT S CLIFTON AVE						F.A.U. RTE.
	DRAWN -	RG / MS / KW	REVISED	-	STATE OF ILLINOIS							1349
PLOT SCALE = 10.0000 ' / 10.	CHECKED -	JH	REVISED	-	DEPARTMENT OF TRANSPORTATION		E DE/	ON AVE	AI S CL	IFION AVE		
PLOT DATE = 1/24/2018	DATE -	1/24/2018	REVISED	-		SCALE: 1" = 5"	SHEET	OF	SHEETS S	STA.	TO STA.	

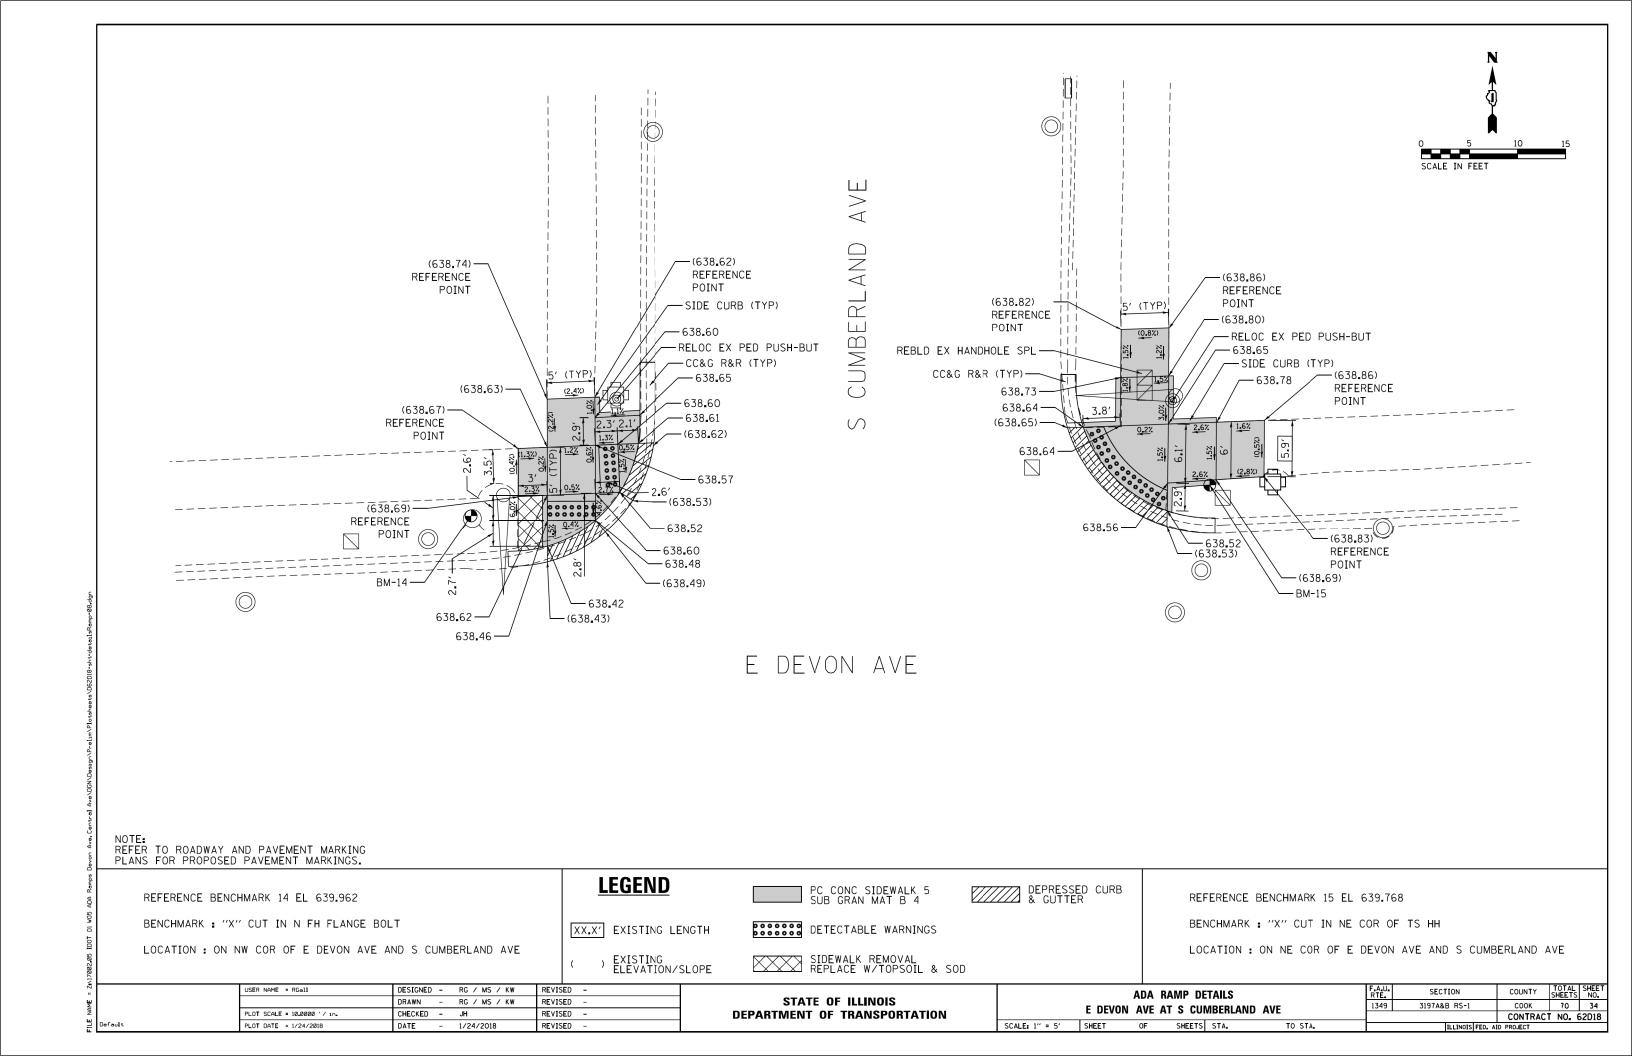


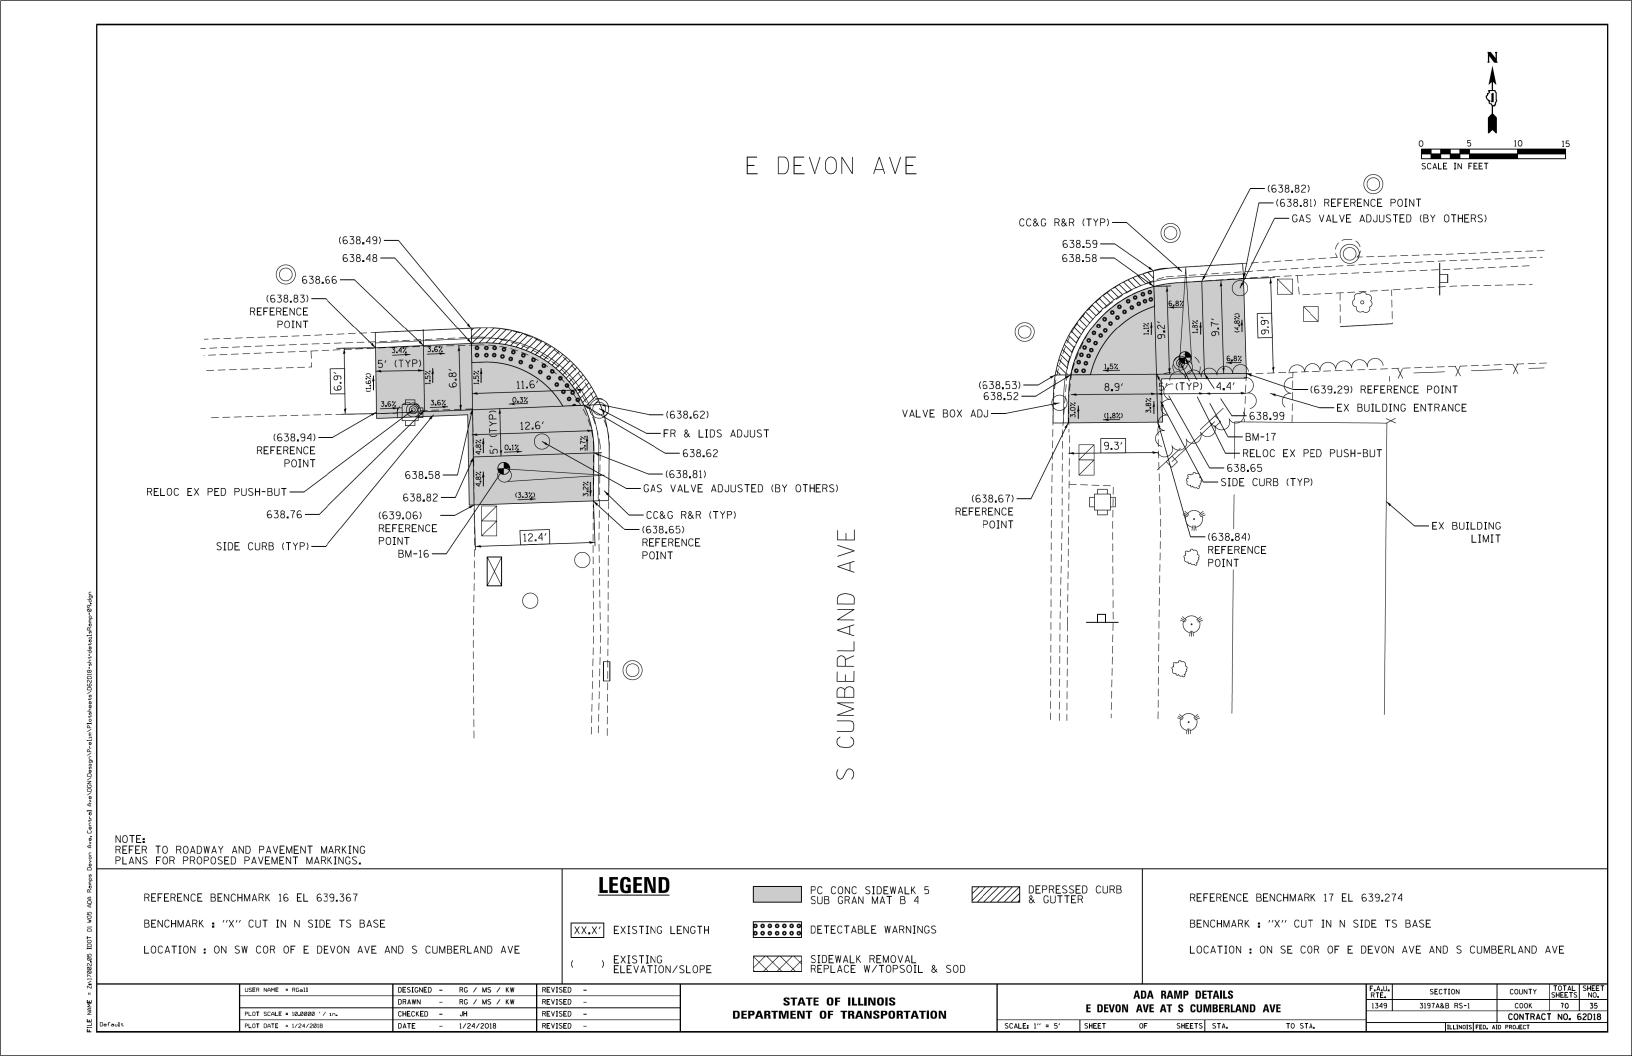


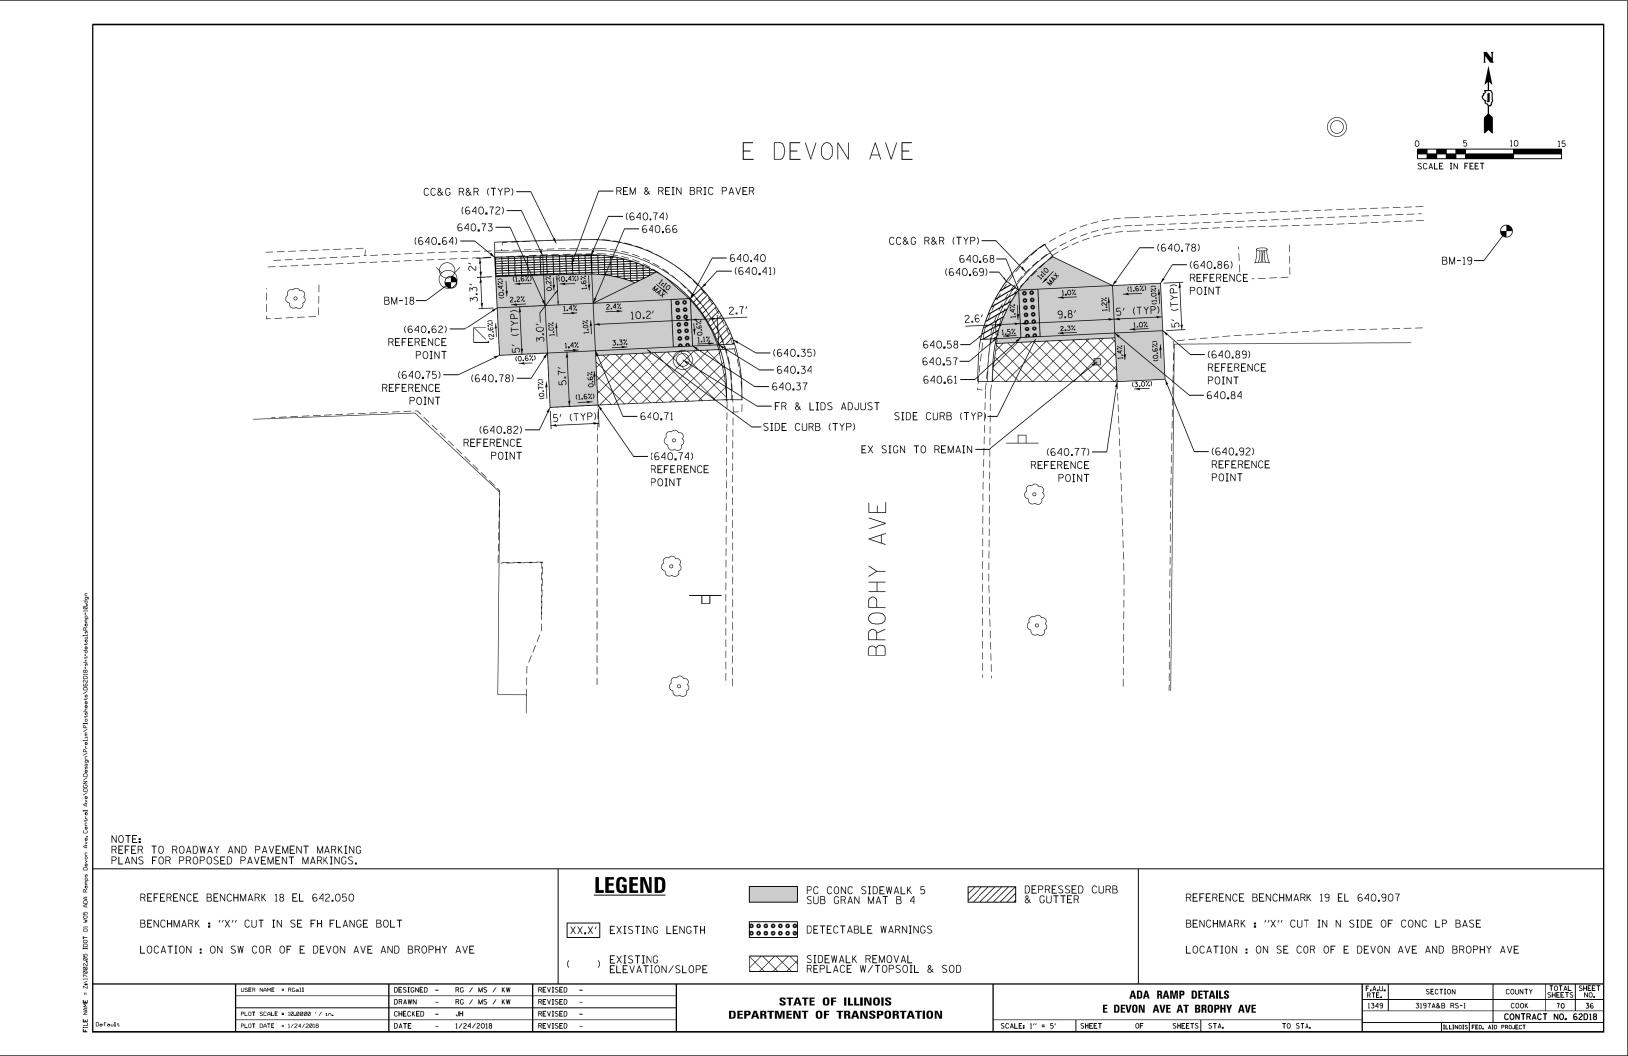

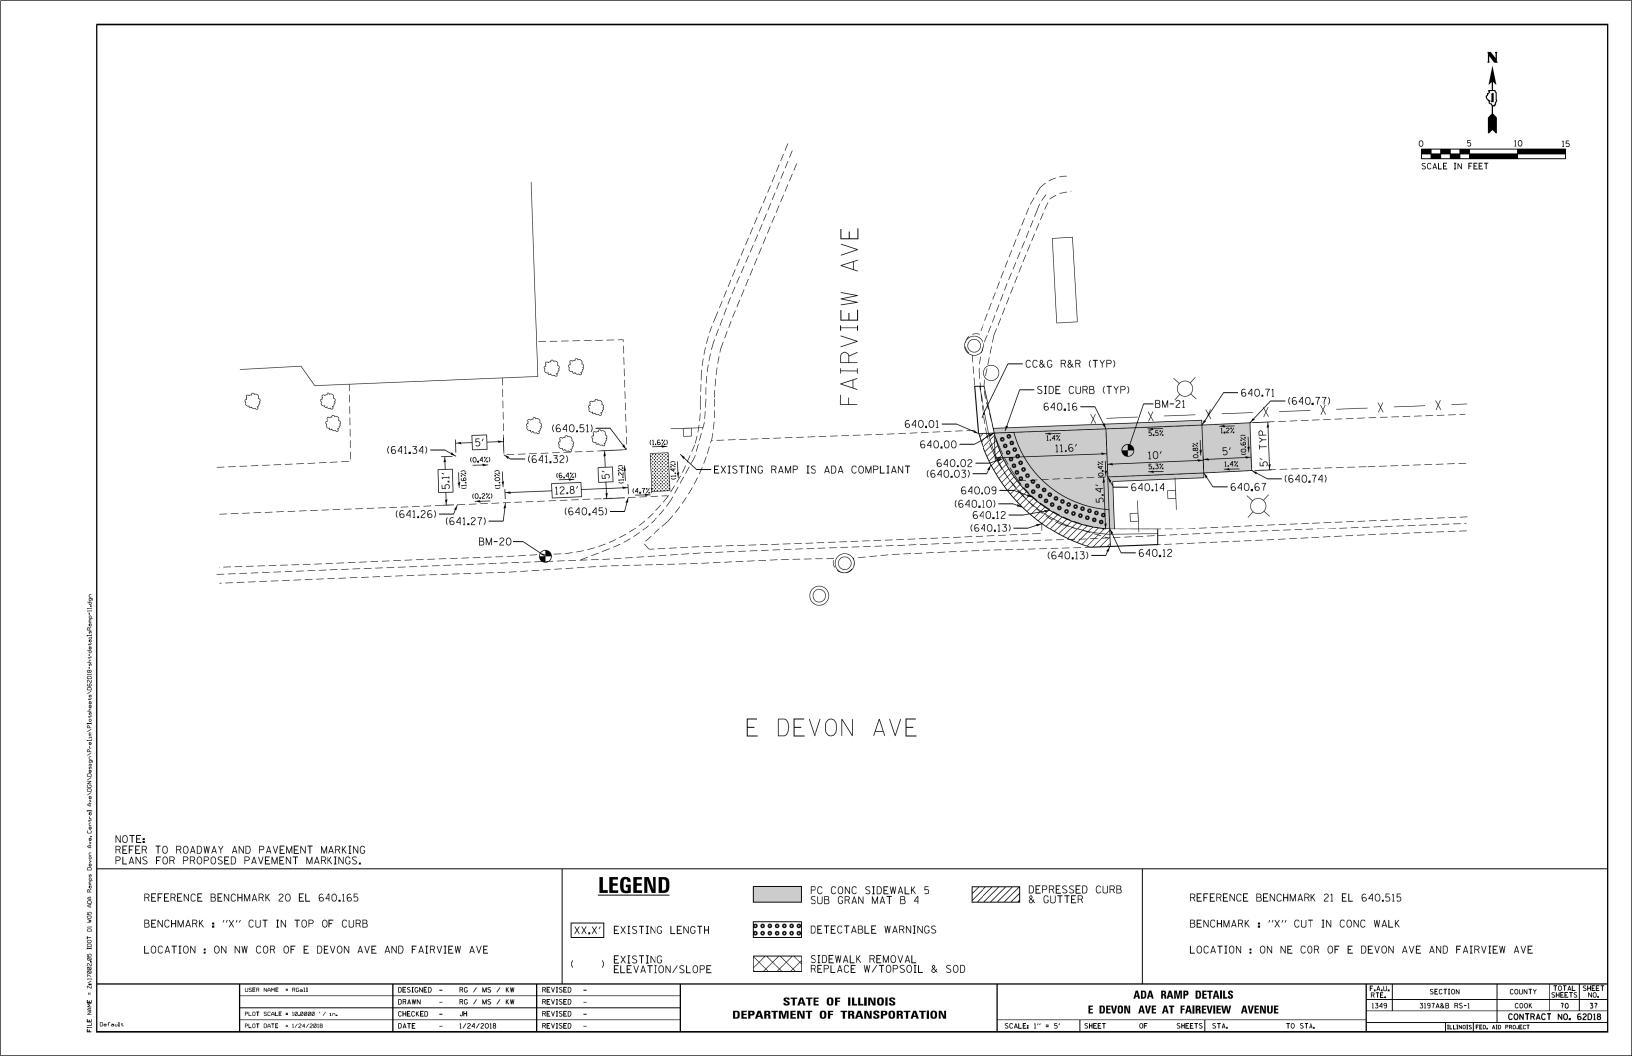

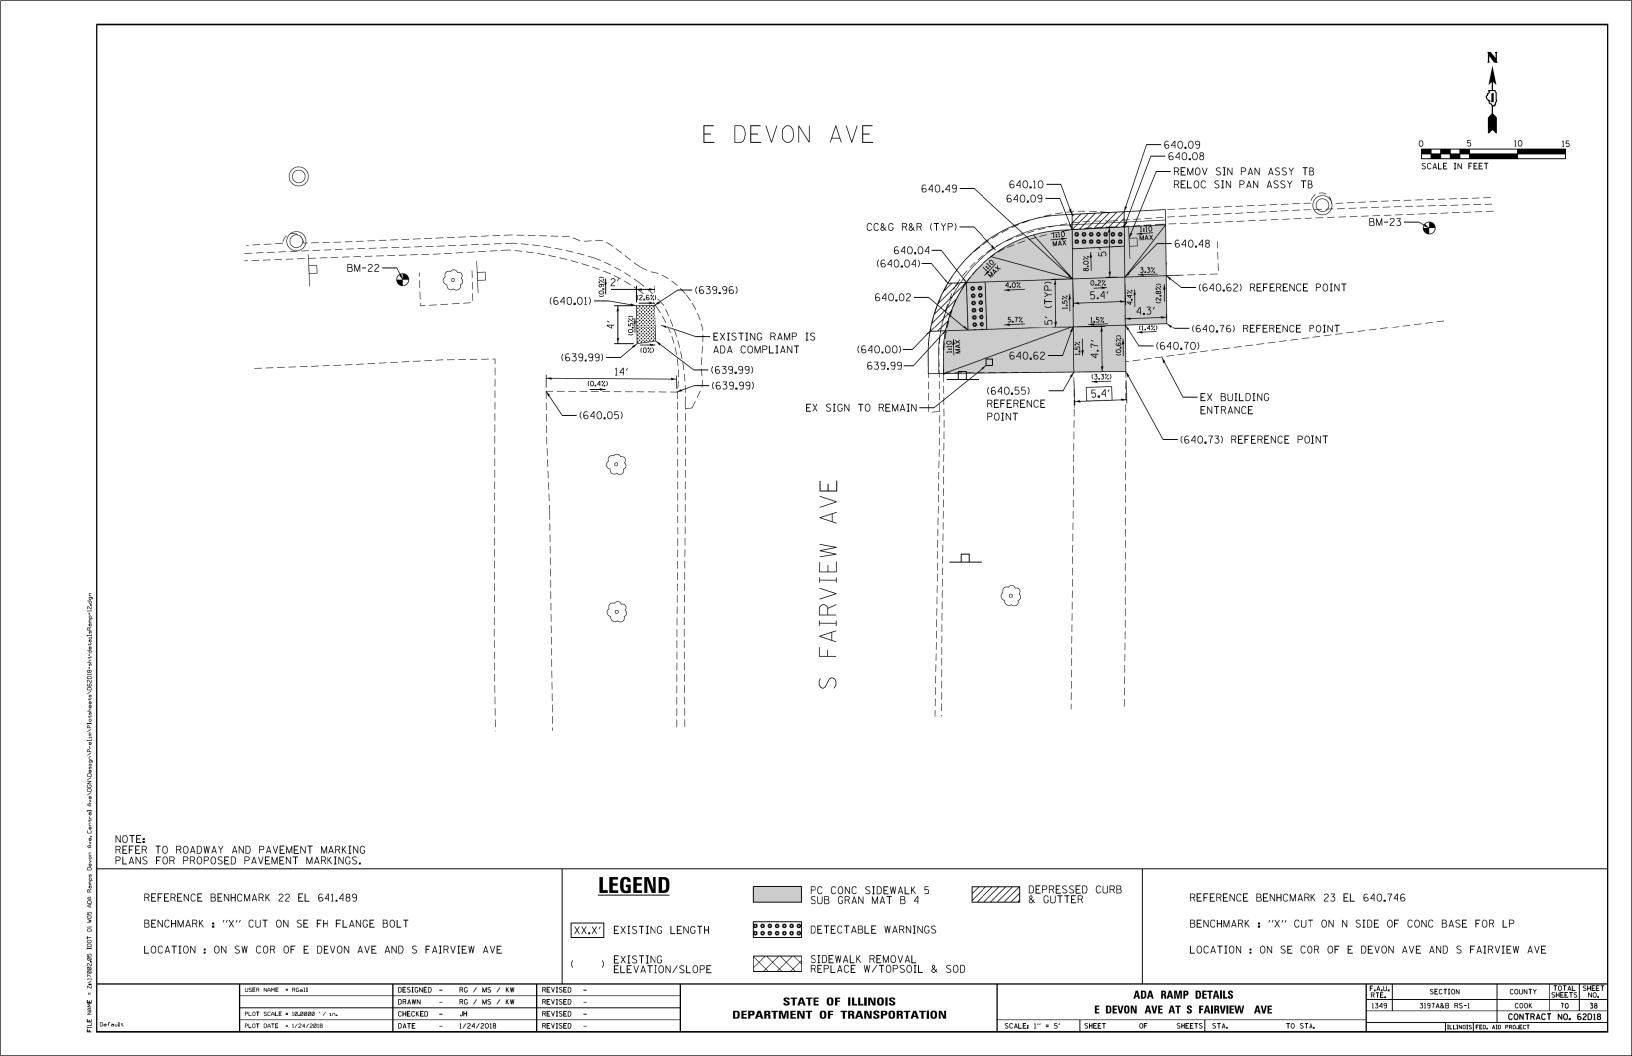

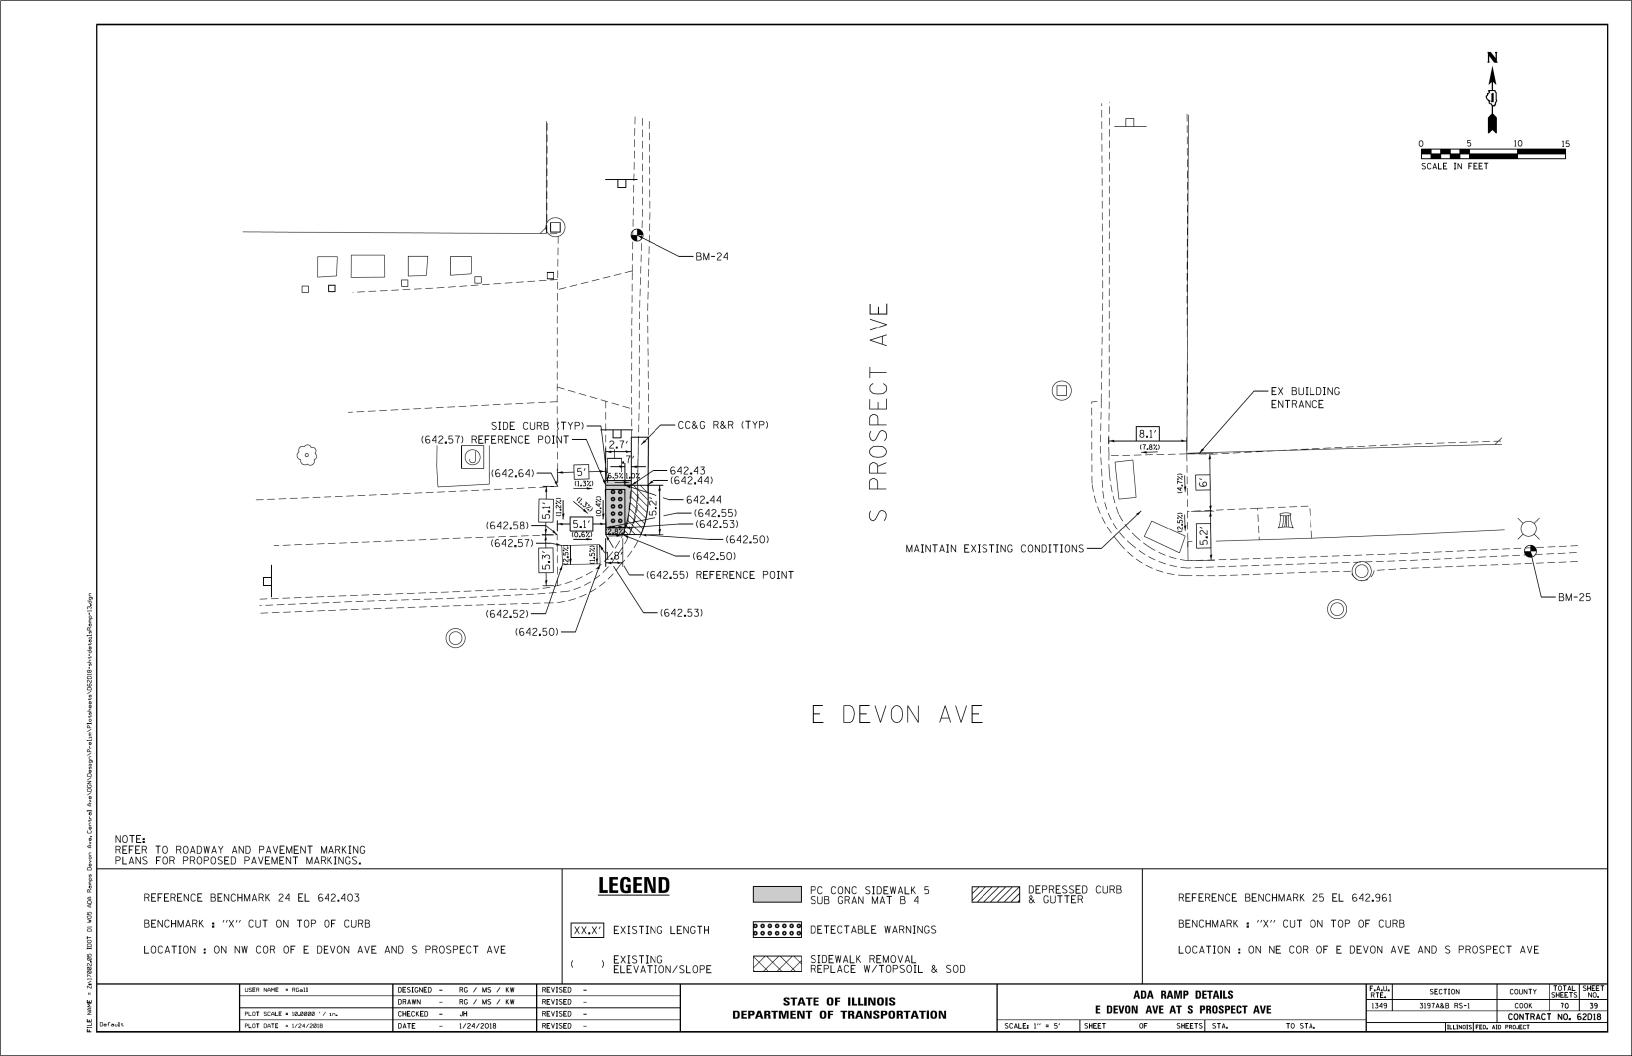

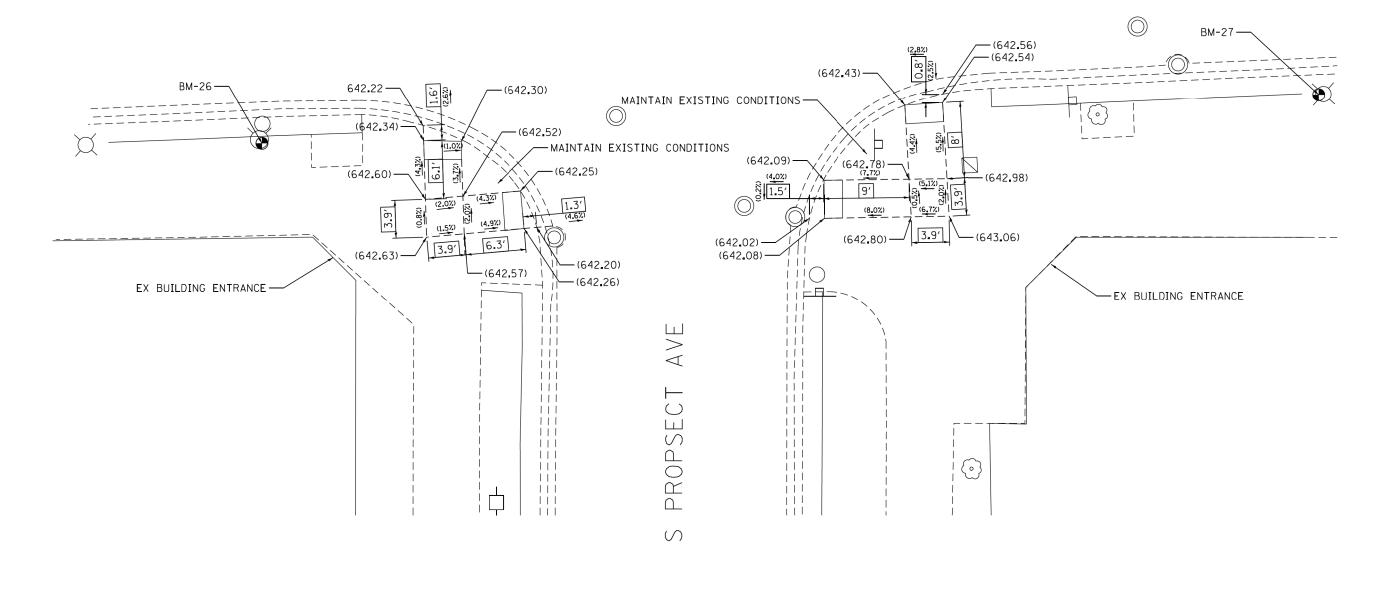

NOTE: REFER TO ROADWAY AND PAVEMENT MARKING PLANS FOR PROPOSED PAVEMENT MARKINGS.

REFERENCE BENCHMARK 26 EL 643.593

BENCHMARK : "X" CUT ON SE FH BOLT

USER NAME = RGall

LOCATION: ON SW COR OF E DEVON AVE AND S PROSPECT AVE

LEGEND

XX.X' EXISTING LENGTH

PC CONC SIDEWALK 5 SUB GRAN MAT B 4

DETECTABLE WARNINGS

DEPRESSED CURB & GUTTER

REFERENCE BENCHMARK 27 EL 643.234

BENCHMARK : "X" CUT ON W FACE LP BASE

LOCATION: ON SE COR OF E DEVON AVE AND S PROSPECT AVE

) EXISTING ELEVATION/SLOPE REVISED -REVISED -

SIDEWALK REMOVAL REPLACE W/TOPSOIL & SOD

ADA RAMP DETAILS E DEVON AVE AT S PROSPECT AVE

COUNTY TOTAL SHEET NO.


COOK 70 40 SECTION 3197A&B RS-1 1349 CONTRACT NO. 62D18


DRAWN - RG / MS / KW PLOT SCALE = 10.00000 '/ in. CHECKED - JH REVISED -PLOT DATE = 1/24/2018 DATE REVISED - 1/24/2018


DESIGNED - RG / MS / KW


STATE OF ILLINOIS **DEPARTMENT OF TRANSPORTATION**

SCALE: 1" = 5' SHEET OF SHEETS STA.

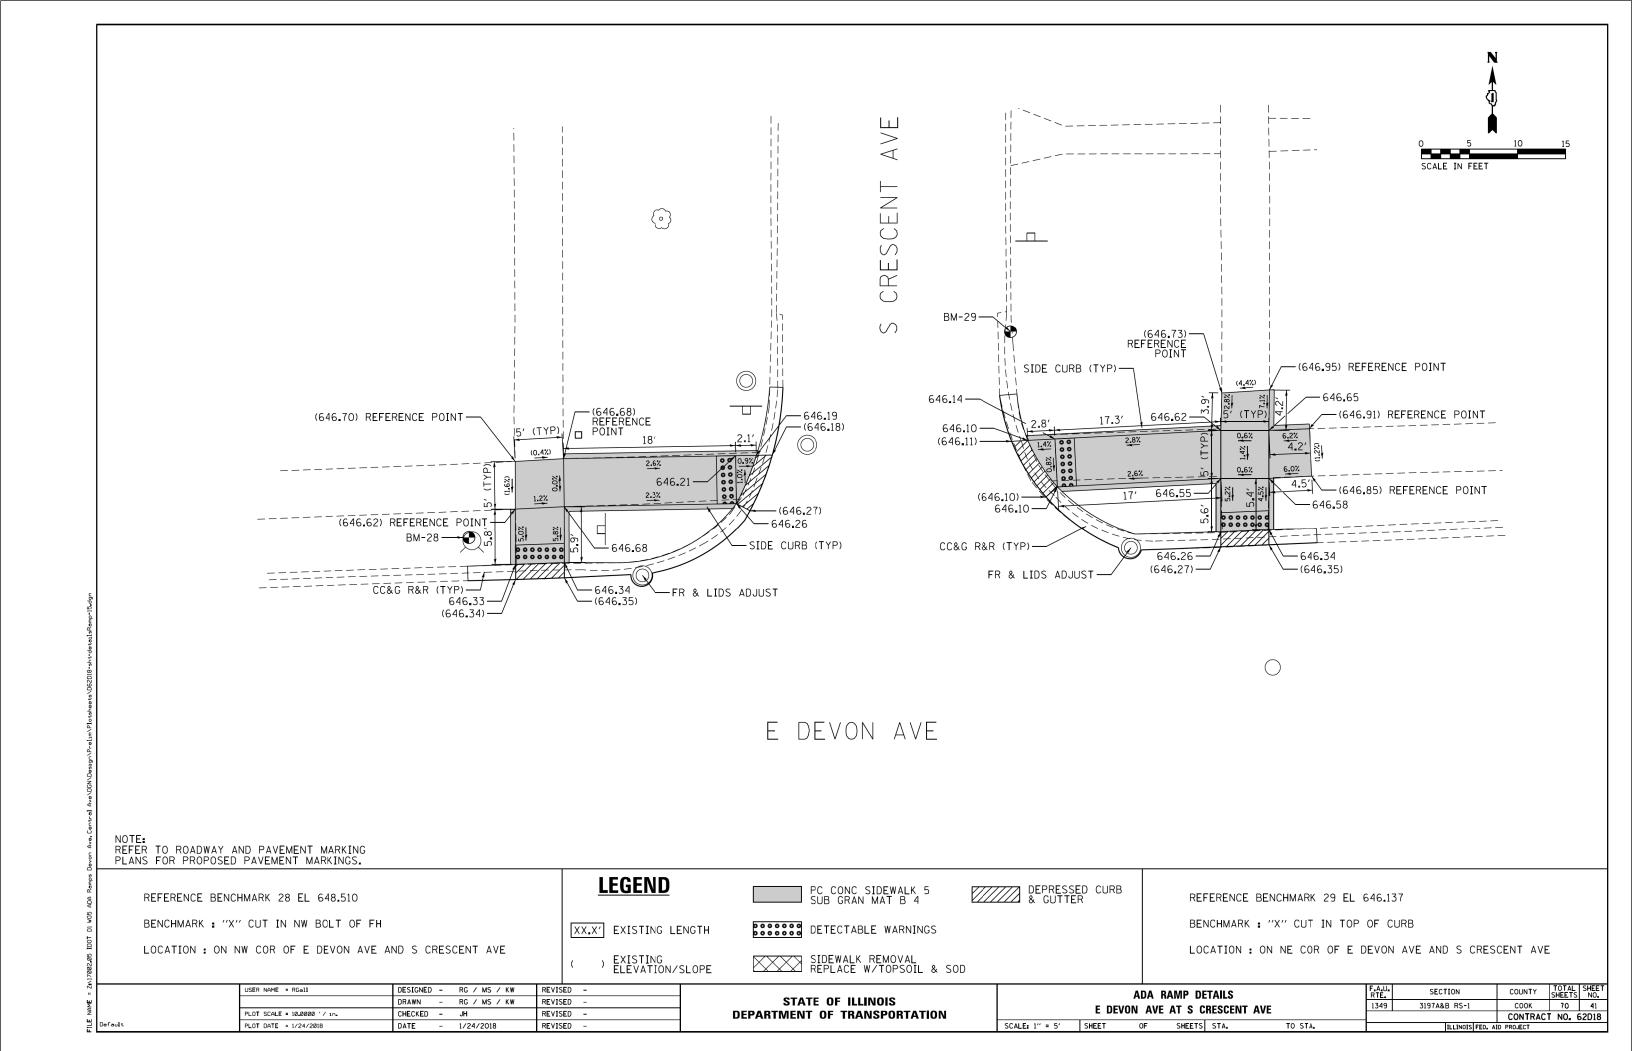

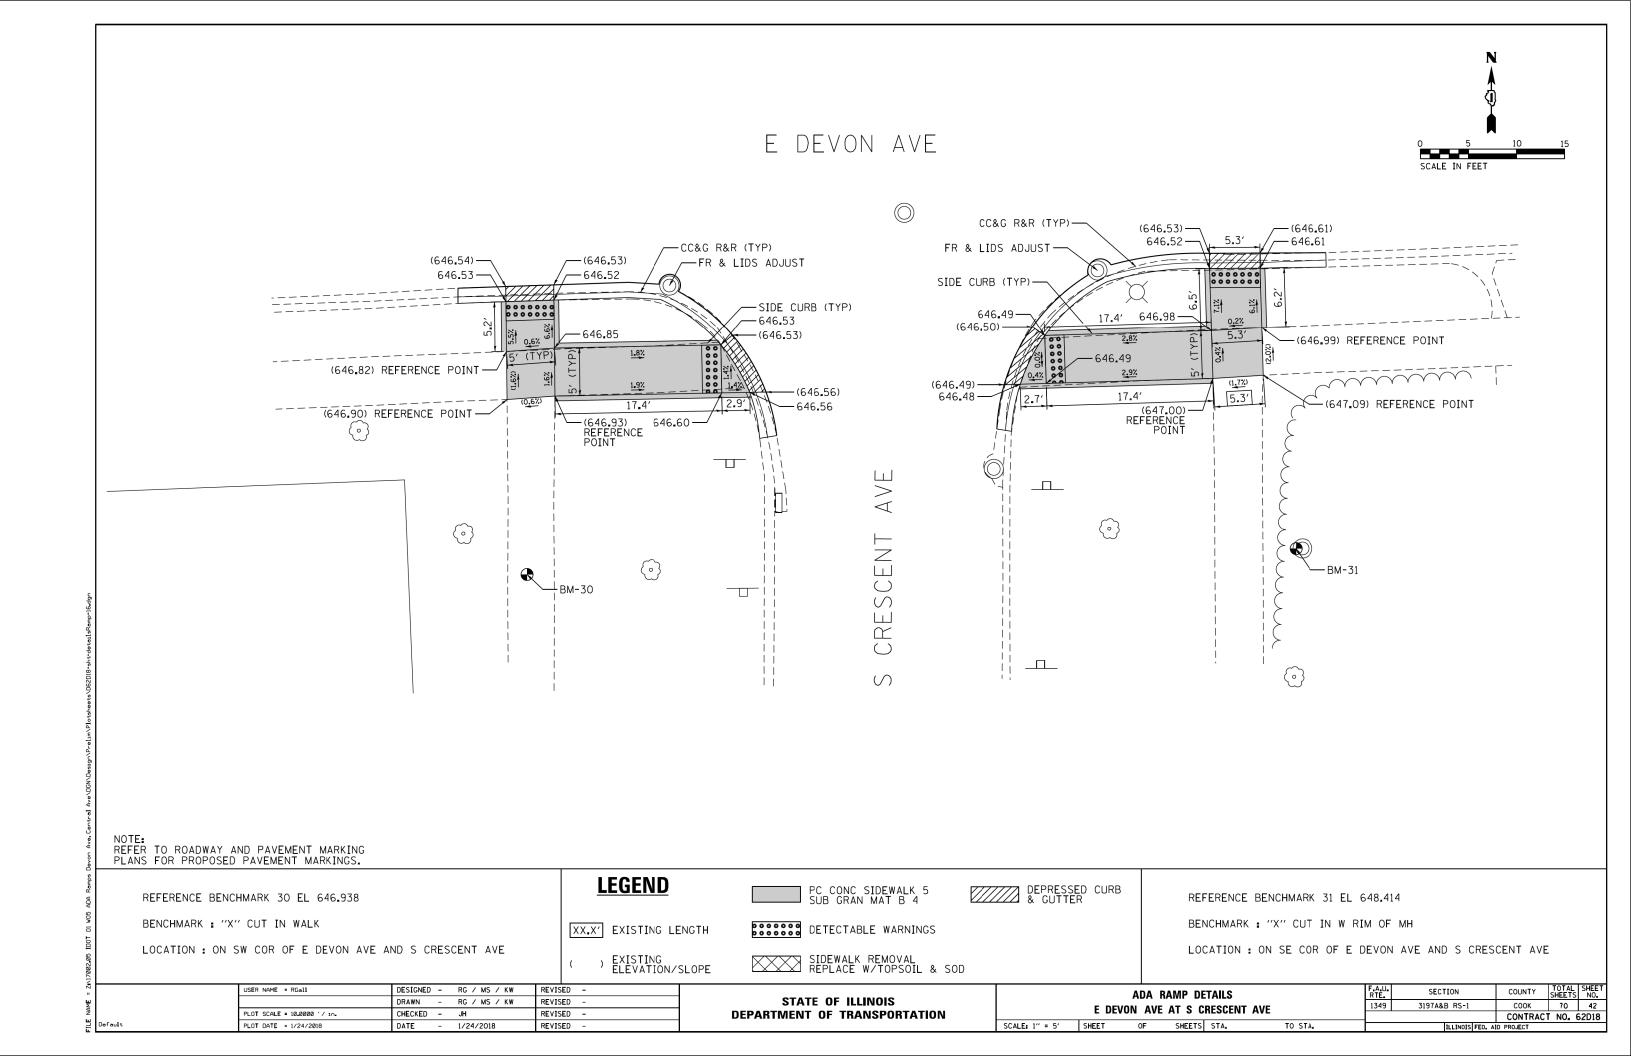

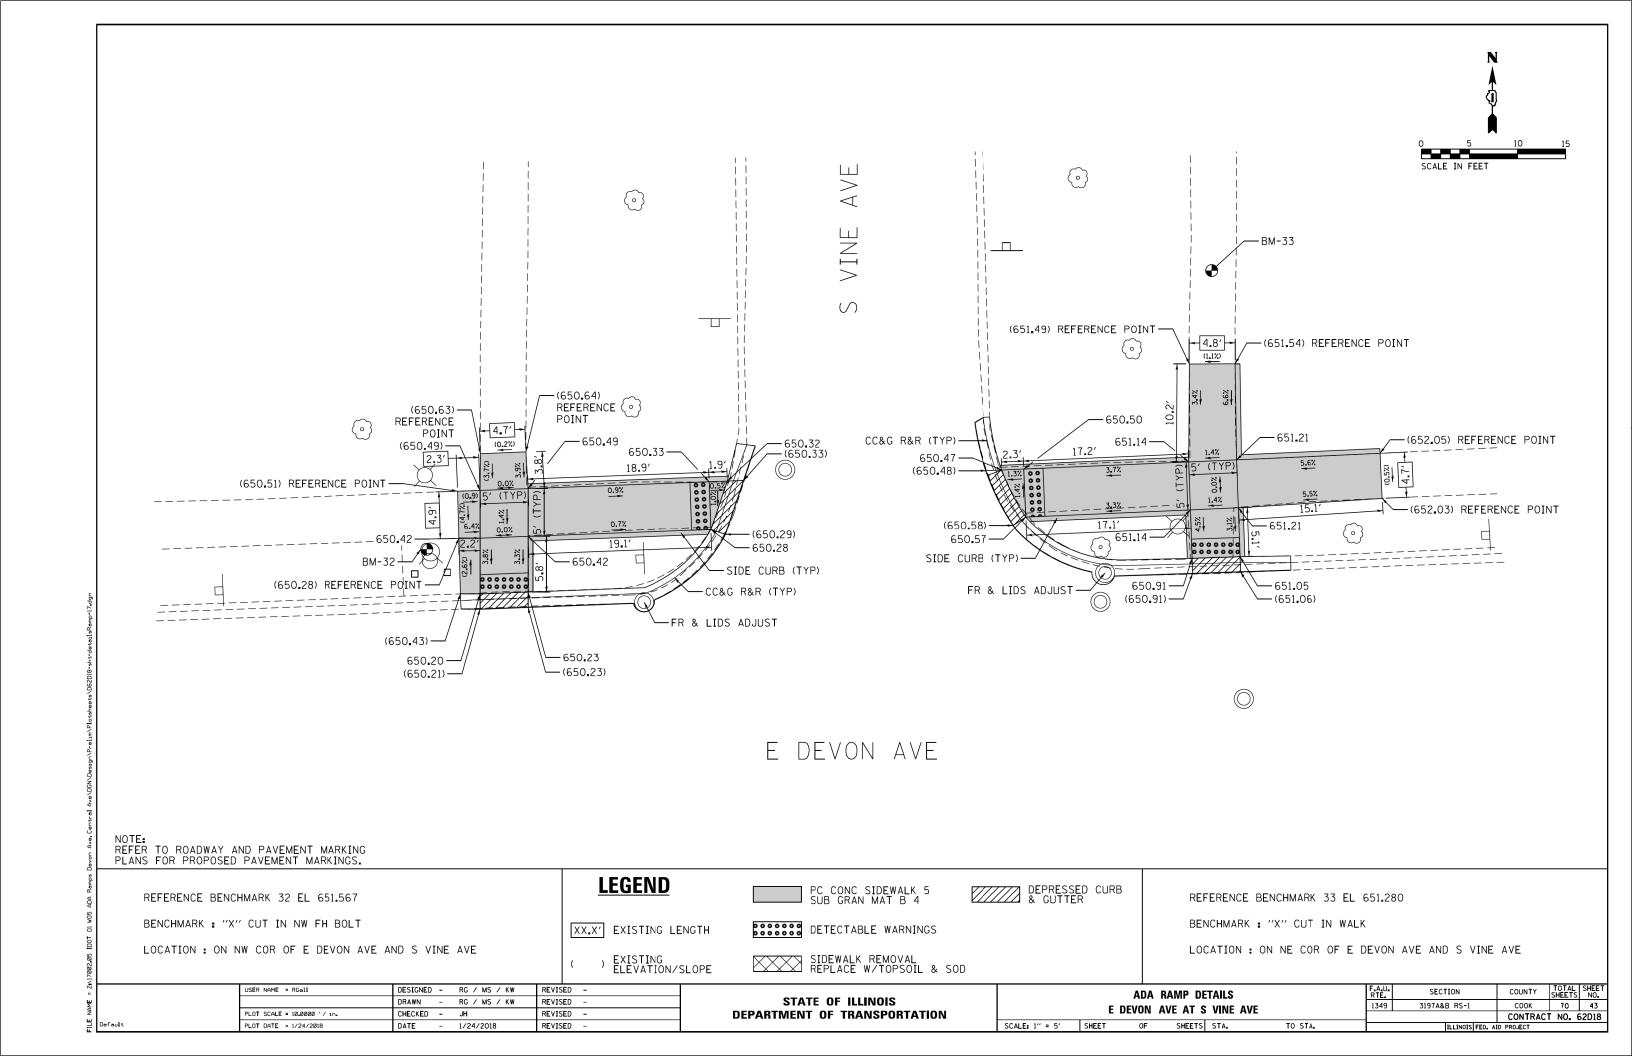

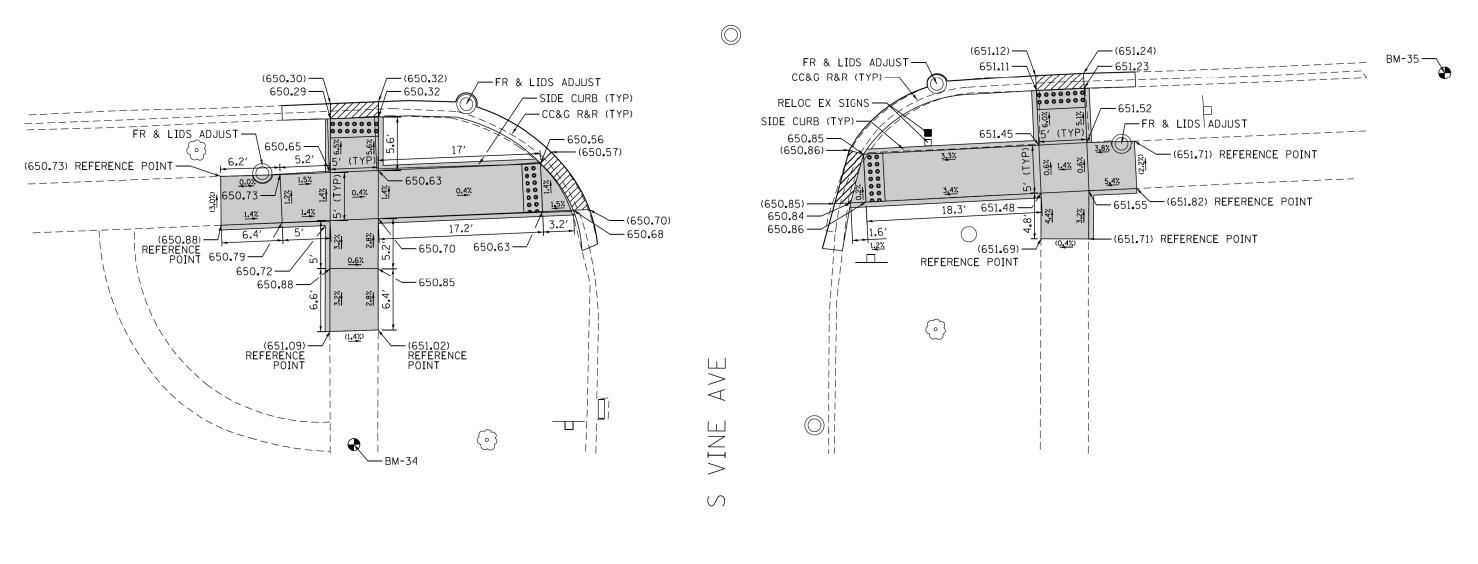

NOTE: REFER TO ROADWAY AND PAVEMENT MARKING PLANS FOR PROPOSED PAVEMENT MARKINGS.

REFERENCE BENCHMARK 35 EL 651.107

BENCHMARK : "X" CUT IN WALK

LOCATION : ON SW COR OF E DEVON AVE AND S VINE AVE

LEGEND

XX.X' EXISTING LENGTH

) EXISTING ELEVATION/SLOPE PC CONC SIDEWALK 5 SUB GRAN MAT B 4

DETECTABLE WARNINGS

SIDEWALK REMOVAL REPLACE W/TOPSOIL & SOD

DEPRESSED CURB & GUTTER

REFERENCE BENCHMARK 35 EL 652.028

BENCHMARK : "X" CUT IN TOP OF CURB

LOCATION: ON SE COR OF E DEVON AVE AND S VINE AVE


USER NAME = RGall	DESIGNED	-	RG / MS / KW	REVISE	ED -
	DRAWN	-	RG / MS / KW	REVISE	ED -
PLOT SCALE = 10.0000 '/ in.	CHECKED	-	JH	REVISE	ED -
PLOT DATE = 1/24/2018	DATE	_	1/24/2018	REVISE	D -


STATE OF ILLINOIS
DEPARTMENT OF TRANSPORTATION

ADA RAMP DETAILS

E DEVON AVE AT S VINE AVE

SCALE: 1" = 5" SHEET OF SHEETS STA. TO S

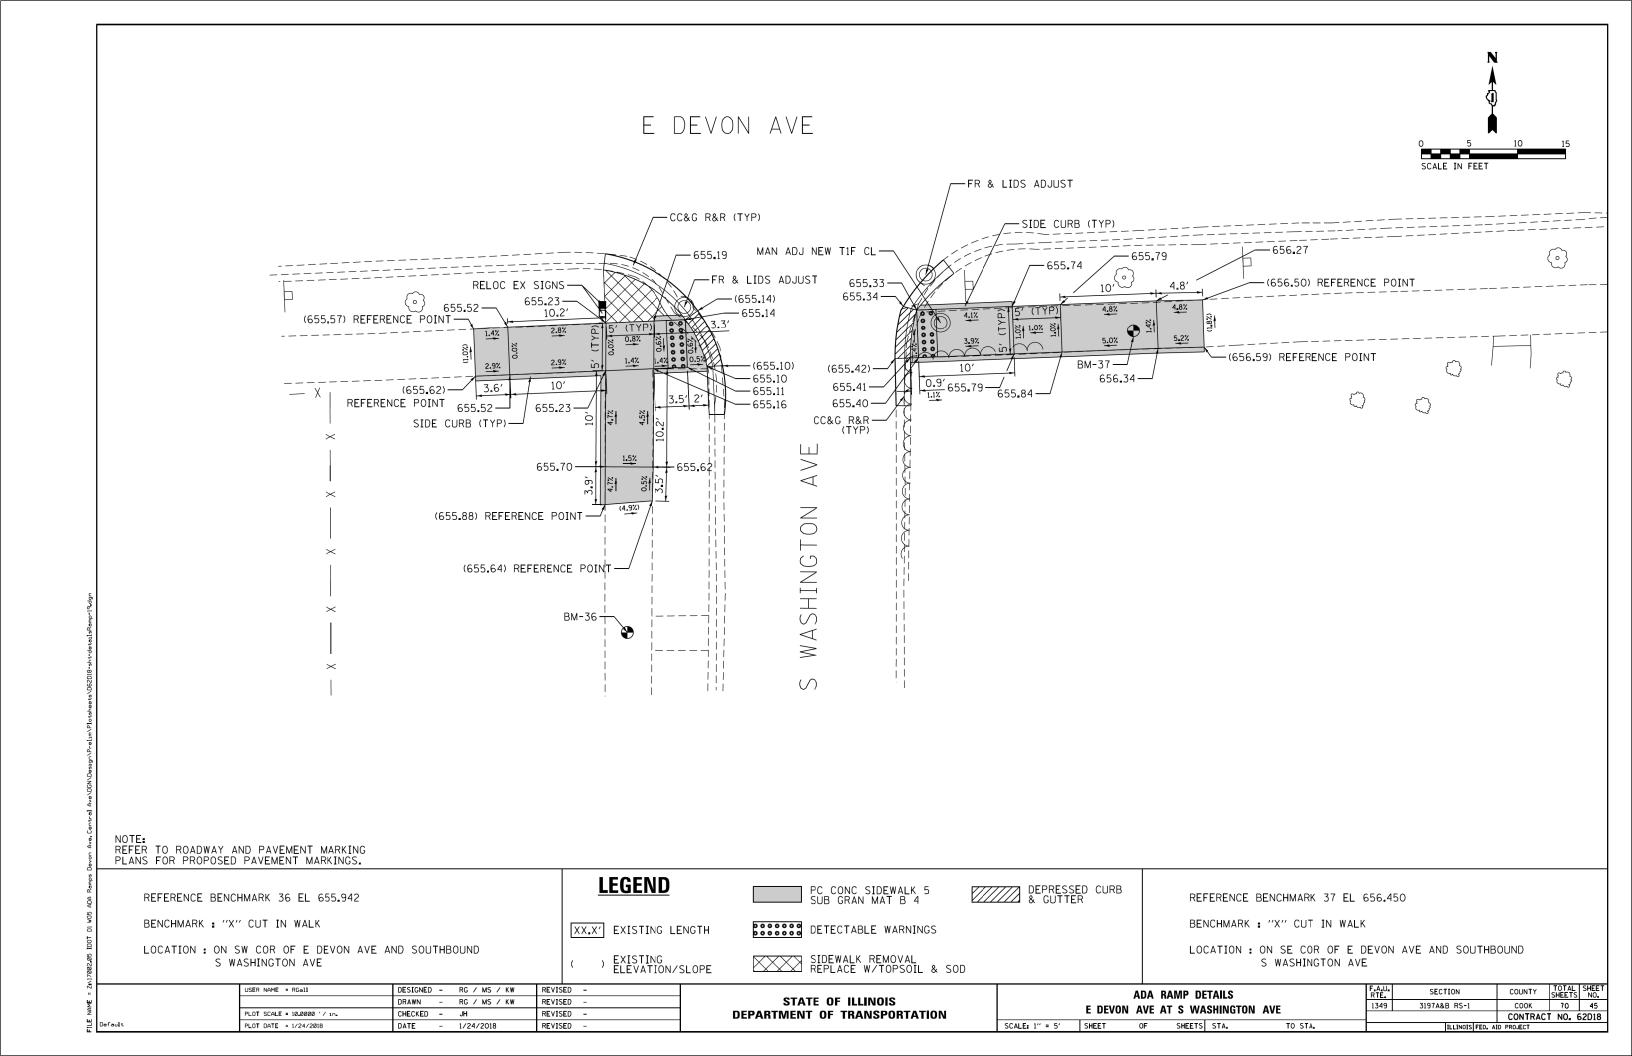


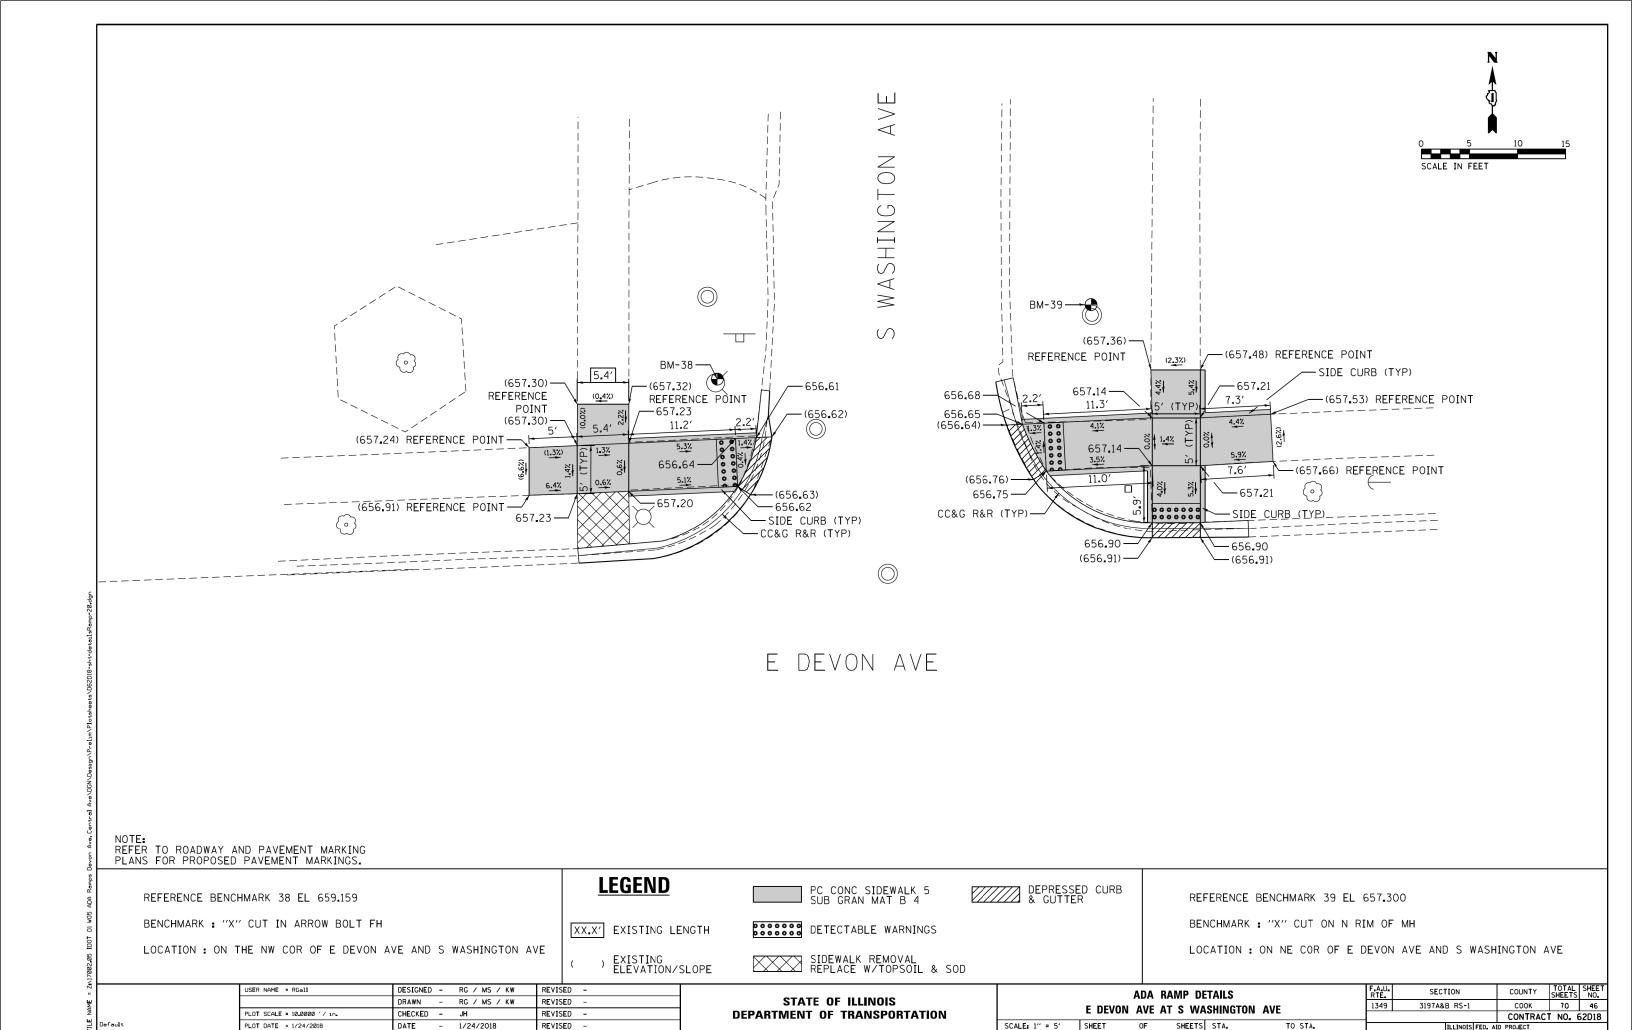


PLOT DATE = 1/24/2018

DATE - 1/24/2018

OF SHEETS STA.

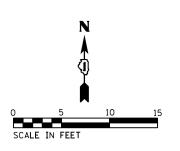

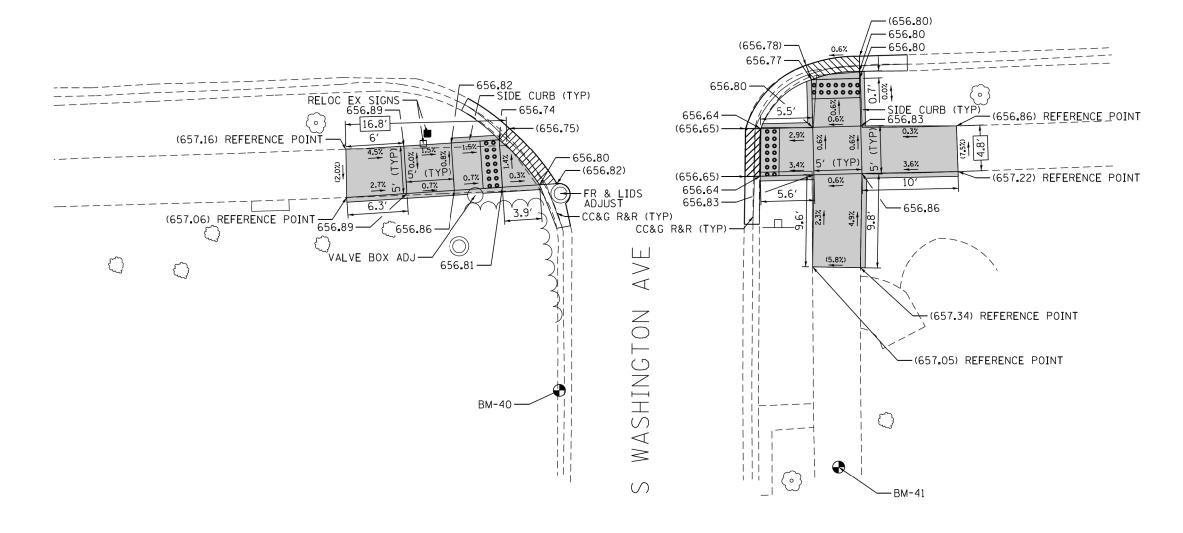

NOTE: REFER TO ROADWAY AND PAVEMENT MARKING PLANS FOR PROPOSED PAVEMENT MARKINGS.

REFERENCE BENCHMARK 40 EL 656.710

BENCHMARK : "X" CUT IN TOP OF CURB

LOCATION: ON SW COR OF E DEVON AVE AND NORTHBOUND

LEGEND



DETECTABLE WARNINGS



REFERENCE BENCHMARK 41 EL 657.164

BENCHMARK : "X" CUT & OF CONC WALK

LOCATION: ON SE COR OF E DEVON AVE AND NORTHBOUND S WASHINGTON AVE

USER NAME = RGall	DESIGNED	-	RG / MS / KW	REVIS	ED	-
	DRAWN	-	RG / MS / KW	REVIS	ED	=
PLOT SCALE = 10.00000 '/ in.	CHECKED	-	JH	REVIS	ED	-
PLOT DATE = 1/24/2018	DATE	_	1/24/2018	REVIS	ED	_

STATE OF ILLINOIS **DEPARTMENT OF TRANSPORTATION**

ADA RAMP DETAILS E DEVON AVE AT S WASHINGTON AVE SCALE: 1" = 5' SHEET OF SHEETS STA.

COUNTY TOTAL SHEET NO.


COOK 70 47 SECTION 3197A&B RS-1 CONTRACT NO. 62D18


S WASHINGTON AVE


) EXISTING ELEVATION/SLOPE

XX.X' EXISTING LENGTH

SIDEWALK REMOVAL REPLACE W/TOPSOIL & SOD

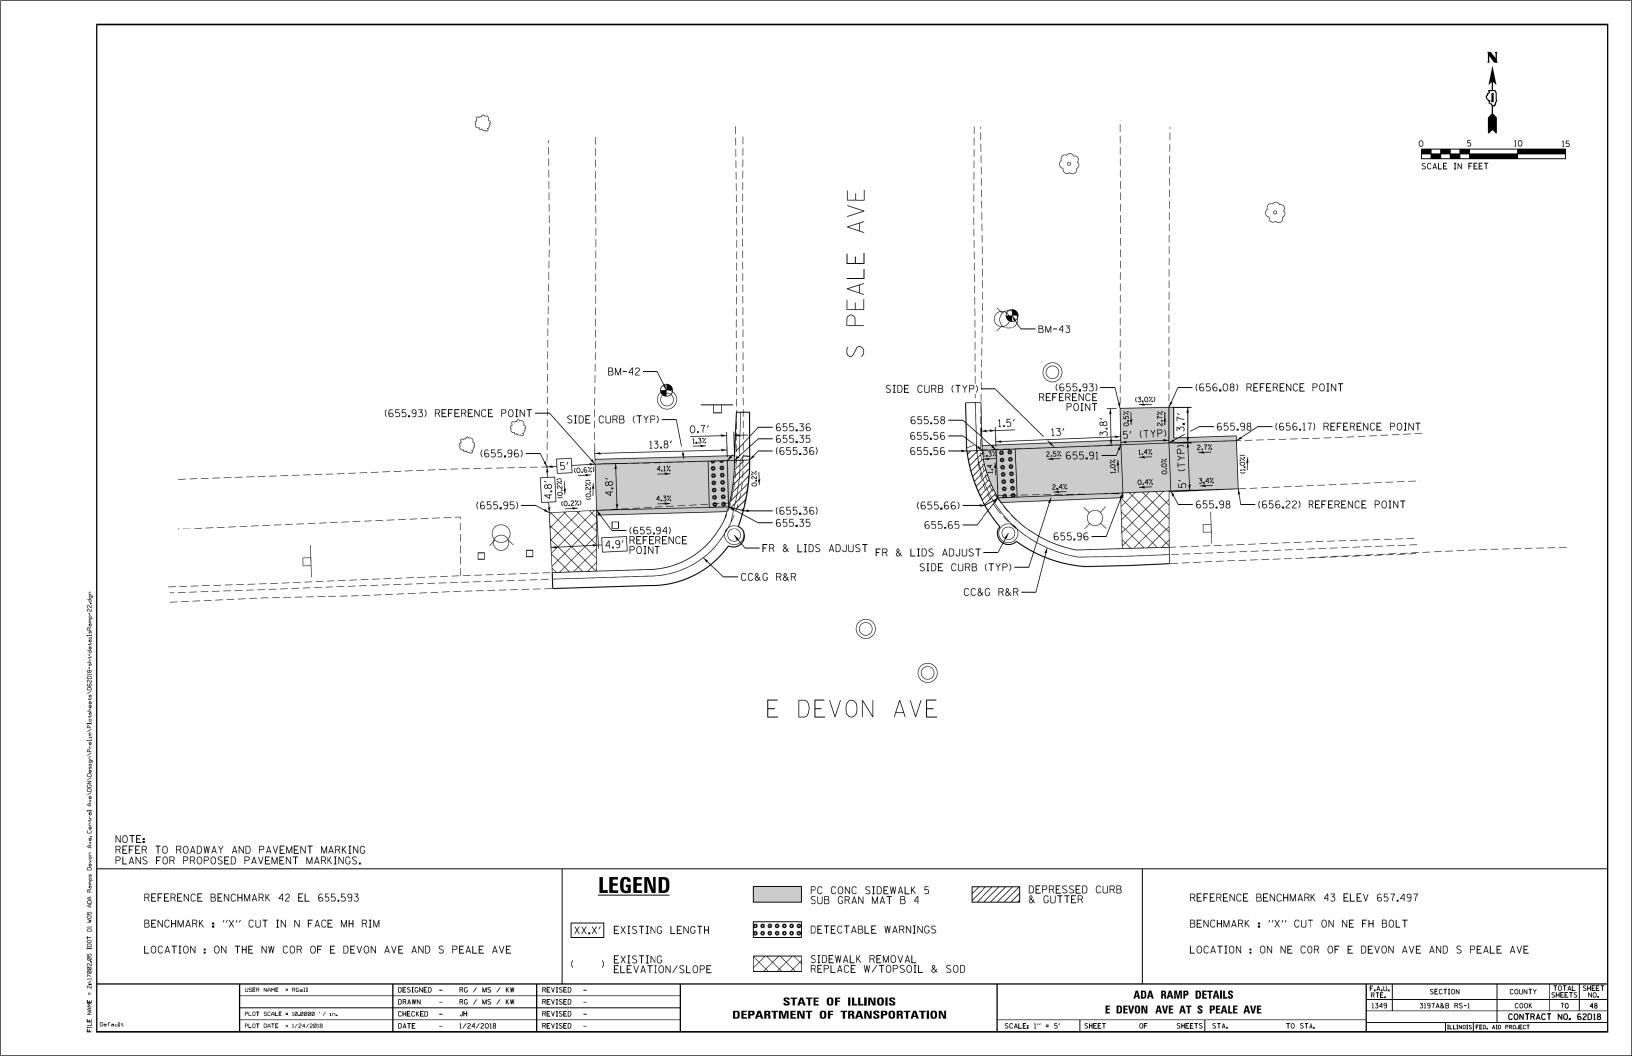

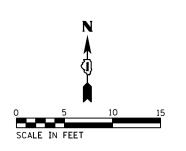


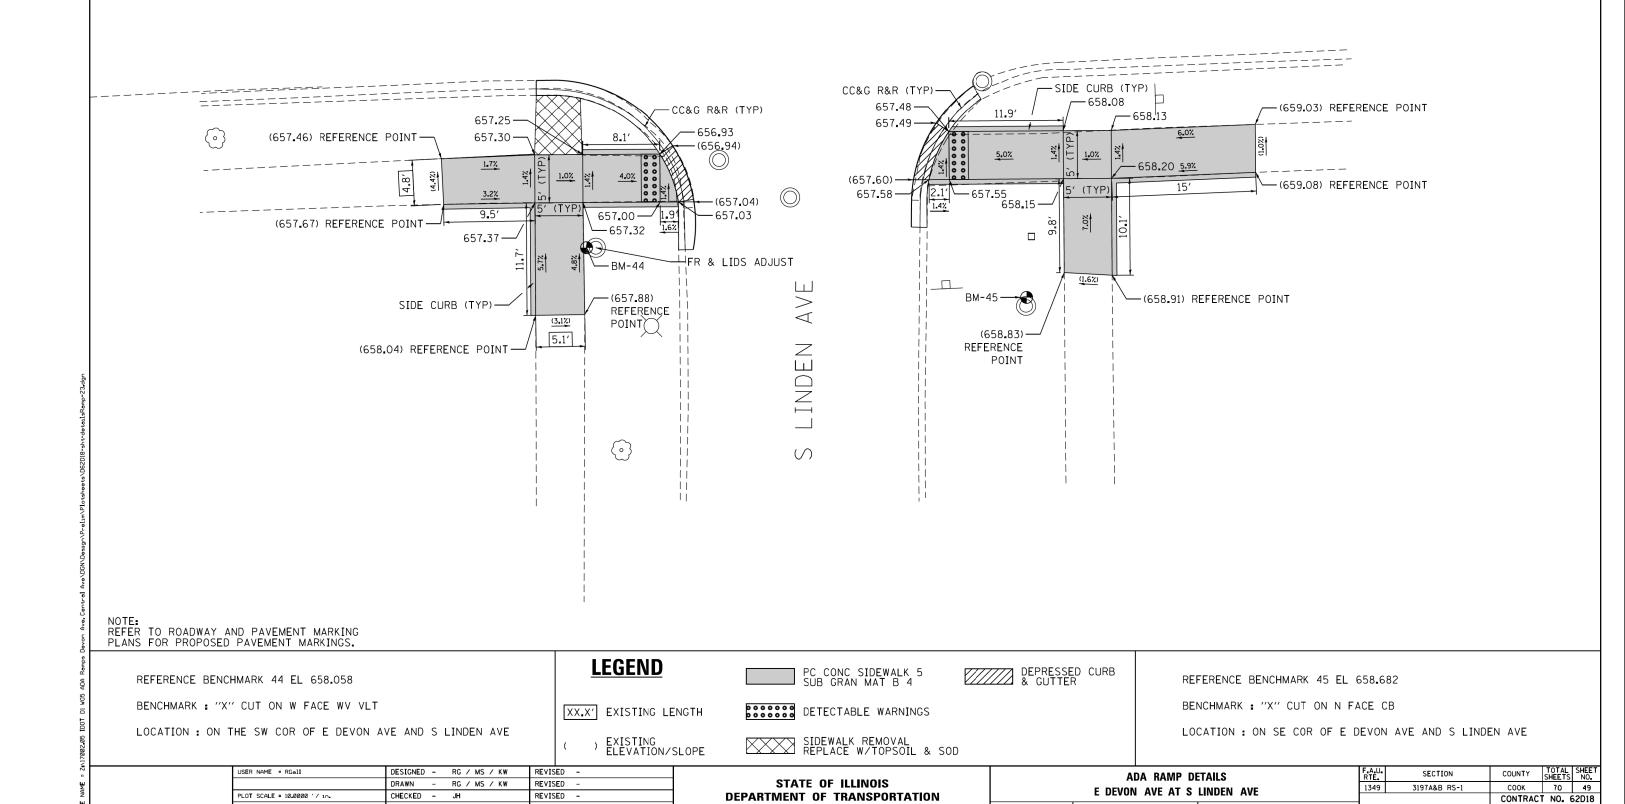


PLOT DATE = 1/24/2018

SCALE: 1" = 5' SHEET

OF SHEETS STA.

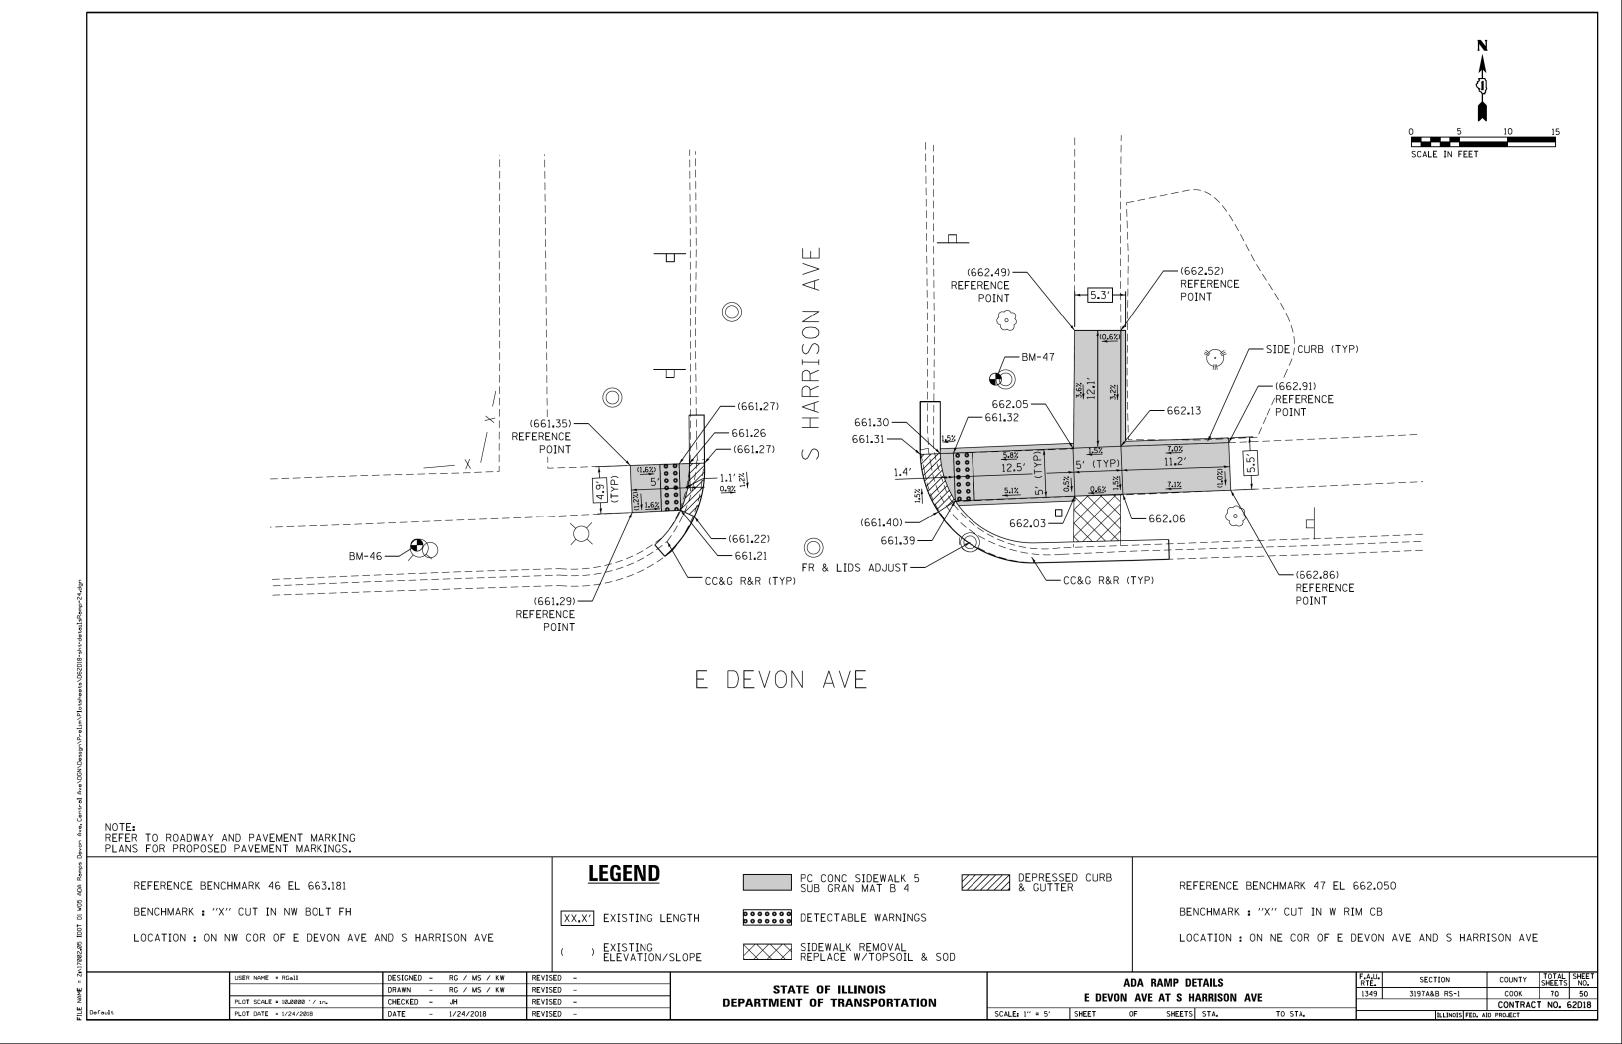

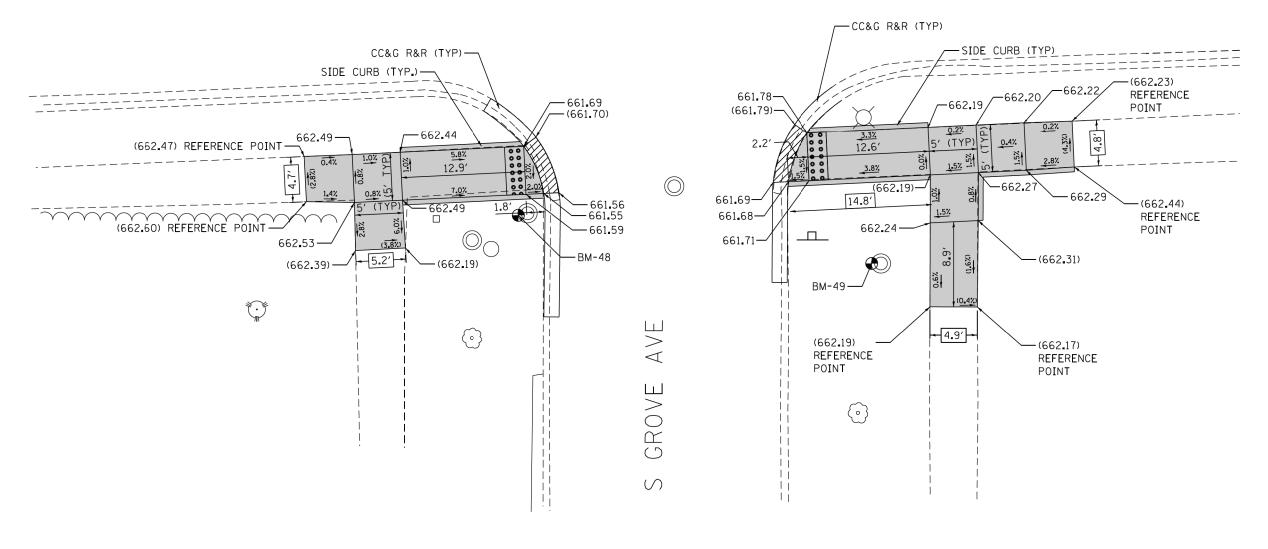

NOTE: REFER TO ROADWAY AND PAVEMENT MARKING PLANS FOR PROPOSED PAVEMENT MARKINGS.

REFERENCE BENCHMARK 48 EL 661.934

BENCHMARK : "X" CUT IN W RIM OF VV

LOCATION: ON THE SW COR OF E DEVON AVE AND S GROVE AVE

LEGEND

XX.X' EXISTING LENGTH

() EXISTING ELEVATION/SLOPE

PC CONC SIDEWALK 5 SUB GRAN MAT B 4



REFERENCE BENCHMARK 49 EL 661.847

BENCHMARK : "X" CUT IN W RIM CB

USER NAME = RGall	DESIGNED	-	RG / MS / KW	REVIS	ED -
	DRAWN	-	RG / MS / KW	REVIS	ED -
PLOT SCALE = 10.00000 '/ 10.	CHECKED	-	JH	REVIS	ED -
PLOT DATE = 1/24/2018	DATE	-	1/24/2018	REVIS	ED -

STATE OF ILLINOIS **DEPARTMENT OF TRANSPORTATION**


SIDEWALK REMOVAL REPLACE W/TOPSOIL & SOD


ADA RAMP DETAILS E DEVON AVE AT S GROVE AVE SCALE: 1" = 5' SHEET OF SHEETS STA. TO STA.


III I INDISTEED. AID PROJECT								
		CONTRACT	NO. 6	52D18				
1349	3197A&B RS-1	COOK	70	51				
F.A.U. RTE	SECTION	COUNTY	TOTAL SHEETS	SHEET NO.				


DETECTABLE WARNINGS


LOCATION: ON SE COR OF E DEVON AVE AND S GROVE AVE

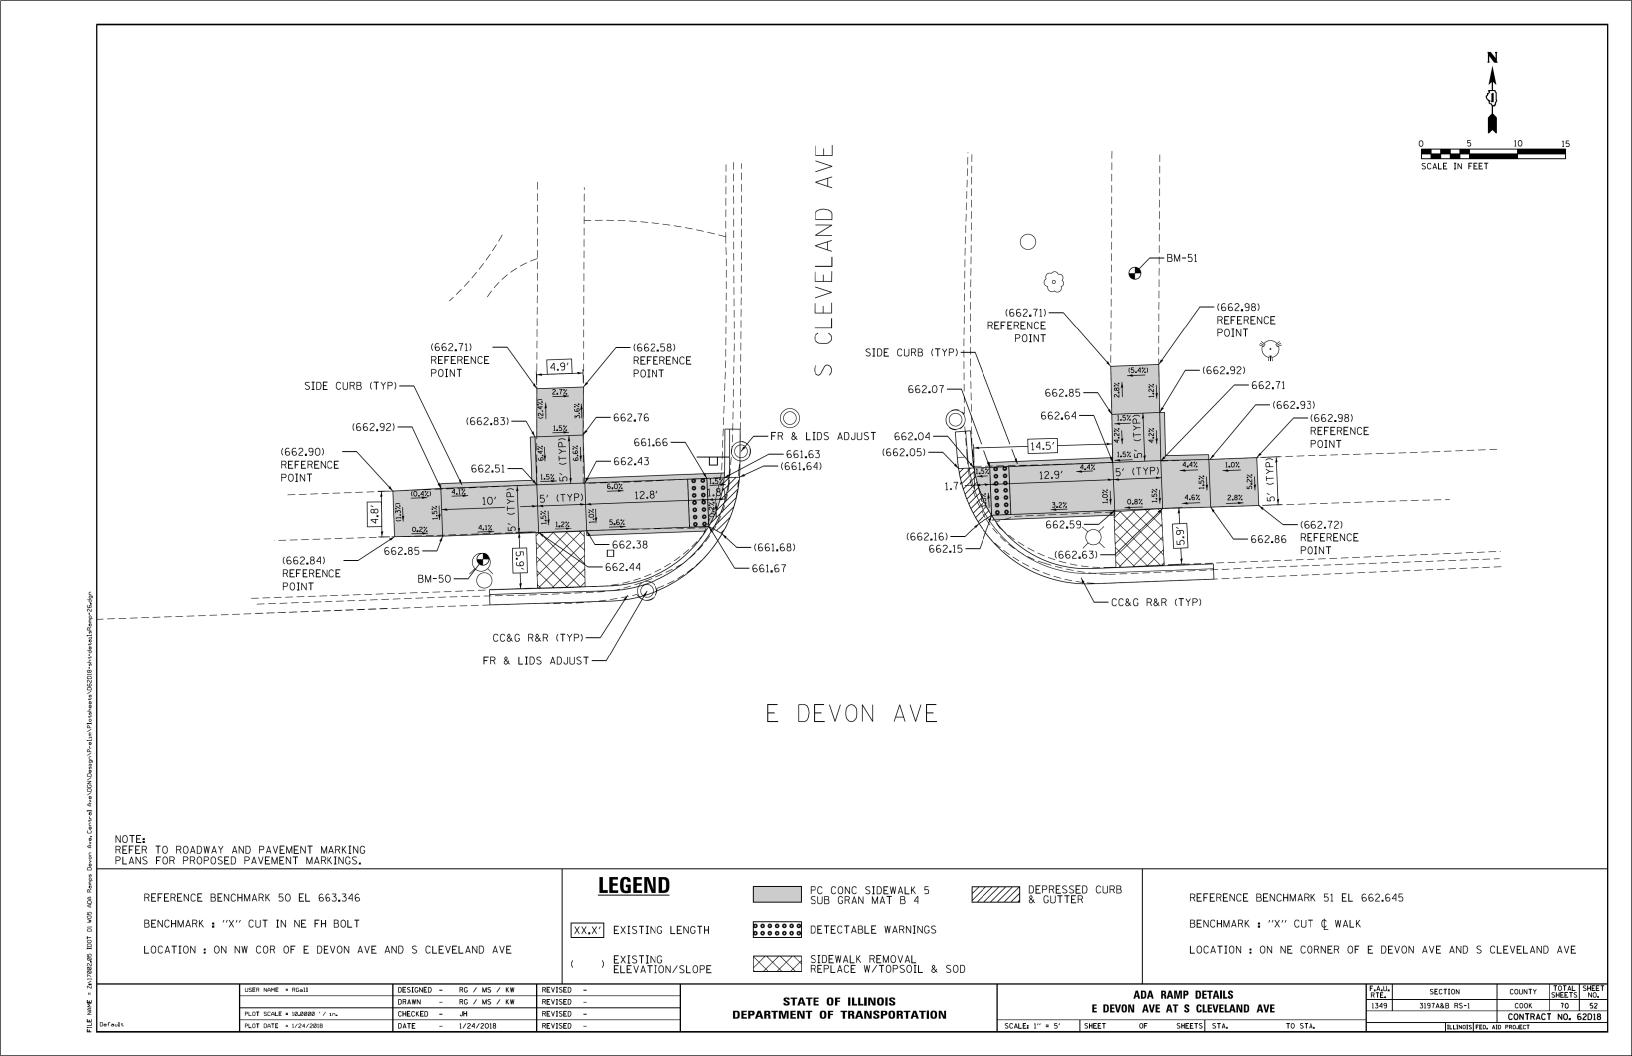


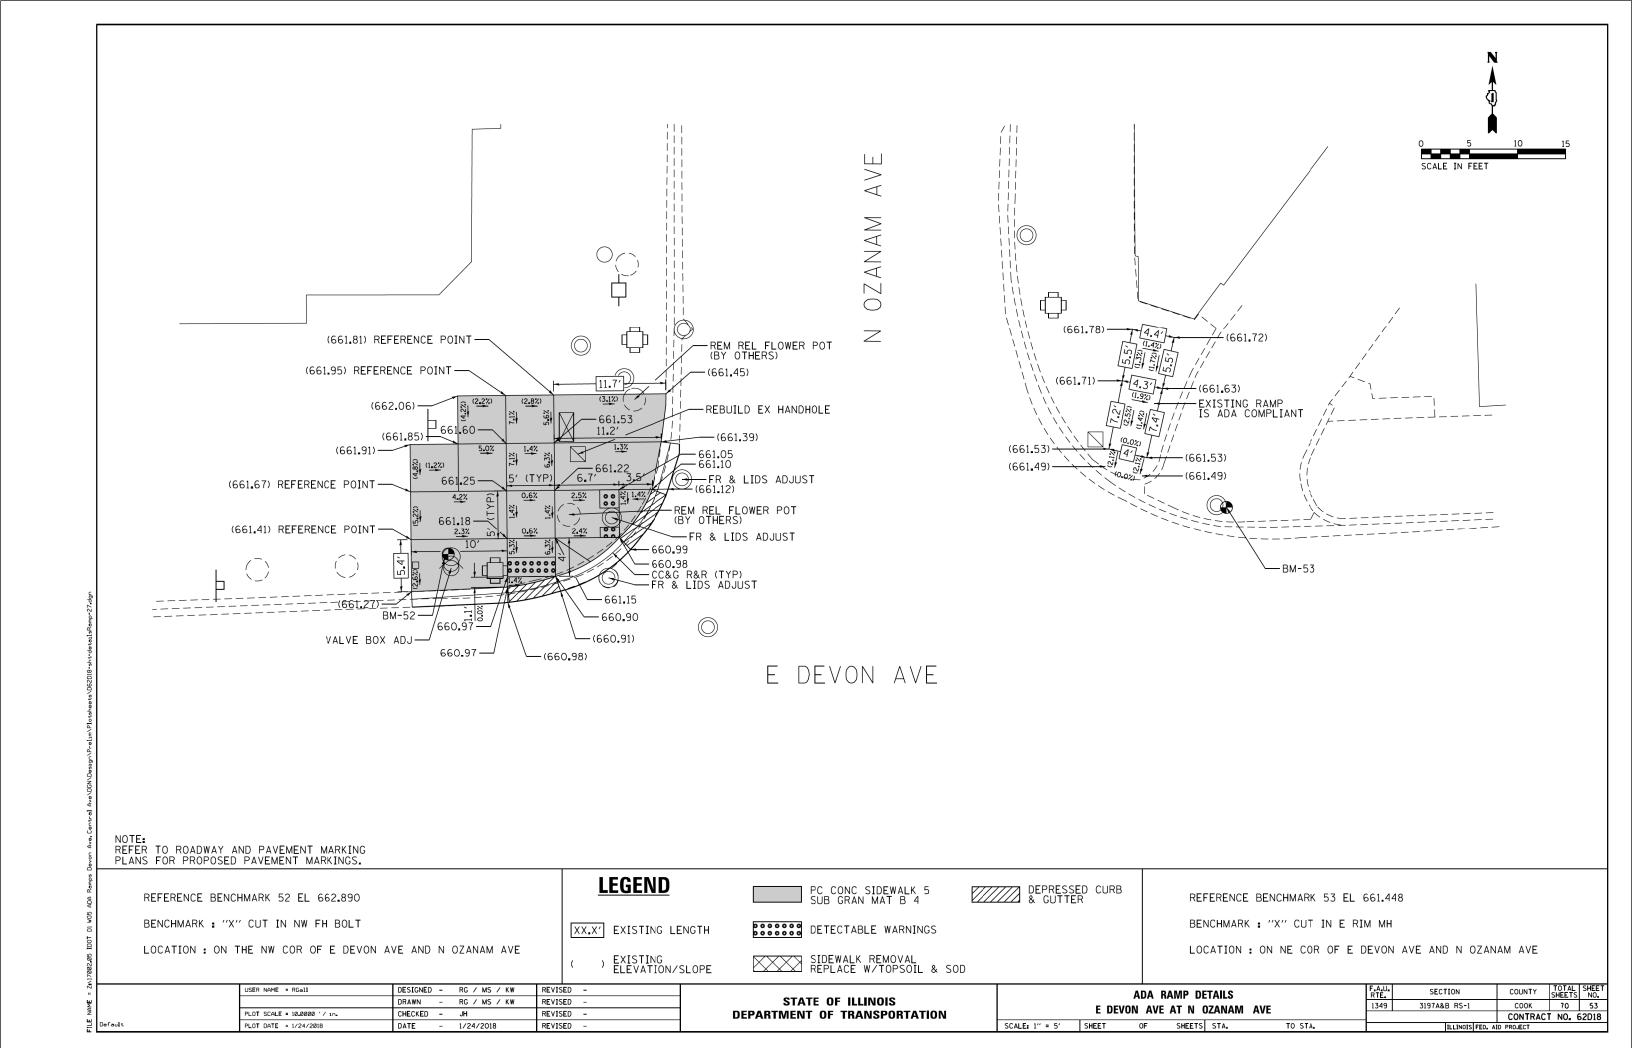


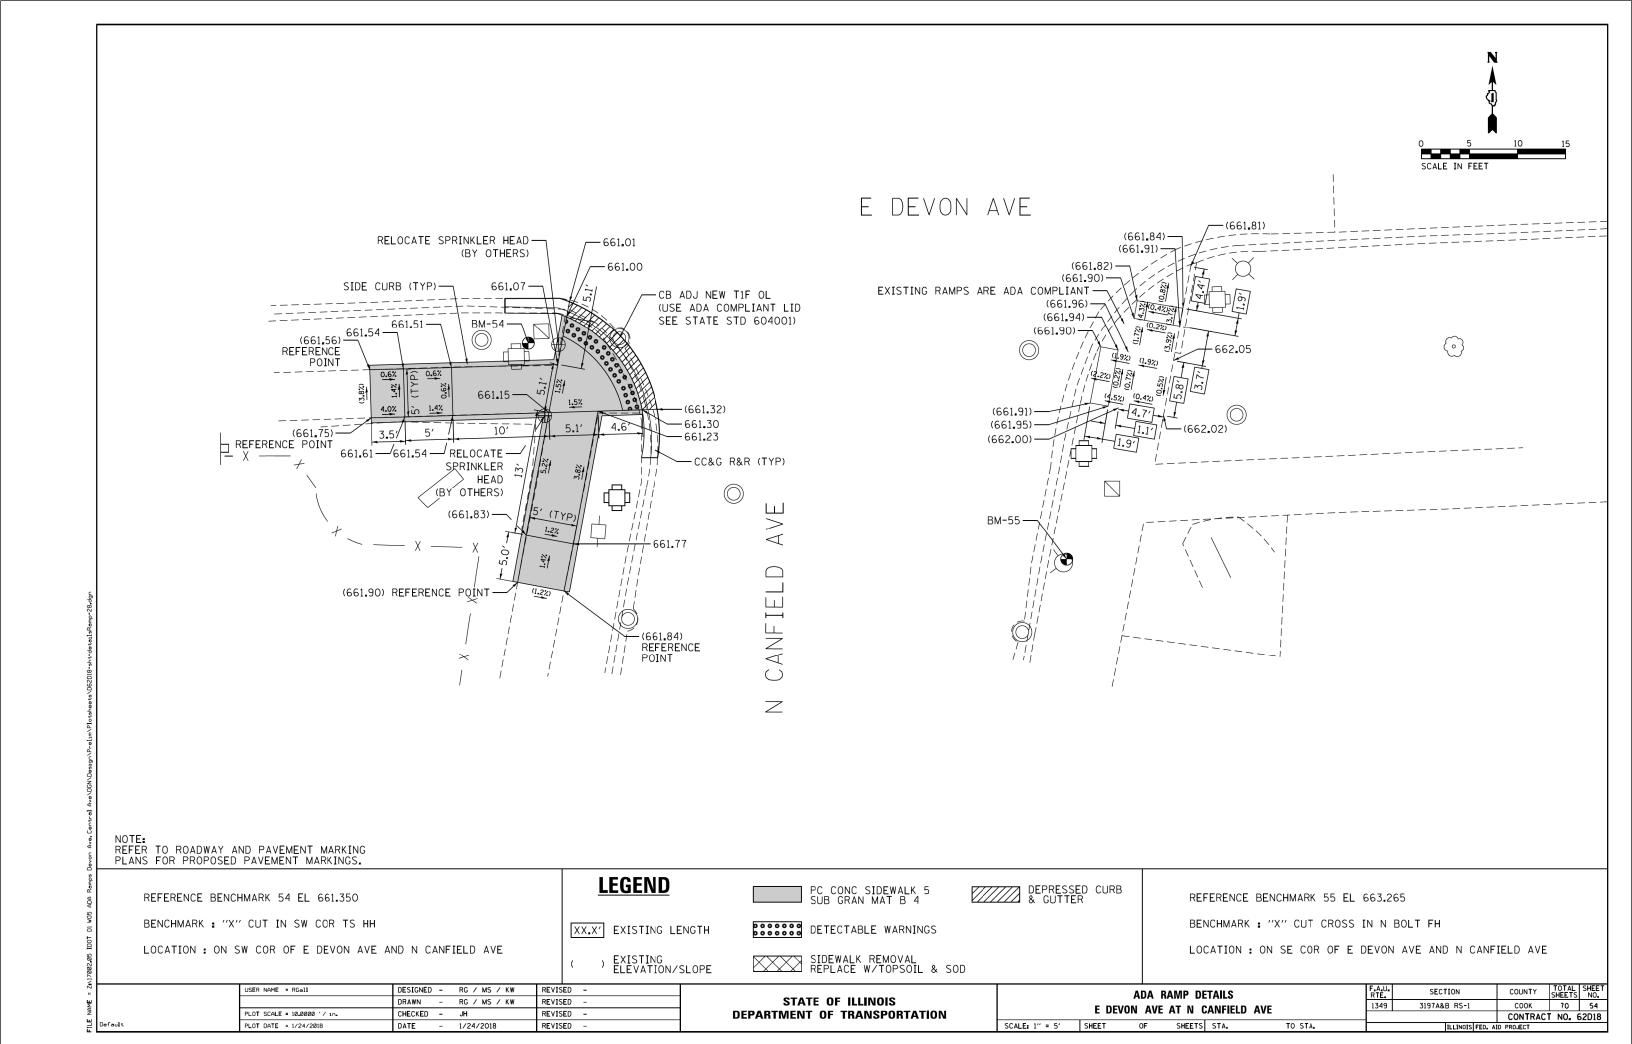


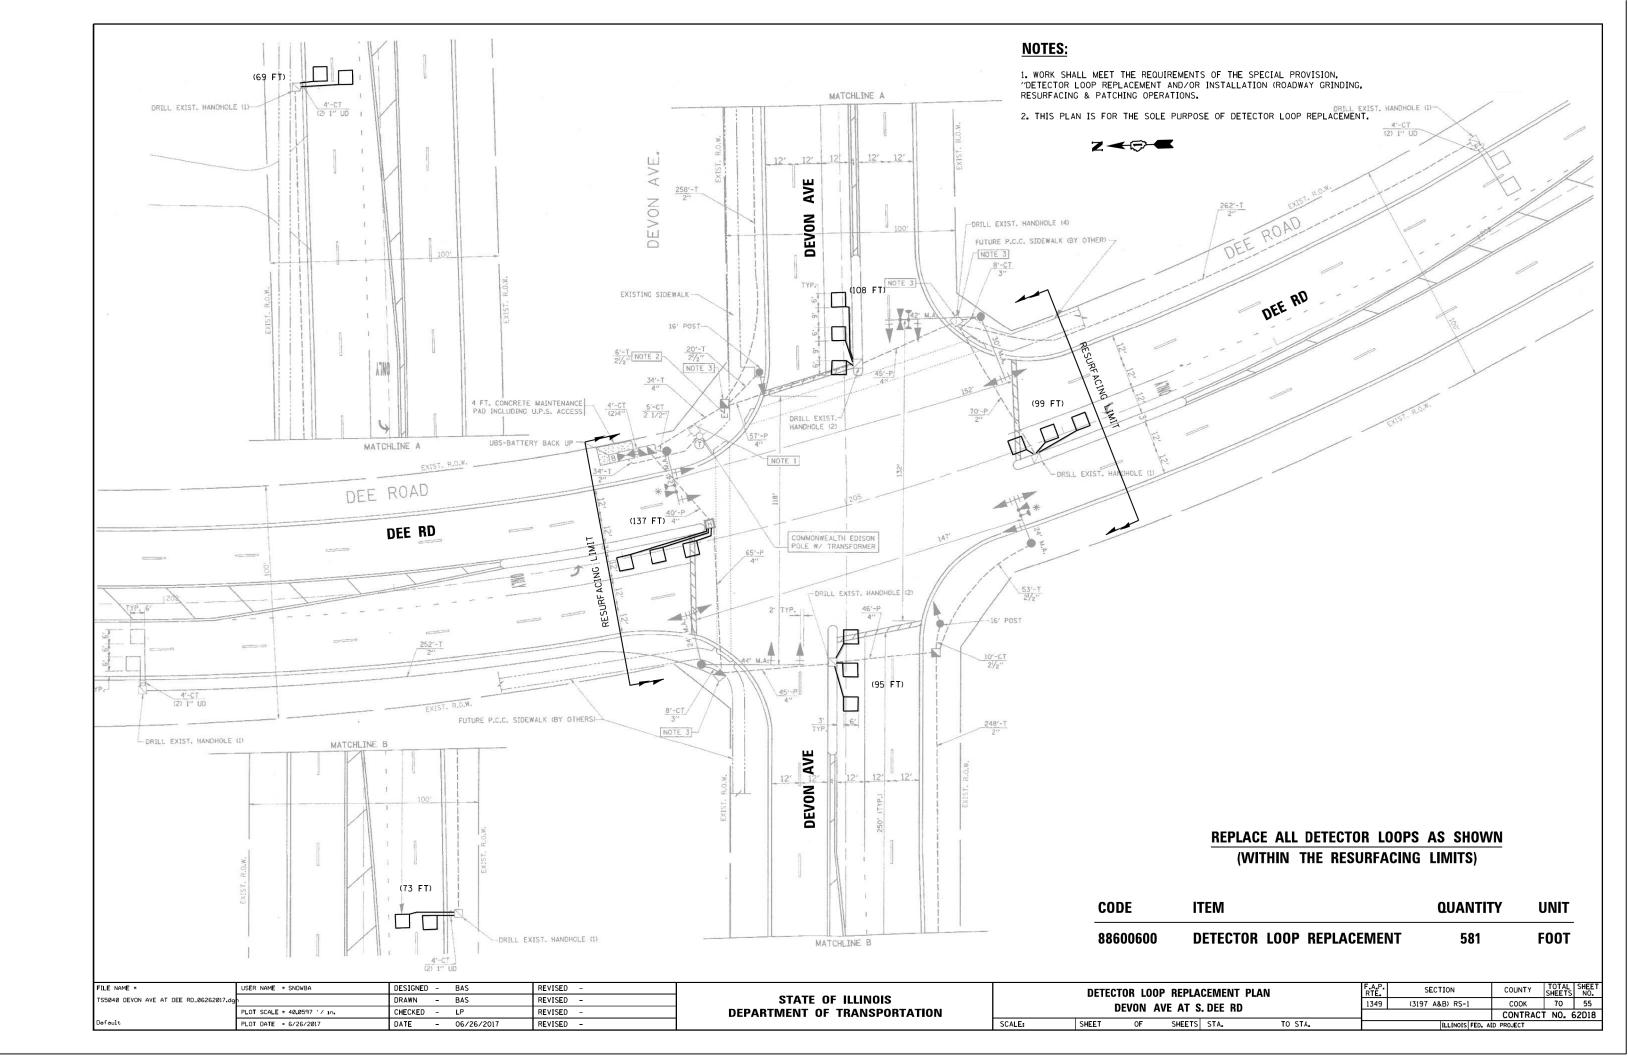


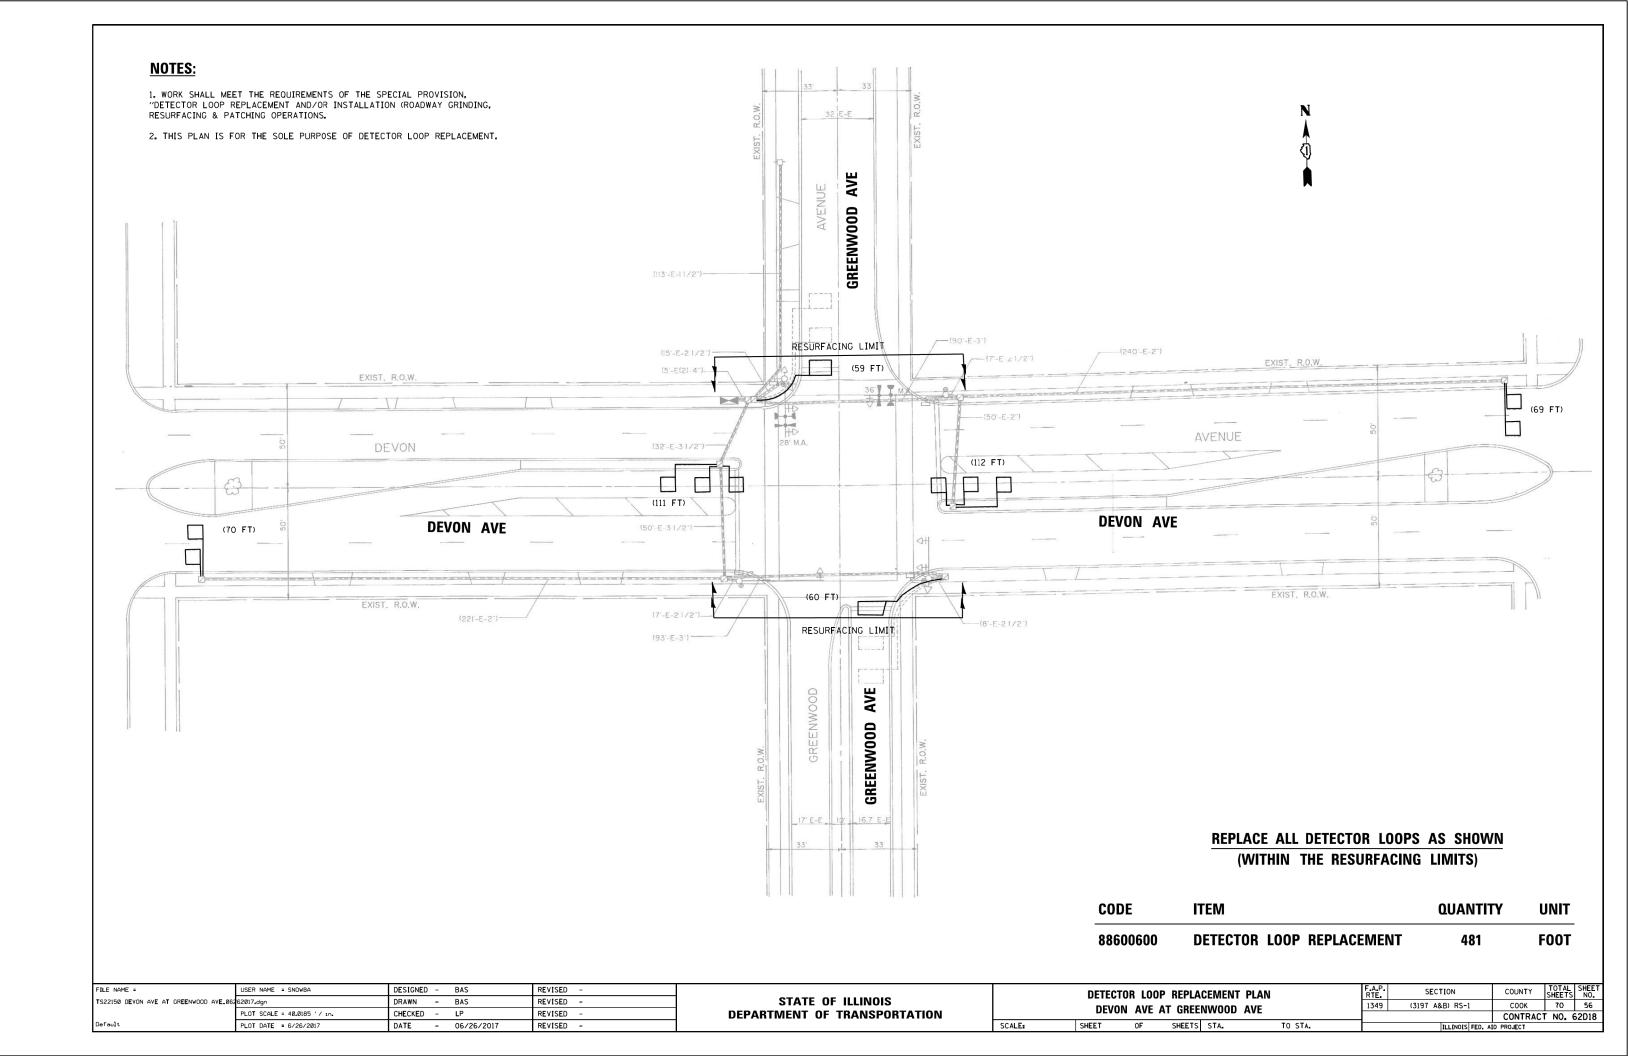

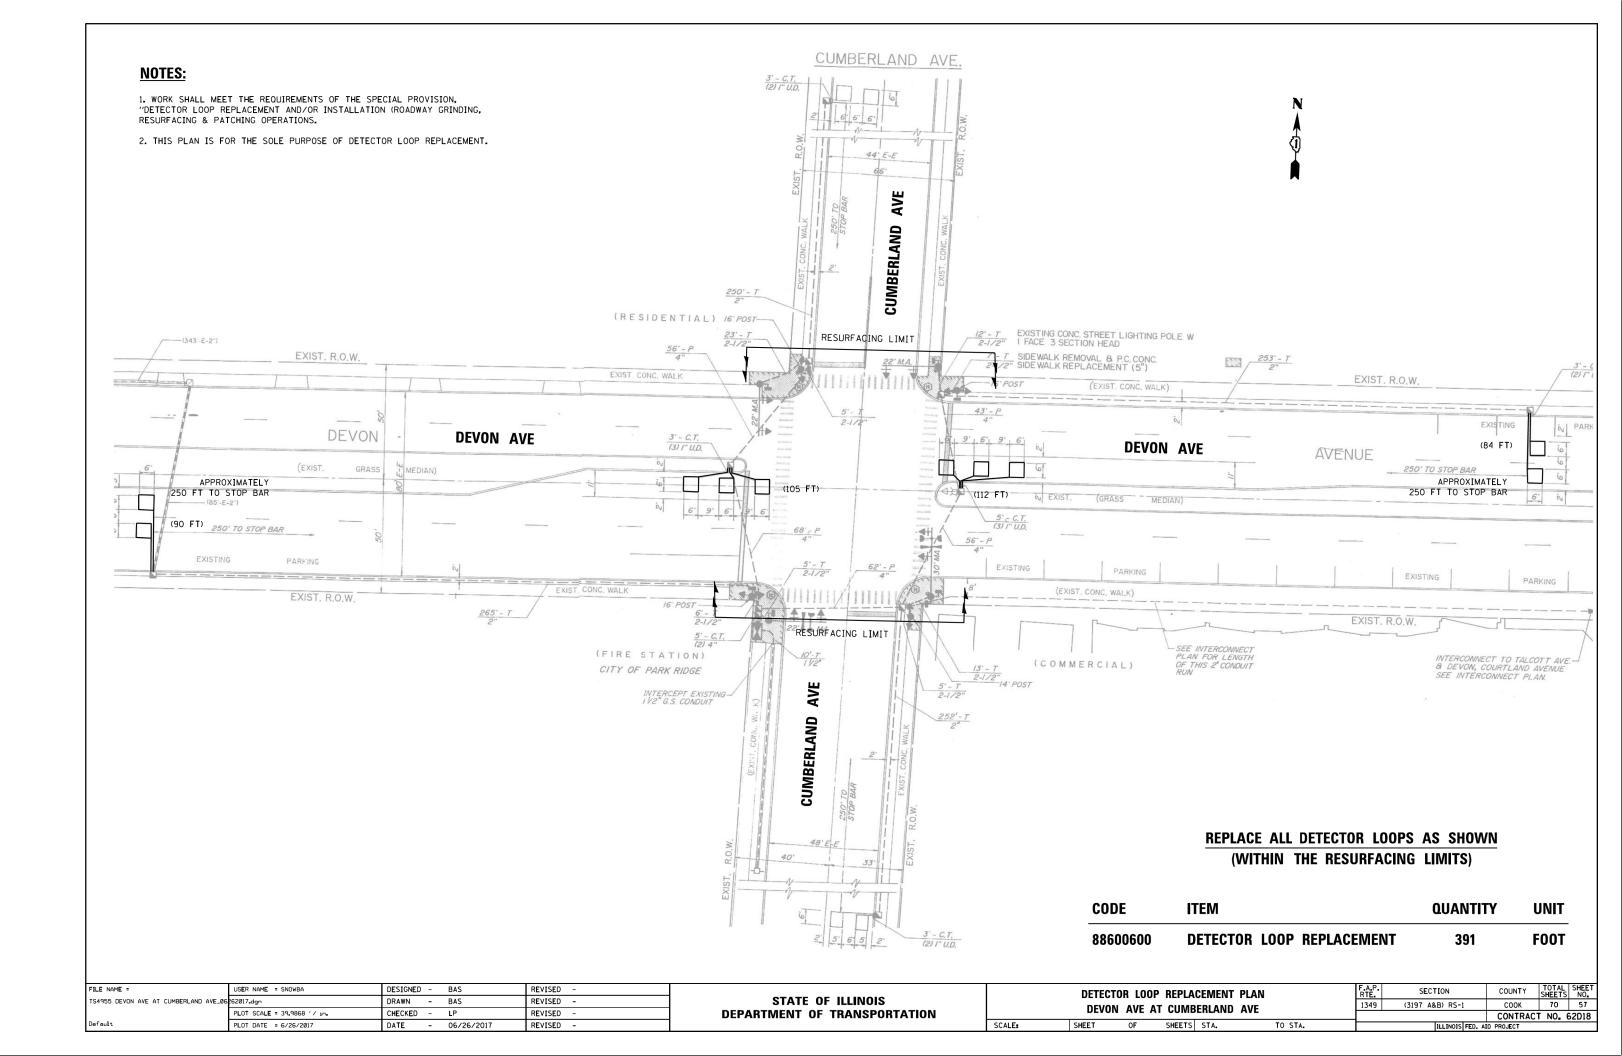

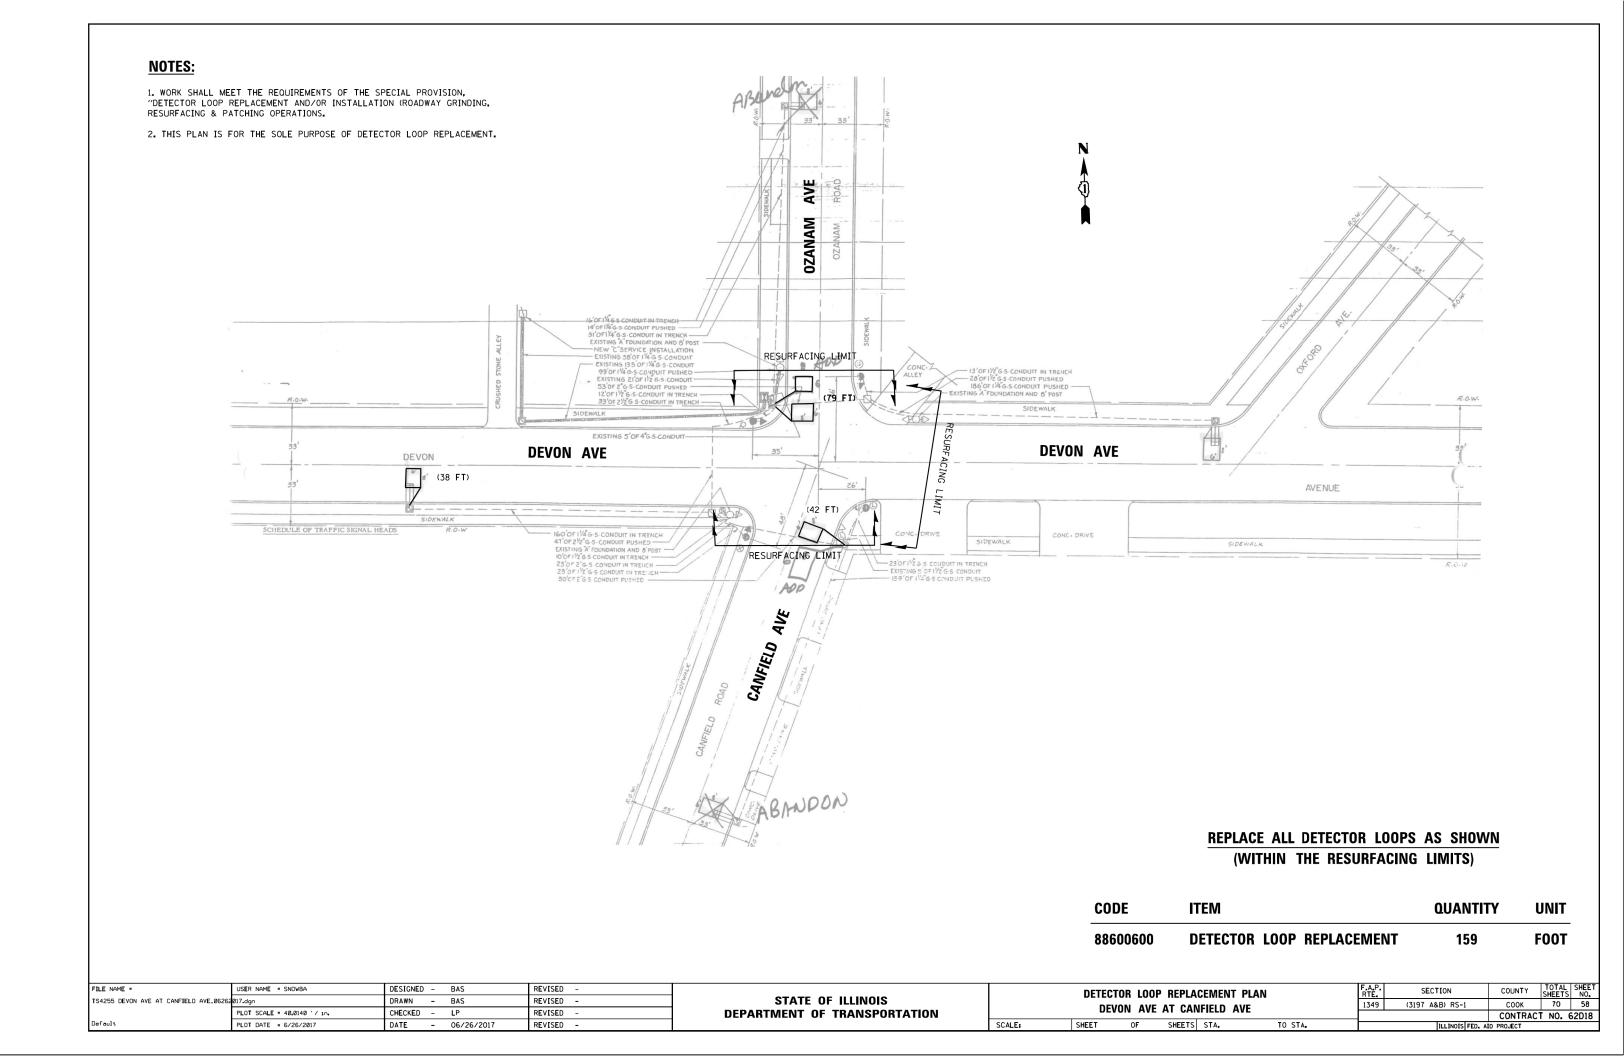

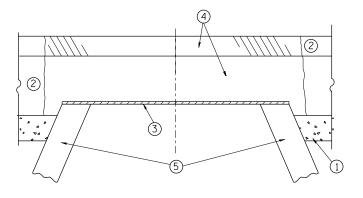

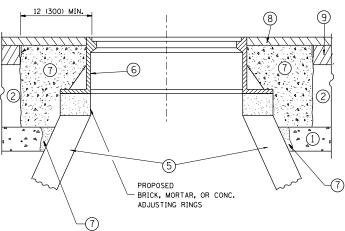

EXISTING BROKEN FRAMES AND LIDS SHALL BE REMOVED AND DISPOSED OF BY THE CONTRACTOR AND SHALL BE REPLACED AS DIRECTED BY THE ENGINEER. REPLACEMENT FRAMES AND LIDS WILL BE PAID FOR IN ACCORDANCE WITH ARTICLE 109.04 OF THE STANDARD SPECIFICATIONS UNLESS A SEPARATE PAY ITEM HAS BEEN PROVIDED.

IF THE EXISTING LIDS ARE OPEN, THE FRAME WILL BE ADJUSTED TO THE ELEVATION OF THE MILLED PAVEMENT SURFACE PRIOR TO THE MILLING OPERATION. THE FRAME WILL NOT BE REMOVED AND COVERED BY THE METAL PLATE.

CITY OF CHICAGO CASTINGS ARE THE PROPERTY OF THE CITY AND THE CONTRACTOR SHALL NOTIFY THE CITY FOR REMOVAL AND DISPOSITION OF THE CASTINGS.

THE METAL PLATE USED TO COVER THE STRUCTURE SHALL REMAIN THE PROPERTY OF THE CONTRACTOR.

WHEN STRUCTURES ARE TO BE ADJUSTED OR RECONSTRUCTED, THE LOWERING AND RAISING OF THE FRAMES AND LIDS WILL NOT BE PAID FOR SEPARATELY BUT WILL BE INCLUDED IN THE COST OF THE CORRESPONDING PAY ITEM.

SCALE: NONE

CONSTRUCTION PROCEDURES

STAGE 1 (BEFORE PAVEMENT MILLING)

- A) REMOVE A MINIMUM OF 12 (300) OF THE PAVEMENT FROM AROUND THE STRUCTURE.
- B) REMOVE THE EXISTING FRAME AND LID FROM THE STRUCTURE.
- C) COVER THE STRUCTURE OPENING WITH A 36 (900) DIAMETER METAL PLATE. D) BACKFILL WITH CRUSHED STONE AND A MINIMUM $1\frac{1}{2}$ (40)
- THICK HMA SURFACE MIX APPROVED BY THE ENGINEER.

STAGE 2 (AFTER PAVEMENT MILLING)

- A) REMOVE THE HMA SURFACE MIX AND CRUSHED STONE.
- B) INSTALL THE FRAME AND LID; ADJUST THE FRAME TO ITS FINAL SURFACE ELEVATION.
- C) THE SURROUNDING SPACE SHALL BE FILLED WITH CLASS PP-1* CONCRETE TO THE ELEVATION OF THE SURFACE OF THE EXISTING BASE COURSE OR THE BINDER COURSE.
- * UNLESS OTHERWISE SPECIFIED IN THE PLANS.

THE PROCEDURE EXPLAINED ABOVE SHALL CONFORM TO THE APPLICABLE PORTIONS OF SECTIONS 353, 406, 602, AND 603 OF THE STANDARD SPECIFICATIONS EXCEPT THAT "THE CONTRACTOR SHALL ADJUST THE STRUCTURES TO THE FINISHED PAVEMENT ELEVATION NO MORE THAN 5 CALENDAR DAYS PRIOR TO PLACEMENT OF THE FINAL LIFT OF SURFACE UNLESS APPROVED BY THE

LEGEND

- 1 SUB-BASE GRANULAR MATERIAL
- (6) FRAME AND LID (SEE NOTES)
- 2 EXISTING PAVEMENT

(5) EXISTING STRUCTURE

- (7) CLASS PP-1* CONCRETE
- 3 36 (900) DIAMETER METAL PLATE
- (8) PROPOSED HMA SURFACE COURSE
- PROPOSED CRUSHED STONE AND HMA SURFACE MIX
- (9) PROPOSED HMA BINDER COURSE

LOCATION OF STRUCTURES:

THE CONTRACTOR WILL BE REQUIRED TO KEEP A RECORD OF THE LOCATIONS OF THE BURIED STRUCTURES ACCORDING TO THE STATION AND DISTANCE LEFT OR RIGHT OF THE CENTERLINE OF PAVEMENT. UPON COMPLETION OF THE WORK. THE CONTRACTOR WILL DELIVER THE RECORD TO THE ENGINEER.

BASIS OF PAYMENT:

REMOVING FRAMES AND LIDS ON DRAINAGE AND UTILITY STRUCTURES IN THE PAVEMENT PRIOR TO MILLING, AND ADJUSTING TO FINAL GRADE PRIOR TO PLACING THE SURFACE COURSE, WILL BE PAID FOR AT THE CONTRACT UNIT PRICE EACH FOR "FRAMES AND LIDS TO BE ADJUSTED

THIS WORK WILL NOT BE PAID FOR WHEN DRAINAGE AND UTILITY STRUCTURES ARE SPECIFIED FOR PAYMENT AS STRUCTURE RECONSTRUCTION.


NEW FRAMES AND LIDS, WHEN SPECIFIED, WILL BE PAID FOR SEPARATELY.

DETAILS FOR FRAMES AND LIDS ADJUSTMENT WITH MILLING

ALL DIMENSIONS ARE IN INCHES (MILLIMETERS) UNLESS OTHERWISE SHOWN

FILE NAME =	USER NAME = paraynoal	DESIGNED - R. SHAH	REVISED - R. WIEDEMAN 05-14-04
pw:\\IL084EBIDINTEG.:ll:no:s.gov:PWIDOT\Do	cuments\IDOT Offices\District 1\Projects\D143	61 BR(AWIN ata\Design\Diststd.dgn	REVISED - R. BORO 01-01-07
	PLOT SCALE = 100.0000 '/ in.	CHECKED -	REVISED - R. BORO 03-09-11
	PLOT DATE = 2/1/2018	DATE - 10-25-94	REVISED - R. BORO 12-06-11

DETAILS FOR	F.A.U. RTE.	SECTION	COUNTY TOTA		SHEET NO.
FRAMES AND LIDS ADJUSTMENT WITH MILLING	1349	(3197A&B) RS-1	соок	70	59
TRANIES AND LIDS ADSOSTIVIENT WITH MILLING		BD600-03 (BD-8)	CONTRACT	NO. (62D18
SHEET NO. 1 OF 1 SHEETS STA. TO STA.	FFD. R	OAD DIST. NO. 1 THE INDIS FED. AT	D PROJECT		

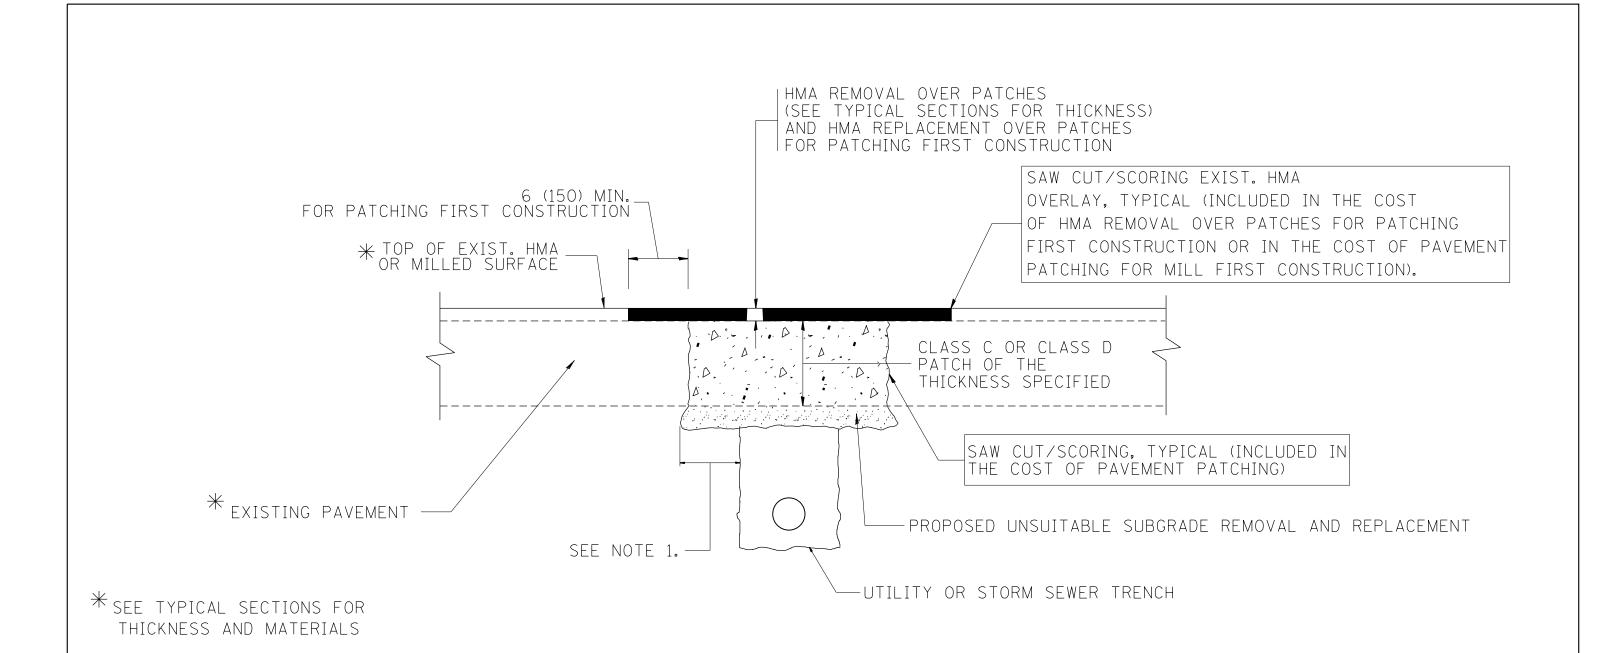

NOTES:

- 1. THE WIDTH OF THE FULL DEPTH PATCH OVER A TRENCH SHALL BE 12 (300) WIDER ON EACH SIDE OF THE TRENCH.
- 2. FOR METHOD OF MEASUREMENT AND BASIS OF PAYMENT, SEE RECURRING SPECIAL PROVISION "PATCHING WITH HOT-MIX ASPHALT OVERLAY REMOVAL".

SEQUENCE OF CONSTRUCTION (PATCHING FIRST)


- 1. REMOVE THE EXISTING HMA MATERIAL OVER THE AREA TO BE PATCHED.
- 2. REMOVE AND REPLACE WITH CLASS C OR D PATCH.
- 3. REPLACE HMA MATERIAL OVER THE AREA TO BE PATCHED.

SEQUENCE OF CONSTRUCTION (MILLING FIRST)

- 1. MILL HMA FIRST IF THERE IS AT LEAST 41/2 INCHES OR MORE OF HMA MATERIAL ON TOP OF THE EXISTING PAVEMENT OR IF THE PAVEMENT IS FULL DEPTH HMA. A MINIMUM OF 2 INCHES OF HMA MATERIAL SHALL BE IN PLACE AFTER MILLING.
- 2. REMOVE AND REPLACE WITH FULL DEPTH CLASS D PATCHES TO TOP OF MILLED SURFACE.

ALL DIMENSIONS ARE IN INCHES (MILLIMETERS) UNLESS OTHERWISE SHOWN.


FILE NAME =	USER NAME = paraynoal	DESIGNED - R. SHAH	REVISED - A. ABBAS 04-27-98		PAVEMENT PATCHING FOR	F.A.U.	SECTION	COUNTY	TOTAL SHE	EET
pw:\\IL084EBIDINTEG.:ll:no:s.gov:PWIDOT\Do	cuments\IDOT Offices\District 1\Projects\D14	361 BRANDN ata\Design\Diststd.dgn	REVISED - R. BORO 01-01-07	STATE OF ILLINOIS		1349	(3197A&B) RS-1	соок	70 6	Ű,
	PLOT SCALE = 100.0000 '/ in.	CHECKED -	REVISED - R. BORO 09-04-07	DEPARTMENT OF TRANSPORTATION	HMA SURFACED PAVEMENT	F	3D400-04 (BD-22)	CONTRACT	T NO. 62D	18
	PLOT DATE = 2/1/2018	DATE - 10-25-94	REVISED - K. ENG 10-27-08		SCALE: NONE SHEET NO. 1 OF 1 SHEETS STA. TO STA.	FED. RO/		FFD. AID PROJECT		_

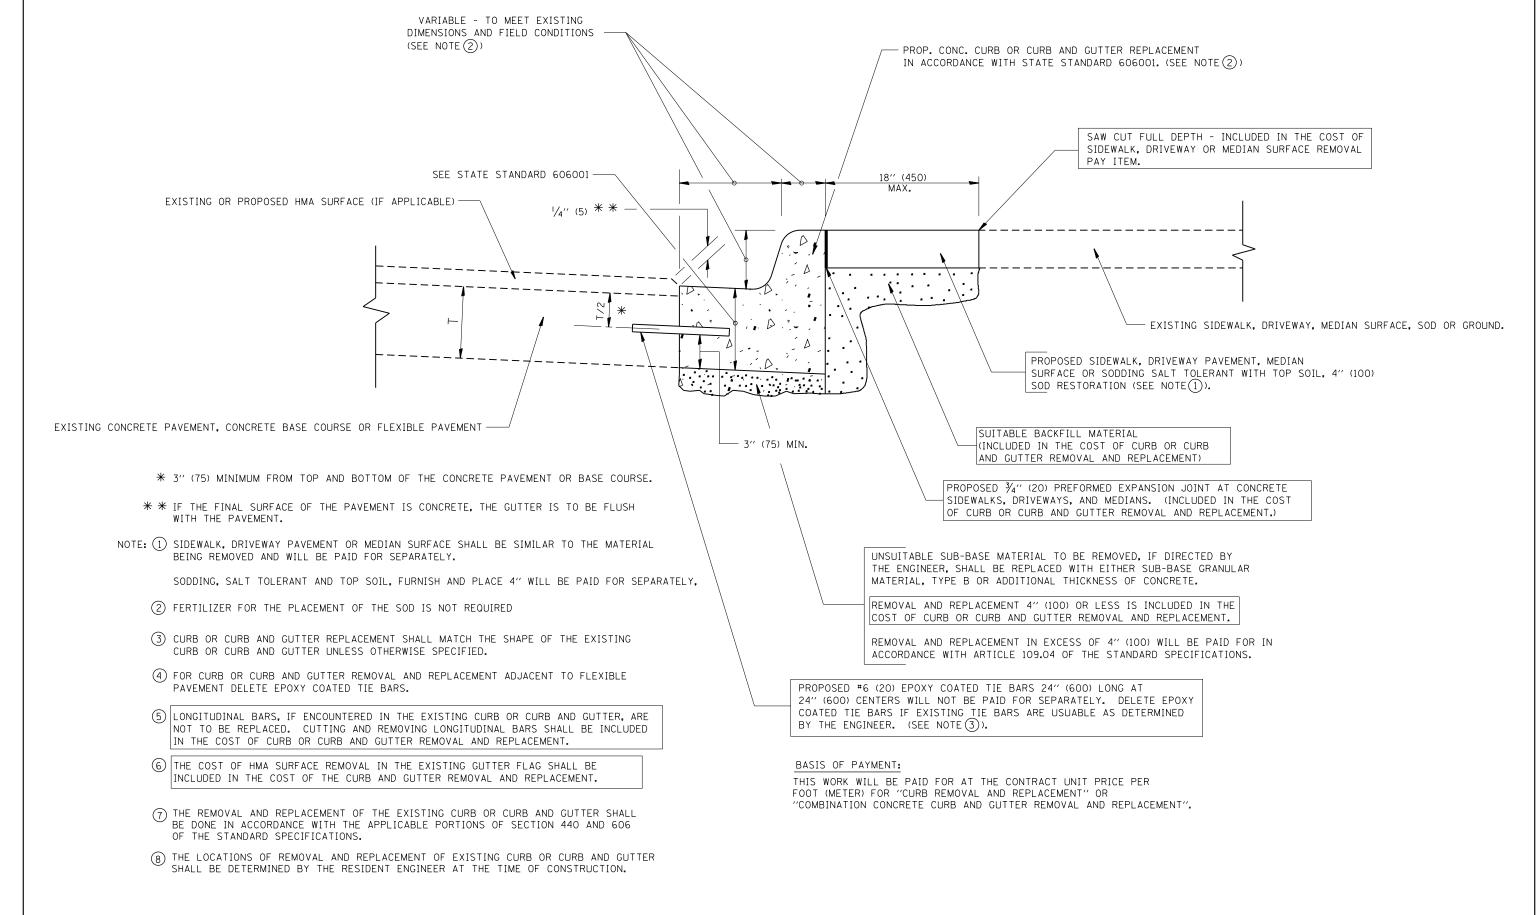


CURB OR CURB AND GUTTER REMOVAL AND REPLACEMENT

ALL DIMENSIONS ARE IN INCHES (MILLIMETERS)
UNLESS OTHERWISE SHOWN.

	F.A.U.	SECTION	COUNTY	Y SHE	FTS N	EE I
ļ l	1349	(3197A&B) RS-1	соок	7	70	61
The state of the s		BD600-06 (BD-24)	CONTRA	ACT NO	. 62[)18
TO STA.						
_	TO STA.		BD600-06 (BD-24)	1349 (3197A&B) RS-1 COOK BD600-06 (BD-24) CONTRA	1349 (3197A&B) RS-1 COOK 7/ BD600-06 (BD-24) CONTRACT NO.	1349 (3197A&B) RS-1 COOK 70 6 BD600-06 (BD-24) CONTRACT NO. 62D

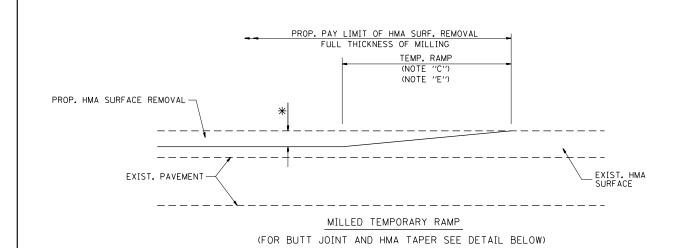

OPTION 1

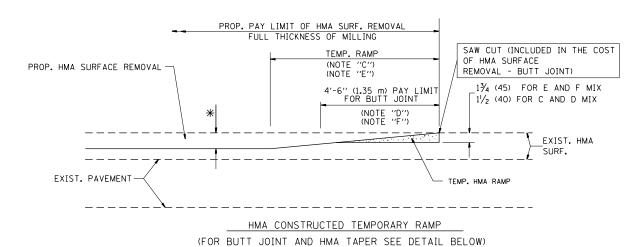

OPTION 2

TYPICAL TEMPORARY RAMP

HMA TAPER LENGTH *** SAW CUT (INCLUDED IN THE COST OF HMA SURFACE PROP. HMA SURF. CRSE. REMOVAL - BUTT JOINT) PROP. HMA BINDER CRSE. 4'-6" (1.35 m) VARIES _ 13/4 (45) FOR E AND F MIX PAY LIMIT FOR BUTT JOINT (NOTE "D") 11/2 (40) FOR C AND D MIX EXIST. HMA SURF. EXIST. PAVEMENT HMA SURF. REMOVAL - BUTT JOINT BUTT JOINT AND HMA TAPER

TYPICAL BUTT JOINT AND HMA TAPER FOR MILLING AND RESURFACING

FILE NAME = USER NAME = paraynoal DESIGNED - M. DE YONG REVISED - R. SHAH 10-25-94


pwi\\[\] \[

STATE OF ILLINOIS
DEPARTMENT OF TRANSPORTATION

ALL DIMENSIONS ARE IN INCHES (MILLIMETERS) UNLESS

OTHERWISE SHOWN.

PROP. HMA OR PCC SURFACE REMOVAL - BUTT JOINT 30'-0" (9.0 m) (NOTE "A") 15'-0" (4.5 m) (NOTE "B") (NOTE "D") ** * EXIST. PAVEMENT BUTT JOINT DETAIL

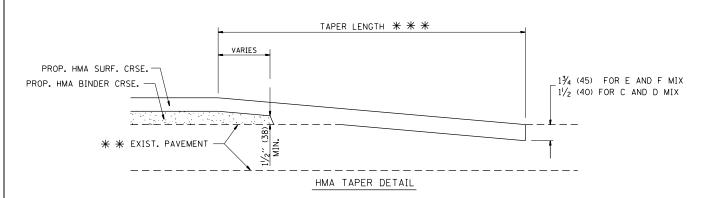

TYPICAL BUTT JOINT AND HMA TAPER FOR RESURFACING ONLY


* * PC CONCRETE, HMA OR HMA RESURFACED PAVEMENT.

NOTES

- A: MAINLINE ROADWAYS AND MAJOR SIDE ROADS.
- : MINOR SIDE ROADS.
- C: THE TEMP. RAMP SHALL BE CONSTRUCTED IMMEDIATELY UPON REMOVAL OF THE EXISTING HMA SURFACE.
- D: THE BUTT JOINT SHALL BE CONSTRUCTED IMMEDIATELY PRIOR TO PLACING THE PROPOSED HMA COURSES.
- E: TAPER THE TEMP. RAMP AT A RATE OF 3'-0" (900 mm) PER 1 INCH (25 mm) OF MILLING THICKNESS.
- F: INSTALLATION AND REMOVAL OF THE 4'-6" (1.35 m) TEMP. RAMP IS INCLUDED IN COST OF HMA SURFACE REMOVAL BUTT JOINT
- G: SEE ARTICLE 406.08 AND 406.14 OF THE STANDARD SPECIFICATIONS FOR "HMA AND/OR PCC SURFACE REMOVAL, BUTT JOINT".
- * SEE TYPICAL SECTIONS FOR MILLING THICKNESS.

BASIS OF PAYMENT:

THE BUTT JOINT WILL BE PAID FOR AT THE CONTRACT UNIT PRICE PER SQUARE YARD (SQUARE METER) FOR "HOT-MIX ASPHALT SURFACE REMOVAL - BUTT JOINT" OR FOR "PORTLAND CEMENT CONCRETE SURFACE REMOVAL- BUTT JOINT".

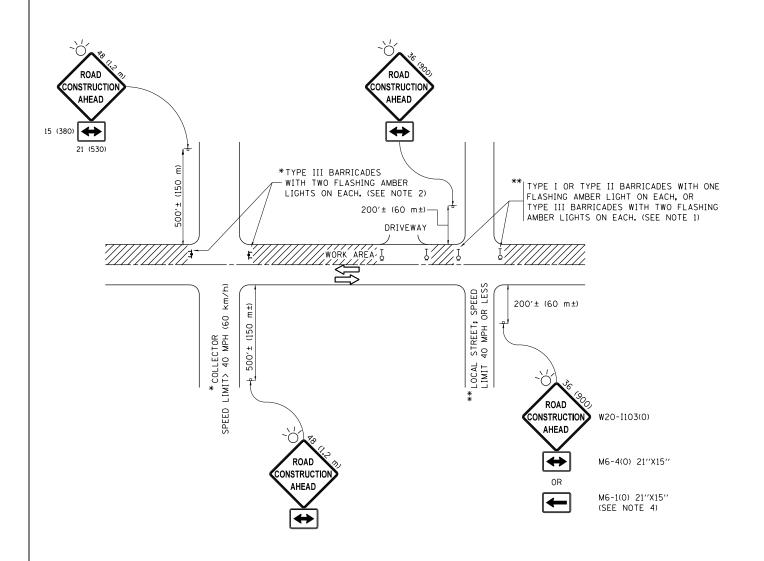

NOTES:

- SIDE ROAD WITH A SPEED LIMIT OF 40 MPH (60 km/h) OR LESS AS SHOWN ON THE DRAWING AND AS DIRECTED BY THE ENGINEER:
 - a) ONE "ROAD CONSTRUCTION AHEAD" SIGN 36 x 36 (900x900) WITH A FLASHER MOUNTED ON IT APPROXIMATELY 200" (60 m) IN ADVANCE OF THE MAIN ROUTE.
 - b) THE CLOSED PORTION OF THE MAIN ROUTE SHALL BE PROTECTED BY BLOCKING WITH TYPE I, TYPE II OR TYPE III BARRICADES, 1/3 OF THE CROSS SECTION OF THE CLOSED PORTION.
- 2. SIDE ROAD WITH A SPEED LIMIT GREATER THAN 40 MPH (60 km/h) AS SHOWN ON THE DRAWING AND AS DIRECTED BY THE ENGINEER:
 - a) ONE "ROAD CONSTRUCTION AHEAD" SIGN 48 x 48 (1.2 m x 1.2 m) WITH A FLASHER MOUNTED ON IT APPROXIMATELY 500" (150 m) IN ADVANCE OF THE MAIN ROUTE.
 - b) THE CLOSED PORTION OF THE MAIN ROUTE SHALL BE PROTECTED BY BLOCKING WITH TYPE III BARRICADES, 1/2 OF THE CROSS SECTION OF THE CLOSED PORTION.
- 3. CONES MAY BE SUBSTITUTED FOR BARRICADES OR DRUMS AT HALF THE SPACING DURING DAY OPERATIONS. CONES SHALL BE A MINIMUM OF 28 (710) IN HEIGHT
- 4. WHEN THE SIDE ROAD LIES BETWEEN THE BEGINNING OF THE MAINLINE SIGNING AND THE WORK ZONE, A SINGLE HEADED ARROW (M6-1) SHALL BE USED IN LIEU OF THE DOUBLE HEADED ARROW (M6-4).

SCALE: NONE

- 5. WHEN WORK IS BEING PERFORMED ON A SIDE ROAD OR DRIVEWAY, FOLLOW THE APPLICABLE STANDARD(S). THE DIRECTIONAL ARROW (M6-1 OR M6-4) SHALL BE COVERED OR REMOVED WHEN NO LONGER CONSISTENT WITH THE TRAFFIC CONTROL SET-UP.
- 6. ADVANCE WARNING SIGNS ARE TO BE OMITTED ON DRIVEWAYS UNLESS OTHERWISE SPECIFIED IN THE PLANS OR BY THE ENGINEER
- 7. THE TRAFFIC CONTROL AND PROTECTION FOR SIDE ROADS, INTERSECTIONS, AND DRIVEWAYS SHALL BE INCLUDED IN THE COST OF SPECIFIED TRAFFIC CONTROL STANDARDS OR ITEMS.


All dimensions are in inches (millimeters) unless otherwise shown.

FILE NAME =	USER NAME = paraynoal	DESIGNED - L.H.A.	REVISED	- A. HOUSEH 10-15-96
pw:\\ILØ84EBIDINTEG.:ll:nois.gov:PWIDOT\Do	cuments\IDOT Offices\District 1\Projects\D143	61 BR0AND Nata\Design\Diststd.dgn	REVISED	-T. RAMMACHER 01-06-00
	PLOT SCALE = 100.0000 '/ in.	CHECKED -	REVISED	- A. SCHUETZE 07-01-13
Default	PLOT DATE = 2/1/2018	DATE - 06-89	REVISED	- A. SCHUETZE 09-15-16

STATI	E OF	: ILLINOIS
DEPARTMENT	0F	TRANSPORTATION


SI						TION FOR DRIVEWAYS	
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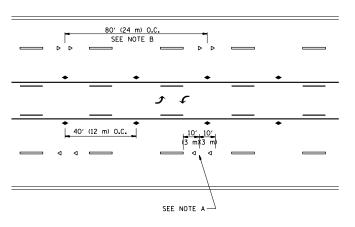
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	TC-10	CONTRACT	NO. 6	52D18
1349	(3197A&B) RS-1	COOK	70	63
F.A.U. RTE.	SECTION	COUNTY	TOTAL SHEETS	SHEE NO.

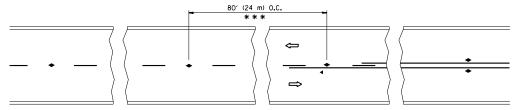


*** REDUCE TO 40' (12 m) O.C. ON CURVES WITH POSTED OR ADVISORY SPEED 45 M.P.H. (70 km/h) OR LESS.

TWO-LANE/TWO-WAY




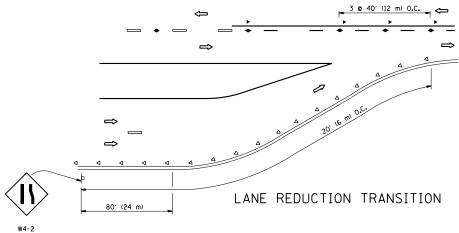

TWO-WAY LEFT TURN

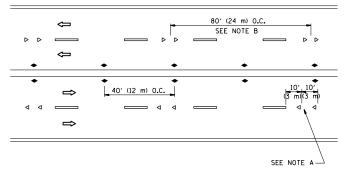

MULTI-LANE/UNDIVIDED

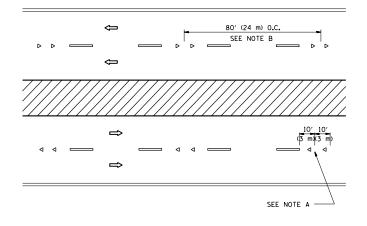

MULTI-LANE/DIVIDED

GENERAL NOTES

- MARKERS USED WITH DASHED LINES SHALL BE CENTERED IN THE GAP BETWEEN SEGMENTS.
- 2. MARKERS USED ADJACENT TO SOLID LINES SHALL BE OFFSET 2 TO 3 (50 TO 75) TOWARD TRAFFIC AS SHOWN.
- 3. MARKERS THROUGH TANGENTS LESS THAN 500' (150 m) IN LENGTH BETWEEN CURVES SHALL BE INSTALLED AT THE LESSER OF THE TWO CURVE SPACINGS.

LANE MARKER NOTES

A. USE DOUBLE LANE LINE MARKERS SPACED AS SHOWN.

B. REDUCE TO 40' (12 m) O.C. ON CURVES WHERE ADVISORY SPEEDS ARE 10 M.P.H (20 km/h) LOWER THAN POSTED SPEEDS.

SYMBOLS

---- YELLOW STRIPE

WHITE STRIPE

- ONE-WAY AMBER MARKER
- ONE-WAY CRYSTAL MARKER (₩/O)
- ◆ TWO-WAY AMBER MARKER

DESIGN NOTES

- 1. DOUBLE LANE LINE MARKERS SHALL BE USED UNLESS SPECIFIED OTHERWISE.
- 2. EXCEPT AS SHOWN ON THE LANE REDUCTION TRANSITION AND FREEWAY EXIT RAMP DETAIL, MARKERS ARE NOT TO BE SPECIFIED ON RIGHT EDGE LINES.
- 3. THE EXACT MARKER LIMITS, SPACING, AND COLOR SHALL BE INCLUDED IN THE PLANS WHEN STANDARD SPECIFICATIONS ARE NOT BEING USED.
- 4. MARKERS SHOULD NOT BE USED ALONGSIDE CURBS EXCEPT FOR EXTREMELY SHORT SECTIONS OF CURBS WHERE NOT MORE THAN TWO MARKERS WOULD BE INVOLVED.

MINIMUM OF 3 W
EQUALLY SPACED 3 @ 80' (24 m) O.C. — ___ 3 @ 80' (24 m) O.C. 3 @ 40' (12 m) 3 @ 40' (12 m) 40' (12 m) 0.C. 40' (12 m) 0.C. ⇔ \Rightarrow ◆ 40′ (12 m) 0.C. 40' (12 m) 0.C. * SEE TWO-LANE/TWO-WAY WHERE MARKERS CONTINUE ** WHERE THE MEDIAN WIDTH IS 6' (2 m) OR LESS USE TWO-WAY MARKERS.

LEFT TURN

All dimensions are in inches (millimeters)

FILE NAME =	USER NAME = paraynoal	DESIGNED -	REVISED	-T. RAMMACHER (09-19-94
pw:\\ILØ84EBIDINTEG.:ll1no1s.gov:PWIDOT\Do	cuments\IDOT Offices\District 1\Projects\D143	61 BR(AMDN ata\Design\Diststd.dgn	REVISED	-T. RAMMACHER (03-12-99
	PLOT SCALE = 100.0000 ' / in.	CHECKED -	REVISED	-T. RAMMACHER C	01-06-00
	PLOT DATE = 2/1/2018	DATE -	REVISED	- C. JUCIUS C	9-09-09

STATE OF ILLINOIS **DEPARTMENT OF TRANSPORTATION**


TYPICAL APPLICATIONS	F.A.U. RTE.	SECTION			
RAISED REFLECTIVE PAVEMENT MARKERS (SNOW-PLOW	1349	(3197A&B) RS-1			
NAISED RELECTIVE PAVEINENT INVANKERS (SNOW-PLOW		TC-11			
SCALE: NONE SHEET NO. 1 OF 1 SHEETS STA.	TO STA.	FED. ROAD	DIST, NO. 1 ILLINOIS FE		

unless otherwise shown. SECTION COUNTY


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70 64

CONTRACT NO. 62D18

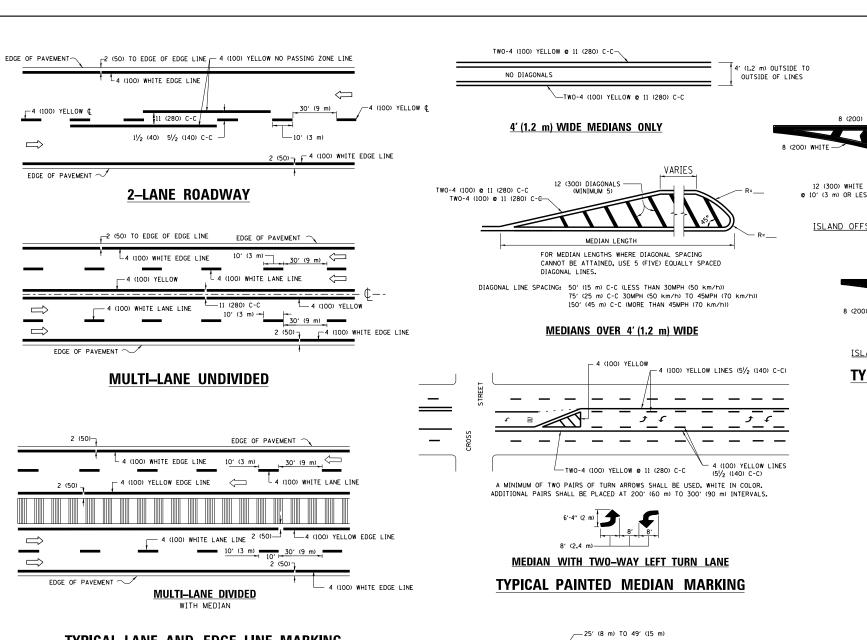

TYPICAL LANE AND EDGE LINE MARKING

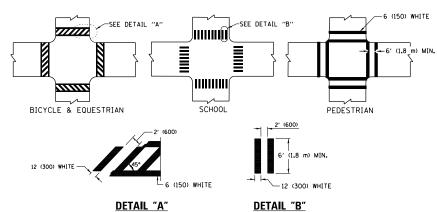

TYPICAL CROSSWALK MARKING

* MARKINGS SHALL BE INSTALLED PARALLEL TO THE CENTERLINE OF THE ROAD WHICH IT CROSSES


−50′ (15 m) TO 200′ (60 m) || OVER 200' (60 m) ____ 6 (150) WHITE

FULL SIZE LETTERS 8' (2.4 m) AND ARROWS SHALL BE USED. AREA = 15.6 SO. FT. (1.5 m²) ONLY AREA = 20.8 SO. FT. (1.9 m²)


* TURN LANES IN EXCESS OF 400' (120 m) IN LENGTH MAY HAVE AN ADDITIONAL SET OF ARROW - "ONLY" INSTALLED MIDWAY BETWEEN THE OTHER TWO SETS OF ARROW - "ONLY".

TYPICAL LEFT (OR RIGHT) TURN LANE

TYPICAL TURN LANE MARKING

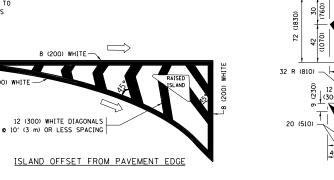





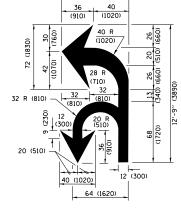

6'-4" (1930)

COMBINATION LEFT AND U-TURN

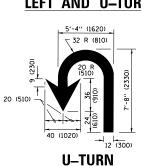

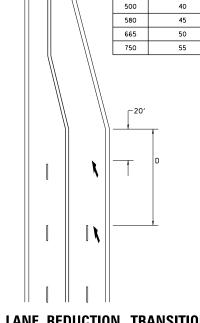

D(FT)

345

425

SPEED LIMIT

LANE REDUCTION TRANSITION

* LANE REDUCTION ARROWS REQUIRED AT SPEEDS OF 45 MPH OR GREATER OR WHEN SPECIFIED IN PLANS.

			Olliv	
TYPE OF MARKING	WIDTH OF LINE	PATTERN	COLOR	SPACING /REMARKS
CENTERLINE ON 2 LANE PAVEMENT	4 (100)	SKIP-DASH	YELLOW	10' (3 m) LINE WITH 30' (9 m) SPACE
CENTERLINE ON MULTI-LANE UNDIVIDED PAVEMENT	2 @ 4 (100)	SOLID	YELLOW	11 (280) C-C
NO PASSING ZONE LINES: FOR ONE DIRECTION FOR BOTH DIRECTIONS	4 (100) 2 @ 4 (100)	SOLID SOLID	YELLOW YELLOW	5½ (140) C-C FROM SKIP-DASH CENTERLINE 11 (280) C-C OMIT SKIP-DASH CENTERLINE BETWEEN
LANE LINES	4 (100) 5 (125) ON FREEWAYS	SKIP-DASH SKIP-DASH	WHITE WHITE	10' (3 m) LINE WITH 30' (9 m) SPACE
DOTTED LINES (EXTENSIONS OF CENTER, LANE OR TURN LANE MARKINGS)	SAME AS LINE BEING EXTENDED	SKIP-DASH	SAME AS LINE BEING EXTENDED	2' (600) LINE WITH 6' (1.8 m) SPACE
EDGE LINES	4 (100)	SOLID	YELLOW-LEFT WHITE-RIGHT	OUTLINE MEDIANS IN YELLOW
TURN LANE MARKINGS	6 (150) LINE; FULL SIZE LETTERS & SYMBOLS (8' (2.4m))	SOLID	WHITE	SEE TYPICAL TURN LANE MARKING DETAIL
TWO WAY LEFT TURN MARKING	2 @ 4 (100) EACH DIRECTION 8' (2.4m) LEFT ARROW	SKIP-DASH AND SOLID IN PAIRS	YELLOW	10' (3 m) LINE WITH 30' (9 m) SPACE FOR SKIP-DASH; 5½ (140) C-C BETWEEN SOLID LINE AND SKIP-DASH LINE SEE TYPICAL TWO-WAY LEFT TURN MARKING DETAIL
CROSSWALK LINES (PEDESTRIAN) A. DIAGONALS (BIKE & EQUESTRIAN) B. LONGITUDINAL BARS (SCHOOL)	2 e 6 (150) 12 (300) e 45° 12 (300) e 90°	SOLID SOLID	WHITE WHITE WHITE	NOT LESS THAN 6' (1.8 m) APART 2' (600) APART 2' (600) APART SEE TYPICAL CROSSWALK MARKING DETAILS.
STOP LINES	24 (600)	SOLID	WHITE	PLACE 4' (1.2 m) IN ADVANCE OF AND PARALLEL TO CROSSWALK, IF PRESENT, OTHERWISE, PLACE AT DESIRED STOPPING POINT. PARALLEL TO CROSSROAD CENTERLINE, WHERE POSSIBLE
PAINTED MEDIANS	2 @ 4 (100) WITH 12 (300) DIAGONALS @ 45° NO DIAGONALS USED FOR 4' (1.2 m) WIDE MEDIANS	SOLID	YELLOW: TWO WAY TRAFFIC WHITE: ONE WAY TRAFFIC	11 (280) C-C FOR THE DOUBLE LINE SEE TYPICAL PAINTED MEDIAN MARKING.
GORE MARKING AND CHANNELIZING LINES	8 (200) WITH 12 (300) DIAGONALS @ 45°	SOLID	WHITE	DIAGONALS: 15' (4,5 m) C-C (LESS THAN 30MPH (50 km/h)) 20' (6 m) C-C 30MPH (50 km/h) TO 45MPH (70 km/h)) 30' (9 m) C-C (OVER 45MPH (70 km/h))
RAILROAD CROSSING	24 (600) TRANSVERSE LINES; "RR" IS 6' (1.8 m) LETTERS; 16 (400) LINE FOR "X"	SOLID	WHITE	SEE STATE STANDARD 780001 AREA OF: "R"=3.6 SQ. FT. (0.33 m²) EACH "X"=54.0 SQ. FT. (5.0 m²)
SHOULDER DIAGONALS (REQUIRED FOR SHOULDERS > 8')	12 (300) © 45°	SOLID	WHITE - RIGHT YELLOW - LEFT	50' (15 m) C-C (LESS THAN 30MPH (50 km/h)) 75' (25 m) C-C (30 MPH (50 km/h) T0 45MPH (70 km/h)) 150' (45 m) C-C (0VER 45MPH (70 km/h))
U TURN ARROW	SEE DETAIL	SOLID	WHITE	16.3 SF
2 ARROW COMBINATION LEFT AND U TURN	SEE DETAIL	SOLID	WHITE	30.4 SF

FOR FURTHER DETAILS ON PAVEMENT MARKING REFER TO STANDARD SPECIFICATIONS FOR ROAD AND BRIDGE CONSTRUCTION AND STATE STANDARD 780001.

SCALE: NONE

All dimensions are in inches (millimeters) unless otherwise shown.

FILE NAME = DESIGNED - EVERS USER NAME = paraynoal REVISED - C. JUCIUS 09-09-09 ow:\\ILØ84EBIDINTEG.:ll:no: ments\IDOT Offices\District 1\Projects\D143616RQANNNata\Design\Diststd.dgr REVISED -C. JUCIUS 07-01-13 CHECKED REVISED -C. JUCIUS 12-21-15 PLOT DATE = 2/1/2018 DATE 03-19-90 REVISED -C. JUCIUS 04-12-16

	DISTRICT ONE					F.A.U. RTE.	SECTION	COUNTY	TOTAL SHEETS	SHEET NO.
TYPICAL PAVEMENT MARKINGS				1349	(3197A&B) RS-1	соок	70	65		
							TC-13	CONTRACT	NO.	62D18
	SHEET 1	OF 1	SHEETS	STA	TO STA.		TI I INDIC EED A	ID DDO IECT		

TURN BAY ENTRANCE AT START OF LANE CLOSURE TAPER

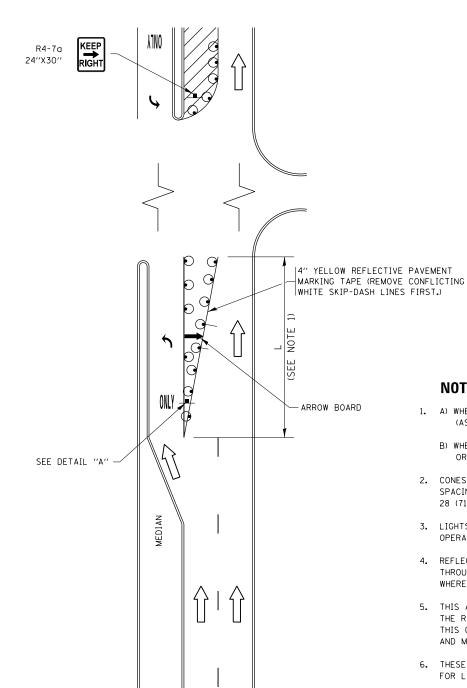


FIGURE 1

LEGEND WORK AREA LANE OPEN TO TRAFFIC ARROW BOARD TYPE I OR II BARRICADE OR DRUM WITH STEADY BURN LIGHT DRUM WITH STEADY BURN LIGHT


TYPE I OR II CHECK BARRICADE WITH FLASHING LIGHT

SIGN ASSEMBLY

NOTES:

- 1. A) WHEN "L" IS < THE STORAGE LENGTH OF THE TURN LANE (AS SHOWN IN FIG. 1), USE FIGURE 1.
 - B) WHEN "L" IS > THE STORAGE LENGTH OF THE TURN LANE OR THE TURN LANE IS WITHIN THE LANE CLOSURE, USE FIGURE 2.
- 2. CONES MAY BE SUBSTITUTED FOR BARRICADES OR DRUMS AT HALF THE SPACING DURING DAY OPERATIONS. CONES SHALL BE A MINIMUM OF 28 (710) IN HEIGHT.
- 3. LIGHTS WILL NOT BE REQUIRED ON BARRICADES OR DRUMS FOR DAY OPERATIONS. ALL LIGHTS SHALL BE MONODIRECTIONAL.
- 4. REFLECTIVE TEMPORARY PAVEMENT MARKINGS SHALL BE PLACED THROUGHOUT THE BARRICADED AREAS OF EACH TURN BAY AS SHOWN WHERE THE CLOSURE TIME IS GREATER THAN FOURTEEN (14) DAYS.
- 5. THIS APPLICATION ALSO APPLIES WHEN WORK IS BEING PERFORMED IN THE RIGHT LANE(S) AND THE RIGHT TURN BAY IS TO REMAIN OPEN. UNDER THIS CONDITION, "RIGHT TURN LANE" R3-I100R 24 x 24 (600 x 600) AND M6-2R 21 \times 15 (530 \times 380) SHALL BE USED.
- 6. THESE CONTROLS SHALL SUPPLEMENT MAINLINE TRAFFIC CONTROL FOR LANE CLOSURES.
- 7. THE SIGNS SHALL BE MOUNTED ABOVE THE BARRICADES/DRUMS ON SEPARATE SIGN SUPPORTS THAT MEET NCHRP 350 OR MASH PREQUIREMENTS.
- 8. TRAFFIC CONTROL AND PROTECTION AT TURN BAYS (TO REMAIN OPEN TO TRAFFIC) SHALL BE INCLUDED IN THE COST OF SPECIFIED TRAFFIC CONTROL STANDARDS OR ITEMS.

TURN BAY ENTRANCE WITHIN A LANE CLOSURE

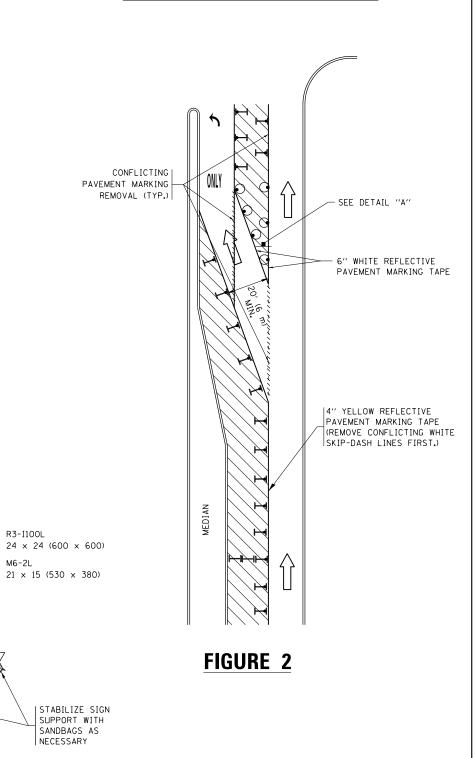


DETAIL A

TURN


All dimensions are in inches (millimeters) unless otherwise shown.

FILE NAME =	USER NAME = paraynoal	REVISED -	T. RAMMACHER 09-08-9		- R. BORO 09-14-09		TRAF	FIC CONTI	ROL AND	PROTE	CTION AT TUI	RN BAYS	RTE.	SECTION	COUNTY	SHEET	TS NO.
pw:\\IL084EBIDINTEG.:ll:no:s.gov:PWIDOT\Do	cuments\IDOT Offices\District 1\Projects\D143	61REC/ASCED:a\De											1349	(3197A&B) RS-1	соок	70	66
	PLOT SCALE = 100.0000 '/ in.	REVISED -	A. HOUSEH 10-12-96	REVISED	- A. SCHUETZE 09-15-16	DEPARTMENT OF TRANSPORTATION	(TO REMAIN OPEN TO TRAFFIC)				TC-14	CONTRACT	T NO.	62D18			
Default	PLOT DATE = 2/1/2018	REVISED -	T. RAMMACHER 01-06-0	O REVISED	-		SCALE: NONE	SHEET 1	OF 1	SHEETS	STA.	TO STA.		ILLINOIS FED.	AID PROJECT		

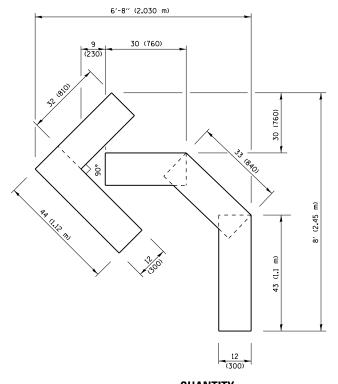


QUANTITY

4 (100) LINE = 45.5 ft. (13.9 m) 15.2 sq. ft. (1.41 sq. m)

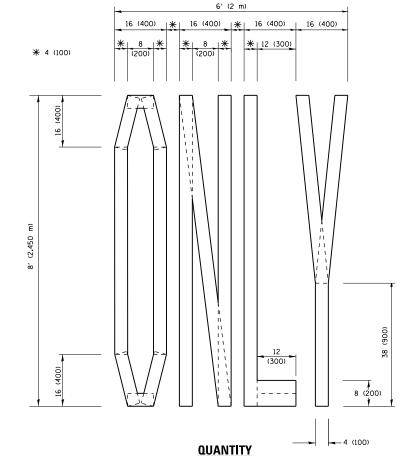

4 (100) LINE = 64.1 ft. (19.5 m) 21.4 sq. ft. (1.99 sq. m)

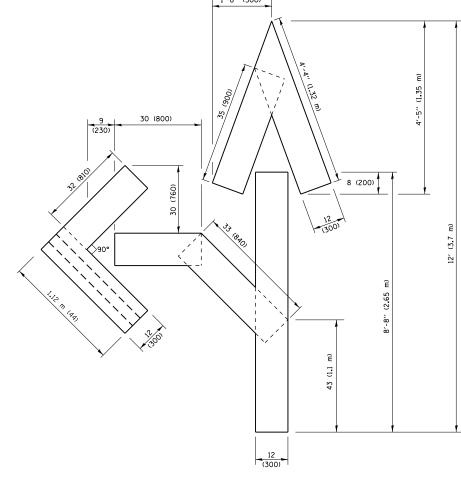


QUANTITY

4 (100) LINE = 82.5 ft. (25.1 m) 27.5 sq. ft. (2.53 sq. m)

NOTE:

ALL QUANTITIES OF PLACEMENT ARE REPRESENTED IN LINEAR FEET OF 4" LINES TO MATCH THE 4" TEMPORARY TAPE PAY ITEM AND REPRESENTS THE TOTAL QUANTITY OF 4" TAPE REQUIRED.

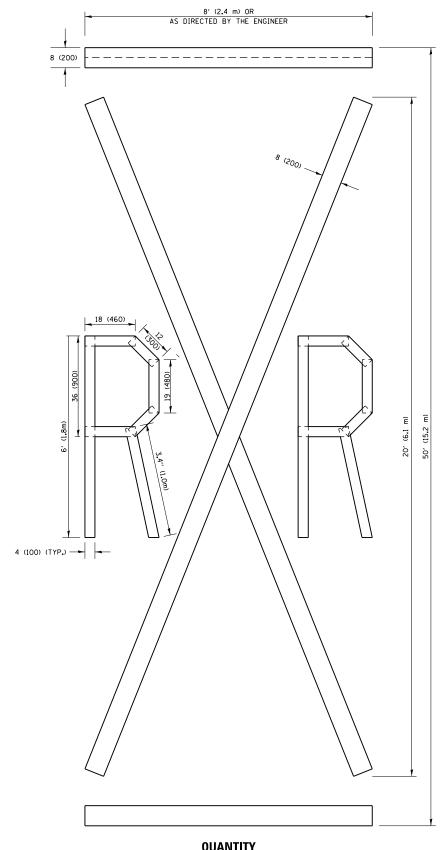


QUANTITY

4 (100) LINE = 225.9 ft. (68.9 m) 75.3 sq. ft. (6.99 sq. m)

> All dimensions are in inches (millimeters) unless otherwise shown.

FILE NAME =	USER NAME = paraynoal	DESIGNED -	REVISED	-T. RAMMACHER 03-02-98
pw:\\IL084EBIDINTEG.:1ll:no:s.gov:PWIDOT\Do	cuments\IDOT Offices\District 1\Projects\D143	61 BR(AWIN ata\Design\Diststd.dgn	REVISED	-E. GOMEZ 08-28-00
	PLOT SCALE = 100.0000 '/ in.	CHECKED -	REVISED	-E. GOMEZ 08-28-00
	PLOT DATE = 2/1/2018	DATE - 09-18-94	REVISED	- A. SCHUETZE 09-15-16

							F.A.U. RTE.	SECTION	COUNTY	TOTAL SHEETS	SHEET NO.
SHORT TERM PAVEMENT MARKING LETTERS AND SYMBOLS					1349	(3197A&B) RS-1	соок	70	67		
								TC-16	CONTRACT	NO.	62D18
SCALE: NONE	SHEET I	NO. 1 (OF 1	SHEETS	STA.	TO STA.	FED. R	DAD DIST. NO. 1 THE INDIS FED. A	ID PROJECT		

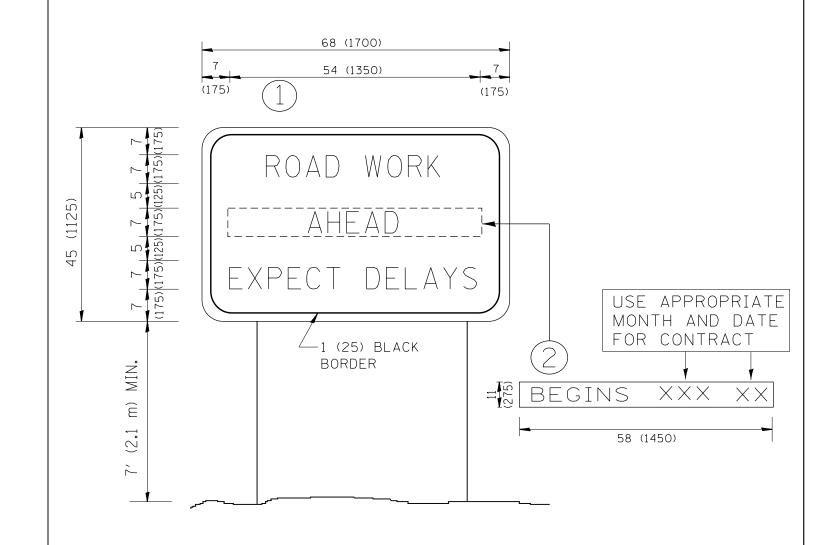

NOTES:

- 1. USE BLACK LETTERING ON ORANGE BACKGROUND.
- 2. ERECT SIGNS IN ADVANCE OF THE LOCATION FOR THE "ROAD CONSTRUCTION AHEAD" SIGN AT LOCATIONS AS DIRECTED BY THE ENGINEER.
- 3. ERECT SIGN (1) WITH INSTALLED PANEL (2) ONE WEEK PRIOR TO THE START OF CONSTRUCTION.
- 4. REMOVE PANEL (2) SOON AFTER THE START OF CONSTRUCTION.
- 5. SEE SPECIAL PROVISION FOR "TEMPORARY INFORMATION SIGNING" FOR ADDITIONAL INFORMATION.
- 6. ONE SIGN ASSEMBLY EQUALS 25.70 SQ. FT. (2.3 SQ. M.)
- 7. SHALL BE PAID FOR AS TEMPORARY INFORMATION SIGNING.


ALL DIMENSIONS ARE IN INCHES (MILLIMETERS) UNLESS OTHERWISE SHOWN.

FILE NAME = pw:\\IL@84EBIDINTEG.:ll:nois.gov:PWIDOT\Delta	USER NAME = paraynoal cuments\IDOT Offices\District 1\Projects\D14:	DESIGNED - 361 BRCAWN ata\Design\Diststd.dgn	REVISED -	- R. MIRS 09-15-97 - R. MIRS 12-11-97	STATE OF ILLINOIS	ARTERIAL ROAD INFORMATION SIGN			F.A.U. RTE. 1349	SECTION (3197A&B) RS-1	COUNTY	TOTAL SHEETS 70	SHEET NO. 68
	PLOT SCALE = 100.0000 ' / in.	CHECKED -	REVISED -	-T. RAMMACHER 02-02-99	DEPARTMENT OF TRANSPORTATION					TC-22	CONTRACT		
	PLOT DATE = 2/1/2018	DATE -	REVISED -	- C. JUCIUS 01-31-07		SCALE: NONE	SHEET NO. 1 OF 1 SHEETS STA.	TO STA.	FED. ROA	D DIST. NO. 1 ILLINOIS FED. A			


LOOP DETECTOR NOTES

- 1. EACH PAIR OF LOOP WIRES SHALL BE PLACED IN A SEPARATE EMPTY COILABLE NONMETALLIC CONDUIT FROM THE EDGE OF PAVEMENT TO THE HANDHOLE. SPACING BETWEEN THE HOLES DRILLED IN THE PAVEMENT SHALL NOT BE LESS THAN 6" (150 mm). EMPTY COILABLE NONMETALLIC CONDUIT SHALL BE INCLUDED IN THE COST OF THE LOOP WIRE.
- 2. THE NUMBER OF LOOP TURNS SHALL BE AS RECOMMENDED BY THE AMPLIFIER MANUFACTURER. ALL ADJACENT SIDES OF THE LOOPS SHALL BE INSTALLED IN SUCH A WAY THAT THE CURRENT FLOW IS IN THE SAME DIRECTION TO REINFORCE ITS MAGNETIC FIELDS FOR SMALL VEHICLE DETECTION.
- 3. EACH LOOP LEAD-IN SHALL BE IDENTIFIED AND PERMANENTLY TAGGED IN THE HANDHOLE. EACH LEAD-IN CABLE TAG SHALL INDICATE THE LOCATION OF THE LOOP, LOOP ROTATION (CLOCKWISE/COUNTERCLOCKWISE), LOOP LEAD-IN DIRECTION (IN OR OUT), LOOP CABLE NUMBER AND LOCATION IN CABINET, AND NUMBER OF TURNS IN THE DETECTOR LOOPS IN WATER PROOF INK AS INDICATED ON THE DISTRICT 1 STANDARD TRAFFIC SIGNAL DESIGN DETAIL. THE CONTRACTOR SHALL MARK LOOP LOCATIONS ON RECORD DRAWINGS AND PRESENT TO THE ENGINEER AFTER FINAL INSPECTION. LOOPS SHALL BE MARKED BY LANE AND LOOP NUMBER. SEE DETAIL BELOW.
- 4. ALL LOOP CABLE SHALL BE FASTENED WITH PLASTIC TIE WRAP TO THE HANDHOLE HOOKS.
- 5. IN ASPHALT PAVEMENT, LOOPS SHOULD BE PLACED IN THE BINDER AND DIVEHOLES MARKED AT THE CURB WITH A SAW-CUT. THE SAW-CUT SHALL BE CUT IN ACCORDANCE WITH LOCAL AND E.P.A. DUST CONTROL REQUIREMENTS. DETECTOR LOOP(S) SHALL NOT BE INSTALLED IN WET CONDITIONS AND THE SAW-CUTS MUST BE FREE OF DEBRIS AND RESIDUE SUCH AS DUST AND WATER WHICH IS TO BE ACHIEVED BY THE USE OF COMPRESSED AIR, WIRE BRUSHING AND HEAT DRYING ACCORDING TO SEALANT MANUFACTURER REQUIREMENTS. THE DETECTOR WIRE SHALL BE HELD IN PLACE BY THE USE OF FORM WEDGES. WEDGES SHALL BE SPACED NO MORE THAN 18" (450 mm) APART.
- 6. LOOP SPLICES SHALL BE SOLDERED USING A SOLDERING IRON. BLOW TORCHES OR OTHER DEVICES WHICH OXIDIZE COPPER CABLE SHALL NOT BE ALLOWED FOR SOLDERING OPERATIONS. SEE DETAIL BELOW RIGHT.
- 7. PREFORMED DETECTOR LOOPS SHALL BE USED, AS SHOWN ON THE PLANS, WHERE NEW CONCRETE PAVEMENT IS PROPOSED. THE INSTALLATION OF PREFORMED LOOPS SHALL BE IN ACCORDANCE WITH THE DISTRICT 1 SPECIFICATIONS OR AS DIRECTED BY THE ENGINEER.

LOOP LEAD-IN CABLE TAG

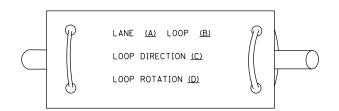



- A. LANE 1 IS THE LANE CLOSEST TO THE CENTERLINE OF THE ROADWAY
- B. LOOP *1 IS THE LOOP IN THE LANE CLOSEST TO THE INTERSECTION.
- C. LABEL LOOP CABLE "IN" OR LOOP CABLE "OUT".
- D. LABEL LOOP CABLE CLOCKWISE OR LOOP CABLE COUNTERCLOCKWISE.

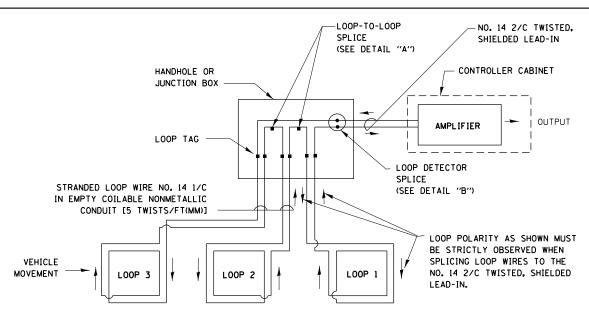

DETECTOR LOOP WIRING SCHEMATIC

- LOOPS SHALL BE SPLICED IN SERIES.
- SAW-CUTS SHALL BE A MINIMUM WIDTH OF 5/16" (8 mm).
- SAW-CUT DEPTHS SHALL BE 3" (75 mm). IF IN CONCRETE,
 THE SAW-CUT DEPTH SHALL BE TO THE TOP OF THE REINFORCEMENT.
- LOOP CORNERS SHALL BE DRILLED WITH A 2" (50 mm) DIAMETER CORE.

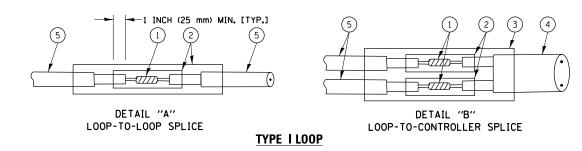

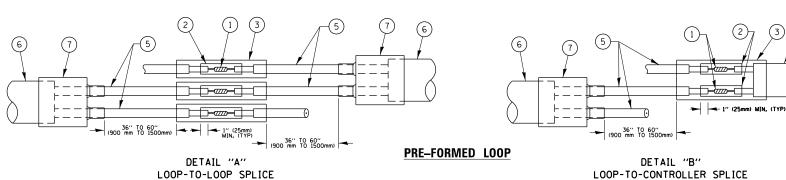

LOOP DETECTOR SPLICE

- 1 WESTERN UNION SPLICE SOLDERED WITH ROSIN CORE FLUX. ALL EXPOSED SURFACES OF THE SOLDER SHALL BE SMOOTH. THE WESTERN UNION SPLICES SHALL BE STAGGERED.
- (2) WCSMW 30/100 HEAT SHRINK TUBE, MINIMUM LENGTH 3" (75 mm), UNDERWATER GRADE.
- (3) WCS 200/750 HEAT SHRINK TUBE, MINIMUM LENGHT 6" (150 mm), UNDERWATER GRADE.
- (4) NO. 14 2/C TWISTED, SHIELDED CABLE.


- 5 LOOP CONDUCTOR WITH FLEXIBLE PLASTIC TUBE.
- 6 PRE-FORMED LOOP
- TXL POLYOLEFIN 2 CONDUCTOR
 BREAKOUT SEALS. TYCO CBR-2 OR APPROVED EQUAL
- FILE NAME : DESIGNED REVISED USER NAME = paraynoal SECTION COUNTY DISTRICT ONE w:\\ILØ84EBIDINTEG.:111:no uments\IDOT Offices\District 1\Projects\D14361**BRGANN**ata\Design\Diststd.dg REVISED STATE OF ILLINOIS 1349 (3197A&B) RS-1 COOK 70 69 STANDARD TRAFFIC SIGNAL DESIGN DETAILS CHECKED REVISED **DEPARTMENT OF TRANSPORTATION** TS-05 CONTRACT NO. 62D18 SCALE: NONE SHEET 2 OF 7 SHEETS STA. REVISED PLOT DATE = 2/1/2018 DATE

PROVIDE A PAVEMENT REPLACEMENT NOTE WHICH SHOULD EQUAL 3' (900 mm) X WIDTH OF PAVED SHOULDER. PAVED OR NON-PAVED SHOULDER PAVED OR NON-PAVED SHOULDER * = (600 mm) * * UNIT DUCT IS TO BE SHOWN ON PLAN SHEETS BUT SHALL NOT BE INCLUDED IN THE PAY ITEMS.

LEFT TURN LANES WITH MEDIANS VOLUME DENSITY ("FAR OUT" DETECTION) ON SAME APPROACH

(PROTECTED / PERMITTED LEFT TURN PHASING)

HANDHOLE LOCATION MAY
VARY DEPENDING ON GEOMETRICS
AND DESIGN OF TRAFFIC SIGNALS.
HEAVY-DUTY HANDHOLES TO BE
USED WHEN THE MEDIAN IS
MOUNTABLE. REFER TO STANDARD
REFER TO STANDARD

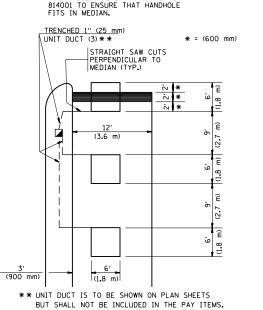


NOTE: DUAL LEFT TURNS NOT SHOWN REFER TO

PLAN SHEET FOR DETECTOR LOOP REPLACEMENT

LEFT TURN LANES WITHOUT MEDIANS VOLUME DENSITY ("FAR OUT" DETECTION) ON SAME APPROACH

(PROTECTED / PERMITTED LEFT TURN PHASING)

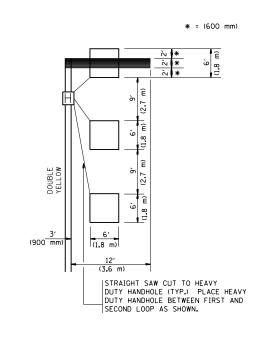



NOTE: DUAL LEFT TURNS NOT SHOWN REFER TO PLAN SHEET FOR DETECTOR LOOP REPLACEMENT

SCALE: NONE

ARTERIAL-VOLUME DENSITY ("FAR OUT" DETECTION)
CROSS STREET-VOLUME DENSITY ("FAR OUT" DETECTION)

ARTERIAL-VOLUME DENSITY ("FAR OUT" DETECTION)
CROSS STREET-NON VOLUME DENSITY ("UPTIGHT" PRESENCE DETECTION)

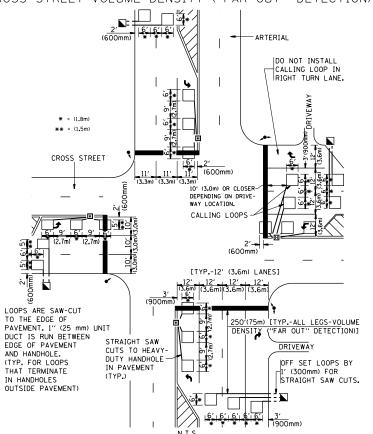

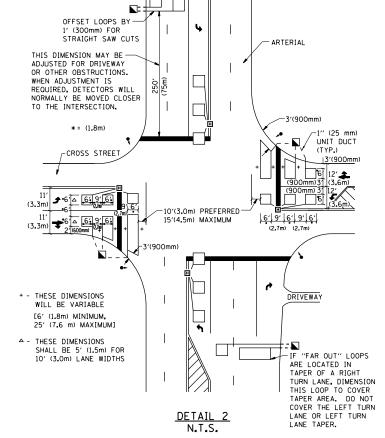

NOTES:

VEHICLES LOOP DETECTORS

- * ALL LEAD IN CABLE SHALL BE TWO CONDUCTOR NO. 14 TWISTED, SHIFLDED.
- * EACH DETECTOR LOOP SHALL HAVE ITS OWN SAW CUT FROM THE LOOP TO THE EDGE OF PAVEMENT OR TO A HANDHOLE IN THE PAVEMENT.
- * EACH DETECTOR LOOP SHALL HAVE ITS OWN ONE INCH (25 mm) UNIT DUCT BETWEEN THE EDGE OF PAVEMENT AND THE FIRST HANDHOLE OR JUNCTION BOX, EACH UNIT DUCT RUN SHALL BE SHOWN ON THE PLANS BY THE DESIGNER, BUT SHALL NOT BE PAID FOR SEPARATLY. THIS ITEM IS INCIDENTAL TO THE PAY ITEM FOR DETECTOR LOOPS.
- * ONE DIMENSION OF <u>ALL</u> DETECTOR LOOPS SHALL BE SIX FEET (1.8 m)
- * EACH LANE OF NON-LOCKING, PRESENCE DETECTION AND EACH LANE OF A DOUBLE LEFT TURN LANE REQUIRES A SEPARATE INDUCTIVE LOOP DETECTOR AND LEAD IN CABLE.
- * WHEN NON-LOCKING, PRESENCE DETECTION IS USED, MORE THAN ONE LOOP PER LANE IS REQUIRED BEHIND THE STOP BAR (i.e. 1-1/2, 1-3/4, 2).
- * WHEN SYSTEM LOOPS ARE REQUIRED ON AN APPROACH OF AN INTERSECTION, THE LOOPS USED FOR VOLUME DENSITY AND INTERSECTION TIMING SHALL ALSO BE USED AS SYSTEM DETECTORS. EACH ONE OF THESE TYPE OF LOOPS REQUIRES A SEPARATE TWO CONDUCTOR NO. 14 TWISTED SHIELDED CABLE AND A SEPARATE INDUCTIVE LOOP DETECTOR WHEN NEW CONTROLLERS ARE UTILIZED. THE DESIGNER SHALL LABEL THESE TYPES OF LOOPS AS "INTERSECTION AND SAMPLING (SYSTEM) DETECTORS" ON THE SIGNAL LAYOUT, THE INTERCONNECT PLAN AND THE SYSTEM CABLE PLAN. WHEN AN EXISTING CONTROLLER IS UTILIZED FOR THIS TYPE OF DETECTION, THE PAY ITEM "INDUCTIVE LOOP DETECTOR WITH SYSTEM OUTPUT" SHOULD BE USED.

PLACEMENT OF DETECTORS

THE FOLLOWING FIGURES REPRESENT THE MOST COMMON DETECTOR LOOP LOCATIONS AND SIZES. ADJUSTMENTS WILL BE NECESSARY FOR SPECIFIC GEOMETRIC CONSIDERATIONS.

LOCATIONS AND DEMENSIONS OF DETECTOR LOOPS ARE REQUIRED ON ALL SIGNAL LAYOUT PLAN SHEETS.

"FAR OUT" DETECTION REFERS TO LOCKING, PRESENCE TYPE DETECTION LOCATED IN THRU LANES, RIGHT TURN LANES, AND RIGHT TURN LANE TAPER AREAS (IF APPLICABLE), USUALLY 250' (75 m) IN ADVANCE OF STOP BARS. "UPTIGHT" DETECTION REFERS TO NON-LOCKING PRESENCE TYPE DETECTION LOCATED IN ALL LANES AND 10'-15' (3.0 m-4.5 m) BEHIND THE CROSSING STREET'S EDGE OF PAVEMENT EXTENDED.

JOTE.

ALL DETAILS AND NOTES SHOWN ARE FROM THE I.D.O.T. DISTRICT 1 TRAFFIC SIGNAL DESIGN GUIDELINES DATED JANUARY 1995

THIS DRAWING HAS BEEN PREPARED TO ASSIST THE RESIDENT ENGINEER FOR ALL ROADWAY RESURFACING OR S.M.A.R.T. PROJECTS WHERE THE DIMENSIONS ARE NOT SHOWN ON THE PLANS AND THE FINAL LOCATIONS FOR CROSSWALKS OR STOP BARS ARE NOT DETERMINED.

N.T.S.										
FILE NAME =	USER NAME = paraynoal	DESIGNED -	REVISED -							
pw:\\ILØ84EBIDINTEG.:ll:nois.gov:PWIDOT\Do	cuments\IDOT Offices\District 1\Projects\D143	61 BR(AWIN ata\Design\Diststd.dgn	REVISED -							
	PLOT SCALE = 100.0000 ' / in.	CHECKED - R.K.F.	REVISED -							
	PLOT DATE = 2/1/2018	DATE -	REVISED -							

DETAIL

DISTRICT 1 - DETECTOR	LOOP INST	F.A.U. RTE.	SECTION	COUNTY	TOTAL SHEETS	SHEET NO.	
DETAILS FOR ROAI	WAY DECIID	1349	(3197A&B) RS-1	соок	70	70	
 DETAILS FOR HOAD	WAT RESUR	ACING		TS-07	CONTRACT	NO.	62D18
SHEET NO. 1 OF 1 SHEET	S STA.	TO STA.	FED RO	DAD DIST NO 1 THE INDIS FED AT	D PROJECT		