


COUNTY TOTAL SHEETS NO. SECTION 764 115 COOK 94 STA. 88+60 (SB I-57) 1126+91 (SB FORD)TO STA. 1313+00 (SB RYAN 42" SS PIPE INV EL. -22.5± (SOLDIER PILE LAYOUT MAY BE ADJUSTED AS NEEDED, MAX PILE SPACING 8'-0") FED. ROAD DIST. NO. ILLINOIS FED. AID PROJECT • (1516.1, 1717, & 1818) R-5 CTA BARRIER WALL FACING (SEE CTA-BARRIER WALL MODIFICATION DETAILS PROPOSED & SB I-94-SB I-94 (DAN RYAN EXPWY) 1307+00 1310+00 1311+00 1312+00 W. 79†h STREETE (OVER EXPRESSWAY) CTA RED LINE LIMITS OF LIMITS OF LIMITS OF TEMP. LIMITS OF TEMP. SOIL RETENTION SYSTEM TEMP. SOIL RETENTION SYSTEM TEMP. SOIL RETENTION SYSTEM SOIL RETENTION SYSTEM CTA BARRIER WALL PLAN - 79th STREET STATION

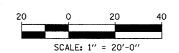

62593

NOTES:

- 1. THE LIMITS SHOWN FOR THE TEMPORARY SOIL RETENTION SYSTEM FOR DRAINAGE IMPROVEMENTS IS APPROXIMATE. THE ACTUAL LIMITS SHALL BE AS DESIGNED BY THE CONTRACTOR AND APPROVED BY THE ENGINEER & THE CTA.
- THE AREA OF THE TEMPORARY SOIL RETENTION SYSTEM FOR THE PROPOSED DRAINAGE STRUCTURE(S) IS AS INDICATED ON THE SCHEDULE GIVEN ON SHEET 151.
- 3. THE PROPOSED SOLDIER PILE WALL & DETAILS INDICATED ON THIS SHEET & SHEETS B1-B3 ARE DESIGNED TO RETAIN THE CTA BALLAST DURING EXCAVATION FOR THE PROPOSED PAVEMENT SECTION ONLY.
- 4. WORK THIS SHEET WITH SHEETS B1 TO B3.
- 5. EXISTING SUB-PIER LOCATIONS ARE TAKEN FROM EXISTING PLANS, SEE SHEETS 124-129.

LEGEND:

- EXISTING SUB-PIER
- o PROPOSED SOLDIER PILE
- PROPOSED CATCH BASIN

REVISIONS NAME DATE		F.A CTA	LINOIS D .I. 94 STATIO	(DAN N BARF	RYA RIER V	N EXF	RESS ODIFI	SWAY) Cation	S
		79 SCALE:	TH, 871 LOCA			STREET 79TH S DRAWN B	TREET		
		DATE:	MARCH 1,	2006		CHECKED	BY:	SP	


CTA BARRIER WALL LOCATION AND MODIFICATION TABLE

STATION	LOCATION	
STATION	STATIONS	MODIFICATION
79th ST.	STA. 1306+80 TO 1312+08	REFACING
87th ST.	STA. 1253+09 TO 1258+27	REFACING
95th ST.	SB I-57 STA 157+60 TO 1213+13	REFACING

STATIONS ARE RELATIVE TO SB & I-94 UNLESS NOTED


DESIGN STRESSES:

FIELD UNITS f'c = 3,500 PSI fy = 60,000 PSI (REINF.)

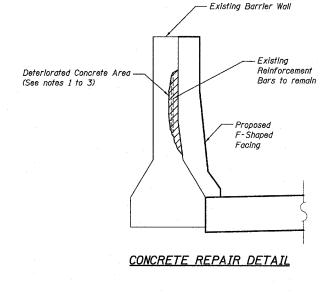


NOTES ON CONCRETE REPAIR DETAIL

- 1. REMOVE DETERIORATED CONCRETE TO SOUND CONCRETE IN ACCORDANCE WITH SECTION 501.03 OF THE STANDARD SPECIFICATIONS. UNDERCUT EXPOSED REINFORCEMENT BARS BY 3/" TO PROVIDE CLEARANCE BETWEEN EXISTING REINFORCEMENT BARS AND THE REMAINING CONCRETE.
- 2. EXPOSED EXISTING REINFORCEMENT BARS SHALL REMAIN IN PLACE AND BE BLAST CLEANED TO GRAY METAL. REINFORCEMENT BARS THAT HAVE BEEN CUT OR HAVE LOST 25% OR MORE OF THEIR ORIGINAL CROSS SECTIONAL AREA SHALL BE SUPPLEMENTED BY NEW EPOXY COATED REINFORCEMENT BARS.
- THE COST OF REMOVING DETERIORATED CONCRETE AND SUPPLEMENTING AND CLEANING EXISTING REINFORCEMENT BARS SHALL BE INCLUDED IN THE COST PER CUBIC YARD OF "CONCRETE STRUCTURES".

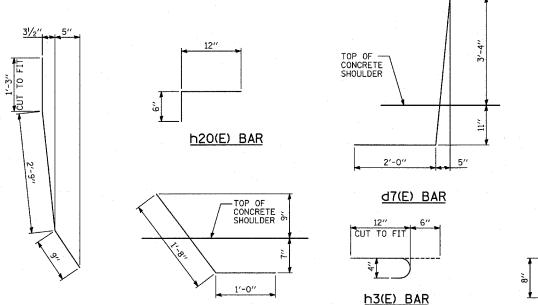

d4(E) BAR

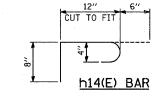

TYLININTERNATIONAL

d3(E) BAR


62593

* (1516.1, 1717, & 1818) R-5

GENERAL NOTES:

IN LOCATIONS WHERE THE MAIN SEWERS, DRAINAGE STRUCTURES, PUBLIC AND PRIVATE DRAIN CONNECTIONS ARE DISTURBED OR DAMAGED DURING CONSTRUCTION BY THE CONTRACTOR, IT WILL BE THE CONTRACTOR'S RESPONSIBILITY TO RESTORE AND REPLACE THE DAMAGED FACILITIES AT HIS/HER OWN EXPENSE TO THE SATISFACTION OF THE DEPARTMENT OF WATER MANAGEMENT. THE SEWER FLOWS MUST BE MAINTAINED AT ALL TIMES.

- 2. IN LOCATIONS WHERE PILINGS/DRILLED SHAFTS ARE BEING PROPOSED IN THE VICINITY OF THE EXISTING SEWER FACILITIES, THE CONTRACTOR MUST PROVIDE A PLAN OF CONSTRUCTION METHODS WITH CALCULATIONS SEALED BY A STRUCTURAL ENGINEER LICENSED BY THE STATE OF ILLINOIS PROVING NO DAMAGE OR HARM TO THE STRUCTURAL INTEGRITY OF THE CITY'S SEWER SYSTEM. THE PLAN MUST BE APPROVED BY THE RESIDENT ENGINEER AND THE CHICAGO DEPARTMENT OF WATER MANAGEMENT PRIOR TO CONSTRUCTION.
- 3. IT SHALL BE THE CONTRACTOR'S RESPONSIBILITY TO ENSURE THAT NO GAP REMAINS BETWEEN PROPOSED CTA FENCING OR WHERE PROPOSED CTA FENCING TERMINATES AND EXISTING CTA FENCE REMAINS IN PLACE.
- 4. PLAN DIMENSIONS AND DETAILS RELATING TO EXISTING STRUCTURES HAVE BEEN TAKEN FROM EXISTING PLANS AND ARE SUBJECT TO NOMINAL CONSTRUCTION VARIATIONS. IT SHALL BE THE CONTRACTOR'S RESPONSIBILITY TO VERIFY SUCH DIMENSIONS AND DETAILS IN THE FIELD AND MAKE NECESSARY APPROVED ADJUSTMENTS PRIOR TO CONSTRUCTION OR ORDERING MATERIALS. SUCH VARIATIONS SHALL NOT BE CAUSE FOR ADDITIONAL COMPENSATION OR A CHANGE IN THE SCOPE OF WORK. THE CONTRACTOR WILL BE PAID FOR THE QUANTITY ACTUALLY FURNISHED AT THE UNIT PRICE FOR THE WORK.
- 5. ALL CONSTRUCTION JOINTS SHALL BE BONDED.
- 6. ALL EXPOSED CONCRETE EDGES SHALL HAVE A 3/4" BY 45° CHAMFER EXCEPT WHERE SHOWN OTHERWISE. CHAMFER ON VERTICAL EDGES SHALL BE CONTINUED A MINIMUM OF 1 FOOT BELOW THE FINISHED GROUND LINE.
- 7. A PROTECTIVE COAT SHALL BE APPLIED WITHIN THE LIMITS SHOWN ON THE PLANS ACCORDING TO SECTION 503.19 OF THE STANDARD SPECIFICATIONS.
- REINFORCEMENT BARS SHALL CONFORM TO THE REQUIREMENTS OF AASHTO M31 OR M322 GRADE 60.
- 9. REINFORCEMENT BARS DESIGNATED "(E)" SHALL BE EPOXY COATED.
- . THE CONTRACTOR IS RESPONSIBLE FOR THE DESIGN AND PERFORMANCE OF THE LAGGING USING NO LESS THAN 3" NOMINAL ROUGH-SAWN THICKNESS AND THE MINIMUM TABULATED UNIT STRESS IN BENDING (fb), USED IN THE DESIGN OF THE TIMBER LAGGING SHALL BE 1000 psi.
- 11. HAMMER DRIVING OF PILES WILL NOT BE ALLOWED.

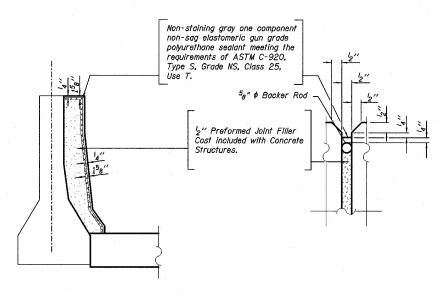

BARRIER JOINT DETAILS

(AT EXISTING BARRIER JOINT LOCATIONS)


REVISIONS

SHEET BI OF 8

CHECKED BY: PF

NAME	DATE	ILLINOIS DE	PARIMENI U	- IKANSPURI	ATION
		F.A.I. 94 (DAN RYAI	N EXPRES	SWAY)
		CTA STATION	BARRIER W	ALL MODIF	ICATIONS
, , , , , , , , , , , , , , , , , , , ,		LOCATION	AND MODIF	ICATION T	ABLE,
		GENERAL	NOTES AND	BAR DETA	AILS
*** ** ********		SCALE: NONE		DRAWN BY:	MPG, SP

DATE: MARCH 1, 2006

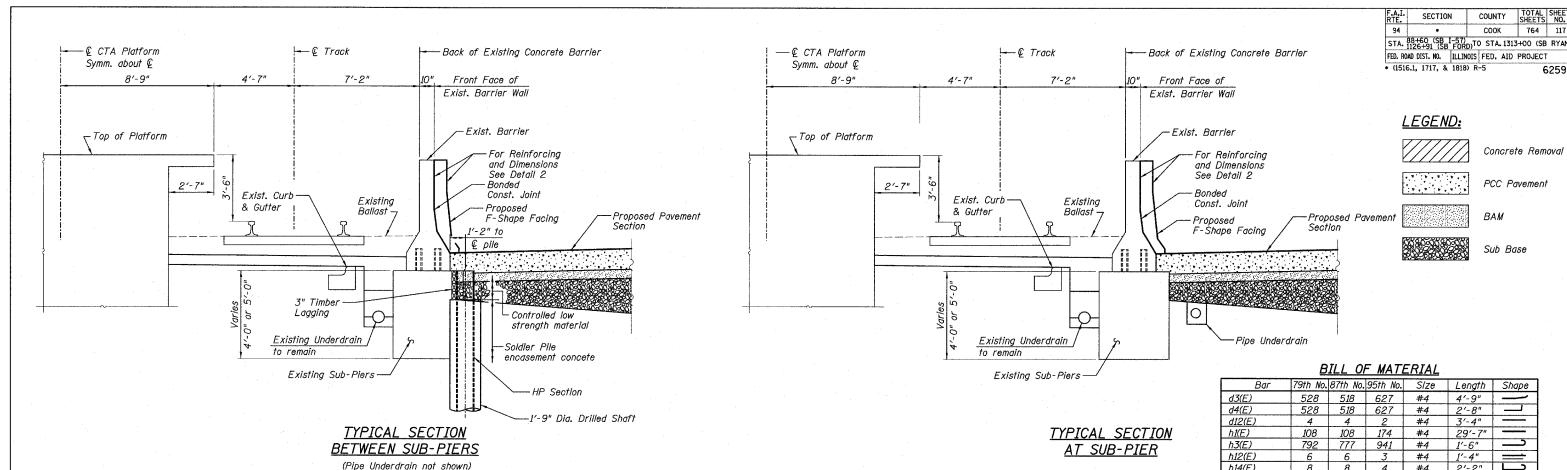

Contractor to cut and dispose of soldier pile tops as required for paving and as directed by the Engineer. Cost to be included in "Furnishing Soldier Piles (HP Section)".

Exist barrier - Refacing not shown for clarity

2'-0"

Limits of Structure

Excavation

2" \$\phi\$ lifting hole

Soldier Pile encasement concete

MISCELLANEOUS DETAILS

10" 8⁵8", -Drill and Epoxy Grout h3(E) Bars @ 2'-0" Horiz. cts. (5" Min. Embedment) #5 @ 12" - Bonded Const. Joint (Typ.) 5'-10"± #4 d3(E) Bar @ 12" cts. #4 d4(E) Bars @ 12" cts. 1'-2" 1'-4" Shoulder Pay Limit DETAIL 2

	DILL OF MATERIAL						
	Bar	79th No.	87th No.	95th No.	Slze	Length	Shape
	d3(E)	528	518	627	#4	4'-9"	1
	d4(E)	528	518	627	#4	2'-8"	
	d12(E)	4	4	2	#4	3'-4"	
	hI(E)	108	108	174	#4	29'-7"	
	h3(E)	792	777	941	#4	1'-6"	L
	h12(E)	6	6	3	#4	1'-4"	
	h14(E)	8	8	4	#4	2'-2"	
	Ite	m		Unit	79th Qty	87th Qty	95th Qty
	Furnishing Soldi	er Piles		Foot	1056	1068	1332
	(HP Section)					*	
	Drilling and Sett	ting		Cu. Ft.	2753	2759	<i>351</i> 6
	Soldier Piles (in Soil)						
	Untreated Timber Lagging			Sq. Ft.	778	872	1111
	Reinforcement Bars,						
	Epoxy Coated			Pound	5570	<i>5510</i>	7510
*	Concrete Structures			Cu. Yd.	63	64	78
	Protective Coat	Sq. Yd.	370	374	<i>4</i> 53		
	Structure Excav	ration		Cu. Yd.	97	100	139

* Coarse Aggregate shall meet the requirements of Article 1004.01-1004.02 of the Standard Specifications except the gradation will be limited to CA-11 or CA-14.

<u>NOTES:</u>

- Drilling and grouting of #4 h3(E) bars shall be in accordance with Section 584 of the Standard Specifications.
- 2. #4 d4(E) bars shall be seated in their final position prior to the placement of the concrete shoulder. Bars shall not be mucked into place.
- 3. The cost of drilling holes, furnishing and placing Epoxy Grout and setting #4 h3(E) bars shall be included in the cost for Concrete Structures.
- 4. Provide joints in facing to match those in the existing barrier, see Sht B1 for details.
- 5. h1(E) bars shall be cut as needed for fit.
- 6. See Sht. B1 for bar detailing.


SHEET B2 OF 8

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NAME	DATE	ILLING	DECARIM	ENT OF TRA	INSPURIATION
		F.A.I.	94 (DAN	RYAN EX	(PRESSWAY)
		CTA STA	TION BARR	IER WALL	MODIFICATIONS
	ļ	79TH, 8	B7TH AND	95TH STRE	ET STATIONS
		, T	YPICAL SEC	CTIONS &	DETAILS
	-				
 	+	SCALE: NON	E.	DRAWN	BY: MPG, SP

DATE: MARCH 1, 2006



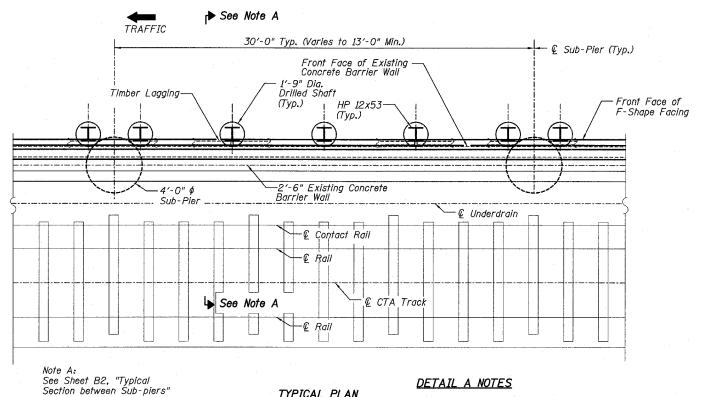


TYPICAL PLAN

DETAIL A NOTES

Soldier Piles are to be HP 12x53, 12' Long (288 required.) Fy min = 36,000 psi (M270 Grade 36)

Pile locations can be adjusted to miss proposed drainage structures. Maximum pile spacing 8'-0".


COUNTY TOTAL SHEET NO. SECTION COOK 764 118 STA. 88+60 (SB I-57) TO STA. 1126+91 (SB FORD)TO STA. 1313+00 (SB RYAN FED. ROAD DIST. NO. ILLINOIS FED. AID PROJECT * (1516.1, 1717, & 1818) R-5 62593

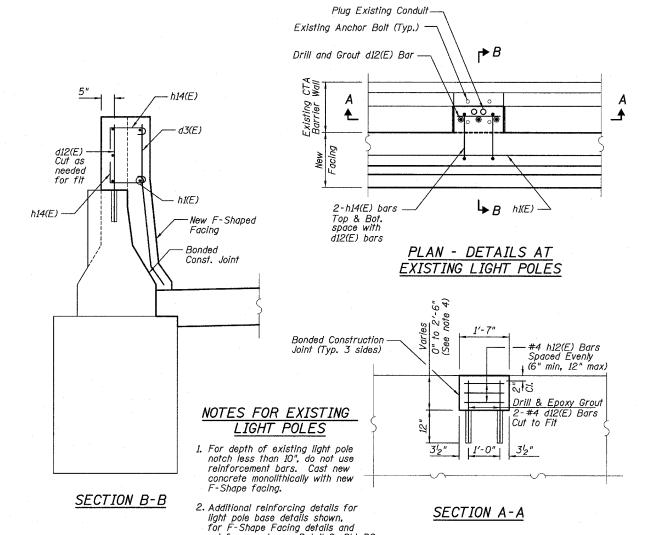


reinforcement, see Detail 2, Sht B2.

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REVISIONS		TLLTN	IOIS DEPART	WENT OF T	BYNZBUB.	TATION
NAME	DATE					
		F.A.I.	94 (DAN	RYAN	EXPRES	SSWAY)
		CTA ST	ATION BAR	RIER WAL	L MODIF	ICATIONS
		79TH.	87TH AND	95TH ST	REET ST	TATIONS
		·	TYPICAL	PLAN/SE	CTIONS	
		SCALE: NO	NE	DRA	WN BY:	SP
		DATE: MA	RCH 1, 2006	CHE	CKED BY:	PDF



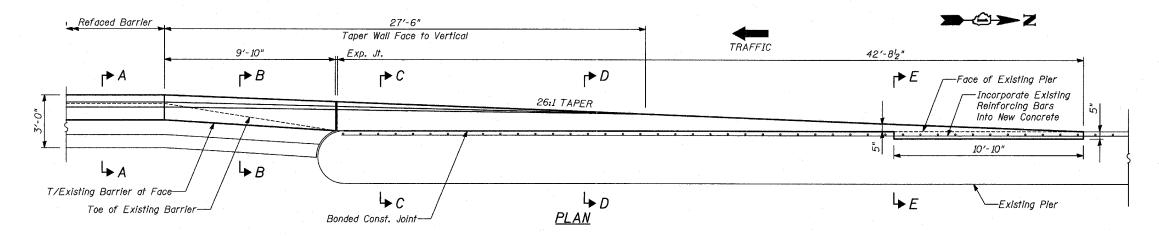

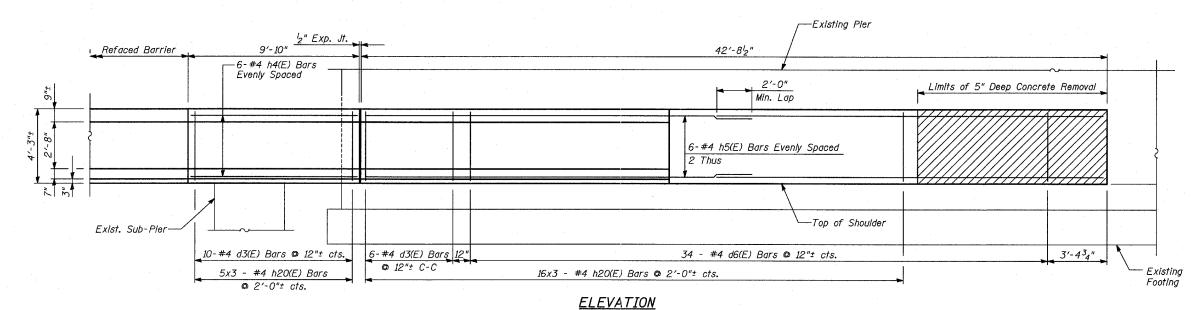



NOTES:

- Drilling and grouting of #4 h2O(E) bars shall be in accordance with Section 584 of the Standard Specifications.
- 2. The cost of drilling holes, furnishing and placing Epoxy Grout and setting #4 h20(E) bars shall be included in the cost for Concrete Structures.
- Provide joints in facing to match those in the existing barrier. See Sht B1 for joint details.
- 4. For Refaced Barrier details, see Sheet B2.
- 5. For Sections A-A thru H-H see Sheet B7.
- 6. For locations of Transition, see Roadway Plans.

RILL OF MATERIAL

	<u>011</u>	L UF	MAIL	<u> </u>	
	Bar	No.	Size	Length	Shape
	d3(E)	16	#4	4'-9"	
	d6(E)	34	#4	3′-11"	
	h4(E)	6	#4	9'-6"	
	h5(E)	12	#4	22'-1"	
	h20(E)	63	#4	1'-6"	
-	Item	Unit	Quantity		
	Reinforcement Ba	rs,			
	Epoxy Coated		Pound	420	
*	Concrete Structur	Cu. Yd.	8		
	Protective Coat	Sq. Yd.	31		
	Concrete Removal		Cu. Yd.	1	

The pay items for the soldier pile wall are included in the quantities on Sheet B2.


* Coarse Aggregate shall meet the requirements of Article 1004.01-1004.02 of the Standard Specifications except the gradation will be limited to CA-11 or CA-14.

SHEET B4 OF 8

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			311	EET D4 OF 0
REVISIO	NS	THE THOTS DEPART	TMENT OF TRANSPORT	TATION
NAME	DATE	ILLINOIS DEFAR	IMENT OF TRANSPORT	ATION
		F.A.I. 94 (DA	N RYAN EXPRES	SSWAY)
		CTA STATION BAR	RRIER WALL MODIF	ICATIONS
		79TH :	STREET STATION	
		REFACED BARRI	IER TO PIER TRAN	SITION
		DETAILS: F	PLAN AND ELEVATI	ON
		SCALE: NONE	DRAWN BY:	MPG

DATE: MARCH 1, 2006

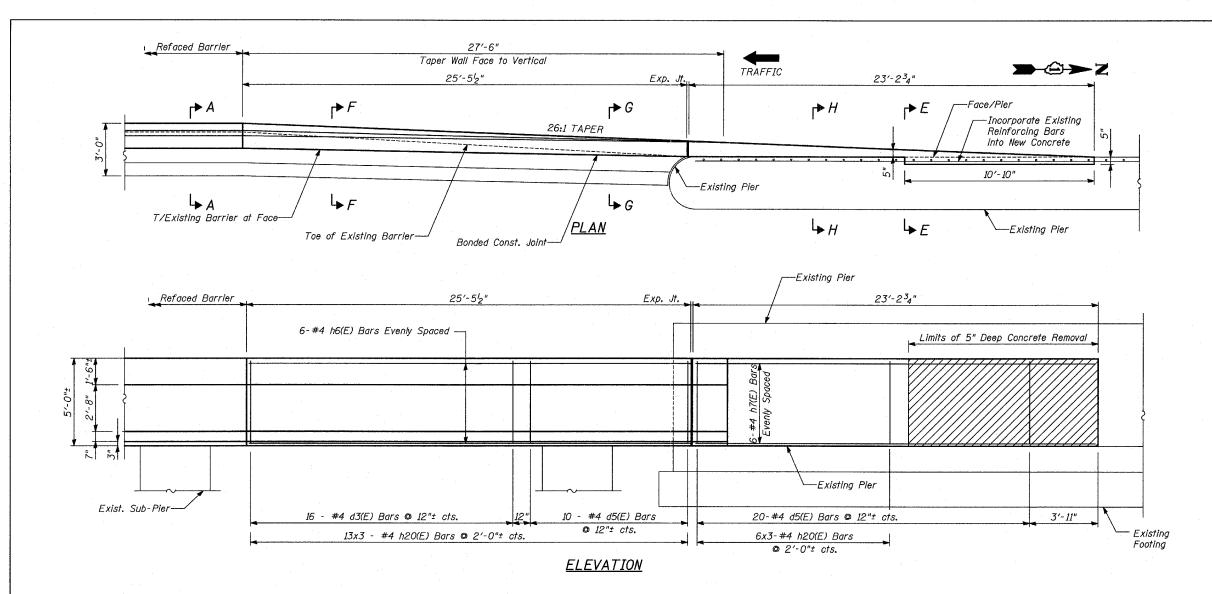

LEGEND:

Concrete Removal

NOTES:

- 1. Drilling and grouting of #4 h20(E) bars shall be in accordance with Section 584 of the Standard Specifications.
- 2. The cost of drilling holes, furnishing and placing Epoxy Grout and setting #4 h20(E) bars shall be included in the cost for Concrete Structures.
- 3. Provide joints in facing to match those in the existing barrier. See Sht B1 for joint details.
- 4. For Refaced Barrier details, see Sheet B2.
- 5. For Sections A-A thru H-H see Sheet B7.
- 6. For locations of Transition, see Roadway Plans.

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COUNTY COOK

764 120

SECTION

BILL OF MATERIAL

		mrsi	-010-	
Bar	No.	Size	Length	Shape
d3(E)	16	#4	4'-9"	
d5(E)	30	#4	4'-8"	
h6(E)	6	#4	25'-0"	
h7(E)	6	#4	22'-8"	
h20(E)	<i>57</i>	#4	1'-6"	
Item			Unit	Quantity
Reinforcement Ba	rs,			
Epoxy Coated			Pound	400
Concrete Structur	95		Cu. Yd.	6
Protective Coat			Sq. Yd.	32
Concrete Removal	Cu. Yd.	1		

The pay items for the soldier pile wall are included in the quantities on Sheet B2.


* Coarse Aggregate shall meet the requirements of Article 1004.01-1004.02 of the Standard Specifications except the gradation will be limited to CA-11 or CA-14.

SHEET B5 OF 8

CHECKED BY: SP

REVISIONS		ILLINOIS DEPARTMENT OF TRANSPORTATION				
NAME	DATE					
		F.A.I. 94 (DA	N RYAN EXPRESSWAY)			
			RRIER WALL MODIFICATIONS			
		87TH STREET STATION				
		REFACED BARR	ER TO PIER TRANSITION			
		DETAILS.	PLAN AND ELEVATION			
		DETAILS! P	LAN AND ELEVATION			
		SCALE: NONE	DRAWN BY: MPG			

DATE: MARCH 1, 2006

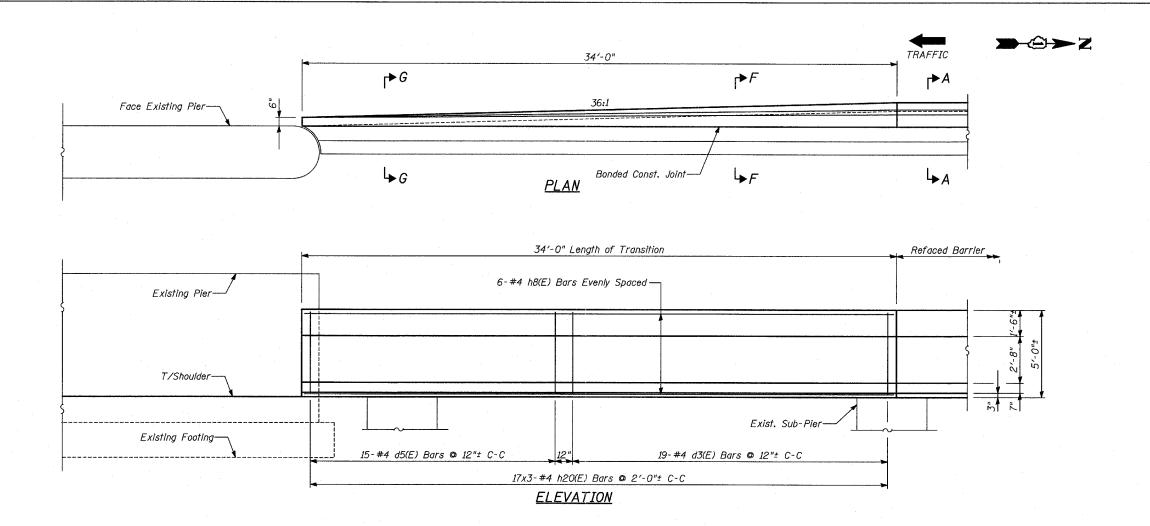

NOTES:

- Drilling and grouting of #4 h20(E) bars shall be in accordance with Section 584 of the Standard Specifications.
- 2. The cost of drilling holes, furnishing and placing Epoxy Grout and setting #4 h2O(E) bars shall be included in the cost for Concrete Structures.
- 3. Provide joints in facing to match those in the existing barrier. See Sht B1 for joint details.
- 4. For Refaced Barrier details, see Sheet B2.
- 5. For Sections A-A thru H-H see sheet B7.
- 6. For locations of Transition, see Roadway Plans.

RILL	OF	MATERIAL

011	<u>_L U/</u>	<u> IMAII</u>	-MAL	
Bar	No.	Size	Length	Shape
h8(E)	6	#4	33'-8"	
h20(E)	51	#4	1'-6"	
d3(E)	19	#4	4'-9"	
d5(E)	15	#4	4'-8"	
Item			Unit	Quantity
Reinforcement Ba	rs,			
Epoxy Coated			Pound	300
Concrete Structures			Cu. Yd.	4
Protective Coat			Sq. Yd.	24

The pay items for the soldier pile wall are included in the quantities on Sheet B2.

* Coarse Aggregate shall meet the requirements of Article 1004.01-1004.02 of the Standard Specifications except the gradation will be limited to CA-11 or CA-14. SHEET B6 OF 8

IL		REVISION
16	DATE	NAME
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CTA		
CIA		
RE		
NE.		
SCALF:		

ILLINOIS DEPARTMENT OF TRANSPORTATION
F.A.I. 94 (DAN RYAN EXPRESSWAY)
TA STATION BARRIER WALL MODIFICATIONS
95TH STREET STATION
REFACED BARRIER TO PIER TRANSITION

DETAILS: PLAN AND ELEVATION

SCALE: NONE
DATE: MARCH 1, 2006

DRAWN BY: MPG CHECKED BY: SP

COUNTY TOTAL SHEET NO.

COOK 764 121


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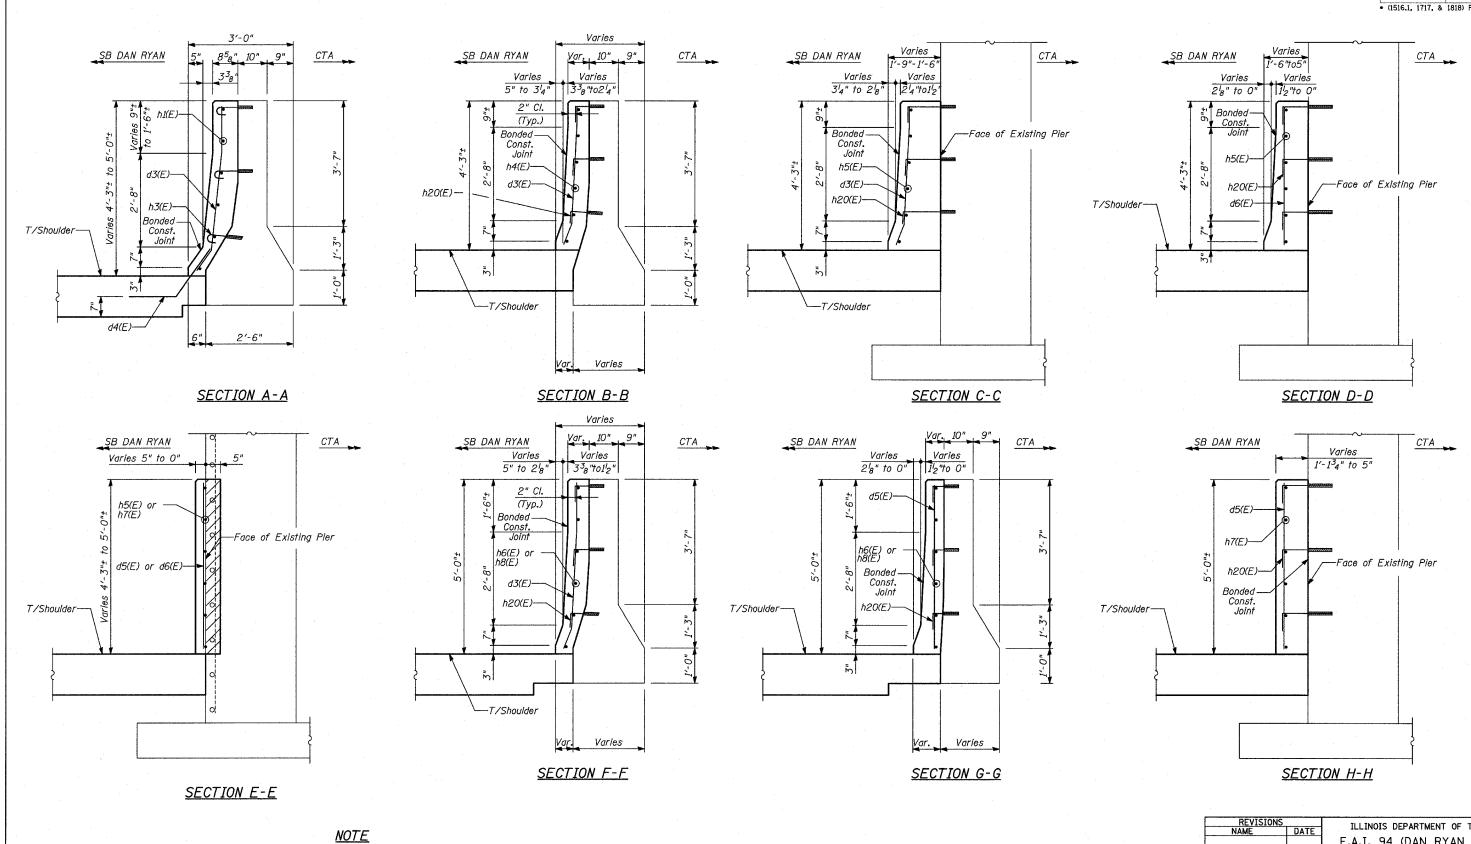
SECTION

* (1516.1, 1717, & 1818) R-5

STA. 88+60 (SB T-57) TO STA. 1313+00 (SB RYAN

FED. ROAD DIST. NO. ILLINOIS FED. AID PROJECT



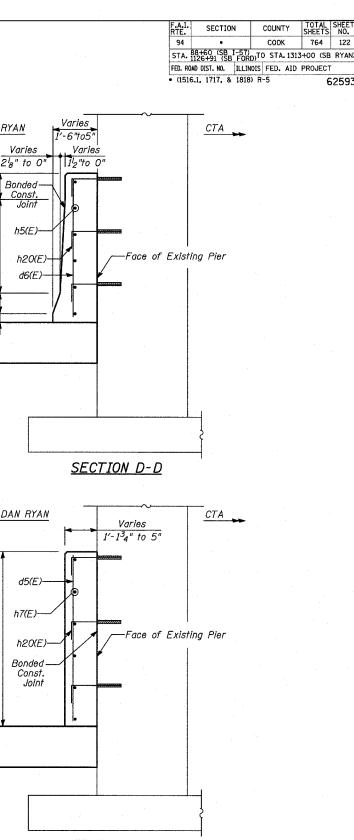

Drill and Epoxy Grout h3(E) and h20(E) Bars


(5" Min. Embedment)


ILLINOIS DEPARTMENT OF TRANSPORTATION F.A.I. 94 (DAN RYAN EXPRESSWAY) CTA STATION BARRIER WALL MODIFICATIONS 79TH, 87TH AND 95TH STREET STATIONS REFACED BARRIER TO PIER TRANSITION **DETAILS: TYPICAL SECTIONS**

SCALE: NONE DATE: MARCH 1, 2006 DRAWN BY: MPG

SHEET B7 OF 8

764 122

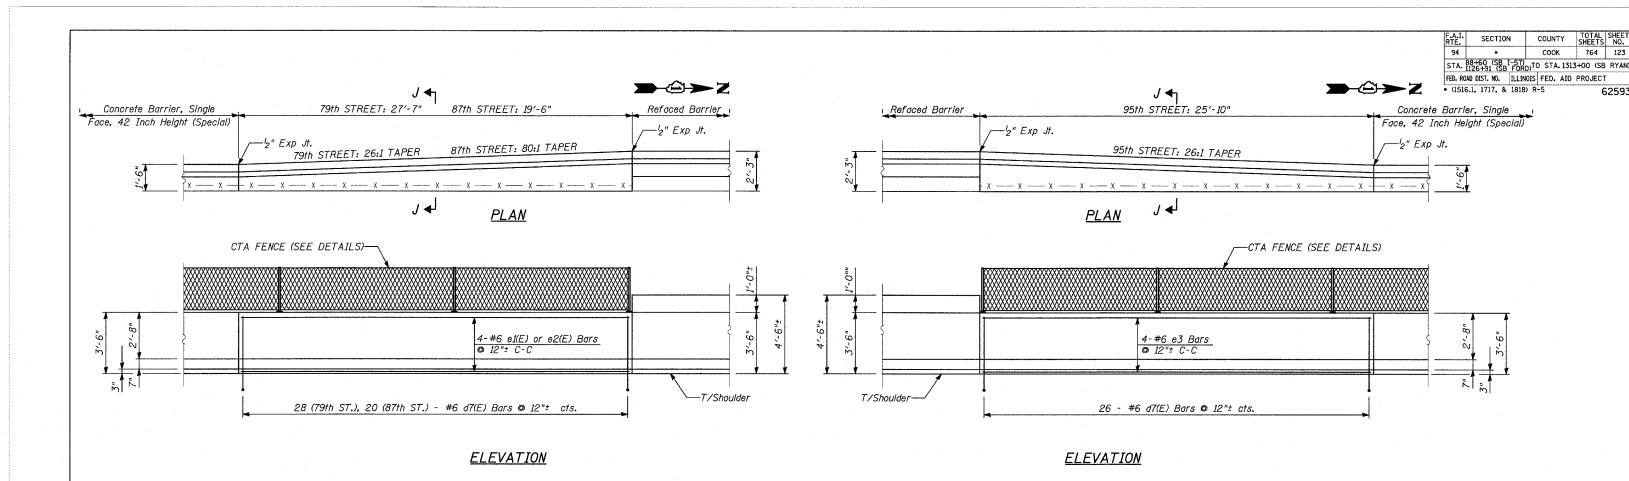

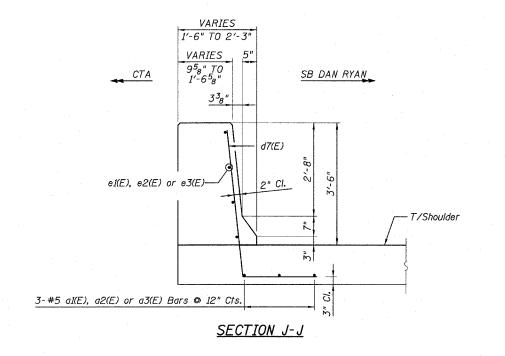

NOTES:

- Provide joints in facing to match those in the Existing Barrier. See Sht B1 for joint details.
- 2. For Refaced Barrier details, see Sheet B2.
- 3. For Concrete Barrier, Single Face, 42" (Special), see Typical Section details.
- 5. For locations of Transition, see Roadway Plans.


BILL OF MATERIAL

	Bar	79th No.	87th No.	95th No.	Size	Length	Shape
	a1(E)	3	-	-	#5	27'-3"	
	a2(E)	-	3	-	#5	19'-2"	
	a3(E)	-	-	3	#5	25′-6"	
	d7(E)	28	20	26	#6	6'-3"	
	e1(E)	4	-	-	#6	27'-3"	
	e2(E)	1	4	-	#6	19'-2"	
	e3(E)	-	-	4	#6	25′-6"	
	<i>Ite</i>	m		Unit	79th Qty	87th Qty	95th Qty
	Reinforcement E	Bars,					
	Epoxy Coated			Pound.	520	370	480
*	Concrete Struct	ures		Cu. Yd.	5	4	5
	Protective Coat			Sq. Yd.	16	-11	<i>1</i> 5

* Coarse Aggregate shall meet the requirements of Article 1004.01-1004.02 of the Standard Specifications except the gradation will be limited to CA-11 or CA-14.

SHEET B8 OF 8

REVISIONS	ILLINOIS DEPARTMENT	OF TRANSPORTATION
NAME DATE		
	F.A.I. 94 (DAN R)	YAN EXPRESSWAY)
	CTA STATION BARRIER	WALL MODIFICATIONS
	70TU 07TU 110 0F	CU CIDEET CIATIONS
· .	(91H, 8(1H AND 95)	TH STREET STATIONS
	DEELOED DADDIED TO	NEW 40 THOU DARRED
	REPACED BARKIER TO	NEW 42 INCH BARRIER
	DETAILS DIAN ELEVAT	TON A TYPICAL CECTION
	DETAILS: PLAN, ELEVAT	ION & TYPICAL SECTION
	SCALE: NONE	DRAWN BY: MPG
	DATE: MARCH 1, 2006	CHECKED BY: SP

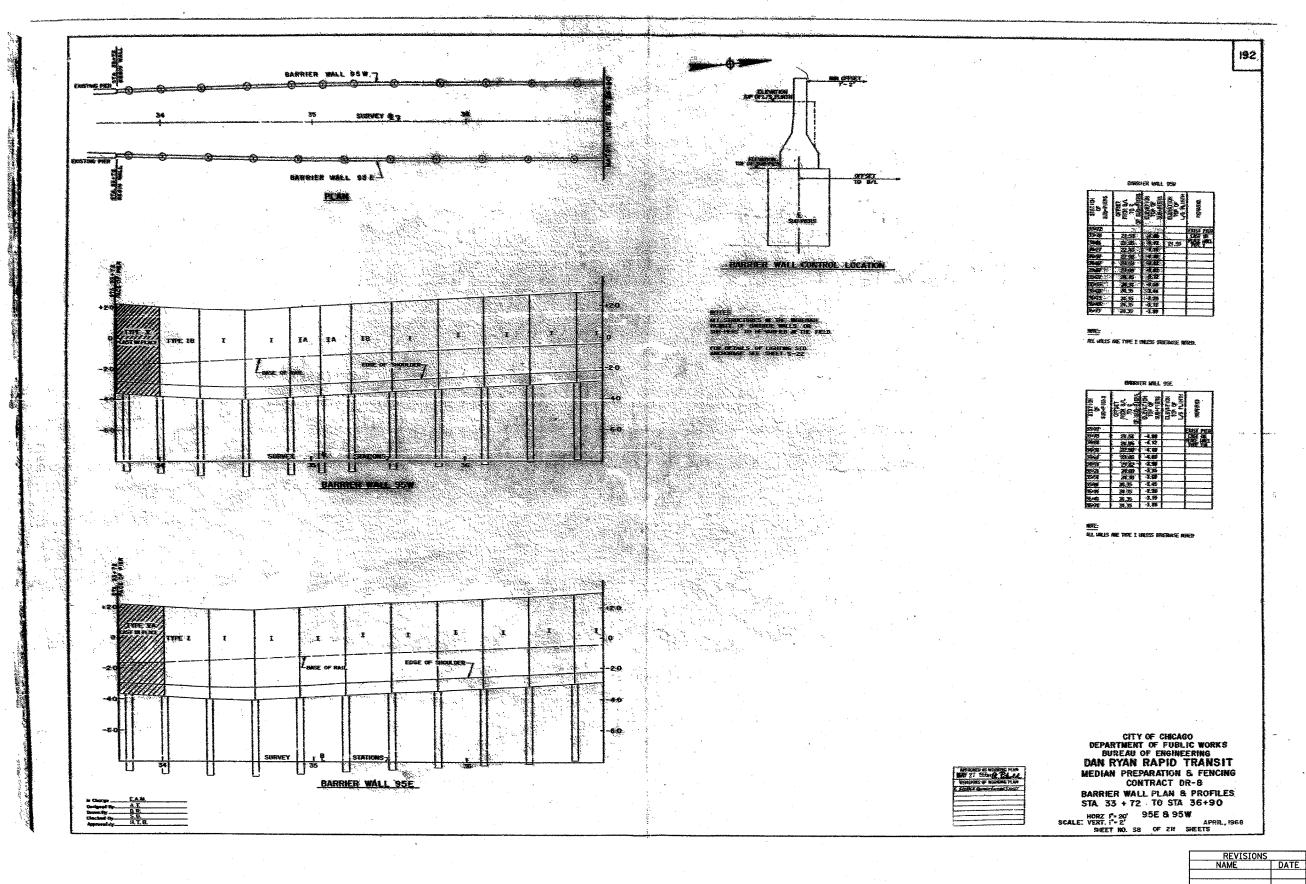

соок 764 124 STA. 88460 (SB I-57) TO STA. 1313+00 (SB RYAN)
FED. ROAD DIST. NO. | ILLINOIS | FED. AID PROJECT

• (1516.1, 1717, & 1818) R-5 | 62593


FOR INFORMATION ONLY

ILLINOIS DEPARTMENT OF TRANSPORTATION F.A.I. 94 (DAN RYAN EXPRESSWAY)

> EXISTING CONCRETE BARRIER AT CTA STATIONS: 95TH STREET (1 OF 2)

DATE: MARCH 1, 2006

DRAWN BY: JJS CHECKED BY: TGB

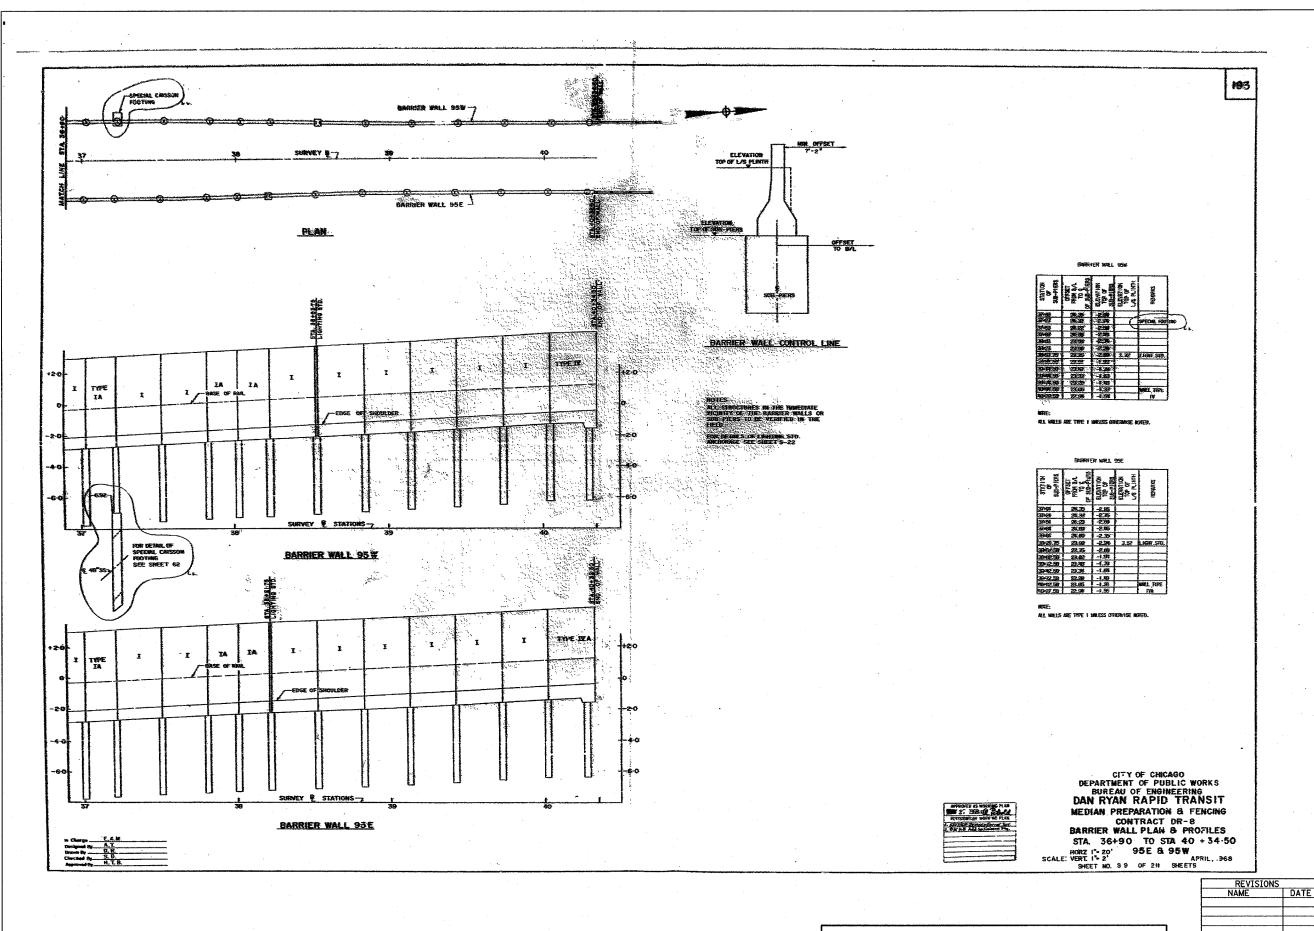

ILLINOIS DEPARTMENT OF TRANSPORTATION F.A.I. 94 (DAN RYAN EXPRESSWAY)

EXISTING CONCRETE BARRIER AT CTA STATIONS: 95TH STREET (2 OF 2)

SCALE: NONE DATE: MARCH 1, 2006 DRAWN BY: JJS

TOTAL SHEET SHEETS NO. 764 125


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COUNTY соок STA. 88+60 (SB I-57) STA. 1126+91 (SB FORD)TO STA. 1313+00 (SB RYAN) FED. ROAD DIST. NO. ILLINOIS FED. AID PROJECT

SECTION

• (1516.1, 1717, & 1818) R-5

FOR INFORMATION ONLY

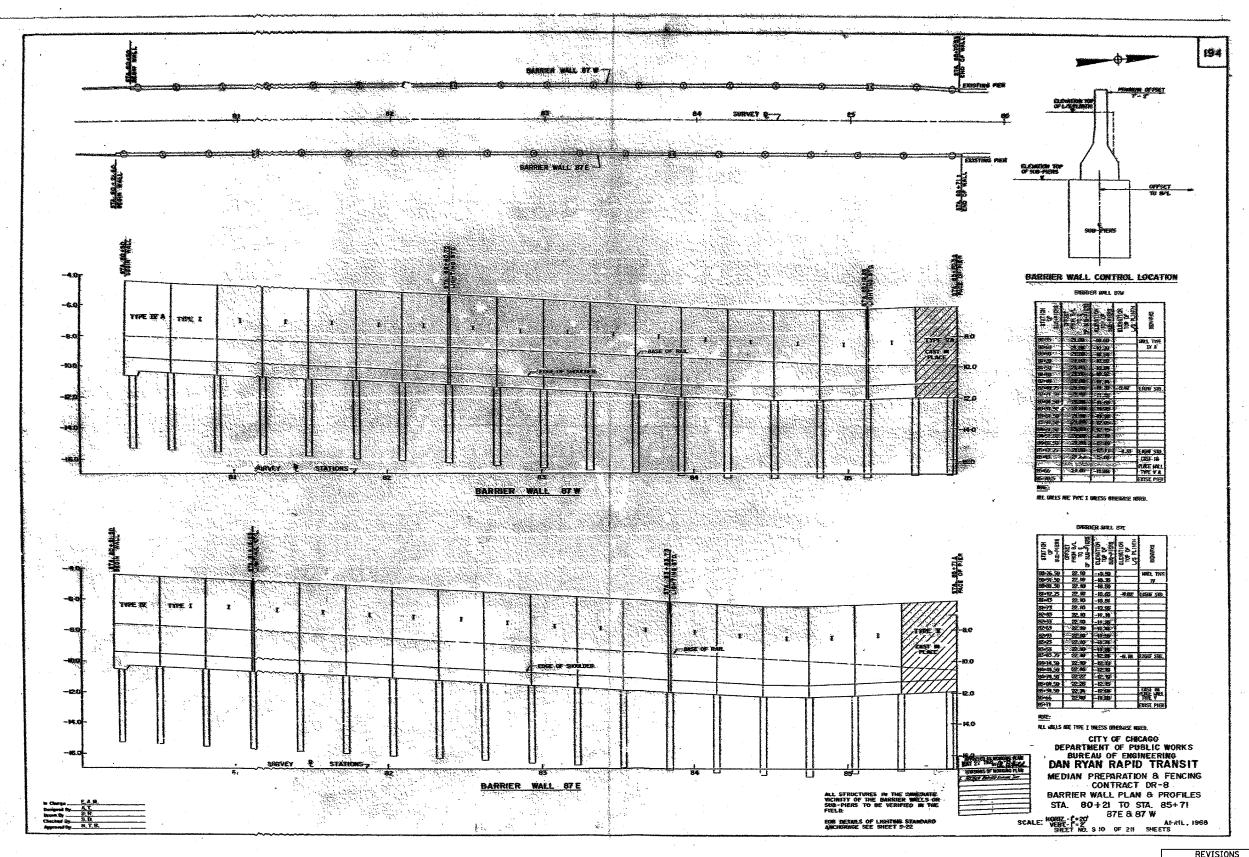

FOR INFORMATION ONLY

REVISIONS		
NAME	DATE	
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		' •
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		SCALE

ILLINOIS DEPARTMENT OF TRANSPORTATION .A.I. 94 (DAN RYAN EXPRESSWAY)

EXISTING CONCRETE BARRIER AT CTA STATIONS: 85TH STREET (1 OF 1)


DRAWN BY: JJS CHECKED BY: TGB

COUNTY СООК

STA. 88+60 (SB I-57) TO STA. 1313+00 (SB RYAN) FED. ROAD DIST. NO. | ILLINOIS | FED. AID | PROJECT |
- (1516.1, 1717, & 1818) R-5 | 62

764 126

62593

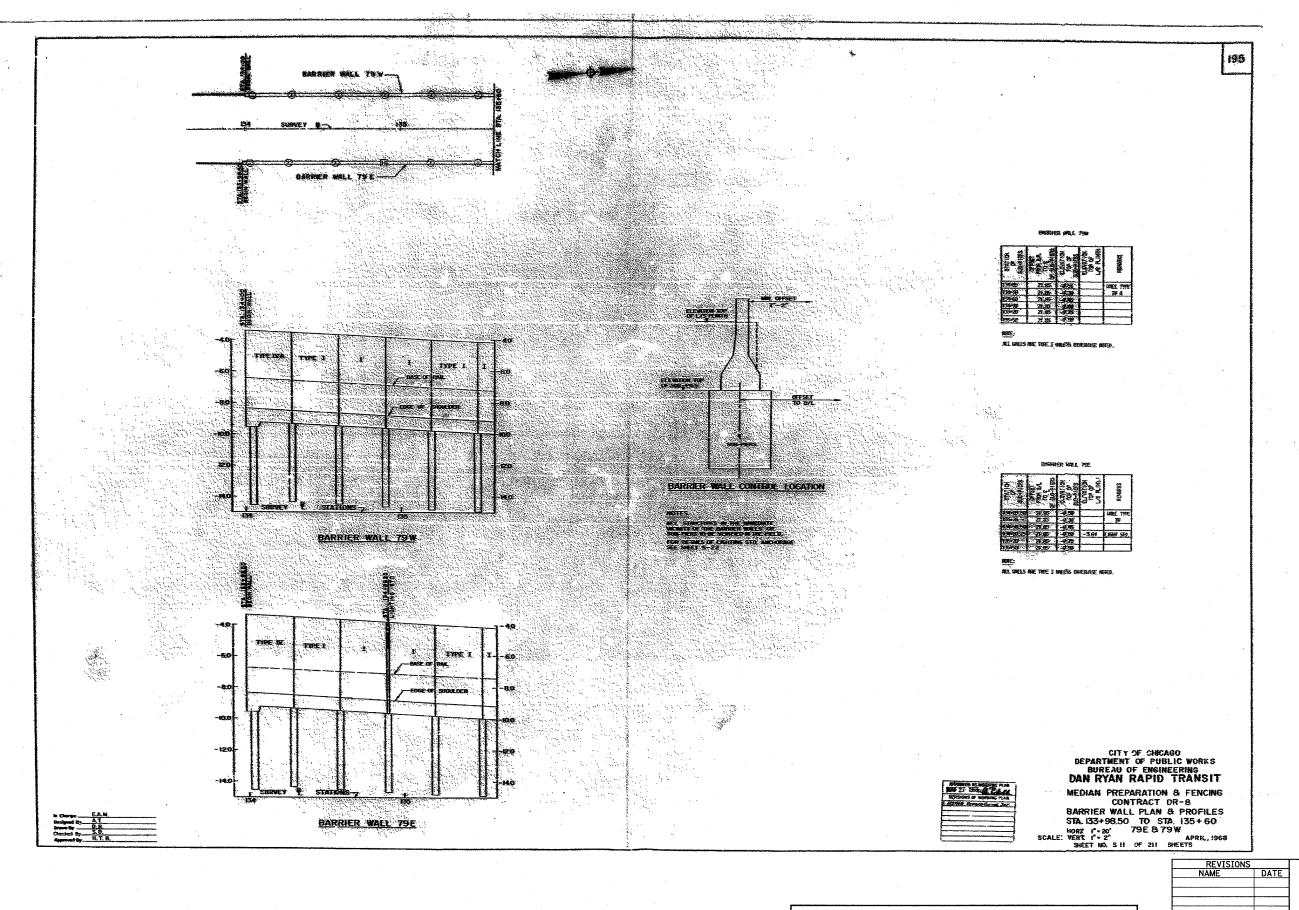

FOR INFORMATION ONLY


F.

ILLINOIS DEPARTMENT OF TRANSPORTATION
F.A.I. 94 (DAN RYAN EXPRESSWAY)

EXISTING CONCRETE BARRIER AT CTA STATIONS: 79TH STREET (1 OF 2)

SCALE: NONE
DATE: MARCH 1, 2006

DRAWN BY: JJS

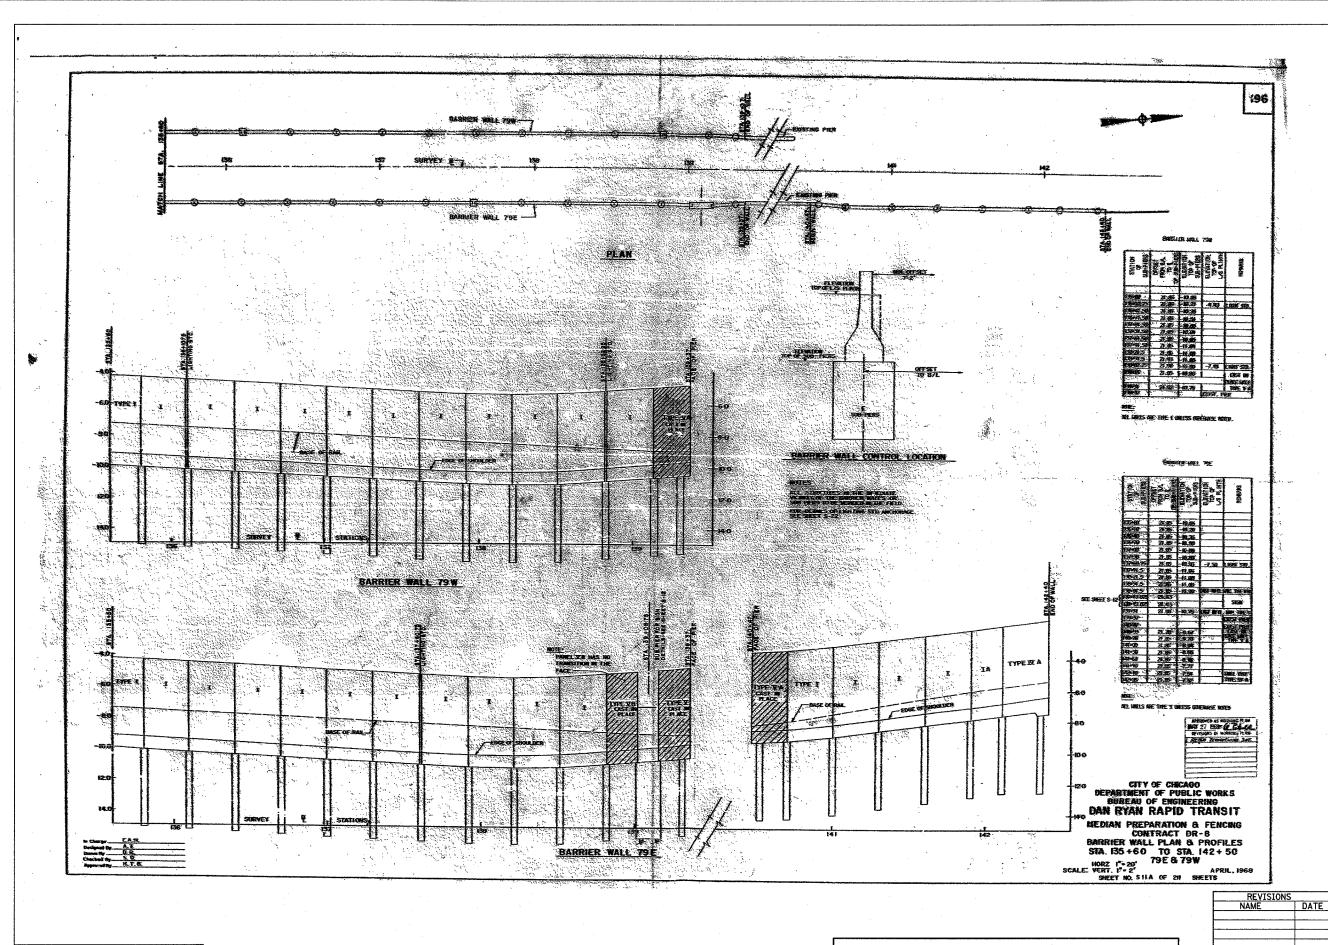


TOTAL SHEET NO. 764 128 COUNTY COOK STA. 88+60 (SB I-57) STA. 1126+91 (SB FORD) TO STA. 1313+00 (SB RYAN) FED. ROAD DIST. NO. | ILLINOIS | FED. AID | PROJECT | (1516.1, 1717, & 1818) R-5 | 62

ILLINOIS DEPARTMENT OF TRANSPORTATION F.A.I. 94 (DAN RYAN EXPRESSWAY)

> EXISTING CONCRETE BARRIER AT CTA STATIONS: 79TH STREET (2 OF 2)

SCALE: NONE DATE: MARCH 1, 2006 DRAWN BY: JJS CHECKED BY: TGB

FOR INFORMATION ONLY

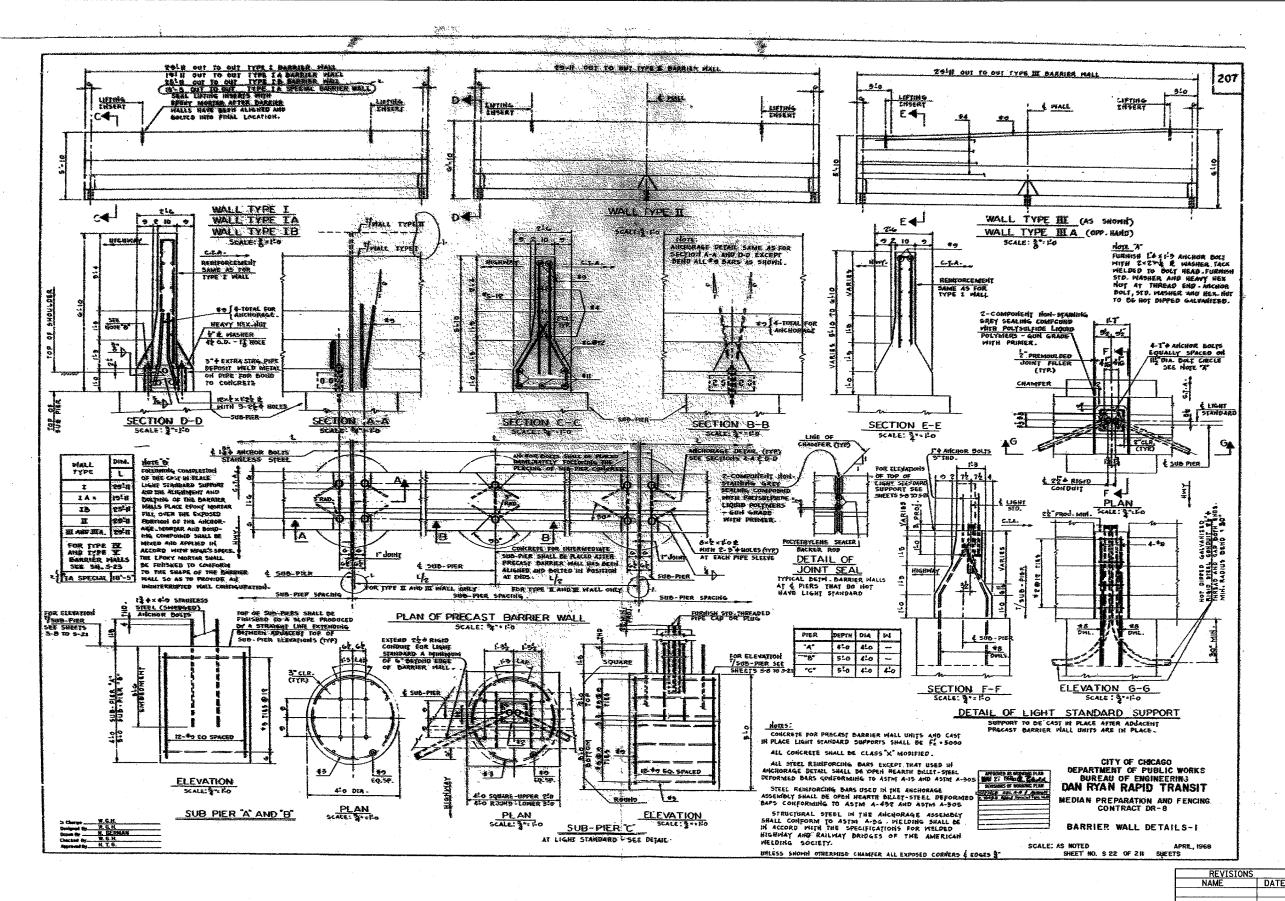

TOTAL SHEE SHEETS NO. SECTION COUNTY COOK 764 129 STA. 88+60 (SB I-57) STA. 1126+91 (SB FORD)TO STA. 1313+00 (SB RYAN) FED. ROAD DIST. NO. ILLINOIS FED. AID PROJECT • (1516.1, 1717, & 1818) R-5 62593

EXISTING CONCRETE BARRIER AT CTA STATIONS: BARRIER DETAILS


ILLINOIS DEPARTMENT OF TRANSPORTATION F.A.I. 94 (DAN RYAN EXPRESSWAY)

DATE: MARCH 1, 2006

DRAWN BY: JJS CHECKED BY: TGB

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FOR INFORMATION ONLY

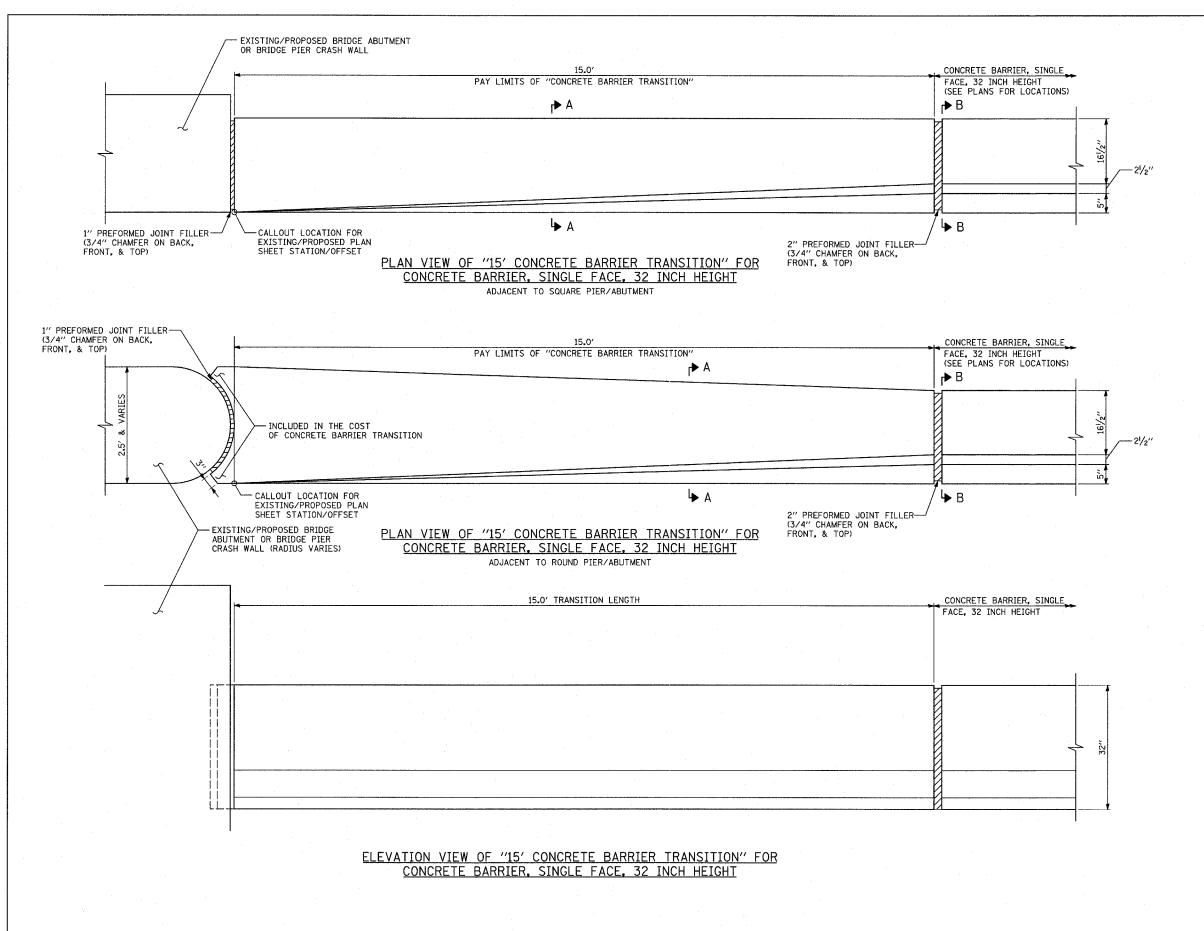

F.A.I.	SECTION	COUNTY	TOTAL	SHEET	No.
94	•	COOK	764	130	
STA. 1126-491 (SB I - 57)	TOTAL	SHEET	No.		
FD. ROAD DIST. NO.	ILLINOIS	FED. AID	PROJECT		

62593

* (1516.1, 1717, & 1818) R-5

NOTE: ALL PREFORMED JOINT FILLER INCLUDED IN THE COST OF "CONCRETE BARRIER TRANSITION"


REVISION	NS.
NAME	DATE

ILLINOIS DEPARTMENT OF TRANSPORTATION
F.A.I. 94 (DAN RYAN EXPRESSWAY)

MISCELLANEOUS DETAILS CONCRETE BARRIER TRANSITION FOR CONCRETE BARRIER, 32 INCH HEIGHT

SCALE: NONE
DATE: MARCH 1, 2006

DRAWN BY: MPG CHECKED BY: TGB

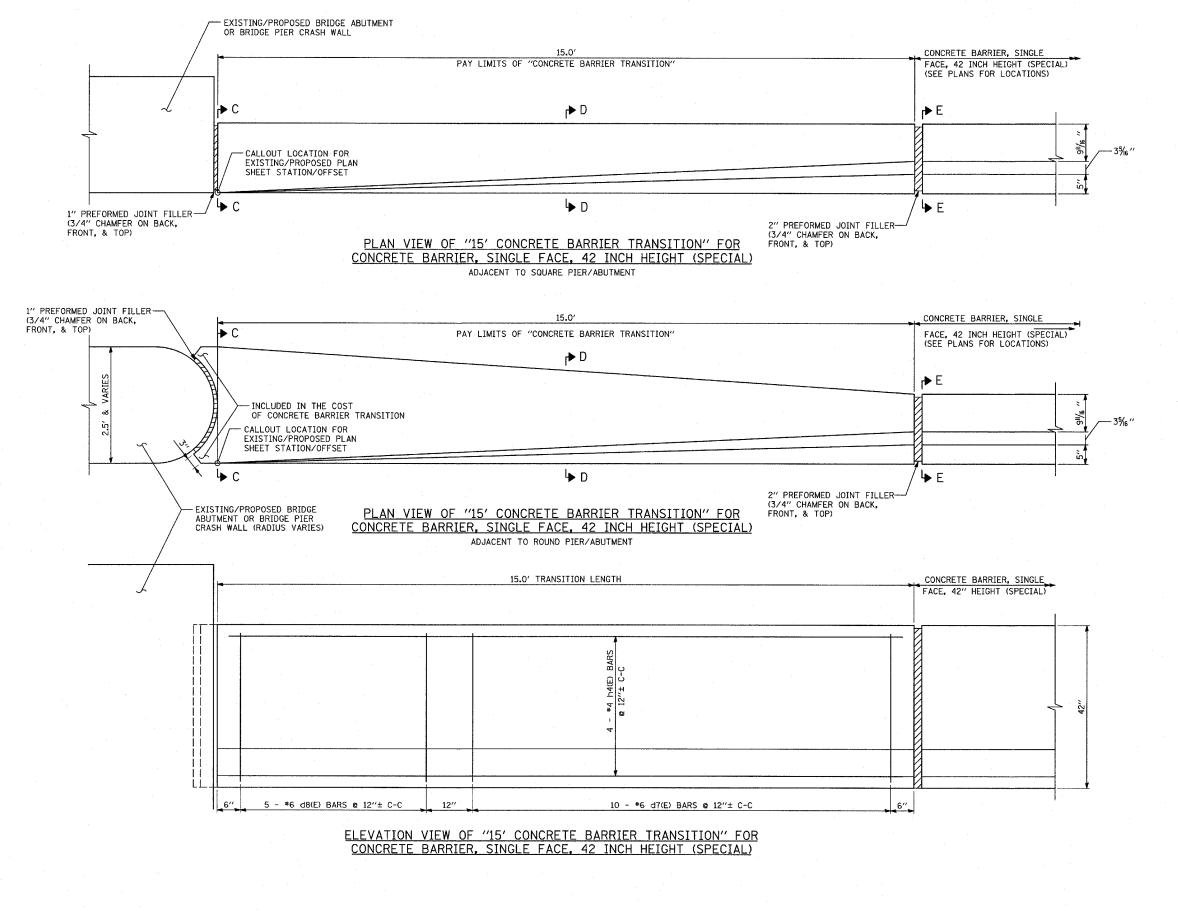



62593

• (1516.1, 1717, & 1818) R-5

NOTE: ALL PREFORMED JOINT FILLER INCLUDED IN THE COST OF "CONCRETE BARRIER TRANSITION"

REVISIONS NAME			LINOIS DEPARTM .I. 94 (DAN			
			MISCELLA ONCRETE BARI ETE BARRIER,	RIER TR	ANSITION	
		SCALE: DATE:	NONE MARCH 1, 2006		AWN BY: ECKED BY:	MPG TGB

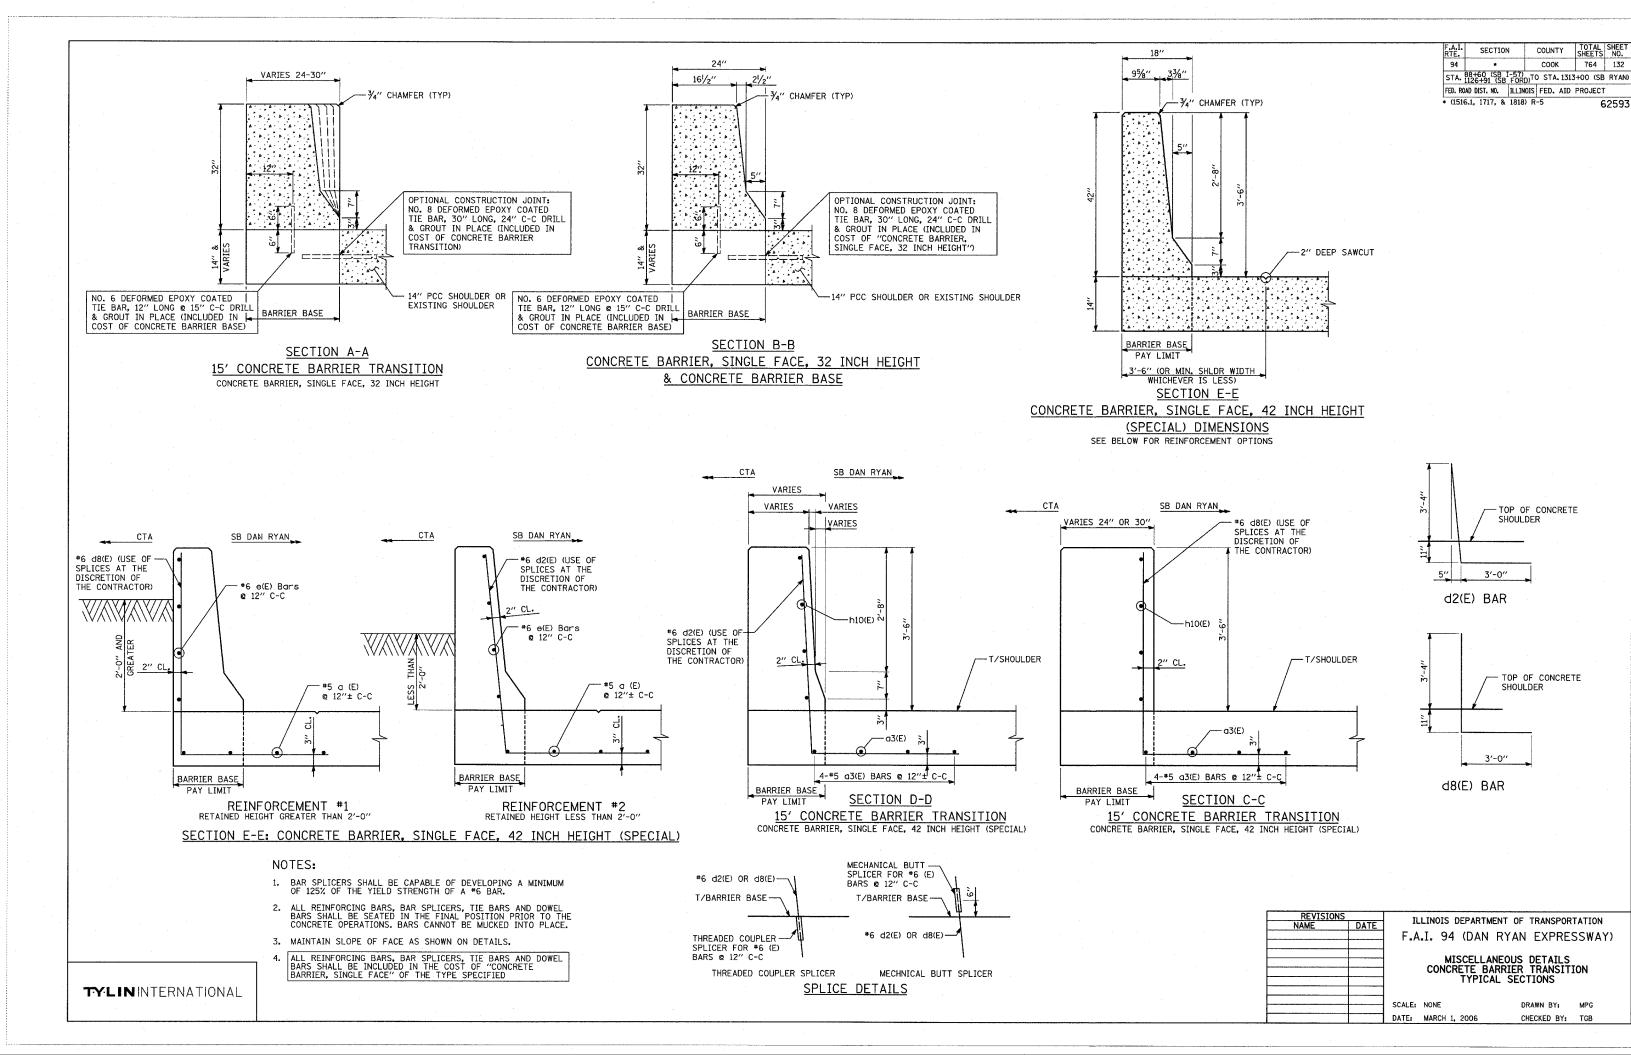

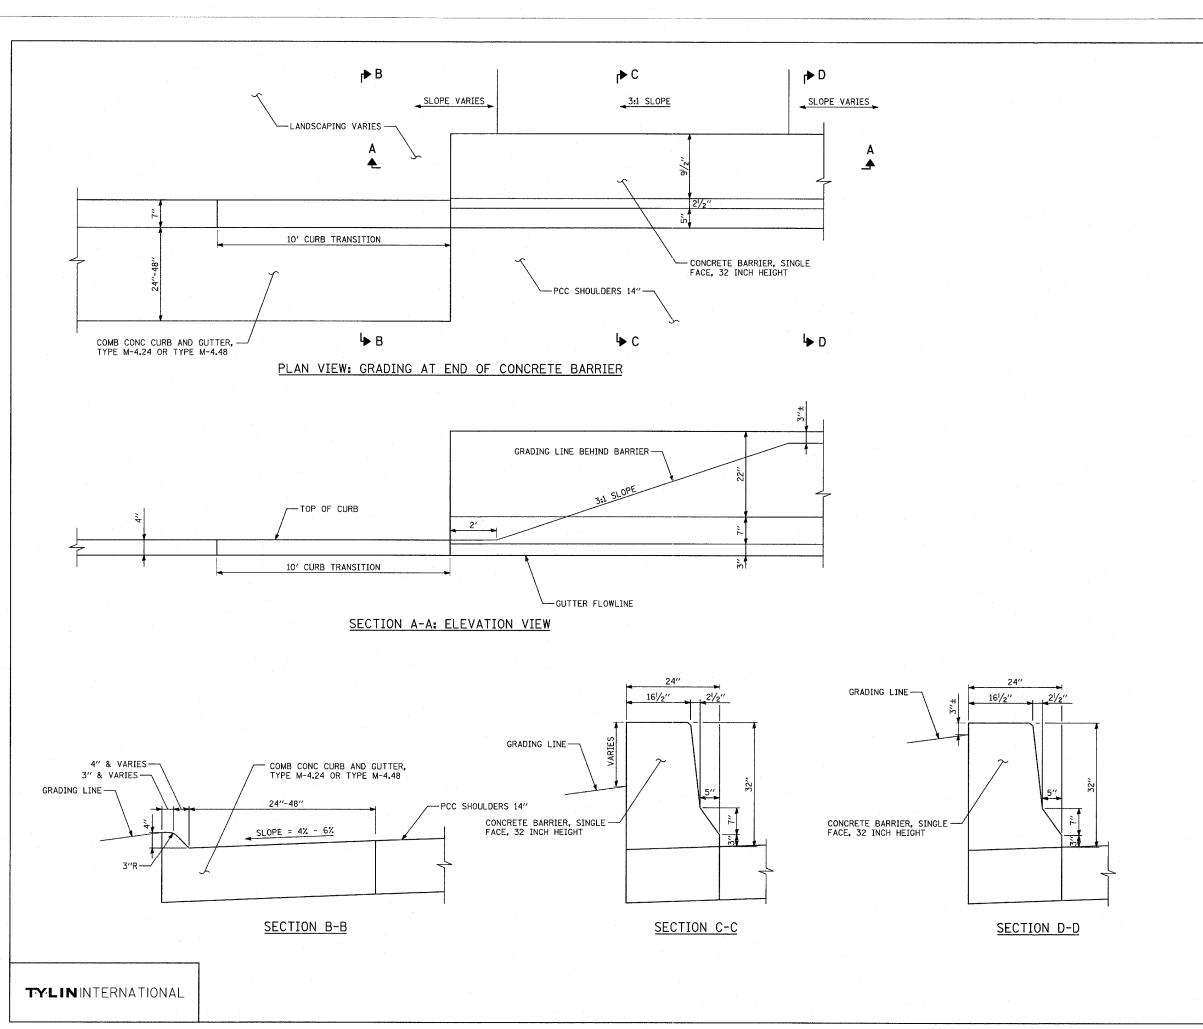


COUNTY TOTAL SHEET NO.

COOK 764 133 SECTION STA. 88+60 (SB I-57) TO STA. 1313+00 (SB RYAN) FED. ROAD DIST. NO. | ILLINOIS | FED. AID PROJECT • (1516.1, 1717, & 1818) R-5 62 62593

NOTES:


1. SEE DRAINAGE AND UTILITY PLANS, CROSS-SECTIONS, AND LANDSCAPING PLANS FOR GRADING LIMITS AND DETAILS.

REVISION	NS	Ti.	I INOIS DEPARTI	AFNT OF TRANSPOR	TATION	
NAME	DATE	ILLINOIS DEPARTMENT OF TRANSPORTATION				
		F.A	.I. 94 (DAN	RYAN EXPRES	SSWAY)	
			MISCELL	ANEOUS DETAILS		
				DETAIL AT END		
			OF CON	CRETE BARRIER		
		SCALE	NONE	DRAWN BY:	MPG	
		DATE:	MARCH 1, 2006	CHECKED BY:	TGB	

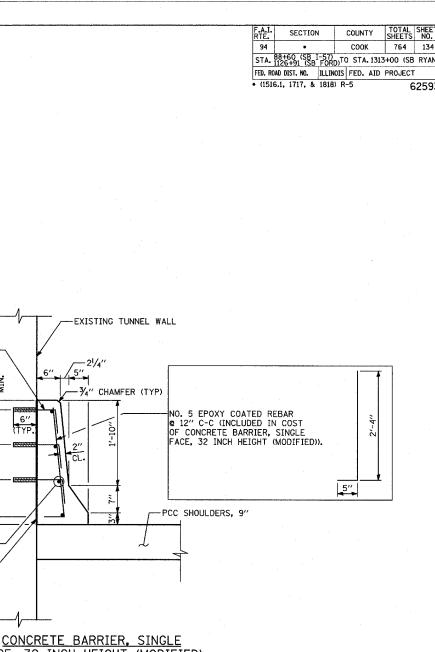

2'-21/2" 91/2" 3/4" CHAMFER (TYP) NO. 4 DEFORMED EPOXY COATED REBAR © 7" C-C DRILL & GROUT IN PLACE - EMBED 12" INTO ADJACENT EXISTING BARRIER - (INCLUDED IN COST OF CONCRETE OPTIONAL CONSTRUCTION JOINT: BARRIER, DOUBLE FACE, 42 INCH HEIGHT) NO. 8 DEFORMED EPOXY COATED TIE BAR, 30" LONG, 24" C-C DRILL & GROUT IN PLACE (INCLUDED IN COST OF BARRIER BASE) 10" PCC PAVEMENT -BARRIER BASE BARRIER BASE NO. 6 DEFORMED EPOXY COATED TIE BAR, 12" LONG @ 15" STAGGERED C-C DRILL & GROUT IN PLACE - (INCLUDED PAY LIMIT PAY LIMIT REINFORCEMENT <u>DIMENSIONS</u> IN COST OF BARRIER BASE) ALL DIMENSIONS ARE APPROXIMATE BASED ON EXISTING PLANS AND MAY VARY - MATCH EXISTING BARRIER

CONCRETE BARRIER, DOUBLE FACE, 42 INCH HEIGHT ALONG SB I-57

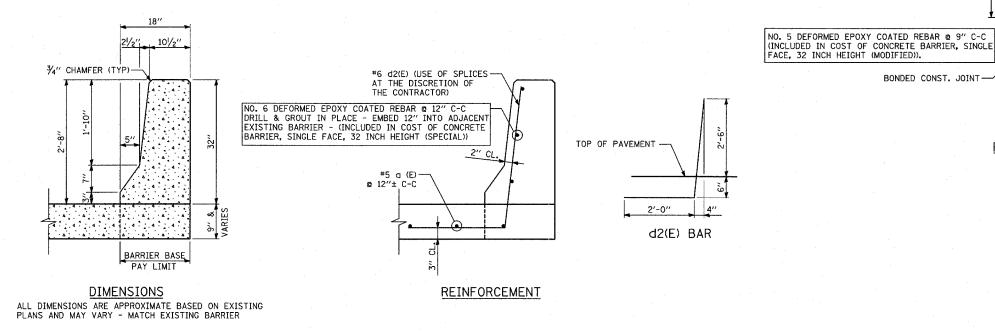

FACE, 32 INCH HEIGHT (MODIFIED) PROVIDE JOINTS IN FACING TO MATCH THOSE IN THE EXISTING STRUCTURES. (INCLUDED IN COST OF CONCRETE BARRIER,

SINGLE FACE, 32 INCH HEIGHT (MODIFIED)).

NO. 6 DEFORMED EPOXY COATED REBAR @ 9" C-C DRILL & GROUT IN PLACE - EMBED 6" INTO ADJACENT EXISTING STRUCTURE - (INCLUDED IN

COST OF CONCRETE BARRIER, SINGLE FACE, 32 INCH HEIGHT (MODIFIED)).

BONDED CONST. JOINT-


CUT BAR TO FIT.


CONCRETE BARRIER, SINGLE FACE, 32 INCH HEIGHT (SPECIAL)

ALONG SB I-94 (BISHOP FORD FREEWAY) AND EB I-57 TO I-94 CONNECTOR


ILLINOIS DEPARTMENT OF TRANSPORTATION F.A.I. 94 (DAN RYAN EXPRESSWAY) MISCELLANEOUS DETAILS
PLAN AND TYPICAL SECTION DETAILS SCALE: AS SHOWN DRAWN BY: MPG

CHECKED BY: TGB

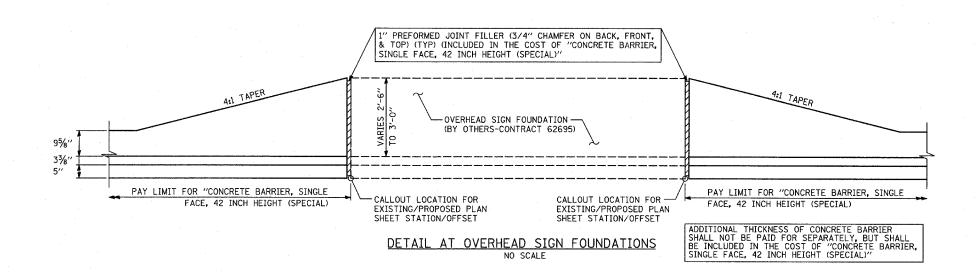


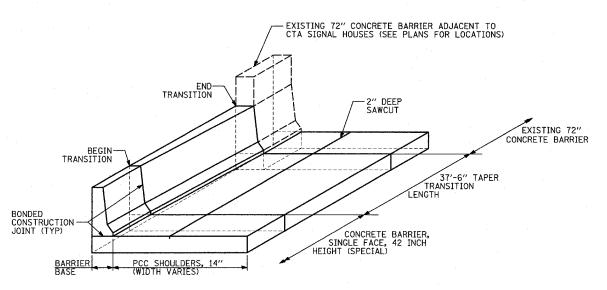


72" CONCRETE BARRIER TRANSITION DETAIL

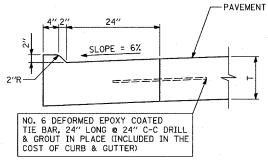

COMBINATION CONCRETE CURB & GUTTER, TYPE M-2.24 SCALE: 1"=1'-0"

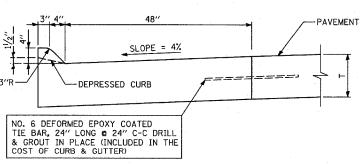


COMBINATION CONCRETE CURB & GUTTER, TYPE M-4.48 SCALE: 1"=1'-0"

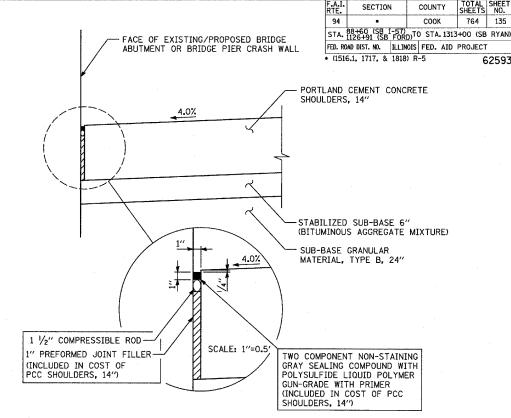


764 135

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PCC SHOULDERS ADJACENT TO BRIDGE ABUTMENT/CRASH WALL SCALE: 1"=1'-0"




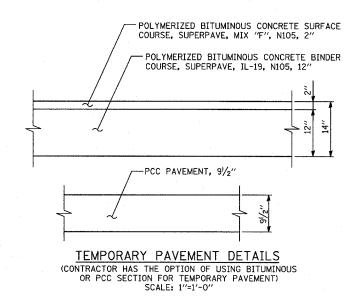

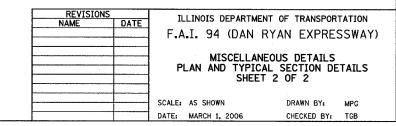
COUNTY TOTAL SHEET NO. SECTION COOK 764 136 STA. 88+60 (SB 1-57) TO STA. 1313+00 (SB RYAN FED. ROAD DIST. NO. | ILLINOIS | FED. AID | PROJECT 62593

• (1516.1, 1717, & 1818) R-5

<u>DETAIL A</u>

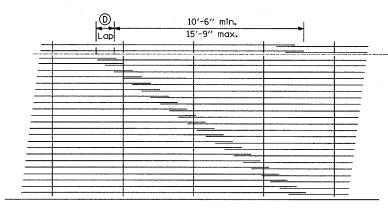


LAP DETAIL II

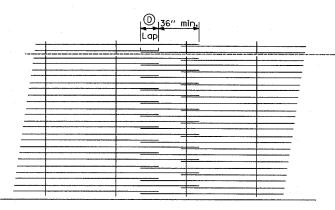

LAP DETAIL III

Longitudinal—	See DETAIL A	Length o	of bars 30'-0"		
Longitudinal Joint				3 E.	qual spaces
\@ _	Lap				
(A)					
14'-0",					
12'-0", 1.					
11′-9					
<u>↓ ↓ ↓</u> <u>↑</u> ↑			4'-0''		
(S, ''	Edge of pavement	ongitudinal bars—		#4 Tr	ansverse bars
		Ĺ	AP DETAIL I		

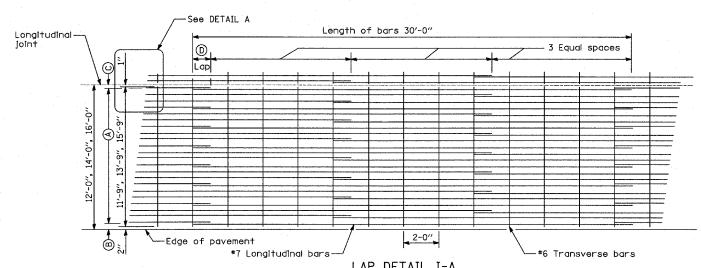

LAP DETAIL I-A
ADDITIONAL REINFORCEMENT IN GORE AREAS - SEE PAVEMENT
JOINTING AND ELEVATION PLANS FOR LOCATIONS

GENERAL NOTES

- 1. THE PAVEMENT REINFORCEMENT SHALL BE 4.5" FROM THE TOP OF PAVEMENT.
- EXCEPT AS NOTED OR SHOWN, THE DIMENSIONS AND NOTES SPECIFIED FOR LAP DETAIL I ARE TYPICAL FOR LAP DETAIL II AND III.
- 3. THE ® DIMENSION AND THE DISTANCE FROM THE END OF THE TRANSVERSE BAR TO THE EDGE OF PAVEMENT MAY BE INCREASED BY 1" FOR SLIP FORM PAVING.

Pavement Width	Bar Size	Pavement Thickness	(Approx. Spacing)	B	©	0
12 feet	#7	14"	23 spaces (24 bars) @ 6"	31/2"	3"	26"
14 feet	#7	14"	27 spaces (28 bars) @ 6"	31/2"	3"	26"
16 feet	#7	14"	31 spaces (32 bars) @ 6"	31/2"	3"	26"

ILLINOIS DEPARTMENT OF TRANSPORTATION F.A.I. 94 (DAN RYAN EXPRESSWAY) MISCELLANEOUS DETAILS EXTENDED LANE REINFORCEMENT FOR CONTINUOUSLY REINFORCED PCC PAVEMENT DRAWN BY: CTE, MPG DATE: MARCH 1, 2006 CHECKED BY: TGB

COUNTY TOTAL SHEET NO.

COOK 764 137 SECTION STA. 88+60 (SB I-57) STA. 1126+91 (SB FORD)TO STA. 1313+00 (SB RYAN) FED. ROAD DIST. NO. | ILLINOIS | FED. AID | PROJECT |
• (1516.1, 1717, & 1818) R-5 | 62 62593

- 10 MIL. POLYETHYLENE BOND BREAKER ON STEEL TROWEL FINISH - 2" PREFORMED EXPANSION JOINT (REFER TO IDOT STANDARD 420001 FOR DETAILS) CONTINUOUSLY REINFORCED PORTLAND CEMENT CONCRETE PAVEMENT, 14" -STABILIZED SUB-BASE 6"
(BITUMINOUS AGGREGATE MIXTURE) SUBBASE GRANULAR MATERIAL, TYPE B 24" -PCC PAVEMENT, 11" (JOINTED) — STABILIZED SUB-BASE 4"
(BITUMINOUS AGGREGATE MIXTURE) -SUBBASE GRANULAR MATERIAL, TYPE B 24" 10' GEOTECHNICAL FABRIC FOR GROUND — STABILIATION (OVERLAP WITH FABRIC PLACED IN PREVIOUS CONTRACTS)

RAMP TERMINAL DETAILS AT EXISTING SLEEPER SLAB


SLEEPER SLAB

NOTES:

1. THE THICKENED EDGE OF THE SUB-BASE SHALL BE INCLUDED IN THE COST OF "SUB-BASE GRANULAR MATERIAL, TYPE B 24""

EXISTING PAVEMENT ITEMS CONSTRUCTED IN PREVIOUS CONTRACTS.


ILLINOIS DEPARTMENT OF TRANSPORTATION DATE F.A.I. 94 (DAN RYAN EXPRESSWAY) MISCELLANEOUS DETAILS:
MISCELLANEOUS PAVEMENT ELEVATION
AND JOINTING DETAILS
SHEET 1 OF 2 SCALE: NONE DRAWN BY: MPG DATE: MARCH 1, 2006 CHECKED BY: TGB

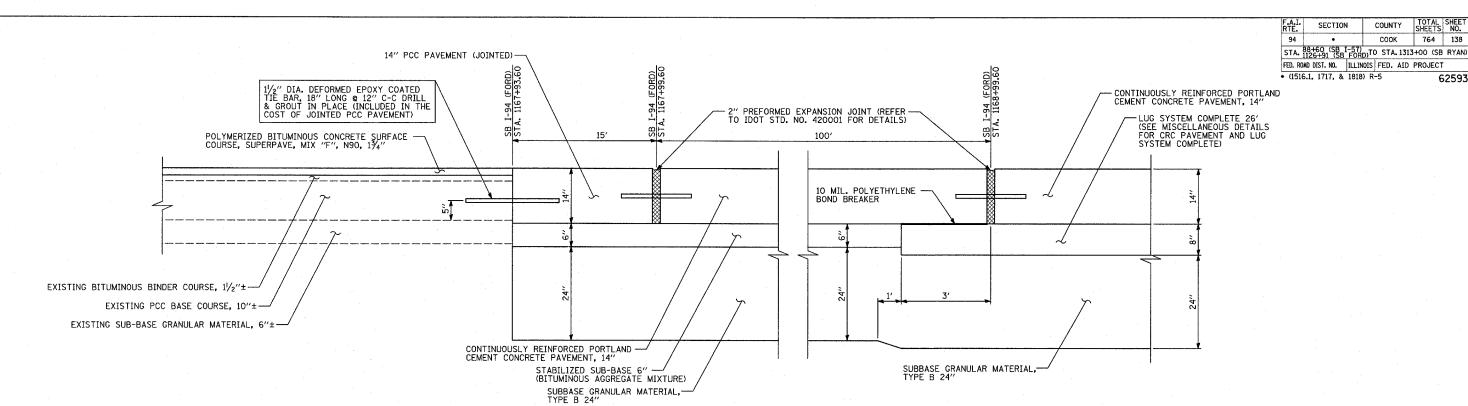



TOTAL SHEET NO. 764 138

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COUNTY соок



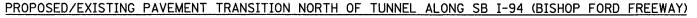


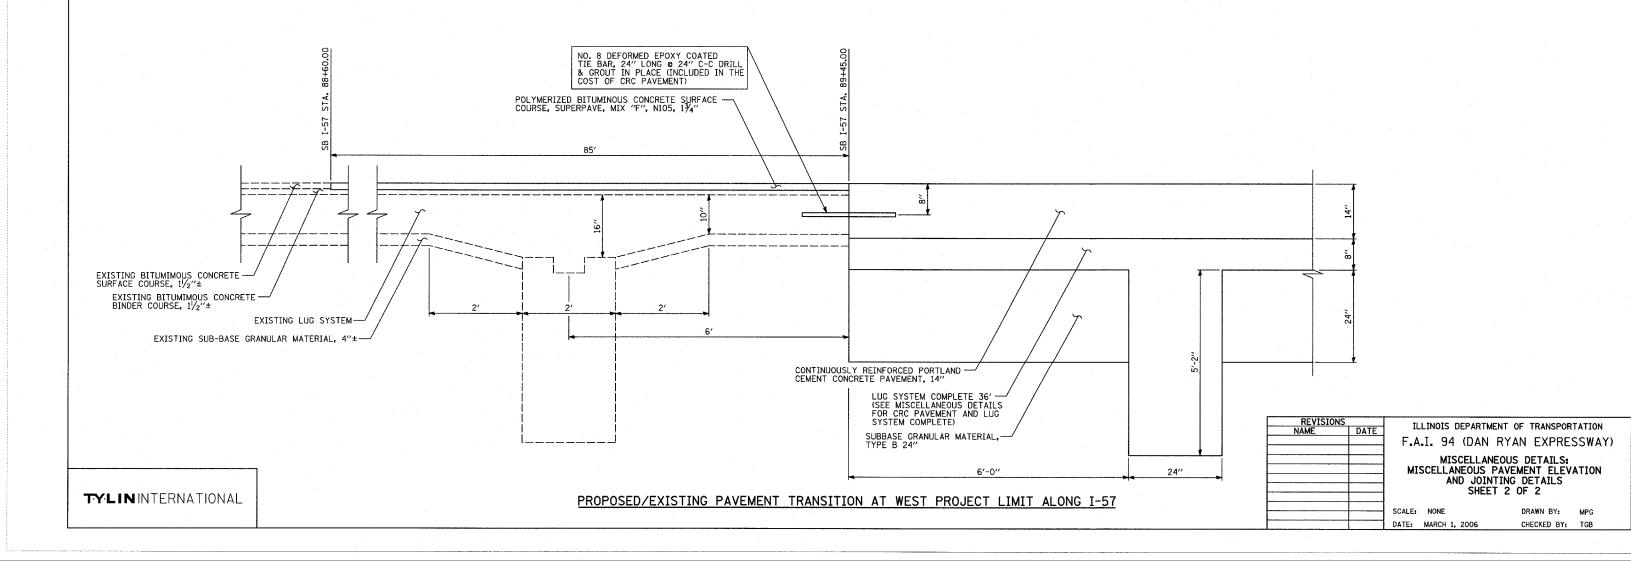

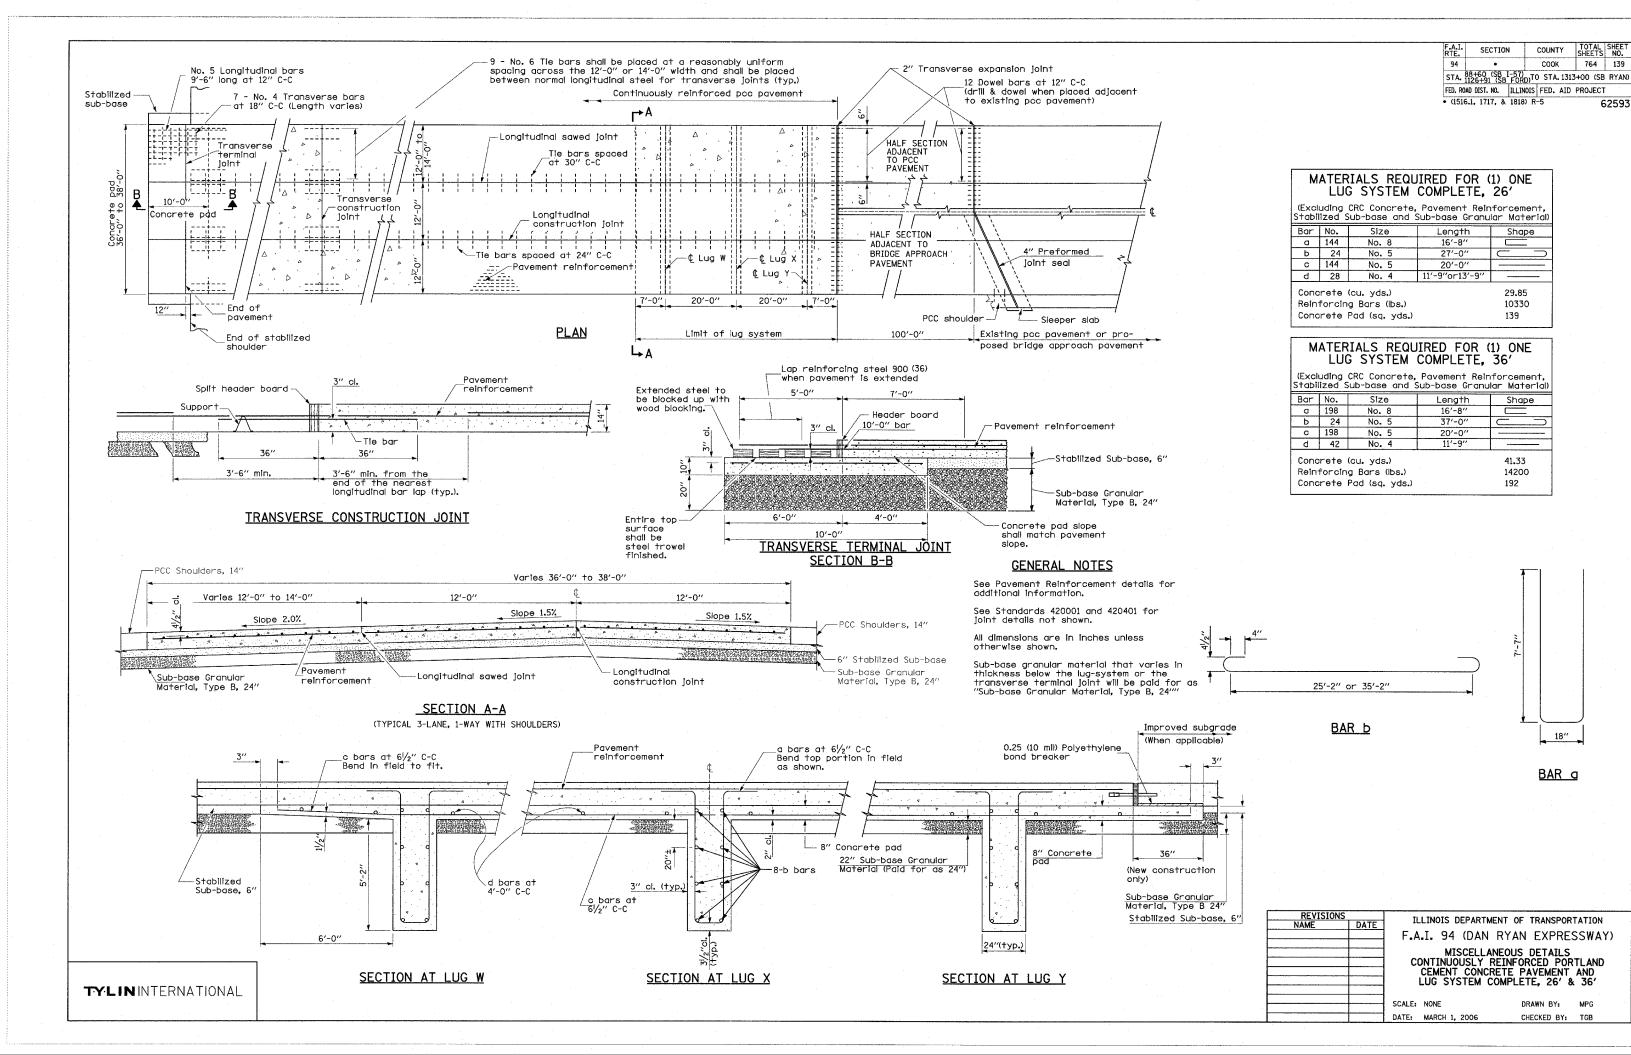
COUNTY TOTAL SHEET NO.

COOK 764 140 SECTION STA. 88+60 (SB I-57) TO STA. 1313+00 (SB RYAN) FED. ROAD DIST. NO. | ILLINOIS | FED. AID PROJECT • (1516.1, 1717, & 1818) R-5 62


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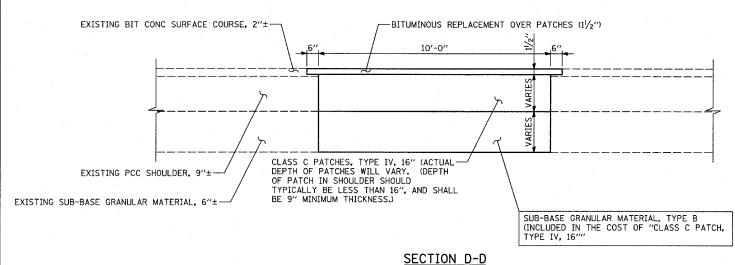
ILLINOIS DEPARTMENT OF TRANSPORTATION DATE F.A.I. 94 (DAN RYAN EXPRESSWAY) MISCELLANEOUS DETAILS
PAVEMENT JOINTING DETAILS
FOR CONCRETE MEDIAN SURFACE, 6" (SPECIAL)
AT TRAFFIC BARRIER TERMINALS SCALE: NONE DRAWN BY: MPG DATE: MARCH 1, 2006 CHECKED BY: TGB

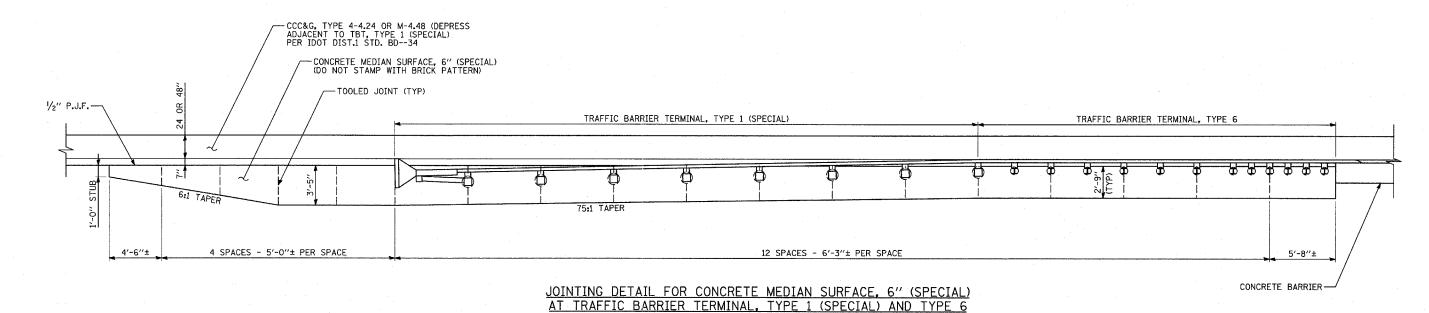


| F.A.I. | SECTION | COUNTY | SHEETS |

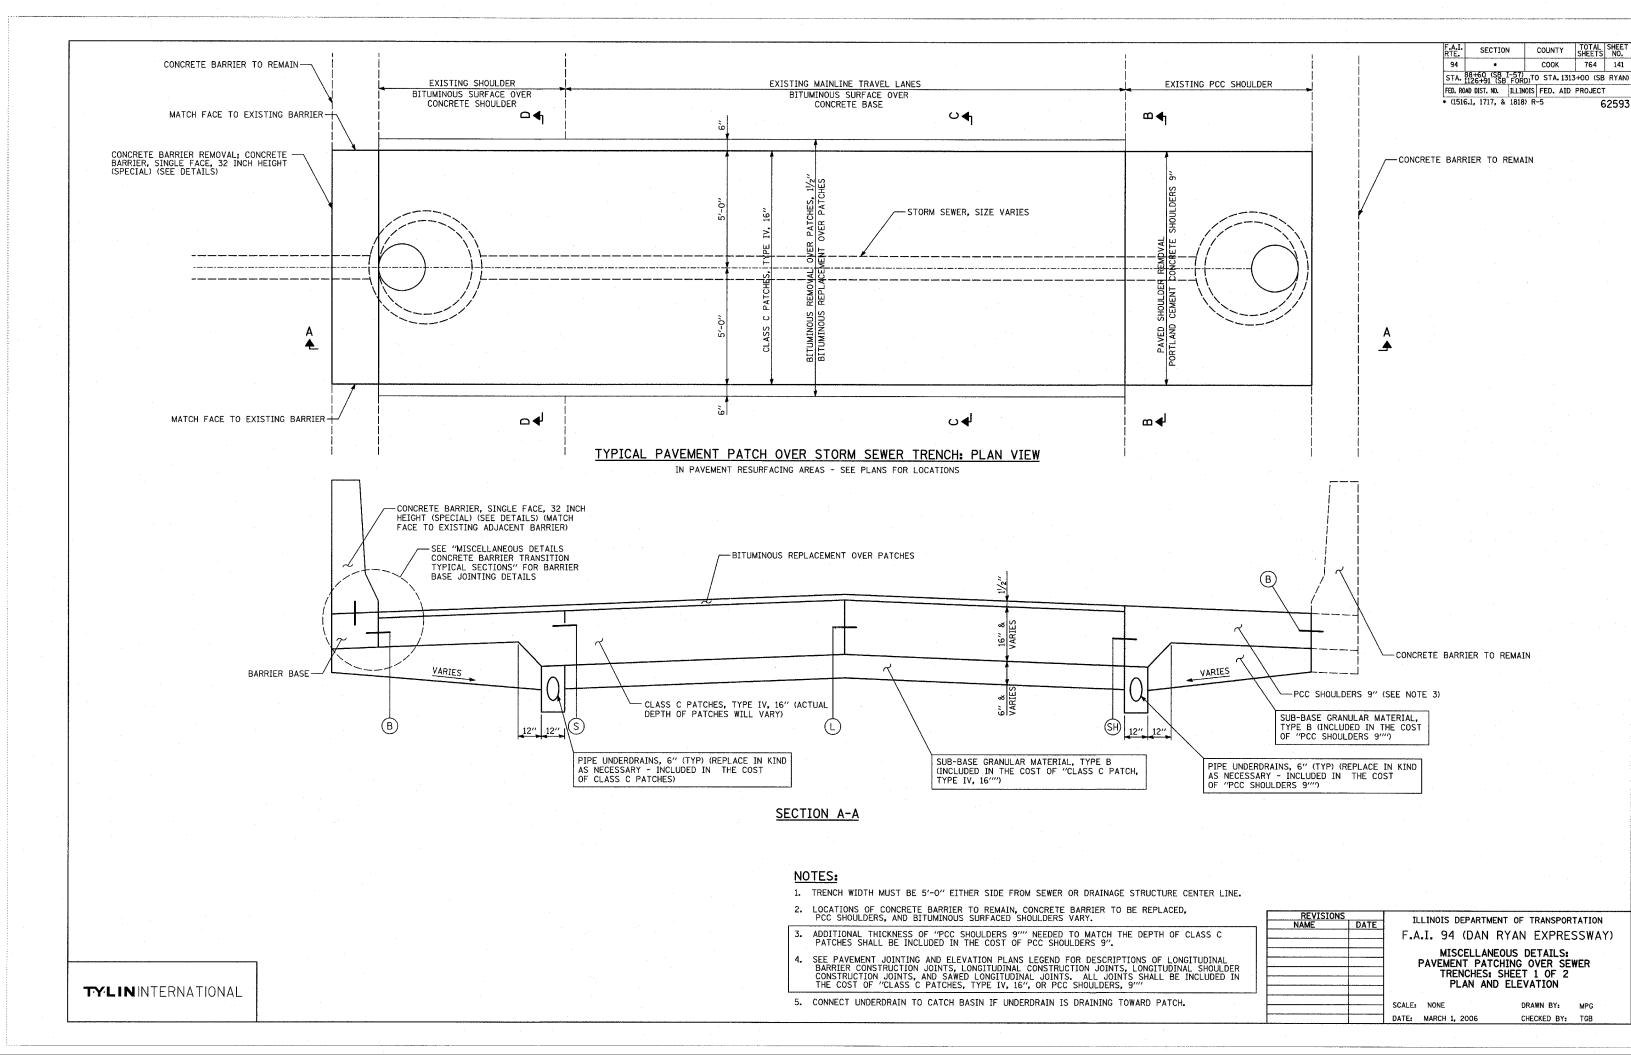

SECTION B-B
PCC SHOULDER WITH NO OVERLAY

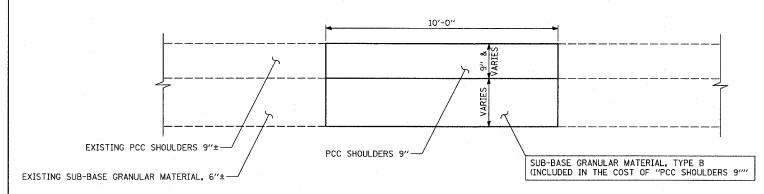

BITUMINOUS SURFACE OVER CONCRETE SHOULDER

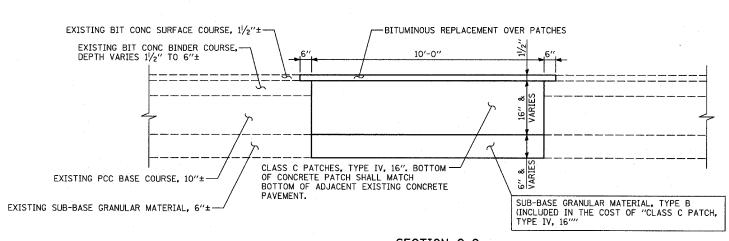

SECTION C-C
BITUMINOUS SURFACE OVER CONCRETE BASE

NOTES:

- 1. TRENCH WIDTH MUST BE 5'-0" EITHER SIDE FROM SEWER OR DRAINAGE STRUCTURE CENTER LINE.
- 2. LOCATIONS OF CONCRETE BARRIER TO REMAIN, CONCRETE BARRIER TO BE REPLACED, PCC SHOULDERS, AND BITUMINOUS SURFACED SHOULDERS VARY.
- 3. ADDITIONAL THICKNESS OF "PCC SHOULDERS 9"" NEEDED TO MATCH THE DEPTH OF CLASS C PATCHES SHALL BE INCLUDED IN THE COST OF PCC SHOULDERS 9".

REVISIONS
NAME DATE


F.A.I. 94 (DAN RYAN EXPRESSWAY)


MISCELLANEOUS DETAILS:
PAVEMENT PATCHING OVER SEWER
TRENCHES: SHEET 2 OF 2


SCALE: NONE
DATE: MARCH 1, 2006


DRAWN BY: MPG CHECKED BY: TGB

TYPICAL SECTIONS

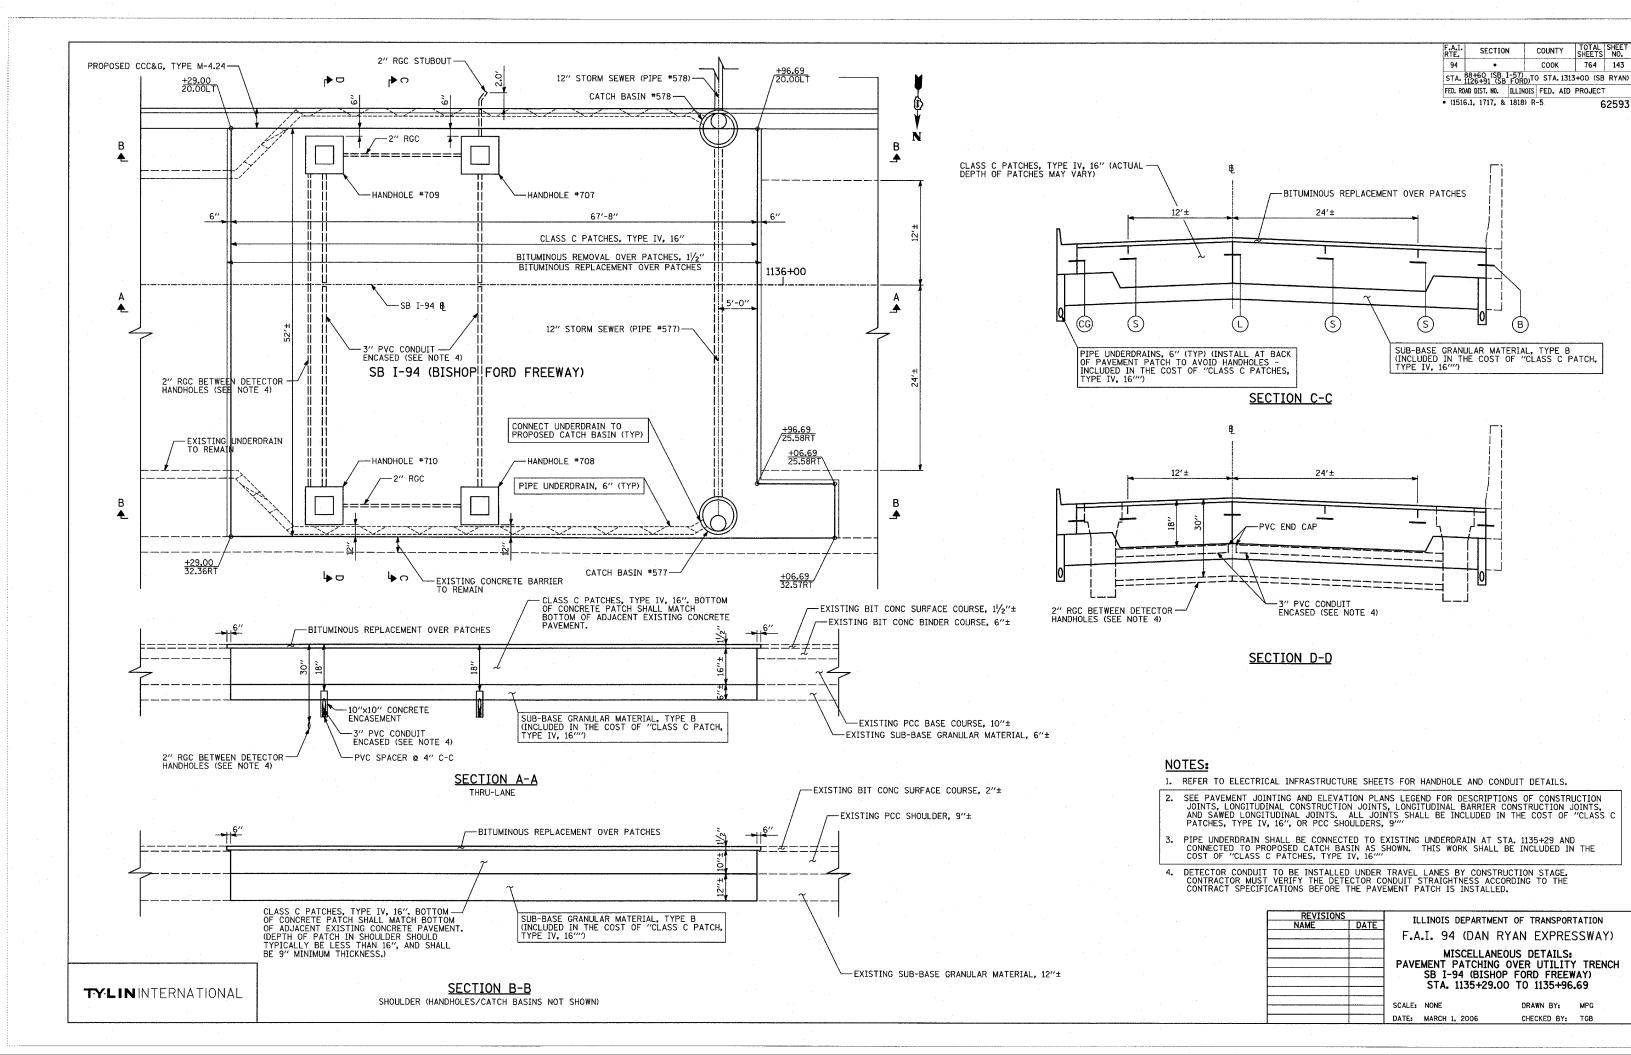

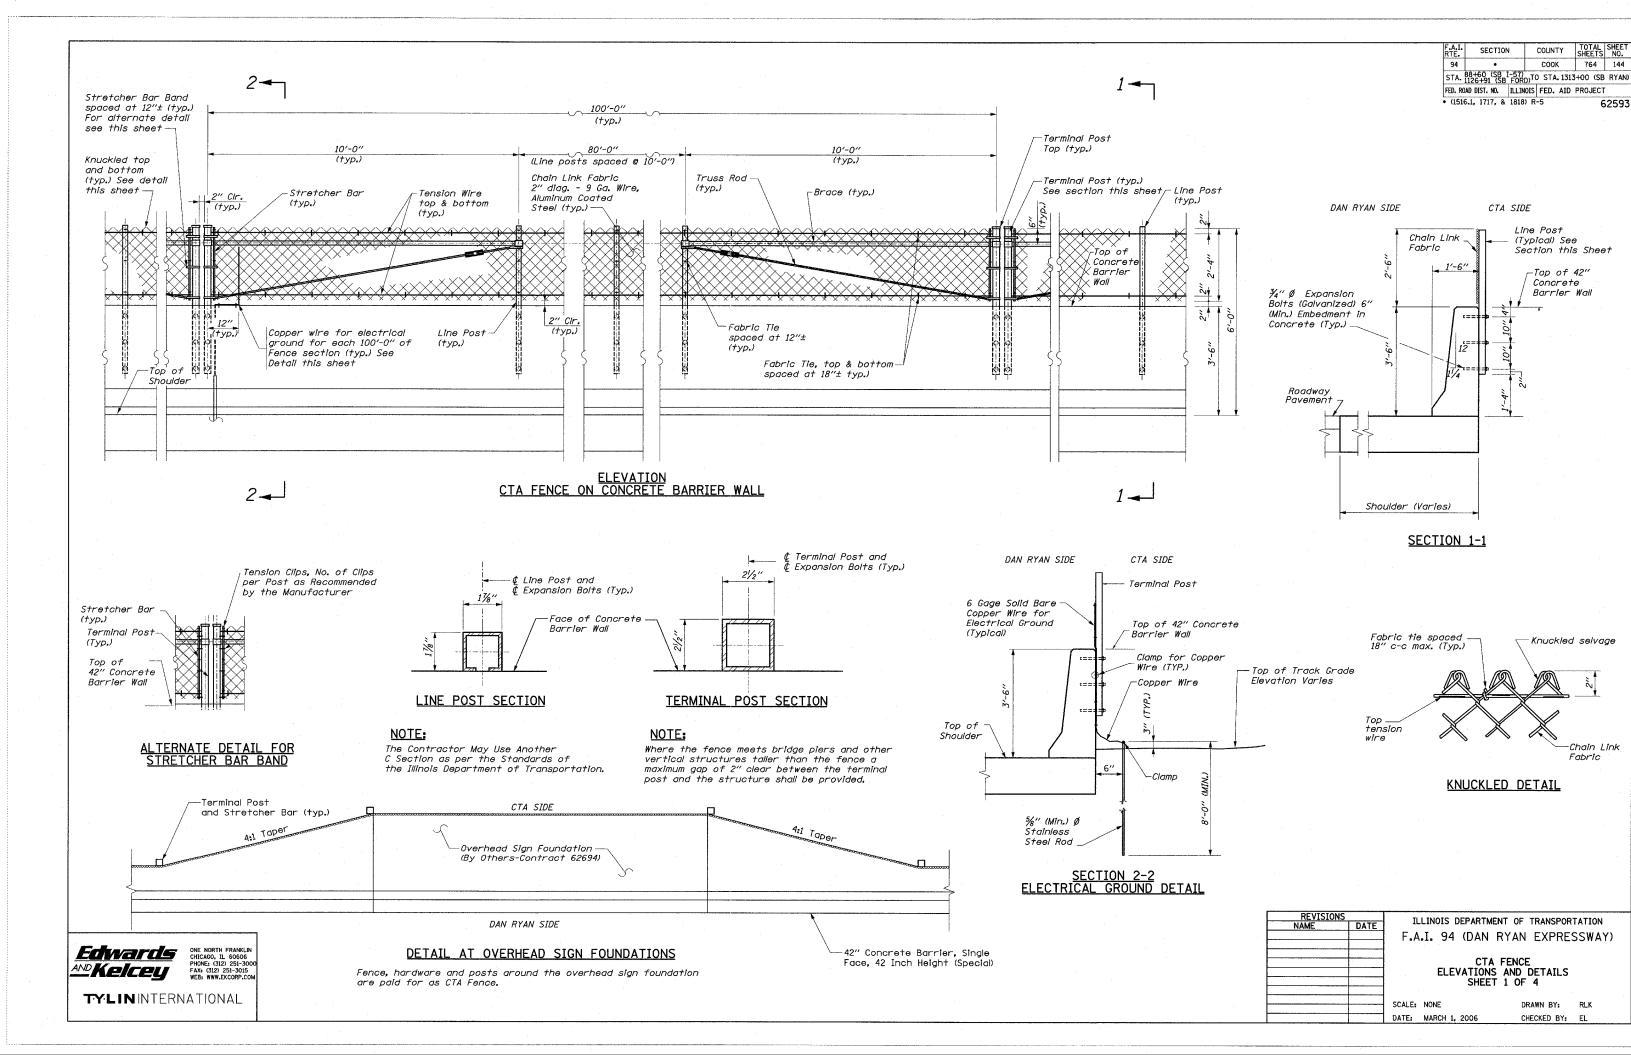

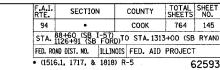


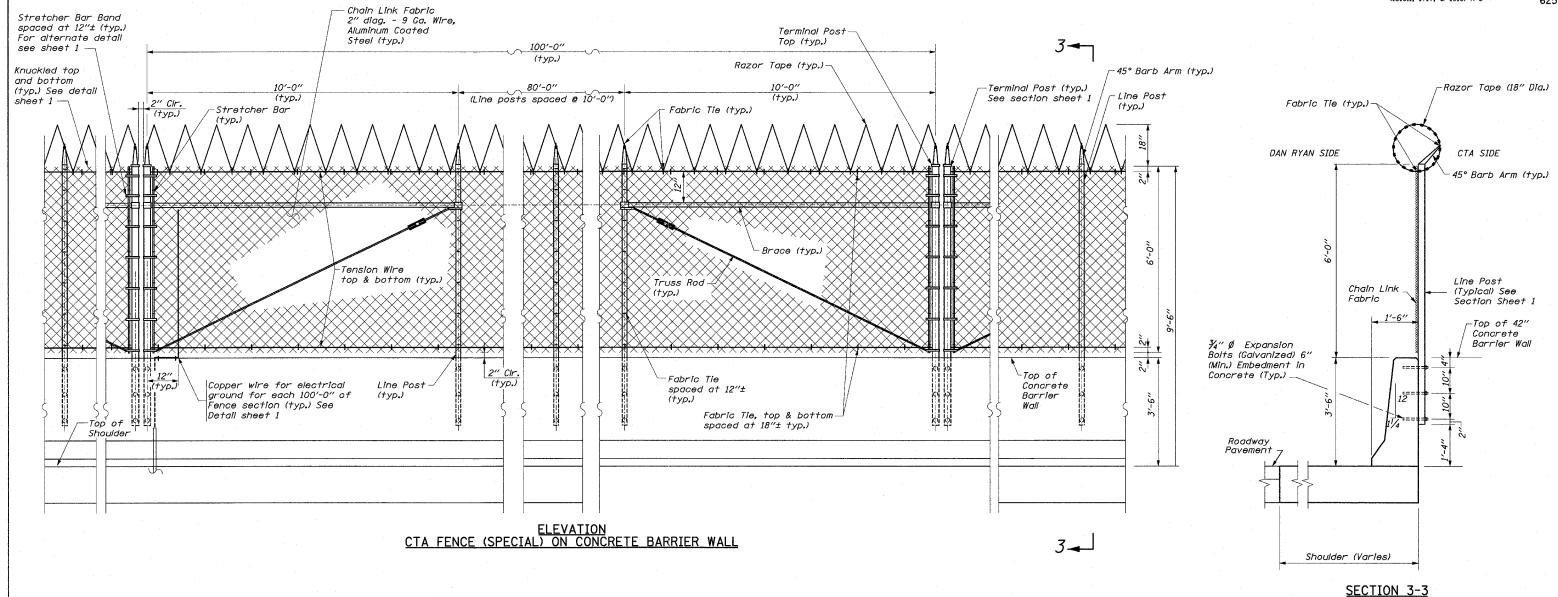

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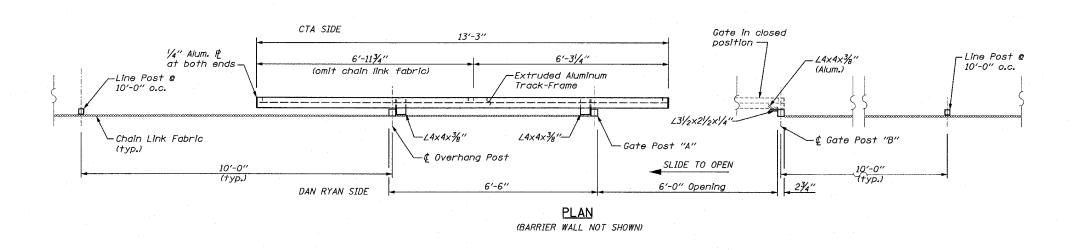
Where the fence meets bridge piers and other vertical structures taller than the fence a maximum gap of 2" clear between the terminal post and the structure shall be provided.


REVISIONS		ILLINOIS DEPARTMENT OF TRANSPORTATION						
NAME D	ATE 10	TECTION OF ANY MENT OF THANS ON TAIL						
	F.A	.I. 94	(DAN	RYAN	EXPRE	SSWAY)	
		OTA FENOR (CDEOTAL)						
		CTA FENCE (SPECIAL)						
		ELEVATIONS AND DETAILS						
		SHEET 2 OF 4						
	SCALE:	NONE		DR	AWN BY:	MPG		
	DATE.	MARCH 1.	2006	CH	ECKED BY:	TGB		
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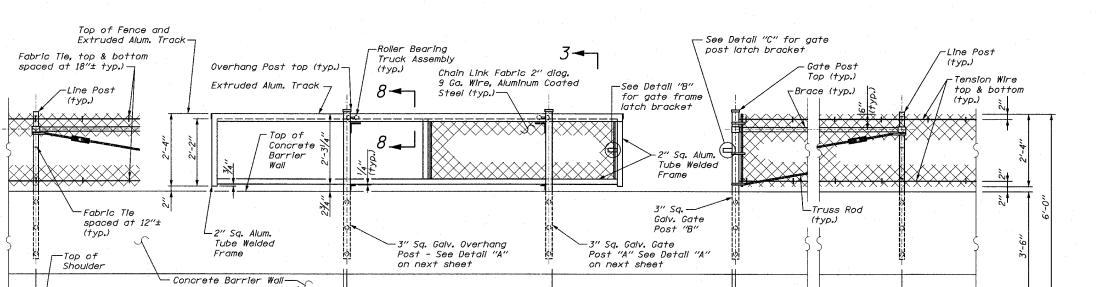


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DAN RYAN SIDE CTA SIDE rExtruded Alum. Track Chain Link Fabric 2" Sq. Alum. Tube Welded Frame L4×4×3/8" 3" Sq. Galv. Post Top of 42" Concrete L31/2×21/2×1/4" Barrier Wall (Alum.) ¾″ Ø Expansion Bolts (Galvanized) 6" (Min.) Embedment in Concrete (Typ.) 1'-6"

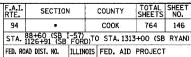ELEVATION
CTA FENCE & CTA GATE

(FOOTING NOT SHOWN)

6'-6"

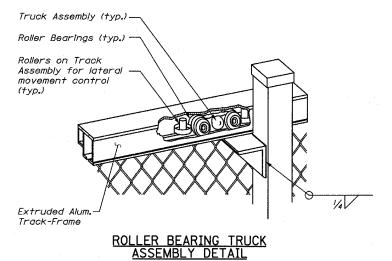3-

6'-0"

10'-0" (typ.)

SECTION 3-3

REVISIONS IL NAME DATE F.A

ILLINOIS DEPARTMENT OF TRANSPORTATION F.A.I. 94 (DAN RYAN EXPRESSWAY)

CTA FENCE ELEVATIONS AND DETAILS SHEET 3 OF 4


SCALE: NONE
DATE: MARCH 1, 2006

DRAWN BY: RLK
CHECKED BY: EL

AND KEICEU

ONE NORTH FRANKLIN CHICAGO, IL 60606
PHONE: (312) 251-3005
WEB: WWW.EKCORP.COM


10'-0"

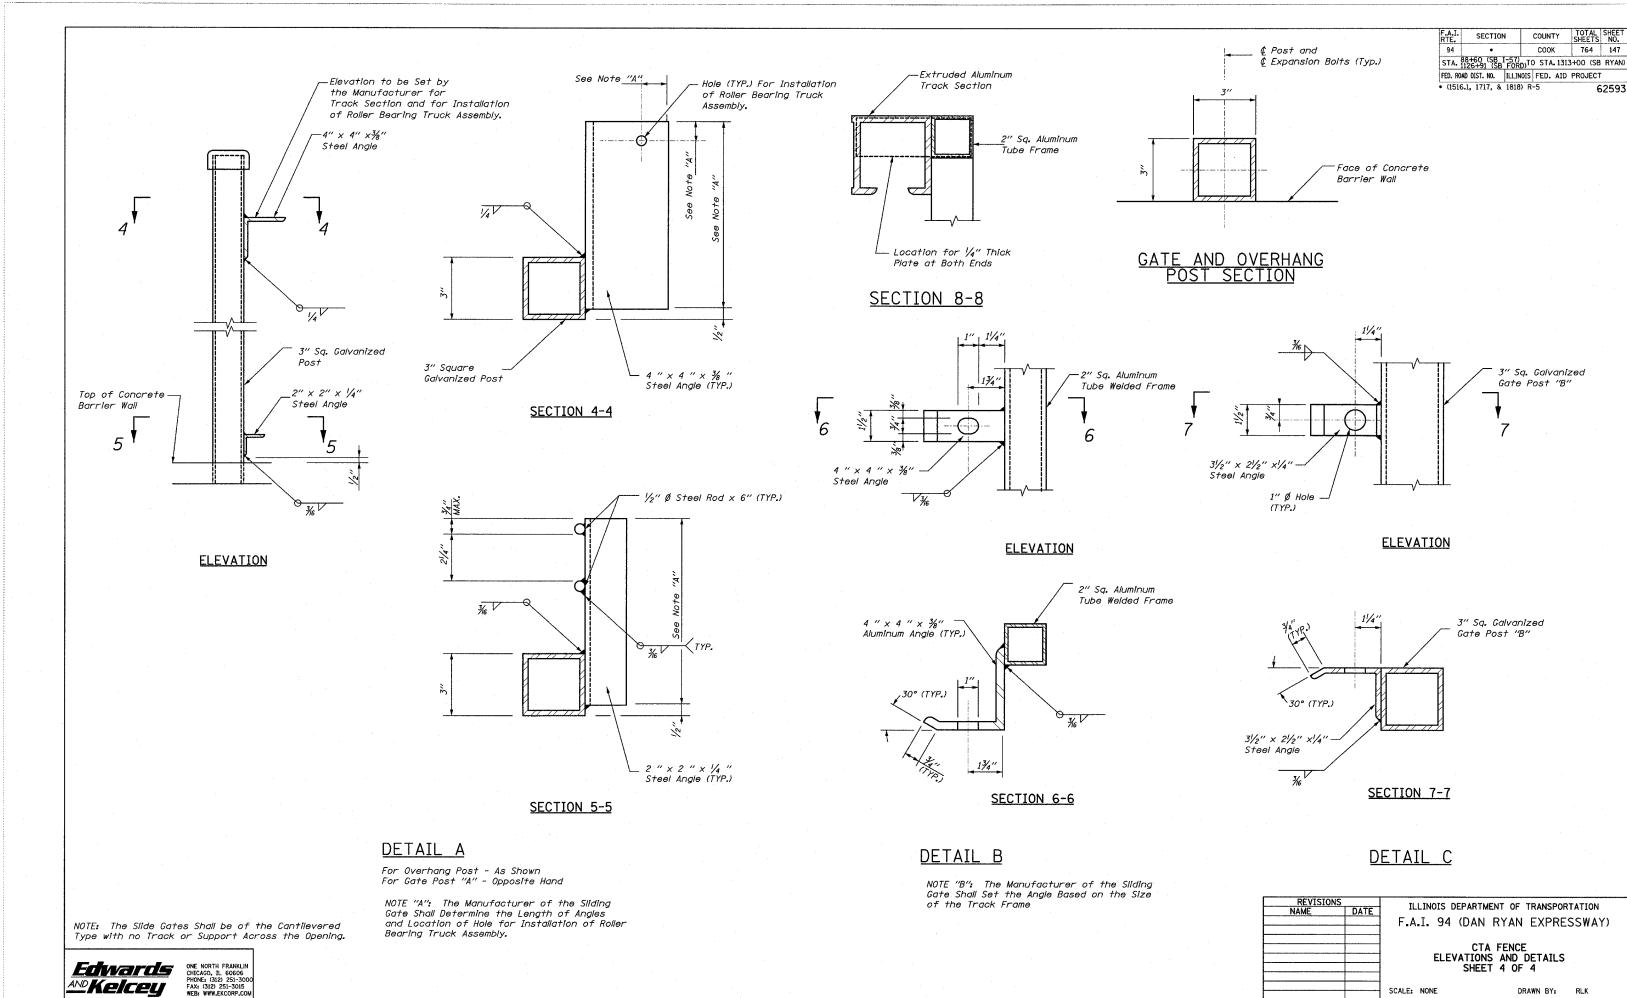


<u> AND Kelceu</u>


SCALE: NONE DRAWN BY: RLK CHECKED BY: EL


DATE: MARCH 1, 2006

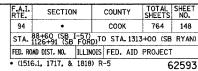

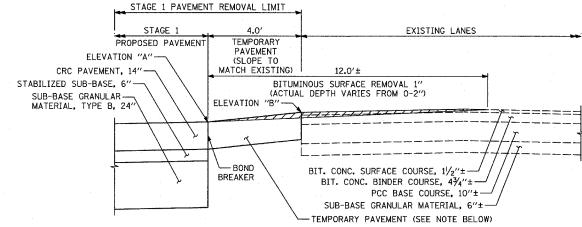


DETAIL OF MAINLINE TEMPORARY PAVEMENT FOR POST-STAGE 1 WINTER LANE CONFIGURATION USE WHERE ELEVATION "A" IS MORE THAN 2" BELOW ELEVATION "B" SEE MAINTENANCE OF TRAFFIC PLANS FOR LOCATIONS

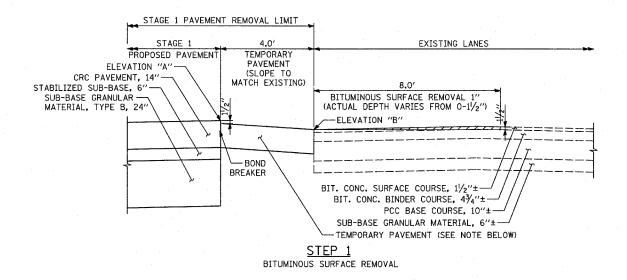

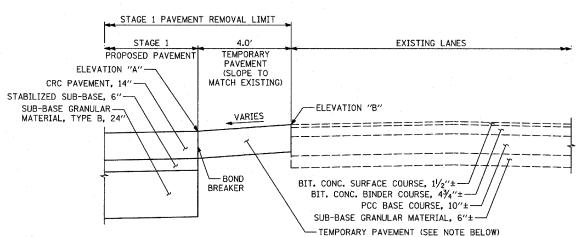

DETAIL OF MAINLINE TEMPORARY PAVEMENT FOR POST-STAGE 1 WINTER LANE CONFIGURATION USE WHERE ELEVATION "A" IS 0-2" BELOW ELEVATION "B" SEE MAINTENANCE OF TRAFFIC PLANS FOR LOCATIONS

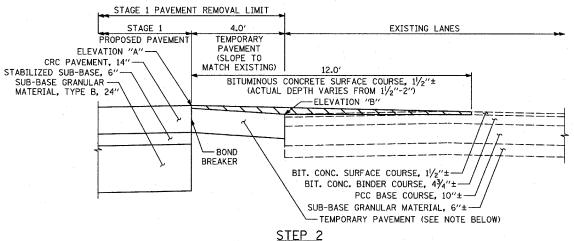

PLACEMENT OF BITUMINOUS SURFACE COURSE

NOTE: CONTRACTOR MUST USE A 14" THICK CONCRETE TEMPORARY PAVEMENT OPTION. ADDITIONAL THICKNESS OF CONCRETE TEMPORARY PAVEMENT WILL NOT BE PAID FOR SEPARATELY BUT BE INCLUDED IN THE COST OF THE TEMPORARY

PAVEMENT.

ILLINOIS DEPARTMENT OF TRANSPORTATION F.A.I. 94 (DAN RYAN EXPRESSWAY)


MISCELLANEOUS DETAILS TEMPORARY PAVEMENT & MILLING OPERATIONS


SCALE: AS SHOWN DATE: MARCH 1, 2006


DRAWN BY: MPG CHECKED BY: TGB

COUNTY TOTAL SHEET SHEETS NO. SECTION COOK 764 149 STA. 88+60 (SB I-57) STA. 1126+91 (SB FORD)TO STA. 1313+00 (SB RYAN) FED. ROAD DIST. NO. | ILLINOIS | FED. AID PROJECT • (1516.1, 1717, & 1818) R-5

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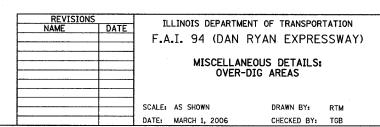


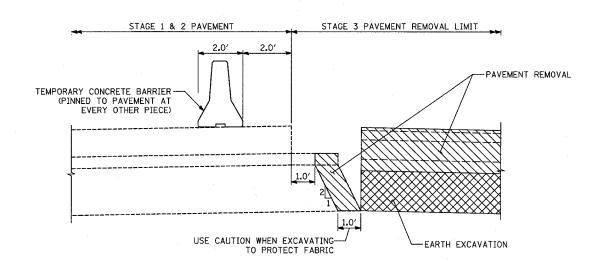


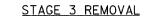STAGE 3 PAVEMENT

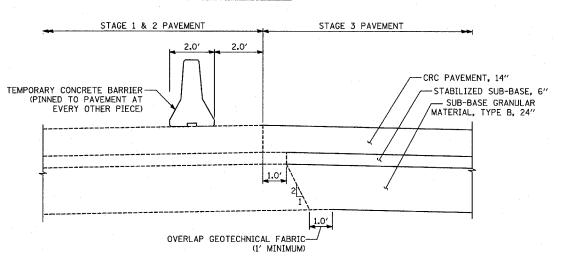
NOTES:

- 1. THESE SECTIONS DEPICT MAINLINE DAN RYAN. SIMILAR SITUATIONS OCCUR ALONG 1-57 WITH A LESSER NUMBER OF LANES, BUT SAME CONSTRUCTION REQUIREMENTS.
- 2. STAGE 2A WILL REQUIRE A 3.0' WIDE STRIP OF TEMPORARY PAVEMENT BETWEEN SB I-94 STA. 1260+00 AND STA. 1270+00. ADDITIONAL THICKNESS OF CONCRETE WILL BE INCLUDED IN THE COST OF THE TEMPORARY PAVEMENT.




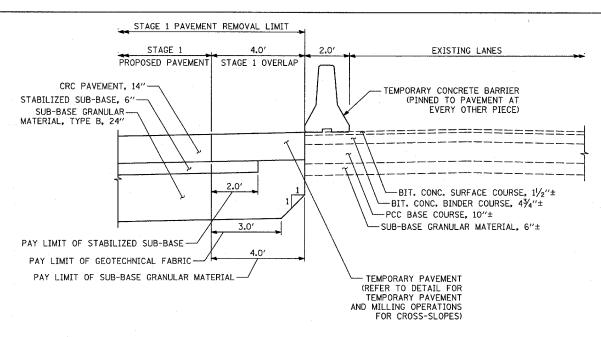

STAGE 1 PAVEMENT

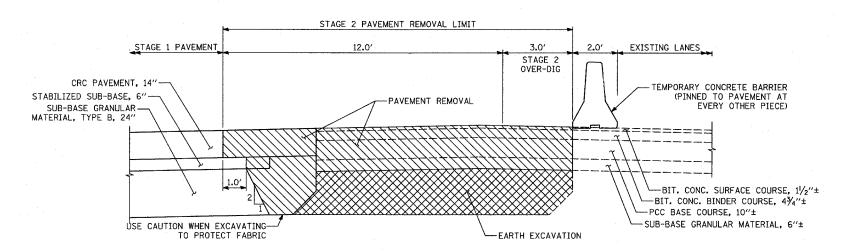

STAGE 2 REMOVAL & OVER-DIG

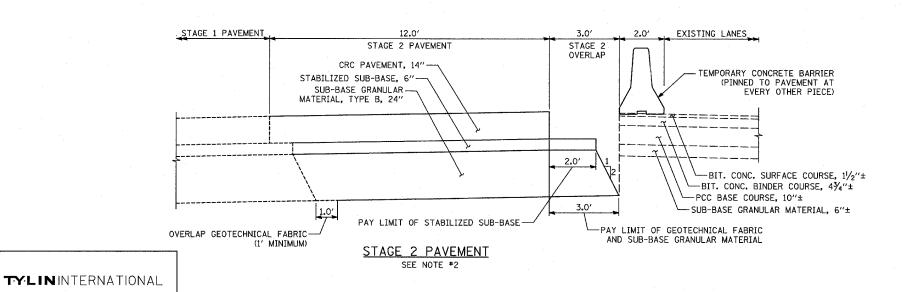


COUNTY TOTAL SHEETS NO.

COOK 764 150 SECTION STA. 88+60 (SB I-57) TO STA. 1313+00 (SB RYAN) FED. ROAD DIST. NO. ILLINOIS FED. AID PROJECT


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• (1516.1, 1717, & 1818) R-5

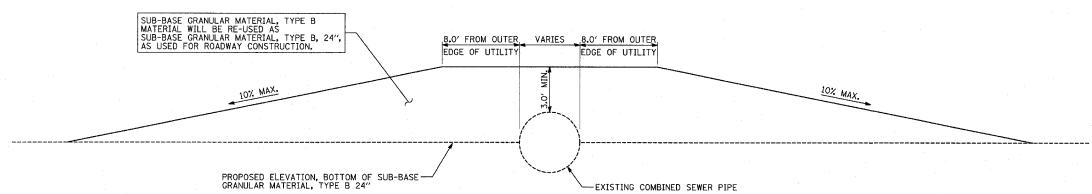

COMBINED SEWER CONSTRUCTION PROTECTION

(SEE COMBINED SEWER CROSSING STATIONS)

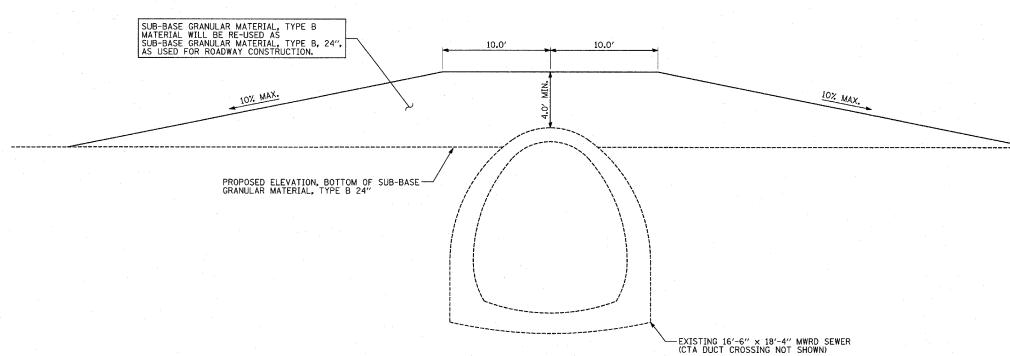

16'-6" X 18'-4" MWRD SEWER - SB I-94 STA. 1358+93.46

CTA DUCT - SB I-94 STA. 1314+13.59

CTA DUCT - SB I-57 STA. 151+94.38

CONSTRUCTION PROTECTION

COMBINED SEWER CROSSING STATIONS:

- 1. SB I-57 STA. 90+32.99 (60")
- SB I-57 STA. 130+21.70/ WB I-94 TO I-57 CONN. STA. 342+09.91 (5'-8" x 3'-7" BOX)
- 3. SB I-57 STA. 143+31.38 (7'-6" x 6'-0" DOUBLE BOX)
- 4. SB I-94 STA. 1245+59.70 (48")
- 5. SB I-94 STA. 1265+92.81 (DOUBLE 48")
- 6. SB I-94 STA. 1279+30.52 (TRIPLE 48")
- SB I-94 STA. 1325+70.55 (10'-0" x 8'-0" BOX)
- 8. SB I-94 STA. 1345+70.10 (60")

NOTES:

- CONTRACTOR WILL PROVIDE A MINIMUM COVER, AS SHOWN ABOVE AT ALL TIMES DURING CONSTRUCTION AND PRIOR TO THE INSTALLATION OF THE PERMANENT PROTECTION SLAB AND/OR ROADWAY. CONSTRUCTION TRAFFIC SHALL NOT CROSS THE UTILITIES WITHOUT TEMPORARY COVER OR PERMANENT SLAB IN PLACE.
- CONTRACTOR IS RESPONSIBLE FOR THE INTEGRITY OF SEWER PIPE THROUGH THE DURATION OF THE PROJECT, AND WILL NOT BE PAID FOR ANY REPAIRS REQUIRED, AS DETERMINED BY THE ENGINEER, TO THE PIPE, DUE TO CONSTRUCTION ACTIVITIES.
- VACUUM EXCAVATION OR HAND DIGGING MUST BE USED WITHIN 2'-O" OF THE EXISTING 16'-6" \times 18'-4" MWRD SEWER AND CTA DUCTS ONLY.

REVISIONS NAME	DATE			DEPARTA			TATION SSWAY
				SCELLA ZONE L			
		SCALE:	NONE		DRAWN	BY:	MPG


DATE: MARCH 1, 2006

CHECKED BY: TGB

F.A.I. RTE.	SECTION		COUNTY		TOTAL SHEETS	SHEET NO.
94	•		COOL	соок		151
STA.	88+60 (SB) 1126+91 (SB	-57) FORE)TO STA	. 1313	+00 (SB	RYAN)
			DIS FED.			
• (151	6.1, 1717, &	1818)	R-5		6	2593

62593

SOIL RETENTION SCHEDULE

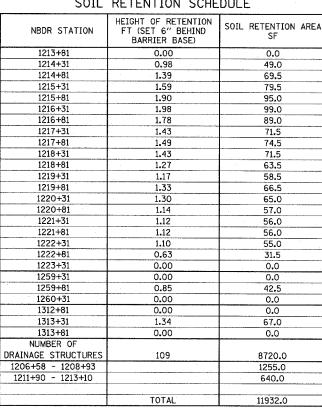

PROPOSED & SB I-94 TEMPORARY PROPOSED B SB I-94 - TEMPORARY FENCE FENCE - MINIMUM DISTANCE TO CTA TRACK CENTERLINE MINIMUM DISTANCE TO CTA TRACK CENTERLINE - 1:1 SLOPE PROPOSED PAVEMENT SECTION PROPOSED PAVEMENT SECTION FOR EXCAVATION ALONG CTA TRACK 1:1 SLOPE FOR EXCAVATION ALONG CTA TRACK HEIGHT OF SOIL RETENTION REQUIRED AT BACK OF BARRIER BASE/SUBBASE HEIGHT OF SOIL RETENTION, 0.5' RT. FROM BACK OF BARRIER BASE/SUBBASE (0.77' + 6") SOIL RETENTION SYSTEM

TEMP SOIL SUPPORT REQUIRED

TEMP SOIL SUPPORT NOT REQUIRED

CALCULATION OF HEIGHT OF TEMP SOIL SUPPORT

- * 80 SF OF EARTH RETENTION IS REQUIRED FOR EACH DRAINAGE STRUCTURE. SEE DRAINAGE SCHEDULES FOR DRAINAGE STRUCTURES REQUIRING EARTH RETENTION
- ** AREA REFLECTS EARTH RETENTION SYSTEM REQUIRED IN ADDITION TO THAT REQUIRED FOR THE PROPOSED DRAINAGE STRUCTURES, SEE SHEET 114.

REVISION:	s I	ILLINOIS DEPARTMENT OF TRANSPORTATION
NAME	DATE	ILLINOIS DEPARTMENT OF TRANSPORTATION
		F.A.I. 94 (DAN RYAN EXPRESSWAY)
		MISCELLANEOUS DETAILS
		TEMPORARY SOIL RETENTION


SECTIONS AND SCHEDULE

SCALE: NONE DATE: MARCH 1, 2006

DRAWN BY: JJS CHECKED BY: JPM/SP

BENCHING DETAIL FOR EMBANKMENT N.T.S.

VARIES VARIES

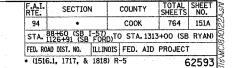

LEGEND:

EARTH EXCAVATION (SPECIAL)

REMOVAL AND DISPOSAL OF UNSUITABLE MATERIAL

NOTES:

DEVICTORS

- 1. SEE LANDSCAPING PLANS AND DETAILS FOR TOPSOIL AND SEEDING TYPES.
- THE EXCAVATION OF THE TOP 6" OF EXISTING SOIL SHALL BE PAID FOR AS "REMOVAL AND DISPOSAL OF UNSUITABLE MATERIAL."
- 3. CONSTRUCT SUCCEEDING BENCH CUTS AND EMBANKMENT PLACEMENT AND COMPACTION FROM BOTTOM TO TOP IN STAIRSTEP FASHION.
- 4. EXISTING FORESLOPE PREPARED IN ACCORDANCE WITH ARTICLE 205.04 OF THE STANDARD SPECIFICATIONS.
- 5. BENCH CUT EXISTING SLOPE TYPICAL FOR EACH STEP.
- 6. EQUAL 6-INCH LIFTS OF EMBANKMENT COMPACTED IN ACCORDANCE WITH ARTICLE 205.06 OF THE STANDARD SPECIFICATIONS.
- 7. EXCAVATION OF BENCH CUTS WITHIN EXISTING EMBANKMENT WILL BE PAID FOR AT THE CONTRACT UNIT PRICE PER CUBIC YARD FOR "EARTH EXCAVATION (SPECIAL)". THIS PRICE WILL INCLUDE ALL LABOR AND MATERIAL. NO ADDITIONAL COMPENSATION WILL BE ALLOWED.
- 8. SEE CROSS SECTIONS SHEETS FOR EMBANKMENT AREAS THAT NEED TO BE BENCHED.

EARTH EXCAVATION (SPECIAL) SCHEDULE

REMOVAL AND DISPOSAL OF

UNSUITABLE MATERIAL

ALIGNMENT	STAT	EARTH	
	FROM	то	(SPECIAL) (CU YD)
SB I-57	144+00	145+80	50
SB I-94	1265+50	1269+00	65
		TOTAL	115

RDT-12


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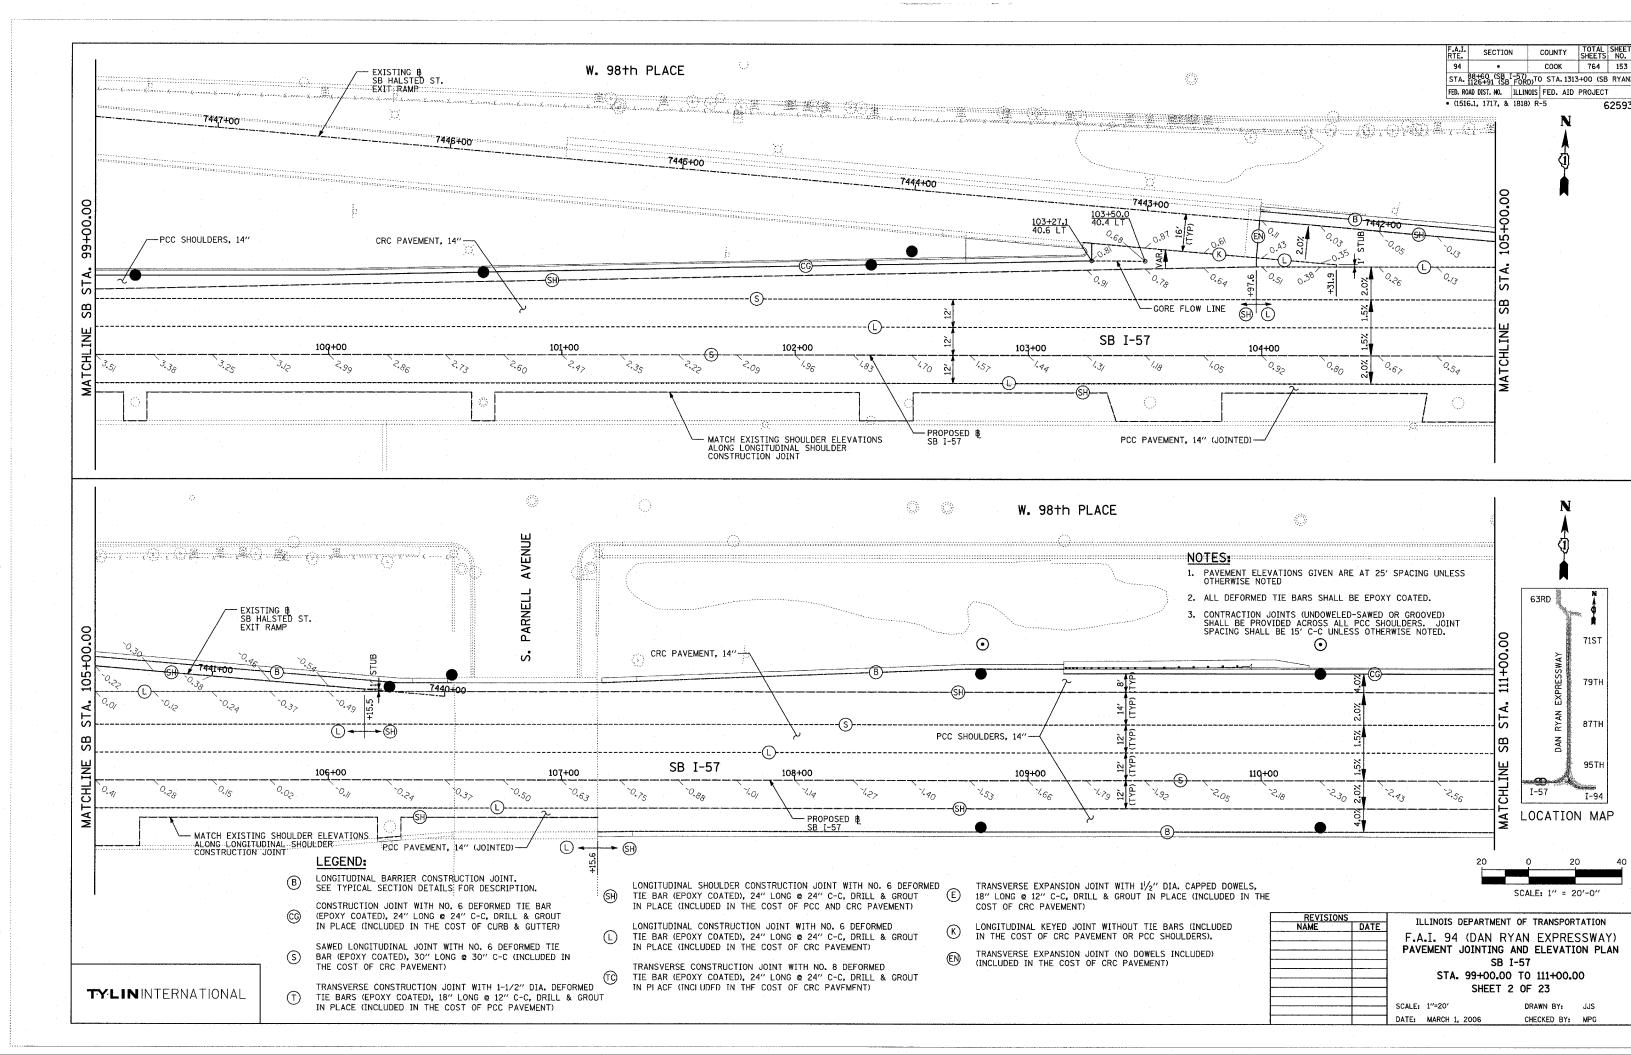
UF A 12101		ILLINGIS DEPARTMENT OF TRANSPORTATION
NAME	DATE	F.A.I. 90/94 (DAN RYAN EXPRESSWAY)
		63RD STREET TO 55TH STREET (NB LOCAL LANES)
		ROADWAY DETAILS BENCHING DETAIL FOR EMBANKMENT
		SCALE: NONE DRAWN BY: NJH


DATE: April 7, 2006


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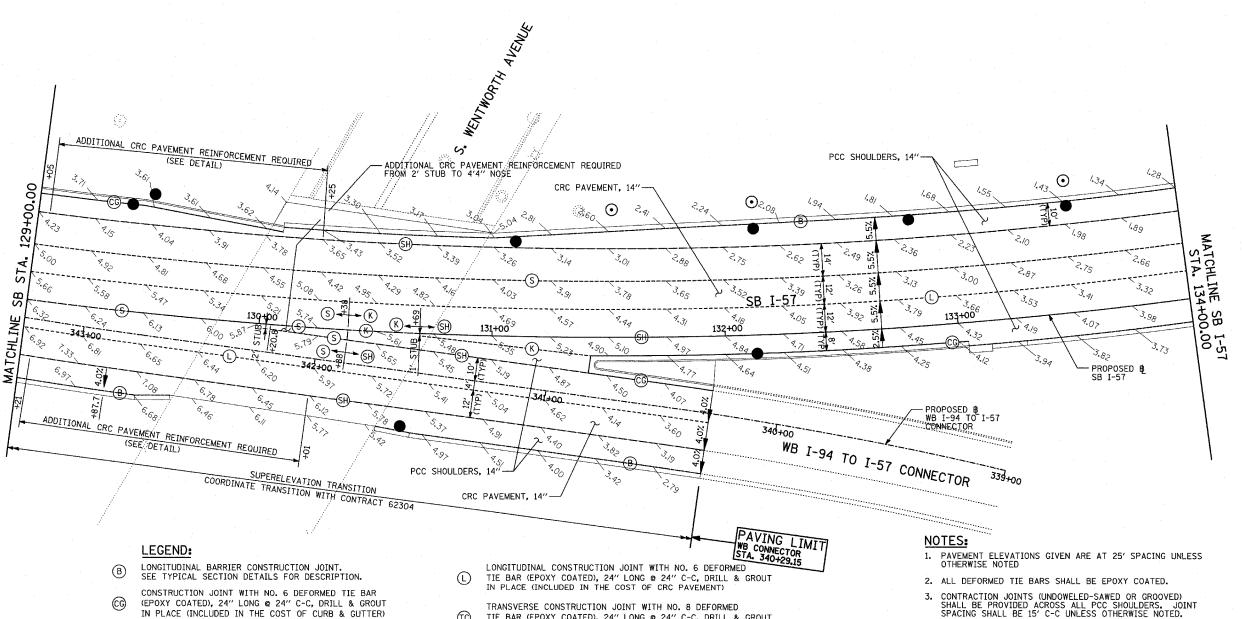
COUNTY


TOTAL SHEE' SHEETS NO. SECTION COUNTY COOK 764 156 STA. 88+60 (SB I-57) 1126+91 (SB FORD)TO STA. 1313+00 (SB RYAN FED. ROAD DIST. NO. | ILLINOIS | FED. AID PROJECT

• (1516.1, 1717, & 1818) R-5

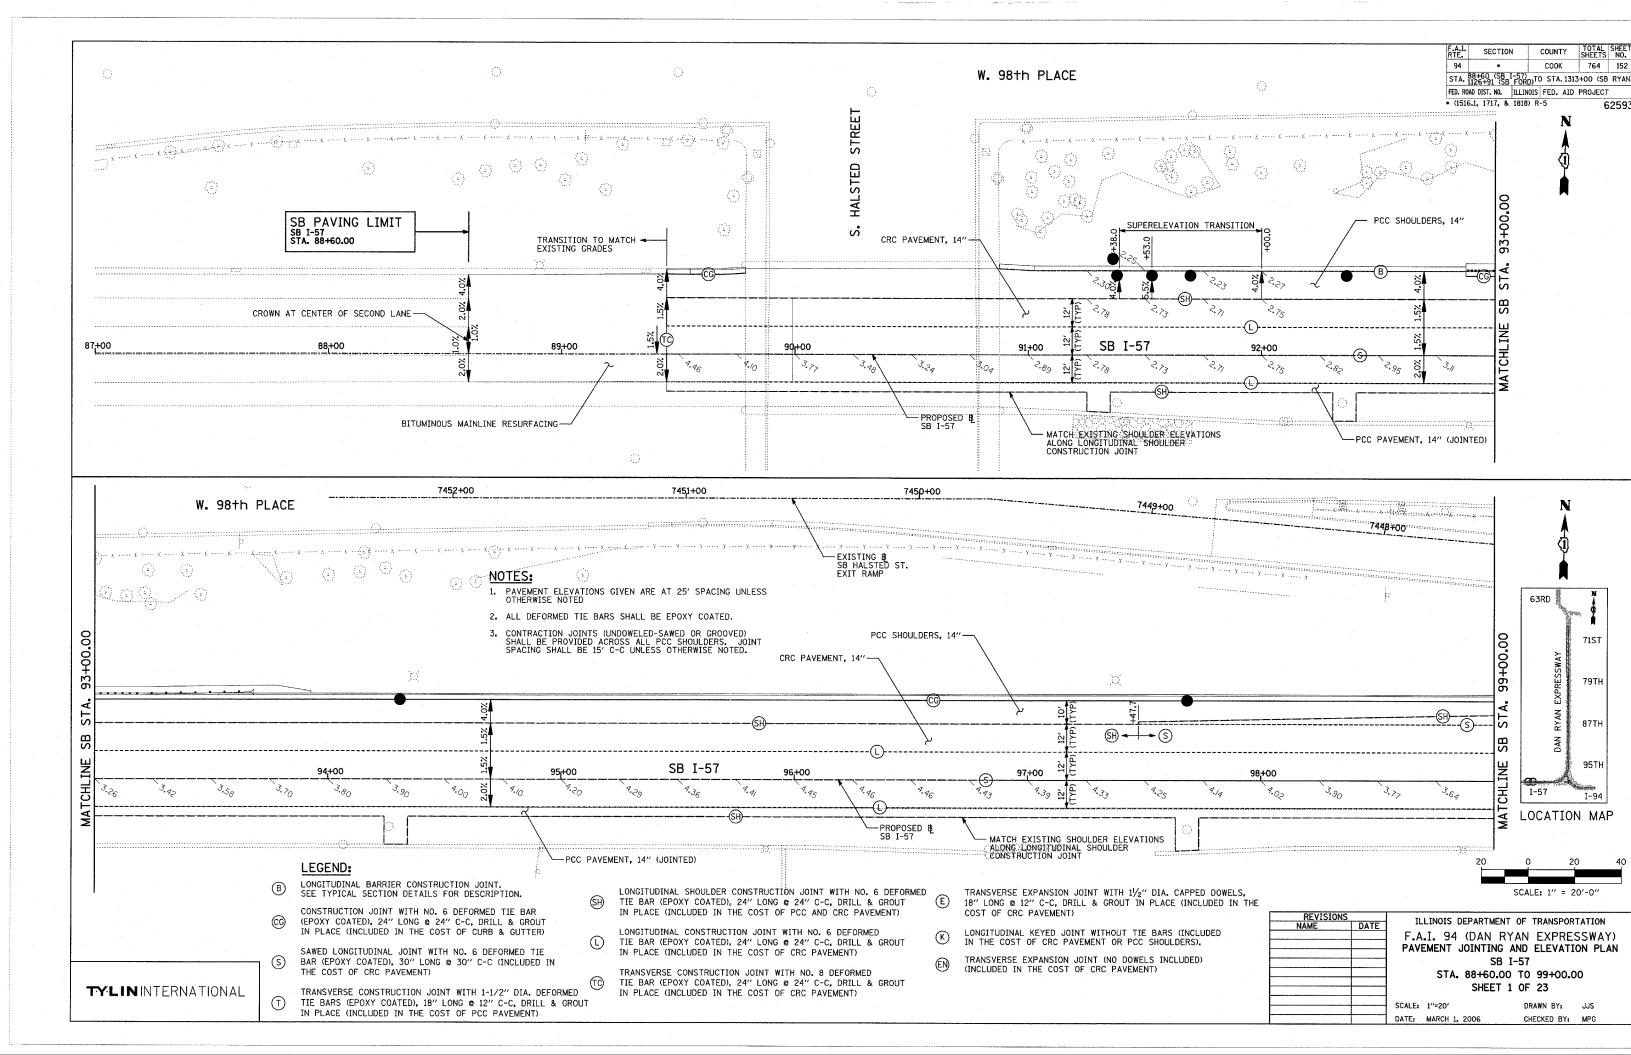
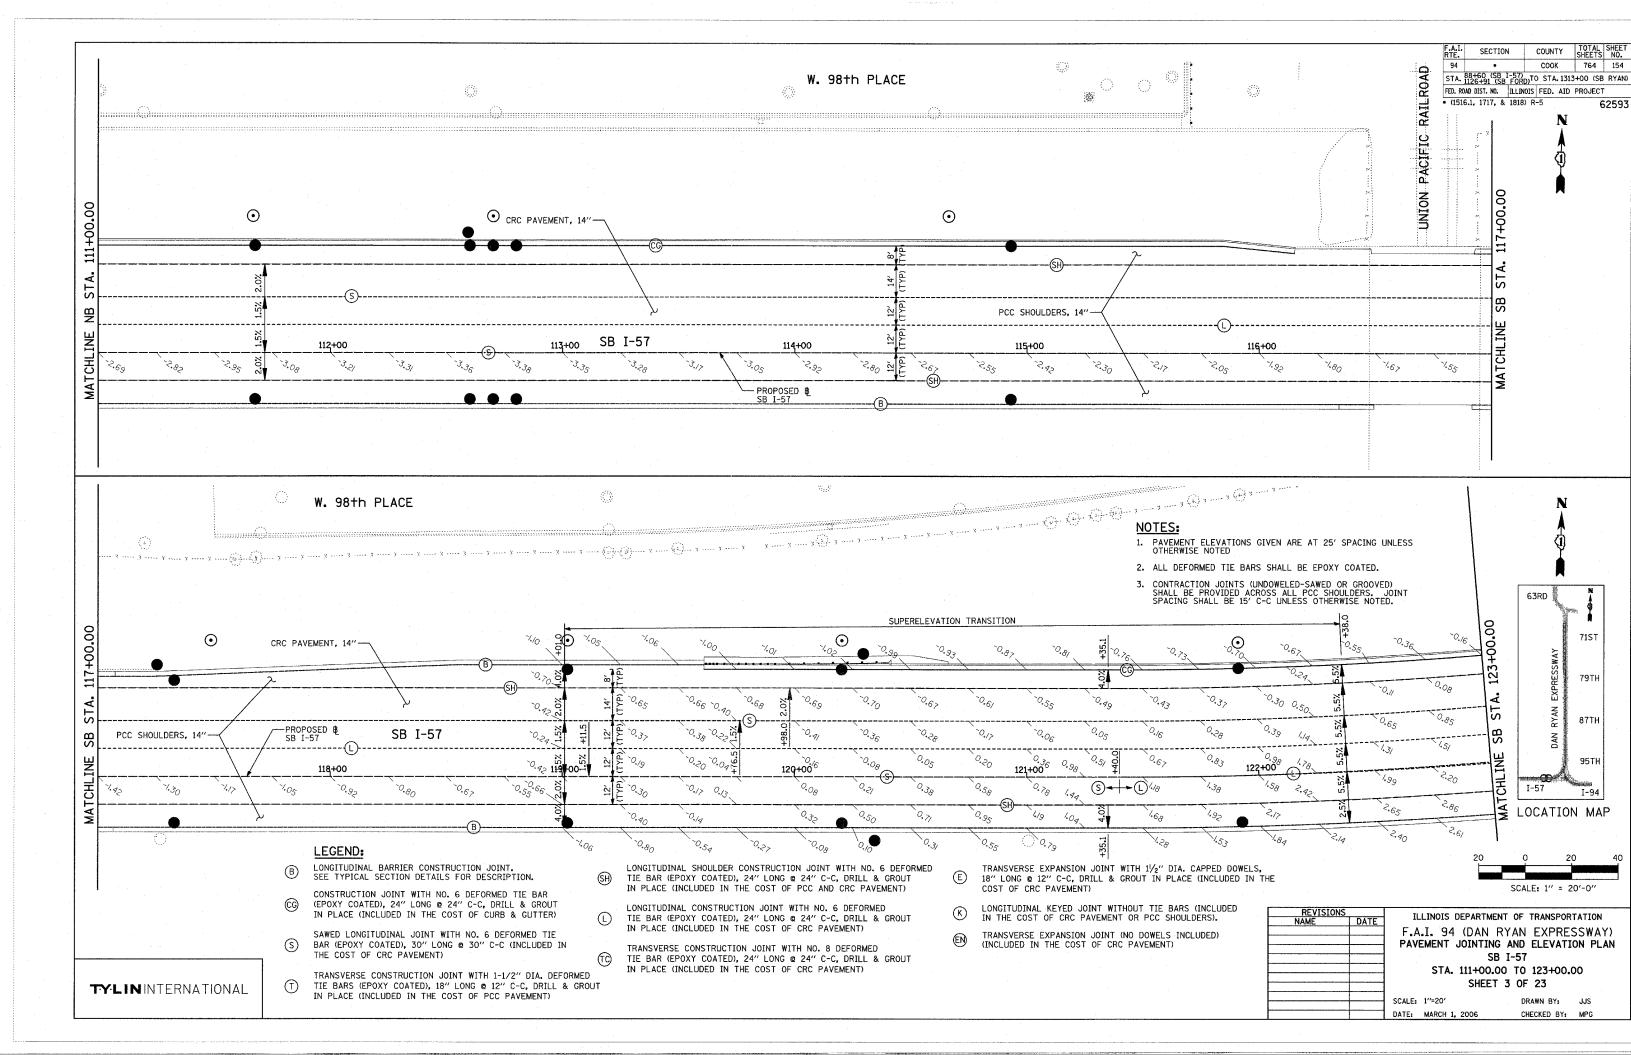
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3. CONTRACTION JOINTS (UNDOWELED-SAWED OR GROOVED) SHALL BE PROVIDED ACROSS ALL PCC SHOULDERS. JOINT SPACING SHALL BE 15' C-C UNLESS OTHERWISE NOTED.

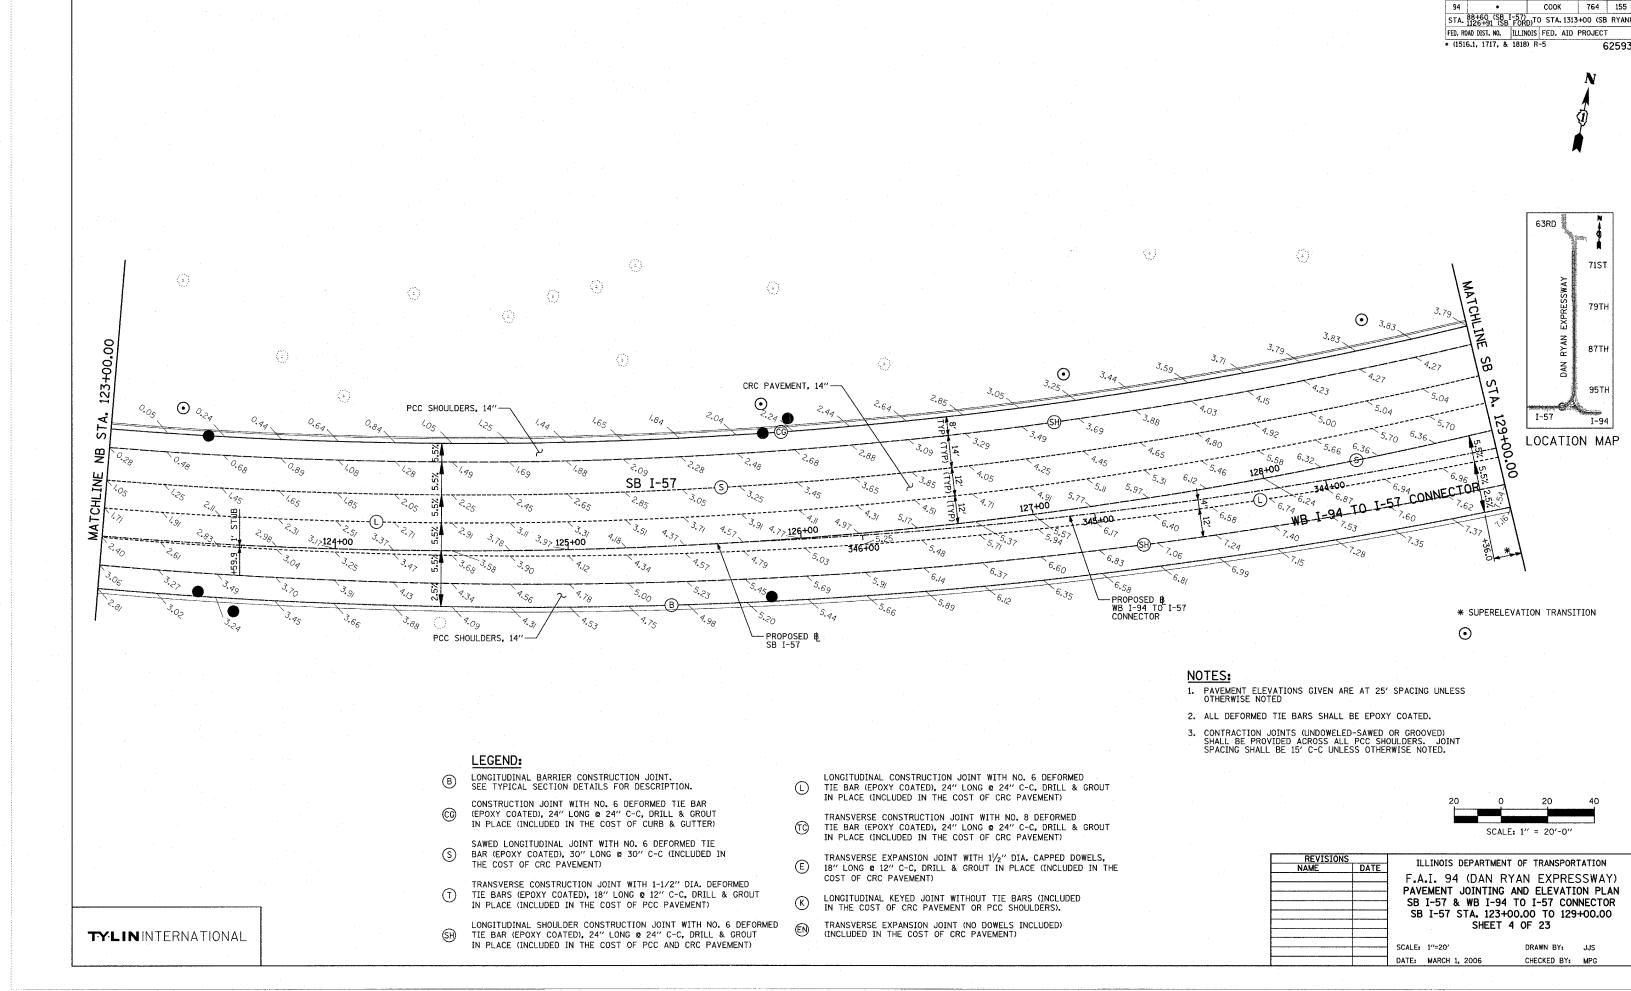

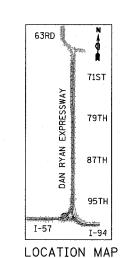REVISIONS		THE THOSE DE	DADTMENT OF	TRANSPORTATION	
NAME	DATE	ILLINOIS DE	FARIMENT OF	INANSPURTATION	
		F.A.I. 94 (DAN RYAN	EXPRESSWAY	')
		DAVENENT IC	THITTHIS AND	ELEVATION DIA	
		PAVEMENI JU	JIN LING AND	ELEVATION PLA	N
		SB I-57 & V	NB I-94 TO 1	I-57 CONNECTOR	₹
		SB I-57 STA.	129+00.00 T	O STA. 134+00.	.00
			SHEET 5 OF		
			SHELL S OF	23	
	i				

SCALE: 1"=20" DATE: MARCH 1, 2006 DRAWN BY: JJS CHECKED BY: MPG

TYLININTERNATIONAL

LONGITUDINAL SHOULDER CONSTRUCTION JOINT WITH NO. 6 DEFORMED EN TIE BAR (EPOXY COATED), 24" LONG @ 24" C-C, DRILL & GROUT IN PLACE (INCLUDED IN THE COST OF PCC AND CRC PAVEMENT)

TRANSVERSE CONSTRUCTION JOINT WITH 1-1/2" DIA. DEFORMED TIE BARS (EPOXY COATED), 18" LONG @ 12" C-C, DRILL & GROUT IN PLACE (INCLUDED IN THE COST OF PCC PAVEMENT)

SAWED LONGITUDINAL JOINT WITH NO. 6 DEFORMED TIE BAR (EPOXY COATED), 30" LONG @ 30" C-C (INCLUDED IN


THE COST OF CRC PAVEMENT)


TRANSVERSE CONSTRUCTION JOINT WITH NO. 8 DEFORMED TIE BAR (EPOXY COATED), 24" LONG @ 24" C-C, DRILL & GROUT IN PLACE (INCLUDED IN THE COST OF CRC PAVEMENT)

TRANSVERSE EXPANSION JOINT WITH $1/\!\!\!/_2$ " DIA. CAPPED DOWELS, 18" LONG @ 12" C-C, DRILL & GROUT IN PLACE (INCLUDED IN THE COST OF CRC PAVEMENT)


LONGITUDINAL KEYED JOINT WITHOUT TIE BARS (INCLUDED IN THE COST OF CRC PAVEMENT OR PCC SHOULDERS).

TRANSVERSE EXPANSION JOINT (NO DOWELS INCLUDED) (INCLUDED IN THE COST OF CRC PAVEMENT)

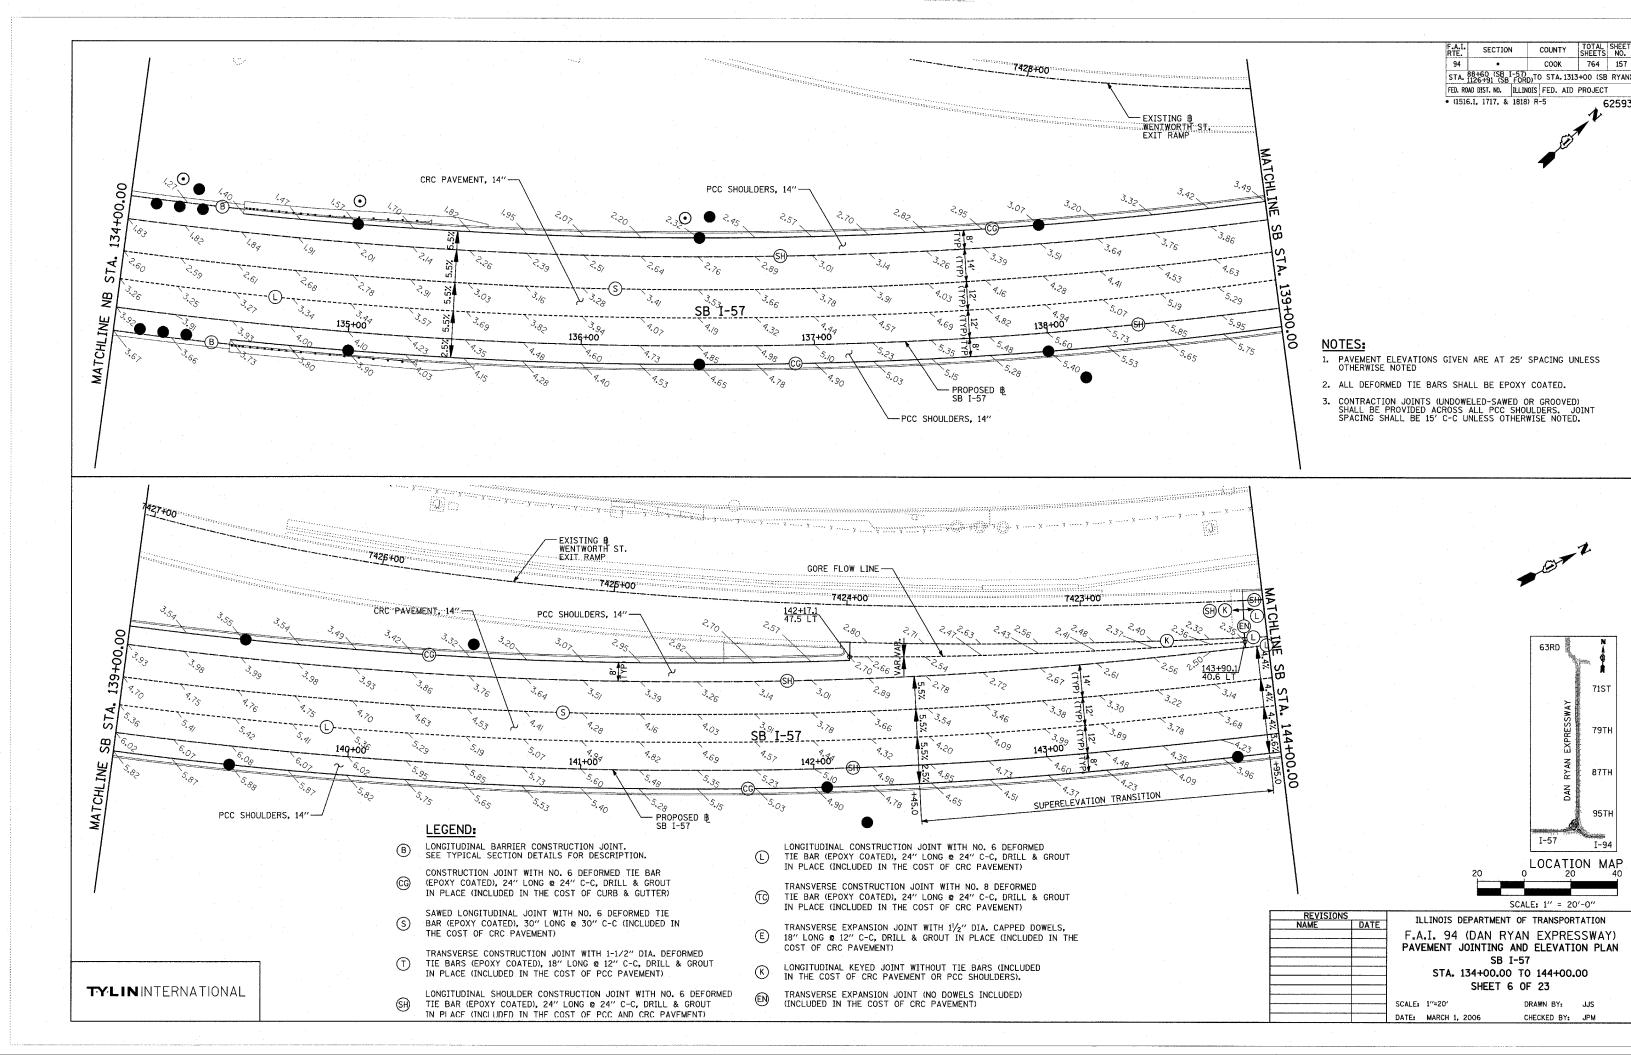

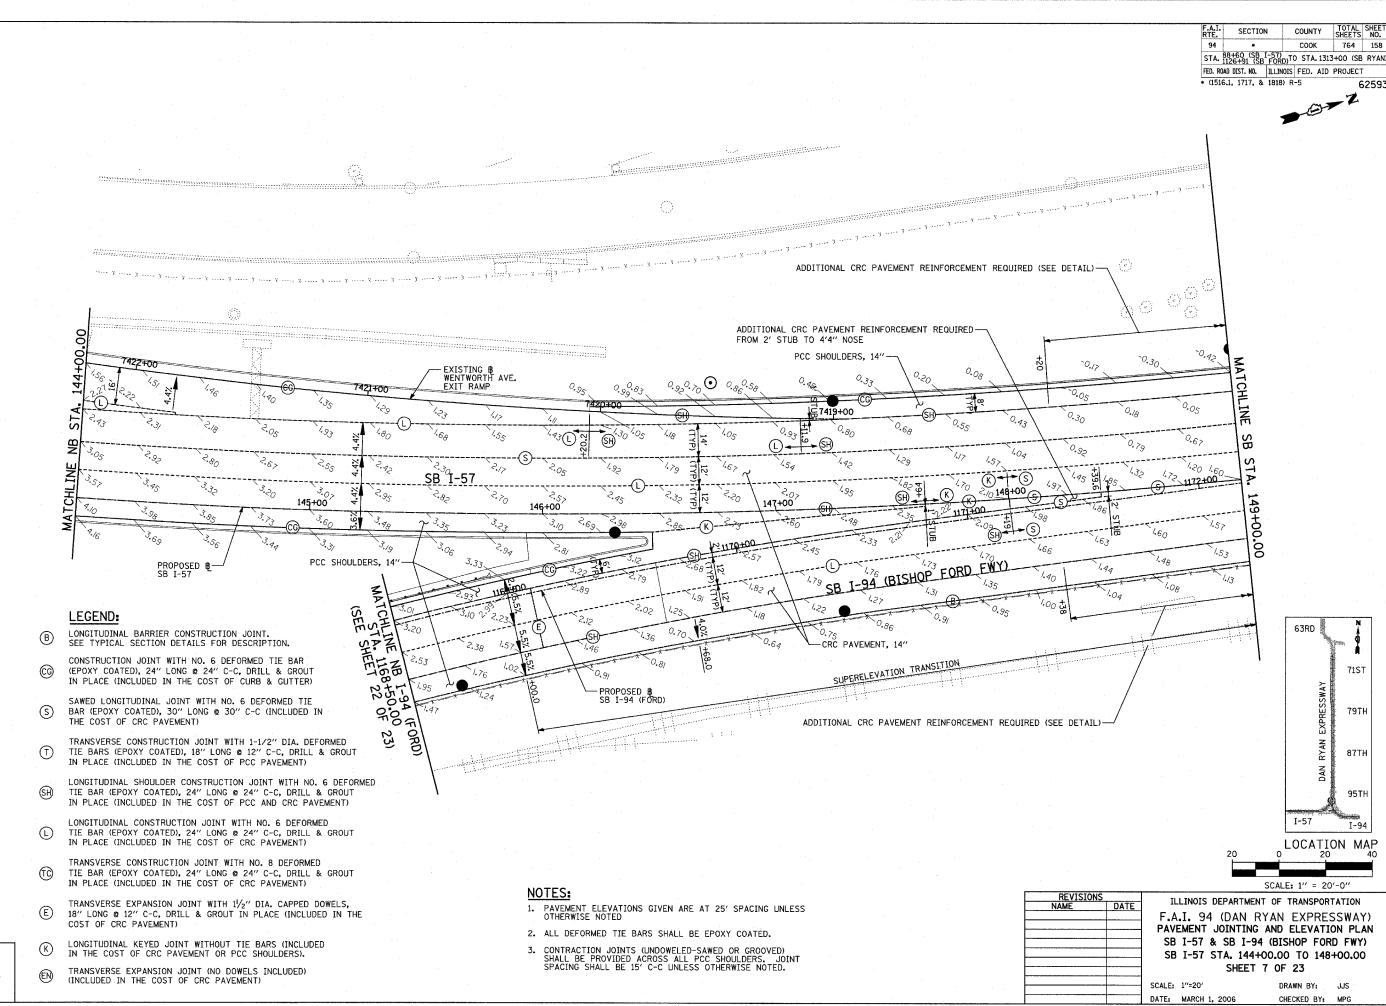

→ G→Z

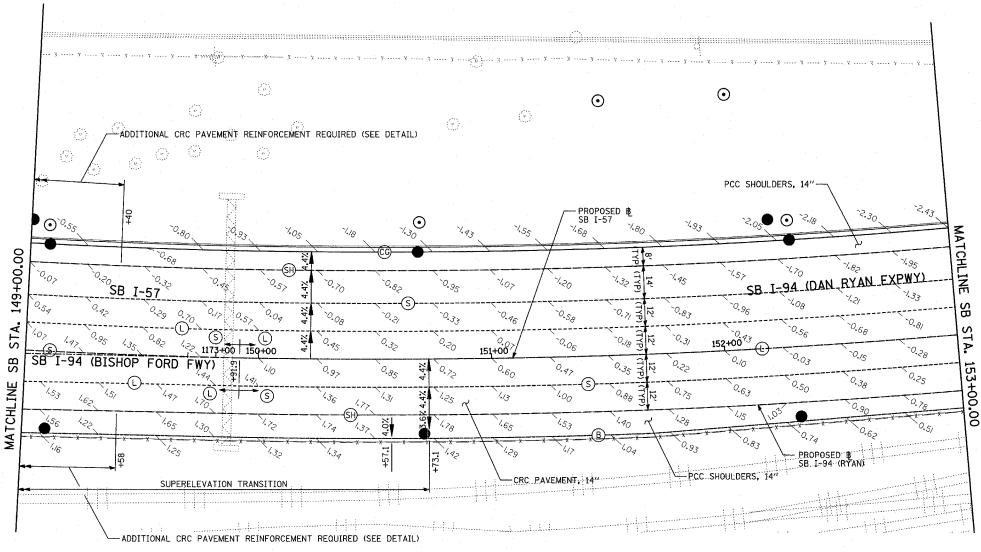


LEGEND:

- B LONGITUDINAL BARRIER CONSTRUCTION JOINT. SEE TYPICAL SECTION DETAILS FOR DESCRIPTION.
- CONSTRUCTION JOINT WITH NO. 6 DEFORMED TIE BAR
 (EPOXY COATED), 24" LONG & 24" C-C, DRILL & GROUT
 IN PLACE (INCLUDED IN THE COST OF CURB & GUTTER)
- SAWED LONGITUDINAL JOINT WITH NO. 6 DEFORMED TIE
 BAR (EPOXY COATED), 30" LONG @ 30" C-C (INCLUDED IN
 THE COST OF CRC PAVEMENT)
- TRANSVERSE CONSTRUCTION JOINT WITH 1-1/2" DIA. DEFORMED
 TIE BARS (EPOXY COATED), 18" LONG © 12" C-C, DRILL & GROUT
 IN PLACE (INCLUDED IN THE COST OF PCC PAVEMENT)
- LONGITUDINAL SHOULDER CONSTRUCTION JOINT WITH NO. 6 DEFORMED
 TIE BAR (EPOXY COATED), 24" LONG @ 24" C-C, DRILL & GROUT
 IN PLACE (INCLUDED IN THE COST OF PCC AND CRC PAVEMENT)


- LONGITUDINAL CONSTRUCTION JOINT WITH NO. 6 DEFORMED
 TIE BAR (EPOXY COATED), 24" LONG @ 24" C-C, DRILL & GROUT
 IN PLACE (INCLUDED IN THE COST OF CRC PAVEMENT)
- TRANSVERSE CONSTRUCTION JOINT WITH NO. 8 DEFORMED TIE BAR (EPOXY COATED), 24" LONG @ 24" C-C, DRILL & GROUT IN PLACE (INCLUDED IN THE COST OF CRC PAVEMENT)
- TRANSVERSE EXPANSION JOINT WITH 11/2" DIA. CAPPED DOWELS, 18" LONG @ 12" C-C, DRILL & GROUT IN PLACE (INCLUDED IN THE COST OF CRC PAVEMENT)
- LONGITUDINAL KEYED JOINT WITHOUT TIE BARS (INCLUDED IN THE COST OF CRC PAVEMENT OR PCC SHOULDERS).
- TRANSVERSE EXPANSION JOINT (NO DOWELS INCLUDED) (INCLUDED IN THE COST OF CRC PAVEMENT)


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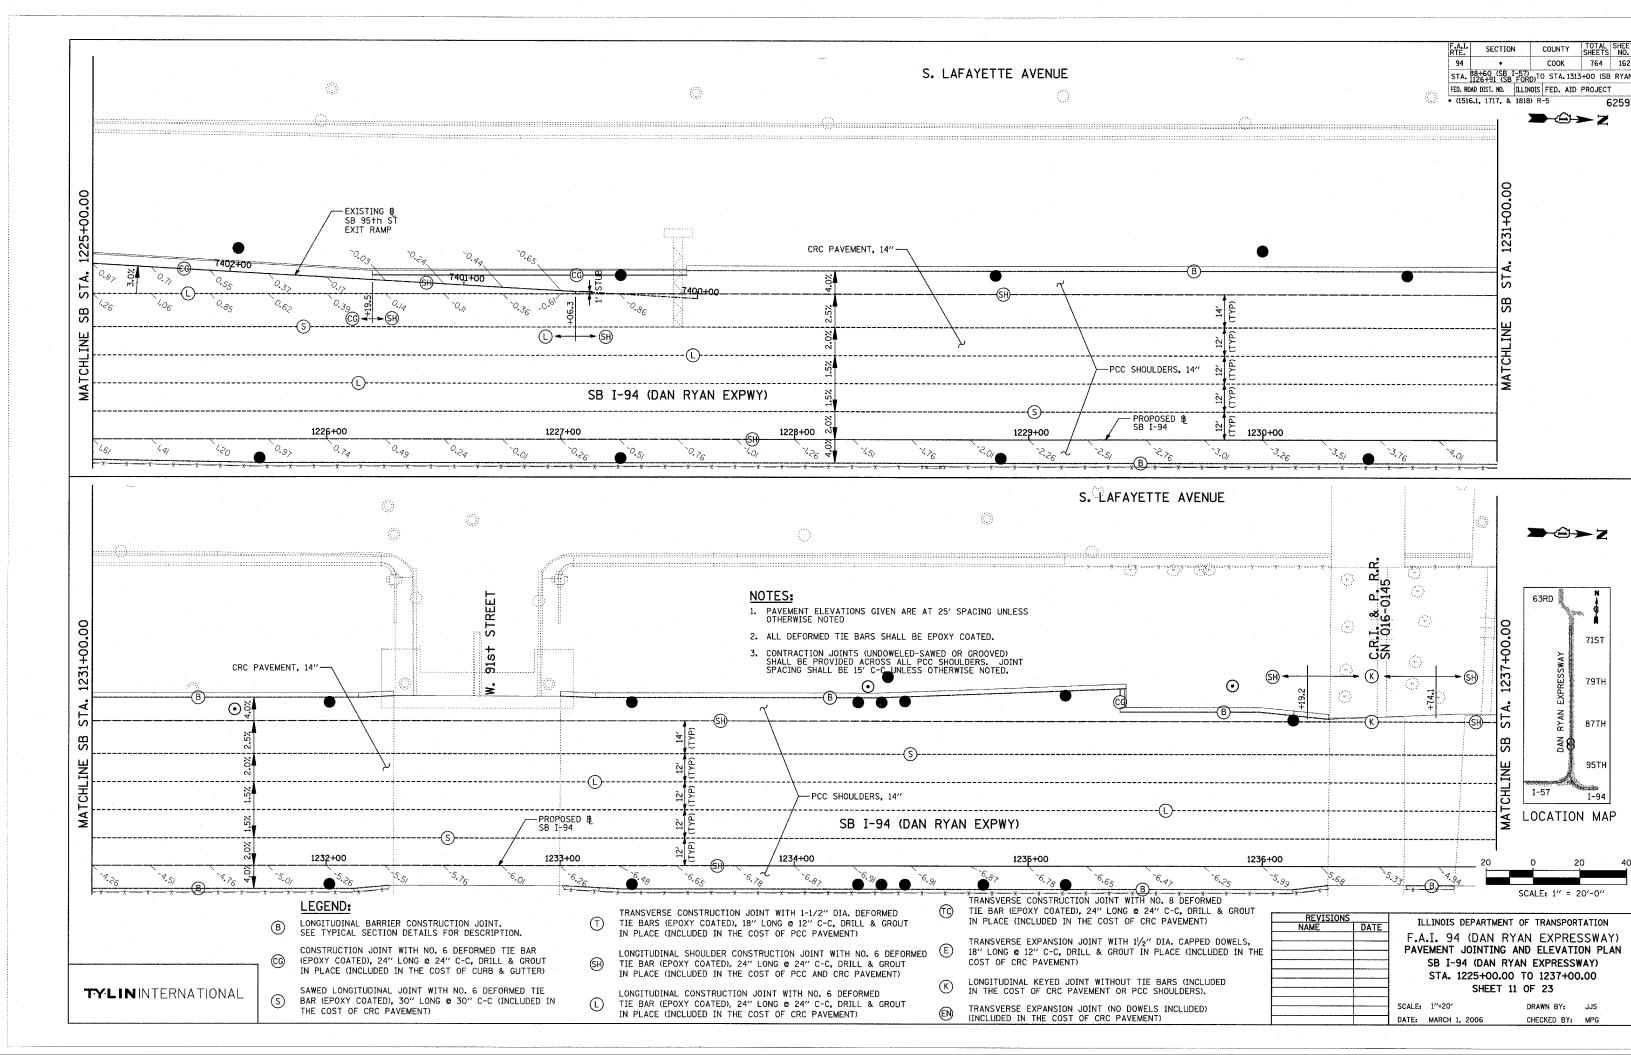
- 1. PAVEMENT ELEVATIONS GIVEN ARE AT 25' SPACING UNLESS OTHERWISE NOTED
- 2. ALL DEFORMED TIE BARS SHALL BE EPOXY COATED.
- 3. CONTRACTION JOINTS (UNDOWELED-SAWED OR GROOVED)
 SHALL BE PROVIDED ACROSS ALL PCC SHOULDERS. JOINT
 SPACING SHALL BE 15' C-C UNLESS OTHERWISE NOTED.

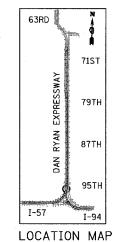



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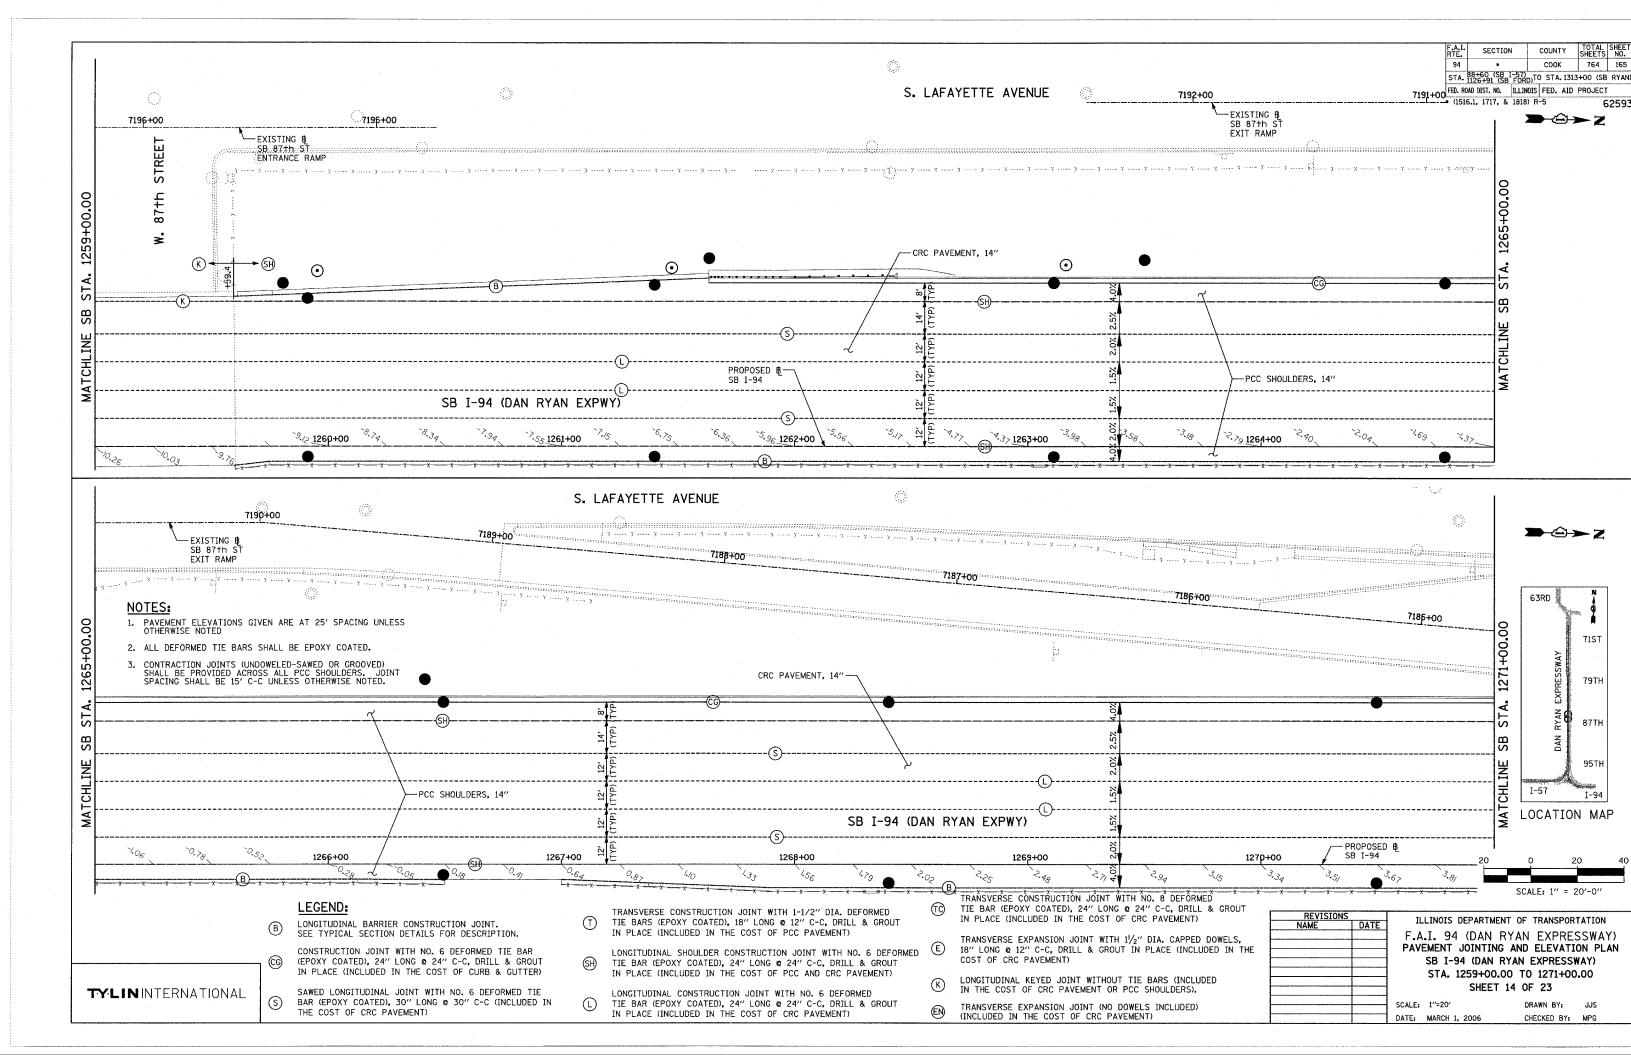





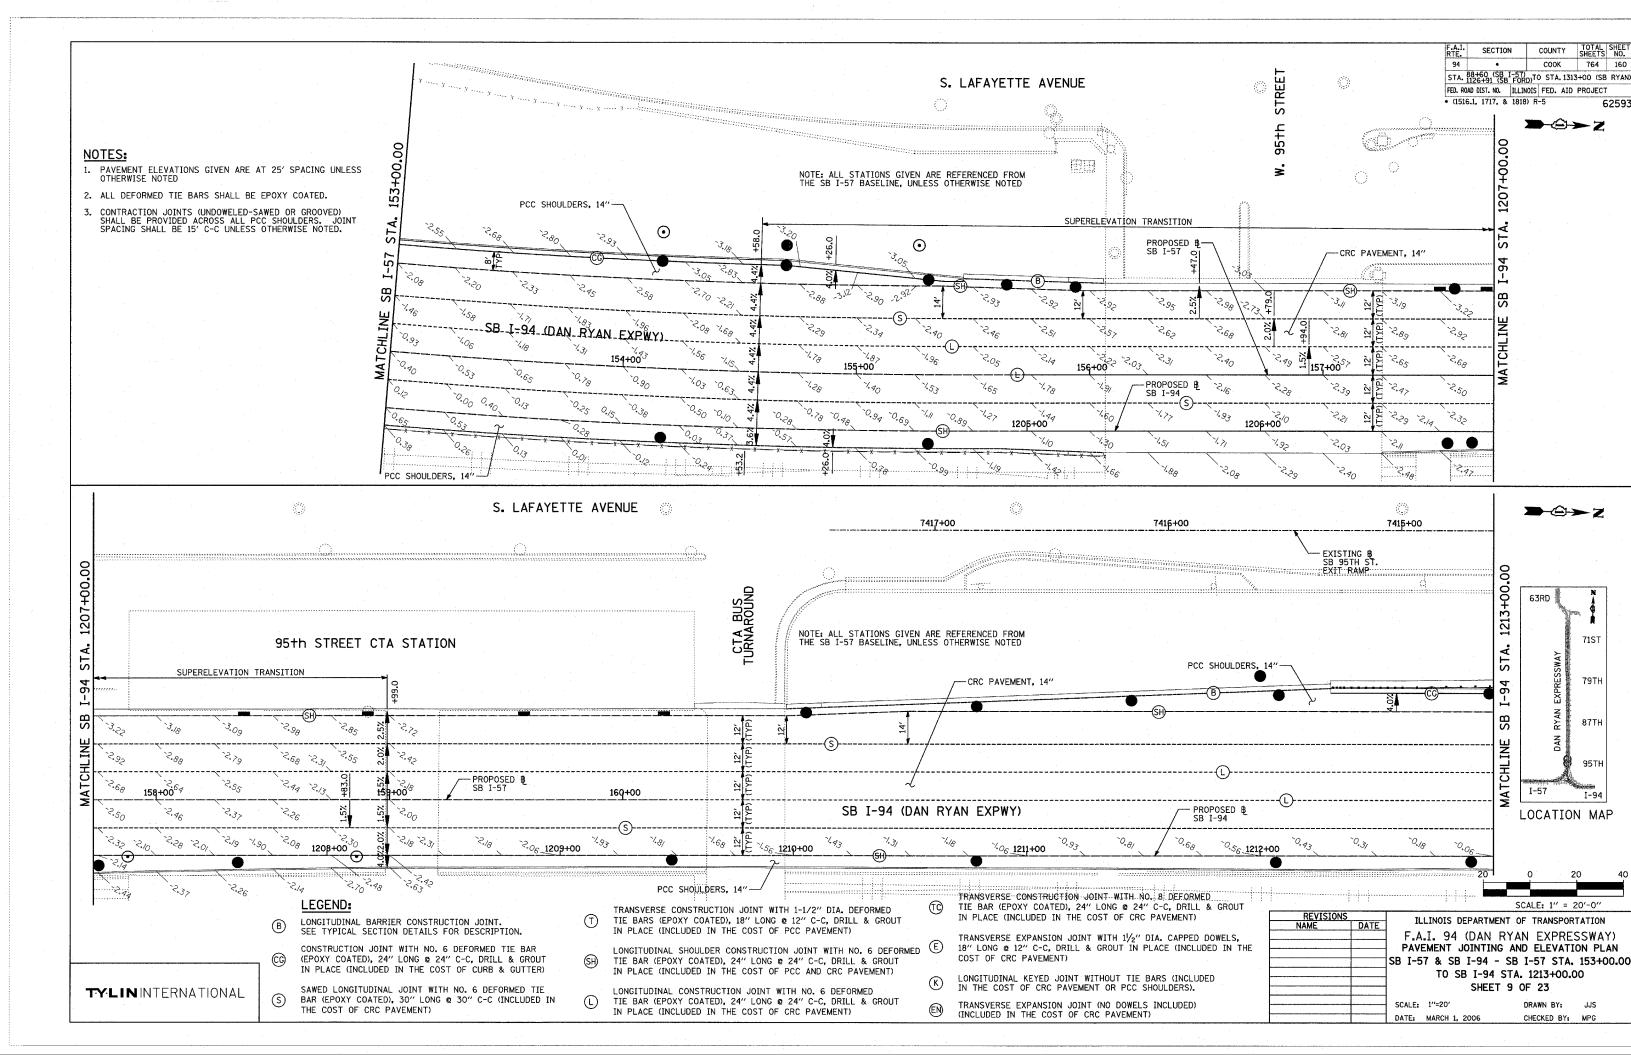


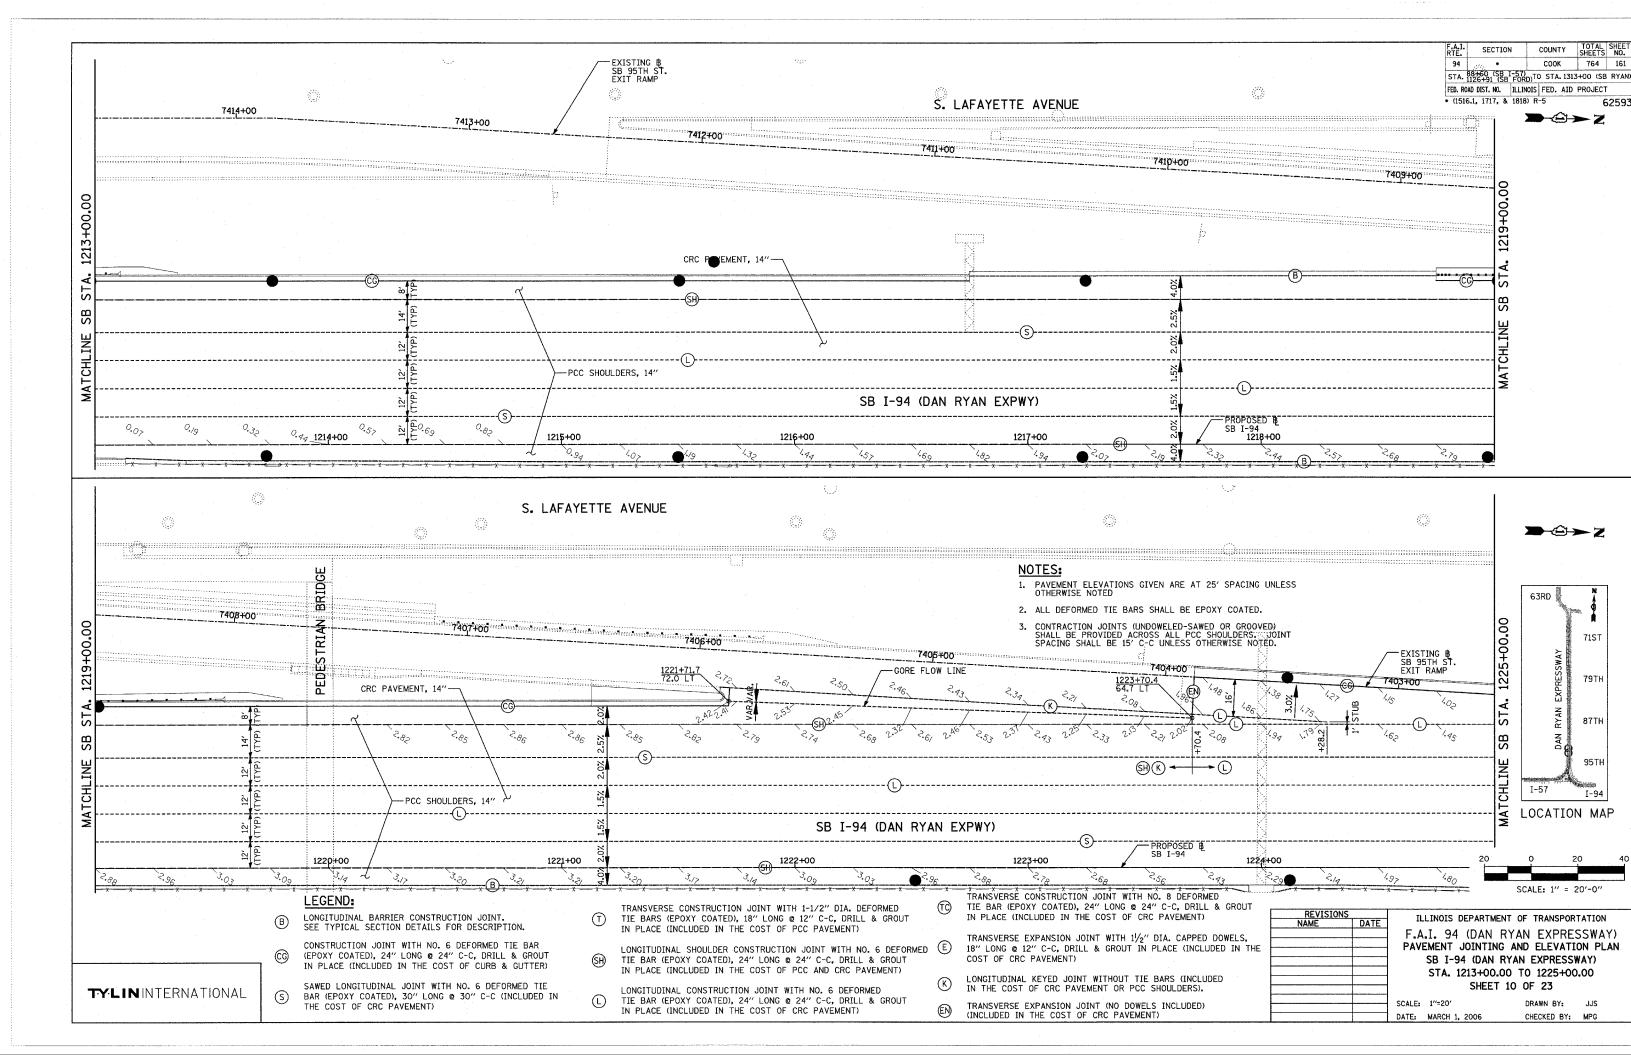


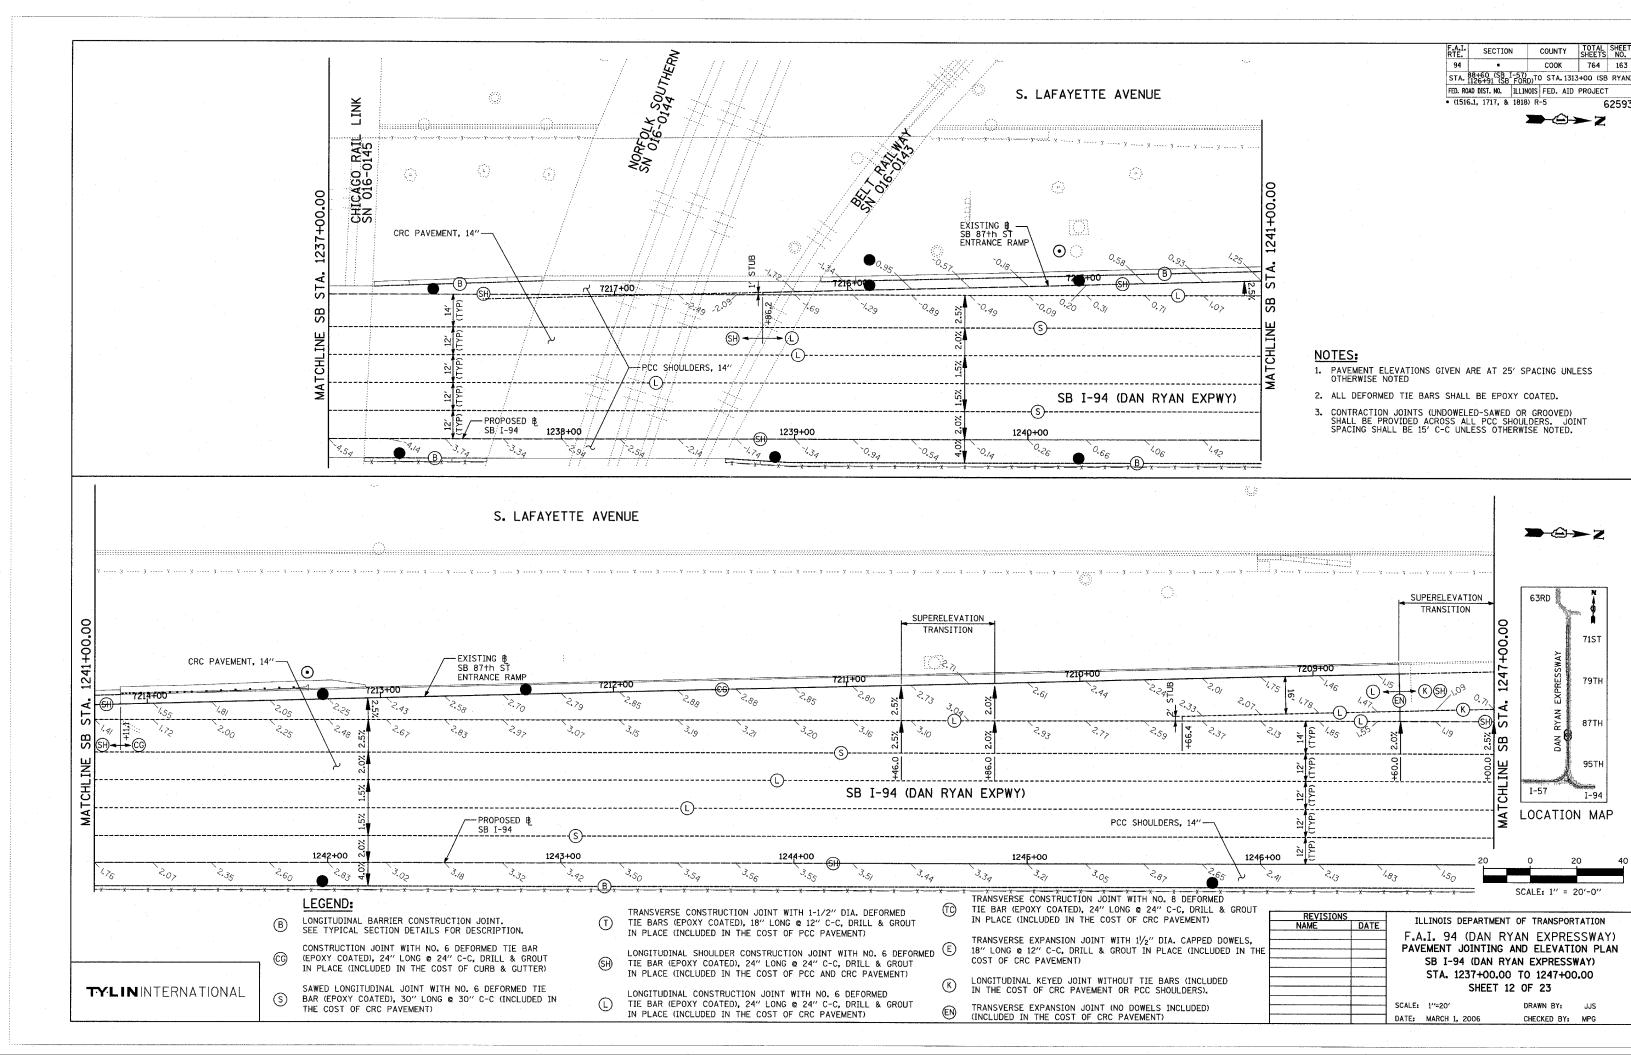


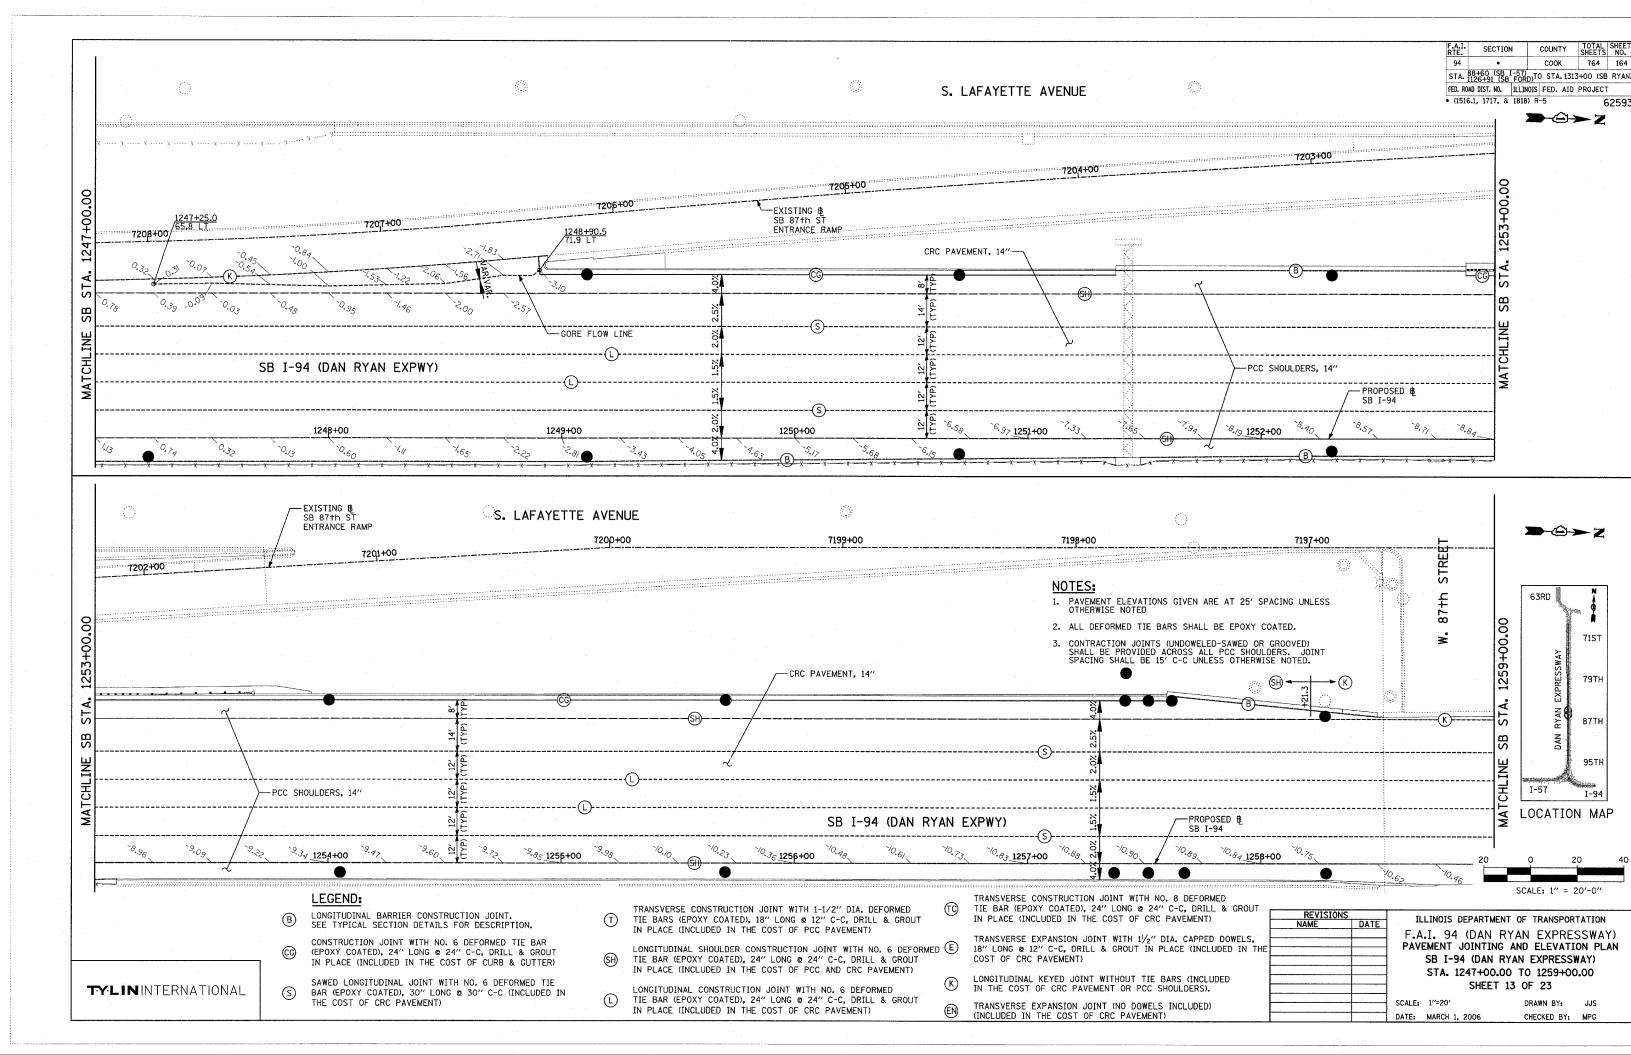


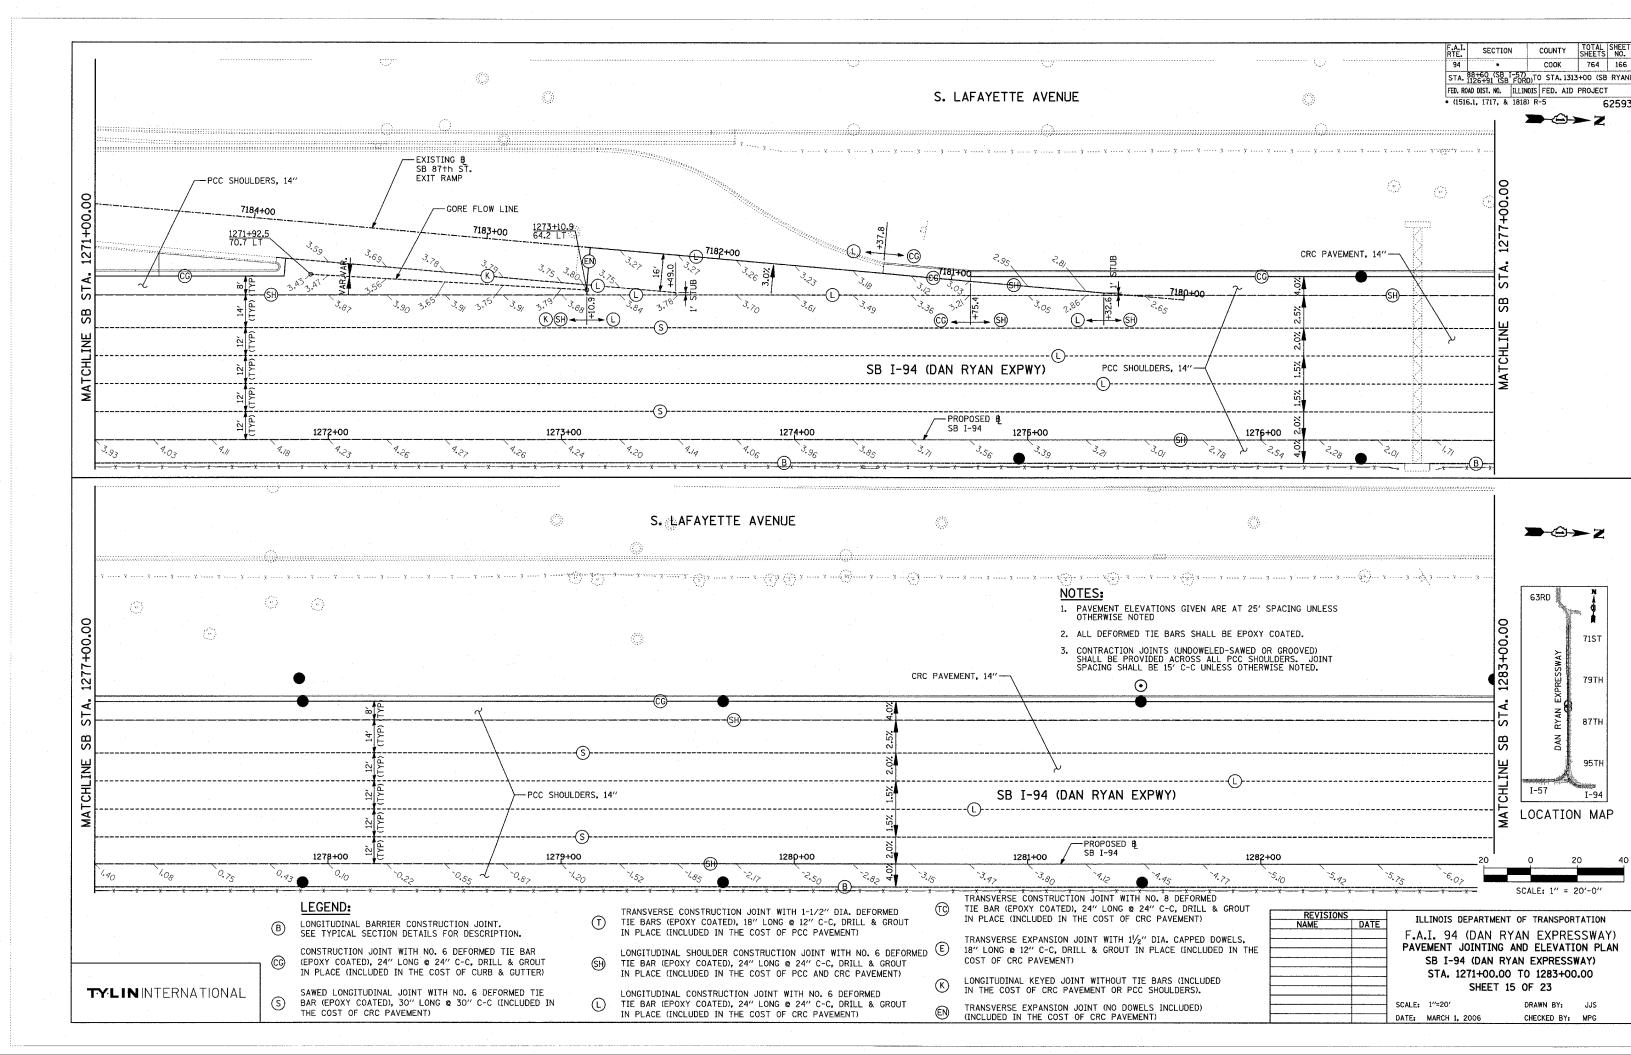


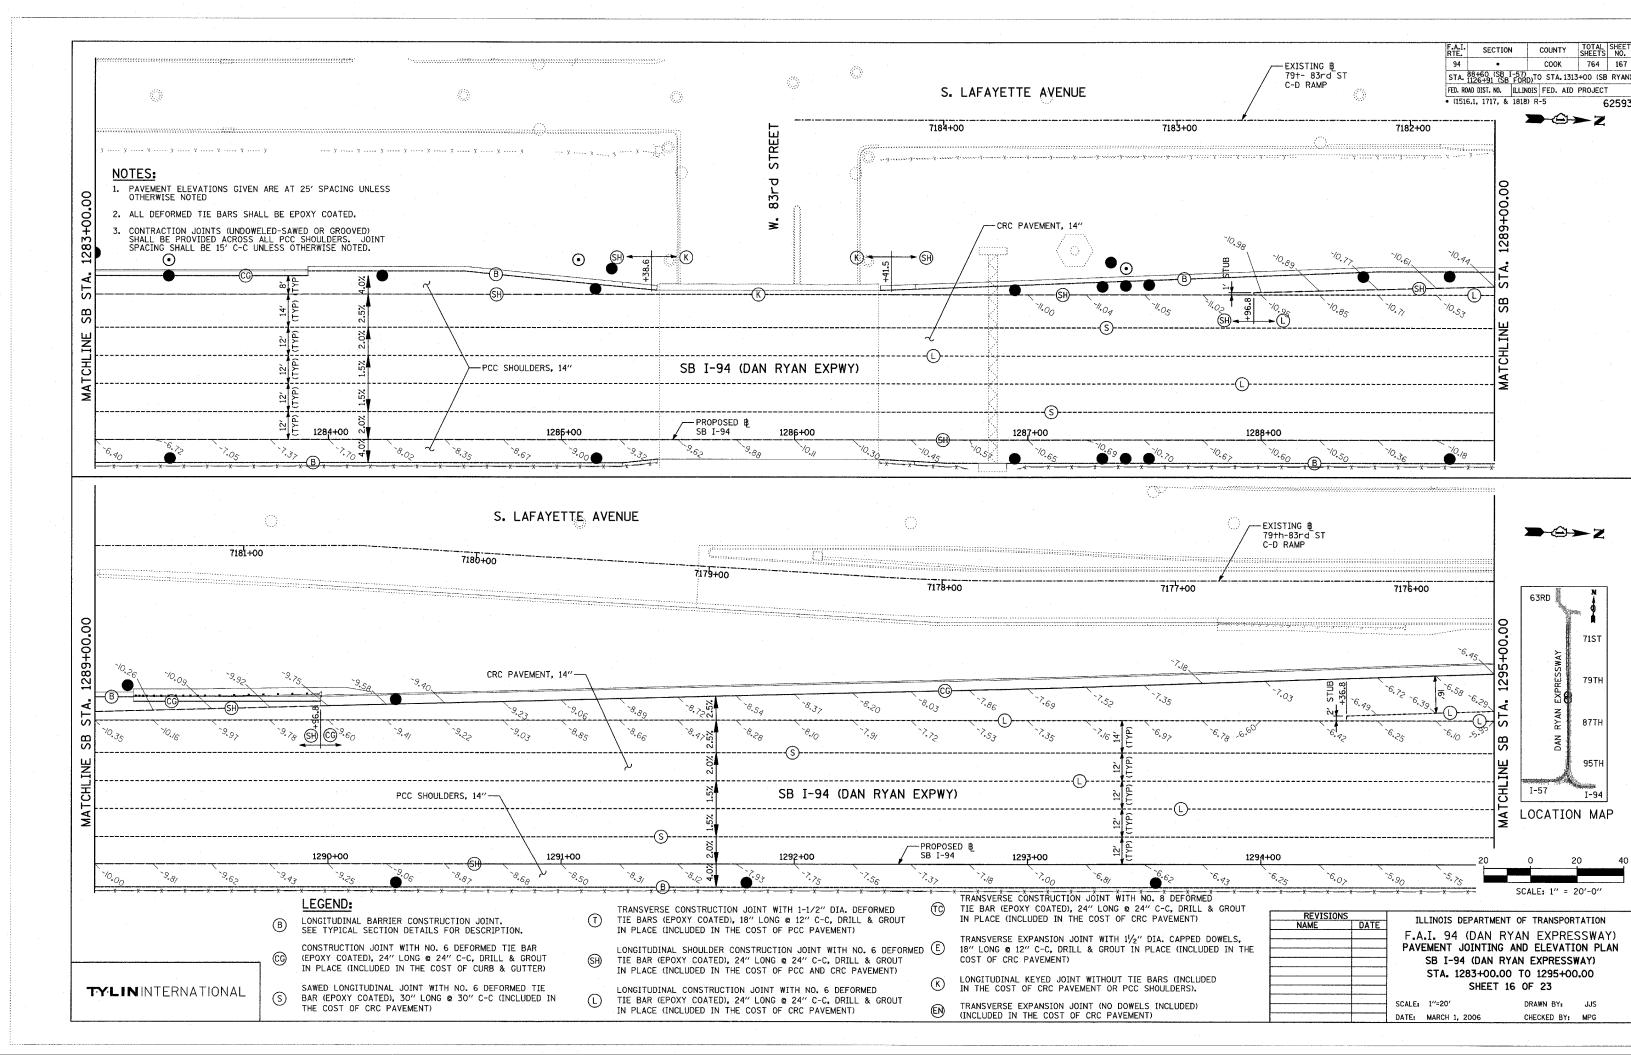


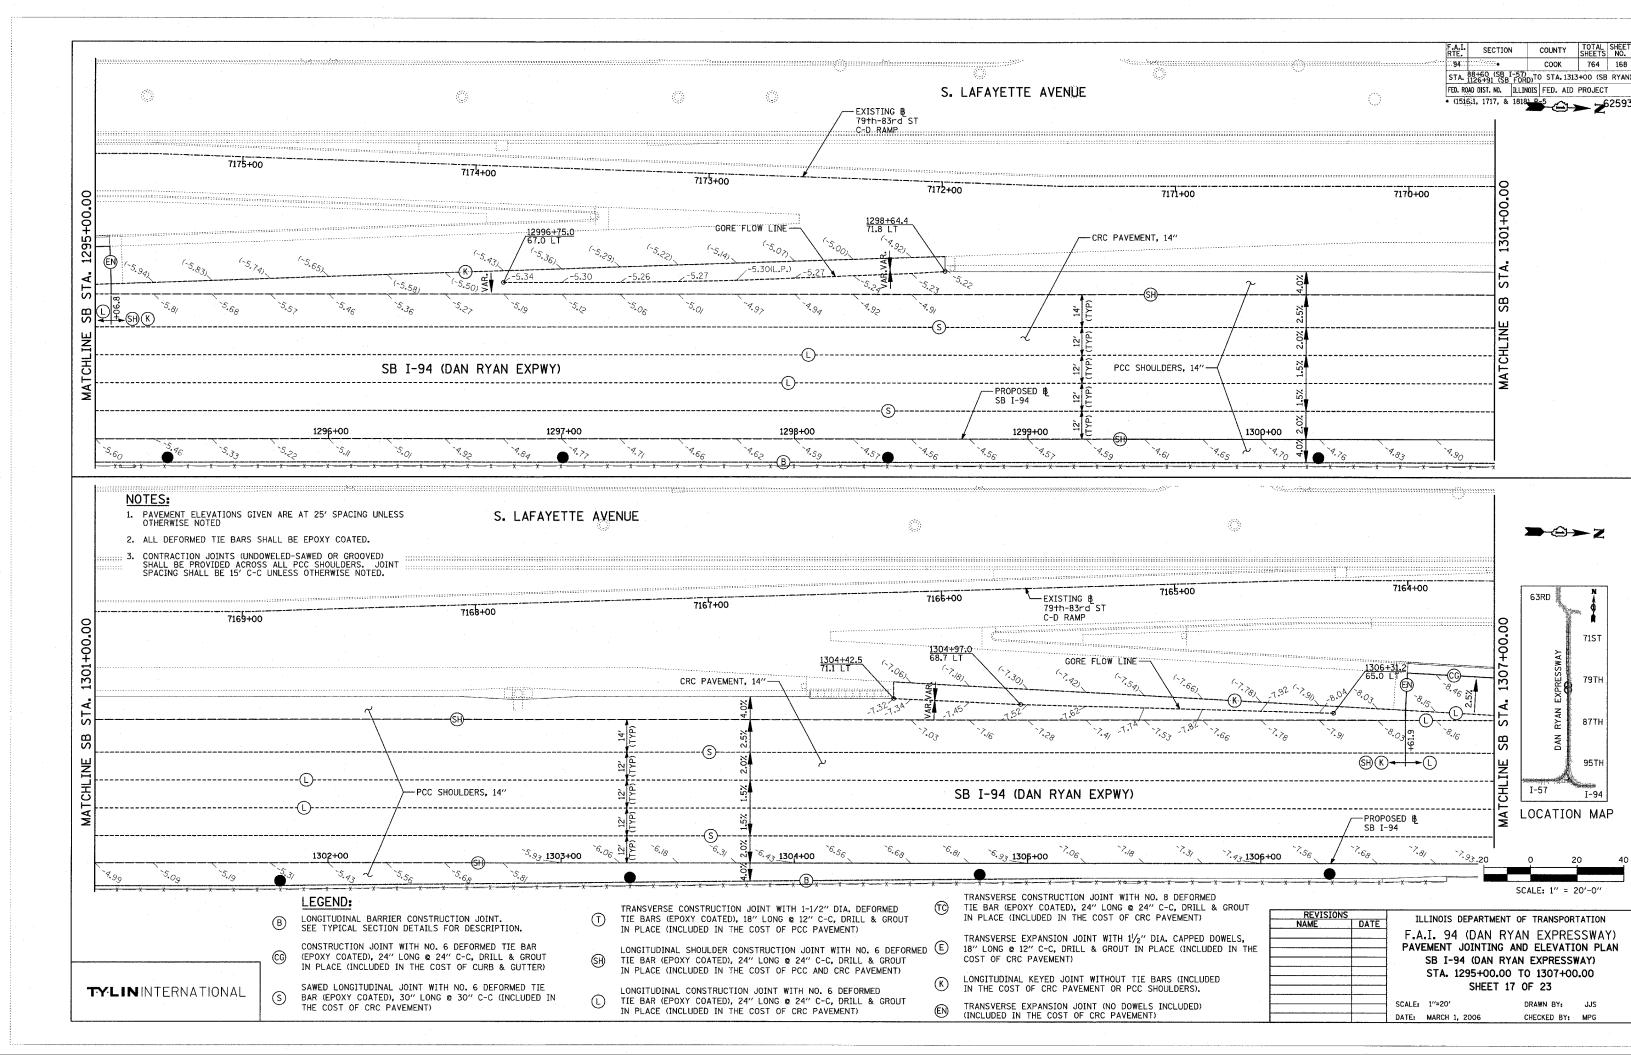


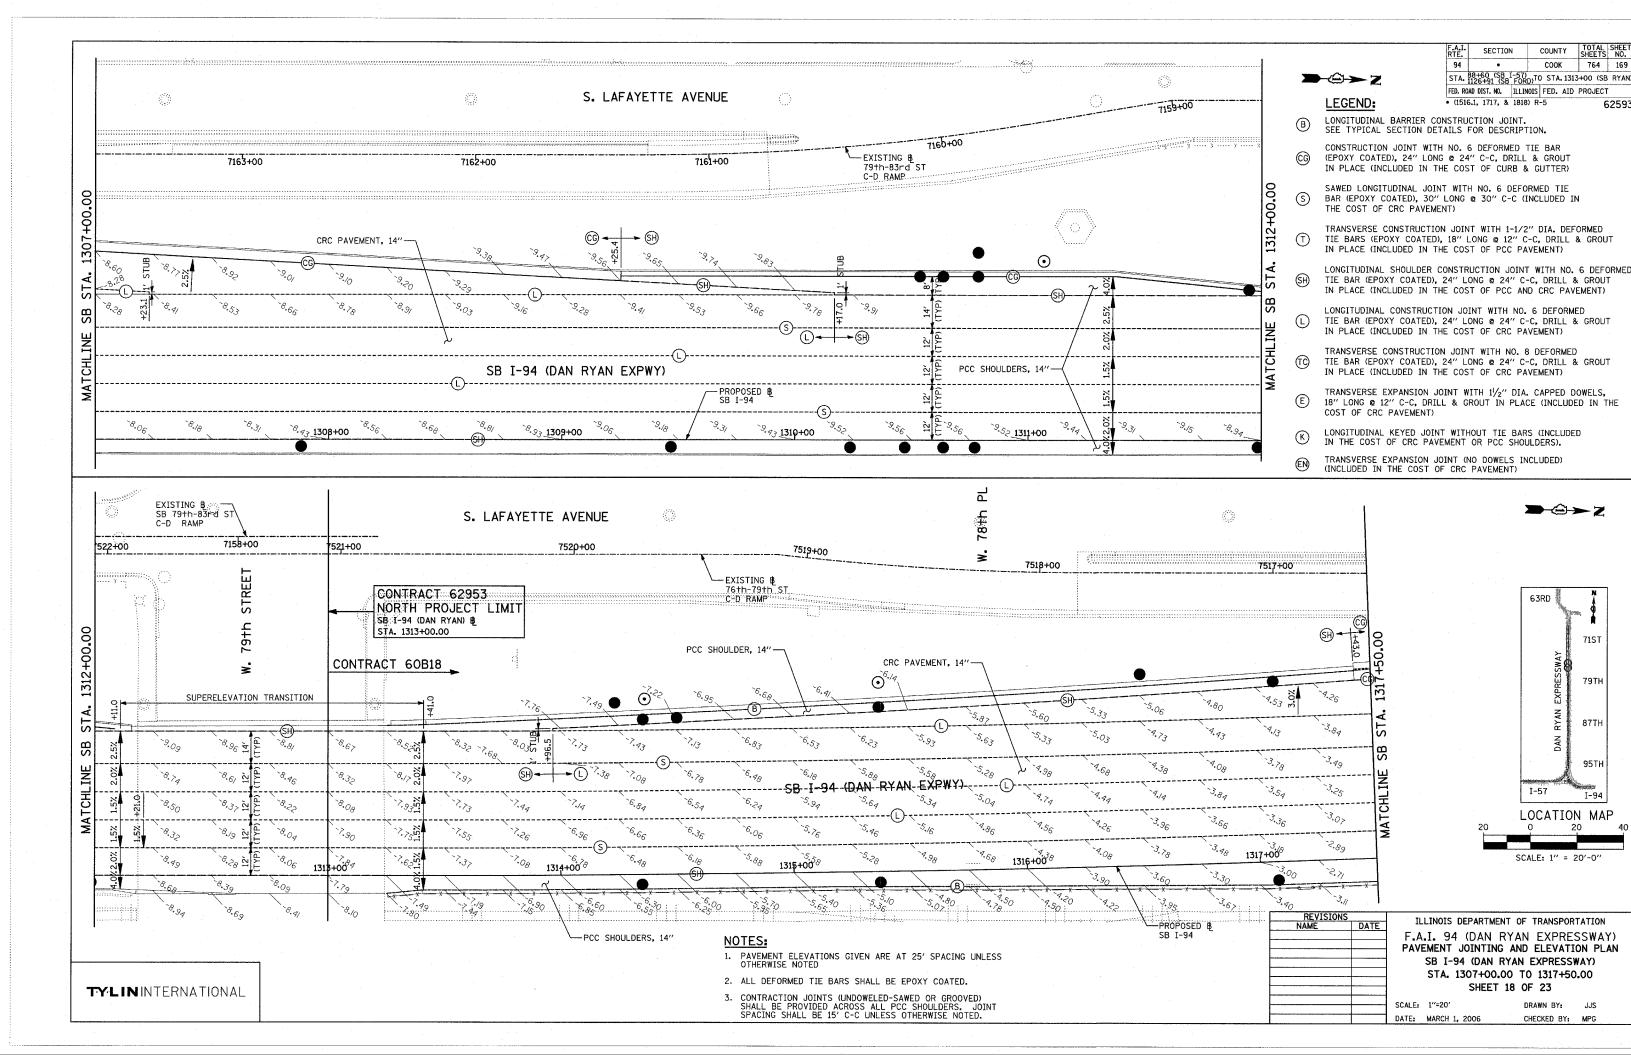


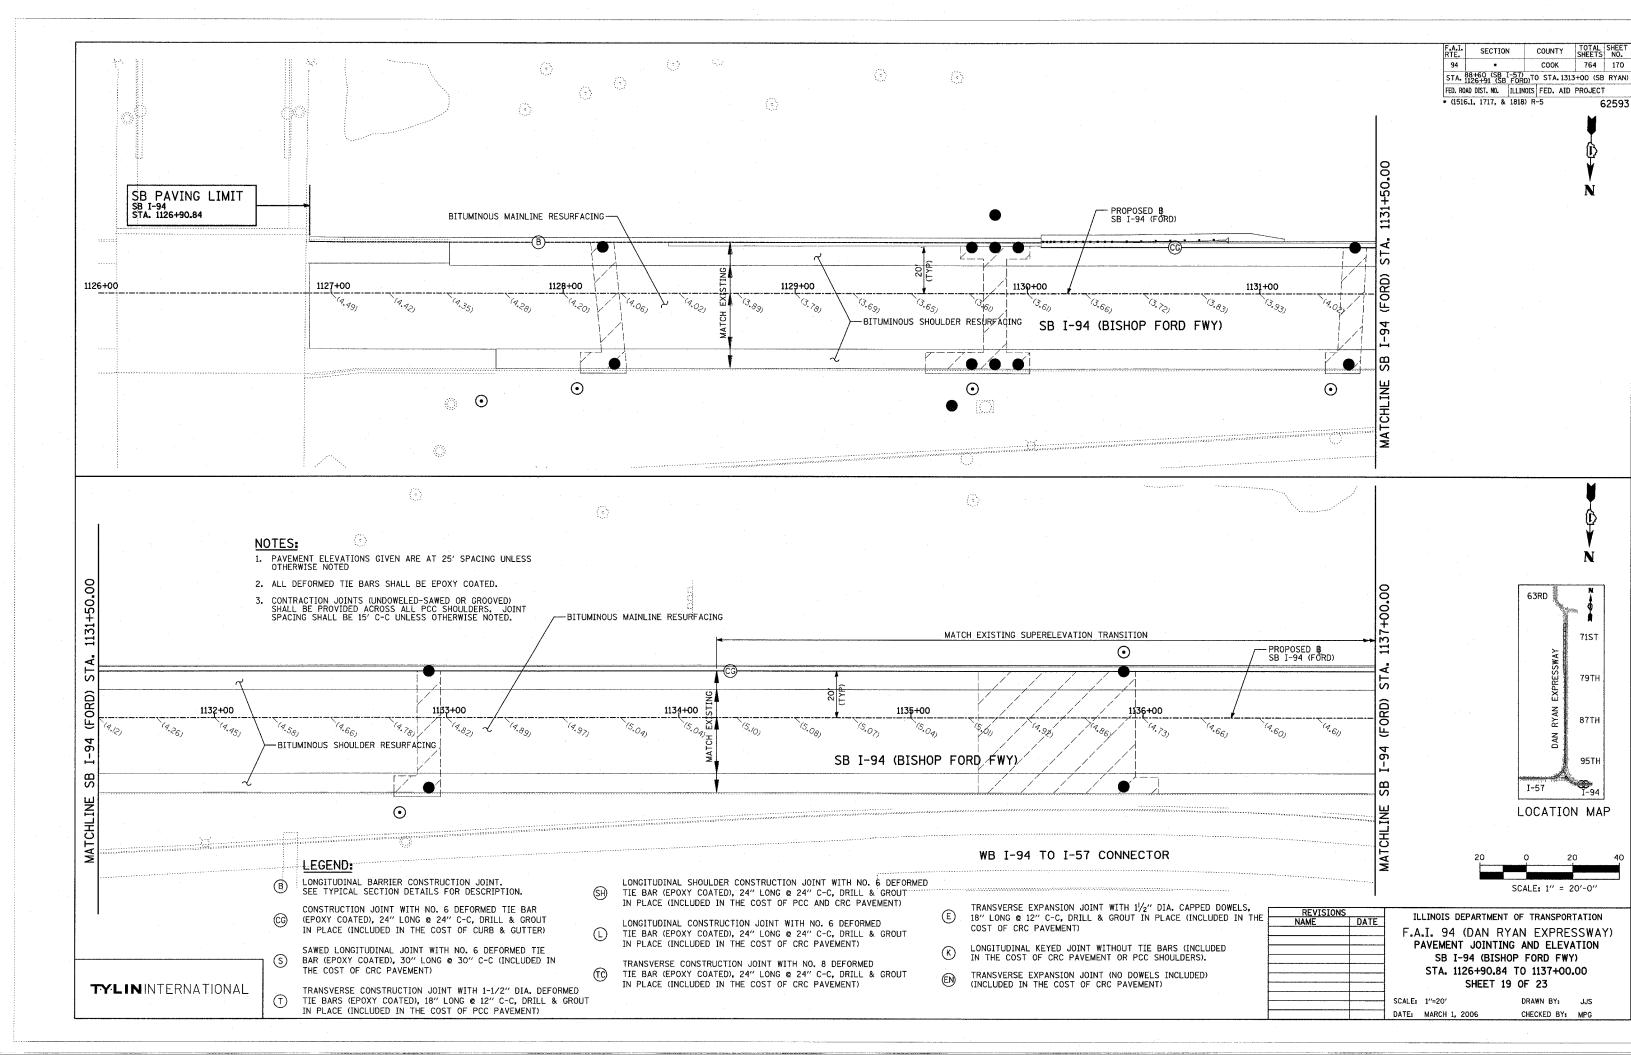

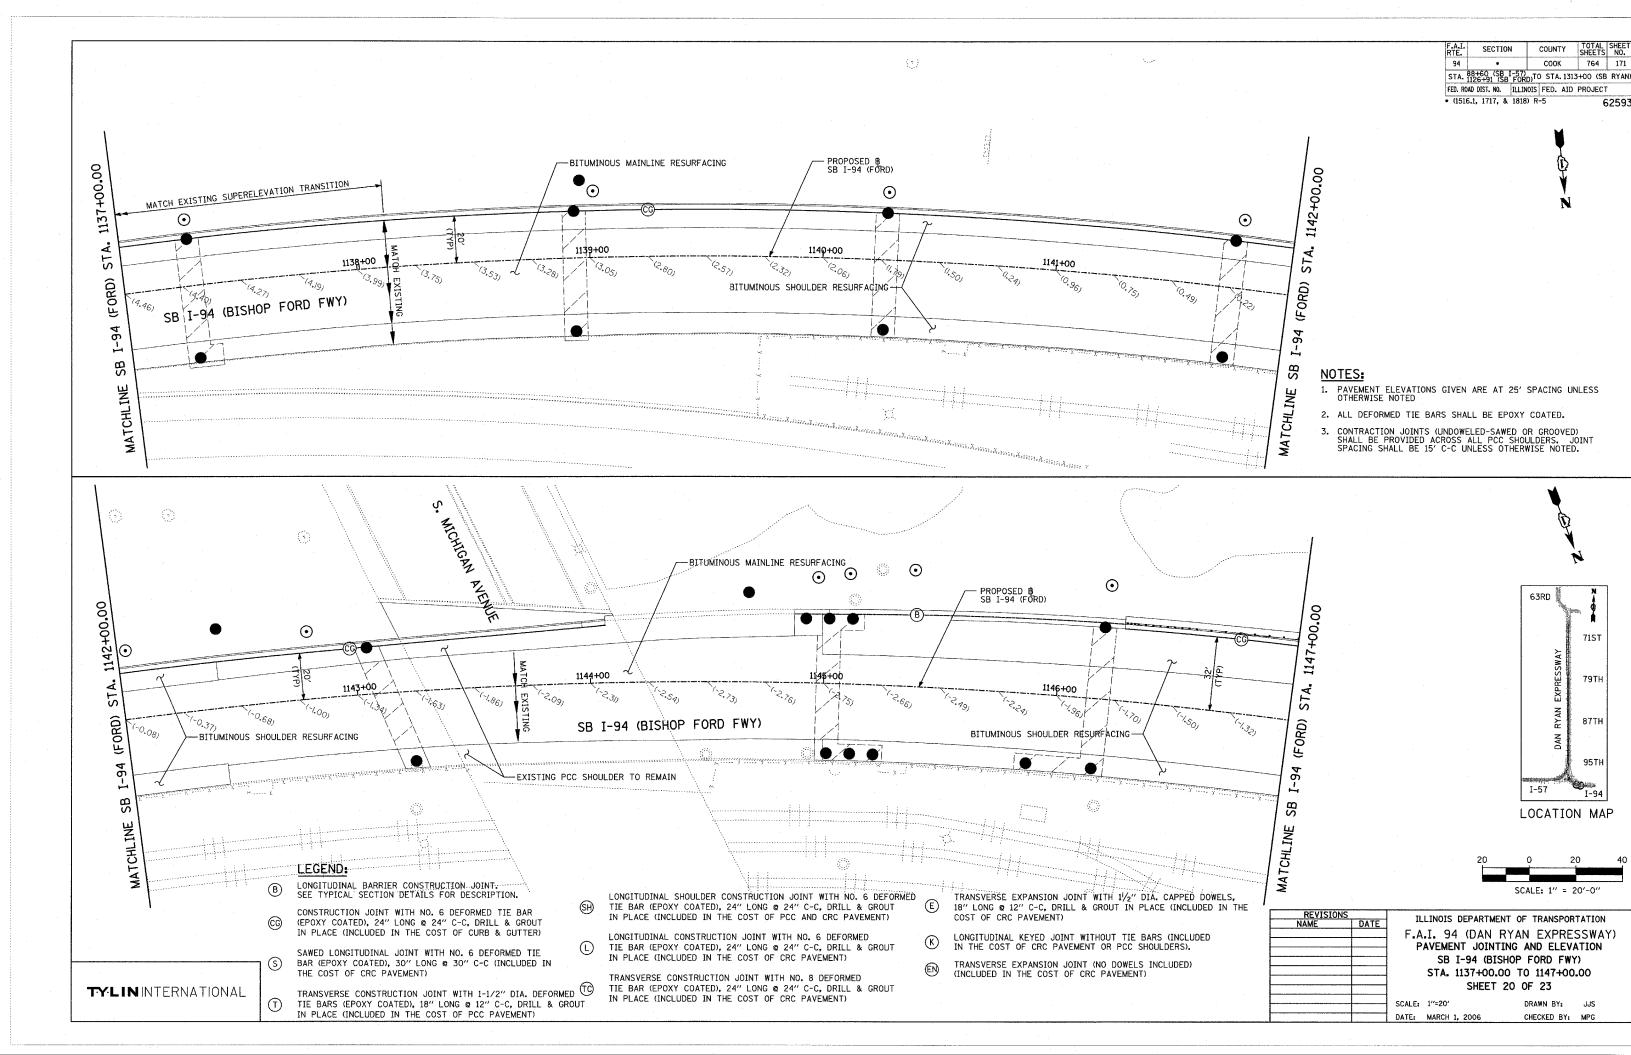

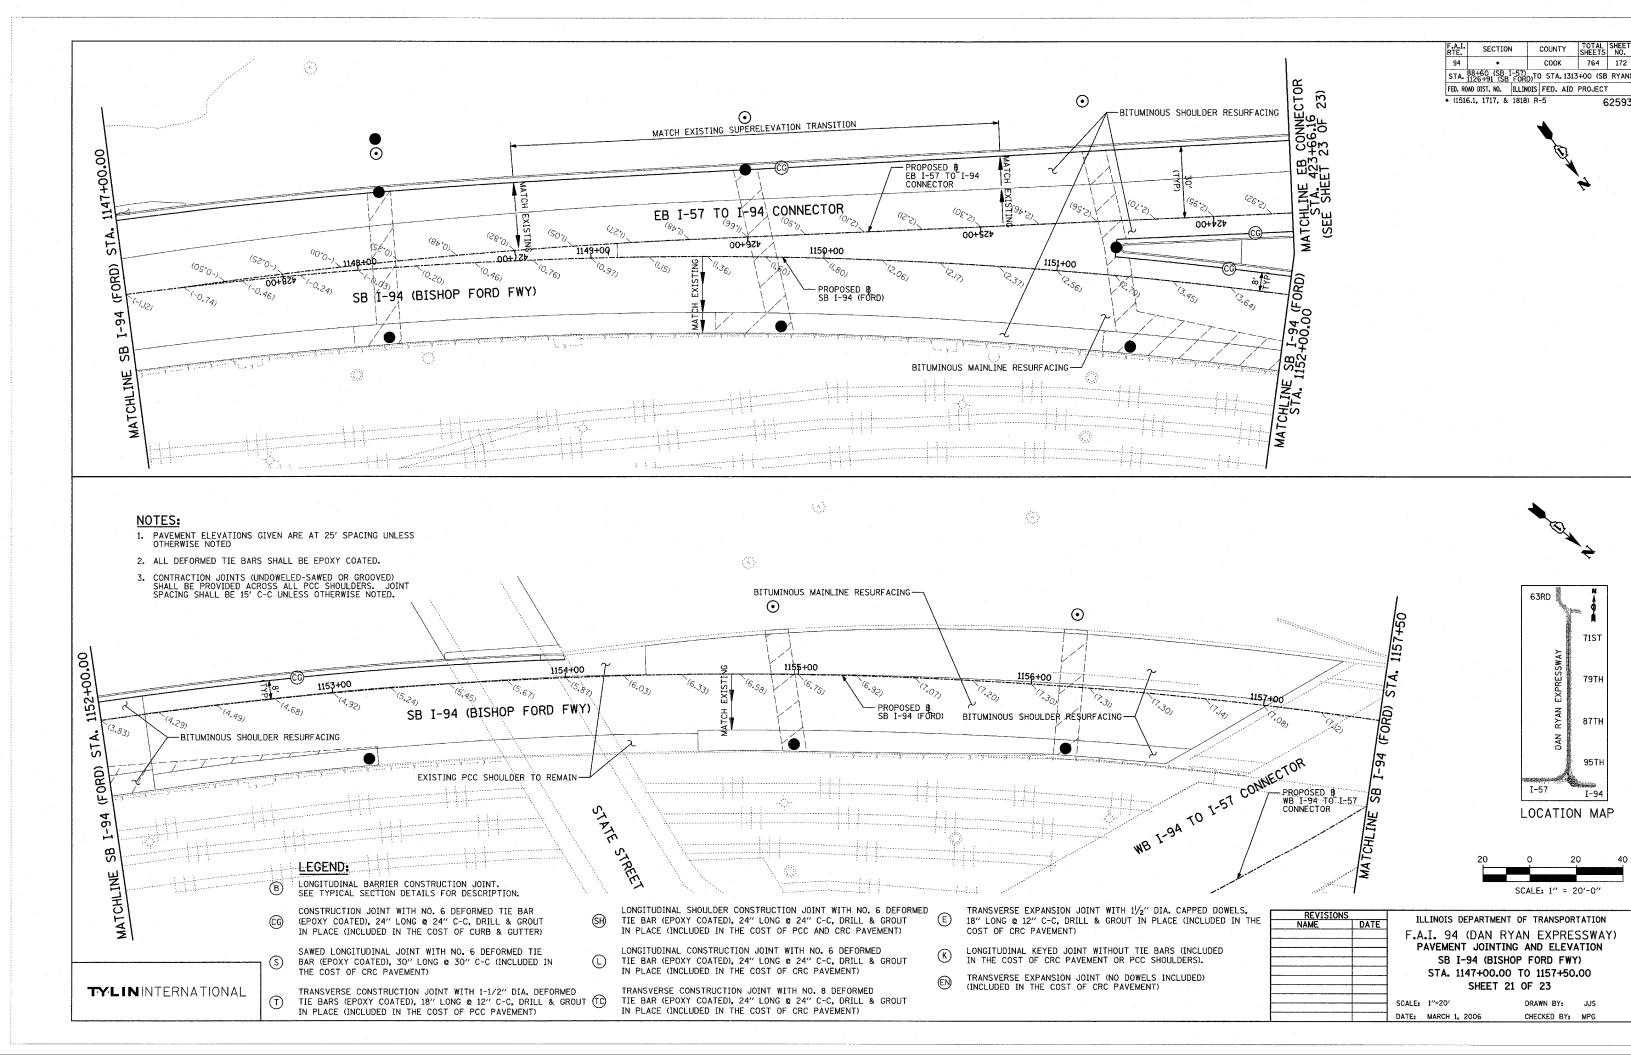

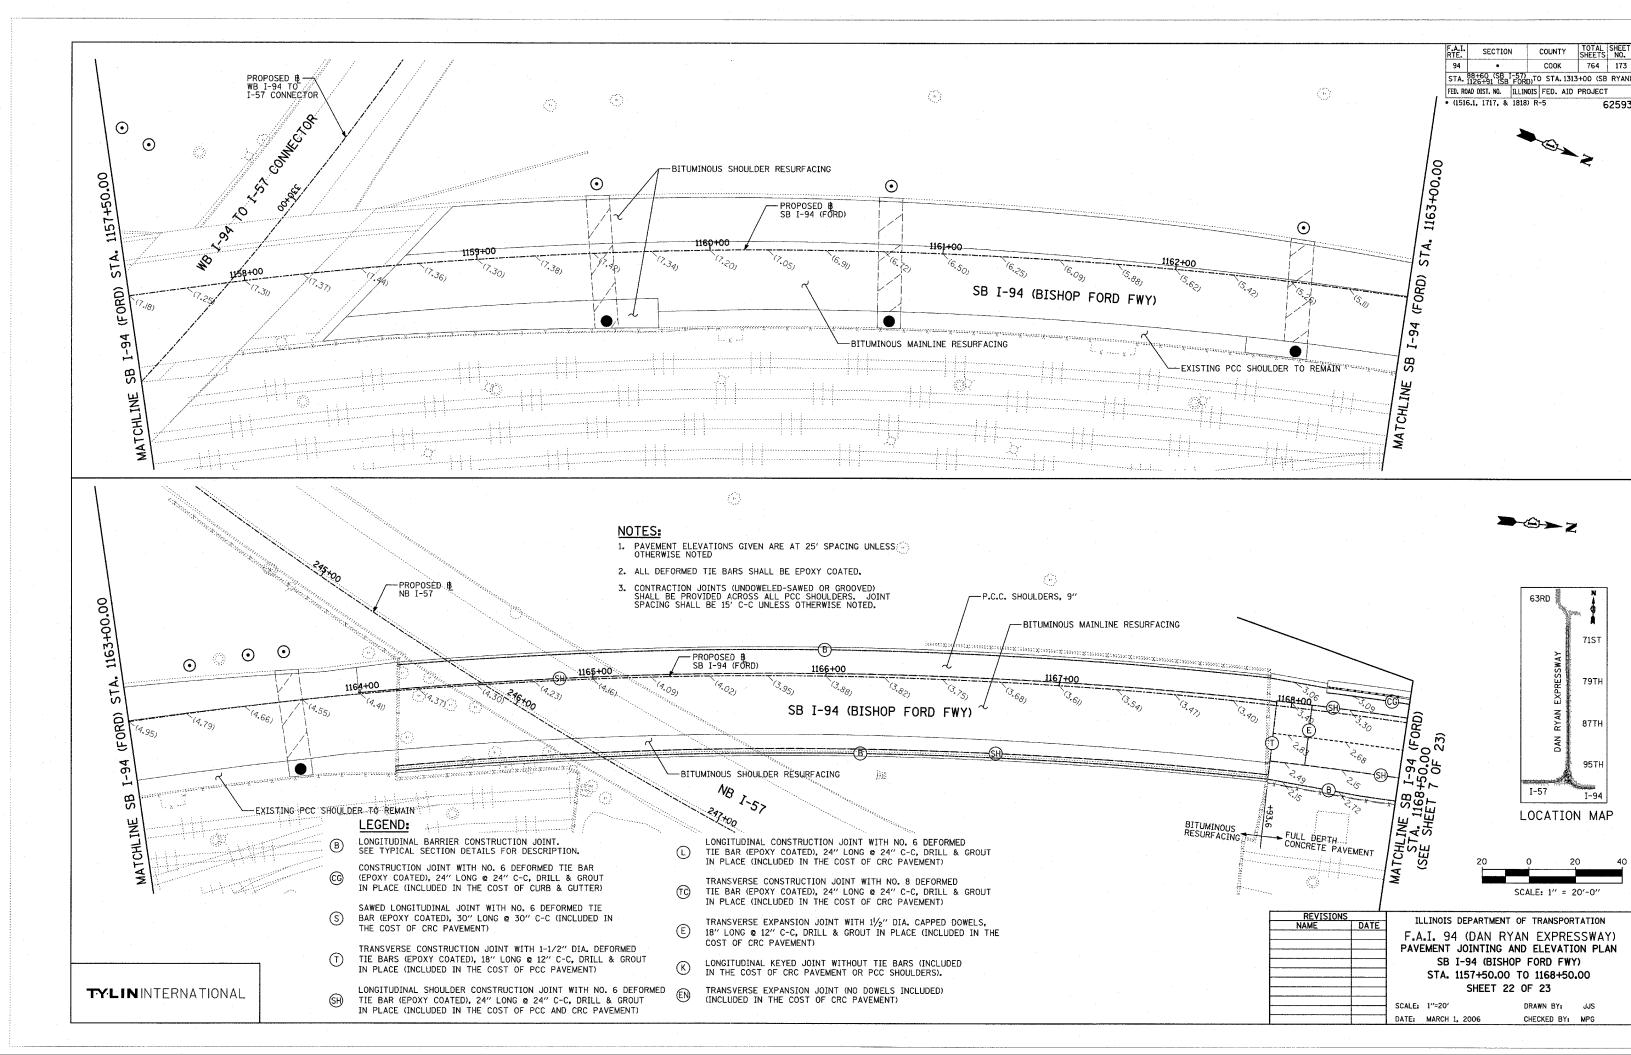

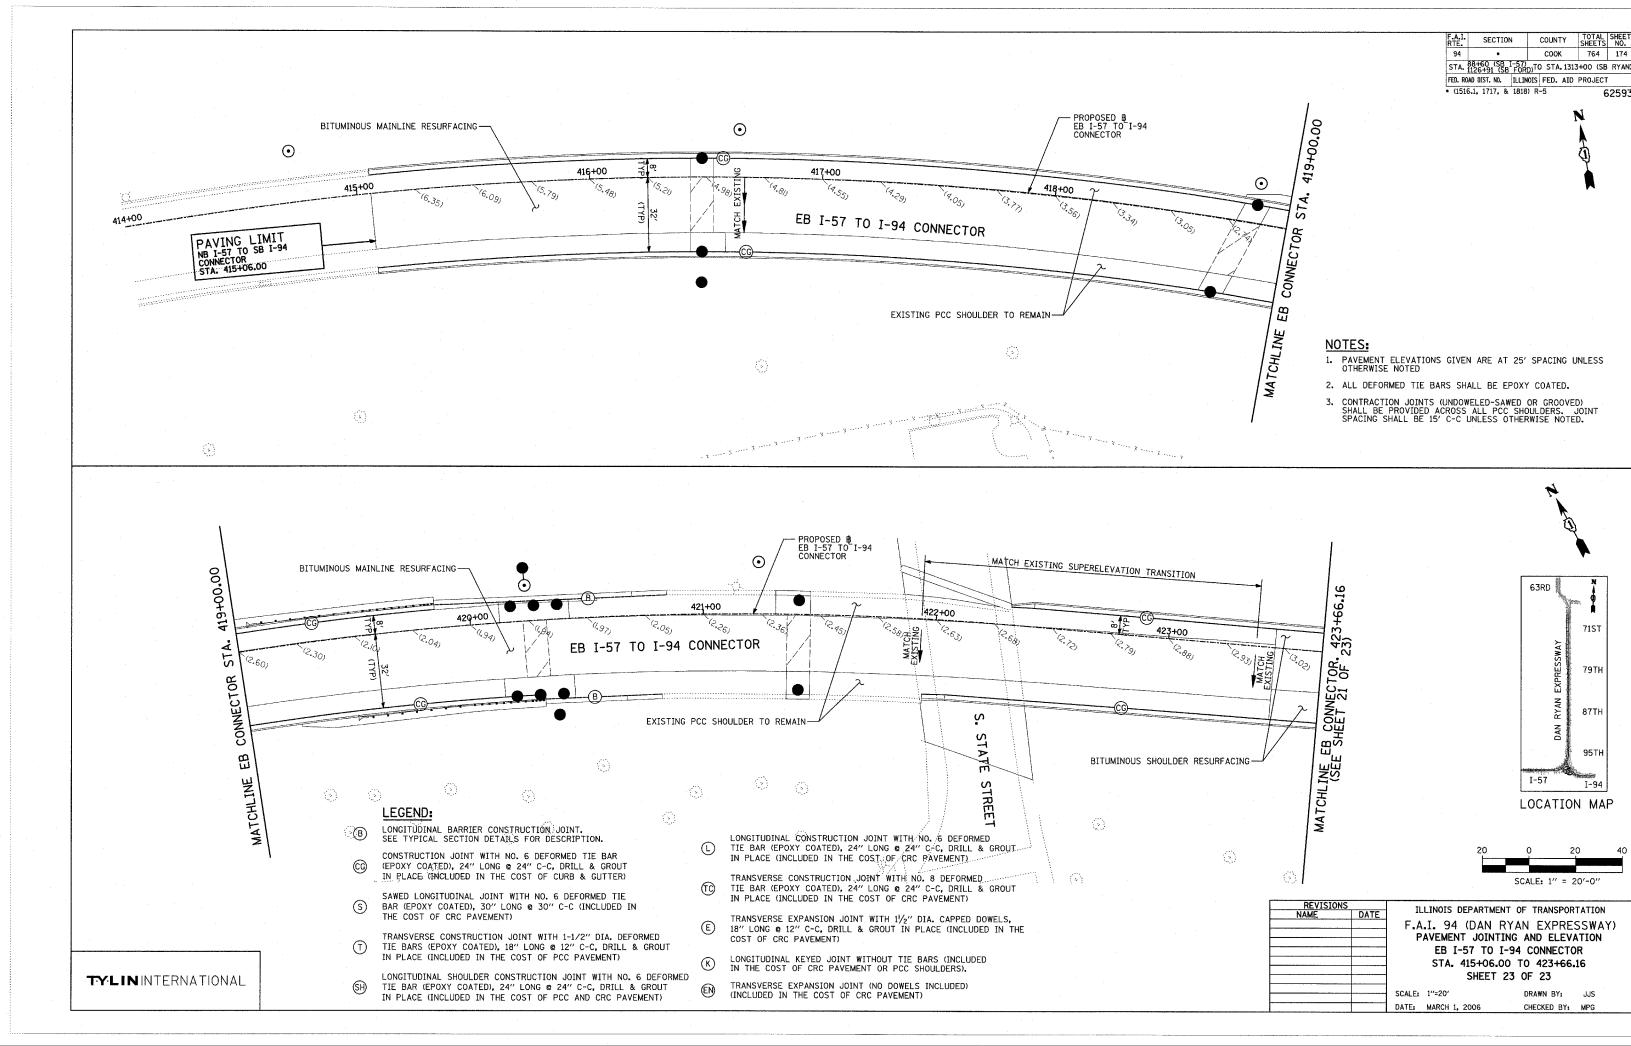

GENERAL NOTES:

SEE SPECIAL PROVISION TITLED TRAFFIC CONTROL AND PROTECTION (EXPRESSWAYS)

A WORK ZONE SPEED LIMIT OF 45 M.P.H. MUST BE MAINTAINED AT ALL TIMES.

QUANTITY FOR TEMPORARY PAVEMENT MARKING - LINE 6" WAS ASSUMED EQUAL TO THE LENGTH OF TEMPORARY CONCRETE BARRIER. UTILIZED WHEN THE BARRIER IS LOCATED ONE FOOT OR LESS FROM THE EDGE OF TRAVELED WAY.

ALL TEMPORARY PAVEMENT MARKINGS PLACED DURING THE WINTER LANE CONFIGURATION OR ON EXISTING PAVEMENT SHALL BE PAID FOR AS EPOXY PAVEMENT MARKING OF THE LINE TYPE AND WIDTH SPECIFIED.

ALL TEMPORARY PAVEMENT MARKINGS PLACED ON NEW PAVEMENT SHALL BE PAID FOR AS PAVEMENT MARKING TAPE, TYPE III OF THE LINE TYPE AND WIDTH SPECIFIED EXCEPT WHEN DIRECTED OTHERWISE.

A TOTAL OF 10 CHANGEABLE MESSAGE SIGNS SHALL BE LOCATED ALONG THE MAINLINE AND NEAR RAMP CLOSURES FOR THE DURATION OF THE THIS CONTRACT. EXACT PLACEMENT OF THE SIGNS SHALL BE DETERMINED BY THE RESIDENT ENGINEER

ANY RAISED REFLECTIVE PAVEMENT MARKERS THAT CONFLICT WITH THE TEMPORARY TRAFFIC LANES MUST HAVE THE REFLECTIVE LENSES REMOVED AS DIRECTED BY THE RESIDENT ENGINEER. MEASURE OF PAYMENT FOR REMOVAL OF REFLECTORS IS INCLUDED IN THE CONTRACT UNIT PRICE FOR TRAFFIC CONTROL AND PROTECTION (EXPRESSWAYS).

FOR ACCESS CONTROL, THE CONTRACTOR IS REQUIRED TO PLACE CHAIN LINK FENCE 6' (SPECIAL), 7'-2'' CLEAR FROM THE CENTERLINE OF CTA TRACK, PRIOR TO REMOVING EXISTING CTA CHAIN LINK FENCE AND BARRIER WALL. THE CONTRACTOR MUST ALSO PLACE CHAIN LINK GATES, 6' X 6' SINGLE AT ALL LOCATIONS WHERE THERE ARE EXISTING CTA FENCE GATES. THE CHAIN LINK FENCE 6' (SPECIAL) MUST REMAIN IN PLACE UNTIL THE NEW PERMANENT CTA FENCE IS COMPLETED.

SEE MISCELLANEOUS DETAILS FOR MAINLINE TEMPORARY PAVEMENT AND MILLING OPERATIONS FOR THE POST-STAGE 1 WINTER LANE CONFIGURATION.

THE RESIDENT ENGINEER SHALL ASSESS THE EXISTING CONDITION OF THE PAVEMENT LOCATED ALONG THE INSIDE SHOULDER. DAMAGED AREAS WILL REQUIRE SHOULDER REHABILITATION INCLUDING MILLING AND RESURFACING. ADDITIONAL QUANTITIES OF 325.0 SQ YD FOR BITUMINOUS SURFACE REMOVAL 1/2" AND 28.0 TONS FOR BITUMINOUS CONCRETE SURFACE COURSE, SUPERPAVE, MIX "D", NTO HAVE BEEN INCLUDED IN THE PLANS.

CONSTRUCTION STAGING NOTES

PRE STAGE 1 & 1A - NIGHT TIME OPERATIONS

INSTALL RAMP CLOSURE ADVANCE INFORMATION SIGNS ON STAGE 1 RAMP CLOSURES A MINIMUM OF 2 WEEKS IN ADVANCE OF THE CLOSURE. SEE STAGE 1 RAMP CLOSURE GUIDELINES IN THE SPECIAL PROVISIONS.

COORDINATE 3 LANES OF TRAFFIC AT SB I-94 (DAN RYAN) STA. 1313+00 WITH CONTRACT #60B18 IN ORDER TO MAINTAIN TRAFFIC FLOW.

COORDINATE SINGLE LANE OF TRAFFIC AT WB I-94 TO I-57 CONNECTOR STA. 340+29 WITH CONTRACT *62304 IN ORDER TO MAINTAIN TRAFFIC FLOW.

PERFORM MEDIAN REMOVAL PARTIAL DEPTH OPERATIONS FROM SB I-57 STA, 129+25 TO STA, 131+77.

UTILIZE DISTRICT 1 DETAIL TC-17 TRAFFIC CONTROL DETAILS FOR FREEWAY SHOULDER CLOSURES TO INSTALL TEMPORARY PAVEMENT WIDENING AND AGGREGATE SHOULDER FROM SB I-57 STA. 131+78 TO STA. 146+45.

COMPLETE SHOULDER REHABILITATION FOR AREAS OF DAMAGED PAVEMENT PRIOR TO SHIFTING TRAFFIC.

REMOVE EXISTING PAVEMENT MARKINGS AND REPLACE WITH EPOXY PAVEMENT MARKINGS

REMOVE LENSES FROM RAISED REFLECTIVE PAVEMENT MARKERS.

INSTALL TEMPORARY CONCRETE BARRIER WALL AND REMAINING TEMPORARY TRAFFIC CONTROL DEVICES FOR STAGE 1 & 1A CONSTRUCTION.

COVER PERMANENT AND TEMPORARY SIGNS AS NEEDED.

STAGE 1 & 1A CONSTRUCTION (AUGUST 1ST, 2006 - NOVEMBER 30, 2006)

STAGE 1 CONSTRUCTS LANES 4, 5, & THE OUTSIDE SHOULDER ALONG THE MAINLINE SB I-94 (DAN RYAN), LANES 3, 4, & THE OUTSIDE SHOULDER ALONG SB I-57, AND RAMP TERMINALS ALONG BOTH SB I-94 AND SB I-57 INCLUDING ALL ADDITIONAL WORK WITHIN THE PROPOSED LIMITS.

STAGE 1 ALSO COMPLETES ALL JACKED IN PLACE STORM SEWERS. ADDITIONAL STAGING COORDINATION WITH CONTRACT *62304 MAY BE REQUIRED.

ALL REPAIR WORK IN THE SB I-94 (BISHOP FORD) AND CTA TUNNELS MUST BE COMPLETED AT THE BEGINNING OF STAGE 1. SEE SPECIAL PROVISIONS FOR THE INTERIM COMPLETION DATE.

MAINLINE SB I-94 (DAN RYAN) TRAFFIC WILL BE SHIFTED LEFT TO THE INSIDE SHOULDER IN 3-11' LANES UNTIL TRAFFIC IS SPLIT AT THE SB I-57 & SB I-94 (BISHOP FORD) JUNCTION. THE CENTER LANE WILL SPLIT INTO TWO LANES ALLOWING 2-11' LANES OF TRAFFIC TO BOTH SB I-57 & SB I-94 (BISHOP FORD). THE WB I-94 TO I-57 CONNECTOR WILL MERGE INTO THE SB I-57 TRAFFIC.

DURING STAGE 1, CONSTRUCTION WORK SHALL BE PROHIBITED BETWEEN SB I-57 STA. 119+18 AND STA. 141+46. THIS AREA IS REQUIRED TO CREATE A SAFER MERGE BETWEEN SB I-57 & THE WB I-94 TO SB I-57 CONNECTOR DUE TO THE TRAFFIC CONFIGURATION IN CONTRACT #62304.

STAGE 1A IS REQUIRED TO CONSTRUCT LANES 3, 4, & THE OUTSIDE SHOULDER FROM SB I-57 STA. 119+18 TO STA. 141+46. THIS STAGE WILL COINCIDE WITH STAGE 1 WHILE THE REMAINING STAGE 1 WORK IS COMPLETED AND MUST BE COORDINATED WITH CONTRACT #62304.

PRE STAGE WINTER LANE CONFIGURATION - NIGHT TIME OPERATIONS

PERFORM TEMPORARY PAVEMENT AND COLD MILLING OPERATIONS ALONG THE SB I-94 & SB I-57 (DAN RYAN) PRIOR TO THE START OF THE WINTER LANE CONFIGURATION.

COORDINATE 4 LANES OF TRAFFIC AT SB I-94 (DAN RYAN) STA. 1313+00 WITH CONTRACT #60B18 IN ORDER TO MAINTAIN TRAFFIC FLOW.

COORDINATE SINGLE LANE OF TRAFFIC AT WB I-94 TO I-57 CONNECTOR STA. 340+29 WITH CONTRACT *62304 IN ORDER TO MAINTAIN TRAFFIC FLOW.

REMOVE CONFLICTING TEMPORARY PAVEMENT MARKINGS FROM STAGES 1 & 1A AND REPLACE WITH EPOXY PAVEMENT MARKINGS.

RELOCATE TEMPORARY CONCRETE BARRIER WALL TO CREATE ADEQUATE SHOULDERS FOR SNOW STORAGE AND RELOCATE REMAINING TEMPORARY TRAFFIC CONTROL DEVICES FOR THE WINTER LANE CONFIGURATION.

INSTALL IMPACT ATTENUATOR, TEMPORARY (SEVERE USE, NARROW) AND REQUIRED TEMPORARY CONCRETE BARRIER TO PROTECT BLUNT END OF PERMANENT BARRIER WALL AT SB I-57 STA. 92+88.

COVER & UNCOVER PERMANENT AND TEMPORARY SIGNS AS NEEDED.

WINTER LANE CONFIGURATION (DECEMBER 1, 2006 - APRIL 1, 2007)

MAINLINE SB I-94 (DAN RYAN) TRAFFIC WILL BE SHIFTED LEFT TO THE INSIDE SHOULDER IN 4-11' LANES UNTIL TRAFFIC IS SPLIT AT THE SB I-57 & SB I-94 (BISHOP FORD) JUNCTION. THE RIGHT 2-11' LANES WILL WEAVE RIGHT TO SB I-57 WITH THE LEFT 2-11' LANES HEADING TO SB I-94 (BISHOP FORD). THE WB I-94 TO I-57 CONNECTOR WILL ADD A THIRD 11' LANE ALONG SB I-57.

PRE STAGE 2 & 2A - NIGHT TIME OPERATIONS

COORDINATE 3 LANES OF SPLIT TRAFFIC AT SB I-94 (DAN RYAN) STA. 1313+00 WITH CONTRACT *60B18 IN ORDER TO MAINTAIN TRAFFIC FLOW.

COORDINATE SINGLE LANE OF TRAFFIC AT WB I-94 TO I-57 CONNECTOR STA. 340+29 WITH CONTRACT \pm 62304 IN ORDER TO MAINTAIN TRAFFIC FLOW.

COORDINATE SINGLE LANE OF TRAFFIC AT EB I-57 TO I-94 CONNECTOR STA. 415+06 WITH CONTRACT \pm 62304 IN ORDER TO MAINTAIN TRAFFIC FLOW.

REMOVE CONFLICTING TEMPORARY PAVEMENT MARKINGS FROM THE WINTER LANE CONFIGURATION AND REPLACE WITH EPOXY OR PAVEMENT MARKING TAPE DEPENDING IF THE PAVEMENT IS EXISTING, NEWLY BUILT OR UNLESS DIRECTED OTHERWISE.

RELOCATE TEMPORARY CONCRETE BARRIER WALL AND REMAINING TEMPORARY TRAFFIC CONTROL DEVICES FOR STAGES 2 & 2A.

PERFORM TEMPORARY PAVEMENT AND COLD MILLING OPERATIONS PRIOR TO THE START OF STAGE 2A FROM DAN RYAN STA. 1260+00 TO 1270+00.

IMPLEMENT 87TH STREET ENTRANCE RAMP TEMPORARY DETOUR FOR TRAFFIC REQUIRING ACCESS TO SB I-94 (BISHOP FORD).

COVER & UNCOVER PERMANENT AND TEMPORARY SIGNS AS NEEDED.

STAGE 2 & 2A CONSTRUCTION (APRIL 2, 2007 - MAY 31, 2007)

STAGE 2 CONSTRUCTS LANE 3 ALONG THE MAINLINE SB I-94 (DAN RYAN) FROM STA. 1216+60 TO STA. 1313+00, PROPOSED STORM SEWER, AND CURB & GUTTER WITHIN THE SOUTH PORTION OF SB I-94 (BISHOP FORD) STA. 1143+00 & STA. 1151+00.

MAINLINE SB I-94 (DAN RYAN) TRAFFIC WILL BE SPLIT INTO 2-11' EXPRESS LANES SHIFTED LEFT TO THE INSIDE SHOULDER AND 1-11' LOCAL LANE SHIFTED RIGHT TO THE OUTSIDE SHOULDER UNTIL STA. 1216+60. A SLIP RAMP WILL BE PLACED BETWEEN STA. 1270+00 AND STA. 1280+00 TO ALLOW TRAFFIC FROM THE LOCAL LANES ACCESS TO THE EXPRESS LANES AND SB I-94 (BISHOP FORD). AN EXIT RAMP FROM THE EXPRESS LANES TO SB I-57 WILL ADD A SECOND LOCAL LANE AT SB I-57 STA. 157+33. THE WB I-94 TO I-57 CONNECTOR WILL ADD A THIRD LANE ALONG SB I-57. THE EB I-57 TO I-94 CONNECTOR WILL ADD AN ADIITIONAL LANE ALONG THE SB I-94 (BISHOP FORD) TRAFFIC.

THE CONTRACTOR MUST FIRST COMPLETE LANE 3 BETWEEN SB I-94 (DAN RYAN) STA. 1260+00 AND STA. 1270+00 IN ORDER TO IMPLEMENT STAGE 2A.

STAGE 2A IS REQUIRED TO CONSTRUCT LANE 3 BETWEEN SB I-94 (DAN RYAN) STA. 1270+00 AND STA. 1280+00. THE SLIP RAMP FROM THE LOCAL LANE TO EXPRESS LANES WILL BE MOVED BETWEEN SB I-94 (DAN RYAN) STA. 1260+00 AND STA. 1270+00. THIS STAGE WILL COINCIDE WITH STAGE 2 WHILE THE REMAINING STAGE 2 WORK IS COMPLETED.

PRE STAGE 3, 3A, 3B, 3C, & 3D - NIGHT TIME OPERATIONS

COORDINATE 3 LANES OF TRAFFIC AT SB I-94 (DAN RYAN) STA. 1313+00 WITH CONTRACT $\pm 60B18$ IN ORDER TO MAINTAIN TRAFFIC FLOW.

COORDINATE SINGLE LANE OF TRAFFIC AT WB I-94 TO I-57 CONNECTOR STA. 340+29 WITH CONTRACT \pm 62304 IN ORDER TO MAINTAIN TRAFFIC FLOW.

COORDINATE SINGLE LANE OF TRAFFIC AT EB I-57 TO I-94 CONNECTOR STA. 415+06 WITH CONTRACT \pm 62304 IN ORDER TO MAINTAIN TRAFFIC FLOW.

PERFORM TEMPORARY PAVEMENT AND COLD MILLING OPERATIONS FROM DAN RYAN STA. 1216+60 TO STA. 1221+60.

REMOVE CONFLICTING TEMPORARY PAVEMENT MARKINGS FROM STAGE 2 AND REPLACE WITH EPOXY OR PAVEMENT MARKING TAPE DEPENDING IF THE PAVEMENT IS EXISTING, NEWLY CONSTRUCTED, OR UNLESS DIRECTED OTHERWISE.

RELOCATE TEMPORARY CONCRETE BARRIER WALL AND REMAINING TEMPORARY TRAFFIC CONTROL DEVICES FOR STAGES 3, 3A, 3B, 3C, & 3D.

COVER & UNCOVER PERMANENT AND TEMPORARY SIGNS AS NEEDED.

STAGE 3 CONSTRUCTION (JUNE 1, 2007 - OCTOBER 31, 2007)

(NORTH OF SB I-94 (DAN RYAN) STA. 1221+60)

STAGE 3 CONSTRUCTS LANES 1, 2, & THE INSIDE SHOULDER ALONG THE MAINLINE SB I-94 (DAN RYAN) FROM STA. 1221+60 TO STA. 1313+00.

MAINLINE SB I-94 (DAN RYAN) TRAFFIC WILL BE SHIFTED RIGHT TO THE OUTSIDE SHOULDER IN 3-11' LANES UNTIL TRAFFIC IS SPLIT AT THE SB I-57 & SB I-94 (BISHOP FORD) JUNCTION. THE RIGHT 2-11' LANES WILL CONTINUE ALONG SB I-57 WITH THE LEFT 1-11' LANE CONTINUING ALONG THE SB I-94 (BISHOP FORD).

STAGE 3A, 3B, 3C, & 3D CONSTRUCTION (JUNE 1, 2007 - OCTOBER 31, 2007) (SOUTH OF SB I-94 (DAN RYAN) STA, 1221+60)

STAGES 3A, 3B, 3C, & 3D CONSTRUCT LANES 1, 2, & THE INSIDE SHOULDER ALONG SB I-57, LANE 3 TO SB I-94 (DAN RYAN) STA. 1216+60, AND THE REMAINING PROPOSED STORM SEWER, CURB & GUTTER, SHOULDERS, TUNNEL WORK, & RESURFACING OPERATIONS ALONG SB I-94 (BISHOP FORD) AND THE EB I-57 TO I-94 CONNECTOR.

IN STAGE 3A, MAINLINE I-94 (DAN RYAN) TRAFFIC WILL BE SPLIT FOR THE SB I-57 & SB I-94 (BISHOP FORD) JUNCTION AT STA. 1221+60. THE WB I-94 TO I-57 CONNECTOR WILL ADD A THIRD LANE ALONG SB I-57, BUT WILL BE PROHIBITED FROM EXITING AT HALSTED STREET. THE EB I-57 TO I-94 CONNECTOR WILL ADD AN ADDITIONAL LANE ALONG THE SB I-94 (BISHOP FORD) TRAFFIC. THIS STAGE WILL COINCIDE WITH STAGE 3 WHILE THE REMAINING WORK IS COMPLETED AND MUST BE COORDINATED WITH CONTRACT #62304.

THE CONTRACTOR MUST FIRST COMPLETE THE REMAINING WORK FROM LANE 2 AT SB I-57 STA. 121+40 EXTENDING TO LANE 3 AT SB I-94 (DAN RYAN) STA. 1216+60, PORTIONS OF STORM SEWER, CURB AND GUTTER, AND SHOULDER ALONG THE INSIDE OF THE EB I-57 TO I-94 CONNECTOR, TEMPORARY PAVEMENT WIDENING AND PORTIONS OF STORM SEWER FROM SB I-94 (BISHOP FORD) STA. 1126+89 TO STA. 1143+16, AND THE TUNNEL WORK ALONG THE OUTSIDE OF SB I-94 (BISHOP FORD) IN ORDER TO IMPLEMENT STAGE 3B.

STAGE 3B IS REQUIRED TO CONSTRUCT LANES 1, 2, AND THE INSIDE SHOULDER WITHIN SB I-57 STA. 89+45 AND WB I-94 TO I-57 CONNECTOR STA. 340+29, ALL REMAINING STORM SEWER, CURB & GUTTER, AND SHOULDER ITEMS ALONG SB I-94 (BISHOP FORD) AND THE EB I-57 TO I-94 CONNECTOR, AND THE TUNNEL WORK ALONG THE INSIDE OF SB I-94 (BISHOP FORD). THIS STAGE WILL COINCIDE WITH STAGE 3 WHILE THE REMAINING WORK IS COMPLETED AND MUST BE COORDINATED WITH CONTRACT #62304.

IN STAGE 3B, MAINLINE I-94 (DAN RYAN) TRAFFIC WILL BE SPLIT FOR THE SB I-57 & SB I-94 (BISHOP FORD) JUNCTION AT STA. 152+92. THE WB I-94 TO I-57 CONNECTOR WILL MERGE INTO THE SB I-57 TRAFFIC. THE EB I-57 TO I-94 CONNECTOR WILL ADD AN ADDITIONAL LANE ALONG THE SB I-94 (BISHOP FORD) TRAFFIC. THE SB I-57 WILL BE IN 2-11' LANES BEGINNING AT STA. 149+91.

THE CONTRACTOR MUST COMPLETE ALL CONSTRUCTION FROM SB I-57 STA, 89+45 TO STA, 107+16 EXCEPT WORK CONSTRAINED BY THE LIMITED WORKING SPACE IN ORDER TO IMPLEMENT STAGE 3C.

THE CONTRACTOR MUST ALSO COMPLETE ALL DRAINAGE WORK ON THE SB I-94 (BISHOP FORD) AND COMPLETE RECONSTRUCTION WORK ON THE DAN RYAN FROM STA. 1205+00 TO 1221+60 PRIOR TO IMPLEMENTING STAGE 3C.

STAGE 3C IS REQUIRED TO TO GIVE THE CONTRACTOR ENOUGH WORKING SPACE TO POUR LANES 1, 2, & THE INSIDE SHOULDER BETWEEN SB I-57 STA. 89+45 AND STA. 107+16. THIS STAGE WILL COINCIDE WITH STAGES 3 & 3B WHILE THE REMAINING WORK IS COMPLETED. AT SB I-57 STA. 108+58 THE RIGHT LANE OF TRAFFIC WILL BE FORCED ONTO THE HALSTED ST. EXIT RAMP AND ONLY A SINGLE 11' LANE OF TRAFFIC WILL BE USED ALONG SB I-57.

IN STAGE 3C, MAINLINE TRAFFIC WILL BE EXPANDED TO 4-11' LANES AT SB I-94 (DAN RYAN) STA. 1215+53. THE TRAFFIC WILL SPLIT AT SB I-57 STA. 152+92. THE SB I-94 (BISHOP FORD) TRAFFIC WILL BE WIDENED TO 2-12' LANES. THE SBI-57 TRAFFIC WILL BE IN THE SAME LANE CONFIGURATION AS STAGE 3B THROUGH STA. 108+58 WHEN TRAFFIC IS REDUCED TO ONE LANE. THE EB I-57 TO I-94 TRAFFIC WILL BE WIDENED TO 1-12' LANE WHERE IT WILL ADD AN ADDITIONAL LANE TO THE SB I-94 (BISHOP FORD).

THE CONTRACTOR MUST FIRST COMPLETE LANES 1, 2, & THE INSIDE SHOULDER IN STAGE 3C FROM SB I-57 STA. 89+45 TO STA. 107+16 IN ORDER TO IMPLEMENT STAGE 3D. A 2-WEEK TIME LIMIT WILL BE APPLIED TO THIS SECTION DUE TO SEVERE TRAFFIC CONSTRAINTS.

STAGE 3D IS REQUIRED TO INCREASE SB I-57 FROM 1-11' LANE TO 2-11' LANES BETWEEN STA. 89+45 AND STA. 107+16. THIS STAGE WILL COINCIDE WITH STAGES 3, 3B, & 3C WHILE THE REMAINING WORK IS COMPLETED.


REVISIONS
NAME
DATE

F.A.I. 94 (DAN RYAN EXPRESSWAY)
GENERAL NOTES
CONSTRUCTION STAGING NOTES
MAINTENANCE OF TRAFFIC DETAILS
SHEET 1 OF 12

SCALE: NO SCALE
DRAWN BY: RTM

DATE: MARCH 1, 2006


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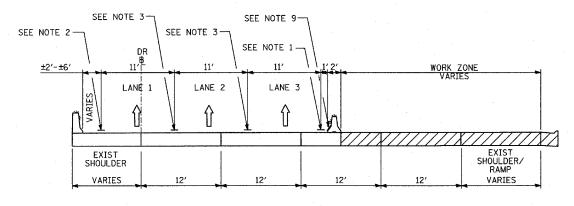
A-A

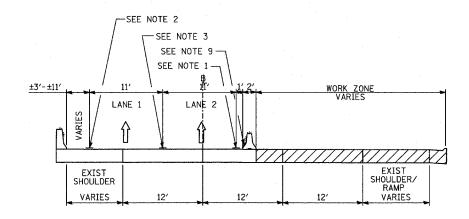STAGE 1: SB I-57; STA. 88+55 TO STA. 119+18


STAGE 1A: SB I-57; STA. 88+55 TO STA. 119+18




<u>B-B</u> STAGE 1: SB I-57; STA. 132+04 TO STA. 141+46

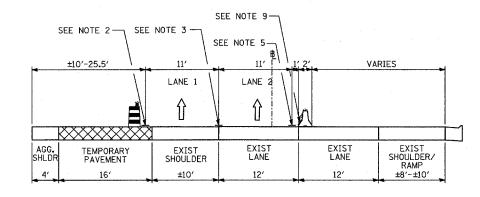

STAGE 1: SB I-94 DAN RYAN; STA. 1205+33 TO STA. 1313+00

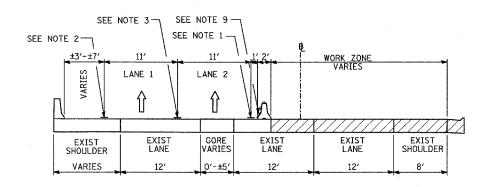

STAGE 1A: SB I-57; STA. 119+18 TO STA. 124+50

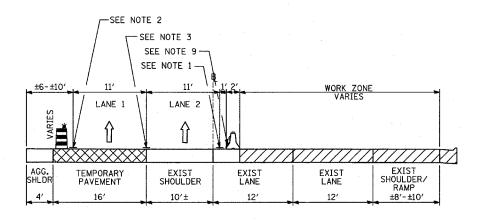

STAGE 1A: SB I-57; STA. 132+04 TO STA. 141+46

NOTE 1 - EPOXY PAVEMENT MARKING-LINE 4" (WHITE)

SECTION

• (1516.1, 1717, & 1818) R-5

COUNTY TOTAL SHEET NO.

764 176

62593

соок

STA. 88+60 (SB 1-57) TO STA. 1313+00 (SB RYAN FED. ROAD DIST. NO. | ILLINOIS | FED. AID | PROJECT

NOTE 2 - EPOXY PAVEMENT MARKING-LINE 4" (YELLOW)

NOTE 3 - EPOXY PAVEMENT MARKING-SKIP-DASH 5" (WHITE), 10' LINE WITH 30' SPACE

NOTE 4 - EPOXY PAVEMENT MARKING LINE 8" (WHITE)

NOTE 5 - PAVEMENT MARKING TAPE, TYPE III 4" LINE (WHITE)

NOTE 6 - PAVEMENT MARKING TAPE, TYPE III 4" LINE (YELLOW)

NOTE 7 - PAVEMENT MARKING TAPE, TYPE III 5" SKIP-DASH (WHITE), 10' LINE WITH 30' SPACE

NOTE 8 - PAVEMENT MARKING TAPE, TYPE III 8" LINE (WHITE)

NOTE 9 - TEMPORARY PAVEMENT MARKING-LINE 6" (WHITE)

NOTE 10 - TEMPORARY PAVEMENT MARKING-LINE 6" (YELLOW)

LEGEND:

TEMPORARY CONCRETE BARRIER (WITH REFLECTORS ON TOP AND SIDE FACING TRAFFIC)

TRAFFIC MOVEMENT

DRUM WITH MONO-DIRECTIONAL STEADY BURNING LIGHT

SINGLE-FACE CONCRETE BARRIER, 32"

SINGLE-FACE CONCRETE BARRIER, 32" (WITH REFLECTORS ON TOP AND SIDE FACING TRAFFIC)

PAVEMENT REMOVAL AREA

TEMPORARY PAVEMENT

*ALL MOT TYPICAL SECTIONS ARE DRAWN IN THE DIRECTION OF TRAFFIC


REVISIONS
NAME DATE

ILLINOIS DEPARTMENT OF TRANSPORTATION
F.A.I. 94 (DAN RYAN EXPRESSWAY)
GENERAL NOTES
CONSTRUCTION STAGING NOTES

CONSTRUCTION STAGING NOTES
MAINTENANCE OF TRAFFIC DETAILS
SHEET 2 OF 12


SCALE: NO SCALE
DATE: MARCH 1, 2006

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CHECKED BY: TGB

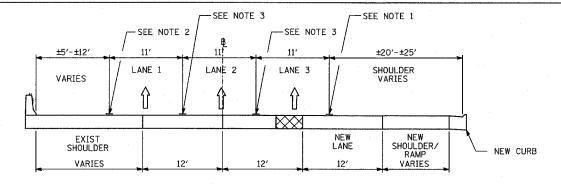


F-F

WINTER LANE CONFIGURATION: SB I-57; STA. 88+60 TO STA. 103+83 STAGE 2: SB I-57; STA. 88+60 TO STA. 103+83 STAGE 3A: SB I-57; STA. 88+60 TO 103+83

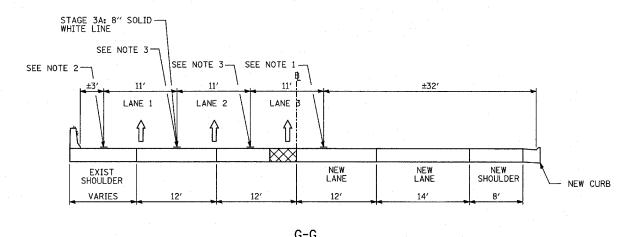


WINTER LANE CONFIGURATION: SB I-57; STA. 108+28 TO STA. 118+28 STAGE 2: SB I-57; STA. 108+28 TO STA. 118+28 STAGE 3A: SB I-57; STA. 108+28 TO STA. 113+35

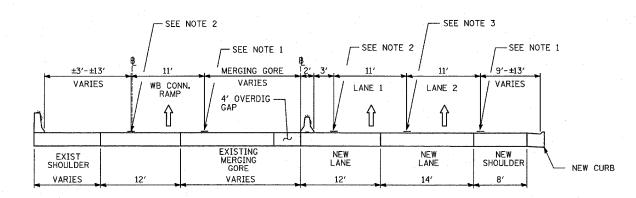

WINTER LANE CONFIGURATION: SB I-57; STA. 123+00 TO STA. 129+00 STAGE 2: SB I-57; STA. 122+28 TO STA. 129+00

SEE NOTE 3-SEE NOTE 2 SEE NOTE 1 -±36'-±40' LANE 1 LANE 2 4' OVERDIG -AGG. SHLDR NEW LANE NEW LANE NEW SHOULDER TEMPORARY EXIST SHOULDER PAVEMENT NEW CURB <u>I-I</u>

WINTER LANE CONFIGURATION: SB I-57; STA. 132+60 TO STA. 143+89 STAGE 2: SB I-57; STA. 132+60 TO STA. 143+89

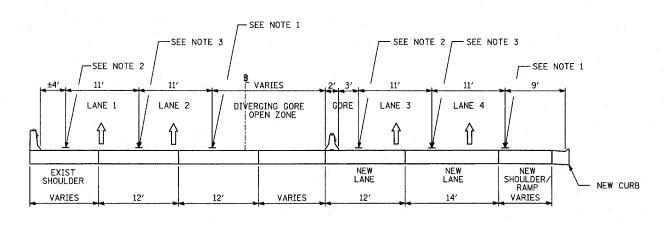

WINTER LANE CONFIGURATION: SB I-57; STA. 149+92 TO STA. 154+40

NOTE 1 - EPOXY PAVEMENT MARKING-LINE 4" (WHITE)

SECTION

* (1516.1, 1717, & 1818) R-5

TOTAL SHEE SHEETS NO.

764 177

62593

COUNTY

COOK

STA. 88+60 (SB I-57) TO STA. 1313+00 (SB RYAN

FED. ROAD DIST. NO. ILLINOIS FED. AID PROJECT

NOTE 2 - EPOXY PAVEMENT MARKING-LINE 4" (YELLOW)

NOTE 3 - EPOXY PAVEMENT MARKING-SKIP-DASH 5" (WHITE), 10' LINE WITH 30' SPACE

NOTE 4 - EPOXY PAVEMENT MARKING LINE 8" (WHITE)

NOTE 5 - PAVEMENT MARKING TAPE, TYPE III 4" LINE (WHITE)

NOTE 6 - PAVEMENT MARKING TAPE, TYPE III 4" LINE (YELLOW)

NOTE 7 - PAVEMENT MARKING TAPE, TYPE III 5" SKIP-DASH (WHITE), 10' LINE WITH 30' SPACE

NOTE 8 - PAVEMENT MARKING TAPE, TYPE III 8" LINE (WHITE)

NOTE 9 - TEMPORARY PAVEMENT MARKING-LINE 6" (WHITE)

NOTE 10 - TEMPORARY PAVEMENT MARKING-LINE 6" (YELLOW)

LEGEND:

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TEMPORARY CONCRETE BARRIER (WITH REFLECTORS ON TOP AND SIDE FACING TRAFFIC)

TRAFFIC MOVEMENT

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DRUM WITH MONO-DIRECTIONAL STEADY BURNING LIGHT

SINGLE-FACE CONCRETE BARRIER, 32"

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SINGLE-FACE CONCRETE BARRIER, 32" (WITH REFLECTORS ON TOP AND SIDE FACING TRAFFIC)

PAVEMENT REMOVAL AREA

T

TEMPORARY PAVEMENT


*ALL MOT TYPICAL SECTIONS ARE DRAWN IN THE DIRECTION OF TRAFFIC

REVISIONS
NAME DATE
F


ILLINOIS DEPARTMENT OF TRANSPORTATION
F.A.I. 94 (DAN RYAN EXPRESSWAY)
GENERAL NOTES
CONSTRUCTION STAGING NOTES
MAINTENANCE OF TRAFFIC DETAILS
SHEET 3 OF 12

SCALE: NO SCALE
DATE: MARCH 1, 2006


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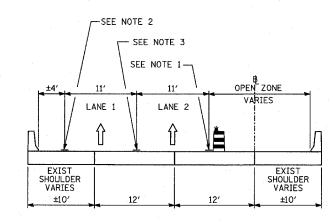
WINTER LANE CONFIGURATION: SB I-94 DAN RYAN; STA. 1217+27 TO 1313+00

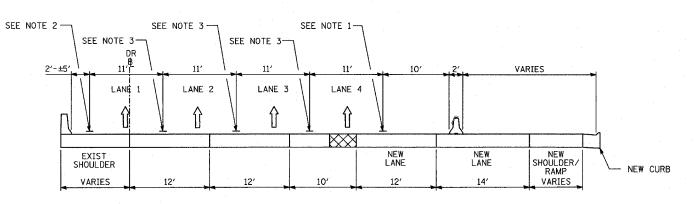


STAGE 2: SB I-94 DAN RYAN; STA. 1216+60 TO STA. 1270+00 STAGE 2: SB I-94 DAN RYAN; STA. 1282+51 TO STA. 1313+00 STAGE 2A: SB I-94 DAN RYAN; STA. 1216+60 TO STA. 1260+00 STAGE 2A: SB I-94 DAN RYAN; STA. 1272+51 TO STA. 1313+00

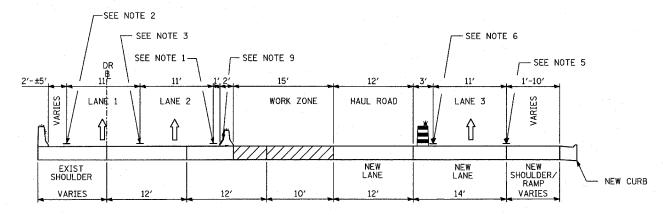

M-M STAGE 2: SB I-94 BISHOP FORD; STA. 1137+07 TO STA. 1142+61

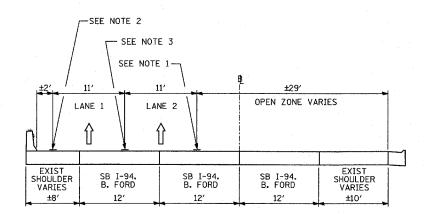

N-N
STAGE 2: SB I-94 BISHOP FORD; STA. 1151+57 TO STA. 1164+00

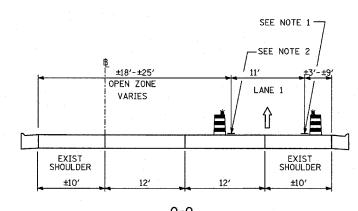

<u>0-0</u> STAGE 2: EB CROSS CONNECTOR; STA. 415+06 TO STA. 421+00

_	F.A.I. RTE.	A.I. SECTION 94 +			COUN	TY	TOTAL SHEETS	SHEET NO.
	94				COO	COOK		178
	STA.	88+60 (SB 1 1126+91 (SB	-57) FORE)T(STA	. 131	3+00 (SB	RYAN
	FED. RO	AD DIST. NO.	ILLIN	DIS	FED.	AID	PROJECT	•
* (1516.1, 1717, & 181				R	-5		- 6	2597

NOTE 1 - EPOXY PAVEMENT MARKING-LINE 4" (WHITE)

NOTE 2 - EPOXY PAVEMENT MARKING-LINE 4" (YELLOW)

NOTE 3 - EPOXY PAVEMENT MARKING-SKIP-DASH 5" (WHITE), 10' LINE WITH 30' SPACE

NOTE 4 - EPOXY PAVEMENT MARKING LINE 8" (WHITE)

NOTE 5 - PAVEMENT MARKING TAPE, TYPE III 4" LINE (WHITE)

NOTE 6 - PAVEMENT MARKING TAPE, TYPE III 4" LINE (YELLOW)

NOTE 7 - PAVEMENT MARKING TAPE, TYPE III 5" SKIP-DASH (WHITE), 10' LINE WITH 30' SPACE

NOTE 8 - PAVEMENT MARKING TAPE, TYPE III 8" LINE (WHITE)

NOTE 9 - TEMPORARY PAVEMENT MARKING-LINE 6" (WHITE)

NOTE 10 - TEMPORARY PAVEMENT MARKING-LINE 6" (YELLOW)

LEGEND:

TEMPORARY CONCRETE BARRIER (WITH REFLECTORS ON TOP AND SIDE FACING TRAFFIC)

TRAFFIC MOVEMENT

DRUM WITH MONO-DIRECTIONAL STEADY BURNING LIGHT

SINGLE-FACE CONCRETE BARRIER, 32"

SINGLE-FACE CONCRETE BARRIER, 32" (WITH REFLECTORS ON TOP AND SIDE FACING TRAFFIC)

PAVEMENT REMOVAL AREA

TEMPORARY PAVEMENT


*ALL MOT TYPICAL SECTIONS ARE DRAWN IN THE DIRECTION OF TRAFFIC

REVISIONS
NAME
DATE


ILLINOIS DEPARTMENT OF TRANSPORTATION
F.A.I. 94 (DAN RYAN EXPRESSWAY)
GENERAL NOTES
CONSTRUCTION STAGING NOTES
MAINTENANCE OF TRAFFIC DETAILS
SHEET 4 OF 12

SCALE: NO SCALE
DATE: MARCH 1, 2006


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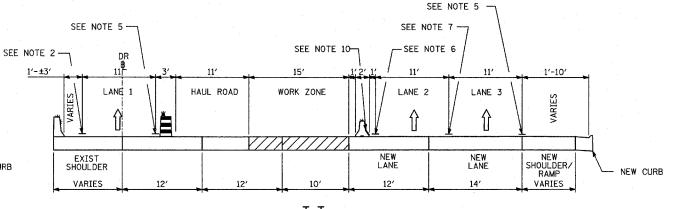
STAGE 3: SB I-94 DAN RYAN; STA. 1221+60 TO STA. 1313+00 STAGE 3B: SB I-94 DAN RYAN; STA. 1205+00 TO STA. 1221+60

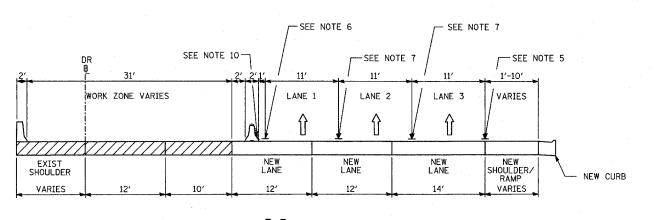


STAGE 3A: SB I-57; STA. 149+92 TO STA. 155+37

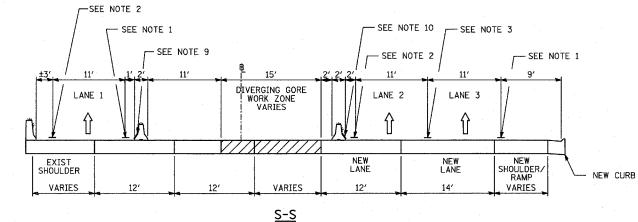

Q-QSTAGE 3A: SB I-57; STA. 120+40 TO STA. 126+00

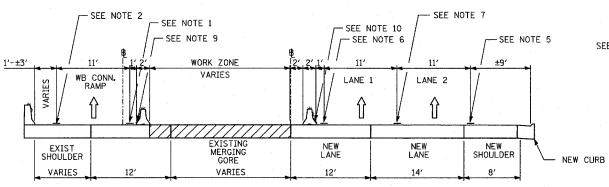

STAGE 3A: SB I-94 DAN RYAN; STA. 1205+00 TO STA. 1216+60

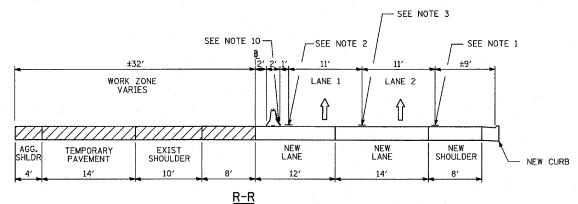

STAGE 3A: SB I-57; STA. 132+05 TO STA. 143+90

		REVISIONS	
. II	DATE	REVISIONS NAME	
F.A			
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SCALE:			

ILLINOIS DEPARTMENT OF TRANSPORTATION A.I. 94 (DAN RYAN EXPRESSWAY) GENERAL NOTES CONSTRUCTION STAGING NOTES MAINTENANCE OF TRAFFIC DETAILS

SHEET 5 OF 12

SECTION

• (1516.1, 1717, & 1818) R-5

NOTE 1 - EPOXY PAVEMENT MARKING-LINE 4" (WHITE)

NOTE 2 - EPOXY PAVEMENT MARKING-LINE 4" (YELLOW)

NOTE 3 - EPOXY PAVEMENT MARKING-SKIP-DASH 5" (WHITE), 10' LINE WITH 30' SPACE

NOTE 4 - EPOXY PAVEMENT MARKING LINE 8" (WHITE) NOTE 5 - PAVEMENT MARKING TAPE, TYPE III 4" LINE (WHITE) NOTE 6 - PAVEMENT MARKING TAPE, TYPE III 4" LINE (YELLOW)

NOTE 7 - PAVEMENT MARKING TAPE, TYPE III 5" SKIP-DASH (WHITE), 10' LINE WITH 30' SPACE

NOTE 9 - TEMPORARY PAVEMENT MARKING-

NOTE 10 - TEMPORARY PAVEMENT MARKING-LINE 6" (YELLOW)

TRAFFIC MOVEMENT

TEMPORARY CONCRETE BARRIER (WITH REFLECTORS ON TOP AND SIDE FACING TRAFFIC)

DRUM WITH MONO-DIRECTIONAL STEADY BURNING LIGHT

SINGLE-FACE CONCRETE BARRIER, 32"

SINGLE-FACE CONCRETE BARRIER, 32" (WITH REFLECTORS ON TOP AND SIDE FACING TRAFFIC)

PAVEMENT REMOVAL AREA

TEMPORARY PAVEMENT

*ALL MOT TYPICAL SECTIONS ARE DRAWN IN THE DIRECTION OF TRAFFIC

NOTE 8 - PAVEMENT MARKING TAPE, TYPE III 8" LINE (WHITE)

LINE 6" (WHITE)

LEGEND:

COUNTY COOK

STA. 88+60 (SB I-57) TO STA. 1313+00 (SB RYAN


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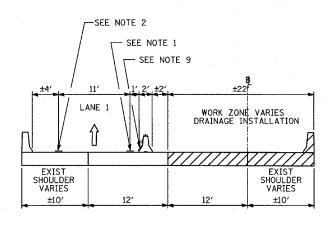
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NO SCALE DATE: MARCH 1, 2006 DRAWN BY: CHECKED BY: TGB


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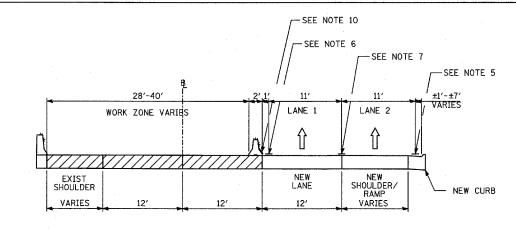
<u>U-U</u> STAGE 3A: SB I-94 BISHOP FORD; STA. 1133+92 TO STA. 1143+07




<u>V-V</u> STAGE 3A: SB I-94 BISHOP FORD; STA. 1151+57 TO STA. 1164+00

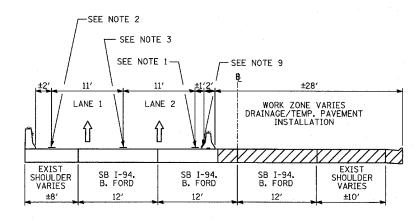

<u>W-W</u>
STAGE 3A: EB CROSS CONNECTOR; STA. 415+06 TO STA. 421+81

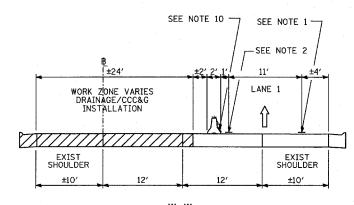

X-X STAGE 3B: SB I-57: STA. 89+60 TO STA. 103+98

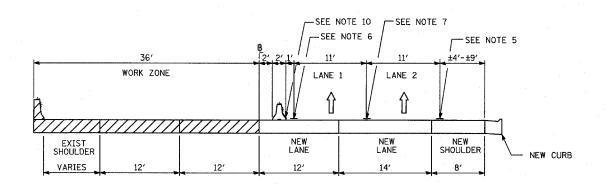

STAGE 3B: SB I-57; STA. 107+16 TO STA. 121+36 STAGE 3C: SB I-57; STA. 107+16 TO STA. 121+36 STAGE 3D: SB I-57; STA. 107+16 TO STA. 121+36

NOTE 1 - EPOXY PAVEMENT MARKING-LINE 4" (WHITE)

• (1516.1, 1717, & 1818) R-5

COUNTY

COOK

STA. 88+60 (SB I-57) 1126+91 (SB FORD)TO STA. 1313+00 (SB RYAN)

FED. ROAD DIST. NO. ILLINOIS FED. AID PROJECT

764 180

62593

NOTE 2 - EPOXY PAVEMENT MARKING-LINE 4" (YELLOW)

NOTE 3 - EPOXY PAVEMENT MARKING-SKIP-DASH 5" (WHITE), 10" LINE WITH 30" SPACE

NOTE 4 - EPOXY PAVEMENT MARKING LINE 8" (WHITE)

NOTE 5 - PAVEMENT MARKING TAPE, TYPE III 4" LINE (WHITE)

NOTE 6 - PAVEMENT MARKING TAPE, TYPE III 4" LINE (YELLOW)

NOTE 7 - PAVEMENT MARKING TAPE, TYPE III 5" SKIP-DASH (WHITE), 10' LINE WITH 30' SPACE

NOTE 8 - PAVEMENT MARKING TAPE, TYPE III 8" LINE (WHITE)

NOTE 9 - TEMPORARY PAVEMENT MARKING-LINE 6" (WHITE)

NOTE 10 - TEMPORARY PAVEMENT MARKING-LINE 6" (YELLOW)

LEGEND:

TEMPORARY CONCRETE BARRIER (WITH REFLECTORS ON TOP AND SIDE FACING TRAFFIC)

TRAFFIC MOVEMENT



DRUM WITH MONO-DIRECTIONAL STEADY BURNING LIGHT

SINGLE-FACE CONCRETE BARRIER, 32"

Ü

SINGLE-FACE CONCRETE BARRIER, 32" (WITH REFLECTORS ON TOP AND SIDE FACING TRAFFIC)

PAVEMENT REMOVAL AREA

TEMPORARY PAVEMENT

*ALL MOT TYPICAL SECTIONS ARE DRAWN IN THE DIRECTION OF TRAFFIC

REVISIONS DATE


ILLINOIS DEPARTMENT OF TRANSPORTATION
F.A.I. 94 (DAN RYAN EXPRESSWAY)
GENERAL NOTES
CONSTRUCTION STAGING NOTES
MAINTENANCE OF TRAFFIC DETAILS

SHEET 6 OF 12

LE: NO SCALE DRAWN BY: RTM

SCALE: NO SCALE
DATE: MARCH 1, 2006

CHECKED BY: TGB

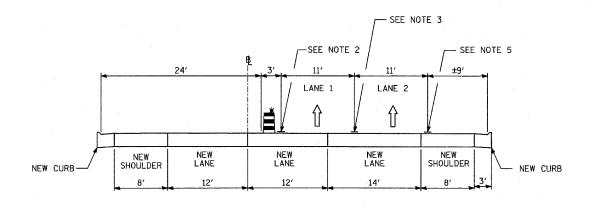


Z-Z


STAGE 3B: SB I-57; STA. 132+05 TO STA. 143+90

STAGE 3C: SB I-57; STA. 132+05 TO STA. 143+90


STAGE 3D: SB I-57; STA. 132+05 TO STA. 143+90

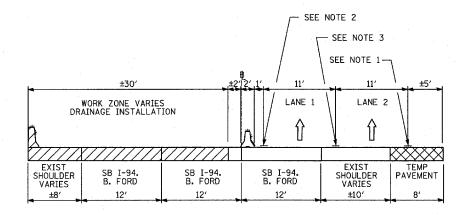


STAGE 3B: SB I-94 BISHOP FORD; STA. 1128+03 TO STA. 1143+00

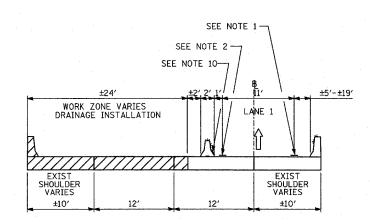

BB-BB
STAGE 3B: SB I-94 BISHOP FORD; STA. 1152+00 TO STA. 1167+00

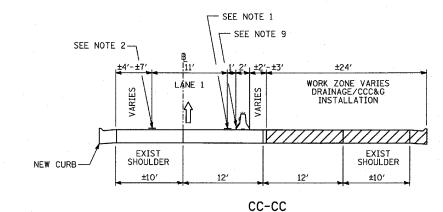

STAGE 3B: EB CROSS CONNECTOR; STA. 415+06 TO STA. 421+81

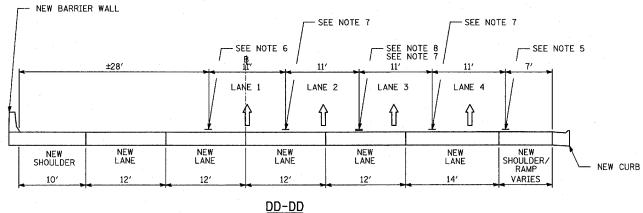

<u>DD-DD</u> STAGE 3C: SB I-57; STA. 150+58 TO STA. 154+68

COUNTY

SECTION

NOTE 1 - EPOXY PAVEMENT MARKING-LINE 4" (WHITE)

NOTE 2 - EPOXY PAVEMENT MARKING-LINE 4" (YELLOW)

NOTE 3 - EPOXY PAVEMENT MARKING-SKIP-DASH 5" (WHITE), 10' LINE WITH 30' SPACE

NOTE 4 - EPOXY PAVEMENT MARKING

NOTE 5 - PAVEMENT MARKING TAPE, TYPE III 4" LINE (WHITE)

NOTE 6 - PAVEMENT MARKING TAPE, TYPE III 4" LINE (YELLOW)

NOTE 7 - PAVEMENT MARKING TAPE, TYPE III 5" SKIP-DASH (WHITE), 10' LINE WITH 30' SPACE

NOTE 8 - PAVEMENT MARKING TAPE, TYPE III 8" LINE (WHITE)

NOTE 9 - TEMPORARY PAVEMENT MARKING-LINE 6" (WHITE)

NOTE 10 - TEMPORARY PAVEMENT MARKING-LINE 6" (YELLOW)

LEGEND:

TEMPORARY CONCRETE BARRIER (WITH REFLECTORS ON TOP AND SIDE FACING TRAFFIC)

TRAFFIC MOVEMENT

DRUM WITH MONO-DIRECTIONAL STEADY BURNING LIGHT

SINGLE-FACE CONCRETE BARRIER, 32"

SINGLE-FACE CONCRETE
BARRIER, 32" (WITH
REFLECTORS ON TOP AND
SIDE FACING TRAFFIC)

PAVEMENT REMOVAL AREA

TEMPORARY PAVEMENT

*ALL MOT TYPICAL SECTIONS ARE DRAWN IN THE DIRECTION OF TRAFFIC


REVISIONS
NAME DATE

ILLINOIS DEPARTMENT OF TRANSPORTATION
F.A.I. 94 (DAN RYAN EXPRESSWAY)
GENERAL NOTES
CONSTRUCTION STAGING NOTES


CONSTRUCTION STAGING NOTES
MAINTENANCE OF TRAFFIC DETAILS
SHEET 7 OF 12

SCALE: NO SCALE
DATE: MARCH 1, 2006


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CHECKED BY: TGB

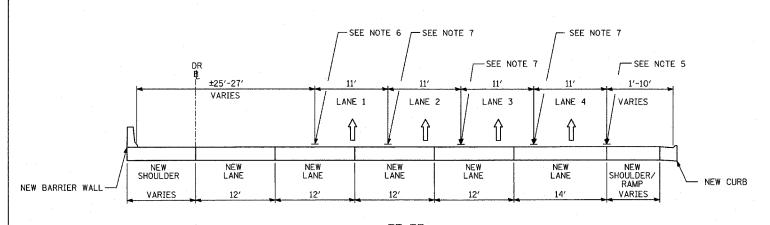


<u>EE-EE</u> STAGE 3C: SB I-94 DAN RYAN; STA. 1205+00 TO STA. 1215+53

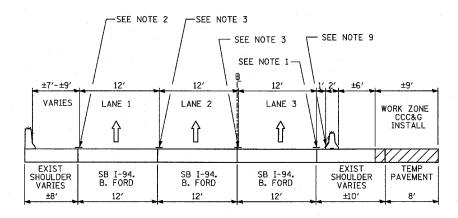


FF-FF
STAGE 3C: SB I-94 BISHOP FORD; STA. 1127+00 TO STA. 1143+04

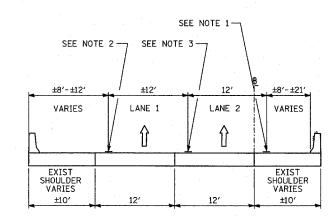


GG-GG STAGE 3C: SB I-94 BISHOP FORD; STA. 1152+00 TO STA. 1167+00

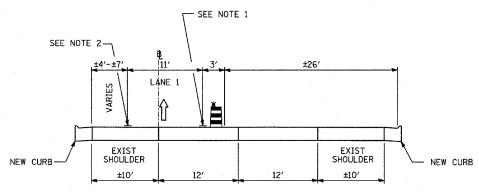

HH-HH
STAGE 3C: EB CROSS CONNECTOR; STA. 415+06 TO STA. 421+81

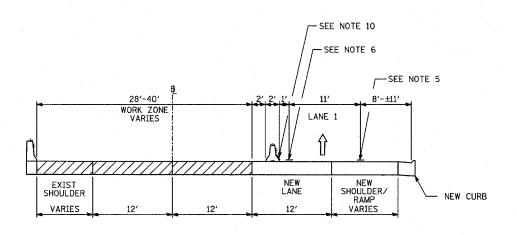

<u>II-II</u> STAGE 3C: SB I-57; STA. 88+60 TO STA. 103+98

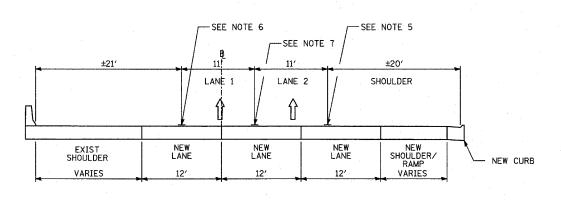

<u>JJ-JJ</u> STAGE 3D: SB I-57; STA. 87+48 TO 97+48

NOTE 1		EDOVY DAVEMENT	MADIZTNIC
NOTE	-	EPOXY PAVEMENT LINE 4" (WHITE)	MARKING.

SECTION

* (1516.1, 1717, & 1818) R-5

TOTAL SHEET SHEETS NO.

764 182

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COUNTY

STA. 88+60 (SB I-57) 1126+91 (SB FORD)TO STA. 1313+00 (SB RYAN)

FED. ROAD DIST. NO. ILLINOIS FED. AID PROJECT

LEGEND:

TEMPORARY CONCRETE BARRIER (WITH REFLECTORS ON TOP AND SIDE FACING TRAFFIC)

TRAFFIC MOVEMENT

DRUM WITH MONO-DIRECTIONAL STEADY BURNING LIGHT

SINGLE-FACE CONCRETE BARRIER, 32"

SINGLE-FACE CONCRETE BARRIER, 32" (WITH REFLECTORS ON TOP AND SIDE FACING TRAFFIC)

PAVEMENT REMOVAL AREA

TEMPORARY PAVEMENT


*ALL MOT TYPICAL SECTIONS ARE DRAWN IN THE DIRECTION OF TRAFFIC

CHECKED BY: TGB

REVISIONS
NAME
DATE
F.A.I. 94 (DAN RYAN EXPRESSWAY)
GENERAL NOTES
CONSTRUCTION STAGING NOTES
MAINTENANCE OF TRAFFIC DETAILS
SHEET 8 OF 12

SCALE: NO SCALE
DRAWN BY: RTM

DATE: MARCH 1, 2006

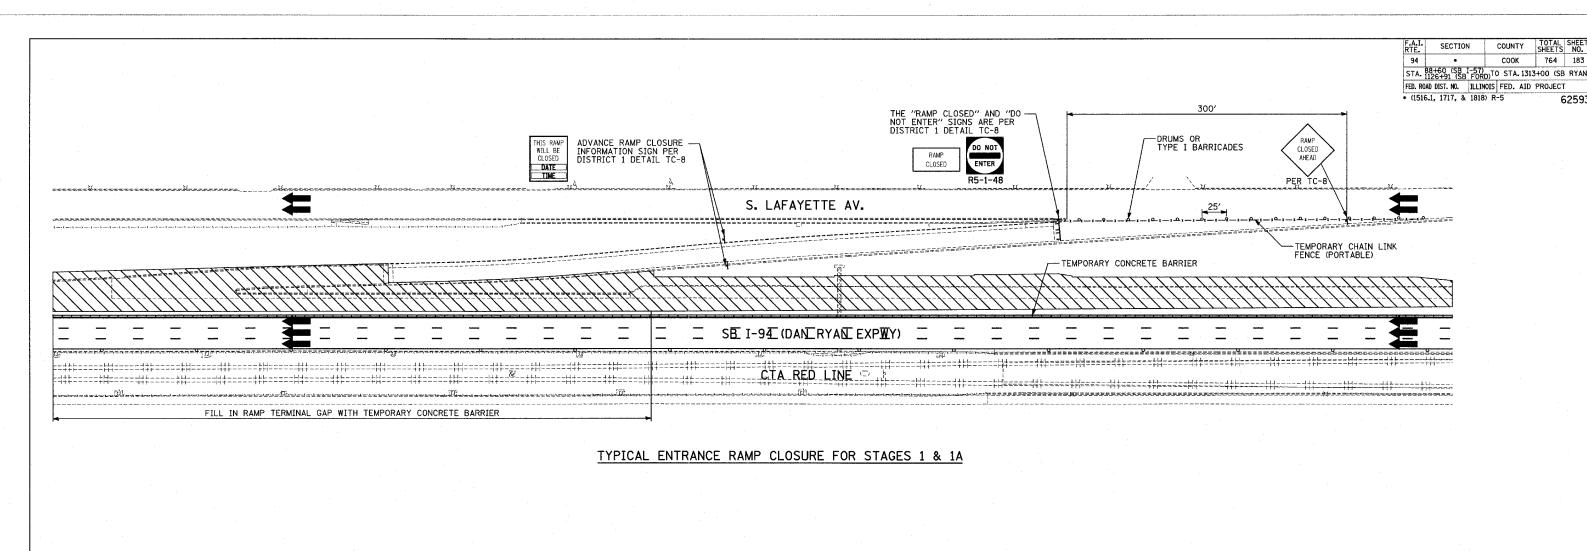

764 183

F.A.I. 94 (DAN RYAN EXPRESSWAY) GENERAL NOTES CONSTRUCTION STAGING NOTES

MAINTENANCE OF TRAFFIC DETAILS SHEET 9 OF 12


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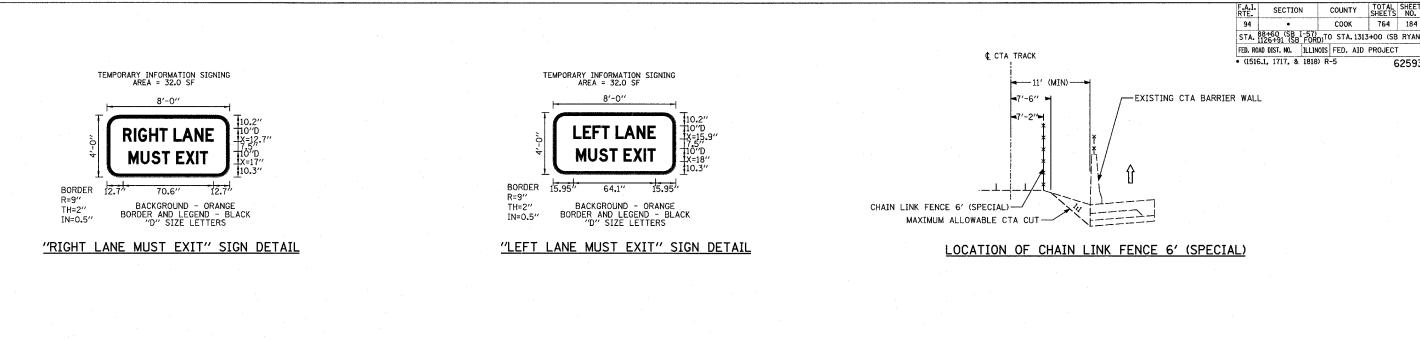
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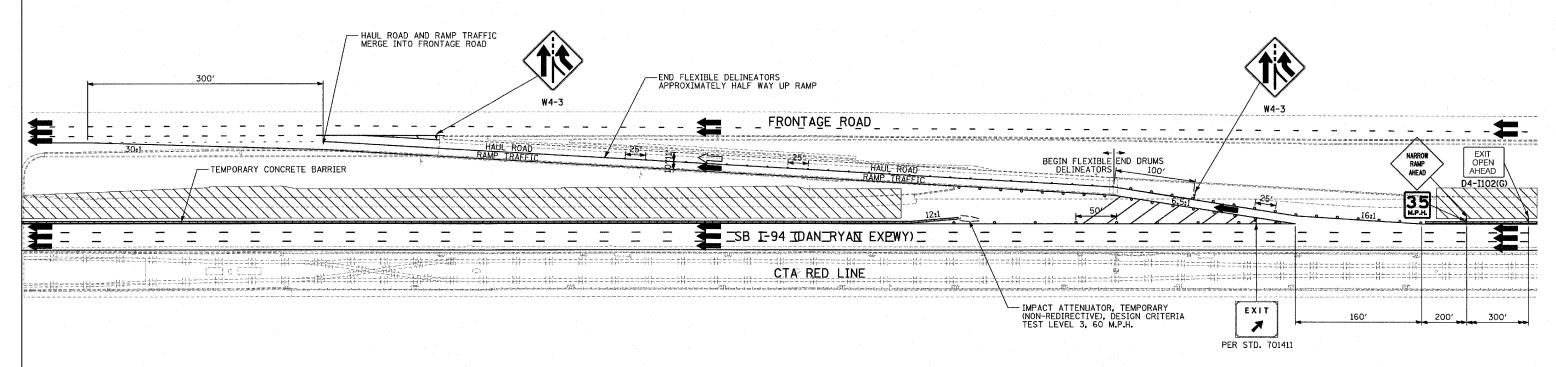
04/15/05 DATE: MARCH 1, 2006

WORK ZONE FOR LANES 4, 5, OUTSIDE SHOULDER, AND RAMP TERMINAL




TYPICAL EXIT RAMP CLOSURE FOR STAGES 1 & 1A



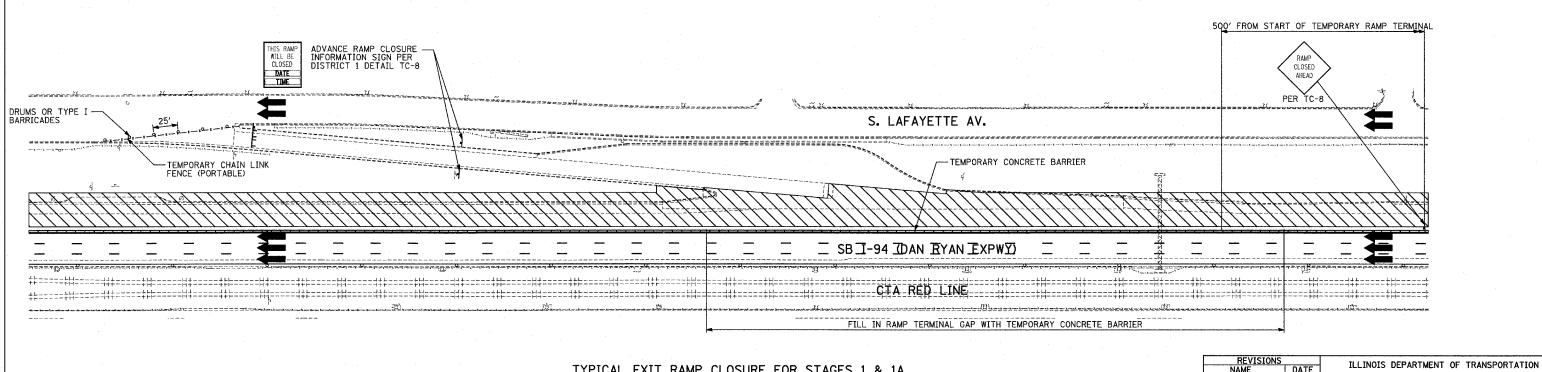

SUGGESTED MAINTENANCE OF TRAFFIC STAGE 1 WORK ZONE EGRESS DETAIL


(AT HALSTED ST., WENTWORTH AVE., & 95TH ST. RAMPS)

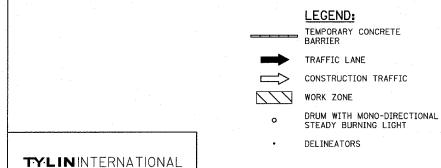


NOTES:

- 1. ALL CONSTRUCTION VEHICLES MUST STAY WITHIN THE HAUL ROAD. CROSSING EXIT RAMP TRAFFIC IS PROHIBITED.
- 2. THE CONTRACTOR SHALL BE RESPONSIBLE TO DIFFERENTIATE BETWEEN THE RAMP EXIT AND HAUL ROAD ENTRANCE.
- THE CONTRACTOR SHALL UTILIZE EITHER THE A.I.S. OR C-D ROADWAY TO MERGE HAUL ROAD AND RAMP TRAFFIC AT ALL OTHER EXIT RAMP LOCATIONS. A STOP SIGN SHALL BE PLACED AT THE UPSTREAM END OF THE C-D ROADWAY TO STOP TRAFFIC ON THE RAMP FROM THE FRONTAGE ROAD.
- ALL SIGNING FROM DISTRICT 1 DETAIL TC-18 SHALL BE APPLIED TO THE ABOVE DETAIL AND ANY OTHER WORK ZONE ACCESS OPTIONS WHICH MAY BE USED BY THE CONTRACTOR.
- SEE FOLLOWING SHEET FOR TYPICAL CROSS-SECTIONS AT EACH LOCATION.


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			CONST	RUCTION	STAGIN	G NOT	ES	
			MAINTEN	IANCE OF	TRAFFI	C DET	AILS	
				SHEET	10 OF 1	2		
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		SCALE	NO SCALE		DRAWN	D1:	L I I IVI	
		DATE:	MARCH 1.	2006	CHECK	ED BY:	TGB	

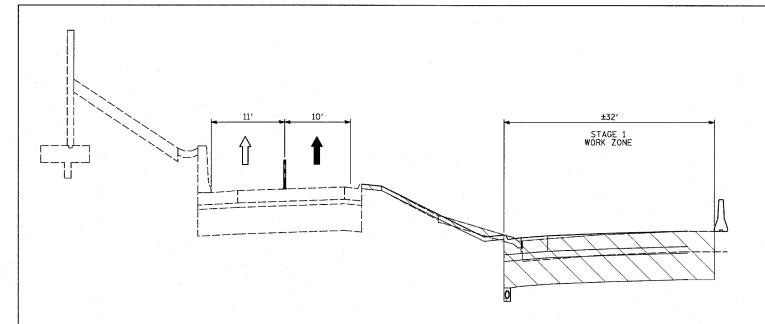

TYPICAL CROSS SECTION OF WORK ZONE EGRESS AT HALSTED ST. EXIT

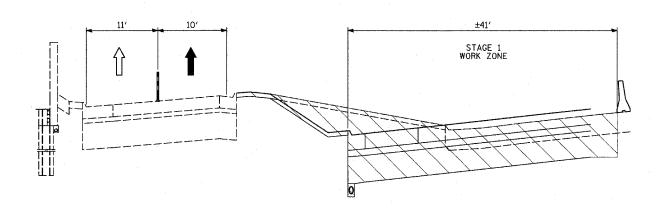


TYPICAL CROSS SECTION OF WORK ZONE EGRESS AT WENTWORTH AVE. EXIT

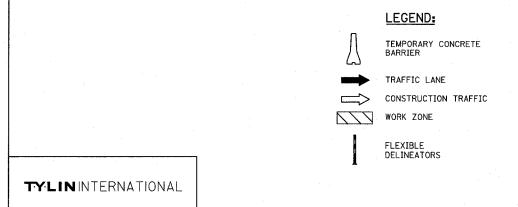



COOK 764 185 STA. 88+60 (SB I-57) 1126+91 (SB FORD)TO STA. 1313+00 (SB RYAN) FED. ROAD DIST. NO. | ILLINOIS | FED. AID | PROJECT * (1516.1, 1717, & 1818) R-5

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TYPICAL CROSS SECTION OF WORK ZONE EGRESS AT 95TH ST. EXIT

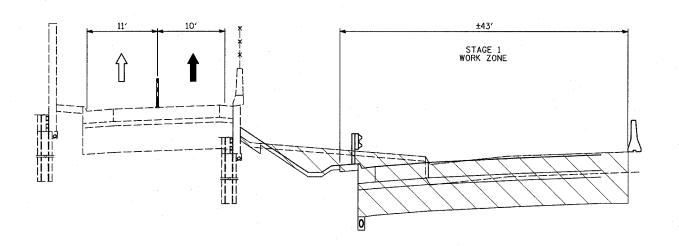

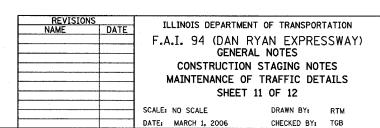

NOTES:
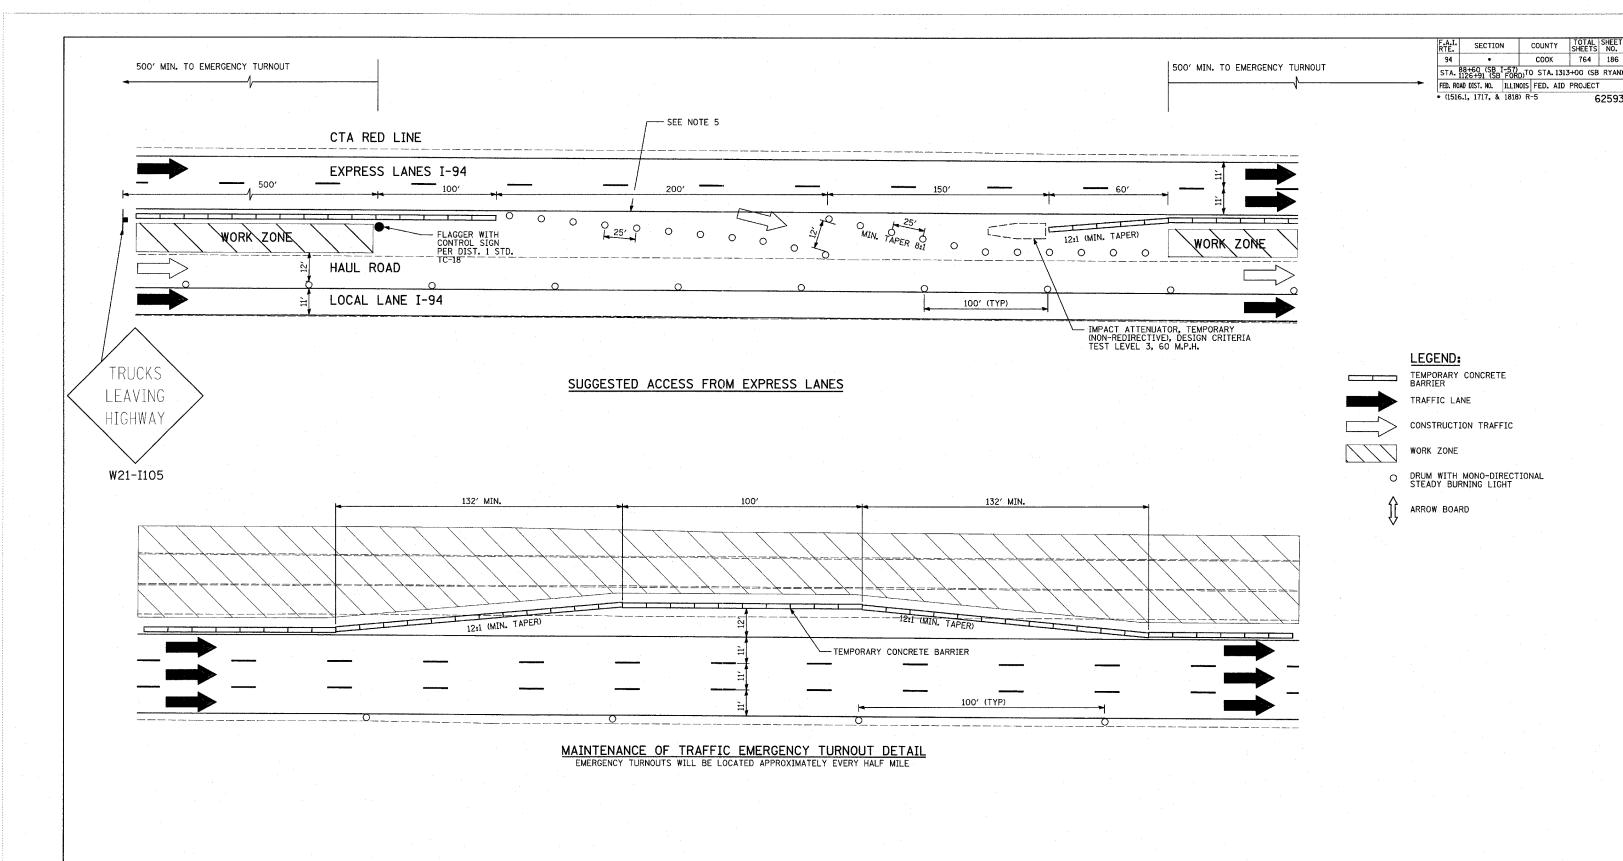
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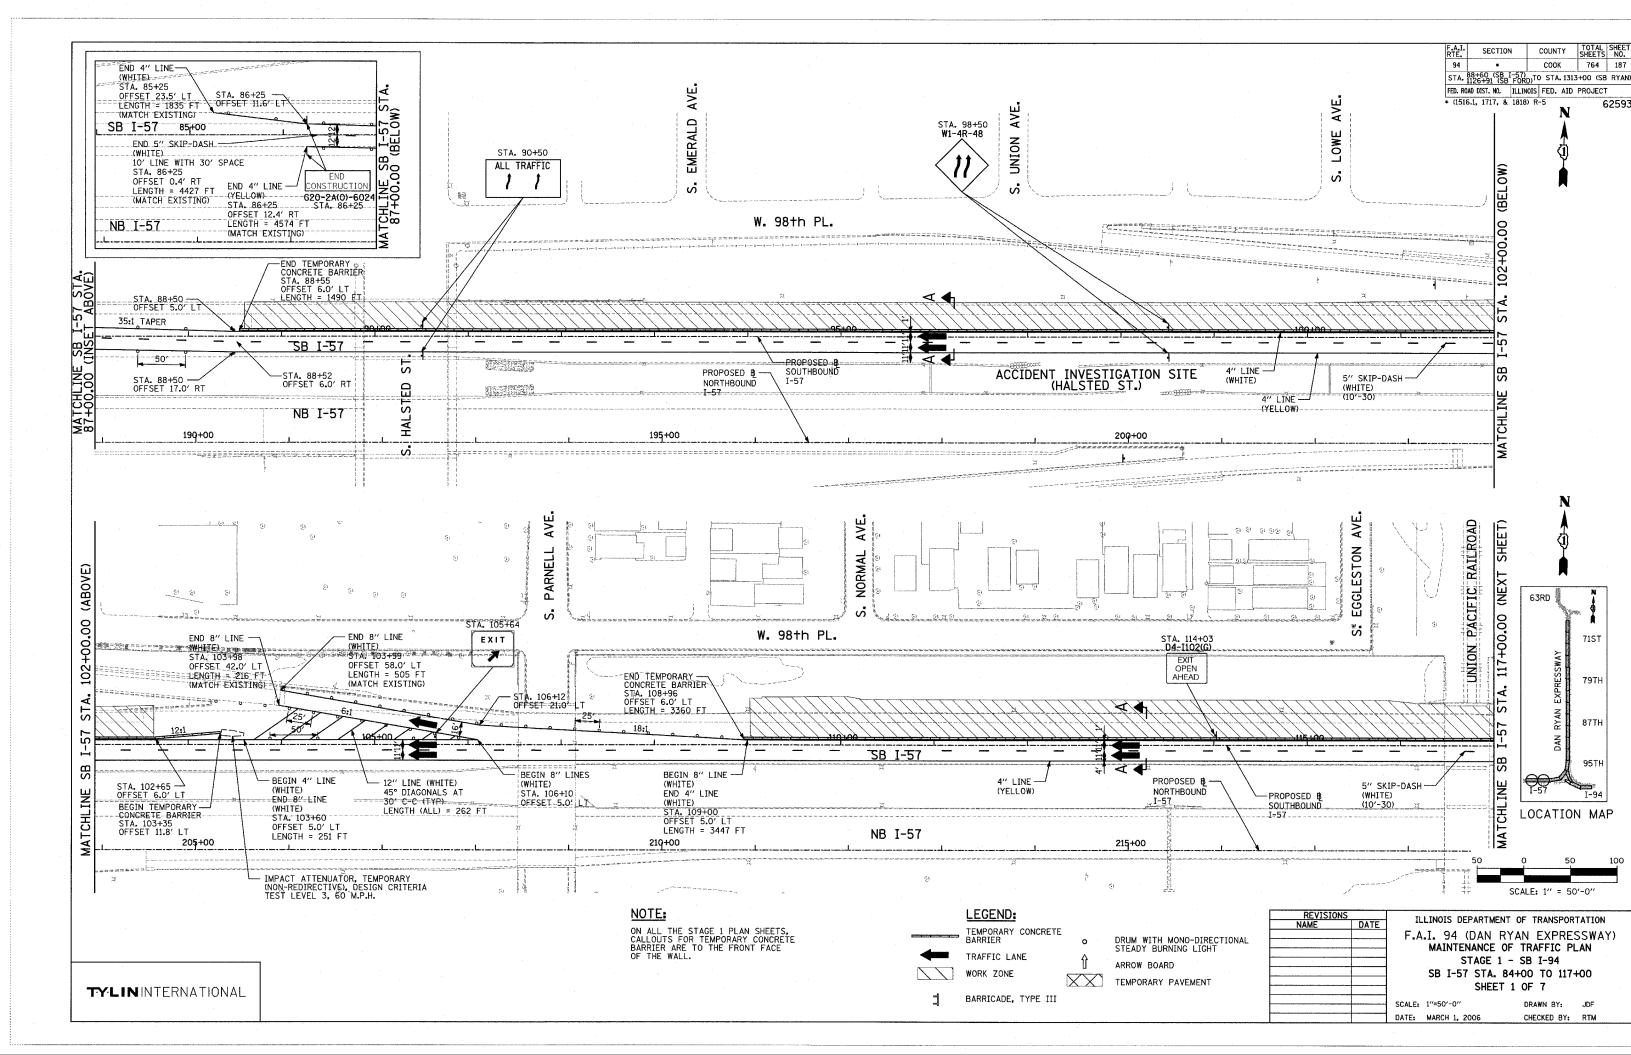
- 1. THERE CAN BE NO MORE THAN TWO (2) WORK ZONE ACCESS/EGRESS COMBINATIONS AND THE CONTRACTOR MUST MAINTAIN AT LEAST ONE (1) EXPRESS LANE ACCESS DURING STAGE 2 CONSTRUCTION.
- THE CONTRACTOR SHALL NOT ENTER OR EXIT THE HAUL ROAD WITHIN THE 100' BARREL-SPACING AREA. WORK ZONE ACCESS AND EGRESS WILL ONLY BE PERMITTED AT THE DESIGNATED LOCATIONS.


- 3. FOR EXPRESS LANE WORK ZONE EGRESS, TAPER LENGTHS SHALL FOLLOW DISTRICT 1 STANDARD TC-18.
- 4. THE CONTRACTOR SHALL CLOSE OPENINGS WITH BARRELS WHEN NOT BEING USED FOR ACCESS.
- 5. TEMPORARY PAVEMENT MARKINGS SHALL BE CARRIED THRU THE OPENING.


REVISIONS	5 T	ILLINOIS DEPARTMENT OF TRANSPORTATION			
NAME	DATE				
		F.A.I. 94 (DAN RYAN EXPRESSWAY) GENERAL NOTES			
		CONSTRUCTION STAGING NOTES			
		MAINTENANCE OF TRAFFIC DETAILS			
		SHEET 12 OF 12			

SCALE: NO SCALE
DATE: MARCH 1, 2006

DRAWN BY: RTM CHECKED BY: TGB



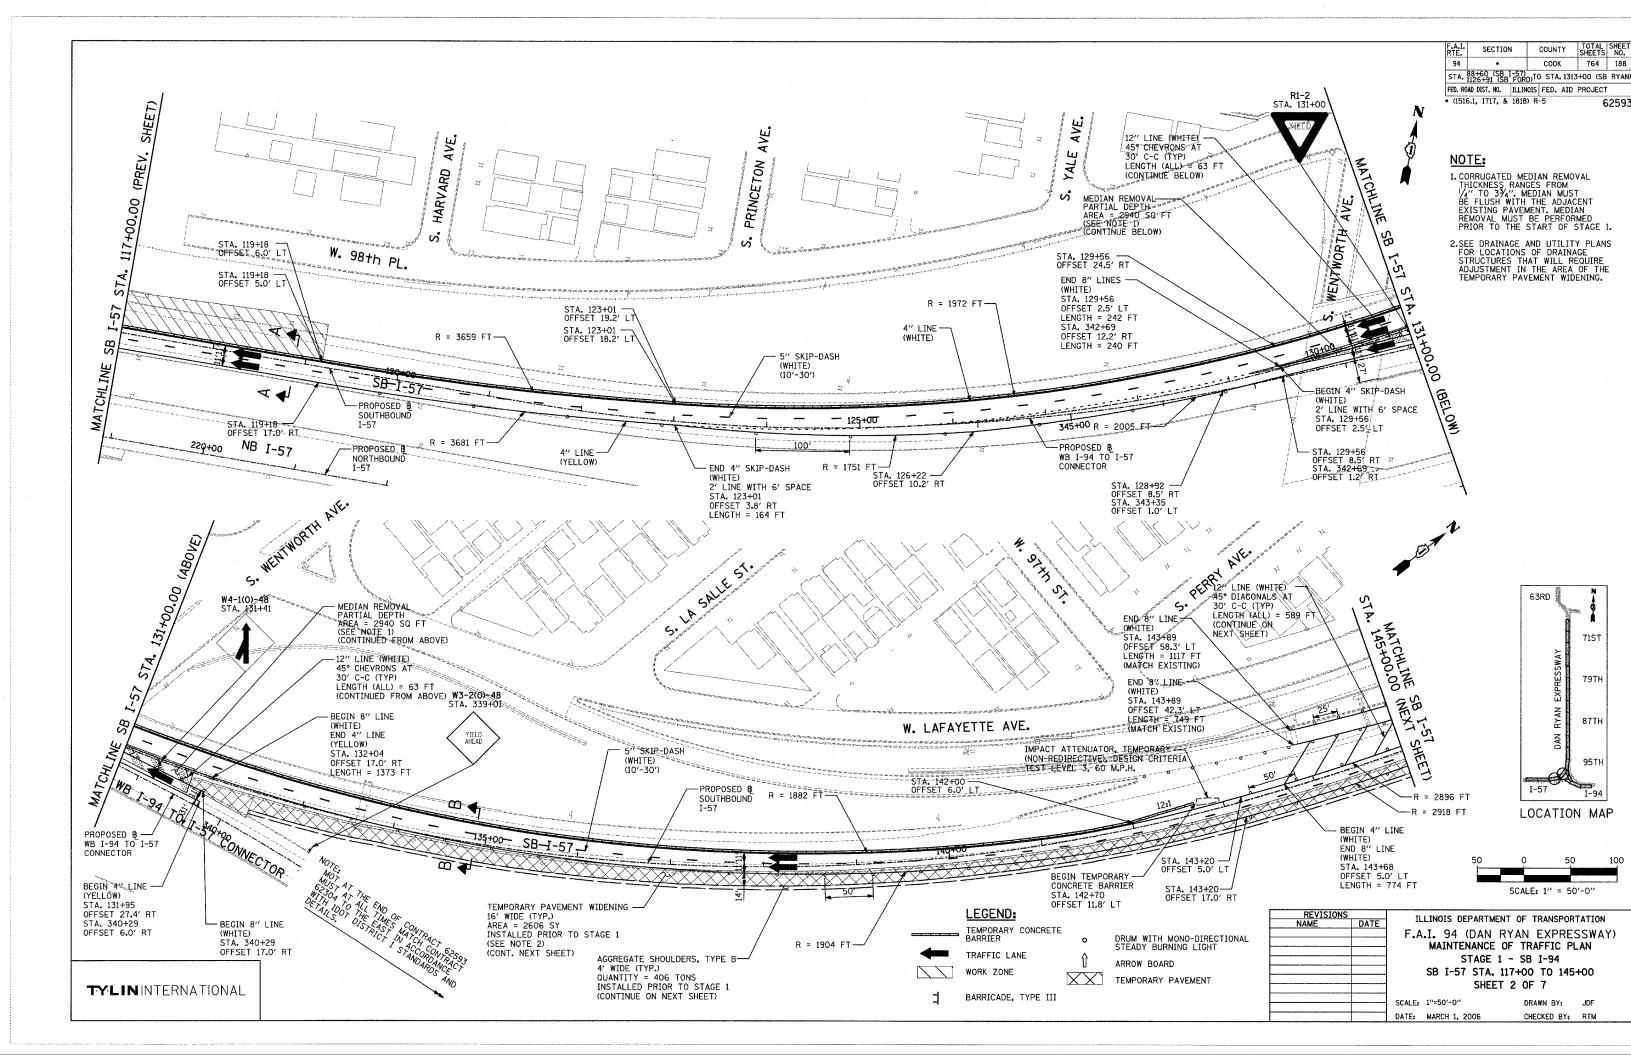

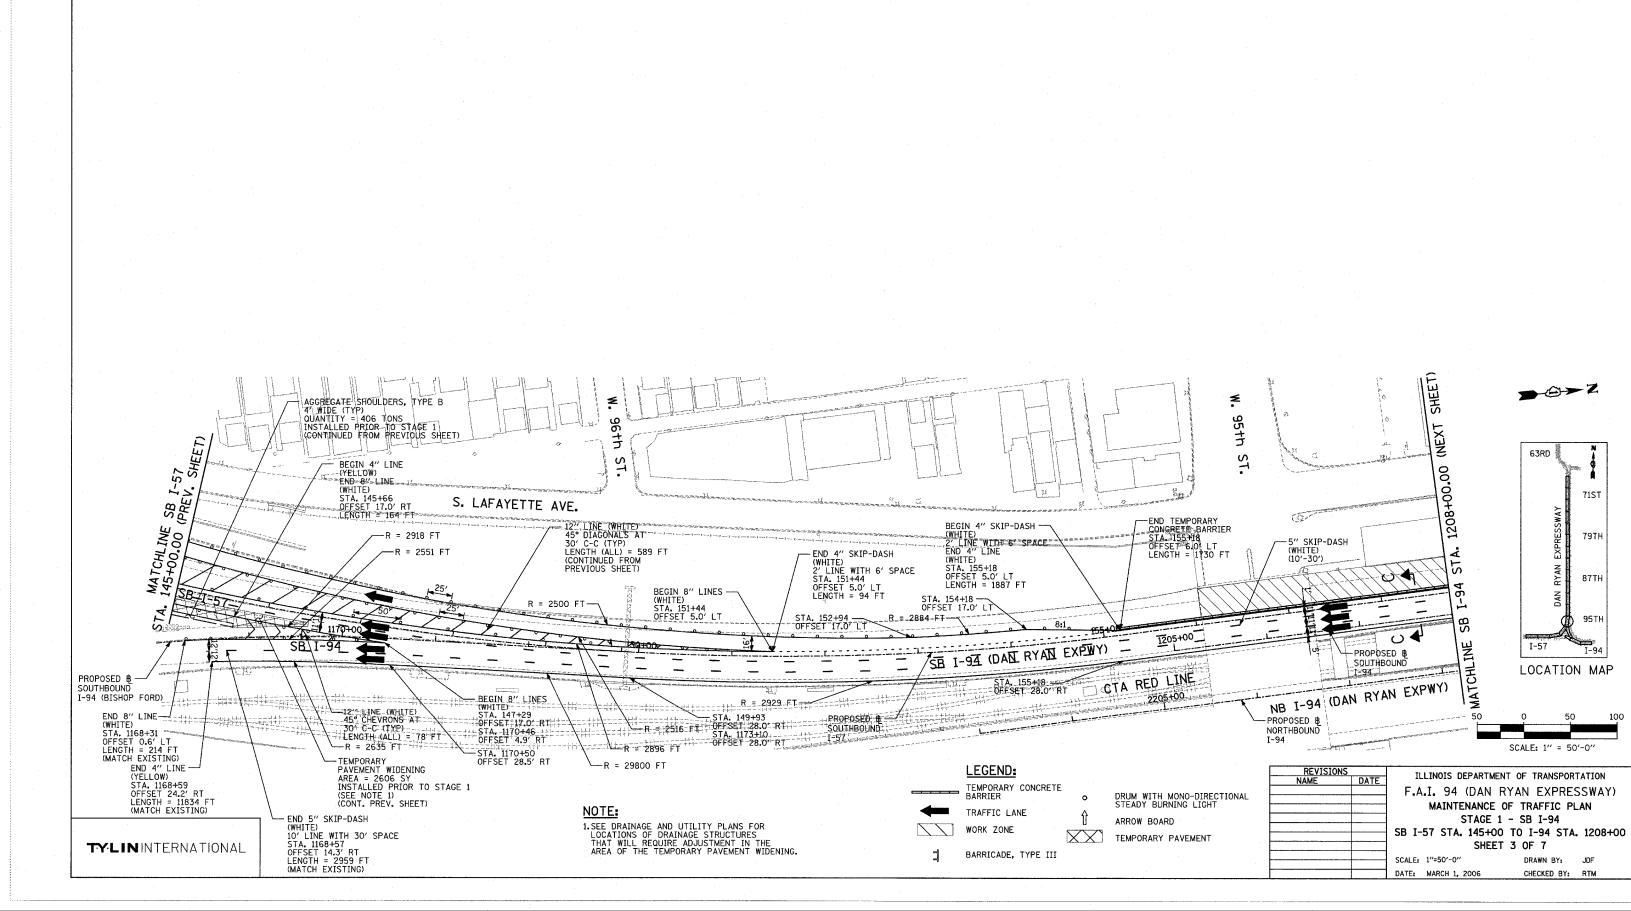

SECTION

COUNTY

COOK

STA. 88+60 (SB I-57) 1126+91 (SB FORD)TO STA. 1313+00 (SB RYAN FED. ROAD DIST. NO. | ILLINOIS | FED. AID PROJECT | 1516.1, 1717, & 1818) R-5 | 62

TOTAL SHEE SHEETS NO.

764 189

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