STATE OF ILLINOIS

DEPARTMENT OF TRANSPORTATION

DIVISION OF HIGHWAYS

PLANS FOR PROPOSED

PLAN - 1"=50' CONSTRUCTION DETAILS - 1"=1'

F.A.U. ROUTE 1585 (119TH STREET) **KOSTNER AVENUE TO PULASKI AVENUE** STREET LIGHTING

> PROJECT NO.:M-8003 (410) **SECTION NO.: 02-00079-00-LT**

VILLAGE OF ALSIP

COOK COUNTY

JOB NO.: C-91-203-04

FEDERAL AID HIGHWAY

LOCATED IN THE VILLAGE OF: ALSIP. ILLINOIS

000001-04 Standard Symbols, Abbreviations and Patterns


Lane Closure, Multilane, Intersection,

For Speeds < 45 MPH

Lane Closure, 2L 2W, Day Or Night Operations,

Lane Closure, Multilane, 2W, With Mountable Median,

Lane Closure, Multilane, 1W Or 2W, Crosswalk or Sidewalk Closure,

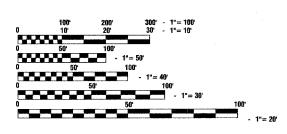

INDEX OF SHEETS

3-4. PLAN SHEETS

STATE STANDARDS

701501-03

701606-04

701701-04

701801-03

5.

6-9.


COVER SHEET

SUMMARY OF QUANTITIES

SINGLE LINE DIAGRAM

CONSTRUCTION DETAILS

FULL SIZE PLANS HAVE BEEN PREPARED USING STANDARD ENGINEERING SCALES, REDUCED SIZED PLANS WILL NOT CONFORM TO STANDARD SCALES, IN MAKING MEASUREMENTS ON REDUCED PLANS, THE ABOVE SCALES MAY BE USED.

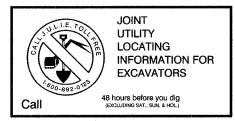



CONTRACT NO. 83841




GROSS LENGTH=2,185 FEET=0.42 MILES

SECTION COUNTY TOTAL SHEET NO FED. ROAD DIST. NO. ILLUNOIS FED. AID PROJECT

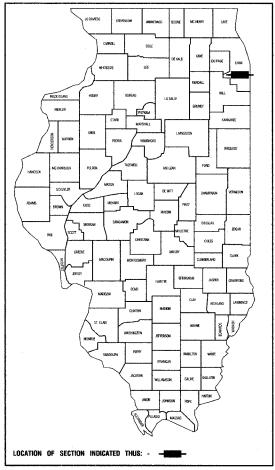


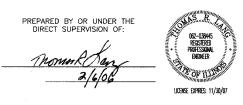


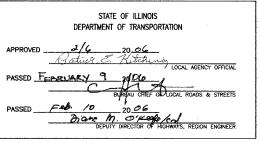


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	·	SUMMARY OF QUANTITIES	1		FAVEMENT	WARKINGS		NSTRUCTION		SIGNALS	TRAINING	<u> </u>	
ITEM #	CODE NO.	PAY ITEM	UNIT	QUAN	SFTY-18	SFTY-1D			Y030-1E	Y031	Y080		
* 1	21101615	TOPSOIL, FURNISH AND PLACE, 4"	SQ YD	852				852					
2	21300010	EXPLORATION TRENCH, SPECIAL	FOOT	200					200			1	
* 3	25200650	SODDING, SALT TOLERANT (SPECIAL)	SQ YD	852				852					
* 4	42400200	PORTLAND CEMENT CONCRETE SIDEWALK, 5 INCH	SQ FT	100	100								
* 5	44000600	SIDEWALK REMOVAL	SQ FT	100	100								
6	67100100	MOBILIZATION	L SUM	1					1			T	
7	70102620	TRAFFIC CONTROL AND PROTECTION, STANDARD 701501	L SUM	1					1				
8	70102625	TRAFFIC CONTROL AND PROTECTION, STANDARD 701606	L SUM	1					1				
9	70102635	TRAFFIC CONTROL AND PROTECTION, STANDARD 701701	L SUM	1			i		1			1	
10	70102640	TRAFFIC CONTROL AND PROTECTION, STANDARD 701801	L SUM	1					1				\\
11	80400100	ELECTRIC SERVICE INSTALLATION	EACH	1					1				·
12	80400200	ELECTRIC UTILITY SERVICE CONNECTION	L SUM	1					1				
13	80700140	GROUND ROD, 5/8" DIA. X 10 FT.	EACH	12					12				
14	81000700	CONDUIT IN TRENCH, 2 1/2" DIA., GALVANIZED STEEL	FOOT	53	+ · · · · · · · · · ·				53				
15	81018600	CONDUIT PUSHED, 2 1/2" DIA., GALVANIZED STEEL	FOOT	333					333				
16	81500200	TRENCH AND BACKFILL FOR ELECTRIAL WORK	FOOT	2010					2010				
17	81600925	UNIT DUCT, WITH 3-1/C NO. 6 AND 1/C NO. 8 GROUND, 600V (XLP-TYPE USE), 1 1/4" DIA., POLYETHYLENE	FOOT	2544					2544				
18	81702440	ELECTRICAL CABLE IN CONDUIT, 600V (XLP-TYPE USE) 3-1/C NO. 1/0	FOOT	60			 		60			<u></u>	
19	82102250	LUMINAIRE, SODIUM VAPOR, HORIZONTAL MOUNT, 250 WATT	EACH	11		air Ann an			11			- materials	
20	82500520	LIGHTING CONTROLLER TYPE CB-RCS 60 AMP - 480 VOLT	EACH	1					1				
21	83007600	LIGHTING POLE, ALUMINUM, 35 FT. M.H., 15 FT. MAST ARM	EACH	11	+				11				
22	83600200	LIGHT POLE FOUNDATION, 24" DIAMETER	FOOT	83	.				83				
23	83600215	LIGHT POLE FOUNDATION, 24" DIAMETER, OFFSET	FOOT	13.5				1	13.5				
24	83800105	BREAKAWAY DEVICE, TRANSFORMER BASE, 11.5 INCH BOLT CIRCLE	EACH	11					11				
	03000103	BREMONIAL BETTOC, TOWNS OF THE STATE BEET GROCE	LAGIT					1	'				
	-							1					
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	ļ											<u> </u>	17000 SOUTH PARK AVENUE SOUTH HOLLAND, ILLINOIS 60473 No. Date Remail (708) 331-6700 FAX (708) 331-3826
													© COPYRIGHT 2005 ILLINOIS DESIGN FIRM REGISTRATION NO. 184001128.
			ļ									<u> </u>	119TH STREET
													STREET LIGHTING SUMMARY OF QUANTITIES
		; 										<u>.</u>	ALSIP, ILLNOIS
			.										Drawn by: RM Date: 12/20/05
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SINGLE LINE LEGEND


X LUMINAIRE, 250W HPS, STREET LIGHT

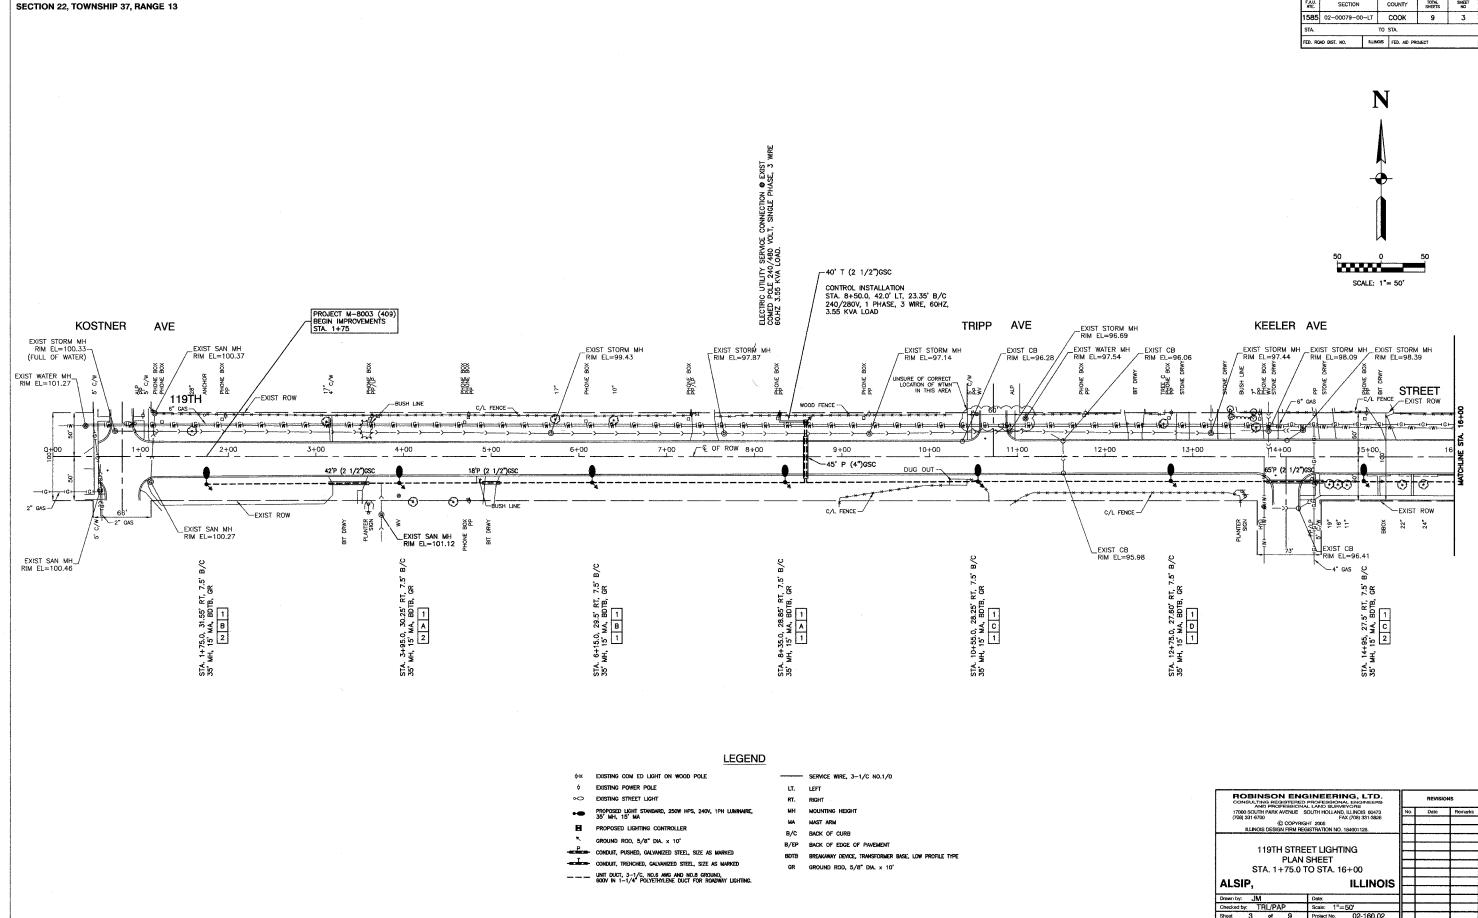
FUSE, 3.5 AMP

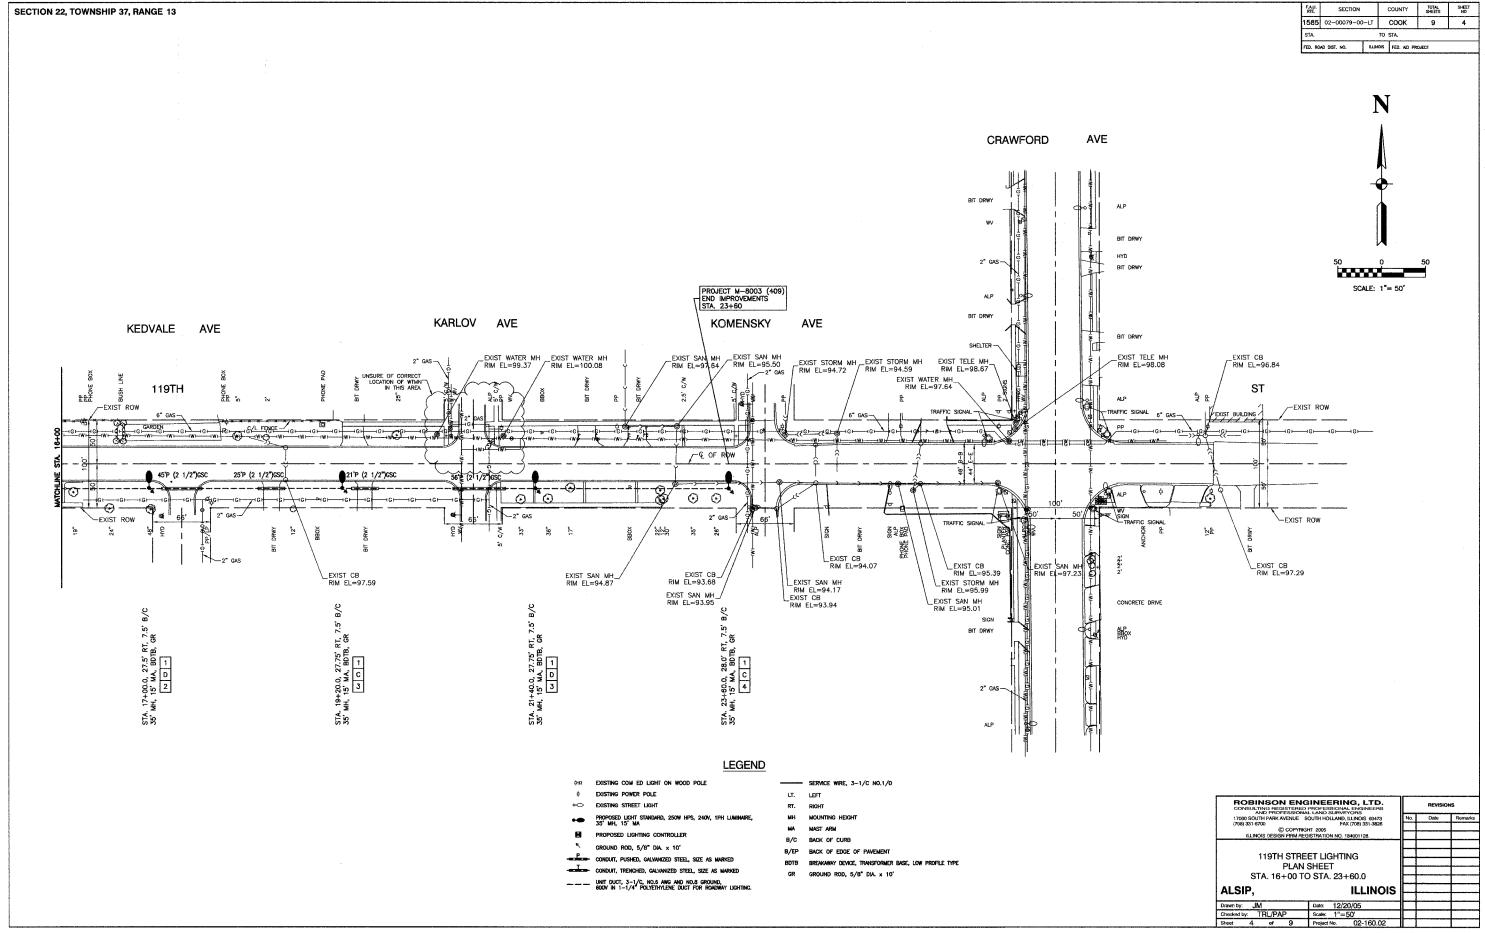CIRCUIT BREAKER


CONNECTION

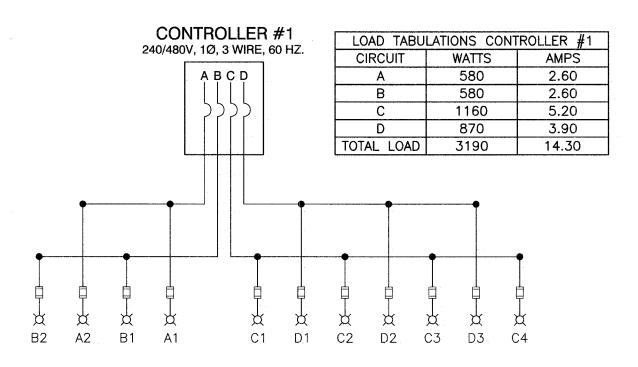
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STREE	H STREET T LIGHTING WIRING DIAGRAM			
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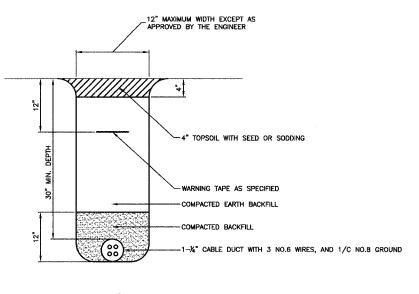
BITUMINOUS PAVEMENT OR CONCRETE SIDEWALK REMOVAL AND REPLACEMENT

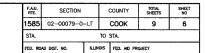

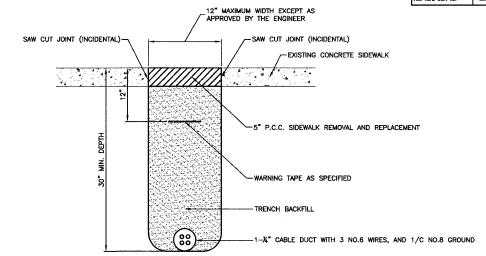

NOTES.

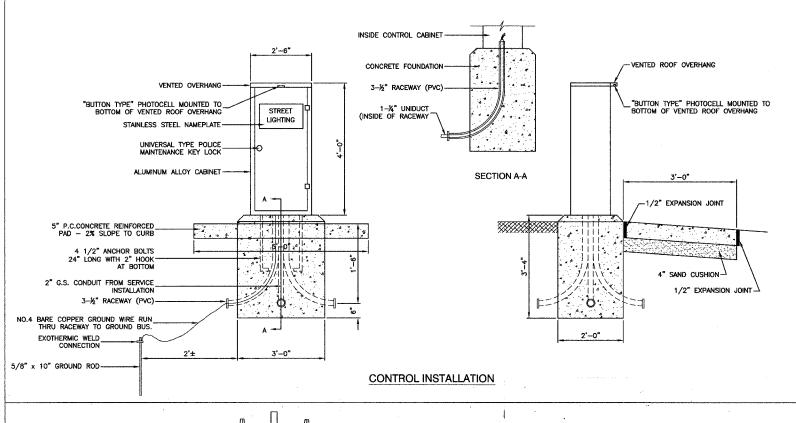- 1. SERVICE VOLTAGE SHALL BE AS INDICATED ELSEWHERE IN THE DRAWINGS.
- 2. UNLESS OTHERWISE INDICATED, ITEMS AND WORK SHALL BE INCLUDED AND PAID AS PART OF ELECTRIC UTILITY SERVICE INSTALLATION.
- CONDUIT AND CONNECTOR DIAMETER SHALL MATCH THE DIAMETER OF THE SERVICE CONDUCTOR RACEWAY AS INDICATED.
- 4. PVC COATED RACEMAYS AND ACCESSORIES SHALL BE CAREFULLY INSTALLED WITH MER RECOMMENDED TOOLS AND PROCEDURES TO AVOID DAMAGE. ANY DAMAGE SHALL BE REPAIRED WITH COMPATIBLE PVC TOUGH-UP MATERIAL TO THE SATISFACTION OF THE ENGINEER OR THE DAMAGED MATERIAL SHALL BE REPLACED AT NO ADDITIONAL COST.
- B. THE CONTRACTOR SHALL OBTAIN INSPECTION AND APPROVAL BY THE HIGHER OF SERVICE INSER ORGANO ELECTRODE, RISSER ELBOW, THE PROPERTY OF THE PROPERTY OF THE PROPERTY OF THE BEFORE BACKFILL AND SHALL ALSO OBTAIN INSPECTION OF SERVICE CONNECTION.
- 6. THE SERVICE METER SOCKET, AS APPLICABLE, MOUNTED ELSEWHERE AS INDICATED SHALL BE INCLUDED AND PAID AS PART OF THE ELECTRICAL UTILITY SERVICE INSTALLATION PAY ITEM.
- 7. THE SERVICE CONDUCTOR RACEWAY SHALL BE AS INDICATED AND SHALL BE MEASURED SEPRATELY FOR PANIENT. WHEN THE RACEWAY IS PVC-COATED RIGID GALVANIZED STATEMENT OF THE PANIENT. WHEN THE RACEWAY IS PVC-COATED RIGID GALVANIZED IN CONCRETE, THE COUPLING SHALL BE A METALL OF NOW NETTAL CAUCHY WHEN THE RACEWAY IS ENCASED IN CONCRETE. THE CONCRETE SHALL EXTEND TO COVER THE COUPLING.
- 8, PLANS AND DETAILS INDICATE THE GENERAL NATURE AND REQUIREMENTS. THEY DO NOT SHOW EVERY ACCESSORY AND ATTACHMENT, AND THEY DO NOT RELIEVE THE OFFICE AND ATTACHMENT, AND THEY DO NOT RELIEVE THE DOT ON ACCESTANCE THE PROPERTY OF MESSAGE AND ATTACHMENT OF THE SPECIFICATIONS AND SPECIAL PROVISIONS ALL ITEMS AND MORK NOT PROVIDED BY THE UTILITY, BUT NECESSARY FOR A COMPLETE SERVICE INSTALLATION.

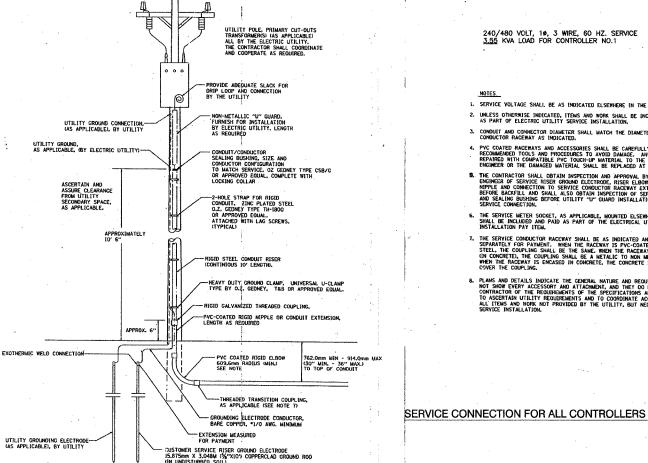


TRENCH DETAIL

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AND PROFESSION	SOUTH HOLLAND, ILLINOIS 60473	No.	Date	Remark
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NOMINAL WATTAGE FUSE SIZE LUMINAIRE FUSE SIZE TABLE

(TYPICAL FOR SINGLE LUMINAIRE INSTALLATION)



ROBINSON ENGINEERING, LTD. Date Remarks 119TH STREET LIGHTING DETAILS ALSIP, ILLINOIS

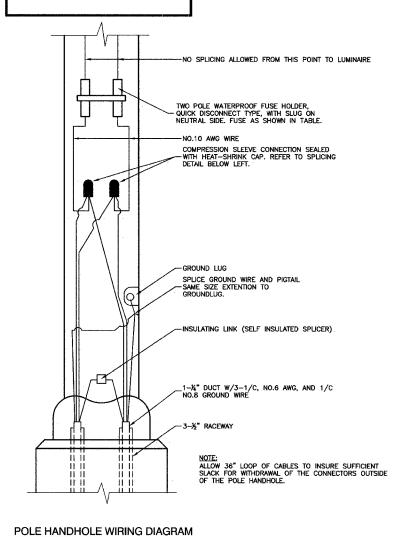CONTROLLER WIRING DIAGRAM LEGEND

- $3{-}1/C,$ No. 2, 600V SERVICE WIRE IN 2" DIA. GALVANIZED STEEL CONDUIT FOR 240/480 VOLT, 10, 3 WIRE, 60HZ. SERVICE. 1
- (1) 60 AMP MAIN CIRCUIT BREAKER, 2 POLE, 600 VOLT, 100 AMP BASE, NON-INTERCHANGEABLE TRIP INTERRUPTING RATING NEMA 14000 AMP AT 480 V. 2
- (1) 60 AMP REMOTE CONTROL CONTACTOR SWITCH, ELECTRICALLY OPERATED, MECHANICALLY HELD, 2 POLE, SINGLE THROW, MINIMUM 60 AMP, 600 VOLT 3
- 4 (4) 30 AMP CIRCUIT BREAKER, 1 POLE, 240 VOLT, 100 AMP BASE, NON-INTER-CHANGEABLE TRIP RATING NEMA - 14000 AMP AT 240 VOLTS.
- (3) 20 AMP CONTROL CIRCUIT-CIRCUIT BREAKER, 1 POLE, 240 VOLT, 100 AMP BASE, NON-INTERCHANGEABLE TRIP INTERRUPTING RATING NEMA 14000 AMP AT 240 V. (5)
- 6 (1) 20 AMP, 1 POLE DOUBLE THROW, 240 VOLT RELAY
- (1) 1.5 KVA, SINGLE PHASE, ENCAPSULATED TRANSFORMER 240x480/120x240 VOLT, 60 HZ. 7
- 8 (1) 20 AMP, 120 VOLT DUPLEX GFCI RECEPTACLE.
- (9) NEUTRAL BUS BAR, 1/4"x1"x12" LONG MOUNTED ON PANEL WITH TAPS.
- 10 3 POSITION SELECTOR SWITCH
- ① SWITCH FOR LIGHTING FIXTURE MOUNTED IN BOX.
- (12) WEATHER-PROOF INCANDESCENT LIGHTING FIXTURE WITH 60 WATT, 120 V LAMP.
- (13) PHOTOCELL MOUNTED TO BOTTOM OF VENTED CONTROL CABINET OVERHANG

 - NO.8 AWG INSULATED GROUND WIRE
- (15) IN-LINE FUSEHOLDER WITH FUSE AS NOTED IN FUSE TABLE
- 16 GROUND BUS BAR 1/4"x1"x12" LONG MOUNTED ON PANEL WITH TAPS.
- 17) LUMINAIRE, 250 HPS

14)

- (18) SURGE SUPPRESSOR
- (A) PROPOSED CIRCUIT
- (c) PROPOSED CIRCUIT
- (D) PROPOSED CIRCUIT
- PROPOSED CIRCUIT

GENERAL NOTES FOR CONTROL CABINET

7 4 9 0 1 1 4 4 4 4 4

(5)

1/2" THICK BENELEX PANEL BOARD

3- 1/C, NO.10 AWG, IN 1" CONDUIT

TO GROUND ROD

3

6

9

(2)

100

NO.1/0 AWG

(5)

11) (12)

=100

NO.1/0 AWG

© 0


- 1. ENTIRE CONTROL CABINET SHALL BE GROUNDED
- 2. ALL WIRING SHALL BE TAGGED WITH SELF-STICKING WIRE MARKERS.
- 3. Ground bus to be color coded green, neutral bus white, and bonded to cabinet. Enclosure, by listed pressure connectors or listed clamps.

CONTROLLER WIRING DIAGRAM


- 4. ALL INTERNAL CONTROLLER WIRING TO BE NO.12 AWG UNLESS OTHERWISE SPECIFIED.
- 5. CABINET WIRING INSULATION TO BE TYPE XHHW OR APPROVED EQUAL.

LIGHTING GENERAL NOTES


- 1. ALL WORK TO CONFORM TO THE NATIONAL ELECTRICAL CODE AND ANY APPLICABLE LOCAL CODES.
- 2. CONTRACTOR TO VERIFY LOCATION OF ALL UNDERGROUND UTILITIES BEFORE TRENCHING OR AUGERING.
- 3. BEFORE INSTALLING STANDARDS NEAR OVERHEAD FACILITIES CALL C.E. Co. FOR APPROVAL OF LOCATION.
- 5. SIZE ALL CONDUIT AS SPECIFIED ON DRAWINGS.
- CONTRACTOR SHALL TAKE ALL NECESSARY MEASURES TO RESTORE ANY SPECIALIZED LANDSCAPING, (i.e. DECORATIVE ROCKS, SHRUBS, PLANTS, ECT.) OR SHALL REPLACE IT, THE COST OF WHICH SHALL BE CONSIDERED INCIDENTAL TO THE CONTRACT.

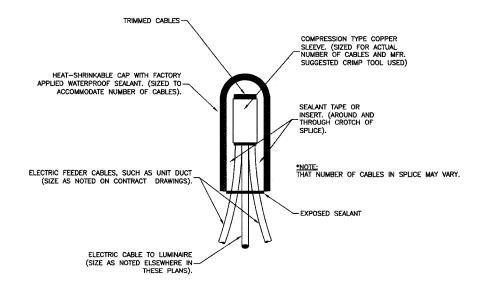

SPLICING ELECTRIC CABLES BASIC MATERIALS AND METHODS

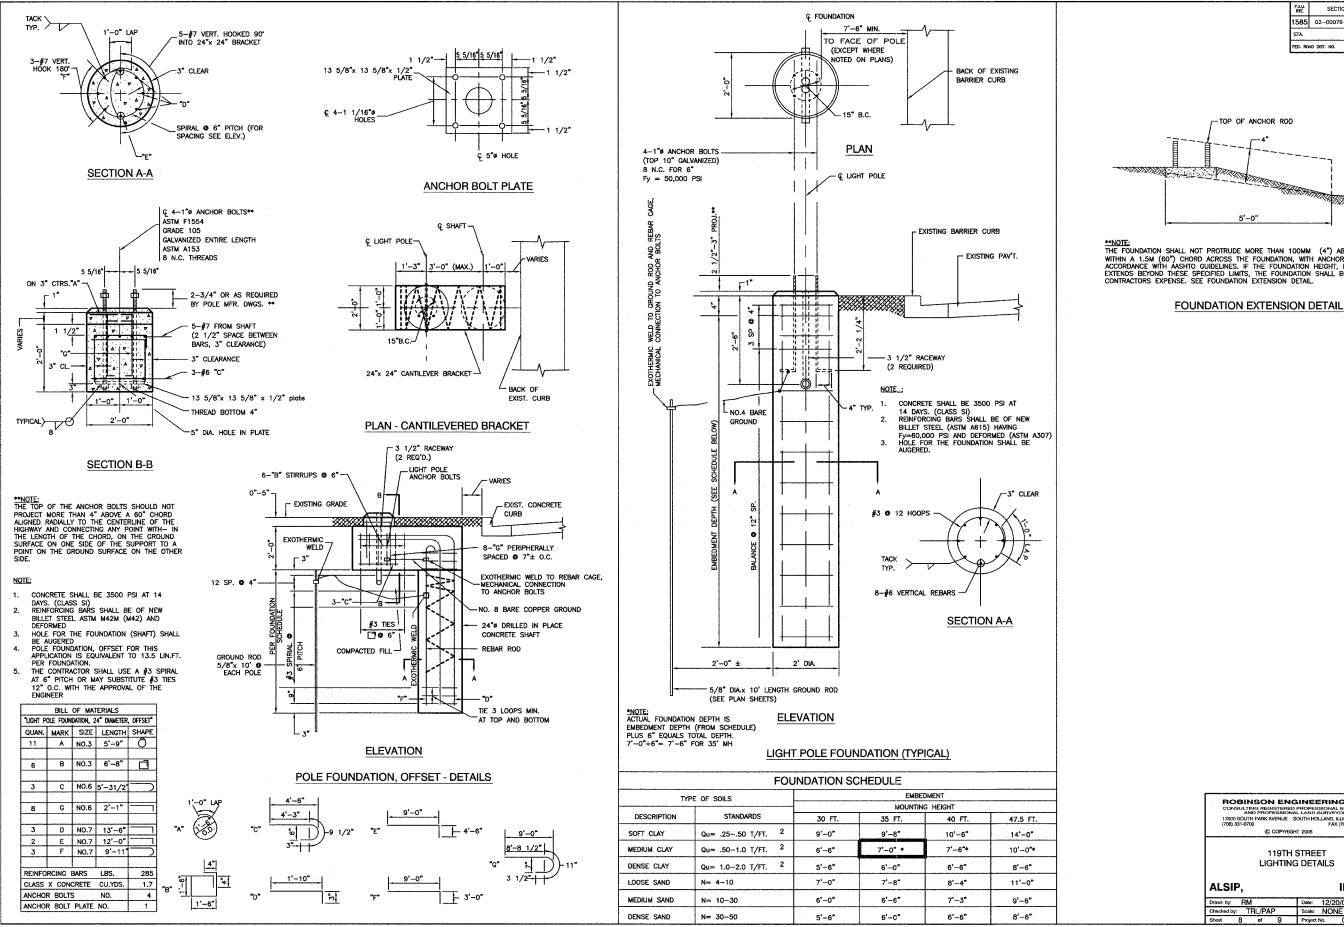


SECTION COUNTY TOTAL SHEET NO 1585 02-00079-0-LT COOK 9 TO STA. FED. ROAD DIST. NO. ILLINOIS FED. AID PROJECT

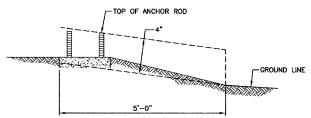

**NOTE:
THE FOUNDATION SHALL NOT PROTRUDE MORE THAN 100MM (4") ABOVE THE FINISHED GRADE
WITHIN A 1.5M (60") CHORD ACROSS THE FOUNDATION, WITH ANCHOR RODS INCLUDED. IN
ACCORDANCE WITH ASKITO GUIDELINES. IF THE FOUNDATION HEIGHT, INCLUDING ANCHOR RODS,
EXTENDS BEYOND THESE SPECIFIED LIMITS, THE FOUNDATION SHALL BE REPLACED AT THE

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-ALUMINUM POLE FINISH TO BE: SATIN GROUND

-FOUNDATION (SEE FOUNDATION DETAILS)

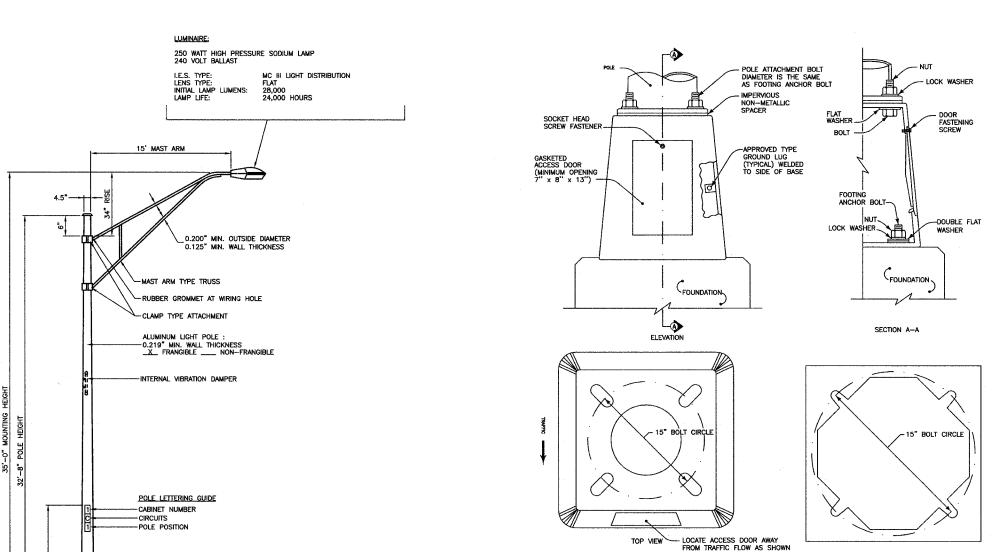11.5" BOLT CIRCLE

TYPICAL POLE INSTALLATION (35' MH)

BOLT COVERS WITH VANDAL PROOF SCREWS, -AND BREAKAWAY DEVICE, TRANSFORMER BASE, STANDARD PROFILE (TO MATCH EXISTING IDOT SYSTEM POLES)

NOTES:

THE LIGHTING UNITS SHALL MEET AASHTO DESIGN CRITERIA. DESIGN FOR 90 M.P.H. WIND WITH 30% GUST AND 75 POUND LUMINARE HAVING AN E.P.A. OF 1.6 SQ. FT. AND PROPER ICE LOADING.

2. ALUMINUM ALLOY 6063-T6 SHALL BE USED.


TRANSFORMER BASE NOTES:

- THE DETAILS INDICATED HEREON ARE TYPICAL FOR A CAST ALUMINUM TRANSFORMER BASE. ALTERNATE DESIGNS MAY BE SUBMITTED TO THE ENGINEER FOR APPROVAL.
- 2. ALL DIMENSIONS SHALL MEET AASHTO STANDARDS.
- 3. MATERIALS AND METHODS OF CONSTRUCTION SHALL BE IN ACCORDANCE WITH 2002 IDOT STANDARD SPECIFICATIONS FOR ROAD AND BRIDGE CONSTRUCTION.

BOTTOM VIEW

4. ALL MATERIALS, COMPONENTS AND EQUIPMENT SHALL BE U.L. LISTED.

TRANSFORMER BASE DETAIL

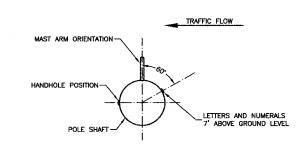

POSITION OF HANDHOLE AND NUMERALS ON POLE

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