04-28-2017 LETTING ITEM 014

STATE OF ILLINOIS **DEPARTMENT OF TRANSPORTATION**

FOR INDEX OF SHEETS, SEE SHEET NO. 2

THIS IMPROVEMENT IS LOCATED IN THE VILLAGE OF BATAVIA AND NORTH AURORA

TRAFFIC DATA

0

0

0

0

2016 ADT = 13900SPEED LIMIT = 30 - 45 MPH


PROPOSED **HIGHWAY PLANS**

F.A.U. ROUTE 3887: IL-31 (Batavia Ave.) FROM MAIN ST. TO MAPLE AVE. **SECTION: A-R-RS-3**

PROJECT STP- 3887(011)

RESURFACING (3P), PEDESTRIAN RAMPS KANE COUNTY

C-91-376-16

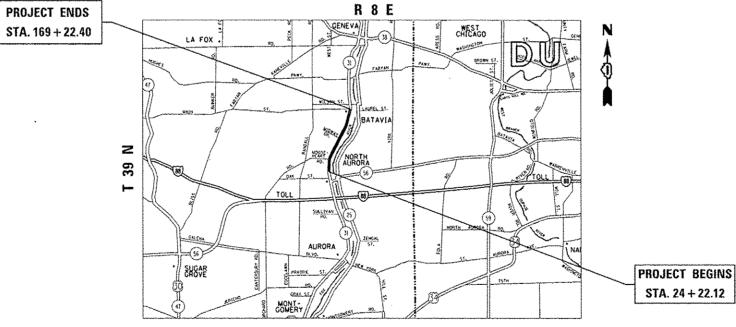

BATAVIA & AURORA TOWNSHIP

STA. 24 + 22.12

GROSS & NET LENGTH = 14500 FT. = 2.746 MILE

12

FULL SIZE PLANS HAVE BEEN PREPARED USING STANDARD ENGINEERING SCALES. REDUCED SIZED PLANS WILL NOT CONFORM TO STANDARD SCALES. IN MAKING MEASUREMENTS ON REDUCED PLANS, THE ABOVE SCALES MAY BE USED.


J.U.L.I.E.


JOINT UTILITY LOCATION INFORMATION FOR EXCAVATION 1-800-892-0123 OR 811

CONTRACT NO. 62C69

PROJECT ENGINEER: ALAIN MIDY (847) 221-3056 PROJECT MANAGER: ISSAM RAYYAN (847) 705-4178

PRINTED BY THE AUTHORITY OF THE STATE OF ILLINOIS

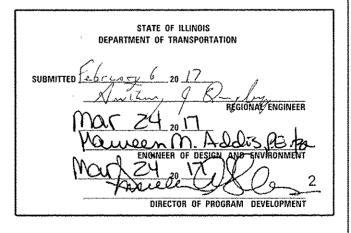

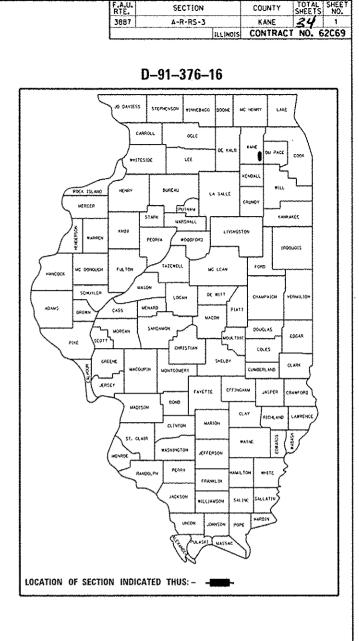

SECTION

A-R-RS-3

KANE

STATE STANDARDS

		STAT	E STANDARDS	GENERAL NOTES
	INDEX OF SHEETS	STANDARD NO.	DESCRIPTION	THE CONTRACTOR SHALL CO OF BATAVIA AND THE VILL
1	COVER SHEET	000001-06	STANDARD SYMBOLS, ABBREVIATIONS AND PATTERNS	BEFORE STARTING ANY EXC OR 811 FOR FIELD LOCATIO
2	INDEX OF SHEETS, STATE STANDARDS & GENERAL NOTES	424001-09	PREPENDICULAR CURB RAMPS FOR SIDEWALKS	(48 HOURS NOTIFICATION I
3-4	SUMMARY OF QUANTITIES	424006+ 02	DIAGONAL CURB RAMPS FOR SIDEWALKS	THE CONTRACTOR WILL NOT WITHOUT THE WRITTEN PER
		424011-03	CORNER PARALLEL CURB RAMPS FOR SIDEWALKS	ALL DAMAGE TO EXISTING
5		424016-03	MID-BLOCK CURB RAMPS FOR SIDEWALKS	OUTSIDE THE REMOVAL LIN
6-11	ROADWAY PLAN	424021-03	DEPRESSED CORNER FOR SIDEWALKS	BEFORE BEGINNING ANY WO ALL EXISTING PAVEMENT M
12	DETECTOR LOOP REPLACEMENT PLANS	442201- <i>0</i> 3	CLASS C AND D PATCHES	THESE LOCATIONS CAN BE
13-21	ADA RAMPS	604001-04	FRAME AND LIDS. TYPE I	MARKINGS SHALL BE AS DI
22	PROPOSED DRAINAGE PLAN	606001-06 606201-03	COMBINATION CONCRETE CURB AND GUTTER TYPE B GUTTER (INLET, OUTLET & ENTRANCE)	IT SHALL BE THE CONTRAC IN THE FIELD PRIOR TO CO
23	DRIVEWAY DETAILS DISTANCE BETWEEN ROW AND FACE OF CURB < 15' (4.5 m) (BD-02)	701101-05	OFF-ROAD OPERATIONS, MULTILANE, 15' TO 24" FROM PAVEMENT EDGE	FRAMES AND GRATES ADJUS BE DONE BY THEIR RESPEC
24	DETAILS FOR FRAMES AND LIDS ADJUSTMENT WITH MILLING (BD-08)	701426-09	LANE CLOSURE, MULTILANE, INTERMITTEN OR MOVING OPERATION FOR	THE CONTRACTOR SHALL CO
		701427-05	SPEEDS ± 45 MPH	AT (847) 705-4470 A MINI
25		701606-10	LANE CLOSURE, INTERMITTENT OR MOVING OPERATION FOR SPEEDS <= 40 MPH URBAN LANE CLOSURE, MULTILANE, 2W WITH MOUNTABLE MEDIAN	THE RESIDENT ENGINEER SH OR AT DON.CHIARUGI@ILLIN PAVEMENT MARKINGS.
		701701- 10	URBAN LANE CLOSURE, MULTILANE INTERSECTION	DO NOT SCALE PLANS FOR
27	BUTT JOINT AND HMA TAPER DETAILS (BD-32)	701801-06	LANE CLOSURE MULTILANE, 1W OR 2W CROSSWALK OR SIDEWALK CLOSURE	WHEN THE MILLED PAVEMEN
28.	TRAFFIC CONTROL AND PROTECTION FOR SIDE ROADS, INTERSECTIONS, AND DRIVEWAYS (TC-10)	701901-06	TRAFFIC CONTROL DEVICES	OF THE MILLING MACHINE S AND 1 INCH WHERE THE SPI WITH WRITTEN APPROVAL O
29	TYPICAL APPLICATIONS RAISED REFLECTIVE PAVEMENT MARKERS (SNOW PLOW RESISTANT) (TC-11)			ALLOWED IF THE EDGE OF WEDGE IS USED.
30	DISTRICT ONE TYPICAL PAVEMENT MARKINGS (TC-13)			ALL PAVEMENT PATCHING L
31	TRAFFIC CONTROL AND PROTECTION AT TURN BAYS (TO REMAIN OPEN TO TRAFFIC) (TC-14)			BUTT JOINTS WILL BE INST EXISTING PAVEMENT) ACCOP INCLUDED IN THE PLANS. U
32	PAVEMENT MARKING LETTERS AND SYMBOLS FOR TRAFFIC STAGING (TC-16)			OVERNIGHT LANE CLOSURES
33	ARTERIAL ROAD INFORMATION SIGN (TC-22)			MILLING AND RESURFACING EXTENDED LANE CLOSURES
34	DISTRICT 1 - DETECTOR LOOP INSTALLATION DETAILS FOR ROADWAY RESURFACING (TS-07)			FOR IN THE CONTRACT SPE
				THE CONTRACTOR SHALL BE DURING THE CONSTRUCTION
				EXISTING BROKEN FRAMES A SHALL BE REPLACED AS DI ACCORDING TO ARTICLE 109 BEEN PROVIDED.
				THE COST OF SURFACE REN OF "HOT-MIX ASPHALT SUR
				ALL COMBINATION CONCRET DETERMINED IN THE FIELD
for the state of t				PAVEMENT MARKING TAPE. ALL FINAL SURFACES.

ſ	FILE NAME :	USER NAME : hassann	DESIGNED -	REVISEO -			NE QUEETO O	STATE STAT	NDADDS AND C	ENERAL NOTES	F.A.U.	SECTION	COUNTY TOTAL SHEET
	p+t\\1L@94EBIDINTEG.111ing1+.gov;PWI00T\Do	umenta/1001 Offices/District 1/Projects/0137			STATE OF ILLINOIS	1	-		MAIN ST. TO		3887	A-R-85-3	COOK 34 2
		PLOT SCALE = 100.0800 1/ 10.	CHECKED -	REVISED -	DEPARTMENT OF TRANSPORTATION	IL-3 I	-, -,	AVE.) FRUIN	I WAIN SI. IU	WAPLE AVE.			CONTRACT NO. 62C69
1	Default	PLOT DATE + 2/10/2017	DATE -	REVISED -		SCALE: NONE	SHEET	OF SI	HEETS STA.	TO STA.		ILLINOIS FED. A	NO PROJECT

COORDINATE CONSTRUCTION ACTIVITIES WITH UTILITY COMPANIES. THE CITY ILLAGE OF NORTH AURORA.

EXCAVATION, THE CONTRACTOR SHALL CALL "JULIE" AT 800-892-0123 TIONS OF BURIED ELECTRIC. TELEPHONE AND GAS FACILITIES. N IS REQUIRED)

NOT BE ABLE TO SET UP A YARD OR FIELD OFFICE ON STATE PROPERTY PERMISSION OF THE DEPARTMENT.

NG PAVEMENT MARKINGS OR RAISED REFLECTIVE PAVEMENT MARKERS LINE SHOWN ON THE PLANS SHALL BE REPLACED AT THE CONTRACTOR'S EXPENSE.

WORK. THE CONTRACTOR SHALL RETAIN AND RECORD FOR FUTURE REFERENCE. MARKING LINES (AND RAISED REFLECTIVE PAVEMENT MARKERS) IN ORDER THAT BE RE-ESTABLISHED FOR STRIPING. EXACT LOCATIONS OF ALL PAVEMENT DIRECTED BY THE ENGINEER.

RACTOR'S RESPONSIBILITY TO VERIFY ALL DIMENSIONS AND CONDITIONS EXISTING CONSTRUCTION AND ORDERING OF MATERIALS.

JUSTMENT OF PRIVATE UTILITIES WITHIN THE LIMITS OF THE IMPROVEMENTS SHALL PECTIVE OWNERS AND ARE NOT PART OF THIS CONTRACT.

CONTACT THE IDOT ARTERIAL DISTRICT ONE TRAFFIC CONTROL SUPERVISOR INIMUM OF 72 HOURS IN ADVANCE OF BEGINNING WORK.

R SHALL CONTACT DON CHIARUGI. TRAFFIC FIELD ENGINEER, AT (847) 741-8857. LINOIS.GOV A MINIMUM OF TWO (2) WEEKS PRIOR TO THE PLACEMENT OF PERMANENT

OR CONSTRUCTION DIMENSIONS.

MENT IS OPEN TO TRAFFIC THE MAXIMUM GRADE DIFFERENTIAL BETWEEN PASSES IE SHALL NOT EXCEED $1\frac{1}{2}$ INCHES WHERE THE SPEED LIMIT IS 40 MPH OR LESS SPEED LIMIT IS GREATER THAN 40 MPH. L OF THE ENGINEER, A MAXIMUM GRADE DIFFERENTIAL OF 3 INCHES MAY BE DF THE MILLING IS SLOPED A MINIMUM 1:3 (V:H) OR A NOTCHED LONGITUDINAL

G LOCATIONS WILL DETERMINED IN THE FIELD BY THE ENGINEER.

NSTALLED AT THE ENDS OF ALL RESURFACING (WHERE RESURFACING MEETS CORDING TO THE "BUTT JOINT AND HOT-MIX ASPHALT TAPER DETAILS" SHEET . UNLESS OTHERWISE SPECIFIED.

RES SHALL NOT BE ALLOWED FOR REHABILITATION PROJECTS INVOLVING DAYTIME NG OPERATIONS AND CLASS D PATCHING UNLESS OTHER CONDITIONS WARRANT ES AS DETERMINED AND APPROVED IN WRITING BY THE ENGINEER OR AS PROVIDED SPECIFICATIONS.

BE REQUIRED TO PROVIDE ACCESS TO ABUTTING PROPERTY AT ALL TIMES ION OF THIS PROJECT.

ES AND LIDS SHALL BE REMOVED AND DISPOSED OF BY THE CONTRACTOR AND DIRECTED BY THE ENGINEER. REPLACEMENT FRAMES AND LIDS WILL BE PAID FOR 109.04 OF THE STANDARD SPECIFICATIONS UNLESS A SEPARATE PAY ITEM HAS

REMOVAL IN THE GUTTER FLAG SHALL BE INCLUDED IN THE COST OF SURFACE REMOVAL 2 1/4" PAY ITEM.

RETE CURB AND GUTTER REMOVAL AND REPLACEMENT LOCATIONS WILL BE LD BY THE ENGINEER.

E. TYPE III SHALL BE USED FOR SHORT TERM PAVEMENT MARKINGS ON

l	SUMMARY OF QUANTITIES		URBAN	and an	CONSTRUCT		1		SUMMARY OF QUANTITIES		URBAN	entro		NSTRUCTIC			,
			TOTAL OUANTITIES	mon			******				TOTAL	80/20				***	
CODE NO	ITEM	UNIT	QUANTITIES	redistric	-			CODE NO	ITEM	UN1T	QUANTITIES	FED/STATE					
CODE NO				0005		*****				-	5 v	0005					
20101000	TEMPORARY FENCE	FOOT	75	75													
								44000158	HOT-MIX ASPHALT SURFACE REMOVAL, 2 1/-	t" SO YD	57700	57700					
20200100	EARTH EXCAVATION	CU YD	32	32												. <u></u>	
								44000200	ORIVEWAY PAVEMENT REMOVAL	SO YD	25	25					
20800150	TRENCH BACKFILL	CU YD	248	248													
								44000600	SIDEWALK REMOVAL	SO FT	2971	2971					
21101625	TOPSOIL FURNISH AND PLACE, 6"	SO YD	692	692					×								
							· · · · · · · · · · · · · · · · · · ·	44201777	CLASS D PATCHES, TYPE II, 11 INCH	SO YD	195	195					
21400100	GRADING AND SHAPING DITCHES	FOOT	60	60													_
								44201781	CLASS D PATCHES, TYPE 111. 11 INCH	SO YD	100	100	 				
25200110	SODDING, SALT TOLERANT	SQ YD	692	692													
·								44201783	CLASS D PATCHES, TYPE IV, 11 INCH	SO YD	3000	3000					-
25200200	SUPPLEMENTAL WATERING	UNIT	1	1													-
								550A0340	STORM SEWERS. CLASS A. TYPE 2 12"	FOOT	72	72				· .	-
40600290	BITUMINOUS MATERIALS (TACK COAT)	POUND	39000	39000													_
	MIXTURE FOR CRACKS, JOINTS, AND							550A0360	STORM SEWERS, CLASS A. TYPE 2 15"	FOOT	41	4)					~
40600400	FLANGEWAYS	TON	90	90				550A0380	STORM SEWERS, CLASS A, TYPE 2 18"								-
	POLYMERIZED LEVELING BINDER (MACHINE								STURM SENERS, CLASS A, TIFE 2 TO	FOOT	172	172					-
40600827	METHOD), IL-4.75, N50	TON	2400	2400				55100400	STORM SEWER REMOVAL 10"	FOOT	11	11					-
40600982	HOT-MIX ASPHALT SURFACE REMOVAL - BUTT	SO YD	340	340													-
	JOINT							60201340		EACH	4	4	·				
40603340	HOT-MIX ASPHALT SURFACE COURSE, MIX	TON	4875	4875					24 FRAME AND GRATE								•
	"D". N70							60208240	CATCH BASINS, TYPE C. TYPE 24 FRAME ANI GRATE	EACH	3	3					•
42001300	PROTECTIVE COAT	SO YD	932	932													•
		-				-		60300305	FRAMES AND LIDS TO BE ADJUSTED	EACH	30	30					-
42300400	PORTLAND CEMENT CONCRETE DRIVEWAY PAVEMENT, 8 INCH	SO YD	20	20									<u></u>				
								60500050	REMOVING CATCH BASINS	EACH	1	1					
42400200	PORTLAND CEMENT CONCRETE SIDEWALK 5 INCH	SO FT	2762	2762													
								60600095	CLASS SI CONCRETE (OUTLET)	CU YD	23	23					
42400800	DETECTABLE WARNINGS	SO FT	251	251				K							· · · · ·		
FILE NAME &		ESIGNED -		REVISED -							J		F.A.U. RTE.	SECTIO)N	COUNT	ī
UMINU ARME BIDINI EG	JIIIndis.gov/PMIDDT-Documents/UDDT Of Hous-District NProjects/Distribut-Doston/Distribut-Distribut- PLOT SCALE = 100.0000 */ 1a C	HECKED -		REVISED - REVISED -		1.		FE OF ILLINOIS	IL-31 (BATAVIA AVE.) FR	OF QUANTITIE		¥ Ľ .	3887	A-8-85	-3	KANE	
		ATE -	·····	REVISED -		י ا	PEI ANT WEN	UT TRANSFURIA	SCALE: SHEET NO. OF			D STA,			1 (CONT	Ř/

1		SUMMARY OF QUANTITIES		URBAN	-	CONSTRU	ICTION TYPE	CODE	· · · · · · · · · · · · · · · · · · ·	_		SUMMA	RY OF QUANTITIES	
ALTY				TOTAL	90/20									
IPATING	CODE NO	ITEM	UNIT	QUANTITIES	6765/ST						CODE NO		ITEM	UNIT
	60605000	COMBINATION CONCRETE CURB AND GUTTER,	FOOT	330	33									
	<u> </u>	TYPE 8-6, 24								*	78000400	THERMOPLAST	C PAVEMENT MARKING - LINE 6"	FOOT
X	66900200	NON-SPECIAL WASTE DISPOSAL	CU YO	293	293									
										*	78000600	THERMOPLASTI	C PAVEMENT MARKING - LINE 12"	FOOT
×	66900450	SPECIAL WASTE PLANS AND REPORTS	LSUM	911-0	1					T				
										*	78000650	THERMOPLAST	C PAVEMENT MARKING - LINE 24"	FOOT
×	66900530	SOIL DISPOSAL ANALYSIS	EACH	3	3					_				
-										_⊁	78100100	RAISED REFLE	CTIVE PAVEMENT MARKER	EACH
	67000400	ENGINEER'S FIELD OFFICE, TYPE A	CAL MO	6	6						78300200	RAISED REFLE	CTIVE PAVEMENT MARKER	EACH
	67100100	MOBILIZATION	LSUM	1	1					_		REMOVAL		
F					·					*	85000200	MAINTENANCE O	F EXISTING TRAFFIC SIGNAL	EACH
	70102625	TRAFFIC CONTROL AND PROTECTION, STANDARD 701606	LSUM	1	1					-		INSTALLATION		-
							<i>y</i> ,			*	88600600	DETECTOR LOC	P REPLACEMENT	FOOT
	70102635	TRAFFIC CONTROL AND PROTECTION. STANDARD 701701	LSUM	1	1					-				
										X	89502376	REBUILD EXIS	TING HANDHOLE	EA
ŀ	70102640	TRAFFIC CONTROL AND PROTECTION. STANDARD 701801	LSUM	1	1					_				
-										-	X0322917	EXISTING MAN	RM SEWER CONNECTION TO HOLE	EACH
	70300100	SHORT TERM PAVEMENT MARKING	FOOT	15725	15	5				_	x5537800	STORM SEWERS	TO BE CLEANED 12"	FOOT
-	70300150	SHORT TERM PAVEMENT MARKING REMOVAL	SO FT	5235	52					4	x3331000	STURM SLEEKS		F001
F								_		1	X5537900	STORM SEWERS	TO BE CLEANED 15"	FOOT
H	70300220	TEMPORARY PAVEMENT MARKING - LINE 4"	FOOT	32200	32	0				+				
											x6030310	FRAMES AND L (SPECIAL)	IDS TO BE ADJUSTED	EACH
	70300240	TEMPORARY PAVEMENT MARKING - LINE 6"	FOOT	375	37								······································	
											X7030005	TEMPORARY PA	VENENT MARKING REMOVAL	SO FT
	70300260	TEMPORARY PAVEMENT MARKING - LINE 12"	FOOT	330	33									
				7 7 7 7 7 7 7 7 7 7 7 7 7 7 7 7 7 7 7							Z0004562	COMBINATION REMOVAL AND	CONCRETE CURB AND GUTTER REPLACEMENT	FOOT
	70300280	TEMPORARY PAVEMENT MARKING - LINE 24"	FOOT	230	23									
10										-15	20030850	TEMPORARY IN	FORMATION SIGNING	SO FT
L	78000200	THERMOPLASTIC PAVEMENT MARKING - LINE 4"	FOOT	32200	32 REVIS			**************************************	*****				······	
1		Indiscon/WiDOT Documents/DOT_Offices/District IVPrafects/DIST665CADDed/Destgn/DIST66-DT	R SCENICO		REVIS			SI	ATE OF	ILL	INOIS		IL-31 (BATAVIA AVE.) FRO	
ŀ		PLOT SCALE + 100,0000 1/ In Ct	HECKED -		REVIS			DEPARTME					SUMMARY	


			C		ON TYPE (ODE	
	URBAN TOTAL QUANTITIES	so/20		T			
	QUANTITIES	FED/STATE					
		0005		2007 2017 2017 2017 2017 2017 2017 2017		****	
				<u> </u>			
	375	375					
	330	330					
	230	230					
					<u></u>		
	1000	1000					
	640	640					
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	75	75					
	550	550					
	21	21					
	11710	11710	·····				
	2354	2354					
						<u> </u>	
					·····		
	102	102					
			F,A.U. RTE.	SECTIO	n I		DTAL SHEET EETS NO.
	T. TO MAPLE NES	AVE.	RTE. 3887	A-R-RS		KANE	34 4
ΤA,		STA.	FED. RO	AD DIST. NO. 1 HL	LINDIS FED. AID	CONTRACT N	и. 62C69

REV

LEGEND



|--|

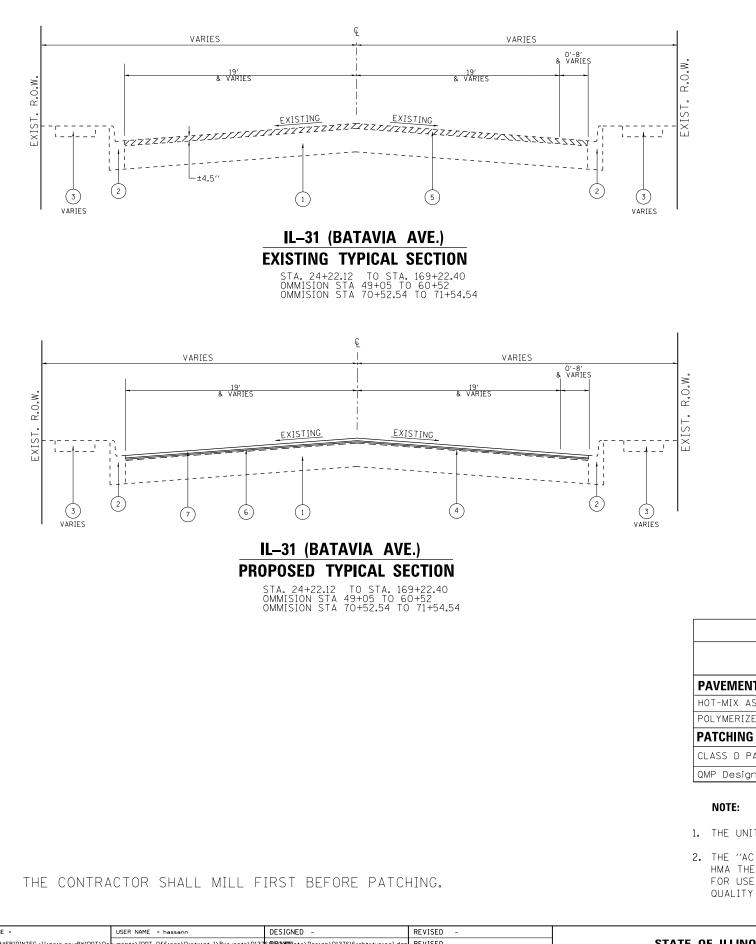MIXTURE USES

PAVEMENT RESURFACING

HOT-MIX ASPHALT SURFACE COURSE, MIX "D", N70 (IL 9.5 mm) POLYMERIZED LEVELING BINDER (MACHINE METHOD), IL-4.75, N50

CLASS D PATCHES (HMA BINDER, IL-19.0 mm)


QMP Designation: Quality Control/Quality Assurance (QC/QA); Quality Control for Performance (QCP)


- 1. THE UNIT WEIGHT USED TO CALCULATE ALL HMA SURFACE MIXTURE QUANTITIES IS 112 LBS/SQYD/IN
- 2. THE "AC TYPE" FOR POLYMERIZED HMA MIXES SHALL BE "SBS/SBR PG 76-22" AND FOR NON-POLYMERIZED HMA THE "AC TYPE" SHALL BE "PG 64-22" UNLESS MODIFIED BY DISTRICT ONE SPECIAL PROVISIONS. FOR USE OF RECYCLED MATERIALS SEE SPECIAL PROVISIONS. QUALITY MANAGEMENT PROGRAM (QMP) IDENTIFIES THE PARTICULAR QUALITY CONTROL SPECIFICATION THAT APPLIES TO THE HMA MIXTURE

[FILE NAME =	USER NAME = hassann	DESIGNED -	REVISED -			FXISTING	& PRO	POSED TYPE	CAL SECTIONS	F.A.U. RTF	SECTION	COUNTY TOTAL SHEET
	pw:\\IL084EBIDINTEG.1llinois.gov:PWIDOT\Do	cuments\IDOT_Offices\District_I\Project	s\D13761 BR(AWD) ata\Design\D137616-sht-typical.de	n REVISED -	STATE OF ILLINOIS						3887	A-R-RS-3	KANE 34 5
		PLOT SCALE = 100.0000 ' / in.	CHECKED -	REVISED -	DEPARTMENT OF TRANSPORTATION	IL-31	(BATAVIA	AVE.) F	KUWI WAIN	ST. TO MAPLE AVE			CONTRACT NO. 62C69
	Default	PLOT DATE = 2/10/2017	DATE -	REVISED -		SCALE: NONE	SHEET	OF	SHEETS ST	A. TO STA.		ILLINOIS FE	D. AID PROJECT


(1) EXIST. P.C.C. PAVEMENT ±7" (2) EXIST. COMBINATION CONCRETE CURB AND GUTTER (3) EXIST. P.C.C SIDEWALK (4) EXIST. HOT-MIX ASPHALT PAVEMENT AFTER MILLING ±2" (5) PROP. HOT-MIX ASPHALT SURFACE REMOVAL, 21/4" (6) PROP. POLYMERIZED LEVELING BINDER (MACHINE METHOD), IL-4.75, N50, 3/4" (7) PROP. HOT-MIX ASPHALT SURFACE COURSE, MIX "D", N70, 11/2"


QUALITY MANAGEMENT VOIDS PROGRAM (QMP) O Ndes 4% AT 70 GYR. **QCP** QCP 3.5% AT 50 GYR. 4% AT 70 GYR. 0C/0A

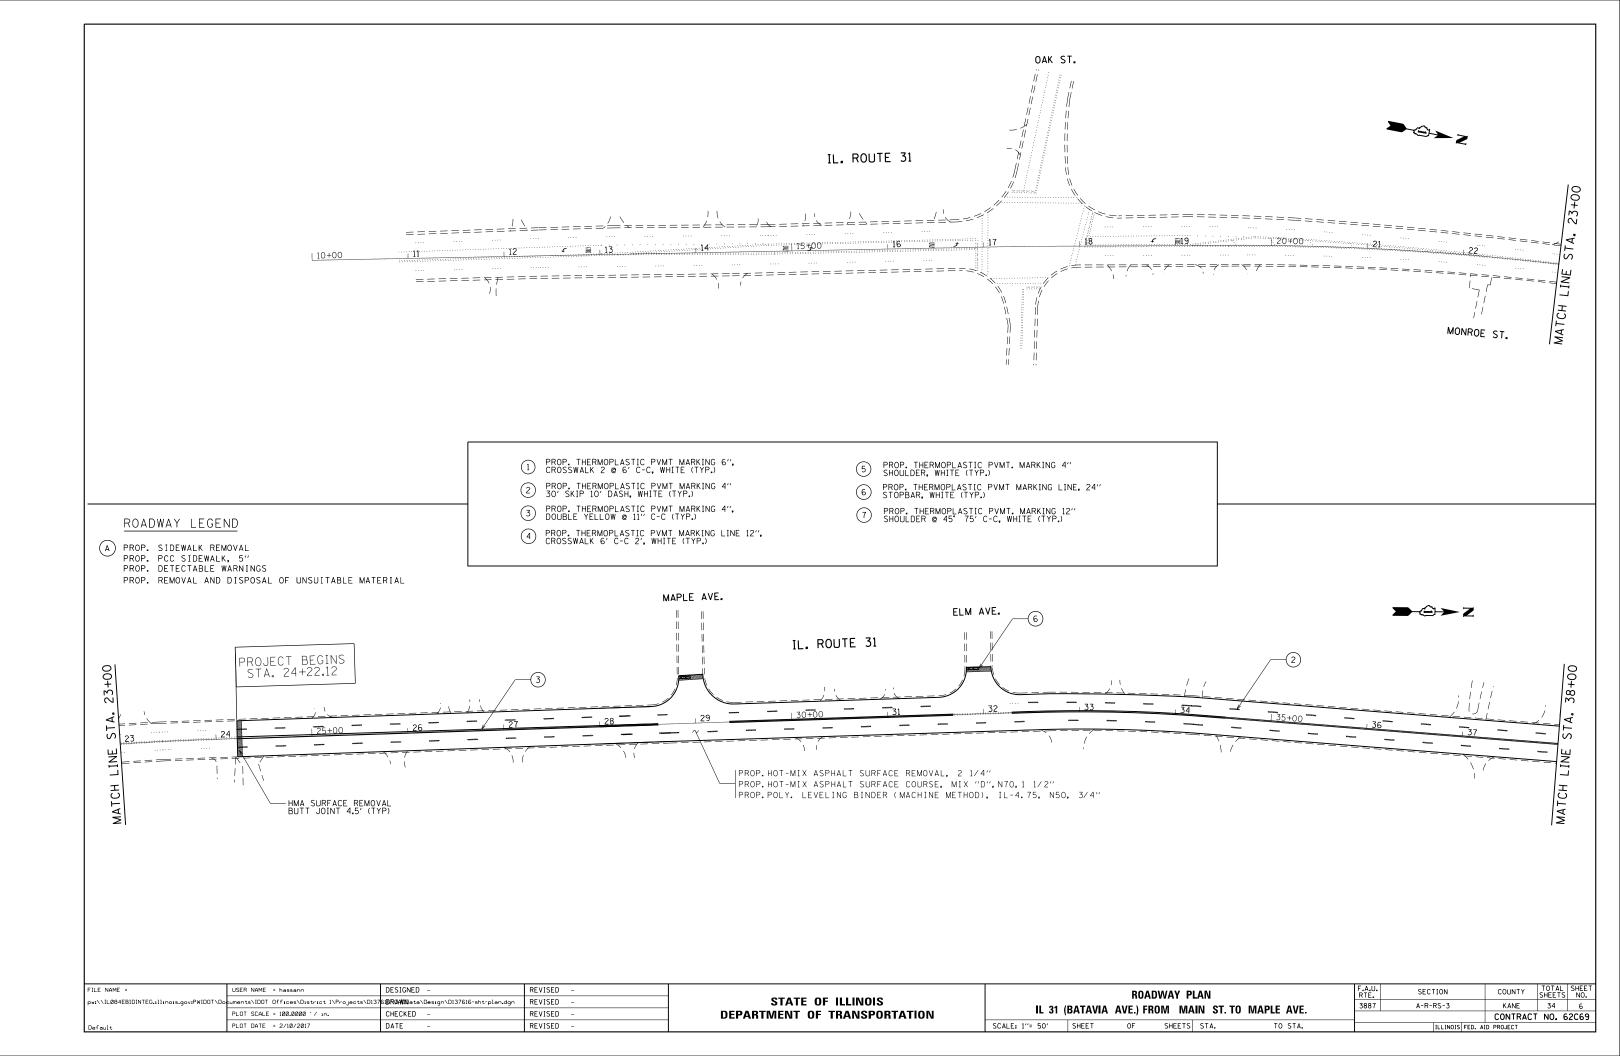


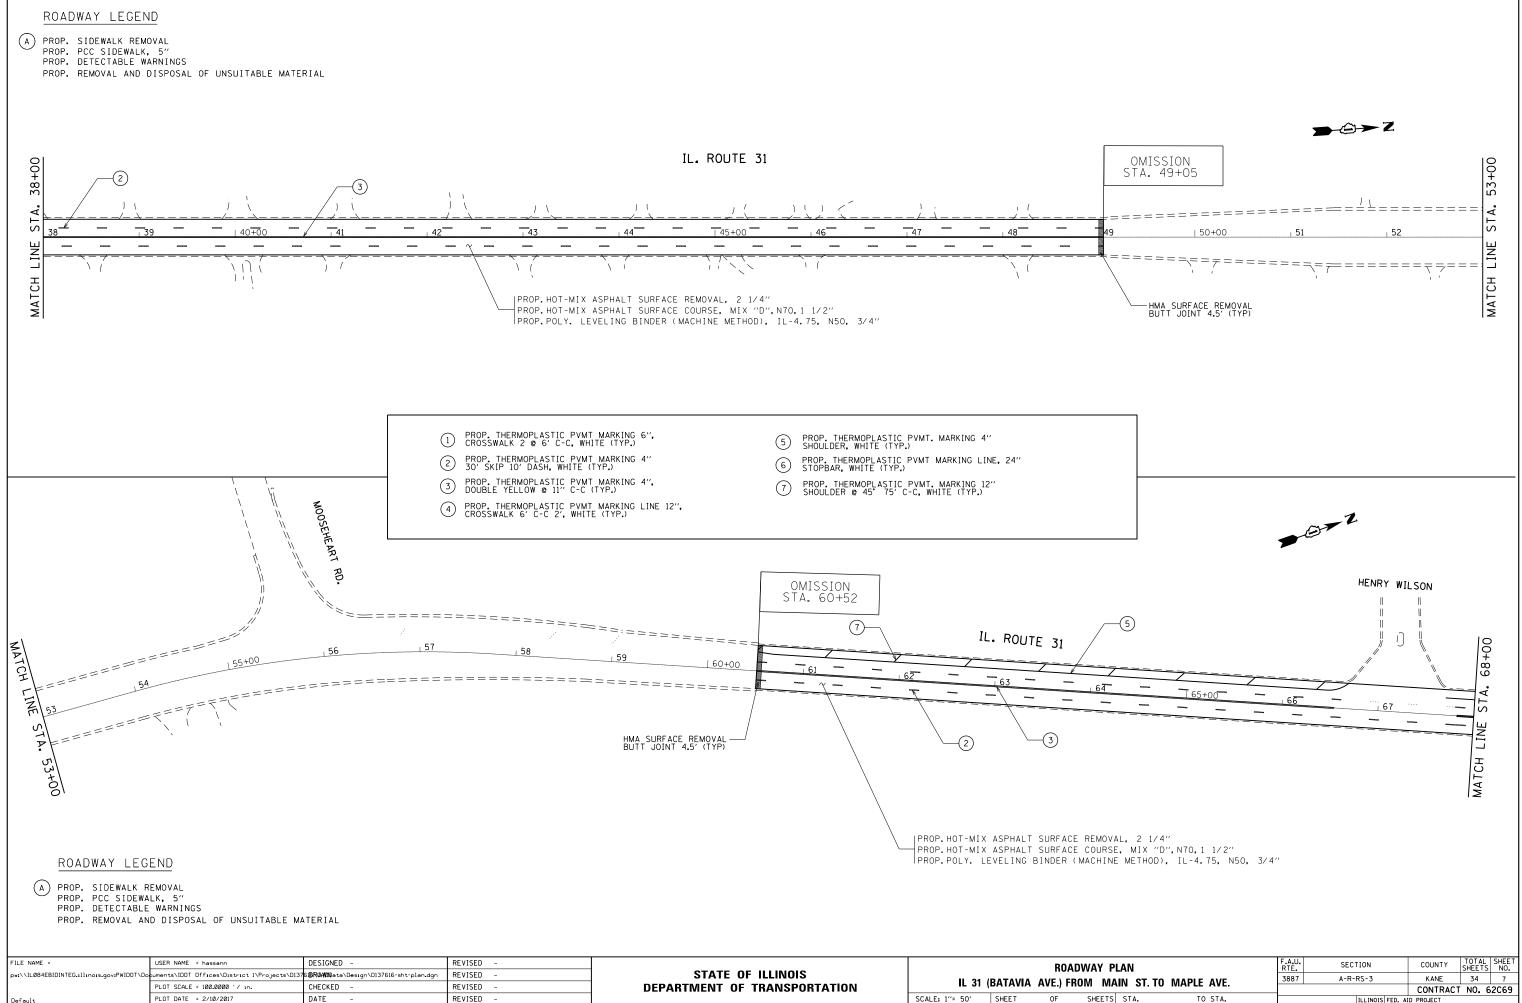



FILE NAME =	USER NAME = hassann cuments\IDOT Offices\District 1\Projects\D137	DESIGNED -	REVISED – REVISED –	STATE OF ILLINOIS	1		ROA	DWAY	
	PLOT SCALE = 100.0000 '/ in.	CHECKED -	REVISED -	DEPARTMENT OF TRANSPORTATION	IL 31 /	AVE.) FR	E.) FROM		
Default	PLOT DATE = 2/10/2017	DATE –	REVISED -		SCALE: 1"= 50'	SHEET	OF	SHEE	

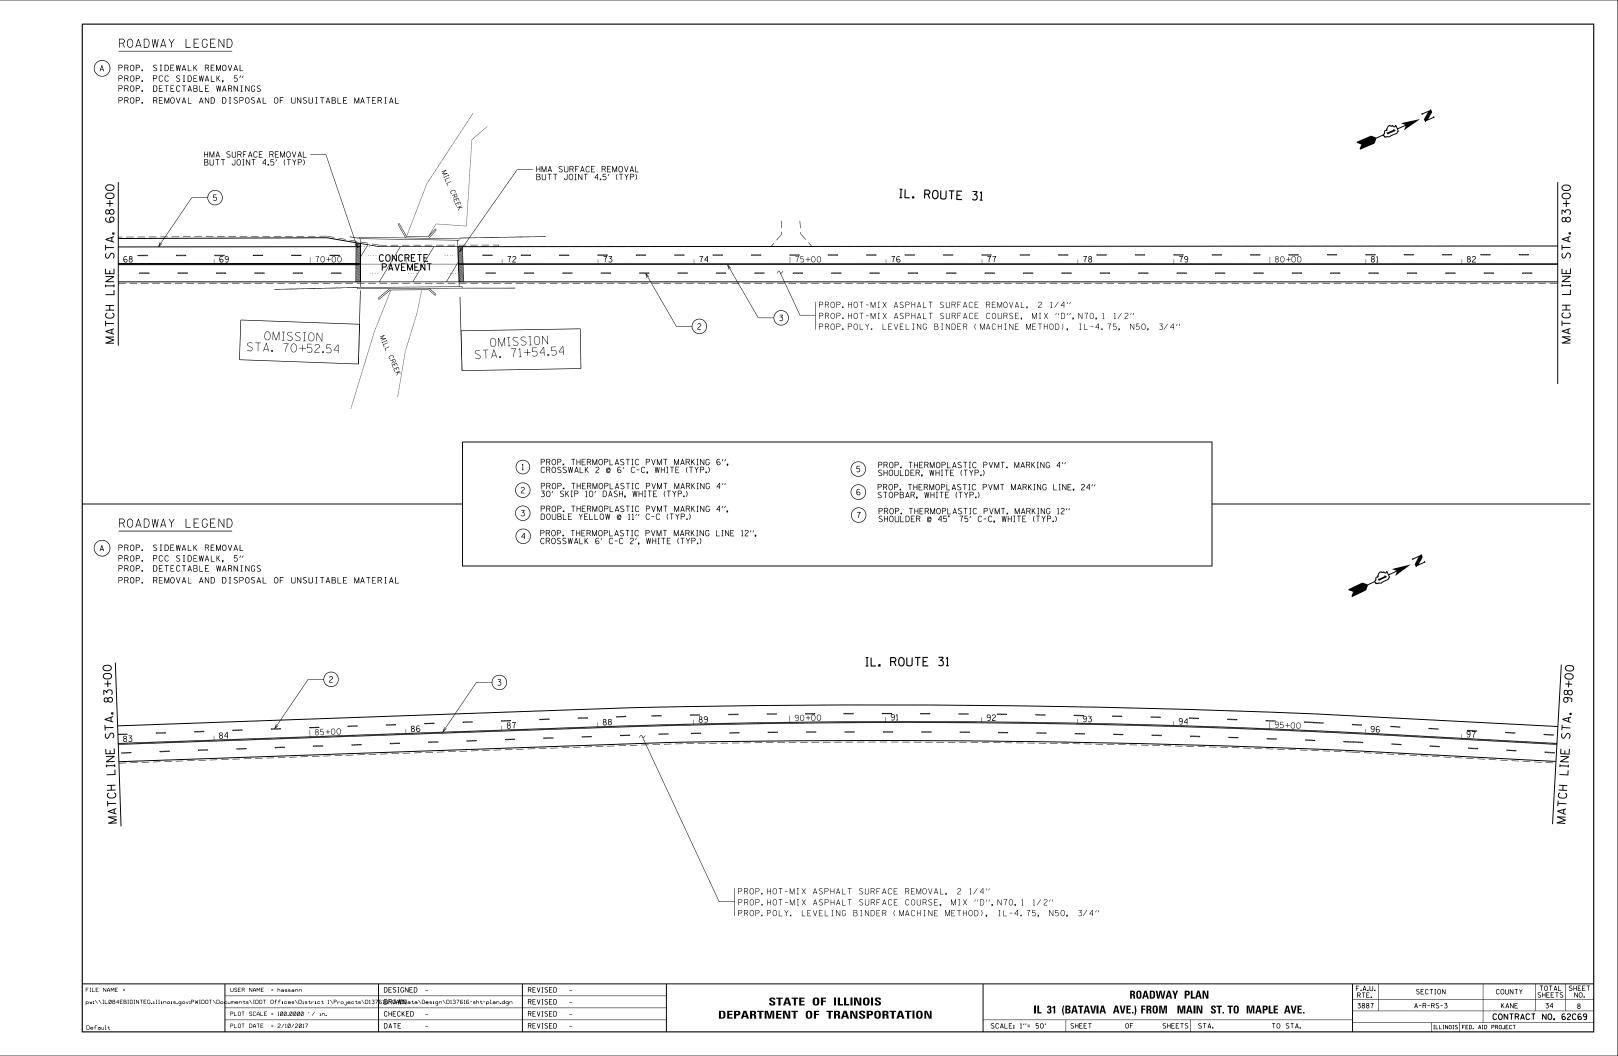


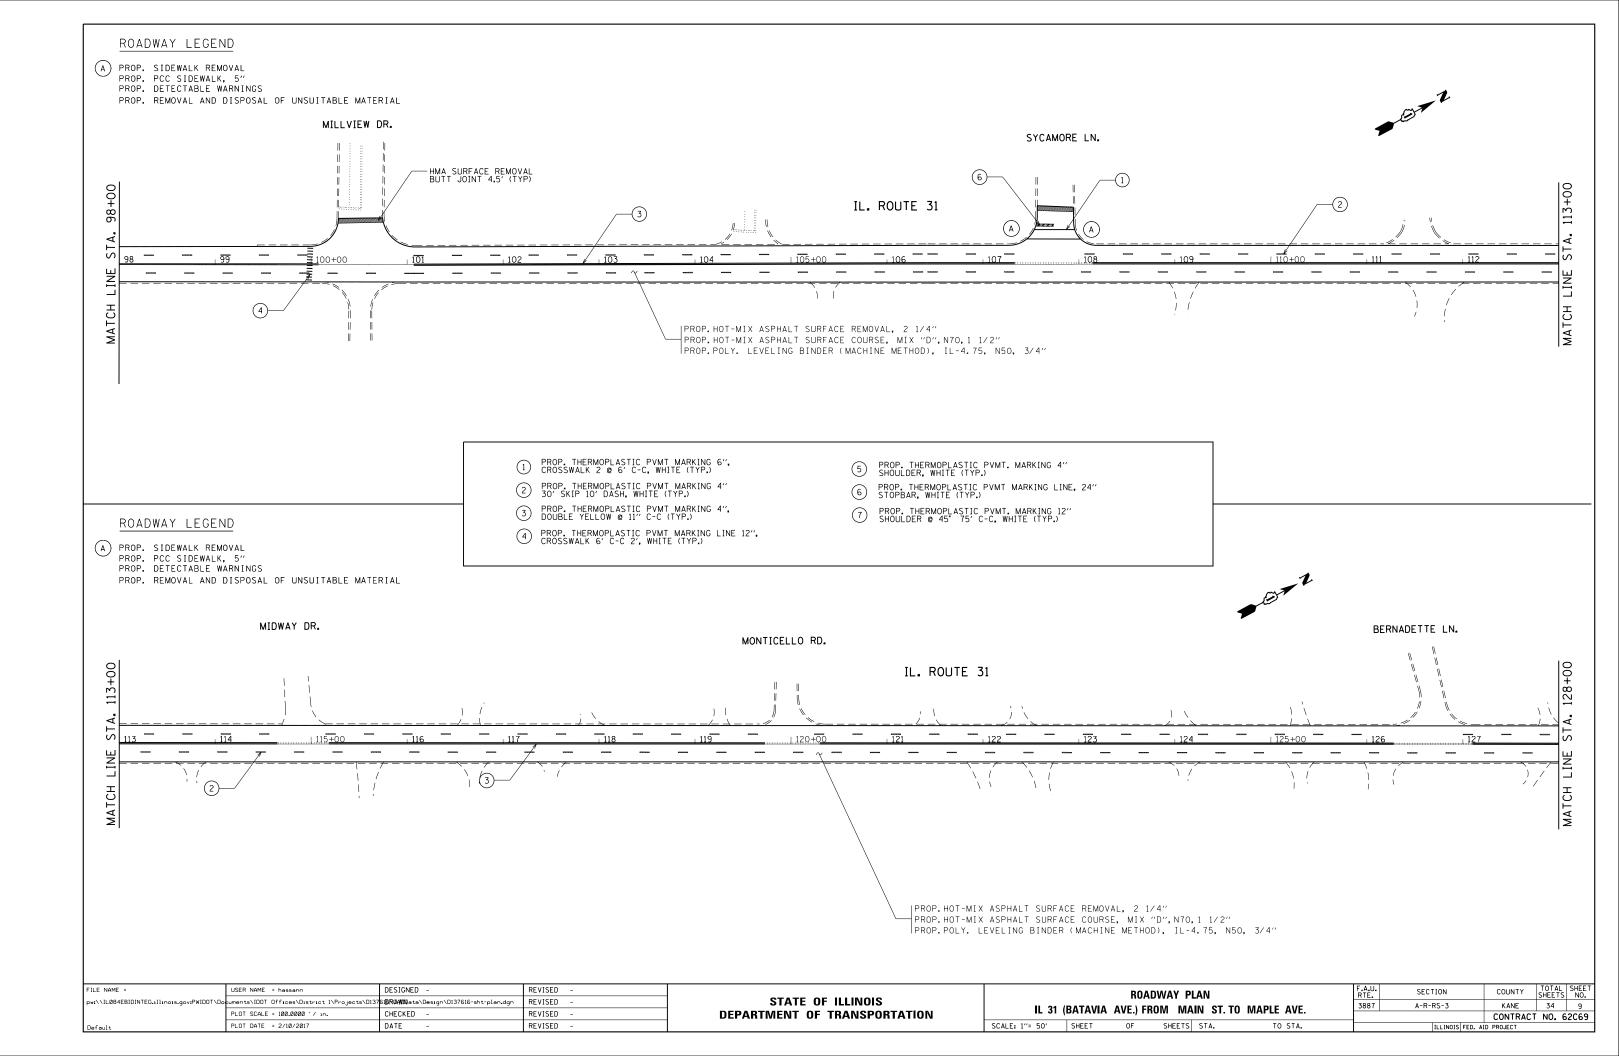

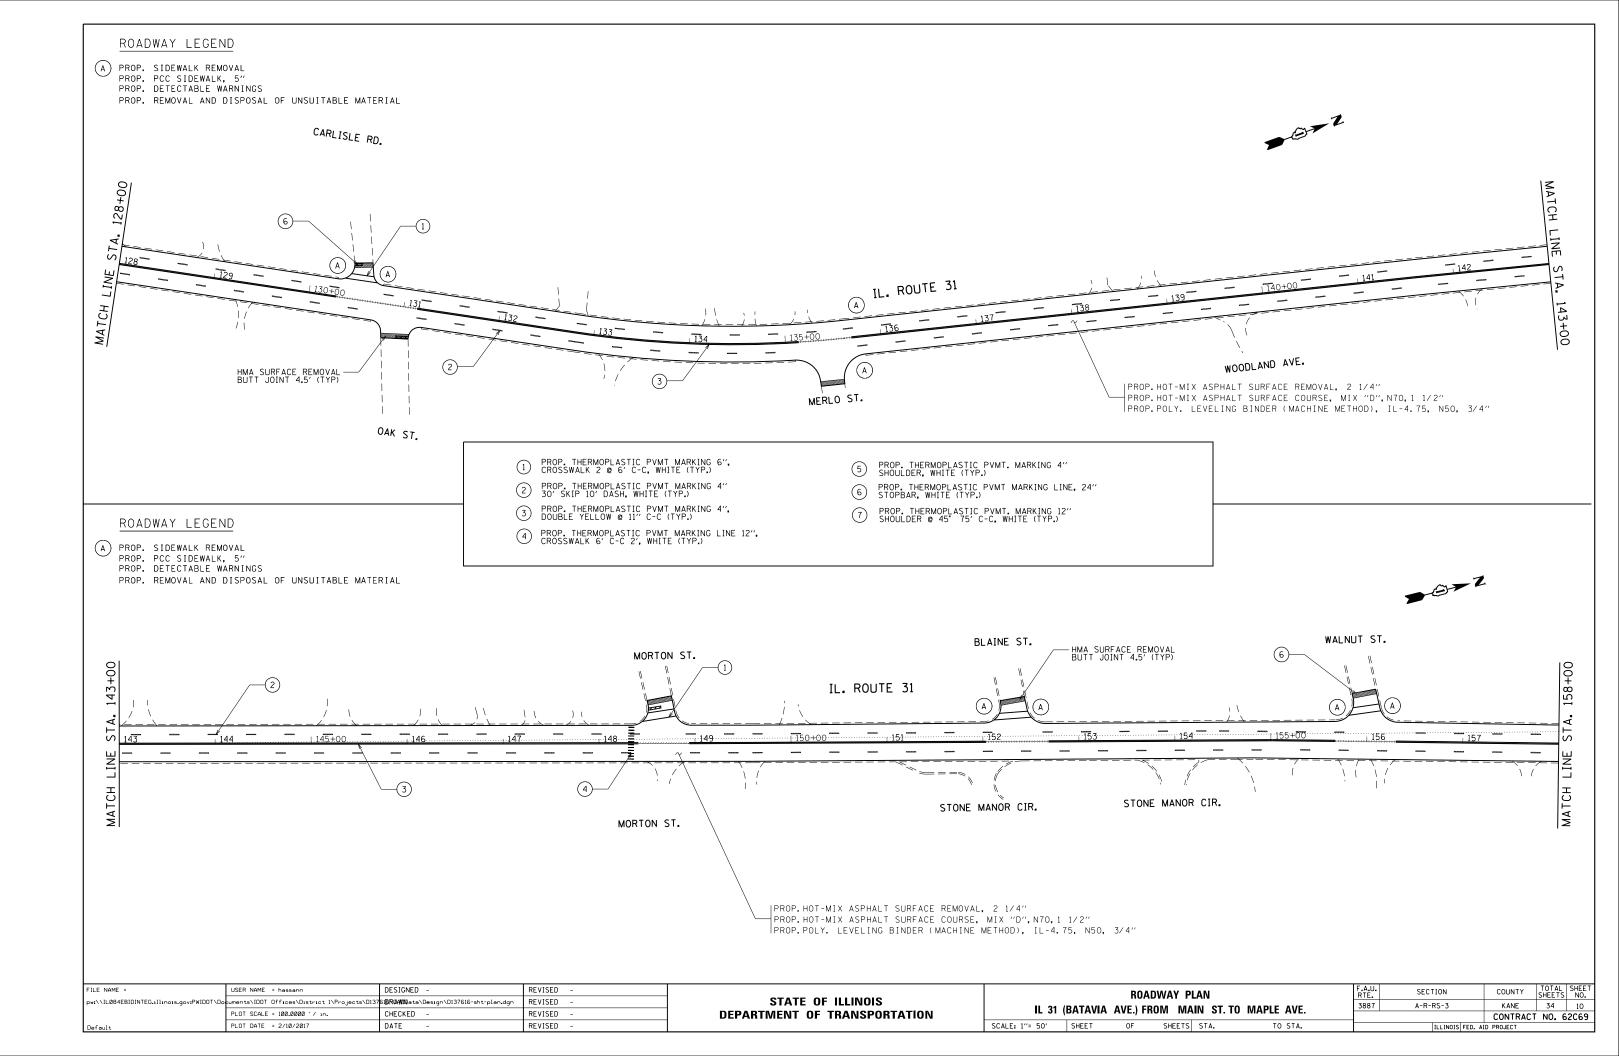

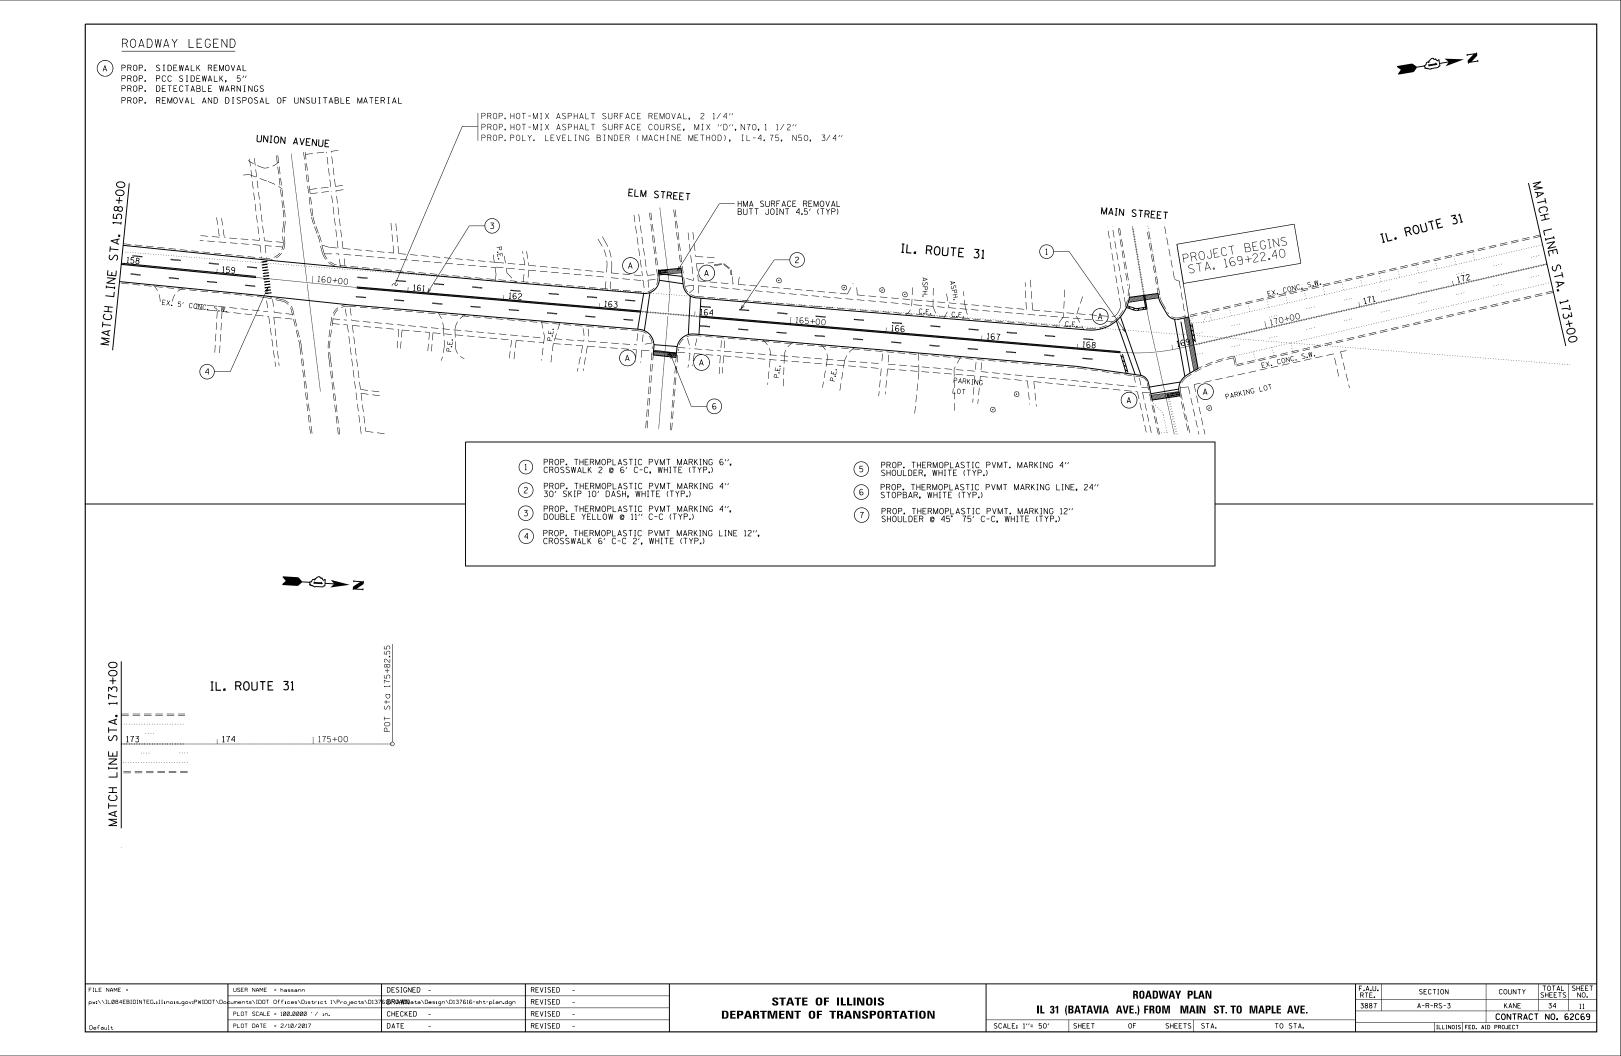

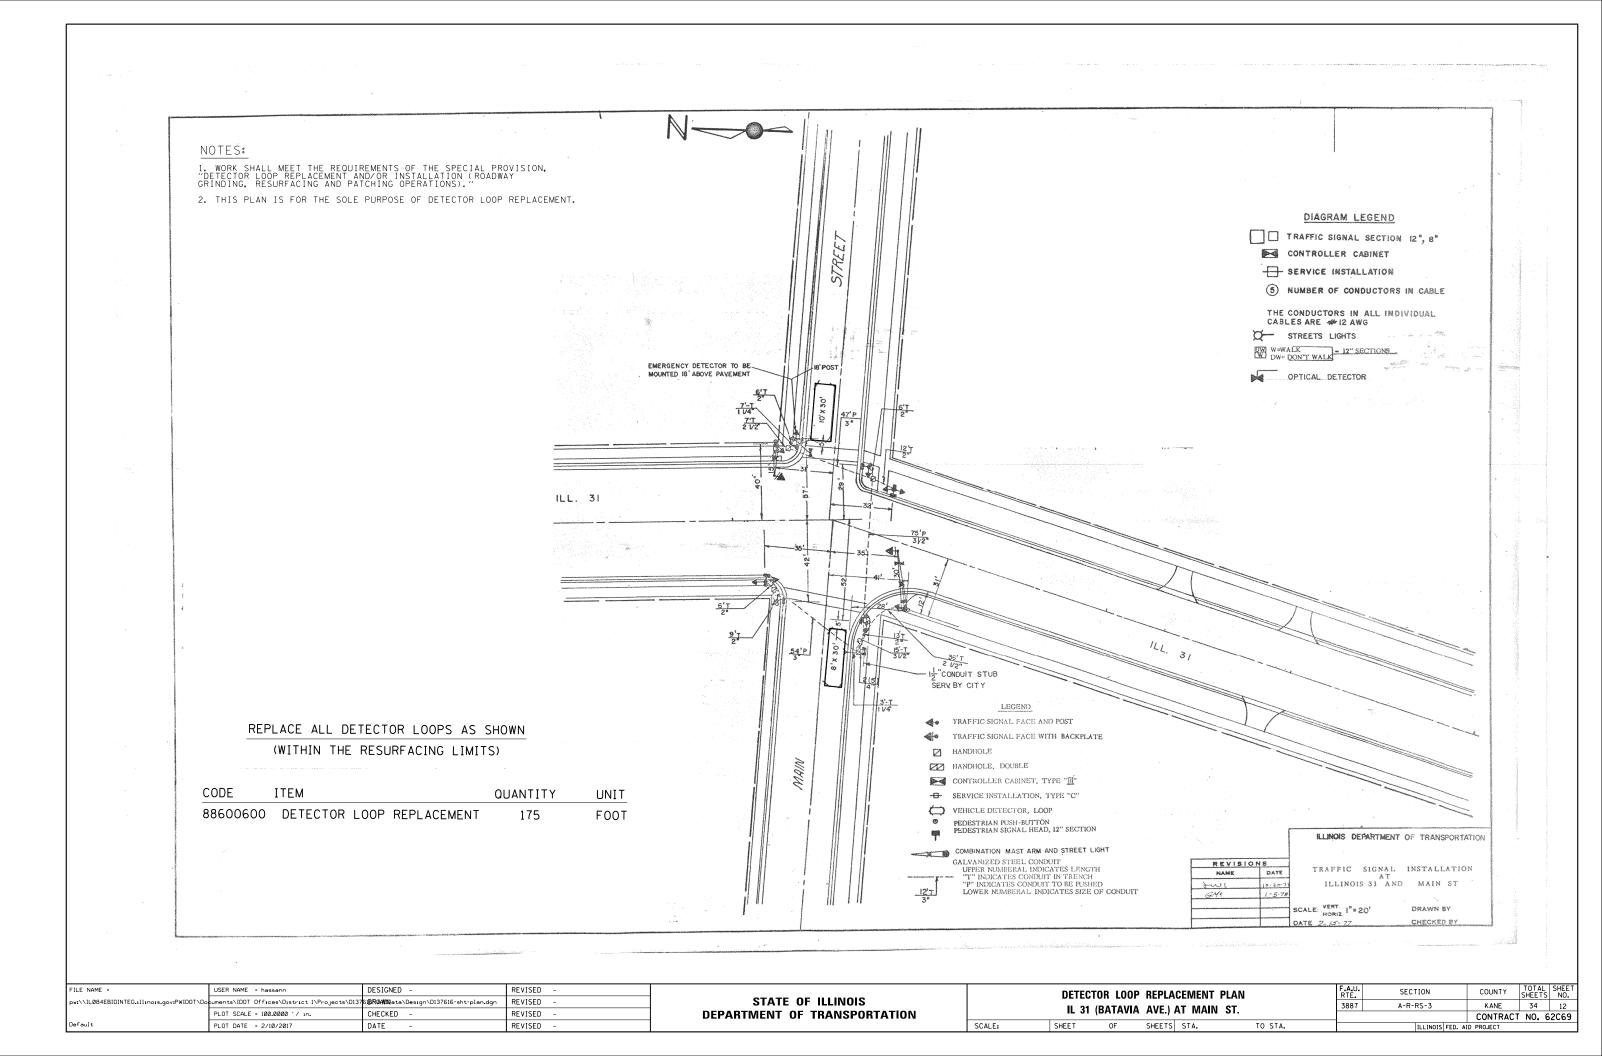

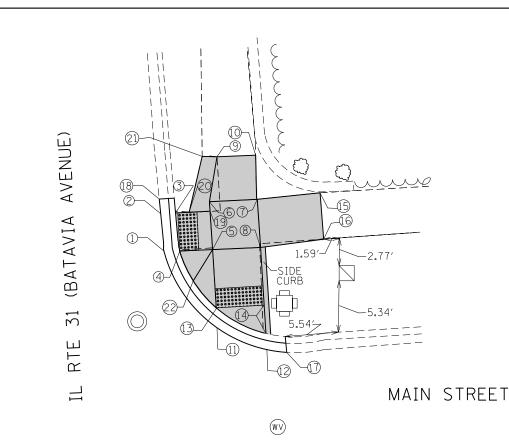

ADA RAMP NORTHEAST CORNER IL-31 AT MAIN ST.

POINT NO .:	EX. ELEVATION	PR. ELEVATION
1	715.13	715.13
2	715.19	715.19
3	NA	715.19
4	NA	715.19
<u>5</u>	NA	715.22
<u>6</u>	NA	715.22
<u>7</u>	NA	715.22
<u>8</u>	NA	715.22
<u>9</u>	715.42	Meet Existing
<u>10</u>	715.38	Meet Existing
<u>11</u>	714.83	Meet Existing
<u>12</u>	714.72	714.78
<u>13</u>	NA	714.83
<u>14</u>	NA	714.75
<u>15</u>	715.07	Meet Existing
<u>16</u>	715.01	Meet Existing
<u>17</u>	714.61	Meet Existing
<u>18</u>	715.22	Meet Existing
<u>19</u>	NA	715.22
<u>20</u>	NA	715.2
<u>21</u>	715.42	Meet Existing
<u>22</u>	NA	715.69


PLOT DATE = 2/10/2017

DATE

Default

<u>POINT NO.</u>	DISTANCE (FEET)	GRADES
15-16	4.85	1.2%
7-15	6.58	2.3%
8-16	6.63	3.2%
6-7	5.00	0.0%
7-8	5.00	0.0%
5-8	5.00	0.0%
5-6	5.00	0.0%
9-10	4.00	1.0%
10-7	4.60	3.4%
9-6	4.74	4.2%
3-19	3.6	0.8%
19-5	4.00	0.0%
19-6	1.00	0.0%
19-20	2.18	0.9%
20-21	5.98	3.6%
21-9	1.54	0.0%
3-19	3.60	0.8%
5-4	3.43	0.9%
5-13	6.09	6.4%
8-14	6.00	7.8%
2-3	1.50	0.0%
4-1	1.50	4.0%
2-1	4.00	1.5%
13-11	1.50	0.3%
11-12	5.00	0.9%
12-14	1.50	2.0%
17-18	21.40	2.83%

REVISED

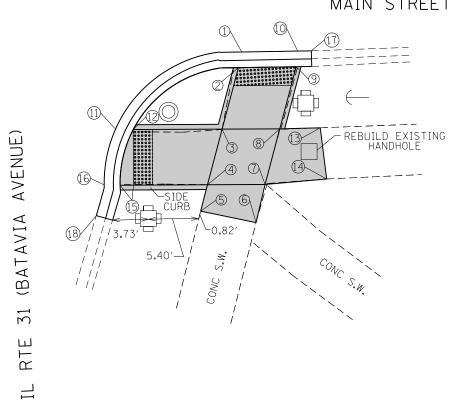

POINT NO .:	EX. ELEVATION	PR. ELEVATION
1	714.44	Meet Existing
<u>2</u>	NA	714.44
<u>3</u>	NA	714.73
<u>4</u>	NA	714.73
5	714.62	Meet Existing
<u>6</u>	714.79	Meet Existing
<u>7</u>	NA	714.73
8	NA	714.73
9	NA	714.35
<u>10</u>	714.35	Meet Existing
<u>11</u>	714.64	Meet Existing
<u>12</u>	NA	714.64
<u>13</u>	714.54	Meet Existing
<u>14</u>	714.72	Meet Existing
<u>15</u>	NA	714.60
<u>16</u>	714.60	Meet Existing
<u>17</u>	714.33	Meet Existing
<u>18</u>	714.49	Meet Existing

SCALE:

LEGEND PROPOSED SIDEWALK REFERENCE BENCHMARK ELEV 714.990 REFERENCE BENCHMARK ELEV 714.990 EXISTING LENGTH XX.XX' 0 0 0 0 0 0 0 0 0 0 0 0 0 0 0 0 0 DETECTABLE WARNINGS BENCHMARK : TOP OF CATCH BASIN BENCHMARK : TOP OF CATCH BASIN PROPOSED SIDE CURB LOCATION : SOUTH WEST CORNTER IL-31 & MAIN ST. SIDEWALK REMOVAL LOCATION : SOUTH WEST CORNTER IL-31 & MAIN ST. EXISTING ELEVATION/SLOPE REPLACE W/TOPSOIL & SOD) (FILE NAME = DESIGNED -REVISED USER NAME = hassann ADA RAN STATE OF ILLINOIS ow:\\IL084EBIDINTEG.1111no15.gov:PWIDOT\Do uments\IDOT_Offices\District_l\Projects\D137<mark>618RMAMNata\De</mark>sign\D137616-sht-details.do REVISED IL-31 (BATAVIA AVE.) FROM M PLOT SCALE = 10.0000 '/ in. CHECKED -REVISED **DEPARTMENT OF TRANSPORTATION**

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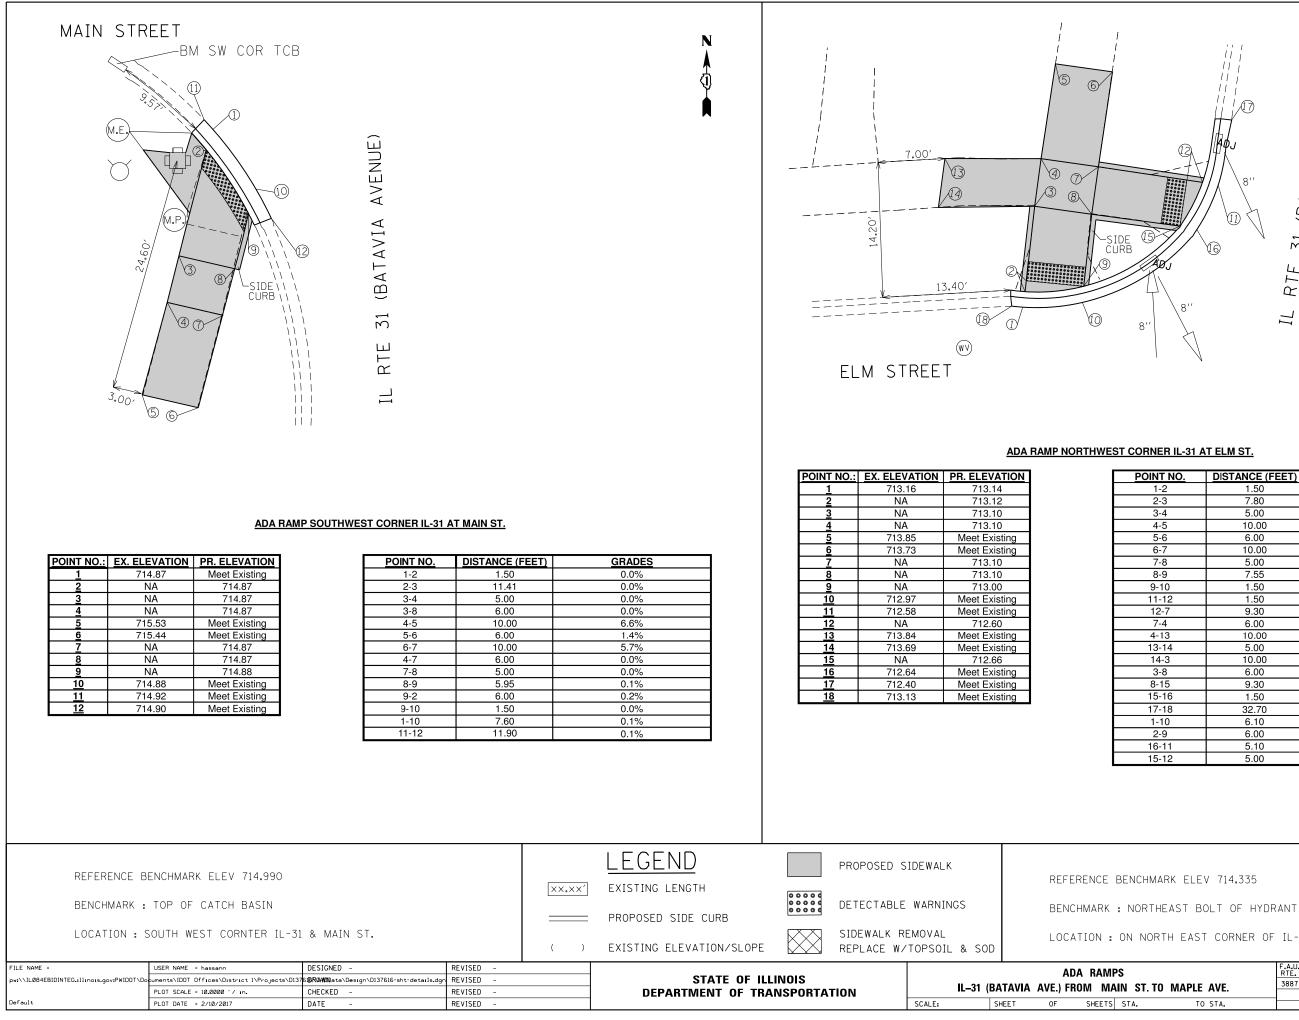
MAIN STREET

ADA RAMP SOUTHEAST CORNER IL-31 AT MAIN ST.

POINT NO.	DISTANCE (FEET)	GRADES
1-2	1.50	0.0%
2-3	6.62	4.3%
3-4	6.00	0.0%
4-5	2.83	3.9%
5-6	5.90	2.9%
6-7	4.08	1.4%
7-8	6.00	0.0%
8-9	6.69	5.6%
9-10	1.50	0.0%
11-12	1.50	0.0%
12-3	9.27	0.9%
3-8	6.00	0.0%
8-13	4.22	4.6%
13-14	5.37	3.3%
14-7	6.45	0.2%
7-4	6.00	0.0%
4-15	7.70	1.7%
15-16	1.50	0.0%
17-18	31.71	0.5%
12-15	6.00	0.7%
11-16	6.10	0.7%
2-9	6.00	1.5%
1-10	6.00	1.5%

		AD	A RAMF	rs		F.A.U. RTE	SECTION	COUNTY TOTAL SHEETS		SHEET NO.	
1 /R/	(BATAVIA AVE.) FROM MAIN ST. TO MAPLE AVE.							A-R-RS-3	KANE	34	13
	I (DATAVIA AVE.) FRUIVI IVIAIN ST. TU IVIAFLE AVE.								CONTRACT	NO. 6	2C69
SE	HEET	OF	SHEETS	STA.	то	STA.		ILLINOIS FED. AI	D PROJECT		





(BATAVIA AVENUE) 31 RTE][

POINT NO.	DISTANCE (FEET)	GRADES
1-2	1.50	1.3%
2-3	7.80	0.3%
3-4	5.00	0.0%
4-5	10.00	7.5%
5-6	6.00	2.1%
6-7	10.00	6.3%
7-8	5.00	0.0%
8-9	7.55	1.3%
9-10	1.50	1.8%
11-12	1.50	1.5%
12-7	9.30	5.4%
7-4	6.00	0.0%
4-13	10.00	7.4%
13-14	5.00	2.9%
14-3	10.00	5.9%
3-8	6.00	0.0%
8-15	9.30	4.7%
15-16	1.50	1.1%
17-18	32.70	2.2%
1-10	6.10	3.00%
2-9	6.00	2.00%
16-11	5.10	1.30%
15-12	5.00	1.20%

LOCATION : ON NORTH EAST CORNER OF IL-31 & ELM STREET

VIP	/IPS IAIN ST. TO MAPLE AVE.		F.A.U. SECTION RTE.				COUNTY	TOTAL SHEETS	SHEET NO.	
лл			TTO MADIE AVE 3887 A-R-RS-3							14
VIAIN ST. TU WAFLE AVE.							CONTRACT	NO. 6	2C69	
TS	STA.	TO	STA.	ILLINOIS FED. AID PROJECT						

BENCHMARK : LOCATION : (ENCHMARK ELEV 714.335 NORTHEAST BOLT OF HYDRAN DN NORTH EAST CORNER OF II USER NAME = hessenn DOT\Documenta\IDOT Offices\District I\Projects\D PLOT SCALE = 10.0000 // in. PLOT DATE = 2/10/2017	L-31 & ELM STREET	REVISED - REVISED - REVISED - REVISED -	()	LEGEND EXISTING LENGTH PROPOSED SIDE CURB EXISTING ELEVATION/SLOPE STATE OF ILL DEPARTMENT OF TRA		SIDEWALK F REPLACE W	E WARNINGS REMOVAL /TOPSOIL &		REFERENCE B BENCHMARK : LOCATION : (ADA RAMPS AVE.) FROM MAII
BENCHMARK : LOCATION : (NORTHEAST BOLT OF HYDRAN DN NORTH EAST CORNER OF II USER NAME = hossonn DOT\Documents\IDDT Offices\District 1\Projects\D	L-31 & ELM STREET DESIGNED - 137618RAMMINata\Design\D137616-sht-details.dgr	REVISED -		EXISTING LENGTH PROPOSED SIDE CURB EXISTING ELEVATION/SLOPE STATE OF ILL		DETECTABLI SIDEWALK F REPLACE W	E WARNINGS REMOVAL /TOPSOIL &		BENCHMARK : LOCATION : (ADA RAMPS
BENCHMARK : Location : (NORTHEAST BOLT OF HYDRAN DN NORTH EAST CORNER OF II	L-31 & ELM STREET	REVISED -		EXISTING LENGTH PROPOSED SIDE CURB EXISTING ELEVATION/SLOPE		DETECTABLI SIDEWALK F	E WARNINGS REMOVAL	SOD	BENCHMARK : Location : (
BENCHMARK :	NORTHEAST BOLT OF HYDRAN				EXISTING LENGTH PROPOSED SIDE CURB		DETECTABLI SIDEWALK F	E WARNINGS REMOVAL	SOD	BENCHMARK :
		IT			EXISTING LENGTH					
REFERENCE B	ENCHMARK ELEV 714.335			XX.XX'		00000				REFERENCE B
					LEGEND		PROPOSED	SIDEWALK		
		9-2 10-1 12-15 11-16	5.00 5.10 6.00 6.00		1.2% 0.2% 0.7% 0.5%					_
		17-18	35.00		3.3%		<u>18</u> 7	'12.51	Meet Existing]
<u>18</u>	713.70 Meet Existing	15-16	1.50		1.3%				Meet Existing	
17	712.55 Meet Existing	4-15	10.80		7.1%			NA /12.98	712.95 Meet Existing	-
<u>15</u> 16	NA 712.68 712.70 Meet Existing	<u> </u>	5.00		7.2% 0.0%				Meet Existing	4
<u>14</u>	713.81 Meet Existing	13-14	6.00		3.3%				Meet Existing]
13	713.61 Meet Existing	8-13	5.00		4.4%			NA	712.90	1
12	NA 712.64	3-8	5.00		0.0%				Meet Existing	1
	712.67 Meet Existing	12-3	10.70		7.6%		<u>×</u>		Meet Existing	4
10	712.43 Meet Existing	11-12	1.50		2.0%		<u>8</u> 9	NA	713.50	4
9	NA 712.45	9-10	1.50		1.3%			NA NA	713.50 713.50	4
	NA 713.45 NA 713.39	8-9	12.30		7.6%				Meet Existing	4
	713.77 Meet Existing NA 713.45	7-8	5.00		6.4% 0.0%				Meet Existing	
<u>×</u>	713.71 Meet Existing	<u>5-6</u> 6-7	5.00		1.2%			NA	713.50	
	NA 713.45	4-5	5.00		5.2%		3	NA	713.50	
4					0.0%		2	NA	712.61	
<u>3</u> <u>4</u> 5	NA 713.45	3-4	6.00							

AMP NORTHEAST CORNER IL-31 AT ELM ST.

RTE 31 (BATAVIA AVENUE)

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(1)

		ADA I
POINT NO .:	EX. ELEVATION	PR. ELEVATION
<u>1</u>	712.44	Meet Existing
2	NA	712.51
<u>3</u>	NA	713.45
4	NA	713.45
<u>5</u>	713.71	Meet Existing
<u>6</u>	713.77	Meet Existing
<u>7</u>	NA	713.45
<u>8</u>	NA	713.39
<u>9</u>	NA	712.45
<u>10</u>	712.43	Meet Existing
<u>11</u>	712.67	Meet Existing
12	NA	712.64
13	713.61	Meet Existing
<u>14</u>	713.81	Meet Existing
<u>15</u>	NA	712.68
16	712.70	Meet Existing

<u>POINT NO.</u>	DISTANCE (FEET)	GRADES
1-2	1.50	4.7%
2-3	11.80	8.0%
3-4	6.00	0.0%
4-5	5.00	5.2%
5-6	5.00	1.2%
6-7	5.00	6.4%
7-8	6.00	0.0%
8-9	12.30	7.6%
9-10	1.50	1.3%
11-12	1.50	2.0%
12-3	10.70	7.6%
3-8	5.00	0.0%
8-13	5.00	4.4%
13-14	6.00	3.3%
14-7	5.00	7.2%
7-4	5.00	0.0%
4-15	10.80	7.1%
15-16	1.50	1.3%
17-18	35.00	3.3%
9-2	5.00	1.2%
10-1	5.10	0.2%
12-15	6.00	0.7%
11-16	6.00	0.5%

/-BM NE BOLT

(c)^{28''}

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(14)

-SIDE CURB

8 0

<u>\</u>3 (9)


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ELM STREET

1.30/~

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RTE][


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31 (BATAVIA AVENUE)


 POINT NO.:
 EX. ELEVATION
 PR. ELEVATION

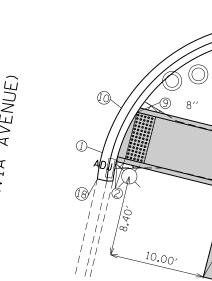 1
 712.60
 Meet Existing

 2
 NA
 712.61

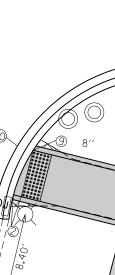

ELM STREET

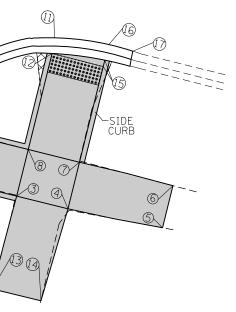

ADA RAMP SOUTHEAST CORNER IL-31 AT ELM ST.


POINT NO.	DISTANCE (FEET)	GRADES
1-2	1.5	1.0%
2-3	11.8	7.5%
3-4	5.5	0.0%
4-5	10	5.7%
5-6	5	1.2%
6-7	10	5.1%
7-8	5.5	0.0%
8-9	11	7.3%
9-10	1.5	1.8%
11-12	1.5	1.5%
12-8	10.3	5.8%
8-3	5	0.0%
3-13	10	6.4%
13-14	5.1	1.1%
14-4	10	5.9%
4-7	5	0.0%
7-15	11	5.0%
15-16	1.5	2.0%
17-18	32.7	1.5%
1-10	5	1.6%
2-9	5	1.8%
16-11	5.5	1.1%
15-12	5.5	0.9%

BENCHMARK ELEV 714.335

NORTHEAST BOLT OF HYDRANT

ON NORTH EAST CORNER OF IL-31 & ELM STREET


MF	MPS MAIN ST. TO MAPLE AVE.		F.A.U. RTE.	SECTION	COUNTY	DUNTY TOTAL SHEETS		
<u>лл</u>			ST TO MADIE AVE 3887 A-R-RS-3					
VIAIN ST. TU WAFLE AVE.					CONTRACT	NO. 6	2C69	
ΤS	STA.	TO STA.		ILLINOI	S FED. A	ID PROJECT		

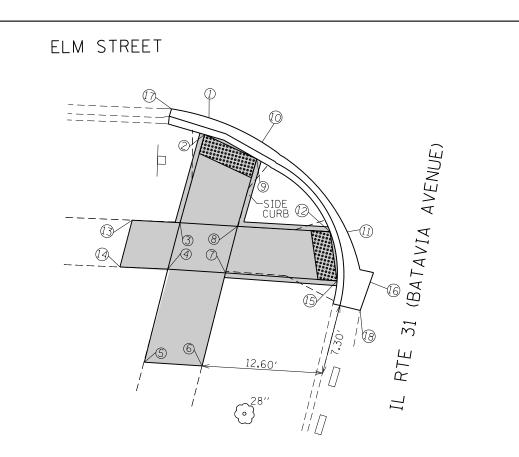

ADA RAMP SOUTHWEST CORNER IL-31 AT ELM ST.

POINT NO .:	EX. ELEVATION	PR. ELEVATION
<u>1</u>	712.90	Meet Existing
<u>2</u>	NA	712.92
<u>3</u>	NA	713.30
4	NA	713.30
<u>5</u>	713.87	Meet Existing
<u>6</u>	713.76	Meet Existing
<u>7</u>	NA	713.30
<u>8</u>	NA	713.30
<u>9</u>	NA	712.80
<u>10</u>	712.78	712.79
<u>11</u>	712.65	Meet Existing
<u>12</u>	NA	712.63
<u>13</u>	713.69	Meet Existing
<u>14</u>	713.81	Meet Existing
<u>15</u>	NA	712.60
<u>16</u>	712.64	Meet Existing
<u>17</u>	712.79	Meet Existing
<u>18</u>	712.52	Meet Existing

<u>POINT NO.</u>	DISTANCE (FEET)	<u>GRADES</u>
1-2	1.50	1.2%
2-3	9.50	4.0%
3-4	5.00	0.0%
4-5	10.00	5.7%
5-6	6.00	1.9%
6-7	10.00	4.6%
7-8	5.00	0.0%
8-9	7.30	6.8%
9-10	1.50	0.7%
11-12	1.50	1.6%
12-8	9.60	7.0%
8-3	6.00	0.0%
3-13	10.00	3.9%
13-14	5.00	2.4%
14-4	10.00	5.1%
4-7	6.00	0.0%
7-15	11.65	6.0%
15-16	1.50	2.5%
17-18	29.60	0.9%
1-10	6.10	1.8%
2-9	6.00	2.0%
16-11	5.00	0.3%
15-12	5.00	0.6%

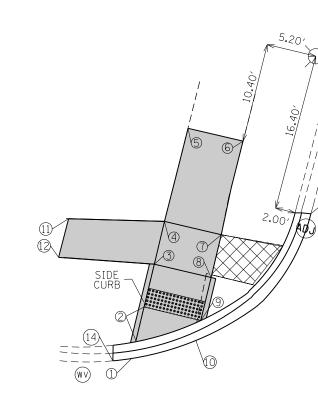

WALNUT STREET

ADA RAMP NORTHWE

POINT NO .:	EX. ELEVATION	PR. ELEVATION				
<u>1</u>	713.45	Meet Existing				
<u>2</u>	NA	713.47				
<u>3</u>	NA	713.75				
<u>4</u>	NA	713.75				
<u>5</u>	714.49	Meet Existing				
<u>6</u>	714.35	Meet Existing				
<u>7</u>	NA	713.75				
<u>8</u>	NA	713.75				
9	NA	713.50				
<u>10</u>	713.49	Meet Existing				
<u>11</u>	714.38	Meet Existing				
<u>12</u>	714.29	Meet Existing				
<u>13</u>	713.45	Meet Existing				
<u>14</u>	713.43	Meet Existing				

REFERENCE	BENCHMARK ELEV 714.335			XX.XX'	LEGEND EXISTING LENGTH		PROPOSED SI	DEWALK	REFERENCE BENCH	MARK ELEV 713.9	172		
BENCHMARK : NORTHEAST BOLT OF HYDRANT				PROPOSED SIDE CURB					BENCHMARK : SQ CUT WEST SIDE OF LP BASE				
LOCATION : ON NORTH EAST CORNER OF IL-31 & ELM STREET		()	EXISTING ELEVATION/SLOPE		SIDEWALK RE Replace w/1	OPSOIL & SOD	LOCATION : ON NO	RTH WEST CORN	ER OF IL-31	& WALNUT ST			
FILE NAME =	USER NAME = hassann	DESIGNED -	REVISED -						ADA RAMPS		F.A.U.	SECTION	COUNTY TOTAL SHEE' SHEETS NO.
p#1\1L084EBIDINTEG.111no1s.gov:PWIDOT\Documents\IDOT Offices\District 1\Projects\D1376 BRGMUN ata\Design\D137616-sht-details.dgn REVISED -			STATE OF ILL	.INOIS		U 04 /DAT	(BATAVIA AVE.) FROM MAIN ST. TO MAPLE AVE.		3887	A-R-RS-3	KANE 34 16		
	PLOT SCALE = 10.0000 '/ in.	CHECKED -	REVISED -		DEPARTMENT OF TRA	NSPORTATIO	DN	IL-31 (BA1	AVIA AVE.) FRUM MAIN SI.	IU WAPLE AVE.			CONTRACT NO. 62C69
Default	PLOT DATE = 2/10/2017	DATE -	REVISED -					SCALE: SHE	ET OF SHEETS STA.	TO STA.		ILLINOIS FEF	D. AID PROJECT

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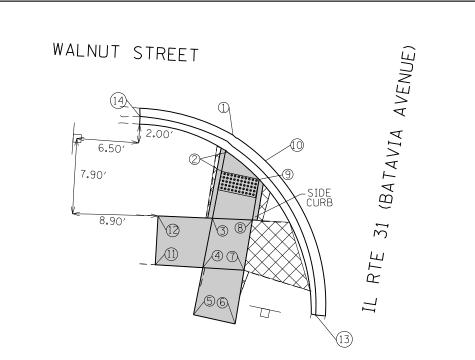


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EST CORNER	IL-31 AT	WALNUT S	т.
	IL OI AI	THAL NOT 0	

POINT NO.		CRADES
	DISTANCE (FEET)	GRADES
1-2	1.5	1.7%
2-3	4.6	6.1%
3-4	4.6	0.0%
4-5	10	7.4%
5-6	6	2.4%
6-7	10	6.0%
7-8	4.6	0.0%
8-9	4.6	5.4%
9-10	1.5	0.8%
11-12	4.2	2.2%
12-3	10	5.4%
11-4	10	6.3%
3-8	6	0.0%
4-7	6	0.0%
2-9	6	0.5%
1-10	7.3	0.6%
13-14	26.22	0.1%

ADA RAMPS	F.A.U. RTE.	SECTION	COUNTY	TOTAL SHEETS	SHEET NO.
1 (BATAVIA AVE.) FROM MAIN ST. TO MAPLE AVE.	3887	A-R-RS-3	KANE	34	16
I (BATAVIA AVE.) I HOW MAIN ST. TO MALLE AVE.			CONTRACT	NO. 6	52C69
SHEET OF SHEETS STA. TO STA.		ILLINOIS FED. A	ID PROJECT		



56 12 0 38 SIDE CURB STOR \bigcirc

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BLAINE STREET

ADA RAMP SOUTHWEST CORNER IL-31 AT WALNUT ST.

POINT NO .:	EX. ELEVATION	PR. ELEVATION
<u>1</u>	713.28	Meet Existing
<u>2</u>	NA	713.30
3	NA	713.50
4	NA	713.50
5	713.70	Meet Existing
<u>6</u>	713.58	Meet Existing
<u>7</u>	NA	713.50
<u>8</u>	NA	713.50
9	NA	713.30
<u>10</u>	713.29	Meet Existing
<u>11</u>	713.70	Meet Existing
<u>12</u>	713.54	Meet Existing
<u>13</u>	713.29	Meet Existing
<u>14</u>	713.12	Meet Existing

PLOT DATE = 2/10/2017

DATE

-

Default

POINT NO.	DISTANCE (FEET)	GRADES
1-2	1.5	1.4%
2-3	5	4.0%
3-4	5	0.0%
4-5	5	4.0%
5-6	4.4	2.7%
6-7	5.7	1.4%
7-8	5	0.0%
8-9	4.3	4.7%
9-10	1.5	0.9%
11-12	5.1	3.1%
12-3	5.7	0.7%
11-4	5	4.0%
3-8	4	0.0%
4-7	4	0.0%
2-9	4	0.0%
1-10	4	0.2%
13-14	30.75	0.6%

ADA RAMP NORTHW

POINT NO .:	EX. ELEVATION	PR. ELEVATION
1	706.26	Meet Existing
2	NA	706.26
<u>3</u>	NA	706.65
<u>4</u>	NA	706.65
<u>5</u>	707.48	Meet Existing
<u>6</u>	707.46	Meet Existing
<u>7</u>	NA	706.65
<u>8</u>	NA	706.65
<u>9</u>	NA	706.26
<u>10</u>	706.53	706.29
<u>11</u>	706.96	Meet Existing
<u>12</u>	706.88	Meet Existing
<u>13</u>	706.10	Meet Existing
<u>14</u>	706.92	Meet Existing

SCALE:

SHEET

OF SHEETS STA.

FILE NAME = pw:\\IL084EBIDINTEG.1111no15.gov:PWIDOT\D	USER NAME = hassann ocuments\IDOT Offices\District 1\Projec PLOT SCALE = 10.0000 '/ in.	DESIGNED - ts\D137618RAMNata\Design\D137616-sht-details CHECKED -	REVISED - REVISED - REVISED -		STATE OF ILL DEPARTMENT OF TRA	TION	IL-31 (BA)	ADA RAMPS TAVIA AVE.) FROM MAIN ST. TO MAPLE AVE.
	F	IL-31 & WALNUT STREET		()	EXISTING ELEVATION/SLOPE	SIDEWALK R REPLACE W/	EMOVAL TOPSOIL & SOD	LOCATION : ON NORTH WEST COF
BENCHMARK : SC	CUT WEST SIDE OF LF	BASE			PROPOSED SIDE CURB	DETECTABLE		BENCHMARK : NORTH EAST BOLT
REFERENCE BENC	CHMARK ELEV 713.972			×ו××′	LEGEND existing length	PROPOSED S	SIDEWALK	REFERENCE BENCHMARK ELEV 710

REVISED -


-BM NE BOLT

31 (BATAVIA AVENUE) RTE][

VEST	CORNER	IL-31 A1	FBLAINE	ST.
				<u></u>

POINT NO.	DISTANCE (FEET)	GRADES
1-2	1.5	0.0%
2-3	6.5	6.0%
3-4	5	0.0%
4-5	15	5.5%
5-6	5	0.4%
6-7	15	5.4%
7-8	5	0.0%
8-9	8	4.9%
9-10	1.5	2.0%
11-12	5	1.6%
12-4	10	2.3%
11-3	9	3.4%
13-14	28.9	2.8%
3-8	5	0.0%
4-7	5	0.0%
1-10	6.7	0.5%
2-9	5	0.0%

TS	TS STA. TO STA.				ILLINOIS FED. A	CONTRACT D PROJECT	NO. 6	2C69
MAIN ST. TO MAPLE AVE. 3887 A-R-RS-3 KANE					34	17		
M	PS			F.A.U. RTE.	SECTION	COUNTY	TOTAL SHEETS	SHEET NO.
:	ON NORTH	WEST	CORNER OF	IL-3	31 & BLAINE STREE	ΞT		
K	: NORTH EAST BOLT OF HYDRANT							
E	BENCHMARK ELEV 710.039							

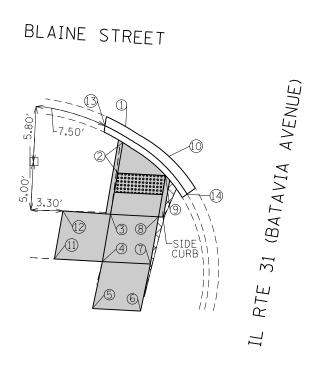

ADA RAMP SOUTHWEST CORNER IL-31 AT BLAINE ST.


POINT NO .:	EX. ELEVATION	PR. ELEVATION
<u>1</u>	705.28	Meet Existing
2	NA	705.30
<u>3</u>	NA	705.60
<u>4</u>	NA	705.68
<u>5</u>	706.07	Meet Existing
<u>6</u>	705.99	Meet Existing
<u>7</u>	NA	705.60
<u>8</u>	NA	705.60
<u>9</u>	NA	705.37
<u>10</u>	705.35	Meet Existing
<u>11</u>	705.93	Meet Existing
<u>12</u>	705.89	Meet Existing
<u>13</u>	705.30	Meet Existing
<u>14</u>	705.39	Meet Existing

POINT NO.	DISTANCE (FEET)	GRADES
1-2	1.5	1.6%
2-3	4.4	6.8%
3-4	5	1.6%
4-5	5	7.8%
5-6	5	1.7%
6-7	5	7.7%
7-8	5	0.0%
8-9	4.4	5.2%
9-10	1.5	1.0%
11-12	5	0.6%
12-3	5	5.9%
11-4	5	4.9%
3-8	5	0.0%
4-7	5	1.6%
2-9	5	1.4%
1-10	5.1	1.5%
13-14	11.3	0.9%

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POINT NO .:	EX. ELEVATION	PR. ELEVATION
1	714.06	Meet Existing
2	NA	714.00
<u>3</u>	NA	714.20
4	NA	714.20
5	NA	714.20
<u>6</u>	714.58	Meet Existing
<u>7</u>	714.62	Meet Existing
<u>8</u>	NA	714.22
9	NA	714.20
<u>10</u>	NA	714.20
<u>11</u>	NA	713.98
<u>12</u>	713.99	Meet Existing
<u>13</u>	714.13	Meet Existing
<u>14</u>	NA	714.15
<u>15</u>	NA	714.15
<u>16</u>	714.14	Meet Existing
<u>17</u>	714.15	Meet Existing
18	714.17	Meet Existing

REFERENCE BENC	HMARK ELEV 710.039						PROPOSED S	IDEWALK		REFEF	RENCE
	DTU FAST DOLT OF UVDDAN	т		XXX'	EXISTING LENGTH		DETECTABLE	WARNINGS		BENCH	
DEINCHMARK : NUI	RTH EAST BOLT OF HYDRAN	1			PROPOSED SIDE CURB	00000				DENU	IWARK
LOCATION : ON M	NORTH WEST CORNER OF IL	-31 & BLAINE STREET		()	EXISTING ELEVATION/SLOPE		SIDEWALK R REPLACE W/	EMOVAL TOPSOIL & SO	D	LOCA	FION
FILE NAME =	USER NAME = hassann	DESIGNED -	REVISED -								A RAN
pw:\\IL084EBIDINTEG.111no1s.gov:PWIDOT\Do	cuments\IDOT_Offices\District_l\Projects\D13	61 6R04WN ata\Design\D137616-sht-details.dgn	REVISED -		STATE OF ILI	LINOIS					
	PLOT SCALE = 10.0000 '/ in.	CHECKED -	REVISED -		DEPARTMENT OF TRA	ANSPORTA	TION	IL-31 (BATAVIA	AVE.) FR	JINI IN
Default	PLOT DATE = 2/10/2017	DATE –	REVISED -					SCALE:	SHEET	OF	SHEET

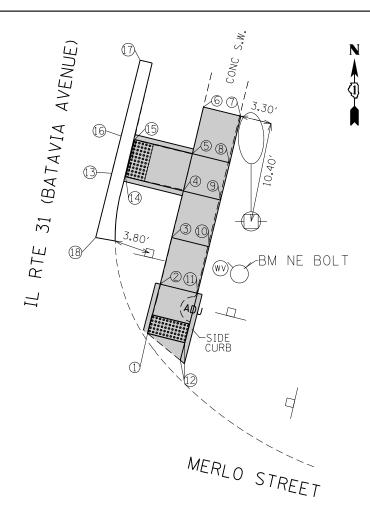

ADA RAMP NORTHEAST CORNER IL-31 AT MERLO ST.


POINT NO.	DISTANCE (FEET)	GRADES
1-2	5.3	1.05%
2-3	5	4.00%
3-4	5	0.00%
4-5	4	0.00%
5-6	5	7.56%
6-7	4	0.97%
7-8	5	7.93%
8-9	4	0.50%
9-10	5	0.00%
10-11	5	4.40%
11-12	7.2	0.08%
13-14	1.5	1.31%
14-4	6.2	0.81%
15-5	6.2	0.81%
15-16	1.5	0.82%
5-8	4	0.50%
4-9	4	0.00%
3-10	4	0.00%
2-11	4	0.50%
1-12	4.42	1.60%
13-16	4	0.18%
17-18	19.1	0.13%

BENCHMARK ELEV 715.935

: NORTH EAST BOLT OF HYDRANT

: ON NORTH EAST CORNER OF IL-31 & MERLO STREET

	A	ADA RAMF	vs			F.A.U. RTE.	SECTION	COUNTY	TOTAL SHEETS	SHEET NO.
1 /RATA	VIA AVE.)		IN ST. TO	MADIE	AVE	3887	A-R-RS-3	KANE	34	18
								CONTRACT	NO. 6	2069
SHEET	r OF	SHEETS	STA.	TO	STA.		ILLINOIS FED. A	ID PROJECT		

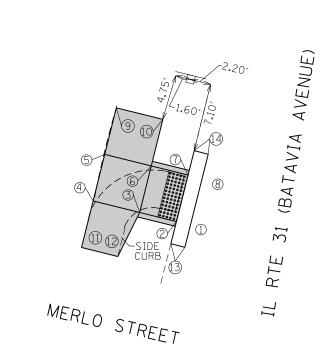

/BM NE BOLT -SIDE CURB CARLISLE ROAD

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ADA RAMP NORTHWEST CORNER IL-31 AT MERLO ST.

POINT NO .:	EX. ELEVATION	PR. ELEVATION
<u>1</u>	713.47	Meet Existing
2	NA	713.50
<u>3</u>	NA	713.80
<u>4</u>	NA	713.80
<u>5</u>	NA	713.82
<u>6</u>	NA	713.80
<u>7</u>	NA	713.54
<u>8</u>	713.53	Meet Existing
<u>9</u>	714.20	Meet Existing
<u>10</u>	714.04	Meet Existing
<u>11</u>	713.96	Meet Existing
<u>12</u>	713.80	Meet Existing
<u>13</u>	713.40	Meet Existing
<u>14</u>	713.54	Meet Existing

POINT NO.	DISTANCE (FEET)	GRADES
1-2	1.5	1.8%
2-3	4	7.5%
3-4	5	0.0%
4-5	5	0.4%
5-9	5	7.7%
9-10	5	3.3%
10-6	5	4.8%
5-6	5	0.4%
6-7	4	6.5%
7-8	1.5	0.7%
11-4	5	3.2%
11-12	4	3.9%
12-3	5.1	0.1%
13-14	10	1.4%
2-7	5	0.8%
3-6	5	0.0%
1-8	5	1.1%

POINT NO .:	EX. ELEVATION	PR. ELEVATION
1	710.18	Meet Existing
2	NA	710.18
<u>3</u>	NA	710.54
<u>4</u>	710.54	Meet Existing
<u>5</u>	710.54	Meet Existing
<u>6</u>	NA	710.54
<u>7</u>	710.36	710.25

SHEET

REFERENCE BENC	HMARK ELEV 715.935				LEGEND		PROPOSED S	SIDEWALK		REFERENCE
BENCHMARK : NO	RTH EAST BOLT OF HYDRAN	ΙT			EXISTING LENGTH PROPOSED SIDE CURB		DETECTABLE	WARNINGS		BENCHMARK
LOCATION : ON M	NORTH EAST CORNER OF IL	-31 & MERLO STREET		()	EXISTING ELEVATION/SLOPE		SIDEWALK R REPLACE W/	EMOVAL 'TOPSOIL & SO	D	LOCATION :
FILE NAME =	USER NAME = hassann	DESIGNED -	REVISED -	•						ADA RAMP
pw:\\IL084EBIDINTEG.1111no1s.gov:PWIDOT\Do	cuments\IDOT Offices\District 1\Projects\D13	761 8R0440N ata\Design\D137616-sht-details.dgr	REVISED -		STATE OF ILL	INOIS				
	PLOT SCALE = 10.0000 '/ in.	CHECKED -	REVISED -		DEPARTMENT OF TRA	NSPORTA	TION	IL-31 (BATAVIA /	AVE.) FROM MA
Default	PLOT DATE = 2/10/2017	DATE -	REVISED -					SCALE:	SHEET	OF SHEETS

31 (BATAVIA AVENUE) RTE][



ADA RAMP NORTHWEST CORNER IL-31 AT CARLISLE RD.


POINT NO.	DISTANCE (FEET)	<u>GRADES</u>
1-2	5.4	0.07%
2-3	7.8	4.67%
3-4	4	0.00%
4-5	4	0.02%
5-6	4	0.00%
6-7	6.9	2.74%
2-7	3.8	1.84%
3-6	4	0.02%
1-7	6.6	1.00%

BENCHMARK ELEV 711.962


: NORTH EAST BOLT OF HYDRANT

ON NORTH WEST CORNER OF IL-31 & CARLISLE ROAD

ADA RAMPS	F.A.U. RTE.	SECTION	COUNTY	TOTAL SHEETS	SHEET NO.
AVE.) FROM MAIN ST. TO MAPLE AVE.	3887	A-R-RS-3	KANE	34	19
AVE., THOM MAIN 31. TO MALE AVE.			CONTRACT	NO. 6	2C69
OF SHEETS STA. TO STA.		ILLINOIS FED. AI	D PROJECT		

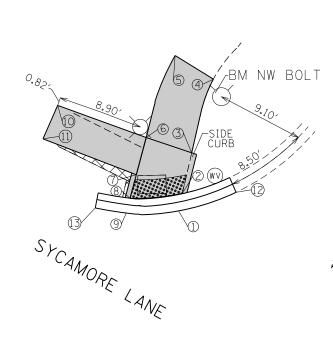

POINT NO .:	EX. ELEVATION	PR. ELEVATION		
<u>1</u>	696.39	Meet Existing		
<u>2</u>	NA	696.40		
<u>3</u>	NA	696.40		
4	696.91	Meet Existing		
<u>5</u>	696.18	Meet Existing		
<u>6</u>	NA	696.40		
<u>7</u>	NA	696.40		
<u>8</u>	NA	696.40		
<u>9</u>	696.46	696.43		
<u>10</u>	696.40	Meet Existing		
<u>11</u>	696.29	Meet Existing		
<u>12</u>	696.32	Meet Existing		
<u>13</u>	696.52	Meet Existing		

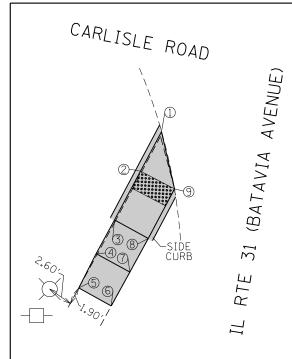

ADA RAMP SOUTHWEST CORNER IL-31 AT CARLISLE RD.

POINT NO .:	EX. ELEVATION	PR. ELEVATION
<u>1</u>	710.05	Meet Existing
<u>2</u>	NA	710.05
<u>3</u>	NA	710.06
4	NA	710.06
<u>5</u>	710.06	Meet Existing
<u>6</u>	710.15	Meet Existing
<u>7</u>	NA	710.10
<u>8</u>	NA	710.10
<u>9</u>	710.04	Meet Existing

POINT NO.	DISTANCE (FEET)	GRADES
1-2	4.6	0.10%
2-3	5.8	0.17%
3-4	4	0.00%
4-5	4	0.07%
5-6	3.9	2.30%
6-7	4	1.31%
7-8	4	0.00%
8-9	5.8	1.06%
1-9	6.1	0.27%
2-9	4	0.29%
3-8	4	1.00%
4-7	4	1.00%

REFERENCE BENCHMARK ELEV 711.962 BENCHMARK : NORTH EAST BOLT OF HYDRANT LOCATION : ON NORTH WEST CORNER OF IL-31 & CARLISLE ROAD				()	EXISTING LENGTH PROPOSED SIDE CURB			SED SIDEWALK TABLE WARNINGS ALK REMOVAL CE W/TOPSOIL & SOD			REFERENCE BENCHMARK ELEV 697.658 BENCHMARK : NORTH WEST BOLT OF HYDRANT LOCATION : ON NORTH WEST CORNER OF IL-31 AND SYCAMORE LANE				E LANE	
FILE NAME = pwt\\L084EBIDINTEG.111no1s.gov:PWIDOT\Do Default	USER NAME = hassann cuments\1001 Offices\01strict 1\Projects\013 PLOT SCALE = 10.0000 // in. PLOT DATE = 2/10/2017	DESIGNED - 619RAWNNatalDesign\0137616-sht-details.dg CHECKED - DATE -	REVISED - REVISED - REVISED - REVISED - REVISED -		STATE OF ILLI DEPARTMENT OF TRAM		ΓΙΟΝ	SCALE:	L-31 (BATAVIA		DA RAMPS ROM MAIN S	ST. TO MAPLE AVE.	F.A.U. RTE. 3887	SECTION A-R-RS-3	COUNTY TOT. SHEE KANE 34 CONTRACT NO.	TAL SHEET STS NO. 34 20 D. 62C69

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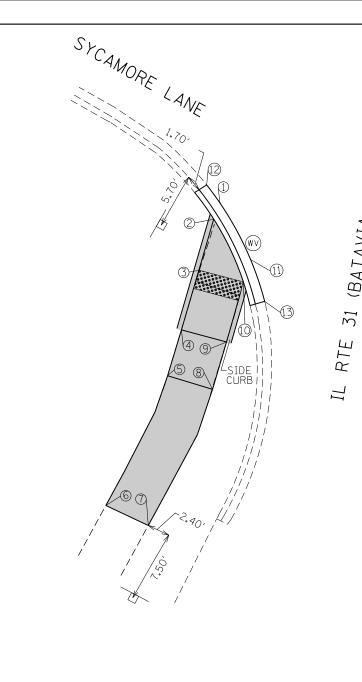
IL RTE 31 (BATAVIA AVENUE)

ADA RAMP NORTHWEST CORNER IL-31 AT SYCAMORE LN.

POINT NO.	DISTANCE (FEET)	GRADES
1-2	1.50	0.9%
2-3	4.34	0.0%
3-4	8.00	6.4%
4-5	4.70	15.6%
5-6	8.00	2.8%
6-7	4.00	0.0%
7-8	2.50	0.0%
8-9	1.50	2.0%
10-11	4.00	2.6%
10-6	9.80	0.0%
12-13	14.60	1.4%
1-9	5.50	0.8%
2-8	5.50	0.0%
3-6	5.00	0.0%
11-7	10.4	1.0%

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31 (BATAVIA AVENUE)

ADA RAMP SOUTHWEST CORNER IL-31 AT SYCAMORE LN.


POINT NO .:	EX. ELEVATION	PR. ELEVATION
1	696.12	696.27
2	NA	696.30
3	NA	696.40
<u>4</u>	NA	696.80
5	NA	696.80
6	697.97	Meet Existing
<u>7</u>	697.92	Meet Existing
8	NA	696.80
9	NA	696.80
<u>10</u>	NA	696.40
<u>11</u>	696.41	Meet Existing
<u>12</u>	696.12	Meet Existing
<u>13</u>	696.56	Meet Existing


POINT NO.	DISTANCE (FEET)	GRADES
1-2	1.50	2.0%
2-3	5.50	1.8%
3-4	6.50	6.2%
4-5	5.00	0.0%
5-6	15.00	7.8%
6-7	5.00	1.0%
7-8	15.00	7.5%
8-9	5.00	0.0%
9-10	6.50	6.2%
12-13	13.70	3.2%
1-11	6.70	2.0%
2-10	7.30	1.4%
3-10	5.00	0.0%
4-9	5.00	0.0%
5-8	5	0.0%
10-11	1.5	0.4%


REFERENCE BENCHMARK ELEV 697.658				XX.XX'	LEGEND existing length		PROPOSED S			
	BENCHMARK : NORTH WEST BOLT OF HYDRANT				PROPOSED SIDE CURB		SIDEWALK REMOVAL			
LUCATION . ON T	NORTH WEST CONNER OF I	SI AND STRAMONE LANE		()	EXISTING ELEVATION/SLOPE		REPLACE W/	/TOPSOIL & SOD		
FILE NAME =	USER NAME = hassann	DESIGNED -	REVISED -						ADA RA	
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	PLOT SCALE = 10.0000 '/ in.	CHECKED -	REVISED -		DEPARTMENT OF TRA	ANSPORTATION		IL–31 (BATAVIA AVE.) FROM MA		
Default	PLOT DATE = 2/10/2017	DATE -	REVISED -					SCALE: SH	EET OF SHEE	

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MPS				F.A.U. RTE.	SECTION	COUNTY	TOTAL SHEETS	SHEET NO.			
лл	IAIN ST. TO MAPLE AVE.			ADIE AVE 3887 A-R-RS-3							
MAIN ST. TO WAFLE AVE.						CONTRACT	NO. 6	2C69			
ſS	STA.	то	STA.		ILLINOIS FED. AID PROJECT						



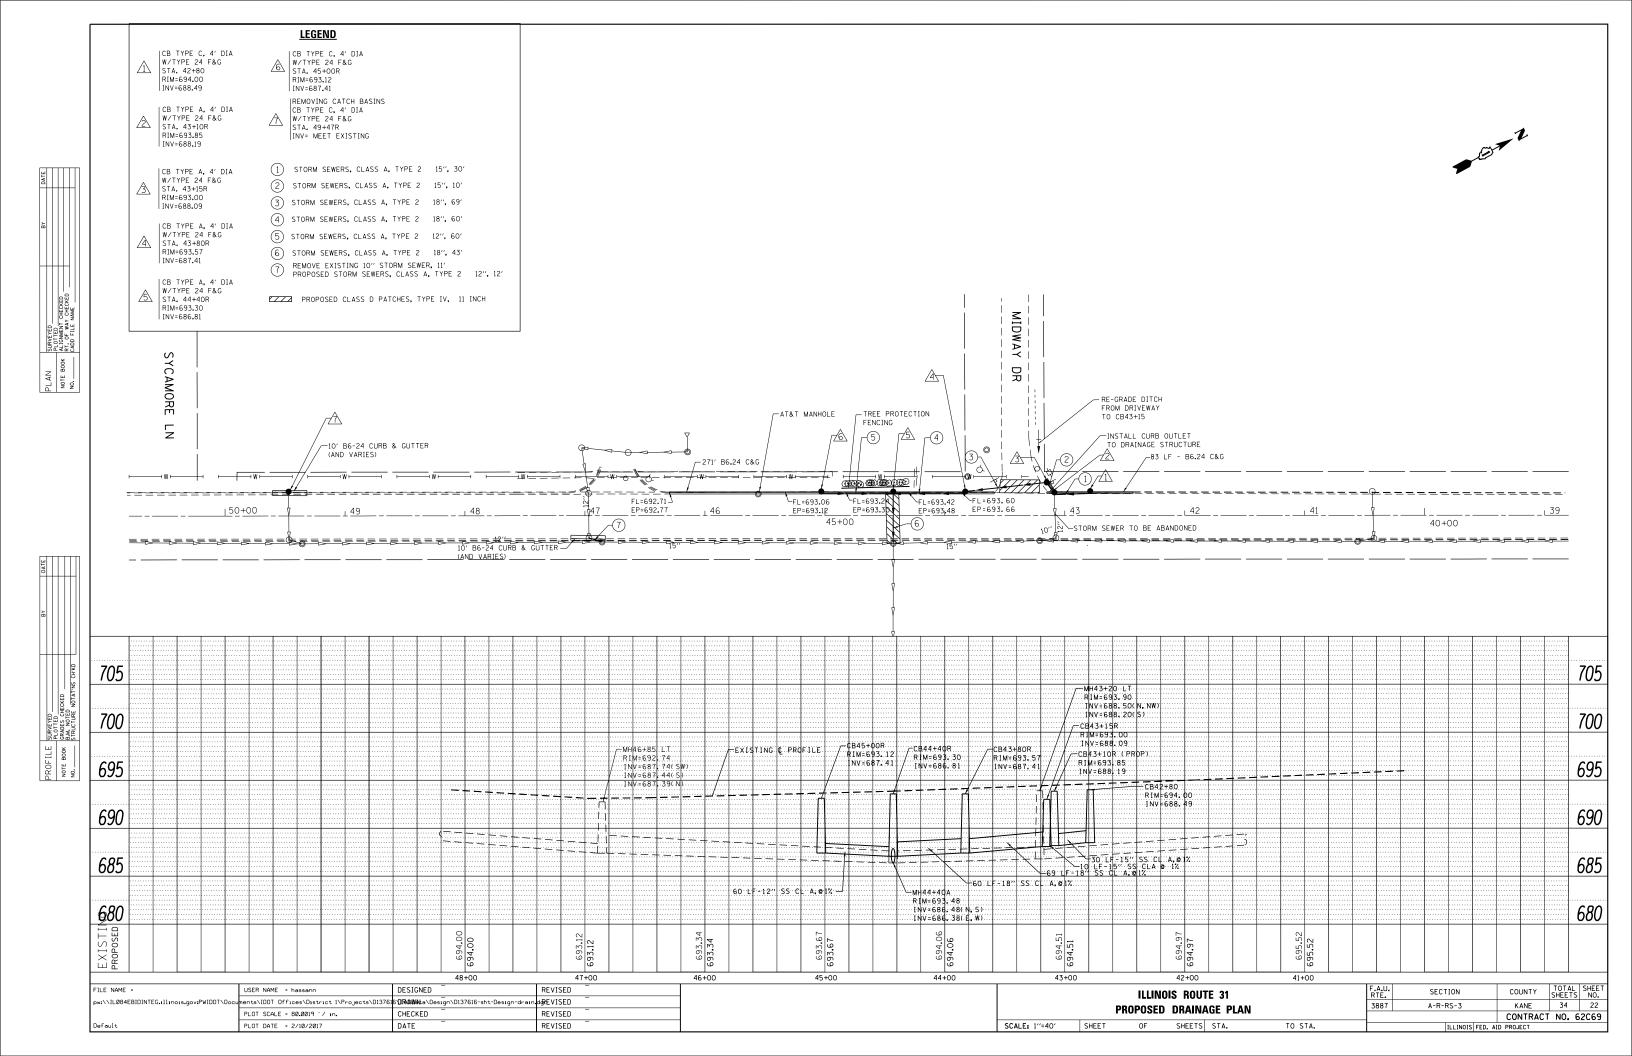

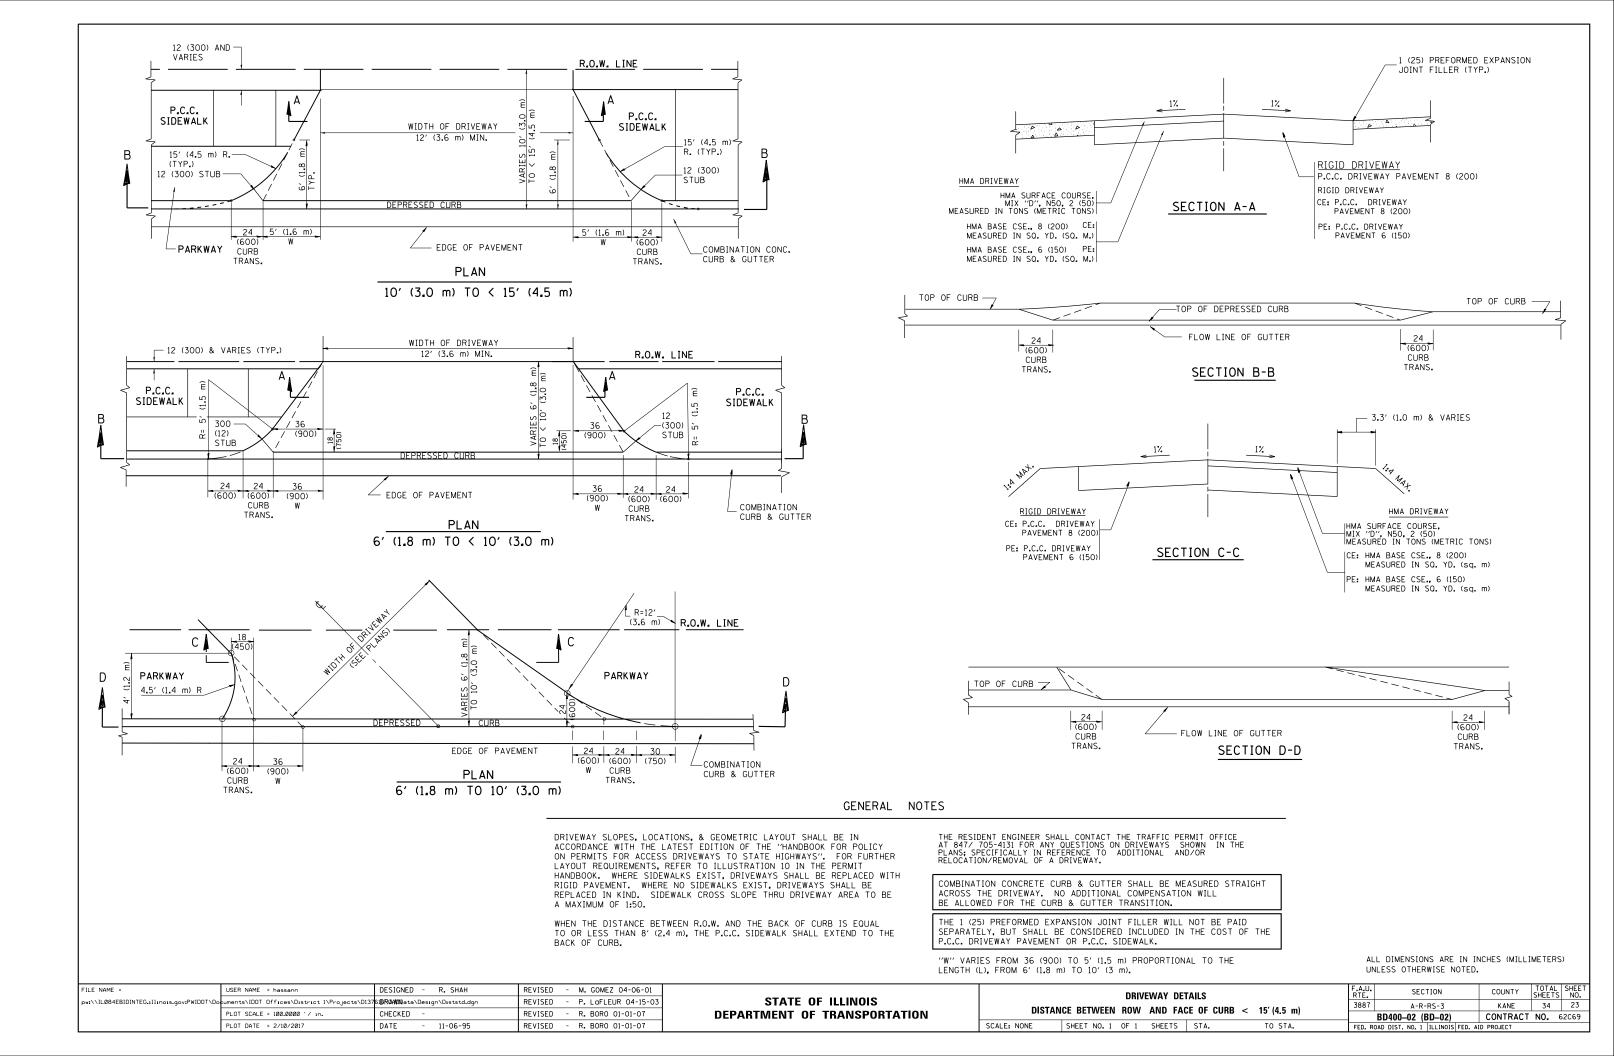

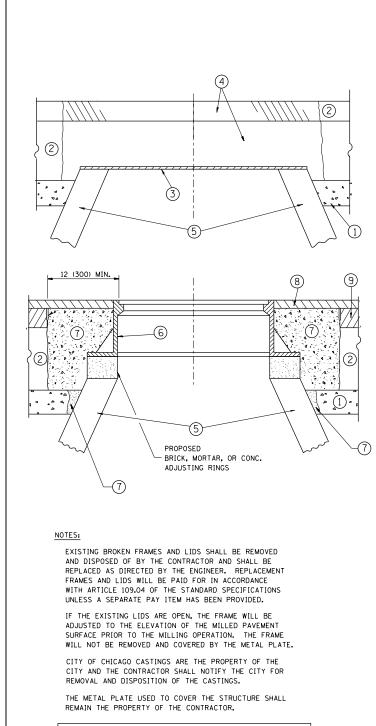WHEN STRUCTURES ARE TO BE ADJUSTED OR RECONSTRUCTED, THE LOWERING AND RAISING OF THE FRAMES AND LIDS WILL NOT BE PAID FOR SEPARATELY BUT WILL BE INCLUDED IN THE COST OF THE CORRESPONDING PAY ITEM.

DETAILS FOR FRAMES AND LIDS ADJUSTMENT WITH MILLING

FILE NAME =	USER NAME = hassann	DESIGNED - R. SHAH	REVISED - R. WIEDEMAN 05-14-04		DETAILS FOR	F.A.U. SECTION	COUNTY TOTAL SHEET
pw:\\ILØ84EBIDINTEG.1111no15.gov:PWIDOT\D	cuments\IDOT_Offices\District_I\Projects\D137	61 8RGAWIN ata\Design\Diststd.dgn	REVISED - R. BORO 01-01-07	STATE OF ILLINOIS		3887 A-R-RS-3	KANE 34 24
	PLOT SCALE = 100.0000 ' / in.	CHECKED -	REVISED - R. BORO 03-09-11	DEPARTMENT OF TRANSPORTATION	FRAMES AND LIDS ADJUSTMENT WITH MILLING	BD600-03 (BD-8)	CONTRACT NO. 62C69
	PLOT DATE = 2/10/2017	DATE - 10-25-94	REVISED - R. BORO 12-06-11		SCALE: NONE SHEET NO. 1 OF 1 SHEETS STA. TO STA.	FED. ROAD DIST. NO. 1 ILLINOIS FED.	

CONSTRUCTION PROCEDURES

STAGE 1 (BEFORE PAVEMENT MILLING)

- A) REMOVE A MINIMUM OF 12 (300) OF THE PAVEMENT FROM AROUND THE STRUCTURE. B) REMOVE THE EXISTING FRAME AND LID FROM THE STRUCTURE.
- C) COVER THE STRUCTURE OPENING WITH A 36 (900) DIAMETER METAL PLATE. D) BACKFILL WITH CRUSHED STONE AND A MINIMUM 1^{\prime}_{2} (40)
- THICK HMA SURFACE MIX APPROVED BY THE ENGINEER.

STAGE 2 (AFTER PAVEMENT MILLING)

- A) REMOVE THE HMA SURFACE MIX AND CRUSHED STONE.
- B) INSTALL THE FRAME AND LID; ADJUST THE FRAME TO ITS FINAL SURFACE ELEVATION.
- C) THE SURROUNDING SPACE SHALL BE FILLED WITH CLASS PP-1* CONCRETE TO THE ELEVATION OF THE SURFACE OF THE EXISTING BASE COURSE OR THE BINDER COURSE.
- * UNLESS OTHERWISE SPECIFIED IN THE PLANS.

THE PROCEDURE EXPLAINED ABOVE SHALL CONFORM TO THE APPLICABLE PORTIONS OF SECTIONS 353, 406, 602, AND 603 OF THE STANDARD SPECIFICATIONS EXCEPT THAT "THE CONTRACTOR SHALL ADJUST THE STRUCTURES TO THE FINISHED PAVEMENT ELEVATION NO MORE THAN 5 CALENDAR DAYS PRIOR TO PLACEMENT OF THE FINAL LIFT OF SURFACE UNLESS APPROVED BY THE ENGINEER."

LEGEND

1	SUB-BASE GRANULAR MATERIAL	6 FRAME AND LID (SEE NOTES)
2	EXISTING PAVEMENT	(7) CLASS PP-1* CONCRETE
3	36 (900) DIAMETER METAL PLATE	(8) PROPOSED HMA SURFACE COURSE
4	PROPOSED CRUSHED STONE AND HMA SURFACE MIX	-
(5)	EXISTING STRUCTURE	9 PROPOSED HMA BINDER COURSE

(5) EXISTING STRUCTURE

LOCATION OF STRUCTURES:


THE CONTRACTOR WILL BE REQUIRED TO KEEP A RECORD OF THE LOCATIONS OF THE BURIED STRUCTURES ACCORDING TO THE STATION AND DISTANCE LEFT OR RIGHT OF THE CENTERLINE OF PAVEMENT. UPON COMPLETION OF THE WORK, THE CONTRACTOR WILL DELIVER THE RECORD TO THE ENGINEER.

BASIS OF PAYMENT:

REMOVING FRAMES AND LIDS ON DRAINAGE AND UTILITY STRUCTURES IN THE PAVEMENT PRIOR TO MILLING, AND ADJUSTING TO FINAL GRADE PRIOR TO PLACING THE SURFACE COURSE, WILL BE PAID FOR AT THE CONTRACT UNIT PRICE EACH FOR "FRAMES AND LIDS TO BE ADJUSTED (SPECIAL)."

THIS WORK WILL NOT BE PAID FOR WHEN DRAINAGE AND UTILITY STRUCTURES ARE SPECIFIED FOR PAYMENT AS STRUCTURE RECONSTRUCTION.

NEW FRAMES AND LIDS, WHEN SPECIFIED, WILL BE PAID FOR SEPARATELY.

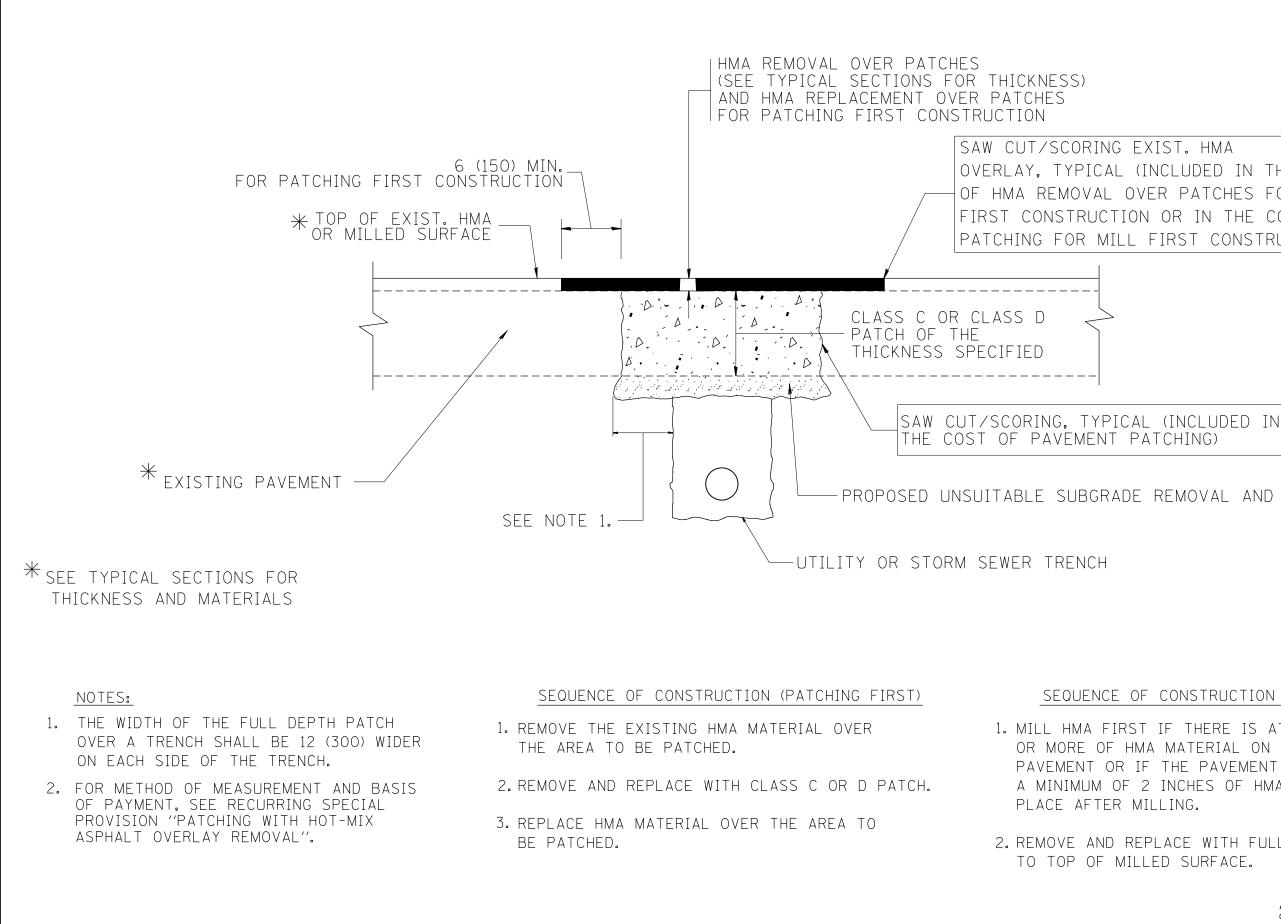

FILE NAME =	USER NAME = hassann	DESIGNED - R. SHAH	REVISED - A. ABBAS 04-27-98			PAVEMENT PATCHING FOR		F.A.U. RTF.	SECTION	COUNTY TOTAL SHEET
pw:\\ILØ84EBIDINTEG.1111no15.gov:PWIDOT\D	ocuments\IDOT_Offices\District_1\Projects\D13	618RA40Nata\Design\Diststd.dgn	REVISED - R. BORO 01-01-07	STATE OF ILLINOIS		HMA SURFACED PAVEMENT		3887	A-R-RS-3	KANE 34 25
	PLOT SCALE = 100.0000 ' / 10.	CHECKED -	REVISED - R. BORO 09-04-07	DEPARTMENT OF TRANSPORTATION				BD40)04 (BD22)	CONTRACT NO. 62C69
	PLOT DATE = 2/10/2017	DATE - 10-25-94	REVISED - K. ENG 10-27-08		SCALE: NONE	SHEET NO. 1 OF 1 SHEETS STA.	TO STA.	FED. ROAD DIS	. NO. 1 ILLINOIS FED.	AID PROJECT

OVERLAY, TYPICAL (INCLUDED IN THE COST OF HMA REMOVAL OVER PATCHES FOR PATCHING FIRST CONSTRUCTION OR IN THE COST OF PAVEMENT PATCHING FOR MILL FIRST CONSTRUCTION).


PROPOSED UNSUITABLE SUBGRADE REMOVAL AND REPLACEMENT

SEQUENCE OF CONSTRUCTION (MILLING FIRST)

1. MILL HMA FIRST IF THERE IS AT LEAST $4\frac{1}{2}$ INCHES OR MORE OF HMA MATERIAL ON TOP OF THE EXISTING PAVEMENT OR IF THE PAVEMENT IS FULL DEPTH HMA. A MINIMUM OF 2 INCHES OF HMA MATERIAL SHALL BE IN

2. REMOVE AND REPLACE WITH FULL DEPTH CLASS D PATCHES TO TOP OF MILLED SURFACE.

> ALL DIMENSIONS ARE IN INCHES (MILLIMETERS) UNLESS OTHERWISE SHOWN.

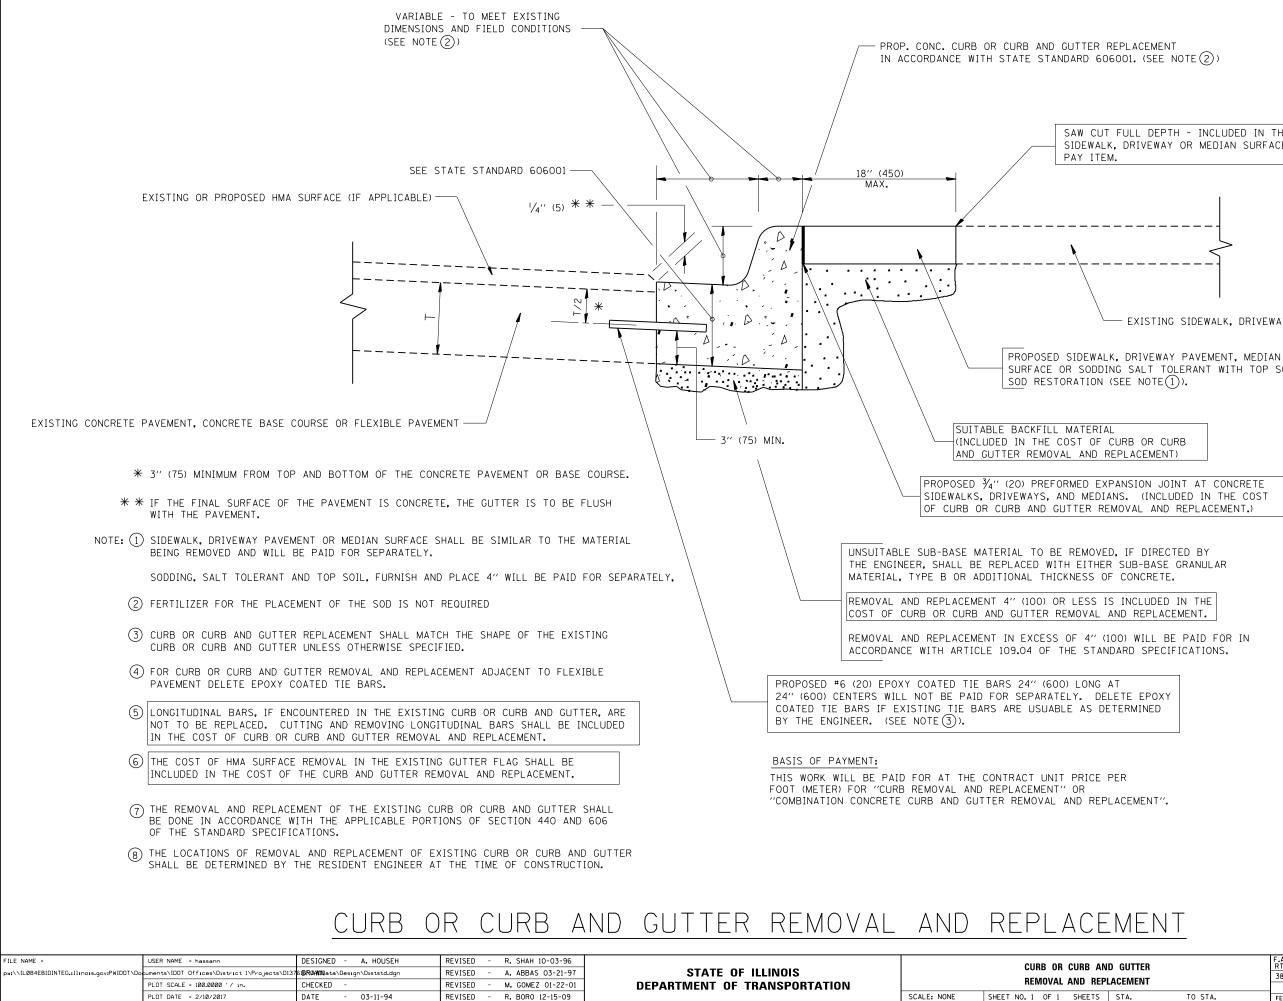


SAW CUT FULL DEPTH - INCLUDED IN THE COST OF SIDEWALK, DRIVEWAY OR MEDIAN SURFACE REMOVAL

EXISTING SIDEWALK, DRIVEWAY, MEDIAN SURFACE, SOD OR GROUND.

SURFACE OR SODDING SALT TOLERANT WITH TOP SOIL, 4" (100)


ALL DIMENSIONS ARE IN INCHES (MILLIMETERS) UNLESS OTHERWISE SHOWN.


AND GUTTER EPLACEMENT		F.A.U. RTE.	RTE. SECTION		TOTAL SHEETS	SHEET NO.	
		3887	A-R-RS-3	KANE	34	26	
	ACLIVILINI			BD600-06 (BD-24)	CONTRACT	NO. 6	52C69
STA. TO STA.		FED. R	DAD DIST. NO. 1 ILLINOIS FED. AI	D PROJECT			

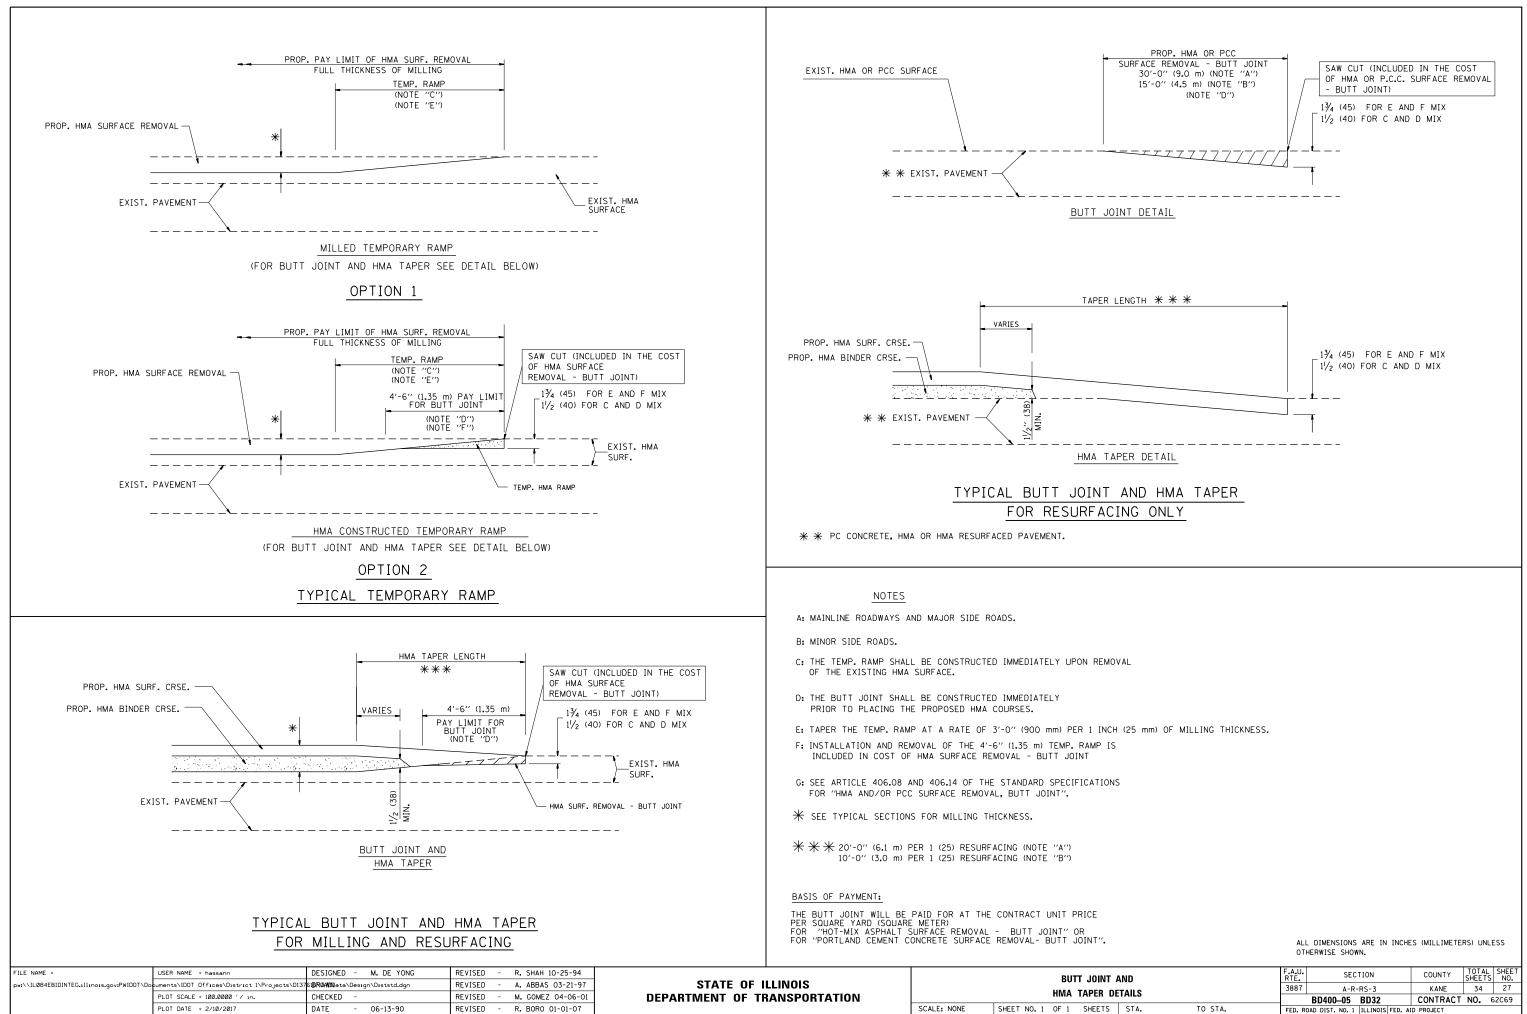

AND DETAILS		A.U. SECTION			COUNTY	TOTAL SHEETS	SHEET NO.
		A-R-	RS-3		KANE	34	27
		BD400-05	BD32		CONTRACT	NO. 6	2069
STA. TO STA.		OAD DIST. NO. 1	ILLINOIS FED.	AID	PROJECT		


	TYPE II BARRICAGES WITH ONE BUILDING AMERIC 21.930
	NOTES:
	 SIDE ROAD WITH A SPEED LIMIT OF 40 MPH (60 km/h) OR LESS AS SHOWN ON THE DRAWING AND AS DIRECTED BY THE ENGINEER: ONE "ROAD CONSTRUCTION AHEAD" SICK 36 × 36 (900×900) WITH A FLASHER MOUNTED ON IT APPROXIMATELY 200' (60 m) IN ADVANCE OF THE MAIN ROUTE. THE CLOSED PORTION OF THE MAIN ROUTE SHALL BE PROTECTED BY BLOCKING WITH TYPE I, TYPE II OR TYPE III BARRICADES, 1/3 OF THE CROSS SECTION OF THE CLOSED PORTION. SIDE ROAD WITH A SPEED LIMIT GREATER THAN 40 MPH (60 km/h) AS SHOWN ON THE DRAWING AND AS DIRECTED BY THE ENGINEER: ONE "ROAD CONSTRUCTION AHEAD" SICN 48 × 48 (1.2 m × 1.2 m) WITH A FLASHER MOUNTED ON IT APPROXIMATELY 500' (150 m) IN ADVANCE OF THE MAIN ROUTE. DI THE CLOSED PORTION OF THE MAIN ROUTE SHALL BE PROTECTED BY BLOCKING WITH TYPE III BARRICADES, 1/2 OF THE CROSS SECTION OF THE CLOSED PORTION OF THE MAIN ROUTE SHALL BE PROTECTED BY BLOCKING WITH TYPE III BARRICADES OR DRUMS AT HALF THE SPACING DURING DAY OPERATIONS. CONES SHALL BE A MINIMUM OF 28 (710) IN HEIGHT. WHEN THE SIDE ROAD LIES BETWEEN THE BEGINNING OF THE MAINLINE SIDEN ADD THE WORK ZONE, A SINGLE HEADED ARROW (M6-1), SHALL BE USED IN LIEU OF THE DOUBLE HEADED ARROW (M6-4).
FILE NAME = USER NAME = hassann DESIGNED - L.H.A. REVISED - A. HOUSEH 10-15-96	All dimensions are in inches (millimeters) unless otherwise shown.
Pert/NL084EBIDINTEG.illinois.gov/PWIDDT/Documents/IDDT Offices/District 1/Projects/DI376BRAMData/Design/Diststd.dgn REVISED -T. RAMMACHER 01-06-00 PLOT SCALE = 100.0000 // in. CHECKED - REVISED - A. SCHUETZE 07-01-13 Default PLOT DATE = 2/10/2017 DATE - 06-89 REVISED - A. SCHUETZE 09-15-16	STATE OF ILLINOIS TRAFFIC CONTROL AND PROTECTION FOR NO. SECTION COUNTY SHEETS NO. DEPARTMENT OF TRANSPORTATION SCALE: NONE SHEET 1 OF 1 SHEETS STA. TO STA. ILLINOIS FED. AID PROJECT

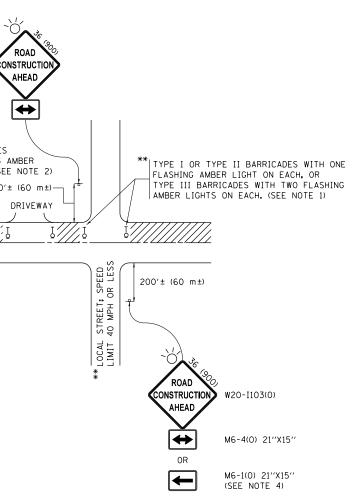


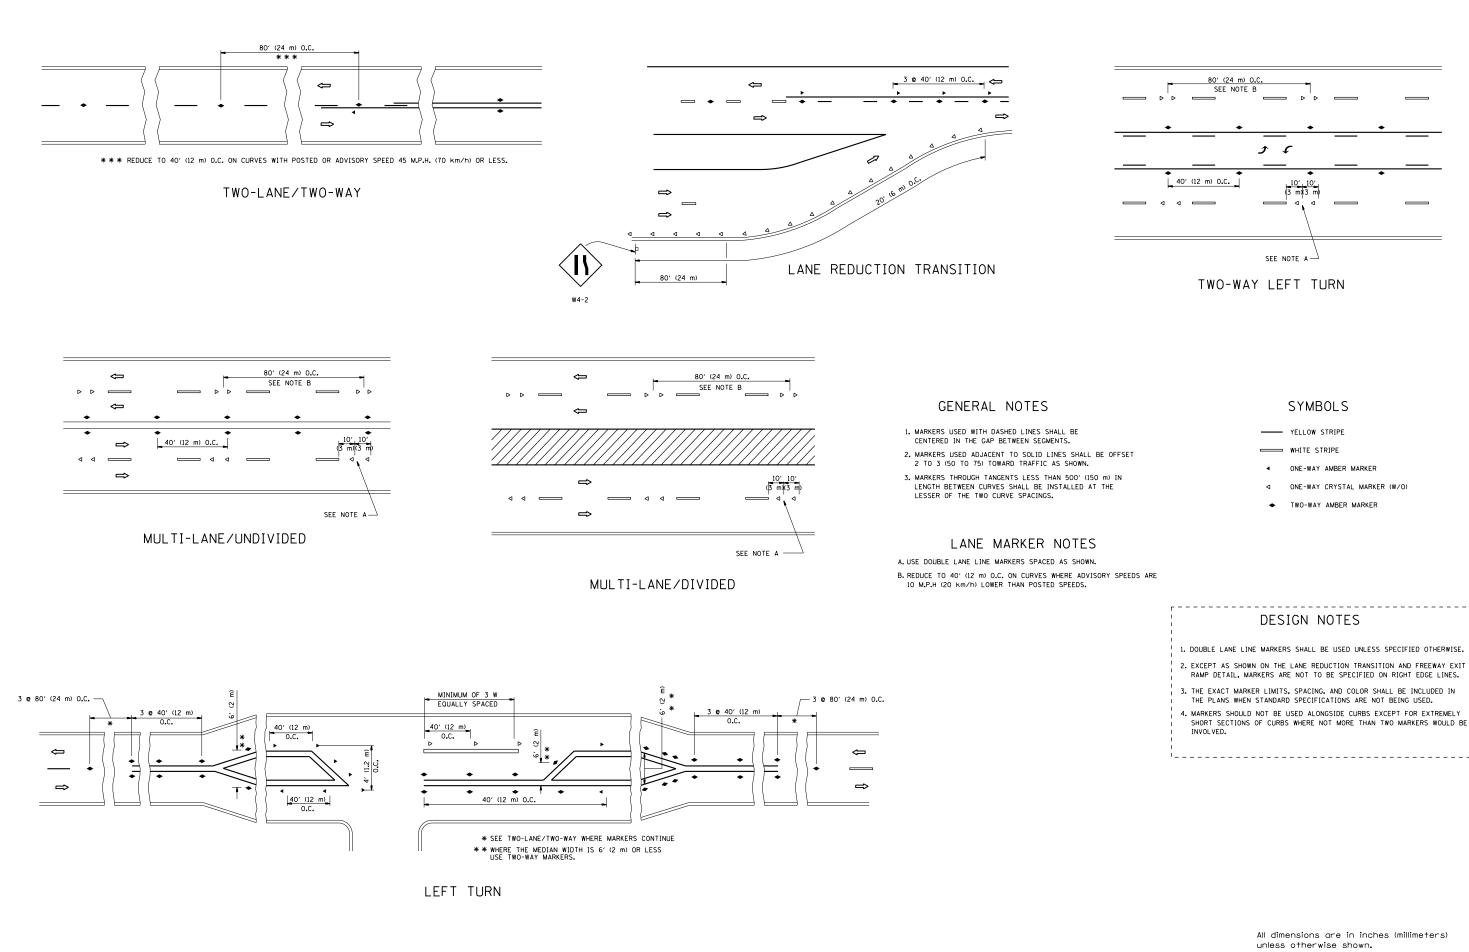

FILE NAME =	USER NAME = hassann	DESIGNED -	REVISED - T. RAMMACHER 09-19-94			TYPICAL APPLICATIONS	F.A.U. RTF	SECTION	COUNTY TOTAL SHEET
pw:\\IL084EBIDINTEG.1111no1s.gov:PWIDOT\Do	uments\IDOT_Offices\District_1\Projects\D137	61 BR(AWD) ata\Design\Diststd.dgn	REVISED -T. RAMMACHER 03-12-99	STATE OF ILLINOIS				A-R-RS-3	KANE 34 29
	PLOT SCALE = 100.0000 ' / in.	CHECKED -	REVISED -T. RAMMACHER 01-06-00	DEPARTMENT OF TRANSPORTATION	RAISED	RAISED REFLECTIVE PAVEMENT MARKERS (SNOW-PLOW RESISTANT)		TC-11	CONTRACT NO. 62069
	PLOT DATE = 2/10/2017	DATE -	REVISED - C. JUCIUS 09-09-09		SCALE: NONE	SHEET NO. 1 OF 1 SHEETS STA. TO STA.	FED. ROAD	DIST. NO. 1 ILLINOIS FED	. AID PROJECT

4. MARKERS SHOULD NOT BE USED ALONGSIDE CURBS EXCEPT FOR EXTREMELY SHORT SECTIONS OF CURBS WHERE NOT MORE THAN TWO MARKERS WOULD BE INVOLVED.

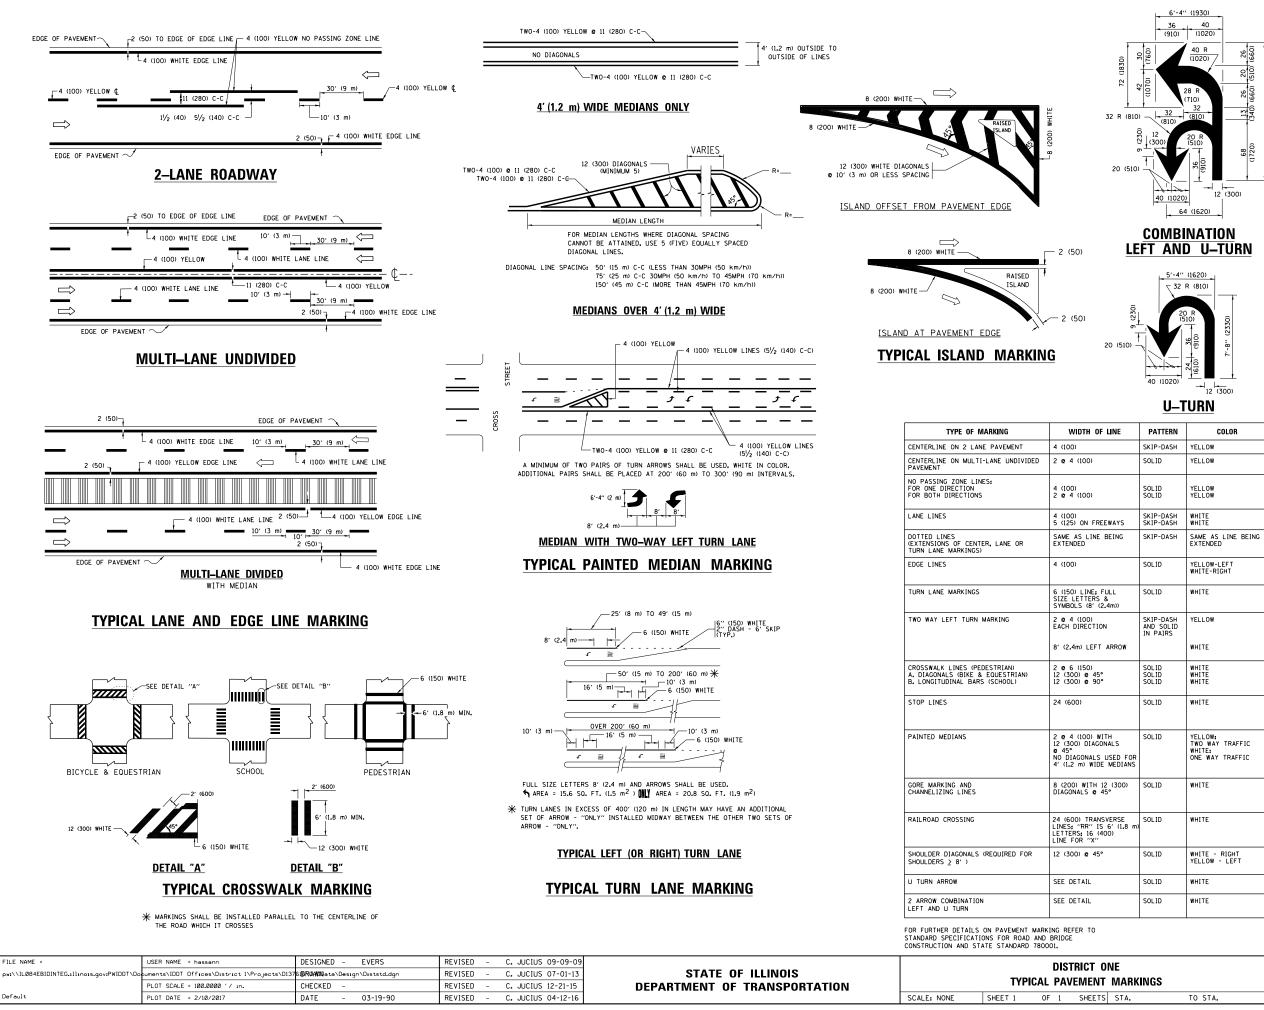

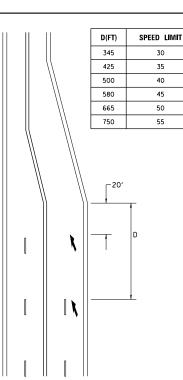

LANE REDUCTION TRANSITION

lane reduction arrows required at speeds of 45 MPH or greater or when specified in plans.

F LINE	PATTERN	COLOR	SPACING /REMARKS
	SKIP-DASH	YELLOW	10' (3 m) LINE WITH 30' (9 m) SPACE
	SOLID	YELLOW	11 (280) C-C
	SOLID SOLID	YELLOW YELLOW	5½ (140) C-C FROM SKIP-DASH CENTERLINE 11 (280) C-C OMIT SKIP-DASH CENTERLINE BETWEEN
EEWAYS	SKIP-DASH SKIP-DASH	WHITE WHITE	10' (3 m) LINE WITH 30' (9 m) SPACE
BEING	SKIP-DASH	SAME AS LINE BEING EXTENDED	2' (600) LINE WITH 6' (1.8 m) SPACE
	SOLID	YELLOW-LEFT WHITE-RIGHT	OUTLINE MEDIANS IN YELLOW
FULL & 2.4m))	SOLID	WHITE	SEE TYPICAL TURN LANE MARKING DETAIL
DN - ARROW	SKIP-DASH AND SOLID IN PAIRS	YELLOW	10' (3 m) LINE WITH 30' (9 m) SPACE FOR SKIP-DASH: 5/2 (140) C-C BETWEEN SOLID LINE AND SKIP-DASH LINE SEE TYPICAL TWO-WAY LEFT TURN MARKING DETAIL
0 0	SOLID SOLID SOLID	WHITE WHITE WHITE	NOT LESS THAN 6' (1.8 m) APART 2' (600) APART 2' (600) APART SEE TYPICAL CROSSWALK MARKING DETAILS.
	SOLID	WHITE	PLACE 4' (1.2 m) IN ADVANCE OF AND PARALLEL TO CROSSWALK, IF PRESENT. OTHERWISE, PLACE AT DESIRED STOPPING POINT. PARALLEL TO CROSSROAD CENTERLINE, WHERE POSSIBLE
USED FOR E MEDIANS	SOLID	YELLOW: TWO WAY TRAFFIC WHITE: ONE WAY TRAFFIC	11 (280) C-C FOR THE DOUBLE LINE SEE TYPICAL PAINTED MEDIAN MARKING.
12 (300) 45°	SOLID	WHITE	DIAGONALS: 15' (4,5 m) C-C (LESS THAN 30MPH (50 km/h)) 20' (6 m) C-C 30MPH (50 km/h) TO 45MPH (70 km/h)) 30' (9 m) C-C (OVER 45MPH (70 km/h))
ISVERSE S 6′(1.8 m) 400)	SOLID	WHITE	SEE STATE STANDARD 780001 AREA OF: "R"=3.6 SO. FT. (0.33 m ²) EACH "X"=54.0 SO. FT. (5.0 m ²)
•	SOLID	WHITE - RIGHT YELLOW - LEFT	50' (15 m) C-C (LESS THAN 30MPH (50 km/h)) 75' (25 m) C-C (30 MPH (50 km/h) TO 45MPH (70 km/h)) 150' (45 m) C-C (0VER 45MPH (70 km/h))
	SOLID	WHITE	16.3 SF
	SOLID	WHITE	30.4 SF

All dimensions are in inches (millimeters) unless otherwise shown.

ONE IT MARKINGS		F.A.U. RTE.	RTE. SECTION		COUNTY	TOTAL SHEETS	SHEET NO.	
		3887	3887 A-R-RS-3			34	30	
	MAININGS			TC-13		CONTRACT	NO. 6	2069
TS STA. TO STA.			ILLINOIS	FED. AI	D PROJECT			



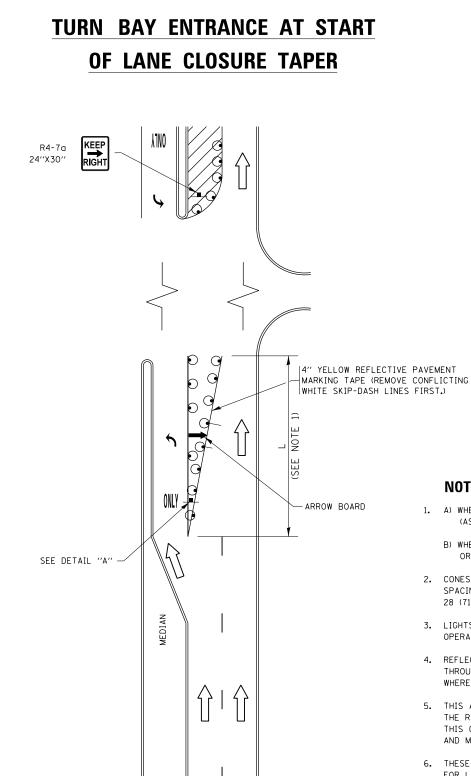


FIGURE 1

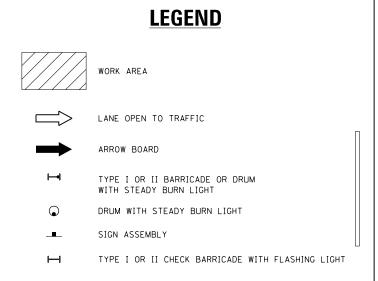


NOTES:

- 1. A) WHEN "L" IS < THE STORAGE LENGTH OF THE TURN LANE (AS SHOWN IN FIG. 1), USE FIGURE 1.
 - B) WHEN "L" IS > THE STORAGE LENGTH OF THE TURN LANE OR THE TURN LANE IS WITHIN THE LANE CLOSURE, USE FIGURE 2.
- 2. CONES MAY BE SUBSTITUTED FOR BARRICADES OR DRUMS AT HALF THE SPACING DURING DAY OPERATIONS. CONES SHALL BE A MINIMUM OF 28 (710) IN HEIGHT.
- 3. LIGHTS WILL NOT BE REQUIRED ON BARRICADES OR DRUMS FOR DAY OPERATIONS. ALL LIGHTS SHALL BE MONODIRECTIONAL.
- 4. REFLECTIVE TEMPORARY PAVEMENT MARKINGS SHALL BE PLACED THROUGHOUT THE BARRICADED AREAS OF EACH TURN BAY AS SHOWN WHERE THE CLOSURE TIME IS GREATER THAN FOURTEEN (14) DAYS.
- 5. THIS APPLICATION ALSO APPLIES WHEN WORK IS BEING PERFORMED IN THE RIGHT LANE(S) AND THE RIGHT TURN BAY IS TO REMAIN OPEN. UNDER THIS CONDITION, "RIGHT TURN LANE" R3-1100R 24 x 24 (600 x 600) AND M6-2R 21 × 15 (530 × 380) SHALL BE USED.
- 6. THESE CONTROLS SHALL SUPPLEMENT MAINLINE TRAFFIC CONTROL FOR LANE CLOSURES.
- 7. THE SIGNS SHALL BE MOUNTED ABOVE THE BARRICADES/DRUMS ON SEPARATE SIGN SUPPORTS THAT MEET NCHRP 350 OR MASH PREQUIREMENTS.
- 8. TRAFFIC CONTROL AND PROTECTION AT TURN BAYS (TO REMAIN OPEN TO TRAFFIC) SHALL BE INCLUDED IN THE COST OF SPECIFIED TRAFFIC CONTROL STANDARDS OR ITEMS.

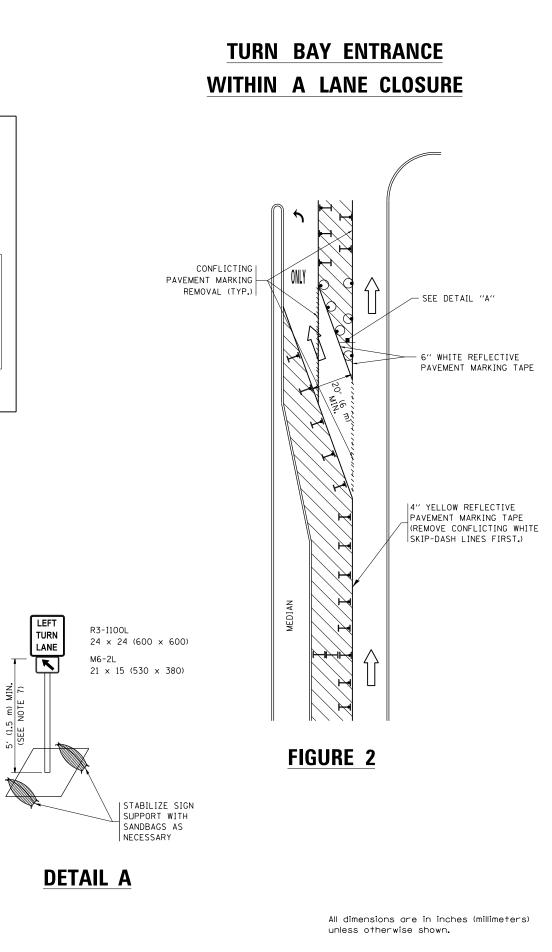


FILE NAME =		REVISED - T. RAMMACHER 09-08-94			TRAFFIC CONTROL AND PROTECTION AT TURN BAYS	F.A.U. RTE.	SECTION	COUNTY TOTAL SHEET SHEETS NO.
pw:\\IL084EBIDINTEG.1llinois.gov:PWIDOT\Do	cuments\IDOT_Offices\District_1\Projects\D137	648E0419E9.a\Design\0,sH0H545H 11-07-95			(TO REMAIN OPEN TO TRAFFIC)		A-R-RS-3	KANE 34 31
	PLOT SCALE = 100.0000 ' / in.	REVISED - A. HOUSEH 10-12-96	REVISED - A. SCHUETZE 09-15-16	DEPARTMENT OF TRANSPORTATION			TC-14	CONTRACT NO. 62C69
Default	PLOT DATE = 2/10/2017	REVISED - T. RAMMACHER 01-06-00	REVISED -		SCALE: NONE SHEET 1 OF 1 SHEETS STA. TO STA.		ILLINOIS FED. A	ND PROJECT

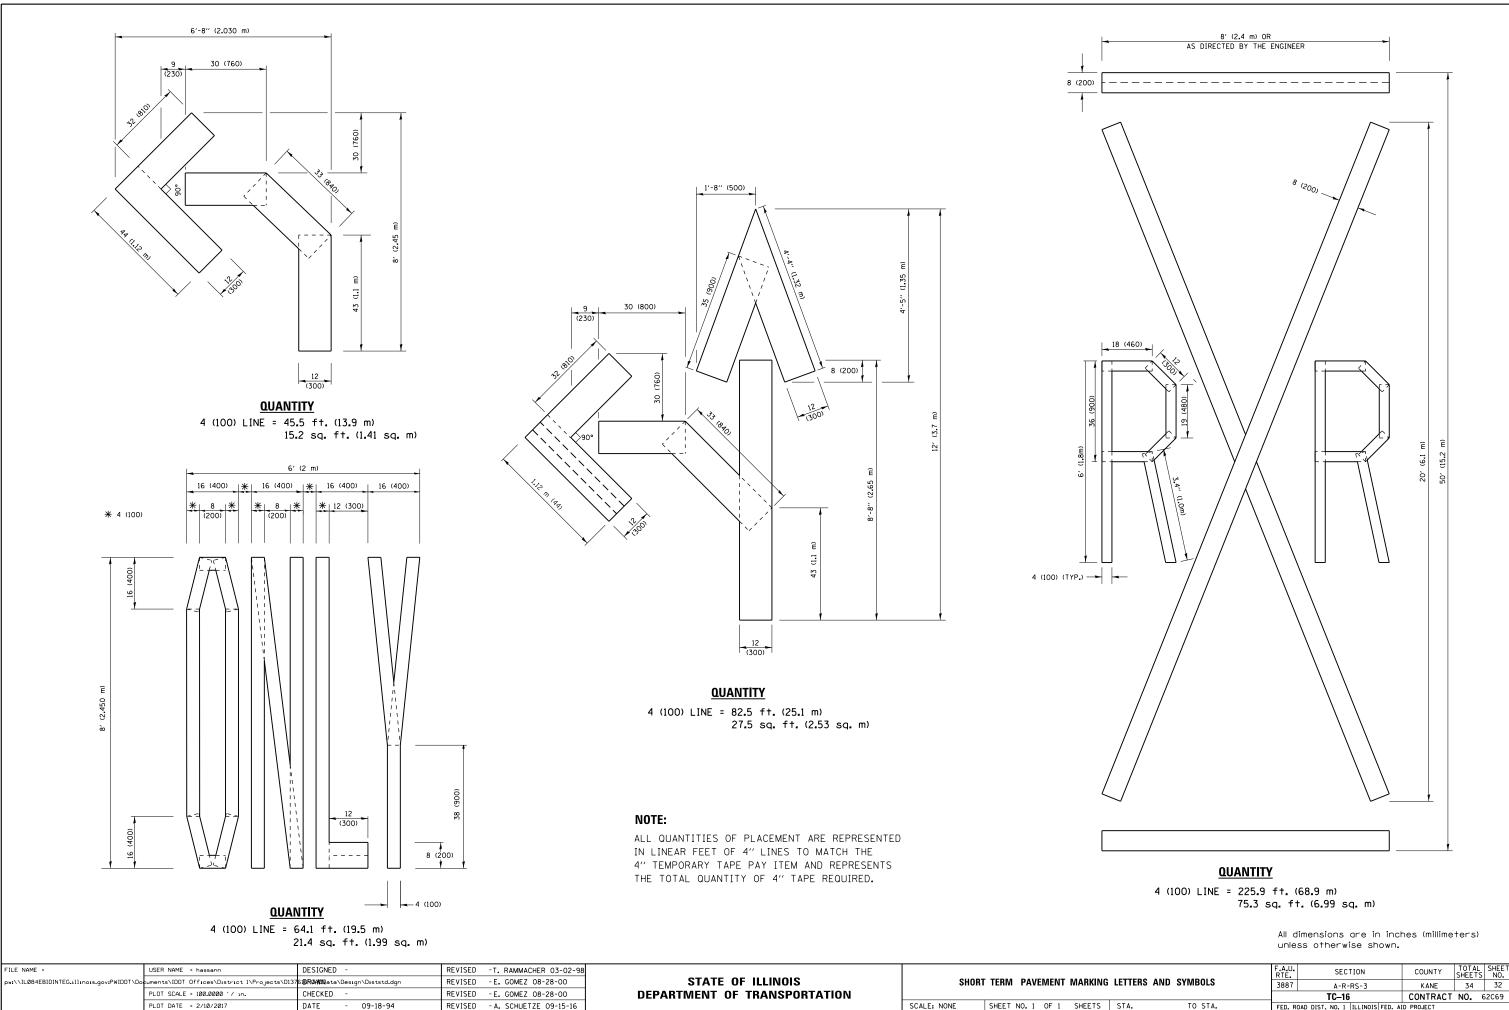

SCALE: NONE SHEET NO. 1 OF 1 SHEETS

				SECTION	COUNTY	TOTAL SHEETS	SHEET NO.
G	LETTERS	LETTERS AND SYMBOLS	3887	A-R-RS-3	KANE	34	32
		_	TC16	CONTRACT	NO. 6	2069	
	STA.	TO STA.	FED. R	DAD DIST. NO. 1 ILLINOIS FED. AI	D PROJECT		

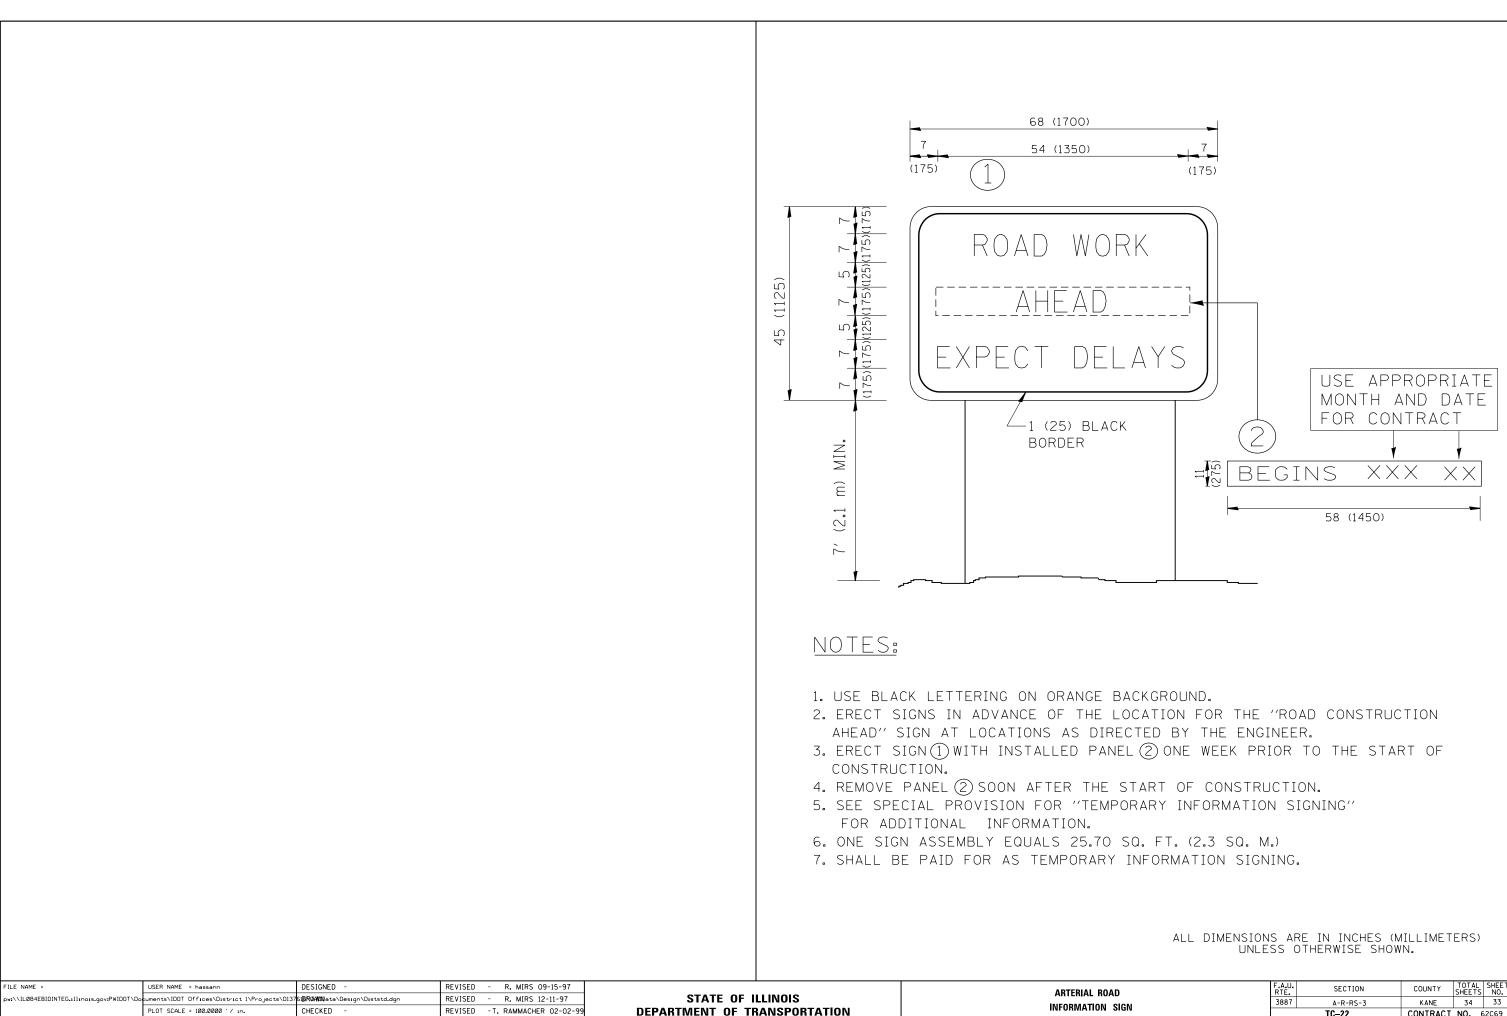


REVISED - C. JUCIUS 01-31-07

PLOT DATE = 2/10/2017

DATE

ROAD N SIGN STA. TO STA.			F.A.U. RTE	SECTION	COUNTY	TOTAL SHEETS	SHEET NO.
			3887	A-R-RS-3	KANE	34	33
			TC-22 CONTRACT NO. 62C6				
			FED. RO	DAD DIST. NO. 1 ILLINOIS FED. AI	D PROJECT		

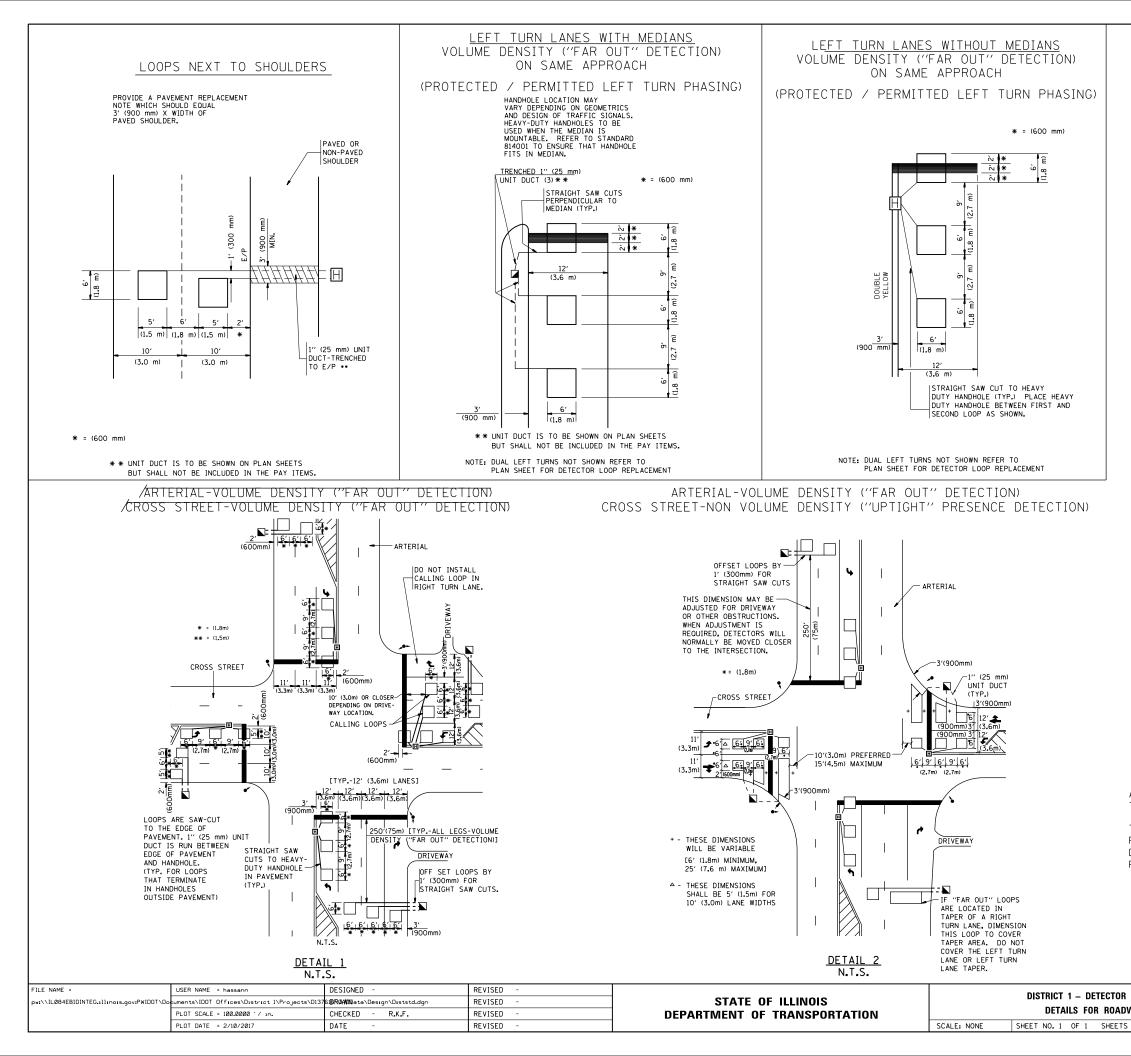

NOTES:

VEHICLES LOOP DETECTORS

- * ALL LEAD IN CABLE SHALL BE TWO CONDUCTOR NO. 14 TWISTED, SHIELDED.
- * EACH DETECTOR LOOP SHALL HAVE ITS OWN SAW CUT FROM THE LOOP TO THE EDGE OF PAVEMENT OR TO A HANDHOLE IN THE PAVEMENT.
- * EACH DETECTOR LOOP SHALL HAVE ITS OWN ONE INCH (25 mm) UNIT DUCT BETWEEN THE EDGE OF PAVEMENT AND THE FIRST HANDHOLE OR JUNCTION BOX. EACH UNIT DUCT RUN SHALL BE SHOWN ON THE PLANS BY THE DESIGNER, BUT SHALL NOT BE PAID FOR SEPARATLY. THIS ITEM IS INCIDENTAL TO THE PAY ITEM FOR DETECTOR LOOPS.
- * ONE DIMENSION OF <u>ALL</u> DETECTOR LOOPS SHALL BE SIX FEET (1.8 m)
- * EACH LANE OF NON-LOCKING, PRESENCE DETECTION AND EACH LANE OF A DOUBLE LEFT TURN LANE REQUIRES A SEPARATE INDUCTIVE LOOP DETECTOR AND LEAD IN CABLE.
- * WHEN NON-LOCKING, PRESENCE DETECTION IS USED, <u>MORE</u> THAN ONE LOOP PER LANE IS REQUIRED BEHIND THE STOP BAR (i.e. 1-1/2, 1-3/4, 2).
- * WHEN SYSTEM LOOPS ARE REQUIRED ON AN APPROACH OF AN INTERSECTION, THE LOOPS USED FOR VOLUME DENSITY AND INTERSECTION TIMING SHALL ALSO BE USED AS SYSTEM DETECTORS. <u>EACH</u> ONE OF THESE TYPE OF LOOPS REQUIRES A <u>SEPARATE</u> TWO CONDUCTOR NO. 14 TWISTED SHIELDED CABLE AND A <u>SEPARATE</u> INDUCTIVE LOOP DETECTOR WHEN NEW CONTROLLERS ARE UTILIZED. THE DESIGNER SHALL LABEL THESE TYPES OF LOOPS AS "INTERSECTION AND SAMPLING (SYSTEM) DETECTORS" ON THE SIGNAL LAYOUT, THE INTERCONNECT PLAN AND THE SYSTEM CABLE PLAN. WHEN AN EXISTING CONTROLLER IS UTILIZED FOR THIS TYPE OF DETECTION, THE PAY ITEM "INDUCTIVE LOOP DETECTOR WITH SYSTEM OUTPUT" SHOULD BE USED.

PLACEMENT OF DETECTORS

THE FOLLOWING FIGURES REPRESENT THE MOST COMMON DETECTOR LOOP LOCATIONS AND SIZES. ADJUSTMENTS WILL BE NECESSARY FOR SPECIFIC GEOMETRIC CONSIDERATIONS.

LOCATIONS AND DEMENSIONS OF DETECTOR LOOPS ARE REQUIRED ON \underline{ALL} SIGNAL LAYOUT PLAN SHEETS.

"FAR OUT" DETECTION REFERS TO LOCKING, PRESENCE TYPE DETECTION LOCATED IN THRU LANES, RIGHT TURN LANES, AND RIGHT TURN LANE TAPER AREAS (IF APPLICABLE), USUALLY 250' (75 m) IN ADVANCE OF STOP BARS. "UPTIGHT" DETECTION REFERS TO NON-LOCKING PRESENCE TYPE DETECTION LOCATED IN ALL LANES AND 10'-15' (3.0 m-4.5 m) BEHIND THE CROSSING STREET'S EDGE OF PAVEMENT EXTENDED.

NOTE:

ALL DETAILS AND NOTES SHOWN ARE FROM THE I.D.O.T. DISTRICT 1 TRAFFIC SIGNAL DESIGN GUIDELINES DATED JANUARY 1995

THIS DRAWING HAS BEEN PREPARED TO ASSIST THE RESIDENT ENGINEER FOR ALL ROADWAY RESURFACING OR S.M.A.R.T. PROJECTS WHERE THE DIMENSIONS ARE NOT SHOWN ON THE PLANS AND THE FINAL LOCATIONS FOR CROSSWALKS OR STOP BARS ARE NOT DETERMINED.

L	OOP INSTA	LLATION	F.A.U. RTE.			COUNTY	TOTAL SHEETS	SHEET NO.
WAY RESURFACING		3887	87 A-R-RS-3		KANE	34	34	
WAT RESURFACING				TS07		CONTRACT	NO. 6	2069
STA. TO STA.		FED. RO	DAD DIST. NO. 1 ILL	INOIS FED. AI	D PROJECT			