

STATE OF ILLINOIS  
DEPARTMENT OF TRANSPORTATION

|             |                 |          |                    |           |
|-------------|-----------------|----------|--------------------|-----------|
| F.A.P. RTE. | SECTION         | COUNTY   | TOTAL SHEETS       | SHEET NO. |
| 339         | 116Y(1&2)R-RS-6 | COOK     | 58                 | 1         |
|             |                 | ILLINOIS | CONTRACT NO. 62C93 |           |

D-91-411-16



# PROPOSED HIGHWAY PLANS


FAP 339 /IL 62 (ALGONQUIN ROAD)  
E /O ROSELLE ROAD TO IL 58 (GOLF ROAD)  
SECTION 116Y(1&2)R-RS-6  
RESURFACING(3P), PEDESTRIAN RAMPS  
PROJECT: NHPP-0339(035)  
COOK COUNTY  
C-91-411-16

FOR INDEX OF SHEETS, SEE SHEET NO. 2


PROJECT IS LOCATED IN:  
THE VILLAGE OF ARLINGTON HEIGHTS  
THE VILLAGE OF PALATINE  
THE CITY OF ROLLING MEADOWS  
THE VILLAGE OF SCHAUMBURG

TRAFFIC DATA

| ROUTE SEGMENT                        | SPEED     | ADT(YEAR)    |
|--------------------------------------|-----------|--------------|
| IL 62 (ALGONQUIN RD)                 |           |              |
| ROSELLE ROAD TO OQUENTIN ROAD        | 45 MPH    | 22,500(2015) |
| OQUENTIN ROAD TO MEACHAM ROAD        | 40 MPH    | 37,800(2015) |
| MEACHAM ROAD TO IL 53                | 35.40 MPH | 35,800(2015) |
| IL 53 TO NEW WILKE ROAD              | 35 MPH    | 29,700(2015) |
| NEW WILKE ROAD TO IL 58 (GOLF ROAD)  | 35 MPH    | 30,700(2015) |
| IL 58 (GOLF RD) S. OF PROJECT LIMITS | 45 MPH    | 29,900(2015) |
| IL 58 (GOLF ROAD)                    |           |              |
| WEST OF IL 62 (ALGONQUIN RD)         | 40 MPH    | 30,900(2015) |
| EAST OF IL 62 (ALGONQUIN RD)         | 40 MPH    | 29,800(2015) |

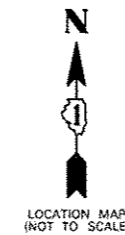

PROJECT BEGINS:  
STATION 50 + 78

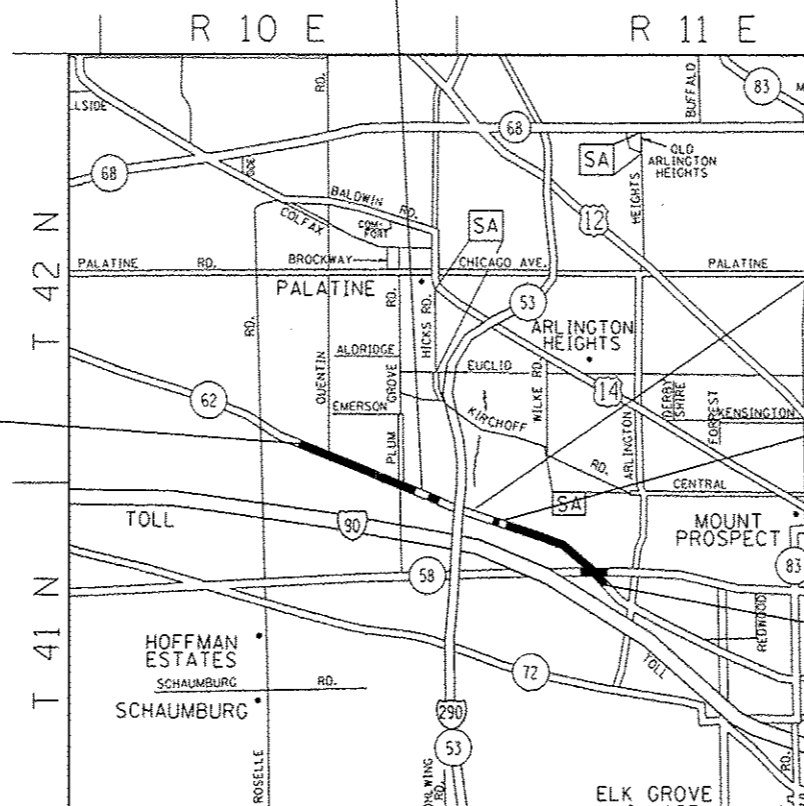


OMISSION  
STATION 115 + 65 TO  
STATION 128 + 65

OMISSION  
STATION 146 + 14.5 TO  
STATION 195 + 71.4

OMISSION  
STATION 201 + 19.5 TO  
STATION 205 + 65.3

PROJECT ENDS:  
STATION 276 + 84.5

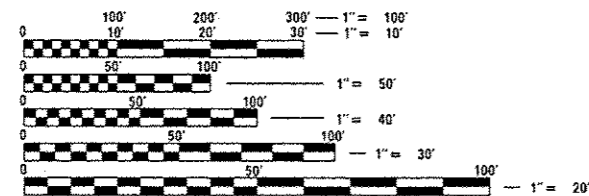

FULL SIZE PLANS HAVE BEEN PREPARED USING STANDARD ENGINEERING SCALES. REDUCED SIZED PLANS WILL NOT CONFORM TO STANDARD SCALES. IN MAKING MEASUREMENTS ON REDUCED PLANS, THE ABOVE SCALES MAY BE USED.

J.U.L.I.E.  
JOINT UTILITY LOCATION INFORMATION FOR EXCAVATION  
1-800-892-0123  
OR 811

PROJECT ENGINEER: DAN WILGREEN (847) 705-4240  
PROJECT MANAGER: FAWAD AQUEEL (847) 705-4247

CONTRACT NO. 62C93

GROSS LENGTH = 22,606.5 FT. = 4.29 MILES  
NET LENGTH = 15,993.8 FT. = 3.02 MILES

STATE OF ILLINOIS  
DEPARTMENT OF TRANSPORTATION

SUBMITTED February 6, 2017  
Regional Engineer

March 24, 2017  
Maureen M. Addis, P.E.  
ENGINEER OF DESIGN AND ENVIRONMENT

March 24, 2017  
Director of Program Development

PRINTED BY THE AUTHORITY  
OF THE STATE OF ILLINOIS

**INDEX OF SHEETS**

**STATE STANDARDS**

**GENERAL NOTES**

| SHEET NO. | DESCRIPTION   |
|-----------|---|
| 1         | COVER SHEET   |
| 2         | INDEX OF SHEETS, STATE STANDARDS, AND GENERAL NOTES                                     |
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| 6-7       | EXISTING AND PROPOSED TYPICAL SECTIONS  |
| 8-14      | ROADWAY AND PAVEMENT MARKING PLAN   |
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| 16-36     | SIDEWALK DETAIL PLAN  |
| 37-46     | DETECTOR LOOP REPLACEMENT PLAN  |
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| 54        | TRAFFIC CONTROL AND PROTECTION AT TURN BAYS (TO REMAIN OPEN TO TRAFFIC) (TC-14)         |
| 55        | PAVEMENT MARKING LETTERS AND SYMBOLS FOR TRAFFIC STAGING (TC-16)                        |
| 56        | ARTERIAL ROAD INFORMATION SIGN (TC-22)  |
| 57        | STANDARD TRAFFIC SIGNAL DESIGN DETAILS (TS-05, SHEET 2 OF 7)                            |
| 58        | DETECTOR LOOP INSTALLATION DETAILS FOR ROADWAY RESURFACING (TS-07)                      |

| STANDARD NO. | DESCRIPTION  |
|--------------|--|
| 000001-06    | TYPICAL SYMBOLS, ABBREVIATIONS AND PATTERNS                                  |
| 424001-09    | PERPENDICULAR CURP RAMPS FOR SIDEWALKS                                       |
| 424006-02    | DIAGONAL CURP RAMPS FOR SIDEWALKS  |
| 424011-02    | CORNER PARALLEL CURB RAMPS FOR SIDEWALKS                                     |
| 424021-03    | DEPRESSED CORNER FOR SIDEWALKS   |
| 424026-01    | ENTRANCE / ALLEY PEDESTRIAN CROSSINGS  |
| 442201-03    | CLASS C AND D PATCHES  |
| 604001-04    | FRAME AND LIDS, TYPE I   |
| 604091-03    | FRAME AND GRATE TYPE 24  |
| 606001-06    | CONCRETE CURB TYPE B AND COMBINATION CONCRETE CURB AND GUTTER                |
| 701101-05    | OFF-RD OPERATIONS, MULTILANE, 15' (4.5 m) TO 24" (600 mm) FROM PAVEMENT EDGE |
| 701426-09    | LANE CLOSURE, MULTILANE, INTERMITTENT OR MOVING OPER., FOR SPEEDS >= 45 MPH  |
| 701427-05    | LANE CLOSURE, MULTILANE, INTERMITTENT OR MOVING OPER., FOR SPEEDS <= 40 MPH  |
| 701601-09    | URBAN LANE CLOSURE, MULTILANE, 1W OR 2W WITH NONTRAVERSABLE MEDIAN           |
| 701602-08    | URBAN LANE CLOSURE, MULTILANE, 2W WITH BIDIRECTIONAL LEFT TURN LANE          |
| 701606-10    | URBAN SINGLE LANE CLOSURE, MULTILANE, 2W WITH MOUNTABLE MEDIAN               |
| 701701-10    | URBAN LANE CLOSURE, MULTILANE INTERSECTION                                   |
| 701801-06    | SIDEWALK, CORNER OR CROSSWALK CLOSURE  |
| 701901-06    | TRAFFIC CONTROL DEVICES  |
| 780001-05    | TYPICAL PAVEMENT MARKINGS  |
| 886001-01    | DETECTOR LOOP INSTALLATIONS  |

- BEFORE STARTING ANY EXCAVATION, THE CONTRACTOR SHALL CALL "JULIE" AT (800) 892-0123 OR 811 FOR FIELD LOCATIONS OF BURIED ELECTRIC, TELEPHONE, AND GAS FACILITIES. (48 HOUR NOTIFICATION REQUIRED)
- THE CONTRACTOR SHALL COORDINATE CONSTRUCTION ACTIVITIES WITH UTILITY COMPANIES AND THE VILLAGES OF ARLINGTON HEIGHTS, PALATINE, SCHAUMBURG, AND THE CITY OF ROLLING MEADOWS.
- THE CONTRACTOR WILL NOT BE ALLOWED TO SET UP A YARD OR FIELD OFFICE ON STATE PROPERTY WITHOUT THE WRITTEN PERMISSION OF THE DEPARTMENT.
- BEFORE BEGINNING ANY WORK, THE CONTRACTOR SHALL RETAIN AND RECORD FOR FUTURE REFERENCE, ALL EXISTING PAVEMENT MARKING LINES (AND RAISED REFLECTIVE PAVEMENT MARKERS) IN ORDER THAT THESE LOCATIONS CAN BE RE-ESTABLISHED FOR STRIPING. EXACT LOCATIONS OF ALL PAVEMENT MARKINGS SHALL BE AS DIRECTED BY THE ENGINEER.
- IT SHALL BE THE CONTRACTOR'S RESPONSIBILITY TO VERIFY ALL DIMENSIONS AND CONDITIONS EXISTING IN THE FIELD PRIOR TO CONSTRUCTION AND ORDERING OF MATERIALS.
- ALL DAMAGE TO EXISTING PAVEMENT MARKINGS OR RAISED REFLECTIVE PAVEMENT MARKERS OUTSIDE THE REMOVAL LINE SHOWN ON THE PLANS SHALL BE REPLACED AT THE CONTRACTOR'S EXPENSE.
- ALL PAVEMENT PATCHING, CURB AND GUTTER REMOVAL AND REPLACEMENT, DRAINAGE ADJUSTMENT LOCATIONS WILL BE DETERMINED IN THE FIELD BY THE ENGINEER.
- THE CONTRACTOR SHALL BE REQUIRED TO PROVIDE ACCESS TO ABUTTING PROPERTY AT ALL TIMES DURING THE CONSTRUCTION OF THIS PROJECT.
- DO NOT SCALE PLANS FOR CONSTRUCTION DIMENSIONS.
- TEN (10) FOOT TRANSITIONS SHALL BE USED TO MATCH PROPOSED CURB AND GUTTER AND MEDIAN ITEMS OF WORK TO EXISTING CURBS AND GUTTER AND MEDIANS IN THE FIELD, UNLESS OTHERWISE SHOWN. THE TRANSITIONS SHALL BE PAID FOR AT THE CONTRACT UNIT PRICE FOR THE PROPOSED ITEMS OF WORK SPECIFIED.
- WHEN MILLED PAVEMENT IS OPEN TO TRAFFIC, THE MAXIMUM GRADE DIFFERENTIAL BETWEEN PASSES OF THE MILLING MACHINE SHALL NOT EXCEED 1 1/2 INCHES WHERE THE SPEED LIMIT IS 45 MPH OR LESS, AND 1 INCH WHERE THE SPEED LIMIT IS OVER 45 MPH. WITH WRITTEN APPROVAL FROM THE RESIDENT ENGINEER, A MAXIMUM GRADE DIFFERENTIAL OF 3 INCHES MAY BE ALLOWED IF THE EDGE OF THE MILLING IS SLOPED A MINIMUM OF 1:3 (V:H).
- THE CONTRACTOR SHALL CONTACT THE DISTRICT ONE TRAFFIC CONTROL SUPERVISOR AT (847) 705-4470 A MINIMUM OF 72 HOURS IN ADVANCE OF BEGINNING WORK.
- THE RESIDENT ENGINEER SHALL CONTACT CORY JUCIUS, ARTERIAL TRAFFIC FIELD ENGINEER, AT CORY.JUCIUS@ILLINOIS.GOV A MINIMUM OF TWO (2) WEEKS PRIOR TO THE PLACEMENT OF PERMANENT PAVEMENT MARKINGS.
- DOUBLE LANE MARKERS ARE TO BE USED AS SHOWN ON THE DISTRICT ONE DETAIL "TYPICAL APPLICATIONS - RAISED REFLECTIVE PAVEMENT MARKERS (SNOW-PLOW RESISTANT)" SHOWN IN THE PLANS.
- PAVEMENT MARKING TAPE, TYPE III SHALL BE USED FOR SHORT TERM PAVEMENT MARKINGS ON ALL FINAL SURFACES.
- BUTT JOINTS WILL BE INSTALLED AT THE ENDS OF RESURFACING (WHERE RESURFACING MEETS EXISTING PAVEMENT) IN ACCORDANCE WITH THE "BUTT JOINT AND HMA TAPER DETAILS" SHEET INCLUDED IN THE PLANS, UNLESS OTHERWISE SPECIFIED.
- UNLESS OTHER CONDITIONS WARRANT EXTENDED LANE CLOSURE AS DETERMINED AND APPROVED IN WRITING BY THE ENGINEER OR AS PROVIDED FOR IN THE CONTRACT SPECIFICATIONS, OVERNIGHT CLOSURES SHALL NOT BE ALLOWED FOR REHABILITATION PROJECTS INVOLVING DAYTIME MILLING AND RESURFACING OPERATIONS AND CLASS D PATCHING.
- EXISTING BROKEN FRAMES AND LIDS SHALL BE REMOVED AND DISPOSED OF BY THE CONTRACTOR AND SHALL BE REPLACED AS DIRECTED BY THE ENGINEER. REPLACEMENT FRAMES AND LIDS WILL BE PAID FOR ACCORDING TO ARTICLE 109.04 OF THE STANDARD SPECIFICATIONS UNLESS A SEPARATE PAY ITEM HAS BEEN PROVIDED.
- ALL PROPOSED SIDEWALK RAMPS WITHIN THE LIMITS OF THE PROJECT SHALL CONFORM TO CURRENT ADA REQUIREMENTS AND APPLICABLE STATE HIGHWAY STANDARDS OR AS DETERMINED BY THE ENGINEER.
- CONTRACTOR SHALL MAINTAIN PEDESTRIAN ACCESS AT ALL TIMES DURING CONSTRUCTION.

|  |  |  |           |   |   |                           |                |        |                 |              |  |
|--|--|--|-----------|---|---|---------------------------|----------------|--------|-----------------|--------------|--|
| FILE NAME *                            | USER NAME = PencePL                          | DESIGNED -                               | REVISED - | <b>STATE OF ILLINOIS<br/>DEPARTMENT OF TRANSPORTATION</b> | <b>INDEX OF SHEETS, STATE STANDARDS, &amp; GENERAL NOTES<br/>IL 62 (ALGONQUIN ROAD) - E0 ROSELLE ROAD TO IL 58(GOLF ROAD)</b> | F.A.P.<br>RTE.            | SECTION        | COUNTY | TOTAL<br>SHEETS | SHEET<br>NO. |  |
| pa\11084E810INTEG.illinois.gov\1001\00 | ements\1001 Offices\District 1\Projects\0141 | CRABON to\Design\0141116-shr-gennote.dgn | REVISED - |   |   | 339                       | 116Y11&2R-RS-6 | COOK   | 98              | 2            |  |
|  | PLOT SCALE = 100.0000' / in.                 | CHECKED -                                | REVISED - |   |   | CONTRACT NO. 62C93        |                |        |                 |              |  |
| Default                                | PLOT DATE = 2/9/2017                         | DATE -                                   | REVISED - |   |   | ILLINOIS FED. AID PROJECT |                |        |                 |              |  |

URBAN

| SUMMARY OF QUANTITIES |  |       | TOTAL QUANTITIES | CONSTRUCTION TYPE CODE     |  |  |  |  |
|-----------------------|--|-------|------------------|----------------------------|--|--|--|--|
| CODE NO               | ITEM   | UNIT  |                  | 80% FEDERAL 20% STATE 0005 |  |  |  |  |
| 20200100              | EARTH EXCAVATION   | CU YD | 53               | 53                         |  |  |  |  |
| 21101615              | TOPSOIL FURNISH AND PLACE, 4"                              | SO YD | 601              | 601                        |  |  |  |  |
| 25000400              | NITROGEN FERTILIZER NUTRIENT                               | POUND | 11               | 11                         |  |  |  |  |
| 25000500              | PHOSPHORUS FERTILIZER NUTRIENT                             | POUND | 11               | 11                         |  |  |  |  |
| 25000600              | POTASSIUM FERTILIZER NUTRIENT                              | POUND | 11               | 11                         |  |  |  |  |
| 25200110              | SODDING, SALT TOLERANT                                     | SO YD | 601              | 601                        |  |  |  |  |
| 35501316              | HOT-MIX ASPHALT BASE COURSE, 8"                            | SO YD | 10               | 10                         |  |  |  |  |
| 40600290              | BITUMINOUS MATERIALS (TACK COAT)                           | POUND | 78764            | 78764                      |  |  |  |  |
| 40600400              | MIXTURE FOR CRACKS, JOINTS, AND FLANGEWAYS                 | TON   | 185              | 185                        |  |  |  |  |
| 40600827              | POLYMERIZED LEVELING BINDER (MACHINE METHOD), 1L-4.75, N50 | TON   | 4273             | 4273                       |  |  |  |  |
| 40600982              | HOT-MIX ASPHALT SURFACE REMOVAL - BUTT JOINT               | SO YD | 910              | 910                        |  |  |  |  |
| 40603335              | HOT-MIX ASPHALT SURFACE COURSE, MIX "D", N50               | TON   | 2                | 2                          |  |  |  |  |
| 42001300              | PROTECTIVE COAT  | SO YD | 1658             | 1658                       |  |  |  |  |
| 42300400              | PORTLAND CEMENT CONCRETE DRIVEWAY PAVEMENT, 8 INCH         | SO YD | 32               | 32                         |  |  |  |  |
| * SPECIALTY ITEMS     |  |       |                  |                            |  |  |  |  |

| SUMMARY OF QUANTITIES |  |       | TOTAL QUANTITIES | CONSTRUCTION TYPE CODE     |  |  |  |  |
|-----------------------|--|-------|------------------|----------------------------|--|--|--|--|
| CODE NO               | ITEM                                     | UNIT  |                  | 80% FEDERAL 20% STATE 0005 |  |  |  |  |
| 42400200              | PORTLAND CEMENT CONCRETE SIDEWALK 5 INCH | SO FT | 7234             | 7234                       |  |  |  |  |
| 42400800              | DETECTABLE WARNINGS                      | SO FT | 666              | 666                        |  |  |  |  |
| 44000100              | PAVEMENT REMOVAL                         | SO YD | 199              | 199                        |  |  |  |  |
| 44000159              | HOT-MIX ASPHALT SURFACE REMOVAL, 2 1/2"  | SO YD | 103599           | 103599                     |  |  |  |  |
| 44000200              | DRIVEWAY PAVEMENT REMOVAL                | SO YD | 42               | 42                         |  |  |  |  |
| 44000500              | COMBINATION CURB AND GUTTER REMOVAL      | FOOT  | 385              | 385                        |  |  |  |  |
| 44000600              | SIDEWALK REMOVAL                         | SO FT | 6680             | 6680                       |  |  |  |  |
| 44003100              | MEDIAN REMOVAL                           | SO FT | 800              | 800                        |  |  |  |  |
| 44003510              | MEDIAN REMOVAL PARTIAL DEPTH             | SO FT | 697              | 697                        |  |  |  |  |
| 44201765              | CLASS D PATCHES, TYPE II, 10 INCH        | SO YD | 1906             | 1906                       |  |  |  |  |
| 44201769              | CLASS D PATCHES, TYPE III, 10 INCH       | SO YD | 240              | 240                        |  |  |  |  |
| 44201771              | CLASS D PATCHES, TYPE IV, 10 INCH        | SO YD | 150              | 150                        |  |  |  |  |
| 60252800              | CATCH BASINS TO BE RECONSTRUCTED         | EACH  | 5                | 5                          |  |  |  |  |
| 60255500              | MANHOLES TO BE ADJUSTED                  | EACH  | 5                | 5                          |  |  |  |  |
| 60300305              | FRAMES AND LIDS TO BE ADJUSTED           | EACH  | 13               | 13                         |  |  |  |  |
| * SPECIALTY ITEMS     |  |       |                  |                            |  |  |  |  |

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| SUMMARY OF QUANTITIES |  |        |                  | CONSTRUCTION TYPE CODE     |  |  |  |  |
|-----------------------|--|--------|------------------|----------------------------|--|--|--|--|
| CODE NO               | ITEM   | UNIT   | TOTAL QUANTITIES | 80% FEDERAL 20% STATE 0005 |  |  |  |  |
| 60404950              | FRAMES AND GRATES, TYPE 24                         | EACH   | 4                | 4                          |  |  |  |  |
| 60406000              | FRAMES AND LIDS, TYPE 1, OPEN LID                  | EACH   | 2                | 2                          |  |  |  |  |
| 60406100              | FRAMES AND LIDS, TYPE 1, CLOSED LID                | EACH   | 2                | 2                          |  |  |  |  |
| 60619200              | CONCRETE MEDIAN, TYPE SB-6.06                      | SO FT  | 1112             | 1112                       |  |  |  |  |
| 60626300              | STABILIZED MEDIAN SURFACE                          | SO YD  | 4                | 4                          |  |  |  |  |
| * 66900200            | NON-SPECIAL WASTE DISPOSAL                         | CU YD  | 53               | 53                         |  |  |  |  |
| * 66900450            | SPECIAL WASTE PLANS AND REPORTS                    | LSUM   | 1                | 1                          |  |  |  |  |
| * 66900530            | SOIL DISPOSAL ANALYSIS                             | EACH   | 4                | 4                          |  |  |  |  |
| 67000400              | ENGINEER'S FIELD OFFICE, TYPE A                    | CAL MO | 6                | 6                          |  |  |  |  |
| 67100100              | MOBILIZATION                                       | LSUM   | 1                | 1                          |  |  |  |  |
| 70102625              | TRAFFIC CONTROL AND PROTECTION,<br>STANDARD 701606 | LSUM   | 1                | 1                          |  |  |  |  |
| 70102630              | TRAFFIC CONTROL AND PROTECTION,<br>STANDARD 701601 | LSUM   | 1                | 1                          |  |  |  |  |
| 70102632              | TRAFFIC CONTROL AND PROTECTION,<br>STANDARD 701602 | LSUM   | 1                | 1                          |  |  |  |  |
| * SPECIALTY ITEMS     |  |        |                  |                            |  |  |  |  |

| SUMMARY OF QUANTITIES |  |       |                  | CONSTRUCTION TYPE CODE     |  |  |  |  |
|-----------------------|--|-------|------------------|----------------------------|--|--|--|--|
| CODE NO               | ITEM   | UNIT  | TOTAL QUANTITIES | 80% FEDERAL 20% STATE 0005 |  |  |  |  |
| 70102635              | TRAFFIC CONTROL AND PROTECTION,<br>STANDARD 701701 | LSUM  | 1                | 1                          |  |  |  |  |
| 70102640              | TRAFFIC CONTROL AND PROTECTION,<br>STANDARD 701801 | LSUM  | 1                | 1                          |  |  |  |  |
| 70300100              | SHORT TERM PAVEMENT MARKING                        | FOOT  | 25801            | 25801                      |  |  |  |  |
| 70300150              | SHORT TERM PAVEMENT MARKING REMOVAL                | SO FT | 8592             | 8592                       |  |  |  |  |
| 70300210              | TEMPORARY PAVEMENT MARKING LETTERS AND<br>SYMBOLS  | SO FT | 2285             | 2285                       |  |  |  |  |
| 70300220              | TEMPORARY PAVEMENT MARKING - LINE 4"               | FOOT  | 52608            | 52608                      |  |  |  |  |
| 70300240              | TEMPORARY PAVEMENT MARKING - LINE 6"               | FOOT  | 12069            | 12069                      |  |  |  |  |
| 70300250              | TEMPORARY PAVEMENT MARKING - LINE 8"               | FOOT  | 267              | 267                        |  |  |  |  |
| 70300260              | TEMPORARY PAVEMENT MARKING - LINE 12"              | FOOT  | 3161             | 3161                       |  |  |  |  |
| 70300280              | TEMPORARY PAVEMENT MARKING - LINE 24"              | FOOT  | 1613             | 1613                       |  |  |  |  |
| 70300520              | PAVEMENT MARKING TAPE, TYPE III 4"                 | FOOT  | 12984            | 12984                      |  |  |  |  |
| * 72400100            | REMOVE SIGN PANEL ASSEMBLY - TYPE A                | EACH  | 1                | 1                          |  |  |  |  |
| * 72400200            | REMOVE SIGN PANEL ASSEMBLY - TYPE B                | EACH  | 1                | 1                          |  |  |  |  |
| * 72400500            | RELOCATE SIGN PANEL ASSEMBLY - TYPE A              | EACH  | 1                | 1                          |  |  |  |  |
| * SPECIALTY ITEMS     |  |       |                  |                            |  |  |  |  |

| SUMMARY OF QUANTITIES |  |       |                  | CONSTRUCTION TYPE CODE     |  |  |  |  |
|-----------------------|--|-------|------------------|----------------------------|--|--|--|--|
| CODE NO               | ITEM   | UNIT  | TOTAL QUANTITIES | 80% FEDERAL 20% STATE 0005 |  |  |  |  |
| * 78000100            | THERMOPLASTIC PAVEMENT MARKING - LETTERS AND SYMBOLS                       | SO FT | 2285             | 2285                       |  |  |  |  |
| * 78000200            | THERMOPLASTIC PAVEMENT MARKING - LINE 4"                                   | FOOT  | 52608            | 52608                      |  |  |  |  |
| * 78000400            | THERMOPLASTIC PAVEMENT MARKING - LINE 6"                                   | FOOT  | 12069            | 12069                      |  |  |  |  |
| * 78000500            | THERMOPLASTIC PAVEMENT MARKING - LINE 8"                                   | FOOT  | 267              | 267                        |  |  |  |  |
| * 78000600            | THERMOPLASTIC PAVEMENT MARKING - LINE 12"                                  | FOOT  | 3161             | 3161                       |  |  |  |  |
| * 78000650            | THERMOPLASTIC PAVEMENT MARKING - LINE 24"                                  | FOOT  | 1613             | 1613                       |  |  |  |  |
| * 78100100            | RAISED REFLECTIVE PAVEMENT MARKER  | EACH  | 1881             | 1881                       |  |  |  |  |
| 78300200              | RAISED REFLECTIVE PAVEMENT MARKER REMOVAL                                  | EACH  | 1429             | 1429                       |  |  |  |  |
| 85000200              | MAINTENANCE OF TRAFFIC SIGNAL INSTALLATION                                 | EACH  | 6                | 6                          |  |  |  |  |
| * 88600600            | DETECTOR LOOP REPLACEMENT  | FOOT  | 4348             | 4348                       |  |  |  |  |
| 89502376              | REBUILD EXISTING HANDHOLE  | EACH  | 8                | 8                          |  |  |  |  |
| 89502378              | REBUILD EXISTING HANDHOLE TO HEAVY-DUTY HANDHOLE                           | EACH  | 2                | 2                          |  |  |  |  |
| X0320050              | CONSTRUCTION LAYOUT (SPECIAL)  | LSUM  | 1                | 1                          |  |  |  |  |
| X4060004              | POLYMERIZED HOT-MIX ASPHALT SURFACE COURSE, STONE MATRIX ASPHALT, 9.5, NBO | TON   | 12497            | 12497                      |  |  |  |  |
| * SPECIALTY ITEMS     |  |       |                  |                            |  |  |  |  |

| SUMMARY OF QUANTITIES |  |       |                  | CONSTRUCTION TYPE CODE     |  |  |  |  |
|-----------------------|--|-------|------------------|----------------------------|--|--|--|--|
| CODE NO               | ITEM   | UNIT  | TOTAL QUANTITIES | 80% FEDERAL 20% STATE 0005 |  |  |  |  |
| X4401198              | HOT-MIX ASPHALT SURFACE REMOVAL. VARIABLE DEPTH              | SO YD | 19394            | 19394                      |  |  |  |  |
| X6030310              | FRAMES AND LIDS TO BE ADJUSTED (SPECIAL)                     | EACH  | 71               | 71                         |  |  |  |  |
| X6061311              | CONCRETE MEDIAN SURFACE, 5 INCH                              | SO FT | 300              | 300                        |  |  |  |  |
| X6350120              | DELINEATOR REMOVAL   | EACH  | 1                | 1                          |  |  |  |  |
| X7030005              | TEMPORARY PAVEMENT MARKING REMOVAL                           | SO FT | 36727            | 36727                      |  |  |  |  |
| Z0004562              | COMBINATION CONCRETE CURB AND GUTTER REMOVAL AND REPLACEMENT | FOOT  | 2053             | 2053                       |  |  |  |  |
| Δ Z0018500            | DRAINAGE STRUCTURES TO BE CLEANED                            | EACH  | 160              | 160                        |  |  |  |  |
| Z0030850              | TEMPORARY INFORMATION SIGNING                                | SO FT | 51.4             | 51.4                       |  |  |  |  |
| Z0038120              | PORTLAND CEMENT CONCRETE SURFACE REMOVAL 1 3/4"              | SO YD | 249              | 249                        |  |  |  |  |
| Ø Z0076000            | TRAINEE'S  | Hour  | 500              | 500                        |  |  |  |  |
| Ø Z0076004            | TRAINEE'S - TRAINING PROGRAM GRADUATE                        | Hour  | 500              | 500                        |  |  |  |  |
| Δ                     | NON-PARTICIPATING (100% STATE)                               |       |                  |                            |  |  |  |  |
| * SPECIALTY ITEMS     |  |       |                  |                            |  |  |  |  |

14

|  |              |            |           |   |  |                     |                 |              |   |                    |  |
|--|--------------|------------|-----------|---|--|---------------------|-----------------|--------------|---|--------------------|--|
| FILE NAME :  | USER NAME :  | DESIGNED : | REVISED : | STATE OF ILLINOIS<br>DEPARTMENT OF TRANSPORTATION | IL RTE. 62 (ALGONQUIN RD.) (E/O ROSELLE RD. TO IL RTE. 58 (GOLF RD.))<br>SUMMARY OF QUANTITIES | F.A.P. RTE.         | SECTION         | COUNTY       | TOTAL SHEETS                                    | SHEET NO.          |  |
| D:\N\LOB\EBID\INT\EG\11111111\p\DOT\Documents\DOT\11111111\Projects\CH11111111\CAD\Design\CH11111111.dwg | PLOT SCALE : | CHECKED :  | REVISED : |   |  | 339                 | 116Y(1&2)R-RS-6 | COOK         | 58  | 5                  |  |
| PLOT DATE :  | DATE :       | REVISED :  | SCALE:    |   |  | SHEET NO. OF SHEETS |                 | STA. TO STA. | FED. ROAD DIST. NO. 1 ILLINOIS FED. AID PROJECT |                    |  |
|  |              |            |           |   |  |                     |                 |              |   | CONTRACT NO. 62C93 |  |

Rev

NOTE: CONTRACTOR SHALL MILL BEFORE PATCHING



| HOT-MIX ASPHALT MIXTURE REQUIREMENTS  |  | AIR VOIDS(%)<br>@ N <sub>DES.</sub> | QUALITY MANAGEMENT PROGRAM (QMP) |
|---|--|-------------------------------------|----------------------------------|
| MIXTURE TYPE  |  |                                     |                                  |
| <b>PAVEMENT RESURFACING</b>   |  |                                     |                                  |
| POLYMERIZED HMA SURFACE COURSE, SMA, N80 (IL 9.5 mm), 1 3/4"  |  | 3.5% @ 80 GYR                       | PFP                              |
| POLYMERIZED LEVELING BINDER (MACHINE METHOD), IL-4.75, N50, 3/4"  |  | 3.5% @ 50 GYR                       | OCP                              |
| <b>PATCHING</b>   |  |                                     |                                  |
| CLASS D PATCHES (HMA BINDER IL-19 mm), 10"  |  | 4% @ 70 GYR                         | QC/QA                            |
| <b>DRIVEWAYS</b>  |  |                                     |                                  |
| HOT-MIX ASPHALT SURFACE COURSE, MIX "D", N50 (IL 9.5 mm), 2"  |  | 4% @ 50 GYR                         | QC/QA                            |
| HMA BASE COURSE (HMA BINDER IL-19 mm), CE - 8"  |  | 4% @ 50 GYR                         | QC/QA                            |
| <b>STABILIZED MEDIAN SURFACE</b>  |  |                                     |                                  |
| HOT-MIX ASPHALT SURFACE COURSE, MIX "D", N50 (IL 9.5 mm), 2"  |  | 4% @ 50 GYR                         | QC/QA                            |
| HOT-MIX ASPHALT BINDER COURSE, IL-19.0, N50, 10"  |  | 4% @ 50 GYR                         | QC/QA                            |
| QMP DESIGNATION: QUALITY CONTROL/QUALITY ASSURANCE(QA/QC); QUALITY CONTROL FOR PERFORMANCE(QCP); PAY FOR PERFORMANCE(PFP) |  |                                     |                                  |

THE UNIT WEIGHT USED TO CALCULATE ALL HMA SURFACE MIXTURE QUANTITIES IS 112 LBS/SQ YD/IN.


THE "AC TYPE" FOR POLYMERIZED HMA MIXES SHALL BE "SBS/SBR PG 76-22" AND FOR NON-POLYMERIZED HMA THE "AC TYPE" SHALL BE "PG 64-22" UNLESS MODIFIED BY DISTRICT ONE SPECIAL PROVISIONS. FOR USE OF RECYCLED MATERIALS SEE SPECIAL PROVISIONS. QUALITY MANAGEMENT PROGRAM (QMP) IDENTIFIES THE PARTICULAR QUALITY CONTROL SPECIFICATION THAT APPLIES TO THE HMA MIXTURE

**LEGEND**

- ① EXISTING PCC PAVEMENT, 10" (±)
- ② EXISTING SUB-BASE GRANULAR MATERIALS, 6" (±)
- ③ EXISTING COMBINATION CONCRETE CURB & GUTTER
- ④ EXISTING HMA SURFACE, 1 3/4"±
- ⑤ EXISTING HMA SURFACE, VARIABLE 1 3/4" - 2 1/2"±
- ⑥ EXISTING HMA LEVELING BINDER, 3/4"± AND VARIES
- ⑦ EXISTING STABILIZED MEDIAN SURFACE, 12"± / PC CONCRETE MEDIAN /PCC CORRUGATED MEDIAN
- ⑧ PROPOSED HOT-MIX ASPHALT SURFACE REMOVAL, 2 1/2"
- ⑨ PROPOSED HOT-MIX ASPHALT SURFACE REMOVAL, VARIABLE DEPTH, 1 3/4" - 2 1/2"
- ⑩ PROPOSED POLYMERIZED HOT-MIX ASPHALT SURFACE COURSE, SMA, N80, 1 3/4"
- ⑪ PROPOSED POLYMERIZED LEVELING BINDER (MACHINE METHOD), IL-4.75, N50, 3/4"

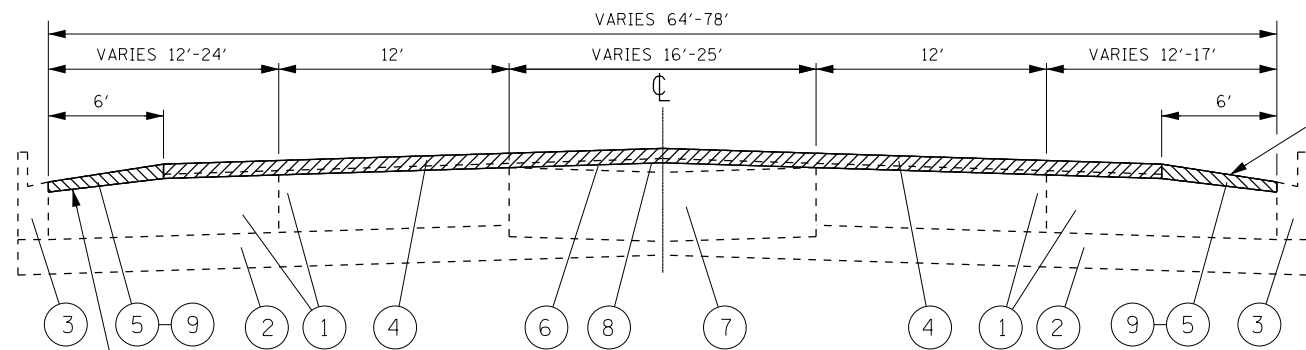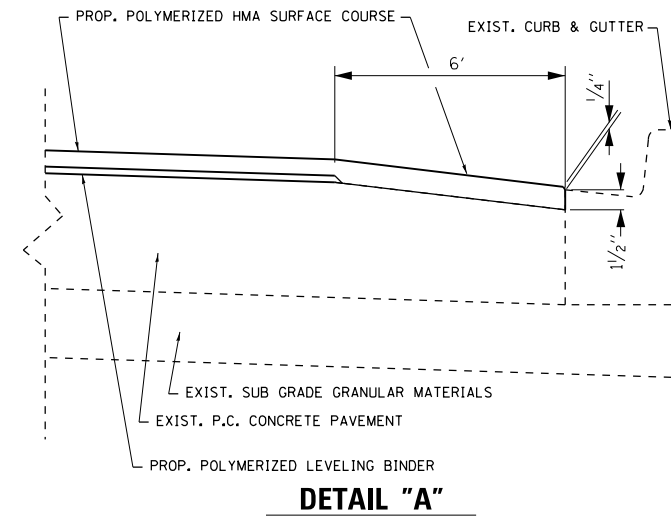


**IL 62 (ALGONQUIN ROAD)**  
**EXISTING TYPICAL SECTION**  
 STA. 50+78 TO STA. 82+90  
 STA. 84+00 TO STA. 93+19  
 STA. 96+30 TO STA. 103+64  
 STA. 104+72 TO STA. 115+65  
 STA. 136+35 TO STA. 146+14.5  
 STA. 195+71.4 TO STA. 201+19.5  
 STA. 205+65.3 TO STA. 207+05  
 STA. 208+02 TO STA. 241+00  
 STA. 245+13 TO STA. 252+66

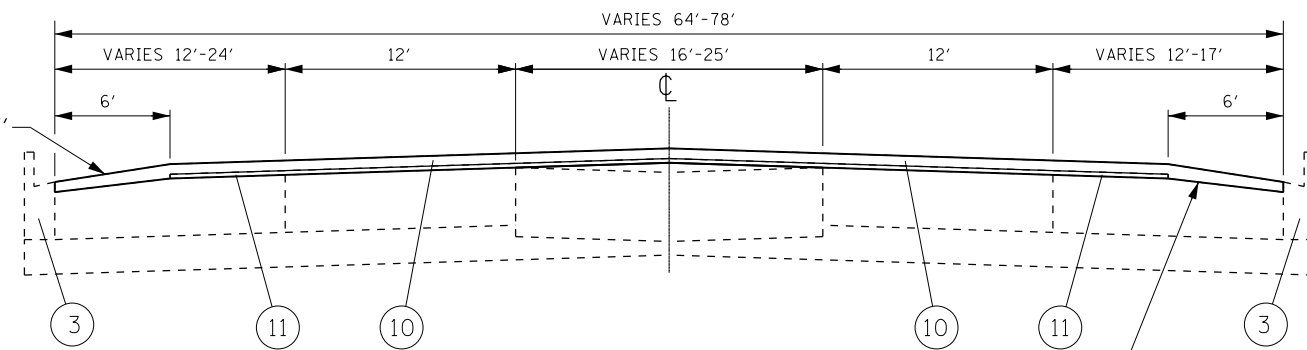


**IL 62 (ALGONQUIN ROAD)**  
**PROPOSED TYPICAL SECTION**  
 STA. 50+78 TO STA. 82+90  
 STA. 84+00 TO STA. 93+19  
 STA. 96+30 TO STA. 103+64  
 STA. 104+72 TO STA. 115+65  
 STA. 136+35 TO STA. 146+14.5  
 STA. 195+71.4 TO STA. 201+19.5  
 STA. 205+65.3 TO STA. 207+05  
 STA. 208+02 TO STA. 241+00  
 STA. 245+13 TO STA. 252+66

NOTE:  
 EXISTING MEDIAN TO BE REMOVED IS BETWEEN STA. 93+19 AND STA. 96+30.  
 PROPOSED CONCRETE MEDIAN TO BE PLACED BETWEEN STA. 91+85 AND STA. 97+47.  
 ANY VOIDS BETWEEN EXISTING MEDIAN REMOVAL AND PROPOSED MEDIAN PLACEMENT SHALL BE FILLED WITH CLASS "D" PATCH.

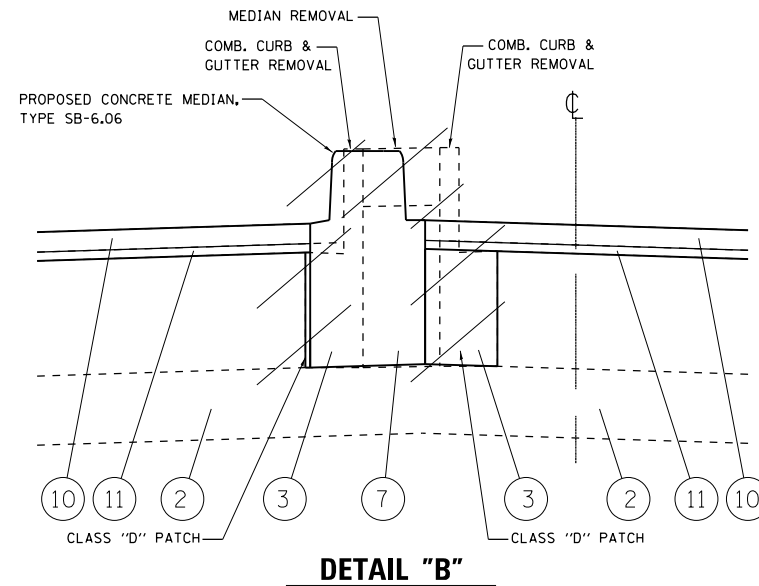


**LEGEND**


- ① EXISTING PCC PAVEMENT, 10" (±)
- ② EXISTING SUB-BASE GRANULAR MATERIALS, 6" (±)
- ③ EXISTING COMBINATION CONCRETE CURB & GUTTER
- ④ EXISTING HMA SURFACE, 1 3/4" ±
- ⑤ EXISTING HMA SURFACE, VARIABLE 1 3/4" - 2 1/2" ±
- ⑥ EXISTING HMA LEVELING BINDER, 3/4" ± AND VARIES
- ⑦ EXISTING STABILIZED MEDIAN SURFACE, 12" ± / PC CONCRETE MEDIAN / PCC CORRUGATED MEDIAN
- ⑧ PROPOSED HOT-MIX ASPHALT SURFACE REMOVAL, 2 1/2"
- ⑨ PROPOSED HOT-MIX ASPHALT SURFACE REMOVAL, VARIABLE DEPTH, 1 3/4" - 2 1/2"
- ⑩ PROPOSED POLYMERIZED HOT-MIX ASPHALT SURFACE COURSE, SMA, N80, 1 3/4"
- ⑪ PROPOSED POLYMERIZED LEVELING BINDER (MACHINE METHOD), IL-4.75, N50, 3/4"

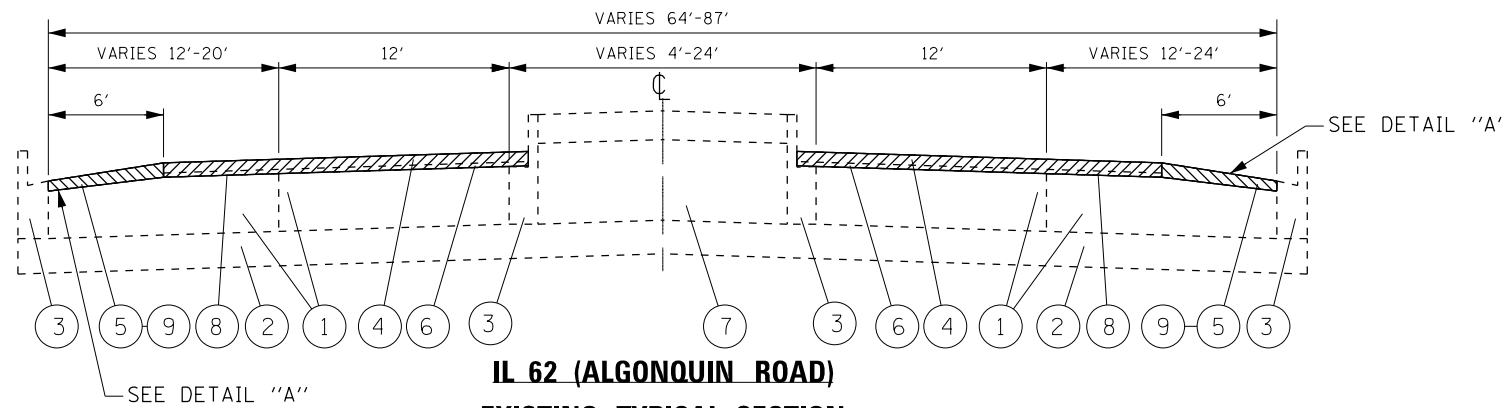


**IL 62 (ALGONQUIN ROAD)**  
**EXISTING TYPICAL SECTION**  
 STA. 82+90 TO STA. 84+00  
 STA. 93+19 TO STA. 96+30  
 STA. 103+64 TO STA. 104+72  
 STA. 134+75 TO STA. 136+35  
 STA. 241+00 TO STA. 245+13  
 STA. 252+66 TO STA. 253+94  
 EB STA. 253+94 TO STA. 257+92  
 STA. 257+92 TO STA. 261+82

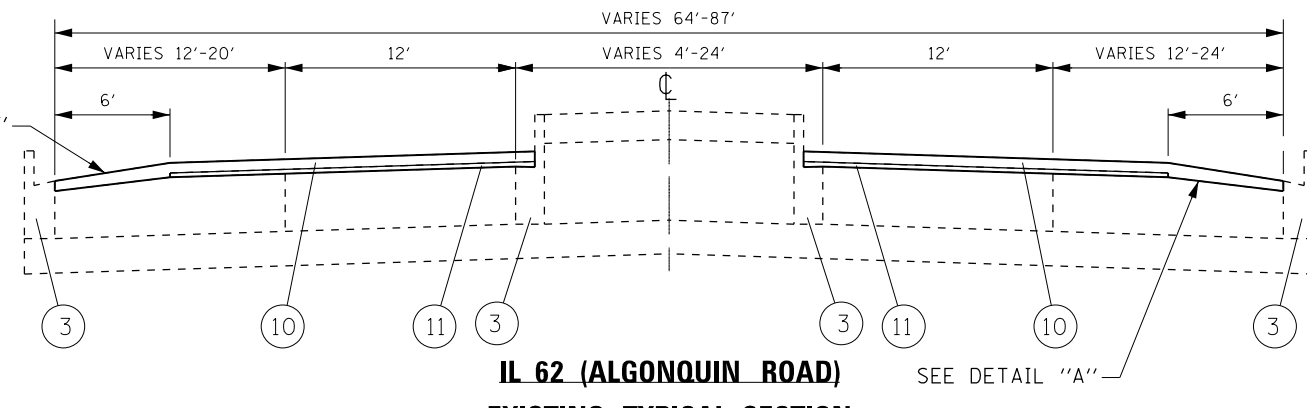

**IL 62 (ALGONQUIN ROAD)**  
**EXISTING TYPICAL SECTION**  
 STA. 82+90 TO STA. 84+00  
 STA. 93+19 TO STA. 96+30  
 STA. 103+64 TO STA. 104+72  
 STA. 134+75 TO STA. 136+35  
 STA. 241+00 TO STA. 245+13  
 STA. 252+66 TO STA. 253+94  
 EB STA. 253+94 TO STA. 257+92  
 STA. 257+92 TO STA. 261+82


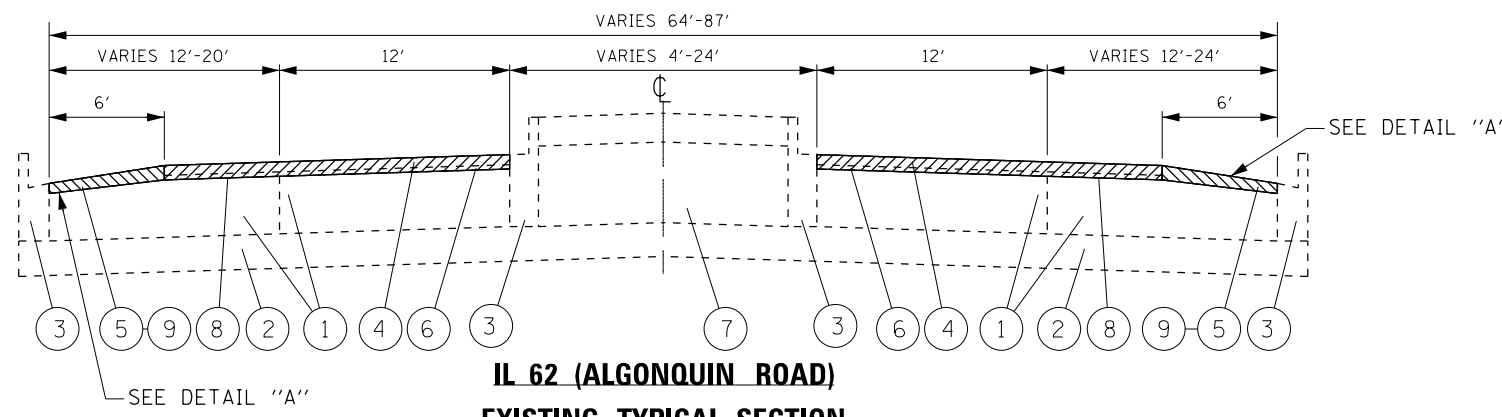


**IL 62 (ALGONQUIN ROAD)**  
**EXISTING TYPICAL SECTION**  
 STA. 128+65 TO STA. 134+75  
 STA. 207+05 TO STA. 208+02  
 WB STA. 253+94 TO STA. 257+92  
 STA. 261+82 TO STA. 276+84.5

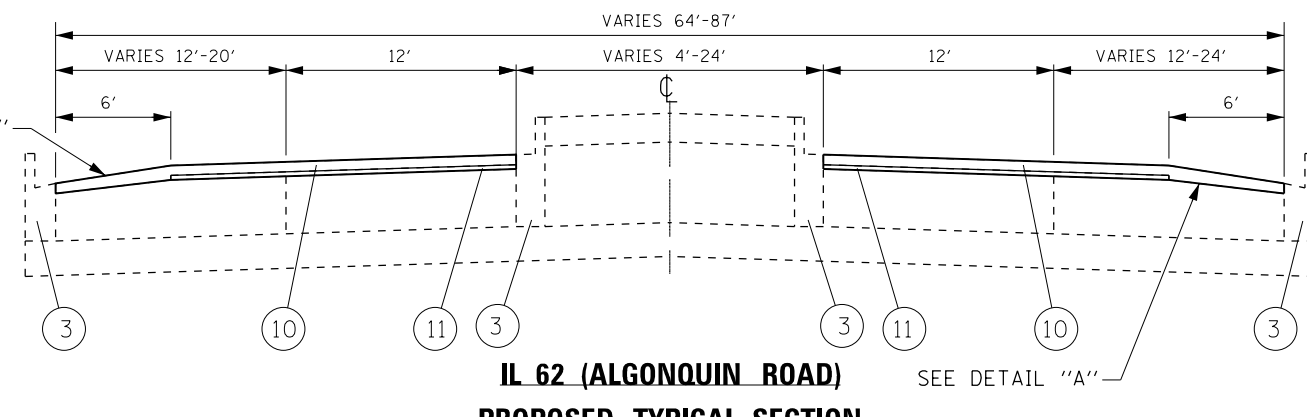



**IL 62 (ALGONQUIN ROAD)**  
**PROPOSED TYPICAL SECTION**  
 STA. 128+65 TO STA. 134+75  
 STA. 207+05 TO STA. 208+02  
 WB STA. 253+94 TO STA. 257+92  
 STA. 261+82 TO STA. 276+84.5

|  |                     |            |           |   |   |                           |                           |               |                   |               |  |
|--|---------------------|------------|-----------|---|---|---------------------------|---------------------------|---------------|-------------------|---------------|--|
| FILE NAME =  | USER NAME = PencePL | DESIGNED - | REVISED - | <b>STATE OF ILLINOIS<br/>DEPARTMENT OF TRANSPORTATION</b> | <b>EXISTING AND PROPOSED TYPICAL SECTIONS<br/>IL 62 (ALGONQUIN ROAD) - E/O ROSELLE ROAD TO IL 58(GOLF ROAD)</b> | F.A.P. RTE. =             | SECTION =                 | COUNTY =      | TOTAL SHEETS =    | SHEET NO. =   |  |
| pw\11084EBIDINTEG\illinois.gov\PWIDOT\Documents\DOT Offices\District 1\Projects\0411084EBIDINTEG\Design\041116-sht-typical.dgn |                     |            |           |   |   | F.A.P. RTE. = 339         | SECTION = 116Y(1&2)R-RS-6 | COUNTY = COOK | TOTAL SHEETS = 58 | SHEET NO. = 7 |  |
| PLOT SCALE = 100.0000' / in.   |                     |            |           |   |   | CONTRACT NO. 62C93        |                           |               |                   |               |  |
| PLOT DATE = 2/4/2017   |                     |            |           |   |   | ILLINOIS FED. AID PROJECT |                           |               |                   |               |  |

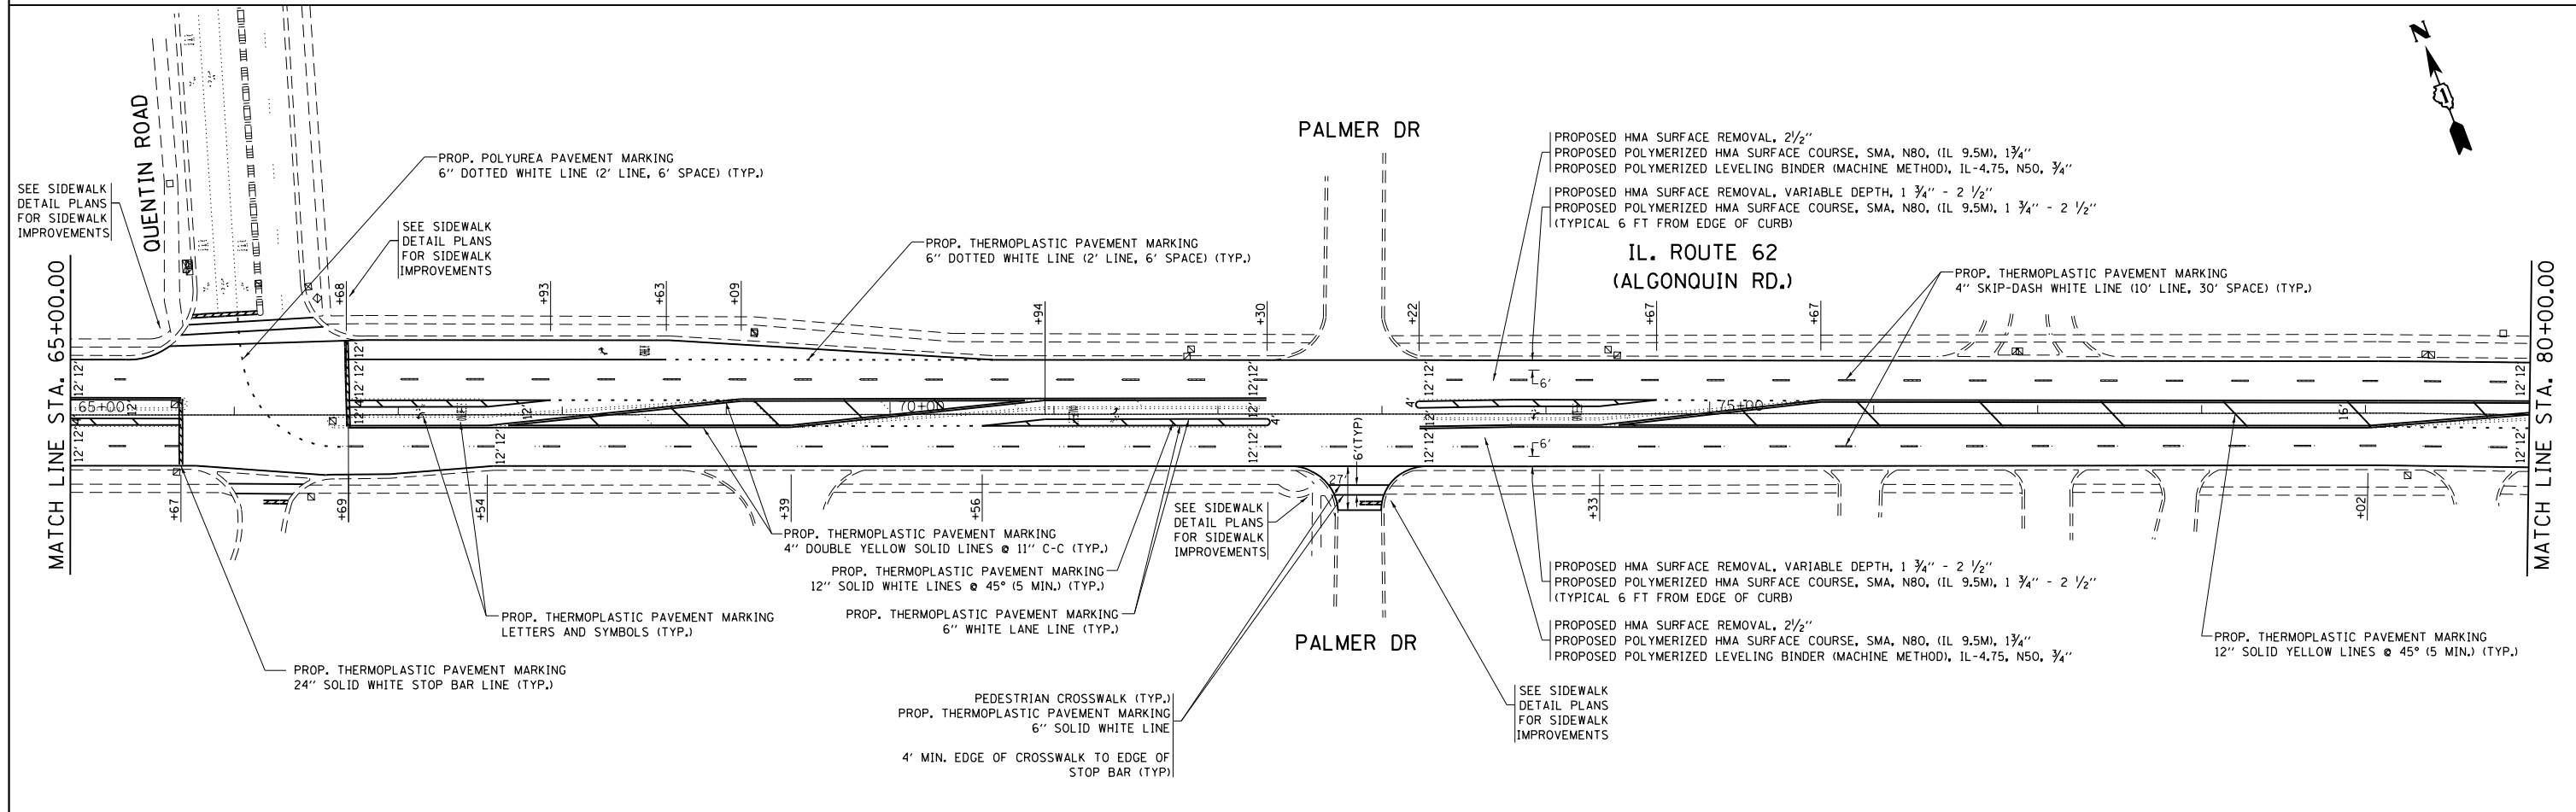
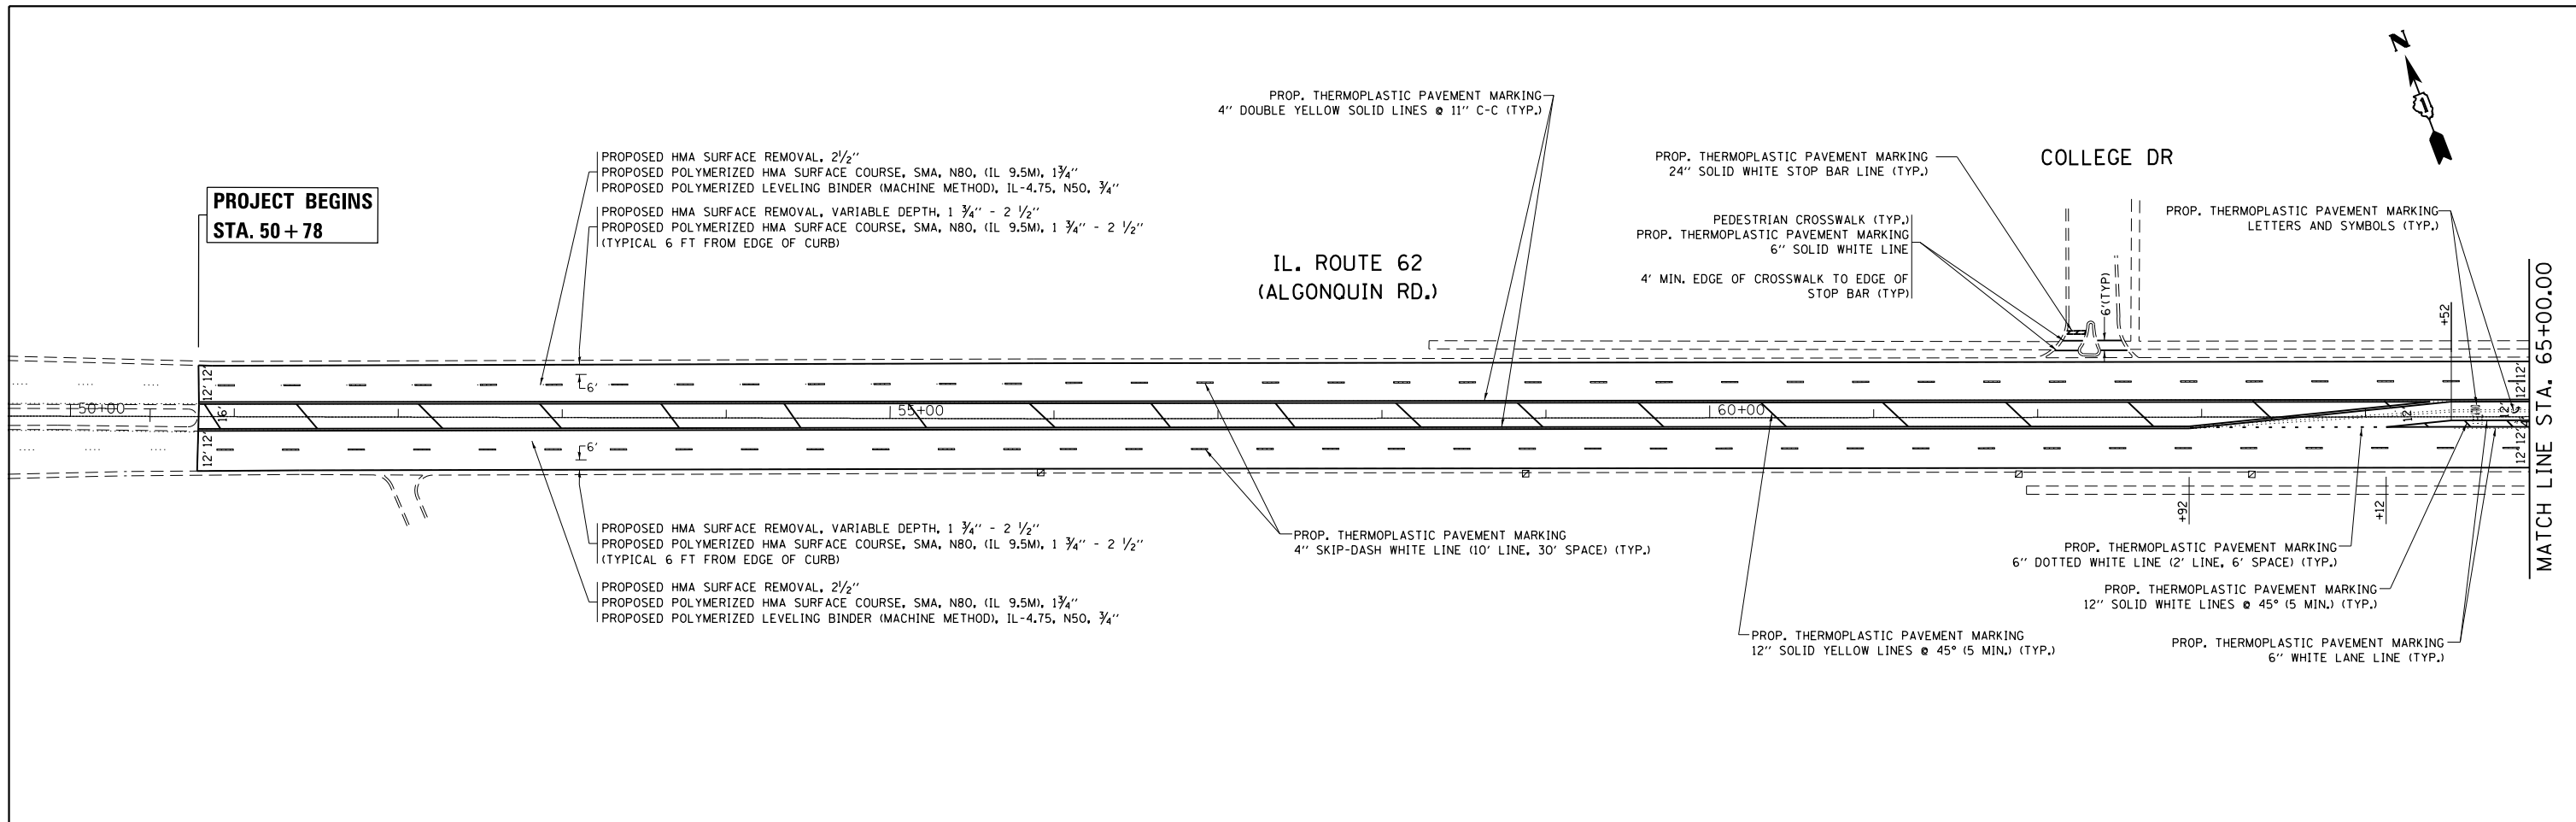


|   |                      |            |           |   |   |                           |                 |        |              |           |  |
|---|----------------------|------------|-----------|---|---|---------------------------|-----------------|--------|--------------|-----------|--|
| FILE NAME =   | USER NAME = PencePL  | DESIGNED - | REVISED - | <b>STATE OF ILLINOIS<br/>DEPARTMENT OF TRANSPORTATION</b> | <b>ROADWAY PLAN<br/>IL RTE. 62 (ALGONQUIN RD.) (E/O ROSELLE RD. TO IL RTE. 58 (GOLF RD.))</b> | F.A.P. RTE.               | SECTION         | COUNTY | TOTAL SHEETS | SHEET NO. |  |
| pw:\IL\084EBIDINTEG.illinois.gov\PIWIDOTDocuments\IDOT Offices\District 1\Projects\04116\04116-sht-plan.dgn | 10/16/2017           | CHECKED -  | REVISED - |   |   | 339                       | 116Y(1&2)R-RS-6 | COOK   | 58           | 8         |  |
| PLOT SCALE = 100.0000' / in.  | DATE -               | REVISED -  | REVISED - |   |   | CONTRACT NO. 62C93        |                 |        |              |           |  |
| Default   | PLOT DATE = 2/4/2017 | DATE -     | REVISED - |   |   | ILLINOIS FED. AID PROJECT |                 |        |              |           |  |





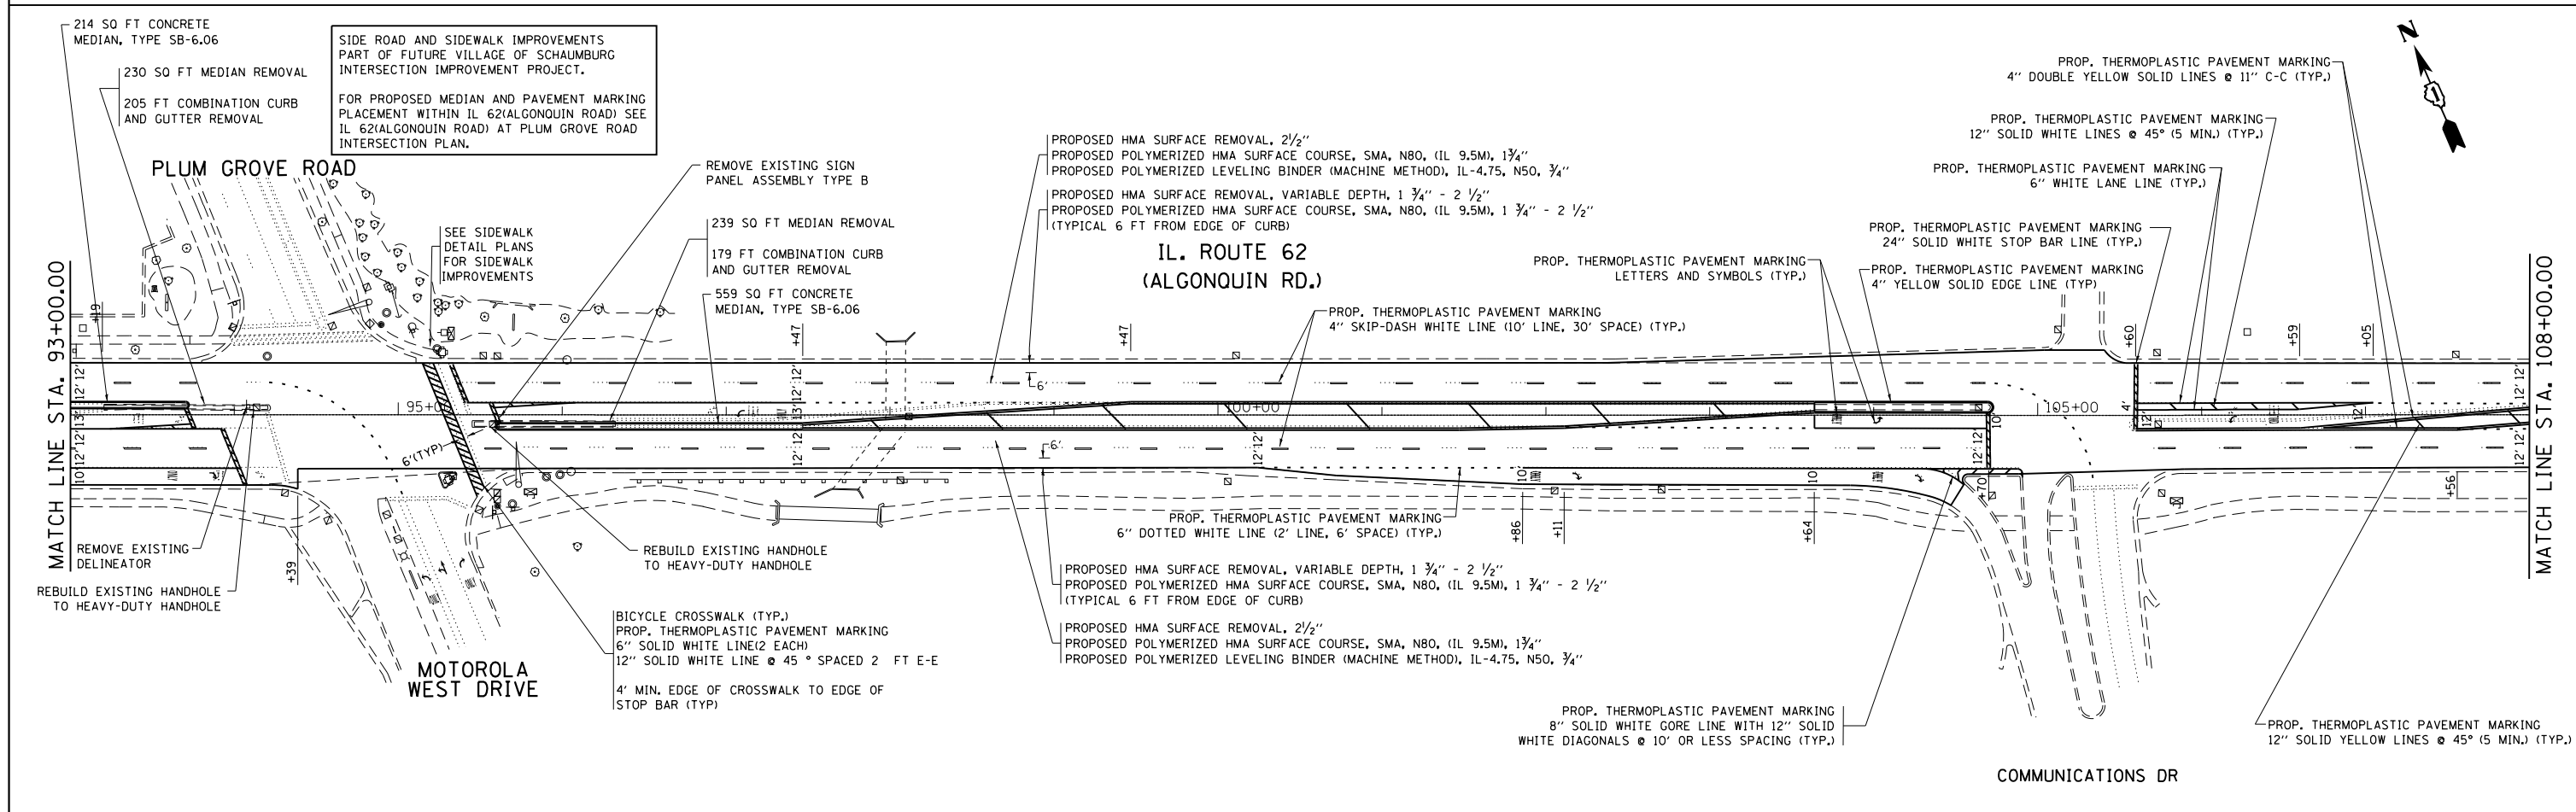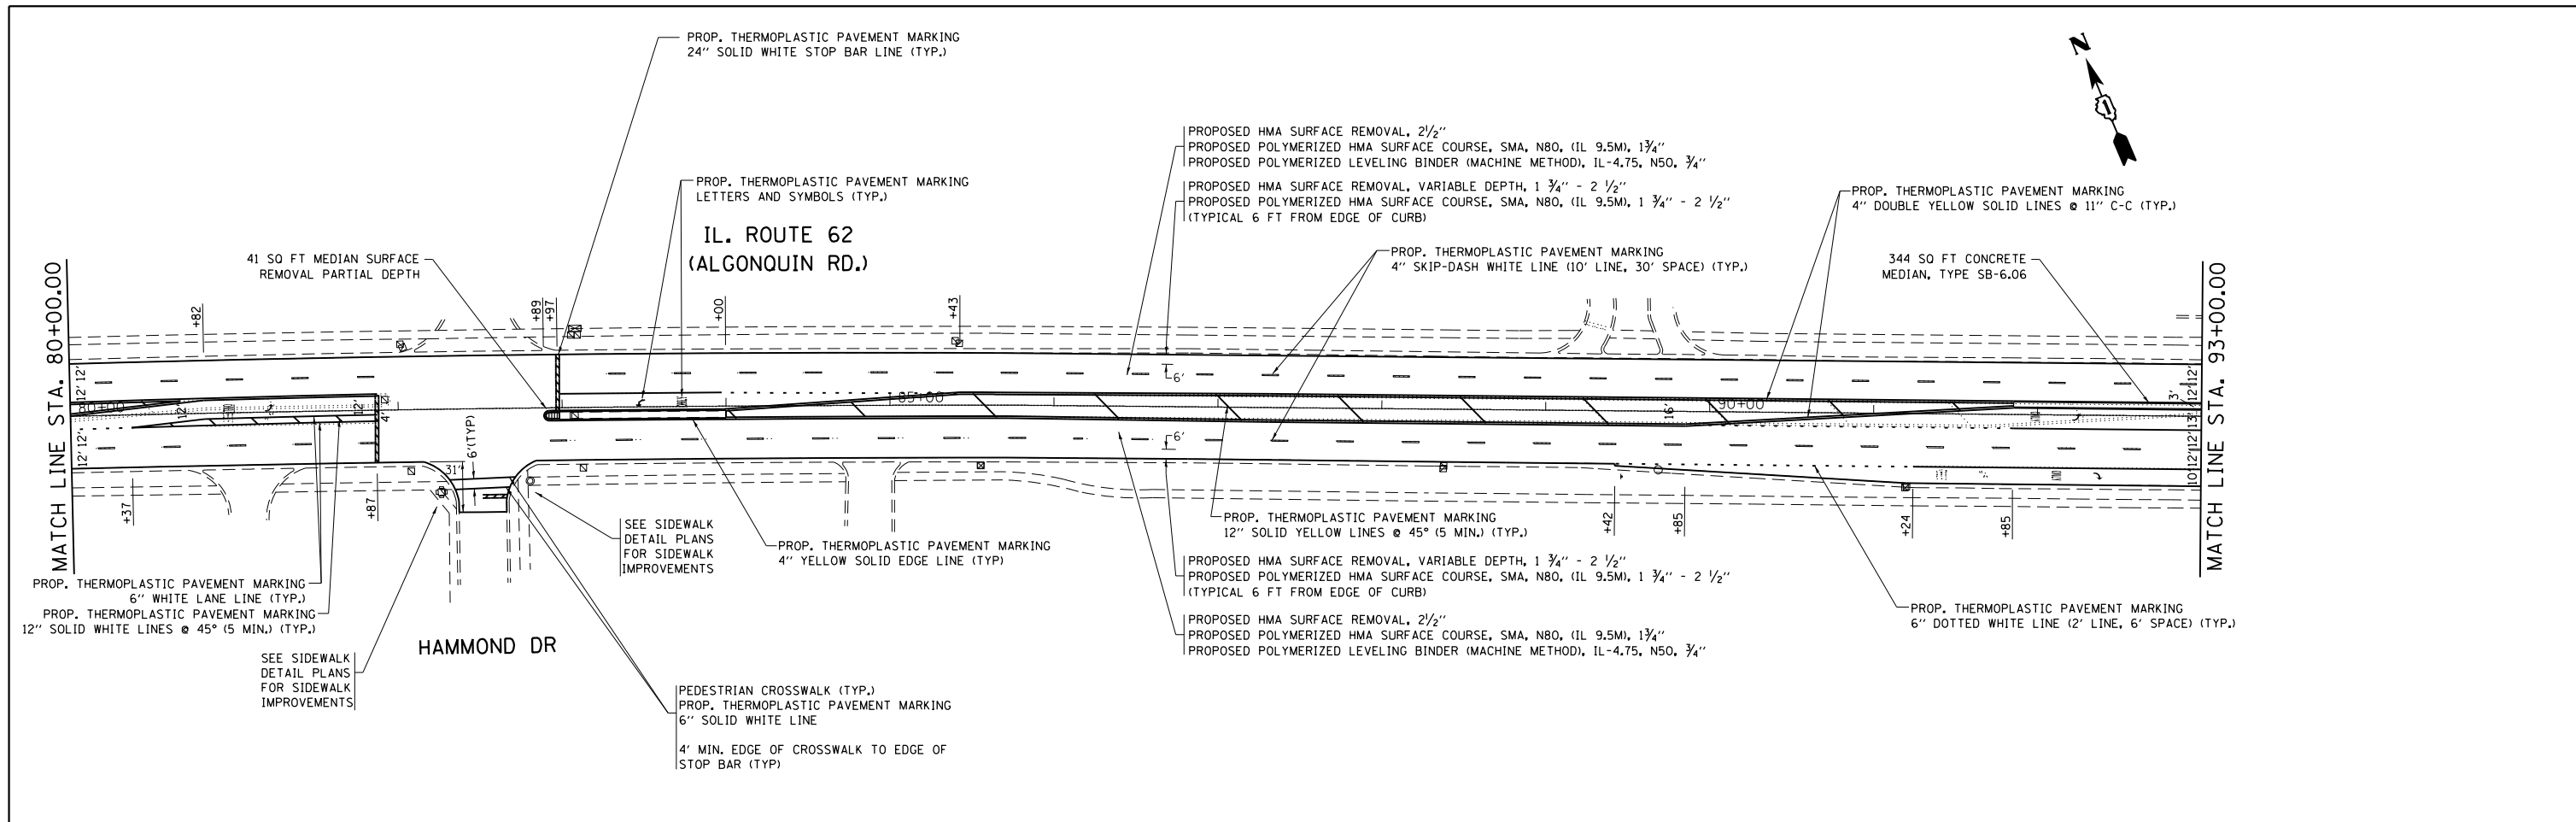



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|---|---------------------|------------|-----------|---|---|---------------------------|-----------------|--------|--------------|-----------|--|
| FILE NAME =   | USER NAME = PencePL | DESIGNED - | REVISED - | <b>STATE OF ILLINOIS<br/>DEPARTMENT OF TRANSPORTATION</b> | <b>ROADWAY PLAN<br/>IL RTE. 62 (ALGONQUIN RD.) (E/O ROSELLE RD. TO IL RTE. 58 (GOLF RD.))</b> | F.A.P. RTE.               | SECTION         | COUNTY | TOTAL SHEETS | SHEET NO. |  |
| pw:\IL084EBIDINTEG.illinois.gov\PIWIDOT\Documents\IDOT Offices\District 1\Projects\0411\0411-116-sht-plan.dgn |                     | CHECKED -  | REVISED - |   |   | 339                       | 116Y(1&2)R-RS-6 | COOK   | 58           | 9         |  |
| PLOT SCALE = 100.0000' / 1in.   |                     | DATE -     | REVISED - |   |   | CONTRACT NO. 62C93        |                 |        |              |           |  |
| Default   |                     |            |           |   |   | ILLINOIS FED. AID PROJECT |                 |        |              |           |  |

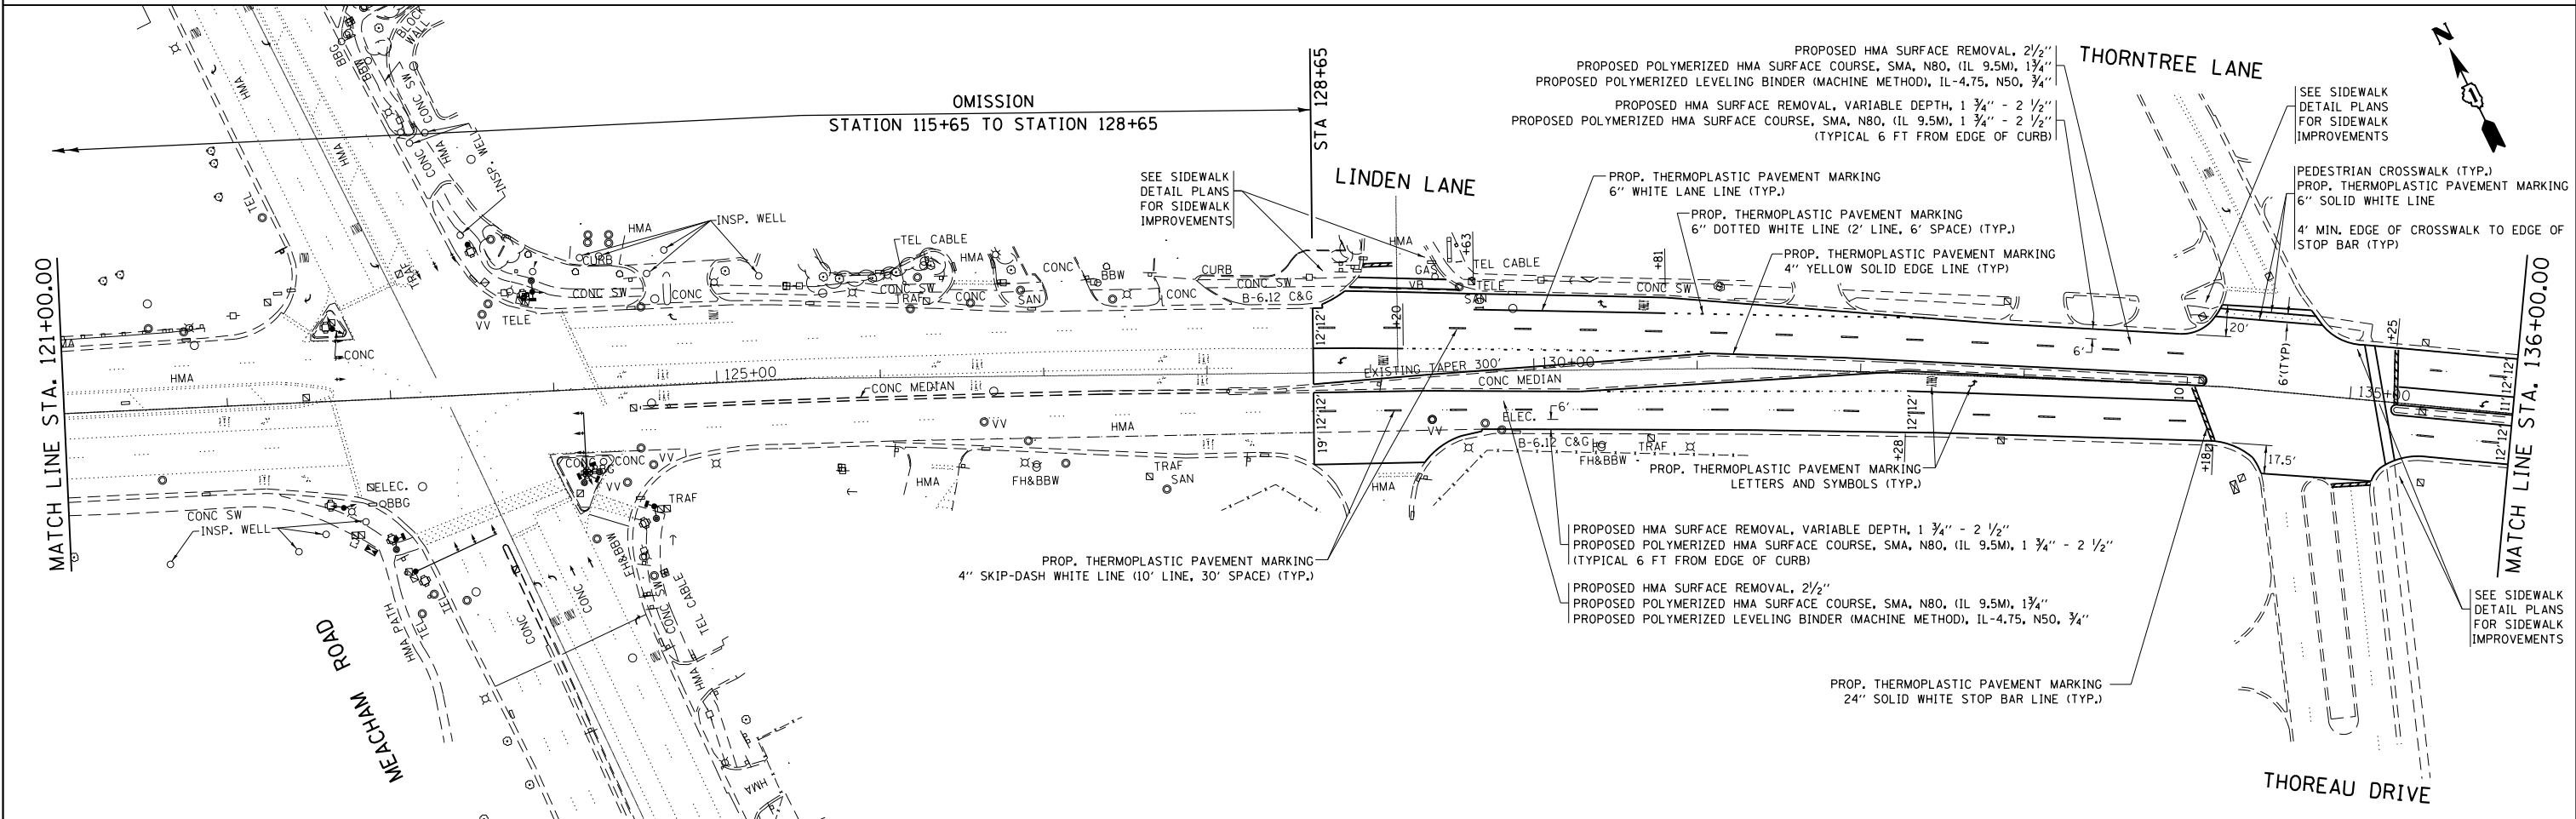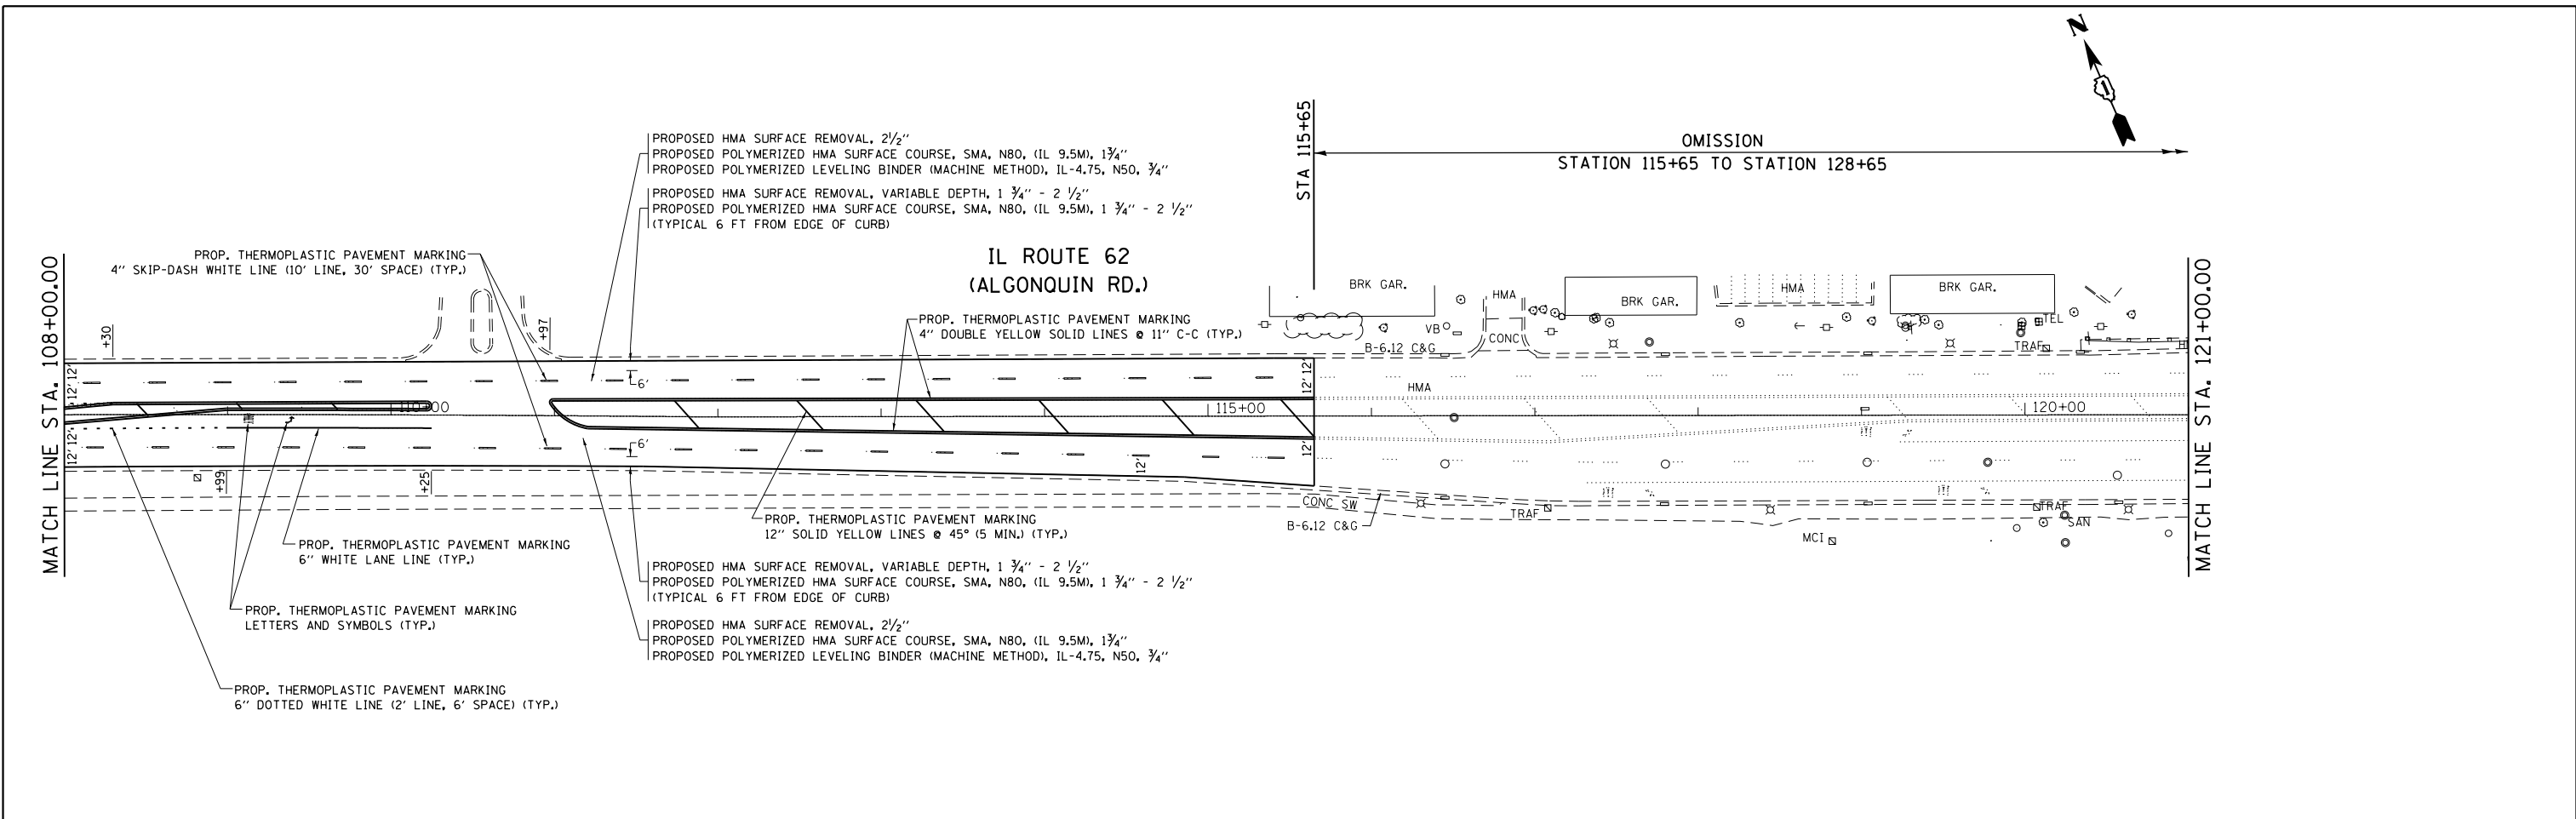



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|---|------------------------------|------------|-----------|---|--|--|--|-----------------|-----------------|--------------|--------------|--------------------|--|
| FILE NAME =   | USER NAME = PencePL          | DESIGNED - | REVISED - | <b>STATE OF ILLINOIS<br/>DEPARTMENT OF TRANSPORTATION</b> | <b>ROADWAY PLAN</b>  |  |  | F.A.P. RTE.     | SECTION         | COUNTY       | TOTAL SHEETS | SHEET NO.          |  |
| pw:\IL084EBIDINTEG\illinois.gov\PIWIDOT\Documents\IDOT Offices\District 1\Projects\14116\RAM\Design\141116-sht-plan.dgn |                              | CHECKED -  | REVISED - |   | <b>IL RTE. 62 (ALGONQUIN RD.) (E/O ROSELLE RD. TO IL RTE. 58 (GOLF RD.))</b> |  |  | 339             | 116Y(1&2)R-RS-6 | COOK         | 58           | 10                 |  |
| Default   | PLOT SCALE = 100.0000' / in. | DATE -     | REVISED - |   | SCALE: 1" = 50'  |  |  | SHEET OF SHEETS |                 | STA. TO STA. |              | CONTRACT NO. 62C93 |  |
|   | PLOT DATE = 2/4/2017         |            |           |   | ILLINOIS FED. AID PROJECT  |  |  |                 |                 |              |              |                    |  |

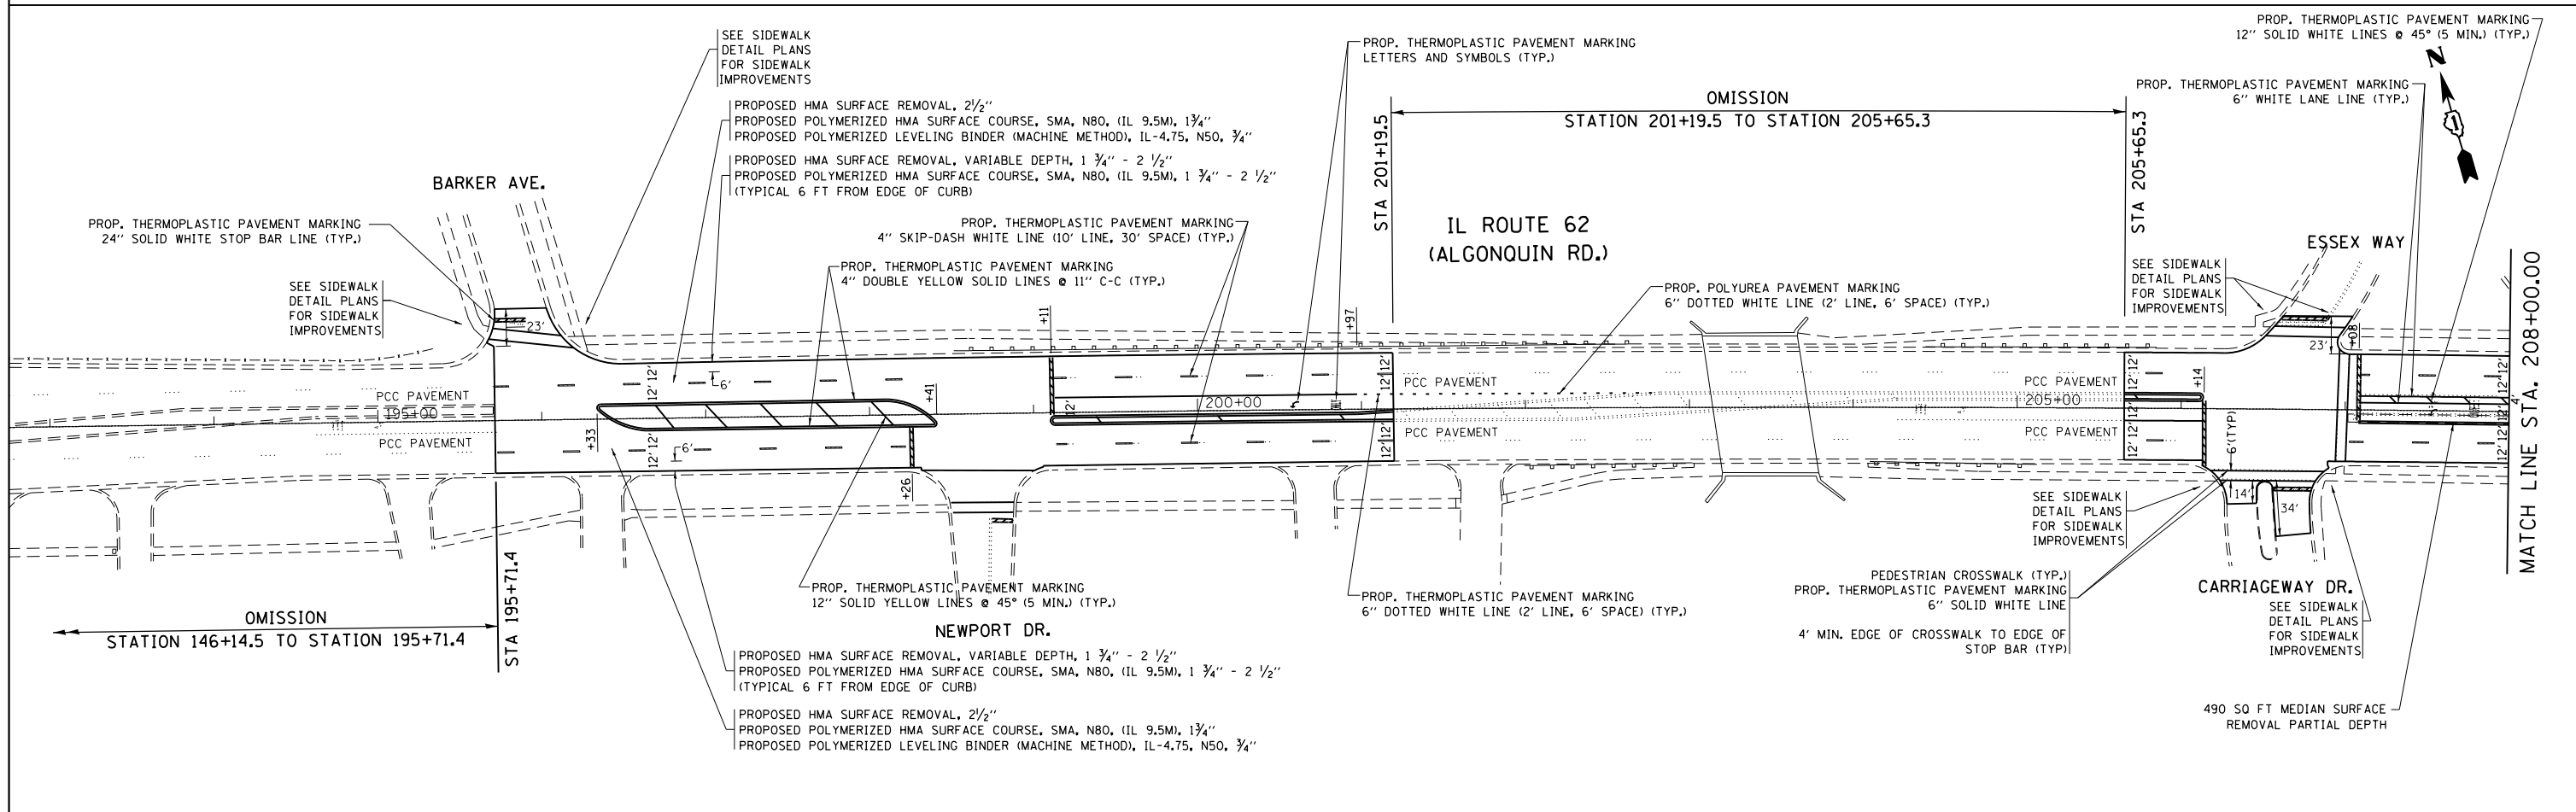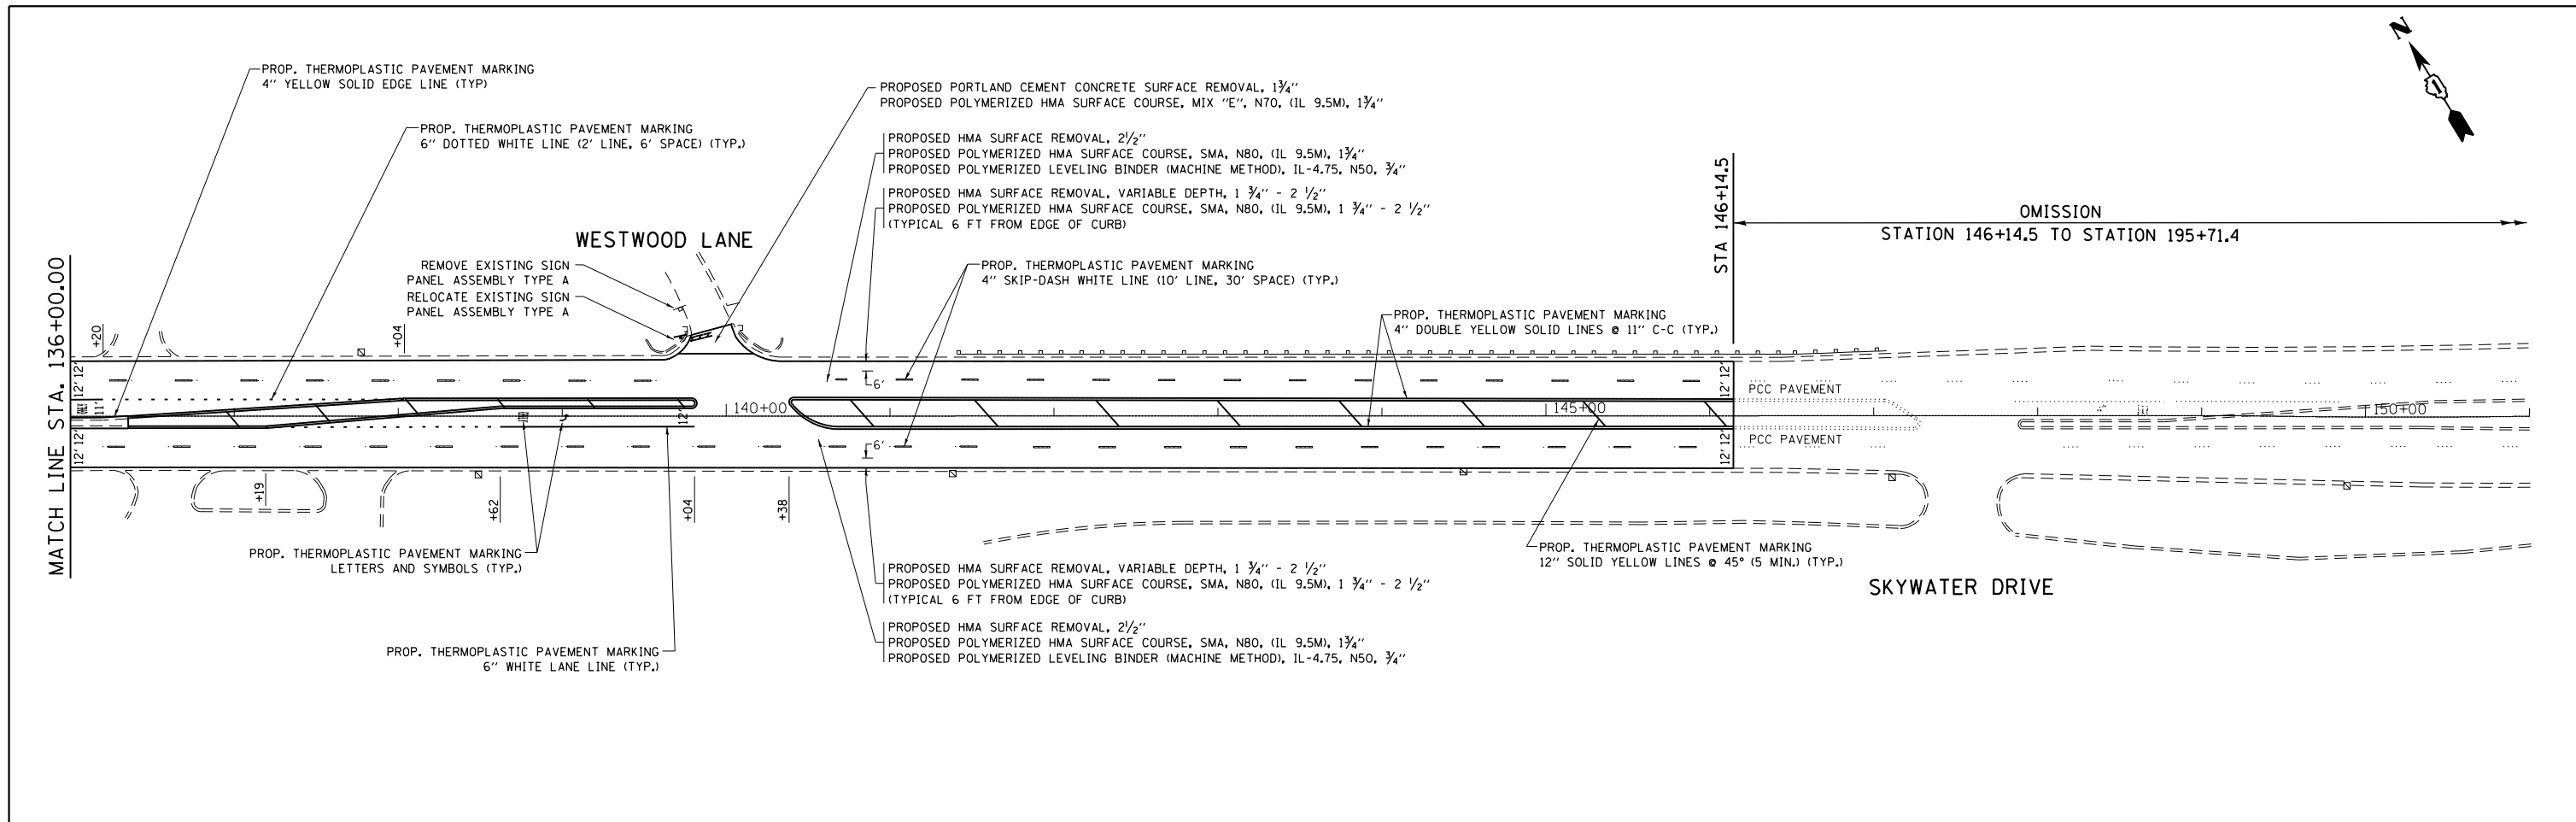



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|---|---------------------|------------|-----------|---|--|-------|-----------|-------------|-----------------|---------------------------|--------------|-----------|
| FILE NAME =   | USER NAME = PencePL | DESIGNED - | REVISED - | <b>STATE OF ILLINOIS<br/>DEPARTMENT OF TRANSPORTATION</b> | <b>ROADWAY PLAN</b>  |       |           | F.A.P. RTE. | SECTION         | COUNTY                    | TOTAL SHEETS | SHEET NO. |
| pw:\IL084EBIDINTEG\illinois.gov\PIWIDOT\Documents\IDOT Offices\District 1\Projects\0141\0141\0141\Design\0141116-sht-plan.dgn |                     | CHECKED -  | REVISED - |   | <b>IL RTE. 62 (ALGONQUIN RD.) (E/O ROSELLE RD. TO IL RTE. 58 (GOLF RD.))</b> |       |           | 339         | 116Y(1&2)R-RS-6 | COOK                      | 58           | 11        |
| PLOT SCALE = 100.0000' / 1in.   |                     | DATE -     | REVISED - |   | SCALE: 1" = 50'  | SHEET | OF SHEETS | STA.        | TO STA.         | CONTRACT NO. 62C93        |              |           |
| Default   |                     |            |           |   |  |       |           |             |                 | ILLINOIS FED. AID PROJECT |              |           |

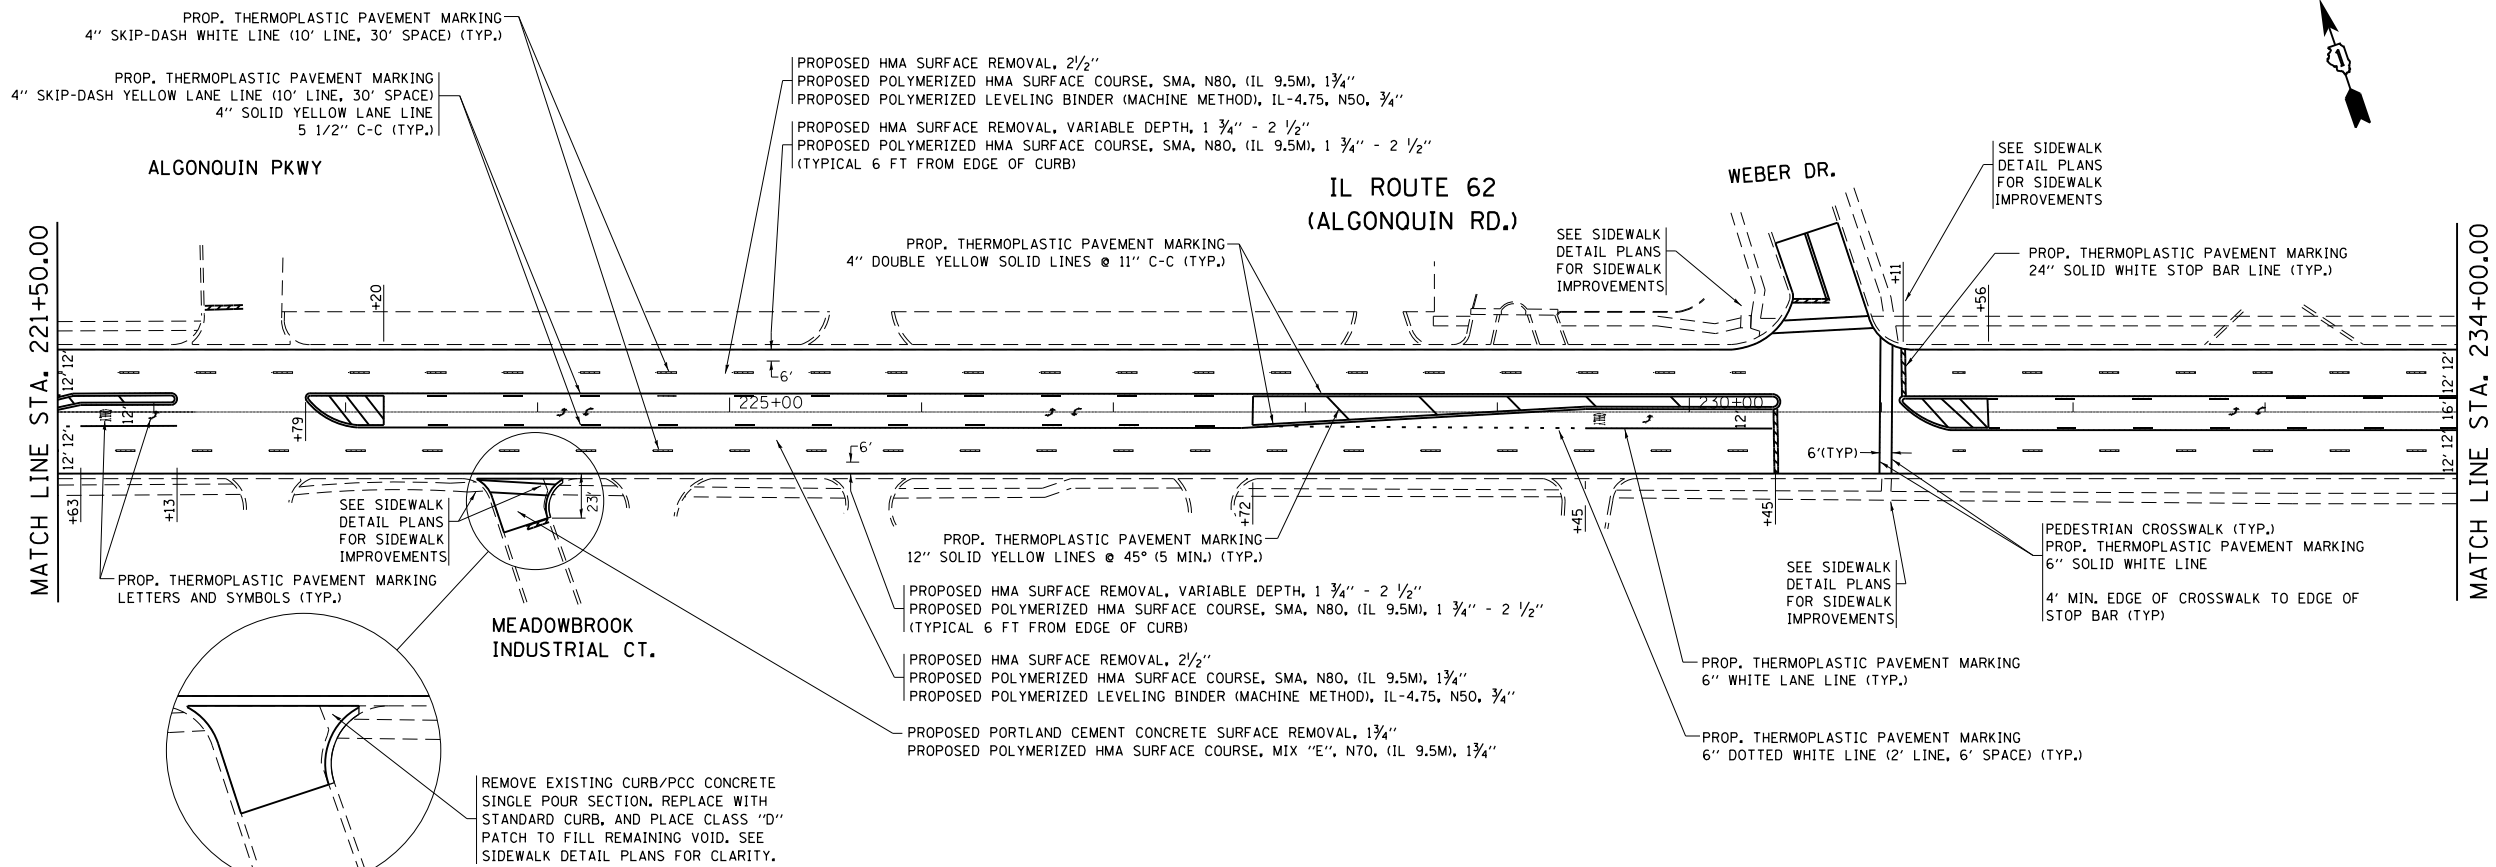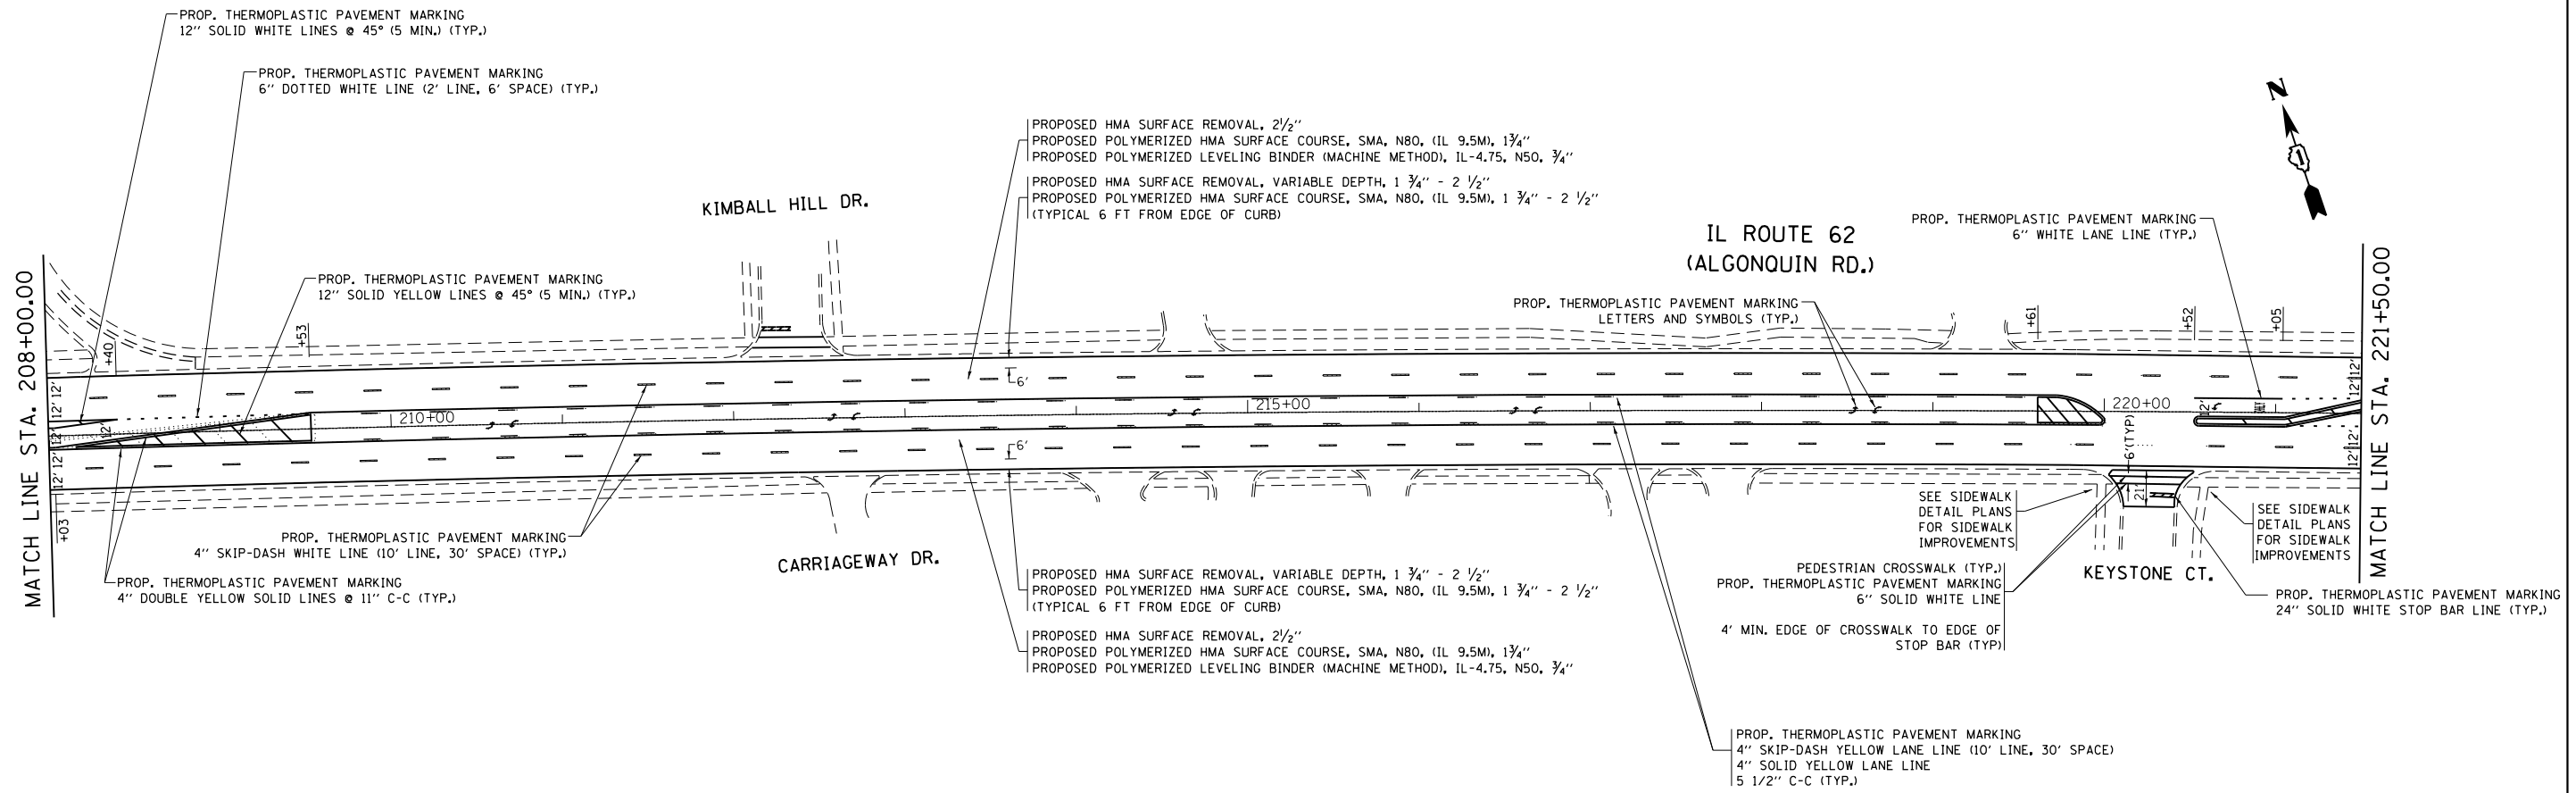

|   |                              |            |           |   |   |                           |                 |        |              |           |  |
|---|------------------------------|------------|-----------|---|---|---------------------------|-----------------|--------|--------------|-----------|--|
| FILE NAME =   | USER NAME = PencePL          | DESIGNED - | REVISED - | <b>STATE OF ILLINOIS<br/>DEPARTMENT OF TRANSPORTATION</b> | <b>ROADWAY PLAN<br/>IL RTE. 62 (ALGONQUIN RD.) (E/O ROSELLE RD. TO IL RTE. 58 (GOLF RD.))</b> | F.A.P. RTE.               | SECTION         | COUNTY | TOTAL SHEETS | SHEET NO. |  |
| p:\IL\084EBID\INTEG.illinois.gov\PIWIDOT\Documents\IDOT Offices\District 1\Projects\0141\ORAN\Design\0141116-sht-plan.dgn | PLOT SCALE = 100.0000' / in. | CHECKED -  | REVISED - |   |   | 339                       | 116Y(1&2)R-RS-6 | COOK   | 58           | 12        |  |
| Default   | PLOT DATE = 2/4/2017         | DATE -     | REVISED - |   |   | CONTRACT NO. 62C93        |                 |        |              |           |  |
|   |                              |            |           |   |   | ILLINOIS FED. AID PROJECT |                 |        |              |           |  |

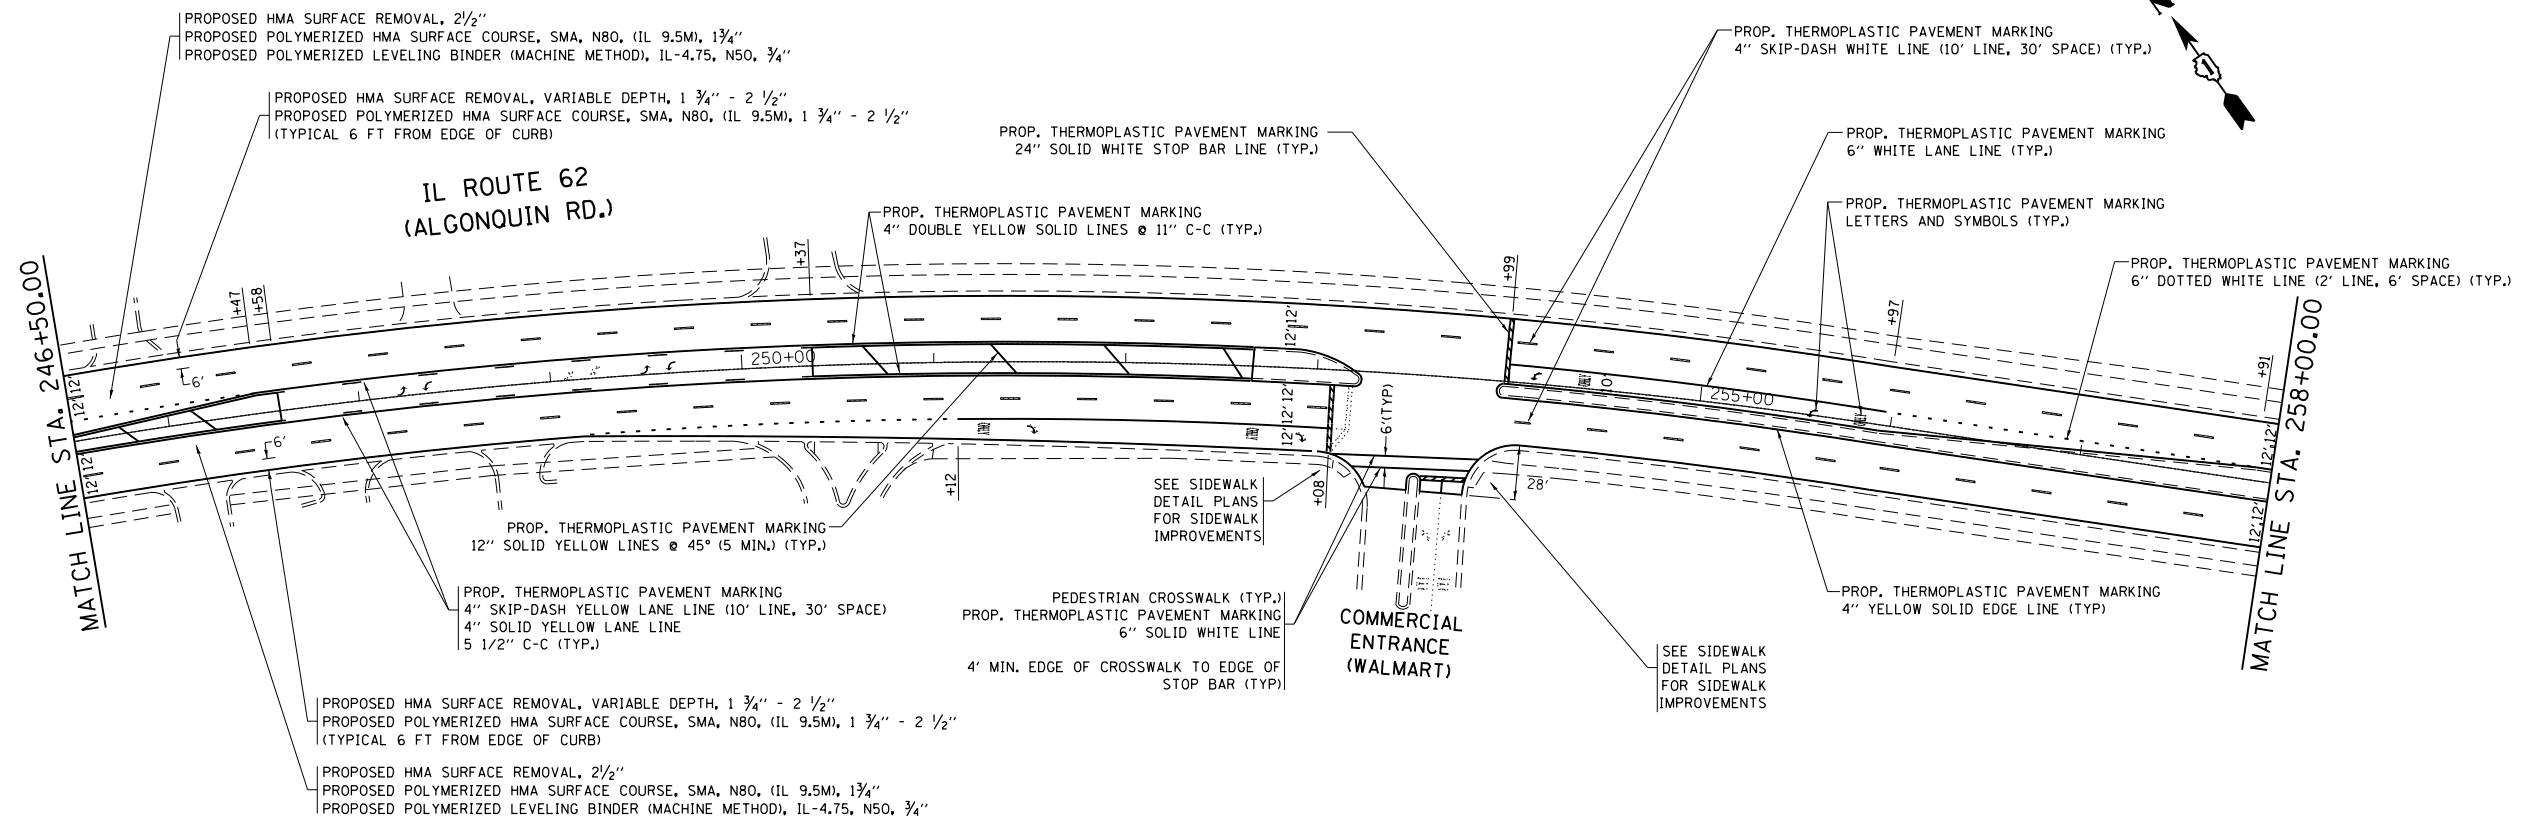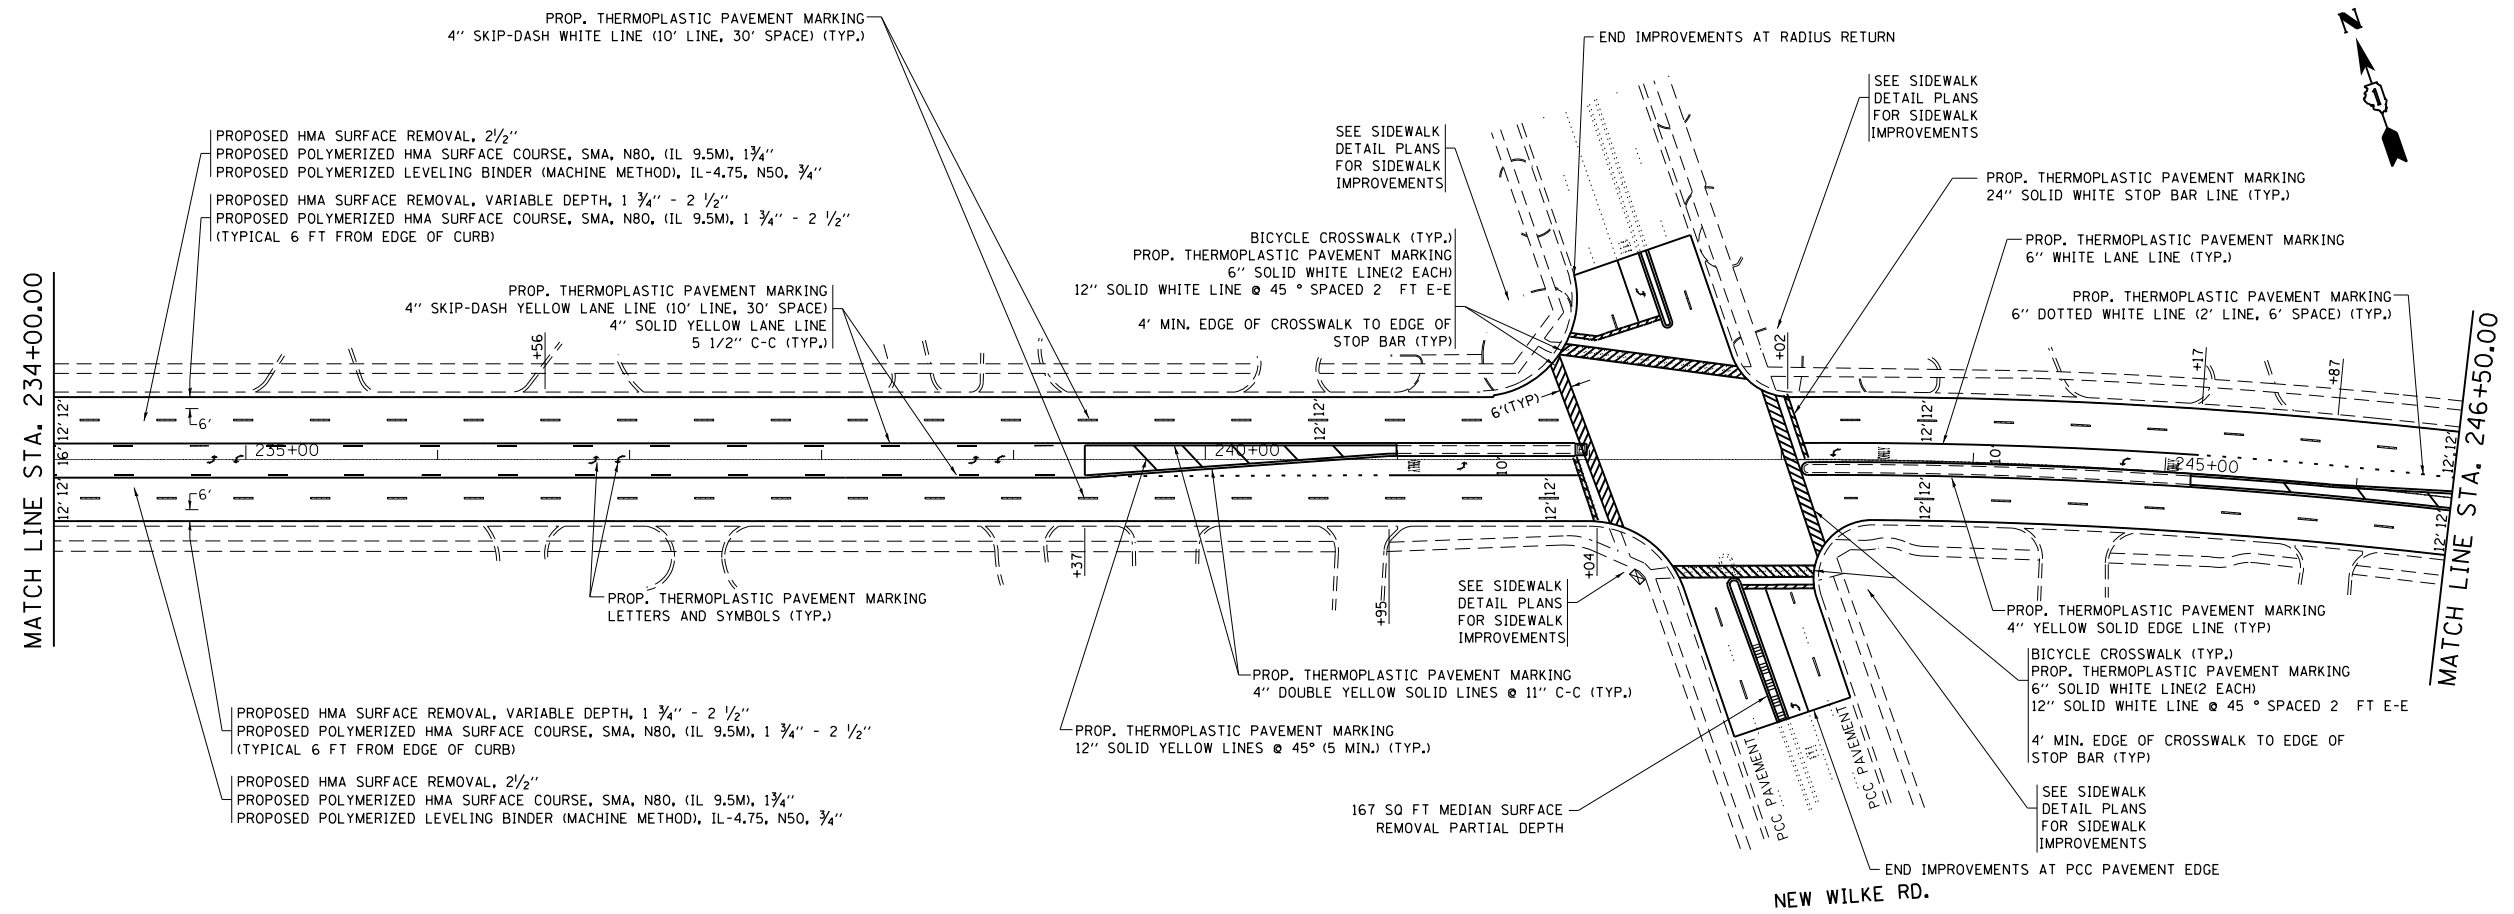

|  |                     |            |           |   |   |                           |                 |        |                 |              |  |
|--|---------------------|------------|-----------|---|---|---------------------------|-----------------|--------|-----------------|--------------|--|
| FILE NAME =  | USER NAME = PencePL | DESIGNED - | REVISED - | <b>STATE OF ILLINOIS<br/>DEPARTMENT OF TRANSPORTATION</b> | <b>ROADWAY PLAN<br/>IL RTE. 62 (ALGONQUIN RD.) (E/O ROSELLE RD. TO IL RTE. 58 (GOLF RD.))</b> | F.A.P.<br>RTE.            | SECTION         | COUNTY | TOTAL<br>SHEETS | SHEET<br>NO. |  |
| pw\IL084EBIDINTEG.illinois.gov\PIWIDOT\Documents\IDOT Offices\District 1\Projects\D141\ORAN\Design\041116-sht-plan.dgn |                     | CHECKED -  | REVISED - |   |   | 339                       | 116Y(1&2)R-RS-6 | COOK   | 58              | 13           |  |
| PLOT SCALE = 100.0000' / in.   |                     | DATE -     | REVISED - |   |   | CONTRACT NO. 62C93        |                 |        |                 |              |  |
| Default  |                     |            |           |   |   | ILLINOIS FED. AID PROJECT |                 |        |                 |              |  |

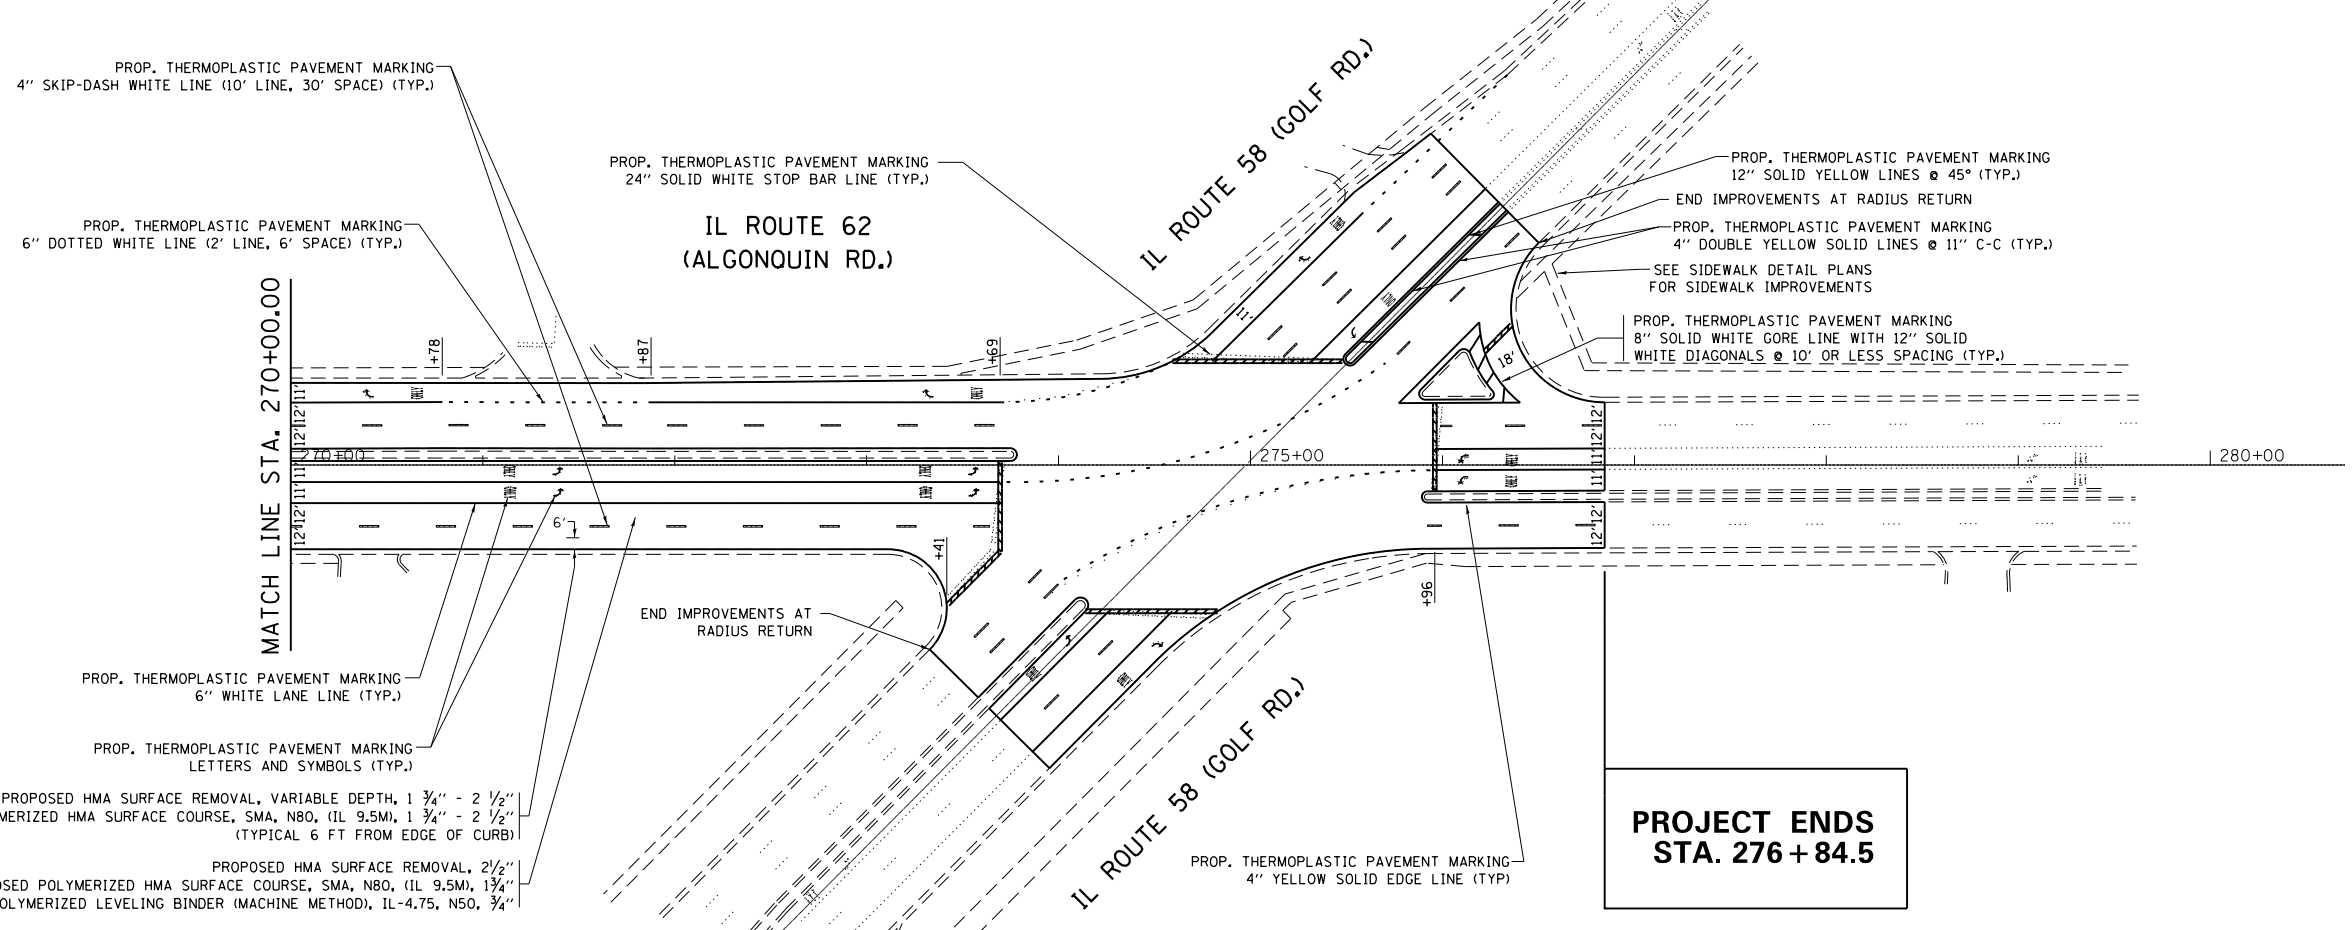
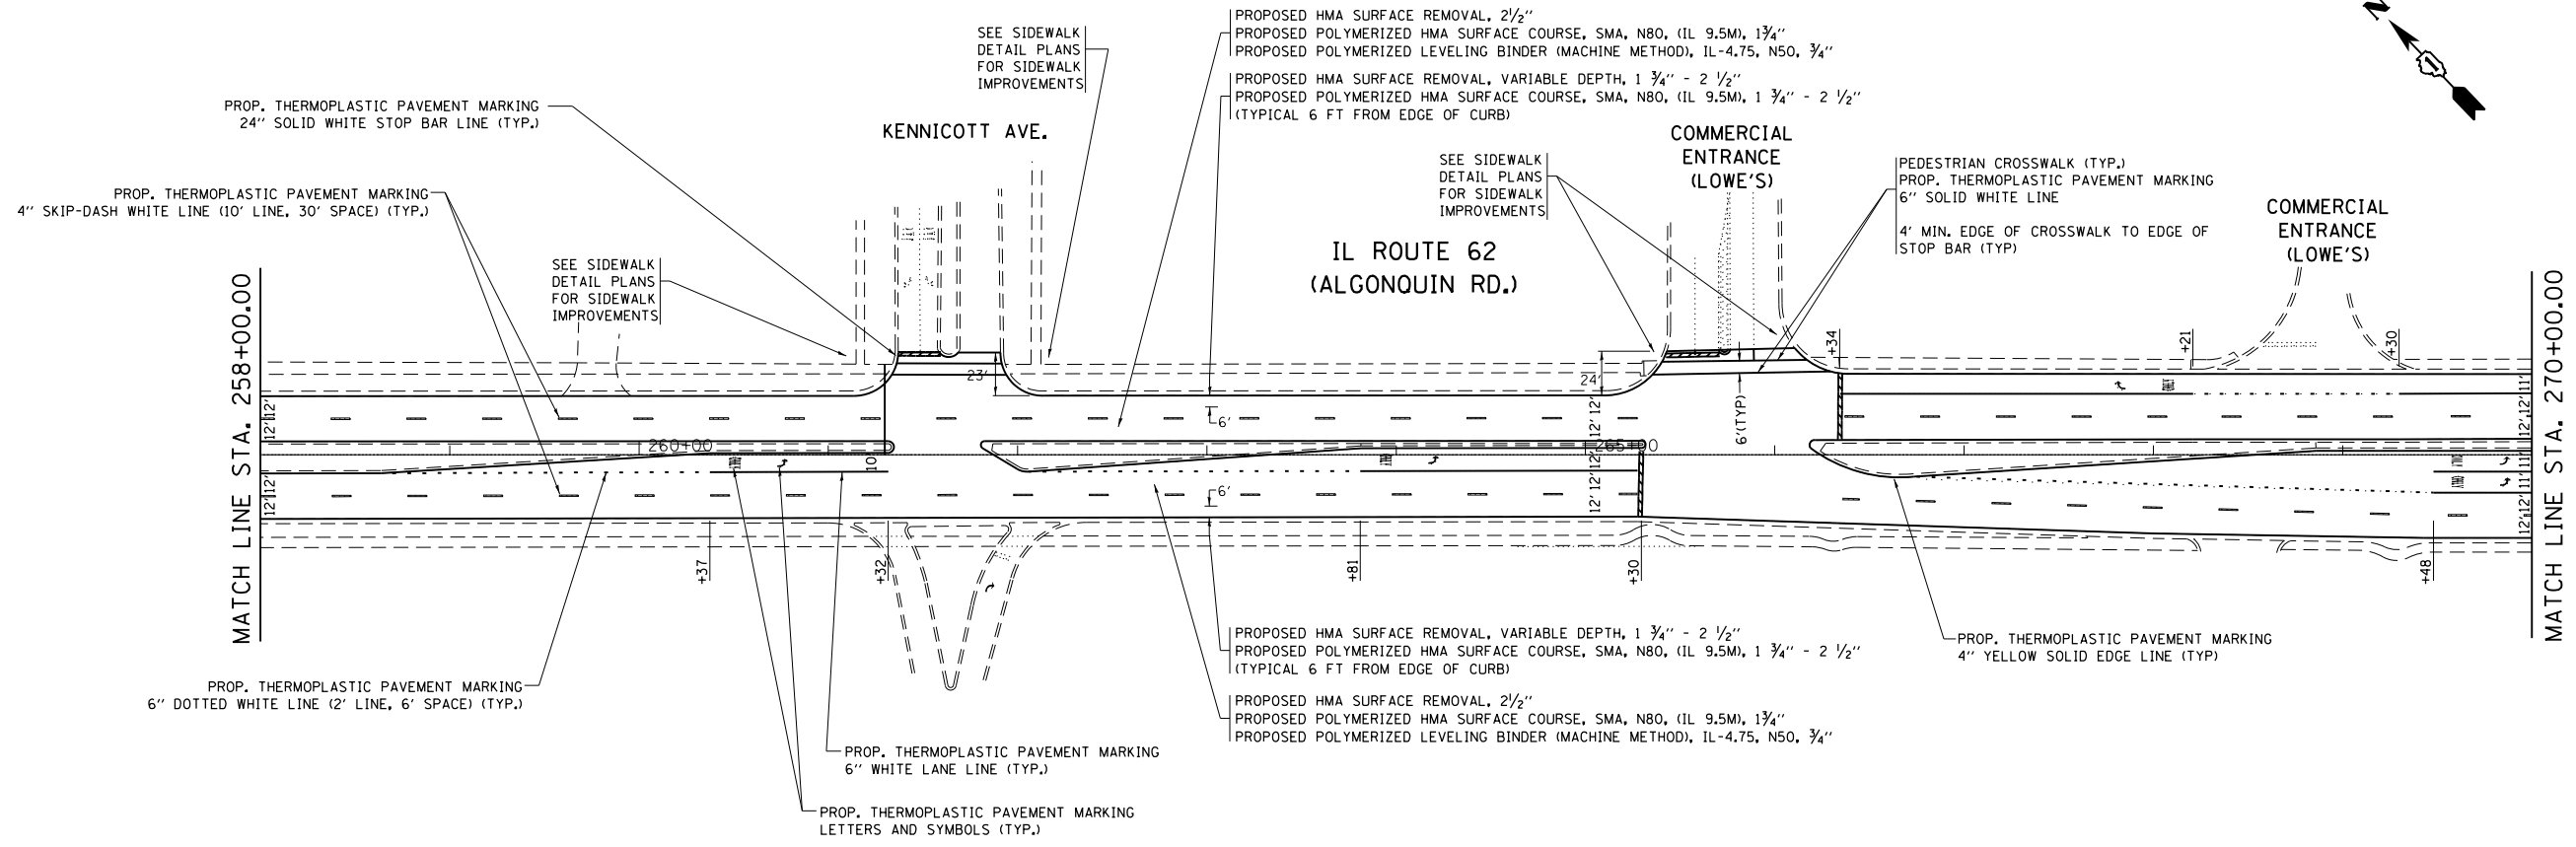


**PROJECT ENDS  
 STA. 276 + 84.5**

|  |                     |            |           |  |  |                           |                 |        |              |           |  |
|--|---------------------|------------|-----------|--|--|---------------------------|-----------------|--------|--------------|-----------|--|
| FILE NAME =  | USER NAME = PencePL | DESIGNED - | REVISED - | <b>STATE OF ILLINOIS<br/>     DEPARTMENT OF TRANSPORTATION</b> | <b>ROADWAY PLAN<br/>     IL RTE. 62 (ALGONQUIN RD.) (E/O ROSELLE RD. TO IL RTE. 58 (GOLF RD.))</b> | F.A.P. RTE.               | SECTION         | COUNTY | TOTAL SHEETS | SHEET NO. |  |
| pw\IL084EBIDINTEG.illinois.gov\PIWIDOT\Documents\IDOT Offices\District 1\Projects\04116\04116-sht-plan.dgn |                     | REVISIONS  | REVISIONS |  |  | 339                       | 116Y(1&2)R-RS-6 | COOK   | 58           | 14        |  |
| PLOT SCALE = 100.0000' / in.   | CHECKED -           | REVISIONS  | REVISIONS |  |  | <b>CONTRACT NO. 62C93</b> |                 |        |              |           |  |
| Default  | DATE -              | REVISIONS  | REVISIONS |  |  | ILLINOIS FED. AID PROJECT |                 |        |              |           |  |

# PLUM GROVE ROAD

NOTE:  
CONTRACTOR SHALL VERIFY ALL LANE WIDTHS PRIOR  
TO PLACING CONCRETE MEDIAN, TYPE SB-6.06

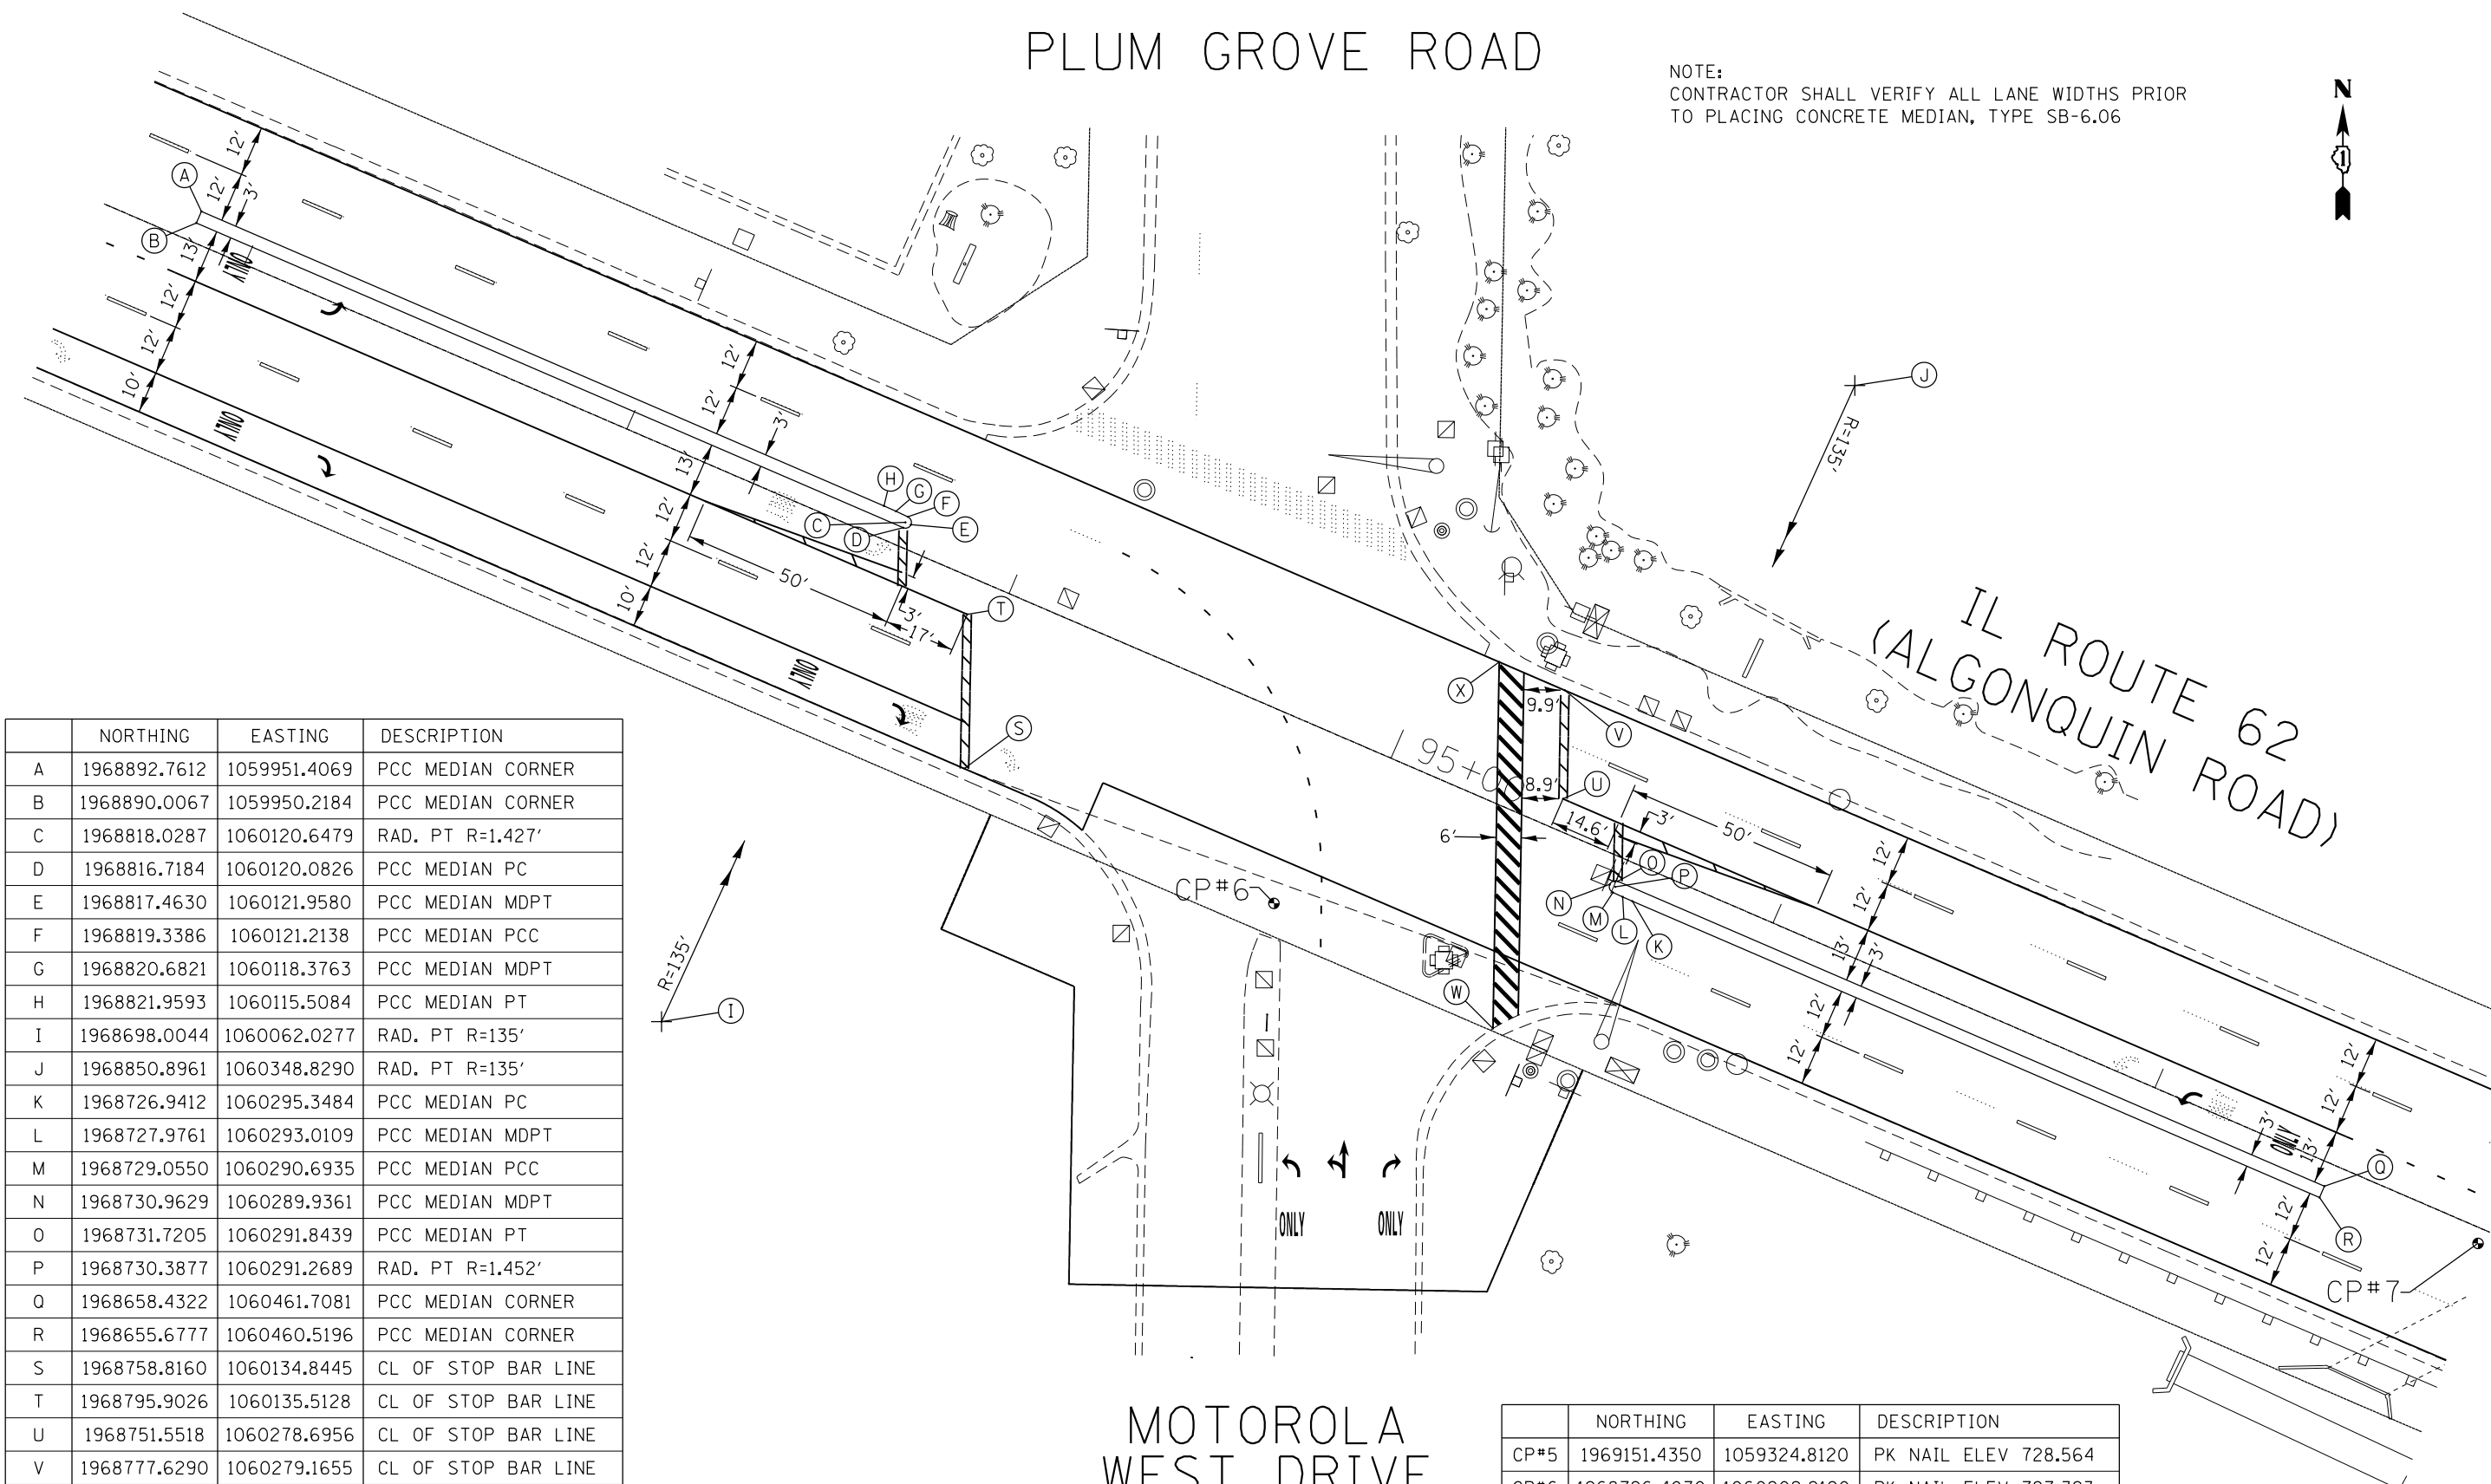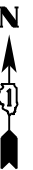



|   | NORTHING     | EASTING      | DESCRIPTION         |
|---|--------------|--------------|---------------------|
| A | 1968892.7612 | 1059951.4069 | PCC MEDIAN CORNER   |
| B | 1968890.0067 | 1059950.2184 | PCC MEDIAN CORNER   |
| C | 1968818.0287 | 1060120.6479 | RAD. PT R=1.427'    |
| D | 1968816.7184 | 1060120.0826 | PCC MEDIAN PC       |
| E | 1968817.4630 | 1060121.9580 | PCC MEDIAN MDPT     |
| F | 1968819.3386 | 1060121.2138 | PCC MEDIAN PCC      |
| G | 1968820.6821 | 1060118.3763 | PCC MEDIAN MDPT     |
| H | 1968821.9593 | 1060115.5084 | PCC MEDIAN PT       |
| I | 1968698.0044 | 1060062.0277 | RAD. PT R=135'      |
| J | 1968850.8961 | 1060348.8290 | RAD. PT R=135'      |
| K | 1968726.9412 | 1060295.3484 | PCC MEDIAN PC       |
| L | 1968727.9761 | 1060293.0109 | PCC MEDIAN MDPT     |
| M | 1968729.0550 | 1060290.6935 | PCC MEDIAN PCC      |
| N | 1968730.9629 | 1060289.9361 | PCC MEDIAN MDPT     |
| O | 1968731.7205 | 1060291.8439 | PCC MEDIAN PT       |
| P | 1968730.3877 | 1060291.2689 | RAD. PT R=1.452'    |
| Q | 1968658.4322 | 1060461.7081 | PCC MEDIAN CORNER   |
| R | 1968655.6777 | 1060460.5196 | PCC MEDIAN CORNER   |
| S | 1968758.8160 | 1060134.8445 | CL OF STOP BAR LINE |
| T | 1968795.9026 | 1060135.5128 | CL OF STOP BAR LINE |
| U | 1968751.5518 | 1060278.6956 | CL OF STOP BAR LINE |
| V | 1968777.6290 | 1060279.1655 | CL OF STOP BAR LINE |
| W | 1968696.3384 | 1060261.8413 | 6" CROSSWALK LINE   |
| X | 1968784.4405 | 1060263.3587 | 6" CROSSWALK LINE   |

|      | NORTHING     | EASTING      | DESCRIPTION          |
|------|--------------|--------------|----------------------|
| CP#5 | 1969151.4350 | 1059324.8120 | PK NAIL ELEV 728.564 |
| CP#6 | 1968726.4070 | 1060209.2120 | PK NAIL ELEV 727.393 |
| CP#7 | 1968644.6670 | 1060498.6170 | PK NAIL ELEV 724.109 |
| CP#8 | 1968297.8800 | 1061144.0970 | PK NAIL ELEV 724.055 |

| IL 62 (ALONGQUIN RD) INTERSECTION | EARTH EXCAVATION | TOPSOIL FURNISH AND PLACE, 4" | NITROGEN FERTILIZER NUTRIENT | PHOSPHORUS FERTILIZER NUTRIENT | POTASSIUM FERTILIZER NUTRIENT | SODDING, SALT TOLERANT | PORTLAND CEMENT CONCRETE SIDEWALK 5 INCH | DETECTABLE WARNINGS | SIDEWALK REMOVAL | CLASS D PATCHES, TYPE II, 12 INCH | MANHOLES TO BE ADJUSTED | REMOVE SIGN PANEL ASSEMBLY - TYPE A | RELOCATE SIGN PANEL ASSEMBLY - TYPE A | REBUILD EXISTING HANDHOLE | COMBINATION CONCRETE CURB AND GUTTER REMOVAL AND REPLACEMENT |
|-----------------------------------|------------------|-------------------------------|------------------------------|--------------------------------|-------------------------------|------------------------|--|---------------------|------------------|-----------------------------------|-------------------------|-------------------------------------|---------------------------------------|---------------------------|--|
|                                   | CU YD            | SQ YD                         | POUND                        | POUND                          | POUND                         | SQ YD                  | SQ FT                                    | SQ FT               | SQ FT            | SQ YD                             | EACH                    | EACH                                | EACH                                  | EACH                      | FOOT   |
|                                   | 20200100         | 21101615                      | 25000400                     | 25000500                       | 25000600                      | 25200110               | 42400200                                 | 42400800            | 44000600         | 44201789                          | 60255500                | 72400100                            | 72400500                              | 89502376                  | Z0004562   |
| QUENTIN RD                        | 6.3              | 43.8                          | 0.9                          | 0.9                            | 0.9                           | 43.8                   | 721.0                                    | 34.0                | 638.0            | 0.0                               | 0.0                     | 0.0                                 | 0.0                                   | 0.0                       | 36.0   |
| PALMER DR                         | 3.0              | 34.0                          | 0.8                          | 0.8                            | 0.8                           | 34.0                   | 331.0                                    | 20.0                | 397.0            | 0.0                               | 0.0                     | 0.0                                 | 0.0                                   | 1.0                       | 35.0   |
| HAMMOND DR                        | 7.8              | 36.1                          | 0.8                          | 0.8                            | 0.8                           | 36.1                   | 540.0                                    | 28.0                | 456.0            | 0.0                               | 1.0                     | 0.0                                 | 0.0                                   | 0.0                       | 42.0   |
| PLUM GROVE RD / WEST DR           | 1.4              | 14.3                          | 0.4                          | 0.4                            | 0.4                           | 14.3                   | 165.0                                    | 22.0                | 180.0            | 0.0                               | 0.0                     | 1.0                                 | 1.0                                   | 0.0                       | 33.0   |
| LINDEN LN                         | 3.0              | 18.6                          | 0.5                          | 0.5                            | 0.5                           | 18.6                   | 410.0                                    | 48.0                | 374.0            | 0.0                               | 1.0                     | 0.0                                 | 0.0                                   | 0.0                       | 51.0   |
| THORNTREE LN / THOREAU DR         | 3.1              | 29.5                          | 0.8                          | 0.8                            | 0.8                           | 29.5                   | 354.0                                    | 47.0                | 329.0            | 0.0                               | 0.0                     | 0.0                                 | 0.0                                   | 1.0                       | 53.0   |
| BARKER AVE                        | 4.8              | 33.9                          | 0.7                          | 0.7                            | 0.7                           | 33.9                   | 434.0                                    | 30.0                | 393.0            | 0.0                               | 0.0                     | 0.0                                 | 0.0                                   | 0.0                       | 28.0   |
| CARRIAGE WAY DR/ ESSEX WAY        | 2.2              | 25.3                          | 0.7                          | 0.7                            | 0.7                           | 25.3                   | 495.0                                    | 84.0                | 462.0            | 0.0                               | 0.0                     | 0.0                                 | 0.0                                   | 1.0                       | 91.0   |
| KEYSTONE CT                       | 1.7              | 29.2                          | 0.6                          | 0.6                            | 0.6                           | 29.2                   | 392.0                                    | 33.0                | 358.0            | 0.0                               | 1.0                     | 0.0                                 | 0.0                                   | 0.0                       | 39.0   |
| MEADOWBROOK CT                    | 1.2              | 11.9                          | 0.3                          | 0.3                            | 0.3                           | 11.9                   | 190.0                                    | 29.0                | 190.0            | 10.0                              | 0.0                     | 0.0                                 | 0.0                                   | 0.0                       | 30.0   |
| WEBER DR                          | 2.8              | 32.2                          | 0.7                          | 0.7                            | 0.7                           | 32.2                   | 483.0                                    | 40.0                | 469.0            | 0.0                               | 0.0                     | 0.0                                 | 0.0                                   | 2.0                       | 57.0   |
| NEW WILKE RD                      | 7.2              | 60.7                          | 1.3                          | 1.3                            | 1.3                           | 60.7                   | 1111.0                                   | 110.0               | 1042.0           | 0.0                               | 2.0                     | 0.0                                 | 0.0                                   | 3.0                       | 100.0  |
| MERIDIAN PARKING                  | 1.1              | 13.8                          | 0.3                          | 0.3                            | 0.3                           | 13.8                   | 189.0                                    | 39.0                | 210.0            | 0.0                               | 0.0                     | 0.0                                 | 0.0                                   | 0.0                       | 42.0   |
| KENNICOTT AVE                     | 4.3              | 38.4                          | 0.8                          | 0.8                            | 0.8                           | 38.4                   | 515.0                                    | 20.0                | 456.0            | 0.0                               | 0.0                     | 0.0                                 | 0.0                                   | 0.0                       | 33.0   |
| LOWES PARKING NORTH               | 1.1              | 13.0                          | 0.4                          | 0.4                            | 0.4                           | 13.0                   | 213.0                                    | 38.0                | 183.0            | 0.0                               | 0.0                     | 0.0                                 | 0.0                                   | 0.0                       | 39.0   |
| LOWES PARKING SOUTH               | 1.2              | 23.3                          | 0.5                          | 0.5                            | 0.5                           | 23.3                   | 360.0                                    | 24.0                | 359.0            | 0.0                               | 0.0                     | 0.0                                 | 0.0                                   | 0.0                       | 99.0   |
| GOLF RD                           | 0.6              | 15.2                          | 0.3                          | 0.3                            | 0.3                           | 15.2                   | 184.0                                    | 20.0                | 184.0            | 0.0                               | 0.0                     | 0.0                                 | 0.0                                   | 0.0                       | 15.0   |
| TOTAL                             | 52.8             | 473.2                         | 10.8                         | 10.8                           | 10.8                          | 473.2                  | 7087                                     | 666                 | 6680             | 10                                | 5                       | 1                                   | 1                                     | 8                         | 823  |

NOTE: RESTORATION (SODDING, NUTRIENTS AND TOPSOIL) LIMITS ARE SHOWN ON THE SITE PLANS WHEN SIDEWALK IS REMOVED AND REPLACED WITH SOD. HOWEVER, FOR RESTORATION AROUND NEW SIDEWALK, QUANTITY HAS BEEN PROVIDED BUT IS NOT SHOWN ON THE SITE PLANS.



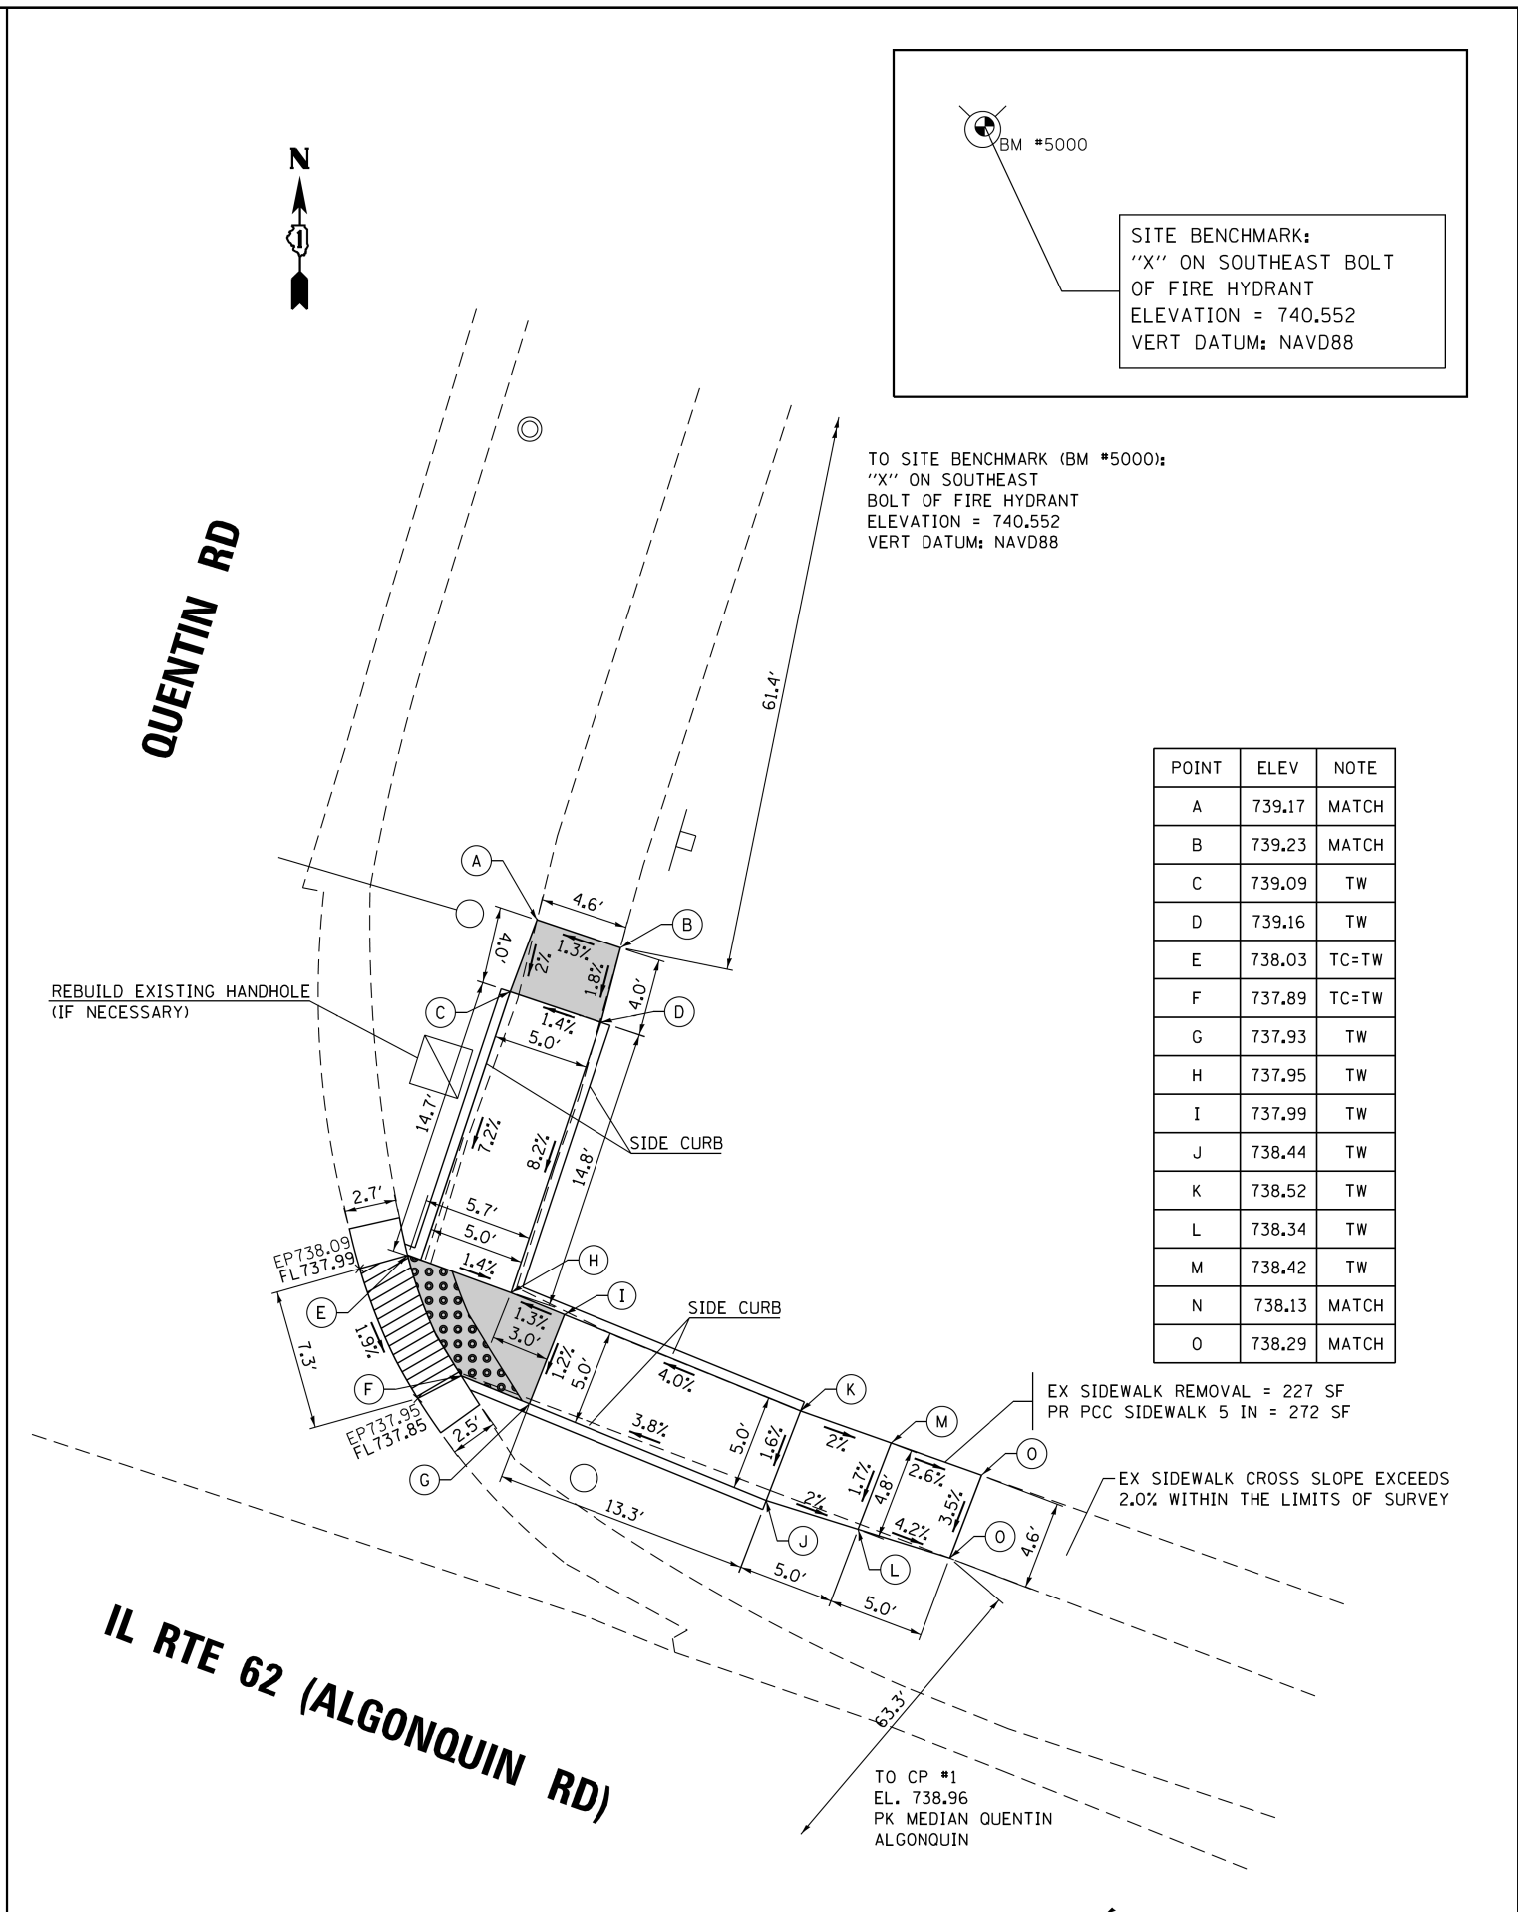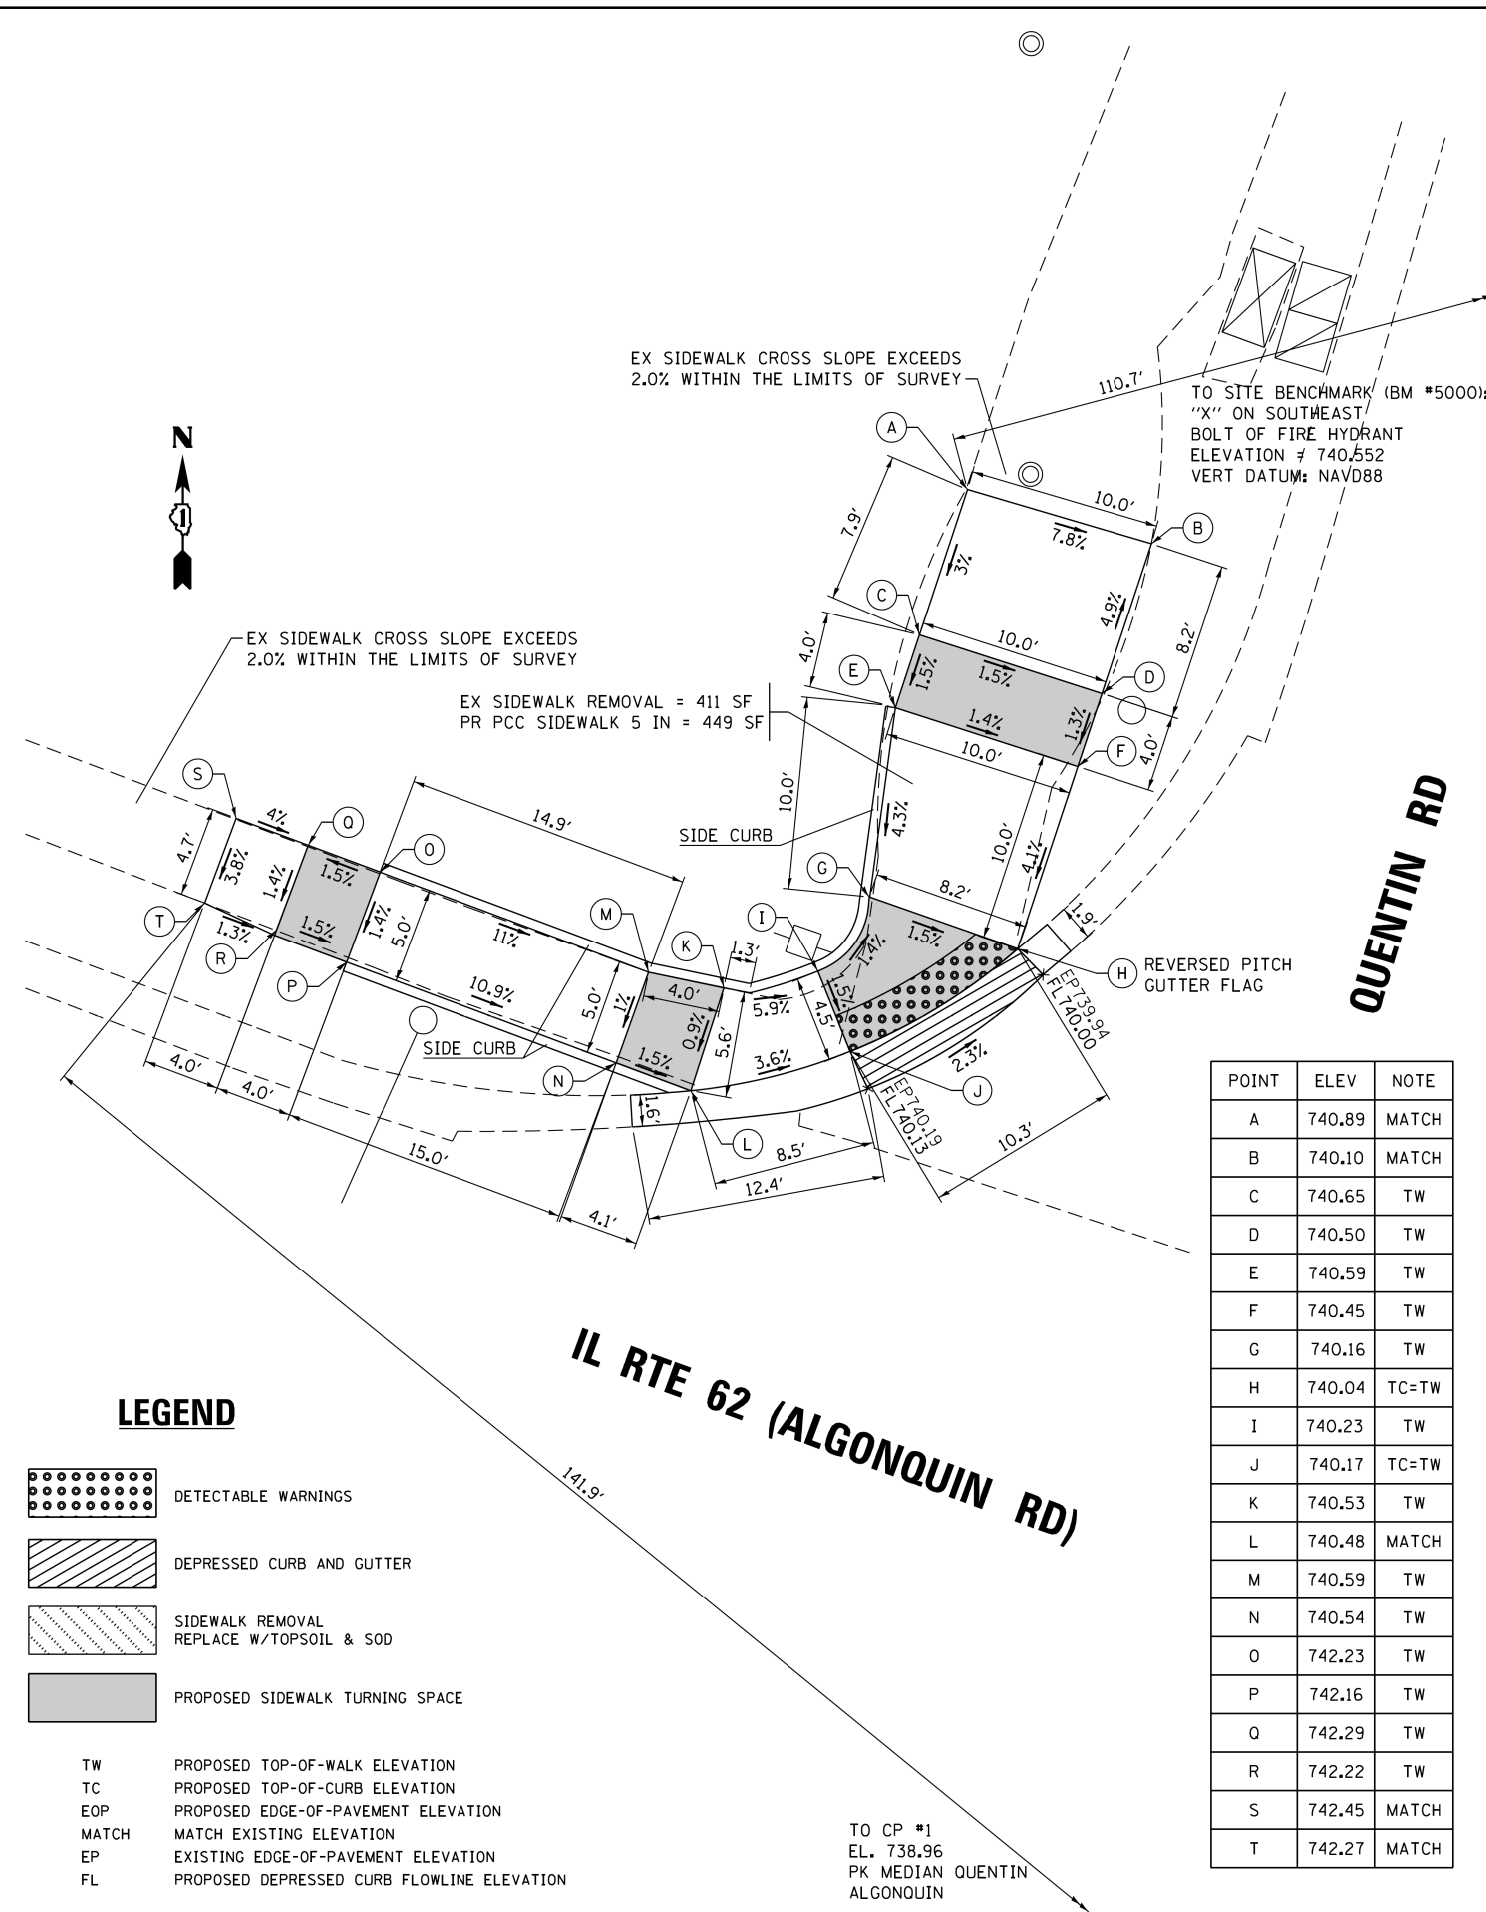

**LEGEND**

- DETECTABLE WARNINGS
- DEPRESSED CURB AND GUTTER
- SIDEWALK REMOVAL  
REPLACE W/TOPSOIL & SOD
- PROPOSED SIDEWALK TURNING SPACE
- TW PROPOSED TOP-OF-WALK ELEVATION
- TC PROPOSED TOP-OF-CURB ELEVATION
- EOP PROPOSED EDGE-OF-PAVEMENT ELEVATION
- MATCH MATCH EXISTING ELEVATION
- EP EXISTING EDGE-OF-PAVEMENT ELEVATION
- FL PROPOSED DEPRESSED CURB FLOWLINE ELEVATION

|                                  |                             |            |           |
|----------------------------------|-----------------------------|------------|-----------|
| FILE NAME = 62C93-sht-plan01.dgn | USER NAME = Dwhite          | DESIGNED - | REVISED - |
| Default                          |                             | DRAWN -    | REVISED - |
|                                  | PLOT SCALE = 10.0000' / in. | CHECKED -  | REVISED - |
|                                  | PLOT DATE = 10/19/2016      | DATE -     | REVISED - |

**STATE OF ILLINOIS  
DEPARTMENT OF TRANSPORTATION**

**SIDEWALK DETAIL PLAN  
IL ROUTE 62 (ALGONQUIN ROAD) AT QUENTIN ROAD**





SCALE: 1" = 5'    SHEET    OF    SHEETS    STA.    TO    STA.

|                           |                         |             |                 |              |
|---------------------------|-------------------------|-------------|-----------------|--------------|
| F.A.P. RTE. 339           | SECTION 116Y(1&2)R-R5-6 | COUNTY COOK | TOTAL SHEETS 58 | SHEET NO. 17 |
| CONTRACT NO. 62C93        |                         |             |                 |              |
| ILLINOIS FED. AID PROJECT |                         |             |                 |              |

IL RTE 62 (ALGONQUIN RD)



**LEGEND**

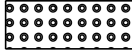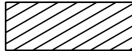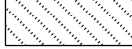
-  DETECTABLE WARNINGS
-  DEPRESSED CURB AND GUTTER
-  SIDEWALK REMOVAL  
REPLACE W/TOPSOIL & SOD
-  PROPOSED SIDEWALK TURNING SPACE
  
- TW PROPOSED TOP-OF-WALK ELEVATION
- TC PROPOSED TOP-OF-CURB ELEVATION
- EOP PROPOSED EDGE-OF-PAVEMENT ELEVATION
- MATCH MATCH EXISTING ELEVATION
- EP EXISTING EDGE-OF-PAVEMENT ELEVATION
- FL PROPOSED DEPRESSED CURB FLOWLINE ELEVATION

| POINT | ELEV   | NOTE  |
|-------|--------|-------|
| A     | 730.90 | MATCH |
| B     | 731.02 | MATCH |
| C     | 730.86 | TW    |
| D     | 730.91 | TW    |
| E     | 730.79 | TW    |
| F     | 730.84 | TW    |
| G     | 730.18 | TW    |
| H     | 730.26 | TW    |
| I     | 730.10 | TW    |
| J     | 730.18 | TW    |
| K     | 729.80 | TC=TW |
| L     | 729.88 | TW    |
| M     | 729.85 | TC=TW |
| N     | 730.95 | TW    |
| O     | 730.88 | TW    |
| P     | 731.03 | TW    |
| Q     | 730.95 | TW    |
| R     | 731.20 | MATCH |
| S     | 731.03 | MATCH |
| T     | 729.54 | TC=TW |
| U     | 729.78 | TC=TW |
| V     | 729.64 | TW    |
| W     | 729.82 | TW    |
| X     | 729.92 | TW    |
| Y     | 729.86 | MATCH |
| Z     | 730.02 | MATCH |

EX SIDEWALK CROSS SLOPE EXCEEDS 2.0% WITHIN THE LIMITS OF SURVEY

EX SIDEWALK REMOVAL = 334 SF  
PR PCC SIDEWALK 5 IN = 256 SF

EX SIDEWALK REMOVAL = 63 SF  
PR PCC SIDEWALK 5 IN = 75 SF

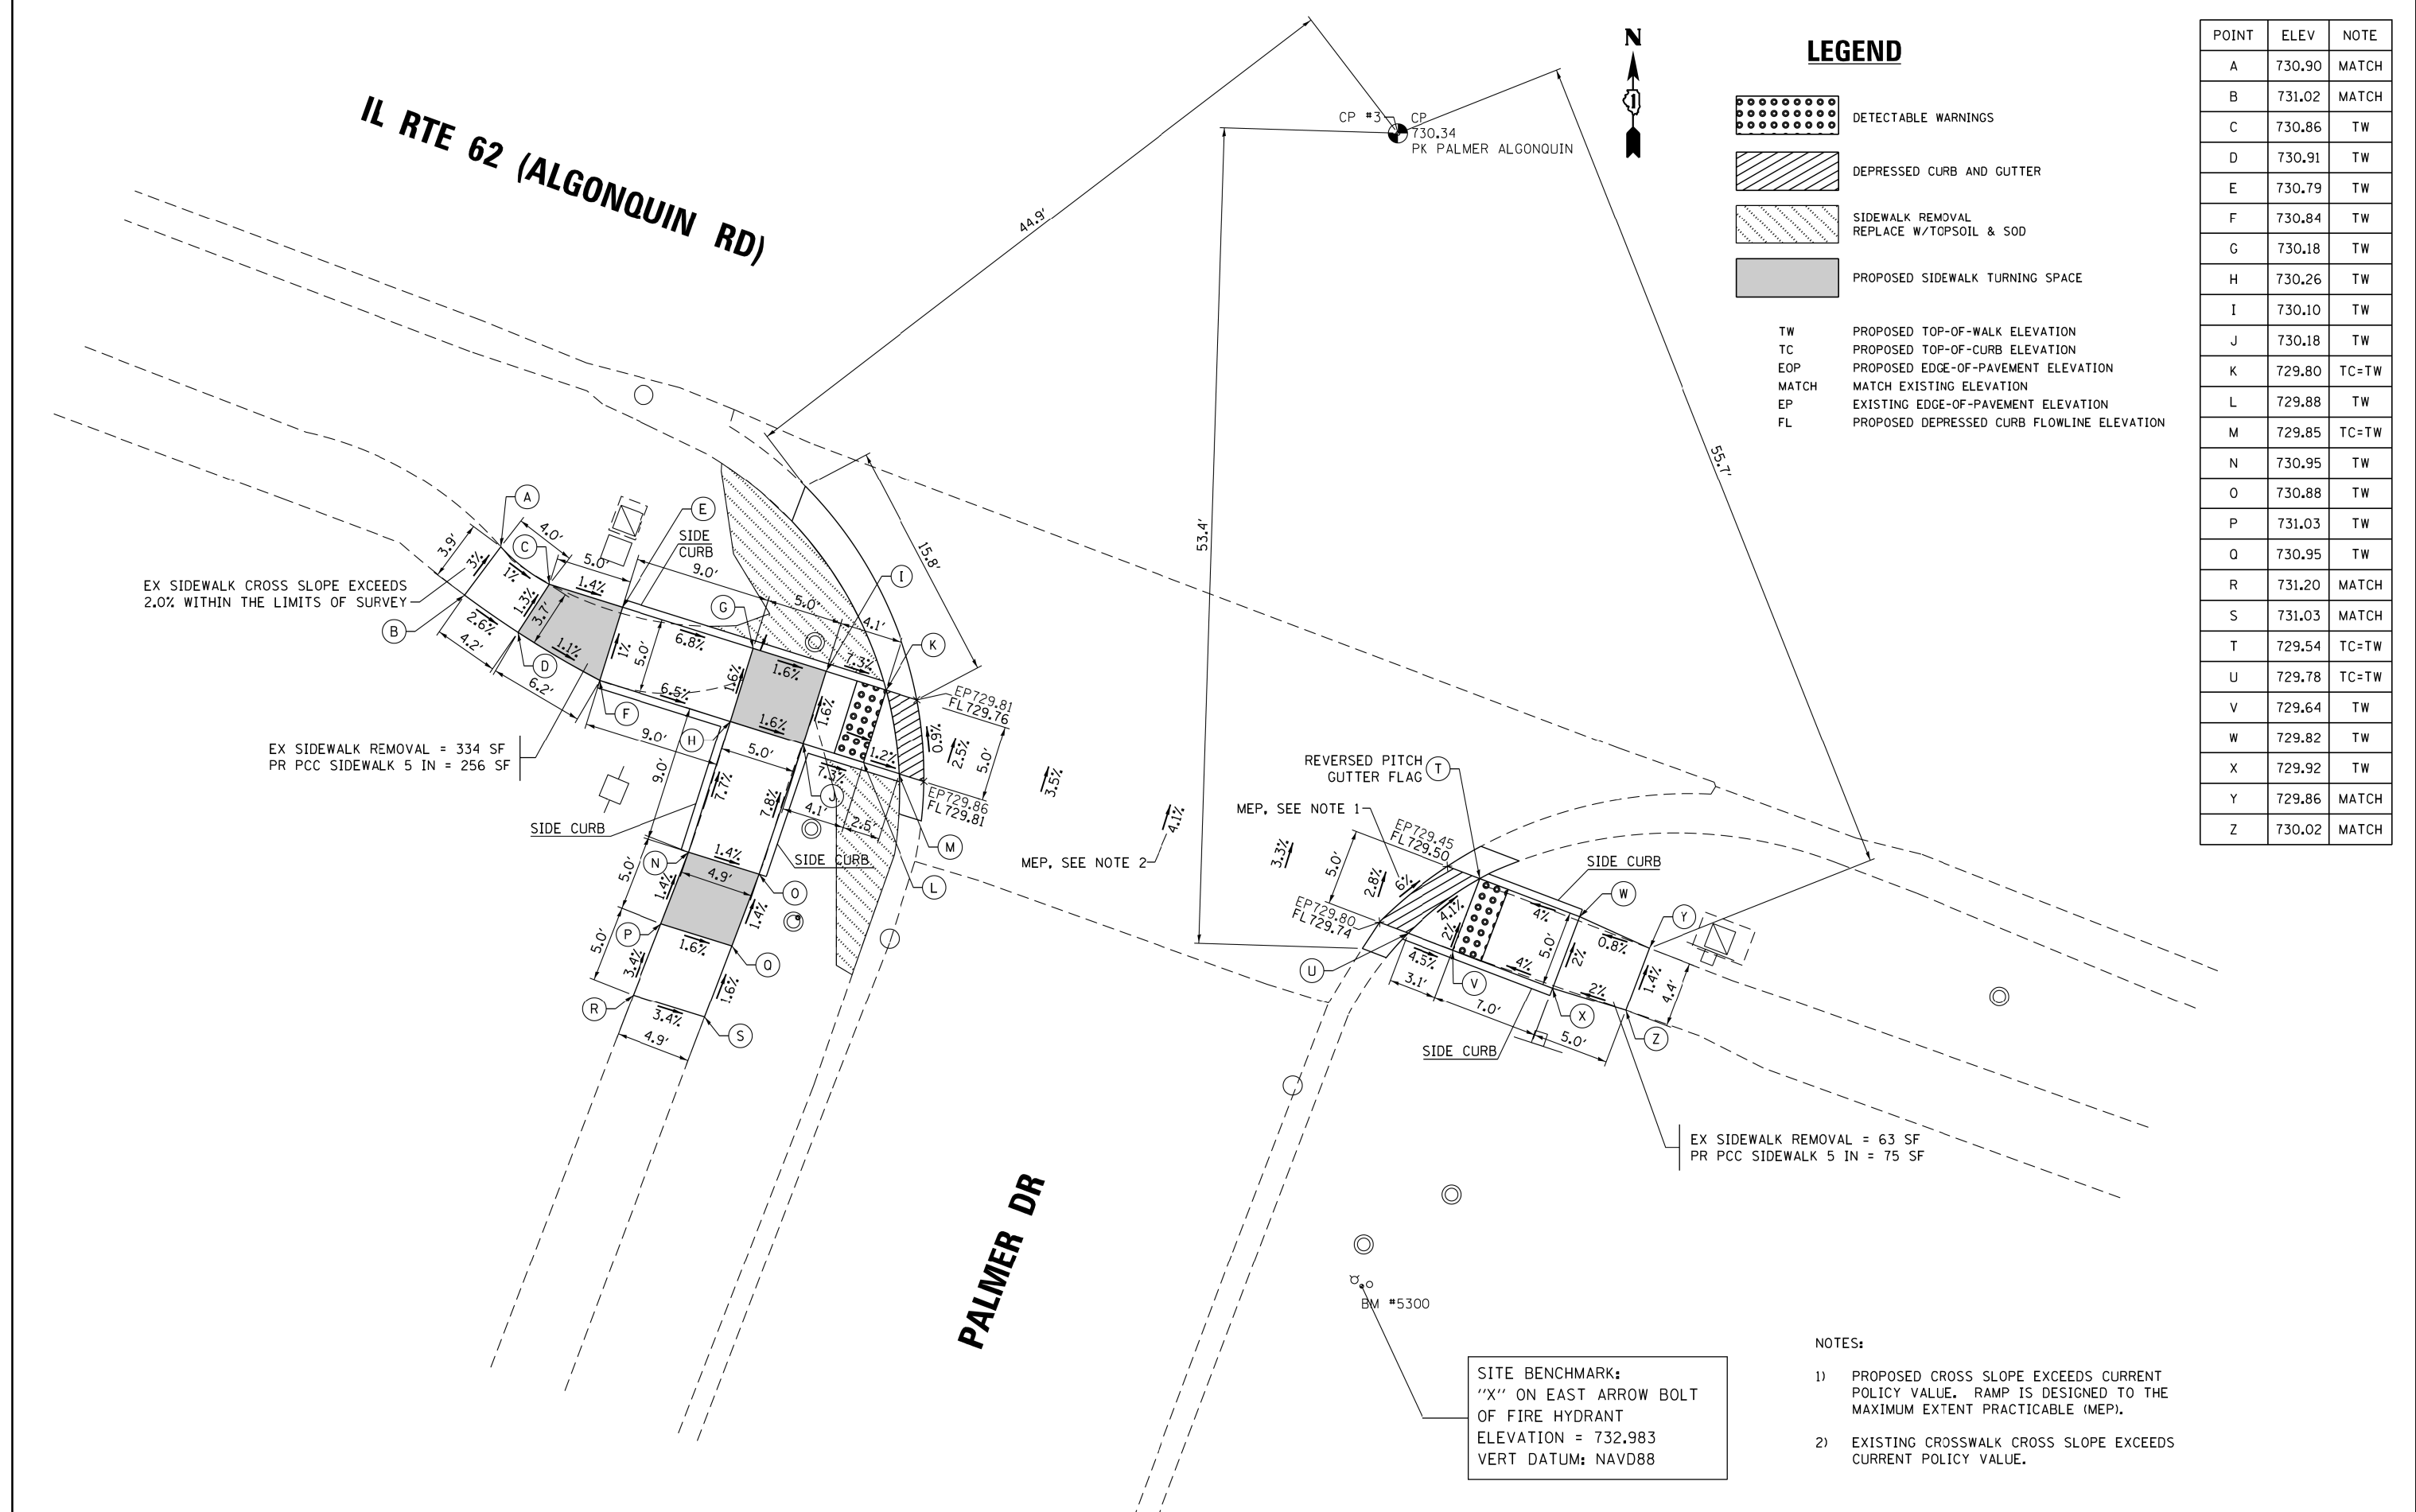

STATE OF ILLINOIS  
DEPARTMENT OF TRANSPORTATION

**SIDEWALK DETAIL PLAN**  
IL ROUTE 62 (ALGONQUIN ROAD) AT PALMER DRIVE

| F.A.P. RTE. | SECTION         | COUNTY | TOTAL SHEETS | SHEET NO. |
|-------------|-----------------|--------|--------------|-----------|
| 339         | 116Y(1&2)R-R5-6 | COOK   | 58           | 18        |

CONTRACT NO. 62C93

| FILE NAME =          | USER NAME = | DESIGNED - | REVISED - |
|----------------------|-------------|------------|-----------|
| 62C93-sht-plan02.dgn | Dwhite      | -          | -         |
| Default              |             | DRAWN -    | REVISED - |
|                      |             | CHECKED -  | REVISED - |
|                      |             | DATE -     | REVISED - |

SCALE: 1" = 5'    SHEET    OF    SHEETS    STA.    TO    STA.

**NOTES:**

- 1) PROPOSED CROSS SLOPE EXCEEDS CURRENT POLICY VALUE. RAMP IS DESIGNED TO THE MAXIMUM EXTENT PRACTICABLE (MEP).
- 2) EXISTING CROSSWALK CROSS SLOPE EXCEEDS CURRENT POLICY VALUE.


SITE BENCHMARK:  
"X" ON EAST ARROW BOLT  
OF FIRE HYDRANT  
ELEVATION = 732.983  
VERT DATUM: NAVD88

### LEGEND

- DETECTABLE WARNINGS
- DEPRESSED CURB AND GUTTER
- SIDEWALK REMOVAL  
REPLACE W/TOPSOIL & 50D
- PROPOSED SIDEWALK TURNING SPACE

- TW PROPOSED TOP-OF-WALK ELEVATION
- TC PROPOSED TOP-OF-CURB ELEVATION
- EOP PROPOSED EDGE-OF-PAVEMENT ELEVATION
- MATCH MATCH EXISTING ELEVATION
- EP EXISTING EDGE-OF-PAVEMENT ELEVATION
- FL PROPOSED DEPRESSED CURB FLOWLINE ELEVATION

| POINT | ELEV   | NOTE     |
|-------|--------|----------|
| A     | 730.79 | MATCH    |
| B     | 730.88 | MATCH    |
| C     | 730.72 | TW       |
| D     | 730.80 | TW       |
| E     | 729.62 | TW       |
| F     | 729.70 | TW       |
| G     | 729.57 | TW=TC    |
| H     | 729.61 | TW       |
| I     | 729.90 | TW       |
| J     | 729.82 | TW       |
| K     | 730.26 | MATCH    |
| L     | 730.06 | MATCH    |
| M     |        | NOT USED |
| N     | 730.78 | MATCH    |
| O     | 730.52 | MATCH    |
| P     | 730.64 | TW       |
| Q     | 730.59 | TW       |
| R     | 730.55 | TW       |
| S     | 730.50 | TW       |
| T     | 729.60 | TC=TW    |
| U     | 729.69 | TW       |
| V     | 729.57 | TC=TW    |
| W     | 729.64 | TW       |
| X     | 729.62 | TW       |
| Y     | 729.74 | TW       |
| Z     | 729.69 | TW       |
| AA    | 730.40 | TW       |
| AB    | 730.45 | TW       |
| AC    | 730.41 | TW       |
| AD    | 730.43 | TW       |
| AE    | 730.48 | MATCH    |
| AF    | 730.63 | MATCH    |

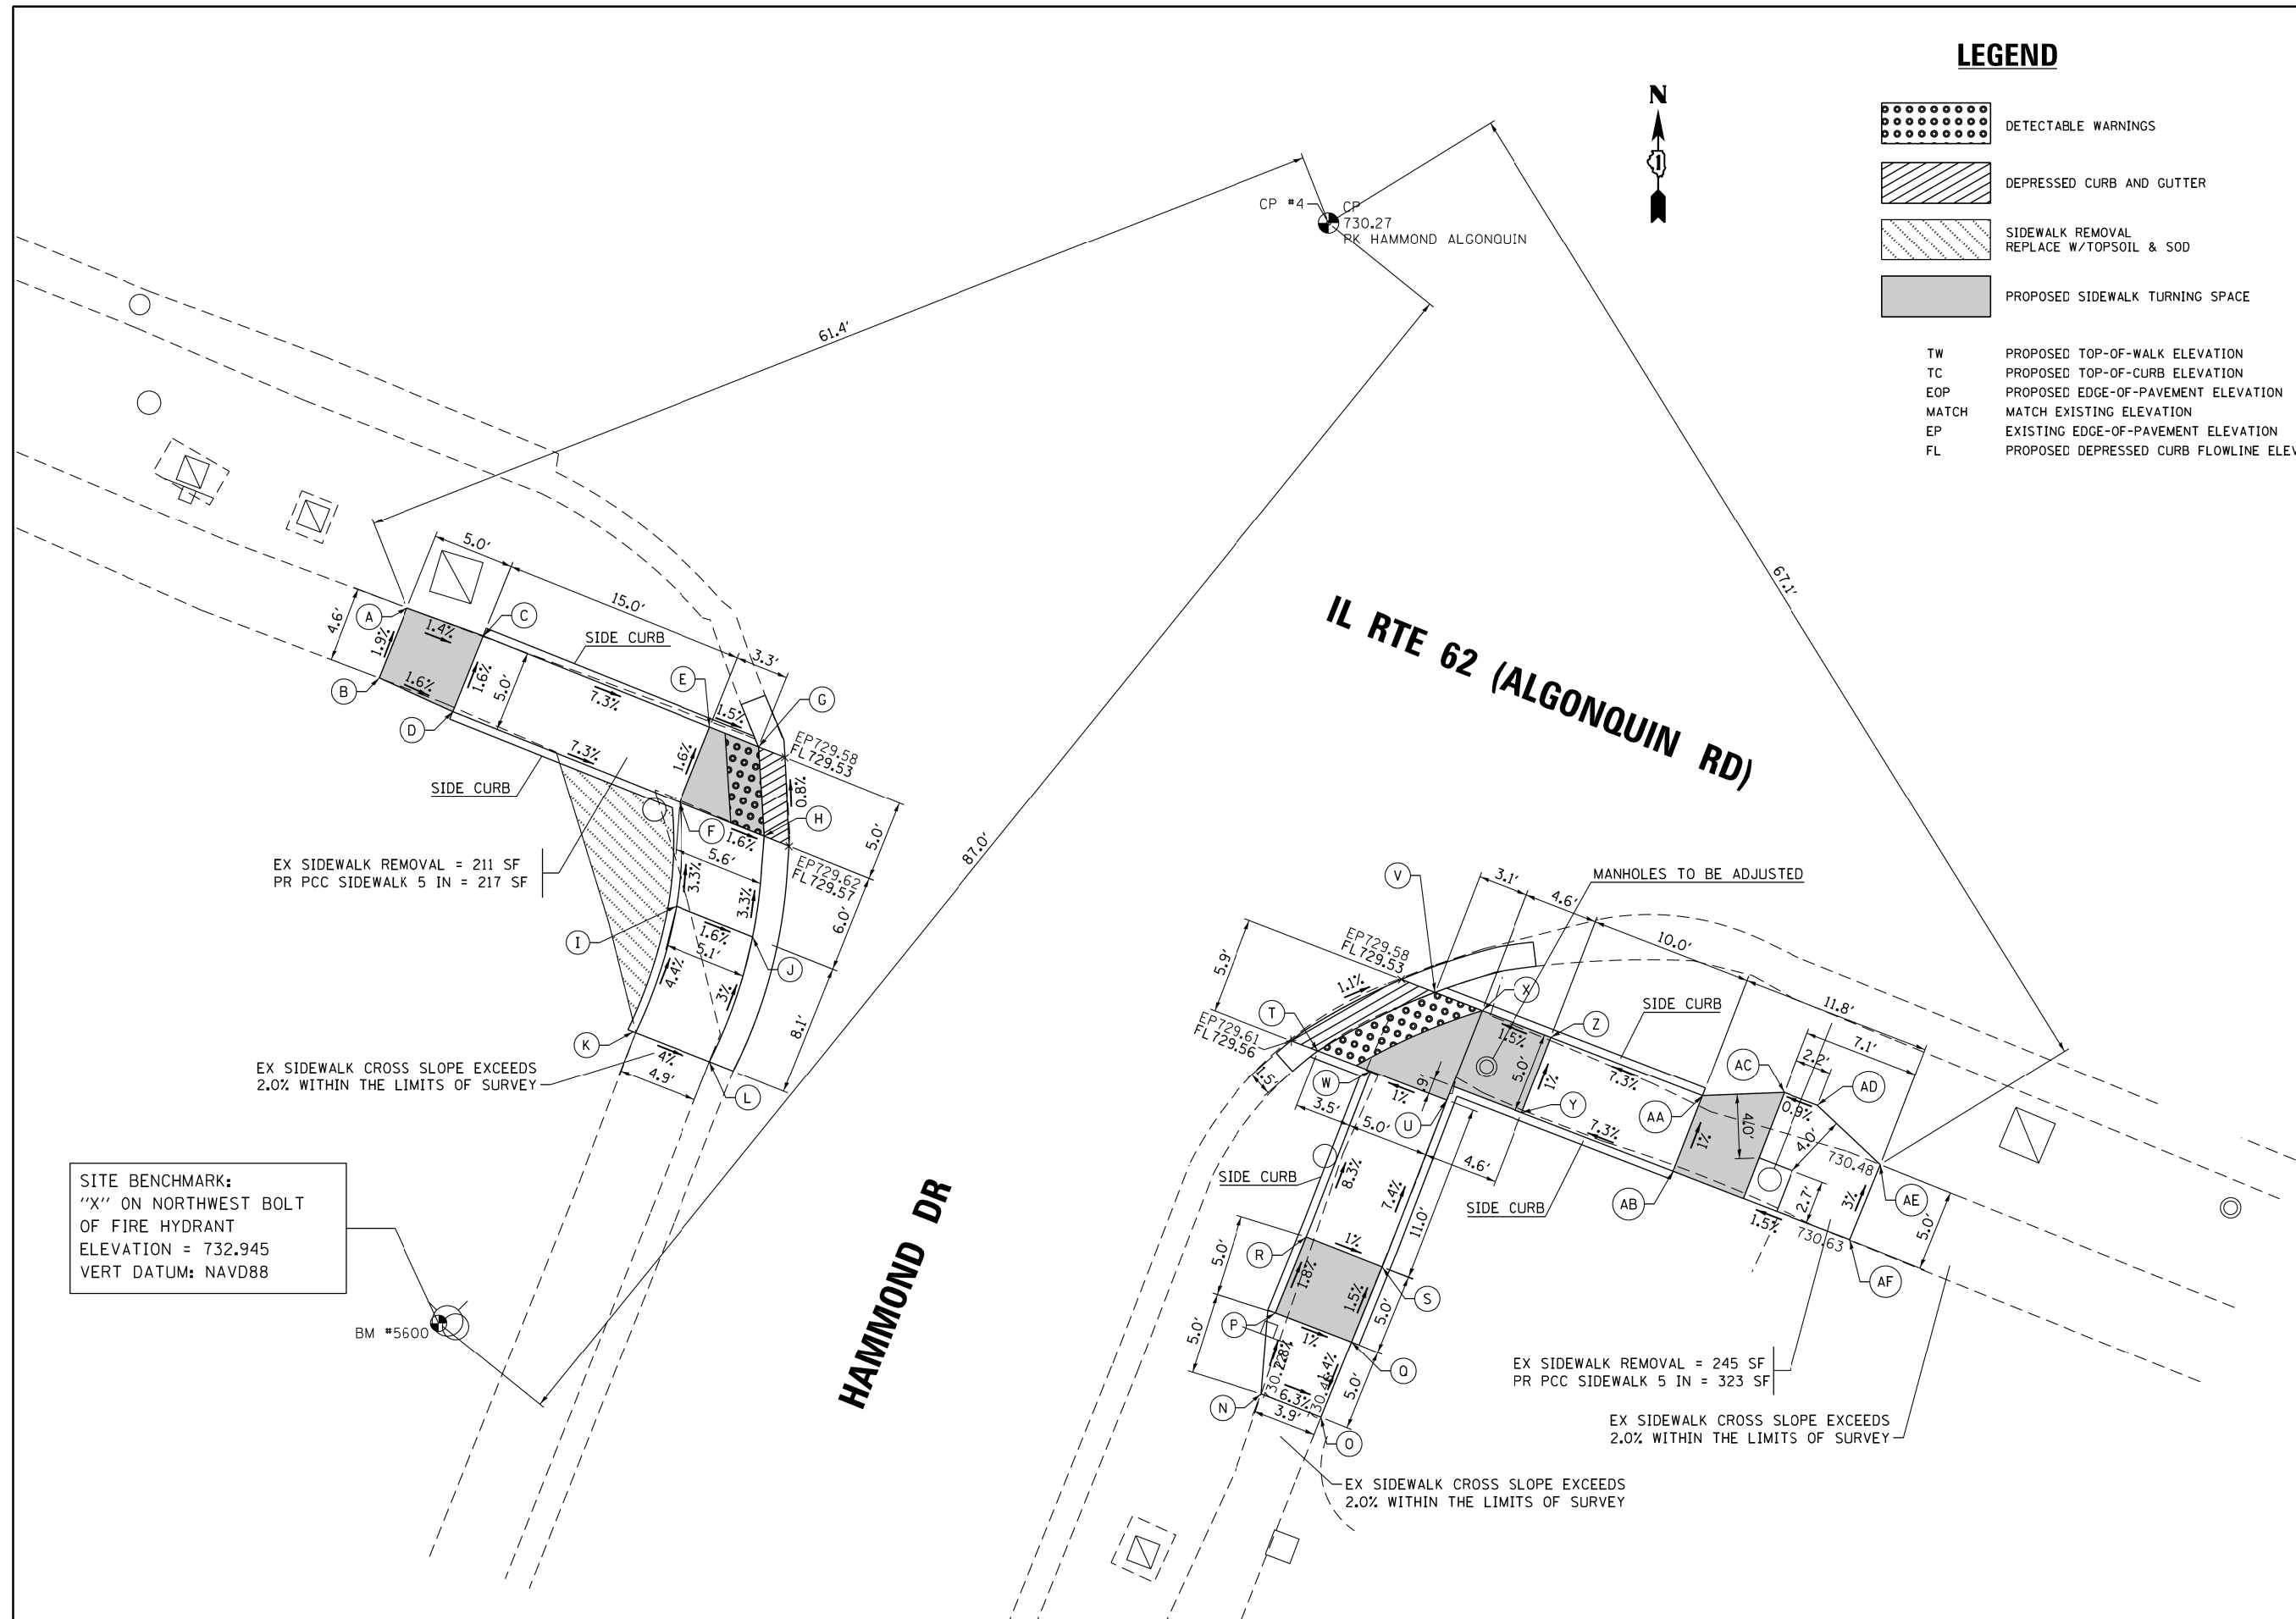

SITE BENCHMARK:  
"X" ON NORTHWEST BOLT  
OF FIRE HYDRANT  
ELEVATION = 732.945  
VERT DATUM: NAVD88

EX SIDEWALK REMOVAL = 211 SF  
PR PCC SIDEWALK 5 IN = 217 SF

EX SIDEWALK CROSS SLOPE EXCEEDS  
2.0% WITHIN THE LIMITS OF SURVEY

EX SIDEWALK REMOVAL = 245 SF  
PR PCC SIDEWALK 5 IN = 323 SF

EX SIDEWALK CROSS SLOPE EXCEEDS  
2.0% WITHIN THE LIMITS OF SURVEY

EX SIDEWALK CROSS SLOPE EXCEEDS  
2.0% WITHIN THE LIMITS OF SURVEY



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|----------------------------------|-----------------------------|------------|-----------|
| FILE NAME = 62C93-sht-plan03.dgn | USER NAME = Dwhite          | DESIGNED - | REVISED - |
|                                  |                             | DRAWN -    | REVISED - |
|                                  | PLOT SCALE = 10.0000' / in. | CHECKED -  | REVISED - |
|                                  | PLOT DATE = 10/19/2016      | DATE -     | REVISED - |

**STATE OF ILLINOIS  
DEPARTMENT OF TRANSPORTATION**

**SIDEWALK DETAIL PLAN  
IL ROUTE 62 (ALGONQUIN ROAD) AT HAMMOND DRIVE**

SCALE: 1" = 5'    SHEET OF SHEETS    STA. TO STA.

|                           |                         |             |                 |              |
|---------------------------|-------------------------|-------------|-----------------|--------------|
| F.A.P. RTE. 339           | SECTION 116Y(1&2)R-R5-6 | COUNTY COOK | TOTAL SHEETS 58 | SHEET NO. 19 |
| CONTRACT NO. 62C93        |                         |             |                 |              |
| ILLINOIS FED. AID PROJECT |                         |             |                 |              |

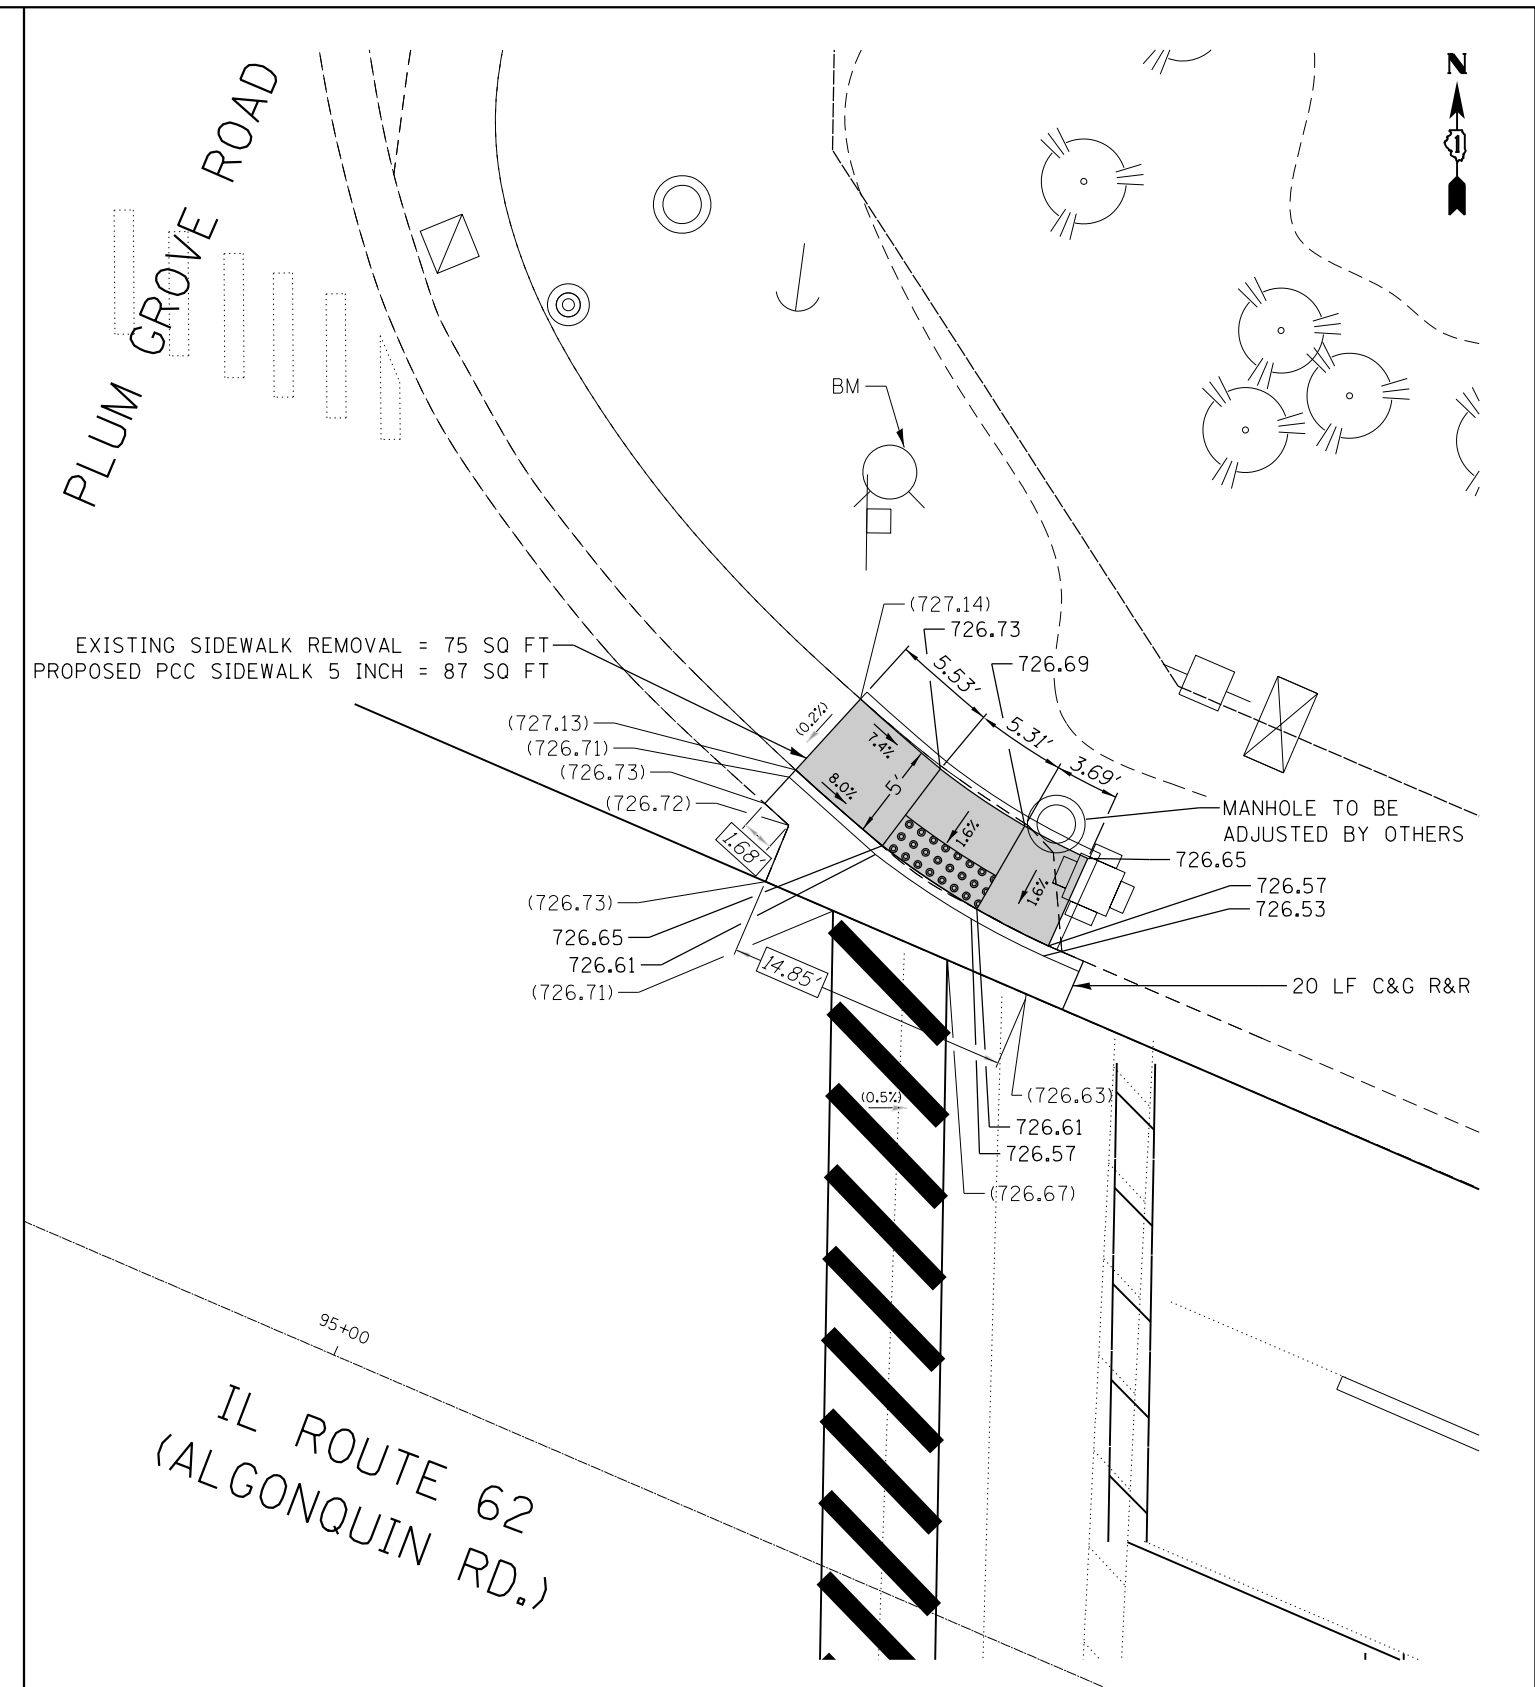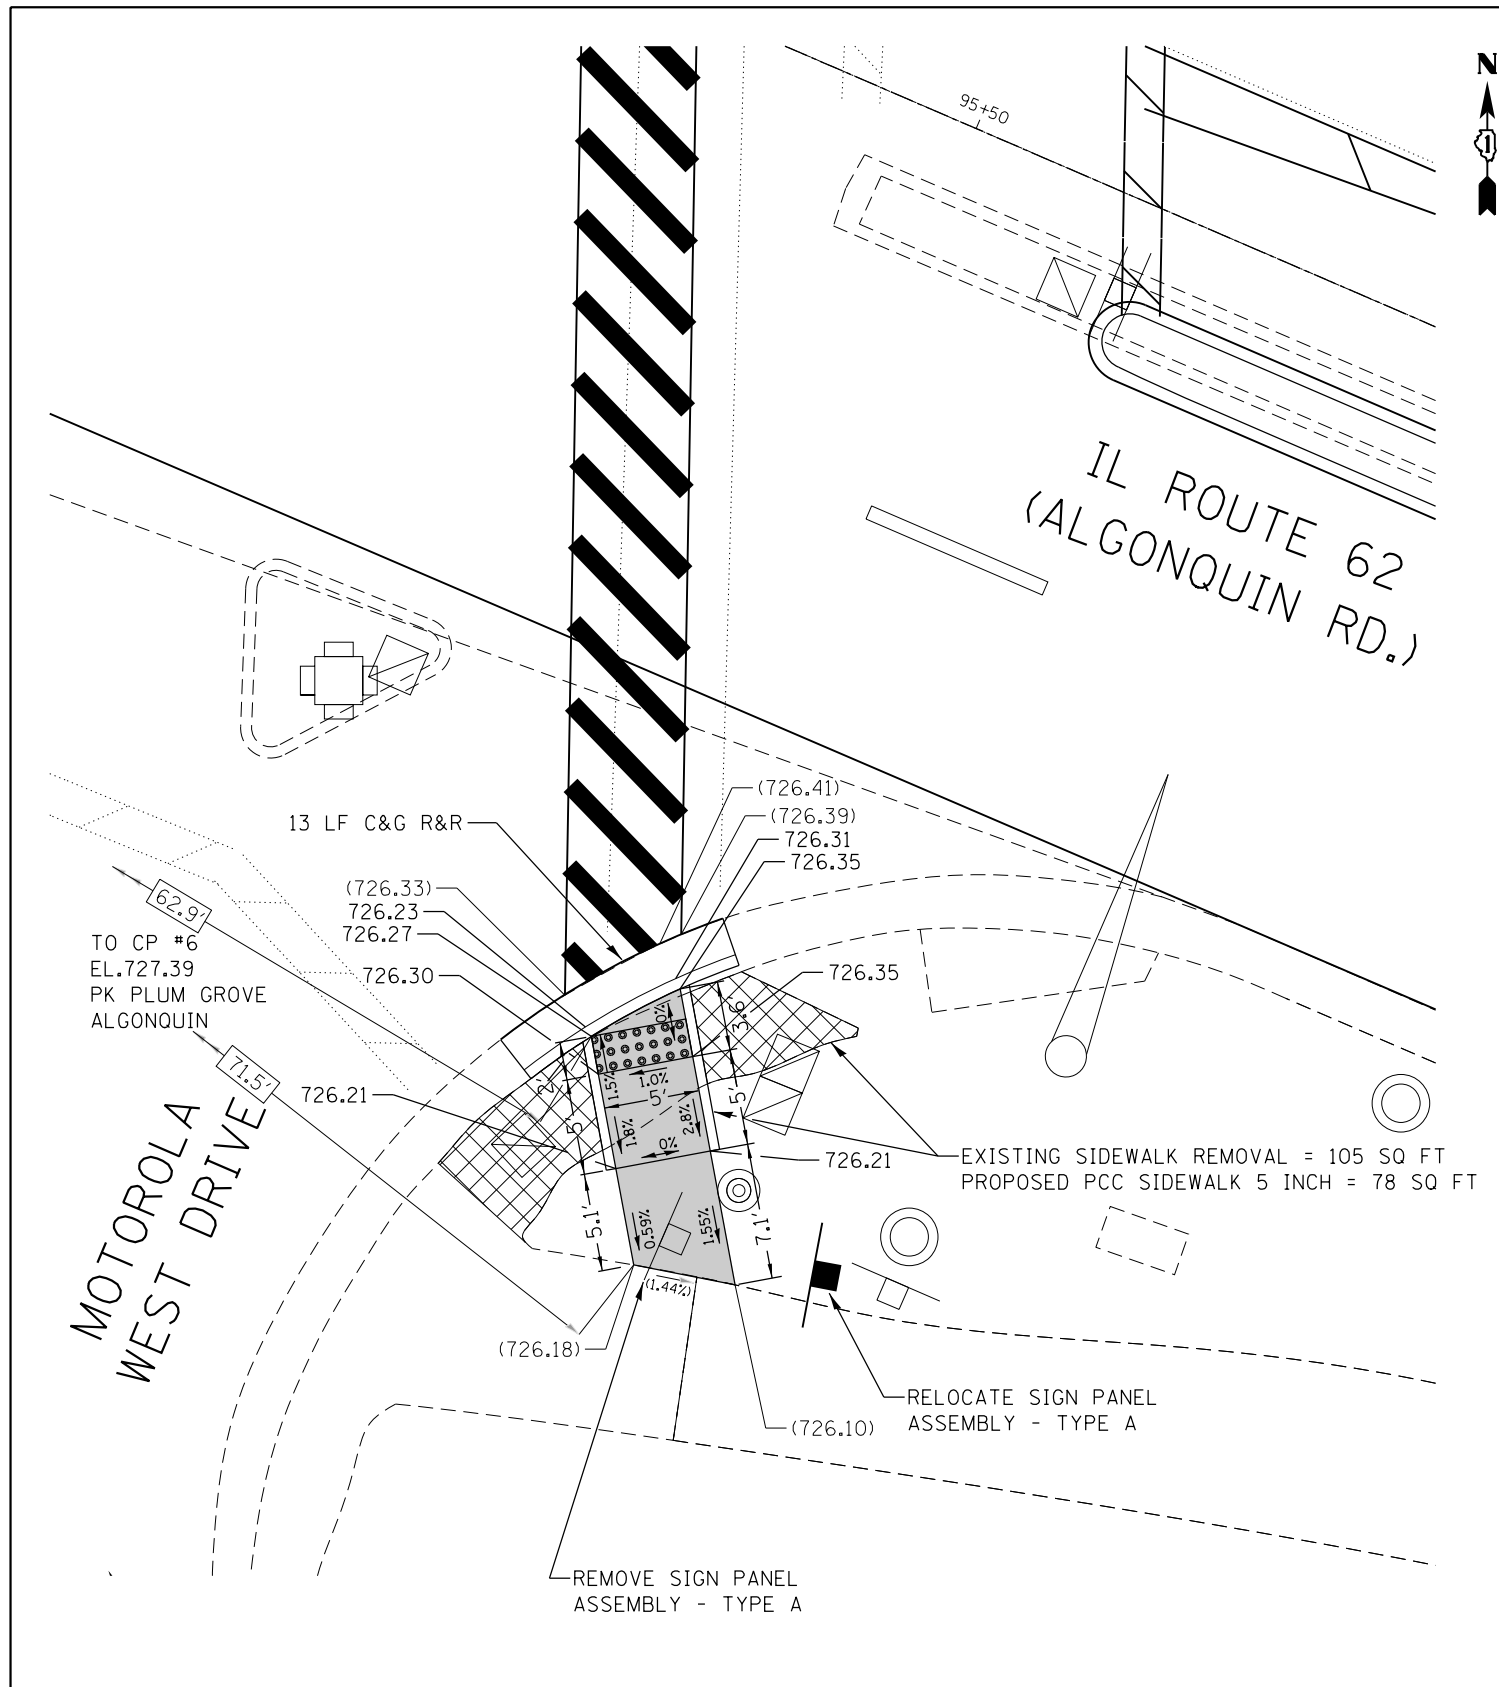

REFERENCE BENCHMARK ELEV 728.327 (NAVD88)  
 BENCHMARK : "X" CUT ON WEST BOLT OF FIRE HYDRANT  
 LOCATION : ON SOUTH WEST CORNER OF IL 62(ALGONQUIN RD) AND PLUM GROVE RD

**LEGEND**

- xx.xx' EXISTING LENGTH
- PROPOSED SIDE CURB
- ( ) EXISTING ELEVATION/SLOPE
- PROPOSED SIDEWALK
- DETECTABLE WARNINGS
- SIDEWALK REMOVAL REPLACE W/TOPSOIL & SOD

REFERENCE BENCHMARK ELEV 730.123 (NAVD88)  
 BENCHMARK : "X" CUT ON NORTH BOLT OF FIRE HYDRANT  
 LOCATION : ON NORTH EAST CORNER OF IL 62(ALGONQUIN RD) AND PLUM GROVE RD

|   |                             |            |           |
|---|-----------------------------|------------|-----------|
| FILE NAME =   | USER NAME = PencePL         | DESIGNED - | REVISED - |
| pw\11084EBIDINTEG\illinois.gov\PWIDOT\Documents\DOT Offices\District 1\Projects\01410RAM\Design\0141116-sht-details.dgn |                             | ORANGE     | REVISED - |
|   | PLOT SCALE = 10.0000' / in. | CHECKED -  | REVISED - |
| Default   | PLOT DATE = 1/31/2017       | DATE -     | REVISED - |

**STATE OF ILLINOIS  
 DEPARTMENT OF TRANSPORTATION**

**SIDEWALK DETAIL PLAN  
 IL ROUTE 62 (ALGONQUIN ROAD) AT PLUM GROVE ROAD / WEST DRIVE**

|                           |                 |        |              |           |
|---------------------------|-----------------|--------|--------------|-----------|
| F.A.P. RTE.               | SECTION         | COUNTY | TOTAL SHEETS | SHEET NO. |
| 339                       | 116Y(1&2)R-RS-6 | COOK   | 58           | 20        |
| CONTRACT NO. 62C93        |                 |        |              |           |
| ILLINOIS FED. AID PROJECT |                 |        |              |           |

SCALE: 1"=5'      SHEET OF SHEETS      STA. TO STA.



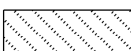

SITE BENCHMARK:  
SPIKE IN NORTH FACE OF  
POWER POLE  
ELEVATION = 741.013  
VERT DATUM: NAVD88

TO CP #10  
EL. 739.60  
PK N SIDE OF  
WENDYS IN XHATCH

TO CP #10  
EL. 739.60  
PK N SIDE OF  
WENDYS IN XHATCH

TO CP #10  
EL. 739.60  
PK N SIDE OF  
WENDYS IN XHATCH

**LEGEND**

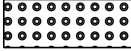-  DETECTABLE WARNINGS
-  DEPRESSED CURB AND GUTTER
-  SIDEWALK REMOVAL  
REPLACE W/TOPSOIL & SOD
-  PROPOSED SIDEWALK TURNING SPACE

- TW PROPOSED TOP-OF-WALK ELEVATION
- TC PROPOSED TOP-OF-CURB ELEVATION
- EOP PROPOSED EDGE-OF-PAVEMENT ELEVATION
- MATCH MATCH EXISTING ELEVATION
- EP EXISTING EDGE-OF-PAVEMENT ELEVATION
- FL PROPOSED DEPRESSED CURB FLOWLINE ELEVATION

| POINT | ELEV   | NOTE  |
|-------|--------|-------|
| A     | 739.83 | MATCH |
| B     | 739.51 | MATCH |
| C     | 739.76 | TW    |
| D     | 739.67 | TW    |
| E     | 739.70 | TW    |
| F     | 739.61 | TW    |
| G     | 738.48 | TW    |
| H     | 738.38 | TW=TC |
| I     | 738.47 | TW=TC |
| L     | 739.16 | MATCH |
| M     | 739.24 | MATCH |
| N     | 739.14 | TW    |
| O     | 739.19 | TW    |
| P     | 738.75 | TC=TW |
| Q     | 738.79 | TW    |
| R     | 738.75 | TC=TW |
| S     | 738.79 | TW    |
| T     | 738.55 | TC=TW |
| U     | 738.66 | TW    |
| V     | 738.89 | MATCH |
| W     | 739.00 | TW    |
| X     | 738.93 | MATCH |
| Y     | 739.04 | TW    |
| Z     | 738.92 | MATCH |
| AA    | 739.14 | MATCH |

EX SIDEWALK CROSS SLOPE EXCEEDS  
2.0% WITHIN THE LIMITS OF SURVEY


EX SIDEWALK REMOVAL = 125 SF  
PR PCC SIDEWALK 5 IN = 146 SF

EX SIDEWALK REMOVAL = 249 SF  
PR PCC SIDEWALK 5 IN = 264 SF

EX SIDEWALK CROSS SLOPE EXCEEDS  
2.0% WITHIN THE LIMITS OF SURVEY

IL RTE 62 (ALGONQUIN RD)

LINDEN LN

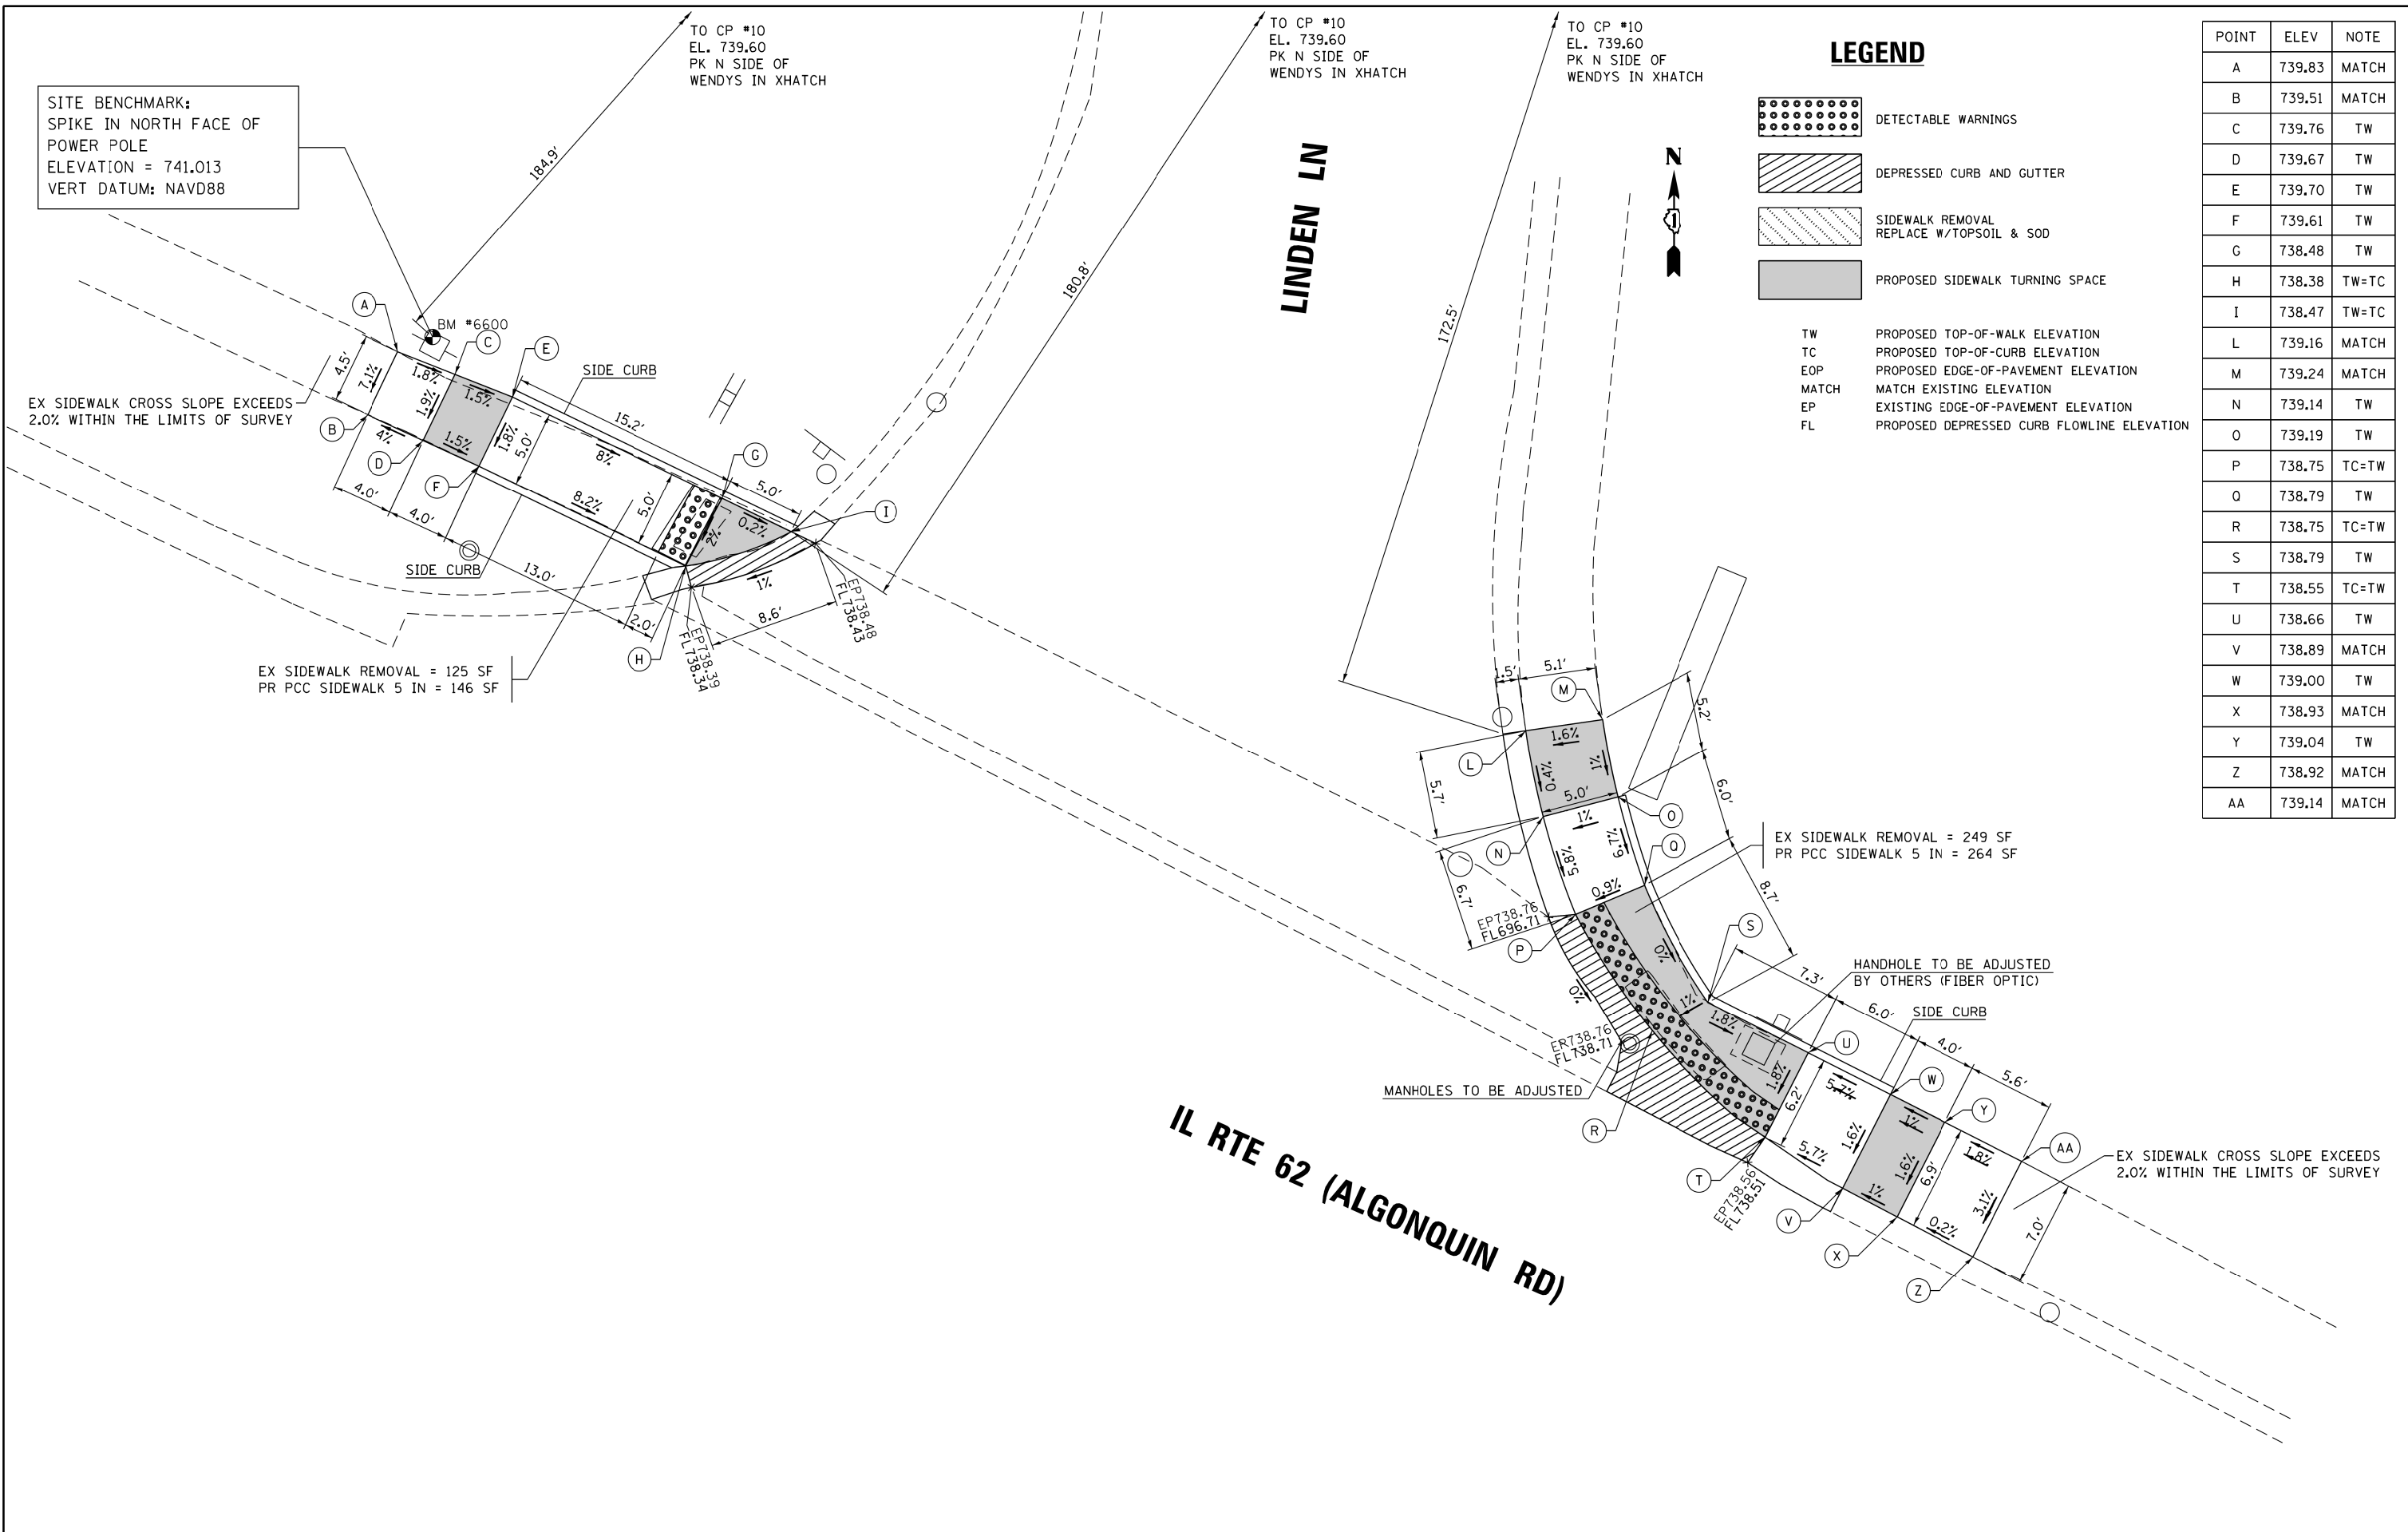

FILE NAME = 62C93-sht-plan07.dgn  
Default

USER NAME = Dwhite  
PLOT SCALE = 10.0000' / in.  
PLOT DATE = 10/19/2016

DESIGNED -  
DRAWN -  
CHECKED -  
DATE -



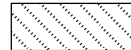

REVISED -  
REVISED -  
REVISED -  
REVISED -

STATE OF ILLINOIS  
DEPARTMENT OF TRANSPORTATION

SIDEWALK DETAIL PLAN  
IL ROUTE 62 (ALGONQUIN ROAD) AT LINDEN LANE  
SCALE: 1" = 5'  
SHEET OF SHEETS STA. TO STA.

| F.A.P. RTE.               | SECTION         | COUNTY | TOTAL SHEETS | SHEET NO. |
|---------------------------|-----------------|--------|--------------|-----------|
| 339                       | 116Y(1&2)R-R5-6 | COOK   | 58           | 21        |
| CONTRACT NO. 62C93        |                 |        |              |           |
| ILLINOIS FED. AID PROJECT |                 |        |              |           |

**LEGEND**

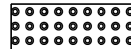-  DETECTABLE WARNINGS
-  DEPRESSED CURB AND GUTTER
-  SIDEWALK REMOVAL  
REPLACE W/TOPSOIL & SOD
-  PROPOSED SIDEWALK TURNING SPACE
  
- TW PROPOSED TOP-OF-WALK ELEVATION
- TC PROPOSED TOP-OF-CURB ELEVATION
- EOP PROPOSED EDGE-OF-PAVEMENT ELEVATION
- MATCH MATCH EXISTING ELEVATION
- EP EXISTING EDGE-OF-PAVEMENT ELEVATION
- FL PROPOSED DEPRESSED CURB FLOWLINE ELEVATION

SITE BENCHMARK:  
"X" ON SOUTHEAST BOLT  
OF FIRE HYDRANT  
ELEVATION = 740.806  
VERT DATUM: NAVD88

**IL RTE 62 (ALGONQUIN RD)**

EX SIDEWALK REMOVAL = 83 SF  
PR PCC SIDEWALK 5 IN = 79 SF

NOTES:  
1) PROPOSED CROSS SLOPE EXCEEDS CURRENT  
POLICY VALUE. RAMP IS DESIGNED TO THE  
MAXIMUM EXTENT PRACTICABLE (MEP).

**THORNTREE LN**



| POINT | ELEV   | NOTE   |
|-------|--------|--------|
| A     | 738.22 | TW=EOP |
| B     | 738.22 | TW=EOP |
| C     | 738.19 | TW     |
| D     | 737.43 | TW=TC  |
| E     | 737.23 | TW     |
| F     | 737.19 | TW=TC  |
| G     | 737.29 | TW=TC  |
| H     | 737.38 | TW=TC  |
| I     | 737.97 | TW     |
| J     | 737.89 | TW     |
| K     | 737.89 | TW     |
| L     | 737.81 | TW     |
| M     | 737.67 | TW=TC  |
| N     | 737.64 | TW=TC  |
| O     | 737.46 | TW     |
| P     | 737.41 | TW     |

EX SIDEWALK REMOVAL = 168 SF  
PR PCC SIDEWALK 5 IN = 197 SF

REBUILD EXISTING HANDHOLE

TO CP #12  
EL. 737.56  
X S SIDE ALGONQUIN  
IN CURB AT THOREAU

|                                     |                             |            |           |
|-------------------------------------|-----------------------------|------------|-----------|
| FILE NAME =<br>62C93-sht-plan08.dgn | USER NAME = Dwhite          | DESIGNED - | REVISED - |
| Default                             | PLOT SCALE = 10.0000' / in. | DRAWN -    | REVISED - |
|                                     | PLOT DATE = 10/19/2016      | CHECKED -  | REVISED - |
|                                     |                             | DATE -     | REVISED - |





**STATE OF ILLINOIS  
DEPARTMENT OF TRANSPORTATION**

**SIDEWALK DETAIL PLAN  
IL ROUTE 62 (ALGONQUIN ROAD) AT THORNTREE LANE**

|                           |                 |        |                 |              |
|---------------------------|-----------------|--------|-----------------|--------------|
| F.A.P.<br>RTE.            | SECTION         | COUNTY | TOTAL<br>SHEETS | SHEET<br>NO. |
| 339                       | 116Y(1&2)R-R5-6 | COOK   | 58              | 22           |
| CONTRACT NO. 62C93        |                 |        |                 |              |
| ILLINOIS FED. AID PROJECT |                 |        |                 |              |

SCALE: 1" = 5' SHEET OF SHEETS STA. TO STA.

**LEGEND**

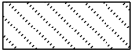
-  DETECTABLE WARNINGS
-  DEPRESSED CURB AND GUTTER
-  SIDEWALK REMOVAL  
REPLACE W/TOPSOIL & SOD
-  PROPOSED SIDEWALK TURNING SPACE
  
- TW PROPOSED TOP-OF-WALK ELEVATION
- TC PROPOSED TOP-OF-CURB ELEVATION
- EOP PROPOSED EDGE-OF-PAVEMENT ELEVATION
- MATCH MATCH EXISTING ELEVATION
- EP EXISTING EDGE-OF-PAVEMENT ELEVATION
- FL PROPOSED DEPRESSED CURB FLOWLINE ELEVATION



**IL RTE 62 (ALGONQUIN RD)**

SITE BENCHMARK:  
"X" ON SOUTHEAST BOLT  
OF FIRE HYDRANT  
ELEVATION = 740.806  
VERT DATUM: NAVD88



| POINT | ELEV   | NOTE  |
|-------|--------|-------|
| A     | 737.39 | TW=TC |
| B     | 737.38 | TW=TC |
| C     | 737.40 | TW    |
| D     | 737.47 | TW    |
| E     | 737.56 | TW    |
| F     | 737.39 | MATCH |
| G     | 737.49 | MATCH |

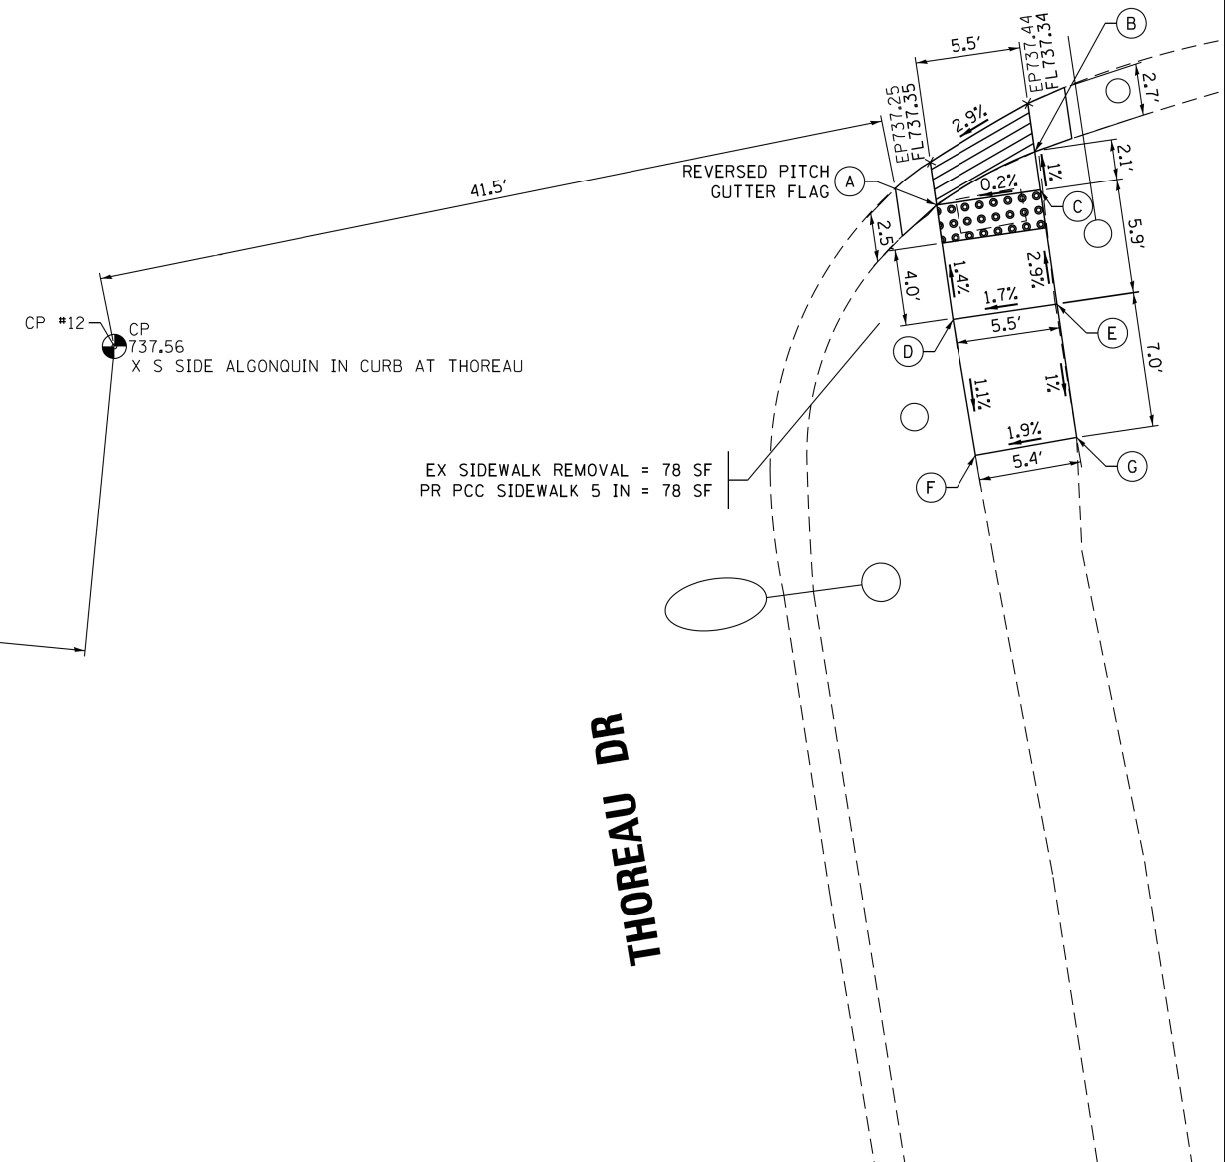

EX SIDEWALK REMOVAL = 78 SF  
PR PCC SIDEWALK 5 IN = 78 SF

**THOREAU DR**



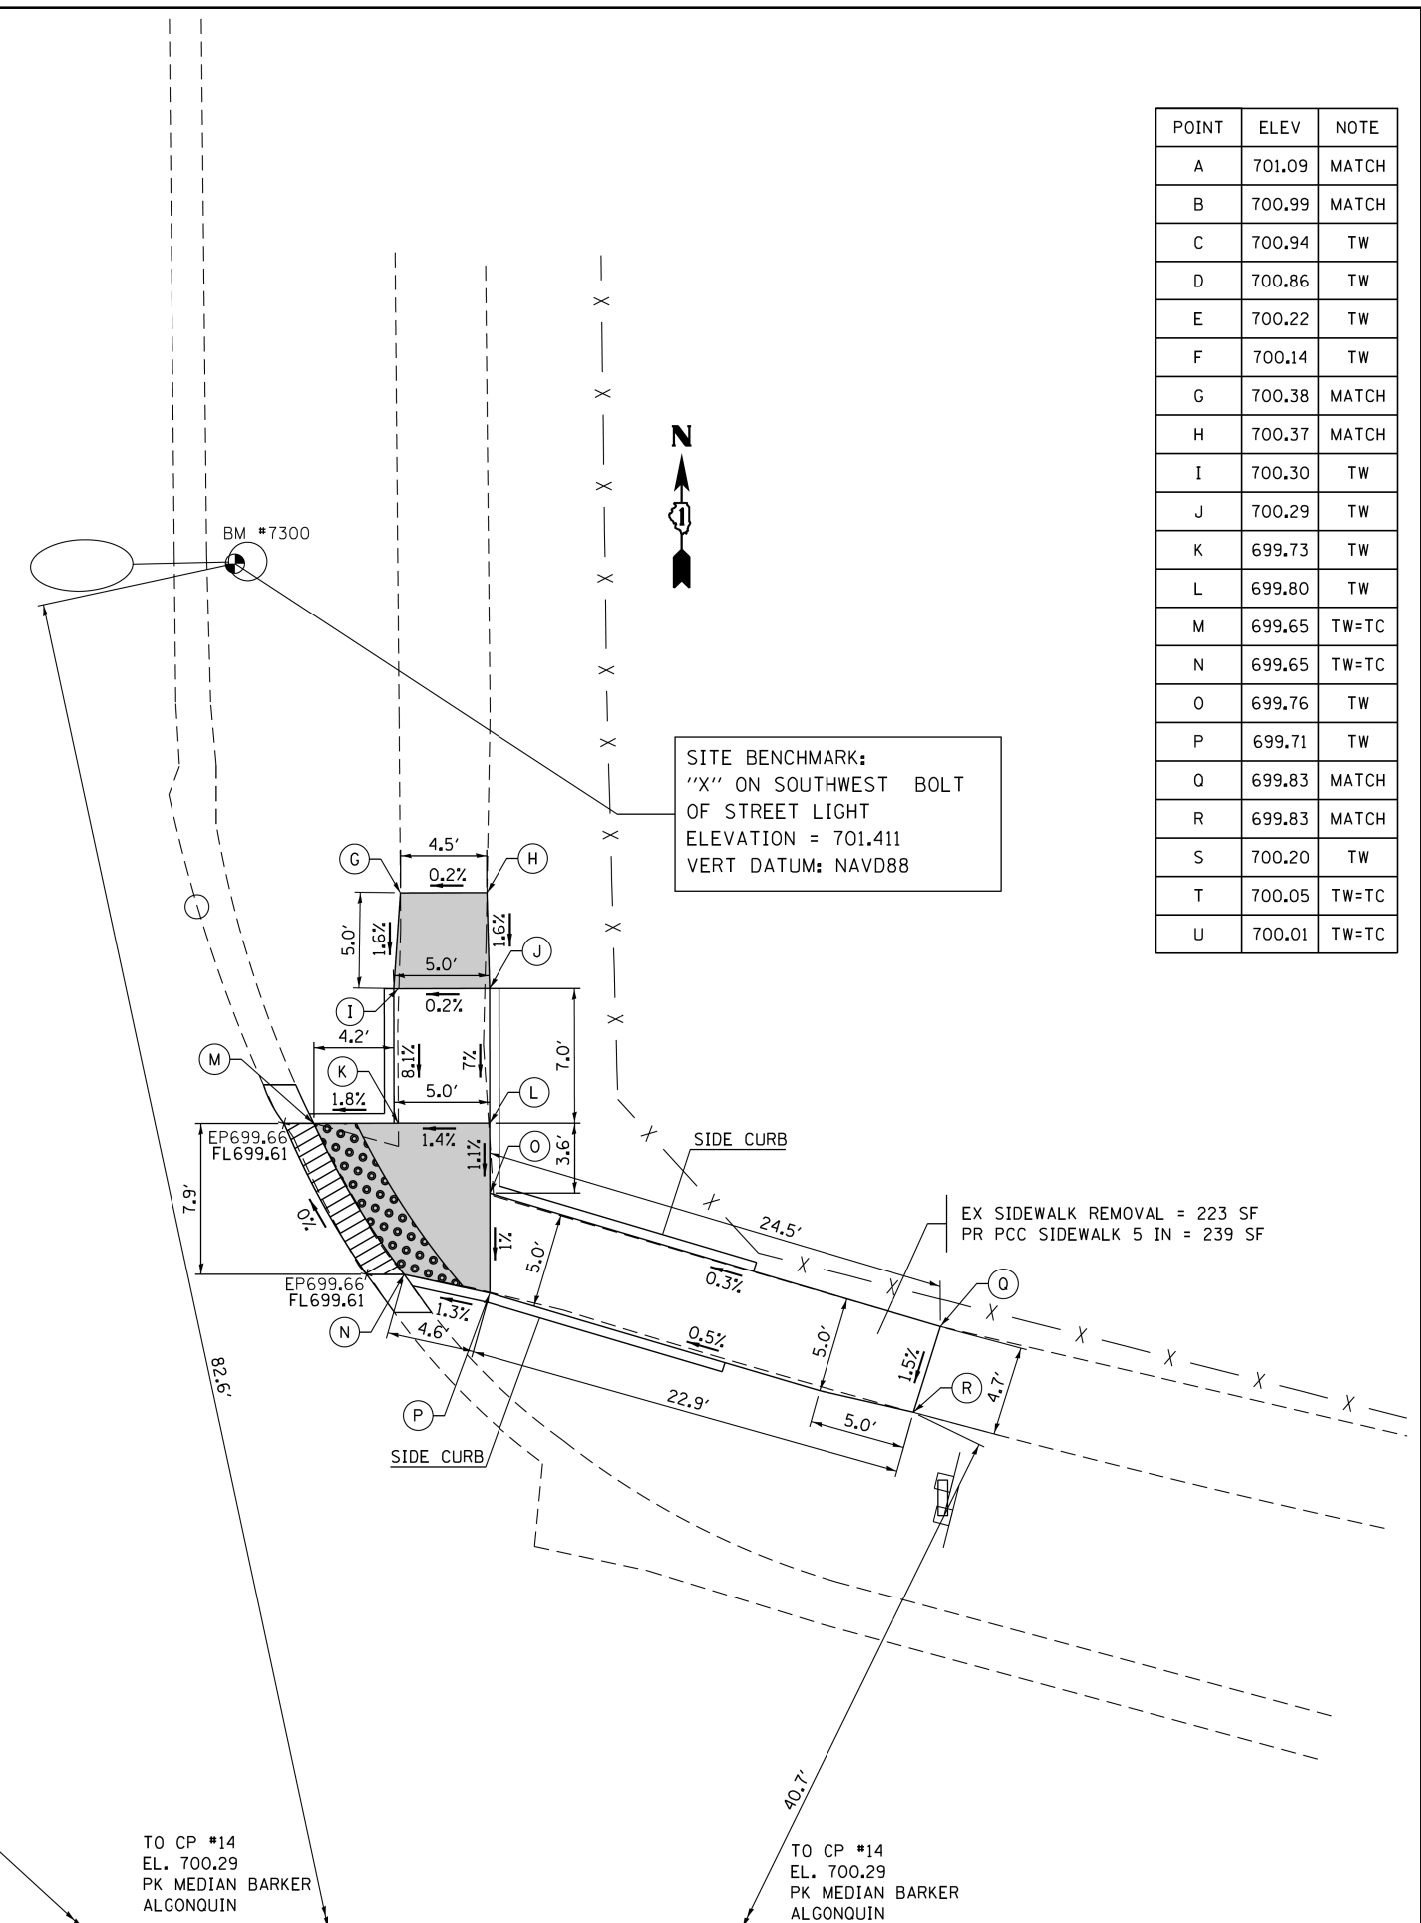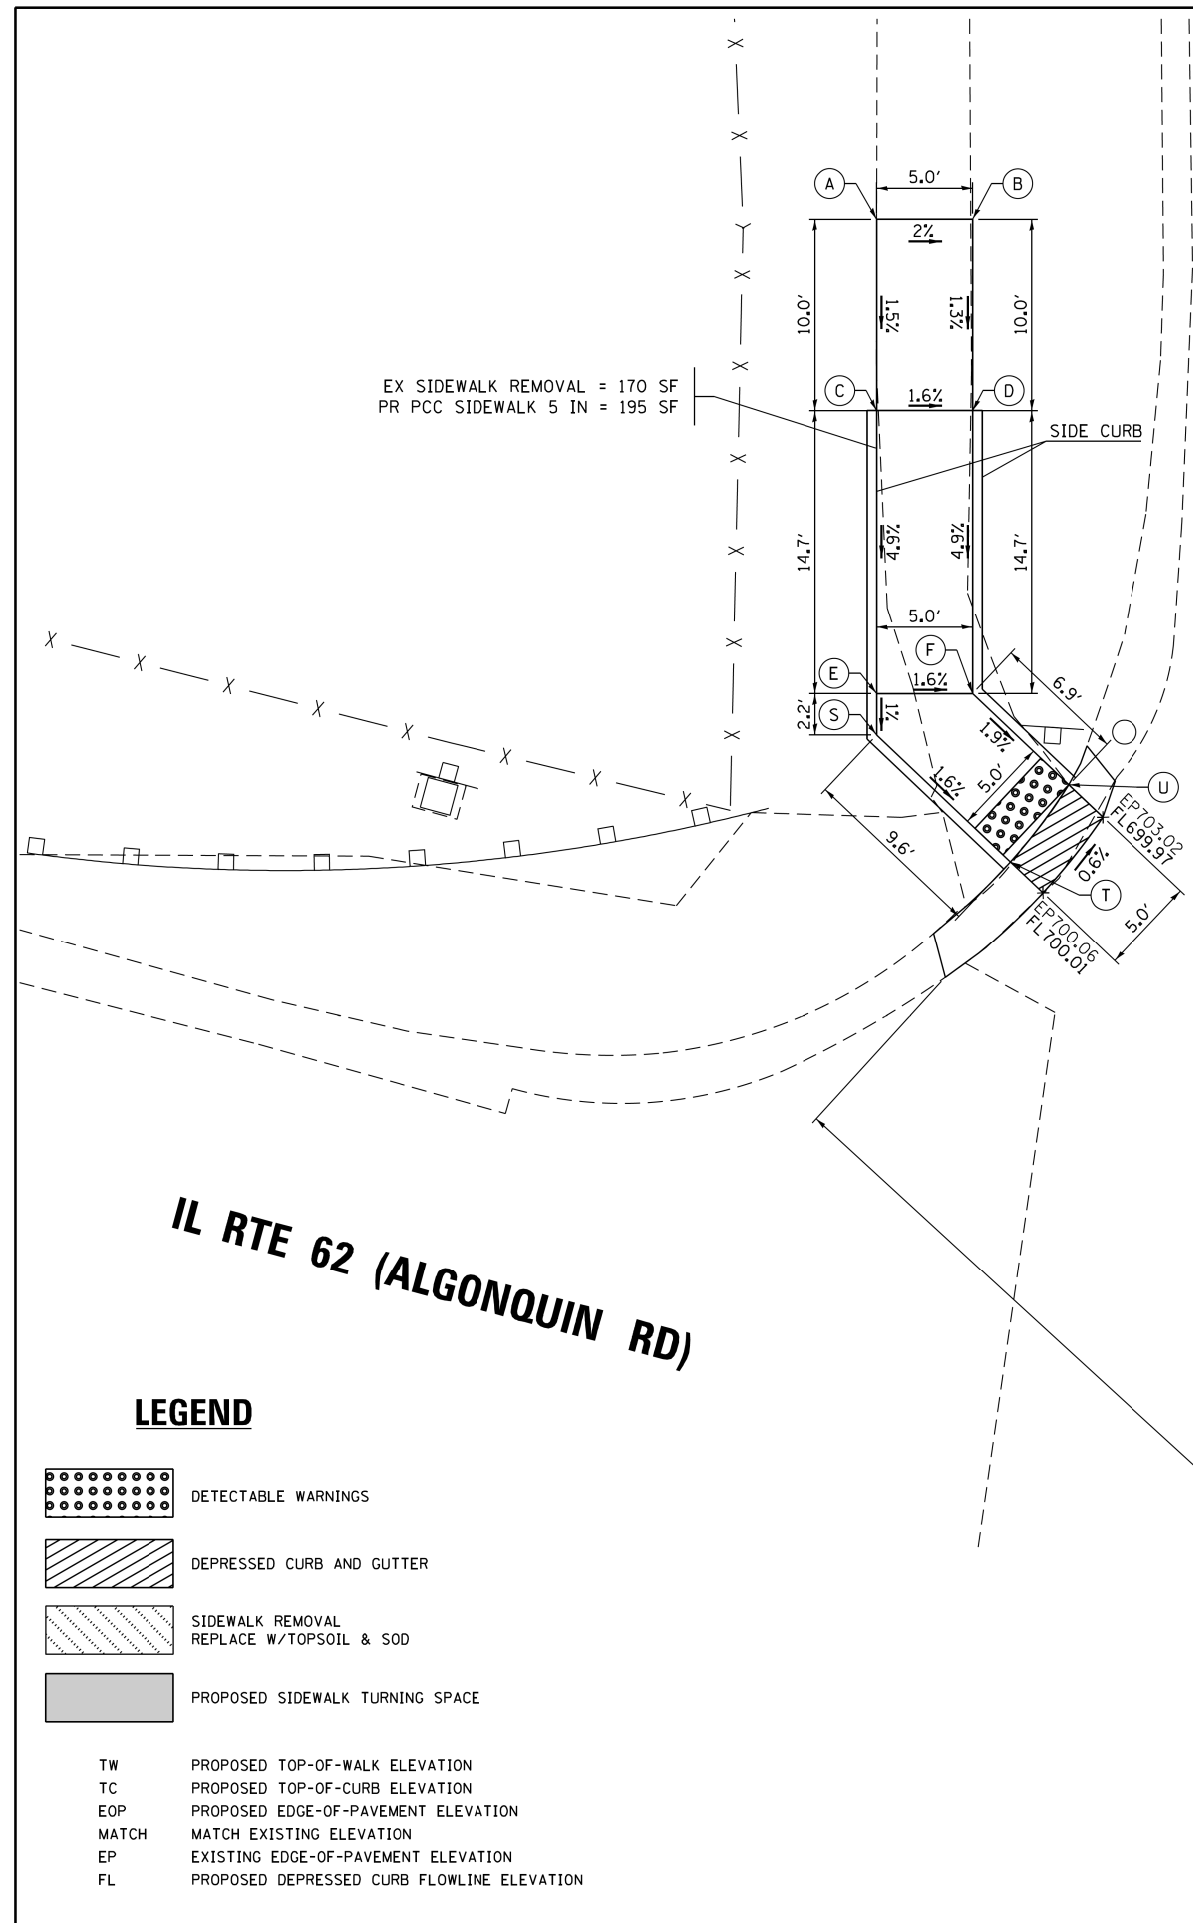

**BARKER AVE**



| POINT | ELEV   | NOTE  |
|-------|--------|-------|
| A     | 701.09 | MATCH |
| B     | 700.99 | MATCH |
| C     | 700.94 | TW    |
| D     | 700.86 | TW    |
| E     | 700.22 | TW    |
| F     | 700.14 | TW    |
| G     | 700.38 | MATCH |
| H     | 700.37 | MATCH |
| I     | 700.30 | TW    |
| J     | 700.29 | TW    |
| K     | 699.73 | TW    |
| L     | 699.80 | TW    |
| M     | 699.65 | TW=TC |
| N     | 699.65 | TW=TC |
| O     | 699.76 | TW    |
| P     | 699.71 | TW    |
| Q     | 699.83 | MATCH |
| R     | 699.83 | MATCH |
| S     | 700.20 | TW    |
| T     | 700.05 | TW=TC |
| U     | 700.01 | TW=TC |

**IL RTE 62 (ALGONQUIN RD)**

**LEGEND**

-  DETECTABLE WARNINGS
-  DEPRESSED CURB AND GUTTER
-  SIDEWALK REMOVAL  
REPLACE W/TOPSOIL & SOD
-  PROPOSED SIDEWALK TURNING SPACE
- TW PROPOSED TOP-OF-WALK ELEVATION
- TC PROPOSED TOP-OF-CURB ELEVATION
- EOP PROPOSED EDGE-OF-PAVEMENT ELEVATION
- MATCH MATCH EXISTING ELEVATION
- EP EXISTING EDGE-OF-PAVEMENT ELEVATION
- FL PROPOSED DEPRESSED CURB FLOWLINE ELEVATION

|                                  |                             |            |           |
|----------------------------------|-----------------------------|------------|-----------|
| FILE NAME = 62C93-sht-plan10.dgn | USER NAME = Dwhite          | DESIGNED - | REVISED - |
| Default                          |                             | DRAWN -    | REVISED - |
|                                  | PLOT SCALE = 10.0000' / in. | CHECKED -  | REVISED - |
|                                  | PLOT DATE = 10/19/2016      | DATE -     | REVISED - |

**STATE OF ILLINOIS  
DEPARTMENT OF TRANSPORTATION**

**SIDEWALK DETAIL PLAN  
IL ROUTE 62 (ALGONQUIN ROAD) AT BARKER AVENUE**

SCALE: 1" = 5'

SHEET OF SHEETS STA. TO STA.

|                           |                         |             |                 |              |
|---------------------------|-------------------------|-------------|-----------------|--------------|
| F.A.P. RTE. 339           | SECTION 116Y(1&2)R-R5-6 | COUNTY COOK | TOTAL SHEETS 58 | SHEET NO. 24 |
| CONTRACT NO. 62C93        |                         |             |                 |              |
| ILLINOIS FED. AID PROJECT |                         |             |                 |              |

TO CP #14  
EL. 700.29  
PK MEDIAN BARKER  
ALGONQUIN

TO CP #14  
EL. 700.29  
PK MEDIAN BARKER  
ALGONQUIN





EX SIDEWALK REMOVAL = 43 SF  
PR PCC SIDEWALK 5 IN = 46 SF

| POINT | ELEV   | NOTE  |
|-------|--------|-------|
| A     | 700.22 | MATCH |
| B     | 700.19 | MATCH |
| C     | 700.09 | TW=TC |
| D     | 700.02 | TW    |
| E     | 699.96 | TW=TC |
| F     | 700.00 | MATCH |
| G     | 700.10 | MATCH |
| H     | 700.06 | TW=TC |
| I     | 700.16 | TW    |
| J     | 700.26 | TW=TC |
| K     | 700.44 | TW=TC |
| L     | 700.37 | TW    |
| M     | 700.28 | TW    |
| N     | 700.52 | TW=TC |
| O     | 700.44 | TW    |
| P     | 700.36 | TW    |
| Q     | 700.46 | MATCH |
| R     | 700.26 | MATCH |


E REVERSED PITCH  
GUTTER FLAG

CP #16 CP 700.10  
PK CARRIAGE ALGONQUIN





EX SIDEWALK REMOVAL = 144 SF  
PR PCC SIDEWALK 5 IN = 163 SF

**CARRIAGE WAY DR**

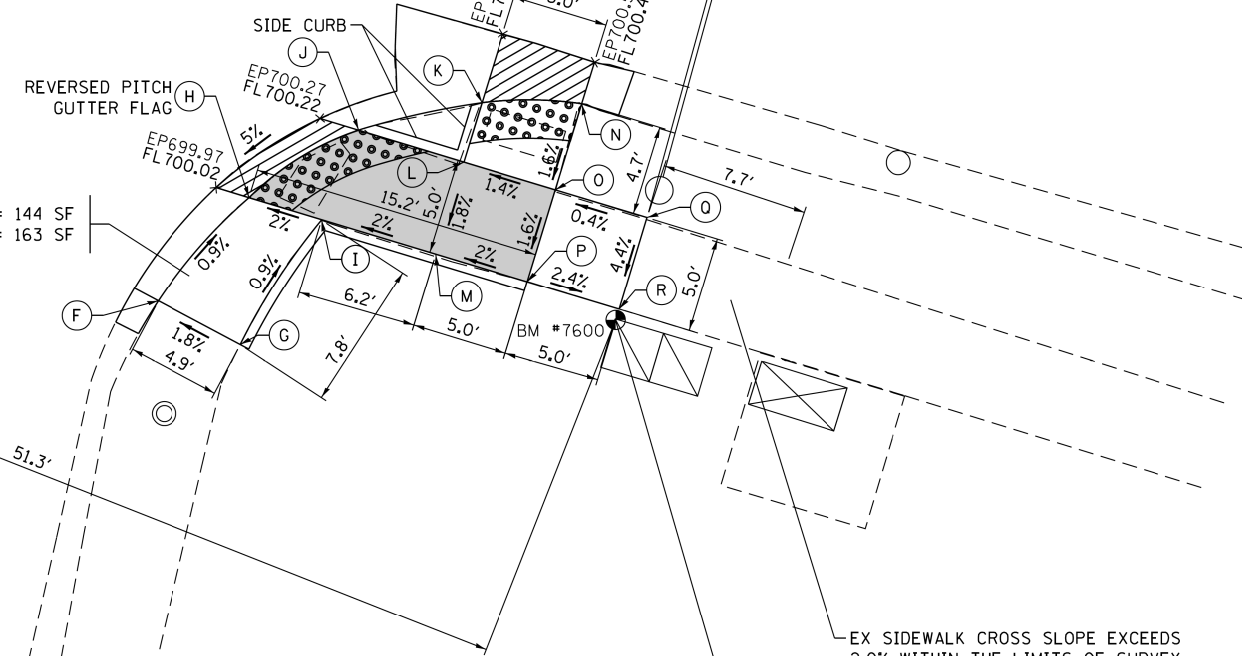**IL RTE 62 (ALGONQUIN RD)**



**LEGEND**

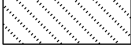-  DETECTABLE WARNINGS
-  DEPRESSED CURB AND GUTTER
-  SIDEWALK REMOVAL  
REPLACE W/TOPSOIL & SOD
-  PROPOSED SIDEWALK TURNING SPACE

- TW PROPOSED TOP-OF-WALK ELEVATION
- TC PROPOSED TOP-OF-CURB ELEVATION
- EOP PROPOSED EDGE-OF-PAVEMENT ELEVATION
- MATCH MATCH EXISTING ELEVATION
- EP EXISTING EDGE-OF-PAVEMENT ELEVATION
- FL PROPOSED DEPRESSED CURB FLOWLINE ELEVATION

SITE BENCHMARK:  
"X" ON NORTHWEST CORNER  
OF HANDHOLE  
ELEVATION = 700.463  
VERT DATUM: NAVD88

|                                     |                             |            |           |
|-------------------------------------|-----------------------------|------------|-----------|
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|                                     |                             | DATE -     | REVISED - |





**STATE OF ILLINOIS  
DEPARTMENT OF TRANSPORTATION**

**SIDEWALK DETAIL PLAN  
IL ROUTE 62 (ALGONQUIN ROAD) AT CARRIAGE WAY DRIVE**


SCALE: 1" = 5' SHEET OF SHEETS STA. TO STA.

|                           |                 |        |                 |              |
|---------------------------|-----------------|--------|-----------------|--------------|
| F.A.P.<br>RTE.            | SECTION         | COUNTY | TOTAL<br>SHEETS | SHEET<br>NO. |
| 339                       | 116Y(1&2)R-R5-6 | COOK   | 58              | 25           |
| CONTRACT NO. 62C93        |                 |        |                 |              |
| ILLINOIS FED. AID PROJECT |                 |        |                 |              |

# LEGEND

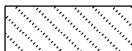-  DETECTABLE WARNINGS
-  DEPRESSED CURB AND GUTTER
-  SIDEWALK REMOVAL  
REPLACE W/TOPSOIL & SOD
-  PROPOSED SIDEWALK TURNING SPACE
- TW PROPOSED TOP-OF-WALK ELEVATION
- TC PROPOSED TOP-OF-CURB ELEVATION
- EOP PROPOSED EDGE-OF-PAVEMENT ELEVATION
- MATCH MATCH EXISTING ELEVATION
- EP EXISTING EDGE-OF-PAVEMENT ELEVATION
- FL PROPOSED DEPRESSED CURB FLOWLINE ELEVATION

| POINT | ELEV   | NOTE  |
|-------|--------|-------|
| A     | 699.90 | TW    |
| B     | 699.98 | TW    |
| C     | 700.19 | TW    |
| D     | 700.33 | TW    |
| E     | 700.13 | TW    |
| F     | 700.29 | TW    |
| G     | 700.14 | TW    |
| H     | 700.23 | TW    |
| I     | 700.37 | MATCH |
| J     | 700.33 | MATCH |
| K     | 700.09 | TW=TC |
| L     | 700.10 | TW=TC |
| M     | 700.80 | TW=TC |
| N     | 700.86 | TW=TC |
| O     | 700.88 | TW    |
| P     | 700.83 | TW    |
| Q     | 700.78 | TW=TC |
| R     | 700.69 | TW=TC |
| S     | 700.86 | TW    |
| T     | 700.91 | TW    |
| U     | 700.94 | MATCH |
| V     | 700.94 | MATCH |
| W     | 699.82 | MATCH |
| X     | 699.96 | MATCH |
| Y     | 700.28 | TW    |

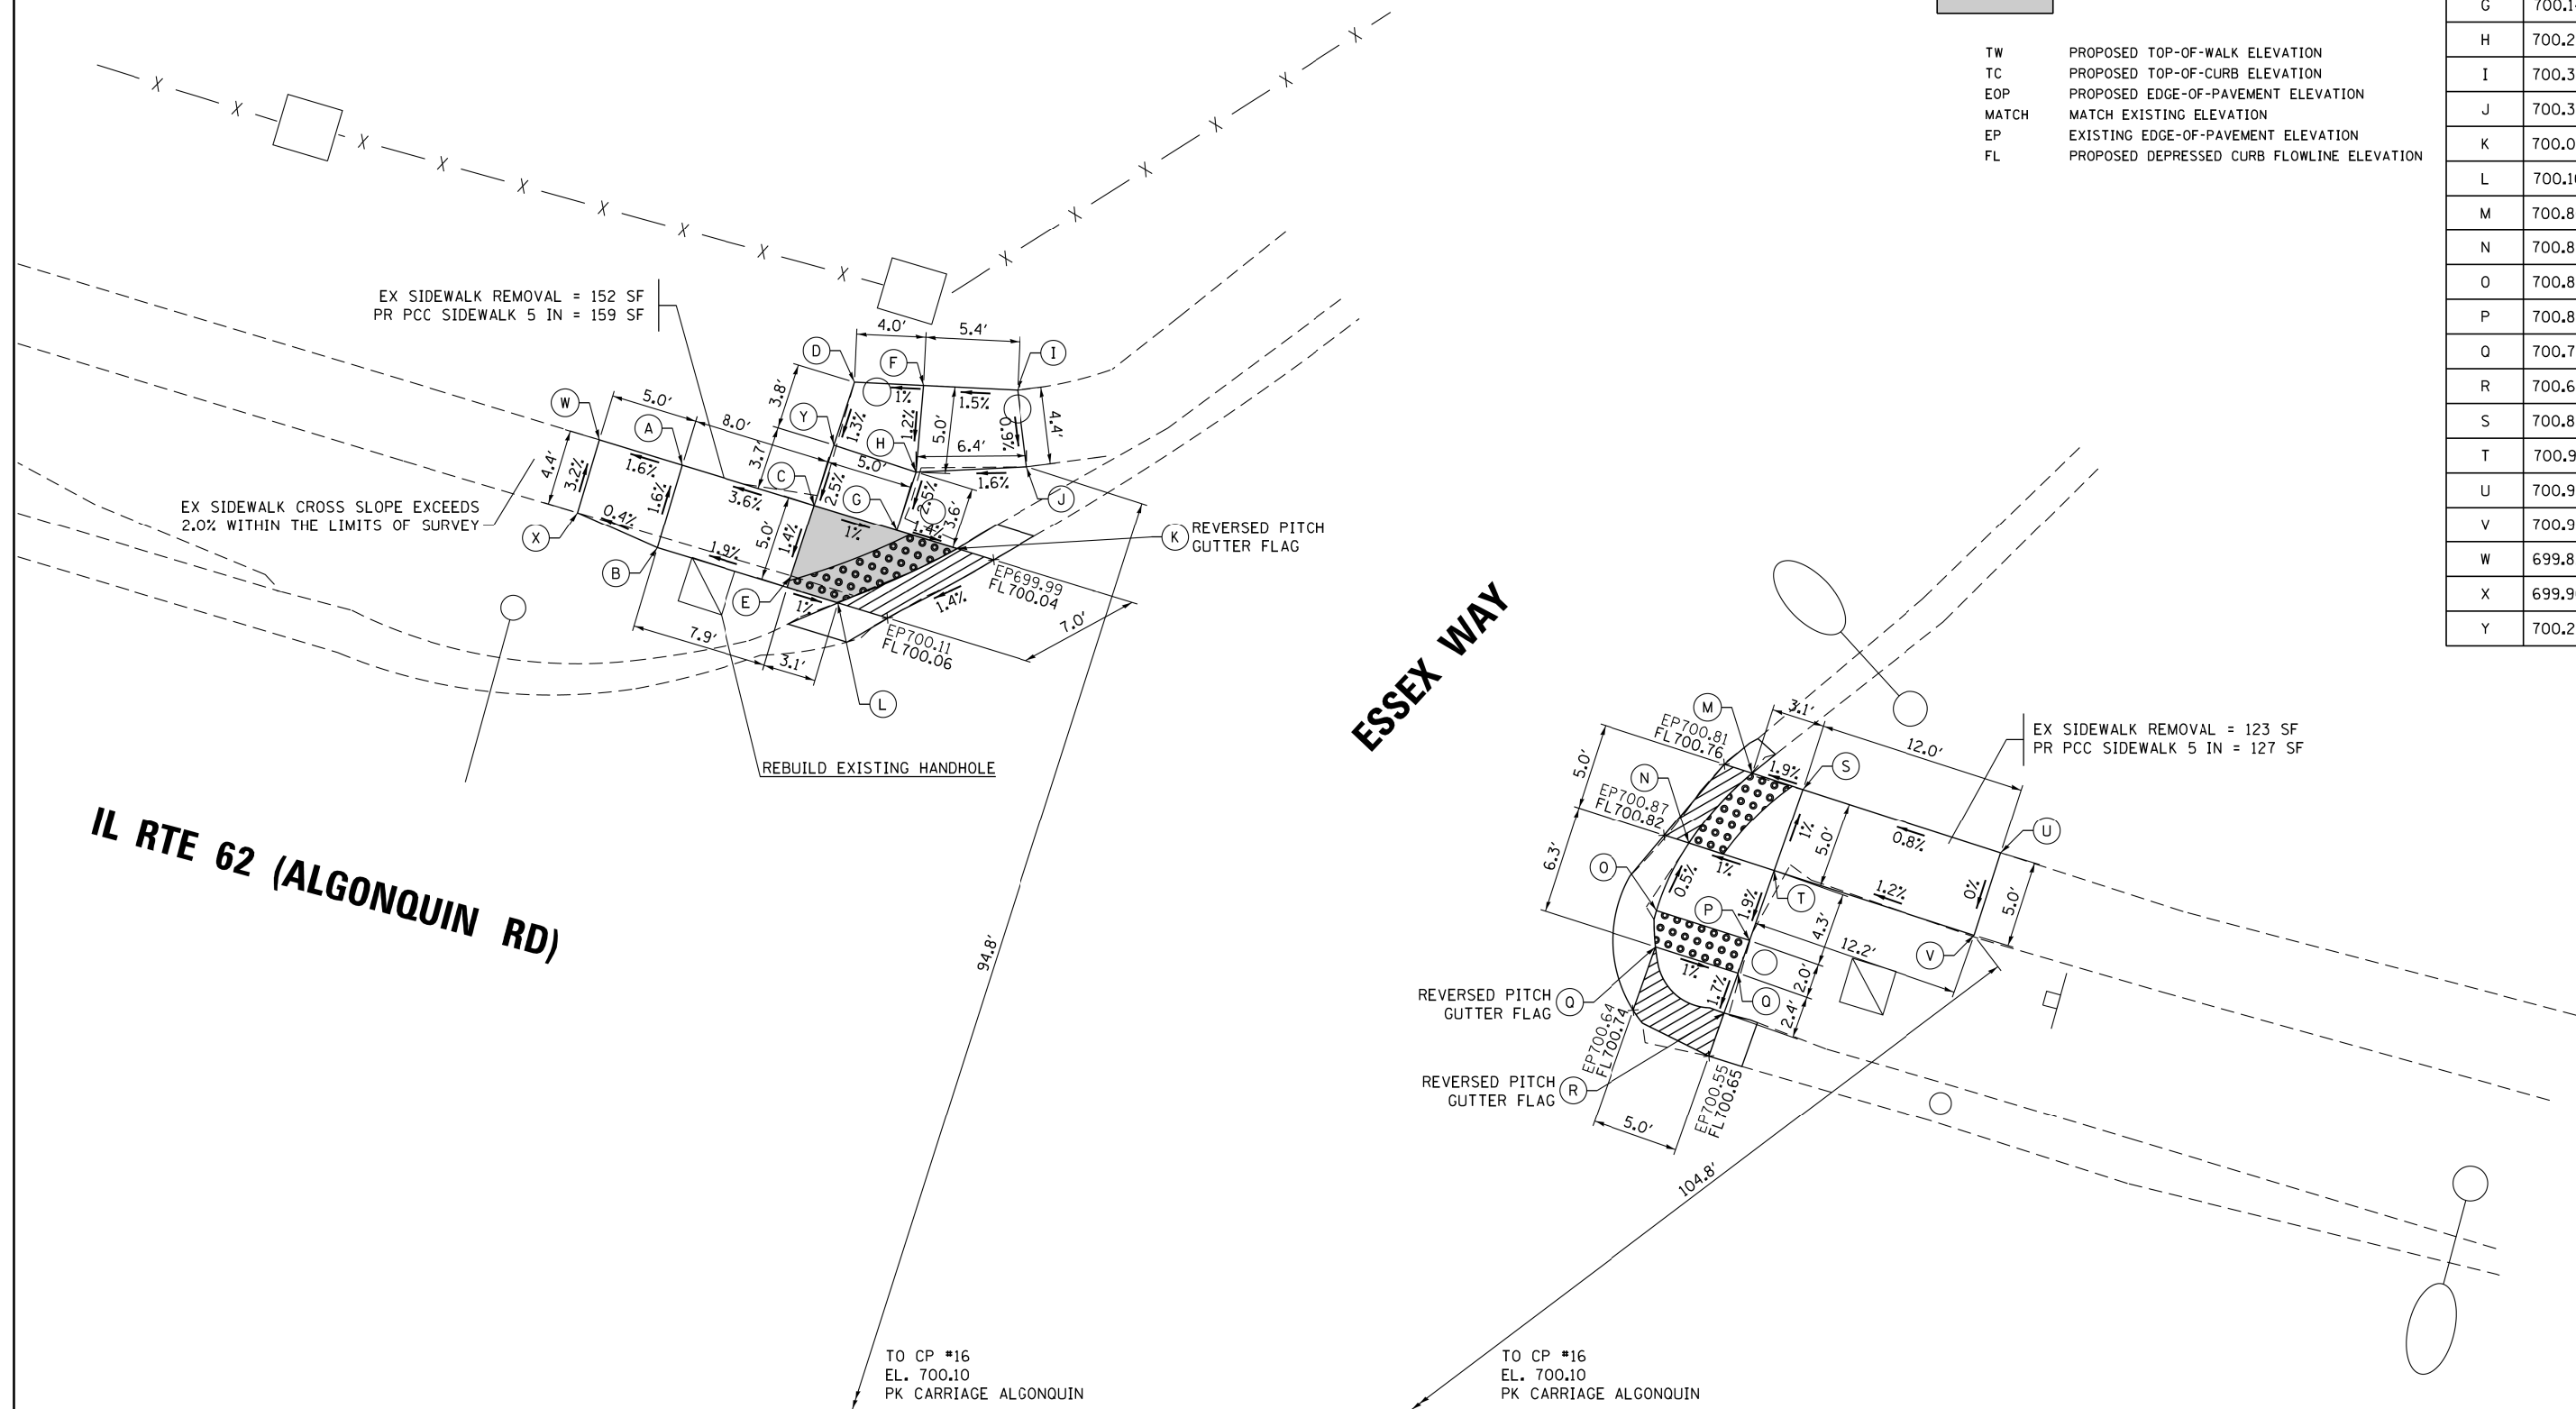

**ESSEX WAY**

**IL RTE 62 (ALGONQUIN RD)**

|                                  |                    |            |           |
|----------------------------------|--------------------|------------|-----------|
| FILE NAME = 62C93-sht-plan12.dgn | USER NAME = Dwhite | DESIGNED - | REVISOR - |
|                                  |                    | DRAWN -    | REVISOR - |
|                                  |                    | CHECKED -  | REVISOR - |
|                                  |                    | DATE -     | REVISOR - |


STATE OF ILLINOIS  
DEPARTMENT OF TRANSPORTATION

**SIDEWALK DETAIL PLAN**  
**IL ROUTE 62 (ALGONQUIN ROAD) AT ESSEX WAY**

|                           |                         |             |                 |              |
|---------------------------|-------------------------|-------------|-----------------|--------------|
| F.A.P. RTE. 339           | SECTION 116Y(1&2)R-R5-6 | COUNTY COOK | TOTAL SHEETS 58 | SHEET NO. 26 |
| CONTRACT NO. 62C93        |                         |             |                 |              |
| ILLINOIS FED. AID PROJECT |                         |             |                 |              |

SCALE: 1" = 5' SHEET OF SHEETS STA. TO STA.


# LEGEND

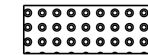

DETECTABLE WARNINGS



DEPRESSED CURB AND GUTTER

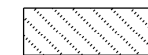


SIDEWALK REMOVAL  
REPLACE W/TOPSOIL & SOD



PROPOSED SIDEWALK TURNING SPACE

TW PROPOSED TOP-OF-WALK ELEVATION  
 TC PROPOSED TOP-OF-CURB ELEVATION  
 EOP PROPOSED EDGE-OF-PAVEMENT ELEVATION  
 MATCH MATCH EXISTING ELEVATION  
 EP EXISTING EDGE-OF-PAVEMENT ELEVATION  
 FL PROPOSED DEPRESSED CURB FLOWLINE ELEVATION

| POINT | ELEV   | NOTE     |
|-------|--------|----------|
| A     |        | NOT USED |
| B     |        | NOT USED |
| C     | 697.03 | MATCH    |
| D     | 697.17 | MATCH    |
| E     | 696.98 | TW       |
| F     | 697.07 | TW       |
| G     | 696.58 | TW       |
| H     | 696.58 | TW       |
| I     | 696.56 | TW       |
| J     | 696.54 | TW=TC    |
| K     | 696.48 | TW       |
| L     | 696.43 | TW=TC    |
| M     | 697.51 | TW       |
| N     | 697.41 | TW       |
| O     | 697.61 | MATCH    |
| P     | 697.51 | MATCH    |
| Q     | 696.51 | TW=TC    |
| R     | 696.48 | TW=TC    |
| S     | 696.60 | TW       |
| T     | 696.52 | TW       |
| U     | 696.68 | TW       |
| V     | 696.60 | TW       |
| W     | 696.94 | MATCH    |
| X     | 697.01 | MATCH    |
| Y     | 696.58 | MATCH    |
| Z     | 696.51 | MATCH    |

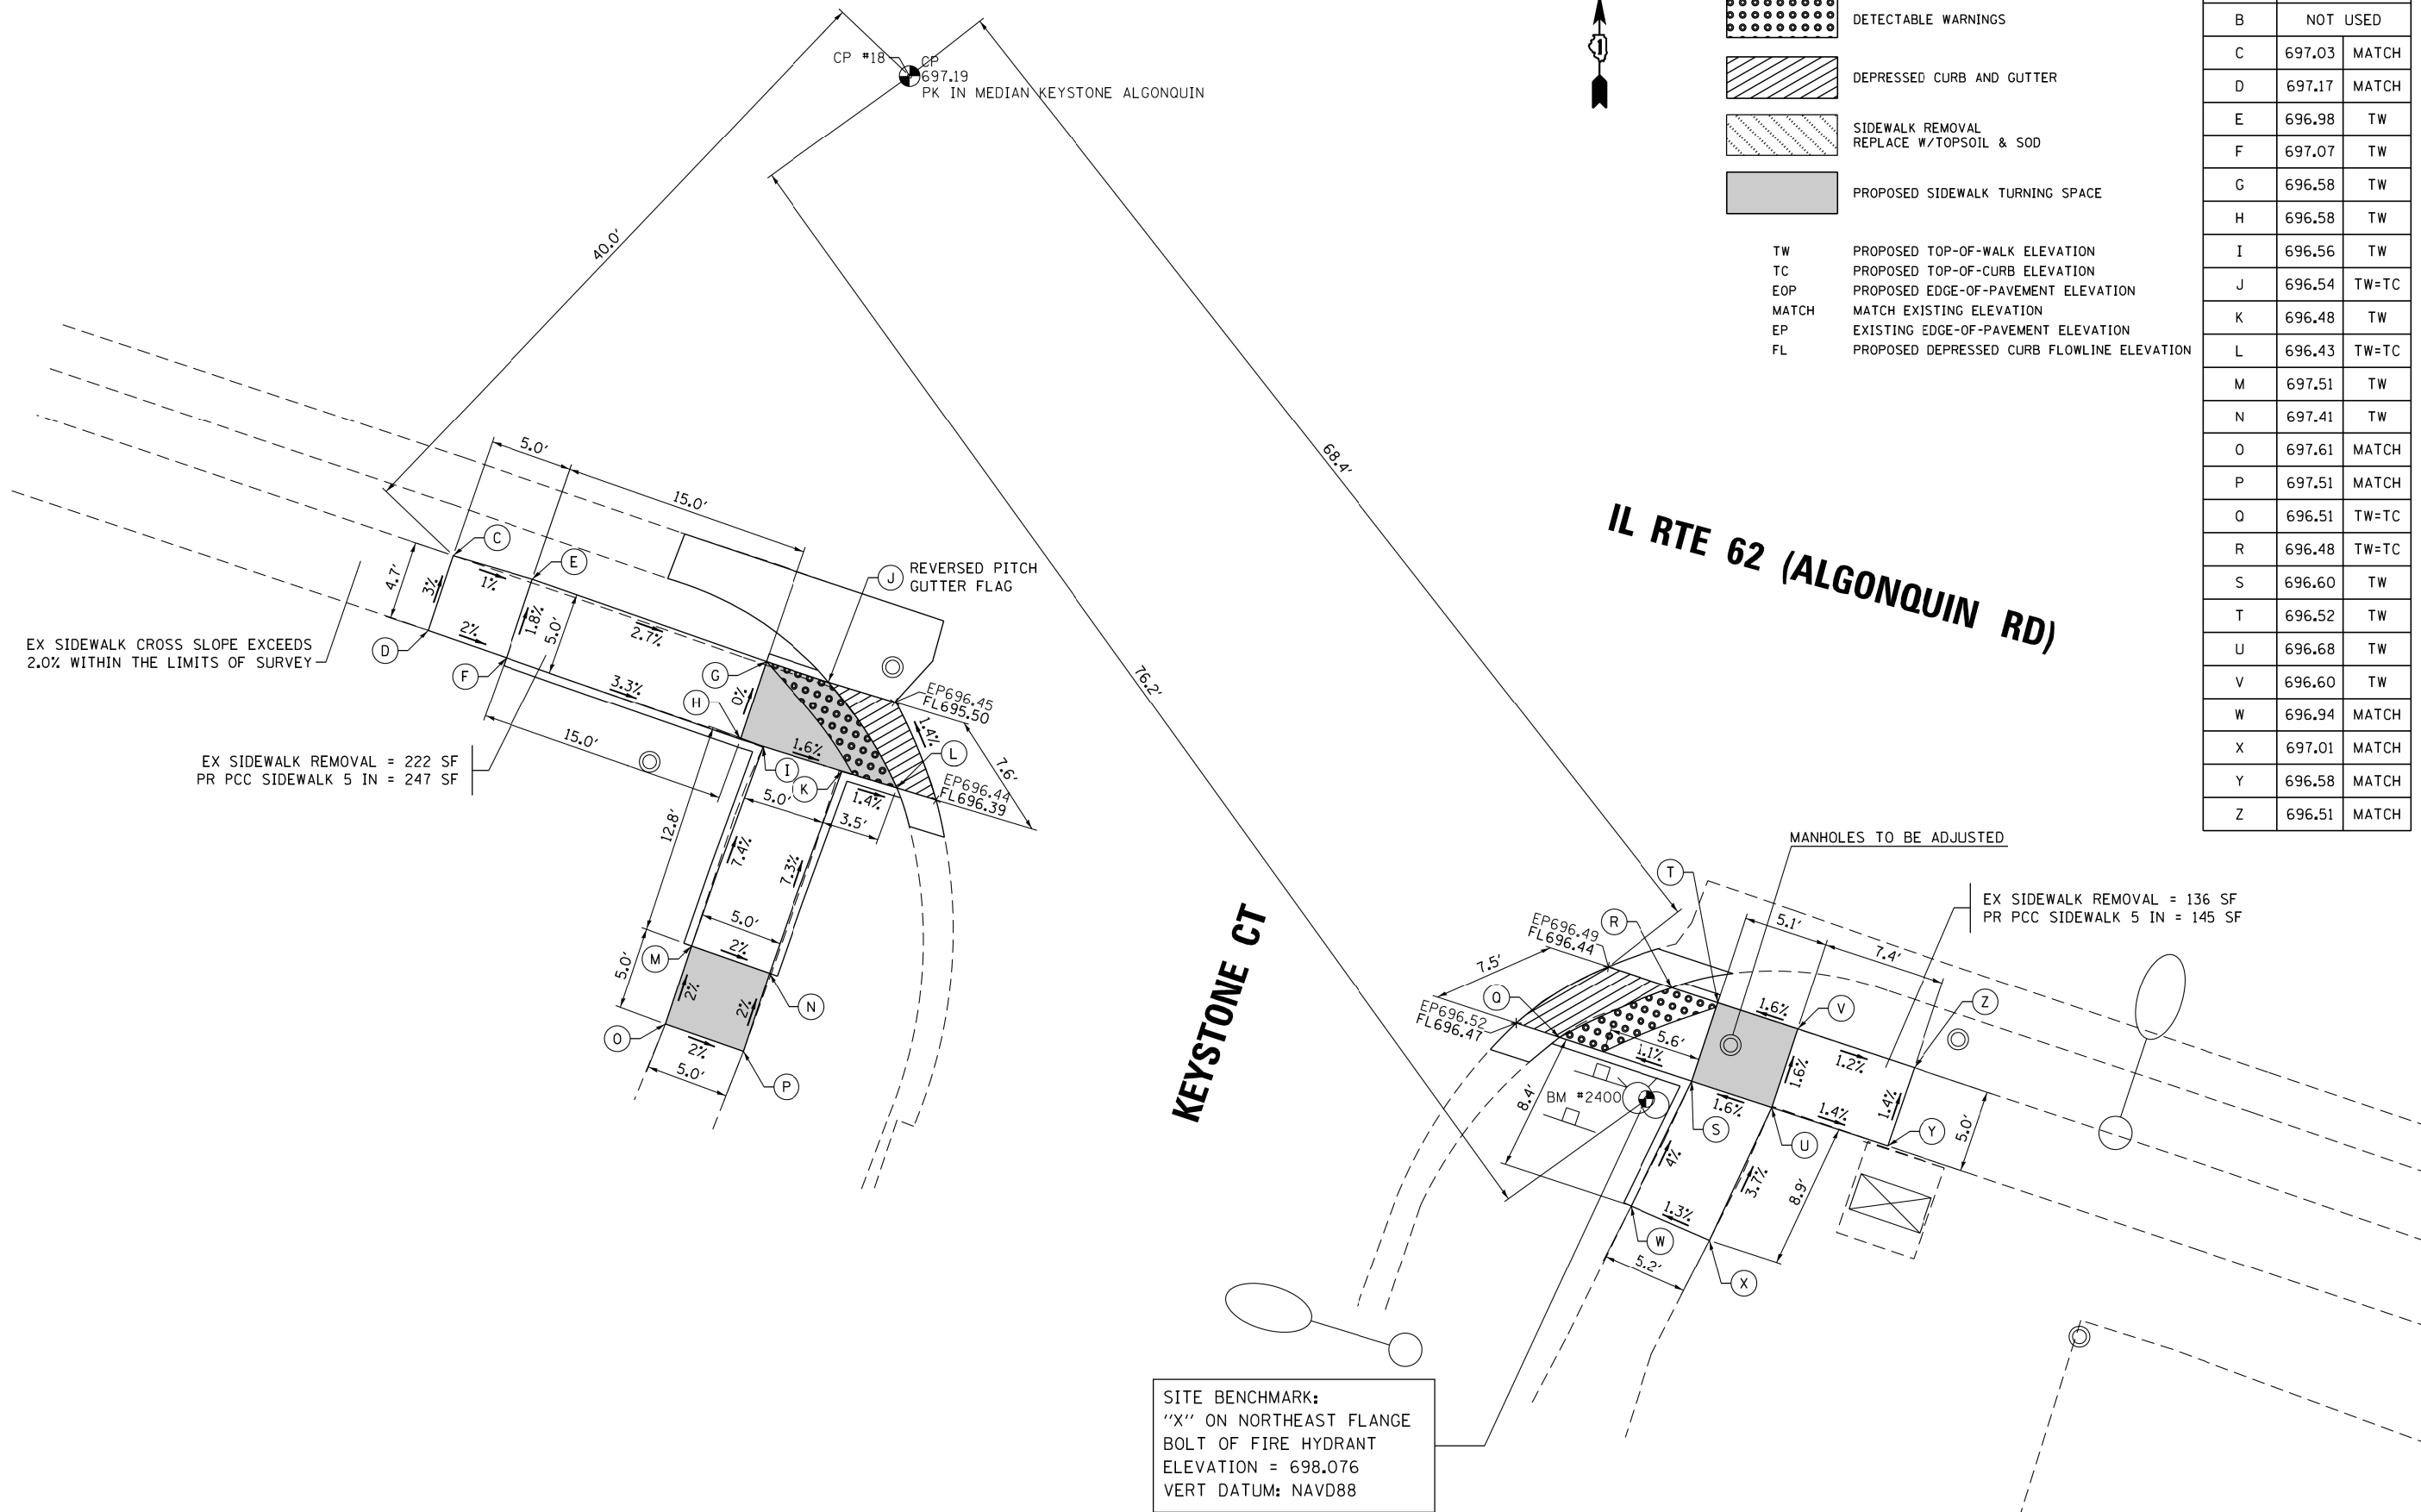

EX SIDEWALK CROSS SLOPE EXCEEDS 2.0% WITHIN THE LIMITS OF SURVEY

EX SIDEWALK REMOVAL = 222 SF  
PR PCC SIDEWALK 5 IN = 247 SF

EX SIDEWALK REMOVAL = 136 SF  
PR PCC SIDEWALK 5 IN = 145 SF

SITE BENCHMARK:  
"X" ON NORTHEAST FLANGE  
BOLT OF FIRE HYDRANT  
ELEVATION = 698.076  
VERT DATUM: NAVD88



| POINT | ELEV   | NOTE  |
|-------|--------|-------|
| A     | 695.59 | MATCH |
| B     | 695.71 | MATCH |
| C     | 695.54 | TW    |
| D     | 695.62 | TW    |
| E     | 694.90 | TW    |
| F     | 694.95 | TW    |
| G     | 694.83 | TW=TC |
| H     | 694.75 | TW=TC |
| I     | 694.33 | TW=TC |
| J     | 694.43 | TW=TC |
| K     | 694.40 | TW    |
| L     | 695.19 | TW    |
| M     | 695.19 | TW    |
| N     | 695.25 | MATCH |
| O     | 695.27 | MATCH |

SITE BENCHMARK:  
 "X" ON SOUTHEAST FLANGE  
 BOLT OF FIRE HYDRANT  
 ELEVATION = 696.949  
 VERT DATUM: NAVD88

CP #19  
 CP  
 695.60  
 PK IN MEDIAN MEADOWBROOK ALGONQUIN

EX SIDEWALK REMOVAL = 111 SF  
 PR PCC SIDEWALK 5 IN = 111 SF



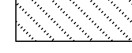
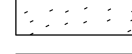

EX SIDEWALK CROSS SLOPE EXCEEDS  
 2.0% WITHIN THE LIMITS OF SURVEY

IL RTE 62 (ALGONQUIN RD)

MEADOWBROOK CT

EX SIDEWALK REMOVAL = 79 SF  
 PR PCC SIDEWALK 5 IN = 79 SF

**LEGEND**

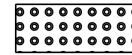-  DETECTABLE WARNINGS
-  DEPRESSED CURB AND GUTTER
-  SIDEWALK REMOVAL  
REPLACE W/TOPSOIL & SOD
-  CLASS D PATCHES
-  PROPOSED SIDEWALK TURNING SPACE

- TW PROPOSED TOP-OF-WALK ELEVATION
- TC PROPOSED TOP-OF-CURB ELEVATION
- EOP PROPOSED EDGE-OF-PAVEMENT ELEVATION
- MATCH MATCH EXISTING ELEVATION
- EP EXISTING EDGE-OF-PAVEMENT ELEVATION
- FL PROPOSED DEPRESSED CURB FLOWLINE ELEVATION

|                                     |                             |            |           |
|-------------------------------------|-----------------------------|------------|-----------|
| FILE NAME =<br>62C93-sht-plan14.dgn | USER NAME = Dwhite          | DESIGNED - | REVISED - |
| Default                             | PLOT SCALE = 10.0000' / in. | DRAWN -    | REVISED - |
|                                     | PLOT DATE = 10/19/2016      | CHECKED -  | REVISED - |
|                                     |                             | DATE -     | REVISED - |





STATE OF ILLINOIS  
 DEPARTMENT OF TRANSPORTATION

**SIDEWALK DETAIL PLAN**  
**IL ROUTE 62 (ALGONQUIN ROAD) AT MEADOWBROOK COURT**


| F.A.P. RTE.               | SECTION         | COUNTY | TOTAL SHEETS | SHEET NO. |
|---------------------------|-----------------|--------|--------------|-----------|
| 339                       | 116Y(1&2)R-R5-6 | COOK   | 58           | 28        |
| CONTRACT NO. 62C93        |                 |        |              |           |
| ILLINOIS FED. AID PROJECT |                 |        |              |           |

SCALE: 1" = 5' SHEET OF SHEETS STA. TO STA.

**LEGEND**

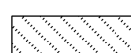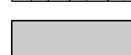-  DETECTABLE WARNINGS
-  DEPRESSED CURB AND GUTTER
-  SIDEWALK REMOVAL  
REPLACE W/TOPSOIL & SOD
-  PROPOSED SIDEWALK TURNING SPACE
- TW PROPOSED TOP-OF-WALK ELEVATION
- TC PROPOSED TOP-OF-CURB ELEVATION
- EOP PROPOSED EDGE-OF-PAVEMENT ELEVATION
- MATCH MATCH EXISTING ELEVATION
- EP EXISTING EDGE-OF-PAVEMENT ELEVATION
- FL PROPOSED DEPRESSED CURB FLOWLINE ELEVATION

SITE BENCHMARK:  
"X" ON SOUTHWEST FLANGE  
BOLT OF FIRE HYDRANT  
ELEVATION = 697.332  
VERT DATUM: NAVD88

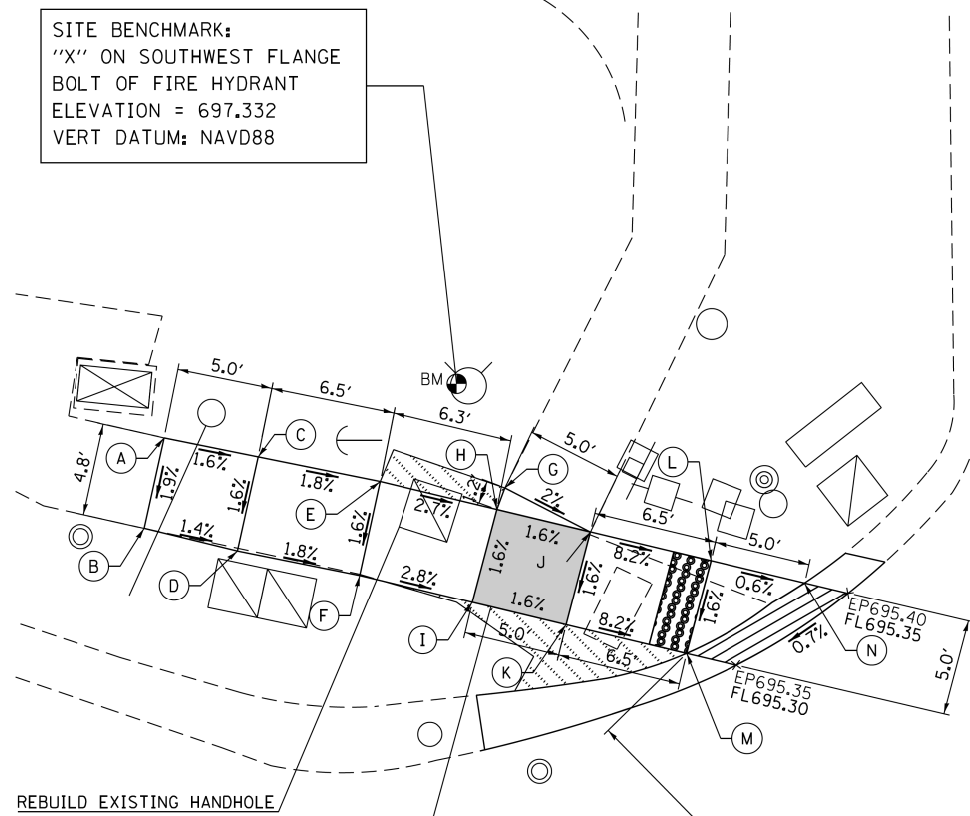

| POINT | ELEV   | NOTE  |
|-------|--------|-------|
| A     | 696.37 | MATCH |
| B     | 696.28 | MATCH |
| C     | 696.29 | TW    |
| D     | 696.21 | TW    |
| E     | 696.17 | TW    |
| F     | 696.09 | TW    |
| G     | 696.05 | MATCH |
| H     | 696.03 | TW    |
| I     | 695.95 | TW    |
| J     | 695.95 | MATCH |
| K     | 695.87 | TW    |
| L     | 695.42 | TW    |
| M     | 695.34 | TW    |
| N     | 695.39 | TW    |
| O     | 696.19 | MATCH |
| P     | 696.20 | MATCH |


| POINT | ELEV   | NOTE  |
|-------|--------|-------|
| Q     | 696.10 | TW    |
| R     | 696.15 | TW    |
| S     | 695.83 | TW    |
| T     | 695.91 | TW    |
| U     | 695.75 | TW    |
| V     | 695.72 | TW=TC |
| W     | 695.80 | TW=TC |
| X     | 695.88 | TW    |
| Y     | 695.96 | TW    |
| Z     | 695.92 | TW    |
| AA    | 695.98 | TW=TC |
| BB    | 695.97 | TW=TC |
| CC    | 696.25 | MATCH |
| DD    | 696.34 | MATCH |
| EE    | 696.28 | MATCH |
| FF    | 696.34 | MATCH |

| POINT | ELEV   | NOTE  |
|-------|--------|-------|
| GG    | 695.84 | TW=TC |
| HH    | 695.89 | TW=TC |
| II    | 696.67 | TW    |
| JJ    | 696.62 | TW    |
| KK    | 696.72 | MATCH |
| LL    | 696.70 | MATCH |


REBUILD EXISTING HANDHOLE

EX SIDEWALK REMOVAL = 182 SF  
PR PCC SIDEWALK 5 IN = 161 SF

**WEBER DR**

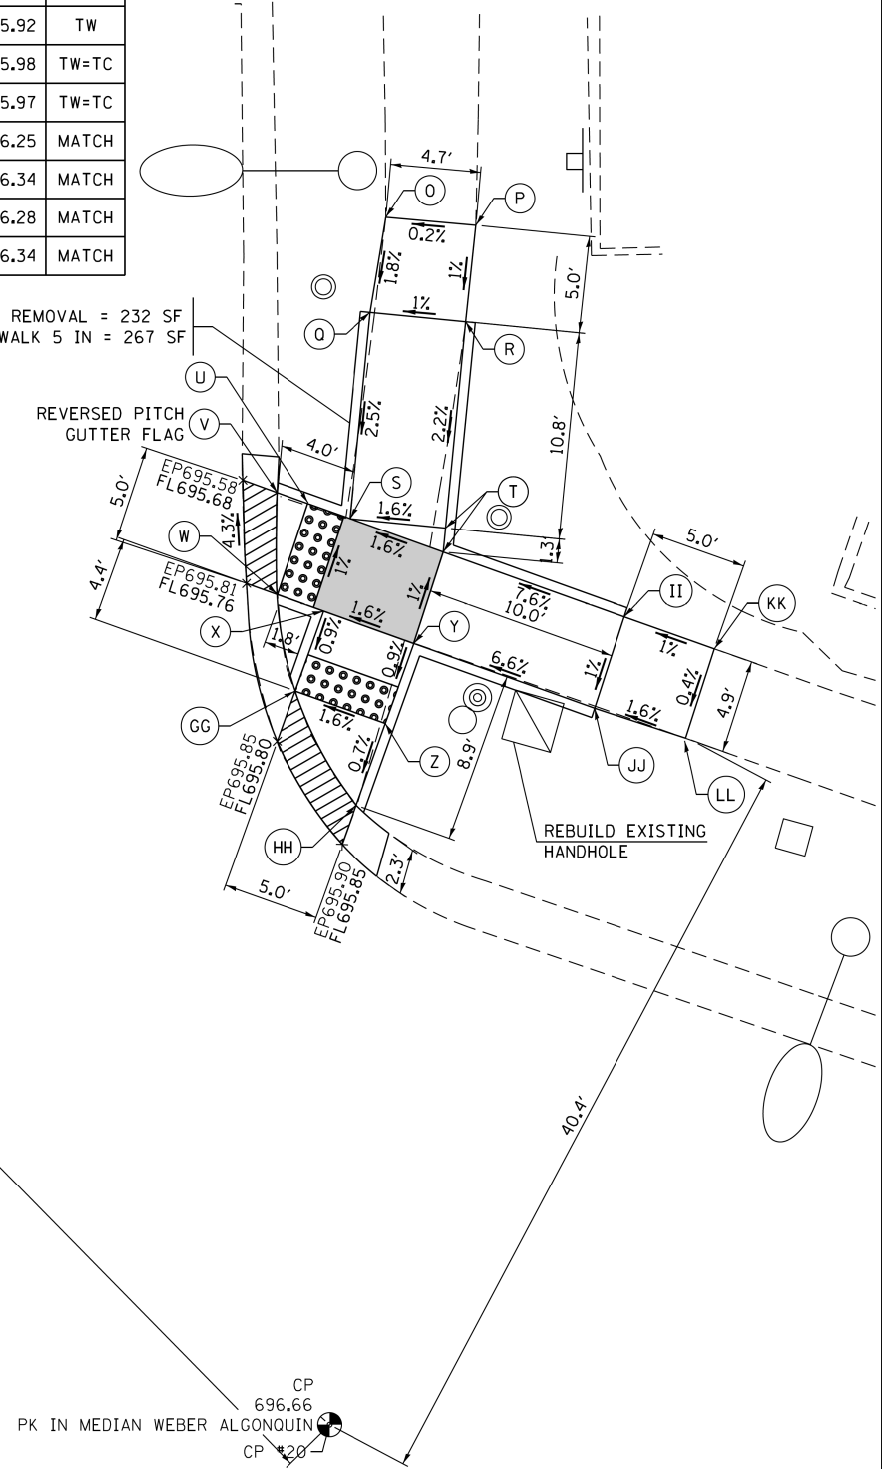

EX SIDEWALK REMOVAL = 232 SF  
PR PCC SIDEWALK 5 IN = 267 SF

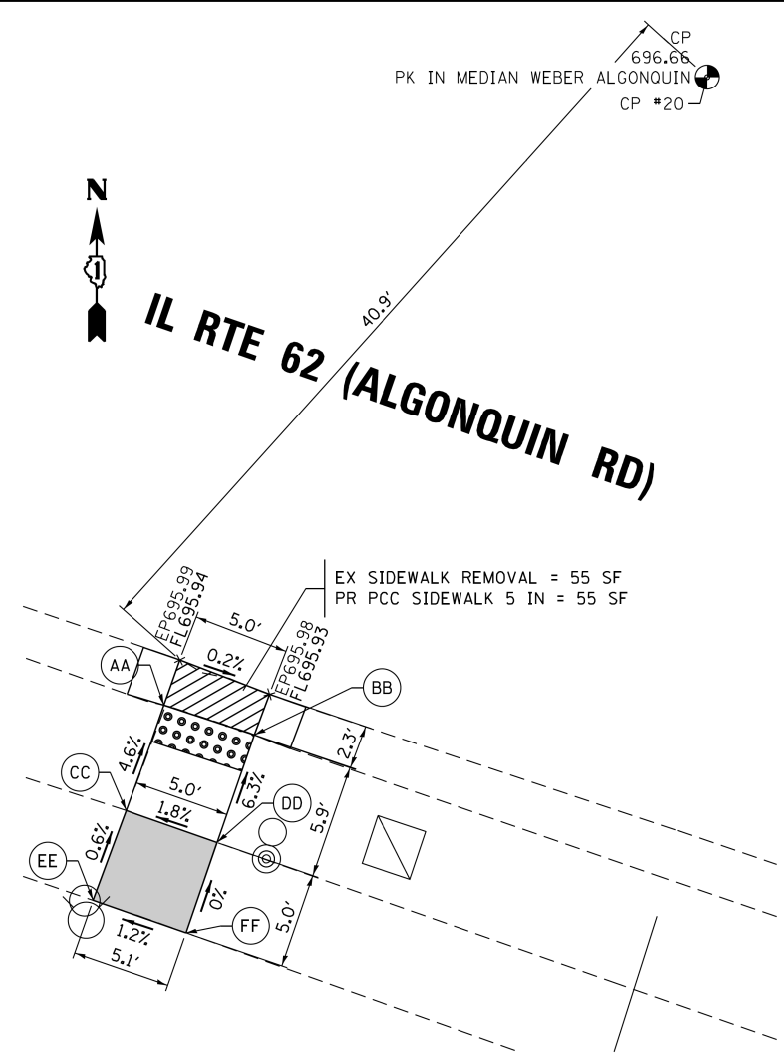

EX SIDEWALK REMOVAL = 55 SF  
PR PCC SIDEWALK 5 IN = 55 SF

FILE NAME = 62C93-sht-plan15.dgn  
Default

USER NAME = Dwhite  
PLOT SCALE = 10.0000' / in.  
PLOT DATE = 10/19/2016

DESIGNED -  
DRAWN -  
CHECKED -  
DATE -

REVISED -  
REVISED -  
REVISED -  
REVISED -


**STATE OF ILLINOIS  
DEPARTMENT OF TRANSPORTATION**

**SIDEWALK DETAIL PLAN  
IL ROUTE 62 (ALGONQUIN ROAD) AT WEBER DRIVE**

SCALE: 1" = 5'  
SHEET OF SHEETS STA. TO STA.

| F.A.P. RTE. | SECTION         | COUNTY | TOTAL SHEETS | SHEET NO. |
|-------------|-----------------|--------|--------------|-----------|
| 339         | 116Y(1&2)R-R5-6 | COOK   | 58           | 29        |

CONTRACT NO. 62C93  
ILLINOIS FED. AID PROJECT

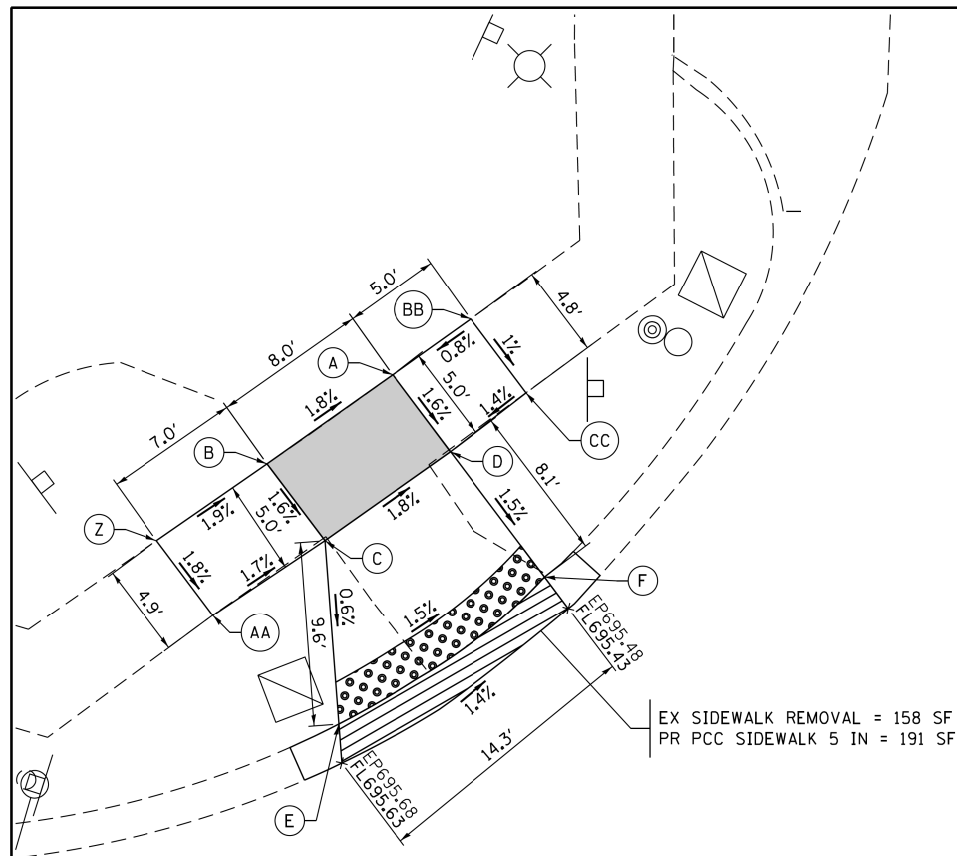

EX SIDEWALK REMOVAL = 158 SF  
PR PCC SIDEWALK 5 IN = 191 SF

**IL RTE 62 (ALGONQUIN RD)**

**NEW WILKE RD**

**LEGEND**

- DETECTABLE WARNINGS
- DEPRESSED CURB AND GUTTER
- SIDEWALK REMOVAL  
REPLACE W/TOPSOIL & SOD
- PROPOSED SIDEWALK TURNING SPACE

- TW PROPOSED TOP-OF-WALK ELEVATION
- TC PROPOSED TOP-OF-CURB ELEVATION
- EOP PROPOSED EDGE-OF-PAVEMENT ELEVATION
- MATCH MATCH EXISTING ELEVATION
- EP EXISTING EDGE-OF-PAVEMENT ELEVATION
- FL PROPOSED DEPRESSED CURB FLOWLINE ELEVATION

| POINT | ELEV   | NOTE  |
|-------|--------|-------|
| A     | 695.67 | TW    |
| B     | 695.81 | TW    |
| C     | 695.73 | TW    |
| D     | 695.59 | TW    |
| E     | 695.67 | TW=TC |
| F     | 695.47 | TW=TC |
| G     | 695.72 | TW=TC |
| H     | 695.76 | TW=TC |
| I     | 695.82 | TW=TC |
| J     | 695.95 | TW    |
| K     | 695.77 | TW    |
| L     | 695.92 | TW    |
| M     | 696.11 | TW    |
| N     | 696.27 | TW    |
| O     | 696.17 | TW    |
| P     | 696.33 | TW    |
| Q     | 696.02 | MATCH |
| R     | 696.45 | MATCH |
| S     | 695.90 | TW    |
| T     | 696.60 | TW    |
| U     | 696.50 | TW    |
| V     | 696.58 | TW    |
| W     | 696.67 | TW    |
| X     | 696.67 | MATCH |
| Y     | 696.89 | MATCH |
| Z     | 695.94 | MATCH |
| AA    | 695.85 | MATCH |
| BB    | 695.71 | MATCH |
| CC    | 695.66 | MATCH |

EX SIDEWALK CROSS SLOPE EXCEEDS 2.0% ACROSS THE DRIVEWAY ENTRANCE

REBUILD EXISTING HANDHOLE

MANHOLES TO BE ADJUSTED

EX GAS VALUE ADJUSTMENT BY OTHERS

EX SIDEWALK REMOVAL = 278 SF  
PR PCC SIDEWALK 5 IN = 303 SF


EX SIDEWALK CROSS SLOPE EXCEEDS 2.0% ACROSS THE DRIVEWAY ENTRANCE

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| Default                             |                              | DRAWN -    | REVISED - |
|                                     | PLOT SCALE = 10.0000' / 1in. | CHECKED -  | REVISED - |
|                                     | PLOT DATE = 10/19/2016       | DATE -     | REVISED - |

**STATE OF ILLINOIS  
DEPARTMENT OF TRANSPORTATION**

**SIDEWALK DETAIL PLAN  
IL ROUTE 62 (ALGONQUIN ROAD) AT NEW WILKE ROAD**  
SCALE: 1" = 5'  
SHEET OF SHEETS STA. TO STA.

|                           |                 |        |              |           |
|---------------------------|-----------------|--------|--------------|-----------|
| F.A.P. RTE.               | SECTION         | COUNTY | TOTAL SHEETS | SHEET NO. |
| 339                       | 116Y(1&2)R-R5-6 | COOK   | 58           | 30        |
| CONTRACT NO. 62C93        |                 |        |              |           |
| ILLINOIS FED. AID PROJECT |                 |        |              |           |

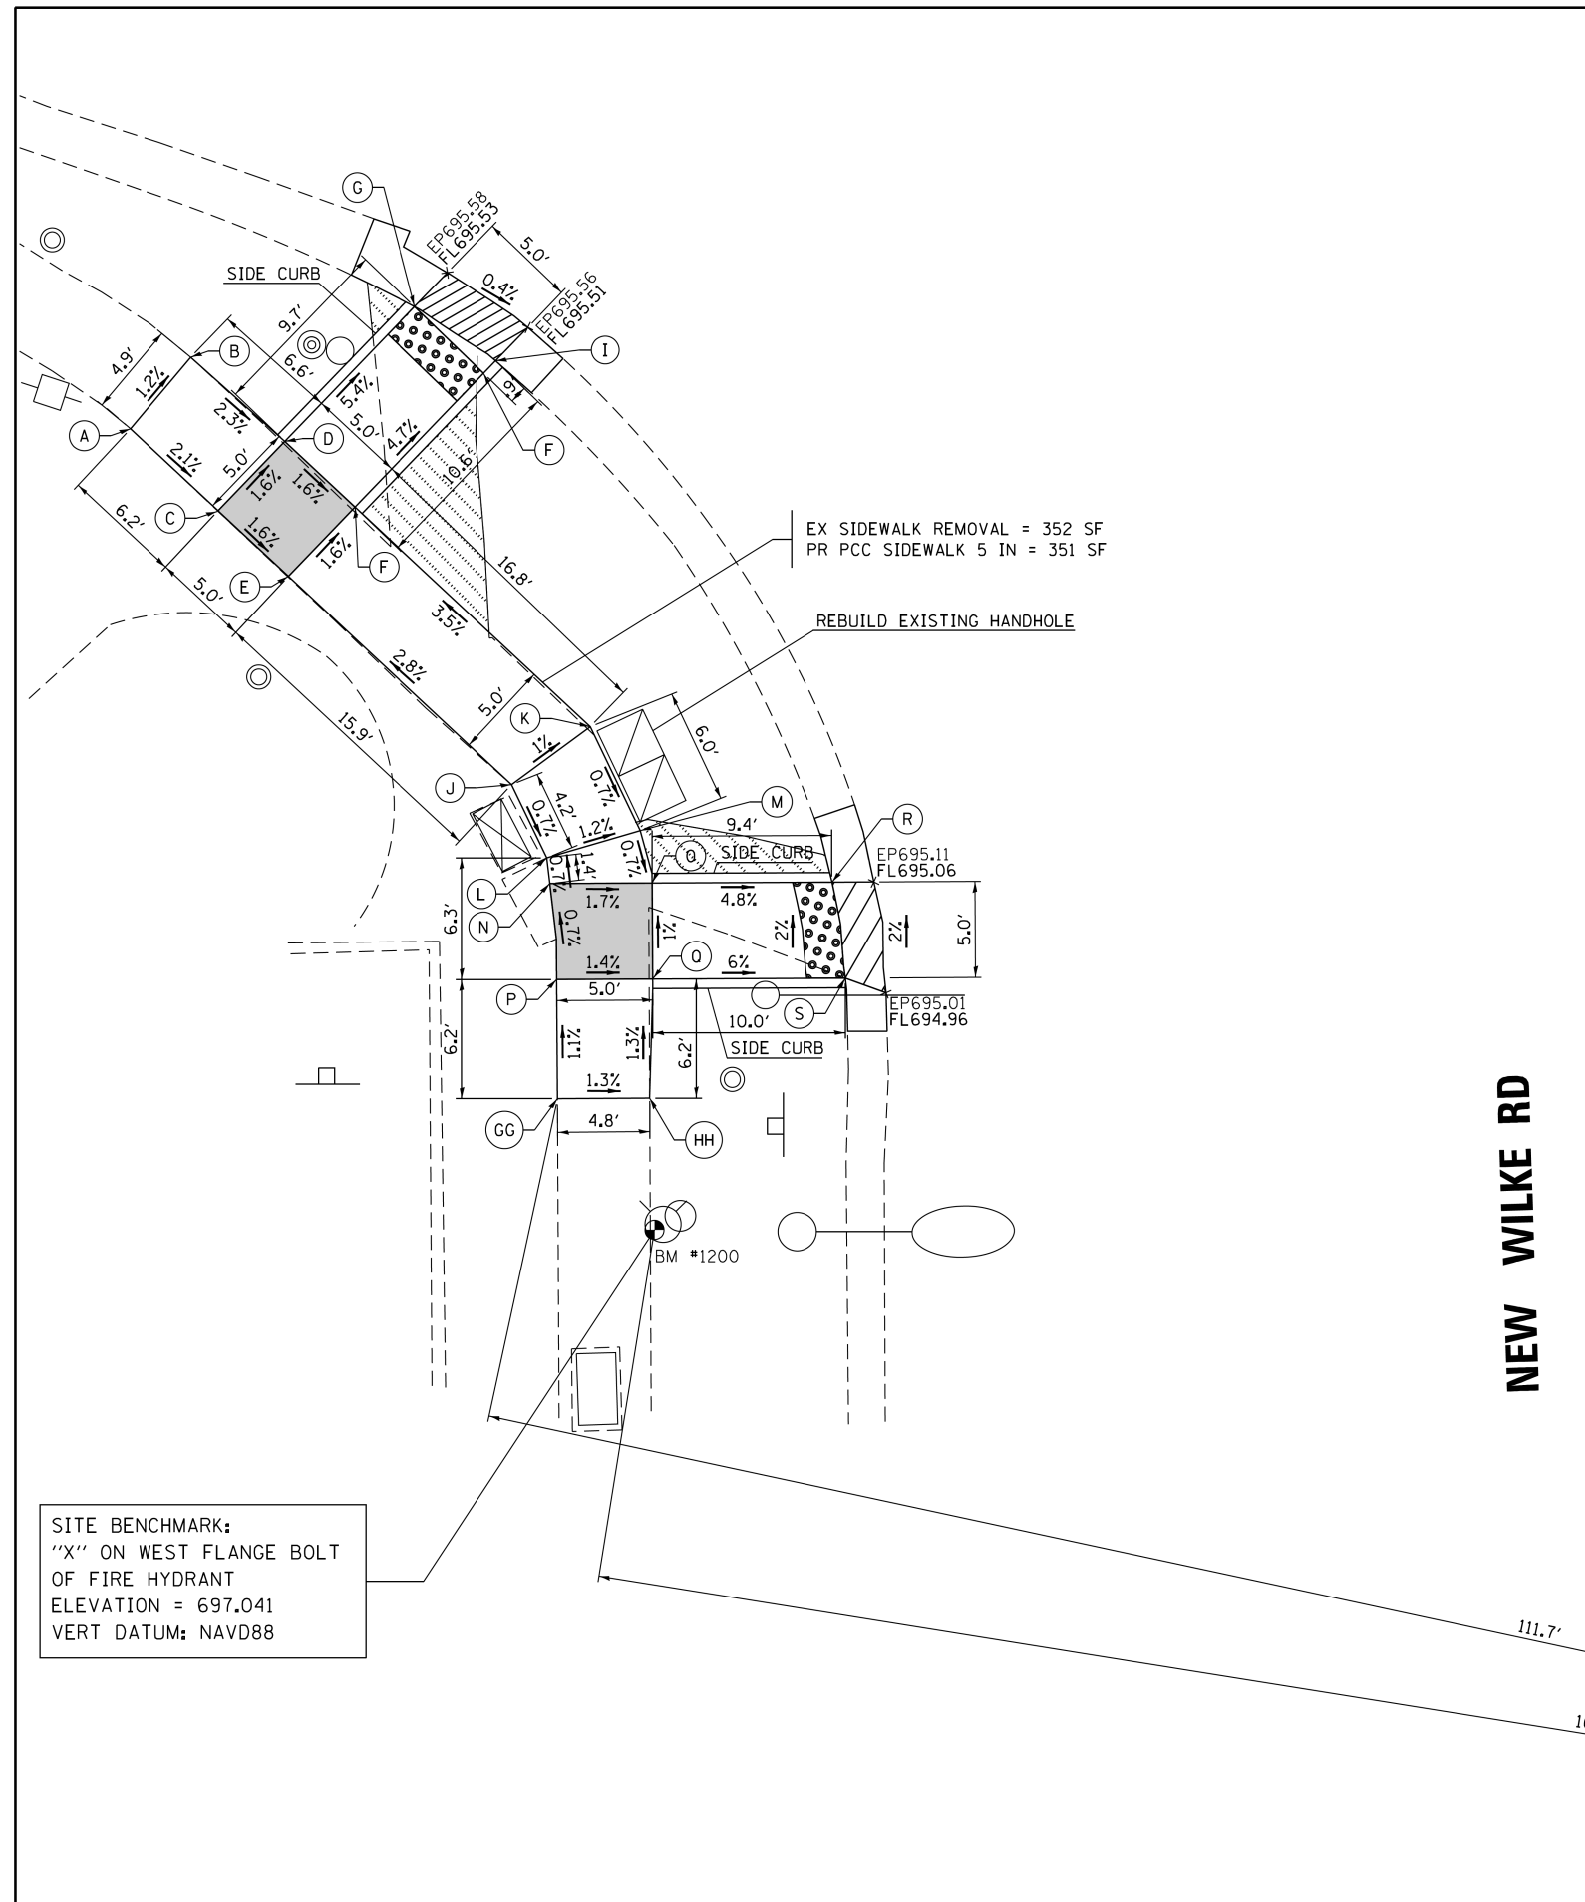





SITE BENCHMARK:  
 "X" ON WEST FLANGE BOLT  
 OF FIRE HYDRANT  
 ELEVATION = 697.041  
 VERT DATUM: NAVD88


| POINT | ELEV   | NOTE  |
|-------|--------|-------|
| A     | 696.31 | MATCH |
| B     | 696.25 | MATCH |
| C     | 696.18 | TW    |
| D     | 696.10 | TW    |
| E     | 696.10 | TW    |
| F     | 696.02 | TW    |
| G     | 695.57 | TW=TC |
| H     | 695.57 | TW    |
| I     | 695.55 | TW=TC |
| J     | 695.66 | MATCH |
| K     | 695.61 | TW    |
| L     | 695.63 | MATCH |
| M     | 695.57 | TW    |
| N     | 695.64 | MATCH |
| O     | 695.55 | TW    |
| P     | 695.67 | TW    |
| Q     | 695.60 | TW    |
| R     | 695.10 | TW=TC |
| S     | 695.00 | TW=TC |
| T     | 695.10 | TW=TC |
| U     | 695.12 | TW=TC |
| V     | 695.19 | TW=TC |
| W     | 695.33 | TW    |
| X     | 695.43 | TW    |
| Y     | 695.17 | TW    |
| Z     | 695.26 | TW    |
| AA    | 695.26 | TW    |
| BB    | 695.88 | TW    |
| CC    | 695.80 | TW    |
| DD    | 695.21 | TW    |
| EE    | 695.37 | MATCH |
| FF    | 695.53 | MATCH |
| GG    | 695.74 | MATCH |
| HH    | 695.68 | MATCH |




**LEGEND**

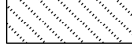



-  DETECTABLE WARNINGS
-  DEPRESSED CURB AND GUTTER
-  SIDEWALK REMOVAL  
REPLACE W/TOPSOIL & SOD
-  PROPOSED SIDEWALK TURNING SPACE
- TW PROPOSED TOP-OF-WALK ELEVATION
- TC PROPOSED TOP-OF-CURB ELEVATION
- EOP PROPOSED EDGE-OF-PAVEMENT ELEVATION
- MATCH MATCH EXISTING ELEVATION
- EP EXISTING EDGE-OF-PAVEMENT ELEVATION
- FL PROPOSED DEPRESSED CURB FLOWLINE ELEVATION

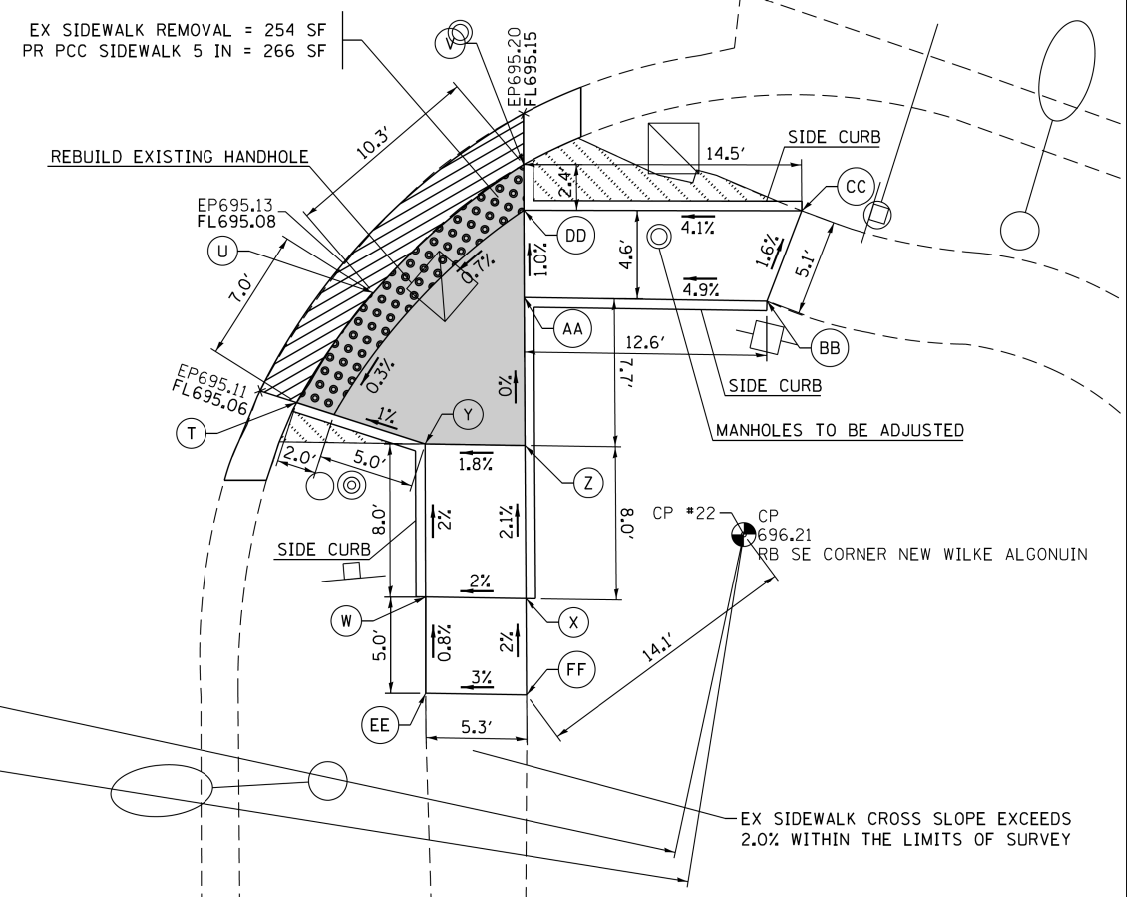**IL RTE 62 (ALGONQUIN RD)**

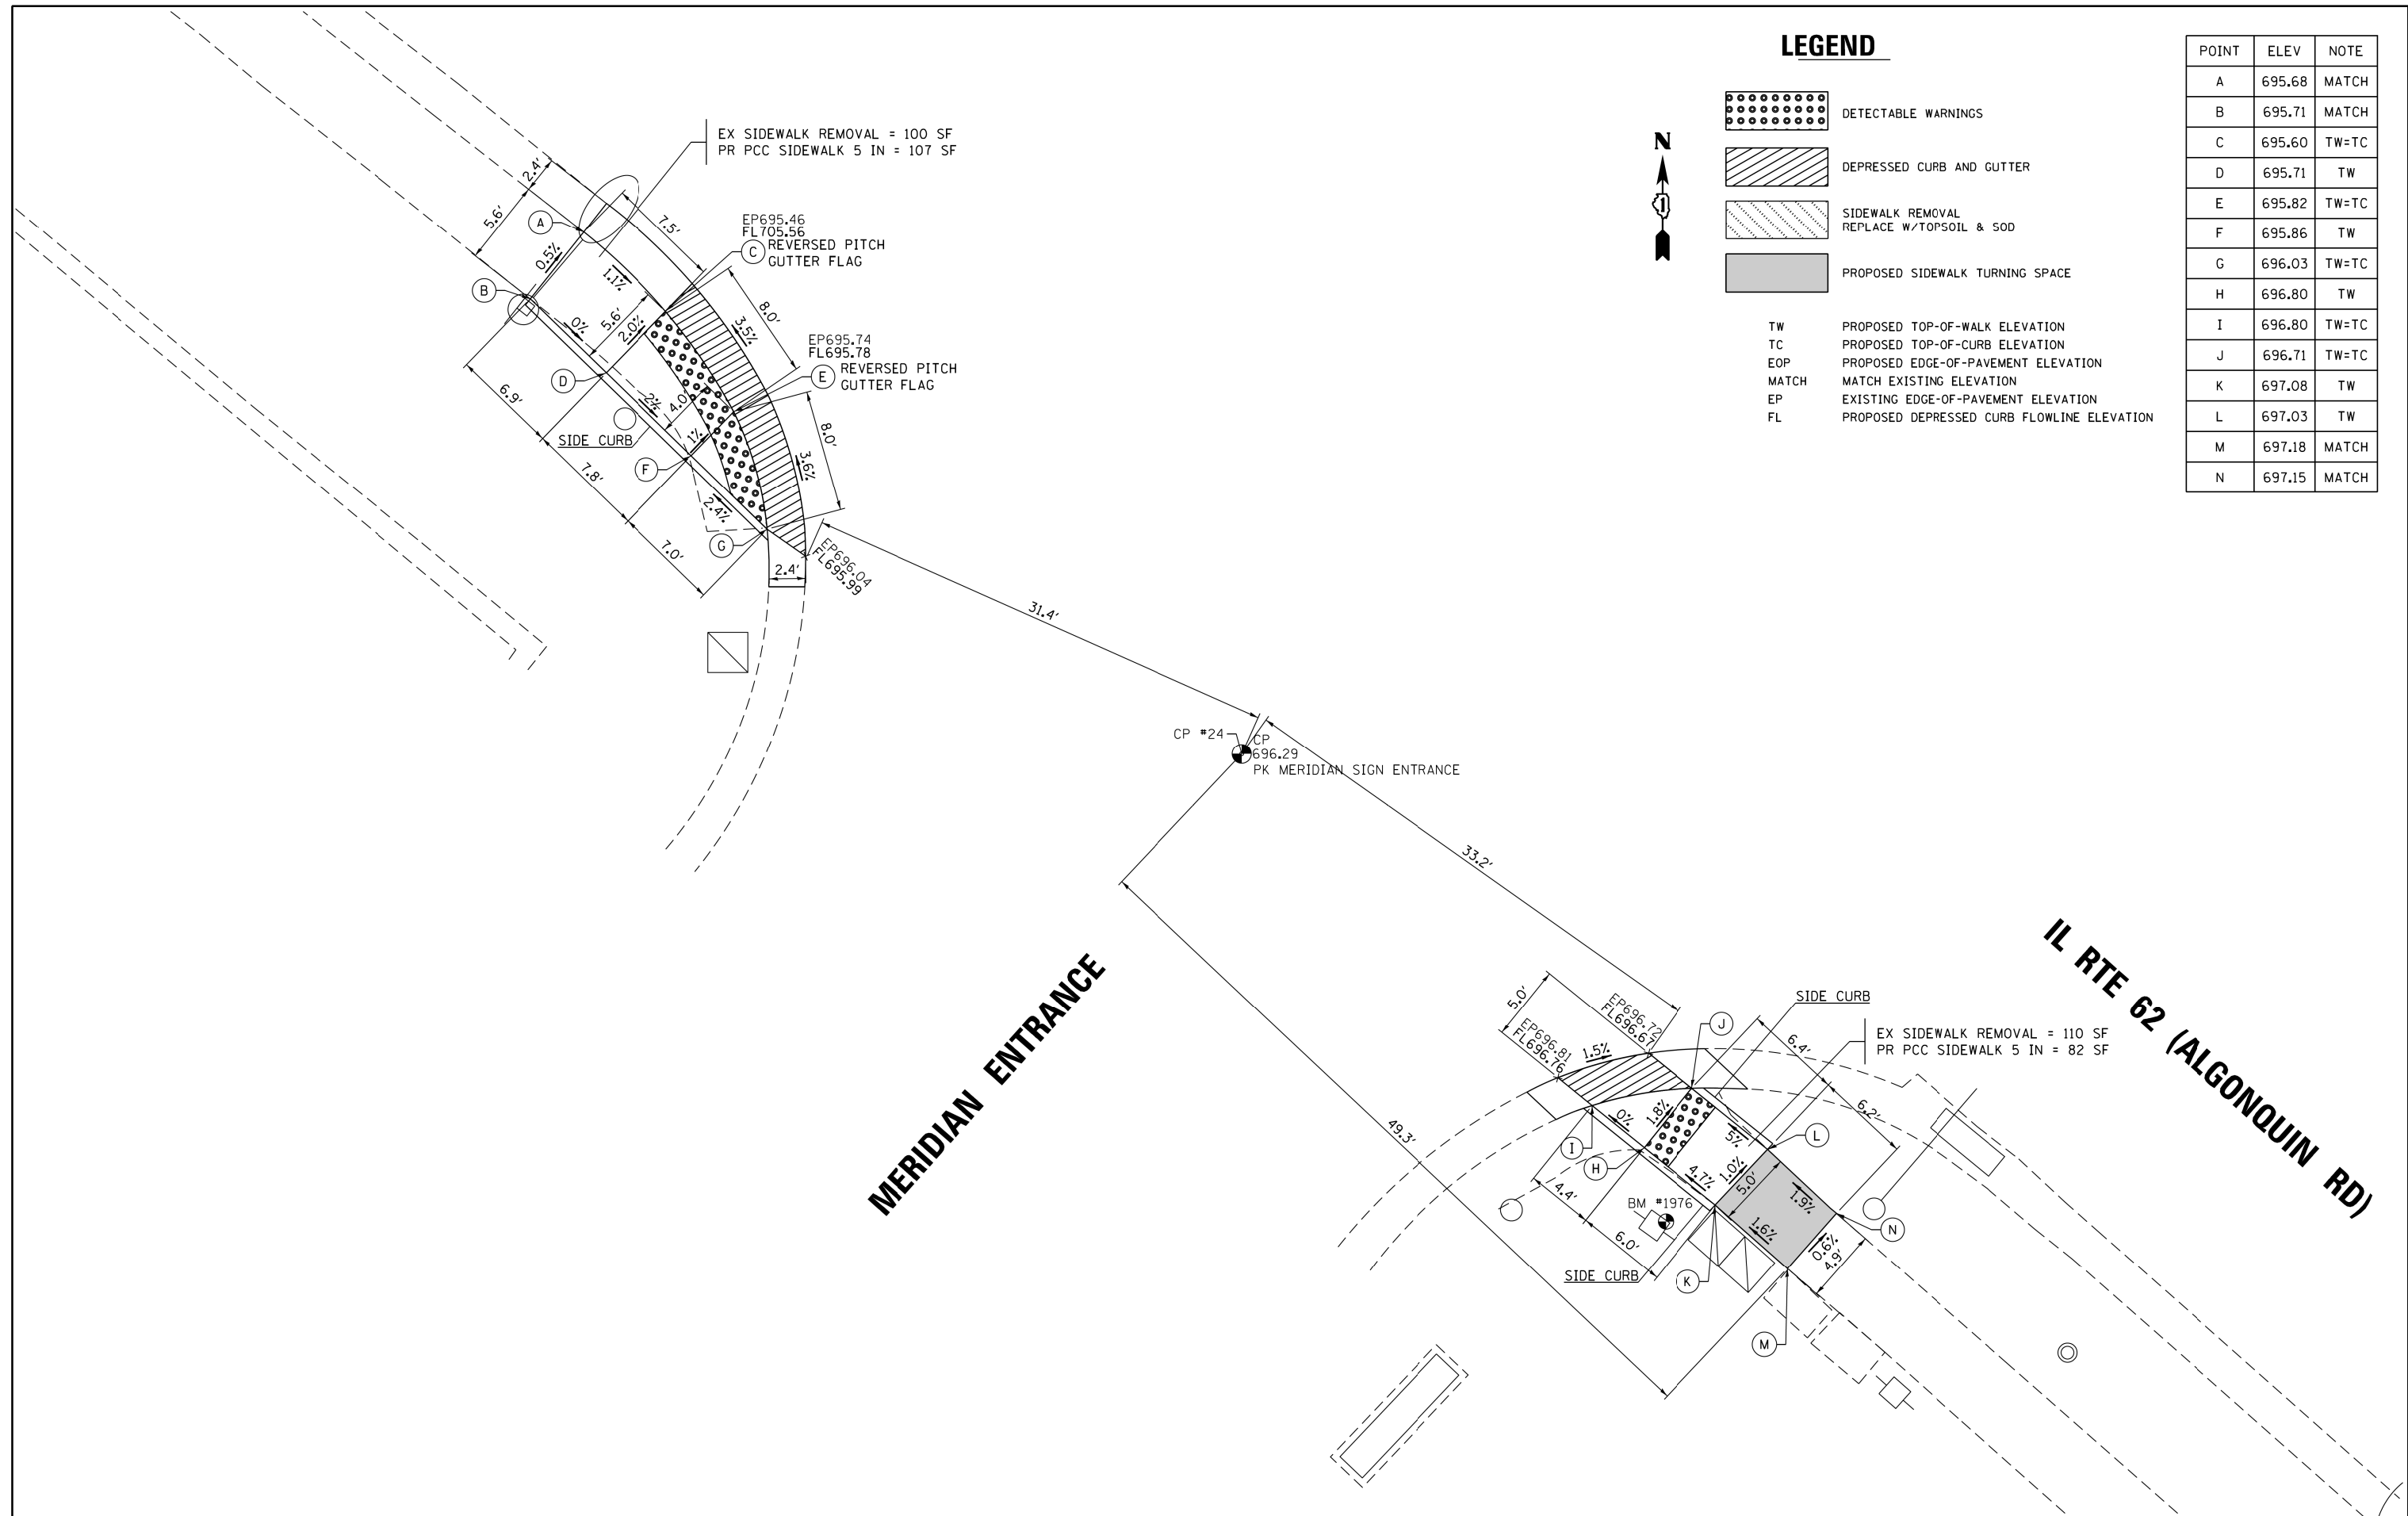



**LEGEND**

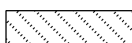-  DETECTABLE WARNINGS
-  DEPRESSED CURB AND GUTTER
-  SIDEWALK REMOVAL  
REPLACE W/TOPSOIL & SOD
-  PROPOSED SIDEWALK TURNING SPACE
- TW PROPOSED TOP-OF-WALK ELEVATION
- TC PROPOSED TOP-OF-CURB ELEVATION
- EOP PROPOSED EDGE-OF-PAVEMENT ELEVATION
- MATCH MATCH EXISTING ELEVATION
- EP EXISTING EDGE-OF-PAVEMENT ELEVATION
- FL PROPOSED DEPRESSED CURB FLOWLINE ELEVATION




| POINT | ELEV   | NOTE  |
|-------|--------|-------|
| A     | 695.68 | MATCH |
| B     | 695.71 | MATCH |
| C     | 695.60 | TW=TC |
| D     | 695.71 | TW    |
| E     | 695.82 | TW=TC |
| F     | 695.86 | TW    |
| G     | 696.03 | TW=TC |
| H     | 696.80 | TW    |
| I     | 696.80 | TW=TC |
| J     | 696.71 | TW=TC |
| K     | 697.08 | TW    |
| L     | 697.03 | TW    |
| M     | 697.18 | MATCH |
| N     | 697.15 | MATCH |





| POINT | ELEV   | NOTE  |
|-------|--------|-------|
| A     | 705.94 | MATCH |
| B     | 706.14 | MATCH |
| C     | 706.05 | TW    |
| D     | 706.15 | TW    |
| E     | 706.18 | MATCH |
| F     | 706.14 | MATCH |
| G     | 706.10 | TW    |
| H     | 706.00 | TW    |
| I     | 706.04 | TW    |
| J     | 705.68 | TW    |
| K     | 705.63 | TW=TC |
| L     | 705.63 | TW=TC |
| M     | 705.78 | TW=TC |
| N     | 705.90 | TW=TC |
| O     | 705.81 | TW    |
| P     | 706.71 | TW    |
| Q     | 706.65 | TW    |
| R     | 706.79 | TW    |
| S     | 706.71 | TW    |
| T     | 707.85 | TW    |
| U     | 707.93 | TW    |
| V     | 706.83 | TW    |
| W     | 706.89 | TW    |
| X     | 706.75 | MATCH |
| Y     | 706.97 | MATCH |
| Z     | 707.93 | TW    |
| AA    | 708.01 | TW    |
| BB    | 706.14 | TW    |
| CC    | 708.11 | MATCH |
| DD    | 707.95 | MATCH |

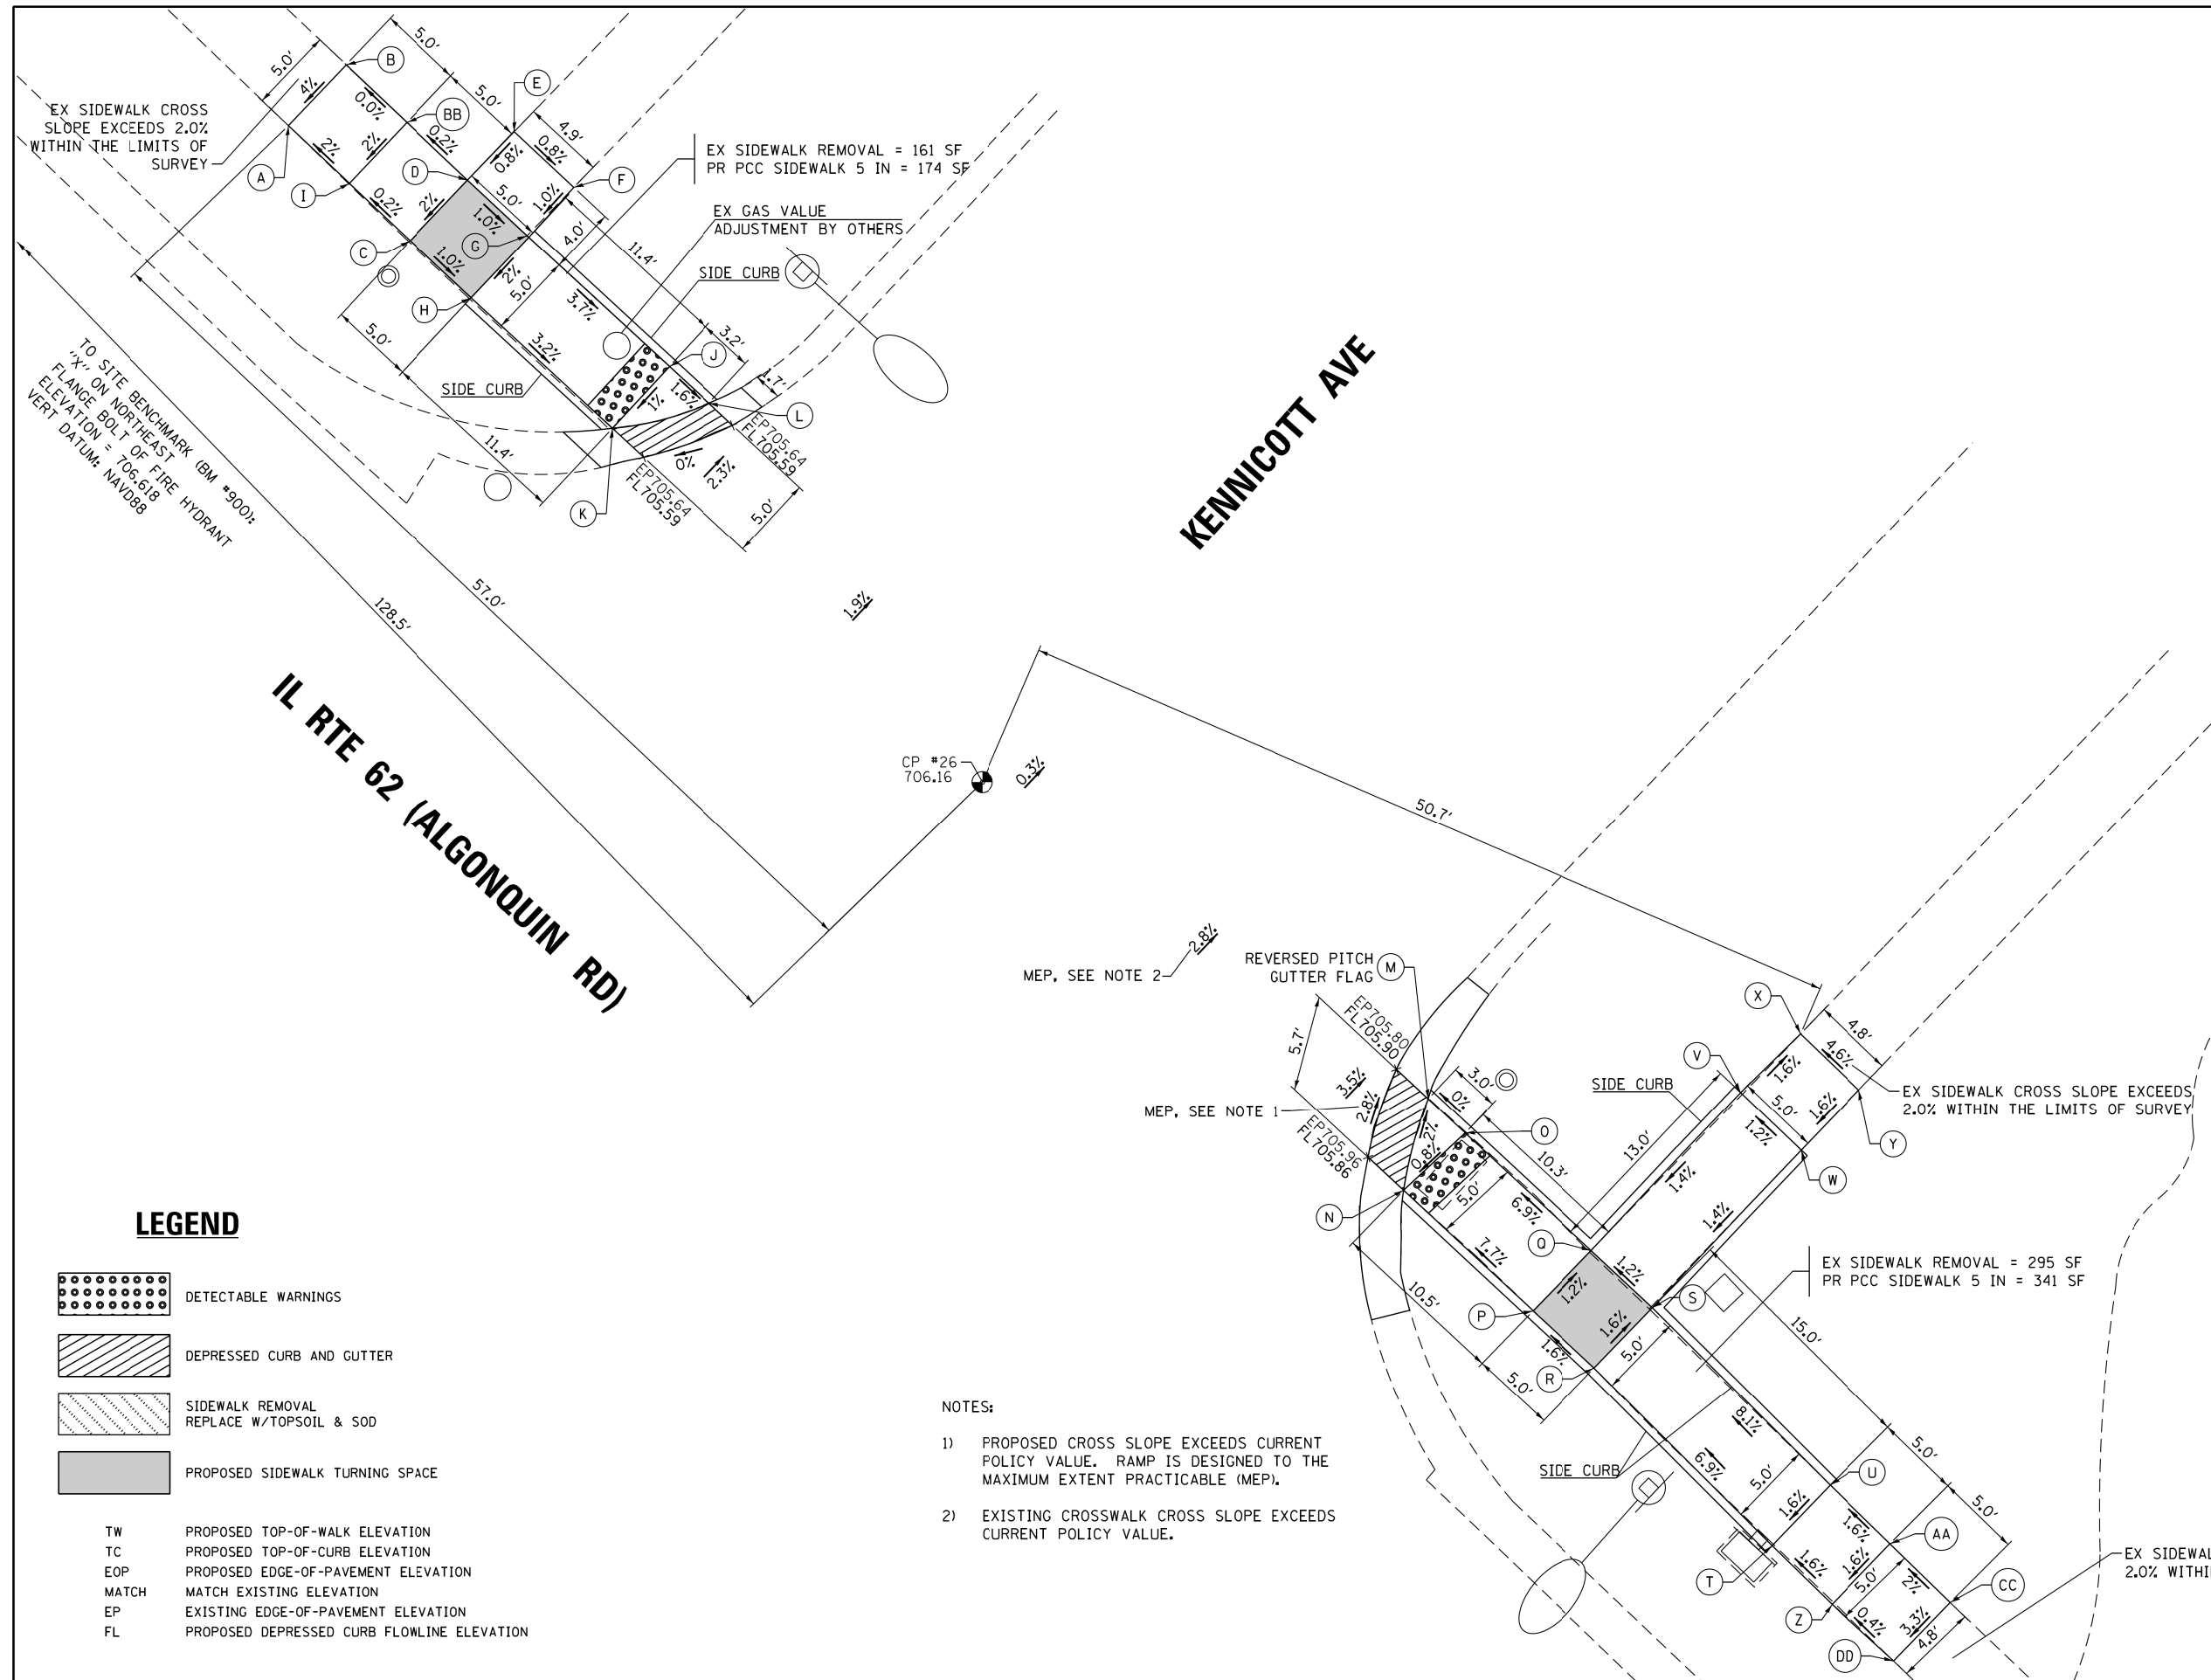

**LEGEND**

- DETECTABLE WARNINGS
- DEPRESSED CURB AND GUTTER
- SIDEWALK REMOVAL REPLACE W/TOPSOIL & SOD
- PROPOSED SIDEWALK TURNING SPACE
  
- TW PROPOSED TOP-OF-WALK ELEVATION
- TC PROPOSED TOP-OF-CURB ELEVATION
- EOP PROPOSED EDGE-OF-PAVEMENT ELEVATION
- MATCH MATCH EXISTING ELEVATION
- EP EXISTING EDGE-OF-PAVEMENT ELEVATION
- FL PROPOSED DEPRESSED CURB FLOWLINE ELEVATION

**NOTES:**

- 1) PROPOSED CROSS SLOPE EXCEEDS CURRENT POLICY VALUE. RAMP IS DESIGNED TO THE MAXIMUM EXTENT PRACTICABLE (MEP).
- 2) EXISTING CROSSWALK CROSS SLOPE EXCEEDS CURRENT POLICY VALUE.

|                                 |                              |            |           |
|---------------------------------|------------------------------|------------|-----------|
| FILE NAME = 62C93-sht-pln19.dgn | USER NAME = Dwhite           | DESIGNED - | REVISED - |
| Default                         |                              | DRAWN -    | REVISED - |
|                                 | PLOT SCALE = 10.0000' / 1in. | CHECKED -  | REVISED - |
|                                 | PLOT DATE = 10/19/2016       | DATE -     | REVISED - |

**STATE OF ILLINOIS  
DEPARTMENT OF TRANSPORTATION**

**SIDEWALK DETAIL PLAN  
IL ROUTE 62 (ALGONQUIN ROAD) AT KENNICOTT AVENUE**

SCALE: 1" = 5'    SHEET OF SHEETS    STA. TO STA.

|                           |                         |             |                 |              |
|---------------------------|-------------------------|-------------|-----------------|--------------|
| F.A.P. RTE. 339           | SECTION 116Y(1&2)R-R5-6 | COUNTY COOK | TOTAL SHEETS 58 | SHEET NO. 33 |
| CONTRACT NO. 62C93        |                         |             |                 |              |
| ILLINOIS FED. AID PROJECT |                         |             |                 |              |



| POINT | ELEV   | NOTE  |
|-------|--------|-------|
| A     | 711.45 | MATCH |
| B     | 711.47 | MATCH |
| C     | 711.00 | TW=TC |
| D     | 711.39 | TW    |
| E     | 711.06 | TW=TC |
| F     | 711.33 | TW    |
| G     | 711.12 | TW    |
| H     | 711.85 | TW=TC |
| I     | 711.78 | TW=TC |
| J     | 711.85 | TW    |
| K     | 711.79 | TW=TC |
| L     | 712.17 | TW    |
| M     | 712.11 | MATCH |
| N     | 712.20 | TW    |
| O     | 712.14 | MATCH |
| P     | 712.26 | MATCH |
| Q     | 712.15 | MATCH |
| R     | 711.85 | TW    |

**NOTES:**

- 1) PROPOSED CROSS SLOPE EXCEEDS CURRENT POLICY VALUE. RAMP IS DESIGNED TO THE MAXIMUM EXTENT PRACTICABLE (MEP).
- 2) EXISTING CROSSWALK CROSS SLOPE EXCEEDS CURRENT POLICY VALUE.

EX SIDEWALK REMOVAL = 73 SF  
PR PCC SIDEWALK 5 IN = 93 SF

REVERSED PITCH  
GUTTER FLAG

MEP, SEE NOTE 1-





CP #27  
711.48

MEP, SEE NOTE 2-

**LOWES ENTRANCE**

**IL RTE 62 (ALGONQUIN RD)**

**LEGEND**

-  DETECTABLE WARNINGS
-  DEPRESSED CURB AND GUTTER
-  SIDEWALK REMOVAL  
REPLACE W/TOPSOIL & SOD
-  PROPOSED SIDEWALK TURNING SPACE
- TW PROPOSED TOP-OF-WALK ELEVATION
- TC PROPOSED TOP-OF-CURB ELEVATION
- EOP PROPOSED EDGE-OF-PAVEMENT ELEVATION
- MATCH MATCH EXISTING ELEVATION
- EP EXISTING EDGE-OF-PAVEMENT ELEVATION
- FL PROPOSED DEPRESSED CURB FLOWLINE ELEVATION

EX SIDEWALK REMOVAL = 110 SF  
PR PCC SIDEWALK 5 IN = 120 SF

EX SIDEWALK CROSS SLOPE EXCEEDS  
2.0% WITHIN THE LIMITS OF SURVEY

TO SITE BENCHMARK (BM #600):  
"X" ON SOUTH SIDE OF LIGHT POLE PAD  
ELEVATION = 715.289  
VERT DATUM: NAVD88


|                                     |                             |            |           |
|-------------------------------------|-----------------------------|------------|-----------|
| FILE NAME =<br>62C93-sht-plan20.dgn | USER NAME = Dwhite          | DESIGNED - | REVISED - |
| Default                             | PLOT SCALE = 10.0000' / in. | DRAWN -    | REVISED - |
|                                     | PLOT DATE = 10/19/2016      | CHECKED -  | REVISED - |
|                                     |                             | DATE -     | REVISED - |

**STATE OF ILLINOIS  
DEPARTMENT OF TRANSPORTATION**

**SIDEWALK DETAIL PLAN  
IL ROUTE 62 (ALGONQUIN ROAD) AT LOWES ENTRANCE**

|                           |                 |        |                 |              |
|---------------------------|-----------------|--------|-----------------|--------------|
| F.A.P.<br>RTE.            | SECTION         | COUNTY | TOTAL<br>SHEETS | SHEET<br>NO. |
| 339                       | 116Y(1&2)R-R5-6 | COOK   | 58              | 34           |
| CONTRACT NO. 62C93        |                 |        |                 |              |
| ILLINOIS FED. AID PROJECT |                 |        |                 |              |

SCALE: 1" = 5' SHEET OF SHEETS STA. TO STA.

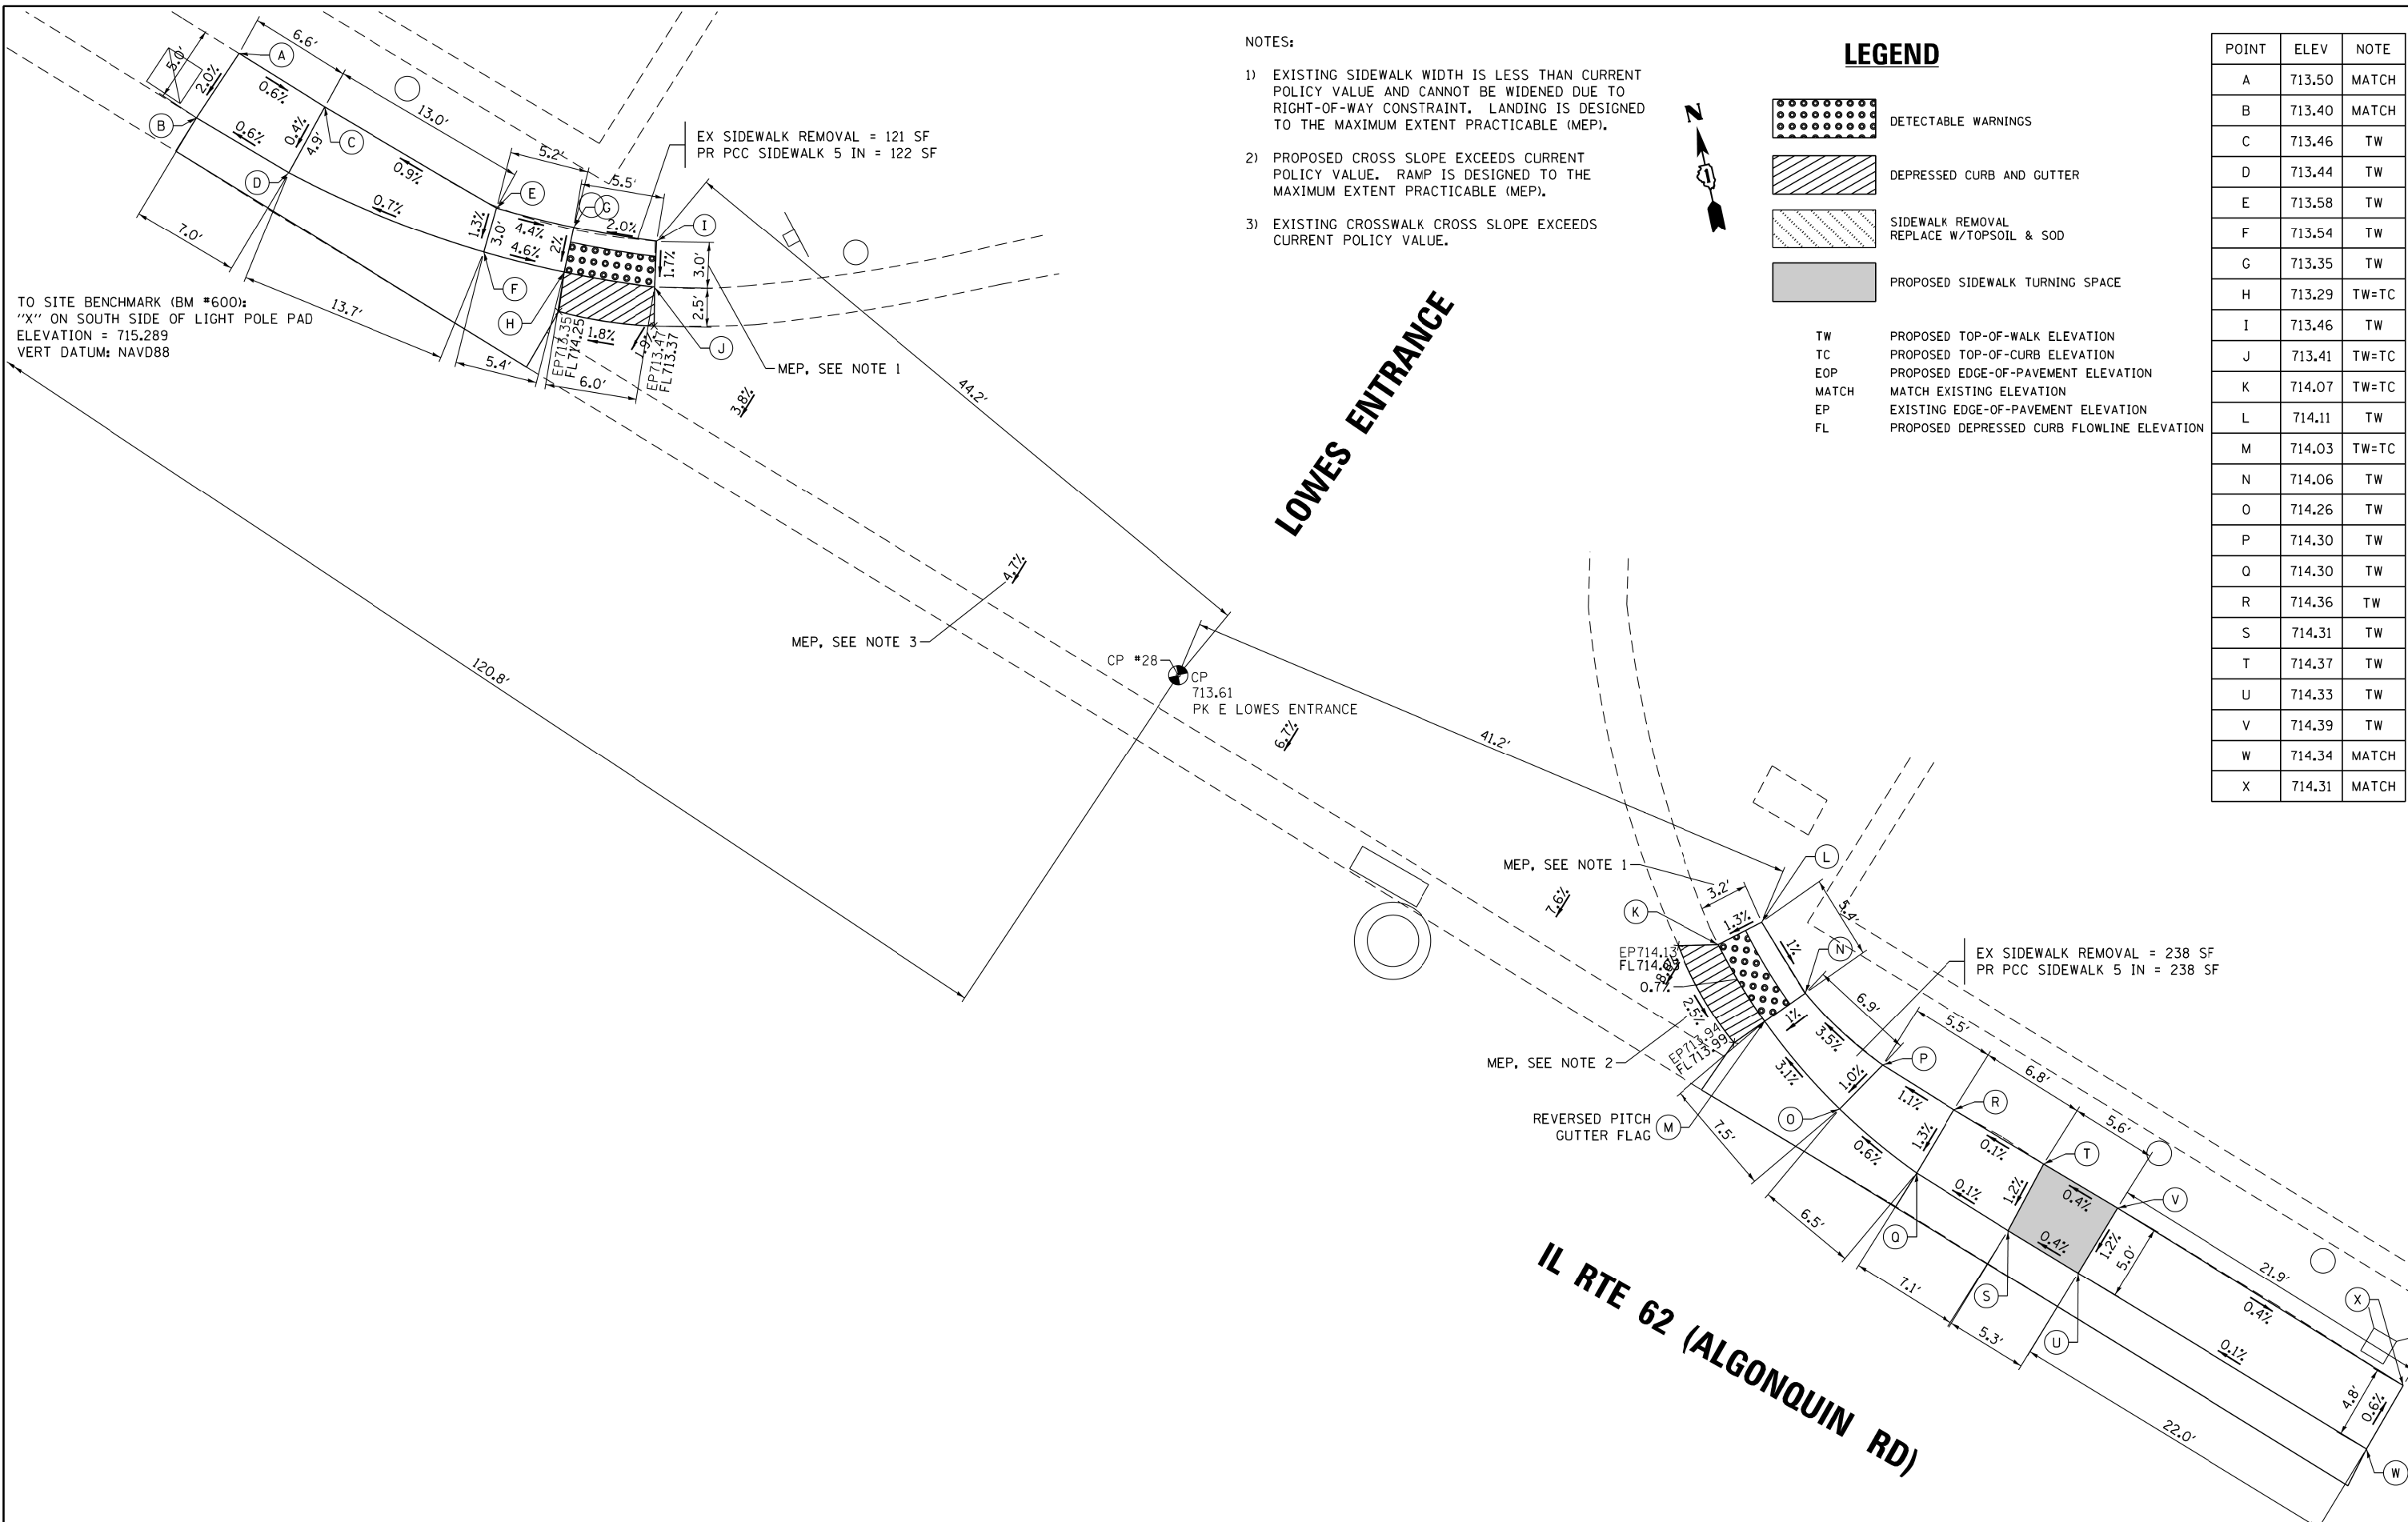

**NOTES:**

- 1) EXISTING SIDEWALK WIDTH IS LESS THAN CURRENT POLICY VALUE AND CANNOT BE WIDENED DUE TO RIGHT-OF-WAY CONSTRAINT. LANDING IS DESIGNED TO THE MAXIMUM EXTENT PRACTICABLE (MEP).
- 2) PROPOSED CROSS SLOPE EXCEEDS CURRENT POLICY VALUE. RAMP IS DESIGNED TO THE MAXIMUM EXTENT PRACTICABLE (MEP).
- 3) EXISTING CROSSWALK CROSS SLOPE EXCEEDS CURRENT POLICY VALUE.

**LEGEND**

- DETECTABLE WARNINGS
  - DEPRESSED CURB AND GUTTER
  - SIDEWALK REMOVAL REPLACE W/TOPSOIL & SOD
  - PROPOSED SIDEWALK TURNING SPACE
- TW PROPOSED TOP-OF-WALK ELEVATION  
 TC PROPOSED TOP-OF-CURB ELEVATION  
 EOP PROPOSED EDGE-OF-PAVEMENT ELEVATION  
 MATCH MATCH EXISTING ELEVATION  
 EP EXISTING EDGE-OF-PAVEMENT ELEVATION  
 FL PROPOSED DEPRESSED CURB FLOWLINE ELEVATION

| POINT | ELEV   | NOTE  |
|-------|--------|-------|
| A     | 713.50 | MATCH |
| B     | 713.40 | MATCH |
| C     | 713.46 | TW    |
| D     | 713.44 | TW    |
| E     | 713.58 | TW    |
| F     | 713.54 | TW    |
| G     | 713.35 | TW    |
| H     | 713.29 | TW=TC |
| I     | 713.46 | TW    |
| J     | 713.41 | TW=TC |
| K     | 714.07 | TW=TC |
| L     | 714.11 | TW    |
| M     | 714.03 | TW=TC |
| N     | 714.06 | TW    |
| O     | 714.26 | TW    |
| P     | 714.30 | TW    |
| Q     | 714.30 | TW    |
| R     | 714.36 | TW    |
| S     | 714.31 | TW    |
| T     | 714.37 | TW    |
| U     | 714.33 | TW    |
| V     | 714.39 | TW    |
| W     | 714.34 | MATCH |
| X     | 714.31 | MATCH |

TO SITE BENCHMARK (BM #600):  
 "X" ON SOUTH SIDE OF LIGHT POLE PAD  
 ELEVATION = 715.289  
 VERT DATUM: NAVD88

EX SIDEWALK REMOVAL = 121 SF  
 PR PCC SIDEWALK 5 IN = 122 SF

EX SIDEWALK REMOVAL = 238 SF  
 PR PCC SIDEWALK 5 IN = 238 SF

STATE OF ILLINOIS  
 DEPARTMENT OF TRANSPORTATION

SIDEWALK DETAIL PLAN  
 IL ROUTE 62 (ALGONQUIN ROAD) AT LOWES ENTRANCE

|                    |                 |        |              |           |
|--------------------|-----------------|--------|--------------|-----------|
| F.A.P. RTE.        | SECTION         | COUNTY | TOTAL SHEETS | SHEET NO. |
| 339                | 116Y(1&2)R-R5-6 | COOK   | 58           | 35        |
| CONTRACT NO. 62C93 |                 |        |              |           |


|                      |                             |            |           |
|----------------------|-----------------------------|------------|-----------|
| FILE NAME =          | USER NAME = Dwhite          | DESIGNED - | REVISED - |
| 62C93-sht-plan21.dgn |                             | DRAWN -    | REVISED - |
| Default              | PLOT SCALE = 10.0000' / in. | CHECKED -  | REVISED - |
|                      | PLOT DATE = 10/19/2016      | DATE -     | REVISED - |

SCALE: 1" = 5' SHEET OF SHEETS STA. TO STA.





ILLINOIS FED. AID PROJECT


| POINT | ELEV   | NOTE  |
|-------|--------|-------|
| A     | 716.74 | TW=TC |
| B     | 716.73 | TW=TC |
| C     | 716.84 | TW    |
| D     | 716.92 | TW    |
| E     | 717.32 | TW    |
| F     | 717.40 | TW    |
| G     | 717.39 | TW    |
| H     | 717.47 | TW    |
| I     | 717.59 | TW    |
| J     | 717.67 | TW    |
| K     | 717.47 | TW    |
| L     | 717.42 | MATCH |
| M     | 717.53 | MATCH |

# GOLF RD

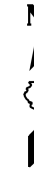

## LEGEND

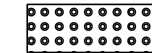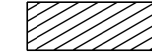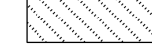-  DETECTABLE WARNINGS
-  DEPRESSED CURB AND GUTTER
-  SIDEWALK REMOVAL  
REPLACE W/TOPSOIL & SOD
-  PROPOSED SIDEWALK TURNING SPACE
  
- TW PROPOSED TOP-OF-WALK ELEVATION
- TC PROPOSED TOP-OF-CURB ELEVATION
- EOP PROPOSED EDGE-OF-PAVEMENT ELEVATION
- MATCH MATCH EXISTING ELEVATION
- EP EXISTING EDGE-OF-PAVEMENT ELEVATION
- FL PROPOSED DEPRESSED CURB FLOWLINE ELEVATION

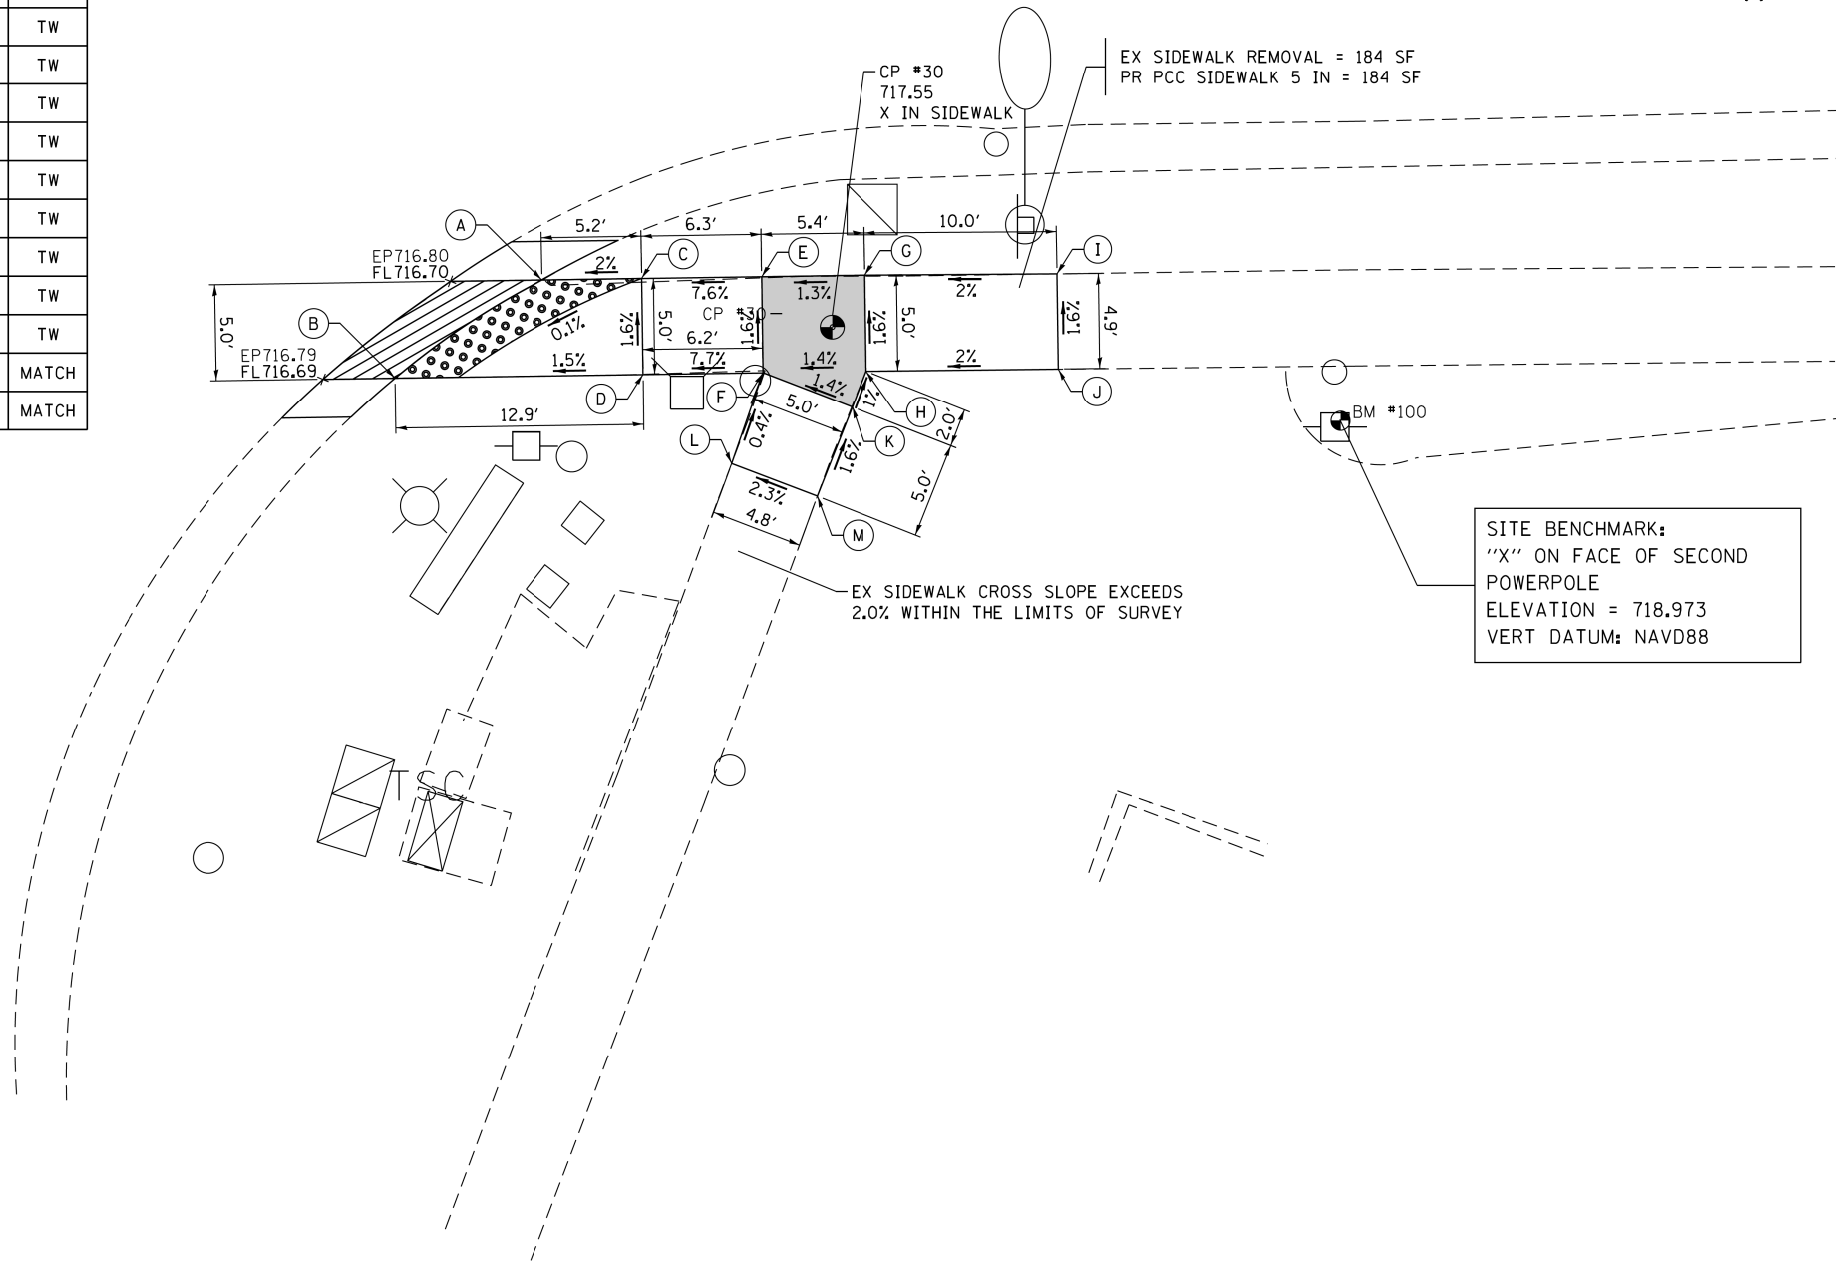


IL RTE 62 (ALGONQUIN RD)

CP #29 CP 716.46  
X IN SIDEWALK NE CORNER ALGONQUIN GOLF

|                                     |                             |            |           |   |   |                 |                |         |        |                 |                           |
|-------------------------------------|-----------------------------|------------|-----------|---|---|-----------------|----------------|---------|--------|-----------------|---------------------------|
| FILE NAME =<br>62C93-sht-plan22.dgn | USER NAME = Dwhite          | DESIGNED - | REVISED - | <b>STATE OF ILLINOIS<br/>DEPARTMENT OF TRANSPORTATION</b> | <b>SIDEWALK DETAIL PLAN<br/>IL ROUTE 62 (ALGONQUIN ROAD) AT GOLF ROAD</b> |                 | F.A.P.<br>RTE. | SECTION | COUNTY | TOTAL<br>SHEETS | SHEET<br>NO.              |
|                                     | PLOT SCALE = 10.0000' / in. | CHECKED -  | REVISED - |   | 339   | 116Y(1&2)R-R5-6 | COOK           | 58      | 36     |                 |                           |
| Default                             | PLOT DATE = 10/19/2016      | DATE -     | REVISED - | SCALE: 1" = 5'  | SHEET   | OF              | SHEETS         | STA.    | TO     | STA.            | ILLINOIS FED. AID PROJECT |

**NOTES:**

1. WORK SHALL MEET THE REQUIREMENTS OF THE SPECIAL PROVISION, "DETECTOR LOOP REPLACEMENT AND/OR INSTALLATION (ROADWAY GRINDING, RESURFACING & PATCHING OPERATIONS).
2. THIS PLAN IS FOR THE SOLE PURPOSE OF DETECTOR LOOP REPLACEMENT.

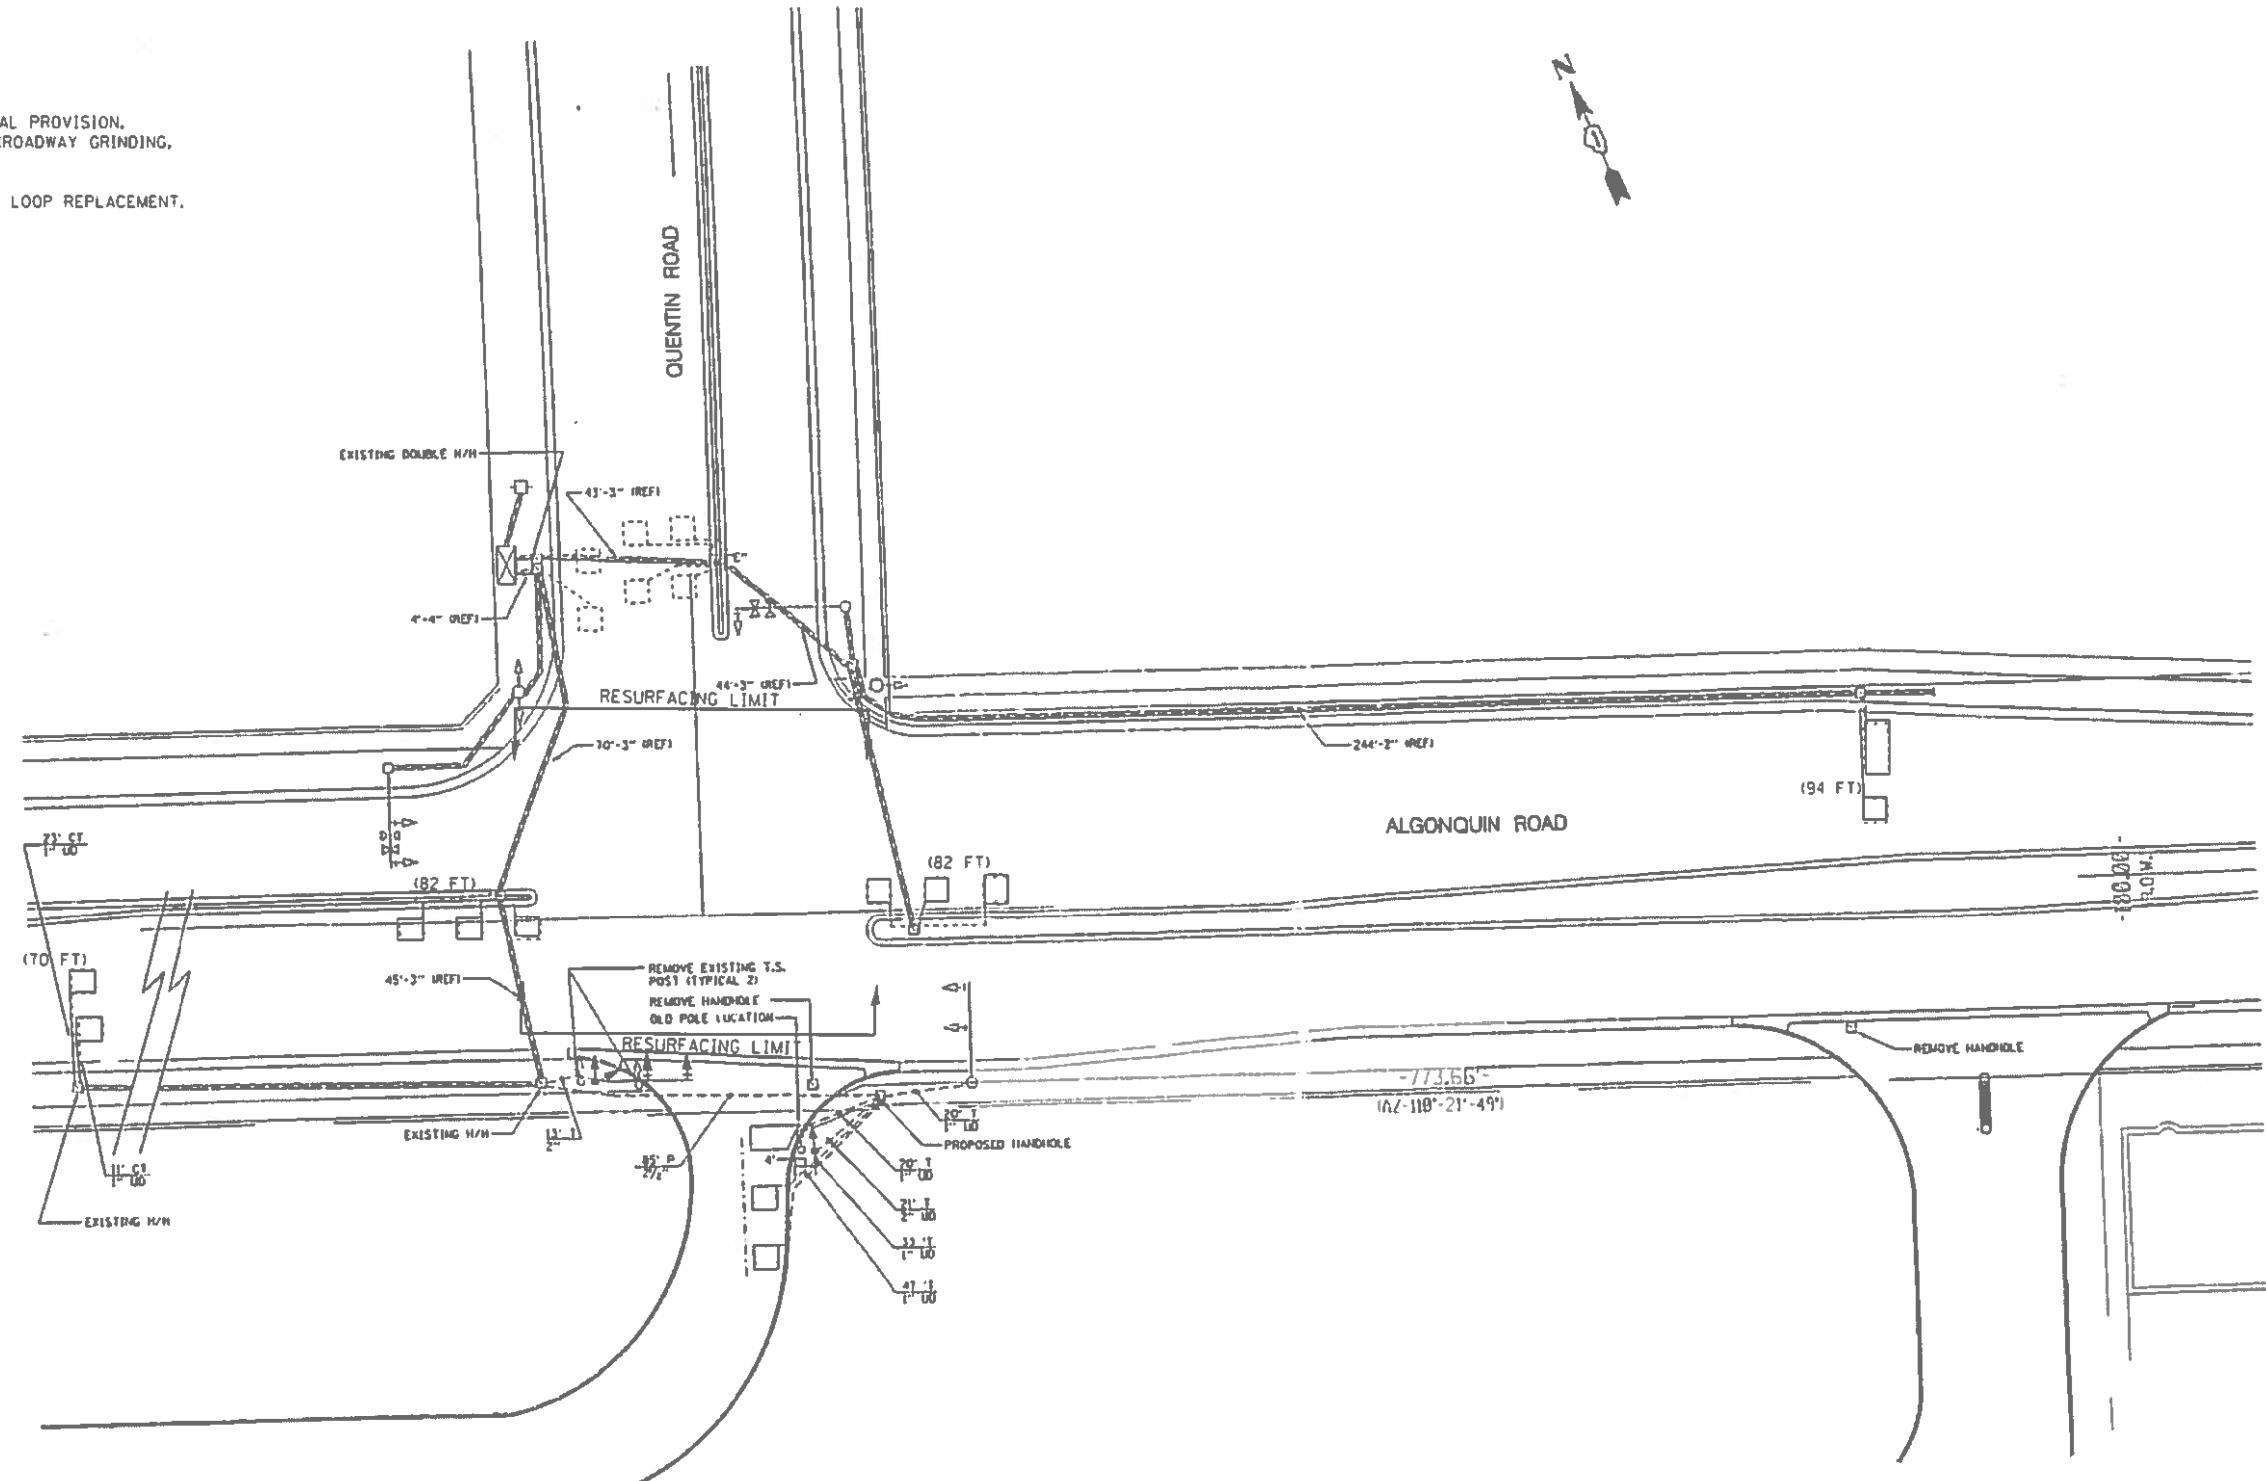



**REPLACE ALL DETECTOR LOOPS AS SHOWN  
(WITHIN THE RESURFACING LIMITS)**

| CODE     | ITEM                      | QUANTITY | UNIT |
|----------|---------------------------|----------|------|
| 88600600 | DETECTOR LOOP REPLACEMENT | 328      | FOOT |

|   |  |              |             |   |  |  |                    |                 |        |              |           |
|---|--|--------------|-------------|---|--|--|--------------------|-----------------|--------|--------------|-----------|
| FILE NAME *                             | USER NAME *                                  | DESIGNED -   | REVISIONS - | <b>STATE OF ILLINOIS<br/>DEPARTMENT OF TRANSPORTATION</b> | <b>DETECTOR LOOP REPLACEMENT PLAN<br/>IL 62 AT QUENTIN</b> |  | F.A.P. RTE.        | SECTION         | COUNTY | TOTAL SHEETS | SHEET NO. |
| S:\WP\Design\JC\Detector Loop Details\2 | 16\62C93\Detector Loop ReplacementSheet.Blor | DRAWINGS.dgn | IP          |   |  |  | 339                | 116Y11&21R-R5-6 | COOK   | 58           | 37        |
| Default                                 | PLOT SCALE *                                 | CHECKED -    | REVISIONS - |   | SCALE: SHEET OF SHEETS STA. TO STA.                        |  | CONTRACT NO. 62C93 |                 |        |              |           |
|   | PLOT DATE *                                  | DATE -       | REVISIONS - |   | [ILLINOIS] FED. AID PROJECT                                |  |                    |                 |        |              |           |

**NOTES:**

1. WORK SHALL MEET THE REQUIREMENTS OF THE SPECIAL PROVISION, DETECTOR LOOP REPLACEMENT AND/OR INSTALLATION (ROADWAY GRINDING, RESURFACING & PATCHING OPERATIONS).
2. THIS PLAN IS FOR THE SOLE PURPOSE OF DETECTOR LOOP REPLACEMENT.

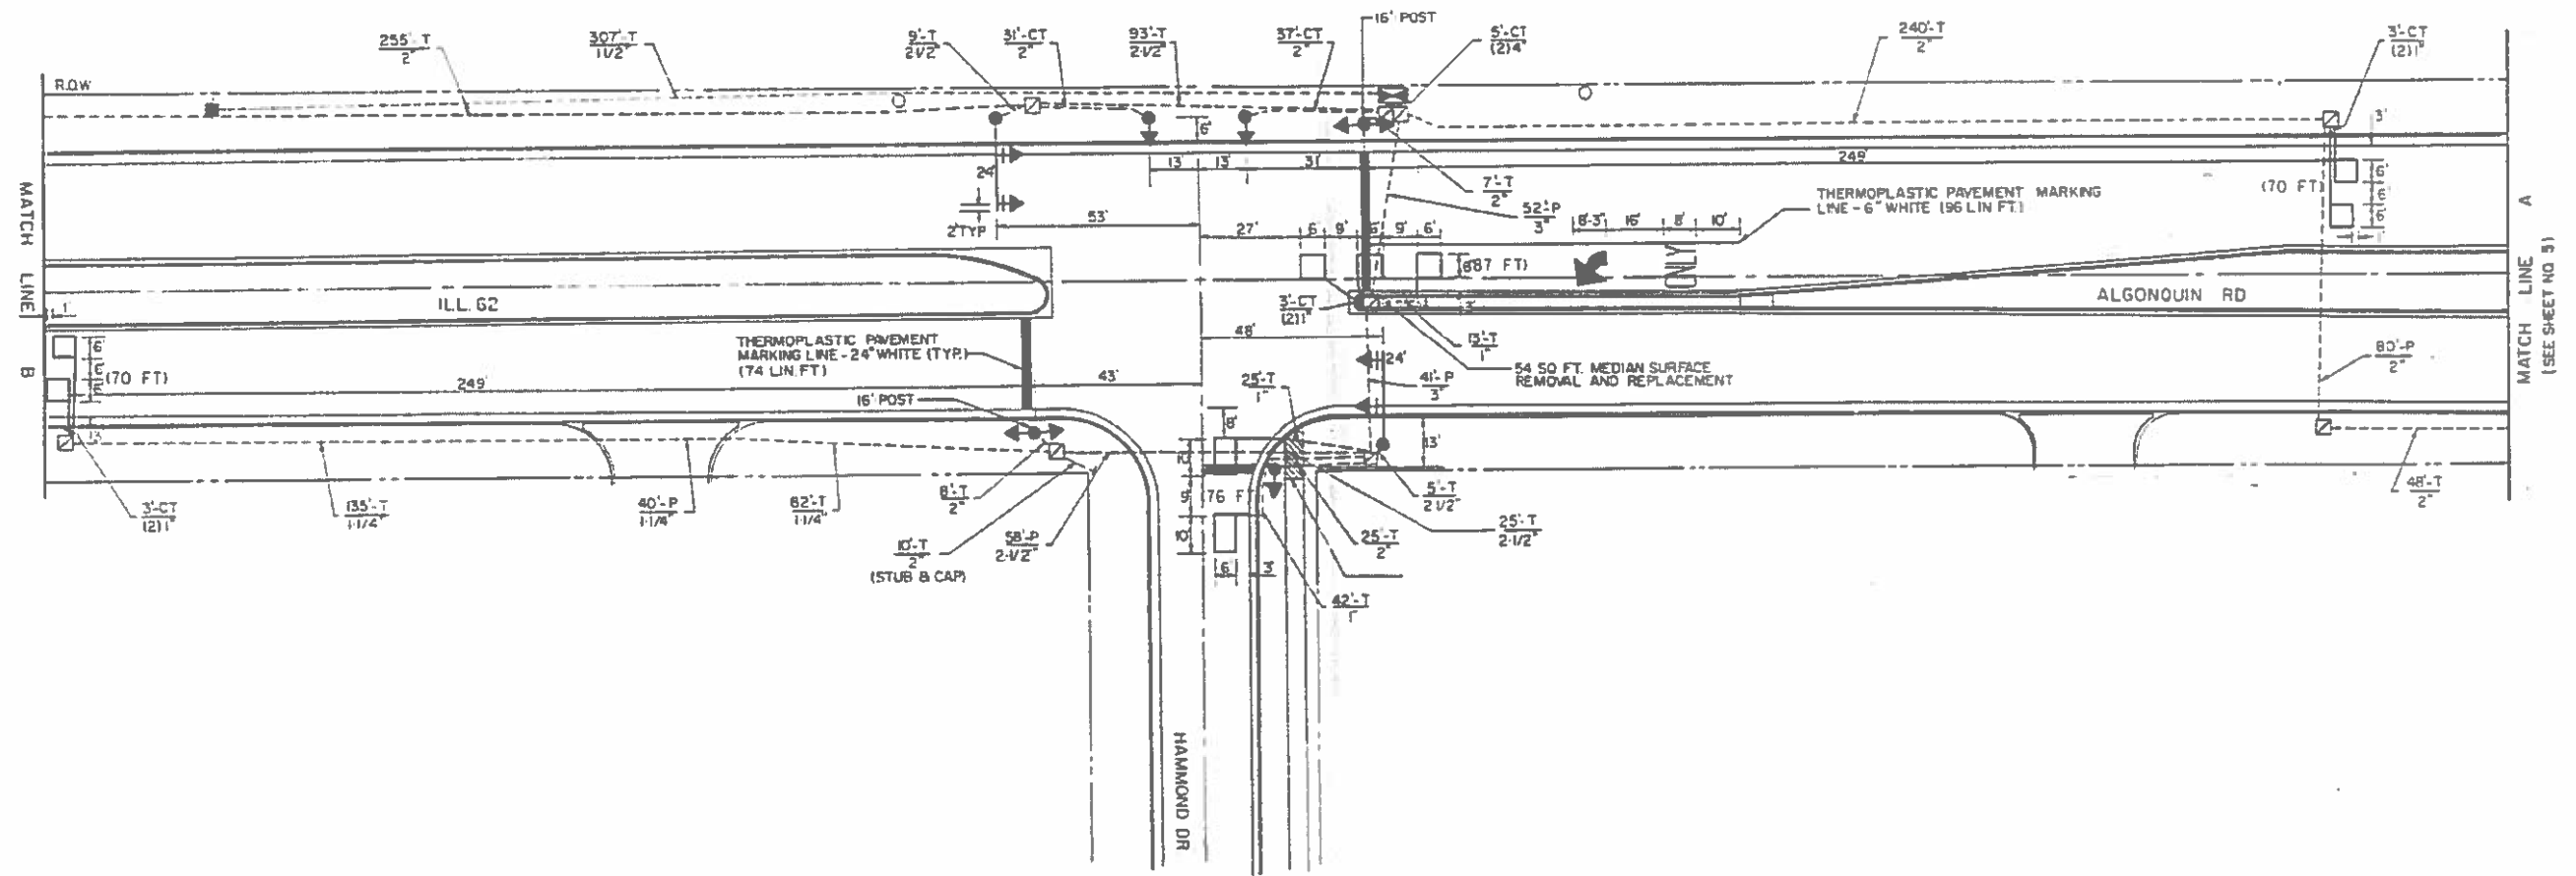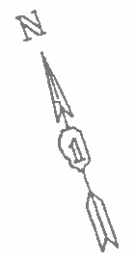


**REPLACE ALL DETECTOR LOOPS AS SHOWN  
(WITHIN THE RESURFACING LIMITS)**

| CODE     | ITEM                      | QUANTITY | UNIT |
|----------|---------------------------|----------|------|
| 88600600 | DETECTOR LOOP REPLACEMENT | 303      | FOOT |

|   |                       |                  |           |   |  |                           |                 |        |              |           |  |
|---|-----------------------|------------------|-----------|---|--|---------------------------|-----------------|--------|--------------|-----------|--|
| FILE NAME =   | USER NAME = curryje   | DESIGNED - JP    | REVISED - | <b>STATE OF ILLINOIS<br/>DEPARTMENT OF TRANSPORTATION</b> | <b>DETECTOR LOOP REPLACEMENT PLAN<br/>IL 62 AT HAMMOND DR.</b> | F.A.P. RTE.               | SECTION         | COUNTY | TOTAL SHEETS | SHEET NO. |  |
| S:\WP\Design\JCN\Detector Loop Details\216\62C93\Detector-LoopReplacementSheet.Blor | DRAWING.dgn           | JP               | REVISED - |   |  | 339                       | 116Y11&21R-RS-6 | COOK   | 58           | 38        |  |
| PLOT SCALE = 48.0460' / 1"  | CHECKED - LP          | REVISED -        | REVISED - |   |  | CONTRACT NO. 62C93        |                 |        |              |           |  |
| Default   | PLOT DATE = 9/21/2016 | DATE = 8/15/2016 | REVISED - |   |  | ILLINOIS FED. AID PROJECT |                 |        |              |           |  |
| SCALE: SHEET OF SHEETS STA. TO STA.   |                       |                  |           |   |  |                           |                 |        |              |           |  |

**NOTES:**

1. WORK SHALL MEET THE REQUIREMENTS OF THE SPECIAL PROVISION, "DETECTOR LOOP REPLACEMENT AND/OR INSTALLATION (ROADWAY GRINDING, RESURFACING & PATCHING OPERATIONS).
2. THIS PLAN IS FOR THE SOLE PURPOSE OF DETECTOR LOOP REPLACEMENT.

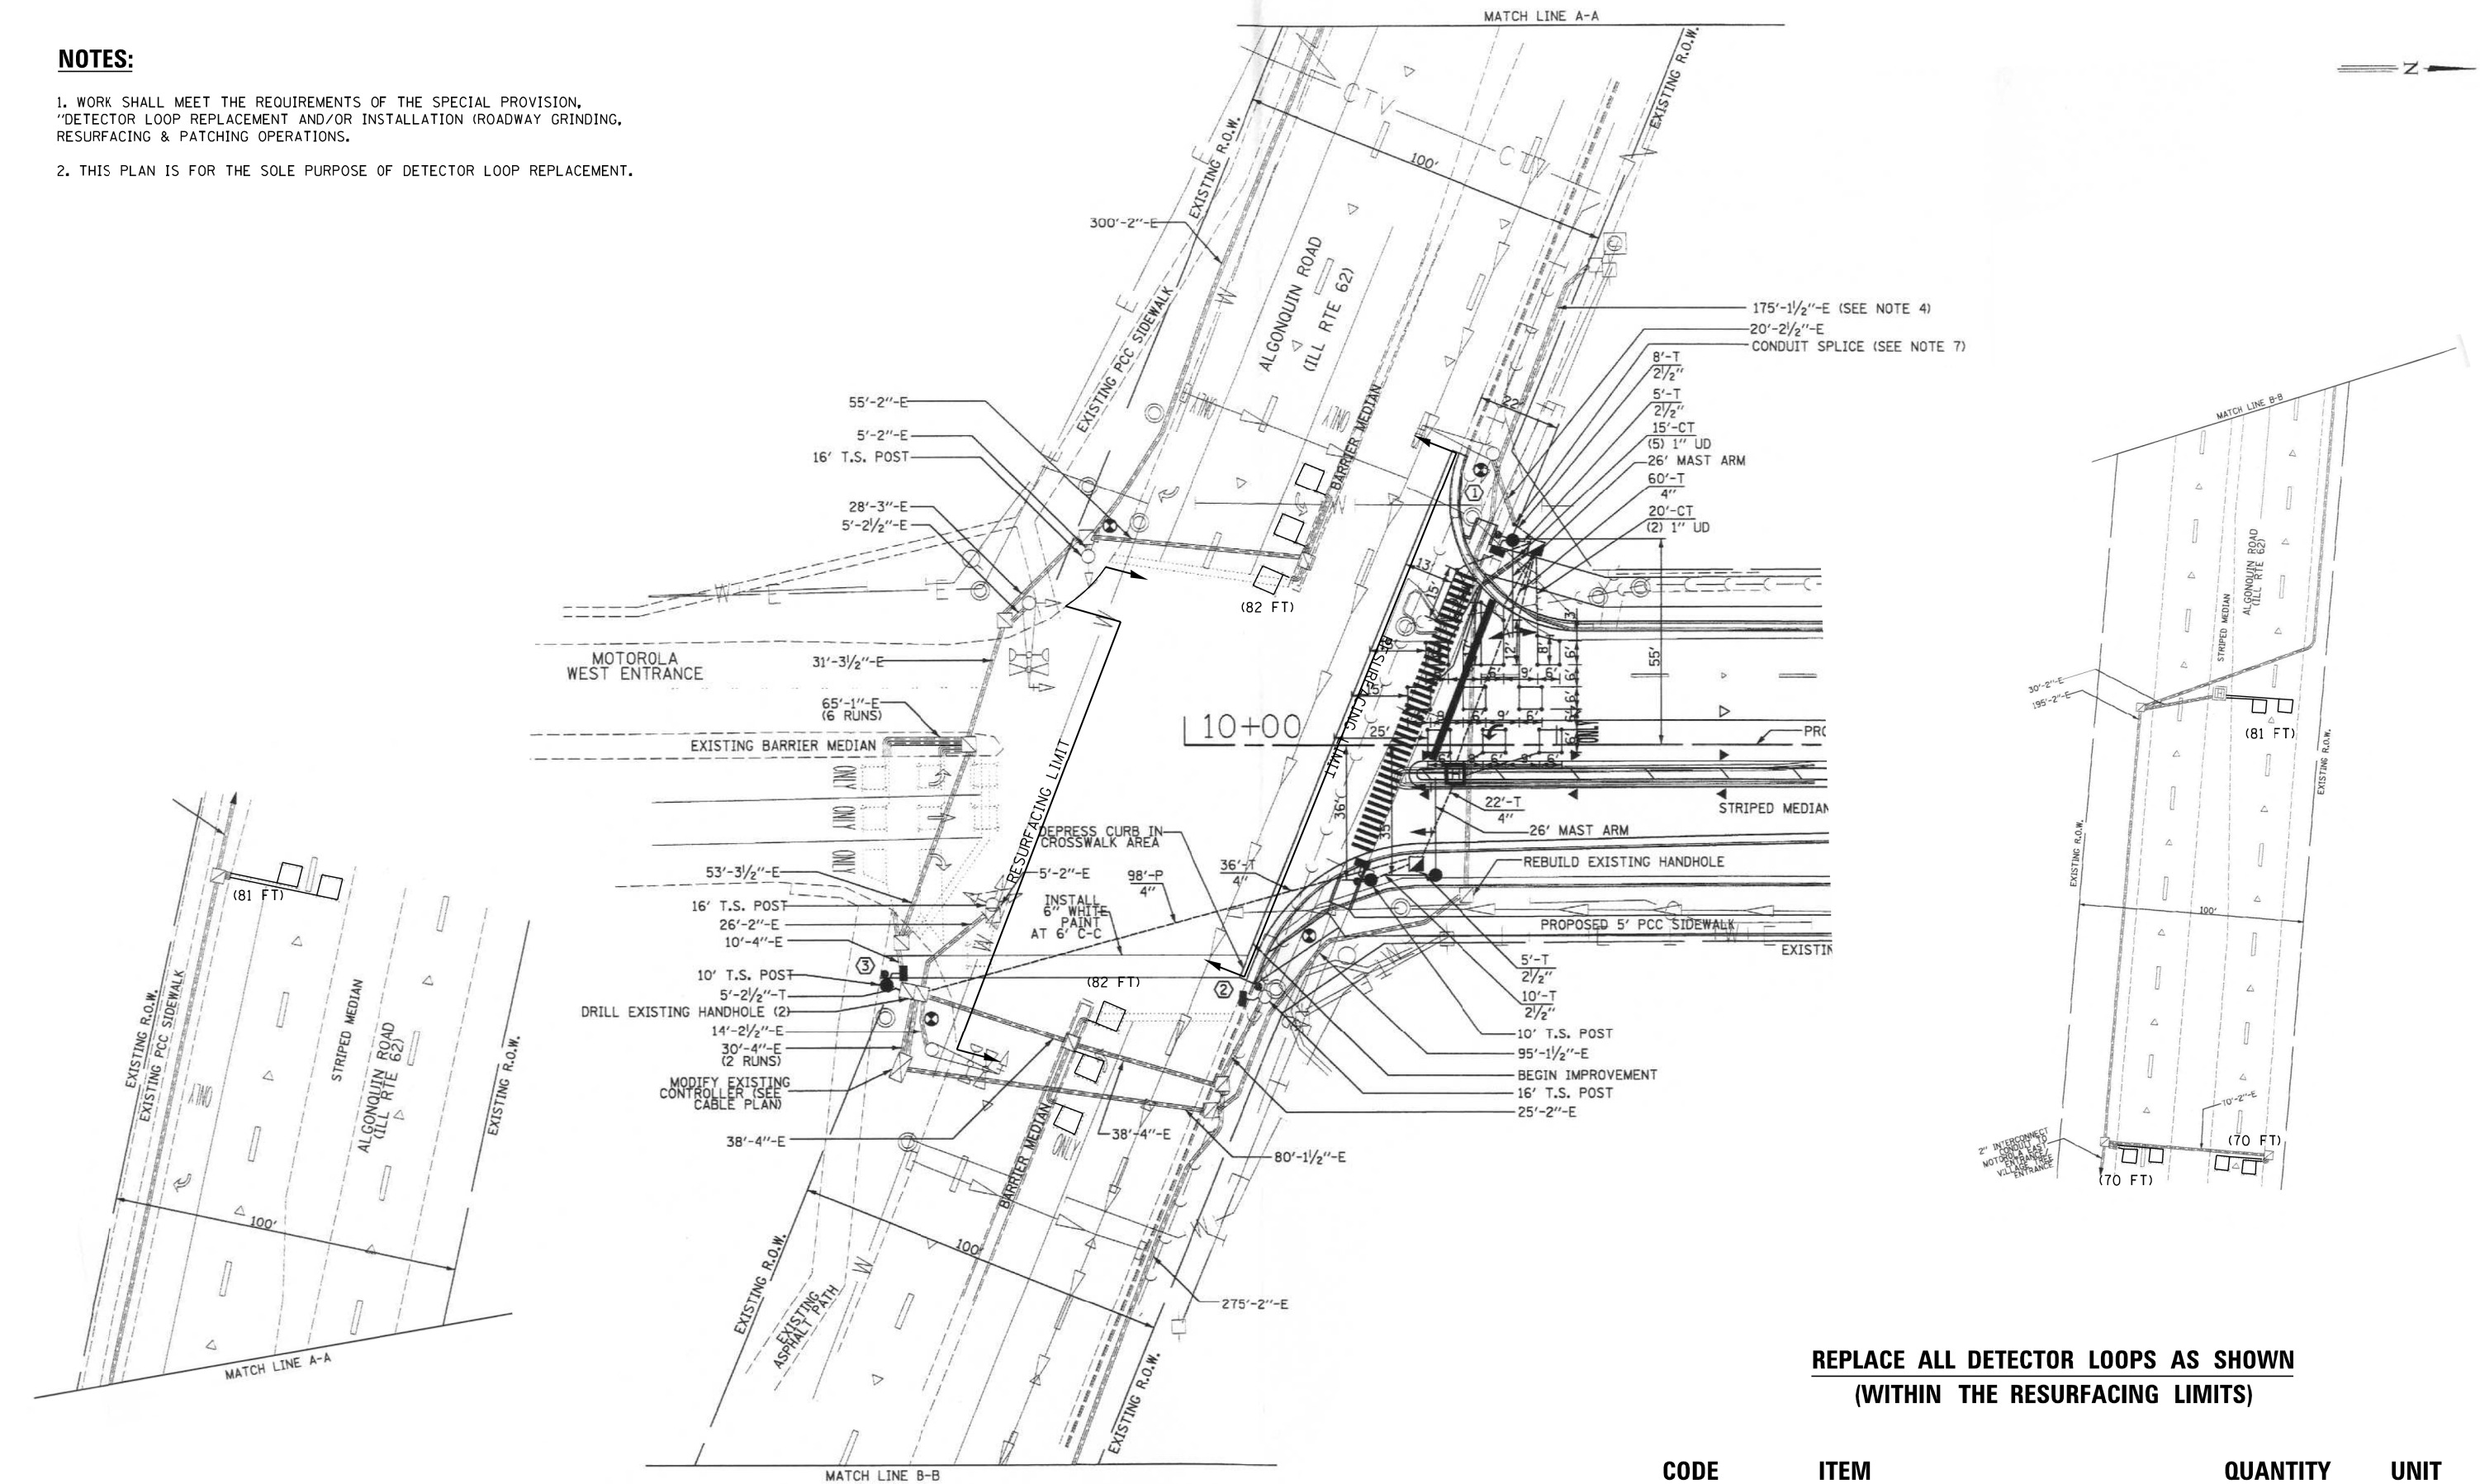


**REPLACE ALL DETECTOR LOOPS AS SHOWN  
(WITHIN THE RESURFACING LIMITS)**

| CODE     | ITEM                      | QUANTITY | UNIT |
|----------|---------------------------|----------|------|
| 88600600 | DETECTOR LOOP REPLACEMENT | 466      | FOOT |

**NOTES:**

1. WORK SHALL MEET THE REQUIREMENTS OF THE SPECIAL PROVISION, "DETECTOR LOOP REPLACEMENT AND/OR INSTALLATION (ROADWAY GRINDING, RESURFACING & PATCHING OPERATIONS).
2. THIS PLAN IS FOR THE SOLE PURPOSE OF DETECTOR LOOP REPLACEMENT.

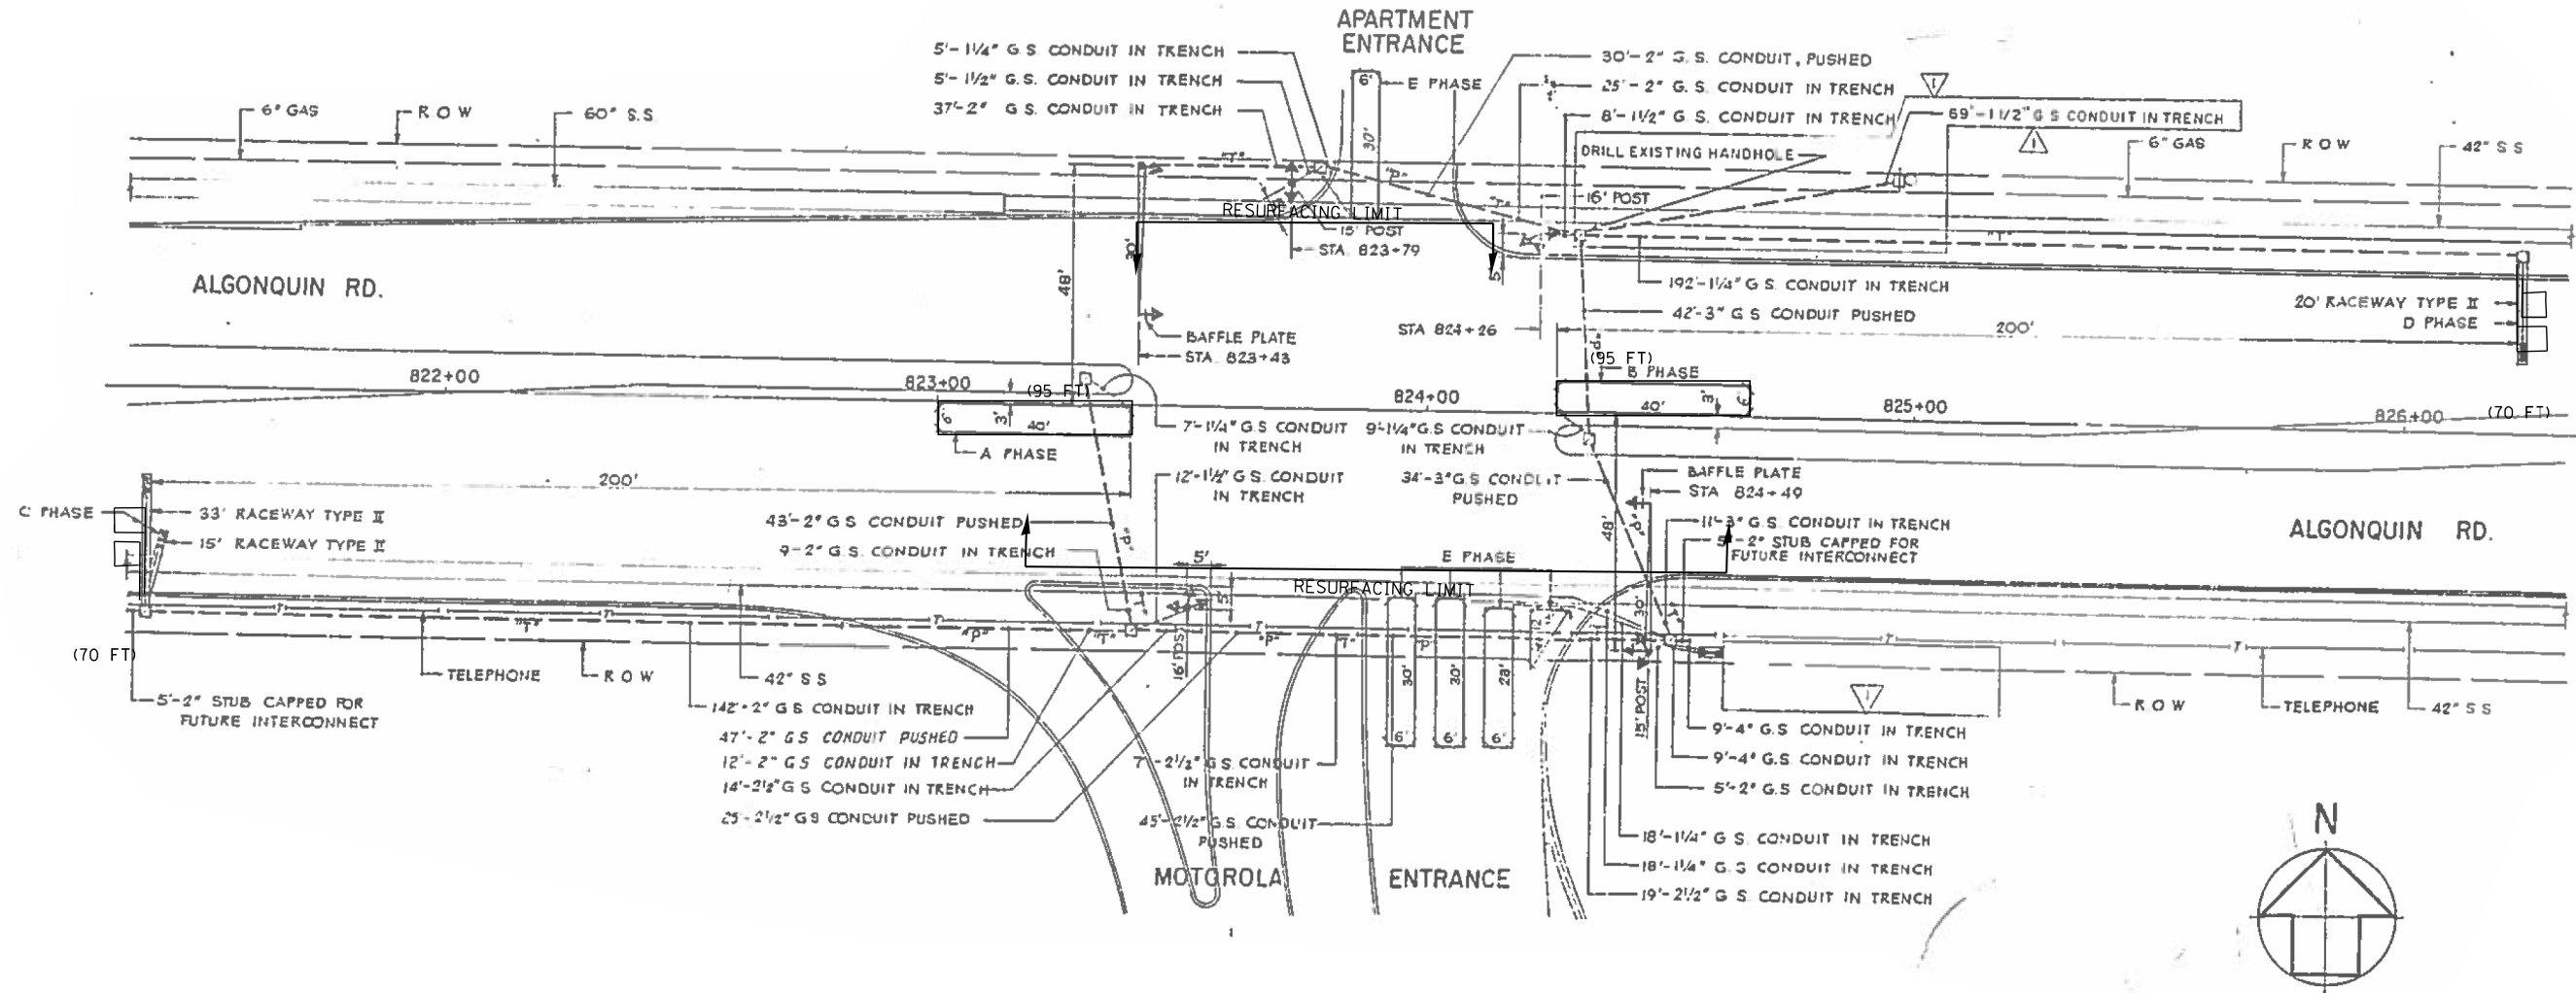

**REPLACE ALL DETECTOR LOOPS AS SHOWN  
(WITHIN THE RESURFACING LIMITS)**


| CODE     | ITEM                      | QUANTITY | UNIT |
|----------|---------------------------|----------|------|
| 88600600 | DETECTOR LOOP REPLACEMENT | 330      | FOOT |

|  |                             |                  |           |   |  |                           |                 |        |              |           |  |
|--|-----------------------------|------------------|-----------|---|--|---------------------------|-----------------|--------|--------------|-----------|--|
| FILE NAME =  | USER NAME = curryja         | DESIGNED - IP    | REVISED - | <b>STATE OF ILLINOIS<br/>DEPARTMENT OF TRANSPORTATION</b> | <b>DETECTOR LOOP REPLACEMENT PLAN<br/>IL 62 AT COMMUNICATIONS DR</b> | F.A.P. RTE.               | SECTION         | COUNTY | TOTAL SHEETS | SHEET NO. |  |
| S:\WP\Design\JC\Detector Loop Details\2016\62C93\DetectorLoopReplacementSheet.Blan | DRAWN6.dgn-                 | IP               | REVISED - |   |  | 339                       | 116Y(1&2)R-RS-6 | COOK   | 58           | 40        |  |
| Default  | PLOT SCALE = 40.0000' / in. | CHECKED - LP     | REVISED - |   |  | CONTRACT NO. 62C93        |                 |        |              |           |  |
|  | PLOT DATE = 1/25/2017       | DATE - 8/15/2016 | REVISED - |   |  | ILLINOIS FED. AID PROJECT |                 |        |              |           |  |



**NOTES:**

1. WORK SHALL MEET THE REQUIREMENTS OF THE SPECIAL PROVISION, "DETECTOR LOOP REPLACEMENT AND/OR INSTALLATION (ROADWAY GRINDING, RESURFACING & PATCHING OPERATIONS).
2. THIS PLAN IS FOR THE SOLE PURPOSE OF DETECTOR LOOP REPLACEMENT.

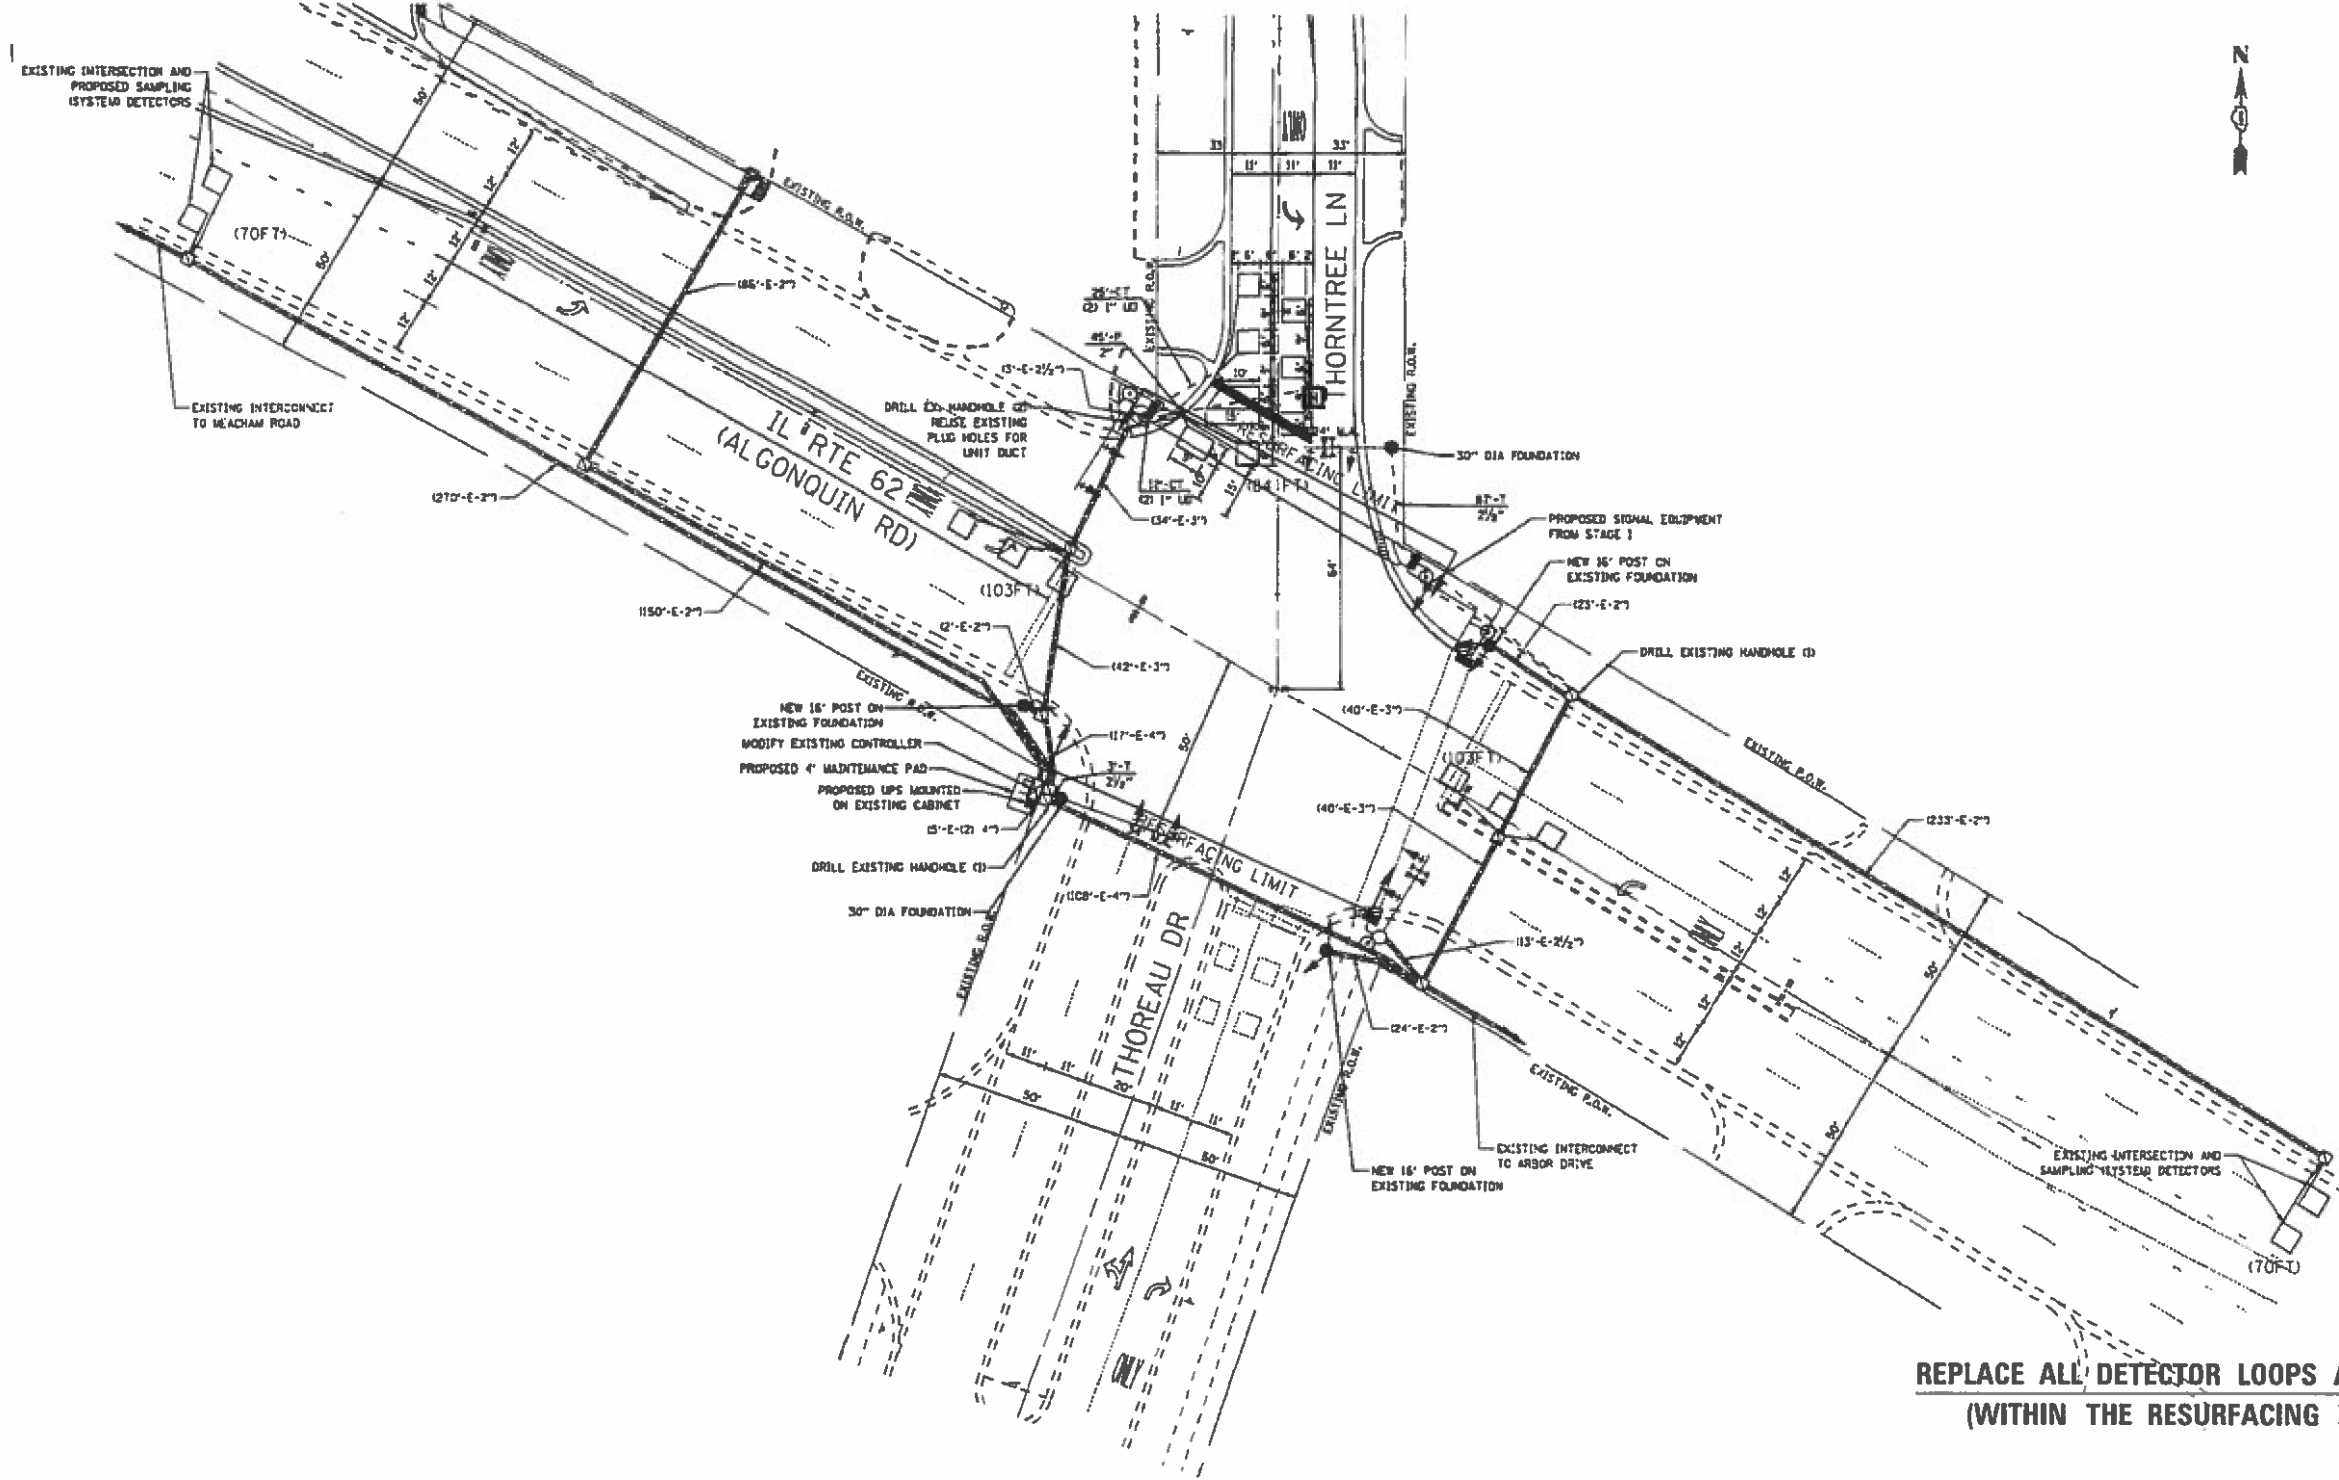


**REPLACE ALL DETECTOR LOOPS AS SHOWN  
(WITHIN THE RESURFACING LIMITS)**

| CODE     | ITEM                      | QUANTITY | UNIT |
|----------|---------------------------|----------|------|
| 88600600 | DETECTOR LOOP REPLACEMENT | 430      | FOOT |

|   |             |            |          |   |   |                             |                 |        |              |           |  |
|---|-------------|------------|----------|---|---|-----------------------------|-----------------|--------|--------------|-----------|--|
| FILE NAME *   | USER NAME * | DESIGNED - | REVISD - | STATE OF ILLINOIS<br>DEPARTMENT OF TRANSPORTATION | DETECTOR LOOP REPLACEMENT PLAN<br>IL 62 AT THORNTREE /THOREAU | F.A.P. RTE.                 | SECTION         | COUNTY | TOTAL SHEETS | SHEET NO. |  |
| S:\WP\Design\JC\Detector Loop Details\216\62C93\Detector Loop ReplacementSheet.B1 | curryj      | IP         | -        |   |   | 339                         | 116Y11&21R-RS-6 | COOK   | 58           | 41        |  |
| PLOT SCALE *  | CHECKED -   | REVISD -   | -        |   |   | CONTRACT NO. 62C93          |                 |        |              |           |  |
| Default   | LP          | -          | -        |   |   | (ILLINOIS) FED. AID PROJECT |                 |        |              |           |  |
| PLOT DATE *   | DATE -      | REVISD -   | -        | SCALE: SHEET OF SHEETS STA. TO STA.               |   |                             |                 |        |              |           |  |
| 9/21/2016   | 8/15/2016   | -          | -        |   |   |                             |                 |        |              |           |  |

**NOTES:**

1. WORK SHALL MEET THE REQUIREMENTS OF THE SPECIAL PROVISION. 'DETECTOR LOOP REPLACEMENT AND/OR INSTALLATION (ROADWAY GRINDING, RESURFACING & PATCHING OPERATIONS).
2. THIS PLAN IS FOR THE SOLE PURPOSE OF DETECTOR LOOP REPLACEMENT.

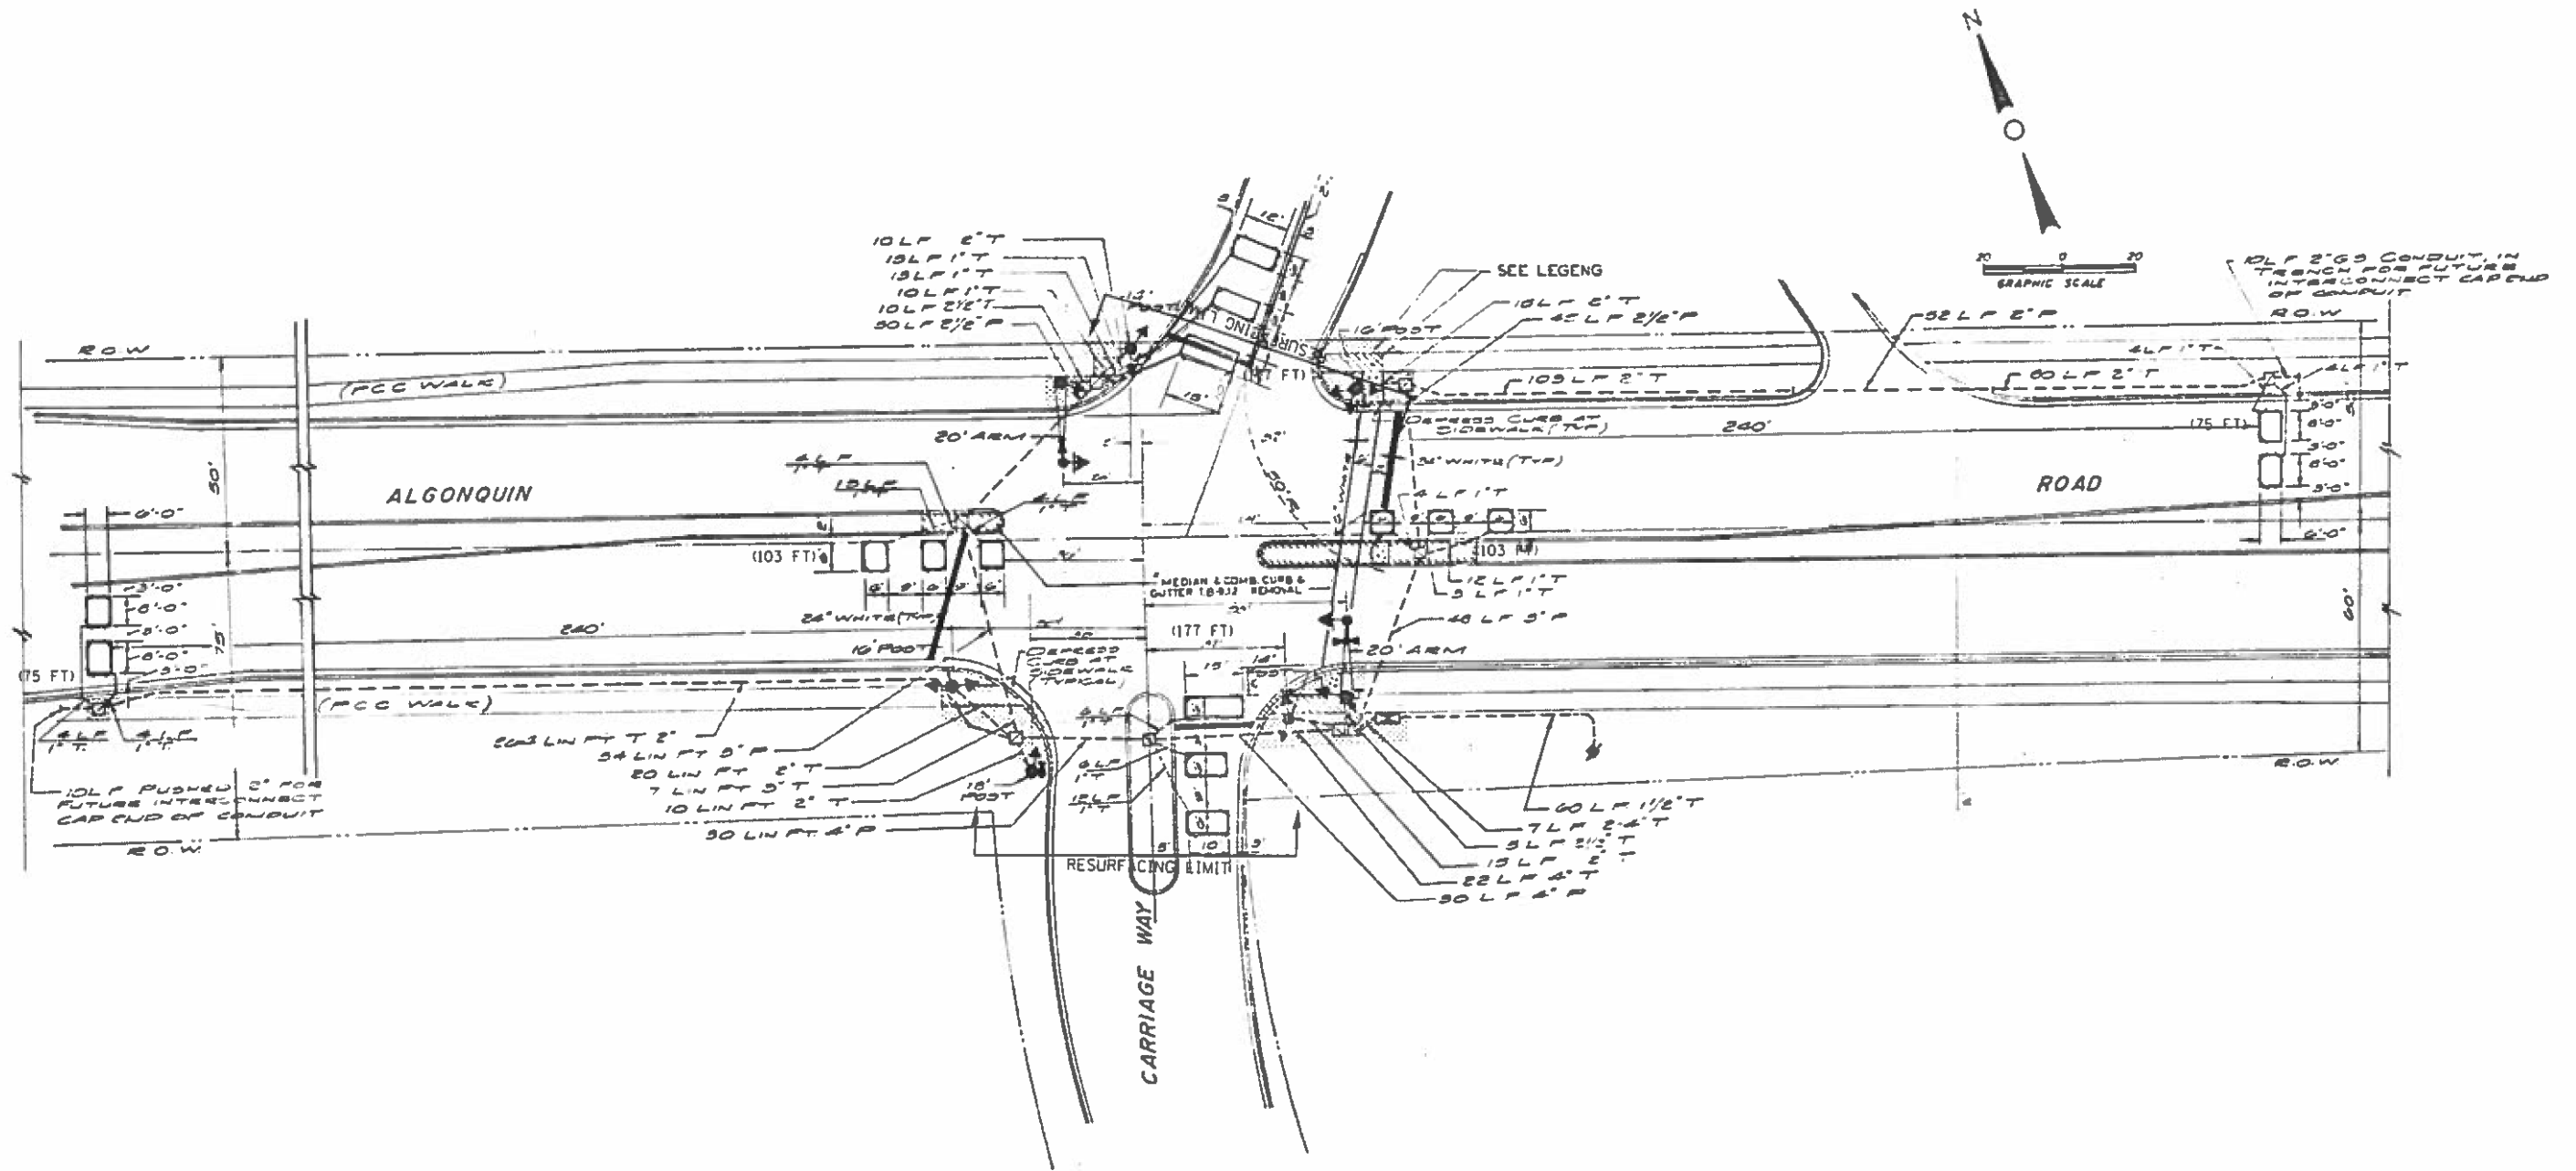


**REPLACE ALL DETECTOR LOOPS AS SHOWN  
(WITHIN THE RESURFACING LIMITS)**

| CODE     | ITEM                      | QUANTITY | UNIT |
|----------|---------------------------|----------|------|
| 88600600 | DETECTOR LOOP REPLACEMENT | 710      | FOOT |

|   |                    |              |                    |   |  |                           |          |         |               |            |
|---|--------------------|--------------|--------------------|---|--|---------------------------|----------|---------|---------------|------------|
| FILE NAME: S:\WP\Design\JC\Detector-Loop-Details\2016\62C93\Detector-Loop-Replacement-Sheet-Block.dwg | USER NAME: curryje | DESIGNED: IP | REVISED: -         | <b>STATE OF ILLINOIS<br/>DEPARTMENT OF TRANSPORTATION</b> | <b>DETECTOR LOOP REPLACEMENT PLAN<br/>IL 62 AT CARRIAGEWAY DR.</b> | F.A.P. RTE.:              | SECTION: | COUNTY: | TOTAL SHEETS: | SHEET NO.: |
| PLOT SCALE: 48.8460 / 10  | CHECKED: LP        | REVISED: -   | 339                |   |  | 116Y11&2R-RS-6            | COOK     | 58      | 42            |            |
| PLOT DATE: 9/21/2016  | DATE: 8/15/2016    | REVISED: -   | CONTRACT NO. 62C93 |   |  |                           |          |         |               |            |
|   |                    |              |                    |   |  | ILLINOIS FED. AID PROJECT |          |         |               |            |

**NOTES:**

1. WORK SHALL MEET THE REQUIREMENTS OF THE SPECIAL PROVISION, "DETECTOR LOOP REPLACEMENT AND/OR INSTALLATION (ROADWAY GRINDING, RESURFACING & PATCHING OPERATIONS).
2. THIS PLAN IS FOR THE SOLE PURPOSE OF DETECTOR LOOP REPLACEMENT.

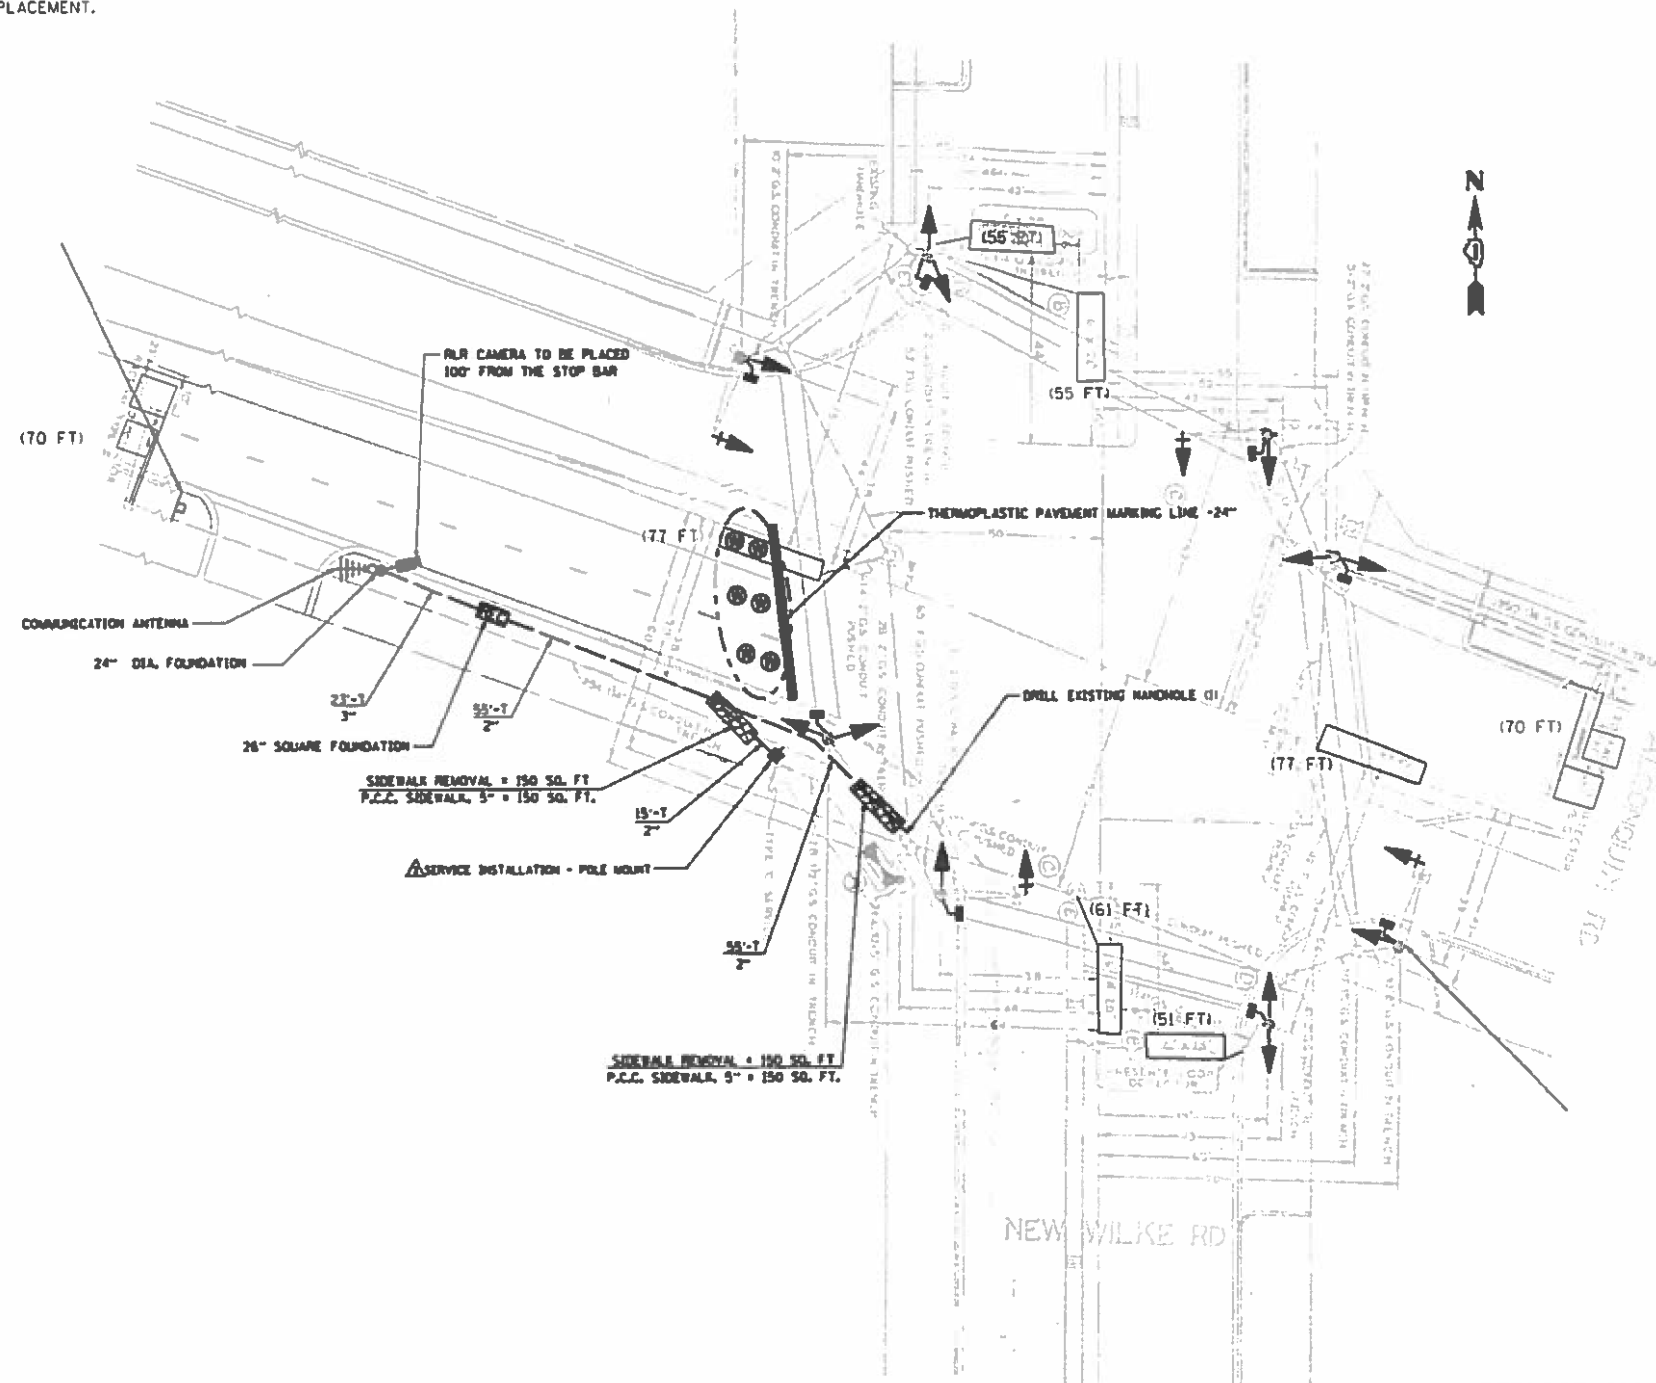

**REPLACE ALL DETECTOR LOOPS AS SHOWN  
(WITHIN THE RESURFACING LIMITS)**


| CODE     | ITEM                      | QUANTITY | UNIT |
|----------|---------------------------|----------|------|
| 88600600 | DETECTOR LOOP REPLACEMENT | 516      | FOOT |

|  |             |            |           |   |  |                           |                |        |              |           |  |
|--|-------------|------------|-----------|---|--|---------------------------|----------------|--------|--------------|-----------|--|
| FILE NAME *  | USER NAME * | DESIGNED - | REVISED - | <b>STATE OF ILLINOIS<br/>DEPARTMENT OF TRANSPORTATION</b> | <b>DETECTOR LOOP REPLACEMENT PLAN<br/>IL 62 AT NEW WILKE</b> | F.A.P. RTE.               | SECTION        | COUNTY | TOTAL SHEETS | SHEET NO. |  |
| S:\WP\Design\JC\Detector Loop Details\216162C93\Detector-LoopReplacementSheet.Blor | curryj      | IP         | -         |   |  | 339                       | 116Y11&2R-RS-6 | COOK   | 58           | 43        |  |
| PLOT SCALE *   | CHECKED -   | LP         | -         |   |  | CONTRACT NO. 62C93        |                |        |              |           |  |
| Default  | PLOT DATE * | 8/15/2016  | -         |   |  | ILLINOIS FED. AID PROJECT |                |        |              |           |  |



**NOTES:**

1. WORK SHALL MEET THE REQUIREMENTS OF THE SPECIAL PROVISION, 'DETECTOR LOOP REPLACEMENT AND/OR INSTALLATION (ROADWAY GRINDING, RESURFACING & PATCHING OPERATIONS).
2. THIS PLAN IS FOR THE SOLE PURPOSE OF DETECTOR LOOP REPLACEMENT.

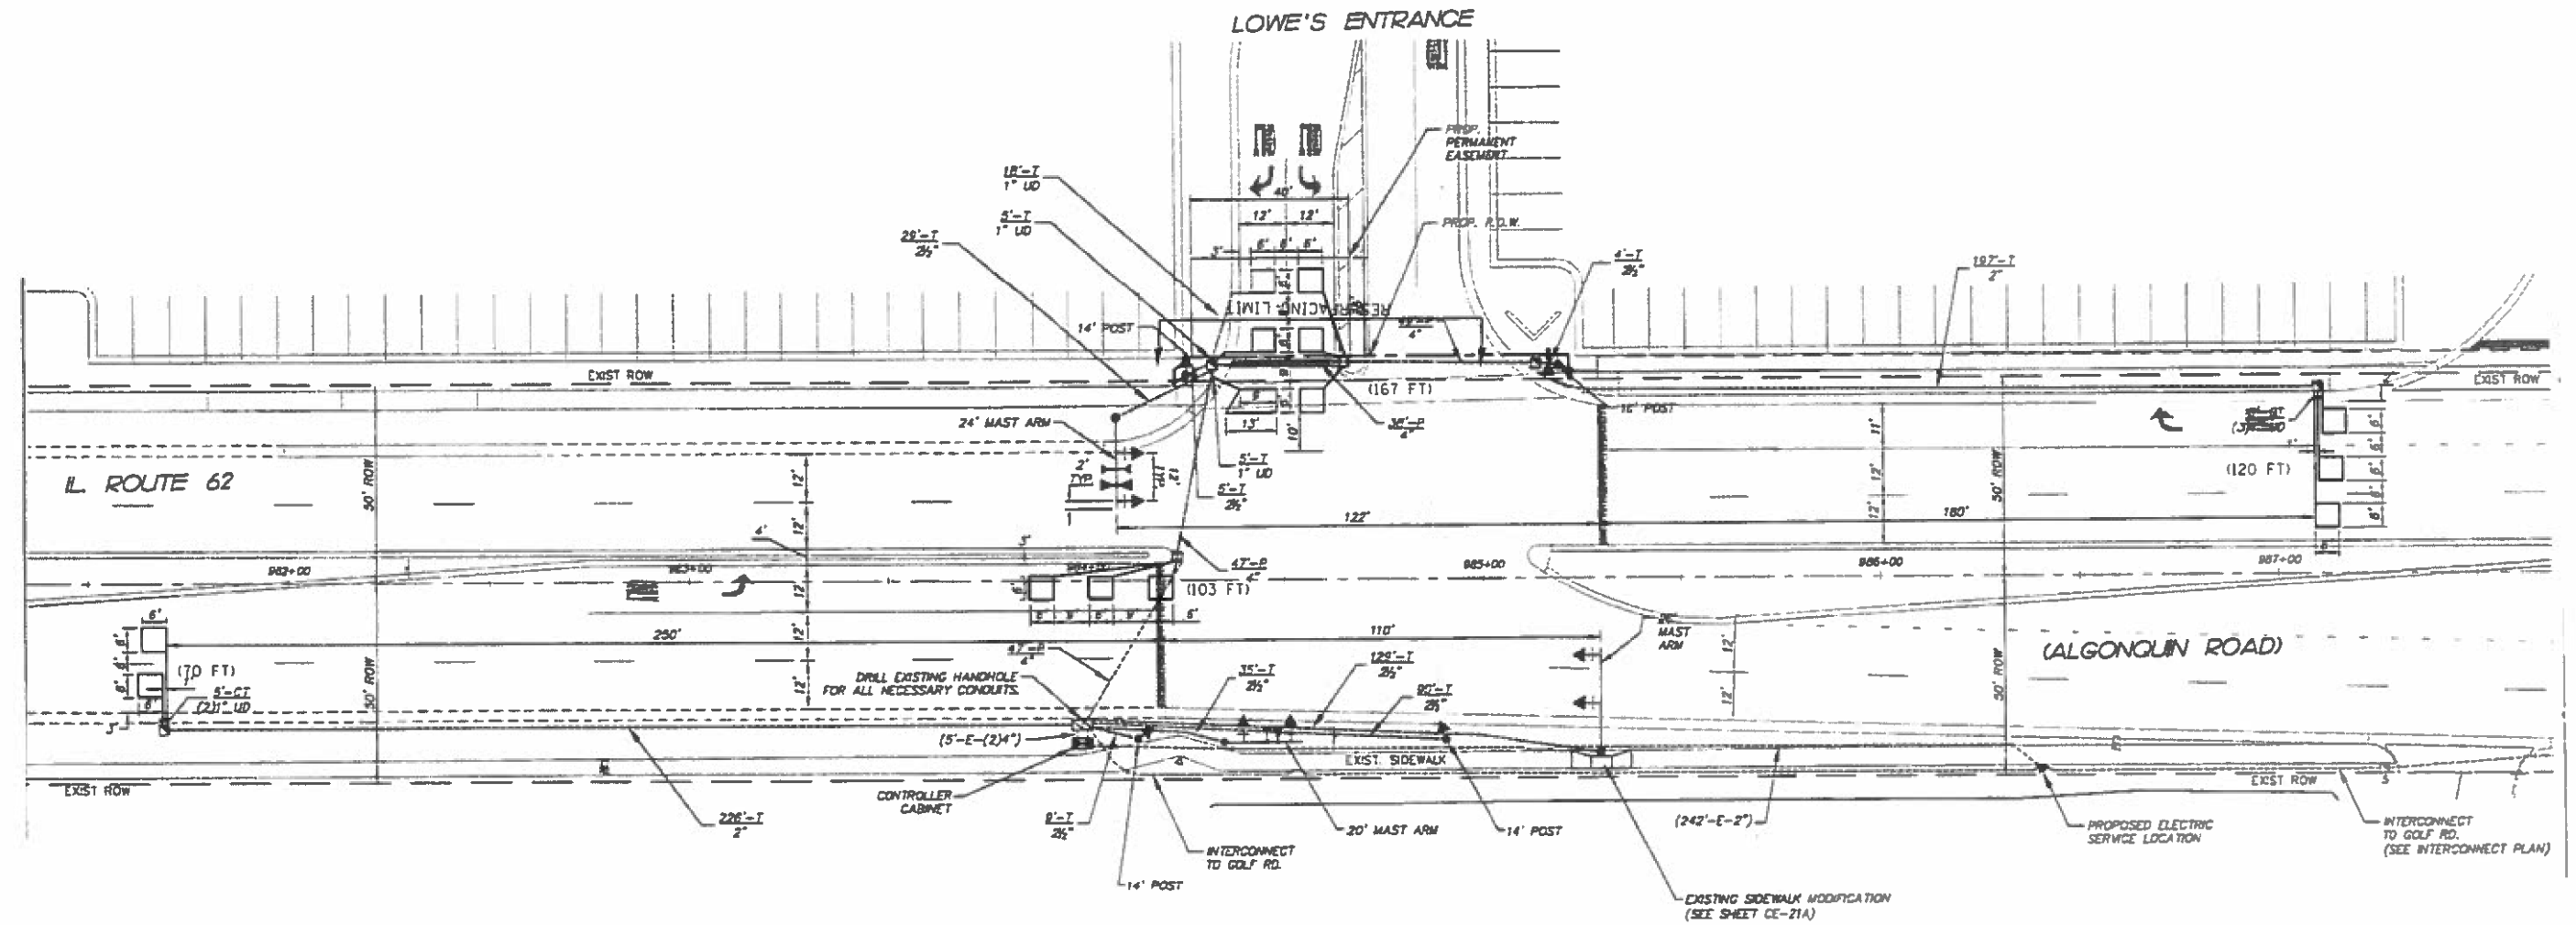


**REPLACE ALL DETECTOR LOOPS AS SHOWN  
(WITHIN THE RESURFACING LIMITS)**

| CODE     | ITEM                      | QUANTITY | UNIT |
|----------|---------------------------|----------|------|
| 88600600 | DETECTOR LOOP REPLACEMENT | 460      | FOOT |

|  |             |            |           |   |  |       |             |                |        |              |                           |  |
|--|-------------|------------|-----------|---|--|-------|-------------|----------------|--------|--------------|---------------------------|--|
| FILE NAME *  | USER NAME * | DESIGNED - | REVISED - | <b>STATE OF ILLINOIS<br/>DEPARTMENT OF TRANSPORTATION</b> | <b>DETECTOR LOOP REPLACEMENT PLAN<br/>IL 62 AT LOWES</b> |       | F.A.P. RTE. | SECTION        | COUNTY | TOTAL SHEETS | SHEET NO.                 |  |
| S:\MP\Design\JC\Detector Loop Details\216\62C93\Detector Loop Replacement\Sheet.Blan | curryj      | IP         | IP        |   |  |       | 339         | 116Y11&2R-RS-6 | COOK   | 58           | 45                        |  |
| PLOT SCALE *   | CHECKED -   | REVISED -  | DATE -    |   | SCALE:   | SHEET | OF          | SHEETS         | STA.   | TO STA.      | CONTRACT NO. 62C93        |  |
| 48.8468 1/ in.   | LP          | REVISED -  | 8/15/2016 |   |  |       |             |                |        |              | ILLINOIS FED. AID PROJECT |  |

**NOTES:**


1. WORK SHALL MEET THE REQUIREMENTS OF THE SPECIAL PROVISION, 'DETECTOR LOOP REPLACEMENT AND/OR INSTALLATION (ROADWAY GRINDING, RESURFACING & PATCHING OPERATIONS).
2. THIS PLAN IS FOR THE SOLE PURPOSE OF DETECTOR LOOP REPLACEMENT.

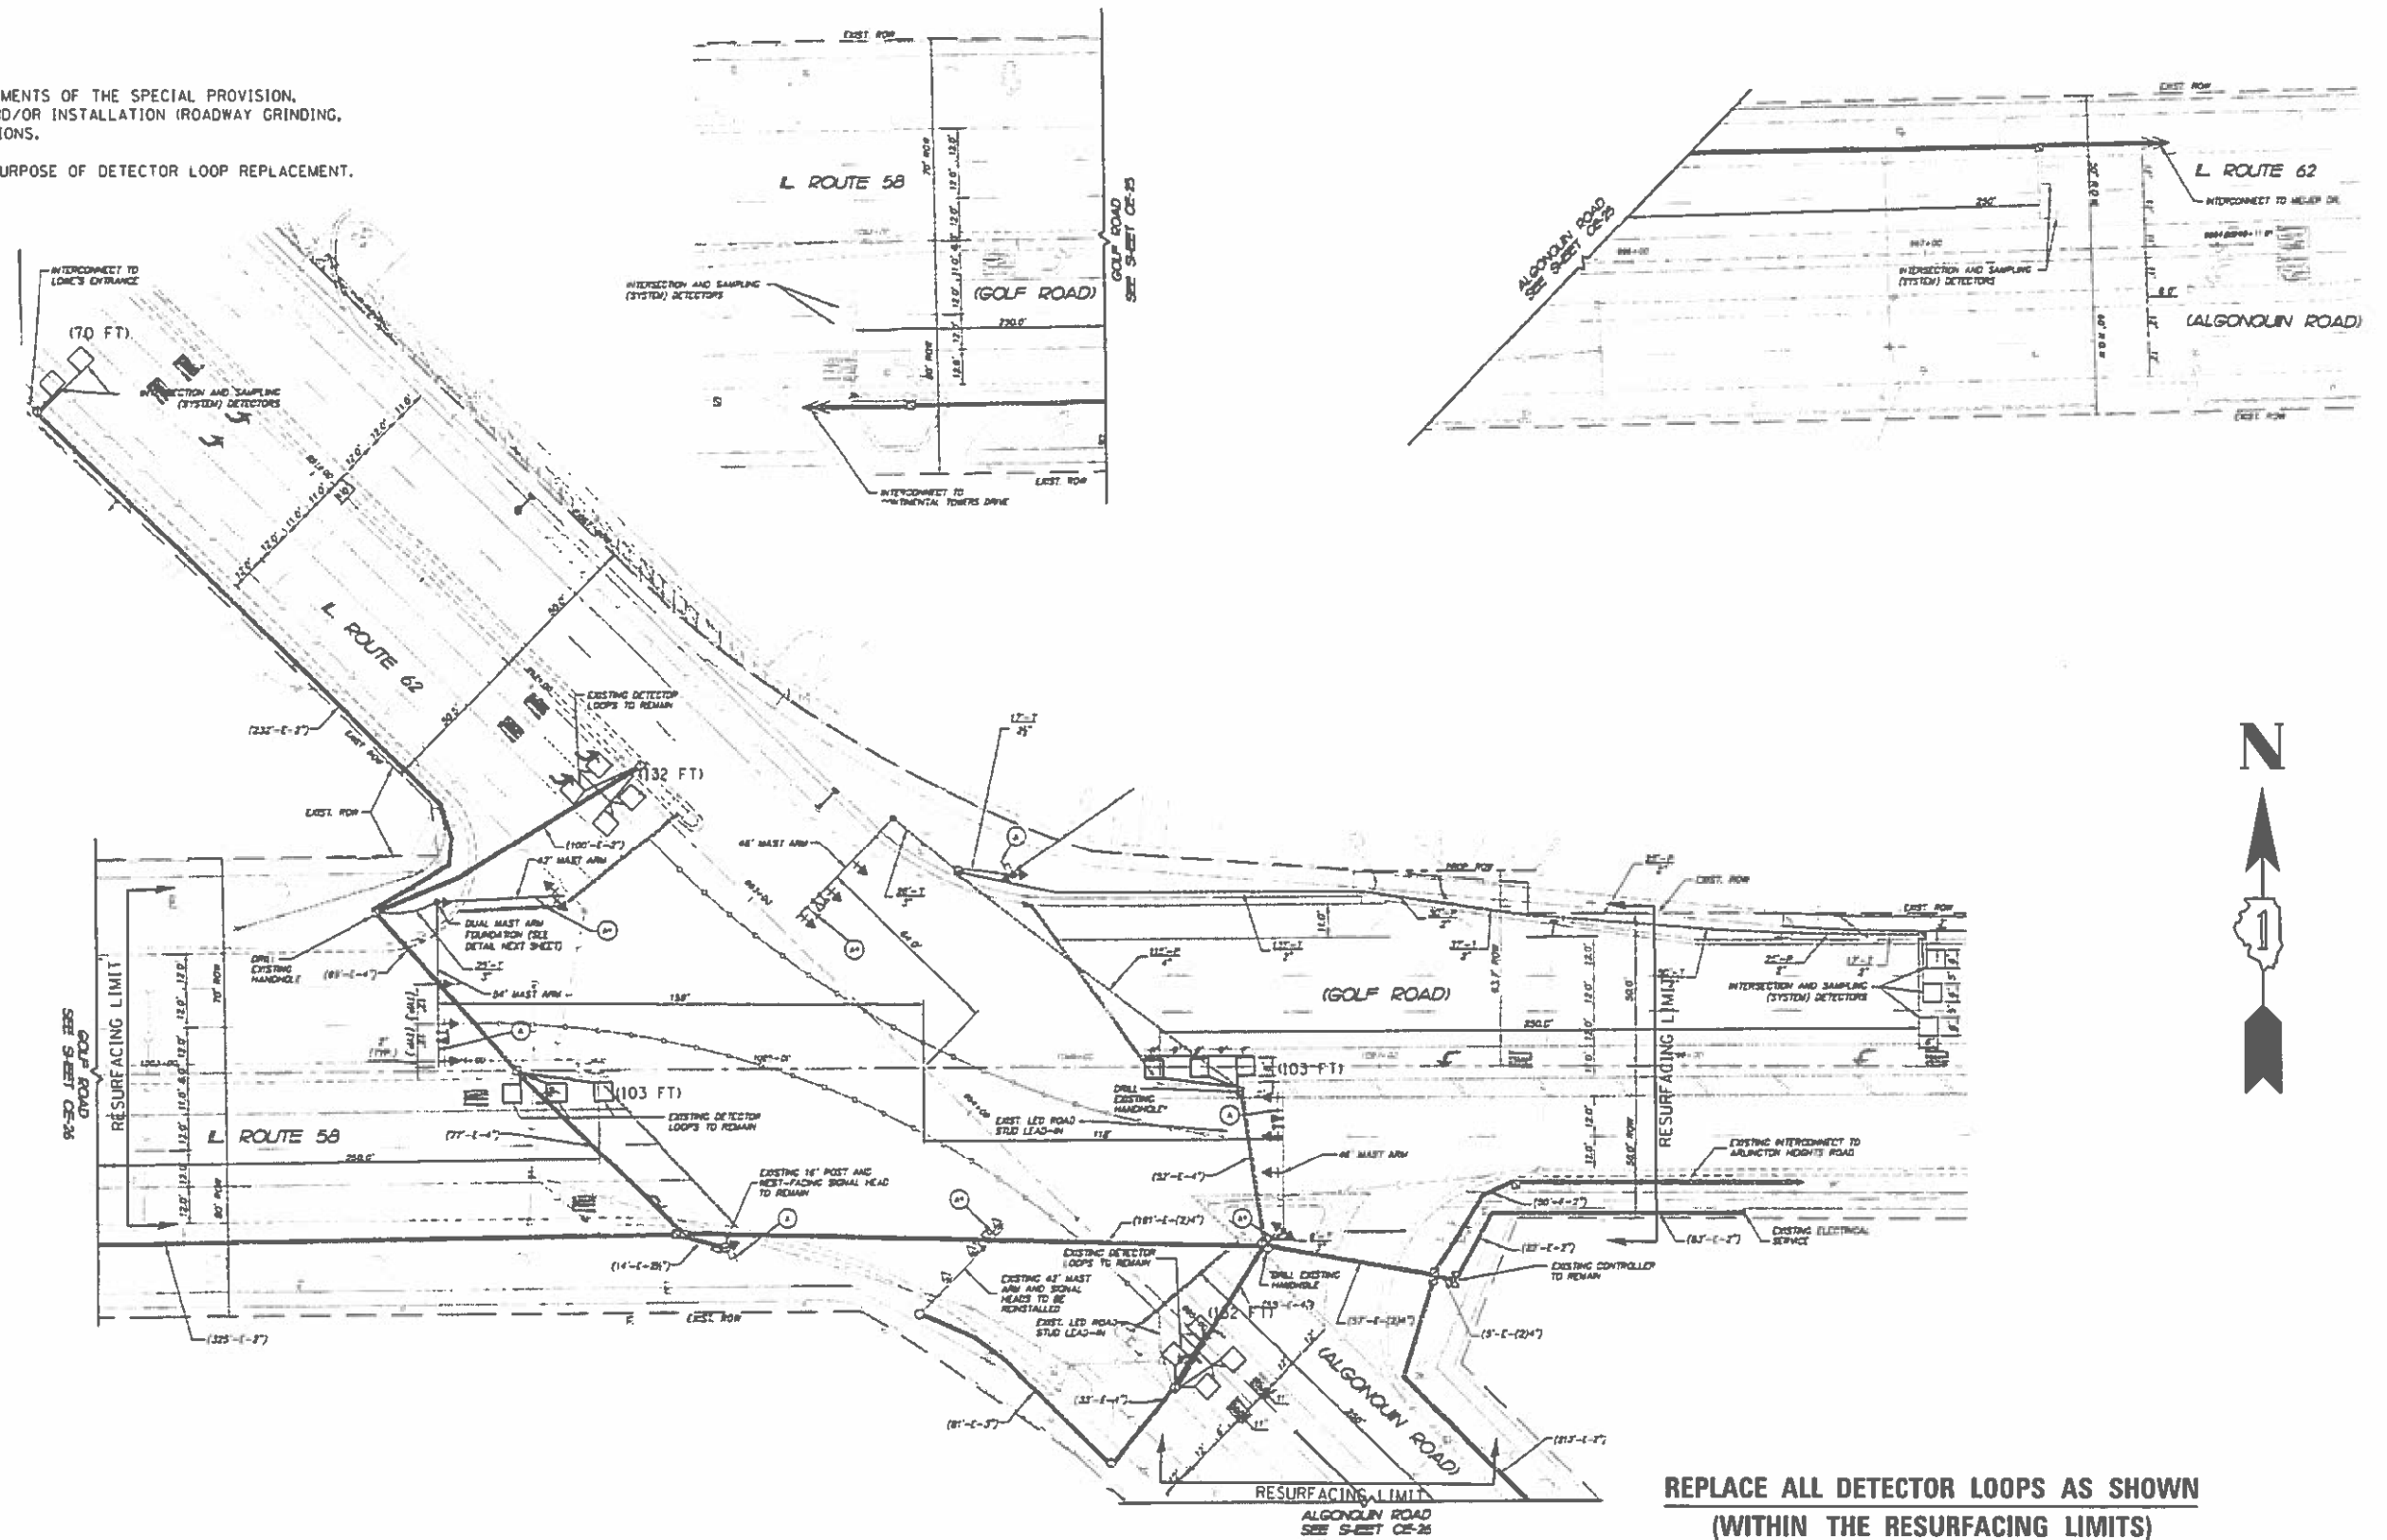

**REPLACE ALL DETECTOR LOOPS AS SHOWN  
(WITHIN THE RESURFACING LIMITS)**

| CODE     | ITEM                      | QUANTITY | UNIT |
|----------|---------------------------|----------|------|
| 88600600 | DETECTOR LOOP REPLACEMENT | 540      | FOOT |

|                                  |             |            |             |   |  |                           |                 |              |              |           |  |
|----------------------------------|-------------|------------|-------------|---|--|---------------------------|-----------------|--------------|--------------|-----------|--|
| FILE NAME *                      | USER NAME * | DESIGNED - | REVISIONS - | <b>STATE OF ILLINOIS<br/>DEPARTMENT OF TRANSPORTATION</b> | <b>DETECTOR LOOP REPLACEMENT PLAN<br/>IL 62 AT IL 58</b> | F.A.P. RTE.               | SECTION         | COUNTY       | TOTAL SHEETS | SHEET NO. |  |
| 16\62C93\Detector Loop Details\2 | curry, a    | IP         | -           |   |  | 339                       | 116Y11&21R-RS-6 | COOK         | 58           | 46        |  |
| PLOT SCALE *                     | DRAWING     | CHECKED -  | REVISIONS - |   |  | CONTRACT NO. 62C93        |                 |              |              |           |  |
| 48.8468' / 1"                    | IP          | LP         | -           |   |  | ILLINOIS FED. AID PROJECT |                 |              |              |           |  |
| Default                          | PLOT DATE * | DATE       | REVISIONS - | SCALE:  |  | SHEET OF SHEETS           |                 | STA. TO STA. |              |           |  |
|                                  | 9/21/2016   | 8/15/2016  | -           |   |  |                           |                 |              |              |           |  |

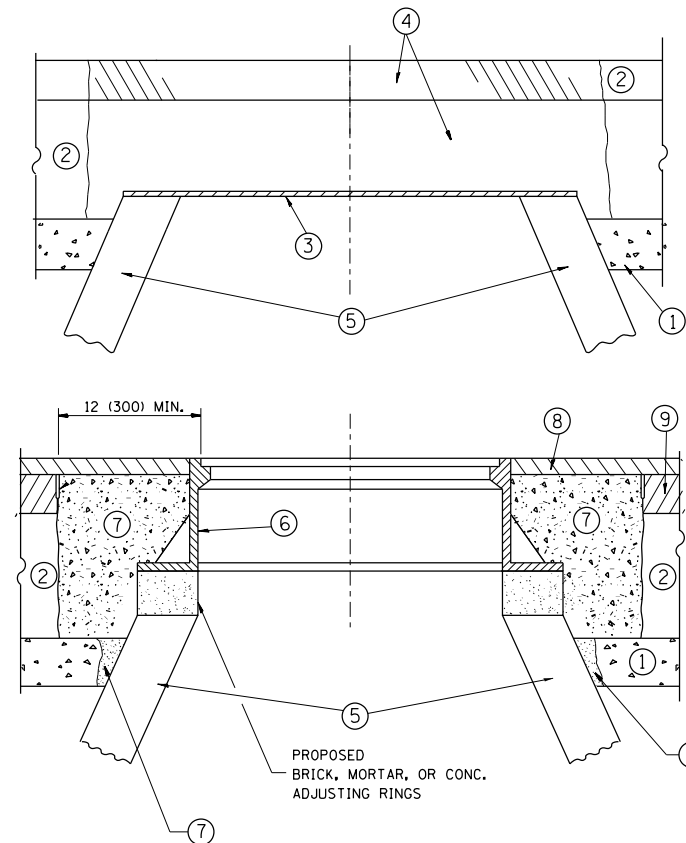

**CONSTRUCTION PROCEDURES**

**STAGE 1 (BEFORE PAVEMENT MILLING)**

- A) REMOVE A MINIMUM OF 12 (300) OF THE PAVEMENT FROM AROUND THE STRUCTURE.
- B) REMOVE THE EXISTING FRAME AND LID FROM THE STRUCTURE.
- C) COVER THE STRUCTURE OPENING WITH A 36 (900) DIAMETER METAL PLATE.
- D) BACKFILL WITH CRUSHED STONE AND A MINIMUM 1/2 (40) THICK HMA SURFACE MIX APPROVED BY THE ENGINEER.

**STAGE 2 (AFTER PAVEMENT MILLING)**

- A) REMOVE THE HMA SURFACE MIX AND CRUSHED STONE.
- B) INSTALL THE FRAME AND LID; ADJUST THE FRAME TO ITS FINAL SURFACE ELEVATION.
- C) THE SURROUNDING SPACE SHALL BE FILLED WITH CLASS PP-1\* CONCRETE TO THE ELEVATION OF THE SURFACE OF THE EXISTING BASE COURSE OR THE BINDER COURSE.

\* UNLESS OTHERWISE SPECIFIED IN THE PLANS.

THE PROCEDURE EXPLAINED ABOVE SHALL CONFORM TO THE APPLICABLE PORTIONS OF SECTIONS 353, 406, 602, AND 603 OF THE STANDARD SPECIFICATIONS EXCEPT THAT "THE CONTRACTOR SHALL ADJUST THE STRUCTURES TO THE FINISHED PAVEMENT ELEVATION NO MORE THAN 5 CALENDAR DAYS PRIOR TO PLACEMENT OF THE FINAL LIFT OF SURFACE UNLESS APPROVED BY THE ENGINEER."

**LEGEND**

- ① SUB-BASE GRANULAR MATERIAL
- ② EXISTING PAVEMENT
- ③ 36 (900) DIAMETER METAL PLATE
- ④ PROPOSED CRUSHED STONE AND HMA SURFACE MIX
- ⑤ EXISTING STRUCTURE
- ⑥ FRAME AND LID (SEE NOTES)
- ⑦ CLASS PP-1\* CONCRETE
- ⑧ PROPOSED HMA SURFACE COURSE
- ⑨ PROPOSED HMA BINDER COURSE

**LOCATION OF STRUCTURES:**

THE CONTRACTOR WILL BE REQUIRED TO KEEP A RECORD OF THE LOCATIONS OF THE BURIED STRUCTURES ACCORDING TO THE STATION AND DISTANCE LEFT OR RIGHT OF THE CENTERLINE OF PAVEMENT. UPON COMPLETION OF THE WORK, THE CONTRACTOR WILL DELIVER THE RECORD TO THE ENGINEER.

**BASIS OF PAYMENT:**

REMOVING FRAMES AND LIDS ON DRAINAGE AND UTILITY STRUCTURES IN THE PAVEMENT PRIOR TO MILLING, AND ADJUSTING TO FINAL GRADE PRIOR TO PLACING THE SURFACE COURSE, WILL BE PAID FOR AT THE CONTRACT UNIT PRICE EACH FOR "FRAMES AND LIDS TO BE ADJUSTED (SPECIAL)."

THIS WORK WILL NOT BE PAID FOR WHEN DRAINAGE AND UTILITY STRUCTURES ARE SPECIFIED FOR PAYMENT AS STRUCTURE RECONSTRUCTION.

NEW FRAMES AND LIDS, WHEN SPECIFIED, WILL BE PAID FOR SEPARATELY.

**NOTES:**

EXISTING BROKEN FRAMES AND LIDS SHALL BE REMOVED AND DISPOSED OF BY THE CONTRACTOR AND SHALL BE REPLACED AS DIRECTED BY THE ENGINEER. REPLACEMENT FRAMES AND LIDS WILL BE PAID FOR IN ACCORDANCE WITH ARTICLE 109.04 OF THE STANDARD SPECIFICATIONS UNLESS A SEPARATE PAY ITEM HAS BEEN PROVIDED.

IF THE EXISTING LIDS ARE OPEN, THE FRAME WILL BE ADJUSTED TO THE ELEVATION OF THE MILLED PAVEMENT SURFACE PRIOR TO THE MILLING OPERATION. THE FRAME WILL NOT BE REMOVED AND COVERED BY THE METAL PLATE.

CITY OF CHICAGO CASTINGS ARE THE PROPERTY OF THE CITY AND THE CONTRACTOR SHALL NOTIFY THE CITY FOR REMOVAL AND DISPOSITION OF THE CASTINGS.

THE METAL PLATE USED TO COVER THE STRUCTURE SHALL REMAIN THE PROPERTY OF THE CONTRACTOR.

WHEN STRUCTURES ARE TO BE ADJUSTED OR RECONSTRUCTED, THE LOWERING AND RAISING OF THE FRAMES AND LIDS WILL NOT BE PAID FOR SEPARATELY BUT WILL BE INCLUDED IN THE COST OF THE CORRESPONDING PAY ITEM.

**DETAILS FOR FRAMES AND LIDS ADJUSTMENT WITH MILLING**

ALL DIMENSIONS ARE IN INCHES (MILLIMETERS) UNLESS OTHERWISE SHOWN


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|---|-------------------------------|--------------------|--------------------------------|
| FILE NAME =   | USER NAME = PencePL           | DESIGNED - R. SHAH | REVISED - R. WIEDEMAN 05-14-04 |
| pw\11084EBIDINTEG.illinois.gov\PIWIDOT\Documents\IDOT Offices\District 1\Projects\141\0RAM\Design\Diststd.dgn |                               |                    | REVISED - R. BORO 01-01-07     |
|   | PLOT SCALE = 100.0000' / 1in. | CHECKED -          | REVISED - R. BORO 03-09-11     |
|   | PLOT DATE = 2/4/2017          | DATE - 10-25-94    | REVISED - R. BORO 12-06-11     |

**STATE OF ILLINOIS  
DEPARTMENT OF TRANSPORTATION**

**DETAILS FOR  
FRAMES AND LIDS ADJUSTMENT WITH MILLING**

SCALE: NONE SHEET NO. 1 OF 1 SHEETS STA. TO STA.

|   |                 |                           |              |           |
|---|-----------------|---------------------------|--------------|-----------|
| F.A.P. RTE.                                     | SECTION         | COUNTY                    | TOTAL SHEETS | SHEET NO. |
| 339   | 116Y(1&2)R-RS-6 | COOK                      | 58           | 47        |
| <b>BD600-03 (BD-8)</b>                          |                 | <b>CONTRACT NO. 62C93</b> |              |           |
| FED. ROAD DIST. NO. 1 ILLINOIS FED. AID PROJECT |                 |                           |              |           |

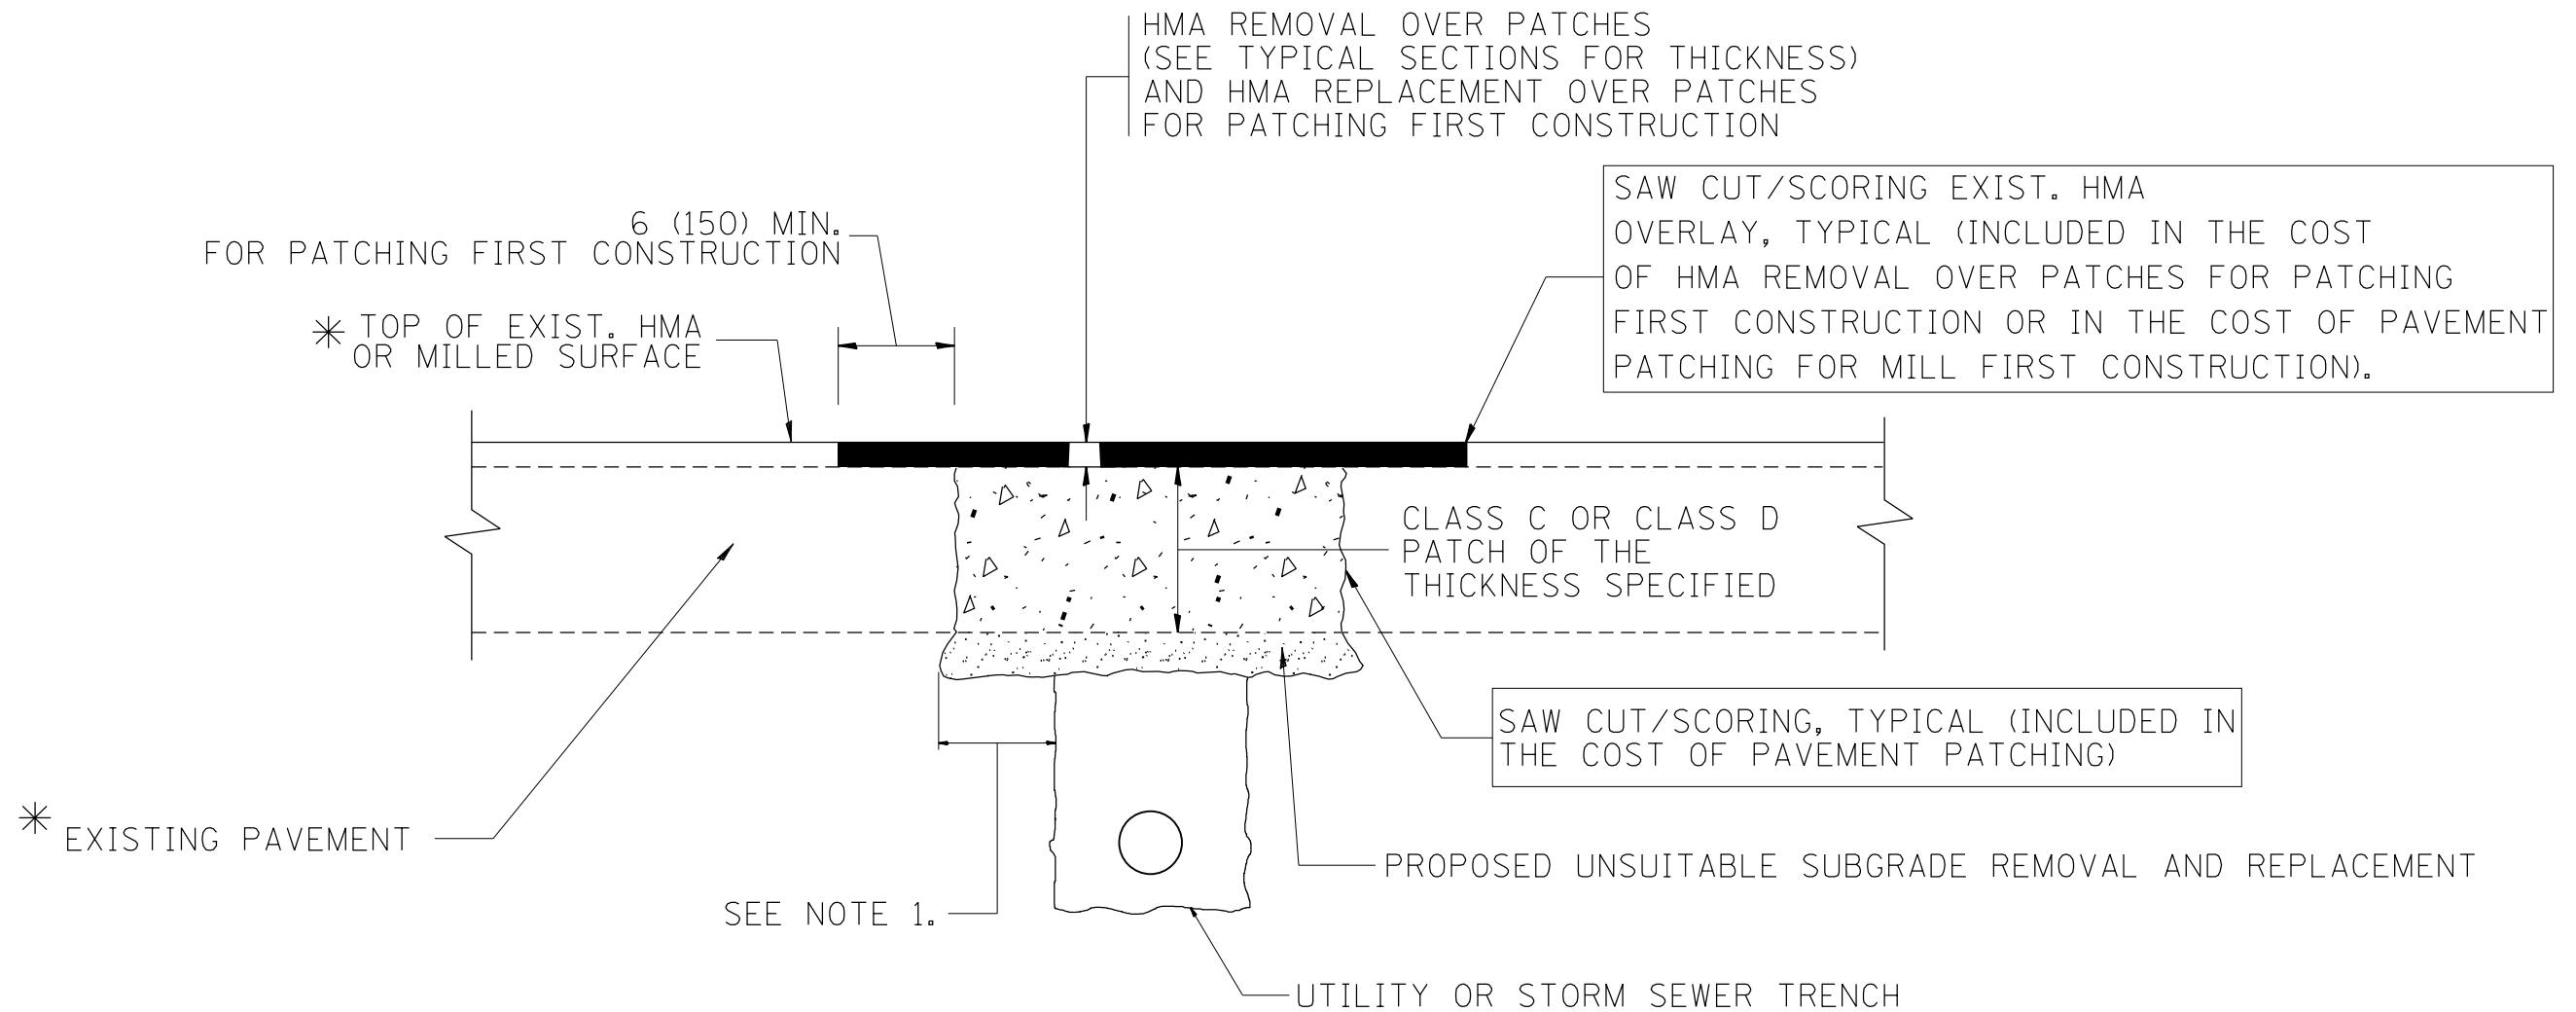

\* SEE TYPICAL SECTIONS FOR THICKNESS AND MATERIALS

**NOTES:**

1. THE WIDTH OF THE FULL DEPTH PATCH OVER A TRENCH SHALL BE 12 (300) WIDER ON EACH SIDE OF THE TRENCH.
2. FOR METHOD OF MEASUREMENT AND BASIS OF PAYMENT, SEE RECURRING SPECIAL PROVISION "PATCHING WITH HOT-MIX ASPHALT OVERLAY REMOVAL".

SEQUENCE OF CONSTRUCTION (PATCHING FIRST)

1. REMOVE THE EXISTING HMA MATERIAL OVER THE AREA TO BE PATCHED.
2. REMOVE AND REPLACE WITH CLASS C OR D PATCH.
3. REPLACE HMA MATERIAL OVER THE AREA TO BE PATCHED.


SEQUENCE OF CONSTRUCTION (MILLING FIRST)

1. MILL HMA FIRST IF THERE IS AT LEAST 4 1/2 INCHES OR MORE OF HMA MATERIAL ON TOP OF THE EXISTING PAVEMENT OR IF THE PAVEMENT IS FULL DEPTH HMA. A MINIMUM OF 2 INCHES OF HMA MATERIAL SHALL BE IN PLACE AFTER MILLING.
2. REMOVE AND REPLACE WITH FULL DEPTH CLASS D PATCHES TO TOP OF MILLED SURFACE.

ALL DIMENSIONS ARE IN INCHES (MILLIMETERS) UNLESS OTHERWISE SHOWN.

|   |                               |                    |                             |   |  |                         |      |                           |   |        |              |           |
|---|-------------------------------|--------------------|-----------------------------|---|--|-------------------------|------|---------------------------|---|--------|--------------|-----------|
| FILE NAME =   | USER NAME = PencePL           | DESIGNED - R. SHAH | REVISED - A. ABBAS 04-27-98 | <b>STATE OF ILLINOIS<br/>DEPARTMENT OF TRANSPORTATION</b> | <b>PAVEMENT PATCHING FOR<br/>HMA SURFACED PAVEMENT</b> |                         |      | F.A.P. RTE.               | SECTION   | COUNTY | TOTAL SHEETS | SHEET NO. |
| pw\11\084EBIDINTEG.illinois.gov\PIWIDOT\Documents\DOT Offices\District 1\Projects\0141\084EBID\Design\Diststd.dgn | PLOT SCALE = 100.0000' / 1in. | CHECKED -          | REVISED - R. BORO 01-01-07  |   |  |                         |      | 339                       | 116Y(1&2)R-RS-6                                     | COOK   | 58           | 48        |
|   | PLOT DATE = 2/4/2017          | DATE - 10-25-94    | REVISED - R. BORO 09-04-07  |   | <b>BD400-04 (BD-22)</b>                                |                         |      | <b>CONTRACT NO. 62C93</b> |   |        |              |           |
|   |                               |                    | REVISED - K. ENG 10-27-08   |   | SCALE: NONE  | SHEET NO. 1 OF 1 SHEETS | STA. | TO STA.                   | FED. ROAD DIST. NO. 1   ILLINOIS   FED. AID PROJECT |        |              |           |



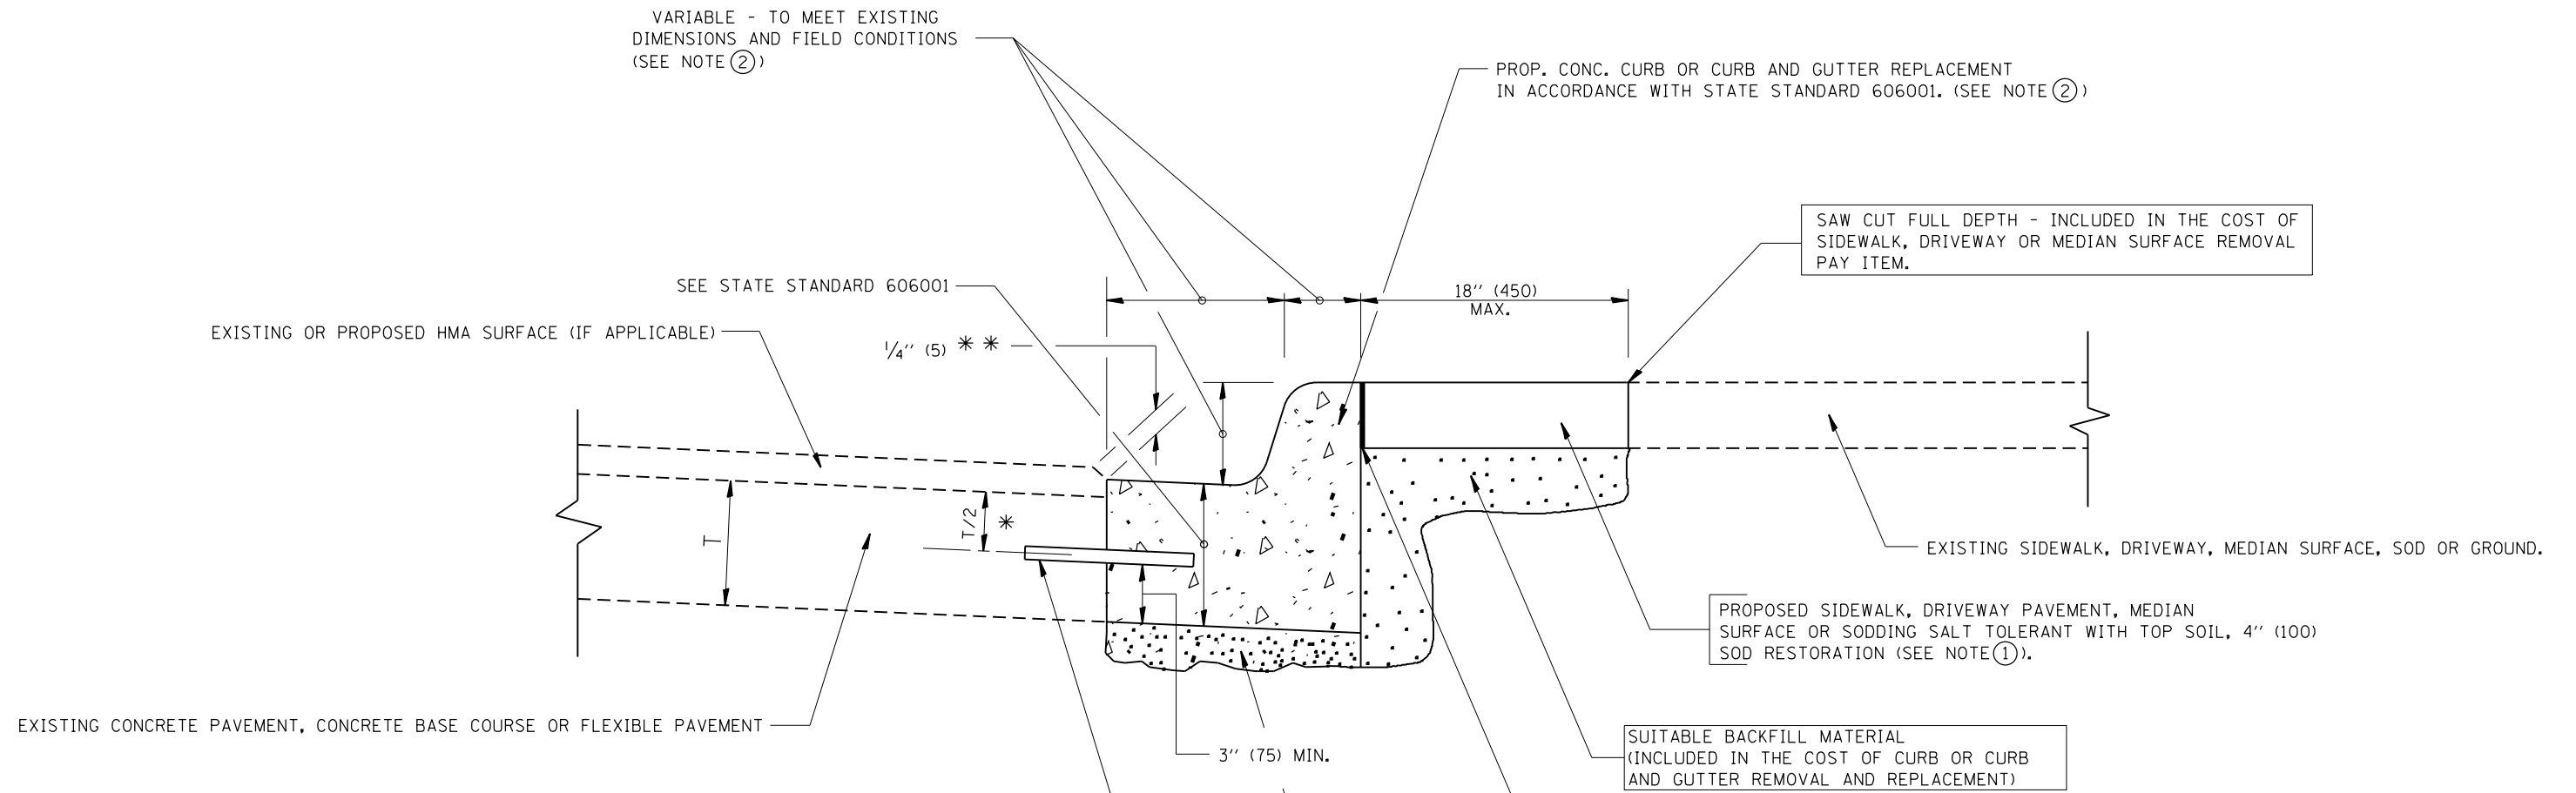

\* 3" (75) MINIMUM FROM TOP AND BOTTOM OF THE CONCRETE PAVEMENT OR BASE COURSE.

\* \* IF THE FINAL SURFACE OF THE PAVEMENT IS CONCRETE, THE GUTTER IS TO BE FLUSH WITH THE PAVEMENT.

NOTE: ① SIDEWALK, DRIVEWAY PAVEMENT OR MEDIAN SURFACE SHALL BE SIMILAR TO THE MATERIAL BEING REMOVED AND WILL BE PAID FOR SEPARATELY.

SODDING, SALT TOLERANT AND TOP SOIL, FURNISH AND PLACE 4" WILL BE PAID FOR SEPARATELY.

② FERTILIZER FOR THE PLACEMENT OF THE SOD IS NOT REQUIRED

③ CURB OR CURB AND GUTTER REPLACEMENT SHALL MATCH THE SHAPE OF THE EXISTING CURB OR CURB AND GUTTER UNLESS OTHERWISE SPECIFIED.

④ FOR CURB OR CURB AND GUTTER REMOVAL AND REPLACEMENT ADJACENT TO FLEXIBLE PAVEMENT DELETE EPOXY COATED TIE BARS.

⑤ LONGITUDINAL BARS, IF ENCOUNTERED IN THE EXISTING CURB OR CURB AND GUTTER, ARE NOT TO BE REPLACED. CUTTING AND REMOVING LONGITUDINAL BARS SHALL BE INCLUDED IN THE COST OF CURB OR CURB AND GUTTER REMOVAL AND REPLACEMENT.

⑥ THE COST OF HMA SURFACE REMOVAL IN THE EXISTING GUTTER FLAG SHALL BE INCLUDED IN THE COST OF THE CURB AND GUTTER REMOVAL AND REPLACEMENT.

⑦ THE REMOVAL AND REPLACEMENT OF THE EXISTING CURB OR CURB AND GUTTER SHALL BE DONE IN ACCORDANCE WITH THE APPLICABLE PORTIONS OF SECTION 440 AND 606 OF THE STANDARD SPECIFICATIONS.

⑧ THE LOCATIONS OF REMOVAL AND REPLACEMENT OF EXISTING CURB OR CURB AND GUTTER SHALL BE DETERMINED BY THE RESIDENT ENGINEER AT THE TIME OF CONSTRUCTION.

UNSUITABLE SUB-BASE MATERIAL TO BE REMOVED, IF DIRECTED BY THE ENGINEER, SHALL BE REPLACED WITH EITHER SUB-BASE GRANULAR MATERIAL, TYPE B OR ADDITIONAL THICKNESS OF CONCRETE.

REMOVAL AND REPLACEMENT 4" (100) OR LESS IS INCLUDED IN THE COST OF CURB OR CURB AND GUTTER REMOVAL AND REPLACEMENT.

REMOVAL AND REPLACEMENT IN EXCESS OF 4" (100) WILL BE PAID FOR IN ACCORDANCE WITH ARTICLE 109.04 OF THE STANDARD SPECIFICATIONS.


PROPOSED #6 (20) EPOXY COATED TIE BARS 24" (600) LONG AT 24" (600) CENTERS WILL NOT BE PAID FOR SEPARATELY. DELETE EPOXY COATED TIE BARS IF EXISTING TIE BARS ARE USABLE AS DETERMINED BY THE ENGINEER. (SEE NOTE ③).

**BASIS OF PAYMENT:**  
THIS WORK WILL BE PAID FOR AT THE CONTRACT UNIT PRICE PER FOOT (METER) FOR "CURB REMOVAL AND REPLACEMENT" OR "COMBINATION CONCRETE CURB AND GUTTER REMOVAL AND REPLACEMENT".


# CURB OR CURB AND GUTTER REMOVAL AND REPLACEMENT

ALL DIMENSIONS ARE IN INCHES (MILLIMETERS) UNLESS OTHERWISE SHOWN.

|  |                     |                             |                             |   |  |                         |                         |                           |              |   |
|--|---------------------|-----------------------------|-----------------------------|---|--|-------------------------|-------------------------|---------------------------|--------------|---|
| FILE NAME =  | USER NAME = PencePL | DESIGNED - A. HOUSEH        | REVISED - R. SHAH 10-03-96  | <b>STATE OF ILLINOIS<br/>DEPARTMENT OF TRANSPORTATION</b> | <b>CURB OR CURB AND GUTTER<br/>REMOVAL AND REPLACEMENT</b> | F.A.P. RTE.             | SECTION                 | COUNTY                    | TOTAL SHEETS | SHEET NO.   |
| pw\11084EBIDINTEG.illinois.gov\PWIDOT\Documents\DOT Offices\District 1\Projects\0141\ORAN\Design\Diststd.dgn |                     | REVISED - A. ABBAS 03-21-97 | REVISED - M. GOMEZ 01-22-01 |   |  | 339                     | 116Y(1&2)R-RS-6         | COOK                      | 58           | 49  |
| PLOT SCALE = 100.0000' / 1in.  | CHECKED -           | REVISED - R. BORO 12-15-09  |                             |   |  | <b>BD600-06 (BD-24)</b> |                         | <b>CONTRACT NO. 62C93</b> |              |   |
| PLOT DATE = 2/4/2017   | DATE - 03-11-94     |                             |                             |   |  | SCALE: NONE             | SHEET NO. 1 OF 1 SHEETS | STA.                      | TO STA.      | FED. ROAD DIST. NO. 1   ILLINOIS FED. AID PROJECT |

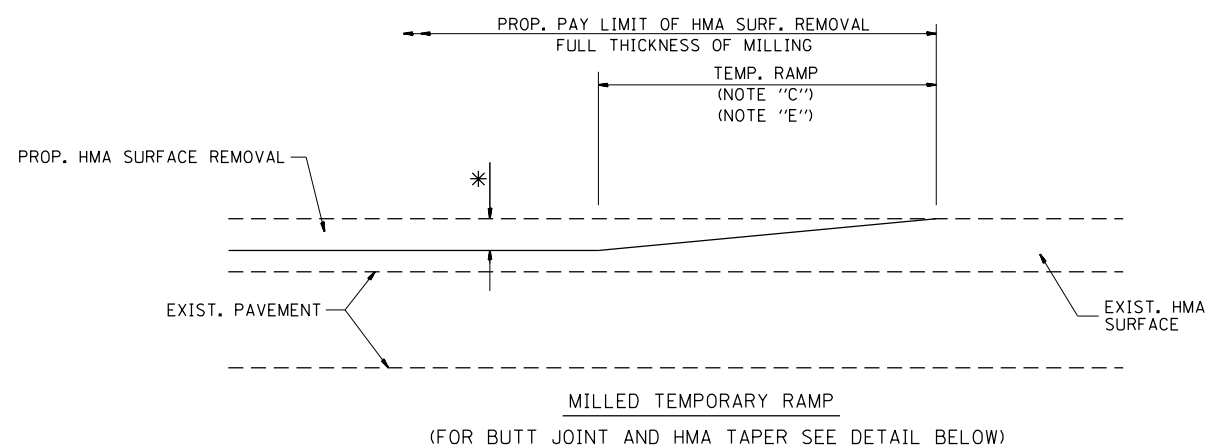


**OPTION 1**

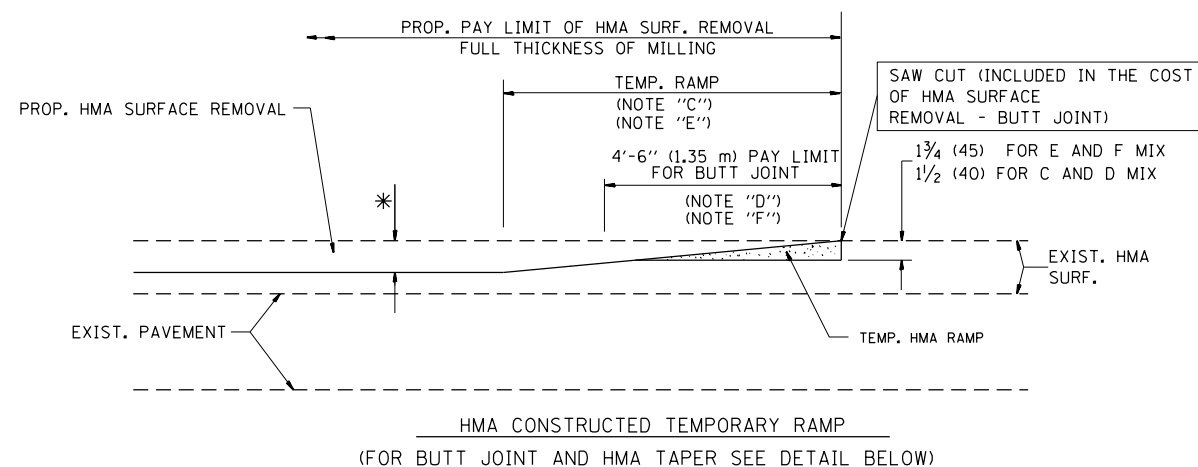


**OPTION 2**

**TYPICAL TEMPORARY RAMP**

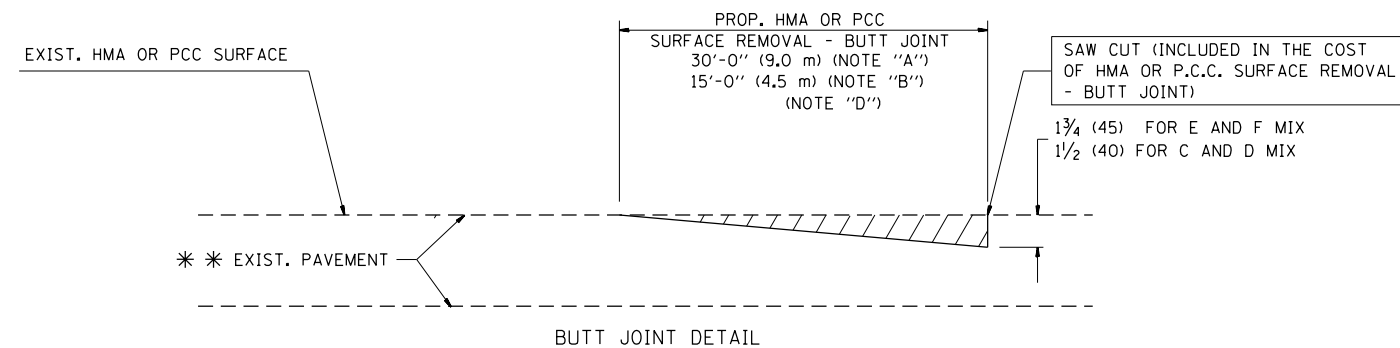

**BUTT JOINT DETAIL**

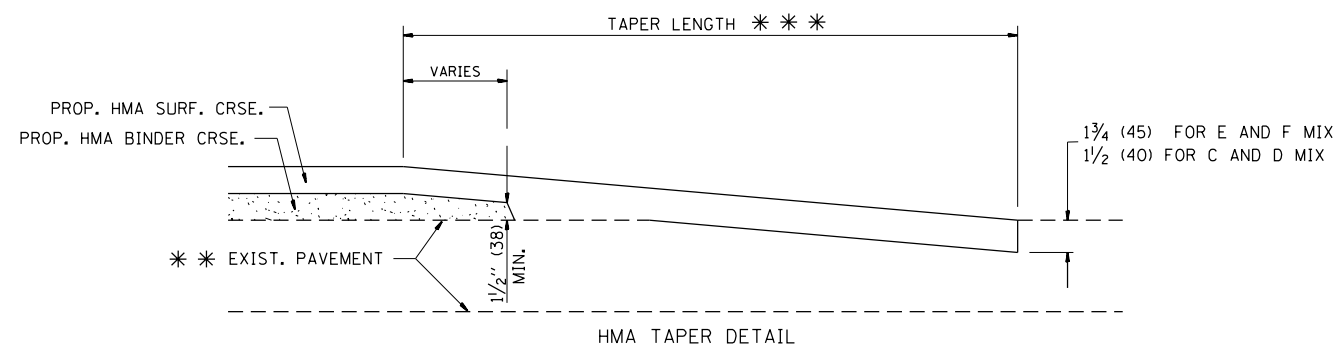

**HMA TAPER DETAIL**

**TYPICAL BUTT JOINT AND HMA TAPER FOR RESURFACING ONLY**

\*\*\* PC CONCRETE, HMA OR HMA RESURFACED PAVEMENT.


**NOTES**

- A: MAINLINE ROADWAYS AND MAJOR SIDE ROADS.
  - B: MINOR SIDE ROADS.
  - C: THE TEMP. RAMP SHALL BE CONSTRUCTED IMMEDIATELY UPON REMOVAL OF THE EXISTING HMA SURFACE.
  - D: THE BUTT JOINT SHALL BE CONSTRUCTED IMMEDIATELY PRIOR TO PLACING THE PROPOSED HMA COURSES.
  - E: TAPER THE TEMP. RAMP AT A RATE OF 3'-0" (900 mm) PER 1 INCH (25 mm) OF MILLING THICKNESS.
  - F: INSTALLATION AND REMOVAL OF THE 4'-6" (1.35 m) TEMP. RAMP IS INCLUDED IN COST OF HMA SURFACE REMOVAL - BUTT JOINT
  - G: SEE ARTICLE 406.08 AND 406.14 OF THE STANDARD SPECIFICATIONS FOR "HMA AND/OR PCC SURFACE REMOVAL, BUTT JOINT".
- \* SEE TYPICAL SECTIONS FOR MILLING THICKNESS.
- \*\*\* 20'-0" (6.1 m) PER 1 (25) RESURFACING (NOTE "A")  
10'-0" (3.0 m) PER 1 (25) RESURFACING (NOTE "B")

**BASIS OF PAYMENT:**

THE BUTT JOINT WILL BE PAID FOR AT THE CONTRACT UNIT PRICE PER SQUARE YARD (SQUARE METER) FOR "HOT-MIX ASPHALT SURFACE REMOVAL - BUTT JOINT" OR FOR "PORTLAND CEMENT CONCRETE SURFACE REMOVAL - BUTT JOINT".

ALL DIMENSIONS ARE IN INCHES (MILLIMETERS) UNLESS OTHERWISE SHOWN.

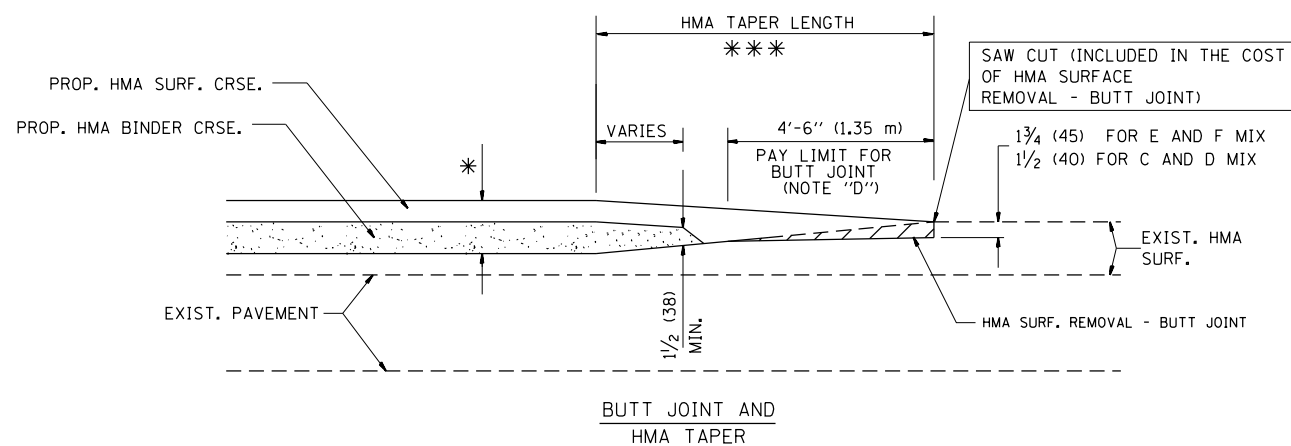

**TYPICAL BUTT JOINT AND HMA TAPER FOR MILLING AND RESURFACING**


|  |                               |                       |                             |
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| FILE NAME =  | USER NAME = PencePL           | DESIGNED - M. DE YONG | REVISED - R. SHAH 10-25-94  |
| pw\11084EBIDINTEG.illinois.gov\PIWIDOT\Documents\DOT Offices\District 1\Projects\01410RAM\Design\Diststd.dgn |                               | CHECKED -             | REVISED - A. ABBAS 03-21-97 |
|  | PLOT SCALE = 100.0000' / 1in. | DATE - 06-13-90       | REVISED - M. GOMEZ 04-06-01 |
|  | PLOT DATE = 2/4/2017          |                       | REVISED - R. BORO 01-01-07  |

**STATE OF ILLINOIS  
DEPARTMENT OF TRANSPORTATION**

**BUTT JOINT AND  
HMA TAPER DETAILS**

SCALE: NONE SHEET NO. 1 OF 1 SHEETS STA. TO STA.

|   |                 |                    |              |           |
|---|-----------------|--------------------|--------------|-----------|
| F.A.P. RTE.                                     | SECTION         | COUNTY             | TOTAL SHEETS | SHEET NO. |
| 339   | 116Y(1&2)R-RS-6 | COOK               | 58           | 50        |
| BD400-05 BD32                                   |                 | CONTRACT NO. 62C93 |              |           |
| FED. ROAD DIST. NO. 1 ILLINOIS FED. AID PROJECT |                 |                    |              |           |

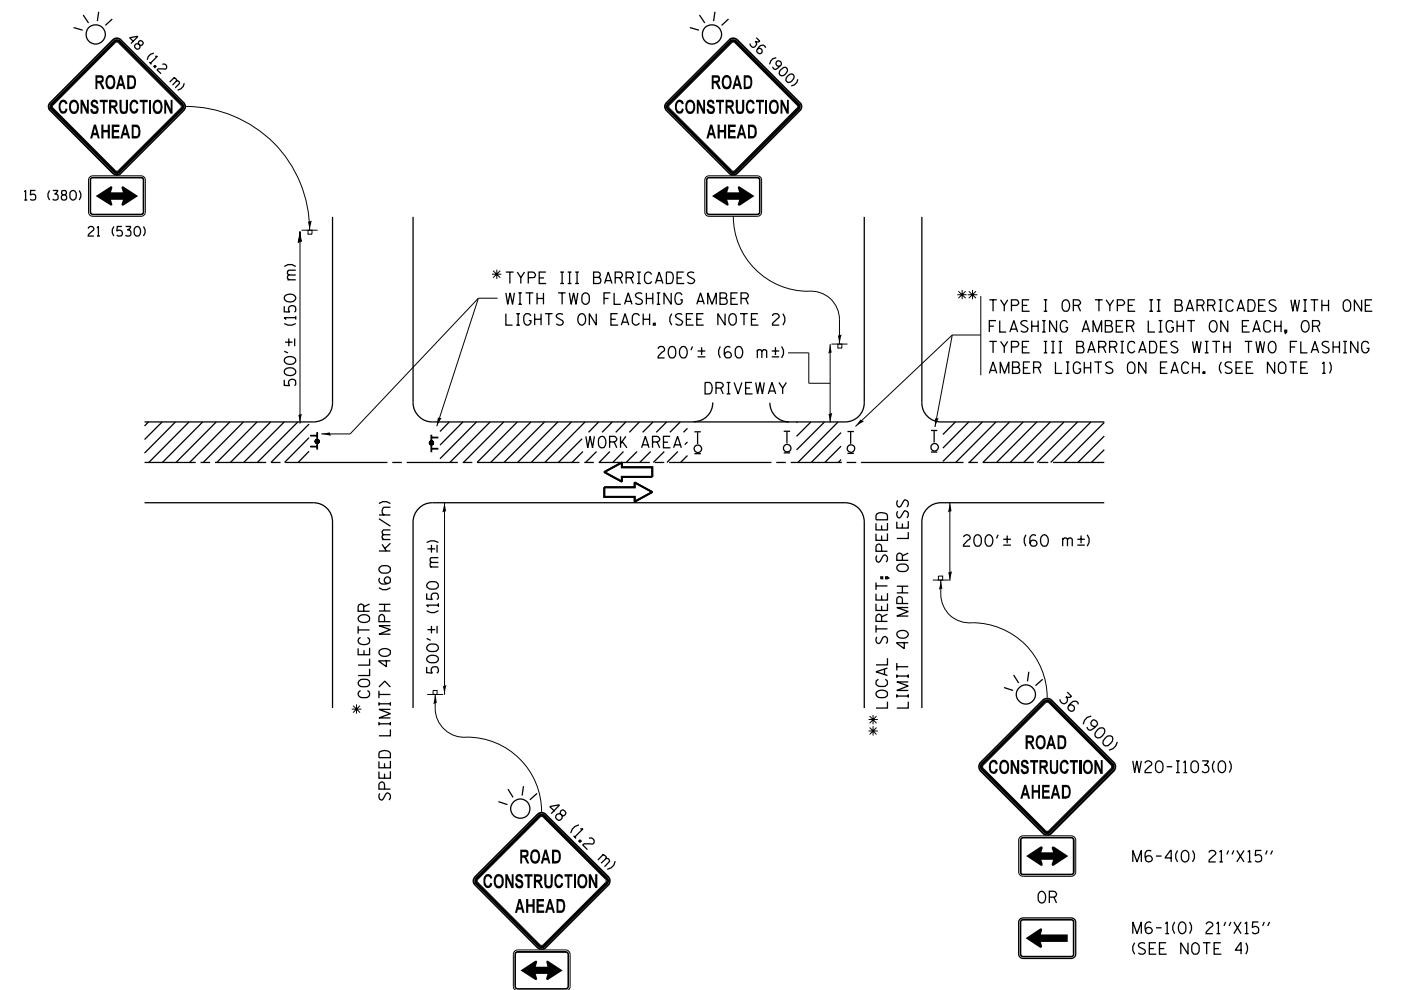

**NOTES:**

1. SIDE ROAD WITH A SPEED LIMIT OF 40 MPH (60 km/h) OR LESS AS SHOWN ON THE DRAWING AND AS DIRECTED BY THE ENGINEER:
  - a) ONE "ROAD CONSTRUCTION AHEAD" SIGN 36 x 36 (900x900) WITH A FLASHER MOUNTED ON IT APPROXIMATELY 200' (60 m) IN ADVANCE OF THE MAIN ROUTE.
  - b) THE CLOSED PORTION OF THE MAIN ROUTE SHALL BE PROTECTED BY BLOCKING WITH TYPE I, TYPE II OR TYPE III BARRICADES, 1/3 OF THE CROSS SECTION OF THE CLOSED PORTION.
2. SIDE ROAD WITH A SPEED LIMIT GREATER THAN 40 MPH (60 km/h) AS SHOWN ON THE DRAWING AND AS DIRECTED BY THE ENGINEER:
  - a) ONE "ROAD CONSTRUCTION AHEAD" SIGN 48 x 48 (1.2 m x 1.2 m) WITH A FLASHER MOUNTED ON IT APPROXIMATELY 500' (150 m) IN ADVANCE OF THE MAIN ROUTE.
  - b) THE CLOSED PORTION OF THE MAIN ROUTE SHALL BE PROTECTED BY BLOCKING WITH TYPE III BARRICADES, 1/2 OF THE CROSS SECTION OF THE CLOSED PORTION.
3. CONES MAY BE SUBSTITUTED FOR BARRICADES OR DRUMS AT HALF THE SPACING DURING DAY OPERATIONS. CONES SHALL BE A MINIMUM OF 28 (710) IN HEIGHT.
4. WHEN THE SIDE ROAD LIES BETWEEN THE BEGINNING OF THE MAINLINE SIGNING AND THE WORK ZONE, A SINGLE HEADED ARROW (M6-1) SHALL BE USED IN LIEU OF THE DOUBLE HEADED ARROW (M6-4).
5. WHEN WORK IS BEING PERFORMED ON A SIDE ROAD OR DRIVEWAY, FOLLOW THE APPLICABLE STANDARD(S). THE DIRECTIONAL ARROW (M6-1 OR M6-4) SHALL BE COVERED OR REMOVED WHEN NO LONGER CONSISTENT WITH THE TRAFFIC CONTROL SET-UP.
6. ADVANCE WARNING SIGNS ARE TO BE OMITTED ON DRIVEWAYS UNLESS OTHERWISE SPECIFIED IN THE PLANS OR BY THE ENGINEER.
7. THE TRAFFIC CONTROL AND PROTECTION FOR SIDE ROADS, INTERSECTIONS, AND DRIVEWAYS SHALL BE INCLUDED IN THE COST OF SPECIFIED TRAFFIC CONTROL STANDARDS OR ITEMS.

All dimensions are in inches (millimeters) unless otherwise shown.


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|--|-------------------------------|-------------------|---------------------------------|
| FILE NAME =  | USER NAME = PencePL           | DESIGNED - L.H.A. | REVISED - A. HOUSEH 10-15-96    |
| pw:\11\084EBIDINTEG\illinois.gov\PIWIDOT\Documents\IDOT Offices\District 1\Projects\0141\RAMM\Design\Diststd.dgn |                               |                   | REVISED - T. RAMMACHER 01-06-00 |
| Default  | PLOT SCALE = 100.0000' / 1in. | CHECKED -         | REVISED - A. SCHUETZE 07-01-13  |
|  | PLOT DATE = 2/4/2017          | DATE - 06-89      | REVISED - A. SCHUETZE 09-15-16  |

**STATE OF ILLINOIS  
DEPARTMENT OF TRANSPORTATION**

**TRAFFIC CONTROL AND PROTECTION FOR  
SIDE ROADS, INTERSECTIONS, AND DRIVEWAYS**


SCALE: NONE SHEET 1 OF 1 SHEETS STA. TO STA.

| F.A.P. RTE.               | SECTION         | COUNTY | TOTAL SHEETS              | SHEET NO. |
|---------------------------|-----------------|--------|---------------------------|-----------|
| 339                       | 116Y(1&2)R-RS-6 | COOK   | 58                        | 51        |
| <b>TC-10</b>              |                 |        | <b>CONTRACT NO. 62C93</b> |           |
| ILLINOIS FED. AID PROJECT |                 |        |                           |           |

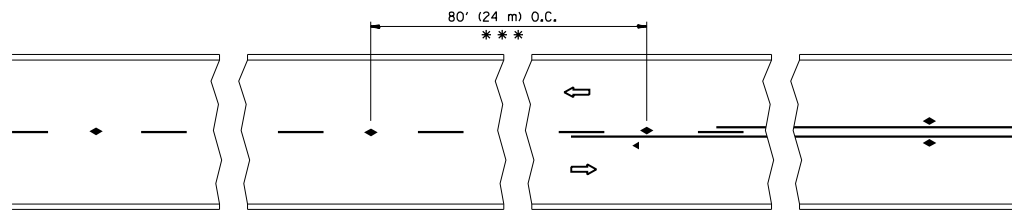


\*\*\* REDUCE TO 40' (12 m) O.C. ON CURVES WITH POSTED OR ADVISORY SPEED 45 M.P.H. (70 km/h) OR LESS.


TWO-LANE/TWO-WAY

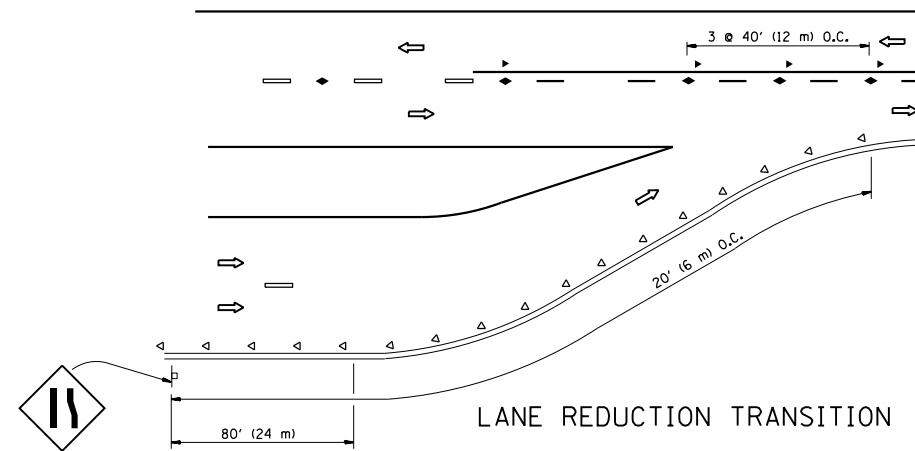


LANE REDUCTION TRANSITION

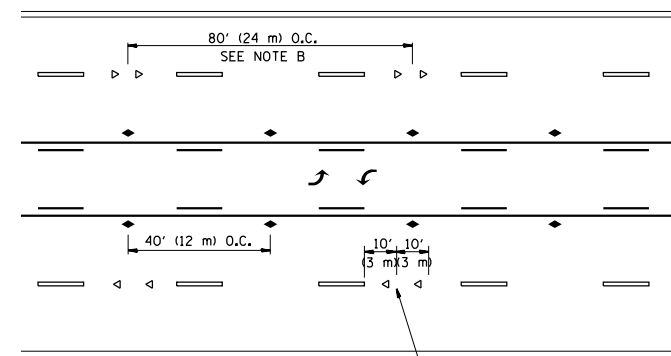

TWO-WAY LEFT TURN

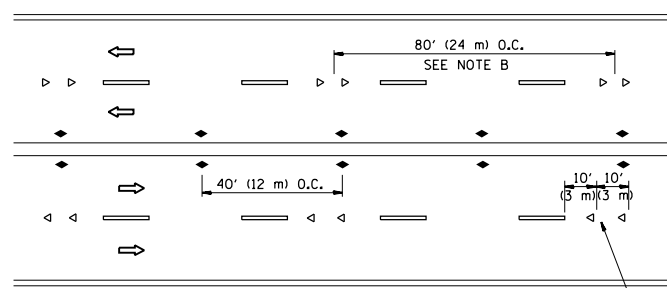

MULTI-LANE/UNDIVIDED

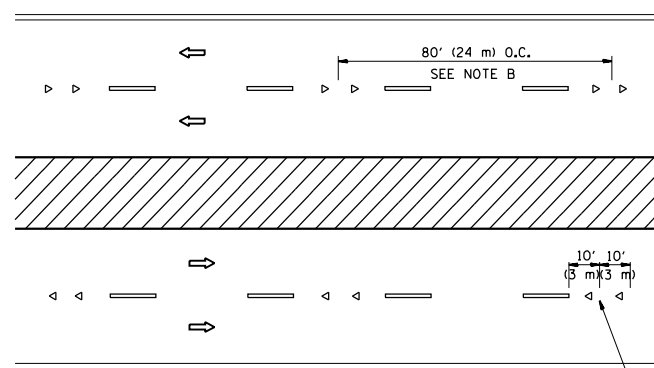

MULTI-LANE/DIVIDED

GENERAL NOTES

1. MARKERS USED WITH DASHED LINES SHALL BE CENTERED IN THE GAP BETWEEN SEGMENTS.
2. MARKERS USED ADJACENT TO SOLID LINES SHALL BE OFFSET 2 TO 3 (50 TO 75) TOWARD TRAFFIC AS SHOWN.
3. MARKERS THROUGH TANGENTS LESS THAN 500' (150 m) IN LENGTH BETWEEN CURVES SHALL BE INSTALLED AT THE LESSER OF THE TWO CURVE SPACINGS.

LANE MARKER NOTES


- A. USE DOUBLE LANE LINE MARKERS SPACED AS SHOWN.
- B. REDUCE TO 40' (12 m) O.C. ON CURVES WHERE ADVISORY SPEEDS ARE 10 M.P.H (20 km/h) LOWER THAN POSTED SPEEDS.

SYMBOLS

- YELLOW STRIPE
- WHITE STRIPE
- ◀ ONE-WAY AMBER MARKER
- ◁ ONE-WAY CRYSTAL MARKER (W/O)
- ◆ TWO-WAY AMBER MARKER

DESIGN NOTES

1. DOUBLE LANE LINE MARKERS SHALL BE USED UNLESS SPECIFIED OTHERWISE.
2. EXCEPT AS SHOWN ON THE LANE REDUCTION TRANSITION AND FREEWAY EXIT RAMP DETAIL, MARKERS ARE NOT TO BE SPECIFIED ON RIGHT EDGE LINES.
3. THE EXACT MARKER LIMITS, SPACING, AND COLOR SHALL BE INCLUDED IN THE PLANS WHEN STANDARD SPECIFICATIONS ARE NOT BEING USED.
4. MARKERS SHOULD NOT BE USED ALONGSIDE CURBS EXCEPT FOR EXTREMELY SHORT SECTIONS OF CURBS WHERE NOT MORE THAN TWO MARKERS WOULD BE INVOLVED.

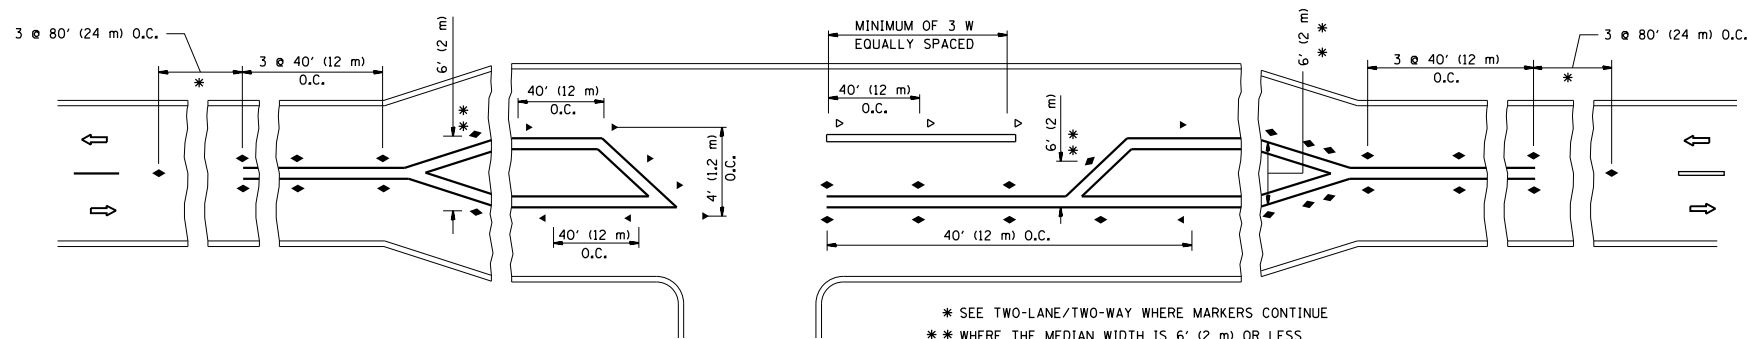

LEFT TURN

\* SEE TWO-LANE/TWO-WAY WHERE MARKERS CONTINUE  
 \*\* WHERE THE MEDIAN WIDTH IS 6' (2 m) OR LESS USE TWO-WAY MARKERS.

All dimensions are in inches (millimeters) unless otherwise shown.


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| FILE NAME =  | USER NAME = PencePL | DESIGNED - | REVISED - T. RAMMACHER 09-19-94 |
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|  |                     | DATE -     | REVISED - T. RAMMACHER 01-06-00 |
|  |                     |            | REVISED - C. JUCIUS 09-09-09    |

STATE OF ILLINOIS  
 DEPARTMENT OF TRANSPORTATION


TYPICAL APPLICATIONS  
 RAISED REFLECTIVE PAVEMENT MARKERS (SNOW-PLOW RESISTANT)

SCALE: NONE SHEET NO. 1 OF 1 SHEETS STA. TO STA.


|   |                 |                    |              |           |
|---|-----------------|--------------------|--------------|-----------|
| F.A.P. RTE.                                     | SECTION         | COUNTY             | TOTAL SHEETS | SHEET NO. |
| 339   | 116Y(1&2)R-RS-6 | COOK               | 58           | 52        |
| TC-11   |                 | CONTRACT NO. 62C93 |              |           |
| FED. ROAD DIST. NO. 1 ILLINOIS FED. AID PROJECT |                 |                    |              |           |

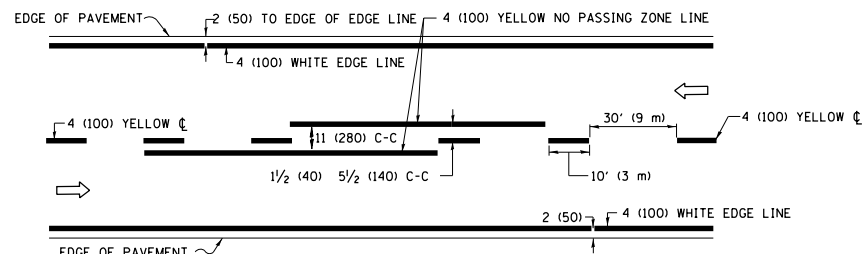

**2-LANE ROADWAY**

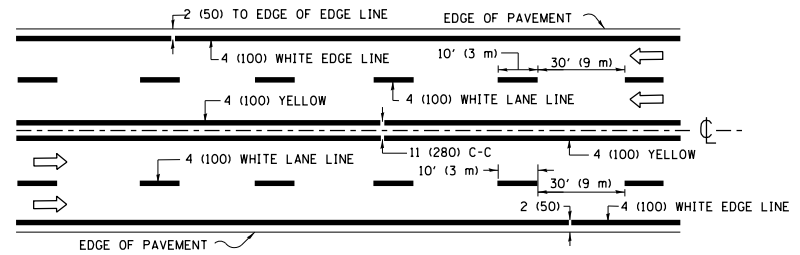


**MULTI-LANE UNDIVIDED**

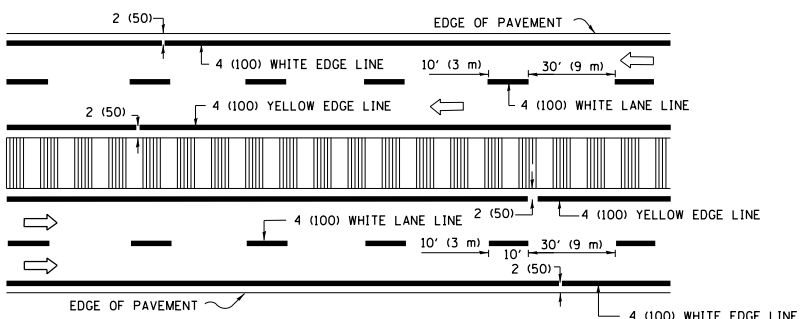


**MULTI-LANE DIVIDED WITH MEDIAN**

**TYPICAL LANE AND EDGE LINE MARKING**

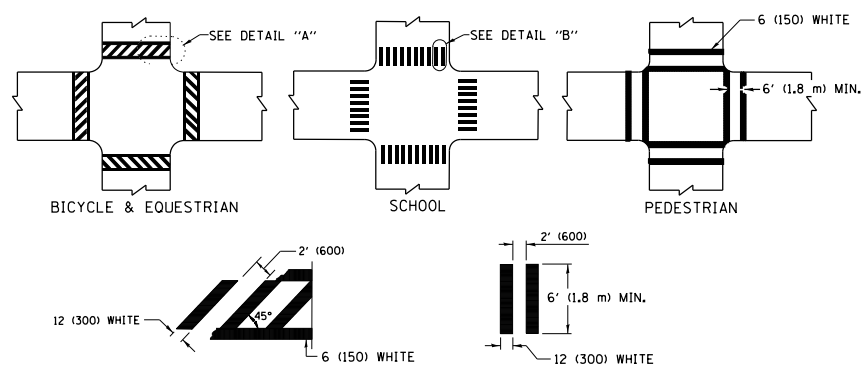


**TYPICAL CROSSWALK MARKING**

\* MARKINGS SHALL BE INSTALLED PARALLEL TO THE CENTERLINE OF THE ROAD WHICH IT CROSSES

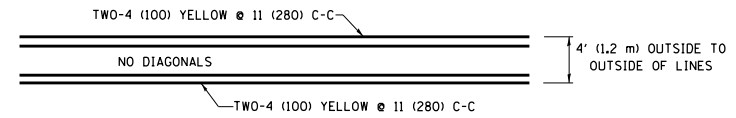


**4' (1.2 m) WIDE MEDIANS ONLY**

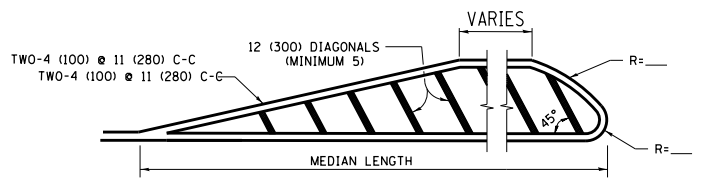


**MEDIANS OVER 4' (1.2 m) WIDE**

DIAGONAL LINE SPACING: 50' (15 m) C-C (LESS THAN 30MPH (50 km/h))  
75' (25 m) C-C 30MPH (50 km/h) TO 45MPH (70 km/h)  
150' (45 m) C-C (MORE THAN 45MPH (70 km/h))

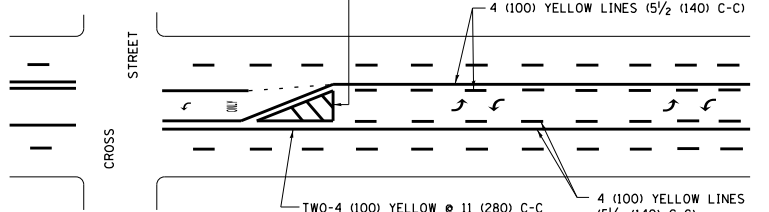


**MEDIAN WITH TWO-WAY LEFT TURN LANE  
TYPICAL PAINTED MEDIAN MARKING**

A MINIMUM OF TWO PAIRS OF TURN ARROWS SHALL BE USED, WHITE IN COLOR. ADDITIONAL PAIRS SHALL BE PLACED AT 200' (60 m) TO 300' (90 m) INTERVALS.

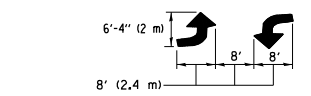


**TYPICAL LEFT (OR RIGHT) TURN LANE  
TYPICAL TURN LANE MARKING**


FULL SIZE LETTERS 8" (2.4 m) AND ARROWS SHALL BE USED.  
AREA = 15.6 SQ. FT. (1.5 m<sup>2</sup>) ONLY AREA = 20.8 SQ. FT. (1.9 m<sup>2</sup>)  
\* TURN LANES IN EXCESS OF 400' (120 m) IN LENGTH MAY HAVE AN ADDITIONAL SET OF ARROW - "ONLY" INSTALLED MIDWAY BETWEEN THE OTHER TWO SETS OF ARROW - "ONLY".

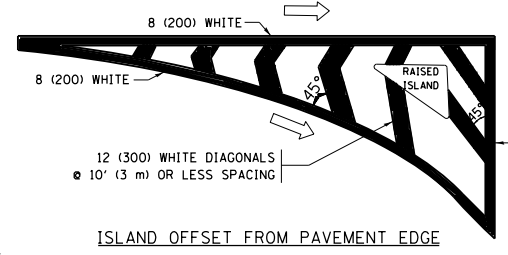


**ISLAND OFFSET FROM PAVEMENT EDGE**

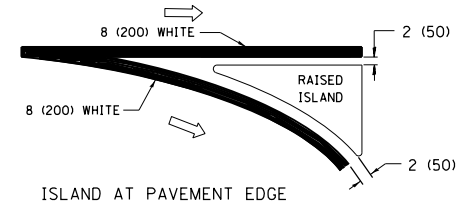

**ISLAND AT PAVEMENT EDGE  
TYPICAL ISLAND MARKING**

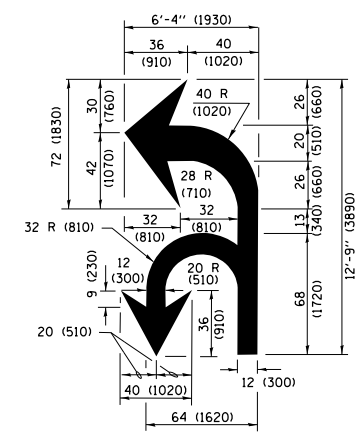

**COMBINATION LEFT AND U-TURN**

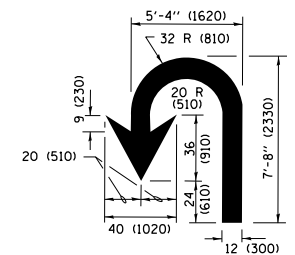

**U-TURN**

**LANE REDUCTION TRANSITION**

\* LANE REDUCTION ARROWS REQUIRED AT SPEEDS OF 45 MPH OR GREATER OR WHEN SPECIFIED IN PLANS.

| D(FT) | SPEED LIMIT |
|-------|-------------|
| 345   | 30          |
| 425   | 35          |
| 500   | 40          |
| 580   | 45          |
| 665   | 50          |
| 750   | 55          |

| TYPE OF MARKING   | WIDTH OF LINE  | PATTERN                      | COLOR   | SPACING /REMARKS  |
|---|--|------------------------------|---|---|
| CENTERLINE ON 2 LANE PAVEMENT   | 4 (100)  | SKIP-DASH                    | YELLOW  | 10' (3 m) LINE WITH 30' (9 m) SPACE   |
| CENTERLINE ON MULTI-LANE UNDIVIDED PAVEMENT   | 2 @ 4 (100)  | SOLID                        | YELLOW  | 11 (280) C-C  |
| NO PASSING ZONE LINES FOR ONE DIRECTION FOR BOTH DIRECTIONS                                       | 4 (100)<br>2 @ 4 (100)   | SOLID<br>SOLID               | YELLOW<br>YELLOW  | 5 1/2 (140) C-C FROM SKIP-DASH CENTERLINE<br>11 (280) C-C<br>OMIT SKIP-DASH CENTERLINE BETWEEN  |
| LANE LINES  | 4 (100)<br>5 (125) ON FREEWAYS   | SKIP-DASH<br>SKIP-DASH       | WHITE<br>WHITE  | 10' (3 m) LINE WITH 30' (9 m) SPACE   |
| DOTTED LINES (EXTENSIONS OF CENTER, LANE OR TURN LANE MARKINGS)                                   | SAME AS LINE BEING EXTENDED  | SKIP-DASH                    | SAME AS LINE BEING EXTENDED                             | 2' (600) LINE WITH 6' (1.8 m) SPACE   |
| EDGE LINES  | 4 (100)  | SOLID                        | YELLOW-LEFT<br>WHITE-RIGHT                              | OUTLINE MEDIANS IN YELLOW   |
| TURN LANE MARKINGS  | 6 (150) LINE; FULL SIZE LETTERS & SYMBOLS (8' (2.4m))                                      | SOLID                        | WHITE   | SEE TYPICAL TURN LANE MARKING DETAIL  |
| TWO WAY LEFT TURN MARKING   | 2 @ 4 (100) EACH DIRECTION<br>8' (2.4m) LEFT ARROW   | SKIP-DASH AND SOLID IN PAIRS | YELLOW<br>WHITE   | 10' (3 m) LINE WITH 30' (9 m) SPACE FOR SKIP-DASH; 5 1/2 (140) C-C BETWEEN SOLID LINE AND SKIP-DASH LINE<br>SEE TYPICAL TWO-WAY LEFT TURN MARKING DETAIL            |
| CROSSWALK LINES (PEDESTRIAN)<br>A. DIAGONALS (BIKE & EQUESTRIAN)<br>B. LONGITUDINAL BARS (SCHOOL) | 2 @ 6 (150)<br>12 (300) @ 45°<br>12 (300) @ 90°  | SOLID<br>SOLID<br>SOLID      | WHITE<br>WHITE<br>WHITE                                 | NOT LESS THAN 6' (1.8 m) APART<br>2' (600) APART<br>2' (600) APART<br>SEE TYPICAL CROSSWALK MARKING DETAILS.  |
| STOP LINES  | 24 (600)   | SOLID                        | WHITE   | PLACE 4' (1.2 m) IN ADVANCE OF AND PARALLEL TO CROSSWALK, IF PRESENT, OTHERWISE, PLACE AT DESIRED STOPPING POINT, PARALLEL TO CROSSROAD CENTERLINE, WHERE POSSIBLE. |
| PAINTED MEDIANS   | 2 @ 4 (100) WITH 12 (300) DIAGONALS @ 45°<br>NO DIAGONALS USED FOR 4' (1.2 m) WIDE MEDIANS | SOLID                        | YELLOW;<br>TWO WAY TRAFFIC<br>WHITE;<br>ONE WAY TRAFFIC | 11 (280) C-C FOR THE DOUBLE LINE<br>SEE TYPICAL PAINTED MEDIAN MARKING.   |
| GORE MARKING AND CHANNELIZING LINES   | 8 (200) WITH 12 (300) DIAGONALS @ 45°  | SOLID                        | WHITE   | DIAGONALS:<br>15' (4.5 m) C-C (LESS THAN 30MPH (50 km/h))<br>20' (6 m) C-C 30MPH (50 km/h) TO 45MPH (70 km/h)<br>30' (9 m) C-C (OVER 45MPH (70 km/h))               |
| RAILROAD CROSSING   | 24 (600) TRANSVERSE LINES; "RR" IS 6' (1.8 m) LETTERS; 16 (400) LINE FOR "X"               | SOLID                        | WHITE   | SEE STATE STANDARD 780001<br>AREA OF:<br>"R"=3.6 SQ. FT. (0.33 m <sup>2</sup> ) EACH<br>"X"=54.0 SQ. FT. (5.0 m <sup>2</sup> )                                      |
| SHOULDER DIAGONALS (REQUIRED FOR SHOULDERS ≥ 8')  | 12 (300) @ 45°   | SOLID                        | WHITE - RIGHT<br>YELLOW - LEFT                          | 50' (15 m) C-C (LESS THAN 30MPH (50 km/h))<br>75' (25 m) C-C (30 MPH (50 km/h) TO 45MPH (70 km/h))<br>150' (45 m) C-C (OVER 45MPH (70 km/h))                        |
| U TURN ARROW  | SEE DETAIL   | SOLID                        | WHITE   | 16.3 SF   |
| 2 ARROW COMBINATION LEFT AND U TURN   | SEE DETAIL   | SOLID                        | WHITE   | 30.4 SF   |

FOR FURTHER DETAILS ON PAVEMENT MARKING REFER TO STANDARD SPECIFICATIONS FOR ROAD AND BRIDGE CONSTRUCTION AND STATE STANDARD 780001.

All dimensions are in inches (millimeters) unless otherwise shown.

|  |                              |                  |                              |
|--|------------------------------|------------------|------------------------------|
| FILE NAME =  | USER NAME = PencePL          | DESIGNED - EVERS | REVISED - C. JUCIUS 09-09-09 |
| pw\1\084EBIDINTEG\11\inois.gov\PIWIDOT\Documents\DOT Offices\District 1\Projects\0141\0RAM\ta\Design\Diststd.dgn |                              | CHECKED -        | REVISED - C. JUCIUS 07-01-13 |
| Default  | PLOT SCALE = 100.0000' / in. | DATE - 03-19-90  | REVISED - C. JUCIUS 12-21-15 |
|  | PLOT DATE = 2/4/2017         |                  | REVISED - C. JUCIUS 04-12-16 |


**STATE OF ILLINOIS  
DEPARTMENT OF TRANSPORTATION**

**DISTRICT ONE  
TYPICAL PAVEMENT MARKINGS**

SCALE: NONE SHEET 1 OF 1 SHEETS STA. TO STA.


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|---------------------------|-----------------|---------------------|--------------|-----------|
| F.A.P. RTE.               | SECTION         | COUNTY              | TOTAL SHEETS | SHEET NO. |
| 339                       | 116Y(1&2)R-RS-6 | COOK                | 58           | 53        |
| <b>TC-13</b>              |                 | <b>CONTRACT NO.</b> | <b>62C93</b> |           |
| ILLINOIS FED. AID PROJECT |                 |                     |              |           |

# TURN BAY ENTRANCE AT START OF LANE CLOSURE TAPER

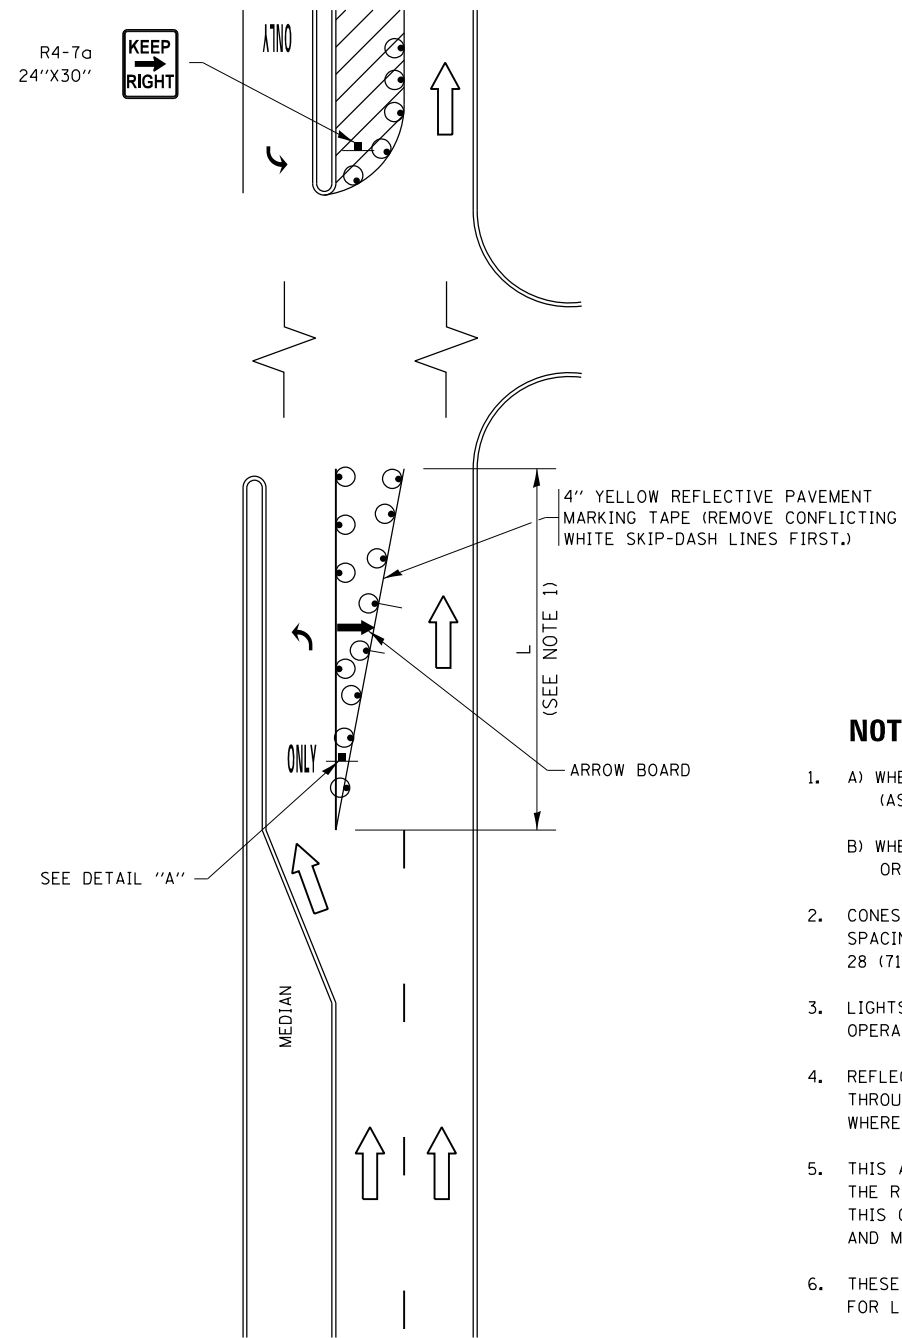


**FIGURE 1**

# TURN BAY ENTRANCE WITHIN A LANE CLOSURE

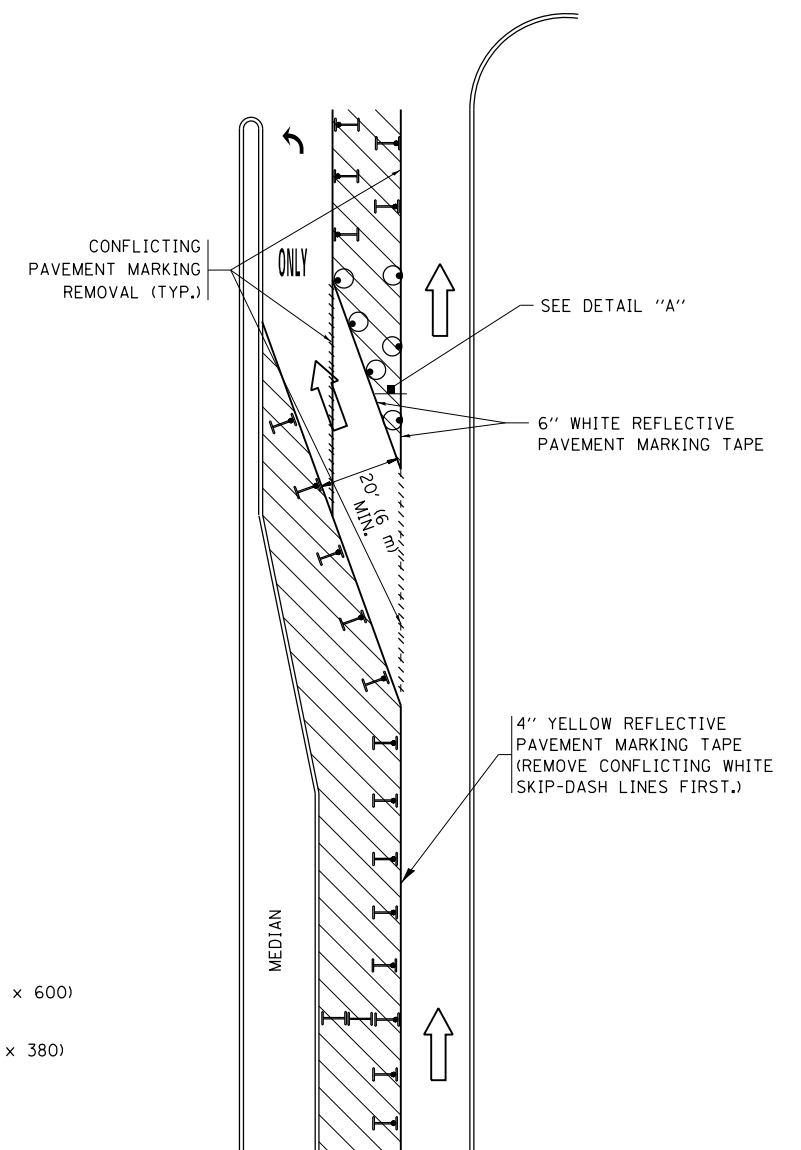


**FIGURE 2**

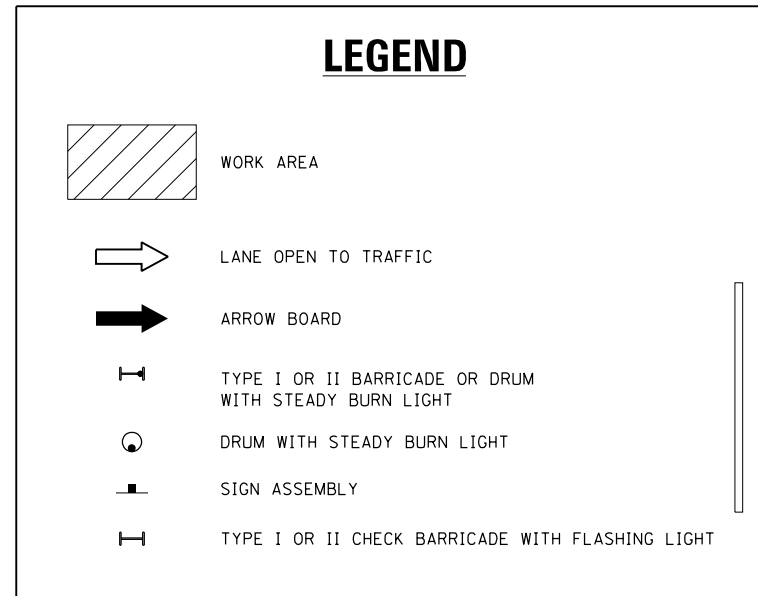

### NOTES:

1. A) WHEN "L" IS  $\leq$  THE STORAGE LENGTH OF THE TURN LANE (AS SHOWN IN FIG. 1), USE FIGURE 1.  
B) WHEN "L" IS  $>$  THE STORAGE LENGTH OF THE TURN LANE OR THE TURN LANE IS WITHIN THE LANE CLOSURE, USE FIGURE 2.
2. CONES MAY BE SUBSTITUTED FOR BARRICADES OR DRUMS AT HALF THE SPACING DURING DAY OPERATIONS. CONES SHALL BE A MINIMUM OF 28 (710) IN HEIGHT.
3. LIGHTS WILL NOT BE REQUIRED ON BARRICADES OR DRUMS FOR DAY OPERATIONS. ALL LIGHTS SHALL BE MONODIRECTIONAL.
4. REFLECTIVE TEMPORARY PAVEMENT MARKINGS SHALL BE PLACED THROUGHOUT THE BARRICADED AREAS OF EACH TURN BAY AS SHOWN WHERE THE CLOSURE TIME IS GREATER THAN FOURTEEN (14) DAYS.
5. THIS APPLICATION ALSO APPLIES WHEN WORK IS BEING PERFORMED IN THE RIGHT LANE(S) AND THE RIGHT TURN BAY IS TO REMAIN OPEN. UNDER THIS CONDITION, "RIGHT TURN LANE" R3-1100R 24 x 24 (600 x 600) AND M6-2R 21 x 15 (530 x 380) SHALL BE USED.
6. THESE CONTROLS SHALL SUPPLEMENT MAINLINE TRAFFIC CONTROL FOR LANE CLOSURES.
7. THE SIGNS SHALL BE MOUNTED ABOVE THE BARRICADES/DRUMS ON SEPARATE SIGN SUPPORTS THAT MEET NCHRP 350 OR MASH PREQUIREMENTS.
8. TRAFFIC CONTROL AND PROTECTION AT TURN BAYS (TO REMAIN OPEN TO TRAFFIC) SHALL BE INCLUDED IN THE COST OF SPECIFIED TRAFFIC CONTROL STANDARDS OR ITEMS.

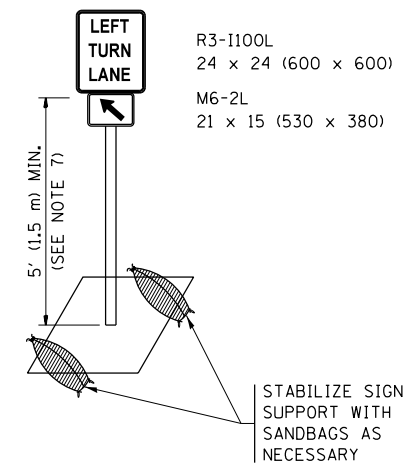


**DETAIL A**



All dimensions are in inches (millimeters) unless otherwise shown.

|   |                              |                                 |                                |   |  |               |                 |                           |              |              |
|---|------------------------------|---------------------------------|--------------------------------|---|--|---------------|-----------------|---------------------------|--------------|--------------|
| FILE NAME =   | USER NAME = PencePL          | REVISED - T. RAMMACHER 09-08-94 | REVISED - R. BORO 09-14-09     | <b>STATE OF ILLINOIS<br/>DEPARTMENT OF TRANSPORTATION</b> | <b>TRAFFIC CONTROL AND PROTECTION AT TURN BAYS<br/>(TO REMAIN OPEN TO TRAFFIC)</b> | F.A.P. R.T.E. | SECTION         | COUNTY                    | TOTAL SHEETS | SHEET NO.    |
| pw\1\084EBIDINTEG.illinois.gov\PIWIDOT\Documents\IDOT Offices\District 1\Projects\0141\REVISED\Design\A HOUSEH 11-07-95 | REVISED - A. HOUSEH 11-07-95 | REVISED - A. SCHUETZE 07-01-13  | REVISED - A. SCHUETZE 07-01-13 |   |  | 339           | 116Y(1&2)R-RS-6 | COOK                      | 58           | 54           |
| Default   | PLOT SCALE = 100.0000' / in. | REVISED - A. HOUSEH 10-12-96    | REVISED - A. SCHUETZE 09-15-16 |   |  | <b>TC-14</b>  |                 | <b>CONTRACT NO. 62C93</b> |              |              |
|   | PLOT DATE = 2/4/2017         | REVISED - T. RAMMACHER 01-06-00 | REVISED -                      |   |  | SCALE: NONE   |                 | SHEET 1 OF 1 SHEETS       |              | STA. TO STA. |


ILLINOIS FED. AID PROJECT

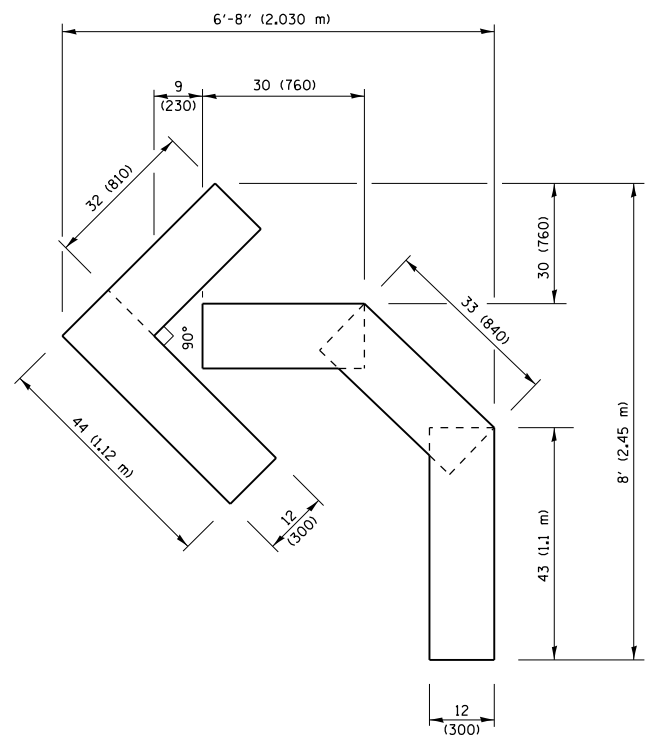

**QUANTITY**  
 4 (100) LINE = 45.5 ft. (13.9 m)  
 15.2 sq. ft. (1.41 sq. m)

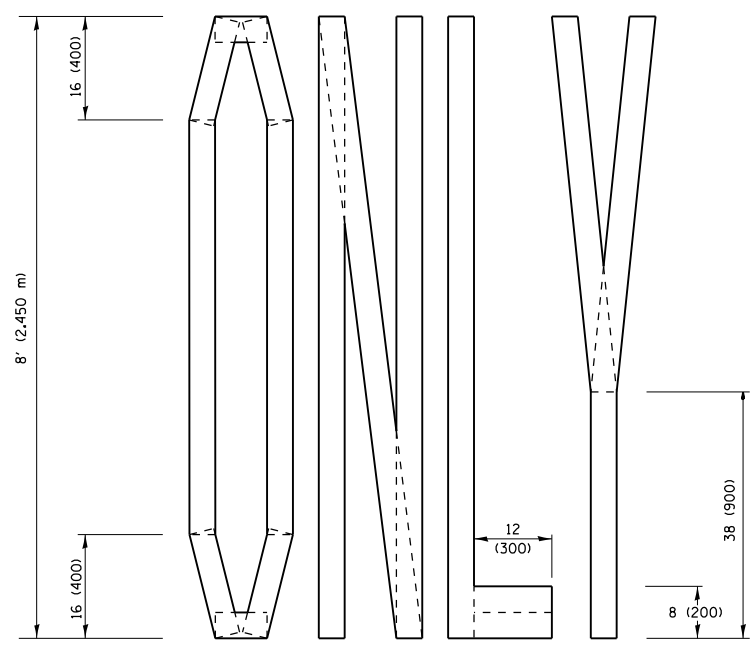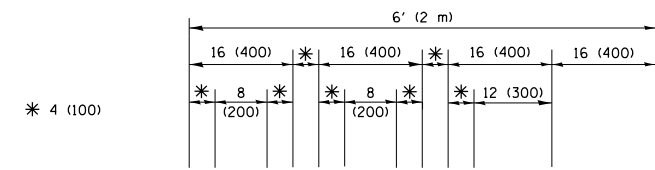


**QUANTITY**  
 4 (100) LINE = 64.1 ft. (19.5 m)  
 21.4 sq. ft. (1.99 sq. m)

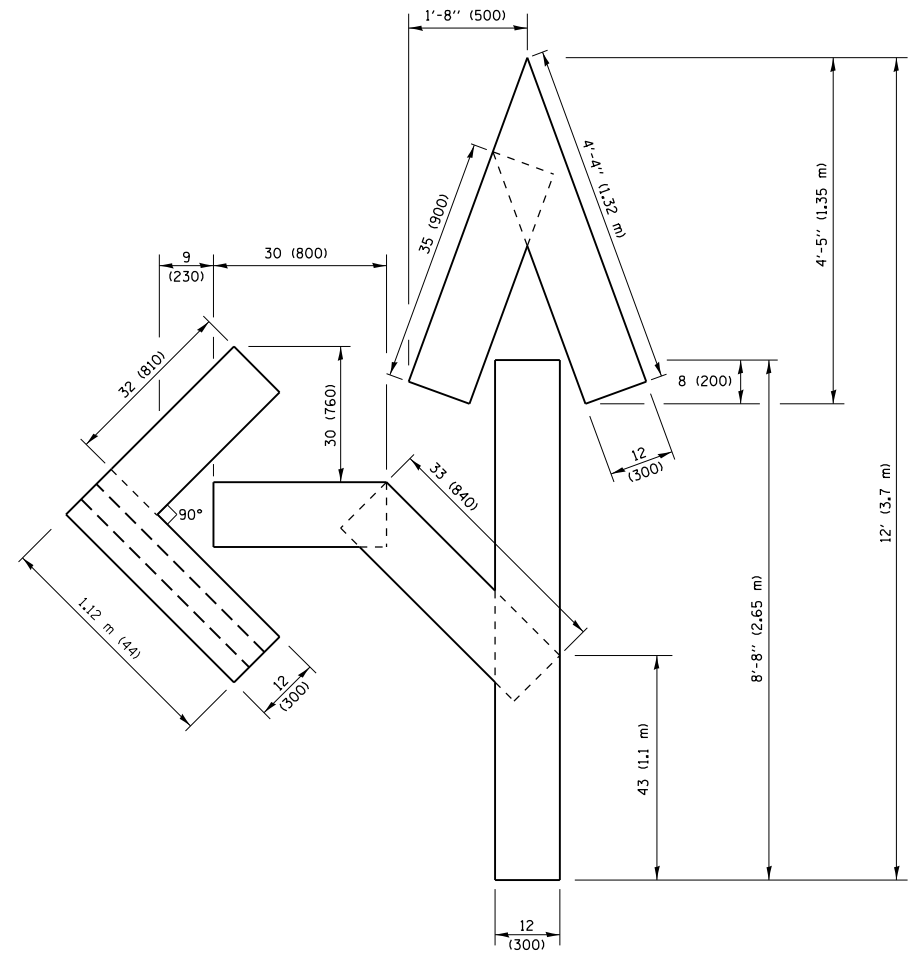

**QUANTITY**  
 4 (100) LINE = 82.5 ft. (25.1 m)  
 27.5 sq. ft. (2.53 sq. m)

**NOTE:**  
 ALL QUANTITIES OF PLACEMENT ARE REPRESENTED IN LINEAR FEET OF 4" LINES TO MATCH THE 4" TEMPORARY TAPE PAY ITEM AND REPRESENTS THE TOTAL QUANTITY OF 4" TAPE REQUIRED.

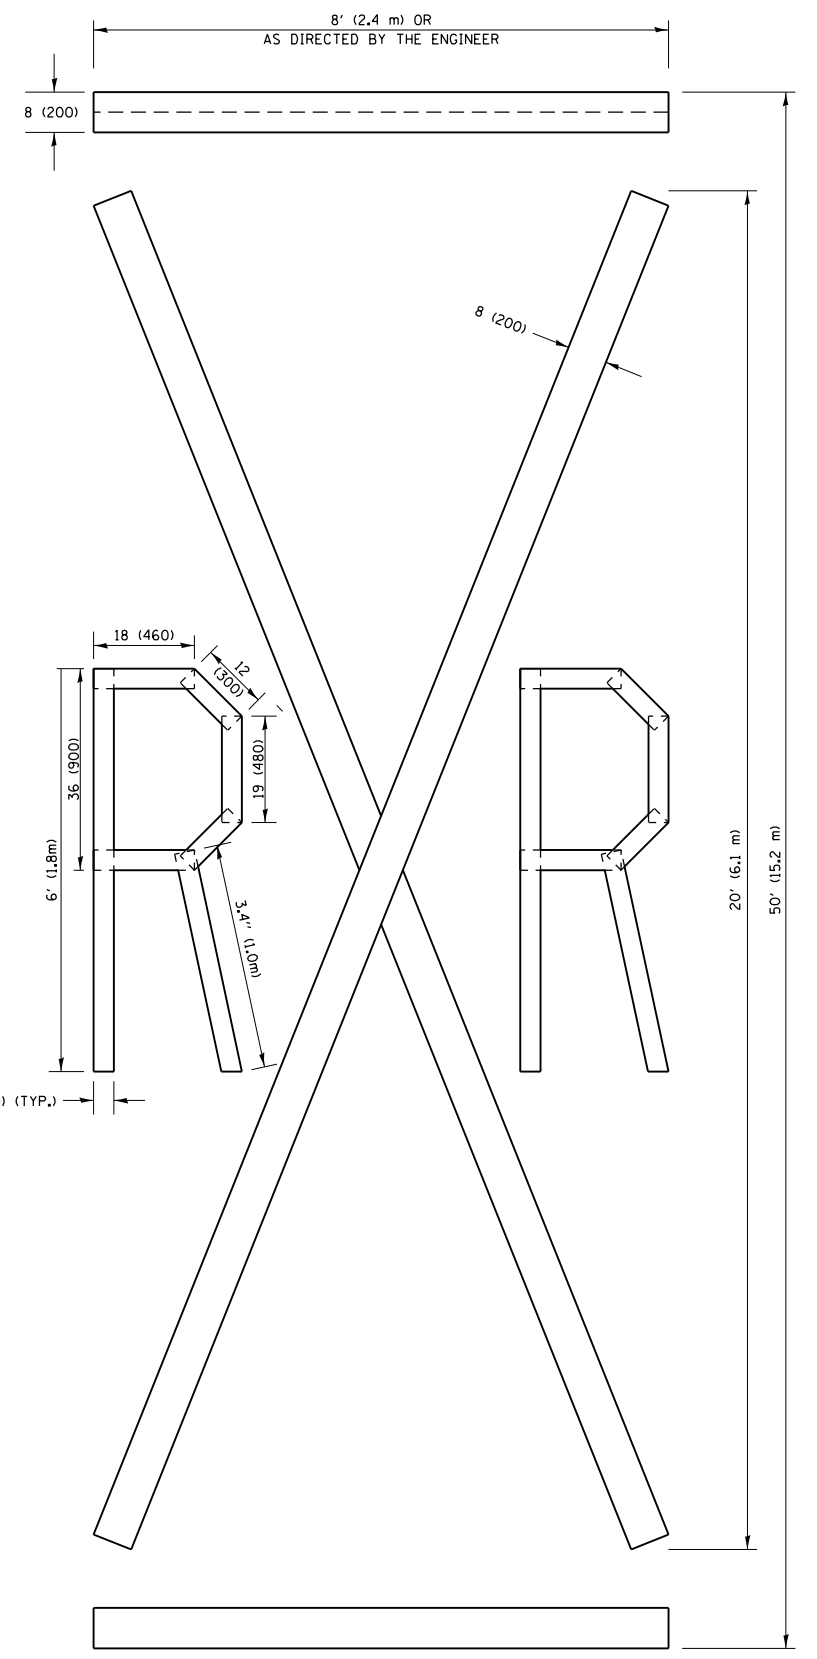

**QUANTITY**  
 4 (100) LINE = 225.9 ft. (68.9 m)  
 75.3 sq. ft. (6.99 sq. m)


All dimensions are in inches (millimeters) unless otherwise shown.

|  |                     |                 |                                 |
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| p:\1\1084EBIDINTEG\illinois.gov\PIWIDOT\Documents\IDOT Offices\District 1\Projects\0141\RAMMach\Design\Diststd.dgn |                     | CHECKED -       | REVISED - E. GOMEZ 08-28-00     |
|  |                     | DATE - 09-18-94 | REVISED - E. GOMEZ 08-28-00     |
|  |                     |                 | REVISED - A. SCHUETZE 09-15-16  |

**STATE OF ILLINOIS  
 DEPARTMENT OF TRANSPORTATION**

|  |                         |      |         |
|--|-------------------------|------|---------|
| <b>SHORT TERM PAVEMENT MARKING LETTERS AND SYMBOLS</b> |                         |      |         |
| SCALE: NONE  | SHEET NO. 1 OF 1 SHEETS | STA. | TO STA. |

|   |                 |                           |              |           |
|---|-----------------|---------------------------|--------------|-----------|
| F.A.P. RTE.                                     | SECTION         | COUNTY                    | TOTAL SHEETS | SHEET NO. |
| 339   | 116Y(1&2)R-RS-6 | COOK                      | 58           | 55        |
| <b>TC-16</b>                                    |                 | <b>CONTRACT NO. 62C93</b> |              |           |
| FED. ROAD DIST. NO. 1 ILLINOIS FED. AID PROJECT |                 |                           |              |           |

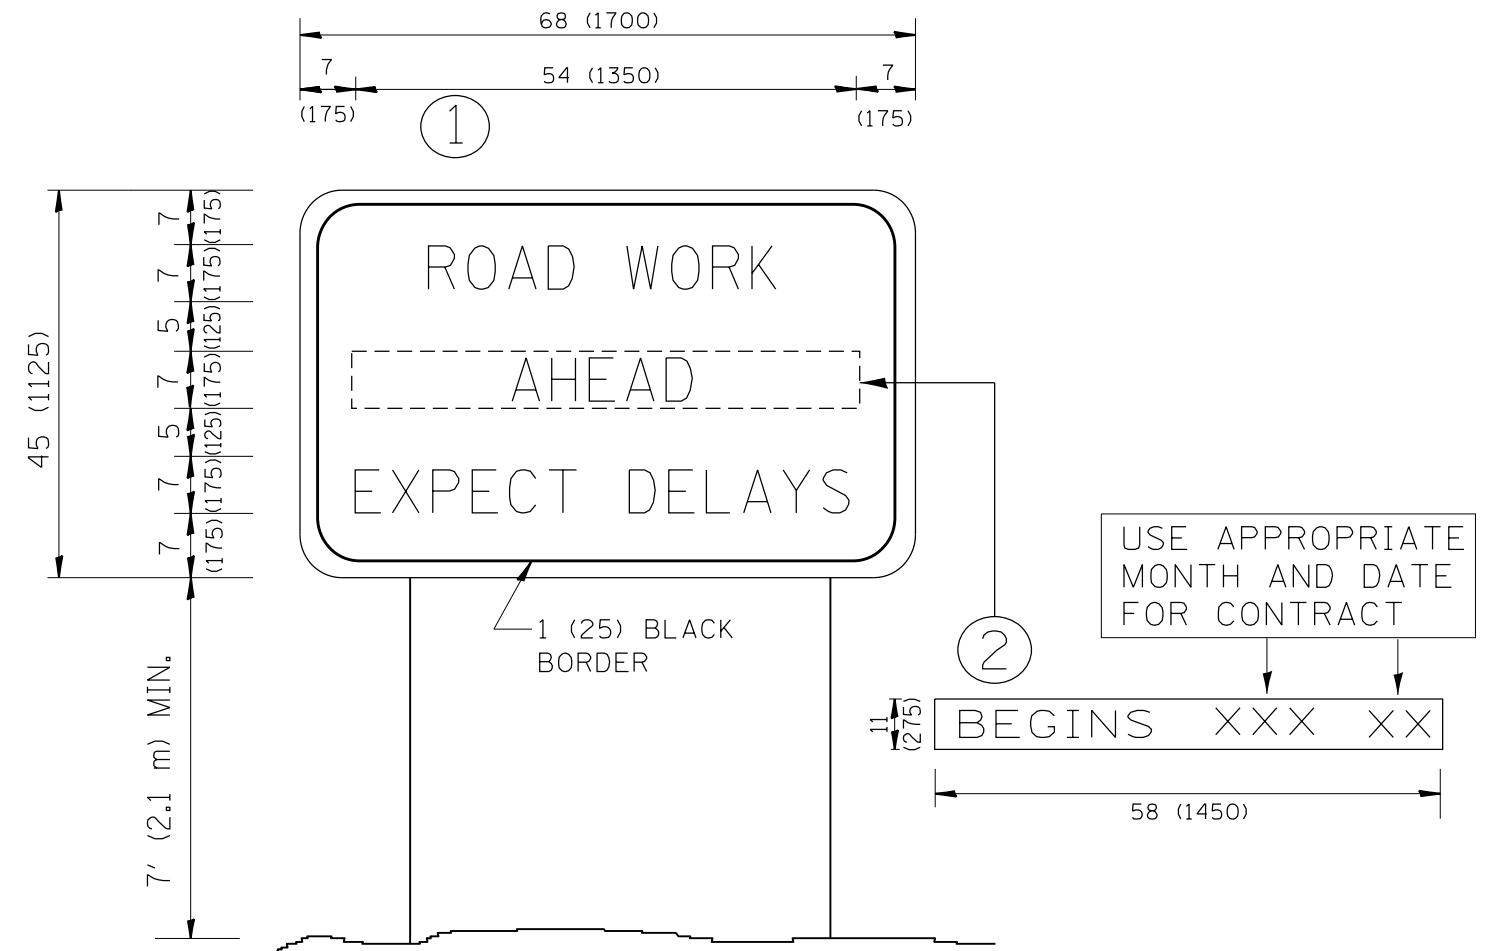

**NOTES:**

1. USE BLACK LETTERING ON ORANGE BACKGROUND.
2. ERECT SIGNS IN ADVANCE OF THE LOCATION FOR THE "ROAD CONSTRUCTION AHEAD" SIGN AT LOCATIONS AS DIRECTED BY THE ENGINEER.
3. ERECT SIGN ① WITH INSTALLED PANEL ② ONE WEEK PRIOR TO THE START OF CONSTRUCTION.
4. REMOVE PANEL ② SOON AFTER THE START OF CONSTRUCTION.
5. SEE SPECIAL PROVISION FOR "TEMPORARY INFORMATION SIGNING" FOR ADDITIONAL INFORMATION.
6. ONE SIGN ASSEMBLY EQUALS 25.70 SQ. FT. (2.3 SQ. M.)
7. SHALL BE PAID FOR AS TEMPORARY INFORMATION SIGNING.


ALL DIMENSIONS ARE IN INCHES (MILLIMETERS) UNLESS OTHERWISE SHOWN.

|  |                     |            |                                 |   |   |              |                         |                           |              |   |
|--|---------------------|------------|---------------------------------|---|---|--------------|-------------------------|---------------------------|--------------|---|
| FILE NAME =  | USER NAME = PencePL | DESIGNED - | REVISED - R. MIRS 09-15-97      | <b>STATE OF ILLINOIS<br/>DEPARTMENT OF TRANSPORTATION</b> | <b>ARTERIAL ROAD<br/>INFORMATION SIGN</b> | F.A.P. RTE.  | SECTION                 | COUNTY                    | TOTAL SHEETS | SHEET NO.   |
| pw\11084EBIDINTEG.illinois.gov\PIWIDOT\Documents\DOT Offices\District 1\Projects\141\ORAN\Design\Diststd.dgn |                     | CHECKED -  | REVISED - R. MIRS 12-11-97      |   |   | 339          | 116Y(1&2)R-RS-6         | COOK                      | 58           | 56  |
| PLOT SCALE = 100.0000' / 1in.  |                     | DATE -     | REVISED - T. RAMMACHER 02-02-99 |   |   | <b>TC-22</b> |                         | <b>CONTRACT NO. 62C93</b> |              |   |
| PLOT DATE = 2/4/2017   |                     |            | REVISED - C. JUCIUS 01-31-07    |   |   | SCALE: NONE  | SHEET NO. 1 OF 1 SHEETS | STA.                      | TO STA.      | FED. ROAD DIST. NO. 1   ILLINOIS   FED. AID PROJECT |




**LOOP DETECTOR NOTES**

1. EACH PAIR OF LOOP WIRES SHALL BE PLACED IN A SEPARATE EMPTY COILABLE NONMETALLIC CONDUIT FROM THE EDGE OF PAVEMENT TO THE HANDHOLE. SPACING BETWEEN THE HOLES DRILLED IN THE PAVEMENT SHALL NOT BE LESS THAN 6" (150 mm). EMPTY COILABLE NONMETALLIC CONDUIT SHALL BE INCLUDED IN THE COST OF THE LOOP WIRE.
2. THE NUMBER OF LOOP TURNS SHALL BE AS RECOMMENDED BY THE AMPLIFIER MANUFACTURER. ALL ADJACENT SIDES OF THE LOOPS SHALL BE INSTALLED IN SUCH A WAY THAT THE CURRENT FLOW IS IN THE SAME DIRECTION TO REINFORCE ITS MAGNETIC FIELDS FOR SMALL VEHICLE DETECTION.
3. EACH LOOP LEAD-IN SHALL BE IDENTIFIED AND PERMANENTLY TAGGED IN THE HANDHOLE. EACH LEAD-IN CABLE TAG SHALL INDICATE THE LOCATION OF THE LOOP, LOOP ROTATION (CLOCKWISE/COUNTERCLOCKWISE), LOOP LEAD-IN DIRECTION (IN OR OUT), LOOP CABLE NUMBER AND LOCATION IN CABINET, AND NUMBER OF TURNS IN THE DETECTOR LOOPS IN WATER PROOF INK AS INDICATED ON THE DISTRICT 1 STANDARD TRAFFIC SIGNAL DESIGN DETAIL. THE CONTRACTOR SHALL MARK LOOP LOCATIONS ON RECORD DRAWINGS AND PRESENT TO THE ENGINEER AFTER FINAL INSPECTION. LOOPS SHALL BE MARKED BY LANE AND LOOP NUMBER. SEE DETAIL BELOW.
4. ALL LOOP CABLE SHALL BE FASTENED WITH PLASTIC TIE WRAP TO THE HANDHOLE HOOKS.
5. IN ASPHALT PAVEMENT, LOOPS SHOULD BE PLACED IN THE BINDER AND DIVEHOLES MARKED AT THE CURB WITH A SAW-CUT. THE SAW-CUT SHALL BE CUT IN ACCORDANCE WITH LOCAL AND E.P.A. DUST CONTROL REQUIREMENTS. DETECTOR LOOP(S) SHALL NOT BE INSTALLED IN WET CONDITIONS AND THE SAW-CUTS MUST BE FREE OF DEBRIS AND RESIDUE SUCH AS DUST AND WATER WHICH IS TO BE ACHIEVED BY THE USE OF COMPRESSED AIR, WIRE BRUSHING AND HEAT DRYING ACCORDING TO SEALANT MANUFACTURER REQUIREMENTS. THE DETECTOR WIRE SHALL BE HELD IN PLACE BY THE USE OF FORM WEDGES. WEDGES SHALL BE SPACED NO MORE THAN 18" (450 mm) APART.
6. LOOP SPLICES SHALL BE SOLDERED USING A SOLDERING IRON. BLOW TORCHES OR OTHER DEVICES WHICH OXIDIZE COPPER CABLE SHALL NOT BE ALLOWED FOR SOLDERING OPERATIONS. SEE DETAIL BELOW RIGHT.
7. PREFORMED DETECTOR LOOPS SHALL BE USED, AS SHOWN ON THE PLANS, WHERE NEW CONCRETE PAVEMENT IS PROPOSED. THE INSTALLATION OF PREFORMED LOOPS SHALL BE IN ACCORDANCE WITH THE DISTRICT 1 SPECIFICATIONS OR AS DIRECTED BY THE ENGINEER.

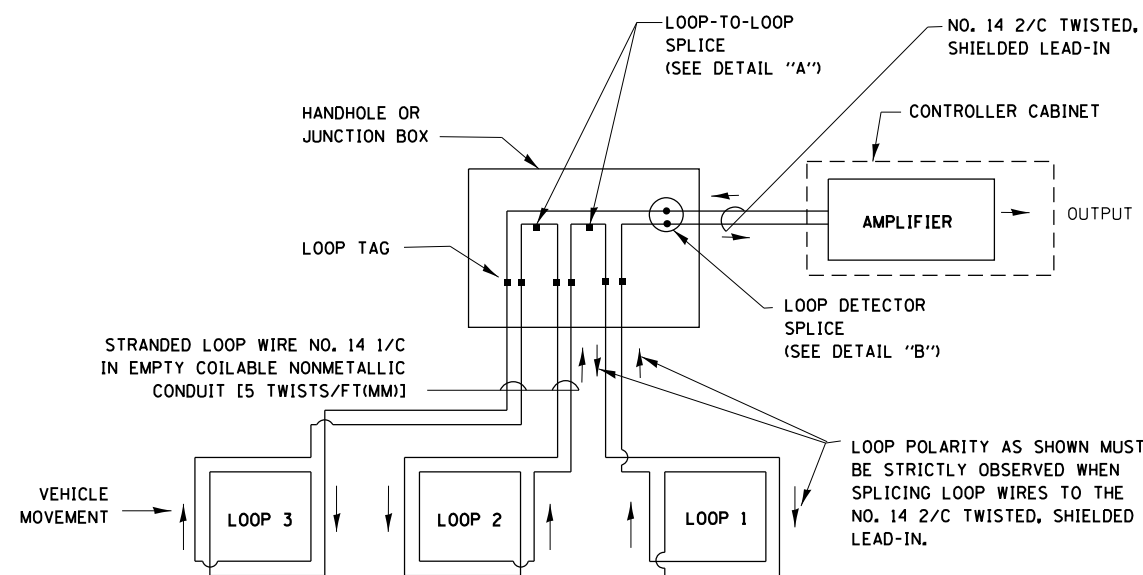


**DETECTOR LOOP WIRING SCHEMATIC**

- LOOPS SHALL BE SPLICED IN SERIES.
- SAW-CUTS SHALL BE A MINIMUM WIDTH OF 5/16" (8 mm).
- SAW-CUT DEPTHS SHALL BE 3" (75 mm). IF IN CONCRETE, THE SAW-CUT DEPTH SHALL BE TO THE TOP OF THE REINFORCEMENT.
- LOOP CORNERS SHALL BE DRILLED WITH A 2" (50 mm) DIAMETER CORE.

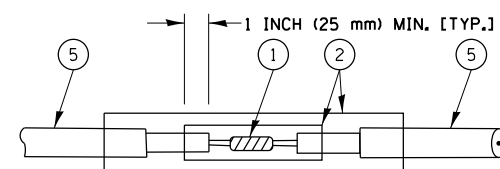


**DETAIL "A"  
LOOP-TO-LOOP SPLICE**

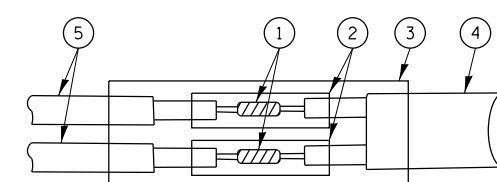


**DETAIL "B"  
LOOP-TO-CONTROLLER SPLICE**

**TYPE I LOOP**


**LOOP LEAD-IN CABLE TAG**

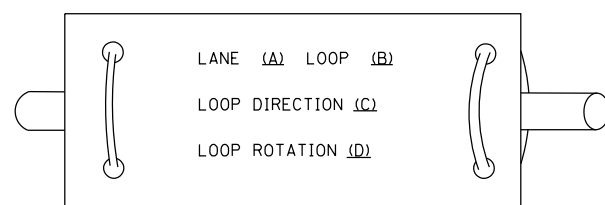

- A. LANE 1 IS THE LANE CLOSEST TO THE CENTERLINE OF THE ROADWAY
- B. LOOP #1 IS THE LOOP IN THE LANE CLOSEST TO THE INTERSECTION.
- C. LABEL LOOP CABLE "IN" OR LOOP CABLE "OUT".
- D. LABEL LOOP CABLE CLOCKWISE OR LOOP CABLE COUNTERCLOCKWISE.

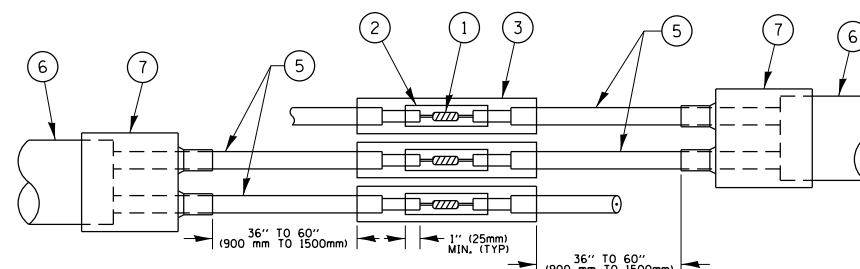

**DETAIL "A"  
LOOP-TO-LOOP SPLICE**

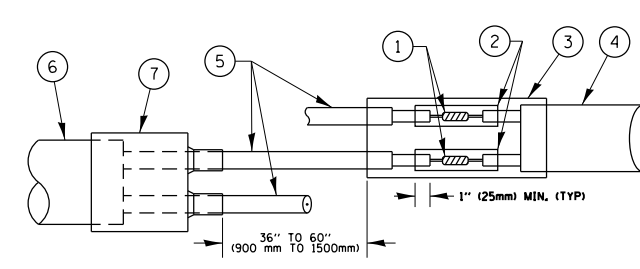

**DETAIL "B"  
LOOP-TO-CONTROLLER SPLICE**


**LOOP DETECTOR SPLICE**

- ① WESTERN UNION SPLICE SOLDERED WITH ROSIN CORE FLUX. ALL EXPOSED SURFACES OF THE SOLDER SHALL BE SMOOTH, THE WESTERN UNION SPLICES SHALL BE STAGGERED.
- ② WCSMW 30/100 HEAT SHRINK TUBE, MINIMUM LENGTH 3" (75 mm), UNDERWATER GRADE.
- ③ WCS 200/750 HEAT SHRINK TUBE, MINIMUM LENGTH 6" (150 mm), UNDERWATER GRADE.
- ④ NO. 14 2/C TWISTED, SHIELDED CABLE.
- ⑤ LOOP CONDUCTOR WITH FLEXIBLE PLASTIC TUBE.
- ⑥ PRE-FORMED LOOP
- ⑦ XL POLYOLEFIN 2 CONDUCTOR BREAKOUT SEALS, TYCO CBR-2 OR APPROVED EQUAL

|   |                              |            |           |   |  |              |                     |                           |              |                           |  |
|---|------------------------------|------------|-----------|---|--|--------------|---------------------|---------------------------|--------------|---------------------------|--|
| FILE NAME =   | USER NAME = PencePL          | DESIGNED - | REVISED - | <b>STATE OF ILLINOIS<br/>DEPARTMENT OF TRANSPORTATION</b> | <b>DISTRICT ONE<br/>STANDARD TRAFFIC SIGNAL DESIGN DETAILS</b> | F.A.P. RTE.  | SECTION             | COUNTY                    | TOTAL SHEETS | SHEET NO.                 |  |
| pw:\IL\084EBIDINTEG\illinois.gov\PIWIDOT\Documents\DOT Offices\District 1\Projects\0141\@RAM\eta\Design\Diststd.dgn | PLOT SCALE = 100.0000' / in. | CHECKED -  | REVISED - |   |  | 339          | 116Y(1&2)R-RS-6     | COOK                      | 58           | 57                        |  |
| Default   | PLOT DATE = 2/4/2017         | DATE -     | REVISED - |   |  | <b>TS-05</b> |                     | <b>CONTRACT NO. 62C93</b> |              | ILLINOIS FED. AID PROJECT |  |
|   |                              |            |           |   |  | SCALE: NONE  | SHEET 2 OF 7 SHEETS | STA. TO STA.              |              |                           |  |

**LOOPS NEXT TO SHOULDERS**

PROVIDE A PAVEMENT REPLACEMENT NOTE WHICH SHOULD EQUAL 3' (900 mm) X WIDTH OF PAVED SHOULDER.

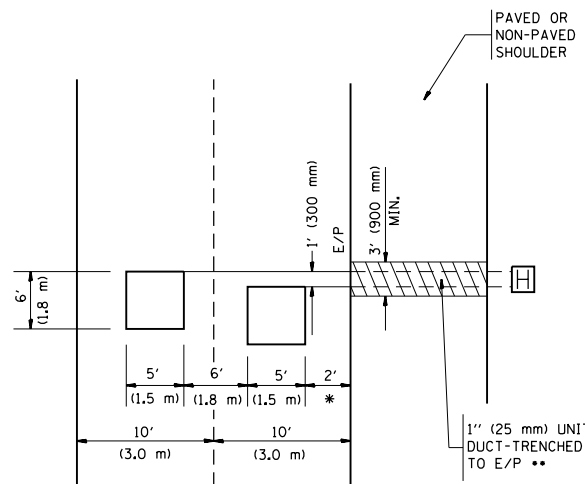


\* = (600 mm)

\*\* UNIT DUCT IS TO BE SHOWN ON PLAN SHEETS BUT SHALL NOT BE INCLUDED IN THE PAY ITEMS.

**LEFT TURN LANES WITH MEDIANS  
VOLUME DENSITY ("FAR OUT" DETECTION)  
ON SAME APPROACH**

(PROTECTED / PERMITTED LEFT TURN PHASING)

HANDHOLE LOCATION MAY VARY DEPENDING ON GEOMETRICS AND DESIGN OF TRAFFIC SIGNALS. HEAVY-DUTY HANDHOLES TO BE USED WHEN THE MEDIAN IS MOUNTABLE. REFER TO STANDARD 814001 TO ENSURE THAT HANDHOLE FITS IN MEDIAN.

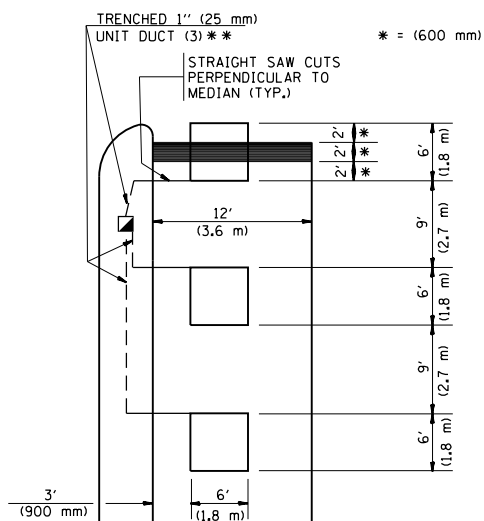


\*\* UNIT DUCT IS TO BE SHOWN ON PLAN SHEETS BUT SHALL NOT BE INCLUDED IN THE PAY ITEMS.

NOTE: DUAL LEFT TURNS NOT SHOWN REFER TO PLAN SHEET FOR DETECTOR LOOP REPLACEMENT


**LEFT TURN LANES WITHOUT MEDIANS  
VOLUME DENSITY ("FAR OUT" DETECTION)  
ON SAME APPROACH**

(PROTECTED / PERMITTED LEFT TURN PHASING)

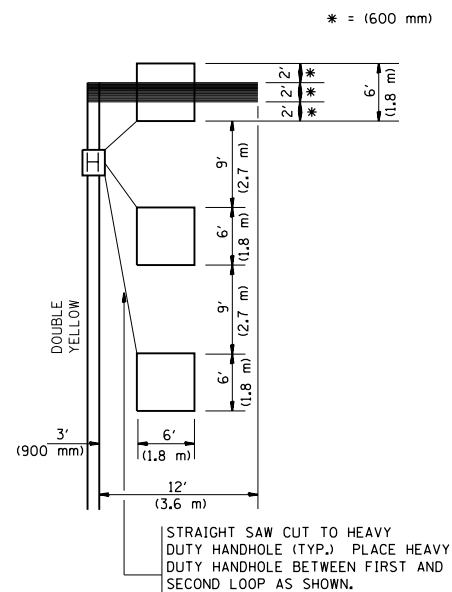


NOTE: DUAL LEFT TURNS NOT SHOWN REFER TO PLAN SHEET FOR DETECTOR LOOP REPLACEMENT

**ARTERIAL-VOLUME DENSITY ("FAR OUT" DETECTION)  
CROSS STREET-VOLUME DENSITY ("FAR OUT" DETECTION)**

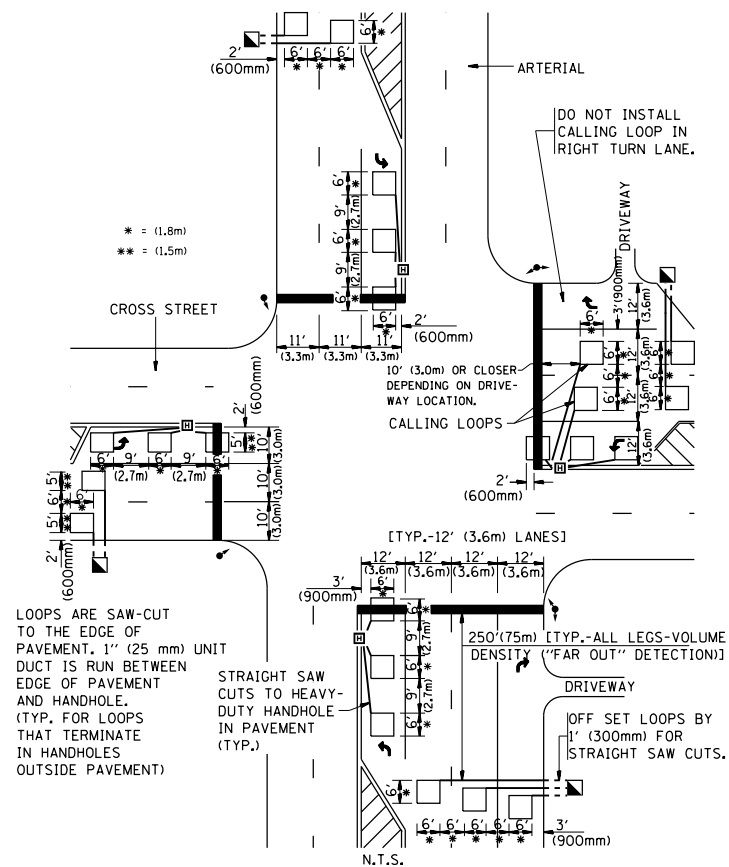

**DETAIL 1  
N.T.S.**

**ARTERIAL-VOLUME DENSITY ("FAR OUT" DETECTION)  
CROSS STREET-NON VOLUME DENSITY ("UPTIGHT" PRESENCE DETECTION)**

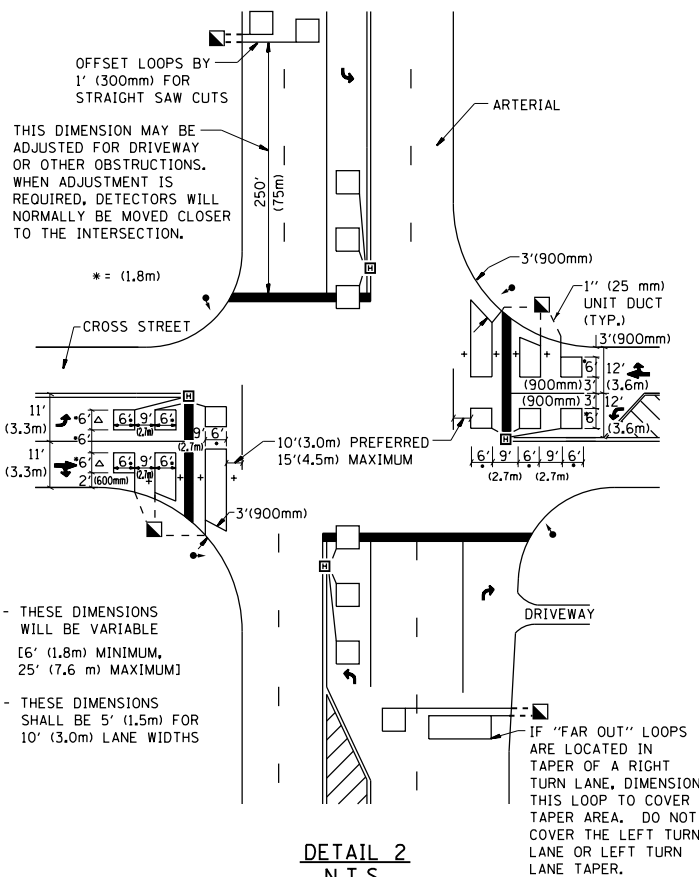

**DETAIL 2  
N.T.S.**

**NOTES:**

**VEHICLES LOOP DETECTORS**

- \* ALL LEAD IN CABLE SHALL BE TWO CONDUCTOR NO. 14 TWISTED, SHIELDED.
- \* EACH DETECTOR LOOP SHALL HAVE ITS OWN SAW CUT FROM THE LOOP TO THE EDGE OF PAVEMENT OR TO A HANDHOLE IN THE PAVEMENT.
- \* EACH DETECTOR LOOP SHALL HAVE ITS OWN ONE INCH (25 mm) UNIT DUCT BETWEEN THE EDGE OF PAVEMENT AND THE FIRST HANDHOLE OR JUNCTION BOX. EACH UNIT DUCT RUN SHALL BE SHOWN ON THE PLANS BY THE DESIGNER, BUT SHALL NOT BE PAID FOR SEPARATELY. THIS ITEM IS INCIDENTAL TO THE PAY ITEM FOR DETECTOR LOOPS.
- \* ONE DIMENSION OF ALL DETECTOR LOOPS SHALL BE SIX FEET (1.8 m)
- \* EACH LANE OF NON-LOCKING, PRESENCE DETECTION AND EACH LANE OF A DOUBLE LEFT TURN LANE REQUIRES A SEPARATE INDUCTIVE LOOP DETECTOR AND LEAD IN CABLE.
- \* WHEN NON-LOCKING, PRESENCE DETECTION IS USED, MORE THAN ONE LOOP PER LANE IS REQUIRED BEHIND THE STOP BAR (i.e. 1-1/2, 1-3/4, 2).
- \* WHEN SYSTEM LOOPS ARE REQUIRED ON AN APPROACH OF AN INTERSECTION, THE LOOPS USED FOR VOLUME DENSITY AND INTERSECTION TIMING SHALL ALSO BE USED AS SYSTEM DETECTORS. EACH ONE OF THESE TYPE OF LOOPS REQUIRES A SEPARATE TWO CONDUCTOR NO. 14 TWISTED SHIELDED CABLE AND A SEPARATE INDUCTIVE LOOP DETECTOR WHEN NEW CONTROLLERS ARE UTILIZED. THE DESIGNER SHALL LABEL THESE TYPES OF LOOPS AS "INTERSECTION AND SAMPLING (SYSTEM) DETECTORS" ON THE SIGNAL LAYOUT, THE INTERCONNECT PLAN AND THE SYSTEM CABLE PLAN. WHEN AN EXISTING CONTROLLER IS UTILIZED FOR THIS TYPE OF DETECTION, THE PAY ITEM "INDUCTIVE LOOP DETECTOR WITH SYSTEM OUTPUT" SHOULD BE USED.

**PLACEMENT OF DETECTORS**

THE FOLLOWING FIGURES REPRESENT THE MOST COMMON DETECTOR LOOP LOCATIONS AND SIZES. ADJUSTMENTS WILL BE NECESSARY FOR SPECIFIC GEOMETRIC CONSIDERATIONS.

LOCATIONS AND DEMENSIONS OF DETECTOR LOOPS ARE REQUIRED ON ALL SIGNAL LAYOUT PLAN SHEETS.

"FAR OUT" DETECTION REFERS TO LOCKING, PRESENCE TYPE DETECTION LOCATED IN THRU LANES, RIGHT TURN LANES, AND RIGHT TURN LANE TAPER AREAS (IF APPLICABLE), USUALLY 250' (75 m) IN ADVANCE OF STOP BARS. "UPTIGHT" DETECTION REFERS TO NON-LOCKING PRESENCE TYPE DETECTION LOCATED IN ALL LANES AND 10'-15' (3.0 m-4.5 m) BEHIND THE CROSSING STREET'S EDGE OF PAVEMENT EXTENDED.

**NOTE:**

ALL DETAILS AND NOTES SHOWN ARE FROM THE I.D.O.T. DISTRICT 1 TRAFFIC SIGNAL DESIGN GUIDELINES DATED JANUARY 1995

THIS DRAWING HAS BEEN PREPARED TO ASSIST THE RESIDENT ENGINEER FOR ALL ROADWAY RESURFACING OR S.M.A.R.T. PROJECTS WHERE THE DIMENSIONS ARE NOT SHOWN ON THE PLANS AND THE FINAL LOCATIONS FOR CROSSWALKS OR STOP BARS ARE NOT DETERMINED.

|   |                     |                  |           |   |  |                         |      |                           |   |        |              |           |
|---|---------------------|------------------|-----------|---|--|-------------------------|------|---------------------------|---|--------|--------------|-----------|
| FILE NAME =   | USER NAME = PencePL | DESIGNED -       | REVISED - | <b>STATE OF ILLINOIS<br/>DEPARTMENT OF TRANSPORTATION</b> | <b>DISTRICT 1 - DETECTOR LOOP INSTALLATION<br/>DETAILS FOR ROADWAY RESURFACING</b> |                         |      | F.A.P. RTE.               | SECTION   | COUNTY | TOTAL SHEETS | SHEET NO. |
| p:\11\084EBID\INTEG\11inois.gov\PI\DOT\Documents\DOT Offices\District 1\Projects\0141\ORAN\Design\Diststd.dgn |                     | CHECKED - R.K.F. | REVISED - |   | 339  | 116Y(1&2)R-RS-6         | COOK | 58                        | 58  |        |              |           |
| PLOT SCALE = 100.0000' / 1"   |                     | DATE -           | REVISED - |   | <b>TS-07</b>   |                         |      | <b>CONTRACT NO. 62C93</b> |   |        |              |           |
| PLOT DATE = 2/4/2017  |                     |                  |           |   | SCALE: NONE  | SHEET NO. 1 OF 1 SHEETS | STA. | TO STA.                   | FED. ROAD DIST. NO. 1 ILLINOIS FED. AID PROJECT |        |              |           |