
04-28-2017	LETTING	ITEM	016
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STATE OF ILLINOIS DEPARTMENT OF TRANSPORTATION

PROPOSED HIGHWAY PLANS

F.A.P. ROUTE 360 (IL 25) SECTION 93RS-2 IL 72 TO BOLZ ROAD PROJECT NHPP-0360 (015) RESURFACING (3P), PEDESTRIAN RAMPS (ADA) KANE COUNTY

C-91-417-16

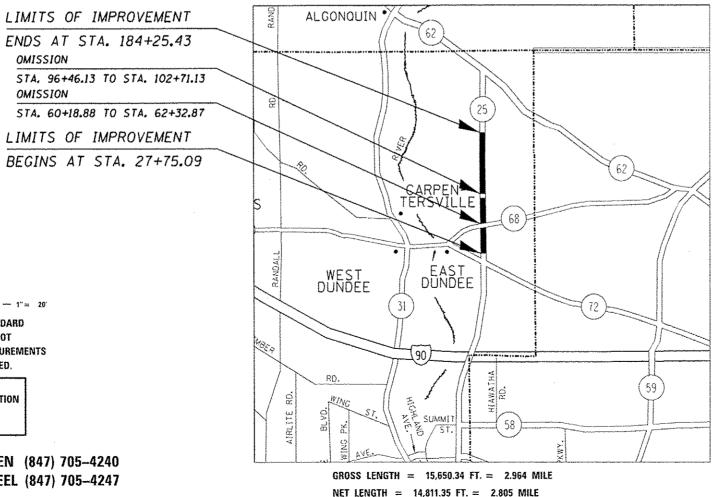

FOR INDEX OF SHEETS, SEE SHEET NO. 2

THIS PROJECT IS LOCATED IN THE VILLAGE OF EAST DUNDEE THE VILLAGE OF CARPENTERSVILLE THE VILLAGE OF BARRINGTON HILLS

2015 ADT: 22,800 POSTED SPEED: 25-45 MPH

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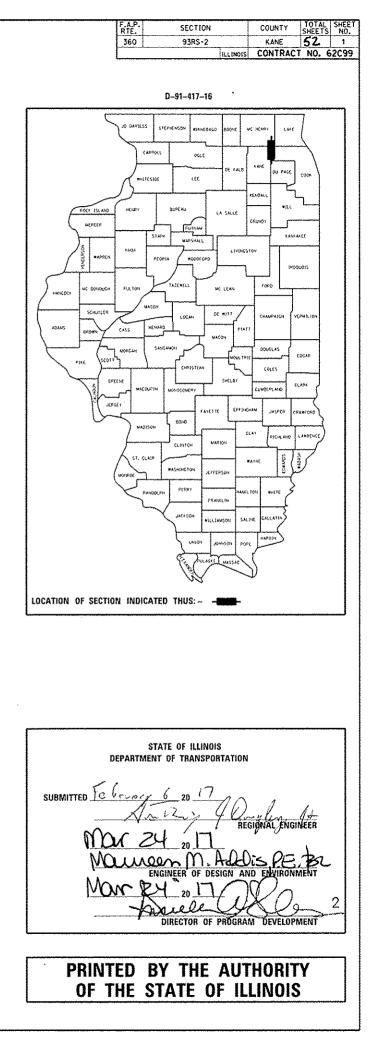
STA. 604 LIMITS BEGINS $300^{--} 1'' = 100'$ 30' -- 1'' = 10'

FULL SIZE PLANS HAVE BEEN PREPARED USING STANDARD ENGINEERING SCALES. REDUCED SIZED PLANS WILL NOT CONFORM TO STANDARD SCALES. IN MAKING MEASUREMENTS ON REDUCED PLANS, THE ABOVE SCALES MAY BE USED.

J.U.L.I.E. Joint Utility Location Information for Excavation 1–800–892–0123 Or 811

PROJECT ENGINEER DAN WILGREEN (847) 705–4240 PROJECT MANAGER FAWAD AQUEEL (847) 705–4247

CONTRACT NO. 62C99



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- STANDARD TRAFFIC SIGNAL DESIGN DETAILS (TS-05) 51
- 52 DISTRICT) - DETECTOR LOOP INSTALLATION DETAILS FOR ROADWAY RESURFACING (TS-07) HIGHWAY STANDARDS

STANDARDS

000001-05	STANDARD SYBMOLS, ABBREVIATIONS. AND PATTERNS
280001-07	TEMPORARY EROSION CONTROL SYSTEMS
424001-09	PERPENDICULAR CURB RAMPS FOR SIDEWALKS
424006-02	DIAGONAL CURB RAMPS FOR SIDEWALKS
424011-03	CORNER PARALLEL CURB RAMPS FOR SIDEWALKS
424016-03	MID-BLOCK CURB RAMPS FOR SIDEWALKS
424021-03	DEPRESSED CORNER FOR SIDEWALKS
442201-03	CLASS C AND D PATCHES
604001-04	FRAME AND LIDS TYPE 1
606001-06	CONCRETE CURB TYPE B AND COMBINATION CONCRETE CURB AND GUTTER
701006-05	OFF-RD OPERATIONS, 2L. 2W, 15' TO 24" FROM PAVEMENT EDGE
701101-05	OFF-RD OPERATIONS, MULTILANE, 15' TO 24" FROM PAVEMENT EDGE
701301-04	LANE CLOSURE, 2L, 2W, SHORT TIME OPERATIONS
701311-03	LANE CLOSURE 2L. 2W MOVING OPERATIONS- DAY ONLY
701426-09	LANE CLOSURE, MULTILANE, INTERMITTENT OR MOVING OPER, FOR SPEEDS > 45 MPH
701427-05	LANE CLOSURE, MULTILANE, INTERMITTENT OR MOVING OPER., FOR SPEEDS \$ 40 MPH
701501-06	URBAN LANE CLOSURE, 2L, 2W, UNDIVIDED
701606-10	URBAN SINGLE LANE CLOSURE, MULTILANE, 2W WITH MOUNTABLE MEDIAN
701701-10	URBAN LANE CLOSURE, MULTILANE INTERSECTION
701801-06	SIDEWALK, CORNER, OR CROSSWALK CLOSURE
701901-06	TRAFFIC CONTROL DEVICES
720001-01	SIGN PANEL MOUNTING DETAILS
720006-04	SIGN PANEL ERECTION DETAILS
720011-01	METAL POSTS FOR SIGNS, MARKERS, & DELINEATORS
729001-01	APPLICATIONS OF TYPES A & B METAL POSTS (FOR SIGNS & MARKERS)

COMMITMENTS

NO COMMITMENTS

GENERAL NOTES

- BEFORE STARTING ANY EXCAVATION. THE CONTRACTOR SHALL CALL "J.U.L.I.E." AT (800) 892-0123 OR 811 FOR FIELD LOCATIONS OF BURIED ELECTRIC. TELEPHONE AND GAS UTILITIES. 48 HOUR NOTIFICATION IS REQUIRED.
- 2 THE CONTRACTOR SHALL BE RESPONSIBLE FOR PROTECTING UTILITY PROPERTY FROM CONSTRUCTION OPERATIONS AS OUTLINED IN ARTICLE 107.31 OF THE STANDARD SPECIFICATIONS. ANY DAMAGE TO THE UNDERGROUND FACILITIES CAUSED BY THE CONTRACTOR SHALL BE REPAIRED TO THE SATISFACTION OF THE DEPARTMENT AT THE CONTRACTOR'S EXPENSE. INCLUDING TEMPORARY REPAIRS WHICH MAY BE REQUIRED TO KEEP THE FACILITY OPERATIONAL WHILE MATERIAL IS BEING OBTAINED TO MAKE PERMANENT REPAIRS.
- (3)THE CONTRACTOR SHALL COORDINATE CONSTRUCTION ACTIVITIES WITH UTILITY COMPANIES, AND THE VILLAGE OF CARPENTERSVILLE.
- (1) THE CONTRACTOR SHALL CONTACT THE DISTRICT ONE TRAFFIC CONTROL SUPERVISOR AT (847) 705-4470 A MINIMUM OF 72 HOURS IN ADVANCE OF **BEGINNING WORK**
- (5) THE CONTRACTOR WILL NOT BE ALLOWED TO SET UP A YARD OR FIELD OFFICE ON STATE PROPERTY WITHOUT WRITTEN PERMISSION FROM THE DEPARTMENT.
- 6) THE CONTRACTOR SHALL BE REQUIRED TO PROVIDE ACCESS TO ABUTTING PROPERTY AT ALL TIMES DURING THE CONSTRUCTION OF THIS PROJECT.
- $\hat{(7)}$ THE CONTRACTOR SHALL MAINTAIN PEDESTRIAN ACCESS AT ALL TIMES DURING CONSTRUCTION.
- (8) BEFORE BEGINNING ANY WORK. THE CONTRACTOR SHALL RETAIN AND RECORD FOR FUTURE REFERENCE, ALL EXISTING PAVEMENT MARKING LINES (AND RAISED REFLECTIVE PAVEMENT MARKERS) IN ORDER THAT THE LOCATIONS CAN BE RE-ESTABLISED FOR STRIPING. EXACT LOCATIONS OF ALL PAVEMENT MARKINGS SHALL BE AS DIRECTED BY THE ENGINEER.
- (9) IN ADDITION TO FIELD AND AERIAL SURVEYS. PLAN DIMENSIONS AND DETAILS RELATIVE TO THE EXISTING FACILITIES HAVE BEEN TAKEN FROM EXISTING PLANS AND ARE SUBJECT TO CONSTRUCTION VARIATIONS. IT SHALL BE THE CONTRACTOR'S RESPONSIBILITY TO VERIFY SUCH DIMENSIONS AND EXISTING CONDITIONS IN THE FIELD PRIOR TO CONSTRUCTION AND ORDERING MATERIALS. SUCH VARIATIONS SHALL NOT BE A CAUSE FOR ADDITIONAL COMPENSATION DUE TO A CHANGE IN THE SCOPE OF WORK. HOWEVER, THE CONTRACTOR WILL BE PAID FOR THE QUANTITY ACTUALLY FURNISHED AT THE UNIT PRICE BID FOR THE WORK.
- (0) THE LOCATIONS OF THOSE BURIED AND ABOVE GROUND UTILITIES SHOWN ARE APPROXIMATE, ARE SHOWN FOR CONTRACTOR INFORMATIONAL USE ONLY, AND ARE NOT TO BE REFERENCED FOR CONSTRUCTION PURPOSES. THE IMPLIED PRESENCE OR ABSENCE OF UTILITIES IS NOT TO BE CONSTRUED BY THE OWNER. ENGINEER, CONTRACTOR, OR SUBCONTRACTORS TO BE AN ACCURATE AND COMPLETE REPRESENTATION OF UTILITIES THAT MAY OR MAY NOT EXIST ON THE CONSTRUCTION SITE. BURIED AND ABOVE GROUND UTILITY LOCATIONS. IDENTIFICATION, AND MARKING ARE THE SOLE RESPONSIBILITY OF THE CONTRACTOR. REROUTING, DISCONNECTION, PROTECTION, ETC. OF ANY UTILITIES MUST BE COORDINATED BETWEEN CONTRACTOR, UTILITY COMPANY, AND OWNER. SITE SAFETY. INCLUDING THE AVOIDANCE OF HAZARDS ASSOCIATED WITH BURIED AND ABOVE GROUND UTILITES REMAIN THE SOLE RESPONSIBILITY OF THE CONTRACTOR
- (11) DO NOT SCALE PLANS FOR CONSTRUCTION DIMENSIONS.
- (12) THE CONTRACTOR SHALL TAKE ALL NECESSARY PRECAUTIONS FOR THE PROTECTION OF EXISTING PLANT MATERIAL FOR WHICH THE CONTRACT DOES NOT PROVIDE REMOVAL. THE PROTECTION OF EXISTING PLANT MATERIAL AND THE REPAIR OR REPLACEMENT OF EXISTING PLANT MATERIAL DAMAGED BY THE CONTRACTOR SHALL BE DONE IN ACCORDANCE WITH THE REQUIREMENTS OF SECTION 201 OF THE STANDARD SPECIFICATIONS.
- (13) OVERNIGHT LANE CLOSURES SHALL NOT BE ALLOWED FOR REHABILITATION PROJECTS INVOLVING DAYTIME MILLING AND RESURFACING OPERATIONS AND CLASS D PATCHING UNLESS OTHER CONDITIONS WARRANT EXTENDED LANE CLOSURES AS DETERMINED AND APPROVED IN WRITING BY THE ENGINEER OR AS PROVIDED IN THE CONTRACT SPECIFICATIONS.
- (14) WHERE SECTION OR SUB-SECTION MONUMENTS ARE ENCOUNTERED. THE ENGINEER SHALL BE NOTIFIED BEFORE SUCH MONUMENTS ARE REMOVED. THE CONTRACTOR SHALL PROTECT AND CAREFULLY PRESERVE ALL PROPERTY MARKERS AND MONUMENTS UNTIL THE OWNER, AN AUTHORIZED SURVEYOR, OR ACENT HAS WITNESSED THEIR LOCATION.
- (15) THE EXACT LOCATIONS AND SIZES OF PAVEMENT PATCHES SHALL BE DETERMINED BY THE ENGINEER IN THE FIELD.
- (16) WHEN THE MILLED PAVEMENT IS OPEN TO TRAFFIC THE MAXIMUM GRADE DIFFERENTIAL BETWEEN PASSES OF THE MILLING MACHINE SHALL NOT EXCEED 1 1/2 INCHES WHERE THE SPEED LIMIT IS 40 MPH OR LESS AND 1 INCH WHERE THE SPEED LIMIT IS GREATER THAN 40 MPH. WITH WRITTEN APPROVAL OF THE ENGINEER. A MAXIMUM GRADE DIFFERENTIAL OF 3 INCHES MAY BE ALLOWED IF THE EDGE OF THE MILLING IS SLOPED A MINIMUM 1:3 (V:H) OR A NOTCHED LONGITUDINAL WEDGE IS USED.
- (17) ANY PAVEMENT MARKINGS AND RAISED REFLECTIVE PAVEMENT MARKERS OBLITERATED BY MILLING AND RESURFACEING OPERATIONS ON SIDE STREETS AND ENTRANCES SHALL BE REPLACED AND PAID FOR IN KIND.
- (18) LOCATION OF COMBINATION CONCRETE CURB AND GUTTER REMOVAL AND REPLANCEMENT, WILL BE DETERMINED IN THE FIELD BY THE ENGINEER.
- (19) DRAINAGE ADJUSTMENT OR RECONSTRUCTION LOCATIONS WILL BE DETERMINED IN THE FIELD BY THE ENGINEER.
- 20 EXISTING BROKEN FRAMES AND LIDS SHALL BE REMOVED AND DISPOSED OF BY THE CONTRACTOR AND SHALL BE REPLACED AS DIRECTED BY THE ENGINEER. REPLACEMENT FRAMES AND LIDS WILL BE PAID FOR ACCORDING TO ARTICLE 109.04 OF THE STANDARD SPECIFICATIONS UNLESS A SEPARATE PAY ITEM HAS BEEN PROVIDED
- (21) FOR FRAMES AND LIDS ADJUSTMENT WITHOUT MILLING, REUSE EXISTING FRAME AND LID UNLESS OTHERWISE SPECIFIED IN THE PLANS.
- 2 FRAMES AND GRATES ADJUSTMENT OF PRIVATE UTILITIES WITHIN THE LIMITS OF THE IMPROVEMENTS SHALL BE DONE BY THEIR RESPECTIVE OWNERS AND
- ARE NOT PART OF THIS CONTRACT. (23) THE NOMINAL THICKNESS FOR HMA BASE AND SURFACE COURSES ARE SHOWN ON THE TYPICAL SECTIONS, STANDARDS, SCHEDULES, OR SPECIAL DETAILS, DEVIATIONS FROM THE NOMINAL THICKNESS WILL BE PERMITTED WHEN SUCH DEVIATIONS OCCUR DUE TO IRREGULARITIES IN THE EXISTING SURFACE OR
- BASE ON WHICH THE HMA MIXUTRE IS PLACED. (2) PAVEMENT MARKING TAPE. TYPE III SHALL BE USED FOR SHORT TERM PAVEMENT MARKINGS ON ALL FINAL SURFACES.
- 25)
- (SNOW-PLOW RESISTANT)" SHOWN IN THE PLANS.
- (26) THE ENGINEER SHALL CONTACT DON CHIARUGI, AREA TRAFFIC FIELD ENGINEER, AT DON.CHIARUGIQILLINDIS.COV A MINIMUM OF TWO (2) WEEKS PRIOR TO THE PLACEMENT OF PERMANENT PAVEMENT MARKINGS.

FILE NAME :	USER NAME I bartonew	DESIGNED - RWB	REVISED -		1	11 25 EDO		0 TO E		TE	A.P.	SECTION	COUNTY	TOTAL SHEET
pwi\\IL@84E8I0INTEG.illinois.goviPWID0T\Qp	umonts/1001 Offices/District 1/Projects/0141	I ORCANOL to \ Cosign \ BWB/16-sht-gennote.c	gr REVISED -	STATE OF ILLINOIS					BOLZ ROAD	. +	31L.	93RS-2	VANE	SHEETS NO.
	PLOT SCALE + 100.0000 1/ .m.	CHECKED -	REVISED -	DEPARTMENT OF TRANSPORTATION	INDEX O	OF SHEETS, STA	TE STA	NDARDS	S, AND GENERAL NOTES	4 F	560	3383-2	CONTRA	CT NO. 62C99
Default	PLOT DATE + 2/9/2017	DATE - 2/9/2017	REVISED -		SCALE:	SHEET 1 OF	F 1 54	HEETS S	TA, TO STA.			ILLINOIS FED. A	10 PROJECT	L1 1101 02033

DOUBLE LANE MARKERS ARE TO BE USED AS SHOWN ON THE DISTRICT ONE DETAIL "TYPICAL APPLICATIONS - RAISED REFLECTIVE PAVEMENT MARKERS

			URBA	N									
	SUMMARY OF QUANTITIES			0005	C01	NSTRUCT1	ON TYPE	CODE I	T		SUMM/	ARY OF QUANTITIES	
CODE NO	ITEM	UNIT	TOTAL QUANTITIES	ROADWAY						CODE NO		ITEM	UNIT
20200100	EARTH EXCAVATION	CU YD	44	44						40603335	HOT-MIX ASP	HALT SURFACE COURSE.	TON
											MIX "0", N5	0	
21101615	TOPSOIL FURNISH AND PLACE, 4"	SO YD	654	654				nemera antica atana da					
								na na vaprani ve tak na mu		40603340	HOT-MIX ASP	HALT SURFACE COURSE.	TON
25000400	NITROGEN FERTILIZER NUTRIENT	POUND	9	9							MIX "D", N7	0	
25000500	PHOSPHORUS FERTILIZER NUTRIENT	POUND	9	9						42300400	PORTLAND CE	MENT CONCRETE DRIVEWAY	SO YD
											PAVEMENT,	8 1NCH	
25000600	POTASSIUM FERTILIZER NUTRIENT	POUND	9	9									
										42400200	PORTLAND CE	MENT CONCRETE SIDEWALK 5 INCH	SO FT
25200110	SODDING, SALT TOLERANT	SQ YD	654	654									
										42400800	DETECTABLE	WARNINGS	SO FT
25200200	SUPPLEMENTAL WATERING	UNIT	10	10			·····			44000158	UAT NEX LOD	HALT SURFACE REMOVAL, 2 1/4"	SO YD
28000400	PERIMETER EROSION BARRIER	FOOT	1000	1000						44000138	NGT-MIX AGE	HALI SUNFALE REMOVAL, 2 1/4	30 10
										44000200	DRIVEWAY PA	VEMENT REMOVAL	SQ YD
28000510	INLET FILTERS	EACH	20	20									
										44000600	SIDEWALK REN	MOVAL	SO FT
35501316	HOT-MIX ASPHALT BASE COURSE. 8"	SO YD	116	116		-		***					
				termen efter et bester efter et bester et						44201789	CLASS D PAT	CHES, TYPE II, 12 INCH	SO YD
40600290	BITUMINOUS MATERIALS (TACK COAT)	POUND	67451	67451									
40600400		TON	150							44201794	CLASS D PATO	CHES, TYPE 111, 12 INCH	SO YD
40600400	MIXTURE FOR CRACKS, JOINTS, AND FLANGEWAYS	TON	150	150						44201796		CHES. TYPE IV, 12 INCH	SQ YD
40600827	POLYMERIZED LEVELING BINDER (MACHINE	TON	4196	4196									
	METHOD), IL-4.75, N50									48102100	AGGREGATE WE	DGE SHOULDER, TYPE B	TON
40600982	HOT-MIX ASPHALT SURFACE REMOVAL -	SO YD	555	555						60250200	CATCH BASIN	S TO BE ADJUSTED	EACH
	BUTT JOINT												
										60255500	MANHOLES TO		EACH
FILE NAME :	USER NAME = bortonne DES	SICNED - R	WA	REVISED							SPECIALTY	·····	
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1	PLOT SCALE + 100,0000 */ IA CHE PLOT DATE + 2/1/2017 DAT	CKED - 2	/7/2017	REVISED		·	1	DEPARTN	IENT OF T	RANSPORTA	TION	SUMMARY SCALE: SHEET NO. 1 OF 3 SHEET	

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	URBAN						
	TOTAL QUANTITIES	OOO5 ROADWAY 80% FEDERAL 20% STATE	C	ONSTRUCT	ION TYPE		
	13	13					
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	8391	8391	·······				
	76	76					
	4060	4060					
					,,		
~	263	263					
	99372	99372					
	192	192					
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	4051	4051					
_							
	2107	2107		-			
	393	393	<u></u>				
	-						
	200	200					
	354	354					
			<u></u>				
	53	53					
	4	4					
		-	F.A.P. RTE.	SECT		COUNTY	TOTAL SHEET SHEETS NO.
	Z ROAD FIES		RTE. 360	93R		KANE	52 3
TA,		ŞTA.	FED, R	040 DIST. NO. 1	ILLINDIS FED. AT	CUNTRACT	NO. 62C99

	SUMMARY OF QUANTITIES		URBAN	T	CONS	TRUCTION T	PE CODE			SUBBLARY OF OURNITITIES		URBAN	1	CON	STRUCTION T	YPE CODE	
	SUMMARY OF OUANTIFIES		-	0005		<u> </u>				SUMMARY OF QUANTITIES	1		0005				
			TOTAL	ROADWAY								TOTAL	ROADWAY		*****		
CODE NO	ITEM	UNIT	QUANTITIES	80% FEDERAL		mg a star a star			CODE NO	ITEM	UNIT	OUANTITIES	80% FEDERAL				
			·····	20% STATE									20% STATE		·		ra program of the second s
50260300	INLETS TO BE ADJUSTED WITH NEW TYPE 1	EACH	1	1					70300210	TEMPORARY PAVEMENT MARKING LETTERS AND	SO FT	1419.6	1419.6				
	FRAME, OPEN LID									SYMBOLS							
50406100	FRAMES AND LIDS. TYPE 1. CLOSED LID	EACH	19	19					70300220	TEMPORARY PAVEMENT MARKING - LINE 4"	FOOT	41930	41930				
										······································							
50618300	CONCRETE MEDIAN SURFACE, 4 INCH	SO FT	2735	2735	44 5 4 4 4 4 4 4 4 4 4 4 4 4 4 4 4 4 4				70300240	TEMPORARY PAVEMENT MARKING - LINE 6"	FOOT	8406	8406				
56900200	NON-SPECIAL WASTE DISPOSAL	CU YD	44	44					70300260	TEMPORARY PAVEMENT MARKING - LINE 12"	FOOT	1463	1463				
																	
56900450	SPECIAL WASTE PLANS AND REPORTS	LSUM	1	1	-				70300280	TEMPORARY PAVEMENT MARKING - LINE 24"	F00T	680	680				
56900530	SOIL DISPOSAL ANALYSIS	EACH	4	4					70300520	PAVEMENT MARKING TAPE, TYPE III 4"	FOOT	10560	10560		**************************************		
57000400	ENGINEER'S FIELD OFFICE. TYPE A	CAL MO	6	6					72400500	RELOCATE SIGN PANEL ASSEMBLY - TYPE A	EACH	3	3				
57100100	MOBILIZATION	LSUM	1	1					K 78000100	THERMOPLASTIC PAVEMENT MARKING -	SO FT	1419.6	1419.6				
70102620	TRAFFIC CONTROL AND PROTECTION.	LSUM	1	1						LETTERS AND SYMBOLS							
	STANDARD 701501								78000200	THERMOPLASTIC PAVEMENT MARKING - LINE 4"	FOOT	41930	41930				
	· · · · · · · · · · · · · · · · · · ·								1								
70102625	TRAFFIC CONTROL AND PROTECTION.	LSUM	1	1					78000400	THERMOPLASTIC PAVEMENT MARKING - LINE 6"	FOOT	8406	8406				
	STANDARD 701606																
									78000600	THERMOPLASTIC PAVEMENT MARKING - LINE 12"	FOOT	1463	1463				
70102635	TRAFFIC CONTROL AND PROTECTION,	LSUM	1	1													
	STANDARD 701701		•						78000650	THERMOPLASTIC PAVEMENT MARKING - LINE 24"	FOOT	680	680				
70102640	TRAFFIC CONTROL AND PROTECTION,	LSUM	1	1					78100100	RAISED REFLECTIVE PAVEMENT MARKER	EACH	1324	1324				
	STANDARD 701801																
70300100	SHORT TERM PAVEMENT MARKING	E007	21+20	21120					78300200	RAISED REFLECTIVE PAVEMENT MARKER REMOVAL	EACH	848	848				
70300100	STUDI IERM FAVEMENT MARKING	F 00T	21120	21120				• Province)	ч 	SPECIALTY ITEMS							
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	\$	CHECKED -		REVISED			DEPARTN	AENT OF T	ANSPORTA	TION SUMMARY	OF QUANTI	TIES		360	93R\$-2	CONTRA	52 . CT NO. 62C

			URBAN	1	CONST	RUCTION TYP	CODE		<u></u>			URBAN					
	SUMMARY OF QUANTITIES		-	0005				<u> </u>		SUMMARY OF QUANTITIES					TION TYPE	CODE	
			TOTAL	ROADWAY	446444444		*****					TOTAL	0005 ROADWAY				
CODE NO	ITEM	UNIT	QUANTITIES	ROY FEDERAL	****		****		CODE NO	ITEM	UNIT	QUANTITIES					
				1 1	*****					1 / 1.141	UNI	VUMILITIES	1				
				20% STATE					-				20% STATE				
85000200	MAINTENANCE OF EXISTING TRAFFIC SIGNAL	EACH	3	3					20030850	TEMPORARY INFORMATION SIGNING	SO FT	51.4	51.4				
	INSTALLATION															1	
									A			Eath	500		~		~~~
88600600	DETECTOR LOOP REPLACEMENT	FOOT	3011	3011					\$ 2007600	TRAINEES	Houre	500	300				
			5011														
									Ø 20071004	TRAINGES - TRAINING PROGRAM GRADUA	re Hour	500	500				
89500400	RELOCATE EXISTING PEDESTRIAN PUSH-BUTTON	EACH	6	6													_
89502376	REBUILD EXISTING HANDHOLE	EACH	4	4				-	-								_
X0320050	CONSTRUCTION LAYOUT (SPECIAL)	L SUM	1	1								-					
															·		
x0327980	PAVEMENT MARKING REMOVAL - WATER BLASTING	SO FT	300	300													
X2020110	GRADING AND SHAPING SHOULDERS	UNIT	93	93					-								
X4400220	CURB REMOVAL AND REPLACEMENT	FOOT	122	122													
X4403800	MEDIAN SURFACE REMOVAL	SO FT	3240	3240													
¥6637000	STORM SEWERS TO BE CLEANED 12"		1305														
×5537800	SIURM SEMERS IN BE GLEANEN 12"	FOOT	1305	1 305	· · · · · ·												
X6030310	FRAMES AND LIDS TO BE ADJUSTED (SPECIAL)	EACH	23	23							*****						
							· · · · · · · · · · · · · · · · · · ·										
X6062100	STABILIZED MEDIAN SURFACE 12"	SO YD	57	57													
							s.										
X7030005	TEMPORARY PAVEMENT MARKING REMOVAL	SQ FT	25904	25904													
70004560	COMPLINATION CONCRETE CURD IN OUTTON		4575														
Z0004562	COMBINATION CONCRETE CURB AND GUTTER	FOOT	4575	4575													_
	REMOVAL AND REPLACEMENT									-						·	-
										Ø 0042							
20018500	DRAINAGE STRUCTURES TO BE CLEANED	EACH	81	81						SPECIALTY ITEMS				6			
FILE NAME =		IGNED - RW		REVISED	-					II 25 FROM	IL 72 TO BOI	7 80AD		F.A.P. SE		COUNTY	1
·····COUNTEGUI	Indisper/PHIDDT/Docyments/DDT Of Floes/District NPto/ads/Deligh/Deligh/Deligh/Deligh/Deligh/Deligh/Deligh/Deligh PLOT SCALE + 100,0000 1/ Ta. CHE(wngh - Rw CKED -		REVISED REVISED	-			STATE OF	ILLINOIS RANSPORTA		RY OF QUANTI				385-2	KANE	1
	PLOT DATE + 2/1/20/7 DATE		*	REVISED			UCPARIN	ICINI UF I	HANSPURIA	SCALE: SHEET NO. 3 OF 3			STA.			CONTRAC	1

LEGEND

HOT-MIX ASPHALT MIXTURE REQUIREME	NTS	QUALITY MANAGEMENT
MIXTURE TYPE	AIR VOIDS © Ndes	PROGRAM (OMP)
RESURFACING		
HOT-MIX ASPHALT SURFACE COURSE, MIX "D", N70 (IL-9.5mm)	4% @ 70 GYR.	PFP
POLYMERIZED LEVELING BINDER (MACHINE METHOD), IL-4.75, N50	3.5% @ 50 GYR.	QCP
PATCHING		
CLASS D PATCHING (HMA BINDER, IL-19.0)	4% @ 70 GYR.	0C/0A
DRIVEWAYS		
HOT-MIX ASPHALT SURFACE COURSE, MIX "D", N50 (IL 9.5 mm), 2"	4% @ 50 GYR.	AC/QA
HOT-MIX ASPHALT BASE COURSE (HMA BINDER IL-19.0 mm), N50, CE-8"	4% @ 50 GYR.	QC/QA
STABILIZED MEDIAN SURFACE		
HOT-MIX ASPHALT SURFACE COURSE, MIX "D", N50 (IL 9.5 mm), 2"	4% @ 50 GYR.	QC/QA
HOT-MIX ASPHALT BASE COURSE (HMA BINDER IL-19.0 mm), N50, 10"	4% @ 50 GYR.	QC/QA

- THE UNIT WEIGHT USED TO CALCULATE ALL HMA SURFACE MIXTURE QUANTITIES IS 112 LBS/SQ YD/IN

- THE "AC TYPE" FOR POLYMERIZED HMA MIXES SHALL BE "SBS/SBR PG 76-22" AND FOR NON-POLYMERIZED HMA THE "AC TYPE" SHALL BE "PG 64-22" UNLESS MODIFIED BY DISTRICT ONE SPECIAL PROVISIONS.

- FOR USE OF RECYCLED MATERIALS SEE SPECIAL PROVISIONS


- QUALITY MANAGEMENT PROGRAM (QMP) IDENTIFIES THE PARTICULAR QUALITY CONTROL SPECIFICATION THAT APPLIES TO THE HMA MIXTURE

- THE SEQUENCE OF CONSTRUCTION SHALL BE MILLING FIRST


F	ILE NAME =	USER NAME = bartonrw	DESIGNED - RWB	REVISED -		IL 25 FROM IL 72 TO BOLZ ROAD			SECTION	COUNTY TOTAL SHEET
P	w:\\IL084EBIDINTEG.1111no1s.gov:PWIDOT\Do	cuments\IDOT Offices\District 1\Projects\D141	/10R0#WMota\Design\RWB716-sht-typical.dgn	REVISED -	STATE OF ILLINOIS			360	93RS-2	KANE 52 6
		PLOT SCALE = 100.0000 ' / in.	CHECKED -	REVISED -	DEPARTMENT OF TRANSPORTATION	TYPICAL SECTIONS				CONTRACT NO. 62C99
D	efault	PLOT DATE = 2/7/2017	DATE - 2/3/2017	REVISED -		SCALE:	SHEET 1 OF 11 SHEETS STA. TO STA.		ILLINOIS FED. A	ID PROJECT


1 EXIST. SUBBASE GRANULAR MATERIAL, TYPE A 4" (2) EXIST. SUBBASE GRANULAR MATERIAL, TYPE B 4" (3) EXIST. AGGREGATE BASE COURSE, TYPE B 8" (4) EXIST. PCC PAVEMENT 9"-6"-9" (5) EXIST. PCC BASE COURSE 9" 6 EXIST. PCC BASE COURSE 10" (7) EXIST. HOT-MIX ASPHALT BASE COURSE 21/4" (8) EXIST. HOT-MIX ASPHALT BASE COURSE 10" (9) EXIST. HOT-MIX ASPHALT BASE COURSE 11³/₄" (10) EXIST. COMBINATION CURB AND GUTTER, TYPE M-2.12 (1) EXIST. COMBINATION CURB AND GUTTER TYPE M-6.06 (12) EXIST. COMBINATION CURB AND GUTTER TYPE B-6.12 (13) EXIST. COMBINATION CURB AND GUTTER TYPE B-6.24 (14) EXIST. COOMBINATION CURB AND GUTTER TYPE B-9.12 (15) EXIST. CONCRETE MEDIAN SURFACE, 4" (16) EXIST. STABILIZED MEDIAN SURFACE, 12" (17) EXIST. CONCRETE MEDIAN (18) EXIST. LEVELING BINDER (VARIES) (19) EXIST. HOT-MIX ASPHALT OVERLAY, 2" 20 EXIST. HOT-MIX ASPHALT OVERLAY, 3" (21) EXIST. HOT-MIX ASPHALT SHOULDER, 61/2" (2) EXIST. AGGREGATE SHOULDER 23) PROP. POLYMERIZED LEVELING BINDER (MACHINE METHOD), IL-4.75, N50, 3/4" (24) PROP. HOT-MIX ASPHALT SURFACE COURSE, MIX "D", N70, 1/2" (25) PROP. AGGREGATE WEDGE SHOULDER, TYPE B (26) PROP. THERMOPLASTIC PAVEMENT MARKING - LINE, 4" (27) PROP. THERMOPLASTIC PAVEMENT MARKING - LINE, 6"

PROP. HOT-MIX ASPHALT SURFACE REMOVAL 21/4"

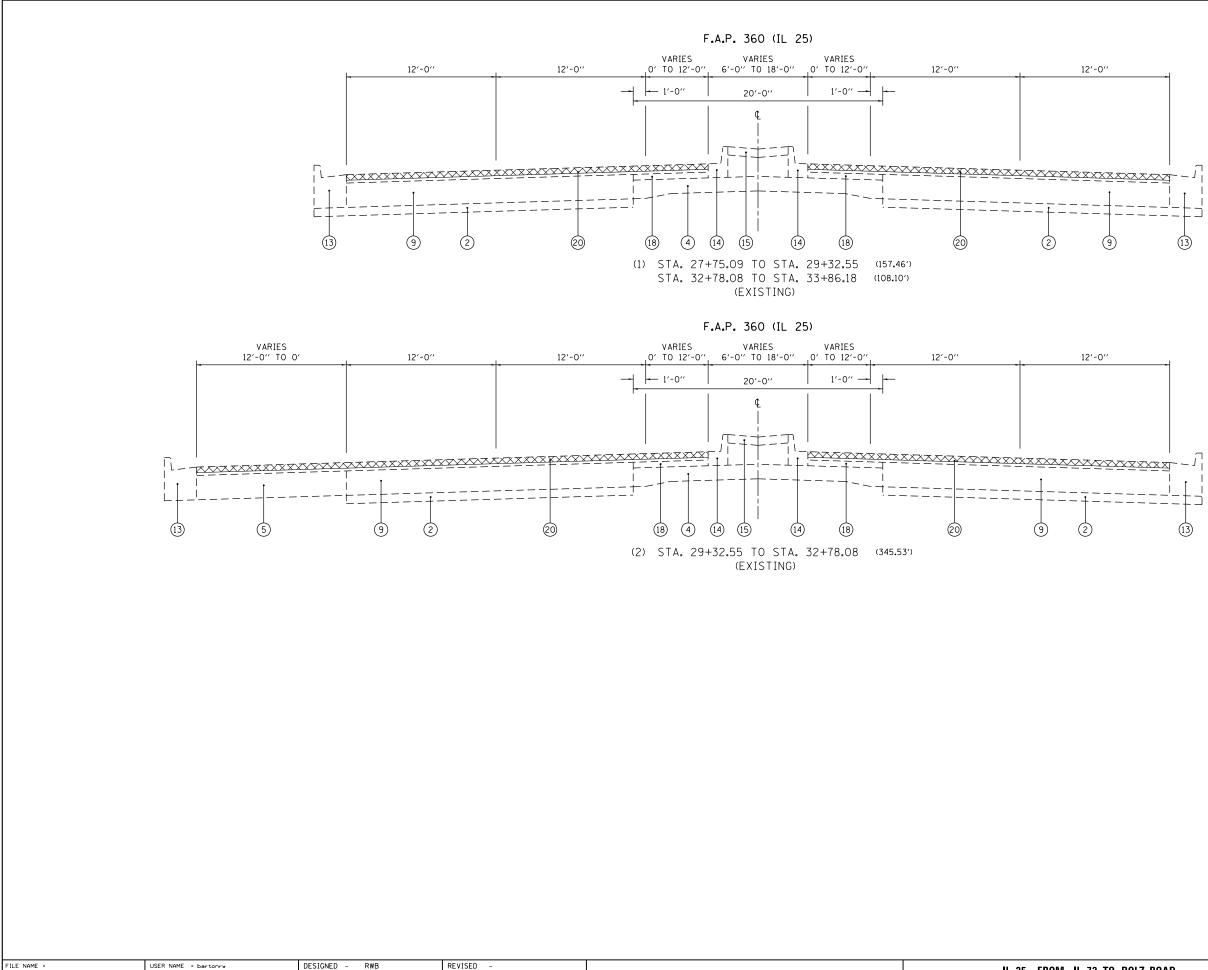

FILE NAME =	USER NAME = bartonrw	DESIGNED -		REVISED -		IL 25 FROM IL 72 TO BOLZ ROAD				SECTION	COUNTY	TOTAL SHEET SHEETS NO.
pw:\\IL084EBIDINTEG.111nois.gov:PWIDDT\Documents\IDDT_Offices\District_1\Projects\D14171DRXW0ata\Design\BWB716-sht-typical.dgn_REVISED		REVISED -	STATE OF ILLINOIS	TYPICAL SECTIONS			360	93RS-2	KANE	52 7		
	PLOT SCALE = 100.0000 ' / in.	CHECKED -		REVISED -	DEPARTMENT OF TRANSPORTATION	ITPICAL SECTIONS					CONTRACT	NO. 62C99
Default	PLOT DATE = 2/7/2017	DATE -	1/11/2017	REVISED -		SCALE: SHEET 2 OF 11 SHEETS STA. TO STA.			ILLINOIS FED. AID PROJECT			

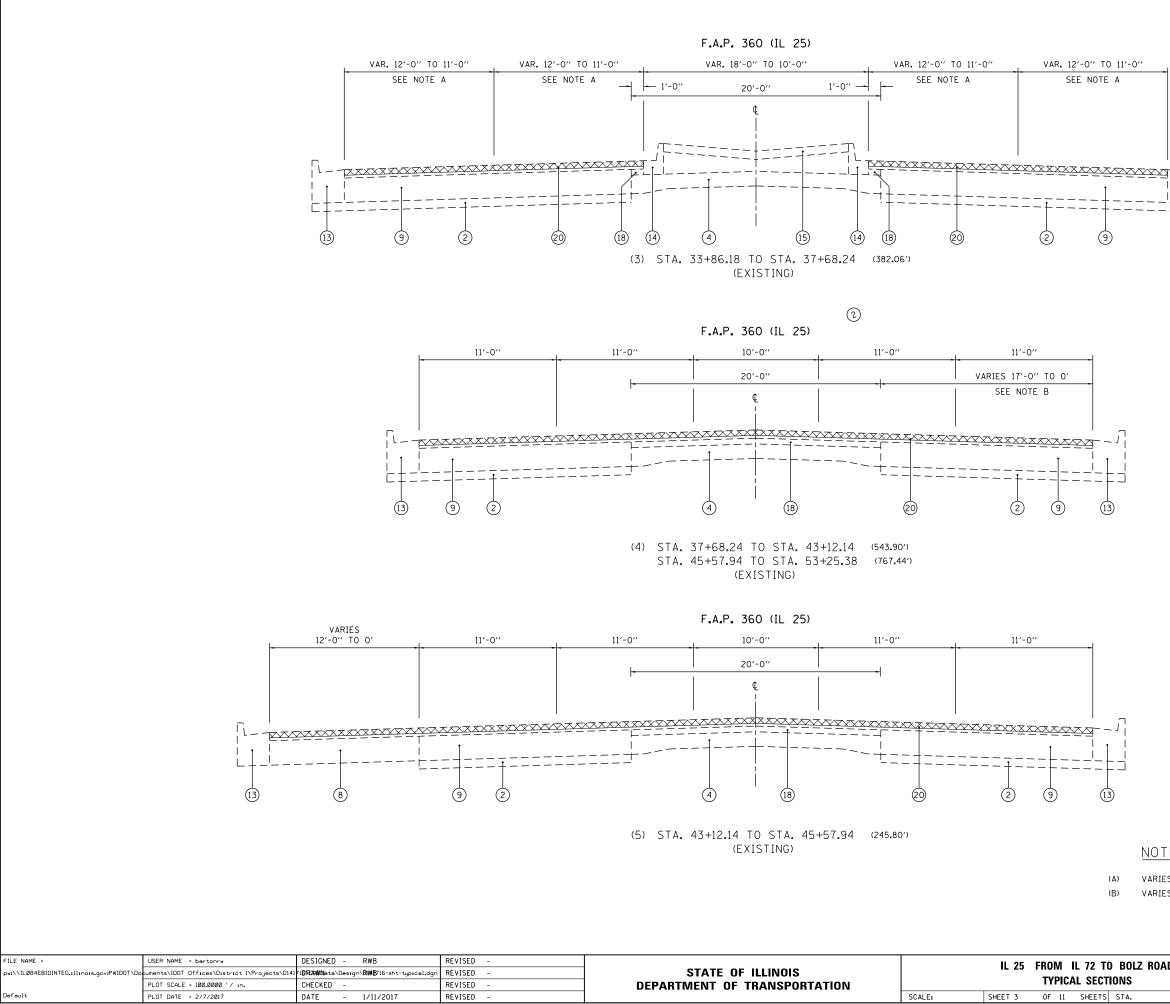

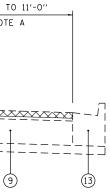






NOTES


(A) VARIES FROM 12'-O" TO 11'-O" FROM STA. 33+86+18 TO STA. 36+31.56 (B) VARIES FROM 17'-0" TO O' FROM STA. 50+01.35 TO STA. 58+58.82

TO BOLZ ROAD CTIONS		F.A.P. RTE.	SECTION	COUNTY	TOTAL SHEETS	SHEET NO.				
		360	93RS-2	KANE	52	8				
5110113		_		CONTRACT	NO. 6	2099				
'S STA.	TO STA.	ILLINOIS FED. AID PROJECT								

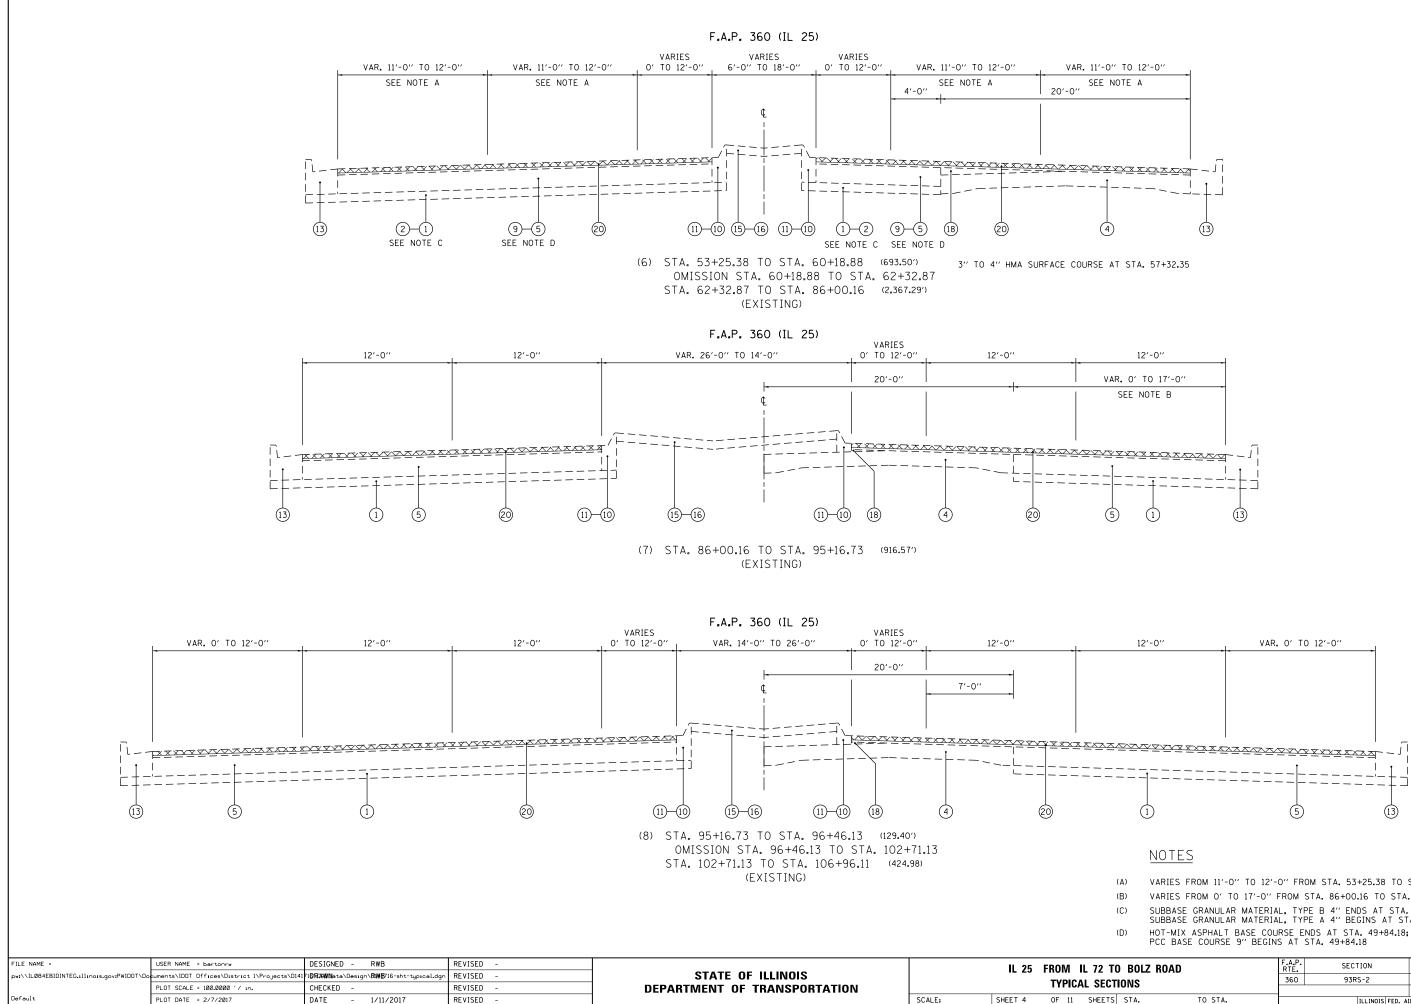


VARIES FROM 11'-0" TO 12'-0" FROM STA. 53+25.38 TO STA. 53+94.14 VARIES FROM O' TO 17'-O" FROM STA. 86+00.16 TO STA. 91+09.52 SUBBASE GRANULAR MATERIAL, TYPE B 4" ENDS AT STA. 49+84.18; SUBBASE GRANULAR MATERIAL, TYPE A 4" BEGINS AT STA. 49+84.18 HOT-MIX ASPHALT BASE COURSE ENDS AT STA. 49+84.18;

TO BOLZ ROAD			SECTION	COUNTY	TOTAL SHEETS	SHEET NO.			
TIONS		360	93RS-2	KANE	52	9			
				CONTRACT	NO. 6	2099			
S STA.	TO STA.		ILLINOIS FED. AID PROJECT						

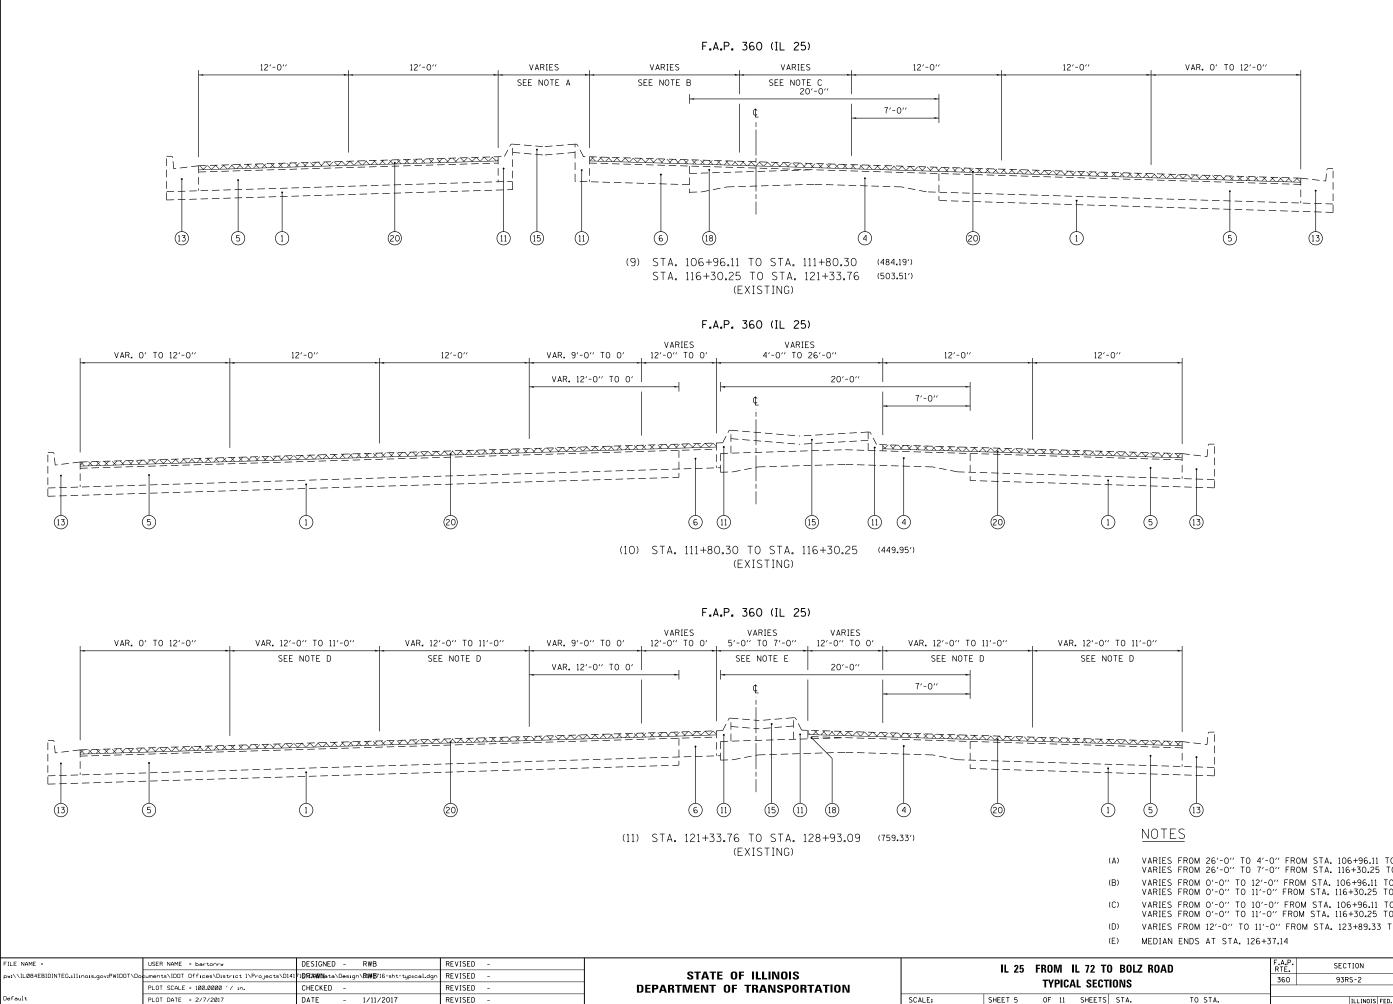

(A)	VARIES FROM 26'-0" TO 4'-0" FROM STA. 106+96.11 TO STA. 111+80.30; VARIES FROM 26'-0" TO 7'-0" FROM STA. 116+30.25 TO STA. 121+33.76
(B)	VARIES FROM 0'-0" TO 12'-0" FROM STA. 106+96.11 TO STA. 111+80.30; VARIES FROM 0'-0" TO 11'-0" FROM STA. 116+30.25 TO STA. 121+33.76
(C)	VARIES FROM 0'-0" TO 10'-0" FROM STA. 106+96.11 TO STA. 111+80.30; VARIES FROM 0'-0" TO 11'-0" FROM STA. 116+30.25 TO STA. 121+33.76
(D)	VARIES FROM 12'-0" TO 11'-0" FROM STA. 123+89.33 TO STA. 126+37.14
(E)	MEDIAN ENDS AT STA. 126+37.14

TO BOLZ RO	AD	F.A.P. RTE.	SECTION	COUNTY	TOTAL SHEETS	SHEET NO.			
CTIONS		360			52	10			
				CONTRACT	NO. 6	2099			
S STA.	TO STA.		ILLINOIS FED. AID PROJECT						

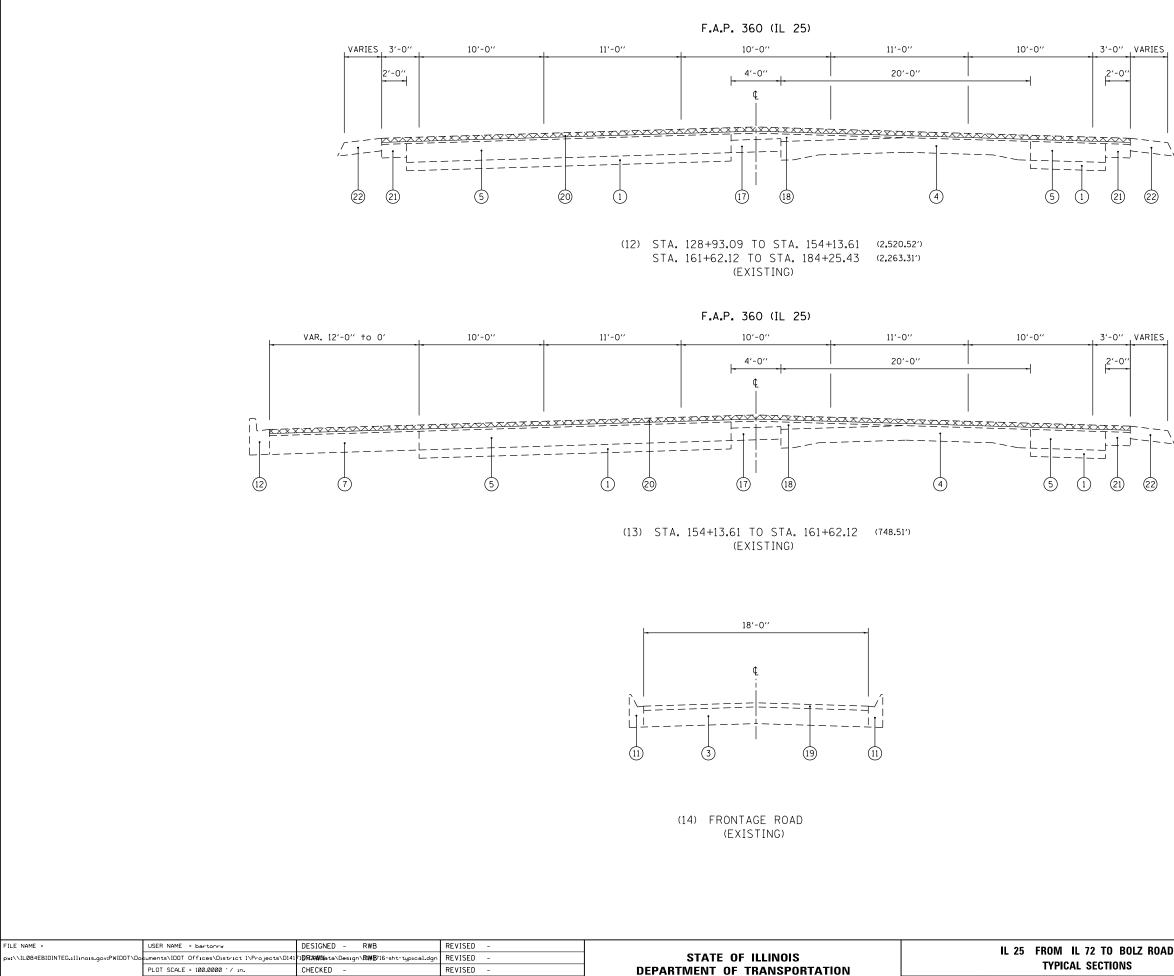

REVISED -


DATE - 1/11/2017

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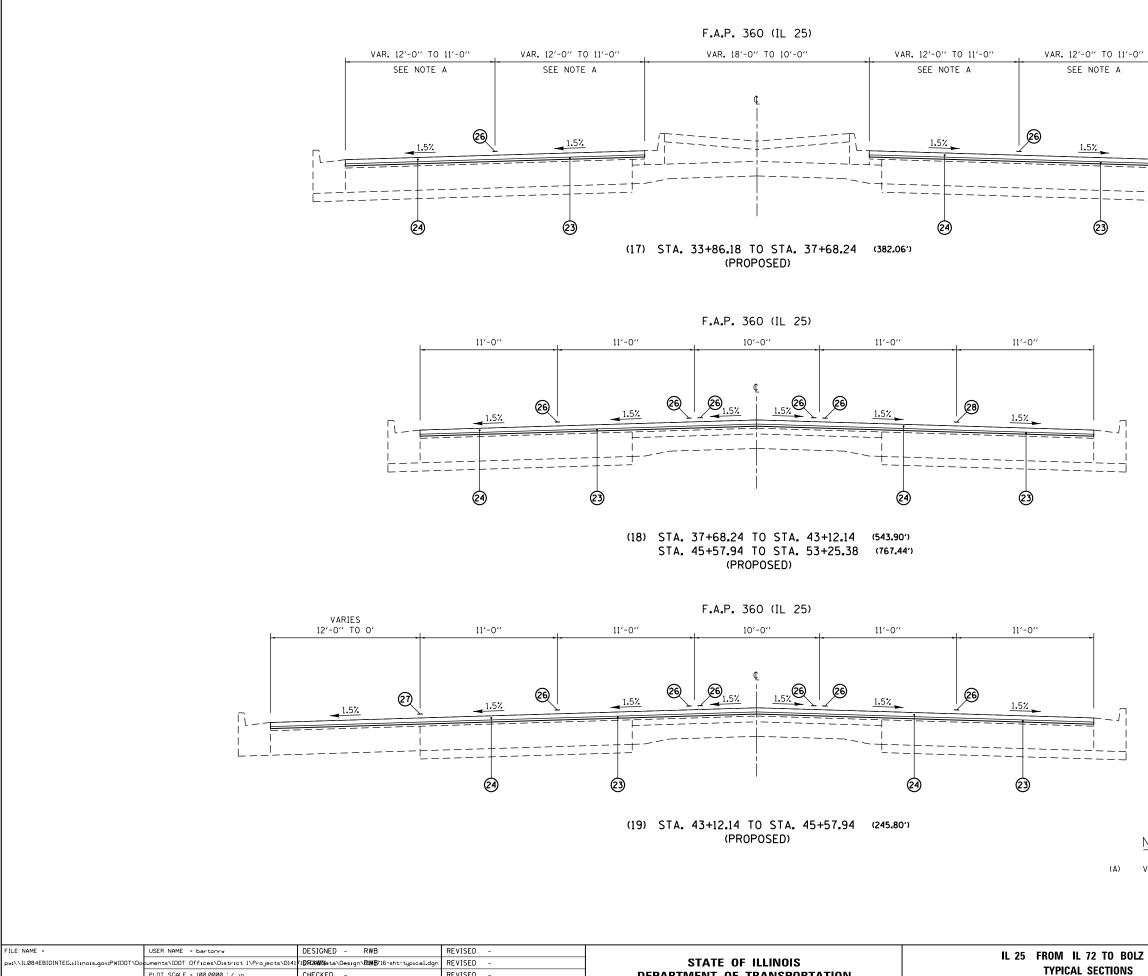
PLOT DATE = 2/7/2017

	IL 25 FROM IL 72 TO BOLZ ROAD Typical sections					F.A.P. RTE.	SECTION	COUNTY	TOTAL SHEETS	SHEET NO.
						360	93RS-2	KANE	52	11
								CONTRACT	NO. 6	2099
	SHEET 6	OF 1	SHEETS	STA.	TO STA.	ILLINOIS FED. AID PROJECT				

SCALE:

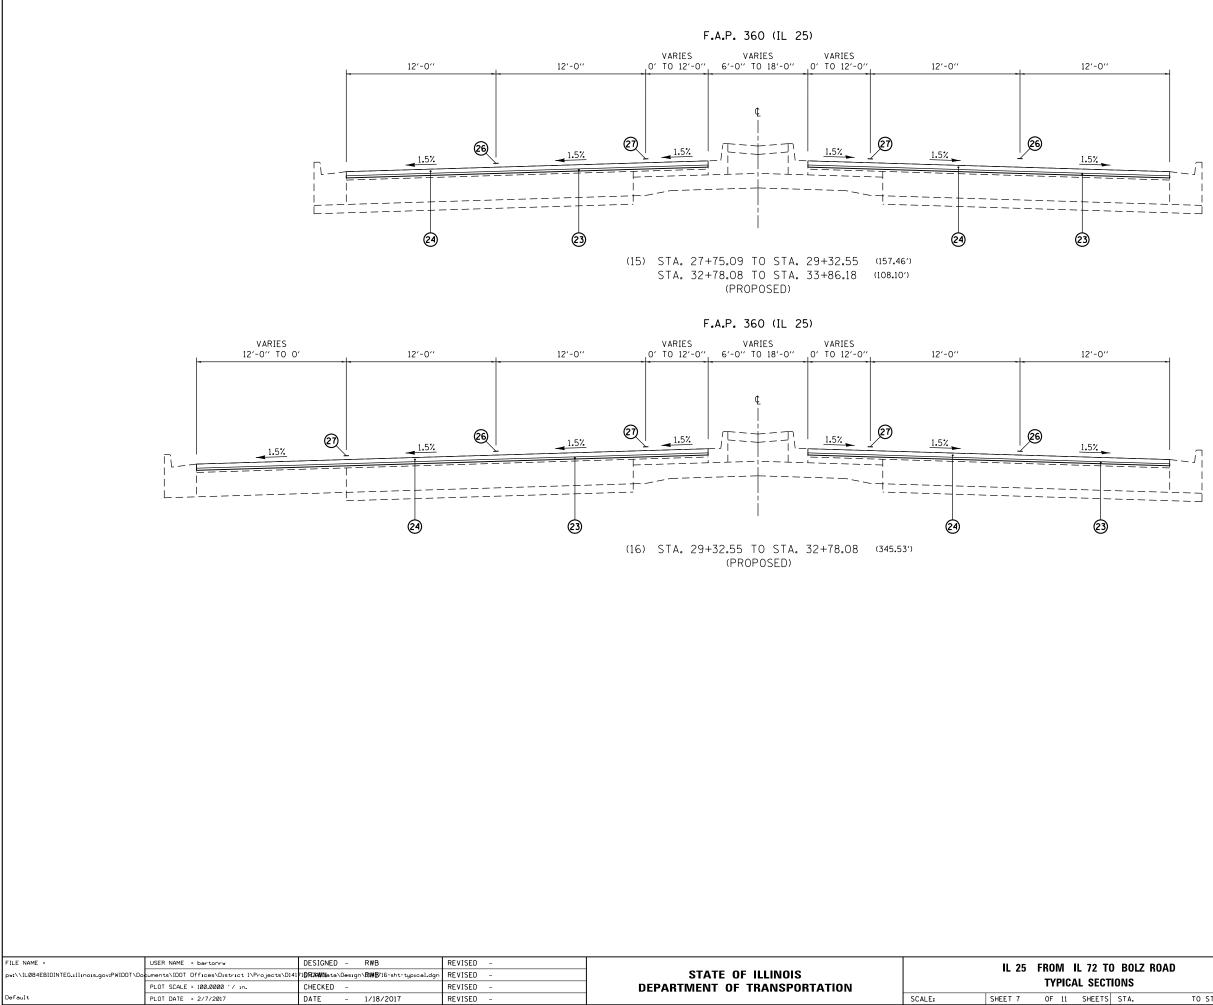


TO BOLZ ROAD			SECTION	COUNTY	TOTAL SHEETS	SHEET NO.			
CTIONS		360	93RS-2	KANE	52	12			
				CONTRACT	NO. 6	2099			
S STA.	TO STA.		ILLINOIS FED. AID PROJECT						



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	PLOT SCALE = 100.0000 ' / in.	CHECKED -	REVISED -	DEPARTMENT OF TRANSPORTATION	
	PLOT DATE = 2/7/2017	DATE - 1/18/2017	REVISED -		SCALE:
					-

Default

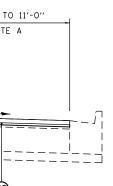




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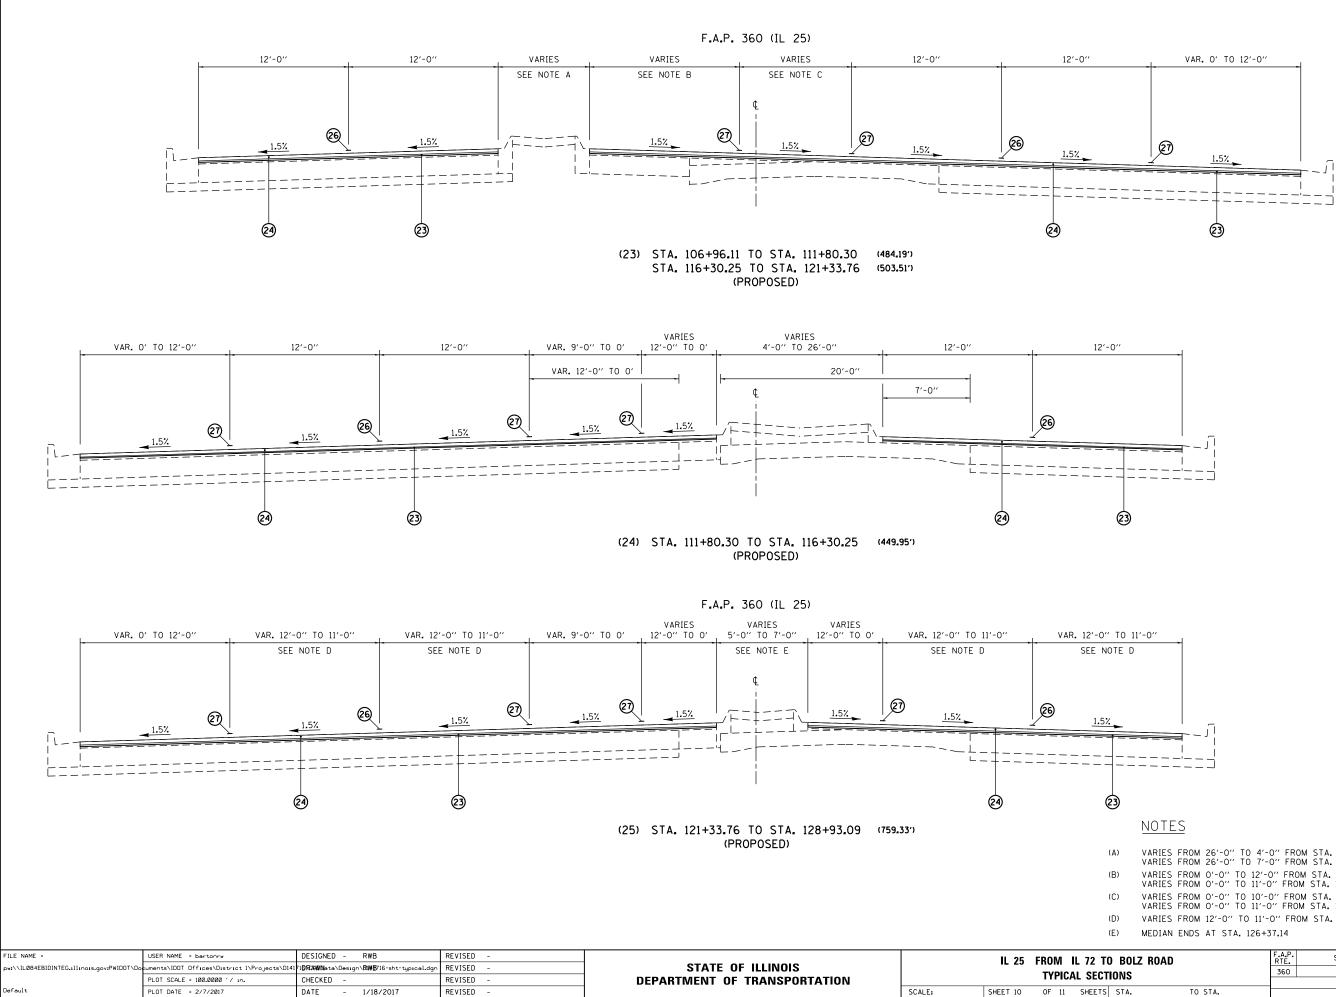
(A) VARIES FROM 12'-0" TO 11'-0" FROM STA. 33+86+18 TO STA. 36+31.56

IL 25 FROM IL 72 TO BOLZ ROAD					F.A.P. RTE.	SECTION	COUNTY	TOTAL		
TYPICAL SECTIONS				360	93RS-2	KANE	52	13		
ITPICAL SECTIONS							CONTRACT	NO.	62099	
SHEET 8	OF	11	SHEETS	STA.	TO STA.	ILLINOIS FED. AID PROJECT				

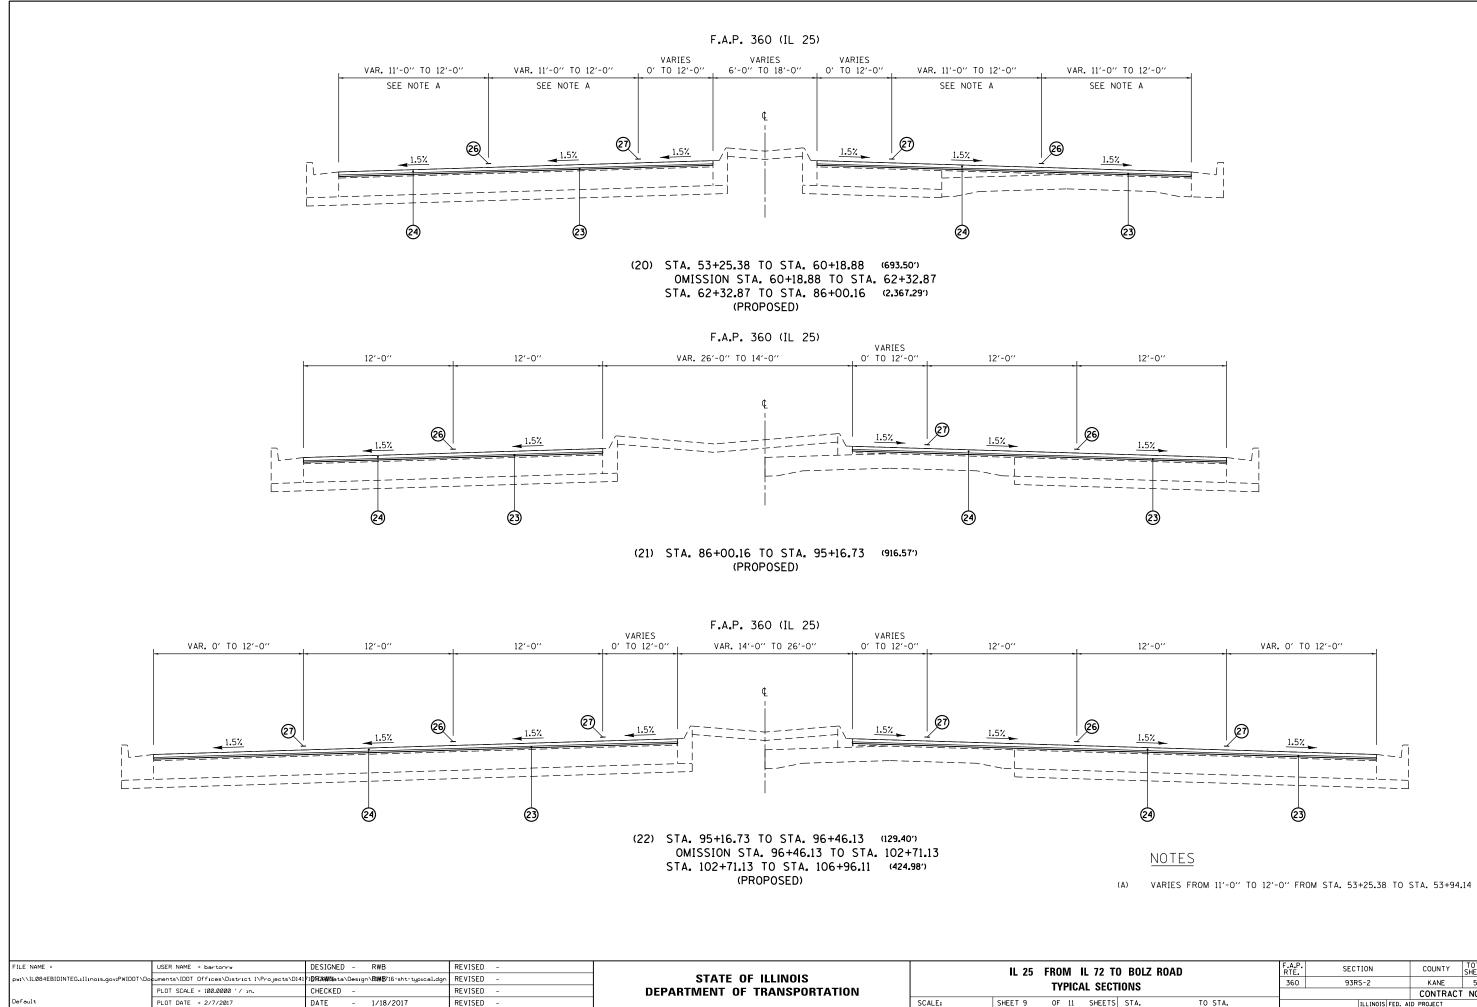


TO BOLZ ROAD Ctions		F.A.P. RTE	SECTION	COUNTY	TOTAL SHEETS	
		360	93RS-2	KANE	52	14
				CONTRACT	NO. 6	2099
IS STA.	TO STA.		ILLINOIS FED. A	ID PROJECT		

	0 10 12	O THOM STA	. 33.23.30 10	31A. 33131.11



(A)			26'-0" TO 4'-0" FROM 26'-0" TO 7'-0" FROM		
(B)			0'-0" TO 12'-0" FROM 0'-0" TO 11'-0" FROM		
(C)			0'-0" TO 10'-0" FROM 0'-0" TO 11'-0" FROM		
(D)	VARIES	FROM	12'-0" TO 11'-0" FROM	STA. 123+89.33	TO STA. 126+37.14
(E)	MEDIAN	ENDS	AT STA. 126+37.14		

TO BOLZ R	OAD	F.A.P. RTE.	SECTION	COUNTY	TOTAL SHEETS	SHEET NO.			
TIONS		NC 360 93RS-2				15			
				CONTRACT	NO. 6	2099			
S STA.	TO STA.		ILLINOIS FED. AID PROJECT						

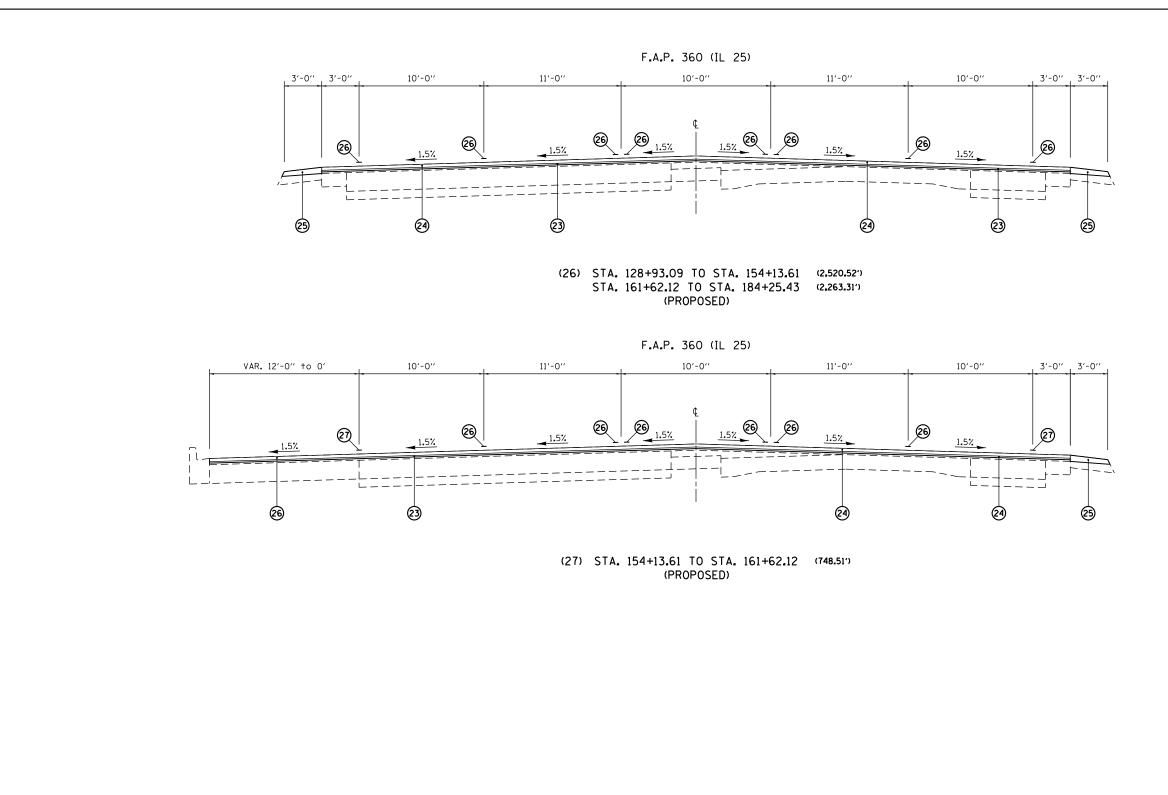

FILE NAME =	USER NAME = bartonrw	DESIGNED - RWB	REVISED -			IL 25 FROM IL 72 TO BOLZ ROAD	F.A.P. RTF.	SECTION	COUNTY TOTAL SHEET
pw:\\ILØ84EBIDINTEG.1llinois.gov:PWIDOT\Do	ouments\IDOT_Offices\District_1\Projects\D1417		-		DEPARTMENT OF TRANSPORTATION TYPICAL SECTIONS		360	93RS-2	KANE 52 16
		CHECKED -	REVISED -	DEPARTMENT OF TRANSPORTATION					CONTRACT NO. 62C99
Default	PLOT DATE = 2/7/2017	DATE - 1/18/2017	REVISED -		SCALE:	SHEET 11 OF 11 SHEETS STA. TO STA.		ILLINOIS FED. A	NID PROJECT


EARTHWORK


TYP. SEC.	LOCATION	CUT (CU YD)	FILL (CU YD)	SHRINKAGE (CU YD)	EARTH EXCAVATION (CU YD)	REM. AND DISPOSAL OF UNSUITABLE MATERIAL (CU YD)	TOPSOIL FURNISH AND PLACE, 4" (SQ YD)
	FAP 360 (IL 25 AND RIVER HAVEN DR.)						0.44
	N.W. QUADRANT	-	-	-	1.5	0	8.41
	S.W. QUADRANT	-	-	-	1.5	0	17.00
	FAP 360 (IL 25 AND NORTHLAKE PKWY.)						
	S.W. QUADRANT	-	-	-	1.5	0	
	FAP 360 (IL 25 AND PRIVATE ROAD)						4.81
	N.W. QUADRANT	_	_	_	2.5	0	21.04
	S.W. QUADRANT	_	_	_	1.5	0	34.01
	S.W. QUADRANT				1.5	0	54.01
	FAP 360 (IL 25 AND LAKE MARIAN RD.)						
	N.W. QUADRANT	-	-	-	3.0	0	15.80
	S.W. QUADRANT	-	-	-	4.5	0	28.75
	FAP 360 (IL 25 AND HAZARD RD.)						
	N.E. QUADRANT	-	-	_	3.0	0	14.46
	S.E. QUADRANT	-	-	-	3.0	0	28.27
	FAP 360 (IL 25 AND BERKLEY ST.)						7.00
	N.W. QUADRANT	-	-	-	2.0	0	7.28
	S.W. QUADRANT	-	-	-	1.5	0	4.95
	FAP 360 (IL 25 AND ROBIN RD.)						
	N.W. QUADRANT	-	-	-	0	0	1.32
	S.W. QUADRANT	-	-	-	0	0	9.59
	S.E. QUADRANT	-	-	-	2.0	0	4.77
	FAP 360 (IL 25 AND FIR ST.)						
	N.E. QUADRANT	_	-	-	1.5	0	7.98
	N.E. GOADITANT				1.5	0	1.50
	FAP 360 (IL 25 AND KINGS RD.)						
	N.W. QUADRANT	-	-	-	3.5	0	18.85
	N.E. QUADRANT	-	-	-	2.0	0	10.30
	S.W. QUADRANT	-	-	-	1.5	0	6.05
	FAP 360 (IL 25 AND HELM RD.)				2.5		10.00
	N.E. QUADRANT	-	-	-	2.5	0	10.60
	S.W. QUADRANT	-	-	-	3.5	0	19.43
	S.E. QUADRANT	-	-	-	2.0	0	18.50
	PROJECT TOTAL		1		44.0	0	654*


* ADDITIONAL QUANTITY IS FOR COMB. CONCRETE CURB AND GUTTER REMOVAL AND REPLACEMENT

FILE NAME =	USER NAME = bartonrw	DESIGNED -	RWB	REVISED -			IL 25	FROM	II 72 ⁻	TO BOLZ ROAD		F.A.P. RTF.	SECTION	COUNTY	TOTAL SHEET SHEETS NO.
pw://IL084EBIDINTEG.1111no1s.gov:PWIDOT/Do	cuments\IDOT_Offices\District_1\Projects\D141	1 01R0AWWD ata\Design\	RWB716-sht-schedule.dg	REVISED -	STATE OF ILLINOIS					UANTITIES		360	93RS-2	KANE	52 17
	PLOT SCALE = 100.0000 ' / in.	CHECKED -		REVISED -	DEPARTMENT OF TRANSPORTATION		3			UANTITLS		_		CONTRAC	T NO. 62C99
Default	PLOT DATE = 2/7/2017	DATE -	1/20/2017	REVISED -		SCALE:	SHEET 1	0F 1	SHEET	TS STA.	TO STA.		ILLINOIS FED. 4	AID PROJECT	



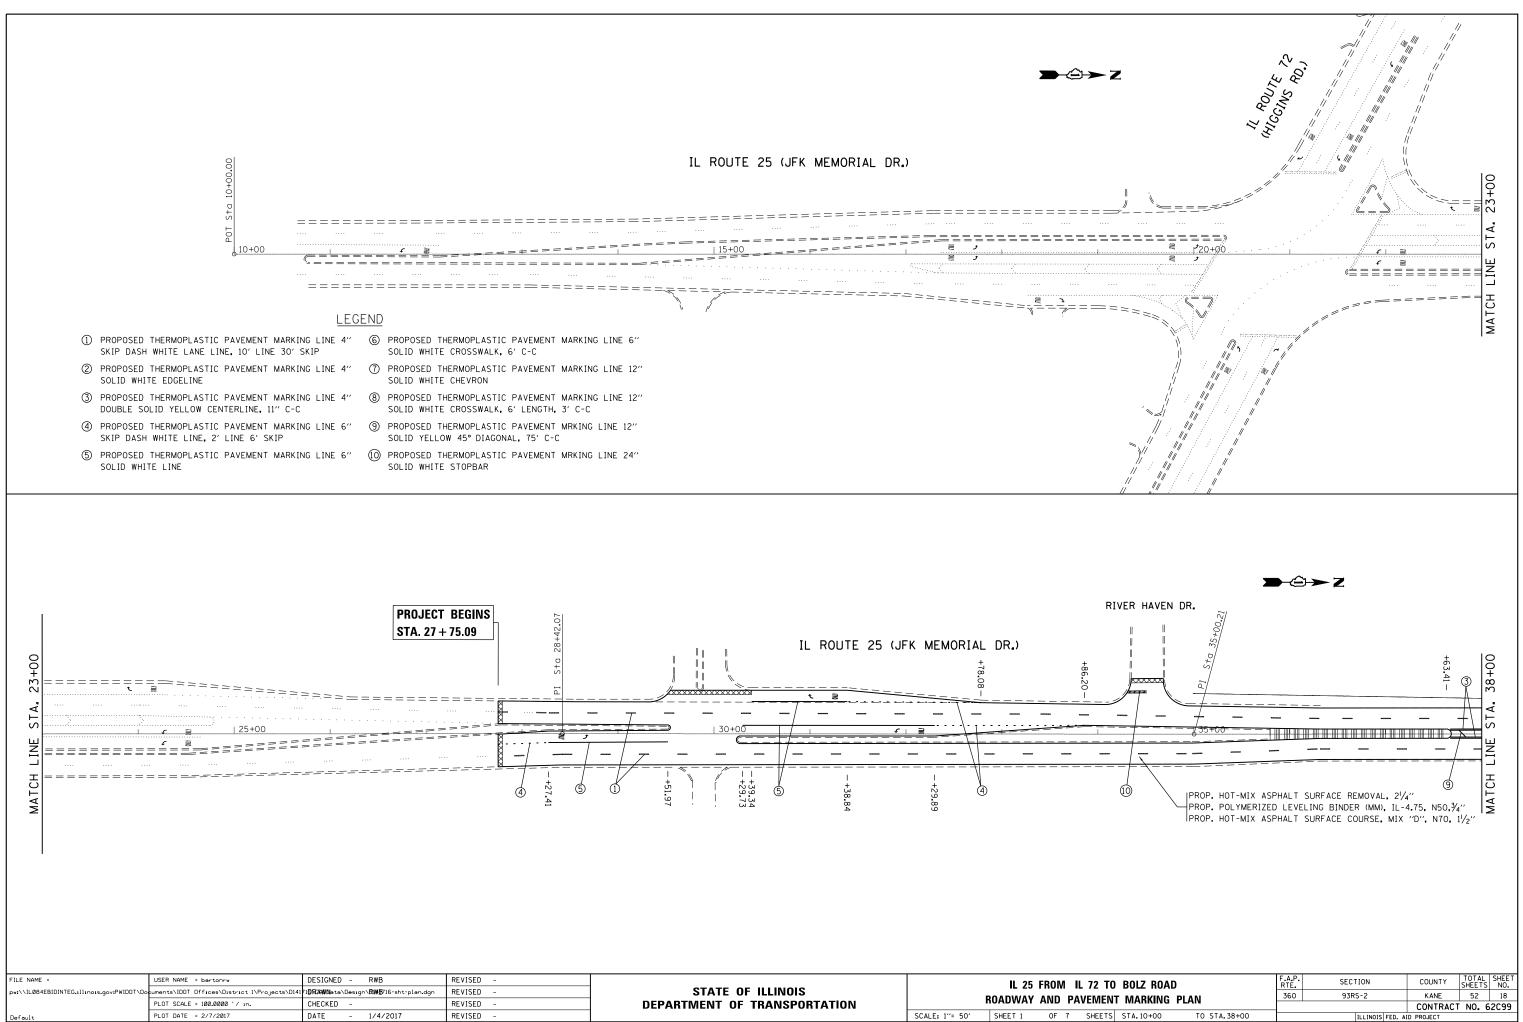

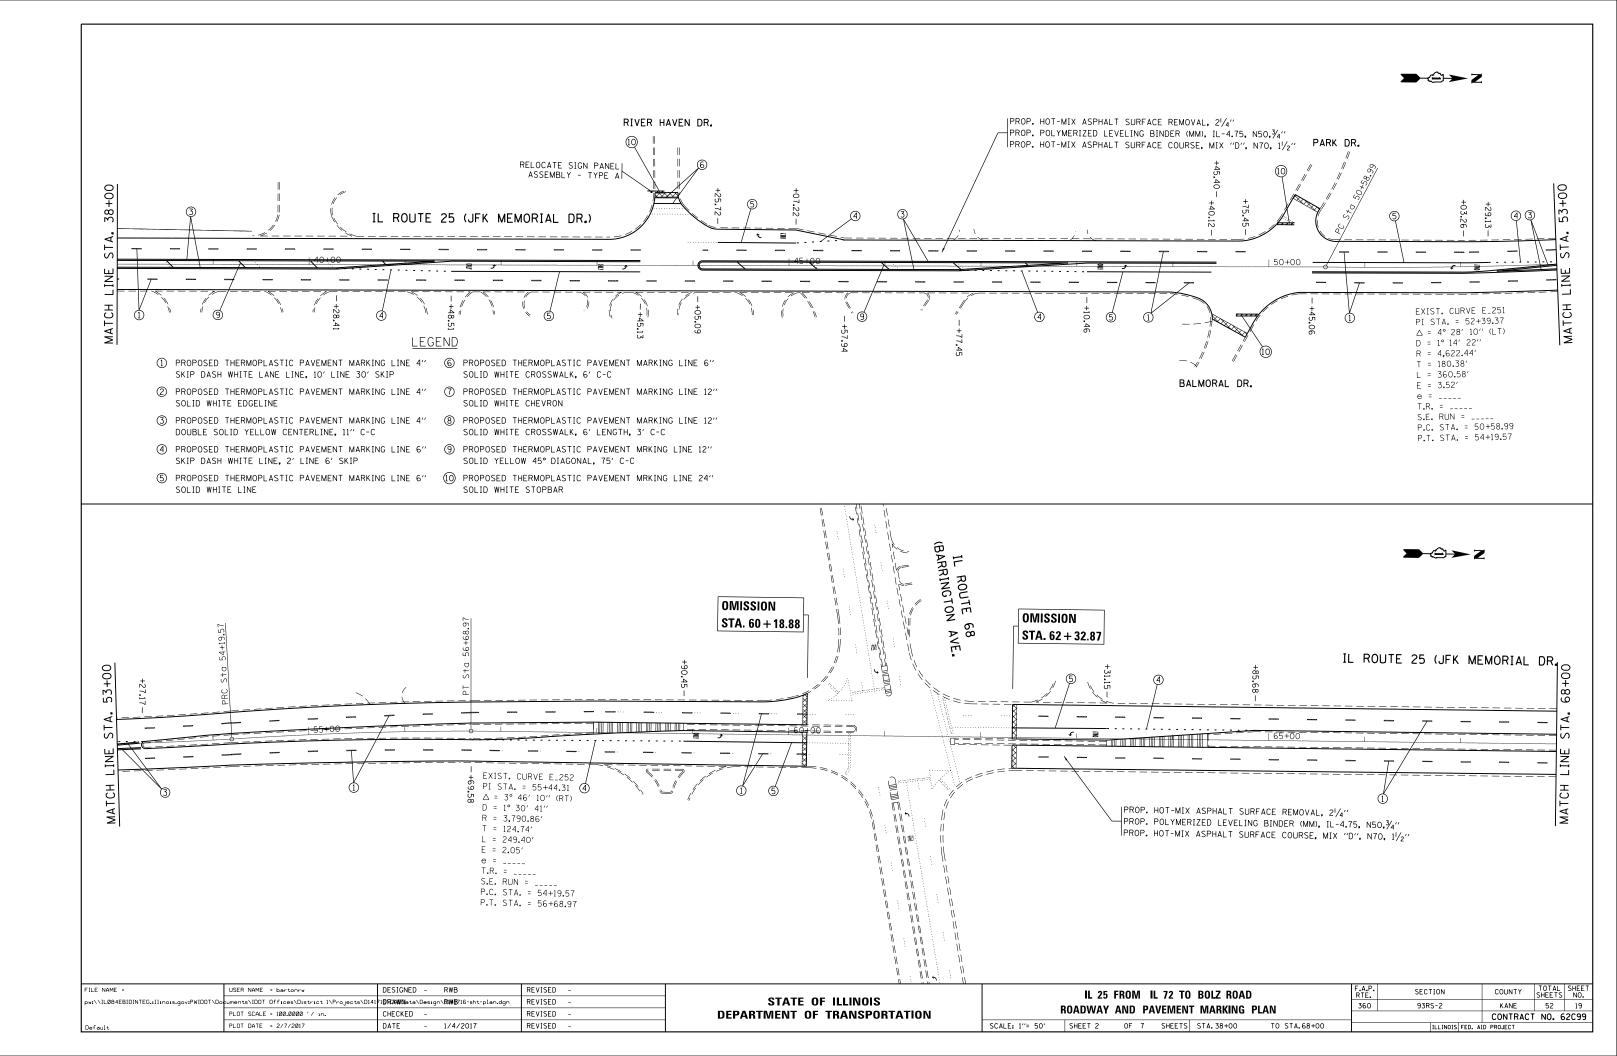


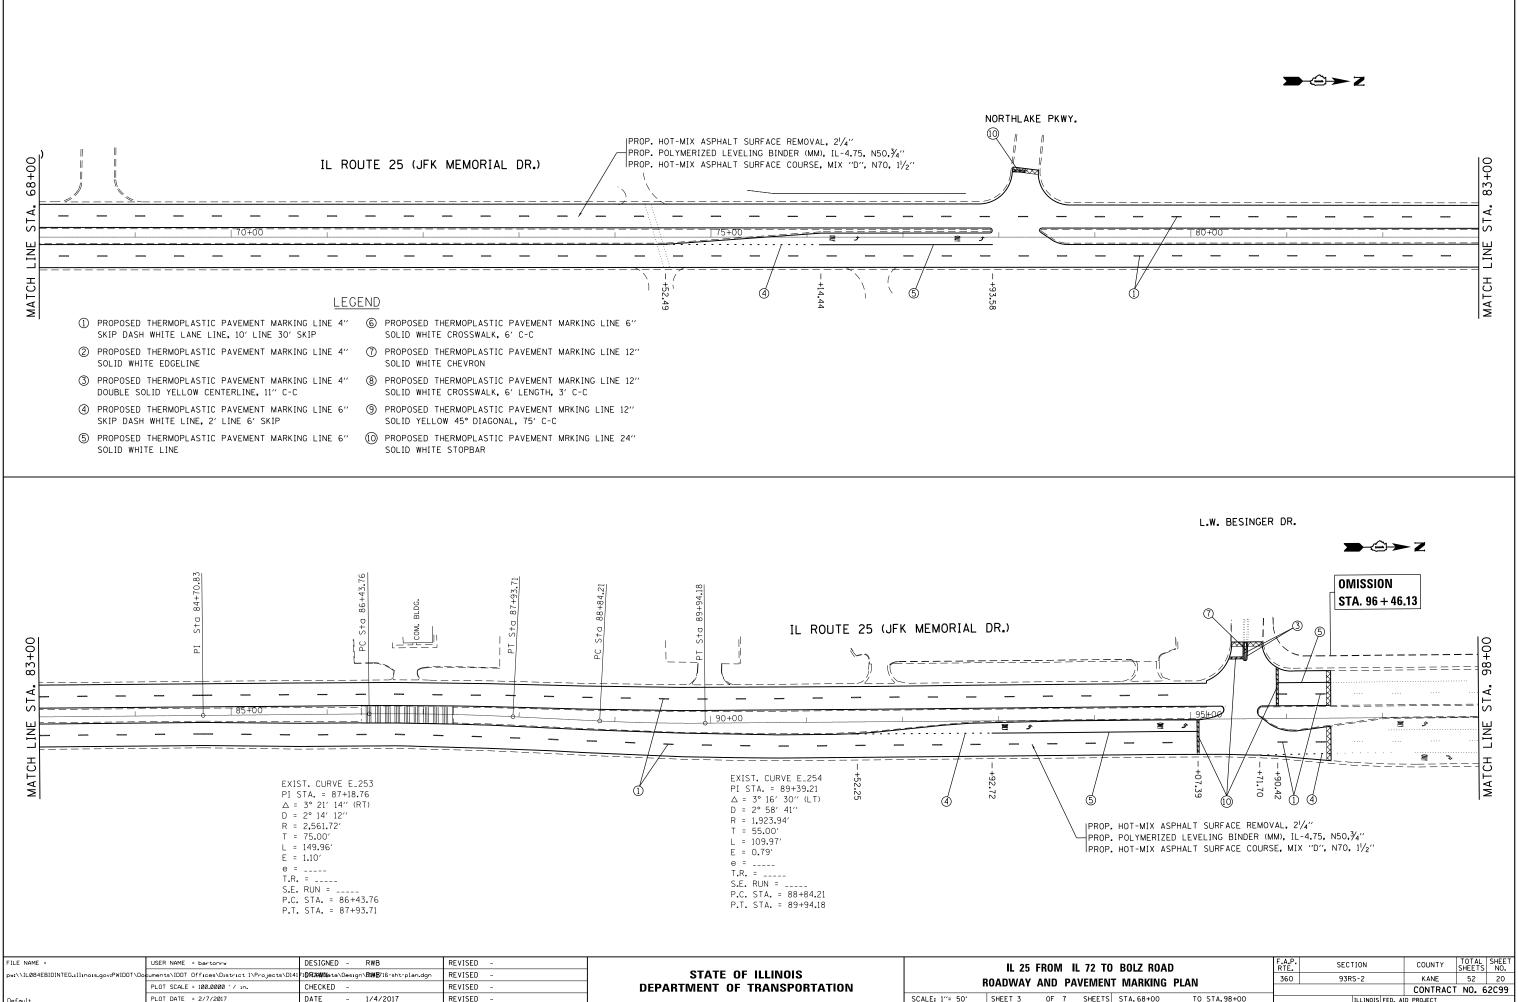



1/4/2017




SCALE: 1"= 50' SHEET 3 OF 7 SHEETS STA. 68+00 TO STA.98+00 ILLINOIS FED. AID PROJECT

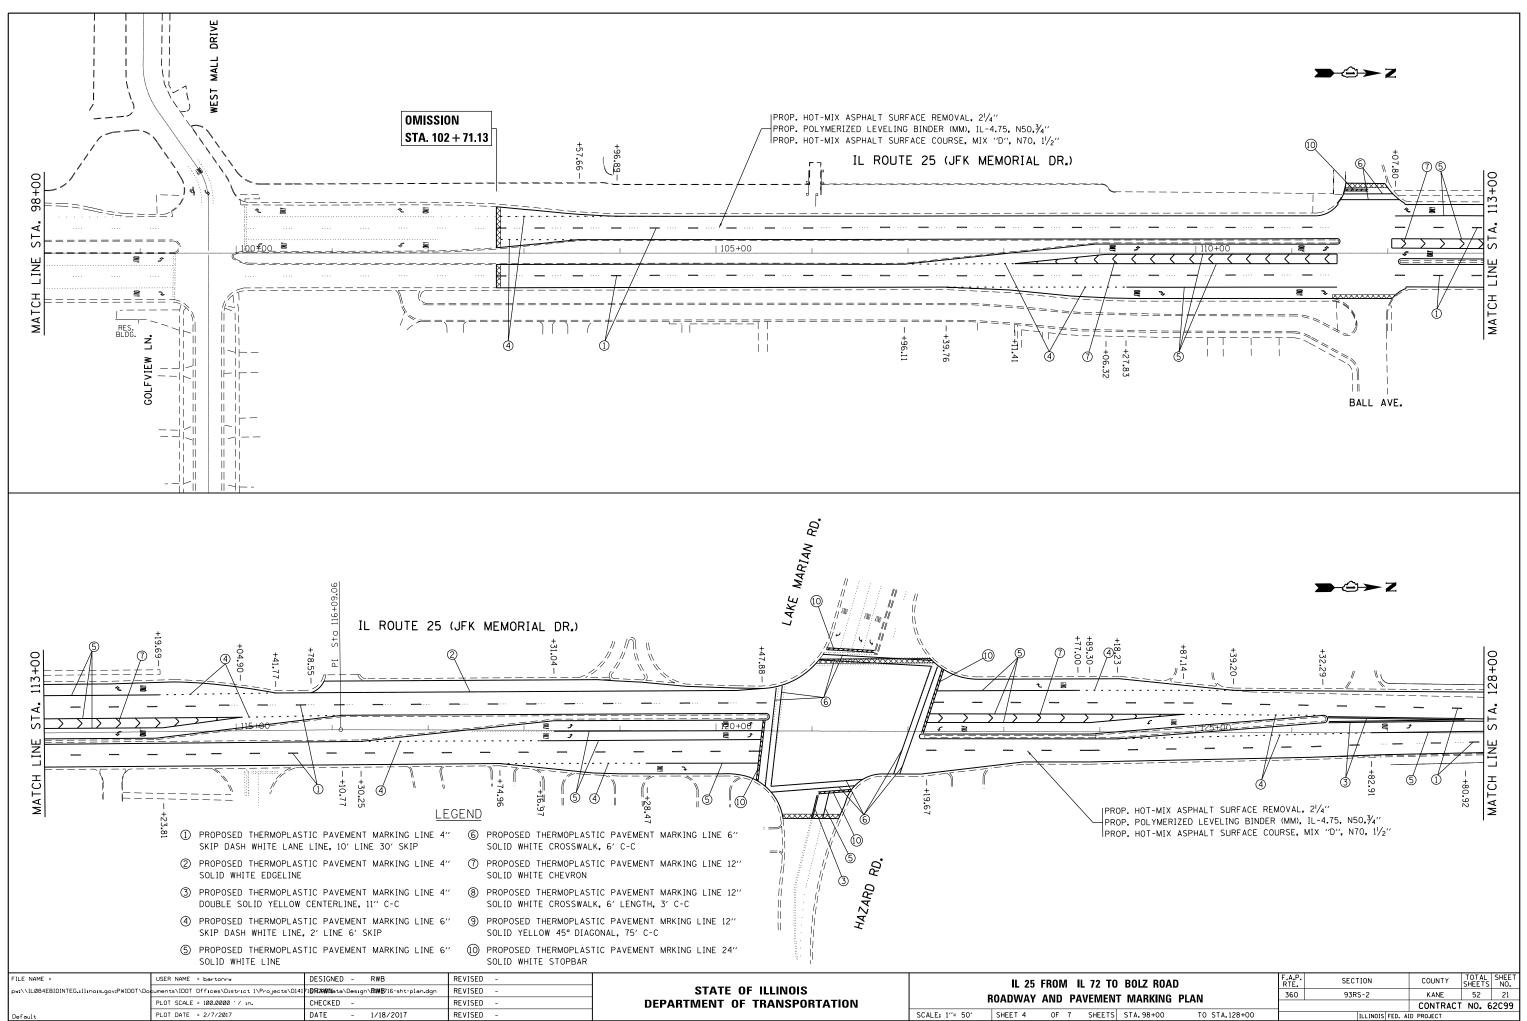


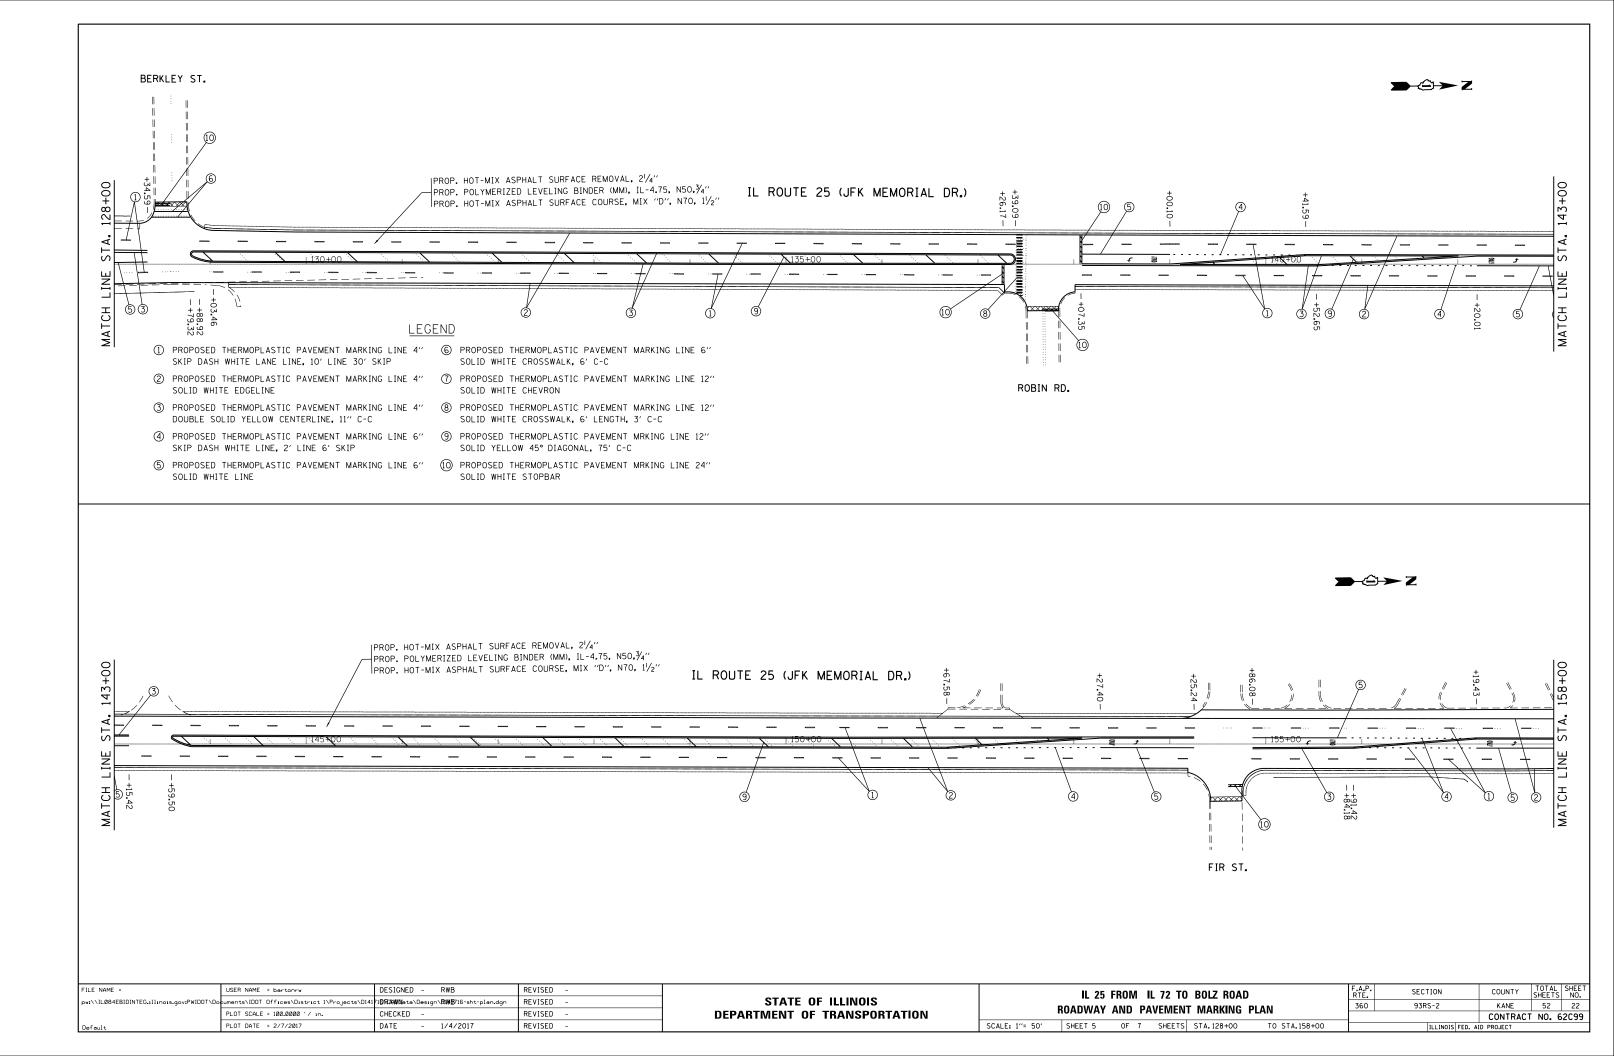


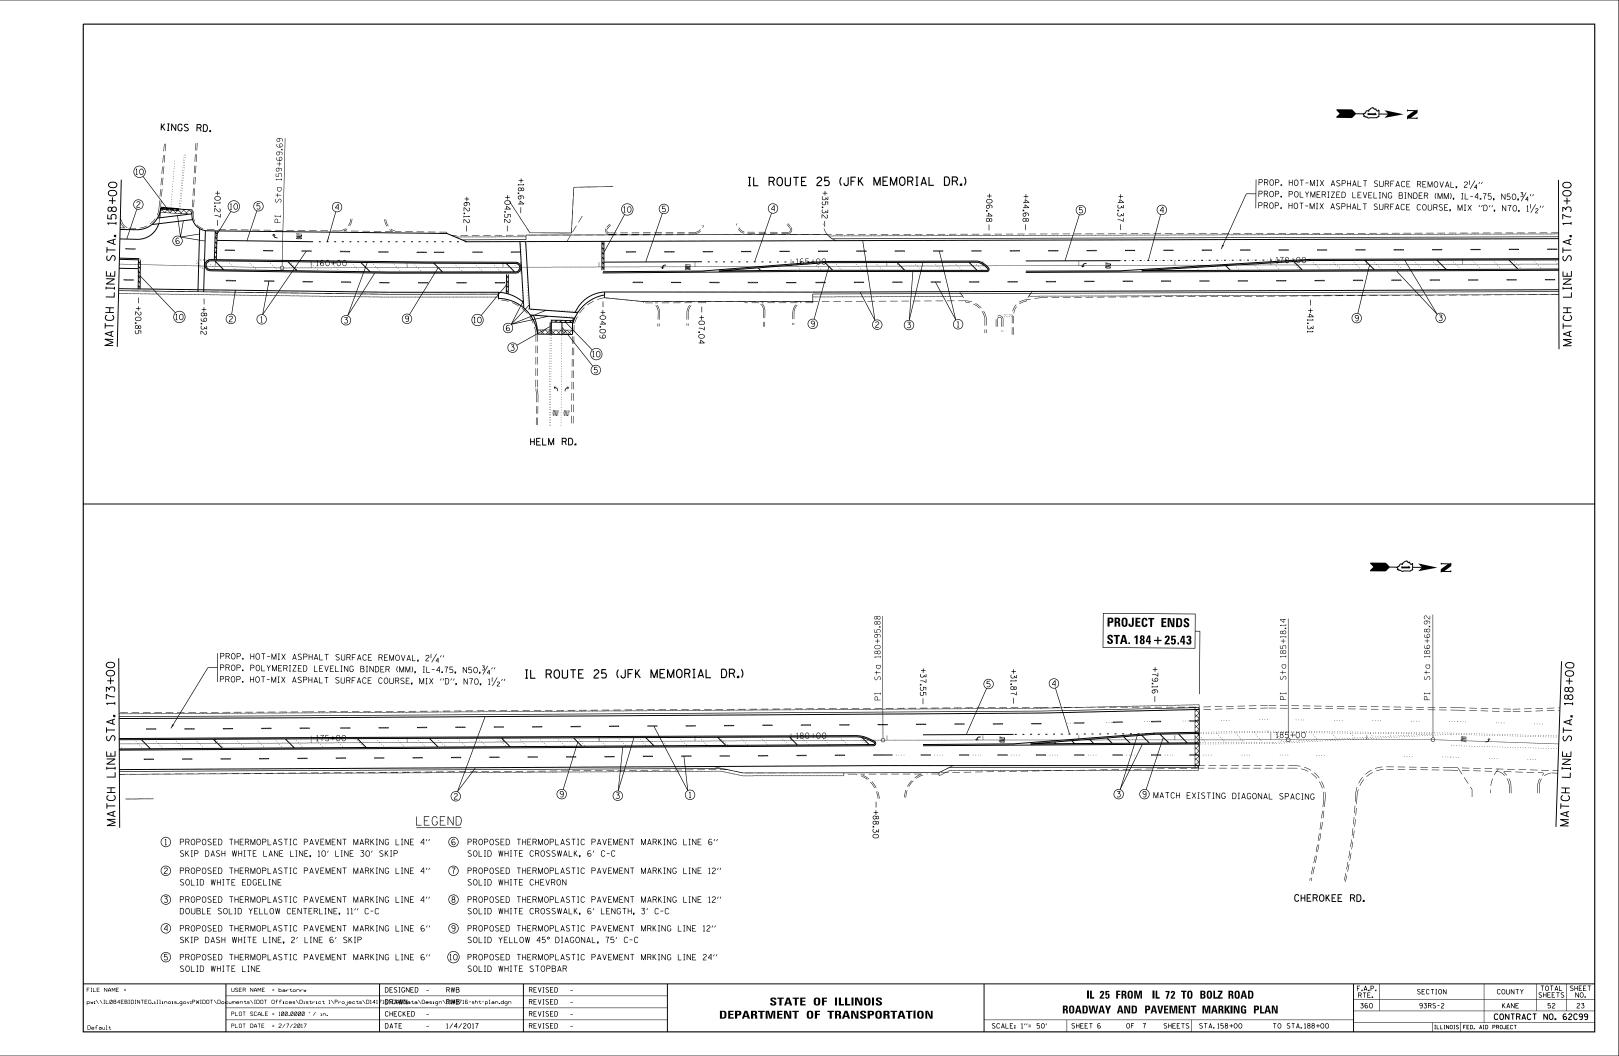

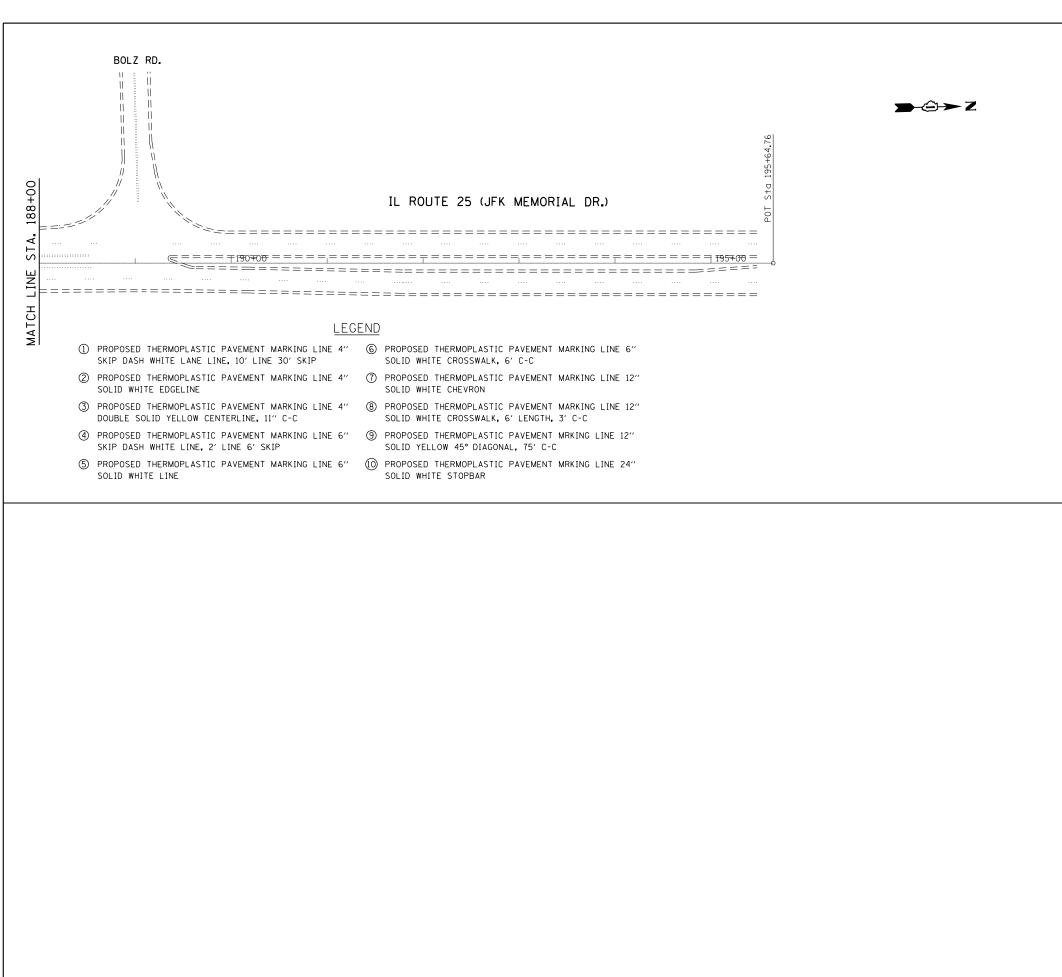


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pw:\\IL084EBIDINTEG.1111no1s.gov:PWIDOT\Do	cuments\IDOT_Offices\District_1\Projects\D14	171 07724WD ata\Design\ R1WB 716-sht-plan.dgn	REVISED -	STATE OF ILLINOIS	ROADWAY AND PAVEMENT MARKING PLAN	360 93RS-2	KANE 52 24
	PLOT SCALE = 100.0000 ' / 10.	CHECKED -	REVISED -	DEPARTMENT OF TRANSPORTATION		-	CONTRACT NO. 62C99
Default	PLOT DATE = 2/7/2017	DATE - 1/4/2017	REVISED -		SCALE: 1"= 50" SHEET 7 OF 7 SHEETS STA. 188+00 TO STA. 195+00	ILLINOIS FED.	AID PROJECT

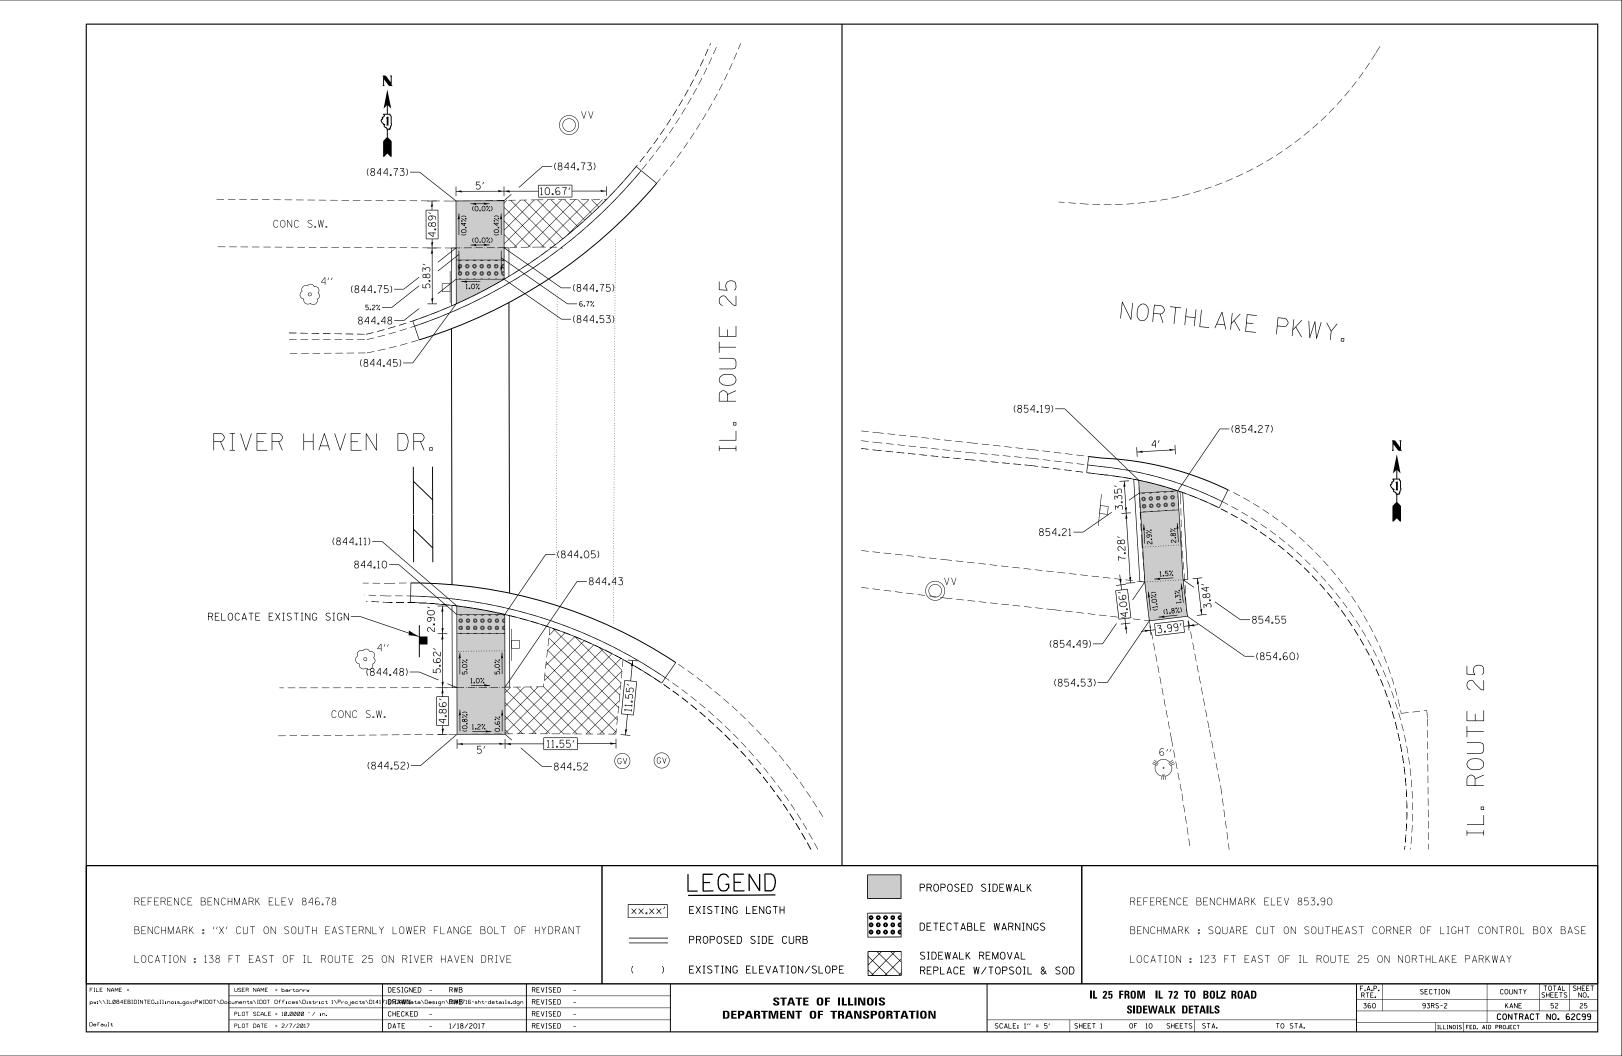


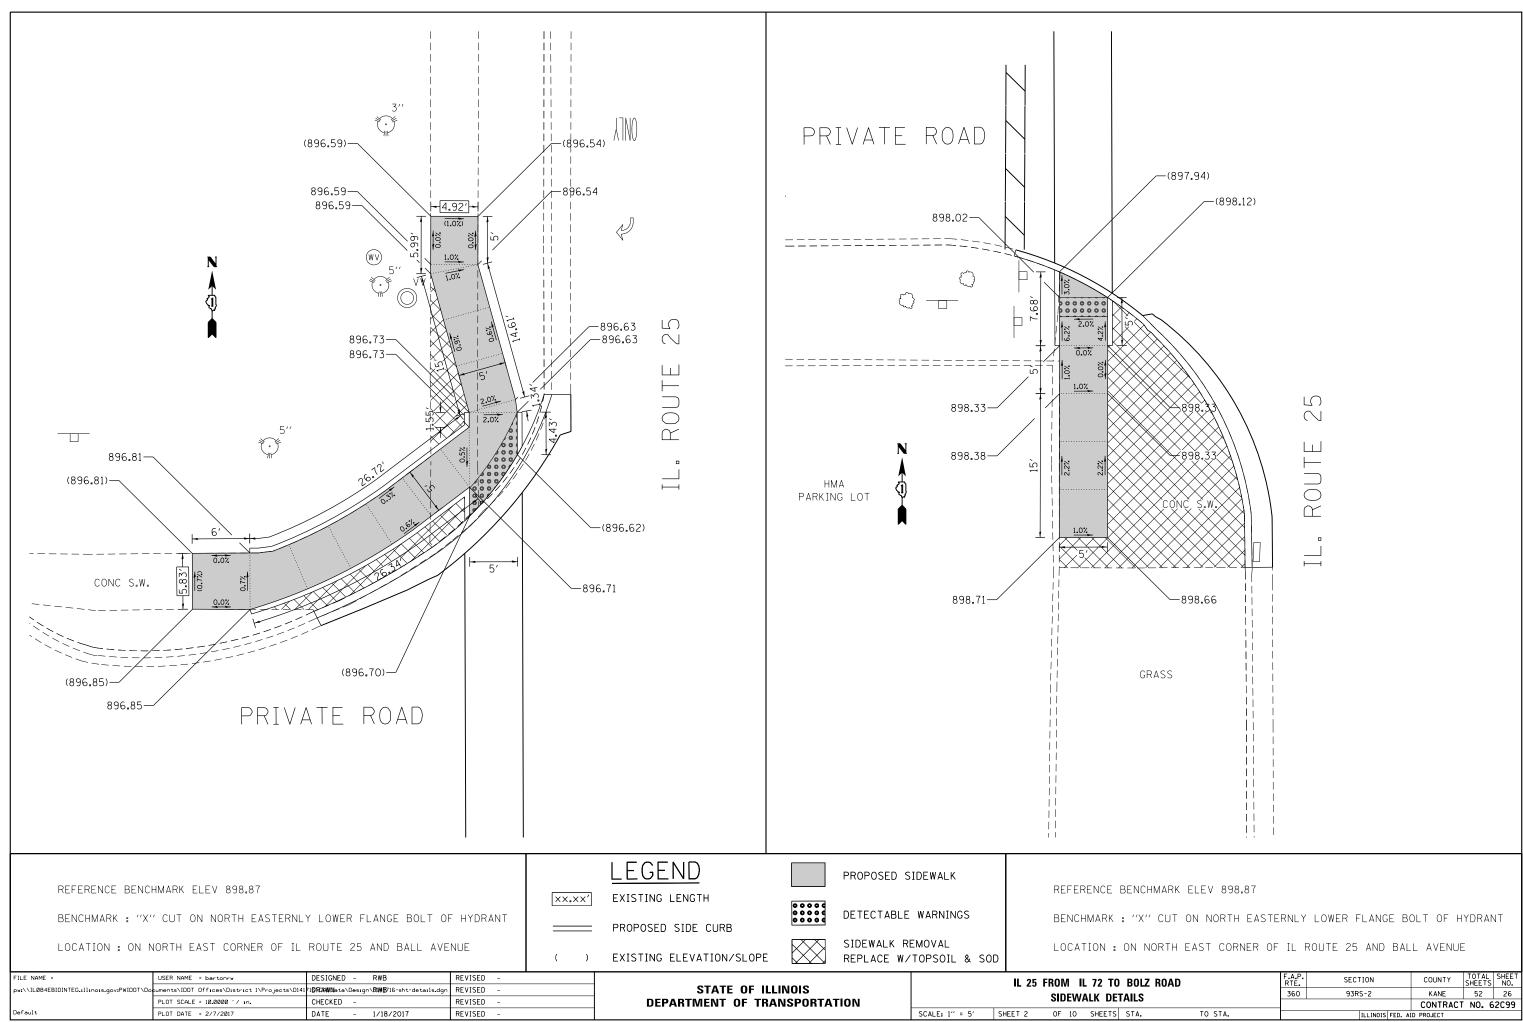


то	BOLZ ROAD		F.A.P. RTE.	SECTION	COUNTY	TOTAL SHEETS	SHEET NO.
)E1	TAILS		360	93RS-2	KANE	52	26
_					CONTRACT	NO. 6	2099
rs	STA.	TO STA.		ILLINOIS FED. A	ID PROJECT		

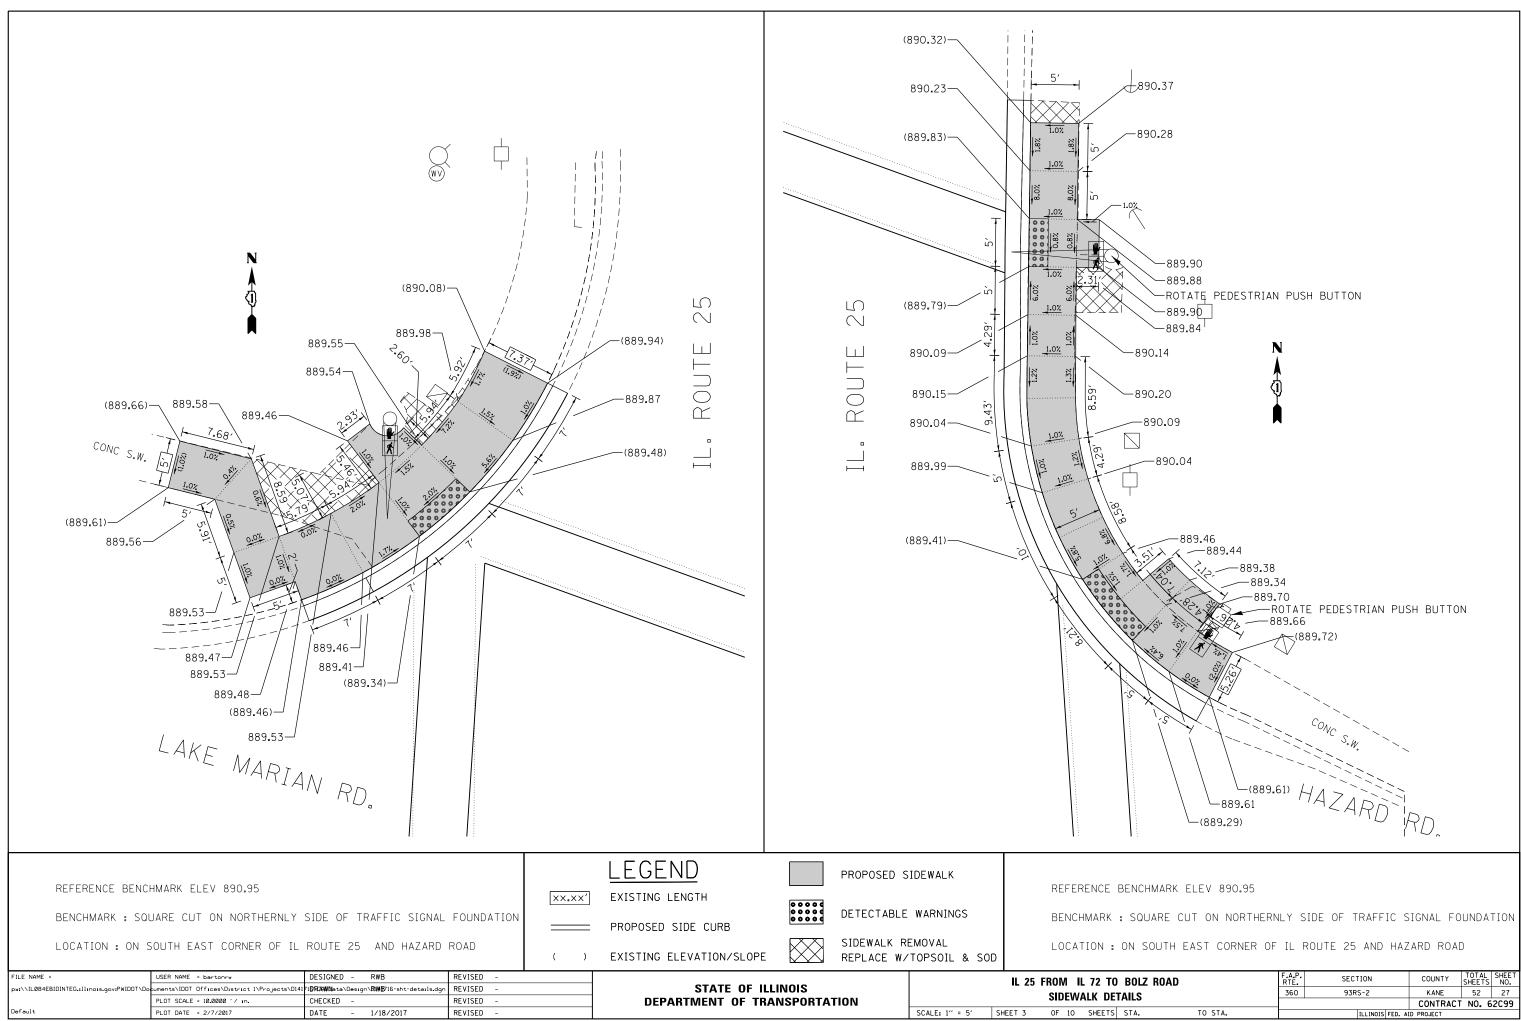


v			1116				JULLIS	110.	
E٦	TAILS		360	93RS	-2	KANE	52	27	ĺ
						CONTRACT	NO. 6	52099	
5	STA.	TO STA.		I	LLINOIS FED. A	D PROJECT			ĺ
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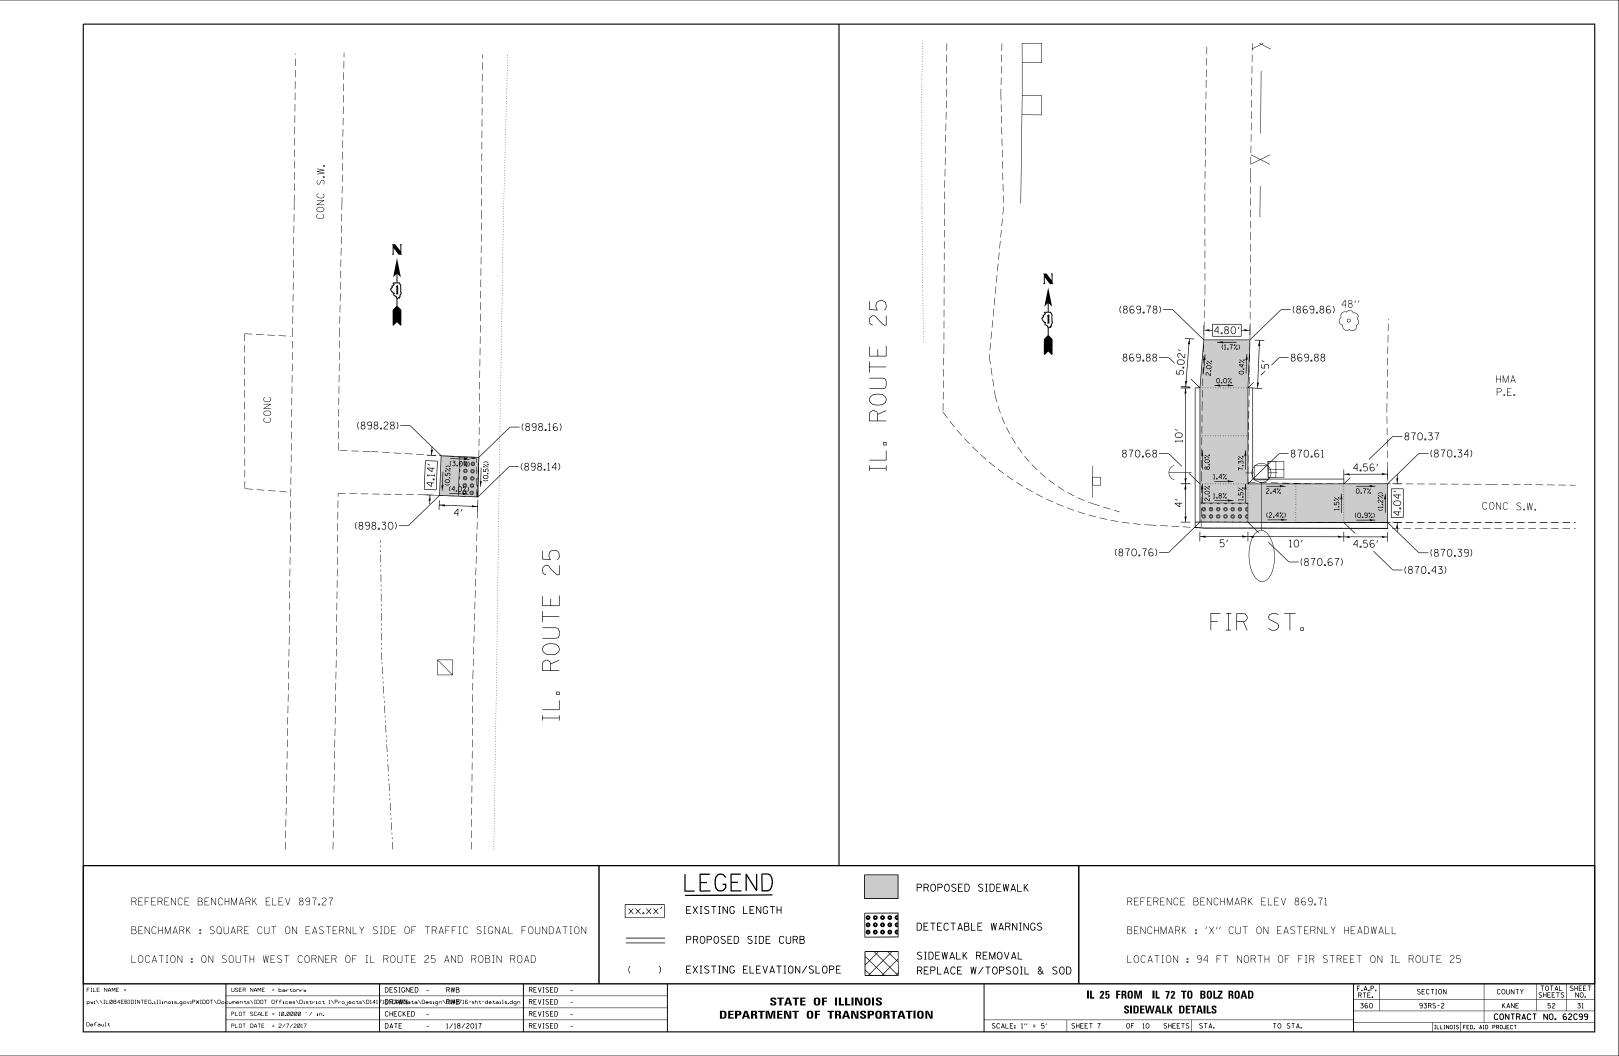


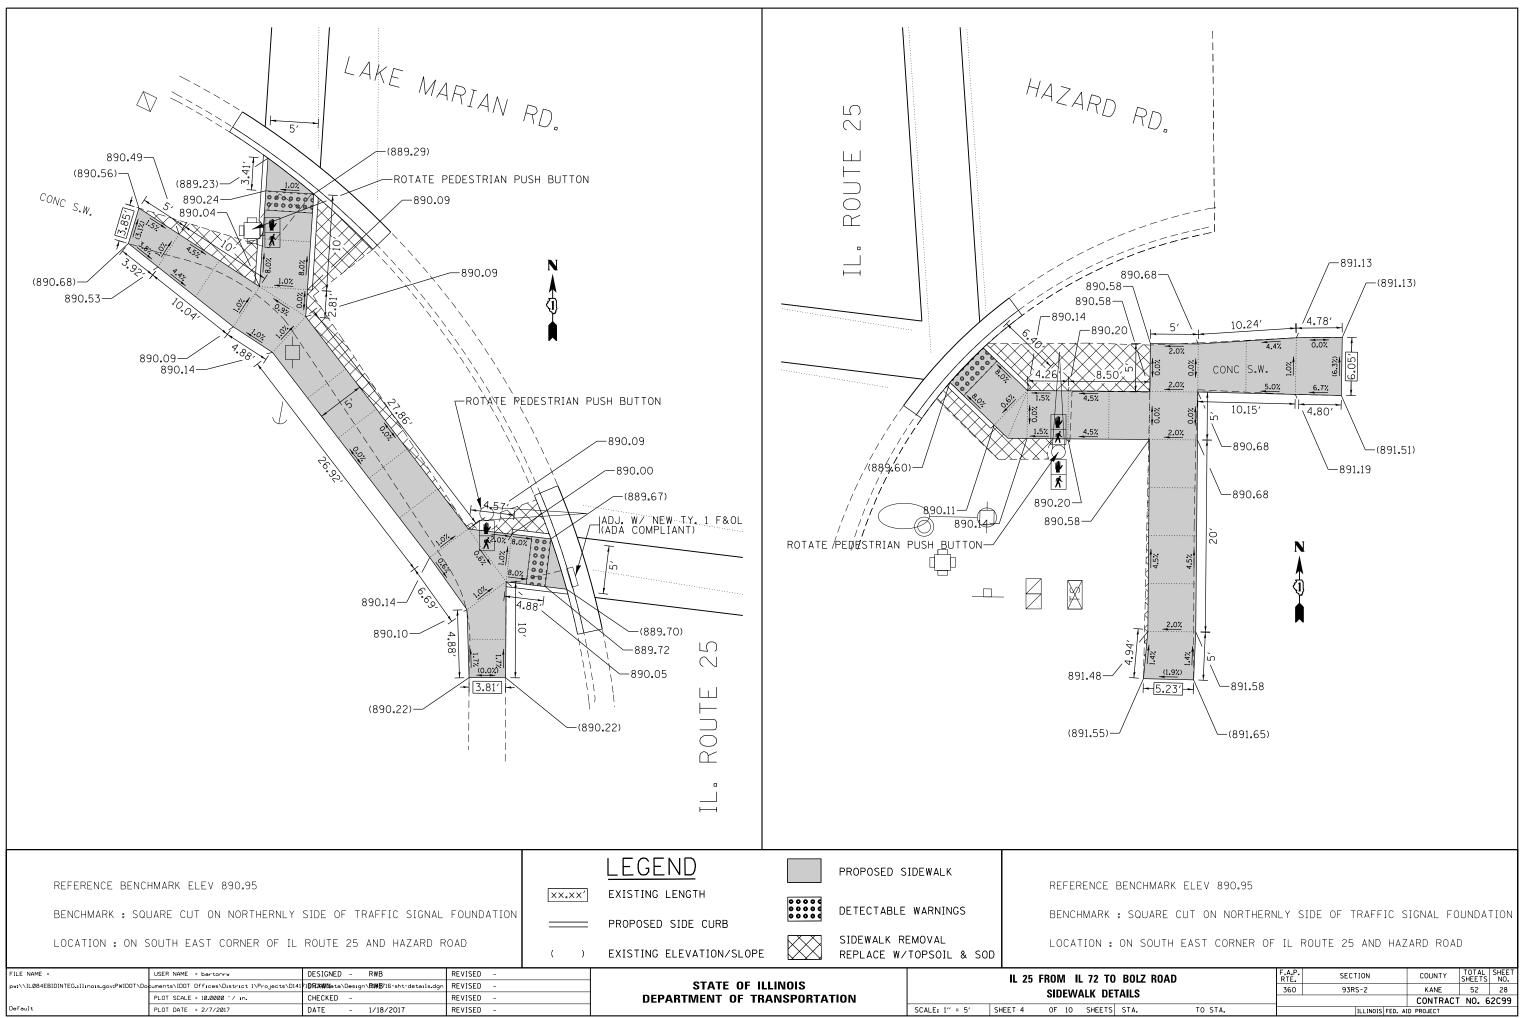
FT	AILS		360	93RS-2		KANE	52	28
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S	STA.	TO STA.		ILLINOIS	FED. A	D PROJECT		



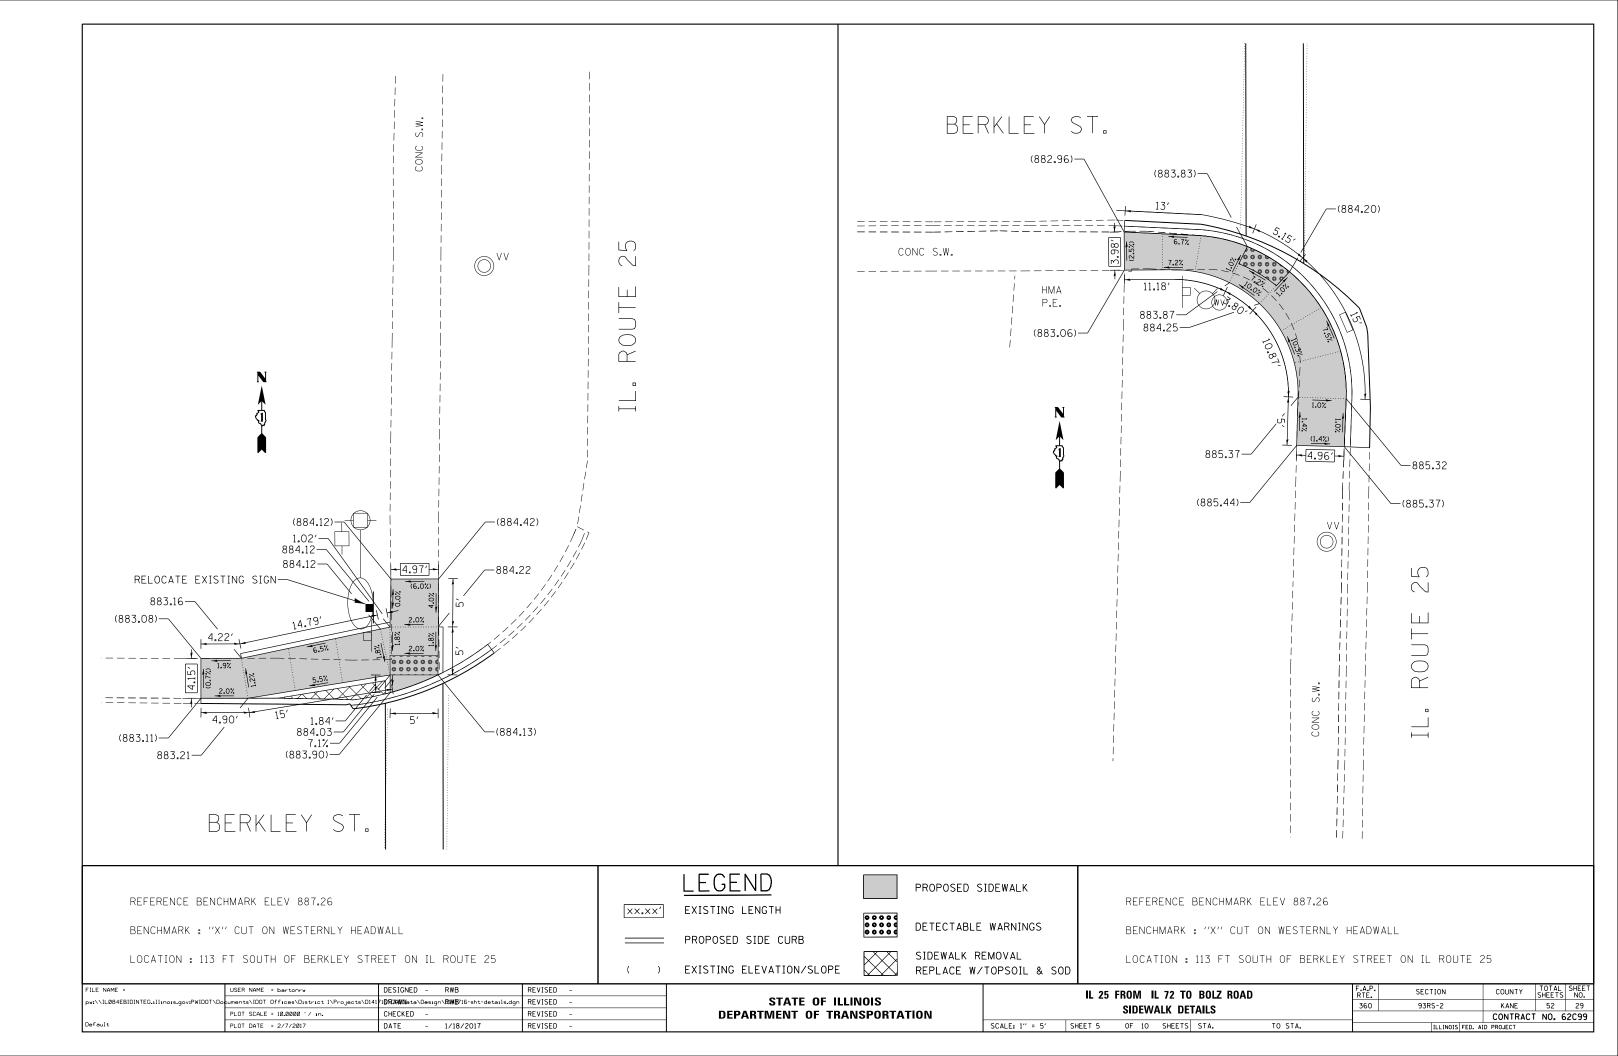


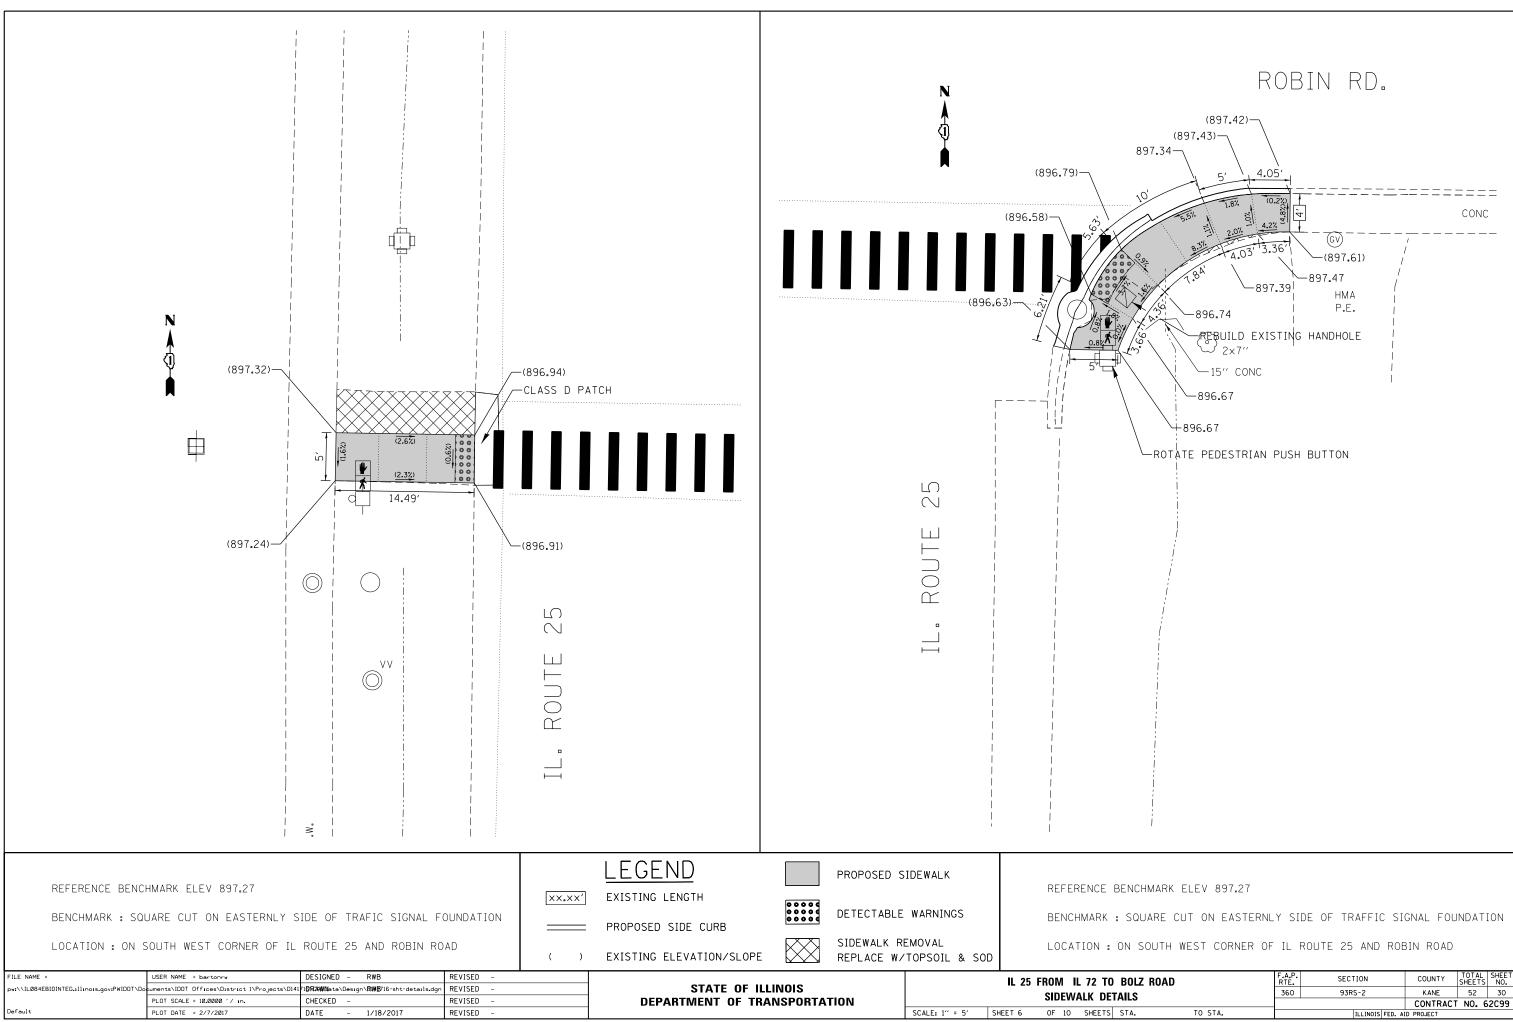
360 93RS-2 KANE 52	
DETAILS JOU 93R5-2 KAINE J2	30
CONTRACT NO.	62C99
TS STA. TO STA. ILLINOIS FED. AID PROJECT	



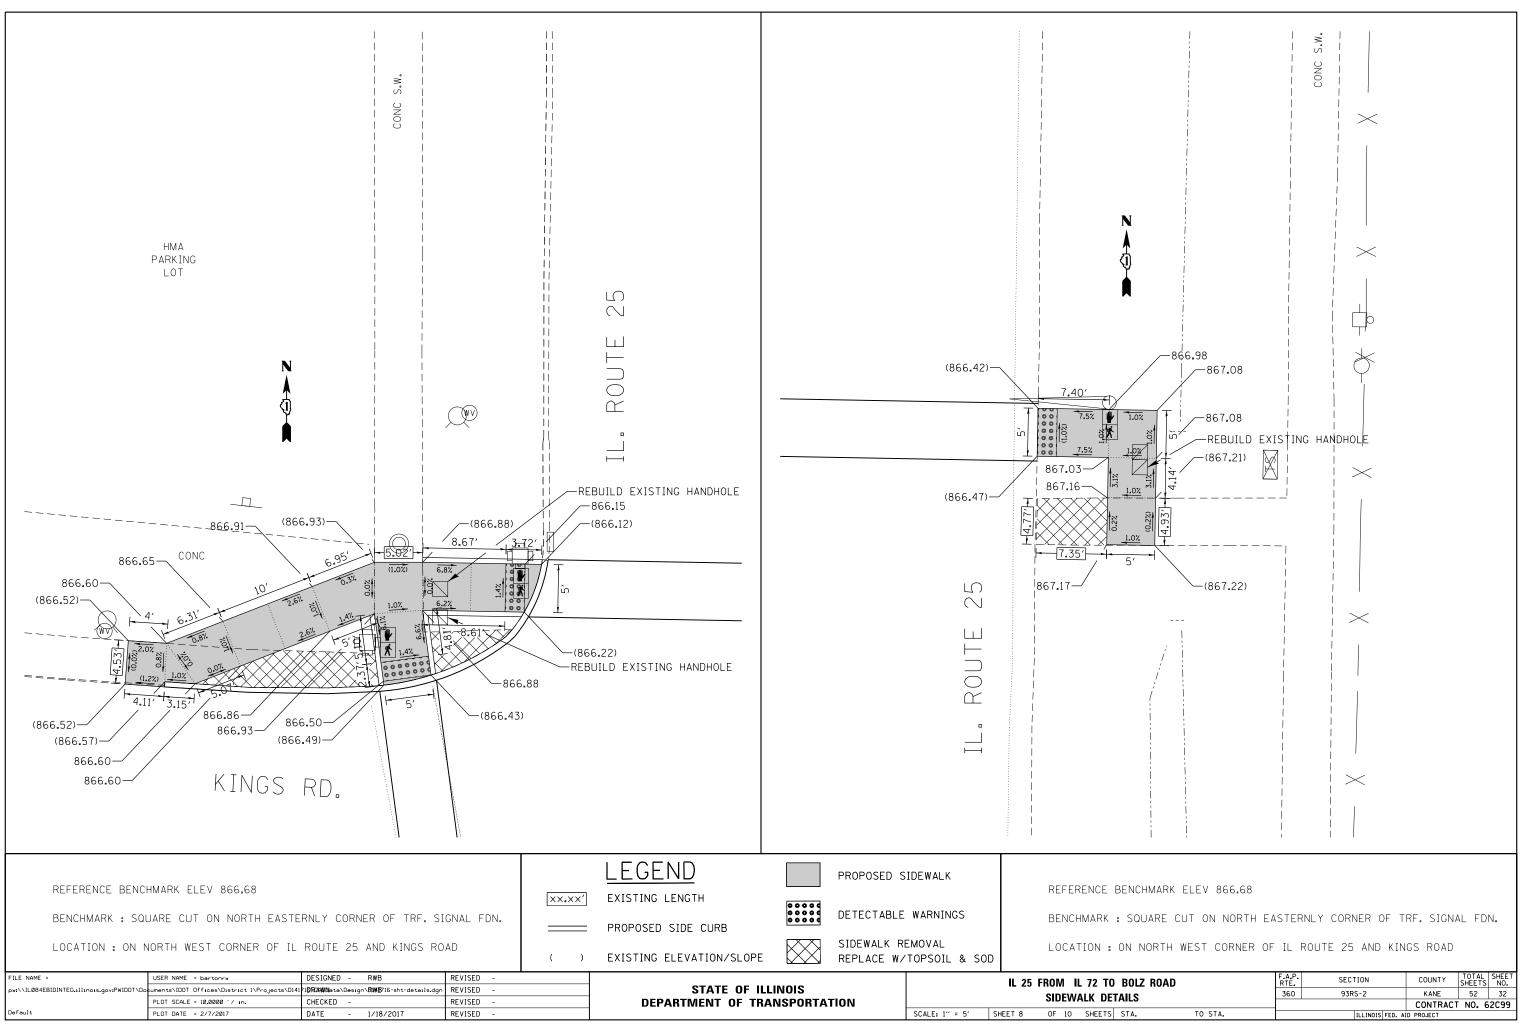


								DITELIO	1101
۱E.	TAILS STA. TO STA.		360 93RS-2			KANE	52	32	
<u>, r</u>	TAILS						CONTRACT	NO. 6	2099
TS	STA.	TO STA.			ILLINOIS	FED. A	D PROJECT		

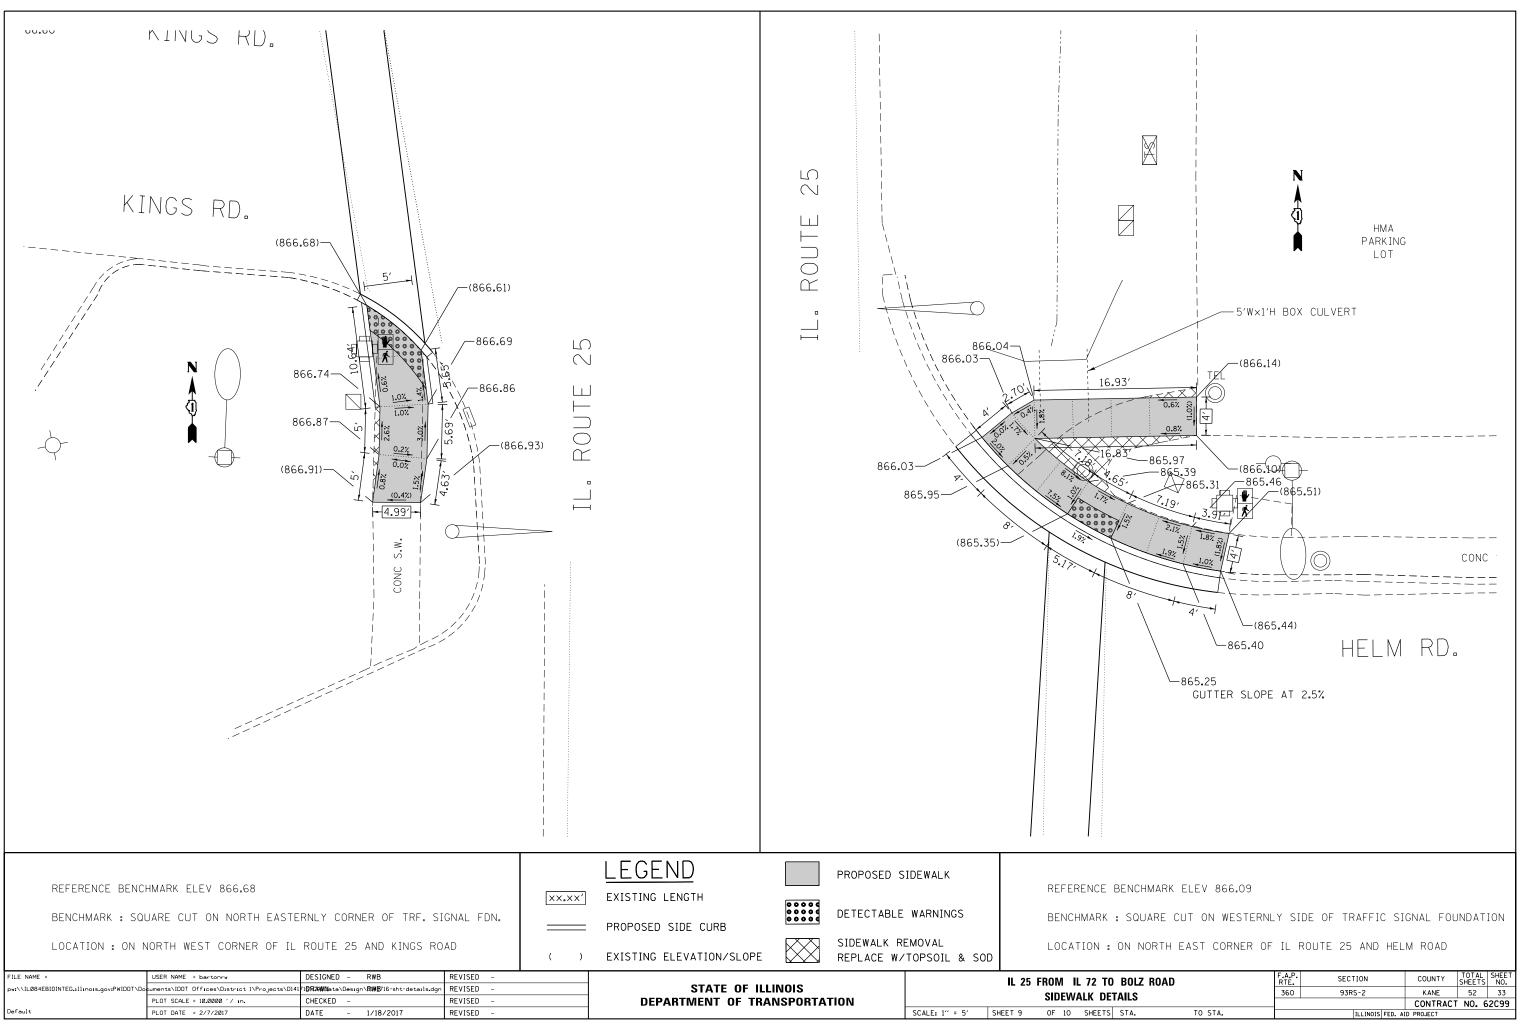

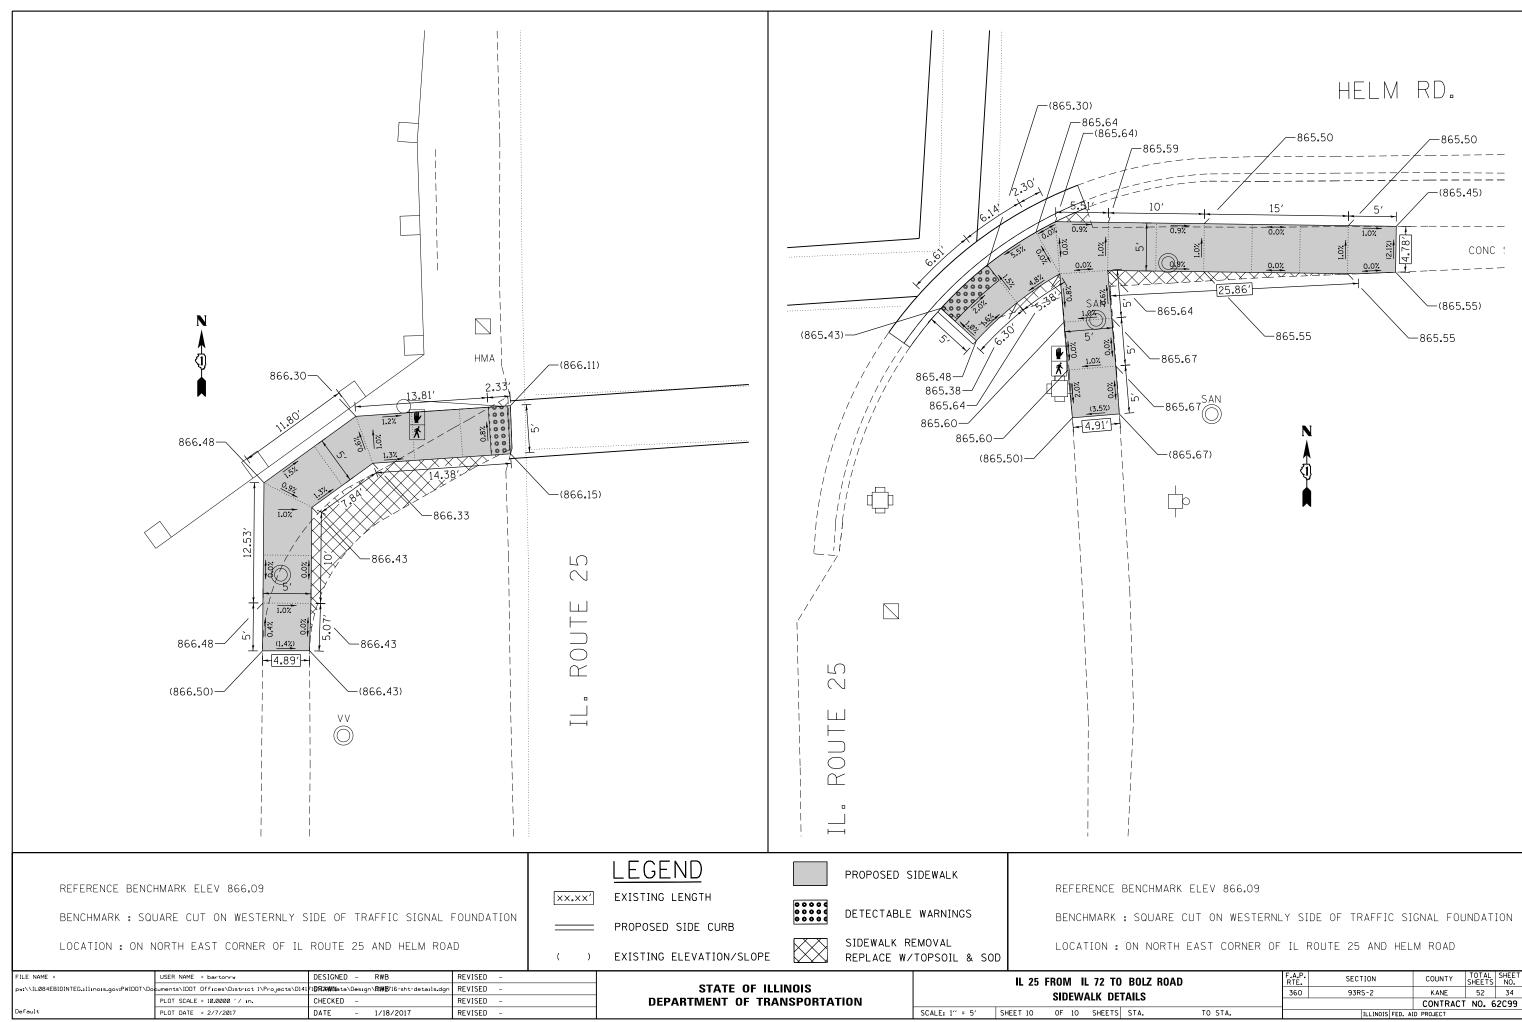

то	BOLZ F	ROAD	F.A.P. RTE.	SECTION	COUNTY	TOTAL SHEETS	SHEET NO.			
)E1	TAILS		360	93RS-2	KANE	52	34			
				CONTRACT NO. 62C99						
٢S	STA.	TO STA.		ILLINOIS FED. A	ID PROJECT					

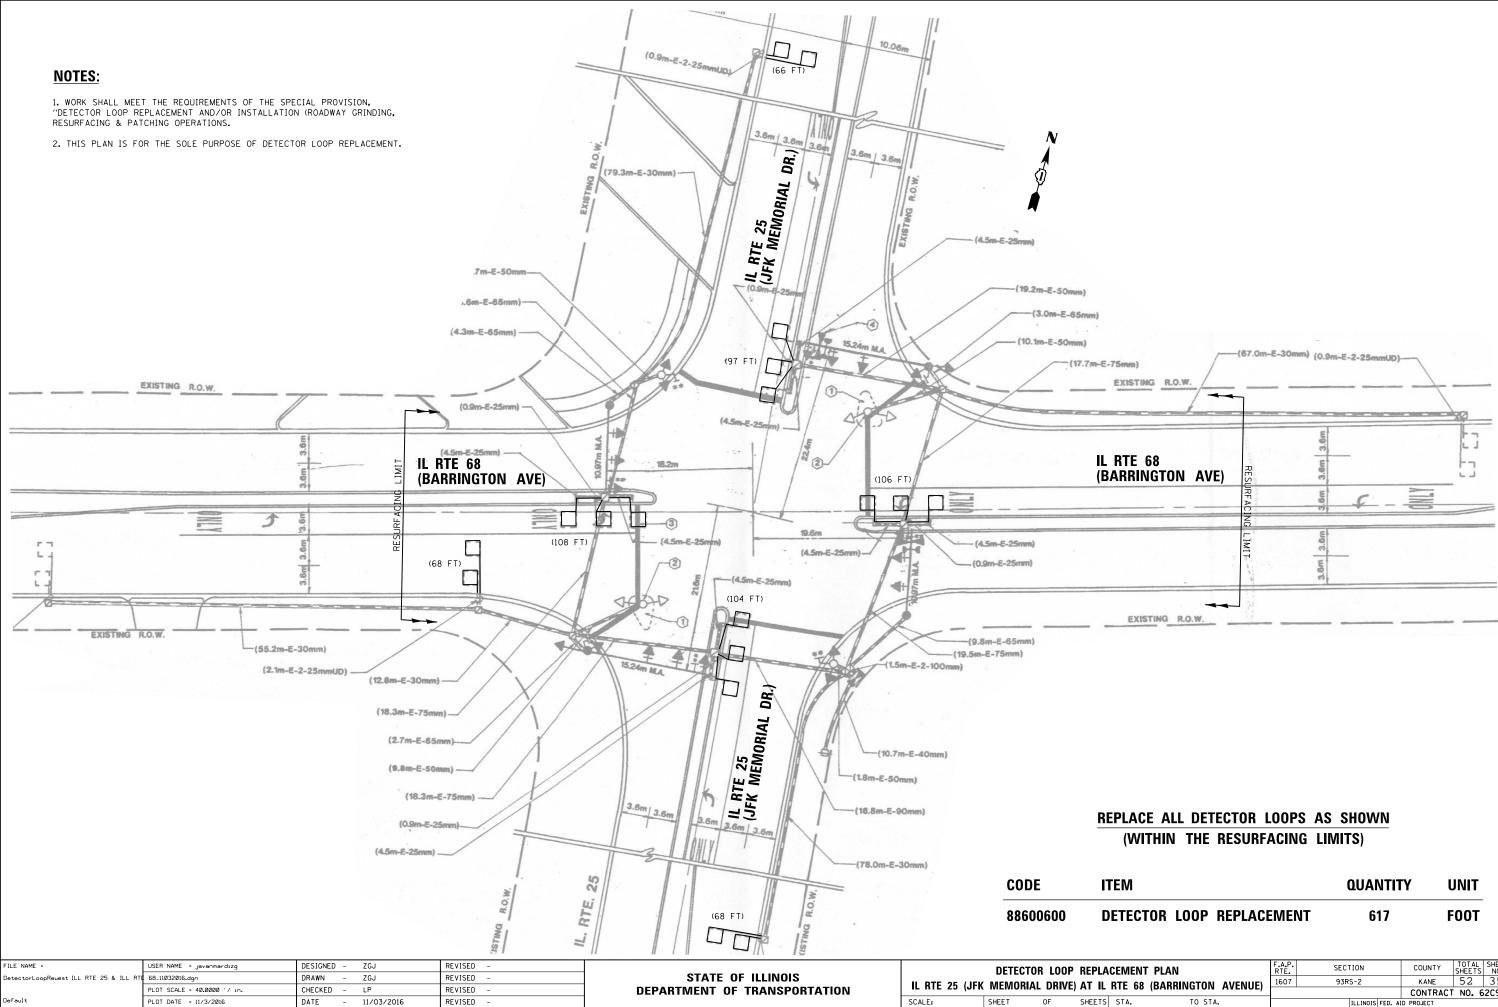


ITEM	QUANTITY	UNIT
		5007

LACEMENT PLAN	F.A.P. RTE	SECTION	COUNTY	TOTAL SHEETS	SHEET NO.
IL RTE 68 (BARRINGTON AVENUE)	1607	93RS-2	KANE	52	35
			CONTRACT	NO. 6	2C99
TS STA. TO STA.		ILLINOIS FED. AI	D PROJECT		

NOTES:

1. WORK SHALL MEET THE REQUIREMENTS OF THE SPECIAL PROVISION, "DETECTOR LOOP REPLACEMENT AND/OR INSTALLATION (ROADWAY GRINDING, RESURFACING & PATCHING OPERATIONS.

2. THIS PLAN IS FOR THE SOLE PURPOSE OF DETECTOR LOOP REPLACEMENT.

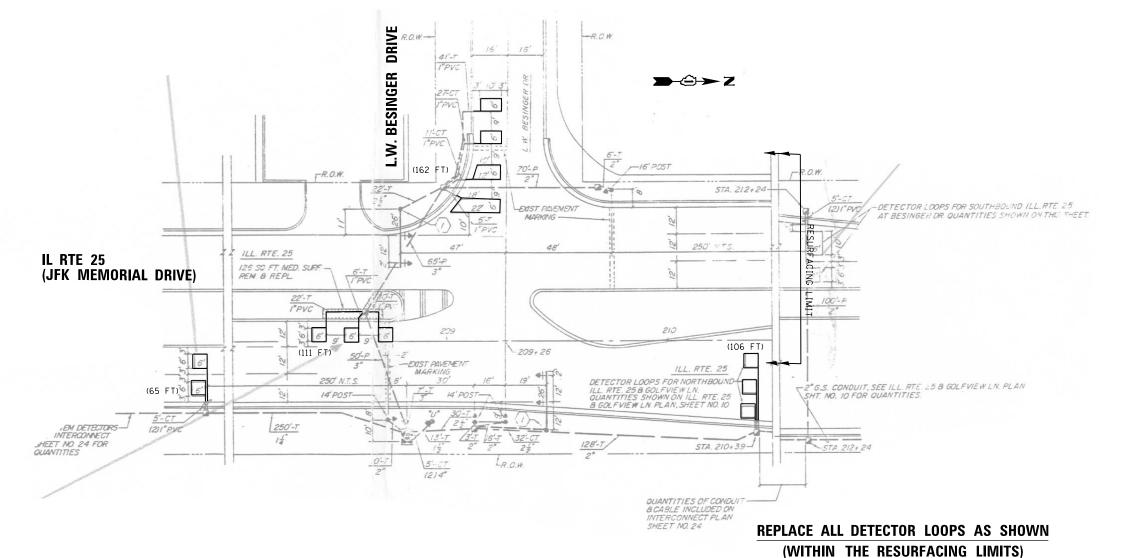

CODE

88600600


FILE NAME =	USER NAME = javanmardızg	DESIGNED - ZGJ	REVISED -			DETEC		OP REPLACEMENT	ΡΙΔΝ	F.A.P.	SECTION	COUNTY	TOTAL SHEET
DetectorLoopReuest ILL RTE 25 & L.W.BE	INGER DRIVE_11032016.dgn	DRAWN - ZGJ	REVISED -	STATE OF ILLINOIS				AL DRIVE) AT L.W. I		360	93RS-2	KANE	52 36
	PLOT SCALE = 40.0000 '/ in.	CHECKED – LP	REVISED -	DEPARTMENT OF TRANSPORTATION	IL N	NIE ZO (JEK I		AL DRIVE AT L.W.	BESINGER DRIVE			CONTRAC	T NO. 62C99
Default	PLOT DATE = 11/9/2016	DATE - 11/09/2016	REVISED -		SCALE:	SHEET	OF	SHEETS STA.	TO STA.		ILLINOIS FED. A	ID PROJECT	

(WITHIN THE RESURFACING LIMITS)

ITEM	QUANTITY	UNIT

DETECTOR LOOP REPLACEMENT

444 FOOT

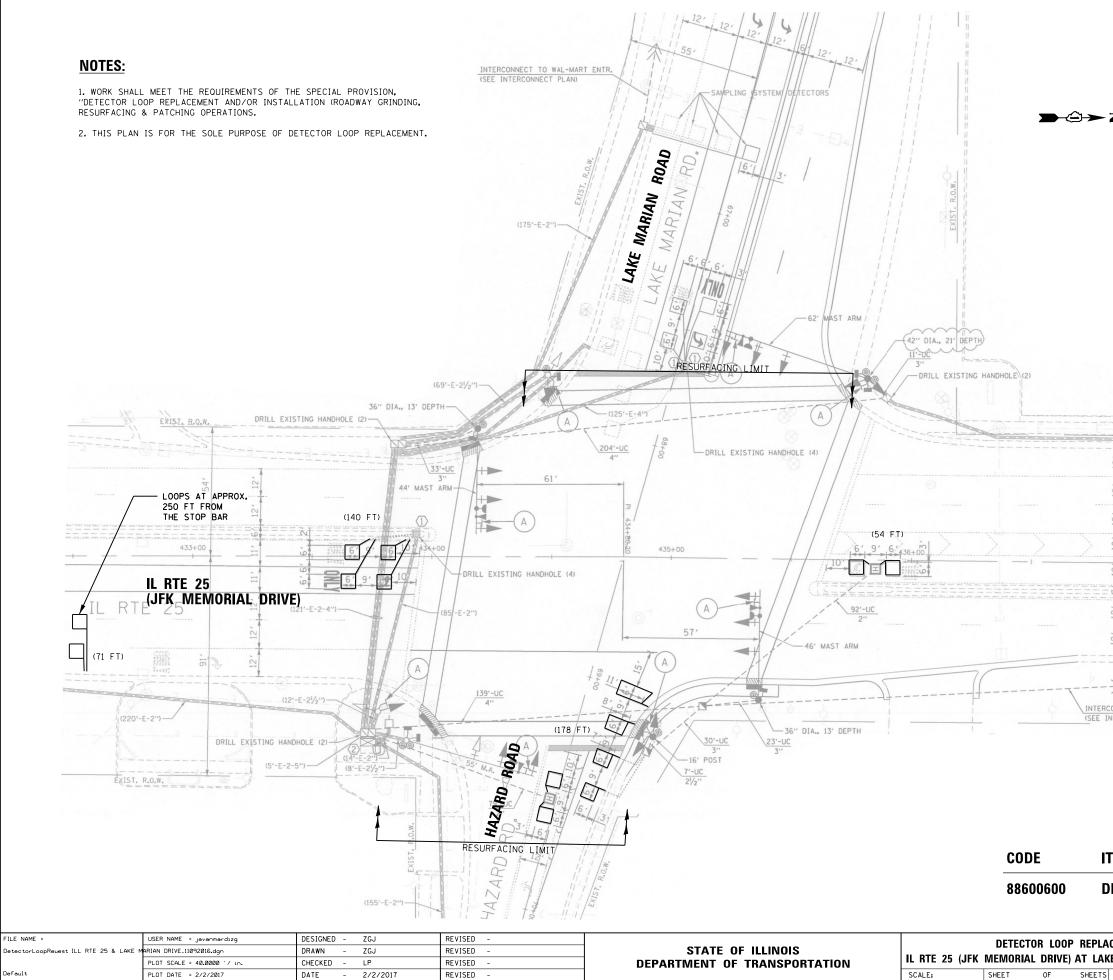


(225'-E-2")	0				
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IL RTE	25	DNIVE			
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			2. 		
	1 67,		·		
ECT TO ROBIN ROAD					
RCONNECT PLAN)	EXIS	0 ST. R.O.W.			

STA.	TO STA.	ILLINOIS FED. AID PROJECT

NOTES:

1. WORK SHALL MEET THE REQUIREMENTS OF THE SPECIAL PROVISION, "DETECTOR LOOP REPLACEMENT AND/OR INSTALLATION (ROADWAY GRINDING, RESURFACING & PATCHING OPERATIONS.

2. THIS PLAN IS FOR THE SOLE PURPOSE OF DETECTOR LOOP REPLACEMENT.

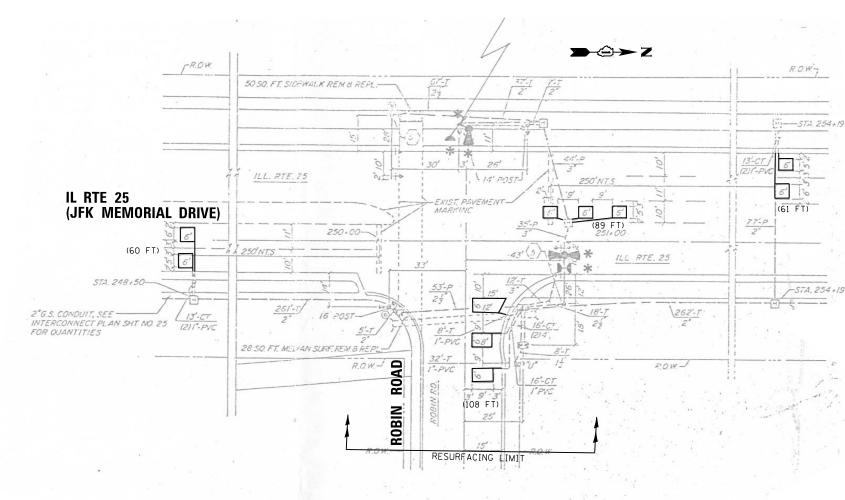

CODE

88600600

FILE NAME =	USER NAME = javanmardızg	DESIGNED – ZGJ	REVISED -		DETECTOR LOOP REPLACEMENT PLAN		F.A.P.	SECTION	COUNTY TOTAL SHEET			
DetectorLoopReuest ILL RTE 25 & ROBIN	0AD_11092016.dgn	DRAWN - ZGJ	REVISED -			360	93RS-2	KANE 52 38				
	PLOT SCALE = 40.0000 '/ in.	CHECKED - LP	REVISED -	DEPARTMENT OF TRANSPORTATION		IL NIE 25 (J		UNIAL UNIVE) AT F				CONTRACT NO. 62C99
Default	PLOT DATE = 11/9/2016	DATE - 11/09/2016	REVISED -		SCALE:	SHEET	OF	SHEETS STA.	TO STA.		ILLINOIS FED. 4	ID PROJECT



ITEM	QUANTITY	UNIT


DETECTOR LOOP REPLACEMENT

318 FOOT

NOTES:

1. WORK SHALL MEET THE REQUIREMENTS OF THE SPECIAL PROVISION, "DETECTOR LOOP REPLACEMENT AND/OR INSTALLATION (ROADWAY GRINDING, RESURFACING & PATCHING OPERATIONS.

2. THIS PLAN IS FOR THE SOLE PURPOSE OF DETECTOR LOOP REPLACEMENT.

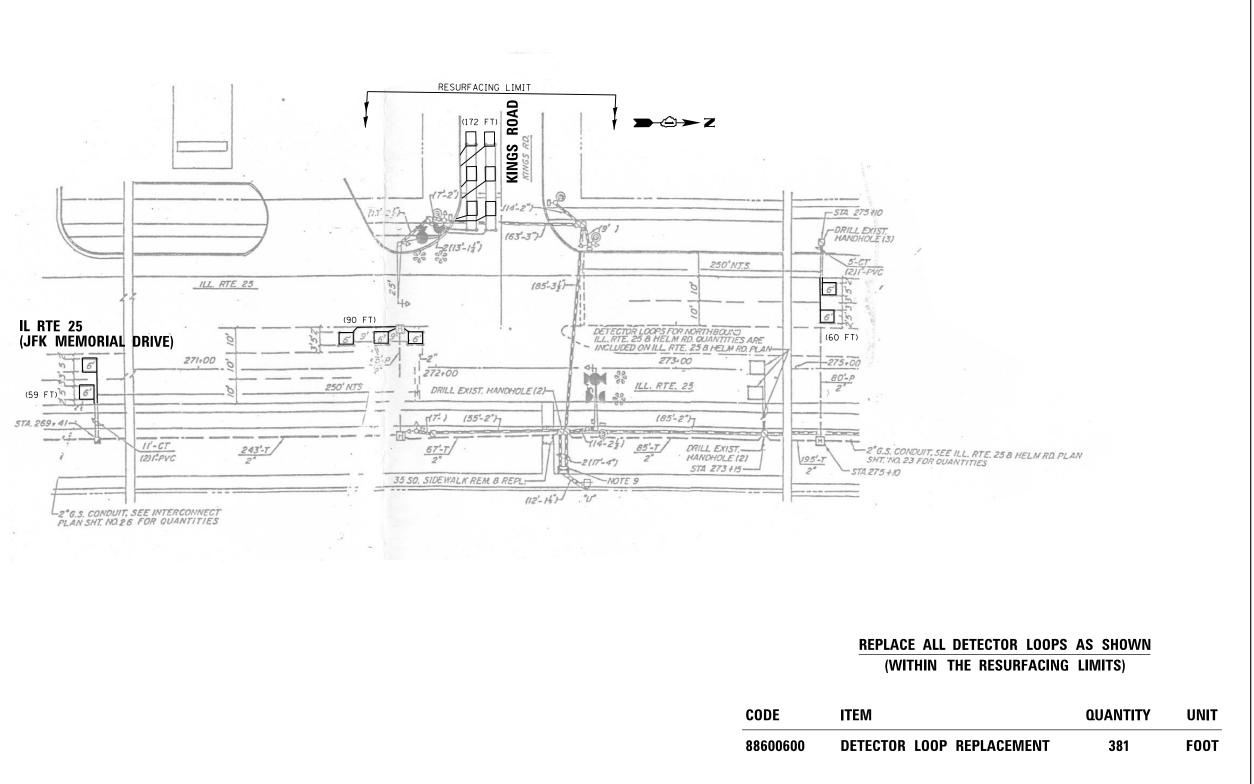

FILE NAME =	USER NAME = javanmardızg	DESIGNED -	ZGJ	REVISED -			DETECTO		REPLACE
TS 4310 ILL RTE 25 & KINGS ROAD_1109201	6.dgn	DRAWN -	ZGJ	REVISED -	STATE OF ILLINOIS				
	PLOT SCALE = 40.0000 ' / in.	CHECKED -	LP	REVISED -	DEPARTMENT OF TRANSPORTATION	IL K	TE 25 (JFK	MENIO	RIAL DRIV
Default	PLOT DATE = 11/9/2016	DATE -	11/09/2016	REVISED -		SCALE:	SHEET	OF	SHEETS S


ACEMENT PLAN DRIVE) AT KINGS ROAD		F.A.P. RTE.	SECTION		COUNTY	TOTAL SHEETS	SHEET NO.
		360	93RS-2		KANE	52	39
					CONTRACT	NO. 6	2099
S STA.	TO STA.		ILLINOIS	FED. AI	ID PROJECT		

NOTES:

1. WORK SHALL MEET THE REQUIREMENTS OF THE SPECIAL PROVISION, "DETECTOR LOOP REPLACEMENT AND/OR INSTALLATION (ROADWAY GRINDING, RESURFACING & PATCHING OPERATIONS.

2. THIS PLAN IS FOR THE SOLE PURPOSE OF DETECTOR LOOP REPLACEMENT.

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88600600

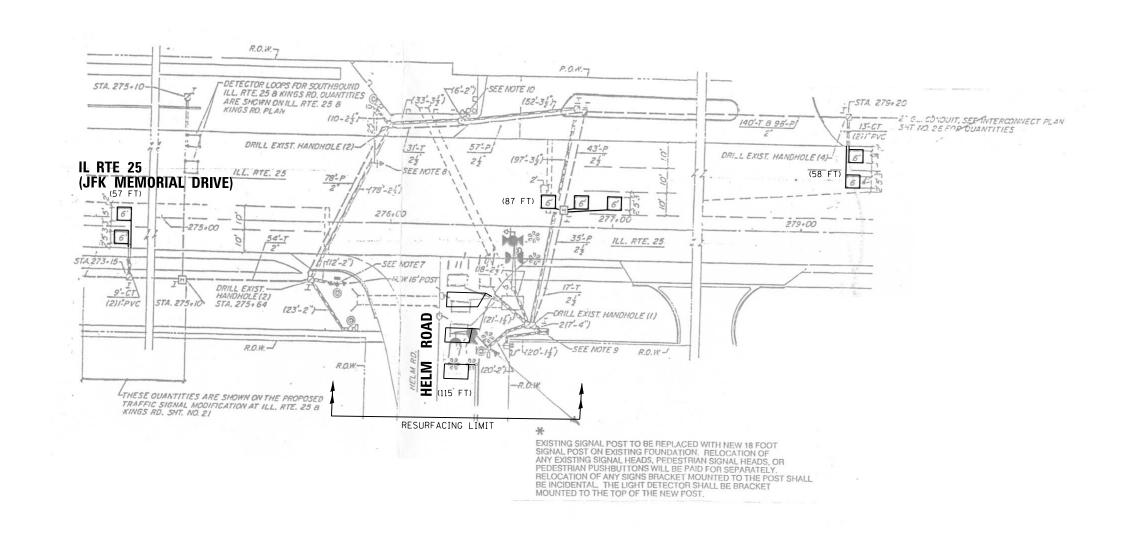
FILE NAME =	USER NAME = javanmardızg	DESIGNED – ZGJ	REVISED -		DETECTOR LOOP REPLACEMENT PLAN		F.A.P.	SECTION	COUNTY TOTAL SHEET			
TS 4320 ILL RTE 25 & HELM ROAD_1109201	ô.dgn	DRAWN – ZGJ	REVISED -	STATE OF ILLINOIS			93RS-2	KANE 52 40				
	PLOT SCALE = 40.0000 '/ in.	CHECKED - LP	REVISED -	DEPARTMENT OF TRANSPORTATION				,				CONTRACT NO. 62C99
Default	PLOT DATE = 11/9/2016	DATE - 11/09/2016	REVISED -		SCALE:	SHEET	OF	SHEETS STA.	TO STA.		ILLINOIS FED.	ND PROJECT

REPLACE ALL DETECTOR LOOPS AS SHOWN (WITHIN THE RESURFACING LIMITS)

ITEM	QUANTITY	UNIT

FOOT

DETECTOR LOOP REPLACEMENT 317

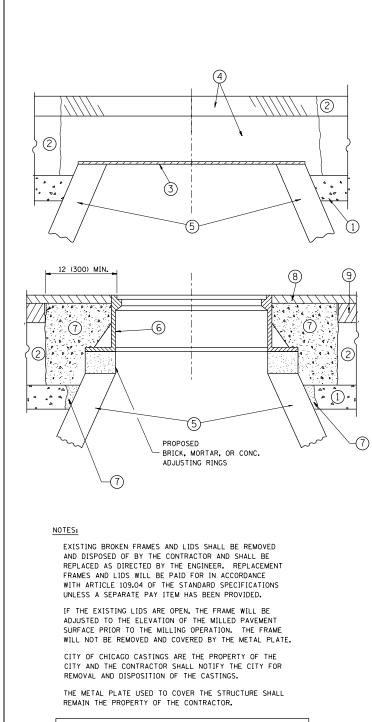

WHEN STRUCTURES ARE TO BE ADJUSTED OR RECONSTRUCTED, THE LOWERING AND RAISING OF THE FRAMES AND LIDS WILL NOT BE PAID FOR SEPARATELY BUT WILL BE INCLUDED IN THE COST OF THE CORRESPONDING PAY ITEM.

DETAILS FOR FRAMES AND LIDS ADJUSTMENT WITH MILLING

FILE NAME =	USER NAME = bartonrw	DESIGNED - R. SHAH	REVISED - R. WIEDEMAN 05-14-04		DETAILS FOR	F.A.P. SECTION	COUNTY TOTAL SHEET
pw:\\IL084EBIDINTEG.1111no15.gov:PWIDOT\D	cuments\IDOT_Offices\District_1\Projects\D141	10RAWNsta\Design\Diststd.dgn	REVISED - R. BORO 01-01-07	STATE OF ILLINOIS		360 93RS-2	KANE 52 41
	PLOT SCALE = 100.0000 ' / 10.	CHECKED -	REVISED - R. BORO 03-09-11	DEPARTMENT OF TRANSPORTATION	FRAMES AND LIDS ADJUSTMENT WITH MILLING	BD600-03 (BD-8)	CONTRACT NO. 62C99
	PLOT DATE = 2/7/2017	DATE - 10-25-94	REVISED - R. BORO 12-06-11		SCALE: NONE SHEET NO. 1 OF 1 SHEETS STA. TO STA.		AID PROJECT

CONSTRUCTION PROCEDURES

STAGE 1 (BEFORE PAVEMENT MILLING)

- A) REMOVE A MINIMUM OF 12 (300) OF THE PAVEMENT FROM AROUND THE STRUCTURE. B) REMOVE THE EXISTING FRAME AND LID FROM THE STRUCTURE.
- C) COVER THE STRUCTURE OPENING WITH A 36 (900) DIAMETER METAL PLATE. D) BACKFILL WITH CRUSHED STONE AND A MINIMUM 1^{\prime}_{2} (40)
- THICK HMA SURFACE MIX APPROVED BY THE ENGINEER.

STAGE 2 (AFTER PAVEMENT MILLING)

- A) REMOVE THE HMA SURFACE MIX AND CRUSHED STONE.
- B) INSTALL THE FRAME AND LID; ADJUST THE FRAME TO ITS FINAL SURFACE ELEVATION.
- C) THE SURROUNDING SPACE SHALL BE FILLED WITH CLASS PP-1* CONCRETE TO THE ELEVATION OF THE SURFACE OF THE EXISTING BASE COURSE OR THE BINDER COURSE.
- * UNLESS OTHERWISE SPECIFIED IN THE PLANS.

THE PROCEDURE EXPLAINED ABOVE SHALL CONFORM TO THE APPLICABLE PORTIONS OF SECTIONS 353, 406, 602, AND 603 OF THE STANDARD SPECIFICATIONS EXCEPT THAT "THE CONTRACTOR SHALL ADJUST THE STRUCTURES TO THE FINISHED PAVEMENT ELEVATION NO MORE THAN 5 CALENDAR DAYS PRIOR TO PLACEMENT OF THE FINAL LIFT OF SURFACE UNLESS APPROVED BY THE ENGINEER."

LEGEND

1	SUB-BASE GRANULAR MATERIAL	6 FRAME AND LID (SEE NOTES)
2	EXISTING PAVEMENT	(7) CLASS PP-1* CONCRETE
3	36 (900) DIAMETER METAL PLATE	(8) PROPOSED HMA SURFACE COURSE
4	PROPOSED CRUSHED STONE AND HMA SURFACE MIX	-
(5)	EXISTING STRUCTURE	9 PROPOSED HMA BINDER COURSE

(5) EXISTING STRUCTURE

LOCATION OF STRUCTURES:

THE CONTRACTOR WILL BE REQUIRED TO KEEP A RECORD OF THE LOCATIONS OF THE BURIED STRUCTURES ACCORDING TO THE STATION AND DISTANCE LEFT OR RIGHT OF THE CENTERLINE OF PAVEMENT. UPON COMPLETION OF THE WORK, THE CONTRACTOR WILL DELIVER THE RECORD TO THE ENGINEER.


BASIS OF PAYMENT:

REMOVING FRAMES AND LIDS ON DRAINAGE AND UTILITY STRUCTURES IN THE PAVEMENT PRIOR TO MILLING, AND ADJUSTING TO FINAL GRADE PRIOR TO PLACING THE SURFACE COURSE, WILL BE PAID FOR AT THE CONTRACT UNIT PRICE EACH FOR "FRAMES AND LIDS TO BE ADJUSTED (SPECIAL)."

THIS WORK WILL NOT BE PAID FOR WHEN DRAINAGE AND UTILITY STRUCTURES ARE SPECIFIED FOR PAYMENT AS STRUCTURE RECONSTRUCTION.

NEW FRAMES AND LIDS, WHEN SPECIFIED, WILL BE PAID FOR SEPARATELY.

ALL DIMENSIONS A	ARE IN INCHES	(MILLIMETERS) UNLESS	OTHERWISE SHOWN
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FILE NAME =	USER NAME = bartonrw	DESIGNED - R. SHAH	REVISED - A. ABBAS 04-27-98			PAVEMENT PATCHING FOR		F.A.P. RTF.	SECTION	COUNTY TOTAL SHEET
pw://IL084EBIDINTEG.111:nois.gov:PWIDOT/Do	cuments\IDOT_Offices\District_I\Projects\D141		REVISED - R. BORO 01-01-07	STATE OF ILLINOIS		HMA SURFACED PAVEMENT			93RS-2	KANE 52 42
	PLOT SCALE = 100.0000 ' / in.	CHECKED	REVISED - R. BORO 09-04-07	DEPARTMENT OF TRANSPORTATION			BD40	00–04 (BD–22)	CONTRACT NO. 62C99	
	PLOT DATE = 2/7/2017	DATE - 10-25-94	REVISED - K. ENG 10-27-08		SCALE: NONE	SHEET NO. 1 OF 1 SHEETS STA.	TO STA.	FED. ROAD DIS	ST. NO. 1 ILLINOIS FED. /	AID PROJECT

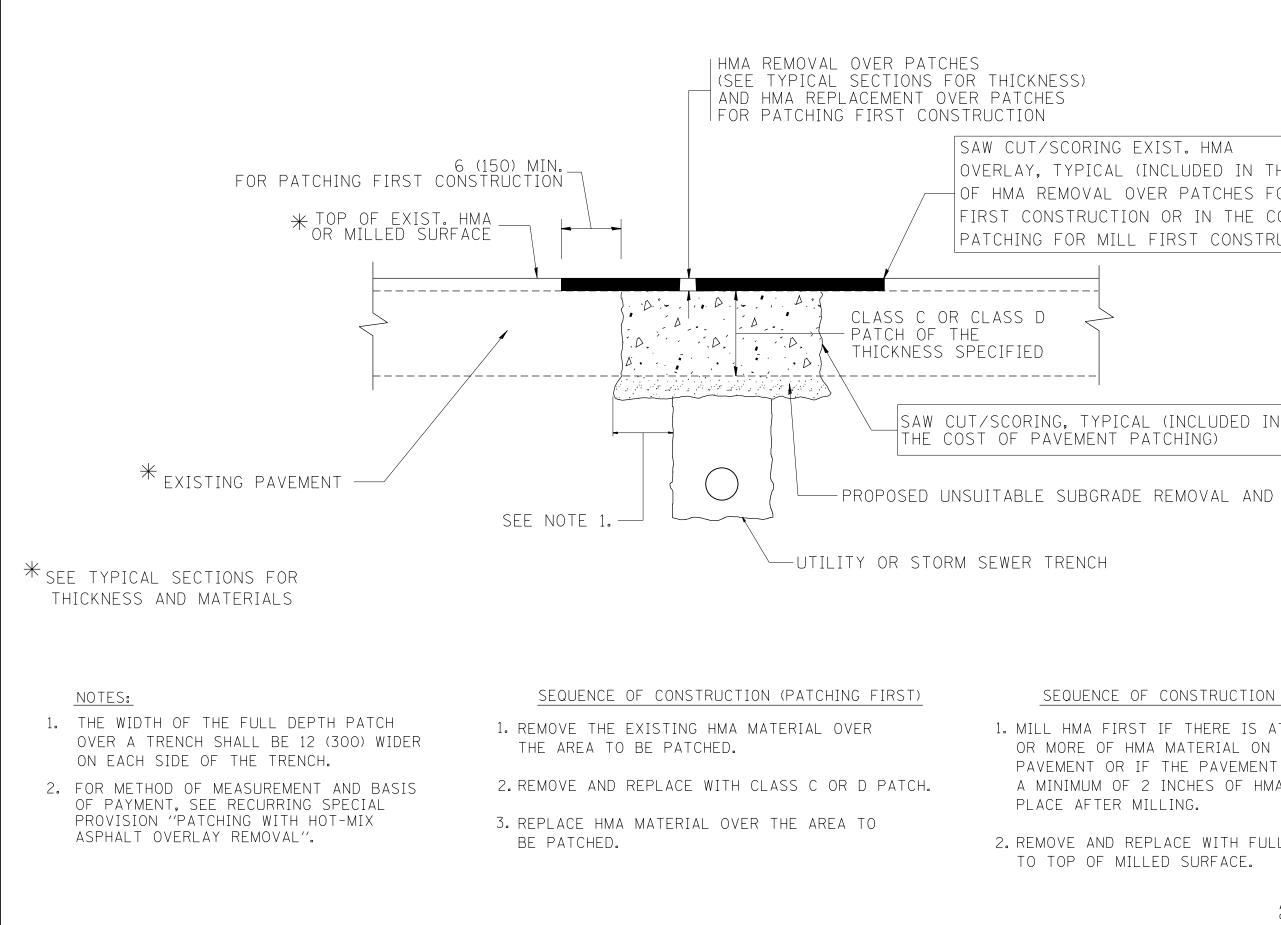OVERLAY, TYPICAL (INCLUDED IN THE COST OF HMA REMOVAL OVER PATCHES FOR PATCHING FIRST CONSTRUCTION OR IN THE COST OF PAVEMENT PATCHING FOR MILL FIRST CONSTRUCTION).


PROPOSED UNSUITABLE SUBGRADE REMOVAL AND REPLACEMENT

SEQUENCE OF CONSTRUCTION (MILLING FIRST)

1. MILL HMA FIRST IF THERE IS AT LEAST $4\frac{1}{2}$ INCHES OR MORE OF HMA MATERIAL ON TOP OF THE EXISTING PAVEMENT OR IF THE PAVEMENT IS FULL DEPTH HMA. A MINIMUM OF 2 INCHES OF HMA MATERIAL SHALL BE IN

2. REMOVE AND REPLACE WITH FULL DEPTH CLASS D PATCHES TO TOP OF MILLED SURFACE.

		DIMENSIONS RWISE SHOWN		INCHES	(MILLIMETERS) UNLES	S
FOR	F.A.P. RTE	SEC	CTION		COUNTY	TOTAL SHEETS	SHEET NO.
	360	93	RS-2		KANE	52	42

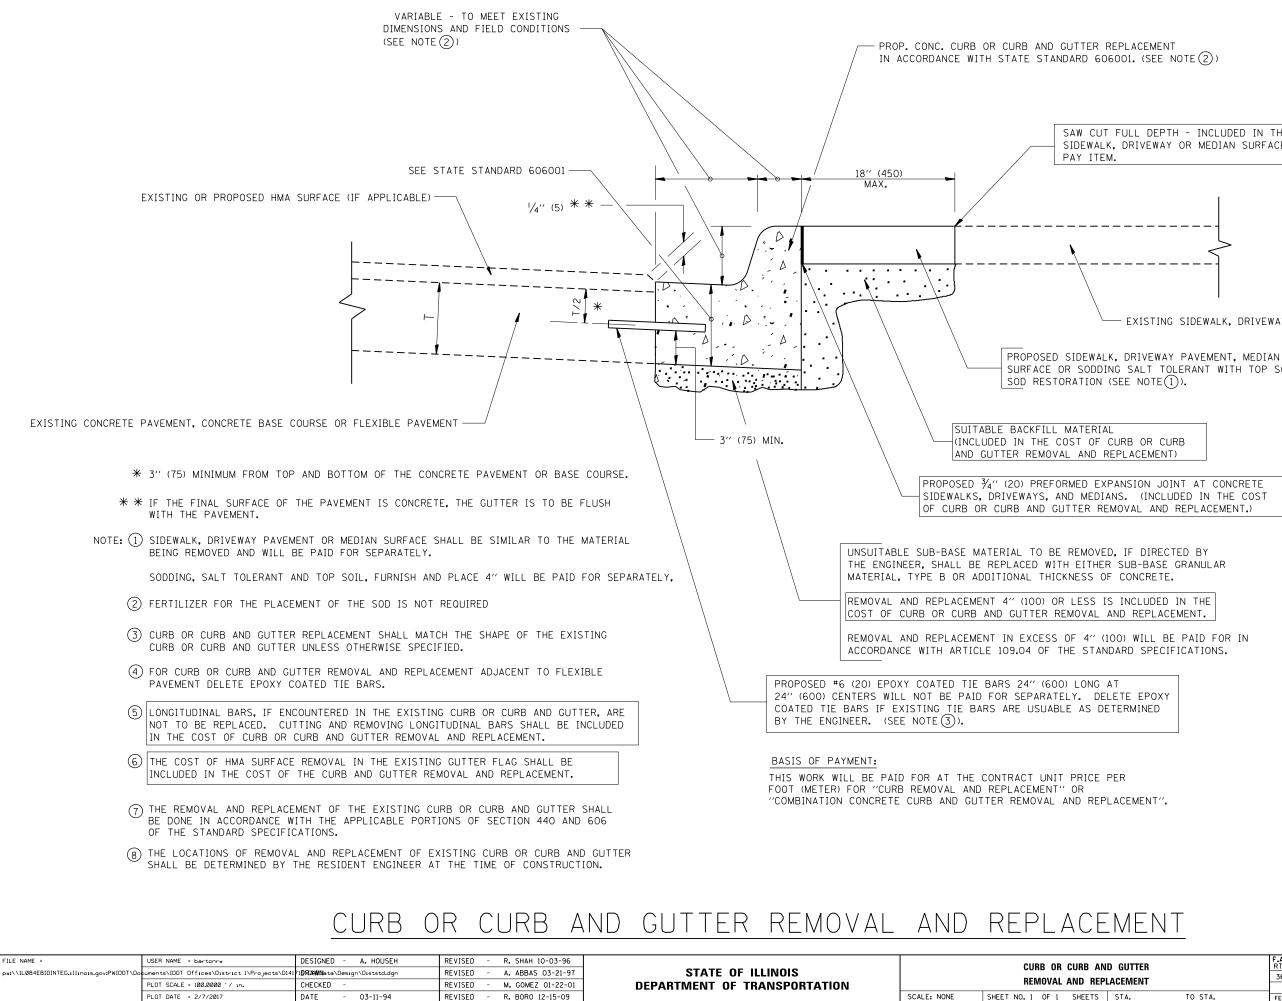


SAW CUT FULL DEPTH - INCLUDED IN THE COST OF SIDEWALK, DRIVEWAY OR MEDIAN SURFACE REMOVAL

EXISTING SIDEWALK, DRIVEWAY, MEDIAN SURFACE, SOD OR GROUND.

SURFACE OR SODDING SALT TOLERANT WITH TOP SOIL, 4" (100)


ALL DIMENSIONS ARE IN INCHES (MILLIMETERS) UNLESS OTHERWISE SHOWN.


٩NI	ND GUTTER		F.A.P. RTE	SECTION	COUNTY	TOTAL SHEETS	SHEET NO.
PLACEMENT		360	93RS-2	KANE	52	43	
				BD600-06 (BD-24)	CONTRACT	NO. 6	2C99
;	STA.	TO STA.	FED. R	DAD DIST. NO. 1 ILLINOIS FED. A	D PROJECT		

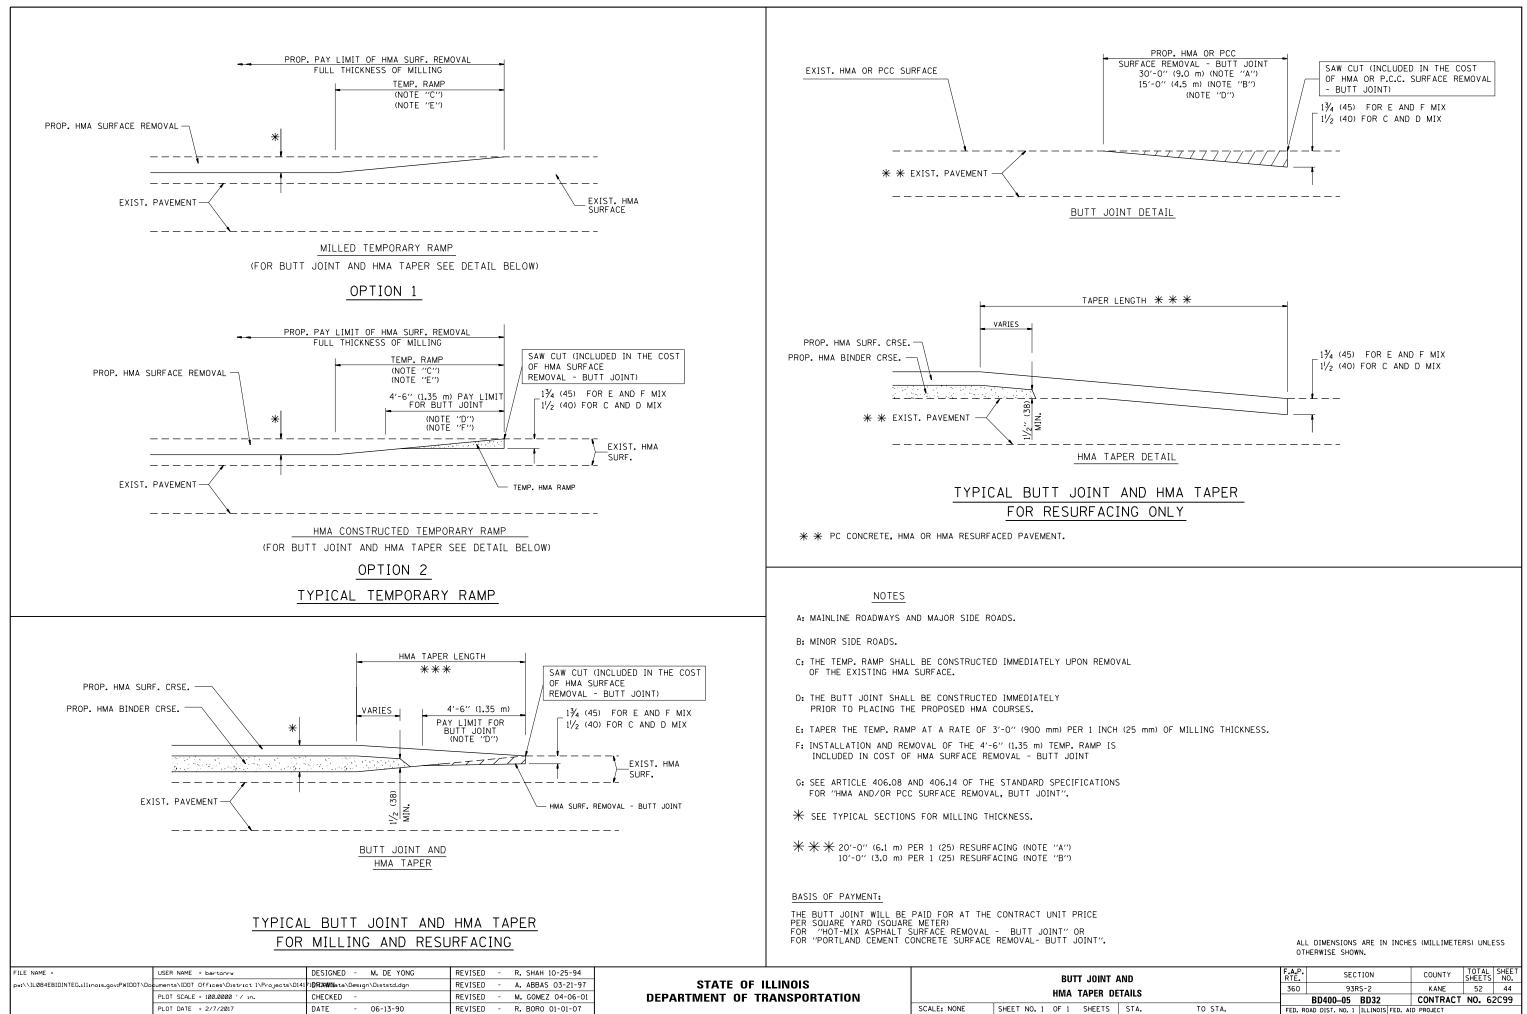

AND DETAILS		SEC	TION		COUNTY	TOTAL SHEETS	SHEET NO.
		93RS-2			KANE	52	44
		BD400-05	BD32		CONTRACT	NO. 6	2C99
STA. TO STA.	FED. R	OAD DIST. NO. 1	ILLINOIS	FED. AI	D PROJECT		


		TYPE II BARRICADES WITH ONE FLASHING AMEER LIGHT ON EACH, OF UNTUE TWO FLASHING AMEER LIGHT ON EACH, OF TYPE II BARRICADES WITH ONE FLASHING AMEER LIGHT ON EACH, OF AMEER LIGHT ON EACH, OF TYPE II BARRICADES WITH ONE FLASHING AMEER LIGHT ON EACH, OF AMEER LIGHT ON EACH, OF TYPE II BARRICADES WITH ONE FLASHING AMEER LIGHT ON EACH, OF TYPE II BARRICADES WITH ONE FLASHING AMEER LIGHT ON EACH, OF TYPE II BARRICADES WITH ONE FLASHING AMEER LIGHT ON EACH, OF TYPE II BARRICADES WITH ONE FLASHING AMEER LIGHT ON EACH, OF TYPE II BARRICADES WITH ONE FLASHING AMEER LIGHT ON EACH, OF TYPE II BARRICADES WITH ONE FLASHING AMEER LIGHT ON EACH, OF TYPE II BARRICADES WITH ONE FLASHING AMEER LIGHT ON EACH, OF TYPE II BARRICADES WITH ONE FLASHING AMEER LIGHT ON EACH, OF TYPE II BARRICADES WITH ONE FLASHING AMEER LIGHT ON EACH, OF TYPE II BARRICADES WITH ONE FLASHING AMEER LIGHT ON EACH, OF TYPE II BARRICADES WITH ONE FLASHING AMEER LIGHT ON EACH, OF TYPE II BARRICADES WITH ONE FLASHING AMEER LIGHT ON EACH, OF TYPE II BARRICADES WITH ONE FLASHING AMEER LIGHT ON EACH, OF TYPE II BARRICADES WITH ONE FLASHING AMEER LIGHT ON EACH, OF TYPE II BARRICADES WITH ONE FLASHING AMEER LIGHT ON EACH, OF TYPE II BARRICADES WITH ONE FLASHING AMEER LIGHT ON EACH, OF TYPE II BARRICADES WITH ONE FLASHING AMEER LIGHT ON EACH, OF TYPE II BARRICADES WITH ONE FLASHING ON EACH, OF TYPE II BARRICADES WITH ONE FLASHING ON EACH, OF
	<u>NOTES:</u>	
	SHOWN ON THE DRAWING AU a) ONE "ROAD CONSTRUM MOUNTED ON IT APPI b) THE CLOSED PORTION BLOCKING WITH TYPE THE CROSS SECTION 2. SIDE ROAD WITH A SPEED AS SHOWN ON THE DRAWIN a) ONE "ROAD CONSTRUM FLASHER MOUNTED O OF THE MAIN ROUTE. b) THE CLOSED PORTION BLOCKING WITH TYPE OF THE CLOSED PORTION BLOCKING WITH TYPE OF THE CLOSED PORTION SPACING DURING DAY OPER IN HEIGHT. 4. WHEN THE SIDE ROAD LIES SIGNING AND THE WORK ZO	N OF THE MAIN ROUTE SHALL BE PROTECTED BY E III BARRICADES, 1/2 OF THE CROSS SECTION
		All dimensions are in inches (millimeters) unless otherwise shown.
FILE NAME = USER NAME = bertonrw DESIGNED - L.H.A. REVISED - A. HOUSEH 10-15-96 pwt:\LL084EBIDINTEG.111nois.gov/PWIDDIND uments\LD01 Offices\District 1\Projects\D141 \DFXWW bato\Design\District.ddgn REVISED - T. RAMMACHER 01-06-00 PLOT SCALE = 100.0000 // in. CHECKED - REVISED - A. SCHUETZE 07-01-13 Defoult PLOT DATE = 2/7/2017 DATE - 06-89 REVISED - A. SCHUETZE 09-15-16	STATE OF ILLINOIS DEPARTMENT OF TRANSPORTATION	F.A.P. SECTION COUNTY TOTAL SHEET SIDE ROADS, INTERSECTIONS, AND DRIVEWAYS SECTION COUNTY TOTAL SHEET SCALE: NONE SHEET 1 OF 1 STA. TO STA.

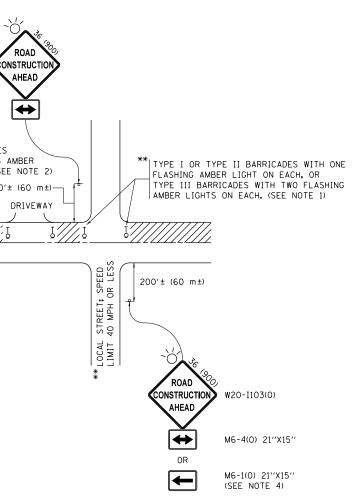


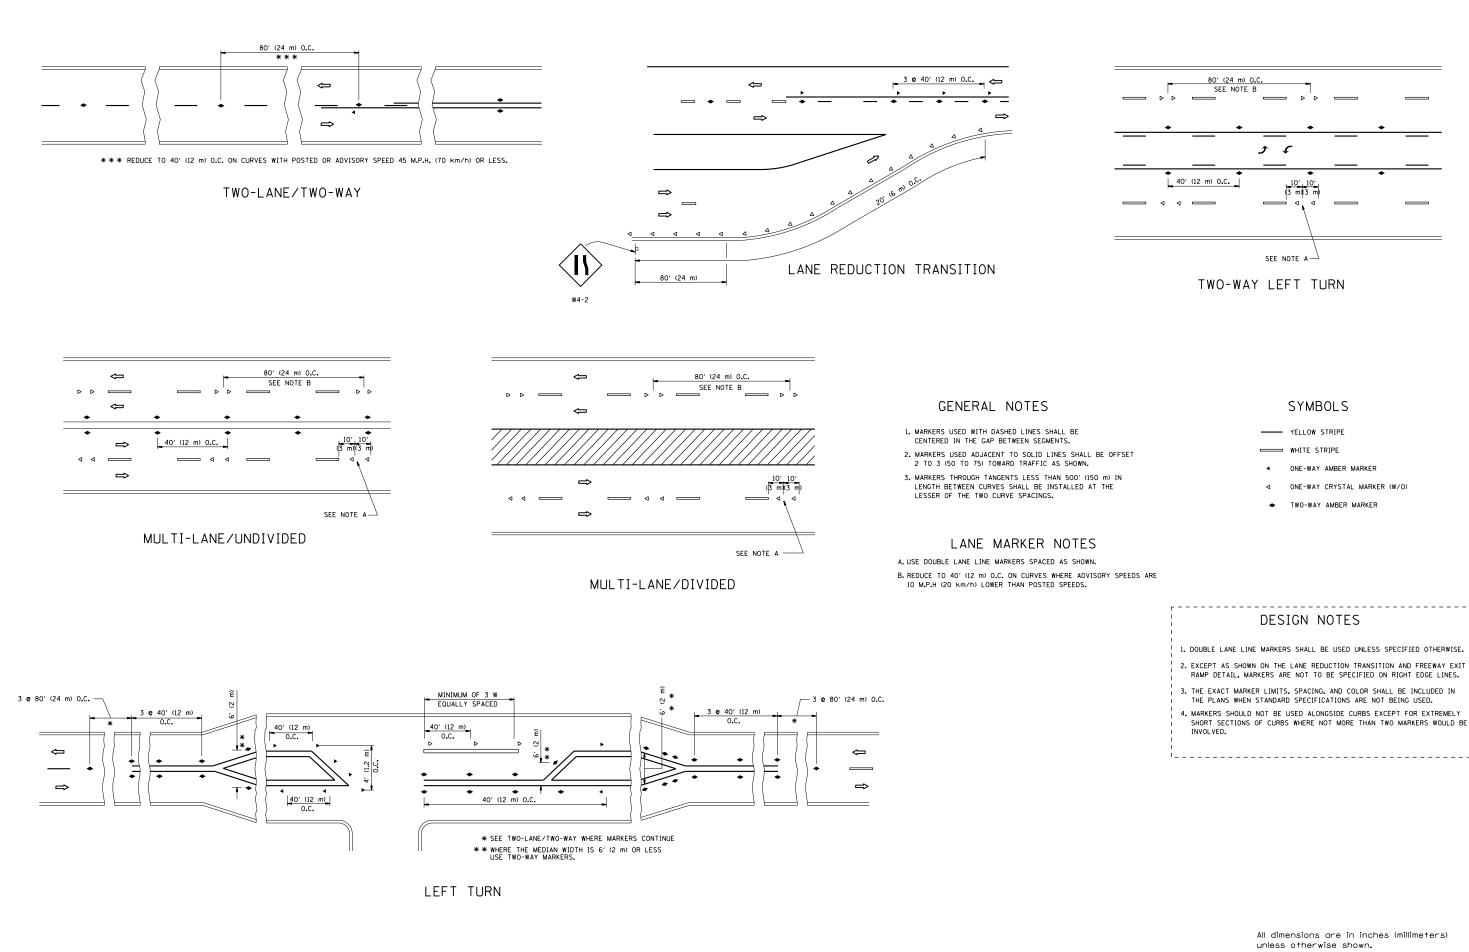

FILE NAME =	USER NAME = bartonrw	DESIGNED -	REVISED - T. RAMMACHER 09-19-94			TYPICAL APPLICATIONS		SECTION	COUNTY TOTAL SHEET
pw:\\IL084EBIDINTEG.1111no15.gov:PWIDOT\Doc	uments\IDOT Offices\District 1\Projects\D141	10RXXVIData\Design\Diststd.dgn	REVISED - T. RAMMACHER 03-12-99	STATE OF ILLINOIS			360	93RS-2	KANE 52 46
	PLOT SCALE = 100.0000 ' / in.	CHECKED -	REVISED -T. RAMMACHER 01-06-00	DEPARTMENT OF TRANSPORTATION	RAISED REFLECTIVE PAVEMENT MARKERS (SNOW-PLOW RESISTANT)			TC-11	CONTRACT NO. 62C99
	PLOT DATE = 2/7/2017	DATE -	REVISED - C. JUCIUS 09-09-09	SCAL		SHEET NO. 1 OF 1 SHEETS STA. TO STA.	FED. ROAD	FED. ROAD DIST. NO. 1 ILLINOIS FED. AID PROJECT	

4. MARKERS SHOULD NOT BE USED ALONGSIDE CURBS EXCEPT FOR EXTREMELY SHORT SECTIONS OF CURBS WHERE NOT MORE THAN TWO MARKERS WOULD BE INVOLVED.

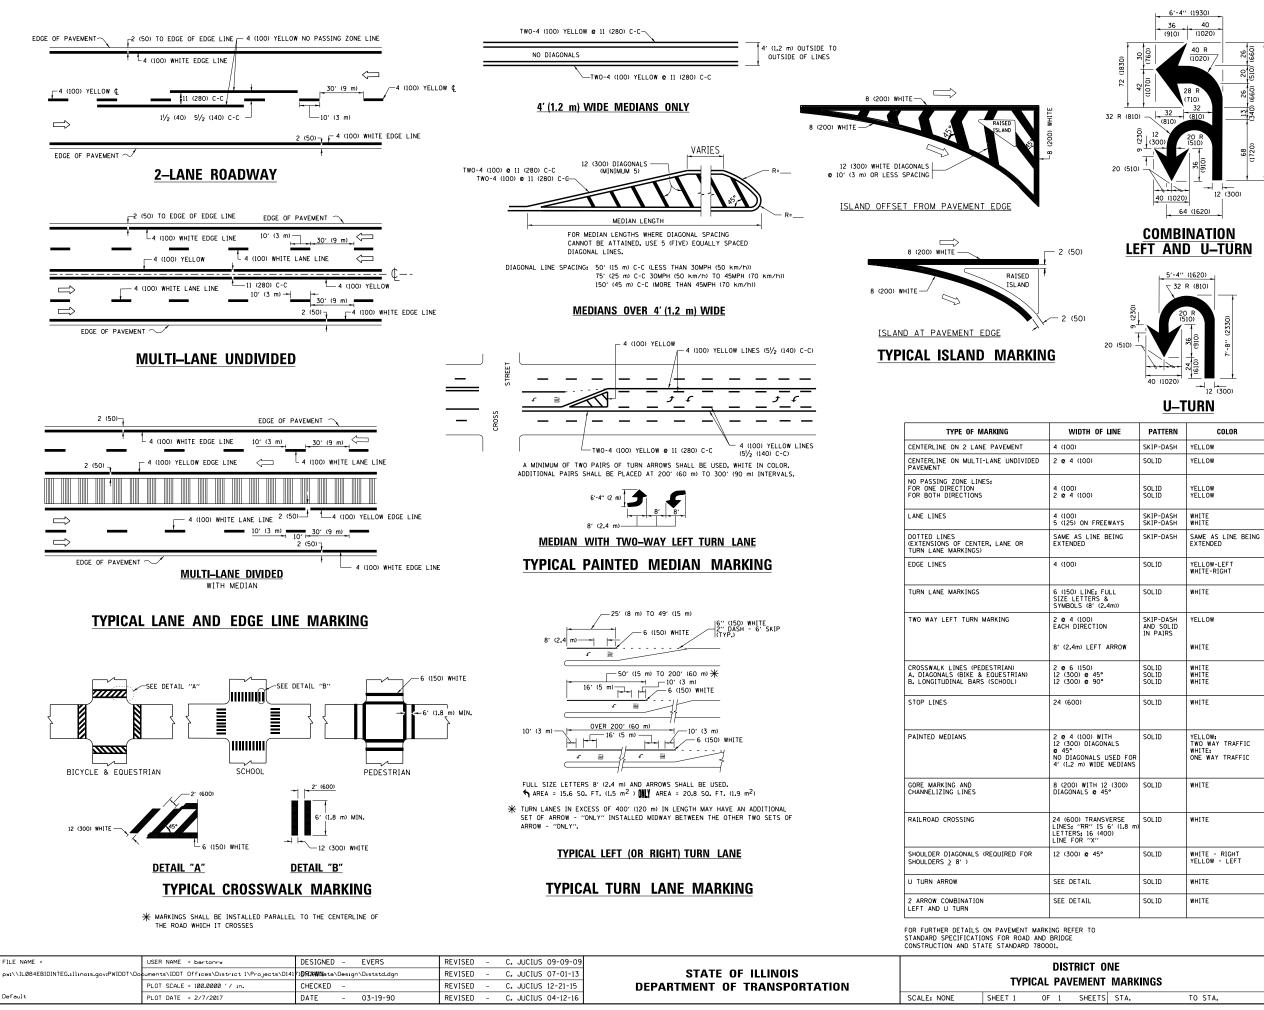

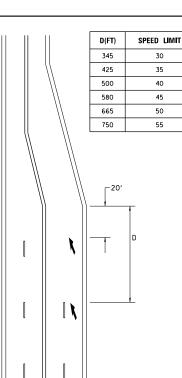

LANE REDUCTION TRANSITION

lane reduction arrows required at speeds of 45 MPH or greater or when specified in plans.

F LINE PATTERN COLOR SKIP-DASH YELLOW SOLID YELLOW	SPACING / REMARKS 10' (3 m) LINE WITH 30' (9 m) SPACE 11 (280) C-C 5½ (140) C-C FROM SKIP-DASH CENTERLINE 11 '(280) C-C 0011 SKIP-DASH CENTERLINE BETWEEN
SOLID YELLOW SOLID YELLOW SOLID YELLOW SKIP-DASH WHITE	11 (280) C-C 51/2 (140) C-C FROM SKIP-DASH CENTERLINE 11 (280) C-C
SOLID YELLOW SOLID YELLOW SKIP-DASH WHITE	51/2 (140) C-C FROM SKIP-DASH CENTERLINE 11 (280) C-C
SOLID YELLOW SKIP-DASH WHITE	11 (280) C-C
	10' (3 m) LINE WITH 30' (9 m) SPACE
BEING SKIP-DASH SAME AS LINE BE	EING 2' (600) LINE WITH 6' (1.8 m) SPACE
SOLID YELLOW-LEFT WHITE-RIGHT	OUTLINE MEDIANS IN YELLOW
FULL SOLID WHITE & 2.4m))	SEE TYPICAL TURN LANE MARKING DETAIL
DN SKIP-DASH YELLOW AND SOLID IN PAIRS ARROW WHITE	10' (3 m) LINE WITH 30' (9 m) SPACE FOR SKIP-DASH, 5½ (140) C-C BETWEEN SOLID LINE AND SKIP-DASH LINE SEE TYPICAL TWO-WAY LEFT TURN MARKING DETAIL
• SOLID WHITE SOLID WHITE SOLID WHITE	NOT LESS THAN 6' (1.8 m) APART 2' (600) APART 2' (600) APART 2' (600) APART SEE TYPICAL CROSSWALK MARKING DETAILS.
SOLID WHITE	PLACE 4' (1,2 m) IN ADVANCE OF AND PARALLEL TO CROSSWALK, IF PRESENT, O'THERWISE, PLACE AT DESIRED STOPPING POINT. PARALLEL TO CROSSROAD CENTERLINE, WHERE POSSIBLE
ITH SOLID YELLOW: DNALS USED FOR EMEDIANS ONE WAY TRAFFI WHITE: ONE WAY TRAFFIC	
12 (300) SOLID WHITE 45° WHITE	DIAGONALS: 15' (4.5 m) C-C (LESS THAN 30MPH (50 km/h)) 20' (6 m) C-C 30MPH (50 km/h) TO 45MPH (70 km/h)) 30' (9 m) C-C (0VER 45MPH (70 km/h))
SVERSE 5 6' (1.8 m) 400)	SEE STATE STANDARD 780001 AREA OF: "R"=3.6 S0. FT. (0.33 m ²) EACH "X"=54.0 S0. FT. (5.0 m ²)
• SOLID WHITE - RIGHT YELLOW - LEFT	50' (15 m) C-C (LESS THAN 30MPH (50 km/h)) 75' (25 m) C-C (30 MPH (50 km/h) TO 45MPH (70 km/h) 150' (45 m) C-C (0VER 45MPH (70 km/h))
SOLID WHITE	16.3 SF
SOLID WHITE	30.4 SF

All dimensions are in inches (millimeters) unless otherwise shown.

0	ONE			SECTION	COUNTY	TOTAL SHEETS	SHEET NO.			
T MARKINGS		360	93RS-2	KANE	52	47				
				TC-13	CONTRACT NO. 62C99					
TS	STA.	TO STA.		ILLINOIS FED. AID PROJECT						



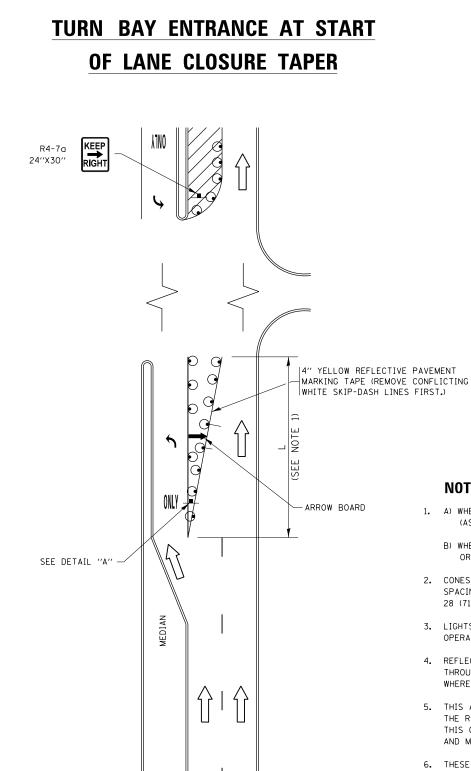


FIGURE 1

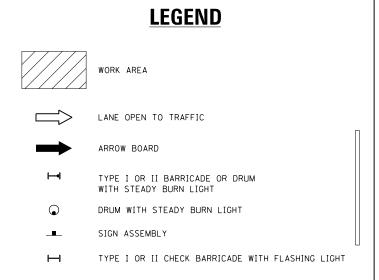


NOTES:

- 1. A) WHEN "L" IS < THE STORAGE LENGTH OF THE TURN LANE (AS SHOWN IN FIG. 1), USE FIGURE 1.
 - B) WHEN "L" IS > THE STORAGE LENGTH OF THE TURN LANE OR THE TURN LANE IS WITHIN THE LANE CLOSURE, USE FIGURE 2.
- 2. CONES MAY BE SUBSTITUTED FOR BARRICADES OR DRUMS AT HALF THE SPACING DURING DAY OPERATIONS. CONES SHALL BE A MINIMUM OF 28 (710) IN HEIGHT.
- 3. LIGHTS WILL NOT BE REQUIRED ON BARRICADES OR DRUMS FOR DAY OPERATIONS. ALL LIGHTS SHALL BE MONODIRECTIONAL.
- 4. REFLECTIVE TEMPORARY PAVEMENT MARKINGS SHALL BE PLACED THROUGHOUT THE BARRICADED AREAS OF EACH TURN BAY AS SHOWN WHERE THE CLOSURE TIME IS GREATER THAN FOURTEEN (14) DAYS.
- 5. THIS APPLICATION ALSO APPLIES WHEN WORK IS BEING PERFORMED IN THE RIGHT LANE(S) AND THE RIGHT TURN BAY IS TO REMAIN OPEN. UNDER THIS CONDITION, "RIGHT TURN LANE" R3-1100R 24 x 24 (600 x 600) AND M6-2R 21 × 15 (530 × 380) SHALL BE USED.
- 6. THESE CONTROLS SHALL SUPPLEMENT MAINLINE TRAFFIC CONTROL FOR LANE CLOSURES.
- 7. THE SIGNS SHALL BE MOUNTED ABOVE THE BARRICADES/DRUMS ON SEPARATE SIGN SUPPORTS THAT MEET NCHRP 350 OR MASH PREQUIREMENTS.
- 8. TRAFFIC CONTROL AND PROTECTION AT TURN BAYS (TO REMAIN OPEN TO TRAFFIC) SHALL BE INCLUDED IN THE COST OF SPECIFIED TRAFFIC CONTROL STANDARDS OR ITEMS.

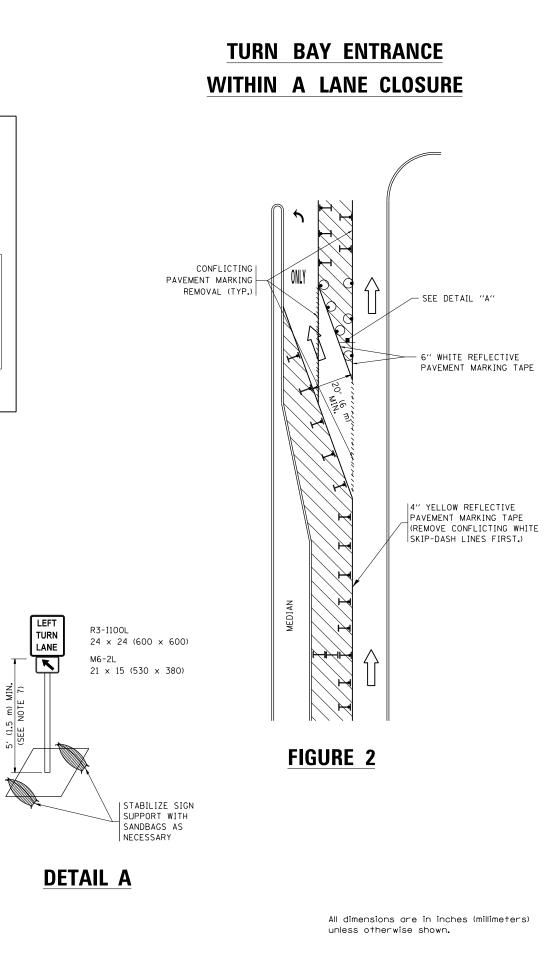


FILE NAME =	USER NAME = bartonrw	REVISED - T. RAMMACHER 09-08-94	REVISED - R. BORO 09-14-09		TRAFFIC CONTROL AND PROTECTION AT TURN BAYS		F.A.P RTF.	SECTION	COUNTY TOTAL SHEET	
pw://IL084EBIDINTEG.1111no1s.gov:PWIDOT/I	ocuments\IDOT Offices\District 1\Projects\D141			STATE OF ILLINOIS	(TO REMAIN OPEN TO TRAFFIC)			360	93RS-2	KANE 52 48
	PLOT SCALE = 100.0000 ' / 10.	REVISED - A. HOUSEH 10-12-96	REVISED - A. SCHUETZE 09-15-16	DEPARTMENT OF TRANSPORTATION				TC-14	CONTRACT NO. 62C99	
Default	PLOT DATE = 2/7/2017	REVISED - T. RAMMACHER 01-06-00	REVISED -		SCALE: NONE	SHEET 1 OF 1 SHEE	TS STA. TO STA.		ILLINOIS FED.	AID PROJECT

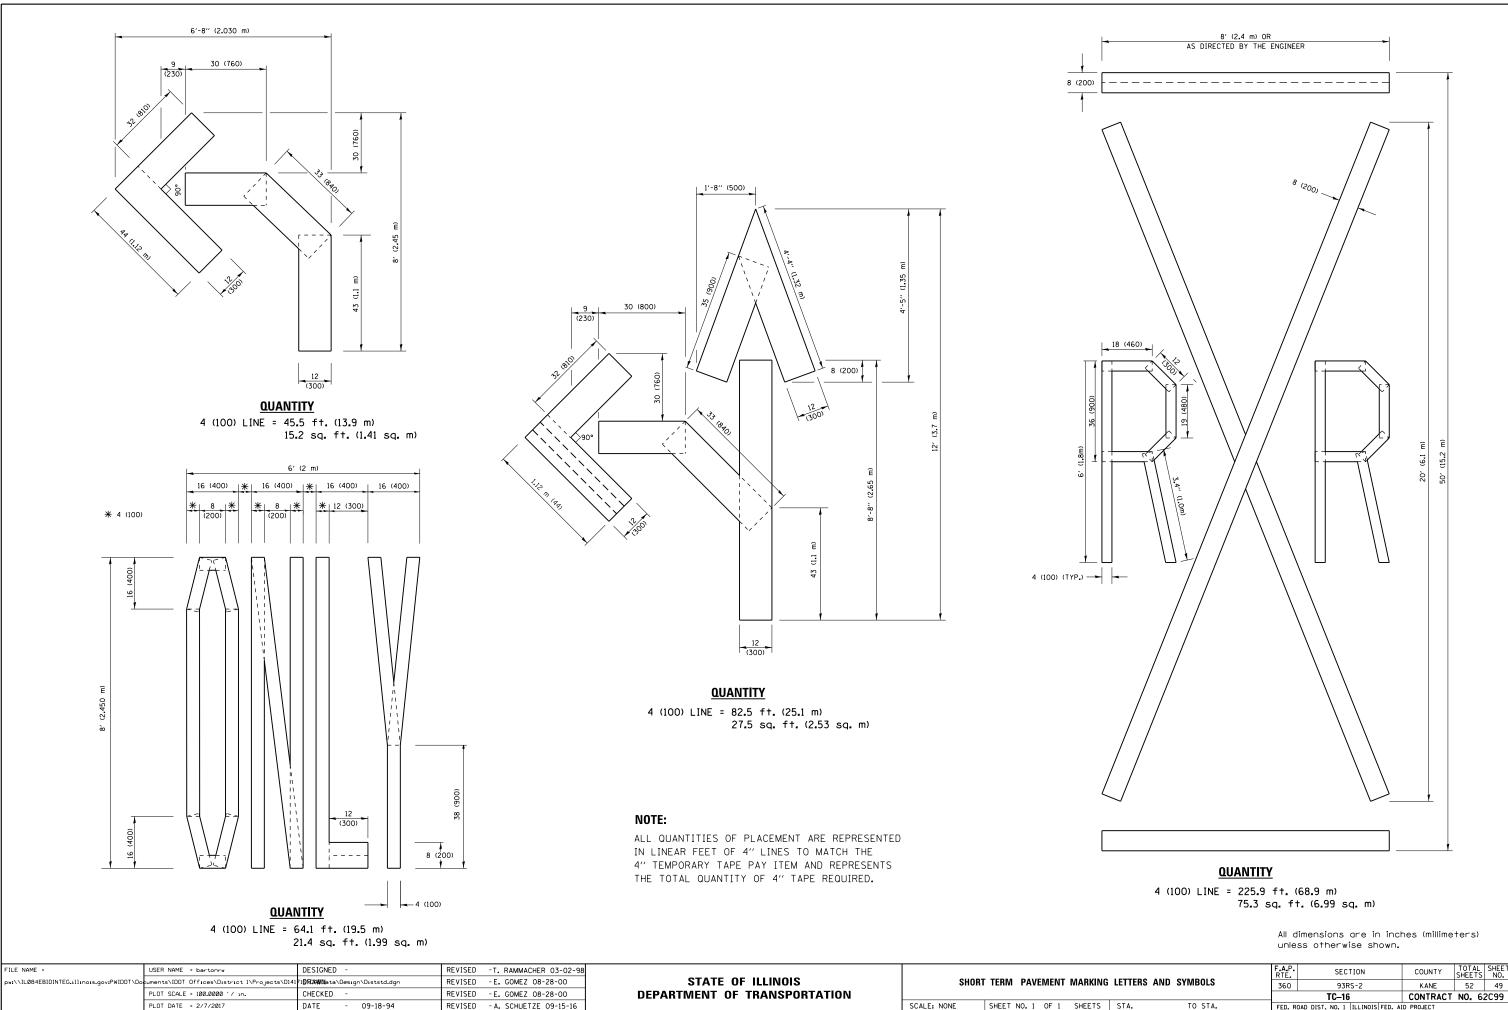

SCALE: NONE SHEET NO. 1 OF 1 SHEETS

		F.A.P. RTE	RTE. SECTION		TOTAL SHEETS	SHEET NO.		
IG	G LETTERS AND SYMBOLS		360	93RS-2	KANE	52	49	
				TC-16	CONTRACT	NO. 62	2C99	
	STA.	TO STA.	FED. R	FED. ROAD DIST. NO. 1 ILLINOIS FED. AID PROJECT				

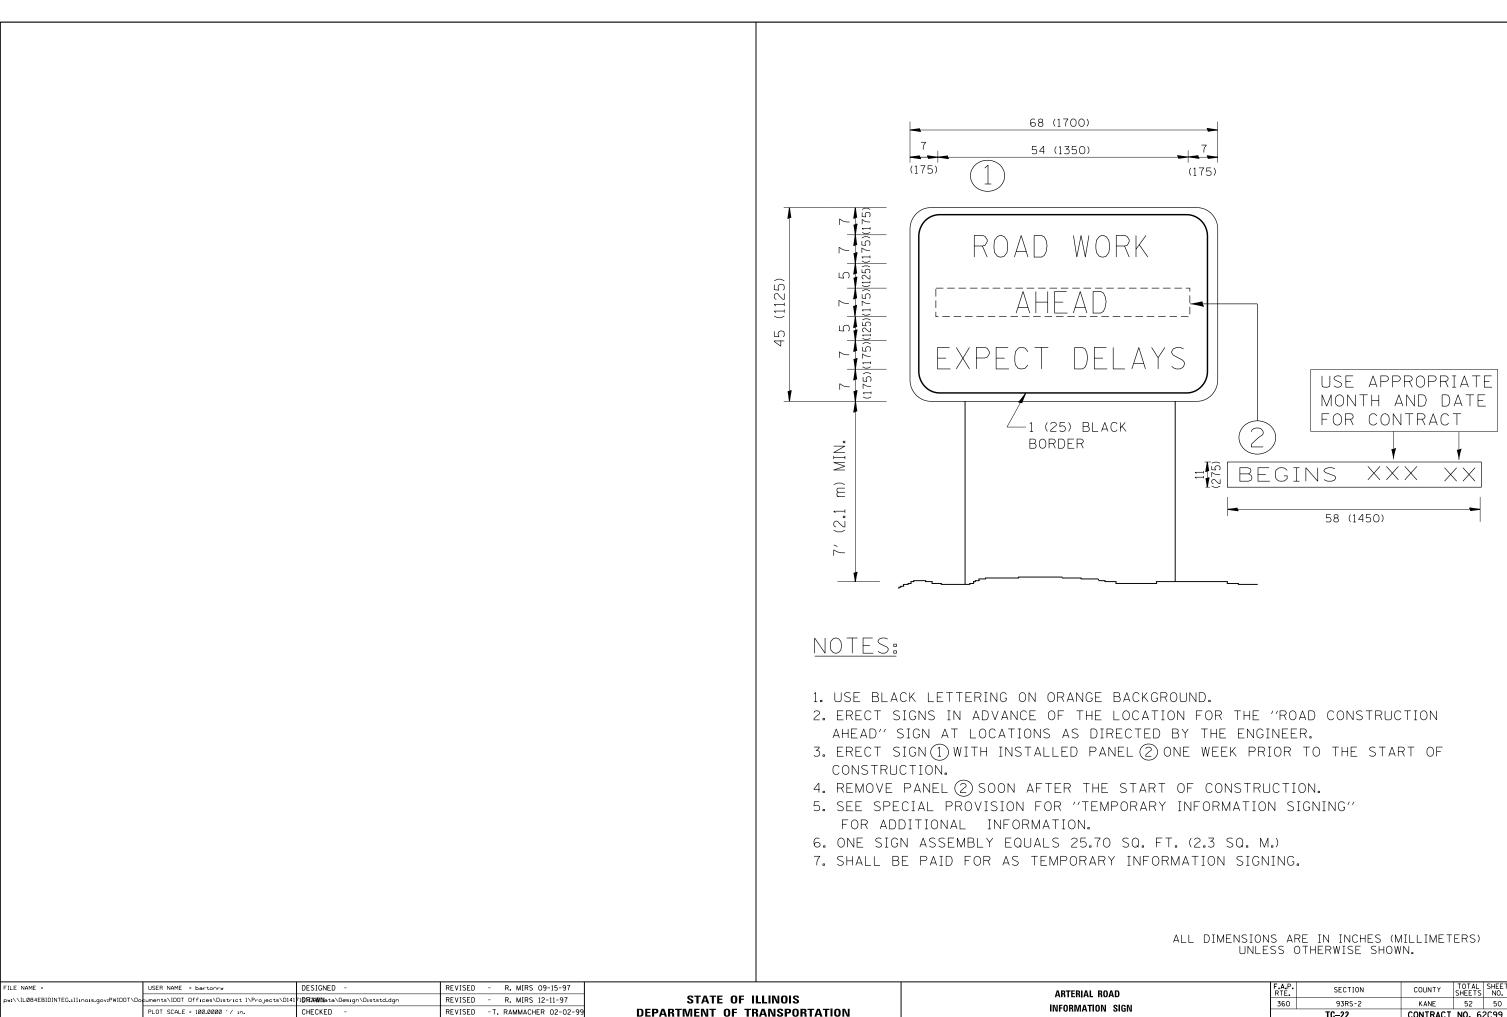

REVISED - C. JUCIUS 01-31-07

PLOT DATE = 2/7/2017

DATE

RO	ROAD			SECTION	COUNTY	TOTAL SHEETS	SHEET NO.	
N SIGN			SIGN 360 93RS-2					
114				TC-22	CONTRACT	NO. 62	2C99	
	STA.	TO STA.	FED. ROAD DIST. NO. 1 ILLINOIS FED. AID PROJECT					