0

 \circ

0

 \circ

STATE OF ILLINOIS **DEPARTMENT OF TRANSPORTATION**

SECTION MADISON 10 1 ILLINOIS CONTRACT NO. 76R90

FOR INDEX OF SHEETS, SEE SHEET NO. 2

TRAFFIC DATA

I-270 TO IL 143 2021 ADT = 35400 (ACTUAL) 2022 ADT = 35800 (ESTIMATED) 2042 ADT = 43600 (ESTIMATED) SU = 2.6% MU = 20.9%

IL 143 TO IL 140

2021 ADT = 38600 (ACTUAL) 2022 ADT = 38900 (ESTIMATED) 2042 ADT = 47600 (ESTIMATED) SU = 3.6%MU = 16.5%


IL 140 TO IL 4

2021 ADT = 33500 (ACTUAL) 2022 ADT = 33800 (ESTIMATED) 2042 ADT = 41300 (ESTIMATED) SU = 2.7% MU = 22.7%

IL 4 TO NEW DOUGLAS RD 2021 ADT = 31900 (ACTUAL) 2022 ADT = 32200 (ESTIMATED) 2042 ADT = 49300 (ESTIMATED) SU = 2.8%MU = 23.8%

NEW DOUGLAS RD TO COUNTY LINE

2021 ADT = 30300 (ACTUAL) 2022 ADT = 30600 (ESTIMATED) 2042 ADT = 37300 (ESTIMATED) SU = 2.8%MU = 20.1%

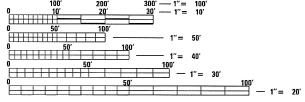

FULL SIZE PLANS HAVE BEEN PREPARED USING STANDARD ENGINEERING SCALES. REDUCED SIZED PLANS WILL NOT CONFORM TO STANDARD SCALES. IN MAKING MEASUREMENTS ON REDUCED PLANS, THE ABOVE SCALES MAY BE USED.


JOINT UTILITY LOCATION INFORMATION FOR EXCAVATION 1-800-892-0123 OR 811

PROJECT ENGINEER: BILLIE OWEN PROJECT MANAGER: MIKE BERG

PROPOSED HIGHWAY PLANS

FAI ROUTE 55 (I–55) SECTION 60-(1,2,3)PP PAVEMENT PATCHING - CM MADISON COUNTY


C-98-053-23

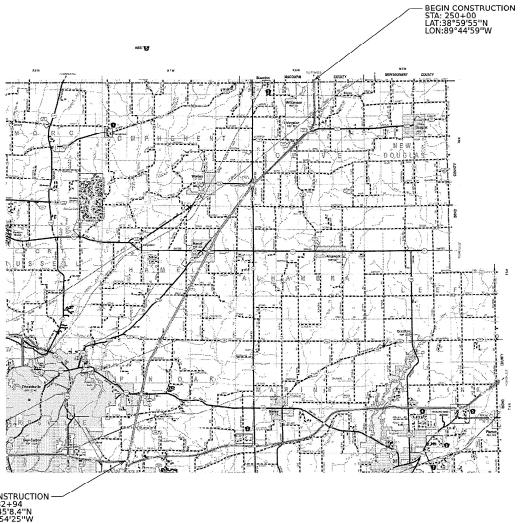

GROSS/NET LENGTH = 103.435.2 FT. = 19.59 MILE

D-98-012-23



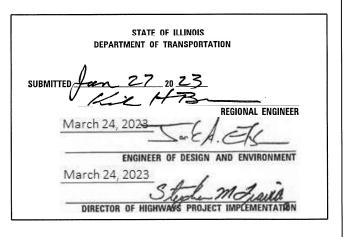

PRINTED BY THE AUTHORITY OF THE STATE OF ILLINOIS

CONTRACT NO. 76R90

INDEX OF SHEETS

- COVER SHEET
- 2. INDEX OF SHEETS, STANDARDS, GENERAL NOTES, COMMITMENTS
- 3. SUMMARY OF QUANTITIES
- 4-5 TYPICALS
- 6-7 SCHEDULE OF QUANTITIES
- 8 CLASS C PATCH (SPECIAL) DETAIL
- 9-10 CLASS A PATCH (SPECIAL) DETAIL

STANDARDS

406101-05	000001-08
442001-04	001001-02
442101-09	001006
442201-03	420001-10
701101-05	780001-05
701106-02	781001-04
701400-11	
701401-13	
701411-09	
701426-09	
701428-01	
701451-05	
701456-05	
701901-08	

GENERAL NOTES

1. UTILITIES KNOWN TO HAVE FACILITIES WITHIN THE PROJECT AREA ARE AS FOLLOWS:

AMEREN ILLINOIS AT&T ILLINOIS BOND MADISON WATER COMPANY **BUCKEYE PARTNERS L.P.--WOOD RIVER PIPELINE** CHARTER COMMUNICATIONS, INC. CONSOLIDATED COMMUNICATIONS CITY OF EDWARDSVILLE VILLAGE OF HAMEL ILLINOIS AMERICAN WATER LEVEL 3 COMMUNICATIONS, LLC MADISON TELEPHONE COMPANY MARATHON PIPE LINE LLC **VERIZON BUSINESS** NORTHEAST CENTRAL COUNTY PUBLIC WATER DISTRICT PLAINES MARKETING, LP SOUTHWESTERN ELECTRIC COOPERATIVE, INC. TC ENERGY WINDSTREAM KDL, INC.

- NO SURVEY WAS PERFORMED FOR THIS PROJECT AND THE PLANS WERE CREATED USING MICROFILM AND FIELD MEASUREMENTS.
- 3. THE RESIDENT ENGINEER SHALL VERIFY THE EXISTENCE OF HIGHWAY LIGHTING AND/OR INTELLIGENT TRANSPORTATION SYSTEMS (I.T.S) UTILITIES WITHIN THE PROJECT LIMITS. IF HIGHWAY LIGHTING AND/OR I.T.S. EXISTS WITHIN THE PROJECT LIMITS, AND IF THESE ITEMS REQUIRE LOCATING, THE CONTRACTOR SHALL BE DIRECTED TO DO SO ACCORDING TO SECTION 803 OF THE STANDARD SPECIFICATIONS. THIS WORK SHALL BE PAID FOR ACCORDING TO ARTICLE 109.04 OF THE STANDARD SPECIFICATIONS.
- 4. FIVE CHANGEABLE MESSAGE SIGNS SHALL BE REQUIRED FOR THIS PROJECT. TWO CHANGEABLE MESSAGE SIGNS SHALL BE PLACED AT THE BEGINNING AND END OF THE PROJECT TWO WEEKS PRIOR TO ANY LANE CLOSURE AND SHALL REMAIN UP FOR THE DURATION OF THE PROJECT. THREE CHANGEABLE MESSAGE SIGNS SHALL BE PLACED AS SPECIFIED IN THE WEEKEND CLOSURES SPECIAL PROVISION.
- THE DEPARTMENT STRONGLY ENCOURAGES THE PRIME CONTRACTOR AND THEIR APPROVED SUB-CONTRACTORS TO HIRE MINORITY, WOMEN, AND DISADVANTAGED INDIVIDUALS FROM ITS FEDERALLY FUNDED HIGHWAY CONSTRUCTION CAREERS TRAINING PROGRAM (HCCTP) TO HELP MEET WORKFORCE AND TRAINEE GOALS. THIS PROGRAM IS TRAINING MINORITIES, WOMEN AND DISADVANTAGED INDIVIDUALS IN HIGHWAY CONSTRUCTION-RELATED SKILLS, E.G., MATH FOR THE TRADES, JOB READINESS, TECHNICAL SKILLS COURSEWORK (CARPENTRY, CONCRETE FLATWORK, BLUEPRINT READING, SITE PLANS, SITE WORK, TOOLS USE, ETC.) AND OSHA 10 HOUR CERTIFICATION, TO PREPARE THEM FOR A CAREER IN THE HIGHWAY CONSTRUCTION TRADES. GRADUATES ARE WELL-TRAINED AND READY TO BECOME PRODUCTIVE ENTRY-LEVEL CONSTRUCTION WORKERS. CONTACT THE DISTRICT 8 EEO OFFICE AT 618-346-3360 AND/OR THE HCCTP COORDINATOR AT 618-874-6528 TO LEARN MORE ABOUT THE PROGRAM AND FOR ASSISTANCE IN MEETING WORKFORCE AND TRAINEE GOALS.

COMMITMENTS

NONE

USER NAME = Robert.Hughes	DESIGNED	REVISED
	DRAWN	REVISED
PLOT SCALE = 0.16666633 ' / in.	CHECKED	REVISED
PLOT DATE = 1/27/2023	DATE	REVISED

STATE OF ILLINOIS
DEPARTMENT OF TRANSPORTATION

INDEX OF SHEETS, STANDARDS, GENERAL NOTES,
AND COMMITMENTS

SCALE: NTS SHEET 1 OF 1 SHEETS STA. + . TO STA. + .

| COUNTY | TOTAL | SHEET | SHE

SECTION

60-(1,2,3)PP

55

REV. - MS

1	LO	0	%	S	Γ	١г	П	E

				ROADWAY	ROADWAY 0006	
CODE			TOTAL	0006		
NO.	ITEM	UNIT	QUANTITY	URBAN	RURAL	
42000060	WELDED WIRE REINFORCEMENT	SQ YD	773	302	471	
44201023	CLASS B PATCHES, TYPE III, 14 INCH	SQ YD	25		25	
44201025	CLASS B PATCHES, TYPE IV, 14 INCH	SQYD	728	438	290	
E .			1			
44201102	CLASS B PATCHES, TYPE II, 20 INCH	SQ YD	8	8		
44201104	CLASS B PATCHES, TYPE III, 20 INCH	SQYD	20	20		
44201298	DOWEL BARS 1 1/4"	EACH	176	116	60	
44004000	DOWEL PARC 44/0"	FACIL	10	40	1	
44201299	DOWEL BARS 1 1/2"	EACH	40	40		
44213000	PATCHING REINFORCEMENT	SQ YD	238		238	
44213200	SAW CUTS	FOOT	3442	883	2559	
44213204	TIE BARS 3/4"	EACH	270	57	213	
67100100	MOBILIZATION	L SUM	1	0.5	0.5	
70100420	TRAFFIC CONTROL AND PROTECTION, STANDARD 701411	EACH	1	1		
70100800	TRAFFIC CONTROL AND PROTECTION, STANDARD 701401	L SUM	1	0.5	0.5	
70100820	TRAFFIC CONTROL AND PROTECTION, STANDARD 701451	L SUM	1	0.33	0.67	
70100825	TRAFFIC CONTROL AND PROTECTION, STANDARD 701456	L SUM	1	0.33	0.67	


100% STATE CONSTRUCTION CODE

CODE NO.	ITEM	UNIT	TOTAL QUANTITY	ROADWAY 0006 URBAN	ROADWA' 0006 RURAL
70107025	CHANGEABLE MESSAGE SIGN	CAL DA	124	56	68
70200100	NIGHTTIME WORK ZONE LIGHTING	LSUM	1	0.5	0.5
70300100	SHORT TERM PAVEMENT MARKING	FOOT	268	148	120
70300150	SHORT TERM PAVEMENT MARKING REMOVAL	SQ FT	89	50	39
78001130	PAINT PAVEMENT MARKING - LINE 6"	FOOT	1247	856	391
78100100	RAISED REFLECTIVE PAVEMENT MARKER	EACH	9	2	7
78300200	RAISED REFLECTIVE PAVEMENT MARKER REMOVAL	EACH	9	2	7
X4420621	CLASS A PATCHES, TYPE II, 14 INCH (SPEC IAL)	SQ YD	62		62
X4420624	CLASS A PATCHES, TYPE III, 14 INCH (SPEC IAL)	SQYD	16		16
X4420628	CLASS A PATCHES, TYPE IV, 14 INCH (SPEC IAL)	SQ YD	160		160
X4420743	CLASS C PATCHES, TYPE IV, 16 INCH (SPECIAL)	SQ YD	50		50

★ SPECIALTY ITEM

1	USER NAME = Robert.Hughes	DESIGNED -	REVISED -	
1		DRAWN -	REVISED	
	PLOT SCALE = 0.16666633 ' / in.	CHECKED -	REVISED -	
- 1	PLOT DATE = 1/27/2023	DATE -	REVISED _	

SCALE: NTS

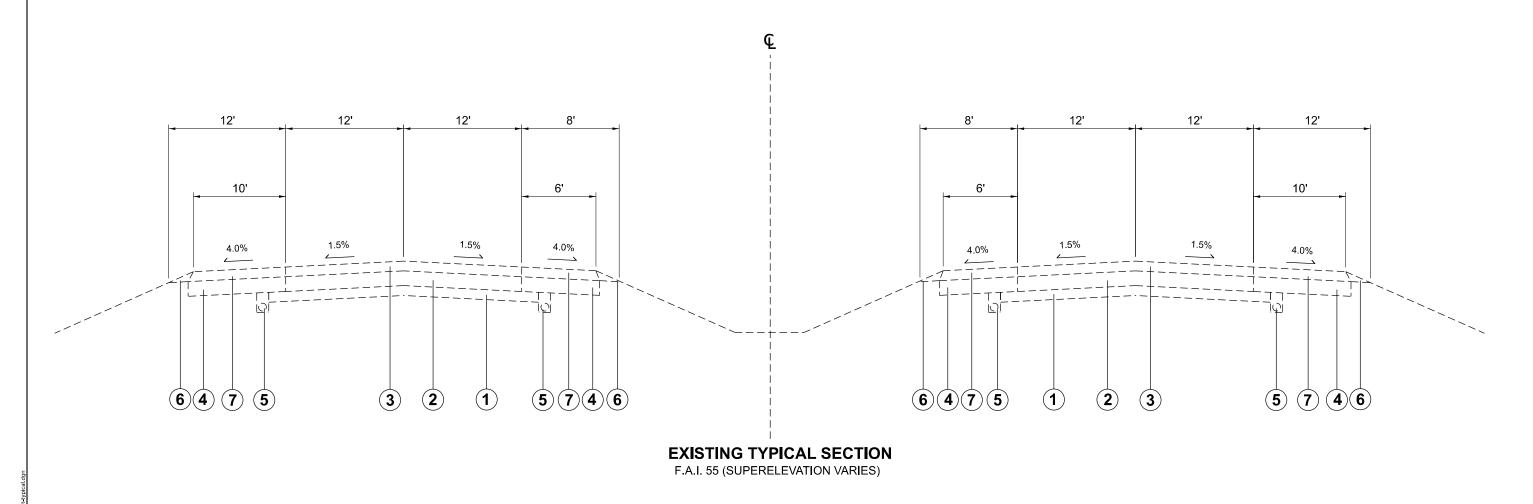


EXISTING LEGEND

- (1) EXISTING STABILIZED SUBBASE (VARIES, SEE TABLE 1)
- (8) EXISTING AGGREGATE BASE COURSE, TYPE A 12"
- 2 EXISTING P.C.C. PAVEMENT (VARIES, SEE TABLE 1)
- (9) EXISTING PCC SHOULDERS 12" (SPECIAL)
- 3 EXISTING BIT. OVERLAY (VARIES, SEE TABLE 1)
- (4) EXISTING STABILIZED SHOULDERS
- (5) EXISTING PIPE UNDERDRAINS
- **6** EXISTING AGGREGATE SHOULDERS
- 7 EXISTING BITUMINOUS SHOULDERS


TABLE 1	APPR. MILE MARKER EQUIVALENCIES	SUBBASE THICKNESS	P.C.C. THICKNESS	CONTINUOUSLY REINFORCED	BIT. OVERLAY THICKNESS
STATION 250+00 TO STATION 520+12.5 N.B & S.B.	MM 39.3 TO 34.0	4"	9"	YES	4 1/4"
STATION 734+00 TO STATION 1033+86.46 N.B. STATION 734+00 TO STATION 1033+86.46 S.B.	MM 29.8 TO 24.3	7"	10"	NO	11 1/2"
STATION 1271+55 TO STATION 1382+94 S.B.	MM 19.5 TO 17.4	8"	10"	NO	5" to 5 1/2"
RAMP (IL 140)	NA	4"	9"	NO	4 1/4"
RAMP (IL 143)	NA	4"	8"	NO	4 1/4"
RAMP (IL 4)	NA	4"	8"	NO	6 1/2"

USER NAME = Robert Hughes	DESIGNED	KEVISED		
	DRAWN	REVISED	STATE OF ILLINOIS	
PLOT SCALE = 0.16666633 / in.	CHECKED	REVISED	DEPARTMENT OF TRANSPORTATION	
PLOT DATE = 1/27/2023	DATE	REVISED		SCAL

T)/DIOALO			F.A.I. RTE	SECT	TION		COUNTY	TOTAL SHEETS	SHEET NO.				
	TYPICALS				55	60-(1,2	2,3)PP		MADISON	10	4		
									CONTRACT	NO. 76	₹90		
SCALE: NTS	SHEET 1	OF 2	SHEETS	STA+	TO STA+	_			ILLINOIS	FED. AID	PROJECT		

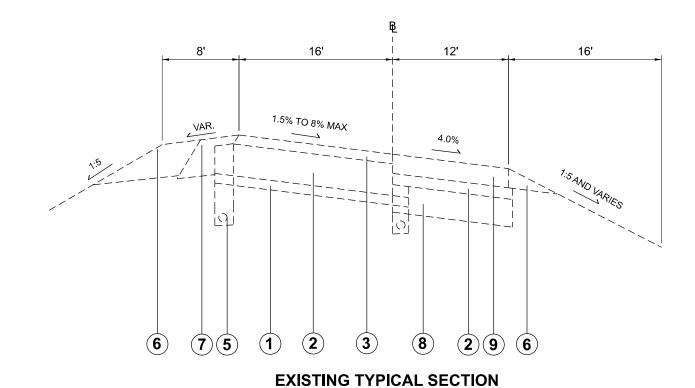

(IL 140, IL 143)

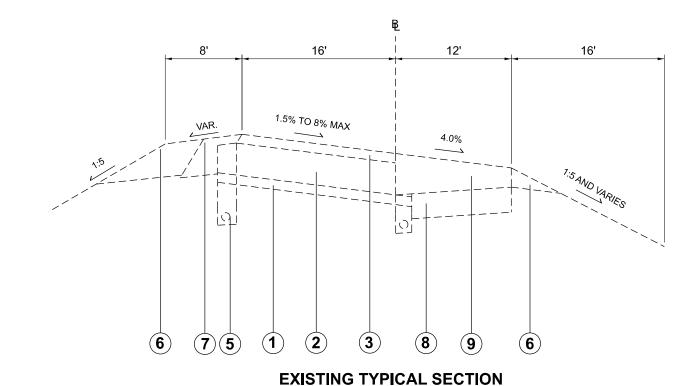

EXISTING LEGEND

- 1 EXISTING STABILIZED SUBBASE (VARIES, SEE CHART)
- 8 EXISTING AGGREGATE BASE COURSE, TYPE A 12"
- 2 EXISTING P.C.C. PAVEMENT (VARIES, SEE CHART)
- (9) EXISTING PCC SHOULDERS 12" (SPECIAL)
- 3 EXISTING BIT. OVERLAY (VARIES, SEE CHART)
- (4) EXISTING STABILIZED SHOULDERS
- **5** EXISTING PIPE UNDERDRAINS
- **6** EXISTING AGGREGATE SHOULDERS
- (7) EXISTING BITUMINOUS SHOULDERS

TABLE 1	APPR. MILE MARKER EQUIVALENCIES	SUBBASE THICKNESS	P.C.C. THICKNESS	CONTINUOUSLY REINFORCED	BIT. OVERLAY THICKNESS
STATION 250+00 TO STATION 520+12.5 N.B & S.B.	MM 39.3 TO 34.0	4"	9"	YES	4 1/4"
STATION 734+00 TO STATION 1033+86.46 N.B. STATION 734+00 TO STATION 1033+86.46 S.B.	MM 29.8 TO 24.3	7"	10"	NO	11 1/2"
STATION 1271+55 TO STATION 1382+94 S.B.	MM 19.5 TO 17.4	8"	10"	NO	5" to 5 1/2"
RAMP (IL 140)	NA	4"	9"	NO	4 1/4"
RAMP (IL 143)	NA	4"	8"	NO	4 1/4"
RAMP (IL 4)	NA	4"	8"	NO	6 1/2"

(IL 4)

MODEL: Sheet 3 [Sheet]

5115111 121111111	AVEMENT MARKING SCHEDUL	_
LOCATION	SKIP DASH WHITE	REMOVAL
LOCATION	(FT)	(SQ FT)
SB I-55 MM 39.0	12	4
SB I-55 MM 38.7	8	3
SB I-55 MM 38.5	8	3
SB I-55 MM 38.4	8	3
SB I-55 MM 38.2	8	3
SB I-55 MM 37.9	8	3
SB I-55 MM 37.8	8	3
SB I-55 MM 37.6	8	3
SB I-55 MM 24.7	8	3
SB I-55 MM 19.5	12	4
NB I-55 MM 39.3	20	7
NB I-55 MM 24.3	8	3
NB I-55 EXIT TO IL 143	8	3
NB I-55 EXIT TO IL 143	64	21
NB I-55 EXIT TO IL 143	20	7
NB I-55 EXIT TO IL 140	8	3
IL 4 ENTRANCE TO I-55 NB	20	7
IL 4 ENTRANCE TO I-55 NB	32	11
TOTAL:	268	89

USER NAME	= Robert.Hughes
PLOT SCALE	= 0.16666633 '/in.
PLOT DATE	= 1/27/2023

DESIGNED -REVISED -DRAWN -REVISED -CHECKED -REVISED -REVISED -DATE

STATE OF ILLINOIS **DEPARTMENT OF TRANSPORTATION**

SCALE: NTS

00115	F.A.I. RTE	SEC	CTION							
SCHEDULE OF QUANTITIES										,2,3)PP
CHEET 4	OE 3	CHEETC	CTA	_	TO CTA	-				

COUNTY TOTAL SHEET NO.


MADISON 10 6 CONTRACT NO. 76R90

	CLASS B PATCHING SCHEDULE											
LOCATION	LENGTH	WIDTH	DEPTH	CLASS B PATCHES, TYPE III, 14 INCH	CLASS B PATCHES, TYPE IV, 14 INCH	CLASS B PATCHES, TYPE II 20 INCH	CLASS B PATCHES, TYPE III, 20 INCH	TIE BARS 3/4"	DOWEL BARS 1 1/4"	DOWEL BARS 1 1/2"	WELDED WIRE REINFORCEMENT	SAW CUTS
	(FT)	(FT)	(IN)	(SQ YD)	(SQ YD)	(SQ YD)	(SQ YD)	(EACH)	(EACH)	(EACH)	(SQ YD)	(FT)
SB I-55 MM 24.7	15	12	21 1/2				20.0			20	20	73
NB I-55 MM 24.3	6	12	21 1/2			8.0				20		49
NB I-55 EXIT TO IL 143	14	16	12 1/4	24.9					28		25	81
NB I-55 EXIT TO IL 143	271	6	12 1/4		180.7			90	8		181	825
NB I-55 EXIT TO IL 143	70	14	12 1/4		108.9			23	24		109	239
NB I-55 EXIT TO IL 140	34	18.5	13 1/4		69.9			11	32		70	144
IL 4 ENTRANCE TO I-55 NB	65	38	14 1/2		274.4			22	72		274	281
IL 4 ENTRANCE TO I-55 NB	106	8	14 1/2		94.2			35	12		94	334
TO	TAL:	1		25	728	8	20	181	176	40	773	2028

CLASS C PATCHING SCHEDULE									
LOCATION	LENGTH	WIDTH	DEPTH	CLASS C PATCHES, TYPE IV, 16 INCH (SPECIAL)	TIE BARS 3/4"	SAW CUTS			
	(FT)	(FT)	(IN)	(SQ YD)	(EACH)	(FT)			
SB I-55 MM 19.5	75	6	15	50.0	25	237			
Ţ	OTAL:			50	25	237			

USER NAME = Robert Hughes	DESIGNED -	REVISED	Γ
	DRAWN	REVISED	
PLOT SCALE = 0.16666633 ' / in.	CHECKED	REVISED	ĺ
PLOT DATE = 2/21/2023	DATE -	REVISED -	

	SCHEDIII	OF QUANTITIE	F.A.I. RTE	SECTION	COUNTY	TOTAL SHEETS	SHEET NO.	
	SCHEDUL	OI QUANTITIE	55	60-(1,2,3)PP	MADISON	8	7	
					CONTRAC	TNO. 76	R90	
SCALE: NTS	SHEET 1 OF 1	SHEETS STA+	+	ILLINOIS FED. AID PROJECT				

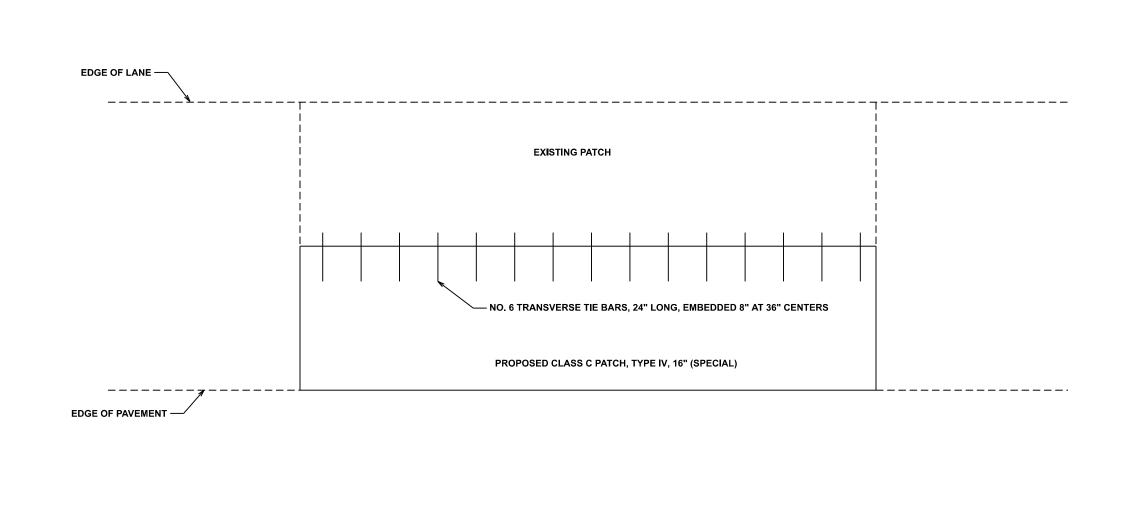

 USER NAME
 = Robert.Hughes
 DESIGNED
 REVISED

 DRAWN
 REVISED

 PLOT SCALE
 = 0.16666633 '/ in.
 CHECKED
 REVISED


 PLOT DATE
 = 1/27/2023
 DATE
 REVISED


STATE OF ILLINOIS
DEPARTMENT OF TRANSPORTATION

 CLASS C PATCH (SPECIAL) DETAIL


 SHEET 1
 OF 1
 SHEETS
 STA. __+__ TO STA. __+_

SCALE: NTS

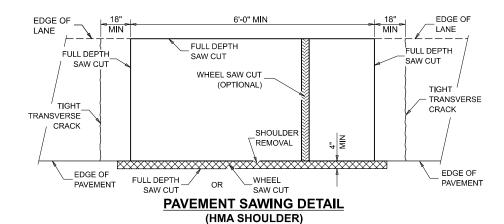


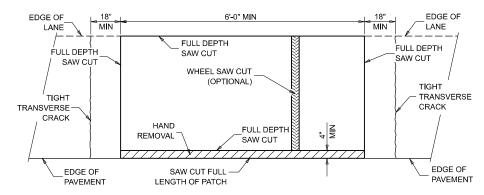

PAVEMENT SAWING DETAIL (PCC SHOULDER)

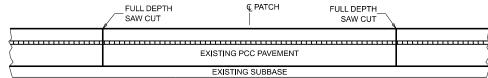


EXISTING PAVEMENT WITHOUT HMA SURFACE

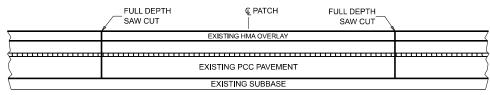


EXISTING PAVEMENT WITH HMA SURFACE

PAVEMENT SAWING DETAIL FOR CLASS A PATCHING (CRC PAVEMENT)

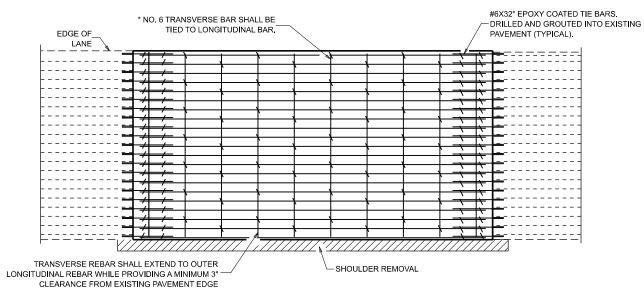

PAVEMENT REINFORCEMENT DETAIL

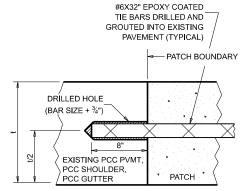

LONGITUDINAL CONSTRUCTION JOINT

PATCHES MORE THAN 20' IN LENGTH SHALL BE TIED TO ADJACENT PAVEMENT, PCC SHOULDERS OR PCC CURB AND GUTTER WITH #6x32" EPOXY COATED TIE BARS AT 36" CENTERS.


NOTES:


EXISTING LONGITUDINAL REINFORCEMENT SPACING; ±6½".

SPACING OF NEW LONGITUDINAL REINFORCEMENT AND NEW LONGITUDINAL TIE BARS SHALL MATCH SPACING OF EXISTING REINFORCEMENT AND SHALL BE TIED TOGETHER WITH A MINIMUM OF TWO TIES PER BAR.

SUPPORT CHAIRS SHALL BE REQUIRED WHENEVER PATCH LENGTH EXCEEDS 6'-0"

- EVERY THIRD INTERSECTION MUST BE TIED. WHEN THE MINIMUM CLEARANCE CANNOT BE OBTAINED WITH THE TRANSVERSE REBAR ON TOP, THEN THE TRANSVERSE REBAR SHALL BE TIED TO THE BOTTOM OF THE LONGITUDINAL REBAR.
- ** VARIABLES WHERE $\mathrm{S}_{1}\mathrm{AND}~\mathrm{S}_{2}\mathrm{ARE}~\mathrm{2}^{1}\!/_{2}\mathrm{"}$ MIN. AND 12" MAX.

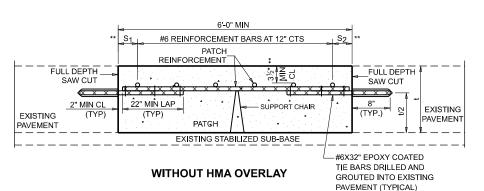

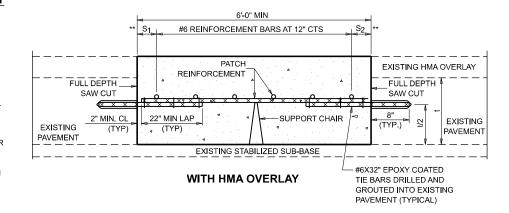

PATCHING DETAIL FOR CLASS A PATCHING (CRC PAVEMENT)

USER NAME = Robert.Hughes	DESIGNED	REVISED -	
	DRAWN	REVISED	
PLOT SCALE = 0.16666633 ' / in.	CHECKED -	REVISED	
PLOT DATE = 1/27/2023	DATE	REVISED	

STATE OF ILLINOIS
DEPARTMENT OF TRANSPORTATION

SCALE: NTS

TRANSVERSE EXPANSION JOINTS

EXISTING

PAVEMENT

FULL DEPTH


SAW CUT

8"


(TYP.)

#6X32" EPOXY COATED TIE BARS DRILLED AND

GROUTED INTO EXISTING PAVEMENT (TYPICAL)

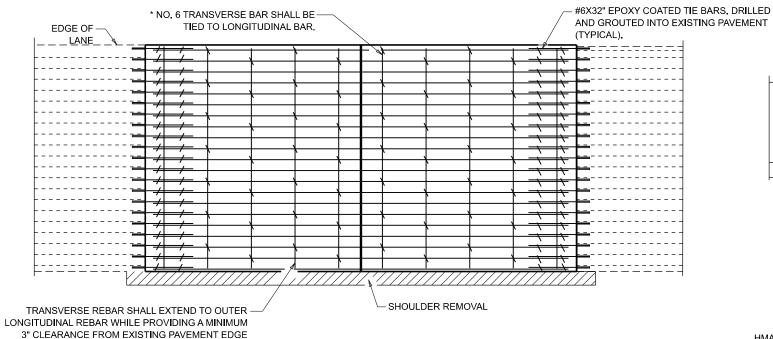


PAVEMENT REINFORCEMENT DETAIL

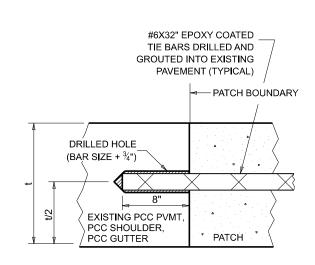

LONGITUDINAL CONSTRUCTION JOINT

PATCHES MORE THAN 20' IN LENGTH SHALL BE TIED TO ADJACENT PAVEMENT, PCC SHOULDERS OR PCC CURB AND GUTTER WITH #6x32" EPOXY COATED TIE BARS AT 36" CENTERS.

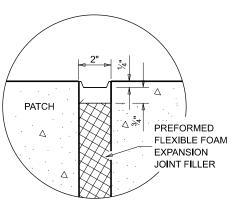

EXISTING -EXISTING HMA SURFACE HMA SURFACE REINFORCEMENT 2" MIN CL (TYP) **FULL DEPTH** FULL DEPTH -SAW CUT SAW CUT SUPPORT 8" 22" MIN LAP 2" MIN CL CHAIR (TYP.) **EXISTING EXISTING** PAVEMENT **PAVEMENT** EXISTING STABILIZED SUB-BASE -#6X32" EPOXY COATED TIE BARS DRILLED AND **WITH HMA OVERLAY** GROUTED INTO EXISTING PAVEMENT (TYPICAL)

6'-0" MIN

SEE SEALING DETAILS -

12'-0" M**I**N

EXISTING STABILIZED SUB-BASE

12'-0" M**I**N

∫ ¢ PATCH

CLASS A PATCH WITH EXPANSION JOINT

WITHOUT HMA OVERLAY

¢ PATCH

6'-0" MIN

SUPPORT

PATCH

6'-0" MIN

CHAIR

2" MIN CL

(TYP)

6'-0" MIN

SEE SEALING DETAILS

PATCH

REINFORCEMENT

22" MIN LAP

(TYP)

FULL DEPTH -

EXISTING


PAVEMENT

SAW CUT

2" MIN CL

(TYP)

SEALING DETAIL

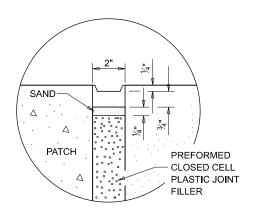

SEALING DETAIL

NOTES:

EXISTING LONGITUDINAL REINFORCEMENT SPACING; ±6½".

SPACING OF NEW LONGITUDINAL REINFORCEMENT AND NEW LONGITUDINAL TIE BARS SHALL MATCH SPACING OF EXISTING REINFORCEMENT AND SHALL BE TIED TOGETHER WITH A MINIMUM OF TWO TIES PER BAR.

SUPPORT CHAIRS SHALL BE REQUIRED WHENEVER PATCH LENGTH EXCEEDS 6'-0"

- * EVERY THIRD INTERSECTION MUST BE TIED. WHEN THE MINIMUM CLEARANCE CANNOT BE OBTAINED WITH THE TRANSVERSE REBAR ON TOP, THEN THE TRANSVERSE REBAR SHALL BE TIED TO THE BOTTOM OF THE LONGITUDINAL REBAR.
- ** VARIABLES WHERE $\rm S_1$ AND $\rm S_2$ ARE $\rm 2^{1}\!\!/_{2}"$ MIN. AND 12" MAX.

USER NAME = Robert.Hughes	DESIGNED	REVISED
	DRAWN	REVISED
PLOT SCALE = 0.16666633 ' / in.	CHECKED	REVISED -
PLOT DATE = 1/27/2023	DATE	REVISED

STATE OF ILLINOIS DEPARTMENT OF TRANSPORTATION

CLASS A	PATCH	(SPE	CIAL) DETAIL	-
SHEET 2	OF 2	SHEETS	STA+	TO STA+

SECTION COUNTY 60-(1,2,3)PP MADISON 10 CONTRACT NO. 76R90