GENERAL NOTES, IDOT STANDARDS, AND TYPICAL SECTION SUMMARY OF QUANTITIES AND EARTHWORK QUANTITIES ALIGNMENT, TIES AND BENCHMARKS **EXISTING CONDITIONS AND REMOVAL PLAN** 

PROPOSED IMPROVEMENTS AND TYPICAL SECTIONS

TITLE SHEET

CONSTRUCTION DETAILS CROSS SECTIONS

> TRAFFIC DATA ADT (2010) = 8000SPEED LIMIT = 35 MPH FUNCTIONAL URBAN

CLASS

BURKE

CHRISTOPHER 9575 West Higgins Posemont, Illinois

ENGINEER: CHAD RIDDLE

OFFICE |

= COLLECTOR

ENGINEERING SCALES. REDUCED SIZED PLANS WILL NOT CONFORM TO STANDARD SCALES. IN MAKING MEASUREMENTS ON REDUCED PLANS, THE ABOVE SCALES MAY BE USED.

JOINT UTILITY LOCATION INFORMATION FOR EXCAVATION I-800-892-0123 OR 811

**CONTRACT NO. 63548** 


### STATE OF ILLINOIS **DEPARTMENT OF TRANSPORTATION DIVISION OF HIGHWAYS**

# PLANS FOR PROPOSED FEDERAL AID HIGHWAY

FAU 2756 (80TH AVENUE) FROM 121ST STREET TO 123RD STREET (McCARTHY ROAD) SIDEWALK PROJECT

> Section No.: 09-00029-00-SW **Project No.: CMM-9003(241) VILLAGE OF PALOS PARK COOK COUNTY**

> > JOB NO.: C-91-327-09

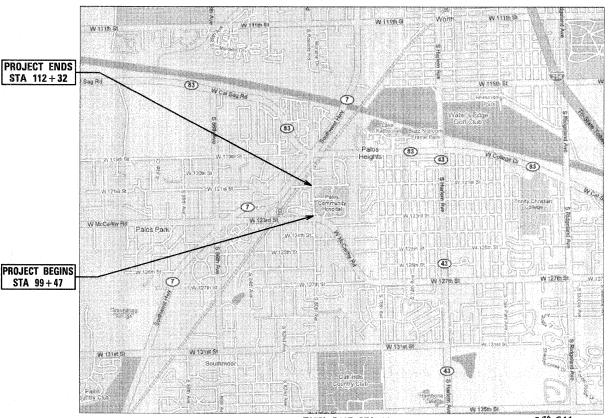

T37N R12E SEC 26 **LOCATION MAP** 

NET LENGTH OF PROJECT = 1285 LINEAL FEET (0.24 MTLES) GROSS LENGTH OF PROJECT = 1285 LINEAL FEET (0.24 MILES)






ENGINEER EXPIRATION DATE: II/30/2011 PRINTED BY AUTHORITY OF THE STATE OF ILLINOIS

SECTION 2756 09-00029-00-SW COOK 14 FED. ROAD DIST. NO. 1 ILLINOIS FED. AID PROJECT

CONTRACT NO. 63548



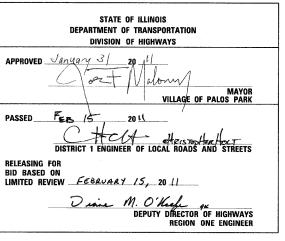

PRINTED BY THE AUTHORITY OF THE STATE OF ILLINOIS

#### SPECIFICATIONS, STANDARDS AND SPECIAL PROVISIONS

#### STAKING

THE CONTRACTOR SHALL PROTECT AND CAREFULLY PRESERVE ALL SECTION OR SUBSECTION MONUMENTS OR PROPERTY OR REFERENCE MARKERS UNTIL THE VILLAGE, HIS AGENT OR AN AUTHORIZED SURVEYOR HAS WITNESSED OR OTHERWISE REFERENCED THEIR LOCATIONS.

ALL RADII FOR PROPOSED CURB AND GUTTER ARE TO THE EDGE OF PAVEMENT UNLESS OTHERWISE NOTED, AND SHALL BE AS INDICATED ON THE PLANS, ELEVATIONS SHOWN AT POINT OF CURVE, ETC. IS EDGE OF PAVEMENT UNLESS OTHERWISE NOTED.

ALL OFFSET LOCATIONS GIVEN ON THE DETAILED PLANS FOR STRUCTURES, ETC., ARE FROM THE PROPOSED BASE LINE OF CONSTRUCTION. FOR STRUCTURES IN THE CURB LIN, THE OFFSET REFERENCES THE EDGE OF PAVEMENT. ALL OTHER STRUCTURES ARE TO THE CENTER OF STRUCTURE

#### MISCELLANEOUS

ACCESS: THE CONTRACTOR SHALL PROVIDE ACCESS TO ABUTTING PROPERTY AT ALL TIMES DURING THE CONSTRUCTION OF THIS PROJECT. EXCEPT FOR PERIODS OF SHORT DURATION. THE COST TO PROVIDE ACCESS SHALL BE INCIDENTAL TO THE CONTRACT

DIMENSIONS: IT SHALL BE THE CONTRACTOR'S RESPONSIBILITY TO VERIFY ALL DIMENSION AND CONDITIONS EXISTING IN THE FIELD PRIOR TO ORDERING MATERIALS AND BEGINNING CONSTRUCTION.

ALL SAWCUTTING SHALL BE INCLUDED IN THE UNIT COST OF REMOVAL ITEMS AND SHALL BE PERFORMED PRIOR TO BEGINNING REMOVAL. ANY ITEMS OF WORK REMOVED PRIOR TO SAWCUTTING WILL NOT BE MEASURED FOR PAYMENT.

PAVEMENT GRADES: THE ELEVATIONS INDICATED ON THE PLANS ARE FINISHED GRADES OF PROPOSED PAVEMENT OF SURFACE COURSE, UNLESS OTHERWISE INDICATED.

BARRICADES: THE CONTRACTOR SHALL PROVIDE AND INSTALL TWO (2) WEIGHTED SAND BAGS ON EACH TYPE I OR TYPE II BARRICADE USED. (ONE (1) WEIGHTED SAND BAG ACROSS EACH BOTTOM RAIL.)

RELOCATING EXISTING SIGNS: EXISTING SIGNS WHICH ARE IN CONFLICT WITH PROPOSED IMPROVEMENTS SHALL BE REMOVED AND REINSTALLED UPON COMPLETION OF CONFLICTING IMPROVEMENTS IN ACCORDANCE WITH THE ILLINOIS DEPARTMENT OF TRANSPORTATION "MANUAL OF UNIFORM TRAFFIC CONTROL DEVICES" AND THE "STANDARD SPECIFICATIONS FOR TRAFFIC CONTROL ITEMS". THIS WORK SHALL BE INCLUDED IN THE COST FOR PORTLAND CEMENT CONCRETE SIDEWALK, 5 INCH, SPECIAL.

ANY EXISTING PAVEMENT DAMAGED BY THE CONTRACTOR DURING THE CONSTRUCTION SHALL BE REPLACED/REPAIRED BY THE CONTRACTOR AT HIS/HERS OWN EXPENSE TO THE SATISFACTION OF THE ENGINEER WITH NO ADDITIONAL COMPENSATION TO THE CONTRACTOR.

ALL TRANSITIONS IN CURB HEIGHT SHALL OCCUR OVER 3 FEET ALONG CURB LINE. AT LOCATIONS WHERE CURB TERMINATES, THE LAST 1 FOOT SHALL BE DEPRESSED. DEPRESSED CURB SHALL ALSO BE AT LOCATIONS SHOWN ON THE PLANS AND AS DIRECTED BY THE ENGINEER.

PAVEMENT REMOVAL HAS BEEN ASSUMED TO BE 10 INCHES.

### STORM SEWER

WHENEVER, DURING CONSTRUCTION, OPERATIONS ANY LOOSE MATERIAL IS DEPOSITED IN THE FLOW LINE OF DRAINAGE STRUCTURES SUCH THAT THE NATURAL FLOW OF WATER IS OBSTRUCTED, IT SHALL BE REMOVED AT THE CLOSE OF EACH WORKING DAY. AT THE CONCLUSION OF CONSTRUCTION OPERATIONS, ALL UTILITY STRUCTURES SHALL BE FREE FROM DIRT AND DEBRIS. THE WORK SPECIFIED ABOVE WILL NOT BE PAID FOR SEPARATELY BUT SHALL BE INCIDENTAL TO THE CONTRACT.

ANY EXISTING OR PROPOSED STORM SEWER DAMAGED BY THE CONTRACTOR DURING CONSTRUCTION SHALL BE REPLACED BY THE CONTRACTOR AT NO COST TO THE VILLAGE.

DRAINAGE STRUCTURE OFFSETS AS SHOWN ON THE PLANS ARE GIVEN TO THE FOLLOWING POINTS: (A) FOR STRUCTURES FALLING IN THE CURB LINE - TO THE EDGE OF PAVEMENT; B) FOR ALL OTHER STRUCTURES - TO THE CENTER OF STRUCTURE.

TOP-OF-FRAME ELEVATIONS SHOWN ON THE PLANS FOR DRAINAGE STRUCTURES IN THE CURB LINE ARE EDGE-OF-PAVEMENT ELEVATIONS.

FRAME ELEVATIONS GIVEN ON THE PLANS ARE ONLY TO ASSIST THE CONTRACTOR IN DETERMINING THE APPROXIMATE OVERALL HEIGHT OF THE STRUCTURE. FRAMES OF ALL NEW, ADJUSTED OR RECONSTRUCTED STRUCTURES SHALL BE ADJUSTED TO THE FINAL ELEVATION OF THE AREA IN WHICH THEY ARE LOCATED AS PART OF THE STRUCTURE, ADJUSTMENT, OR RECONSTRUCTION COST.

WHEN EXISTING DRAINAGE OR SEWERAGE FACILITIES ARE DISTURBED, THE CONTRACTOR SHALL PROVIDE AND MAINTAIN TEMPORARY OUTLETS AND CONNECTIONS FOR ALL PUBLIC OR PRIVATE DRAINS, SEWERS, OR CATCH BASINS, HE SHALL PROVIDE FACILITIES TO TAKE ALL STORM WATER WHICH WOULD BE RECEIVED BY THESE FACILITIES AND DISCHARGE SAME. HE SHALL ALSO PROVIDE AND MAINTAIN AN EFFICIENT PUMPING PLANT, IF NECESSARY. AND A TEMPORARY OUTLET, AND BE PREPARED AT ALL TIMES TO DISPOSE OF THE WATER RECEIVED FROM THESE TEMPORARY CONNECTIONS UNTIL SUCH TIME THAT PERMANENT CONNECTIONS WITH SEWERS ARE CONSTRUCTED AND IN SERVICE. THIS WORK SHALL BE CONSIDERED INCIDENTAL TO THE CONTRACT.

ALL TRENCH BACKFILL QUANTITIES FOR STORM SEWERS HAVE BEEN COMPUTED AND SHALL BE PAID FOR IN ACCORDANCE WITH SPECIFICATIONS FOR WATER AND SEWER MAIN CONSTRUCTION IN ILLINOIS.

ALL REMOVAL OR EXCAVATION ITEMS BEING DISPOSED OF AT AN UNCONTAMINATED SOIL FILL OPERATION OR CLEAN CONSTRUCTION AND DEMOLITION DEBRIS (CCDD) FILL SITE SHALL MEET THE REDUIREMENTS OF PUBLIC ACT 96-1416. ALL COSTS ASSOCIATED WITH MEETING THESE REDUIREMENTS SHALL BE INCLUDED IN THE UNIT PRICE COST FOR THE ASSOCIATED REMOVAL OR EXCAVATION ITEMS IN THE CONTRACT. THESE COSTS SHALL INCLUDE BUT ARE NOT LIMITED TO ALL REDUIRED TESTING, LAB ANALYSIS, CERTIFICATION BY A LICENSED PROFESSIONAL ENGINEER, AND STATE OR LOCAL TIPPING FEES.

#### GENERAL NOTES

THE OWNER, THE VILLAGE OF PALOS PARK SHALL BE NOTIFIED IN WRITING AT LEAST (3) FULL WORKING DAYS PRIOR TO COMMENCEMENT OF CONSTRUCTION.

BEFORE BEGINNING CONSTRUCTION, THE CONTRACTOR SHALL VERIFY THE LINE AND GRADES SHOWN ON THE CONTRACT DRAWINGS. IF THERE ARE ANY DISCREPANCIES FROM WHAT IS SHOWN ON THE CONTRACT DRAWINGS, THE CONTRACTOR SHALL IMMEDIATELY REPORT SAME TO THE OWNER PRIOR TO PERFORMING WORK. CONTRACTOR SHALL BE RESPONSIBLE FOR COORDINATION OF WORK AS REQUIRED.

ALL ELEVATIONS SHOWN ON THE CONTRACT DRAWINGS ARE NAVD 1988 DATUM UNLESS OTHERWISE SPECIFIED.

THE CONTRACT DOCUMENTS ARE NOT INTENDED TO SHOW EVERY AND ALL DETAILS OF WORK TO BE PERFORMED OR EQUIPMENT TO BE SUPPLIED. THE INTENT OF THE CONTRACT DOCUMENTS IS TO ILLUSTRATE THE CONCEPTUAL DESIGN AND LAYOUT. THE CONTRACTOR SHALL BE KNOWLEDGEABLE AND REGULARLY ENCAGED IN THE TYPE OF WORK DESCRIBED BY THESE CONTRACT DOCUMENTS, AND SHALL BE RESPONSIBLE FOR UNDERSTANDING THEIR INTENT. ANY WORK TO BE PERFORMED OR ITEM OF COUTMENT OF THE REPORT OF THE OWNER TO BE SUPPLIED WHICH IS NOT SPECIFICALLY CALLED FOR BY THESE CONTRACT DOCUMENTS BUT WHICH IS NECESSARY TO PROVIDE A COMPLETE AND SUCCESSFUL WORKING SYSTEM SHALL BE INCLUDED IN THE CONTRACTOR'S SCOPE OF WORK AT NO ADDITIONAL COST TO THE OWNER.

IT IS THE CONTRACTOR'S RESPONSIBILITY TO DETERMINE ALL MATERIAL OUANTITIES AND APPRAISE HIMSELF/HERSELF OF ALL CONDITIONS. THE CONTRACT PRICE SUBMITTED BY THE CONTRACTOR SHALL BE CONSIDERED AS THE TOTAL COST FOR THE COMPLETE PROJECT. NO CLAIMS FOR EXTRA WORK WILL BE RECOGNIZED DUE TO THE CONTRACTOR'S FAILURE TO UNDERSTAND THE SCOPE OF WORK.


ORIENTATION OF PIPING, CONDUITS, EQUIPMENT, ETC. MAY VARY. CONTRACTOR TO COORDINATE SAME WITH THE OWNER.

ANY AND ALL DEWATERING REQUIRED TO KEEP EXCAVATIONS DRY SHALL BE THE RESPONSIBILITY OF THE CONTRACTOR.

SOIL EROSION PROTECTION SHALL BE IN ACCORDANCE WITH IEPA STANDARDS AND SPECIFICATIONS FOR SOIL EROSION AND SEDIMENT CONTROL. ALL DISTURBED AREAS (NOT IMPERVIOUS IN NATURE) SHALL BE FINE GRADED, TOP SOIL RESTORED (MIN 6 INCHES) AND SEED/MULCH APPLIED UNLESS OTHERWISE SPECIFIED ON THE PLANS.


#### **IDOT STANDARDS**

(STD. 000001-06)	STANDARD SYMBOLS, ABBREVIATIONS AND PATTERNS
(STD. 280001-05)	TEMPORARY EROSION CONTROL SYSTEMS
(STD. 420001-07)	PAVEMENT JOINTS
(STD. 424001-05)	CURB RAMPS FOR SIDEWALKS
(STD. 542301-03)	PRECASET REINFORCED CONCRETE FLARED END SECTION
(STD. 602001-02)	CATCH BASIN TYPE A
(STD. 604001-03)	FRAME AND LIDS TYPE 1
(STD. 606001-04)	CONCRETE CURB TYPE B AND COMBINATION CONCRETE CURB AND GUTTER
(STD. 701501-06)	LANE CLOSURE, 2L, 2W, DAY ONLY, FOR SPEEDS LESS THAN 45MPH
(STD. 701801-04)	LANE CLOSURE MULTILANE 1W OR 2W CROSSWALK OR SIDEWALK CLOSURE
(STD, 701901-01)	TRAFFIC CONTROL DEVICES

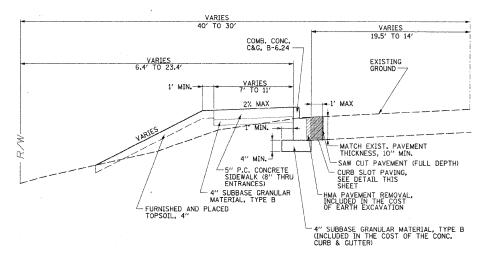

### TYPICAL SECTION

STA 99+47 TO STA 112+17

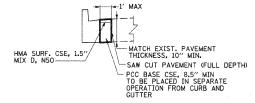

### CURB SLOT PAVING TYPICAL SECTION

STA 99+88 TO STA 112+31

STATE OF ILLINOIS
DEPARTMENT OF TRANSPORTATION

GENERAL NOTES AND IDOT STANDARDS

VILLAGE OF PALOS PARK

SCALE: N.T.S. SHEET NO. OF SHEETS STA. TO STA.

FA.U SECTION COUNTY TOTAL SHEET NO. SHEETS NO. O9-00029-00-SW COOK 14 2 CONTRACT NO. 63548

	PAY ITEM#	ITEM	UNIT	0021 TOTAL QUANTITY
	20200100	EARTH EXCAVATION	CU YD	260
	20800150	TRENCH BACKFILL	CU YD	185
	21101615	TOPSOIL FURNISH AND PLACE, 4"	SQ YD	1000
	25000100	SEEDING, CLASS 1	ACRE	0.02
	25000400	NITROGEN FERTILIZER NUTRIENT	POUND	2
	25000500	PHOSPHORUS FERTILIZER NUTRIENT	POUND	2
	25000600	POTASSIUM FERTILIZER NUTRIENT	POUND	2
	25100630	EROSION CONTROL BLANKET	SQ YD	1000
	25200200	SUPPLEMENTAL WATERING	UNIT	15
*	28000305	TEMPORARY DITCH CHECKS	FOOT	50
	28000400	PERIMETER EROSION BARRIER	FOOT	1200
٠,	28000510	INLET FILTERS	EACH	12
	31101100	SUBBASE GRANULAR MATERIAL, TYPE B	CU YD	130
	35300310	PORTLAND CEMENT CONCRETE BASE COURSE 8 1/2"	SQ YD	150
	40603335	HOT-MIX ASPHALT SURFACE COURSE, MIX "D", N50	TON	15
	42300400	PORTLAND CEMENT CONCRETE DRIVEWAYPAVEMENT, 8 INCH	SQ YD	185
*	42400200	PORTLAND CEMENT CONCRETE SIDEWALK 5 INCH	SQ FT	8100
×	42400410	PORTLAND CEMENT CONCRETE SIDEWALK 8 INCH	SQ FT	390
**	42400800	DETECTABLE WARNINGS	SQ FT	60
	44000100	PAVEMENT REMOVAL	SQ YD	150
	44000200	DRIVEWAY PAVEMENT REMOVAL	SQ YD	150
	44000500	COMBINATION CURB AND GUTTER REMOVAL	FOOT	25


PAY ITEM #	ITEM	UNIT	0021 TOTAL QUANTITY
			-
54213657	PRECAST REINFORCED CONCRETE FLARED END SECTIONS 12"	EACH	3
54213660	PRECAST REINFORCED CONCRETE FLARED END SECTIONS 15"	EACH	1
550A0050	STORM SEWERS, CLASS A, TYPE 1 12"	FOOT	150
550A0070	STORM SEWERS, CLASS A, TYPE 1 15"	FOOT	222
56400100	FIRE HYDRANTS TO BE MOVED	EACH	2
60201340	CATCH BASINS, TYPE A, 4'-DIAMETER, TYPE 24 FRAME AND GRATE	EACH	11
60208240	CATCH BASINS, TYPE C, TYPE 24 FRAME AND GRATE	EACH	2
60207005	CATCH BASINS, TYPE C, TYPE 1 FRAME, CLOSED LID	EACH	1
60237470	INLETS, TYPE A, TYPE 24 FRAME AND GRATE	EACH	2
60250200	CATCH BASINS TO BE ADJUSTED	EACH	1
60255500	MANHOLES TO BE ADJUSTED	EACH	2
60265700	VALVE VAULTS TO BE ADJUSTED	EACH	3
60605000	COMBINATION CONCRETE CURB AND GUTTER, TYPE B-6,24	FOOT	1300
61140100	STORM SEWERS (SPECIAL), 10"	FOOT	30
61140200	STORM SEWERS (SPECIAL), 12"	FOOT	20
01110200	ordina certain de comprise	1001	2.0
67100100	MOBILIZATION	L SUM	1
70102620	TRAFFIC CONTROL AND PROTECTION, STANDARD 701501	LSUM	1
70102640	TRAFFIC CONTROL AND PROTECTION, STANDARD 701801	L SUM	1
	CONSTRUCTION LAYOUT	LSUM	1


\* SPECIAL PROVISION


#### EARTHWORK SCHEDULE

		EARTH EXCAVATION		EARTHWORK	
		ADJUSTED FOR		BALANCE WASTE (+)	
Street	EARTH EXCAVATION	SHRINKAGE (15%)	EMBANKMENT	OR SHORTAGE (-)	TOPSOIL PLACEMENT
	CY	CY .	CY	CY	CY
80th Ave	306	260	215	45	110

FILE NAME =	USER NAME = CMCCOLLO	DESIGNED - CJM	DESIGNED - CJM REVISED - SUMMARY OF QUANTITIES AND EARTHWORK TABLE		WORK TABLE	F.A.U RTE.	SECTION	COUNTY	TOTAL SHEE SHEETS NO.					
N:\palospark\100055\C1v1\\\$001_100055.DG		DRAWN - CJM	REVISED -	STATE OF ILLINOIS		VILLAGE OF PALOS PARK		2756	09-00029-00-SW	COOK	14 3			
	PLOT SCALE = 1'	CHECKED - KRC/DV	REVISED -	DEPARTMENT OF TRANSPORTATION						CONTRAC	T NO. 63548			
	PLOT DATE = 2/17/2011	DATE 10/20/10	REVISED -		SCALE: 1:1'	SHEET NO.	OF	SHEETS	STA.	TO STA.		ILLINOIS FED.	AID PROJECT	

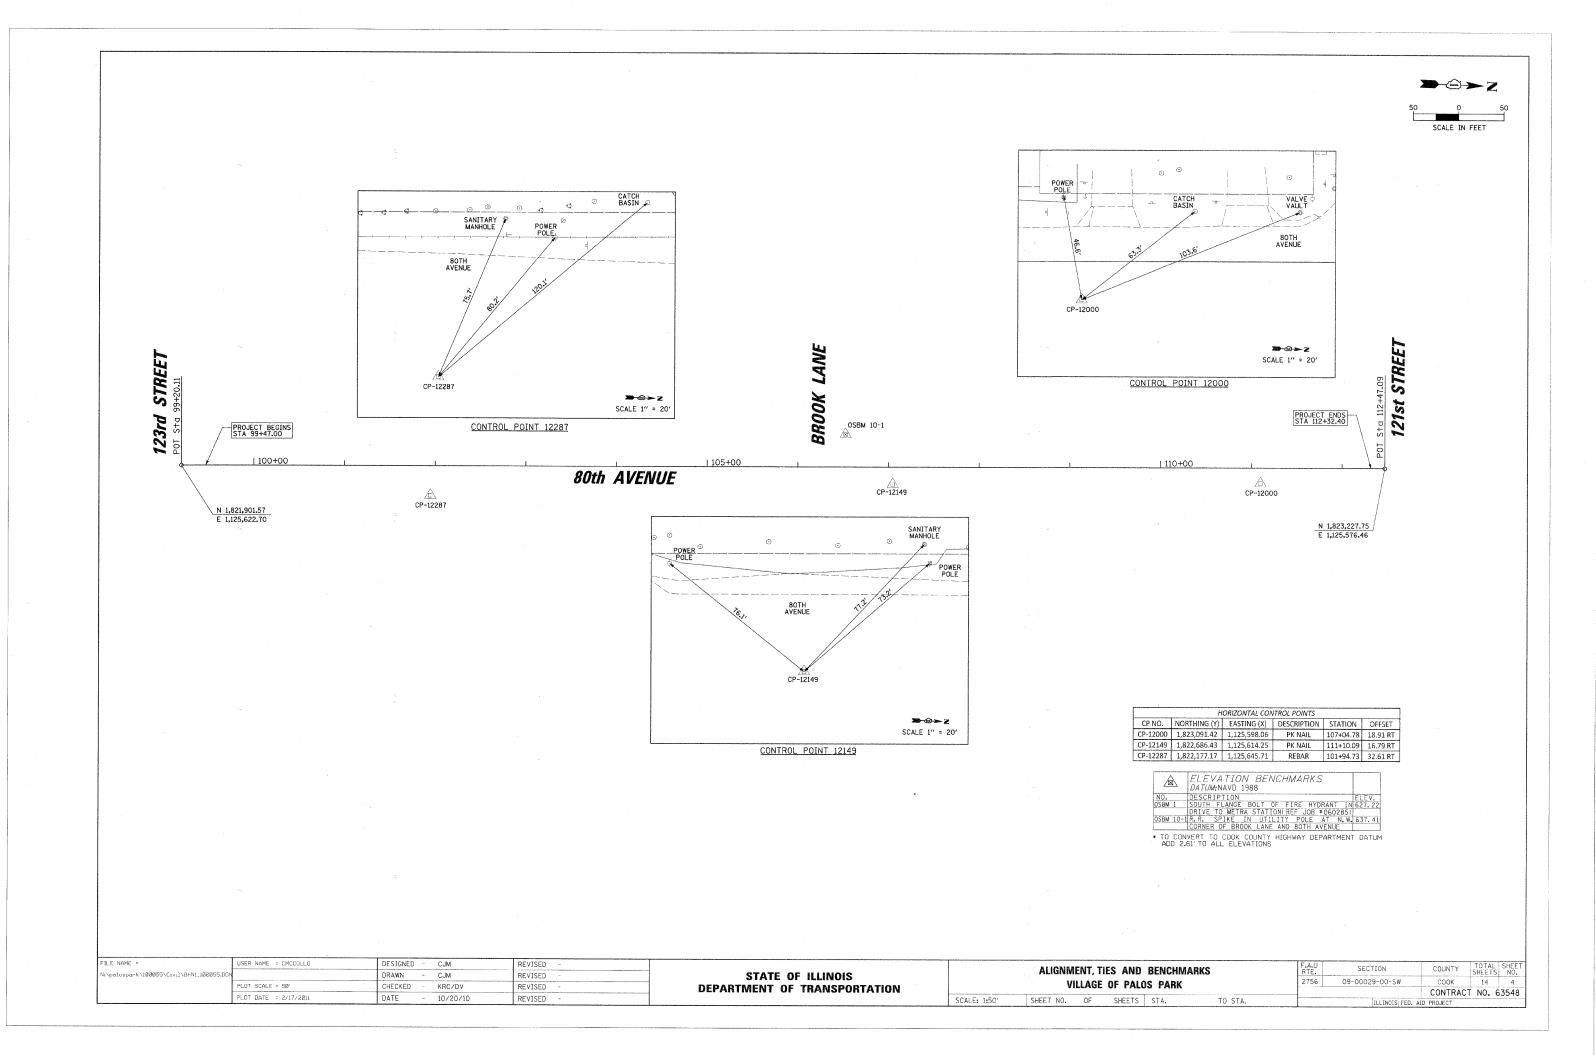

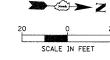

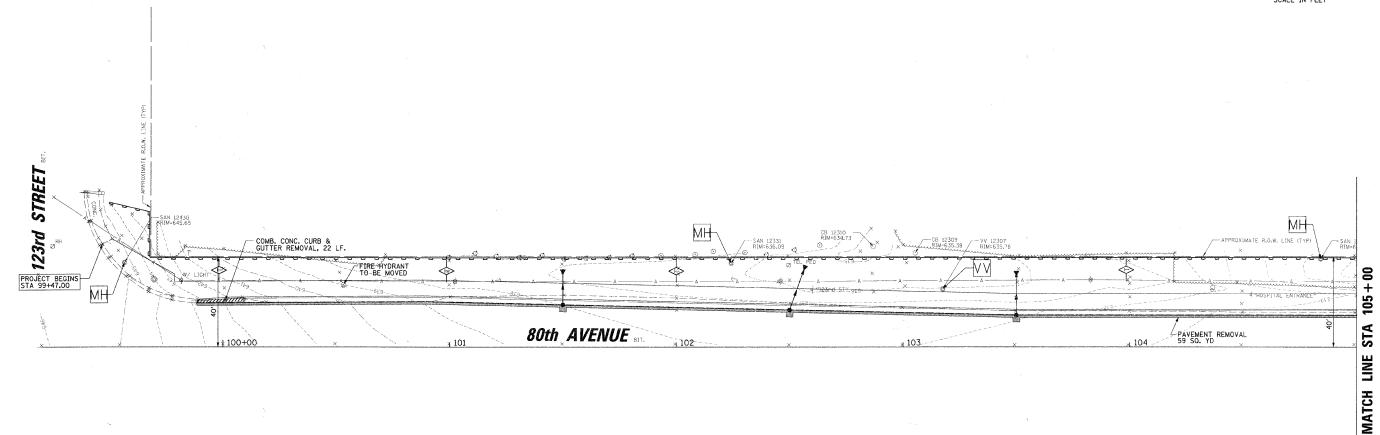

#### LEGEND:

CATCH BASINS TO BE ADJUSTED VALVE VAULTS TO BE ADJUSTED

SHOULDER REMOVAL

MANHOLES TO BE ADJUSTED

PAVEMENT REMOVAL

COMBINATION CURB AND GUTTER REMOVAL PERIMETER EROSION BARRIER

INLET FILTER


DRIVEWAY PAVEMENT REMOVAL


TEMPORARY DITCH CHECK


FILE NAME =	USER NAME = CMCCOLLO	DESIGNED	-	CJM	REVISED	
N:\palospark\100055\Civil\REM1_100055.DGN		DRAWN	-	CJM	REVISED	-
	PLOT SCALE = 20'	CHECKED	-	KRC/DV	REVISED	
	PLOT DATE = 2/17/2011	DATE	m	10/20/10	REVISED	-


STATE	OF	ILLINOIS
DEPARTMENT	OF	TRANSPORTATION

EXISTING	CONDITIONS	S, REN	IOVAL, ANI	) EROSION	CONTROL PLAN	F.A.U RTE.	SECTION	COUNTY	TOTAL SHEETS	SHEET NO.
	V	HACE	OF PAIN	C DADY		2756	. 09-00029-00-SW	COOK	14	5
VILLAGE OF PALOS PARK								CONTRAC	T NO. 6	3548
SCALE: 1:20'	SHEET NO.	OF	SHEETS	STA. 99+20.11	TO STA. 105+00.00		ILLINOIS FED. AI	D PROJECT		

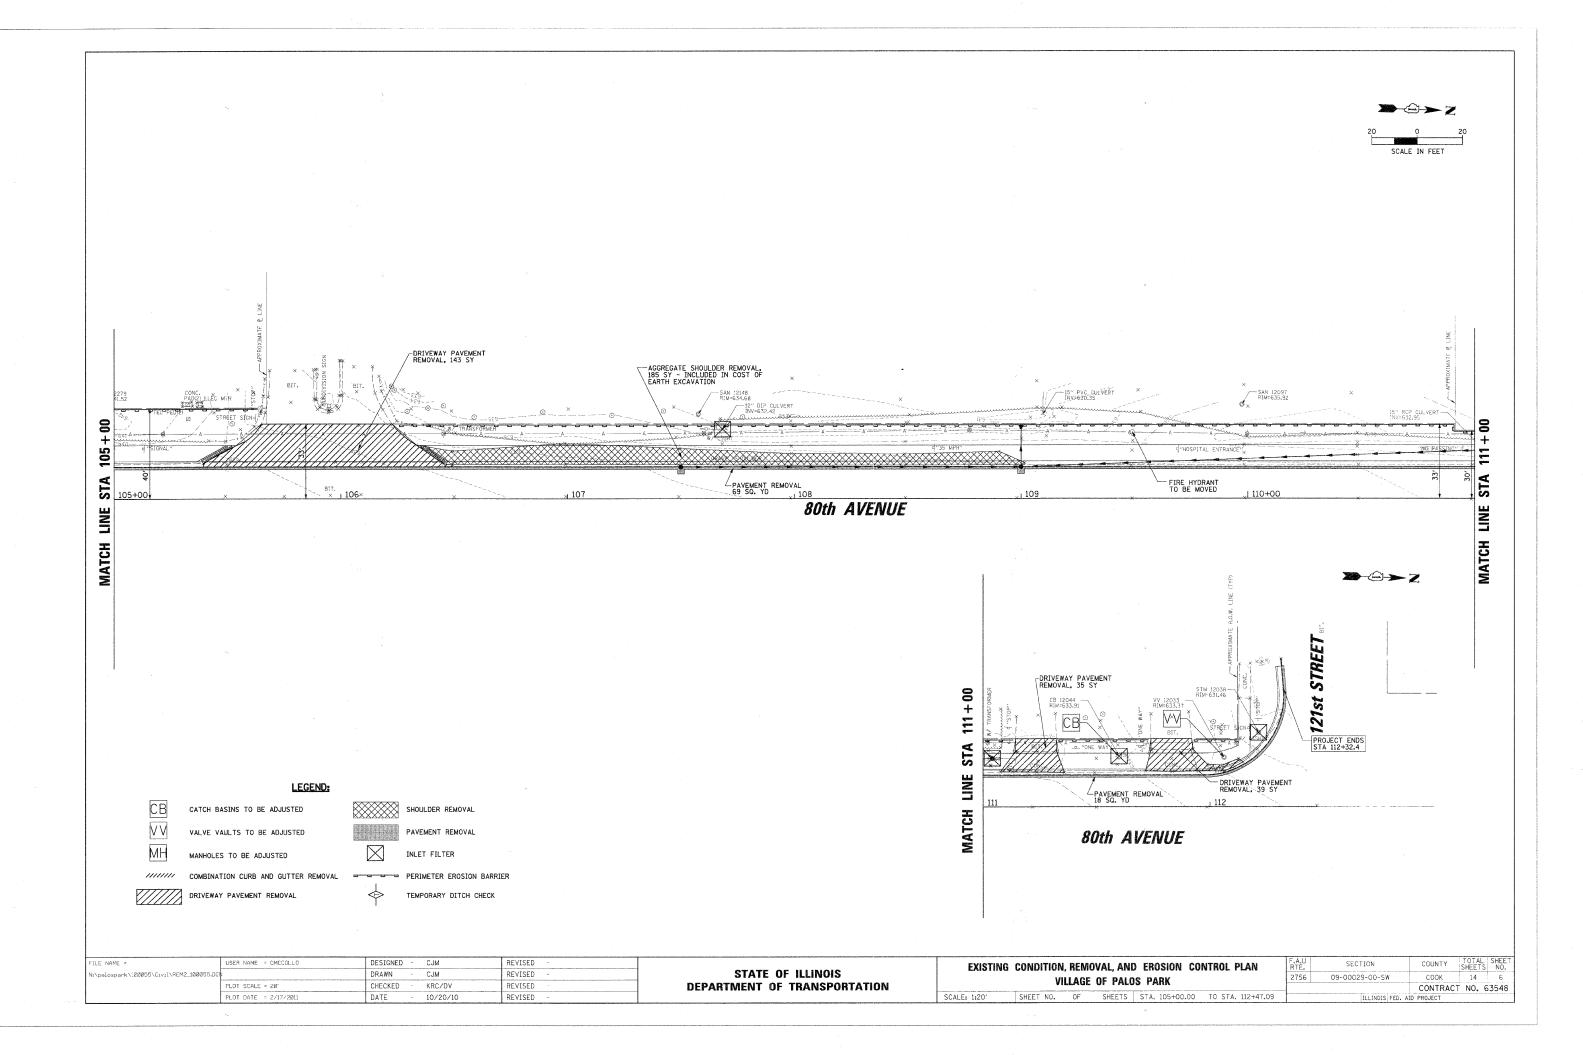

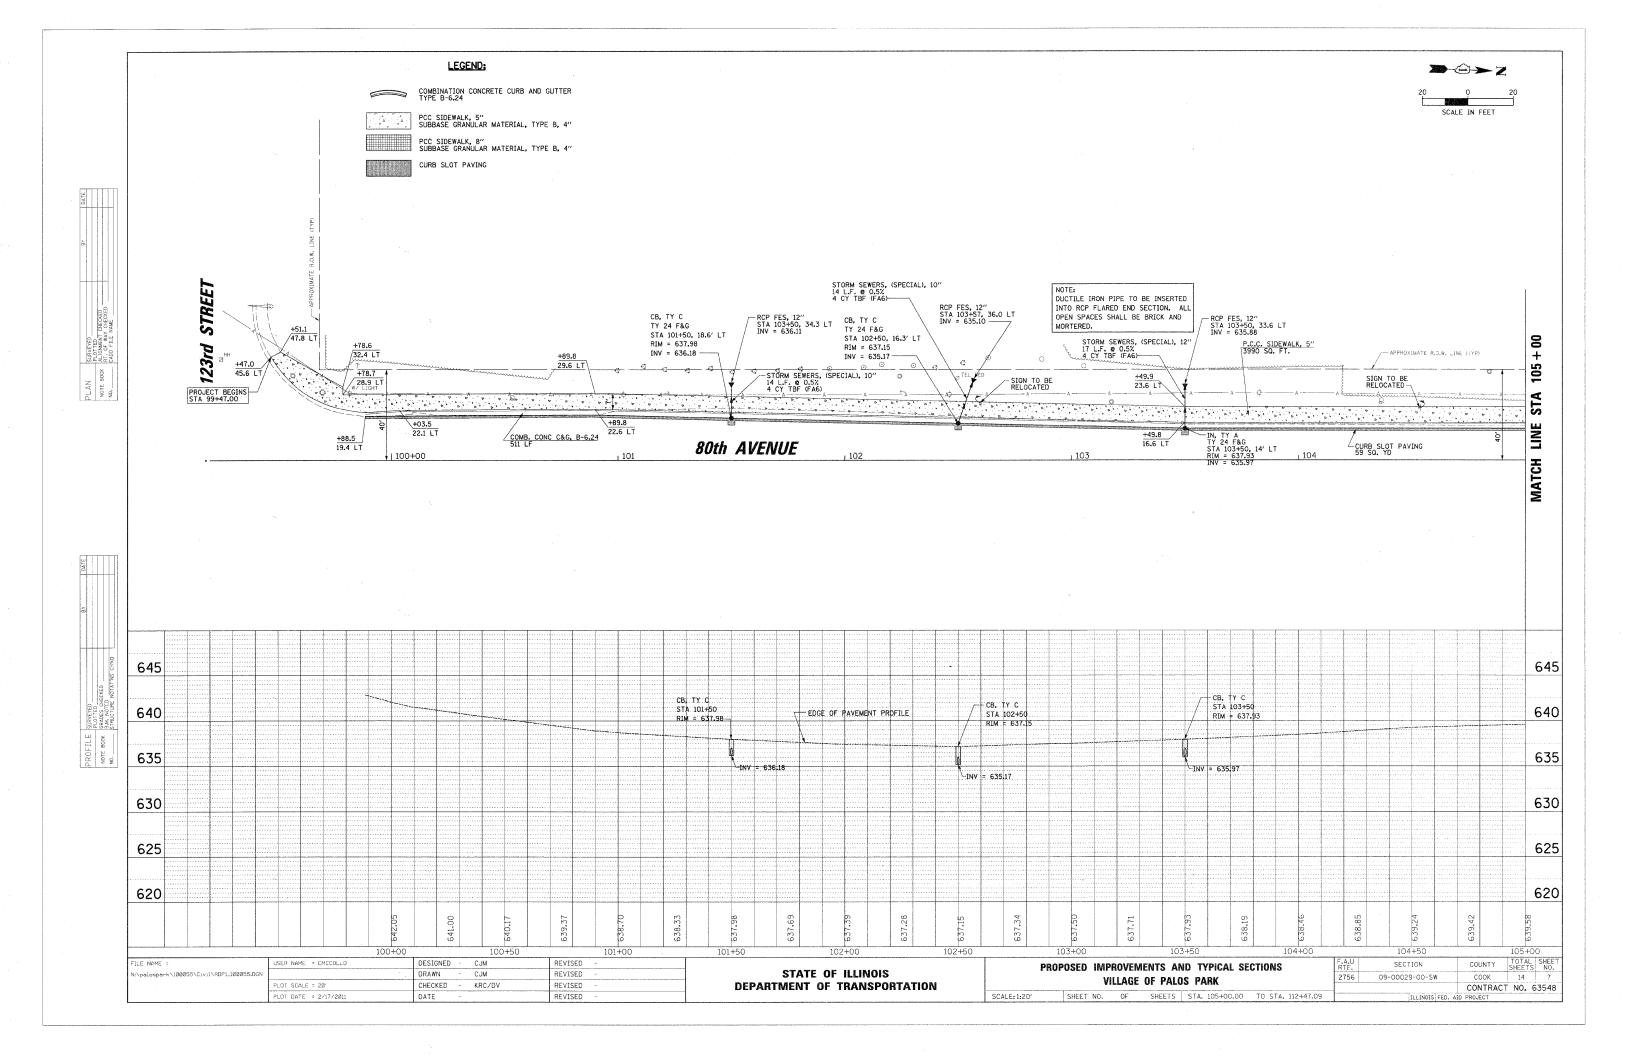


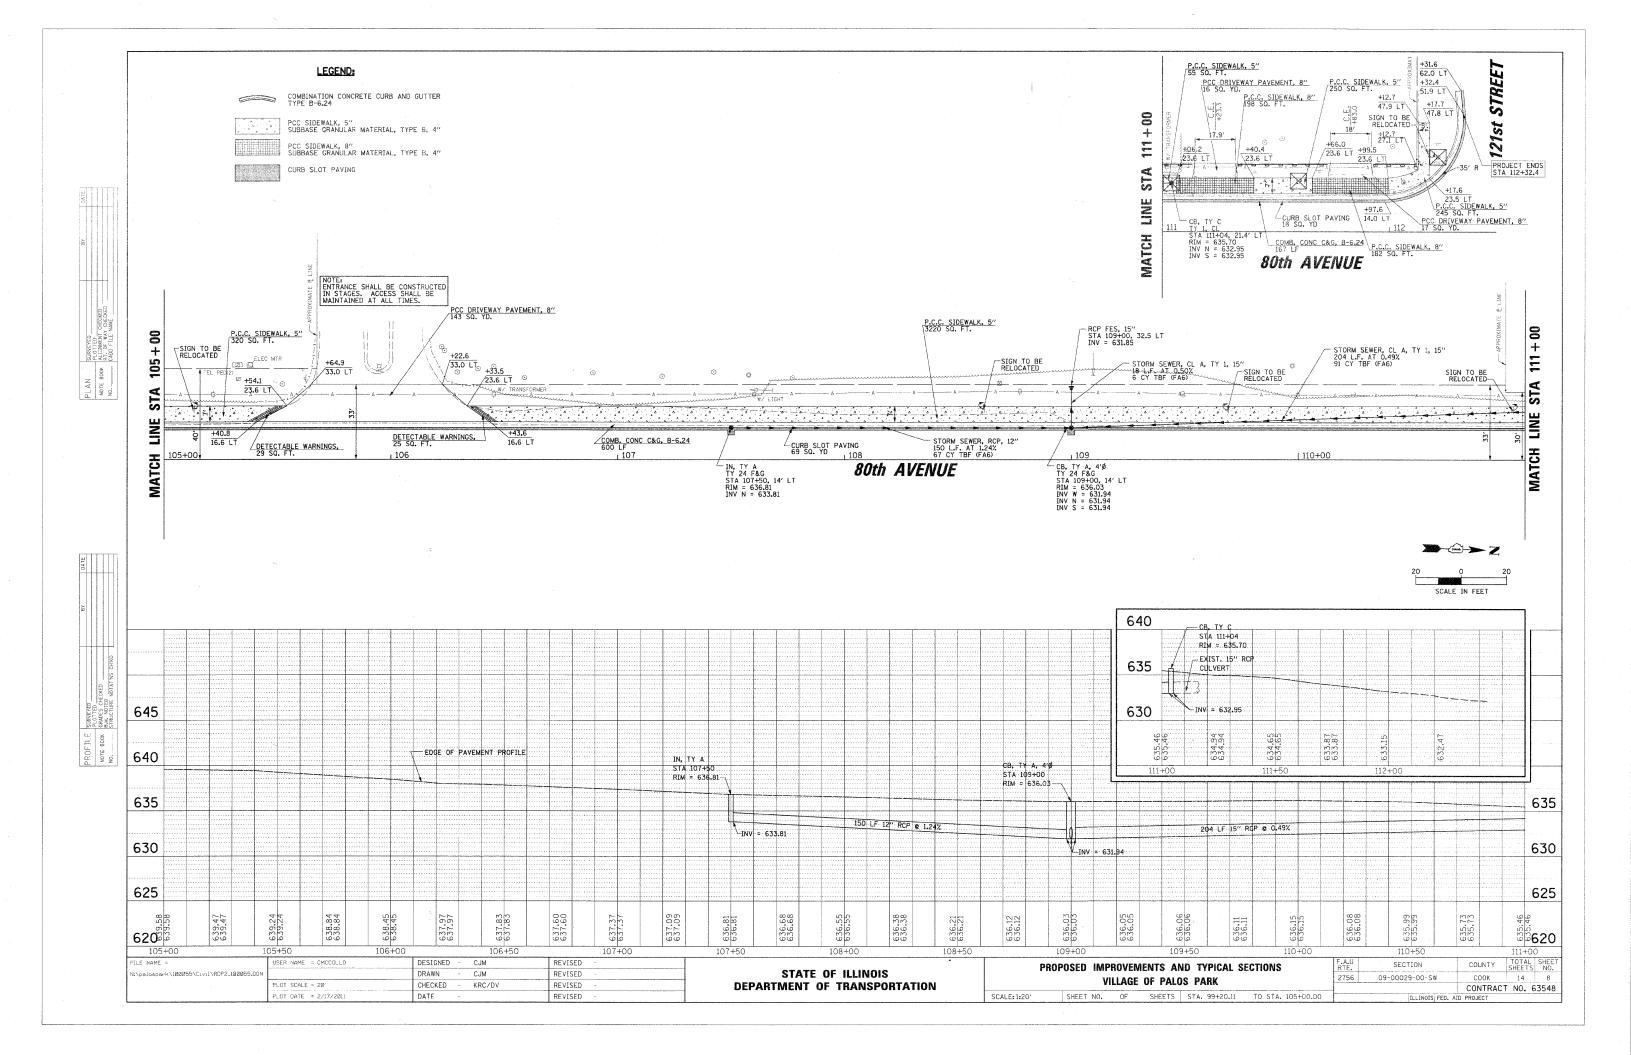

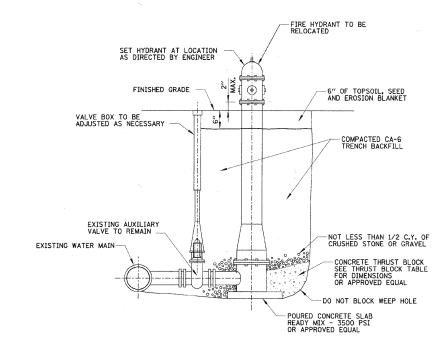

NOTE: HEIGHT FROM FINISHED GRADE TO WATER MAIN ELEVATION VARIES


FIRE HYDRANT

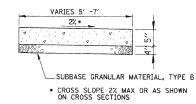

#### NOTES:

- 1. ALL REQUIRED EARTH EXCAVATION TO CONSTRUCT P.C.C. SIDEWALK SHALL BE INCIDENTAL TO THE P.C.C. SIDEWALK 5 INCH, SPECIAL.
- 2. WHEN FORMS ARE REMOVED FROM THE SIDEWALK EITHER THE SIDEWALK SHALL BE BARRICADED OR BACKFILLED WITHIN 24 HOURS.


## P.C.C. SIDEWALK, 5 INCH SPECIAL DETAIL

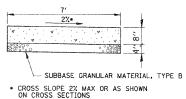

#### NOTES:

- 1. ALL REQUIRED EARTH EXCAVATION TO CONSTRUCT P.C.C. SIDEWALK SHALL BE INCIDENTAL TO THE P.C.C. SIDEWALK 8 INCH, SPECIAL.
- 2. WHEN FORMS ARE REMOVED FROM THE SIDEWALK EITHER THE SIDEWALK SHALL BE BARRICADED OR BACKFILLED WITHIN 24 HOURS.

## P.C.C. SIDEWALK, 8 INCH SPECIAL DETAIL

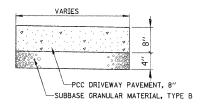

# DRIVEWAY PAVEMENT REPLACEMENT DETAIL

HOT-MIX ASPHALT MIXTURE REQUIREMEN	NTS
ITEM	VOIDS
HOT-MIX ASPHALT SURFACE COURSE, 1-1/2" MIX "D", N50 (IL-9.5 MM)	4% & 50 GYR

THE UNIT WEIGHT USED TO CALCULATE ALL HMA SURFACE MIXTURE QUANTITIES IS 112 LBS/SY/IN.

THE "AC TYPE" FOR POLYMERIZED HMA MIXES SHALL BE "SBS/SBR PG 70-22" AND FOR NON-POLYMERIZED HMA THE "AC TYPE" SHALL BE "PG 64-22" UNLESS MODIFIED BY DISTRICT ONE SPECIAL PROVISIONS.

FOR "PERCENT RAP" SEE DISTRICT ONE SPECIAL PROVISIONS.

		<u> </u>					
FILE NAME =	USER NAME = CMCCOLLO	DESIGNED - CJM	REVISED -		GENERAL DETAILS	F.A.U SECTION	COUNTY TOTAL SHEET
N:\palospark\100055\Civil\	DET1_120055,DGN	DRAWN - CJM	REVISED -	STATE OF ILLINOIS		2756 09-00029-00-SW	COOK 14 9
	PLOT SCALE = 1"	CHECKED - KRC/DV	REVISED -	DEPARTMENT OF TRANSPORTATION	ATION VILLAGE OF PALOS PARK		CONTRACT NO. 63548
	PLOT DATE ≈ 2/17/2011	DATE - 10/20/10	REVISED ~		SCALE: N.T.S. SHEET NO. OF SHEETS STA. TO STA.	ILLINOIS FED. A	AID PROJECT

