04-29-2022 LETTING ITEM 022

FOR LIST OF HIGHWAY STANDARDS, SEE SHEET NO. 2.

STATE OF ILLINOIS **DEPARTMENT OF TRANSPORTATION**

BUREAU CONTRACT NO. 66K35

INDEX OF SHEETS

CROSS SECTIONS

37-40

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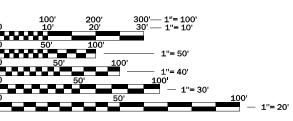
HIGHWAY STANDARDS, GENERAL NOTES & LEGEND 3-7 SUMMARY OF QUANTITIES 8-9 TYPICAL SECTIONS 10-13 SCHEDULES OF QUANTITIES ALIGNMENT. TIES AND BENCHMARKS PLAN & PROFILES 16 RIGHT OF WAY PLAT STAGING PLANS EROSION CONTROL & DRAINAGE PLANS 26 PAVEMENT MARKING & SIGNING PLANS STRUCTURE PLANS 34-36 MISCELLANEOUS DETAILS

PROPOSED HIGHWAY PLANS

FAP ROUTE 316 (IL RTE 26)

SECTION (114)CR PROJECT NO. NHPP-KT28 (758) **CULVERT REPLACEMENT BUREAU COUNTY**


C-93-051-22



FULL SIZE PLANS HAVE BEEN PREPARED USING STANDARD ENGINEERING SCALES. REDUCED SIZED PLANS WILL NOT CONFORM TO STANDARD SCALES. IN MAKING MEASUREMENTS ON REDUCED PLANS, THE ABOVE SCALES MAY BE USED.

JOINT UTILITY LOCATION INFORMATION FOR EXCAVATION 1-800-892-0123

PROJECT ENGINEER: JACOB OYIER, P.E. **UNIT CHIEF: STEPHANIE CARMIN DISTRICT 3 NO. (815) 434-6131** CONTRACT NO. 66K35

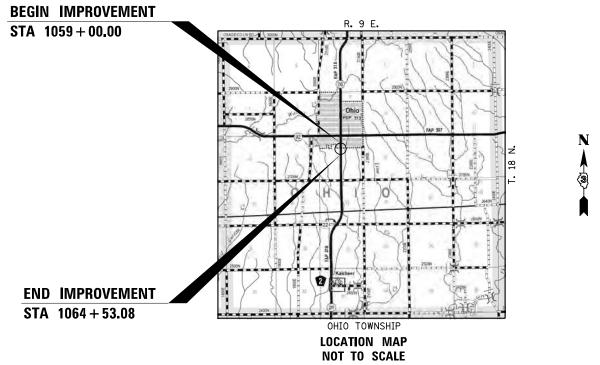


GROSS LENGTH = 553.08 FT. = 0.105 MILE NET LENGTH = 553.08 FT. = 0.105 MILE Hutchison Engineering, Inc.



JOB #4684.09

C-93-051-22

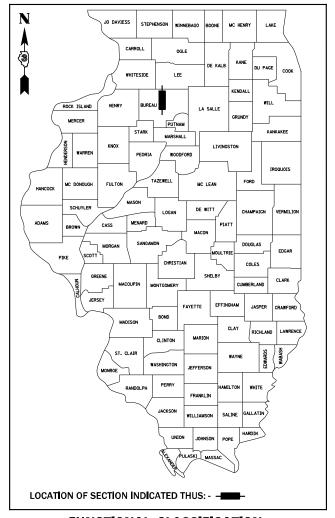

FUNCTIONAL CLASSIFICATION PRINCIPAL ARTERIAL 2019 ADT = 2250

P.U. = 88% S.U. = 7% M.U. = 5%

DESIGN SPEED = 55 MPH

STATE OF ILLINOIS DEPARTMENT OF TRANSPORTATION SUBMITTED February 07, 20 22 REGIONAL ENGINEER

PRINTED BY THE AUTHORITY OF THE STATE OF ILLINOIS

GENERAL NOTES

THE THICKNESS OF HMA SHOWN ON THE PLANS IS THE NOMINAL THICKNESS. DEVIATIONS FROM THE NOMINAL THICKNESS WILL BE PERMITTED WHEN SUCH DEVIATIONS OCCUR DUE TO IRREGULARITIES IN THE EXISTING SURFACE OR BASE ON WHICH THE HMA IS PLACED.

EXCEPT AS NOTED ON THE PLANS, PAVEMENT GRADES SHOWN ARE AT THE TOP OF PAVEMENT SURFACES.

BEFORE ORDERING PIPE CULVERTS OR PIPE DRAINS, THE CONTRACTOR SHALL CONSULT THE ENGINEER FOR EXACT LENGTHS.

THE ENGINEER WILL BE THE SOLE JUDGE CONCERNING CURING TIME FOR THE VARIOUS HMA LIFTS.

FOR STABILIZATION, ALL TYPE III BARRICADES SHALL REQUIRE A MINIMUM OF FOUR SAND BAGS PER BARRICADE.

SEEDING SHALL NOT BE PERMITTED AT ANY TIME WHEN THE GROUND IS FROZEN, WET, OR IN AN UNTILLABLE CONDITION. LOCATIONS TO BE SEEDED WILL BE DETERMINED BY THE ENGINEER.

ONLY THOSE TREES DESIGNATED BY THE ENGINEER OR LISTED IN THE TREE REMOVAL SCHEDULE SHALL BE REMOVED. THE CONTRACTOR SHALL PROTECT ALL REMAINING TREES FROM DAMAGE DUE TO THEIR OPERATIONS. NO TREES WILL BE REMOVED FROM APRIL 1ST TO SEPTEMBER 30TH DUE TO FEDERALLY PROTECTED BAT SPECIES HABITAT.

ALL ELEVATIONS REFER TO U.S.G.S. MEAN SEA LEVEL DATUM.

ANY REFERENCE TO A STANDARD IN THESE PLANS SHALL BE INTERPRETED TO MEAN THE EDITION AS INDICATED BY THE SUBNUMBER SHOWN IN THE LIST OF STANDARDS OR THE COPY INCLUDED IN THESE PLANS.

THE REMOVAL AND DISPOSAL OF ALL FENCING, DELINEATORS, DEBRIS, BRUSH, RIPRAP, STONE CONCRETE SLABS, TILE, ETC. NOT PAID SPECIFICALLY ON THE PLANS WILL BE INCLUDED IN THE COST OF EARTH EXCAVATION.

MEMBERS OF J.U.L.I.E. KNOWN TO BE WITHIN THE LIMITS OF THE IMPROVEMENT ARE:

- . VILLAGE OF OHIO
- AT&T 4. COMED

 AT&T 5. HEARTLAND CABLE
- AT&T
 FRONTIER

NON-MEMBERS OF J.U.L.I.E. KNOWN TO BE WITHIN THE LIMITS ARE:

1. ILLINOIS DEPARTMENT OF TRANSPORTATION

THE CONTRACTOR SHALL CONTACT J.U.L.I.E. AT LEAST 48 HOURS PRIOR TO EXCAVATION TO DETERMINE WHICH UTILITIES ARE IN THE AREA.

THE FINISHED EARTHWORK SHALL HAVE A VEGETATION SUSTAINING SOIL COVERING THE TOP FOUR INCHES (100 MM) IN AREAS TO BE SEEDED OR SODDED. THE VEGETATION SUSTAINING SOIL REQUIRED WILL NOT BE PAID FOR SEPARATELY BUT WILL BE INCLUDED IN THE COST OF FURNISHED EXCAVATION.

ABANDONED UTILITIES THAT CONFLICT WITH THE CONSTRUCTION SHALL BE DISPOSED OF OUTSIDE THE LIMITS OF THE RIGHT OF WAY ACCORDING TO ARTICLE 202.03 OF THE STANDARD SPECIFICATIONS AND AS DIRECTED BY THE ENGINEERS. THIS WORK WILL NOT BE PAID FOR SEPARATELY, BUT WILL BE INCLUDED IN THE COST OF EARTH EXCAVATION.

ALL DAMAGE TO THE DEPARTMENT OWNED UNDERGROUND FACILITIES, CAUSED BY THE CONTRACTOR SHALL BE REPAIRED TO THE SATISFACTION OF THE DEPARTMENT AT THE CONTRACTOR'S EXPENSE. THIS SHALL INCLUDE ALL TEMPORARY REPAIRS REQUIRED TO KEEP THE FACILITY OPERATIONAL WHILE MATERUAL IS BEING OBTAINED TO MAKE PERMANENT REPAIRS.

BEFORE BEGINING ANY WORK, THE CONTRACTOR SHALL RETAIN AND RECORD FOR FUTURE REFERENCE, ALL EXISTING PAVEMENT MARKING LINES AND RAISED REFLECTIVE PAVEMENT MARKERS THAT CONFLICT WITH THE PROPOSED STRIPING AT THE COMPLETION OF THIS CONTRACT, EXACT LOCATIONS OF ALL PROPOSED PAVEMENT MARKINGS SHALL BE DIRECTED BY THE RESIDENT ENGINEER.

THE FOLLOWING RATES OF APPLICATION HAVE BEEN ASSUMED IN CALCULATING PLAN QUANTITIES:

GRANULAR MATERIALS	2.05	TONS/CH YD			
BITUMINOUS MATERIALS PRIME COAT					
DITOMINOUS MATERIALS TRIME COAT-		IBS/SQ FT			
PRIME COAT FOR AGGREGATE BASES					
HOT-MIX ASPHALT SURFACE COURSE					
HOT-MIX ASPHALT BINDER COURSE	115	LBS/SQ YD/INCH			
LEVELING BINDER (MACHINE METHOD)	112	LBS/SQ YD/INCH			
NITROGEN FERTILIZER NUTRIENT	60	LBS/ACRE (SODDING)	90	LBS/ACRE	(SEEDING
PHOSPHORUS FERTILIZER NUTRIENT	60	LBS/ACRE (SODDING)	90	LBS/ACRE	(SEEDING
POTASSIUM FERTILIZER NUTRIENT	60	LBS/ACRE (SODDING)	90	LBS/ACRE	(SEEDING

COMMITMENTS

NONE.

HIGHWAY STANDARDS

000001-08 001006 280001-07 542206-04 542401-04 630001-12	STANDARD SYMBOLS, ABBREVIATIONS AND PATTERNS DECIMAL OF AN INCH AND OF A FOOT TEMPORARY EROSION CONTROL SYSTEMS REINFORCED CONCRETE END SECTIONS FOR PIPE CULVERTS 42" THRU 60" DIA. SKEWED WITH ROADWAY METAL END SECTION FOR PIPE CULVERTS STFFI PI ATF BFAM GUARDRAII
630201-07	PCC/HMA STABILIZATION AT STEEL PLATE BEAM GUARDRAIL
630301-09 666001-01	SHOULDER WIDENING FOR TYPE 1 (SPECIAL) GUARDRAIL TERMINALS RIGHT OF WAY MARKERS
701001-01	OFF-RD OPERATIONS, 2L, 2W, MORE THAN 15' AWAY
701006-05	OFF-RD OPERATIONS, 2L, 2W, 15' TO 24" FROM PAVEMENT EDGE
701011-04	OFF-RD MOVING OPERATIONS, 2L, 2W, DAY ONLY
701201-05	LANE CLOSURE, 2L, 2W, DAY ONLY, FOR SPEEDS > 45 MPH
701301-04	LANE CLOSURE, 2L, 2W, SHORT TIME OPERATIONS_
701306-04	LANE CLOSURE, 2L, 2W, SLOW MOVING OPERATIONS DAY ONLY, FOR SPEEDS > 45 MPH
701311-03	LANE CLOSURE, 2L, 2W, MOVING OPERATIONS - DAY ONLY
701321-18 701326-04	LANE CLOSURE, 2L, 2W, BRIDGE REPAIR WITH BARRIER LANE CLOSURE. 2L. 2W. PAVEMENT WIDENING. FOR SPEEDS > 45 MPH
701901-08	TRAFFIC CONTROL DEVICES
704001-08	TEMPORARY CONCRETE BARRIER
720001-01	SIGN PANEL MOUNTING DETAILS
720006-04	SIGN PANEL ERECTION DETAILS
720011-01	METAL POSTS FOR SIGNS, MARKERS & DELINEATORS
725001-01	OBJECT AND TERMINAL MARKERS
728001-01	TELESCOPING_STEEL SIGN_SUPPORT
780001-05	TYPICAL PAVEMENT MARKINGS
781001-04	TYPICAL APPLICATIONS RAISED REFLECTIVE PAVEMENT MARKERS
782006-01	GUARDRAIL AND BARRIER WALL REFLECTOR MOUNTING DETAILS

<u>LEGEND</u>

HOT-MIX ASPHALT BUTT JOINT

→ → PROPOSED DITCH FLOW

TO BE REMOVED

STATE OF ILLINOIS
DEPARTMENT OF TRANSPORTATION
DISTRICT THREE
AS BUILT INFORMATION

TBR

STATE OF ILLINOIS
DEPARTMENT OF TRANSPORTATION
DISTRICT THREE

	SUPERVISING CONSTRUCTION FIELD ENGINEER		
		PREPARED BY:	
			DISTRICT STUDIES & PLANS ENGINEER
	RESIDENT ENGINEER / TECHNICIAN		
		DATE:	
START & END DATES			
OF CONSTRUCTION:			
		EXAMINED BY:	
INSPECTORS:			DISTRICT CONSTRUCTION ENGINEER
			DISTRICT MATERIALS ENGINEER
			DISTRICT OPERATIONS ENGINEER

Hutchison Engineering, Inc.

Jacksonville - Moline - Peorla - Shorewood
Since 1945

STATE OF ILLINOIS
DEPARTMENT OF TRANSPORTATION

FAP ROUTE 316 (IL RTE 26)
HIGHWAY STANDARDS, GENERAL NOTES & LEGEND

SCALE: N/A

SHEET 1 OF 1 SHEETS STA. N/A TO STA. N/A

CONSTR.	COD
80% FE	-
20% STA	ΙΤΕ

				ROADWAY
CODE	LTEM	LINIT	TOTAL	0004
NO.	ITEM	UNIT	QUANTITY	RURAL
20200100	EARTH EXCAVATION	CU YD	165	165
20201200	REMOVAL AND DISPOSAL OF UNSUITABLE MATERIAL	CU YD	44	44
20400800	FURNISHED EXCAVATION	CU YD	208	208
20700220	POROUS GRANULAR EMBANKMENT	CU YD	44	44
20800150	TRENCH BACKFILL	CU YD	92	92
25000210	SEEDING, CLASS 2A	ACRE	0.50	0.50
25000400	NITROGEN FERTILIZER NUTRIENT	POUND	40	40
25000500	PHOSPHORUS FERTILIZER NUTRIENT	POUND	40	40
23000300	- THOSTHOROS TERTIFICIAL NOTIFICATION	1 00110	40	
25000600	POTASSIUM FERTILIZER NUTRIENT	POUND	40	40
25100630	EROSION CONTROL BLANKET	SQ YD	1695	1695
28000250	TEMPORARY EROSION CONTROL SEEDING	POUND	50	50
28000305	TEMPORARY DITCH CHECKS	FOOT	50	50
28000400	PERIMETER EROSION BARRIER	FOOT	1071	1071
28000500	INLET AND PIPE PROTECTION	EACH	1	1

9		
2	TT	U
Y IVIE	Hutchison Engineering, Inc.	
ž	Jacksonville - Moline - Peoria - Shorewood	PI
Ĕ	Since 1945	PL

	USER NAME = default	DESIGNED	-	LDZ	REVISED -
nc.		DRAWN	-	RMD	REVISED -
boo	PLOT SCALE = \$SCALE\$	CHECKED	-	WLP	REVISED -
	PLOT DATE = 1/11/2022	DATE	-	11/5/2021	REVISED -

				CONSTITUTE CODE
				80% FED 20% STATE
			1	ROADWAY
CODE			TOTAL	0004
NO.	ITEM	UNIT	QUANTITY	RURAL
28100107	STONE RIPRAP, CLASS A4	SQ YD	24	24
28200200	FILTER FABRIC	SQ YD	24	24
40600290	BITUMINOUS MATERIALS (TACK COAT)	POUND	1079	1079
40.500.270		5007		552
40600370	LONGITUDINAL JOINT SEALANT	FOOT	553	553
40604052	HOT-MIX ASPHALT SURFACE COURSE, IL-9.5, MIX "C", N70	TON	184	184
40800050	INCIDENTAL HOT-MIX ASPHALT SURFACING	TON	11	11
44000156	HOT-MIX ASPHALT SURFACE REMOVAL, 1 3/4"	SQ YD	1821	1821
44201809	CLASS D PATCHES, TYPE IV, 13 INCH	SQ YD	52	52
48101200	AGGREGATE SHOULDERS, TYPE B	TON	23	23
			_	
48203021	HOT-MIX ASPHALT SHOULDERS, 6"	SQ YD	393	393
50105220	PIPE CULVERT REMOVAL	FOOT	49	49
50800105		POUND	2008	2008
52200020	TEMPORARY SOIL RETENTION SYSTEM	SQ FT	538	538
54003000	CONCRETE BOX CULVERTS	CU YD	10	10
542A1105	PIPE CULVERTS, CLASS A, TYPE 2 60"	FOOT	78	78
542D0223	PIPE CULVERTS, CLASS D, TYPE 1 18"	FOOT	54	54
		1		<u> </u>

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ic.		DRAWN	-	RMD	REVISED	-
bod	PLOT SCALE = \$SCALE\$	CHECKED	-	WLP	REVISED	-
	PLOT DATE = 1/11/2022	DATE	-	11/5/2021	REVISED	-

STATE OF ILLINOIS	
DEPARTMENT OF TRANSPORTATION	NC

FAP ROUTE 316 (IL RTE 26) SUMMARY OF QUANTITIES						
SHEET	2	OF	5	SHEETS	STA. N/A	

TO STA. N/A

SCALE: N/A

CONSTR. CODE

				80% FED 20% STATE
				ROADWAY
CODE			TOTAL	0004
NO.	ITEM	UNIT	QUANTITY	RURAL
54215460	CAST-IN-PLACE REINFORCED CONCRETE END SECTIONS 60"	EACH	1	1
54262718	METAL FLARED END SECTIONS 18"	EACH	2	2
63000001	STEEL PLATE BEAM GUARDRAIL, TYPE A, 6 FOOT POSTS	FOOT	337.5	337.5
63100045	TRAFFIC BARRIER TERMINAL, TYPE 2	EACH	1	1
63100167	TRAFFIC BARRIER TERMINAL, TYPE 1 (SPECIAL) TANGENT	EACH	3	3
63200310	GUARDRAIL REMOVAL	FOOT	648	648
67100100	MOBILIZATION	L SUM	1	1
70100405	TRAFFIC CONTROL AND PROTECTION, STANDARD 701321	EACH	1	1
70106500	TEMPORARY BRIDGE TRAFFIC SIGNALS	EACH	1	1
70300100	SHORT TERM PAVEMENT MARKING	FOOT	1960	1960
70300150	SHORT TERM PAVEMENT MARKING REMOVAL	SQ FT	330	330
70300221	TEMPORARY PAVEMENT MARKING - LINE 4" - PAINT	FOOT	2237	2237
70300281	TEMPORARY PAVEMENT MARKING - LINE 24" - PAINT	FOOT	60	60
70400100	TEMPORARY CONCRETE BARRIER	FOOT	237.5	237.5

CONSTR. CODE

*= SPECIALTY ITEM

H utchison Engineering Ir	USER NAME = default	DESIGNED - LDZ	REVISED -		FAP ROUTE 316 (IL RTE 26)	F.A.P. SECTION COUNTY TOTAL SHEET NO.
≝ ∏ uīcnison Engineering, ir		DRAWN - RMD	REVISED -	STATE OF ILLINOIS	· · · · · ·	316 (114)CR BUREAU 40 5
Jacksonville - Moline - Peoria - Shorewo	od PLOT SCALE = \$SCALE\$	CHECKED - WLP	REVISED -	DEPARTMENT OF TRANSPORTATION	SUMMARY OF QUANTITIES	CONTRACT NO. 66K35
Since 1945	PLOT DATE = 1/17/2022	DATE - 11/5/2021	REVISED -		SCALE: N/A SHEET 3 OF 5 SHEETS STA. N/A TO STA. N/A	ILLINOIS FED. AID PROJECT

				CONSTR. CODE 80% FED
CODE NO .	ITEM	UNIT	TOTAL QUANTITY	20% STATE ROADWAY 0004 RURAL
			_	
70400125	PINNING TEMPORARY CONCRETE BARRIER	EACH	30	30
70400200	RELOCATE TEMPORARY CONCRETE BARRIER	FOOT	137.5	137.5
70600250	IMPACT ATTENUATORS, TEMPORARY (NON- REDIRECTIVE), TEST LEVEL 3	EACH	2	2
70600260	IMPACT ATTENUATORS, TEMPORARY (FULLY REDIRECTIVE, NARROW), TEST LEVEL 3	EACH	1	1
70600350	IMPACT ATTENUATORS, RELOCATE (NON- REDIRECTIVE), TEST LEVEL 3	EACH	1	1
72000100	SIGN PANEL - TYPE 1	SQ FT	18	18
72400100	REMOVE SIGN PANEL ASSEMBLY - TYPE A	EACH	2	2
73000100	WOOD SIGN SUPPORT	FOOT	30	30
78001110	PAINT PAVEMENT MARKING - LINE 4"	FOOT	4680	4680
78001130	PAINT PAVEMENT MARKING - LINE 6"	FOOT	400	400
78004620	PREFORMED PLASTIC PAVEMENT MARKING, TYPE D - LINE 4"	FOOT	72	72
78011035	GROOVING FOR RECESSED PAVEMENT MARKING 7"	FOOT	72	72
78100100	RAISED REFLECTIVE PAVEMENT MARKER	EACH	10	10
78200005	GUARDRAIL REFLECTORS, TYPE A	EACH	8	8

*= SPECIALTY ITEM

TT	U!
Hutchison Engineering, Inc.	
Jacksonville - Moline - Peoria - Shorewood Since 1945	PL
SINC# 1945	

	USER NAME = default	DESIGNED	-	LDZ	REVISED	-
ing, Inc.		DRAWN	-	RMD	REVISED	-
Shorewood	PLOT SCALE = \$SCALE\$	CHECKED	-	WLP	REVISED	-
	PLOT DATE = 1/17/2022	DATE	-	11/5/2021	REVISED	-

STATE OF ILLINOIS						
DEPARTMENT OF TRANSPORTATION						

FAP ROUTE 316 (IL RTE 26) SUMMARY OF QUANTITIES										
	SCALE: N/A	SHEET	4	OF	5	SHEETS	STA. N/A			

TO STA. N/A

CONSTR.	CODE				
80% FED					
20% STATE					


				ROADWAY
CODE			TOTAL	0004
NO.	ITEM	UNIT	QUANTITY	RURAL
	-			
78300200	RAISED REFLECTIVE PAVEMENT MARKER REMOVAL	EACH	10	10
78300202	PAVEMENT MARKING REMOVAL - WATER BLASTING	SQ FT	880	880
X0326649	LINEAR DELINEATOR PANELS, 6 INCH	EACH	4	4
V1200050	DOV. CHANEDT, DEMONAL	5007	60	6.0
X1200050	BOX CULVERT REMOVAL	FOOT	60	60
V2700001	TEMPORARY RUMPLE CTRIPE (CRECIAL)	FACIL	2	2
X2700001	TEMPORARY RUMBLE STRIPS (SPECIAL)	EACH	3	3
X6330725	STEEL PLATE BEAM GUARDRAIL (SHORT RADIUS)	FOOT	25.0	25.0
	· · · · · · · · · · · · · · · · · · ·			
X7030005	TEMPORARY PAVEMENT MARKING REMOVAL	SQ FT	866	866
Z0013798	CONSTRUCTION LAYOUT	L SUM	1	1
Z0030850	TEMPORARY INFORMATION SIGNING	SQ FT	42	42
Z0055400	RUMBLE STRIP	FOOT	1106	1106
Z0062456	TEMPORARY PAVEMENT	SQ YD	127	127

Hutchison Engineering, Inc.
Jacksonville - Moline - Peorla - Shorewood
Since 1945

- 1	USER NAME = default	DESIGNED	2:	LDZ	REVISED =
C.		DRAWN	e :	RMD	REVISED -
ood	PLOT SCALE = \$SCALE\$	CHECKED		WLP	REVISED -
	PLOT DATE = 1/14/2022	DATE		11/5/2021	REVISED +

FAP ROUTE 316 (IL RTE 26) SUMMARY OF QUANTITIES										
	SHEET	5	OF	5	SHEETS	STA. N/A				

TO STA. N/A

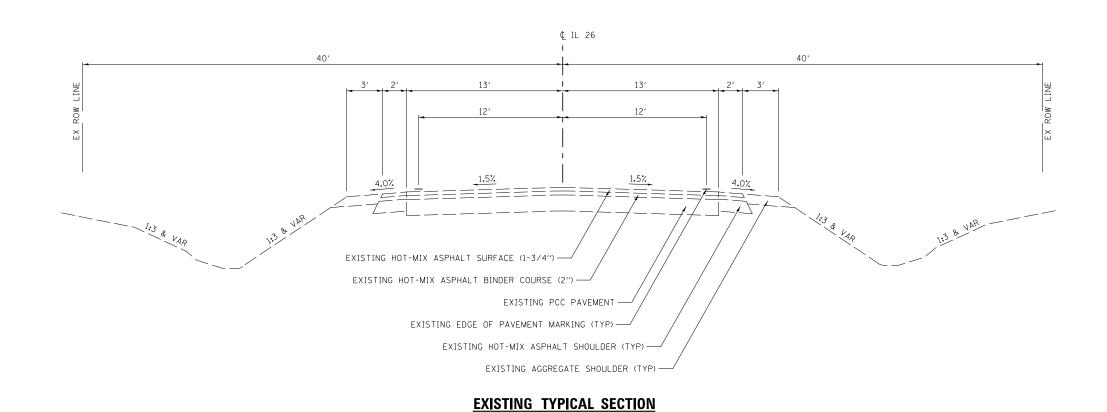

FAP ROUTE 316 (IL RTE 26)


STA 1059+00.00 TO STA 1064+53.08

Hutchison Engineering, Inc.

Jacksonville - Peoria - Ouad Cities - Shorewood
Since 1945

PLOT
PLOT

STATE OF ILLINOIS
DEPARTMENT OF TRANSPORTATION

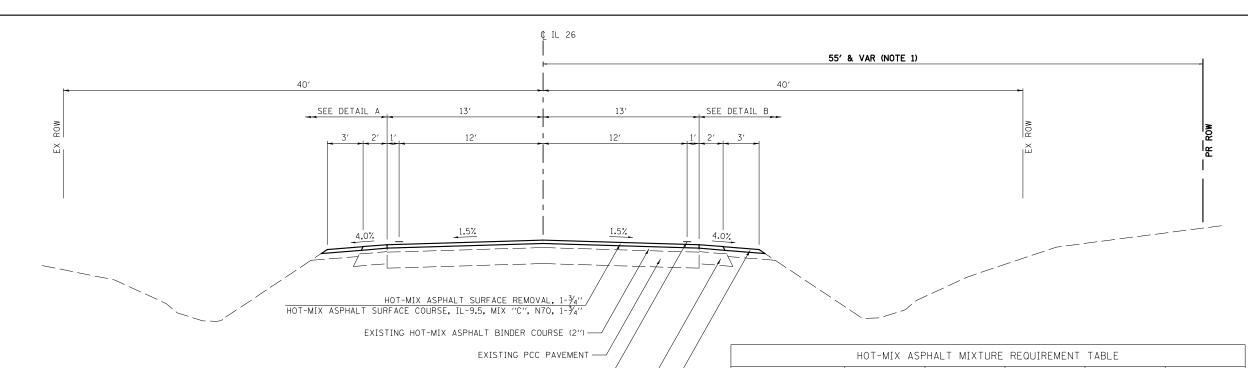

NOTES:

1. PROPOSED ROW VARIES FROM 40' AT STA 1060+80 TO 55' AT STA 1061+20 AND FROM 55' AT STA 1064+50 TO 40' AT STA 1065+55.

PROPOSED TYPICAL SECTION FAP ROUTE 316 (IL RTE 26)


AGGREGATE SHOULDER, TYPE B (TYP) ---


EXISTING HOT-MIX ASPHALT SHOULDER (TYP) —

EDGE OF PAVEMENT STRIPE AND RUMBLE STRIP (TYP) —

STA 1059+00.00 TO STA 1064+53.08

LOCATION(S):	ENTIRE PROJECT	ENTIRE PROJECT	ENTIRE PROJECT	ENTIRE PROJECT	ENTIRE PROJECT
MIXTURE USE(S):	HMA SURFACE	HMA SHOULDER BOTTOM (LIFTS)	HMA SHOULDER TOP LIFT	TEMP PAVEMENT BOTTOM (LIFTS)	TEMP PAVEMENT TOP LIFT
BINDER GRADE (PG):	PG 64-22	PG 64-22	PG 64-22	PG 64-22	PG 64-22
DESIGN AIR VOIDS:	4.0% @ N70	4.0% @ N50	4.0% @ N50	4.0% @ N50	4.0% @ N50
MIXTURE COMPOSITION: (MIXTURE GRADATION)	IL-9.5	IL-19.0	IL-9.5	IL-19.0	
FRICTION AGGREGATE:	MIXTURE C		MIXTURE C		
MIXTURE WEIGHT:	112.0 LB/SY/IN	112.0 LB/SY/IN	112.0 LB/SY/IN	112.0 LB/SY/IN	112.0 LB/SY/IN
QUALITY MANAGEMENT PROGRAM:	QCQA	QCQA	QCQA	QCQA	
SUBLOT SIZE:	N/A	N/A	N/A	N/A	
DENSITY TEST METHOD:	CORES	CORES	CORES	SATISFACTION OF ENGINEER	SATISFACTION OF ENGINEER
MATERIAL TRANSFER DEVICE (REQUIRED):	N0	NO	NO NO	NO	N/A

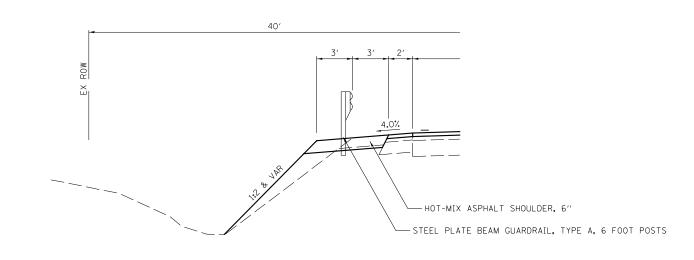

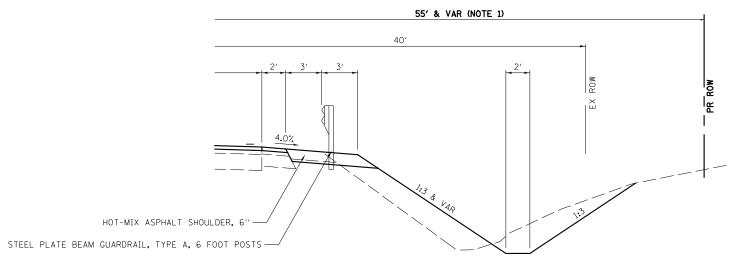

DETAIL A

STA 1061+02 TO STA 1063+73

DETAIL B

STA 1	059+82	ΤO	STA	1061+97
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100E	USER NAME = default	DESIGNED -	LDZ	REVISED -			FAP ROUTE 316 (IL RTE 26)		F A P RTF	SECTION	COUNTY	TOTAL SP	ET
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Jacksonville - Peoria - Quad Cities - Shorev	PLOT SCALE = \$SCALE\$	CHECKED -	WLP	REVISED -	DEPARTMENT OF TRANSPORTATION	CCALE: NVA	THOI GOLD THIOME GEOTION		_		CONTRACT	NO. 66K3	5
24	PLOT DATE = 1/11/2022	DATE -	11/5/2021	REVISED -		SCALE: N/A	SHEET 1 OF 1 SHEETS STA. N/A	TO STA. N/A		ILLINOIS FED. A	ID PROJECT		

EARTH EXCAVATION CU YD	3 SUITABLE EXCAVATION ADJUSTED FOR SHRINKAGE CU YD	EMBANKMENT	5 EARTH BALANCE WASTE(+) OR SHORTAGE(-)
EXCAVATION	EXCAVATION ADJUSTED FOR SHRINKAGE		WASTE(+) OR
CUYD	CU YD	CLLVD	
		CU YD	CU YD
165	124	332	-208
165	124	332	-208
ISE PAY ITEM TO	TALS BELOW		
	C = CUT (FROM CF	ROSS SECTIONS)	
	165 ISE PAY ITEM TO	165 124 ISE PAY ITEM TOTALS BELOW C = CUT (FROM CF SS SECTIONS (C) CAVATION SHRINKAGE FACTOR)	165 124 332 ISE PAY ITEM TOTALS BELOW C = CUT (FROM CROSS SECTIONS) SS SECTIONS (C) CAVATION SHRINKAGE FACTOR)

165 CU YD

CUYD

208

	LOC	CATION		SEEDING, CLASS 2A	NITROGEN FERTILIZER NUTRIENT	PHOSPHORUS FERTILIZER NUTRIENT	POTASSIUM FERTILIZER NUTRIENT	EROSION CONTROI BLANKET
STATION +/-	ТО	STATION +/-	SIDE	ACRE	POUND	POUND	POUND	SQ YD
				25000210	25000400	25000500	25000600	25100630
L RTE 26								
1059+00	TO	1064+53	LT	0.09	9	9	9	436
1059+00	TO	1061+94	RT	0.14	13	13	13	578
1062+24	ТО	1064+53	RT	0.12	11	11	11	581
			TOTAL	0.35	33	33	33	1695
			USE	0.50	40	40	40	1695

STATION +/-	то	STATION +/-	SIDE	TEMP SEED	POUNDS PER APPLICATION PER	NUMBER OF APPLICATIONS	TOTAL
				ACRES	ACRE	AFFLICATIONS	POUND
							28000250
IL RTE 26							
1059+00	TO	1064+53	LT	0.09	100	1	9
1059+00	TO	1061+94	RT	0.14	100	1	14
1059+00	ТО	1061+94	RT	0.12	100	1	12
						TOTAL	23
						USE	50

MULCH METHOD 2 IS USED FOR TEMPORARY MULCHING

LOCAT	ION	LENGTH
STATION	OFFSET	FOOT
		28000305
IL RTE 26		
1059+04	32' RT	10
1060+00	36' RT	10
1061+00	35' RT	10
1063+00	29' RT	10
1064+00	28' RT	10
	TOTAL	50

COLUMN 5 - = COLUMN 3 - COLUMN 4

PAY ITEMS:

COLUMN #2 IS EARTH EXCAVATION (20200100) =

COLUMN #5 IS FURNISHED EXCAVATION (20400800) =

ID PIPE PROTE	CTION
OFFSET	EACH
	28000500
30' RT	1
22207	
	OFFSET

STATION	TO	STATION	SIDE	LENGTH	
STATION	10	STATION	SIDE	FOOT	
				28000400	
IL RTE 26					
1059+00	TO	1062+00	LT	308	
1059+00	TO	1061+94	RT	295	
1062+24	TO	1064+53	RT	231	
1062+29	ТО	1064+53	LT	237	
			TOTAL	1071	

TT	US
Hutchison Engineering, Inc.	
Jacksonville - Moline - Peoria - Shorewood Since 1945	PLO
SINCE 1945	DI.

	USER NAME = default	DESIGNED	-	LDZ	REVISED -
•		DRAWN	-	RMD	REVISED -
i	PLOT SCALE = \$SCALE\$	CHECKED	-	WLP	REVISED -
	PLOT DATE = 1/11/2022	DATE	-	11/5/2021	REVISED -

STATE	OF	ILLINOIS
DEPARTMENT	OF	TRANSPORTATION

	FA	P RO	UTE	316 (IL	RTE 26)		F.A.P. RTE	SEC.	TION		COUNTY	TOTAL SHEETS	SHEET NO.
	SC	HED	шЕ	OF OU	ANTITIES		316	(11	4)CR		BUREAU	40	10
		IILD	OLL								CONTRACT	NO. 66	5K35
SHEET	1	OF	4	SHEETS	STA. N/A	TO STA. N/A			ILLINOIS	FED. AI	D PROJECT		

					PAVEMENT				
LC	LOCATION		BITUMINOUS MATERIALS (TACK COAT)	HOT-MIX ASPHALT SURFACE COURSE, IL-9.5, MIX "C", N70	AGGREGATE SHOULDERS, TYPE B 6"	HOT-MIX ASPHALT SHOULDERS, 6"	LONGITUDINAL JOINT SEALANT	HOT-MIX ASPHALT SURFACE REMOVAL, 13/4"	RUMBLE STRIP
STATION	TO	STATION	POUND	TON	TON	SQ YD	FOOT	SQ YD	FOOT
			40600290	40604052	48101200	48203021	40600370	44000156	Z0055400
IL RTE 26							_		
1059+00.00	то	1059+57.00	87	19	5		57	183	114
1059+57.00	TO	1061+02.00	218	48	6	99	145	477	290
1061+02.00	TO	1062+06.00	157	35		164	104	344	208
1062+06.00	TO	1063+98.00	287	63	7	130	192	633	384
1063+98.00	TO	1064+53.00	84	19	5		55	184	110
		TOTAL	833	184	23	393	553	1821	1106

CLASS D PATCHES											
		TYPE IV	TRENCH								
STATION +/-	SIDE	13 INCH	BACKFILL								
		SQ YD	CU YD								
44201809 20800150											
IL RTE 26		-									
1061+80.0	RT	26	42								
1061+80.0	LT	26	42								
	TOTAL	52	84								

	STEEL PLATE BEAM GUARDRAIL													
STATION +/- TO STATION +/-	SIDE	STEEL PLATE BEAM GUARDRAIL, TYPE A, 6 FOOT POSTS	STEEL PLATE BEAM GUARDRAIL (SHORT RADIUS)	TRAFFIC BARRIER TERMINAL, TYPE 2	TRAFFIC BARRIER TERMINAL, TYPE 1 (SPECIAL) TANGENT	GUARDRAIL REFLECTORS, TYPE A	LINEAR DELINEATOR PANELS, 6 INCH							
				FOOT	FOOT	EACH	EACH	EACH	EACH					
				63000001	X6330725	63100045	63100167	78200005	X0326649					
IL RTE 26														
1059+67.5	TO	1061+97.0	RT	162.5	25.0	1	1	4	2					
1061+12.5	TO	1063+87.5	LT	175.0			2	4	2					
			TOTAL	337.5	25.0	1	3	8	4					

ENTRANCES											
LOCA	ATION	BITUMINOUS MATERIALS (TACK COAT)	INCIDENTAL HOT-MIX ASPHALT SURFACING								
STATION	SIDE	TYPE	POUND	TON							
			40600290	40800050							
IL RTE 26											
1062+15.2	RT	CE	246	11							
		TOTAL	246	11							

PIPE CULVERT REMOVAL									
STATION +/- SIDE 18" CN									
		FOOT							
50105220									
IL RTE 26									
1062+14.6	29.6' RT	49							
	SUB-TOTAL	49							
TOTAL 49									
NOTE: END SECT	ION REMOVAL W	ILL BE INCLUDED							
IN THE COST	OF PIPE CULVER	T REMOVAL.							

PIPE CULVERTS											
LOCATIC	NN .	CLASS D	METAL FLARED	TRENCH							
LOCATIC	/IN	TYPE 1 18"	18"	BACKFILL							
STATION	SIDE	FOOT	EACH	CU YD							
		542D0223	54262718	20800150							
IL RTE 26											
1062+12.10	RT	54	2	8							
	TOTAL	54	2	8							

DRAWN - RMD REVISED -	USER NAME = default	DESIGNED - LDZ	REVISED -
		DRAWN - RMD	REVISED -
BLOT DATE - 1/14/2022 DATE 11/5/2021 DEVICED	PLOT SCALE = \$SCALE\$	CHECKED - WLP	REVISED -
PEOT BATE = 1/14/2022 BATE - 11/5/2021 REVISED -	PLOT DATE = 1/14/2022	DATE - 11/5/2021	REVISED -

STATE	: OI	FILLINOIS
DEPARTMENT	0F	TRANSPORTATION

	FAP ROUTE 316 (IL RTE 26)			F.A.P. RTE	SEC.	TION		COUNTY	TOTAL SHEETS	SHEET NO.			
	SC	HED	HE	OF OU	ANTITIES		316	(11	4)CR		BUREAU	40	11
		IILD	OLL								CONTRACT	NO. 66	5K35
SHEET	2	OF	4	SHEETS	STA. N/A	TO STA. N/A			ILLINOIS	FED. AI	D PROJECT		

GUARDRAIL REMOVAL												
STATION +/- TO STATION +/- SIDE FOOT												
63200310												
IL RTE 26												
1059+37	TO	1061+89	RT	253								
1060+99	TO	1064+14	LT	316								
1062+43	ТО	1063+21	RT	79								
	·		TOTAL	648								

SHORT TERM PAVEMENT MARKING REMOVAL												
	YELLOW											
			DIRECTION	SQ FT								
				70300150								
IL RTE 26												
1058+20	TO	1066+00	NB/SB	330								
			SUB-TOTAL	330								
			TOTAL	330								

SHORT TERM PAVEMENT MARKING											
				SOLID	SKIP DASH						
STATION	то	STATION	DIRECTION	YELLOW	YELLOW						
STATION	10	STATION	DIRECTION	CENTERLINE	CENTERLINE						
				FO	ОТ						
70300100											
IL RTE 26											
1058+20	TO	1066+00	NB/SB	780	200						
IL	RTE 2	6 SUB-TOTAL		780	200						
2 APPLICATIONS 1560 400											
			TOTAL	19	60						

	TEMPORARY CONCRETE BARRIER													
				TEMPORARY	PINNING	RELOCATE	IMPACT ATTENUATORS,	IMPACT ATTENUATORS,	IMPACT ATTENUATORS,					
STATION 1/	TO	STATION 1/	CIDE	CONCRETE	TEMPORARY	TEMPORARY	TEMPORARY (NON-	TEMPORARY (FULLY	RELOCATE (NON-					
STATION +/-	TO	STATION +/-	SIDE	BARRIER	CONCRETE BARRIER	CONCRETE BARRIER	REDIRECTIVE), TEST LEVEL	REDIRECTIVE, NARROW) TEST	REDIRECTIVE), TEST LEVEL 3					
				FOOT	EACH	FOOT	EACH	EACH	EACH					
				70400100	70400125	70400200	70600250	70600260	70600350					
IL RTE 26														
STAGE 1														
1060+54	TO	1062+94	LT/RT	237.5	15		2							
STAGE 2														
16+43	TO	21+53	LT/RT		15	137.5		1	1					
			TOTAL	237.5	30	<u>13</u> 7.5	2	1	1					

SIGNING REMOVAL										
STATION	SIDE	SIGN DESCRIPTION	REMOVE SIGN PANEL ASSEMBLY - TYPE A							
			EACH							
			72400100							
IL RTE 26										
1061+21	21.7' LT	STOP AHEAD	1							
1061+23	20.6' LT	STOP AHEAD	1							
		TOTAL	2							

SIGN PANEL AND SIGN SUPPORTS										
LOCATI	ΟN	SIGN	SIGN PANEL	WOODSIGN						
LOCATION		DESIGNATION	TYPE 1	SUPPORT						
STATION	SIDE	DESIGNATION	SQ FT	FOOT						
			72000100	73000100						
IL RTE 26										
1060+90	LT	W3-1	9.00	15.0						
1060+90	RT	W3-1	9.00	15.0						
•		TOTAL	18.00	30.0						
		USE	18	30						

Τ	USER NAME = default	DESIGNED	-	LDZ	REVISED -
Г		DRAWN	-	RMD	REVISED -
Г	PLOT SCALE = \$SCALE\$	CHECKED	-	WLP	REVISED -
Г	PLOT DATE = 1/17/2022	DATE	-	11/5/2021	REVISED -

STATI	E 01	F ILLINOIS
DEPARTMENT	0F	TRANSPORTATION

	F	AP ROUTE	316 (IL	RTE 26)		F.A.P. RTE	SECT	ΓΙΟΝ		COUNTY	TOTAL SHEETS	
SCHEDULE OF QUANTITIES							(114	4)CR		BUREAU	40	12
SCHEDOLL OF QUANTIFIES										CONTRACT	T NO. 60	6K35
SCALE: N/A	SHEET 3	OF 4	SHEETS	STA. N/A	TO STA. N/A			ILLINOIS	FED. AI	ID PROJECT		

WORK ZONE PAVEMENT MARKING										
			TEMPORARY PAVEM	ENT MARKING PAINT	TEMPORARY					
					PAVEMENT					
L	OCATIO	N	LINE 4" SOLID	LINE 24" SOLID	MARKING					
					REMOVAL					
			FOOT							
			70300221	70300281	X7030005					
IL RTE 26										
STAGE 1										
1058+32	TO	1065+83	1106	26	421					
STAGE 2										
1058+38	то	1065+88	1131	34	445					
			2237	60	866					
		TOTAL	2237	60	866					

PAVEMEN	T MAR	KING REMO	VAL - WATER I	BLASTING
				LINES
STATION	TO	STATION	LOCATION	4"
				SQ FT
				78300202
IL RTE 26				
1058+20	TO	1066+00	CL	360
1058+20	TO	1066+00	EDGE	520
			TOTAL	880

LOCATION STATION TO STATION SIDE IL RTE 26 PRE-STAGE 1	SUBBASE GRANULAR MATERIAL, TYPE A 4"	BITUMINOUS MATERIALS (TACK COAT) POUND	HATION ONLY HOT-MIX ASPHALT BINDER COURSE, IL- 19.0, N70, 6"	HOT-MIX ASPHALT SURFACE COURSE, MIX "C", N70, 13/4" TON	TEMPORARY PAVEMENT SQ YD Z0062456
STATION TO STATION SIDE	GRANULAR MATERIAL, TYPE A 4"	MATERIALS (TACK COAT)	ASPHALT BINDER COURSE, IL- 19.0, N70, 6"	ASPHALT SURFACE COURSE, MIX "C", N70, 13/4"	PAVEMENT SQ YD
IL RTE 26	SQ YD	POUND	TON	TON	
					Z0062456
PRE-STAGE 1					
ı					
1060+36 TO 1063+26 RT	106	219	24	10	97
STAGE 1					
1060+30 TO 1061+02 LT	42	68	8	3	30

SEE STAGING TYPICAL AND SPECIAL PROVISION

			P.A	AVEMENT IV	ARKING SCH	HEDULE		
							PREFORMED	GROOVING FOR
				PAINT	PAVEMENT M	ARKING	PLASTIC PAVEMENT	RECESSED
							MARKING, TYPE D	PAVEMENT
	Le	OCATION		4"	4"	6"	4"	
				SOLID	SOLID	SKIP DASH	SOLID	
				WHITE	YELLOW	YELLOW	WHITE	
				78001110 780011			78004620	78011035
STATION	TO	STATION	DIRECTION					
IL RTE 26								
1058+20	TO	1066+00	NB/SB	3120	1560	400		
1062+91	ТО	1063+01	NB				72	72
			SUB-TOTAL	3120	1560	400	72	72
			TOTAL	46	80	400	72	72


NOTE: ADDITIONAL QUANTITY HAS BEEN INCLUDED TO ALLOW FOR TWO SEPARATE APPLICATIONS OF PAINT PAVEMENT MARKING LINE.

RAISED REFLECTIVE PAVEMENT MARKER REMOVAL									
	EACH								
STATION									
				78300200					
IL RTE 26									
1058+20	TO	1066+00	NB/SB	10					
		-	TOTAL	10					

RAISED REFLECTIVE PAVEMENT MARKER										
	L	OCATION		2-WAY AMBER						
STATION	ТО	STATION	DIRECTION	EACH						
				78100100						
IL RTE 26										
1058+20.0	TO	1066+00.0	NB/SB	10						
	•									
	•		SUB-TOTAL	10						
			TOTAL	10						

USER NAME = default	DESIGNED	-	LDZ	REVISED	-
	DRAWN	-	RMD	REVISED	-
PLOT SCALE = \$SCALE\$	CHECKED	-	WLP	REVISED	-
PLOT DATE = 1/14/2022	DATE	-	11/5/2021	REVISED	-

FA	P RO	UTE	316 (IL	RTE 26)		F.A.P. RTE	SECT	ПОИ		COUNTY	TOTAL SHEETS	SHEET NO.
St	HED	HIE	OF OU	NTITIES		316	316 (114)CR		BUREAU	40	13	
 	/IILD	OLL	or yor	WINITES						CONTRACT	NO. 66	5K35
SHEET 4	OF	4	SHEETS	STA. N/A	TO STA. N/A			ILLINOIS	FED. A	ID PROJECT		

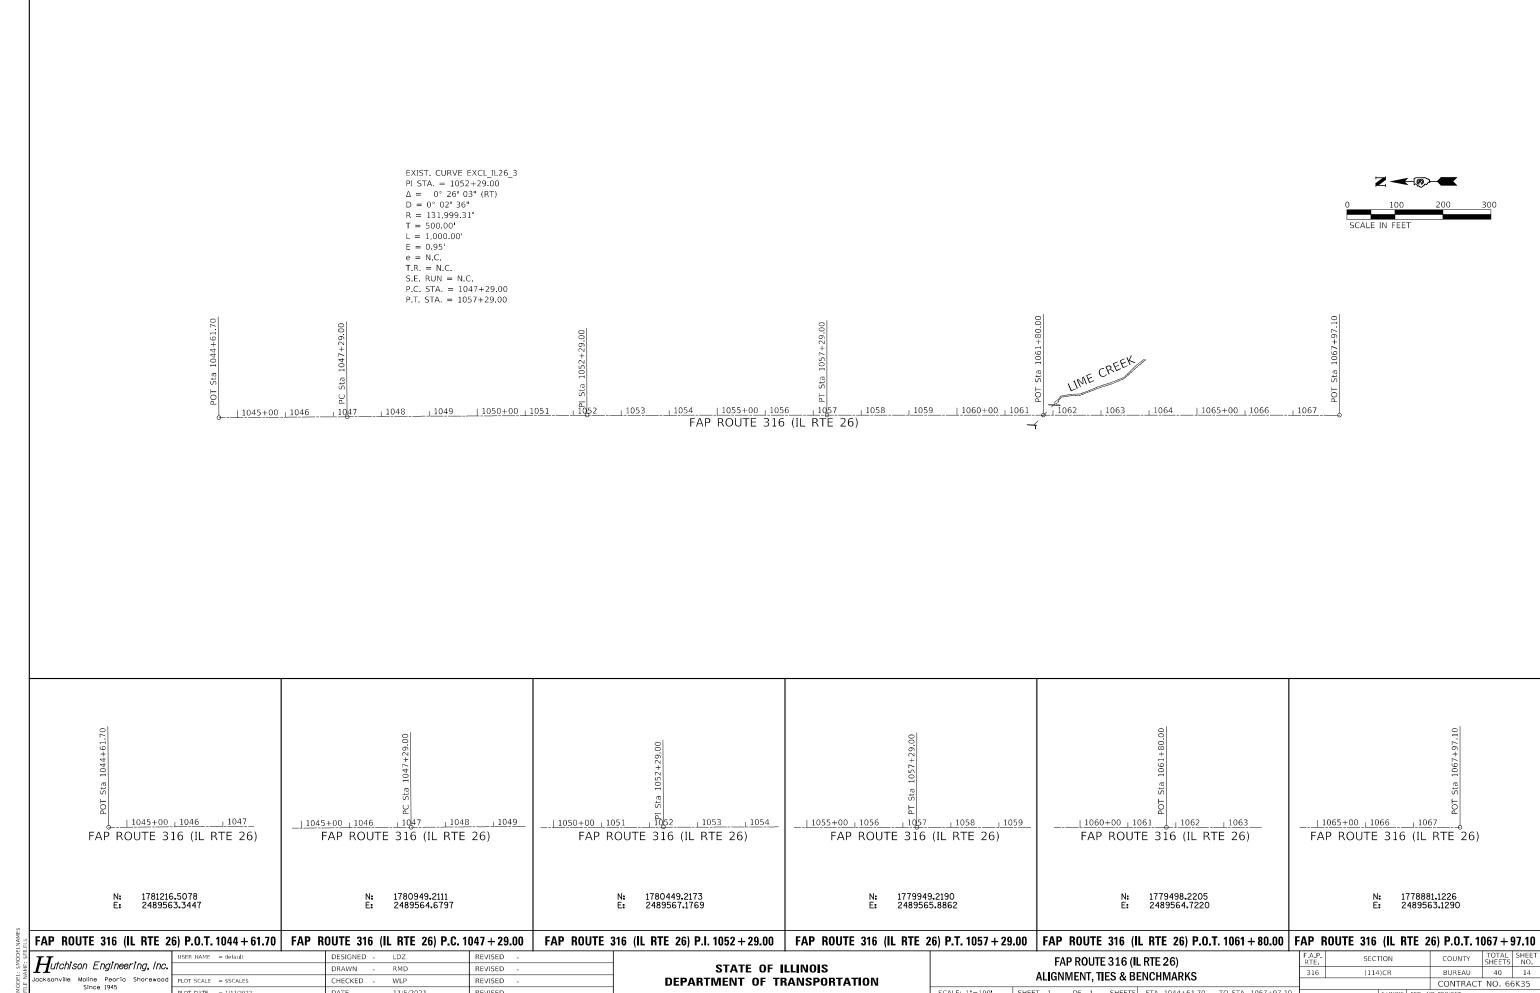


REVISED

11/5/2021


CONTRACT NO. 66K35


SCALE: 1"=100' SHEET 1 OF 1 SHEETS STA. 1044+61.70 TO STA. 1067+97.10

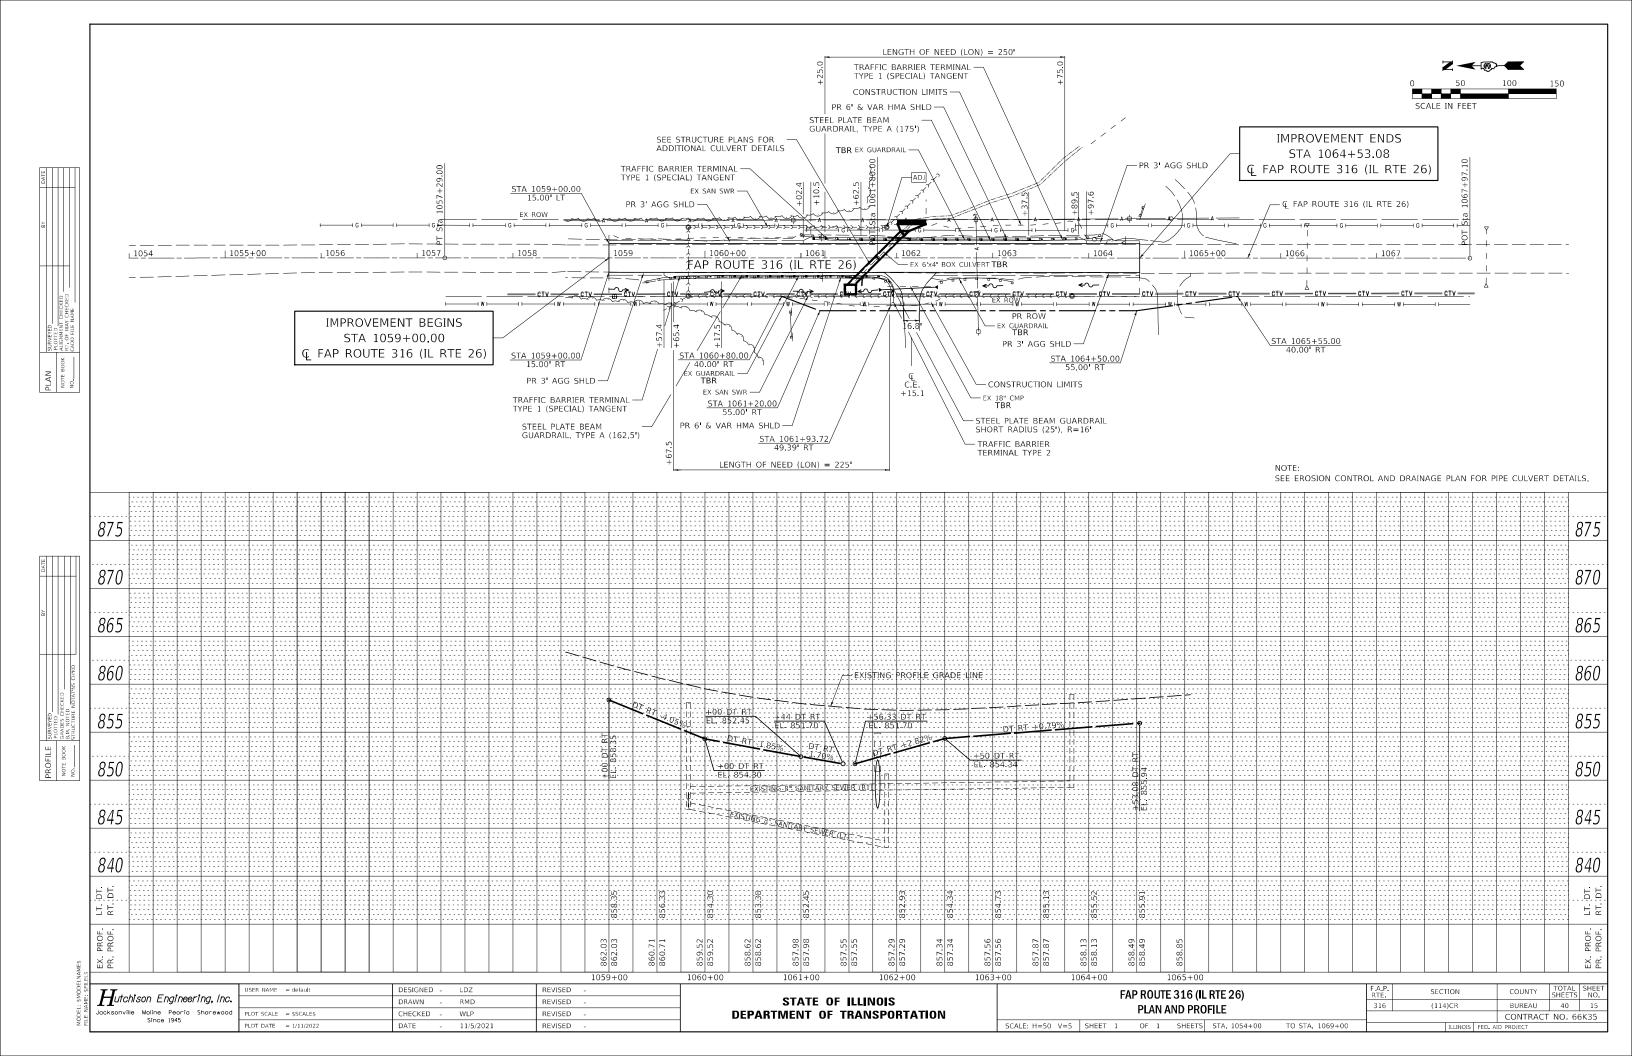

NORTHWEST 1/4 OF SEC. 16, T. 18 N., R. 9 E., 4TH P.M.



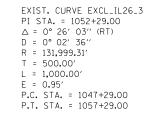

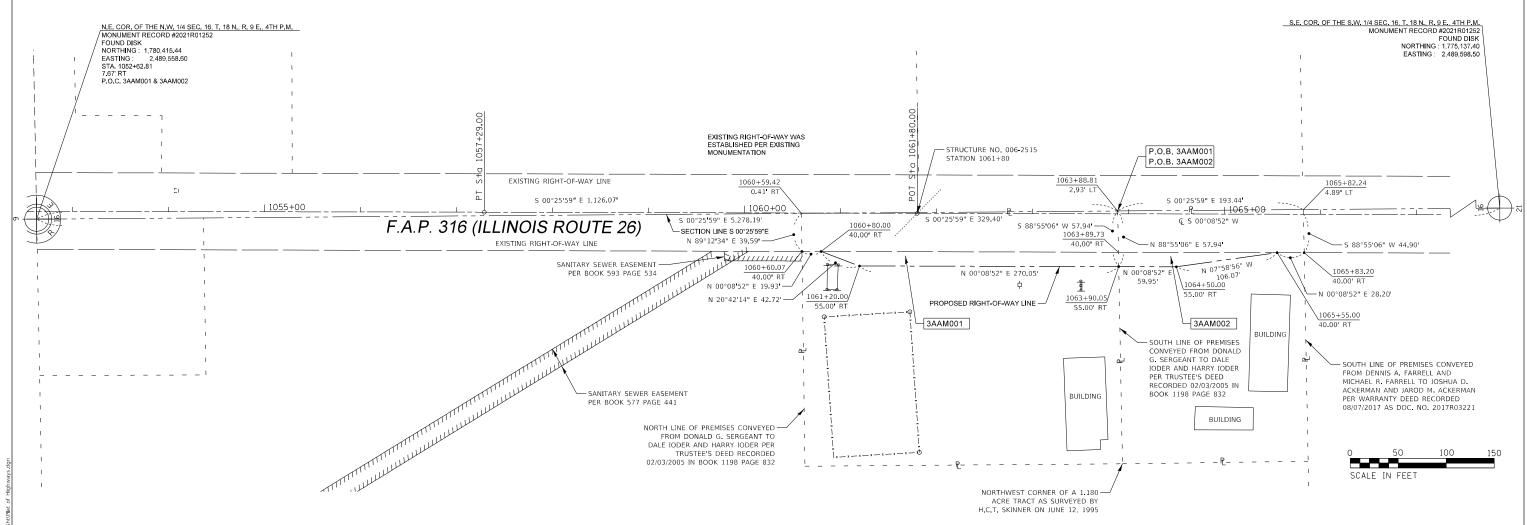

SURVEYOR'S STATEMENT

I, KEVIN A. KROHE, HEREBY CERTIFY THAT I AM A PROFESSIONAL LAND SURVEYOR OF THE STATE OF ILLINOIS, THAT THE SURVEY OF F.A.P. 316 (IL. 26) WAS MADE BY ME OR UNDER MY DIRECTION, AND THAT THE SURVEY IS TRUE AND COMPLETE AS SHOWN TO THE BEST OF MY KNOWLEDGE AND BELIEF, THAT ALL MONUMENTS AND MARKS ARE OF THE CHARACTER AND OCCUPY THE POSITION SHOWN THEREON, AND ARE SUFFICIENT TO ENABLE THE SURVEY TO BE RETRACED. THIS PROFESSIONAL SERVICE CONFORMS TO THE CURRENT ILLINOIS MINIMUM STANDARDS FOR A BOUNDARY SURVEY.

KEVIN A. KROHE, ILLINOIS PROFESSIONAL DATED LAND SURVEYOR NO. 35-3761 (EXPIRES NOV. 2022)



NOTE: GRID BEARINGS AND DISTANCES SHOWN HEREON ARE REFERENCED TO THE ILLINOIS STATE PLANE COORDINATE SYSTEM, (GRID) WEST ZONE, (NAD-83, 2011 ADJ.).

ALL AREAS ARE BASED ON GROUND MEASUREMENTS

COMBINED FACTOR = 0.99994529

TOTAL HOLDING AREA SURVEYED

PARCEL 3AAM001

P.I.N.: 04-16-100-010

TOTAL HOLDING = 1.996 AC. +/- 86.933 SQ.FT. +/-TOTAL R.O.W. REQUIRED = 0.412 AC. +/- 17,945 SQ.FT. +/-AREA IN EXISTING R.O.W. NET R.O.W. REQUIRED

= 0.312 AC. 13,597 SQ.FT. = 0.100 AC. +/- 4,348 SQ.FT. +/-= 1.584 AC. +/- 68,988 SQ.FT. +/-

SCALE: 1"=50"

SHEET

PARCEL 3AAM002

P.I.N.: 04-16-100-007

TOTAL HOLDING TOTAL R.O.W. REQUIRED AREA IN EXISTING R.O.W. NET R.O.W. REQUIRED

= 1.167 AC. +/- 50,835 SQ.FT. +/-= 0.234 AC. +/- 10,184 SQ.FT. +/-= 0.195 AC. 8,495 SQ.FT. = 0.039 AC. +/- 1,689 SQ.FT. +/-= 0.933 AC. +/- 40,651 SQ.FT. +/-



USER NAME = Steve	DESIGNED -	REVISED -
	DRAWN -	REVISED -
PLOT SCALE = 50.0000 / in.	CHECKED -	REVISED -
PLOT DATE = 10/4/2021	DATE -	REVISED -

STATE OF ILLINOIS **DEPARTMENT OF TRANSPORTATION**

	DIAT	0F 1116	NINA/AN/O			F.A.P RTE	SECT	TION		COUNTY	TOTAL SHEETS	SHEET NO.
PLAT OF HIGHWAYS						316 (114)ES				BUREAU 40		16
						ILI	INOIS 26			CONTRACT N	IO. 66K35	
2	OF 2	SHEETS	STA 1060±00	TO STA	1066+00			II LIMOIC	EED AL	D DDOJECT		

PRE-STAGE 1 CONSTRUCTION

INSTALL TRAFFIC CONTROL SIGNING ACCORDING TO IDOT HIGHWAY STANDARD 701326.

CONSTRUCT TEMPORARY WIDENING FROM STA 1060+36 TO 1063+26 (RT) AS SHOWN IN THE PRE-STAGE 1 PLANS.

TRAFFIC CONTROL AND PROTECTION

TRAFFIC CONTROL AND PROTECTION SHALL BE PERFORMED IN ACCORDANCE WITH THE TRAFFIC CONTROL PLAN, SECTION 701 OF THE STANDARD SPECIFICATIONS AND THE SPECIAL PROVISIONS.

TWO-WAY TRAFFIC SHALL BE ACCOMMODATED AT ALL TIMES ON EXISTING PAVEMENT, EXCEPT DURING ISOLATED FLAGGER CONTROLLED LANE CLOSURES.


EXISTING TRAFFIC CONTROL SIGNS AND DEVICES WILL BE REMOVED BY THE CONTRACTOR AFTER THE PROPOSED TRAFFIC CONTROL REQUIREMENTS ARE MET, OR AS AUTHORIZED BY THE ENGINEER. SIGNS OR DEVICES LEFT IN PLACE AT THIS TIME ARE TO BE PROTECTED FROM DAMAGE BY THE CONTRACTOR

THE CONTRACTOR SHALL SCHEDULE OPERATIONS TO ENSURE THAT NO DROP-OFF OF GREATER THAN 12", WITHIN 3" OF THE TRAVEL LANE, IS PRESENT FOR 48 HOURS OR MORE.

NO DROP-OFF GREATER THAN 24" WITHIN 12" OF THE TRAVEL LANE WILL BE ALLOWED UNLESS A FLAGGER CONTROLLED LANE CLOSURE IS PROVIDED. SEGMENTS WHERE THESE CONDITIONS OCCUR DURING NON-WORKING HOURS MUST BE PROTECTED WITH TEMPORARY CONCRETE BARRIER, UNLESS AUTHORIZED BY THE ENGINEER, THE CONTRACTOR WILL ONLY BE PAID FOR TEMPORARY CONCRETE BARRIER ALONG SEGMENTS SHOWN IN THE PLANS.

VERTICAL PANELS, TYPE II BARRICADES OR DRUMS WITH STEADY-BURNING LIGHTS SHALL BE REQUIRED TO DELINEATE THE TRAVEL WAY. THE MAXIMUM SPACING SHALL BE 100 FEET, CENTER TO CENTER ALONG TANGENTS (50 FEET ALONG TAPERS); AND 25 FEET, CENTER TO CENTER ALONG RADII TO SIDE ROADS AND ENTRANCES.

THE FOLLOWING TRAFFIC CONTROL STANDARDS ARE THE MINIMUM REQUIREMENTS FOR THE TRAFFIC FOR THIS PROJECT: 701001, 701006, 701011, 701201, 701301, 701321, 701326, 701901 & 704001.

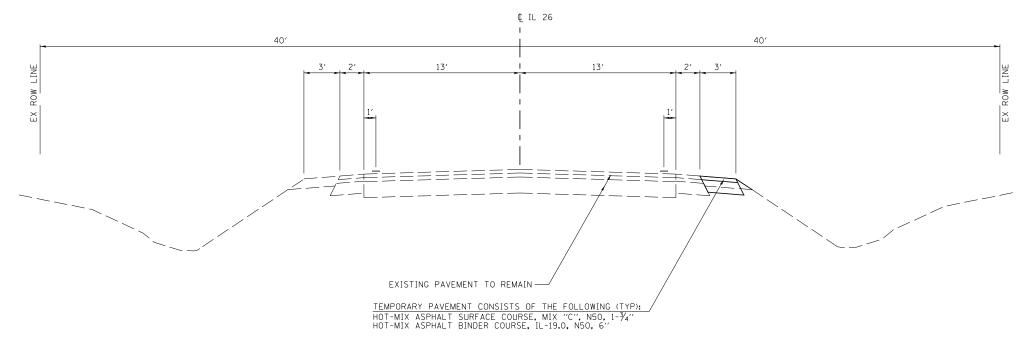


PRE-STAGE 1 TYPICAL SECTION FAP ROUTE 316 (IL RTE 26)

STA 1060+36 TO STA 1063+26

TT	USER I
Hutchison Engineering, Inc.	
acksonville - Peoria - Quad Cities - Shorewood	
Since 1945	PLOT D

	USER NAME = default	DESIGNED	-	LDZ	REVISED -
		DRAWN	-	RMD	REVISED -
bd	PLOT SCALE = \$SCALE\$	CHECKED	-	WLP	REVISED -
	PLOT DATE = 1/11/2022	DATE	-	11/5/2021	REVISED -

FAP ROUTE 316 (IL RTE 26)	F.A.P. RTE	SECTION		COUNTY	TOTAL SHEETS	SHEET NO.
PRE-STAGE 1 CONSTRUCTION NOTES AND TYPICAL SECTIONS	316	(114)CR		BUREAU	40	17
THE STALE I SOMETHOUTION NOTES AND THIOME SECTIONS				CONTRACT	F NO. 6	5K35
SCALE: N/A SHEET 1 OF 1 SHEETS STA. N/A TO STA. N/A		ILLING	IS FED. A	ID PROJECT		

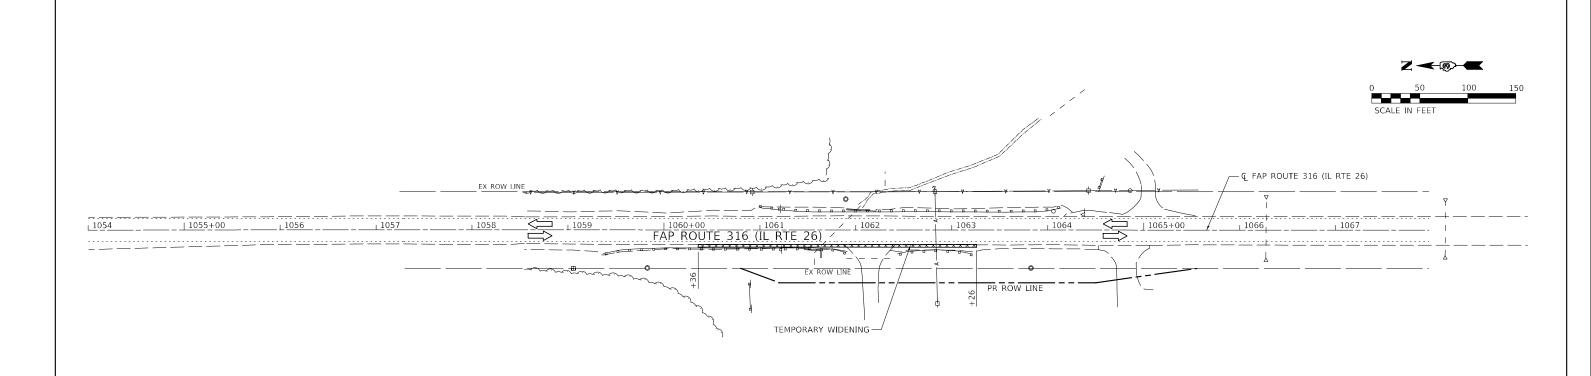

LEGEND

- TYPE II BARRICADE, DRUM OR

 VERTICAL BARRICADE WITH STEADY
 BURN BI-DIRECTIONAL LIGHT
- TYPE III BARRICADE WITH FLASHING LIGHT (2-EA.)
- DOUBLE VERTICAL PANEL
- WORK AREA
- CONSTRUCTION SIGN
- DIRECTION OF TRAFFIC)
- ☼ FLASHING MONO-DIRECTIONAL LIGHT

3		
÷	TT	U
į	Hutchison Engineering, Inc.	
	Jacksonville Moline Peoria Shorewood Since 1945	
i	Since 1945	Р

	USER NAME = default	DESIGNED	-	LDZ	REVISED -
nc.		DRAWN	-	RMD	REVISED -
boo	PLOT SCALE = \$SCALE\$	CHECKED	-	WLP	REVISED -
	PLOT DATE = 1/11/2022	DATE	-	11/5/2021	REVISED -

STATI	E 01	F ILLINOIS
DEPARTMENT	OF	TRANSPORTATION

SCALE: 1"=50'

		ı	FAP RO	าบา	ΓΕ 316 (IL	. RTE 26)		F.A.P. RTE	SEC ⁻	ΠΟΝ		COUNTY	TOTAL SHEETS	SHEET NO.
PRESTAGE 1 CONSTRUCTION & TRAFFIC CONTROL						316	(114	I)CR		BUREAU	40	18		
,	FRESTAGE I CONSTRUCTION & TRAFFIC CONTROL										CONTRACT	Γ NO. 66	5K35	
	SHEET	1	OF	1	SHEETS	STA. 1054+00	TO STA. 1067+97.10			ILLINOIS	FED. A	ID PROJECT		

STAGE 1 CONSTRUCTION

INSTALL TRAFFIC CONTROL SIGNING ACCORDING TO IDOT HIGHWAY STANDARD 701321.

AT STA 1061+80, REMOVE EAST HALF OF THE EXISTING BOX CULVERT AS SHOWN IN THE STRUCTURE PLANS AND CONSTRUCT EAST HALF OF THE PROPOSED PIPE CULVERT AS SHOWN IN THE STAGE 1 AND STRUCTURE PLANS.

CONSTRUCT NORTHBOUND PATCH ALONG FAP 316 (IL 26) AT THE PROPOSED CULVERT LOCATION DISCUSSED ABOVE. CONSTRUCT HOT-MIX ASPHALT SHOULDER AND ERECT STEEL PLATE BEAM GUARDRAIL TO THE LIMITS SHOWN IN THE STAGE 1 CONSTRUCTION PLANS.

CONSTRUCT TEMPORARY WIDENING FROM STA 1060+30 TO STA 1061+02 (LT) AS SHOWN IN THE STAGE 1 PLANS (SEE PRE-STAGE 1 TYPICAL FOR TEMPORARY PAVEMENT DETAILS).

TRAFFIC CONTROL AND PROTECTION

TRAFFIC CONTROL AND PROTECTION SHALL BE PERFORMED IN ACCORDANCE WITH THE TRAFFIC CONTROL PLAN, SECTION 701 OF THE STANDARD SPECIFICATIONS AND THE SPECIAL PROVISIONS.

ONE LANE, TWO-WAY TRAFFIC SHALL BE ACCOMMODATED AT ALL TIMES.

EXISTING TRAFFIC CONTROL SIGNS AND DEVICES WILL BE REMOVED BY THE CONTRACTOR AFTER THE PROPOSED TRAFFIC CONTROL REQUIREMENTS ARE MET, OR AS AUTHORIZED BY THE ENGINEER. SIGNS OR DEVICES LEFT IN PLACE AT THIS TIME ARE TO BE PROTECTED FROM DAMAGE BY THE CONTRACTOR.


THE CONTRACTOR SHALL SCHEDULE OPERATIONS TO ENSURE THAT NO DROP-OFF OF GREATER THAN 12", WITHIN 3' OF THE TRAVEL LANE, IS PRESENT FOR 48 HOURS OR MORE.

NO DROP-OFF GREATER THAN 24" WITHIN 12' OF THE TRAVEL LANE WILL BE ALLOWED UNLESS A FLAGGER CONTROLLED LANE CLOSURE IS PROVIDED. SEGMENTS WHERE THESE CONDITIONS OCCUR DURING NON-WORKING HOURS MUST BE PROTECTED WITH TEMPORARY CONCRETE BARRIER. UNLESS AUTHORIZED BY THE ENGINEER, THE CONTRACTOR WILL ONLY BE PAID FOR TEMPORARY CONCRETE BARRIER ALONG SEGMENTS SHOWN IN THE PLANS.

VERTICAL PANELS, TYPE II BARRICADES OR DRUMS WITH STEADY-BURNING LIGHTS SHALL BE REQUIRED TO DELINEATE THE TRAVEL WAY. THE MAXIMUM SPACING SHALL BE 100 FEET, CENTER TO CENTER ALONG TANGENTS (50 FEET ALONG TAPERS); AND 25 FEET, CENTER TO CENTER ALONG RADII TO SIDE ROADS AND ENTRANCES.


THE FOLLOWING TRAFFIC CONTROL STANDARDS ARE THE MINIMUM REQUIREMENTS FOR THE TRAFFIC FOR THIS PROJECT: 701001, 701006, 701011, 701201, 701301, 701321, 701326, 701901 & 704001.

TEMPORARY RUMBLE STRIPS WILL NOT BE REQUIRED FOR SOUTHBOUND TRAFFIC.

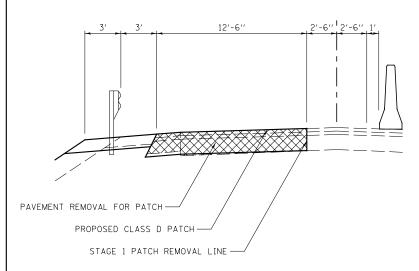

DETAIL A


STA 1061+74 TO STA 1061+90

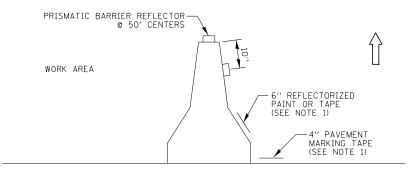

NOTES:

- 1. THE CONTRACTOR HAS THE OPTION OF USING EITHER THE LINE ON THE TEMPORARY CONCRETE BARRIER OR ON THE PAVEMENT.
- 2. THE COST OF THE REFLECTORS IS INCLUDED IN THE COST OF THE TEMPORARY CONCRETE BARRIER.

TEMPORARY CONCRETE BARRIER WALL DETAILS

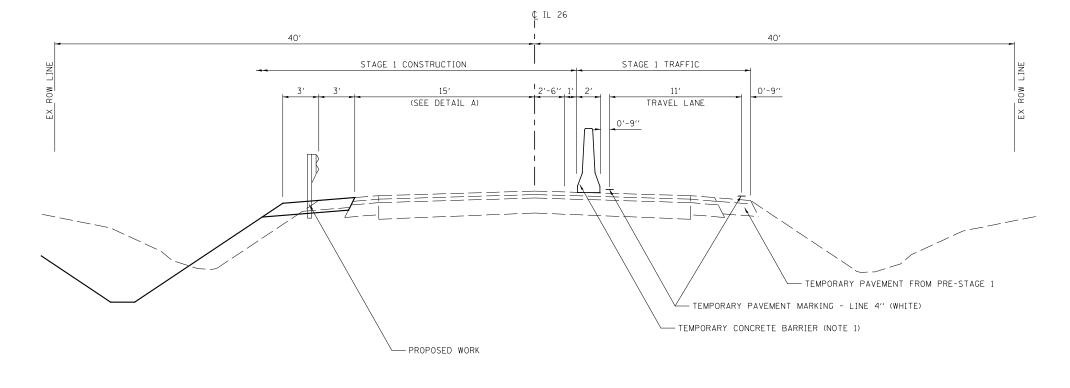

STAGE 1 TYPICAL SECTION FAP ROUTE 316 (IL RTE 26)

STA 1061+02 TO STA 1063+73

NOTES:

1. TEMPORARY CONCRETE BARRIER TO BE PINNED FROM STA 1061+70 TO STA 1061+94.

Hutchison Engineering, Inc.

Jacksonville - Peeria - Ouad Cities - Shorewood | |

STATE OF ILLINOIS
DEPARTMENT OF TRANSPORTATION


FAP ROUTE 316 (IL RTE 26)
STAGE 1 CONSTRUCTION NOTES AND TYPICAL SECTIONS


A SHEET 1 OF 1 SHEETS STA. N/A TO STA. N/A

F.A.P. SECTION COUNTY TOTAL SHEES NO.
316 (114)CR BUREAU 40 19

CONTRACT NO. 66K35

MODEL: \$MODELNAME;

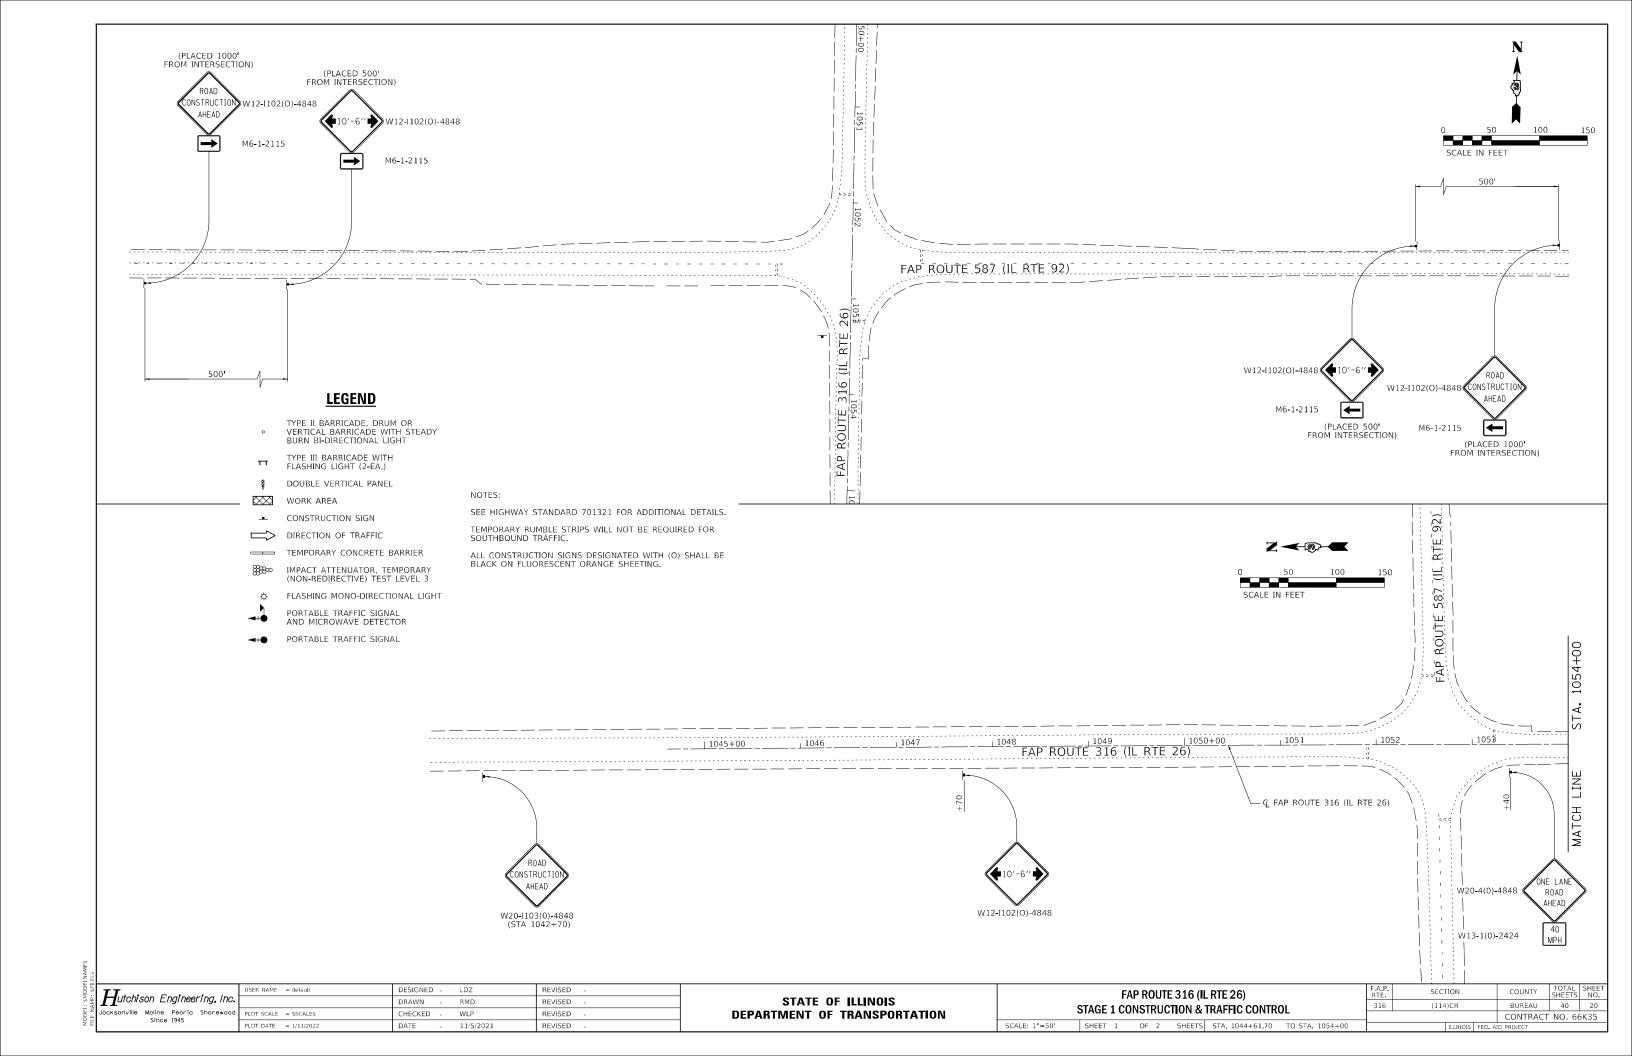

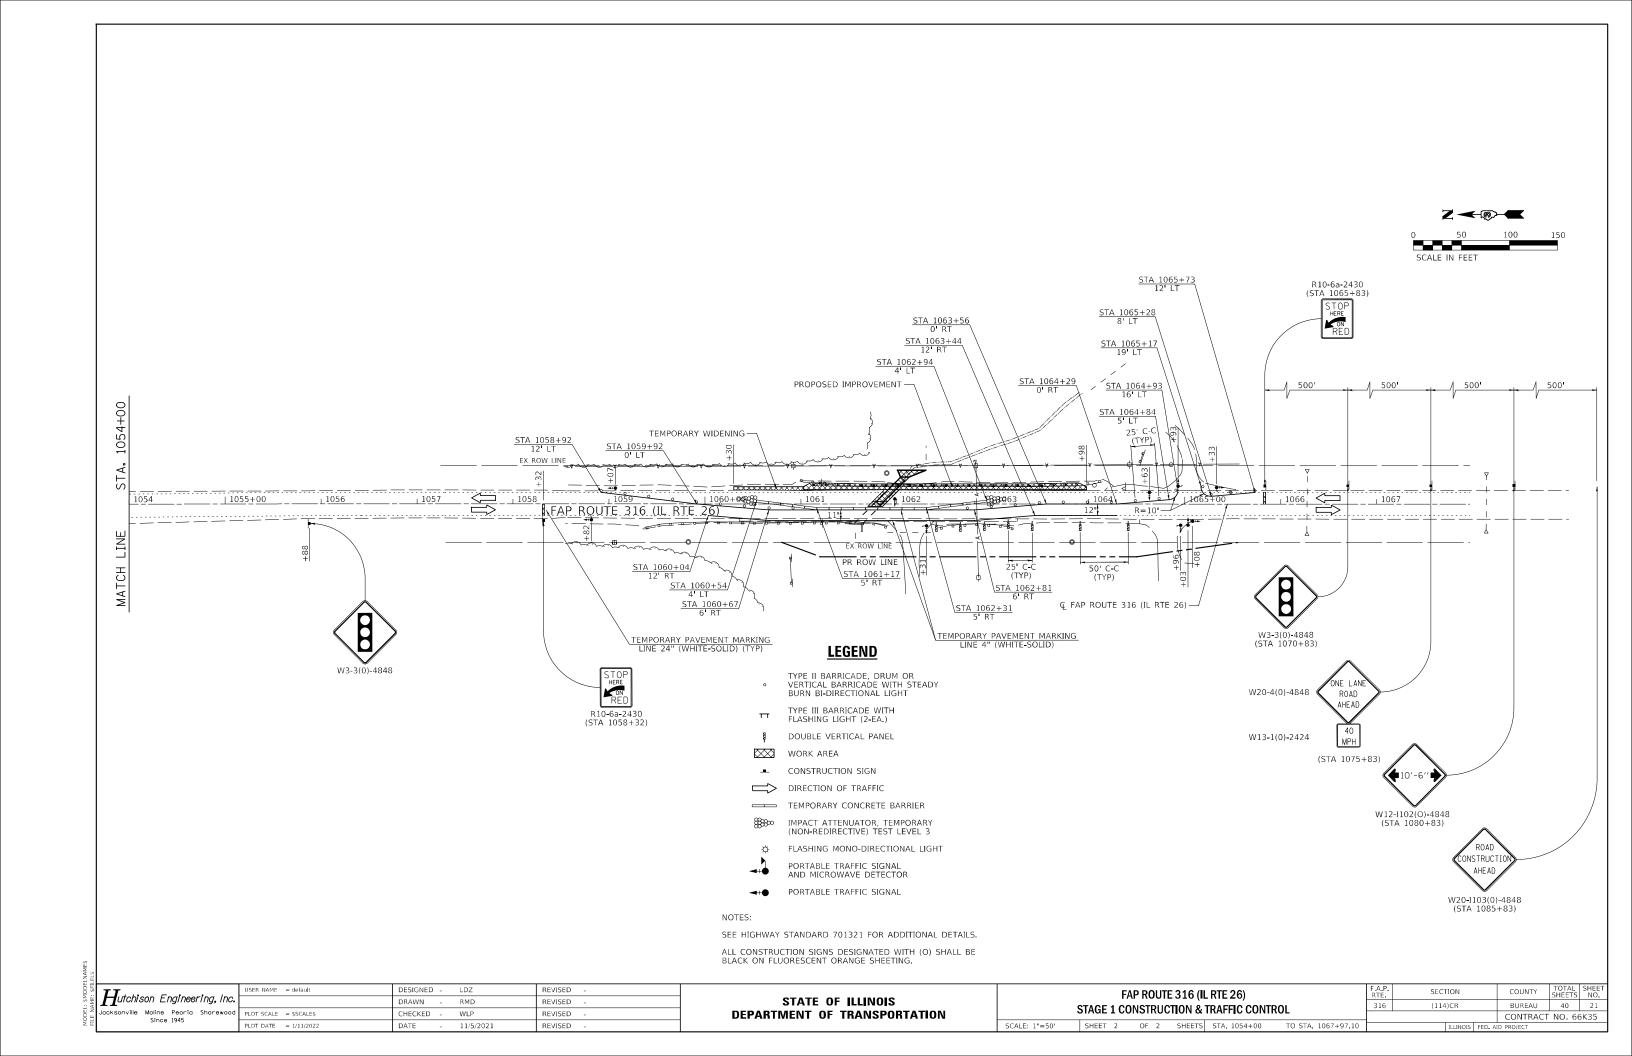

STAGE 2 CONSTRUCTION

INSTALL TRAFFIC CONTROL SIGNING ACCORDING TO IDOT HIGHWAY STANDARD 701321.

AT STA 1061+80, REMOVE WEST HALF OF THE EXISTING BOX CULVERT AS SHOWN IN THE STRUCTURE PLANS AND CONSTRUCT WEST HALF OF THE PROPOSED PIPE CULVERT AS SHOWN IN THE STAGE 1 AND STRUCTURE PLANS.

CONSTRUCT SOUTHBOUND PATCH ALONG FAP 316 (IL 26) AT THE PROPOSED CULVERT LOCATION DISCUSSED ABOVE. CONSTRUCT HOT-MIX ASPHALT SHOULDER AND ERECT STEEL PLATE BEAM GUARDRAIL TO THE LIMITS SHOWN IN THE STAGE 2 CONSTRUCTION PLANS.

TRAFFIC CONTROL AND PROTECTION

TRAFFIC CONTROL AND PROTECTION SHALL BE PERFORMED IN ACCORDANCE WITH THE TRAFFIC CONTROL PLAN, SECTION 701 OF THE STANDARD SPECIFICATIONS AND THE SPECIAL PROVISIONS.

ONE LANE, TWO-WAY TRAFFIC SHALL BE ACCOMMODATED AT ALL TIMES.

EXISTING TRAFFIC CONTROL SIGNS AND DEVICES WILL BE REMOVED BY THE CONTRACTOR AFTER THE PROPOSED TRAFFIC CONTROL REQUIREMENTS ARE MET, OR AS AUTHORIZED BY THE ENGINEER. SIGNS OR DEVICES LEFT IN PLACE AT THIS TIME ARE TO BE PROTECTED FROM DAMAGE BY THE CONTRACTOR.

THE CONTRACTOR SHALL SCHEDULE OPERATIONS TO ENSURE THAT NO DROP-OFF OF GREATER THAN 12", WITHIN 3" OF THE TRAVEL LANE, IS PRESENT FOR 48 HOURS OR MORE.

NO DROP-OFF GREATER THAN 24" WITHIN 12' OF THE TRAVEL LANE WILL BE ALLOWED UNLESS A FLAGGER CONTROLLED LANE CLOSURE IS PROVIDED. SEGMENTS WHERE THESE CONDITIONS OCCUR DURING NON-WORKING HOURS MUST BE PROTECTED WITH TEMPORARY CONCRETE BARRIER. UNLESS AUTHORIZED BY THE ENGINEER, THE CONTRACTOR WILL ONLY BE PAID FOR TEMPORARY CONCRETE BARRIER ALONG SEGMENTS SHOWN IN THE PLANS.

VERTICAL PANELS, TYPE II BARRICADES OR DRUMS WITH STEADY-BURNING LIGHTS SHALL BE REQUIRED TO DELINEATE THE TRAVEL WAY. THE MAXIMUM SPACING SHALL BE 100 FEET, CENTER TO CENTER ALONG TANGENTS (50 FEET ALONG TAPERS); AND 25 FEET, CENTER TO CENTER ALONG RADII TO SIDE ROADS AND ENTRANCES.

THE FOLLOWING TRAFFIC CONTROL STANDARDS ARE THE MINIMUM REQUIREMENTS FOR THE TRAFFIC FOR THIS PROJECT: 701001, 701001, 701301, 701321, 701326, 701901 & 704001.

TEMPORARY RUMBLE STRIPS WILL NOT BE REQUIRED FOR SOUTHBOUND TRAFFIC.

TRAVEL LANE 0'-9" CLASS D PATCH FROM STAGE 1 STAGE 2 CONSTRUCTION LINE PROPOSED CLASS D PATCH -PAVEMENT REMOVAL FOR PATCH-


DETAIL A

STA 1061+74 TO STA 1061+90

POST STAGE 2 CONSTRUCTION

CONSTRUCT HOT-MIX ASPHALT SURFACE REMOVAL AND HOT-MIX ASPHALT SURFACE COURSE FROM STA 1059+00 TO STA 1065+55.


CONSTRUCT COMMERCIAL ENTRANCE AT STA 1062+15.

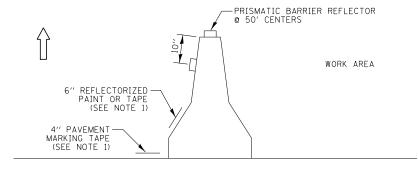

NOTES:

- THE CONTRACTOR HAS THE OPTION OF USING EITHER THE LINE ON THE TEMPORARY CONCRETE BARRIER OR ON THE PAVEMENT.
- THE COST OF THE REFLECTORS IS INCLUDED IN THE COST OF THE TEMPORARY CONCRETE BARRIER.

TEMPORARY CONCRETE BARRIER WALL DETAILS

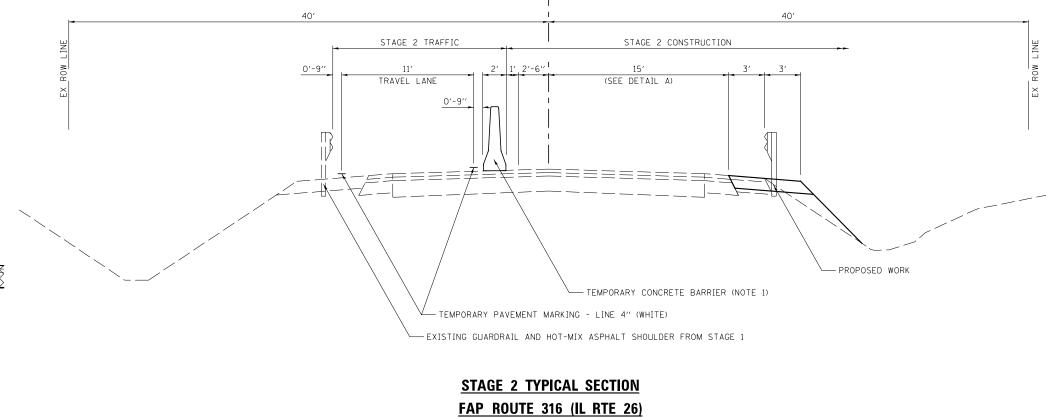

₡ IL 26

STA 1061+02 TO STA 1063+73

NOTES:

TEMPORARY CONCRETE BARRIER TO BE PINNED FROM STA 1061+70 TO STA 1061+94.


Hutchison Engineering, Inc. sonville - Peoria - Quad Cities - Shorew Since 1945


JSER NAME = default DESIGNED -LDZ REVISED DRAWN RMD REVISED HECKED REVISED PLOT DATE = 1/11/2022 REVISED DATE 11/5/2021


STATE OF ILLINOIS **DEPARTMENT OF TRANSPORTATION**

FAP ROUTE 316 (IL RTE 26) STAGE 2 CONSTRUCTION NOTES AND TYPICAL SECTIONS SHEET 1 OF 1 SHEETS STA. N/A

SECTION COUNTY (114)CR BUREAU 40 22 CONTRACT NO. 66K35

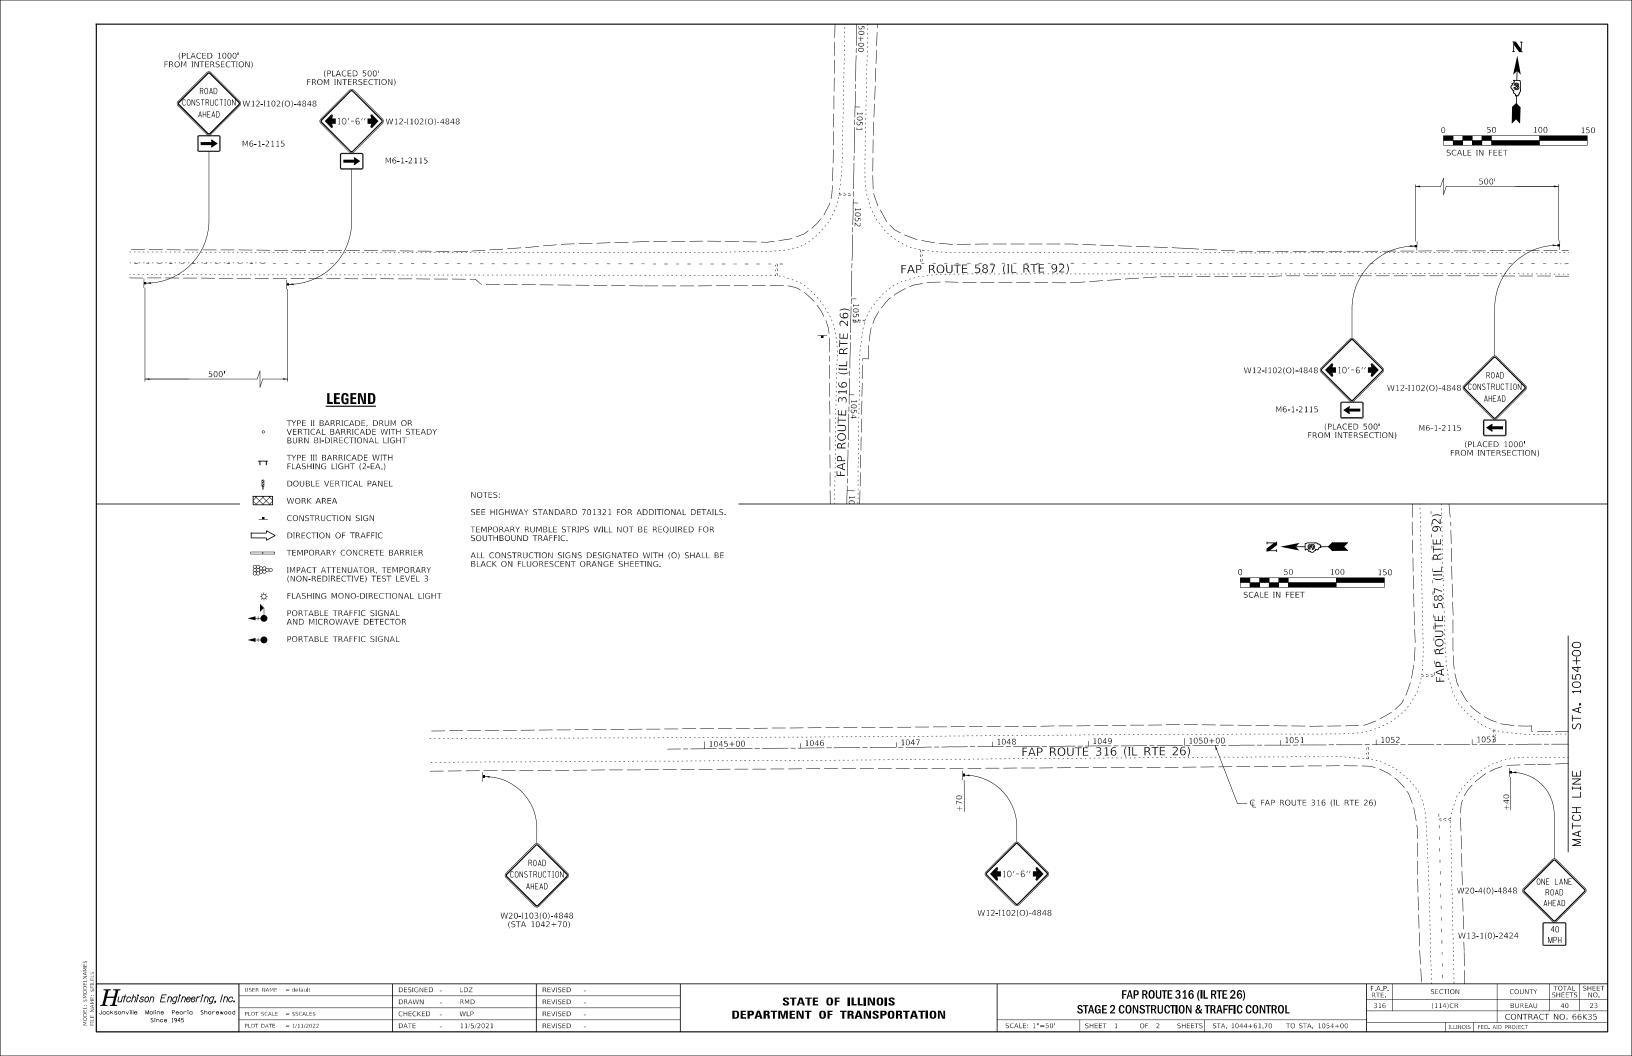

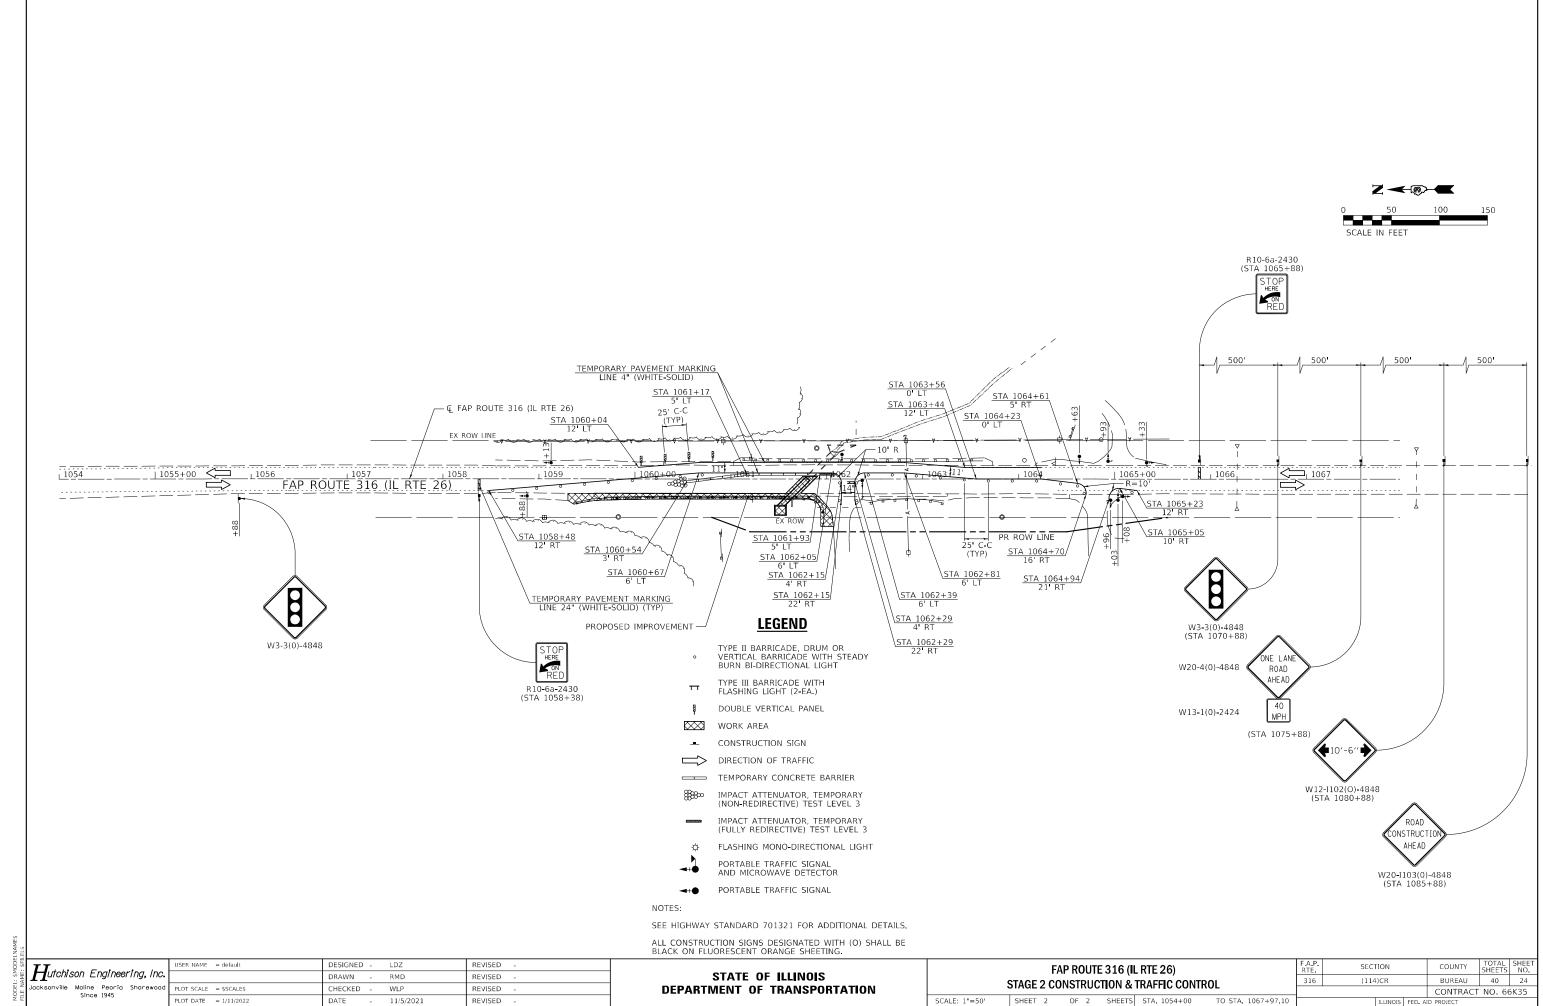


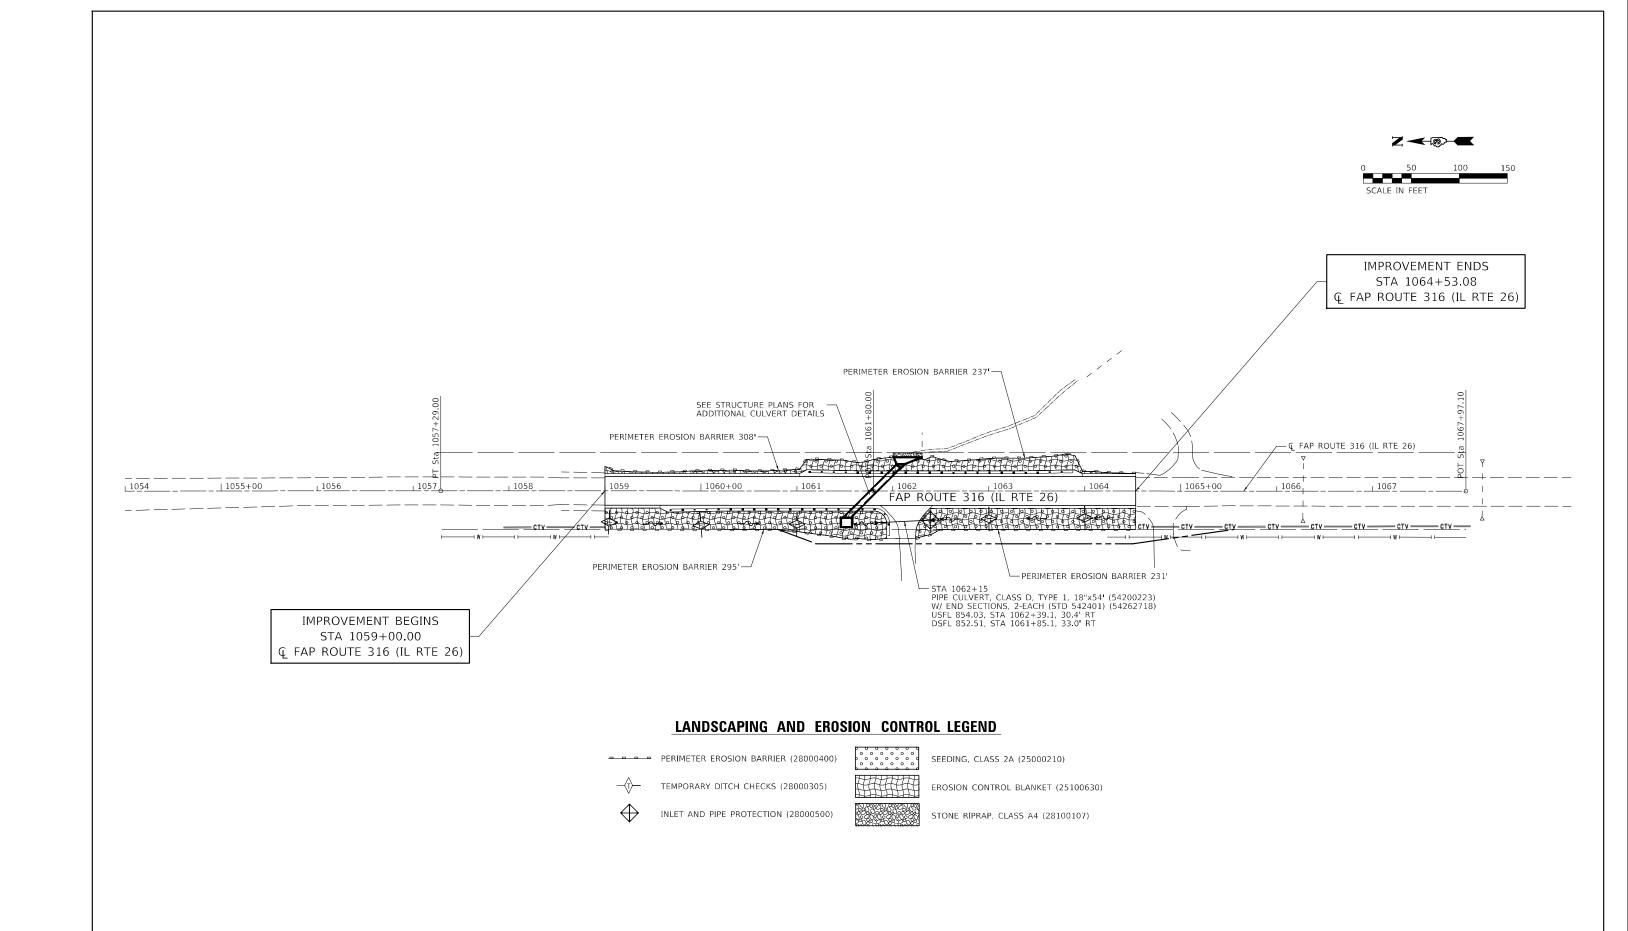


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Jacksonville Moline Peoria Shorewood	PLO
Since 1945	DI O

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nc.		DRAWN	-	RMD	REVISED -
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	PLOT DATE = 1/11/2022	DATE	-	11/5/2021	REVISED -

	F	AP ROL	JTE 316 (I	L RTE 26)		F.A.P. RTE	SEC.	ΠΟΝ		COUNTY	TOTAL SHEETS	
EROSION CONTROL & DRAINAGE PLAN							316 (114)CR		BUREAU	40	25	
					CONTRACT	NO. 6	6K35					
SCALE: 1"=50'	SHEET 1	OF 1	SHEETS	STA. 1054+00	TO STA. 1067+97.10			ILLINOIS	FED. AI	D PROJECT		

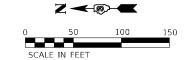

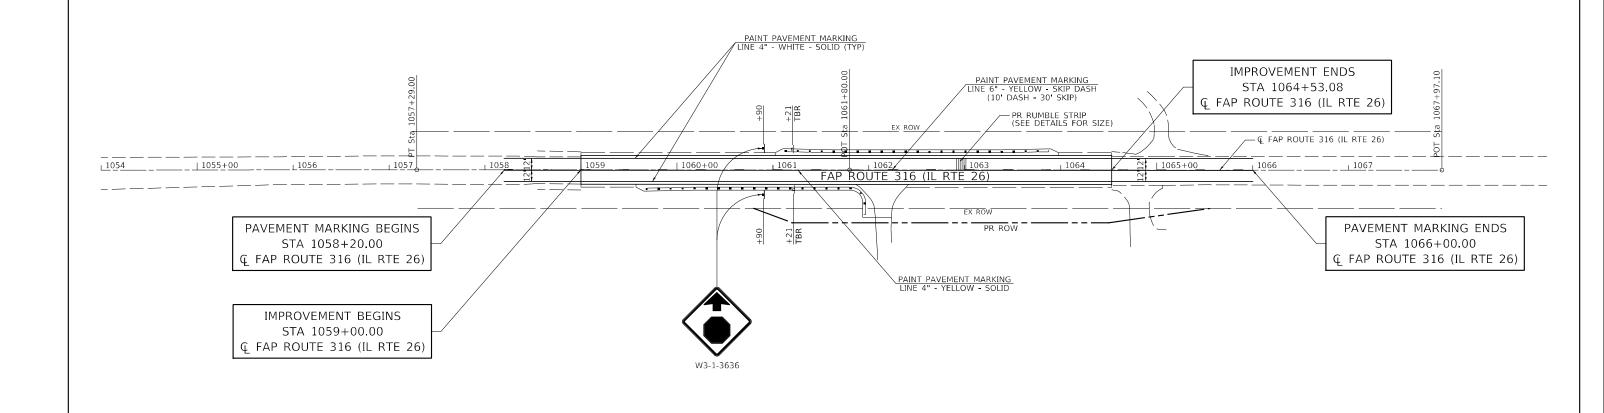


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¥ME:	$m{H}$ utchison Engineering, Inc.	
E S	Jacksonville Moline Peoria Shorewood Since 1945	PL
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Inc.		DRAWN	-	RMD	REVISED	-
boows	PLOT SCALE = \$SCALE\$	CHECKED	-	WLP	REVISED	-
	PLOT DATE = 1/11/2022	DATE	-	11/5/2021	REVISED	-

STATE OF	: ILLINOIS
DEPARTMENT OF	TRANSPORTATION

FAP ROUTE 316 (IL RTE 26)									SE
	316	(1:							
				,,,	iiigii a a	SIGNING PLAN	<u> </u>		
SCALE: 1"=50'	SHEET	1	OF	1	SHEETS	STA. 1054+00	TO STA. 1067+97.10		

	F.A.P. RTE	SEC ⁻	IJON		COUNTY	TOTAL SHEETS	SHEE NO.
	316	(114	I)CR		BUREAU	40	26
					CONTRACT	NO. 66	5K35
+97.10			ILLINOIS	FED. A	ID PROJECT		

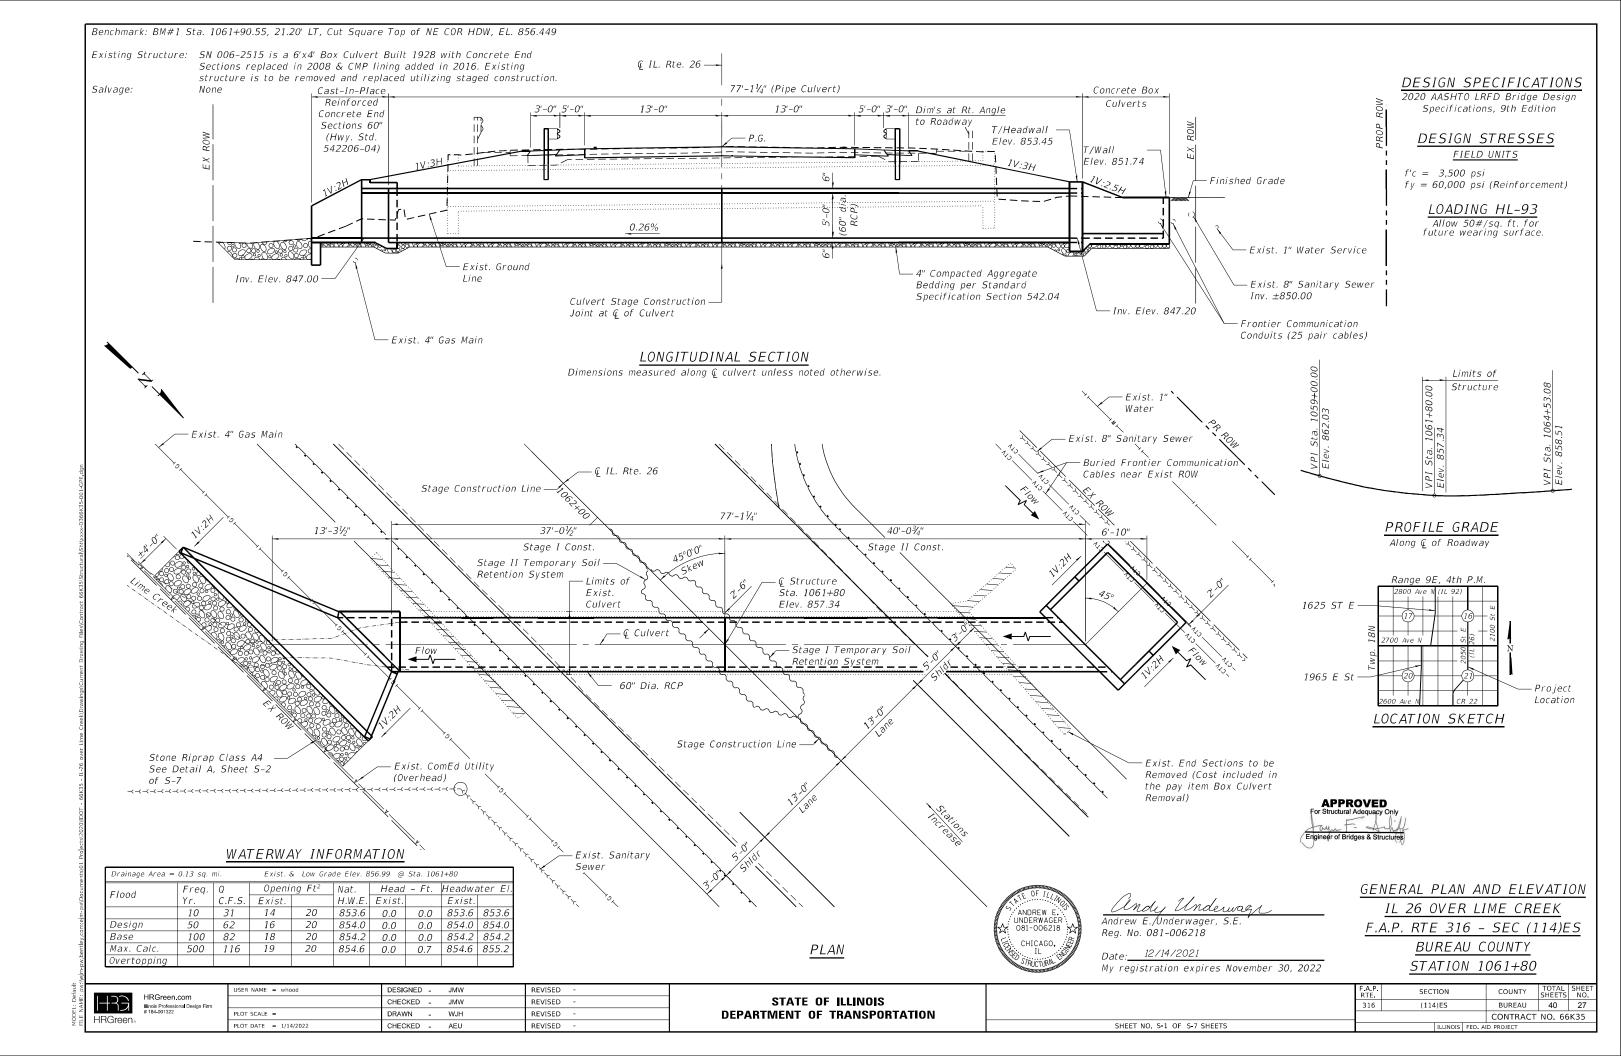


GENERAL NOTES


- 1. Fill varies from 4'-0" to 5'-0" within limits of roadway.
- 2. Contractor shall maintain ditch flows in accordance with the Standard Specifications Article 502.
- 3. Cover from the face of Cast-in-Place Concrete to reinforcement bars shall be 3" from surfaces formed against earth and 2" for all other surfaces unless otherwise shown.
- 4. Chloride containing admixtures shall not be used for Class SI concrete.
- 5. Removal and Disposal of Unsuitable Material and Porous Granular Embankment pay items are listed with an assumed quantity for 1' or overexcavation to be used if poor soils are encountered below the base of the culvert and end sections.

TOTAL BILL OF MATERIAL

ITEM NO.	ITEM	UNIT	QUANTITY
20201200	Removal and Disposal of Unsuitable Material	Cu Yd	44
20700220	Porous Granular Embankment	Cu Yd	44
28100107	Stone Riprap, Class A4	Sq Yd	24
28200200	Filter Fabric	Sq Yd	24
50800105	Reinforcement Bars	Pound	2,008
52200020	Temporary Soil Retention System	Sq Ft	538
54003000	Concrete Box Culverts	Cu Yd	10
54215460	Cast-In-Place Reinforced Concrete End Sections 60"	Each	1
542A1105	Pipe Culverts, Class A, Type 2 60"	Foot	78
X1200050	Box Culvert Removal	Foot	60

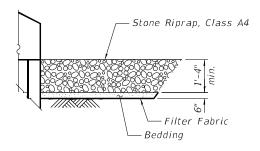

DETAIL A

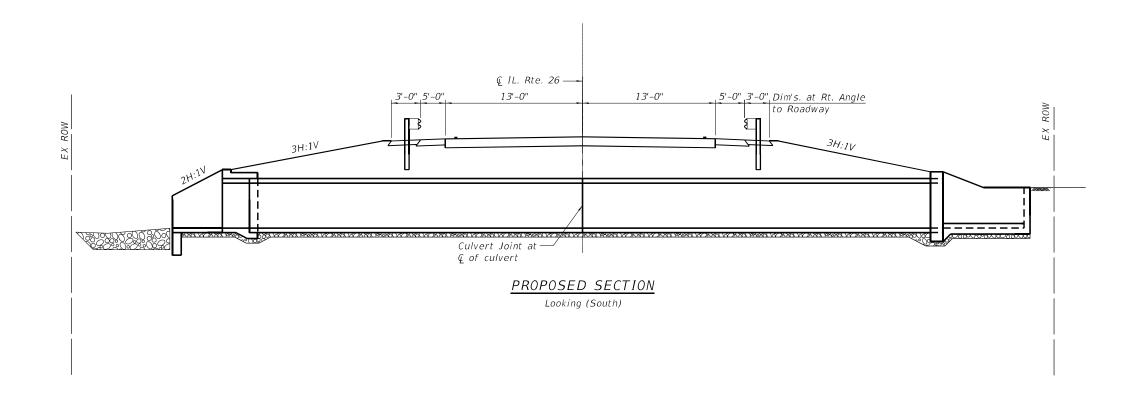


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USER NAME = whood	DESIGNED - JMW	REVISED -
	CHECKED - JMW	REVISED -
PLOT SCALE =	DRAWN - WJH	REVISED -
PLOT DATE = 1/14/2022	CHECKED - AEU	REVISED -


STATE OF	ILLINOIS
DEPARTMENT OF	TRANSPORTATION


OFNEDAL DATA		A.P. SECTION			COUNTY	TOTAL SHEETS	SHEET NO.
GENERAL DATA	316	(114)ES			BUREAU	40	28
					CONTRACT	NO. 66	K35
SHEET NO. S-2 OF S-7 SHEETS			ILLINOIS	FED. AI	D PROJECT		

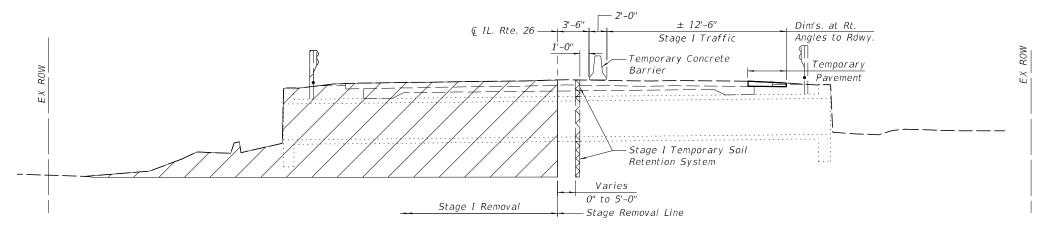

STAGE I REMOVAL

Looking (South)

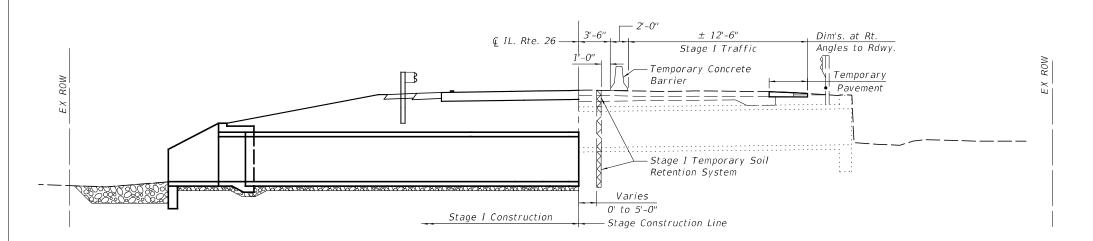

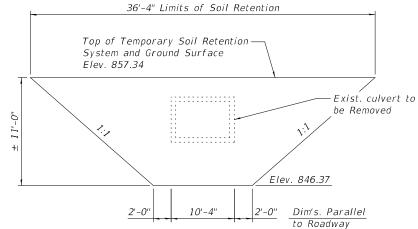

STAGE I TEMPORARY SOIL RETENTION SYSTEM

Note: the sketch above represents an estimated area of retained soil near the staged construction line for a single stage of construction. Per the IDOT Standard Specifications Article 522.07, all labor and material necessary to design and construct a soil retention system and any modifications to the soil retention system required for additional stages of construction shall be included in the unit price for the Temporary Soil Retention System.


STAGE	Ι	CONSTRUCTION

Looking (South)

The Table	HRGreen,	HRGreen.com Illinois Professional Desig # 184-001322


USER NAME = default	DESIGNED - JMW	REVISED -
	CHECKED - JMW	REVISED -
PLOT SCALE =	DRAWN - WJH	REVISED -
PLOT DATE = 1/11/2022	CHECKED - AEU	REVISED -

STAGE CONSTRUCTION DETAILS	F.A.P. RTE	SECTION		COUNTY	TOTAL SHEETS	SHEE NO.
	316	(114)ES		BUREAU	40	29
				CONTRACT	NO 66	K35
SHEFT NO. S-3 OF S-7 SHEFTS		ILLINOIS	EED A	ID PROJECT		

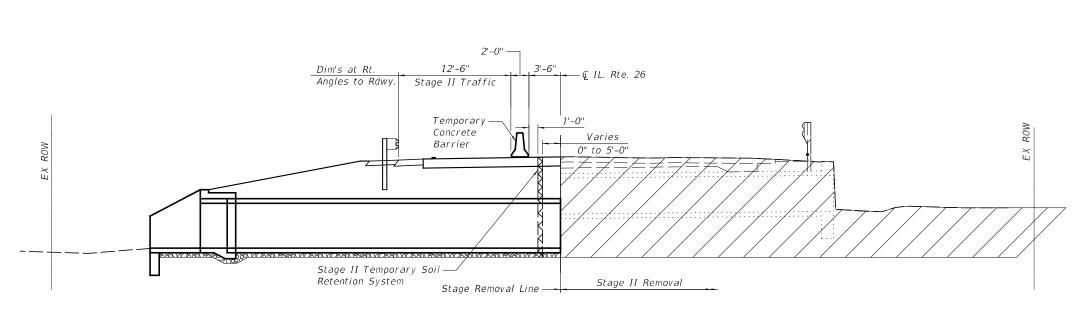


STAGE II REMOVAL

Looking (South)

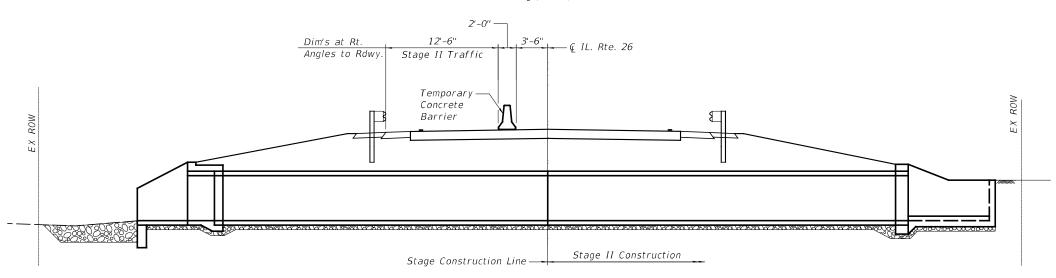

STAGE II CONSTRUCTION

Looking (South)

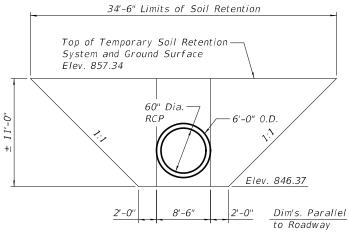

STAGE II TEMPORARY SOIL RETENTION SYSTEM


Note: the sketch above represents an estimated area of retained soil near the staged construction line for a single stage of construction. Per the IDOT Standard Specifications Article 522.07, all labor and material necessary to design and construct a soil retention system and any modifications to the soil retention system required for additional stages of construction shall be included in the unit price for the Temporary Soil Retention System.

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	PLOT SCALE =	DRAWN - WJH	REVISED -
	PLOT DATE = 1/11/2022	CHECKED - AEU	REVISED -
_			,

STAGE CONSTRUCTION DETAILS	F.A.P. RTE.	SECTION	COUNTY	TOTAL SHEETS	SHEE NO.
	316	(114)ES	BUREAU	40	30
			CONTRACT	NO. 66	K35
SHEET NO. S-4 OF S-7 SHEETS		ILLINOIS FED. A	ID PROJECT		



PLAN

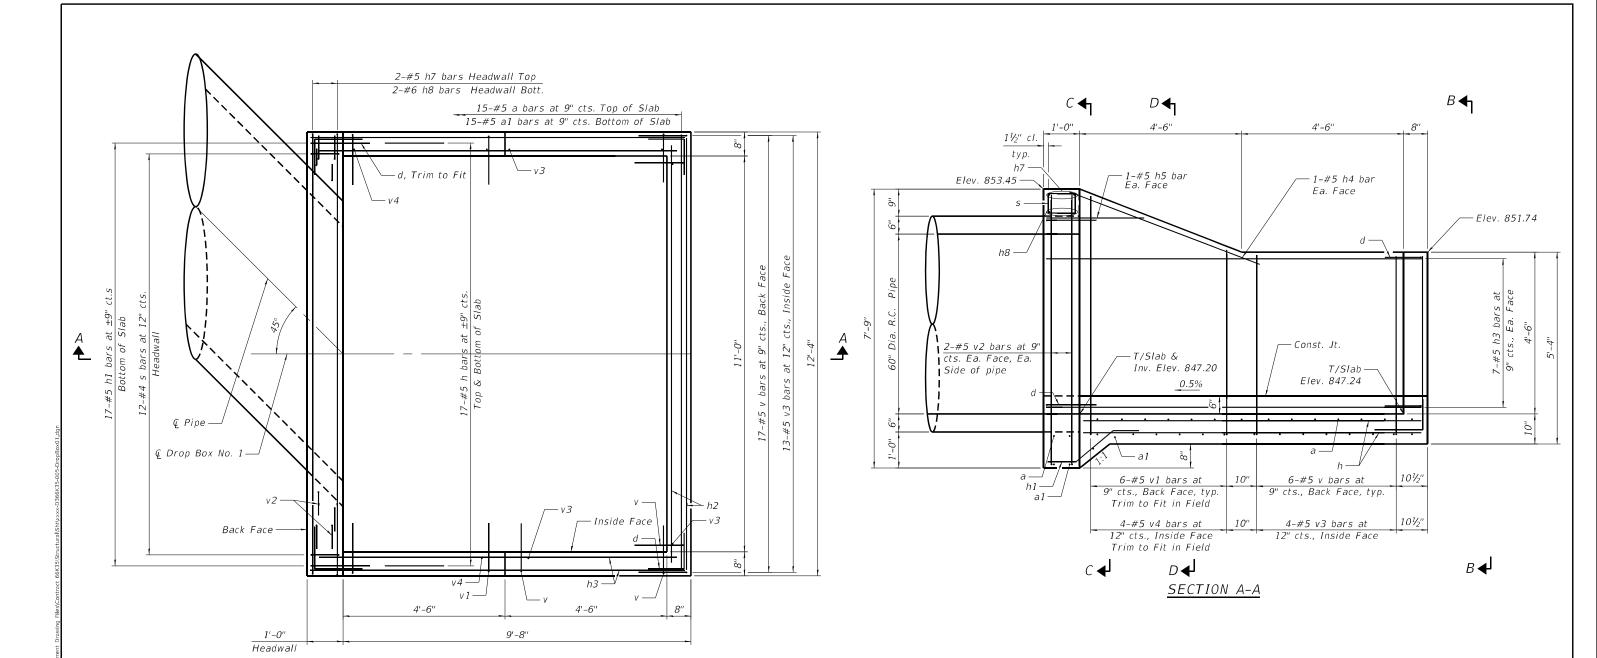GENERAL NOTES


- 1. The contract unit price per Cubic Yard for Concrete Box Culverts shall include the Concrete, Earth Excavation, backfilling and necessary grading to construct the drop box as shown.
- 2. This work shall be done according to the applicable portions of 501, 503, 505, 508, and 540 of the Standard Specifications.
- 3. See Section C-C, Section D-D and View B-B on Sheet S-5 of S-7 for reinforcement clearance.

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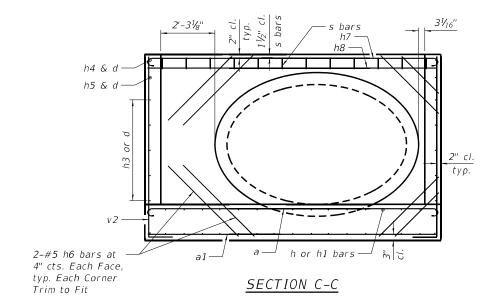
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PLOT SCALE =	DRAWN -	WJH	REVISED -
PLOT DATE = 1/14/2022	CHECKED -	AEU	REVISED -


STATI	E OF	ILLINOIS
DEPARTMENT	0F	TRANSPORTATION

DROP BOX		SECT	ΓΙΟΝ		COUNTY	TOTAL SHEETS	SHEET NO.
PLAN AND ELEVATION	316	(114)ES		BUREAU	40	31	
FLAN AND ELEVATION					CONTRACT	NO. 66	K35
SHEET NO. S-5 OF S-7 SHEETS			ILLINOIS	FED. AI	D PROJECT		

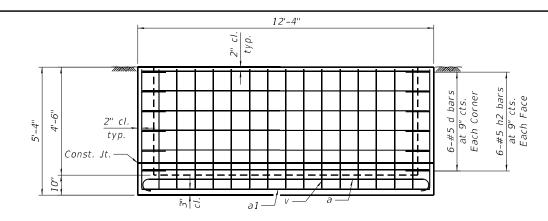


VIEW B-B




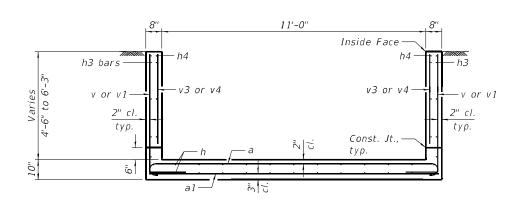


SECTION D-D

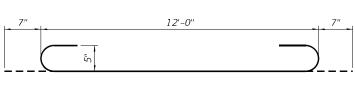

<u>BARS a & h7</u>

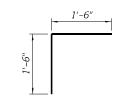

<u>BAR d</u>

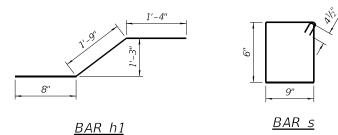

<u>BARS v, v1 & v2</u>

BILL OF MATERIALS

BAR	NO.	SIZE	LENGTH	SHAPE
а	15	#5	13'- 2"	
a1	15	#5	12'- 0"	
d	24	#5	3'- 0"	Γ
h	34	#5	9'- 4"	
h1	17	#5	3'- 9"	
h2	12	#5	12'- 0"	
h3	28	#5	10'- 4"	
h4	4	#5	5'- 4"	
h5	4	#5	2'- 8"	
h6	16	#5	4'- 6"	
h7	2	#5	13'- 2"	ـــــ
h8	2	#6	12'- 0"	
S	12	#4	3'- 3"	
V	29	#5	6'- 3"	_
v 1	12	#5	8'- 0"	
v2	8	#5	8'- 8"	_
v3	21	#5	3'- 10"	
v 4	8	#5	5'- 7"	
DESCRI	PTION		UNIT	QTY.
Concret	е Вох С	ulverts	Cu. Yd.	10.0
Reinfor	cement	Bars	Pound	2,008
Reinfor	cement	Bars ———	Pound	2,00

HRGreen.com Illinois Professional Design Firm #184-001322

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USER NAME = whood	DESIGNED - JMW	REVISED -	_
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PLOT SCALE =	DRAWN - WJH	REVISED -	
PLOT DATE = 1/14/2022	CHECKED - AEU	REVISED -	

DROP BOX	F.A.P. RTE.	SECTION		COUNTY	TOTAL SHEETS	SHEE NO.	
DETAILS	316	(114	1)ES		BUREAU	40	32
DETAILS					CONTRACT	NO. 66	K35
SHEET NO. S-6 OF S-7 SHEETS			ILLINOIS	FED. AI	D PROJECT		



SOIL BORING LOG

Page <u>1</u> of <u>1</u>

Date __4/13/07_

ROUT	FAP 316 (IL 26)		SCR	IPTION	N _IL	26 ove	er a Stream, 0.20 miles	South of IL 9	2_ LC	OGGI	ED BY	Larry	Myer
SECT	TON (114)I		_ 1	LOCAT	TION _			RNG. 09E,					
cour	NTY Bureau DR	RILLING	ME	THOD	c		ide , Longitude llow Stem Auger	HAMMER	TYPE .		ME A	utoma	itic
Stat	ICT. NO. 006-2515 ion 1061+80	=	D E P T	B L O W	U C S	M O I S	Surface Water Elev. Stream Bed Elev.	851.80	ft ft	D E P T	B L O W	U C S	M 0 1 S
Stat	NG NO. 1 (N.E. Quad.) ion 1061+66 et 17.0 ft Lt.	_	н	S	Qu	Т	Groundwater Elev.: First Encounter Upon Completion		ft	н	S	Qu	Т
	und Surface Elev. 856.92	ft	(ft)	(/6")	(tsf)	(%)	After Hrs.		ft	(ft)	(/6")	(tsf)	(%)
Auge Brow	red Brown Shoulder Stone, n Silty Clay Fill		_				Very Stiff Brownish G Clay Loam Till (contin	ray Sandy ued)	0	_	6 10	3.7 S	12
		854.42							10	_	•		
Stiff I	Dark Brown Silty Clay Loam		_	3	1.3	27	-		0.5	_	3 5	3.1	13
		05040		3	Р					-	7	S	
Stiff E	Black to Brown Silty Clay Fill?	852.42	-5	2			Free Water at 25 Ft.		1	-25	2		
				3	1.3	32	Tree water at 25 rt.				7	2.9	12
		0.40.00	_	3	Р		Layers of Sand / Grav	el at 26 Ft.			14	S	
Stiff E	Black Clay / Silty Clay Fill?	849.92	: ::==	3							7		
			_	2 4	1.0 P	35	Layers of Sandy Loan	n at 28 Ft.		_	10 14	3.5 S	13
		846.92	-10							-30			
Stiff (Gray / Brown Silty Clay Loam		-	5	1.2	16				-	5	3.2	13
			_	5	B	10					9	S.2	13
		844.42		1									
Layer	Stiff Gray Sandy Loam with s of Sandy Clay Loam & / Gravel & Silt Pockets	Į.	_	3 5 7	2.7 B	14				_			
	7 Graver a Gill 1 Goldon		-15	Ė	В		* Hole caved in at 14	Ft.		-35			
3			-13	5					0	-30	4		
3			_	7 8	2.7 S	16	1		820.42		5	3.0 S	13
		839.92	. –	۳	-		End of Boring		020.42	-		- 3	
Very	Stiff Brownish Gray Sandy Loam Till		_	3						_			
Very Clay	Louin IIII		_	5	2.9	14	1						
			_	7	В								
5			_										

The Unconfined Compressive Strength (UCS) Failure Mode is indicated by (B-Bulge, S-Shear, P-Penetrometer)
The SPT (N value) is the sum of the last two blow values in each sampling zone (AASHTO T206)
BBS, form 137 (Rev. 8-99)



SOIL BORING LOG

Page $\underline{1}$ of $\underline{1}$

Date __4/13/07

SECTION(114)I		_ ι	OCAT	ION _	NE 1/4	4, SEC. 16, TWP. 18N, RNG. 09E, de , Longitude					
COUNTYBureau DR	ILLING	ME	THOD			low Stem Auger HAMME	R TYPE		ME A	utoma	tic
STRUCT. NO. 006-2515 Station 1061+80 BORING NO. 2 (N.W. Quad.) Station 1061+63 Offset 15.0 ft Rt. Ground Surface Elev. 857.23	_	D E P T H	B L O W S	U C S Qu (tsf)	M O I S T (%)	Surface Water Elev. Stream Bed Elev. Groundwater Elev.: First Encounter Upon Completion After Hrs.	ft 2_ft⊻ 2_ft∑	D E P T H	B L O W S (/6")	U C S Qu (tsf)	M O I S T
Augered Brown Shoulder Stone, Brown Silty Clay Fill	854.73					Very Stiff Brownish Gray Sandy Clay Loam Till (continued)			7 9	3.1 S	13
Stiff Brown Silty Clay Loam, Silty Clay Fill		_	2 3 2	1.3 P	20	Free Water at 23 Ft.		<u>v</u> _	4 6 9	2.9 S	1.
	850.23	-5	2 2 2	1.0 P	18	Minor Layers of Sand at 24 Ft.		-25	6 9 11	3.4 S	1
Stiff Brown, Gray, Green Sandy Clay Loam / Sandy Loam Fill?	850.23	<u> </u>	2 2 2	1.3 P	27			=	5 8 10	3.1 S	1
Stiff Brown / Gray Silty Clay Loam / Silty Loam	847.73	-10	2 3 5	1.5 P	18			-30	5 7 11	3.1 S	3
Very Stiff Brownish Gray Sandy Clay Loam Till	845.23	- -	2 3	2.1	14			=		3	
Layers of Sandy Lcam at 15 Ft.		-15	6 9	2.6	11			-35	6	2.7	10
		_	6	S	42	End of Boring	820.7	3 _	9	S	
		-20	7 8	2.5 S	13			-40			

The Unconfined Compressive Strength (UCS) Failure Mode is indicated by (B-Bulge, S-Shear, P-Penetrometer)
The SPT (N value) is the sum of the last two blow values in each sampling zone (AASHTO T206)
BBS, form 137 (Rev. 8-99)

HRGreen»	HRGreen.com Illinois Professional Desi # 184-001322


 USER NAME
 default
 DESIGNED
 JMW
 REVISED


 CHECKED
 JMW
 REVISED


 PLOT SCALE
 DRAWN
 WJH
 REVISED

 PLOT DATE
 =
 1/11/2022
 CHECKED
 AEU
 REVISED

STATE OF ILLINOIS
DEPARTMENT OF TRANSPORTATION

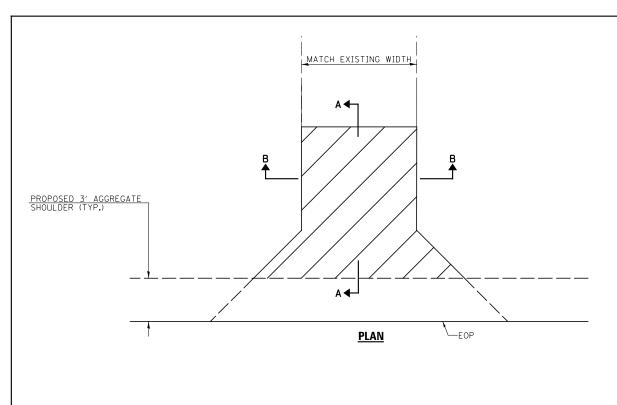


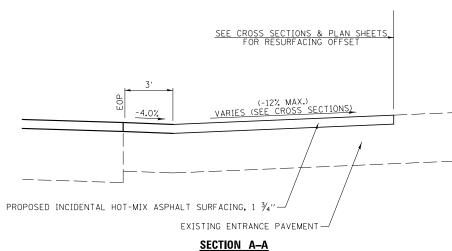

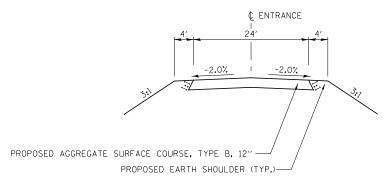

SECTION B-B

COMMERCIAL ENTRANCE (CE) DETAILS

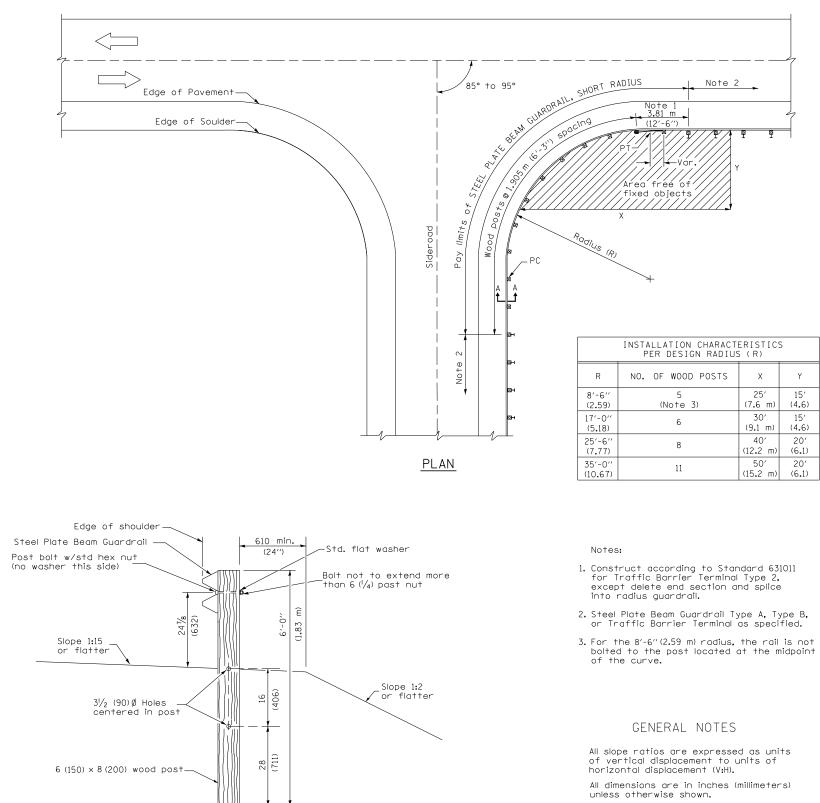

STEEL PLATE BEAM GUARDRAIL, SHORT RADIUS

2	TT	USER NAME = default	DESIGNED - LDZ	REVISED -
HINE:	Hutchison Engineering, Inc.		DRAWN - RMD	REVISED -
N.	Jacksonville Moline Peoria Shorewood Since 1945	PLOT SCALE = \$SCALE\$	CHECKED - WLP	REVISED -
Ĕ	2luce 1942	PLOT DATE = 1/11/2022	DATE - 11/5/2021	REVISED -

STATE OF ILL	INOIS
DEPARTMENT OF TRA	NSPORTATION


SECTION A-A

SCALE: N/A

SHEET 1

F	AP RO	UTE	316 (II	RTE 26)		F.A.P. RTE	SECTION			COUNTY	TOTAL SHEETS	SHEET NO.		
	MISCELLANEOUS DETAILS						(114)CR			BUREAU	40	34		
	VIJOCLI		IVLOUS	DEIAILO						CONTRACT NO. 66K35				
1	OF	3	SHEETS	STA. N/A	TO STA. N/A	ILLINOIS FED. AID PROJECT								

BDE Memo 36-03 Attachment A

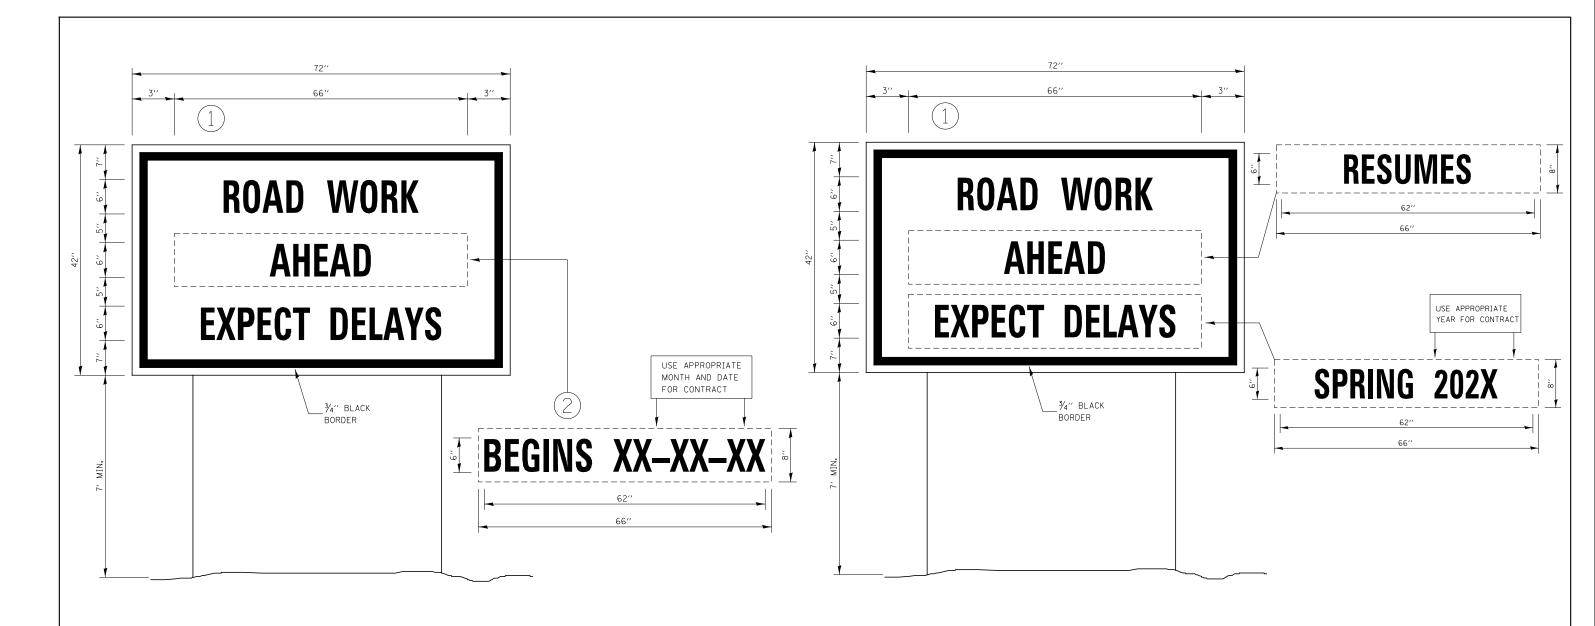

TEMPORARY INFORMATION SIGNING

WINTER SHUT DOWN SIGNING

NOTES:


- 1. USE 6" D BLACK LETTERING ON FLOURESENT ORANGE BACKGROUND.
- ERECT SIGNS AT LOCATIONS IN ADVANCE OF THE "ROAD CONSTRUCTION AHEAD" SIGNS AS DIRECTED BY THE ENGINEER.
- 3. ERECT SIGN () WITH INSTALLED PANEL (2) A MINIMUM OF ONE WEEK PRIOR TO THE START OF THE LANE CLOSURE.
- 4. REMOVE PANEL (2) ON THAT DATE.
- 5. SEE SPECIAL PROVISION "TEMPORARY INFORMATION SIGNING" FOR ADDITIONAL INFORMATION.
- 6. WILL BE PAID FOR PER SQ FT AS "TEMPORARY INFORMATION SIGNING". EACH SIGN = 21 SQ FT AND THE DATE PANEL ② WILL NOT BE MEASURED SEPARATELY FOR PAYMENT.


SFI	TT	USER NAME	= default
AME .	M utchison Engineering, inc.		
E N.	Hutchison Engineering, Inc. Jacksonville Moline Peoria Shorewood Since 1945	PLOT SCALE	= \$SCALE\$
ÉĒ	2luce 1342	PLOT DATE	= 1/11/2022

	USER NAME = default	DESIGNED	-	LDZ	REVISED -	
nc.		DRAWN	-	RMD	REVISED -	
boov	PLOT SCALE = \$SCALE\$	CHECKED	-	WLP	REVISED -	
	PLOT DATE = 1/11/2022	DATE	-	11/5/2021	REVISED -	

STAT	E OI	F ILLINOIS
DEPARTMENT	0F	TRANSPORTATION

F	FAP ROUTE 316 (IL RTE 26)						F.A.P. RTE				TOTAL SHEETS	SHEE NO.		
	MISCELLANEOUS DETAILS					316	(114	-)CR		BUREAU	40	35		
	MISOLLI	ייים	ILUU3 I	DEIAILO								CONTRACT	NO. 66	5K35
2	OF 3		SHEETS	STA N/A		TO STA N/A	١			TELIMOTE	EED AL	D BROJECT		

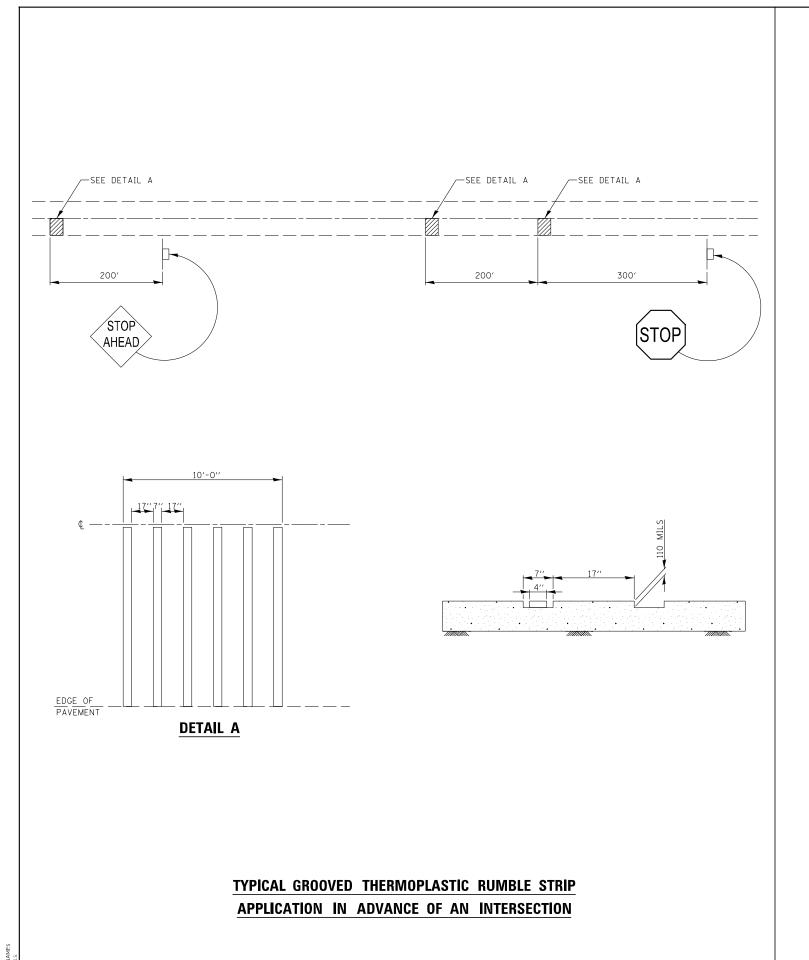

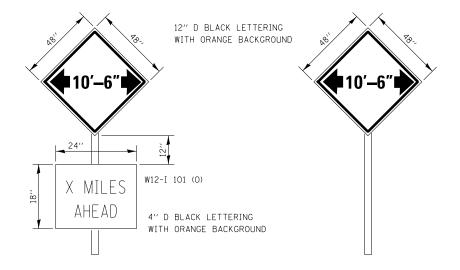

TO BE POST MOUNTED AT THE FOLLOWING LOCATIONS:

- NORTHBOUND IMMEDIATELY PRIOR TO CONSTRUCTION ZONE.
- SOUTHBOUND IN ADVANCE OF IL 26 AND IL 92 INTERSECTION.
- EASTBOUND IN ADVANCE OF IL 26 AND IL 92 INTERSECTION.
- WESTBOUND IN ADVANCE OF IL 26 AND IL 92 INTERSECTION.

ENGINEER SHALL DETERMINE EXACT LOCATION.

SHEET 3

THE ENGINEER WILL NOTIFY DISTRICT 3 BUREAU OF OPERATIONS 14 CALENDAR DAYS PRIOR TO INSTALLING ANY TRAFFIC CONTROL DEVICES THAT WILL RESTRICT THE PAVEMENT WIDTH.

THE CONTRACTOR SHALL BE RESPONSIBLE FOR COORDINATING WITH THE ENGINEER TO MEET THIS REQUIREMENT.

COST OF SUPPLYING, INSTALLING, MAINTAINING AND REMOVING WIDTH RESTRICTION SIGNS SHALL BE INCLUDED IN THE COST OF THE TRAFFIC CONTROL AND PROTECTION PAY ITEMS.

SEE SPECIAL PROVISION FOR SUPPLEMENTAL "MILES AHEAD" PLAQUE INFORMATION.

WIDTH RESTRICTION SIGN AND ANY SUPPLEMENTAL DISTANCE/ARROW SIGNS SHALL BE BLACK LETTERS ON FLUORESCENT ORANGE SHEETING.

WIDTH RESTRICTION SIGNING DETAILS


TT	USER NAME
Hutchison Engineering,Inc	
Jacksonville Moline Peoria Shorewood Since 1945	PLOT SCALE
2IUC6 1342	PLOT DATE

	USER NAME = default	DESIGNED	-	LDZ	REVISED -	
nc.		DRAWN	-	RMD	REVISED -	
boo	PLOT SCALE = \$SCALE\$	CHECKED	-	WLP	REVISED -	
	PLOT DATE = 1/11/2022	DATE	-	11/5/2021	REVISED -	
						_

FAP ROUTE 316 (IL RTE 26) MISCELLANEOUS DETAILS				F.A.P. RTE	SECTION			COUNTY	TOTAL SHEETS	SHEET NO.
				316	(114)CR			BUREAU	40	36
									CONTRACT NO. 66K35	
OF 3	SHEETS	STA N/A	ΤΟ STΔ Ν/Δ			HILIMOTE	EED AL	D DROIECT		

 1059 ± 50 1059 ± 00 + DESIGNED REVISED COUNTY TOTAL SHEET NO.

BUREAU 40 37 SECTION FAP ROUTE 316 (IL RTE 26) STATE OF ILLINOIS DRAWN RMD REVISED (114)CR **CROSS SECTIONS DEPARTMENT OF TRANSPORTATION** PLOT SCALE = \$SCALE\$ CHECKED WLP REVISED CONTRACT NO. 66K35 SCALE: H=10 V=5 SHEET 1 OF 4 SHEETS STA. 1059+00 TO STA. 1060+50 11/5/2021

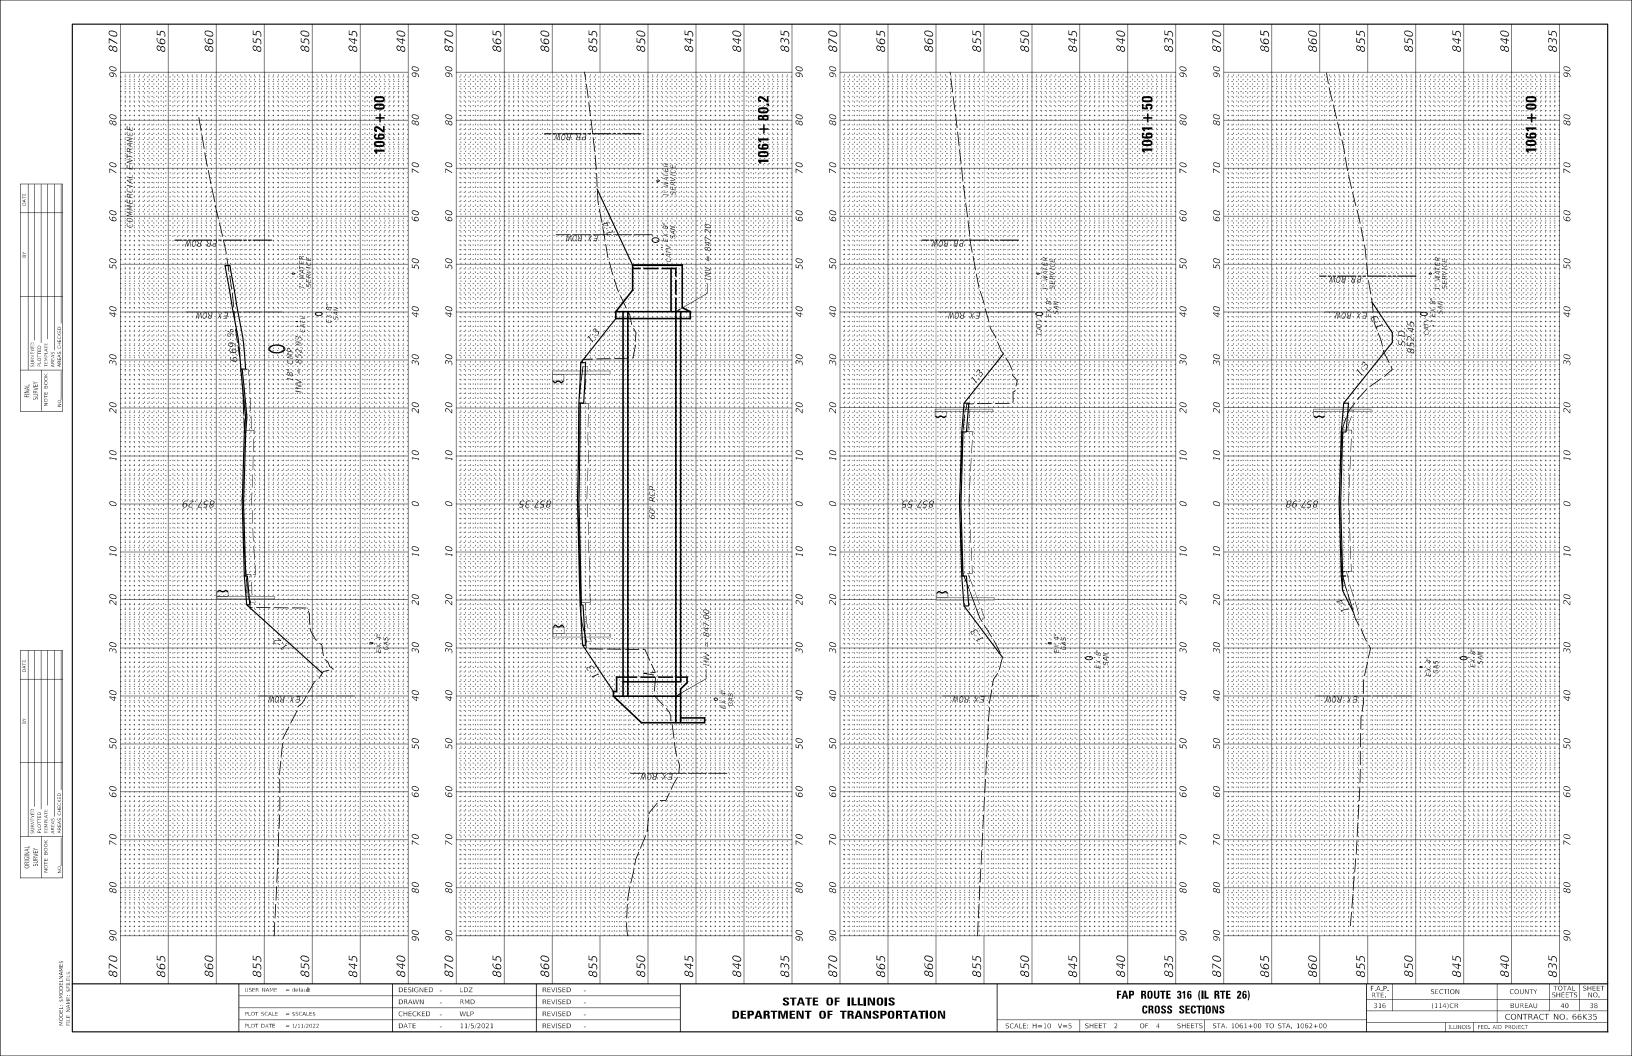

875 840 845 835 860 850 845 840 835 865 860 850 870 865 860 855 850 870 855 1062 ± 15.1015 1062 + 5095 258 875 860 870 845 865 850 845 860 850 COUNTY TOTAL SHEETS NO.

BUREAU 40 39 JSER NAME = defau**l**t DESIGNED -REVISED FAP ROUTE 316 (IL RTE 26) STATE OF ILLINOIS
DEPARTMENT OF TRANSPORTATION DRAWN RMD REVISED (114)CR CROSS SECTIONS PLOT SCALE = \$SCALE\$ CHECKED WLP REVISED CONTRACT NO. 66K35 11/5/2021 SCALE: H=10 V=5 SHEET 3 OF 4 SHEETS STA. 1062+15.1015 TO STA. 1063+00

