


NOTE:
1. SEE UTILITY PLAN AND PROFILE SHEETS FOR DETAILED STORM SEWER, SANITARY SEWER, AND WATER MAIN IMPROVEMENTS.

HORIZONTAL CURVE TABLE											
CURVE	LENGTH	RADIUS	DELTA	TANGENT	CHORD BEARING	CHORD LENGTH	M	PC	PT	PI	E
CURVE 1	113.80'	473.50'	13°46'13"	57.18'	N83°16'11"E	113.53'	3.41'	208+04.54	209+18.34	208+61.44	3.44'R
CURVE 2	110.20'	458.50'	13°46'13"	55.36'	S83°16'11"W	109.93'	3.31'	209+18.34	210+28.53	209+73.44	3.33'L

SCALE:
HORIZONTAL 1" = 20'
VERTICAL 1" = 5'

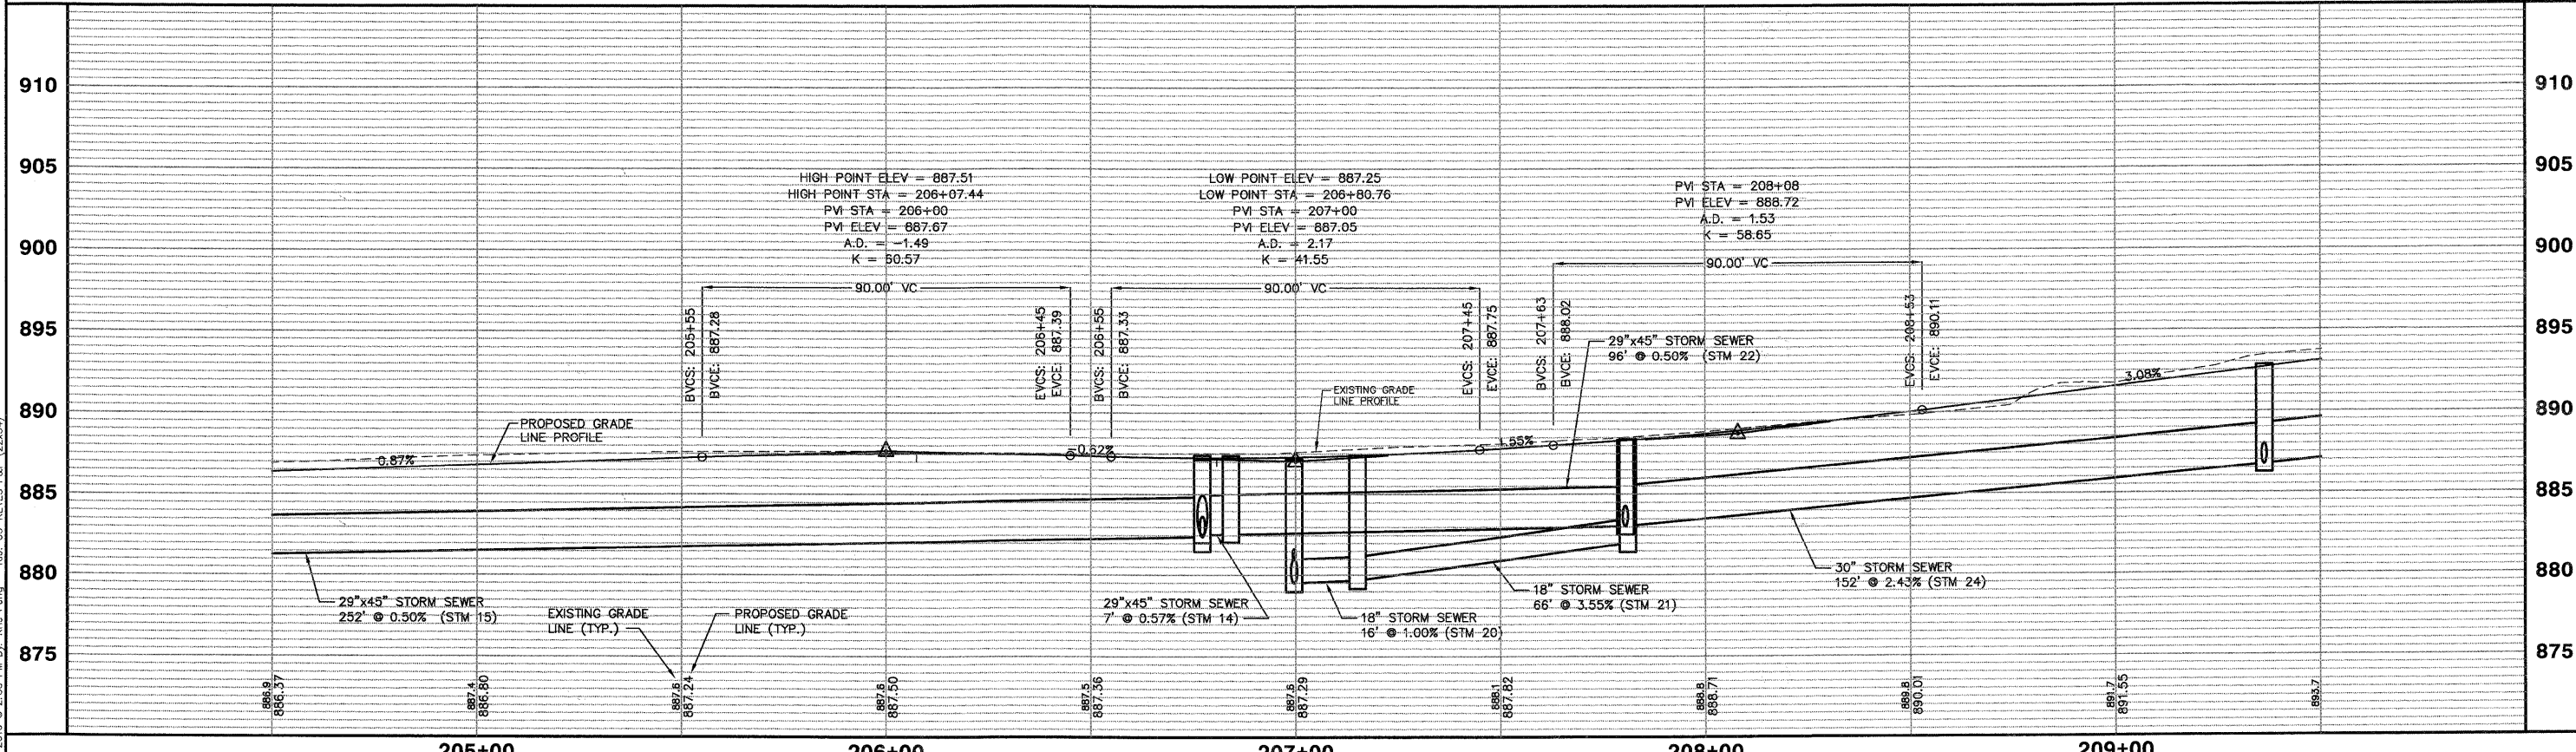

COPYRIGHT © 2010 ENGINEERING ENTERPRISES, INC. FILE NAME #FILE#				USER NAME = #USER# DESIGNED - JAM, SWM DRAWN - KKP CHECKED - JAM DATE - 10/16/09				REVISED - 12/02/09 REVISED - 01/22/10 REVISED - 02/03/10 REVISED -				STATE OF ILLINOIS DEPARTMENT OF TRANSPORTATION PROPOSED KEYES AVENUE PLAN AND PROFILE PROJECT NO. HPP-1468(004) JOB NO. C-91-175-06 SHEET NO. 32 OF 92 SHEETS STA. N/A TO STA. N/A				F.A. R.T.E. - SECTION N/A 06-00015-00-PV		COUNTY KANE		TOTAL SHEETS 97		SHEET NO. 35	
PLOT SCALE = #SCALE# PLOT DATE = #DATE#		DATE - 10/16/09		DATE - 10/16/09		DATE -		SCALE: 1"=20' SHEET NO. 32 OF 92 SHEETS		STA. N/A TO STA. N/A						FED. ROAD DIST. NO. - [ILLINOIS] FED. AID PROJECT		Contract No. 63406					

Plotted: February 1, 2010 @ 2:35 PM By: Kris Pung - Tab: 35--KEYES.Pkg (22-34)

Path: S:\SRG\QV\H0367\DWG\H0367.DWG\FINAL ENG\H0367-PP.ROD