EROSION CONTROL LEGEND मिक्षक प्रकार TEMPORARY EROSION CONTROL SEEDING TEMPORARY DITCH CHECK AND MULCH METHOD 2 TEMPORARY DITCH CHECK INSTALLED TEMPORARY EROSION CONTROL SEEDING AND TEMPORARY EROSION CONTROL BLANKET IN PREVIOUS STAGE PERMANENT SEEDING (SEE NOTE 3) INLET & PIPE PROTECTION TEMPORARY EROSION CONTROL SEEDING OR PERMANENT INLET & PIPE PROTECTION INSTALLED SEEDING INSTALLED IN A PREVIOUS STAGE IN PREVIOUS STAGE TEMPORARY PAVEMENT FLOW DIRECTION (SEE NOTE 4) PERIMETER EROSION BARRIER (SEE NOTE 2) PROPOSED STORM SEWER (SEE NOTE 1) PERIMETER EROSION BARRIER INSTALLED PROPOSED STORM SEWER INSTALLED IN PREVIOUS STAGE IN PREVIOUS STAGE INLET FILTER TEMPORARY PIPE CULVERT

CHECKED JCM

12/14/201

DATE

REVISED

REVISED

(27)

INLET FILTER INSTALLED IN PREVIOUS STAGE

PERMANENT DRAINAGE STRUCTURE


NUMBER (SEE NOTE 1)

NOTES

- 1. SEE PROPOSED DRAINAGE PLANS FOR STORM SEWER INFORMATION.
- PERIMETER EROSION BARRIER SHALL BE ERECTED ADJACENT TO R.O.W., EASEMENT, AND CONSTRUCTION LIMITS AND AS DIRECTED BY THE ENGINEER.
- 3. SEE LANDSCAPING PLANS FOR LANDSCAPING REQUIREMENTS.
- 4. SEE PRE-STAGE CROSS SECTIONS FOR GRADING INFORMATION.
- 5. REMOVING INLETS/CATCH BASINS/MANHOLES TO MAINTAIN FLOW.

SCALE: AS SHOWN SHEET NO. 7 OF 70 SHEETS STA. 85+50 TO STA. 97+00

CONTRACT NO. 60R30

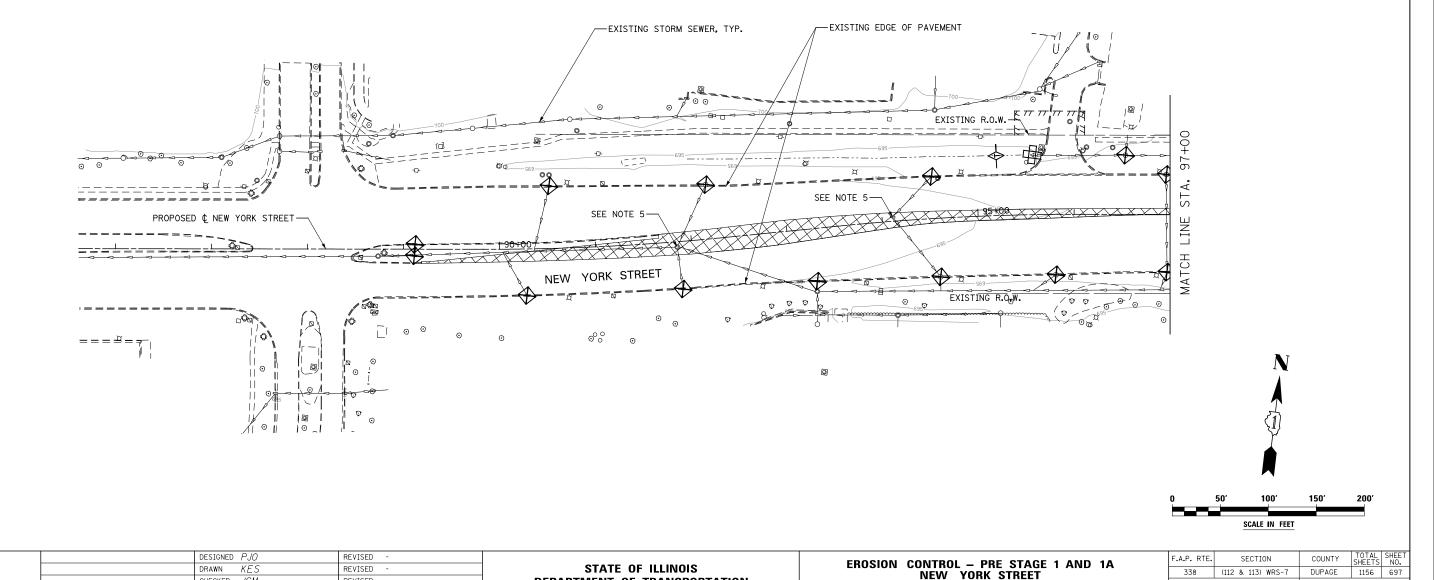

DEPARTMENT OF TRANSPORTATION