EROSION CONTROL LEGEND TEMPORARY EROSION CONTROL SEEDING TEMPORARY DITCH CHECK AND MULCH METHOD 2 TEMPORARY EROSION CONTROL SEEDING TEMPORARY DITCH CHECK INSTALLED AND TEMPORARY EROSION CONTROL BLANKET IN PREVIOUS STAGE \oplus PERMANENT SEEDING (SEE NOTE 3) INLET & PIPE PROTECTION \oplus TEMPORARY EROSION CONTROL SEEDING OR PERMANENT INLET & PIPE PROTECTION INSTALLED SEEDING INSTALLED IN A PREVIOUS STAGE IN PREVIOUS STAGE TEMPORARY PAVEMENT FLOW DIRECTION (SEE NOTE 4) PERIMETER EROSION BARRIER (SEE NOTE 2) PROPOSED STORM SEWER (SEE NOTE 1) PERIMETER EROSION BARRIER INSTALLED PROPOSED STORM SEWER INSTALLED IN PREVIOUS STAGE IN PREVIOUS STAGE \oplus

DRAWN KES

CHECKED JCM

12/14/201

DATE

REVISED

REVISED

REVISED

(27)

TEMPORARY PIPE CULVERT

NUMBER (SEE NOTE 1)

PERMANENT DRAINAGE STRUCTURE

INLET FILTER

INLET FILTER INSTALLED IN PREVIOUS STAGE

NOTES

- 1. SEE PROPOSED DRAINAGE PLANS FOR STORM SEWER INFORMATION.
- 2. PERIMETER EROSION BARRIER SHALL BE ERECTED ADJACENT TO R.O.W., EASEMENT, AND CONSTRUCTION LIMITS AND AS DIRECTED BY THE ENGINEER.
- 3. SEE LANDSCAPING PLANS FOR LANDSCAPING REQUIREMENTS.
- 4. SEE PRE-STAGE CROSS SECTIONS FOR GRADING INFORMATION.

(112 & 113) WRS-7


338

LIBERTY STREET

SCALE: AS SHOWN SHEET NO. 9 OF 70 SHEETS STA. 185+00 TO STA. 198+00

DUPAGE 1156 699

CONTRACT NO. 60R30

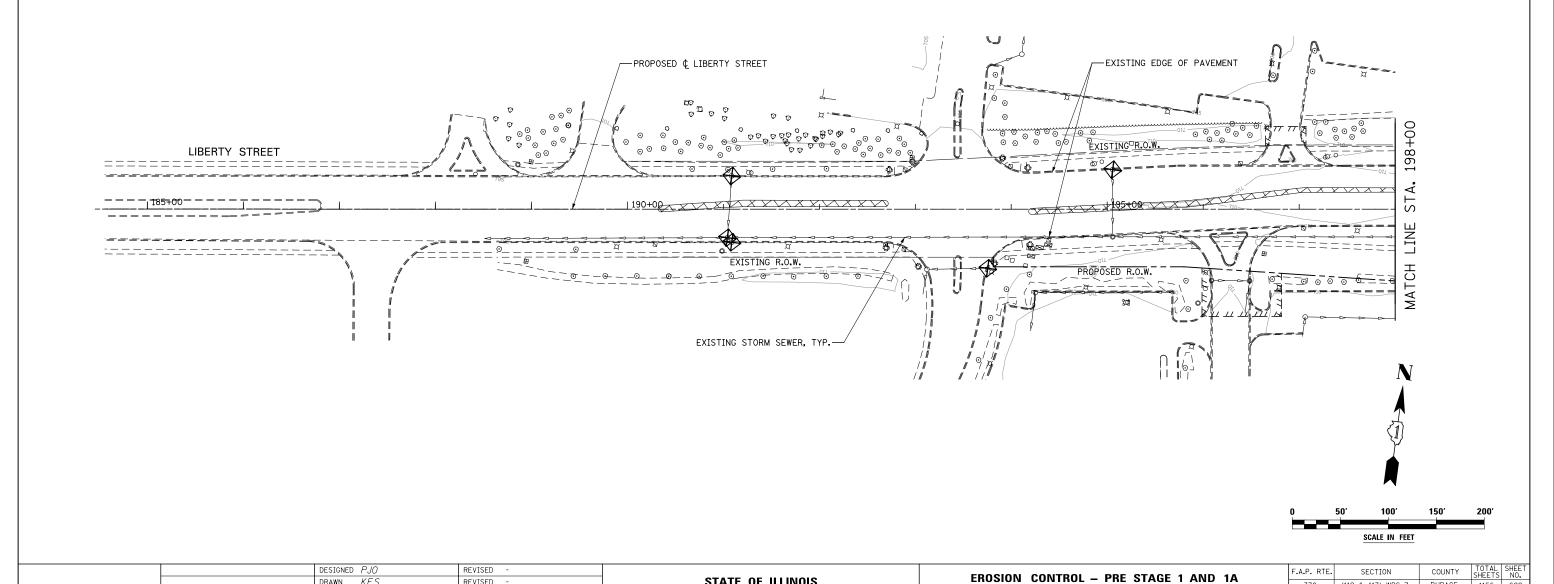

STATE OF ILLINOIS

DEPARTMENT OF TRANSPORTATION