EROSION CONTROL LEGEND TEMPORARY EROSION CONTROL SEEDING TEMPORARY DITCH CHECK TEMPORARY EROSION CONTROL SEEDING TEMPORARY DITCH CHECK INSTALLED AND TEMPORARY EROSION CONTROL BLANKET IN PREVIOUS STAGE PERMANENT SEEDING (SEE NOTE 3) INLET & PIPE PROTECTION TEMPORARY EROSION CONTROL SEEDING OR PERMANENT INLET & PIPE PROTECTION INSTALLED SEEDING INSTALLED IN A PREVIOUS STAGE IN PREVIOUS STAGE TEMPORARY PAVEMENT FLOW DIRECTION (SEE NOTE 4) PERIMETER EROSION BARRIER (SEE NOTE 2) PROPOSED STORM SEWER (SEE NOTE 1) PERIMETER EROSION BARRIER INSTALLED PROPOSED STORM SEWER INSTALLED IN PREVIOUS STAGE IN PREVIOUS STAGE INLET FILTER TEMPORARY PIPE CULVERT PERMANENT DRAINAGE STRUCTURE INLET FILTER INSTALLED IN PREVIOUS STAGE NUMBER (SEE NOTE 1)

CHECKED JCM

DATE

12/14/201

REVISED

REVISED

(*) - SEE NOTE 5

NOTES

- 1. SEE PROPOSED DRAINAGE PLANS FOR STORM SEWER INFORMATION.
- 2. PERIMETER EROSION BARRIER SHALL BE ERECTED ADJACENT TO R.O.W., EASEMENT, AND CONSTRUCTION LIMITS AND AS DIRECTED BY THE ENGINEER.
- 3. SEE LANDSCAPING PLANS FOR LANDSCAPING REQUIREMENTS.
- 4. SEE PRE-STAGE CROSS SECTIONS FOR GRADING INFORMATION.
- 5. PROPOSED STRUCTURE SHALL BE BURIED AND TEMPORARILY COVERED/CLOSED WITH STEEL PLATE OF THICKNESS SPECIFIED AND APPROVED BY THE ENGINEER, PAYMENT FOR THIS TEMPORARY COVER INSTALLATION AND REMOVAL SHALL BE CONSIDERED INCLUDED IN THE COST OF THE PROPOSED STRUCTURE.
- 6. REMOVING INLETS/CATCH BASINS/MANHOLES TO MAINTAIN FLOW.

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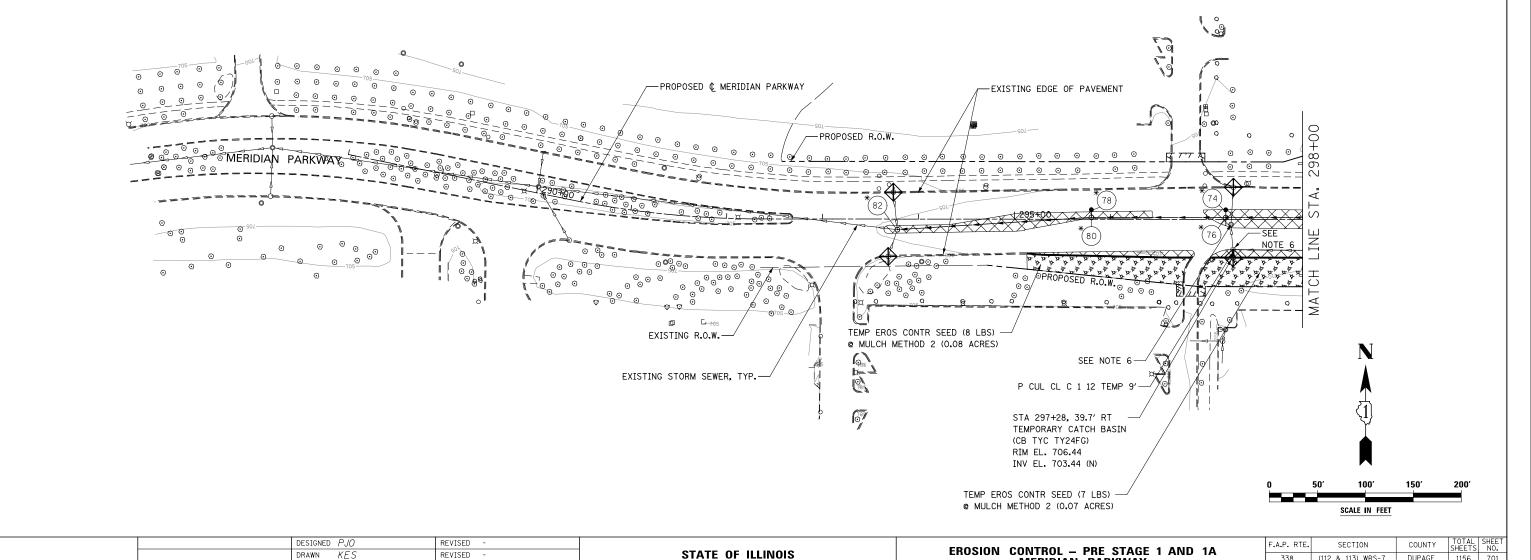
MERIDIAN PARKWAY

SCALE: AS SHOWN SHEET NO. 11 OF 70 SHEETS STA. 288+00 TO STA. 298+00

(112 & 113) WRS-7

DUPAGE 1156 701

CONTRACT NO. 60R30



DEPARTMENT OF TRANSPORTATION